

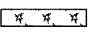
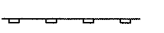

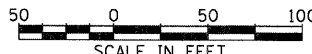
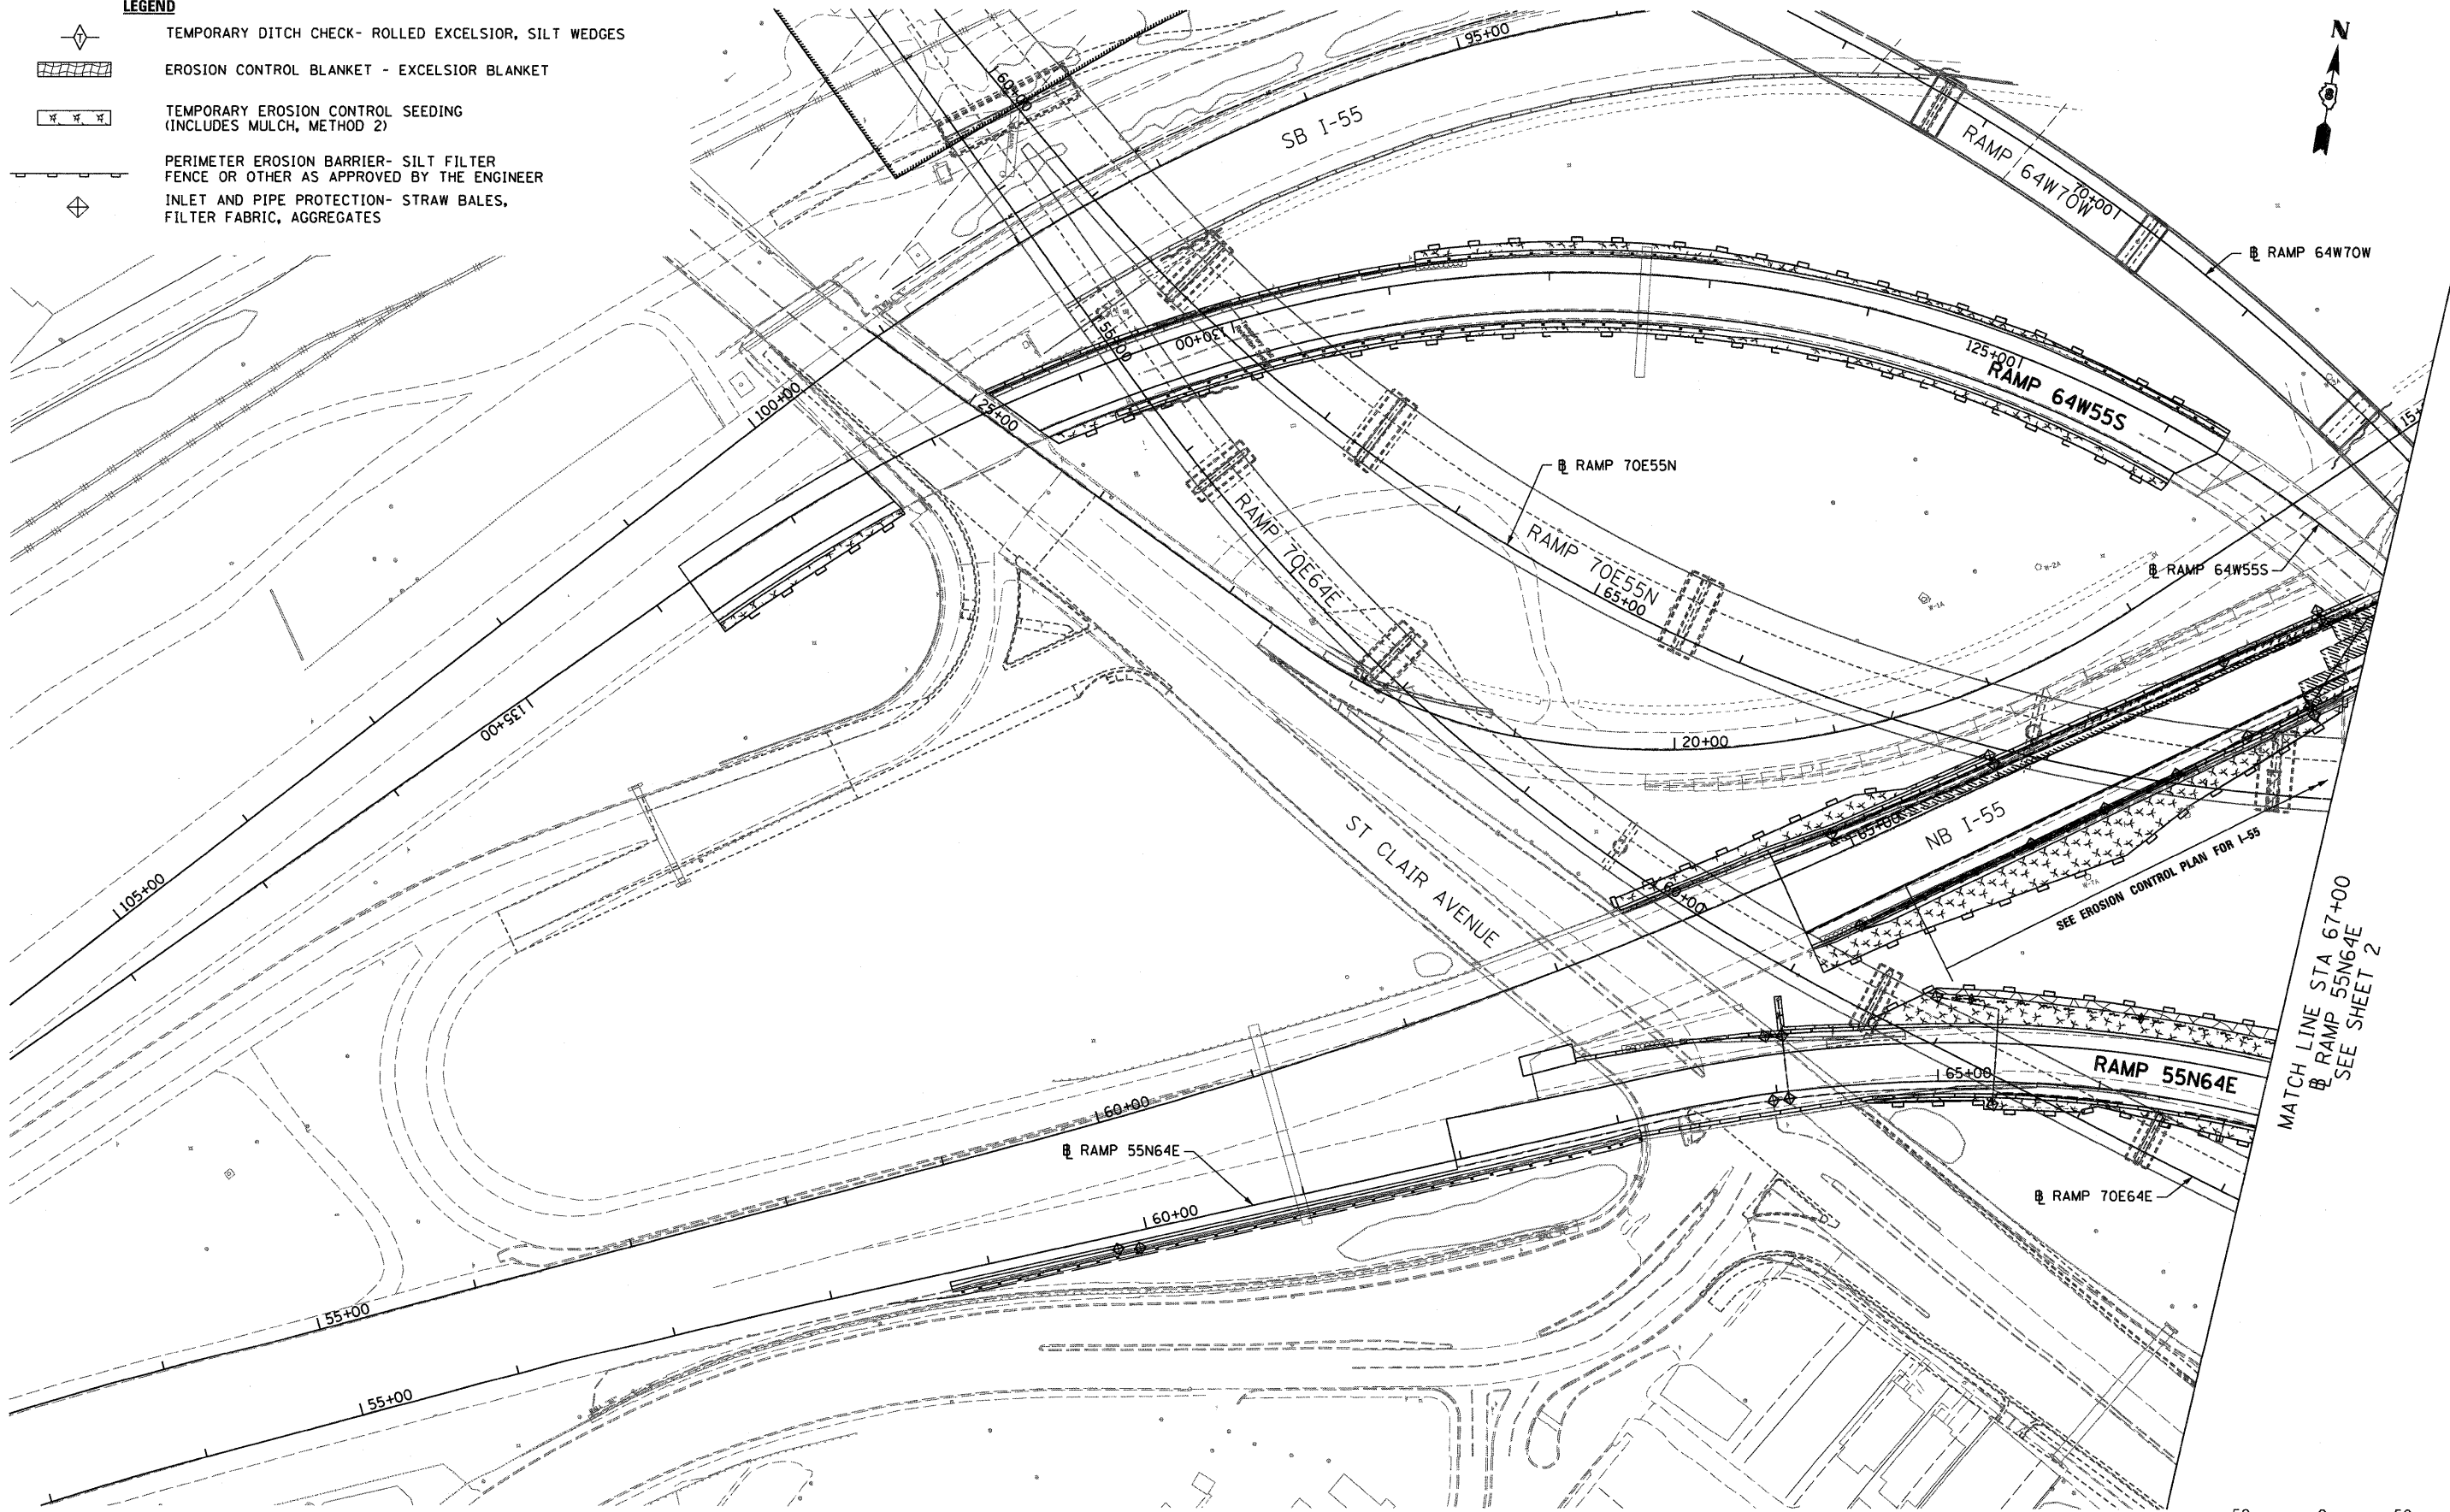


**LEGEND**

-  TEMPORARY DITCH CHECK- ROLLED EXCELSIOR, SILT WEDGES
-  EROSION CONTROL BLANKET - EXCELSIOR BLANKET
-  TEMPORARY EROSION CONTROL SEEDING (INCLUDES MULCH, METHOD 2)
-  PERIMETER EROSION BARRIER- SILT FILTER FENCE OR OTHER AS APPROVED BY THE ENGINEER
-  INLET AND PIPE PROTECTION- STRAW BALES, FILTER FABRIC, AGGREGATES



FILE NAME = DBT-1-76C52-ah-eros-01.dgn

USER NAME = searsb  
 PLOT SCALE = 100.0000' / in.  
 PLOT DATE = 1/24/2012

DESIGNED KK  
 DRAWN BS  
 CHECKED DBM  
 DATE 1-20-12

REVISED -  
 REVISED -  
 REVISED -  
 REVISED -

**STATE OF ILLINOIS  
 DEPARTMENT OF TRANSPORTATION**

**EROSION CONTROL PLAN - I-64**

SCALE: 1" = 50'    SHEET NO. 1 OF 7 SHEETS    STA. BEGIN    TO STA. 67+00

F.A.I. RTE.	SECTION	COUNTY	TOTAL SHEETS	SHEET NO.
64/998/70	82-1-R(A), 82-1-R(B)	ST. CLAIR	629	240
FED. ROAD DIST. NO. ILLINOIS FED. AID PROJECT			CONTRACT NO. 76C52	

MATCH LINE STA 67+00  
 @ RAMP 55N64E  
 SEE SHEET 2

SEE EROSION CONTROL PLAN FOR I-55