IMPROVEMENT LOCATED IN THE VILLAGE OF LIBERTYVILLE.

STATE OF ILLINOIS

DEPARTMENT OF TRANSPORTATION

DIVISION OF HIGHWAYS


PLANS FOR PROPOSED FEDERAL-AID HIGHWAY

INDEX OF SHEETS

FOR INDEX OF SHEETS, SEE SHEET NO. 2

F.A.U. ROUTE 1236 (LAKE STREET) F.A.U. ROUTE 2647 (BUTTERFIELD ROAD) TO BRAINERD AVENUE **SECTION 08-00100-00-PV** PROJECT NO. M-9003 (244) RESURFACING AND WATERMAIN INSTALLATION

LAKE COUNTY

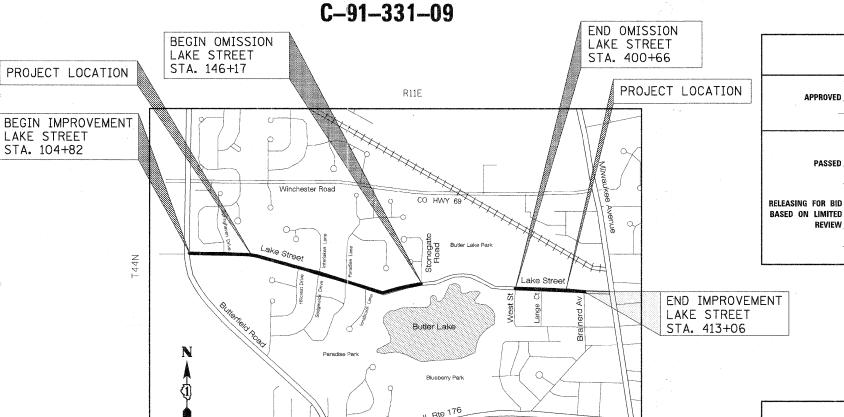

LOCATION MAP NOT TO SCALE

JOINT UTILITY LOCATION INFORMATION FOR EXCAVATION

1-800-892-0123 OR 811

LAKE STREET **FUNCTIONAL CLASSIFICATION** COLLECTOR-URBAN 2007 ADT = 3,300


LAKE STREET - 5375 FT (1.02 MILE) NET - 7038 FT (1.33 MI) GROSS

POSTED AND DESIGN SPEEDS: LAKE STREET - 30 MPH DESIGN; 25 MPH POSTED

450 E. Devon Ave, Suite 300 - Itasca, Illinois 60143
Tel: 630.773.3900 - Fax: 630.773.3975
www.civittechinc.com

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FOR LIST OF STATE STANDARDS, SEE SHEET NO. 3

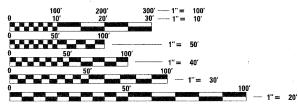

ENGINEERING SCALES. REDUCED SIZED PLANS WILL NOT CONFORM TO STANDARD SCALES, IN MAKING MEASUREMENTS ON REDUCED PLANS, THE ABOVE SCALES MAY BE USED.



Utility Locating

48 hours before you dig

CONTRACT NO. 63697

END IMPROVEMENT

PASSED

11/30/2013

Diana M. O'Mark
DEPUTY DIRECTOR OF HIGHWAYS, REGION ONE ENGINEER

08-00100-00-PV

STATE OF ILLINOIS

DIVISION OF HIGHWAYS

DEPARTMENT OF TRANSPORTATION

FEBRUARY ZI

FEBRUARY 23,

LAKE

CONTRACT NO. 63697

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ENGINEERING,

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SPECIFICATIONS, STANDARDS AND SPECIAL PROVISIONS

- 1. ALL CONSTRUCTION SHALL BE IN ACCORDANCE WITH THE "STANDARD SPECIFICATIONS FOR ROAD AND BRIDGE CONSTRUCTION" ("STANDARD SPECIFICATIONS"), ADOPTED JANUARY 1, 2012; THE "SUPPLEMENTAL SPECIFICATIONS AND RECURRING SPECIAL PROVISIONS", ADOPTED JANUARY 1, 2012; THE LATEST EDITION OF THE "ILLINOIS MANUAL ON UNIFORM TRAFFIC CONTROL DEVICES FOR STREETS AND HIGHWAYS", (IMUTCD; "THE STANDARD SPECIFICATIONS FOR WATER AND SEWER MAIN CONSTRUCTION IN ILLINOIS" JULY 2009 SIXTH EDITION, THE DETAILS IN THE PLANS, AND THE SPECIAL PROVISIONS AND IDOT STANDARD DRAWINGS INCLUDED IN THE CONTRACT DOCUMENTS.
- 2. ALL REFERENCES TO "ENGINEER" SHALL BE INTERPRETED AS THE RESIDENT ENGINEER.
- ALL UTILITY COMPANIES, SCHOOL DISTRICTS, AND LOCAL POLICE AND FIRE DEPARTMENTS SHALL BE NOTIFIED BY THE CONTRACTOR AT LEAST 72 HOURS PRIOR TO THE START OF CONSTRUCTION.

STAKING

- ALL RADII FOR PROPOSED CURB AND GUTTER ARE TO THE EDGE OF PAVEMENT UNLESS OTHERWISE NOTED.
- 2. THE STATION/OFFSET/ELEVATIONS NOTED FOR ALL DRAINAGE STRUCTURES LOCATED IN THE CURB LINE REFER TO THE POSITION OF THE ADJACENT EDGE OF PAVEMENT. THE CONTRACTOR SHALL BE RESPONSIBLE FOR DETERMINING THE OFFSET NECESSARY FOR EACH STRUCTURE TO SET THE FRAME AND GRATE IN THE PROPER LOCATION. ALL OTHER STRUCTURES ARE DIMENSIONED TO THE CENTER OF STRUCTURE, UNLESS OTHERWISE NOTED.
- PAVEMENT GRADES: THE ELEVATIONS INDICATED ON THE PLANS ARE FINISHED GRADES OF PROPOSED PAVEMENT, UNLESS OTHERWISE INDICATED.
- 4. THE CONSTRUCTION BASELINE HAS BEEN ESTABLISHED FOR STAKING PURPOSES ONLY AND IS NOT INTENDED TO BE A CENTERLINE OF RIGHT-OF-WAY.
- THE CONTRACTOR SHALL PROTECT AND CAREFULLY PRESERVE ALL SECTION
 OR SUBSECTION MONUMENTS OR PROPERTY OR REFERENCE MARKERS UNTIL THE VILLAGE,
 THE COUNTY, ITS AGENT OR AN AUTHORIZED SURVEYOR HAS WITNESSED OR OTHERWISE
 REFERENCED THEIR LOCATIONS.

PAVING AND CURB & GUTTER

1. THE CONTRACTOR SHALL SAW CUT PAVEMENT, CURB & GUTTER, PAVEMENT PATCHES, DRIVEWAYS AND SIDEWALK AS INDICATED ON THE PLANS TO SEPARATE THE EXISTING MATERIAL TO BE REMOVED BY MEANS OF AN APPROVED SAW TO FULL DEPTH AS SHOWN ON THE PLANS OR AS DIRECTED BY THE ENGINEER. THIS WORK SHALL BE CONSIDERED INCLUDED IN THE COST OF THE ITEM BEING REMOVED.

THE CONTRACTOR SHALL BE REQUIRED TO SAW VERTICAL CUTS SO AS TO FORM CLEAN VERTICAL JOINTS. SHOULD THE CONTRACTOR DEFACE ANY EDGE, A NEW SAWED JOINT SHALL BE PROVIDED AND ANY ADDITIONAL WORK, INCLUDING REMOVAL AND REPLACEMENT, SHALL BE DONE AT THE CONTRACTOR'S EXPENSE.

- THE LEVELING BINDER COURSE SHALL NOT BE PLACED ADJACENT TO CURB AND GUTTER UNTIL THE CURB AND GUTTER HAS BEEN PROPERLY CURED AND BACK FILLED TO THE SATISFACTION OF THE ENGINEER.
- HOT-MIX ASPHALT SURFACE COURSE SHALL NOT BE PLACED UNTIL ALL EARTH EXCAVATION, TOPSOIL PLACEMENT, AND HOT-MIX ASPHALT BINDER COURSE HAVE BEEN COMPLETED TO THE SATISFACTION OF THE ENGINEER.
- 4. THE THICKNESSES OF HOT-MIX ASPHALT MIXTURES SHOWN ON THE PLANS ARE NOMINAL. DEVIATIONS MAY OCCUR DUE TO IRREGULARITIES IN THE LEVEL BINDER OR EXISTING PAVEMENT UPON WHICH THE HOT-MIX ASPHALT MATERIALS ARE PLACED.

EXCAVATION

L. ALL EXCESS MATERIAL (BROKEN CONCRETE, SEWER PIPE, WASTE ROADWAY EXCAVATION AND SURPLUS MATERIAL FROM TRENCHES) SHALL BE LEGALLY DISPOSED OF OUTSIDE THE LIMITS OF THE RIGHT-OF-WAY. IT SHALL BE THE CONTRACTOR'S RESPONSIBILITY TO SELECT DUMP SITES AND OBTAIN PERMISSION AND ALL NECESSARY PERMITS TO USE SUCH DUMP SITES. THE COST OF THIS WORK SHALL BE INCLUDED IN THE COST OF THE REMOVAL ITEMS IN THE CONTRACT.

TREE PROTECTION, PRUNING, ROOT PRUNING, AND CLEARING

- ALL TREE PROTECTION, PRUNING AND ROOT PRUNING SHALL BE COMPLETED BEFORE CONSTRUCTION OPERATIONS
 COMMENCE IN ANY AREA. AT NO TIME SHALL THE CONTRACTOR PRUNE OR REMOVE ANY TREES UNLESS DIRECTED
 BY THE ENGINEER.
- 2. WHEN TREE TRUNK PROTECTION REQUIRES TEMPORARY FENCING, IT SHALL BE ERECTED ALONG THE DRIP LINE OF EXISTING TREES TO REMAIN WITHIN THE LIMITS OF CONSTRUCTION OR AS DIRECTED BY THE ENGINEER. AFTER TREES ARE SAFELY FENCED, NOTHING IS TO BE STORED, DRIVEN, OR DISTURBED INSIDE THE FENCED AREA. PROTECTIVE TEMPORARY FENCE IS TO BE REMOVED ONLY AFTER ALL CONSTRUCTION WORK HAS BEEN COMPLETED.
- 3. TREE PROTECTION, TREE PRUNING, AND ROOT PRUNING SHALL BE DIRECTED BY THE ENGINEER.
- CLEARING OF BRUSH, HEDGES, LANDSCAPING MATERIALS, AND FLOWERS SHALL BE INCLUDED IN THE COST OF THE CONTRACT. NO ADDITIONAL COMPENSATION WILL BE ALLOWED.
- PRIVATE SPRINKLER SYSTEMS ARE PRESENT AT VARIOUS LOCATIONS ON THE PRJOECT. IF A SPRINKLER SYSTEM IS IN CONFLICT WITH THE WATERMAIN INSTALLATION, THE CONTRACTOR SHALL CUT AND CAP THE EXISTING SYSTEM AT THE R.O.W. TO THE SATISFACTION OF THEN ENGINEER. THIS WORK SHALL BE INCLUDED IN THE COST OF THE CONTRACT

SEWER

- 1. THE COST OF MAKING SEWER CONNECTIONS TO EXISTING OR PROPOSED SEWER OR DRAINAGE STRUCTURES SHALL BE INCLUDED IN THE COST OF THE SEWER OR STRUCTURE BEING CONSTRUCTED.
- 2. UNLESS OTHERWISE NOTED ON THE PLANS, THE EXISTING DRAINAGE FACILITIES SHALL REMAIN IN USE DURING THE PERIOD OF CONSTRUCTION. LOCATIONS OF EXISTING DRAINAGE STRUCTURES AND SEWERS AS SHOWN ON THE PLANS ARE APPROXIMATE. PRIOR TO COMMENCING WORK THE CONTRACTOR, AT HIS OWN EXPENSE, SHALL DETERMINE THE EXACT LOCATIONS OF EXISTING STRUCTURES WHICH ARE WITHIN THE PROPOSED CONSTRUCTION LIMITS. DURING CONSTRUCTION, IF THE CONTRACTOR ENCOUNTERS OR OTHERWISE BECOMES AWARE OF ANY SEWERS, UNDERDRAINS OR FIELD DRAINS WITHIN THE RIGHT-OF-WAY OTHER THAN THOSE SHOWN ON THE PLANS, HE SHALL SO INFORM THE ENGINEER, WHO SHALL DIRECT THE WORK NECESSARY TO MAINTAIN OR REPLACE THE FACILITIES IN SERVICE AND TO PROTECT THEM FROM DAMAGE DURING CONSTRUCTION IF MAINTAINED. EXISTING FACILITIES TO BE MAINTAINED THAT ARE DAMAGED BECAUSE OF THE NON-COMPLIANCE WITH THIS PROVISION SHALL BE REPLACED AT THE CONTRACTOR'S OWN EXPENSE. SHOULD THE ENGINEER HAVE DIRECTED THE REPLACEMENT OF A FACILITY, THE NECESSARY WORK AND PAYMENT SHALL BE IN ACCORDANCE WITH SECTIONS 550 AND 601, AND ARTICLE 104.02 OF THE STANDARD SPECIFICATIONS.
- 3. WHEN EXISTING DRAINAGE FACILITIES ARE DISTURBED, THE CONTRACTOR SHALL PROVIDE AND MAINTAIN TEMPORARY OUTLETS AND CONNECTIONS FOR ALL PRIVATE OR PUBLIC DRAINS, SEWERS OR CATCH BASINS. THE CONTRACTOR SHALL PROVIDE FACILITIES TO TAKE IN ALL STORM WATER WHICH WILL BE RECEIVED BY THESE DRAINS AND SEWERS AND DISCHARGE THE SAME. HE SHALL PROVIDE AND MAINTAIN AN EFFICIENT PUMPING PLANT, IF NECESSARY, AND A TEMPORARY OUTLET. HE SHALL BE PREPARED AT ALL TIMES TO DISPOSE OF THE WATER RECEIVED FROM TEMPORARY CONNECTIONS UNTIL SUCH TIME AS THE PERMANENT CONNECTIONS WITH SEWER ARE BUILT AND IN SERVICE. THIS WORK WILL NOT BE PAID FOR SEPARTELY, BUT SHALL BE INCLUDED IN THE CONTRACT.
- 4. ALL SEWER AND WATER SERVICES CROSSED BY NEW STORM SEWERS SHALL BE PROPERLY LOCATED AND PROTECTED DURING CONSTRUCTION. ANY DAMAGE TO SAID SERVICES NOT CONSIDERED TO BE IN CONFLICT WITH THE PROPOSED STORM SEWER SHALL BE REPAIRED BY THE CONTRACTOR AT HIS OWN EXPENSE.

EROSION CONTROL

- ALL VEGETATIVE AND STRUCTURAL EROSION CONTROL PRACTICES SHALL BE CONSTRUCTED AND MAINTAINED IN ACCORDANCE
 WITH THE MINIMUM STANDARDS AND SPECIFICATIONS OF THE "ILLINOIS PROCEDURES AND STANDARDS FOR URBAN SOIL EROSION
 AND SEDIMENTATION CONTROL" AND THE "STANDARDS AND SPECIFICATIONS FOR SOIL EROSION AND SEDIMENT CONTROL" OF THE
 ILLINOIS ENVIRONMENTAL PROTECTION AGENCY.
- SOIL DISTURBANCE SHALL BE CONDUCTED IN SUCH A MANNER AS TO MINIMIZE EROSION. SOIL STABILIZATION MEASURES SHALL CONSIDER THE TIME OF YEAR, SITE CONDITIONS AND THE USE OF TEMPORARY OR PERMANENT MEASURES.
- ALL EROSION CONTROL MEASURES SHALL BE IN PLACE BEFORE ANY WORK BEGINS.
- THE CONTRACTOR SHALL INSPECT ALL EROSION CONTROL MEASURES PERIODICALLY AND AFTER EACH RUNOFF-PRODUCING RAINFALL EVENT. ANY NECESSARY REPAIRS OR CLEANUP TO MAINTAIN THE EFFECTIVENESS OF SAID MEASURES SHALL BE MADE TRANSPORTED Y
- 5. ALL STORM SEWER FACILITIES THAT ARE OR WILL BE FUNCTIONING DURING CONSTRUCTION SHALL BE PROTECTED, FILTERED OR OTHERWISE TREATED TO REMOVE SEDIMENT. MUD AND SEDIMENT DEPOSITS SHALL BE REMOVED FROM THE ROADWAY AT THE END OF EACH WORK DAY BY SHOVELING AND/OR SWEEPING.
- ALL SLOPES SHALL BE COVERED WITH SOD OR SEED & EROSION CONTROL BLANKET AS SOON AS GRADING AND PLACEMENT OF TOPSOIL HAS BEEN COMPLETED.
- 7. INLET FILTERS SHALL BE PLACED ON ALL CATCH BASINS, INLETS, AND MANHOLES WITH OPEN GRATES IN THE CURB AND GUTTER.
- THE EROSION CONTROL MEASURES INDICATED ON THE PLANS ARE THE MINIMUM REQUIREMENTS. ADDITIONAL MEASURES MAY BE REQUIRED. AS DIRECTED BY THE ENGINEER.

PAVEMENT PATCHING

- 1. THE PATCHES SHOWN ON THE PLANS ARE APPROXIMATE. THE ENGINEER WILL DIRECT THE CONTRACTOR AS TO THE EXACT LOCATION AND LIMIT OF PATCHES.
- 2. PATCHING SHALL BE DONE UNDER DAILY LANE CLOSURES AND SHALL FOLLOW IDOT STANDARD 701201. ACCESS MUST BE MAINTAINED IN BOTH DIRECTIONS AT ALL TIMES.
- 3. WHEN PLACING TYPE C PATCHES, THE CONTRACTOR MAY PLATE THE PATCH WHILE WAITING FOR THE CONCRETE TO CURE. THE PLATING OF THESE PATCHES WILL NOT BE PAID FOR SEPERATELY BUT SHALL BE INCLUDED IN THE COST OF THE TYPE C PATCH.
- THE ENGINEER WILL DIRECT THE CONTRACTOR AS TO THE DEPTH REQUIRED FOR REMOVAL AND DISPOSAL OF UNSUITABLE MATERIALS AND PGE FOR EACH PATCH LOCATION.

SIGNING, STRIPING & LANDSCAPING

- THE CONTRACTOR SHALL ADHERE TO LIMITS OF RESTORATION SHOWN. AREAS OUTSIDE THESE LIMITS THAT ARE DAMAGED OR DISTURBED BY THE CONTRACTOR SHALL BE RESTORED BY THE CONTRACTOR AT HIS EXPENSE, AND NO ADDITIONAL COMPENSATION WILL BE ALLOWED.
- 2. SIGNS THAT ARE TO BE RELOCATED ARE TO BE REMOVED AND RE-ERECTED IN THEIR FINAL LOCATION WITH-IN A PERIOD OF 24 HOURS. IF THE CONTRACTOR CANNOT RE-ERECT SIGN WITH-IN THIS TIME FRAME, HE SHALL PROVIDE A TEMPORARY SIGN OF THE SAME TYPE AND SIZE. PROVIDING AND MAINTAINING THE TEMPORARY SIGN SHALL BE INCLUDED IN THE COST OF THE CONTRACT AND NO ADDITIONAL COMPENSATION WILL BE ALLOWED.
- 3. THE ENGINEER WILL DETERMINE THE APPROPRIATE LOCATION FOR RELOCATED SIGNS AND DIRECT THE CONTRACTOR.

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UTILITIES

- 1. THE CONTRACTOR SHALL COORDINATE ALL CONSTRUCTION ACTIVITIES WITH UTILITY COMPANIES. THE LOCATION OF PUBLIC OR PRIVATE UTILITIES SHOWN ON THE PLANS ARE APPROXIMATE AND THE ENGINEER DOES NOT GUARANTEE THEIR ACCURACY. THE CONTRACTOR WILL BE REQUIRED TO ASCERTAIN THE EXACT LOCATION OF SUCH UTILITIES AND EXERCISE CARE DURING HIS CONSTRUCTION OPERATIONS SO AS NOT TO DAMAGE THEM IN ACCORDANCE WITH THE SPECIAL PROVISIONS AND ARTICLE 107.31 OF THE "STANDARD SPECIFICATIONS." THE CONTRACTOR SHALL BE RESPONSIBLE FOR CONTACTING THE OWNERS OF ALL EXISTING UTILITIES SO THAT THEIR FACILITIES MAY BE LOCATED AND ADJUSTED OR MOVED, IF NECESSARY, PRIOR TO THE START OF THE CONSTRUCTION OPERATIONS.
- 2. THE CONTRACTOR SHALL BE RESPONSIBLE FOR THE PROTECTION OF ALL ABOVE AND BELOW GROUND UTILITIES EVEN THOUGH
 THEY MAY NOT BE SHOWN ON THE PLANS. ANY UTILITY THAT IS DAMAGED DURING CONSTRUCTION SHALL BE REPAIRED
 OR REPLACED TO THE SATISFACTION OF THE ENGINEER OR THE UTILITY OWNER. THIS WORK SHALL BE AT THE CONTRACTOR'S
 EXPENSE. THE CONTRACTOR SHALL NOTIFY ALL UTILITY OWNERS OF HIS CONSTRUCTION SCHEDULE AND SHALL COORDINATE CONSTRUCTION
 OPERATIONS WITH THE UTILITY OWNERS SO THAT RELOCATION OF UTILITY LINES AND STRUCTURES MAY
 PROCEED IN AN ORDERLY MANNER. NOTIFICATION SHALL BE IN WRITING, WITH COPIES TRANSMITTED TO THE ENGINEER.
- 3. ANY EXISTING OR PROPOSED SEWER DAMAGED BY THE CONTRACTOR DURING CONSTRUCTION SHALL BE REPLACED BY THE CONTRACTOR TO THE SATISFACTION OF THE ENGINEER AT NO COST TO THE VILLAGE.
- 4. THE CONTRACTOR SHALL RECEIVE NO ADDITIONAL COMPENSATION FOR CONSTRUCTION STAGING NECESSARY TO ACCOMMODATE UTILITY RELOCATION OR ADJUSTMENT AND/OR FOR DELAYS CAUSED BY UTILITY RELOCATION OR ADJUSTMENT.
- THE CONTRACTOR SHALL FURNISH ALL LABOR, EQUIPMENT AND MATERIAL NECESSARY FOR DEWATERING TRENCH EXCAVATIONS
 AS WELL AS SHORING TRENCH WALLS DURING UTILITY OPERATIONS. COMPLIANCE WITH THE ABOVE WILL BE INCLUDED IN THE COST
 OF THE CONTRACT.
- 6. THE CONTRACTOR SHALL BE RESPONSIBLE FOR CONTACTING THE VILLAGE OF LIBERTYVILLE REGARDING SANITARY SEWERS AND WATER MAINS TO VERIFY THE MATERIALS AND METHODS ALLOWED FOR THE ADJUSTMENT OR RELOCATION OF THEIR FACILITIES, IF NECESSARY.

MATERIALS QC/QA POLICY

- ALL HOT-MIX ASPHALT AND P.C. CONCRETE MATERIALS USED ON THIS PROJECT SHALL BE TESTED AND INSPECTED IN ACCORDANCE WITH THE ILLINOIS DEPARTMENT OF TRANSPORTATION'S QC/QA REQUIREMENTS.
- 2. THE CONTRACTOR SHALL PROVIDE OC TESTING AND INFORM THE ILLINOIS DEPARTMENT OF TRANSPORTATION BUREAU OF MATERIALS ORDER BOARD (PHONE: 847-705-4337 OR FAX: 847-705-4529) BY 4:00 P.M., 24-HOURS IN ADVANCE OF CONSTRUCTION FOR INSPECTION OF ALL HOT-MIX ASPHALT AND CONCRETE MATERIALS USED ON THIS PROJECT.
- 3. THE CONTRACTOR IS TO SUBMIT A QC PLAN FOR HMA AND CONCRETE MATERIALS TO THE QA MANAGER FOR APPROVAL PRIOR TO CONSTRUCTION OPERATIONS COMMENCING. THE QA MANAGER WILL APPROVE THIS PLAN AND COPY THE DISTRICT MATERIALS OFFICE ON THE APPROVAL LETTER.
- 4. QC AND QA REPORTS FOR CONCRETE WILL BE SENT TO THE DISTRICT BUREAU OF MATERIALS OFFICE AFTER REVIEW AND APPROVAL BY THE QA MANAGER.
- 5. QC REPORT FOR HOT-MIX ASPHALT MIXTURES WILL BE TRANSMITTED DIRECTLY BY THE CONTRACTOR DAILY DURING PRODUCTION. THE DISTRICT WILL REVIEW AND RETAIN THE QA PLANT REPORTS. THE QA FIELD REPORTS CAN BE SUBMITTED BY THE QA MANAGER TO THE DISTRICT VIA THE DISTRICT LOCAL ROADS OFFICE.
- 6. THE COSTS TO COMPLY WITH THESE REQUIREMENTS SHALL BE INCLUDED IN THE COST OF THE VARIOUS HOT-MIX ASPHALT AND P.C. CONCRETE ITEMS.

MISCELLANEOUS

- 1. DIMENSIONS: IT SHALL BE THE CONTRACTOR'S RESPONSIBILITY TO VERIFY ALL DIMENSIONS AND CONDITIONS EXISTING IN THE FIELD PRIOR TO ORDERING MATERIALS AND BEGINNING CONSTRUCTION.
- 2. UNLESS OTHERWISE AUTHORIZED BY THE ENGINEER, ALL EXISTING ACCESS POINTS SHALL BE MAINTAINED AT ALL TIMES BY THE CONTRACTOR.

IDOT STATE STANDARDS

000001-06 001001-02	STANDARD SYMBOLS, ABBREVIATIONS AND PATTERNS AREAS OF REINFORCING BARS
424001-06	CLASS C AND D PATCHES
424006	PERPENDICULAR CURB RAMPS FOR SIDEWALKS
424011	DIAGONAL CURB RAMPS FOR SIDEWALKS
424016	CORNER PARALLEL CURB RAMPS FOR SIDEWALKS
442201-03	MID-BLOCK CURB RAMPS FOR SIDEWALKS
606001-04	CONCRETE CURB TYPE B AND COMBINATION CONCRETE CURB AND GUTTER
701201-04	LANE CLOSURE, 2L, 2W, DAY ONLY, FOR SPEEDS ≥ 45 MPH
701501-06	URBAN LANE CLOSURE, 2L, 2W, UNDIVIDED
701901-02	TRAFFIC CONTROL DEVICES
720001-01	SIGN PANEL MOUNTING DETAILS
720006-03	SIGN PANEL ERECTION DETAILS
728001-01	TELESCOPING STEEL SIGNING SUPPORT

IDOT DISTRICT 1 STANDARDS

BD400-05	BUTT JOINT AND HMA TAPER DETAILS
BD600-03	DETAILS FOR FRAMES AND LIDS ADJUSTMENT WITH MILLING
BD600-06	CURB OR CURB AND GUTTER REMOVAL AND REPLACEMENT
TC-13	DISTRICT ONE TYPICAL PAVEMENT MARKINGS

VILLAGE OF LIBERTYVILLE STANDARDS

001	P.C.C. SIDEWALK
003	INTEGRAL CURB & GUTTER REPLACEMENT FOR NEW OR REPLACEMENT DRIVEWAY
007	WATER SERVICE INSTALLATION
010	THRUST BLOCK INSTALLATION
012	SIDEWALK AND DRIVEWAY REPLACEMENT
017	WATERMAIN VALVE VAULT
018	TYPICAL HYDRANT INSTALLATION
021	PROTECTION OF STREET LIGHTING CABLES
024	TYPICAL TRENCH AND BEDDING DETAIL
025	TREE AND BUSH ROOT PRUNING
036	SERVICE RE-CONNECTIONS
048	STORM SEWER UNDERDRAIN

USER NAME = eds	DESIGNED	-	EDS	REVISED	-
	DRAWN	-	EDS	REVISED	**
PLOT SCALE = 1.0000 '/ in.	CHECKED		DNM	REVISED	-
PLOT DATE = 2/20/2012	DATE	-	02/06/12	REVISED	m

	INDEX OF SHEETS, GEI	VERAL NOTES.		F.A. RTE.	SECTION	COUNTY	TOTAL SHEETS	SHEE NO.
	STATE & LOCAL S'			1236	08-01100-00-PV	LAKE	35	3
	OINIE & EGONE G	IMIDAIDO				CONTRAC	T NO. 6	53697
SCALE: N.T.S.	SHEET NO. 2 OF 2 SHEETS	STA.	TO STA.	FED. RO	AD DIST. NO. 7 ILLINOIS FED. AT	D PROJECT		

						NON-PARTICIPATIN
PAY ITEM	DESCRIPTION	UNIT	TOTAL	ROADWAY RESURFACING 0005	TRAINEES 0042	UTILITIES 0043
20100110	TREE REMOVAL (6 TO 15 UNITS DIAMETER)	UNIT	50	0	0	50
20101100	TREE TRUNK PROTECTION	EACH	10	0	0	10
20101200	TREE ROOT PRUNING	EACH	20	0	0	20
20101700	SUPPLEMENTAL WATERING	UNIT	50	0	0	50
20201200	REMOVAL AND DISPOSAL OF UNSUITABLE MATERIAL	CU YD	265	265	0	0
20400800	FURNISHED EXCAVATION	CU YD	40	40	0	0
20800150	TRENCH BACKFILL	CU YD	300	0	0	300
21101615	TOPSOIL FURNISH AND PLACE, 4"	SQ YD	4582	0	0	4582
25000400	NITROGEN FERTILIZER NUTRIENT	POUND	57	0	0	57
25000500	PHOSPHORUS FERTILIZER NUTRIENT	POUND	57	0	0	57
25000600	POTASSIUM FERTILIZER NUTRIENT	POUND	57	0	0	57
25200110	SODDING, SALT TOLERANT	SQ YD	4582	0	0	4582
28000400	PERIMETER EROSION BARRIER	FOOT	1500	0	0	1500
28000510	INLET FILTERS	EACH	37	37	0	. 0
31101100	SUBBASE GRANULAR MATERIAL, TYPE B	CU YD	91	91	0	0
35501316	HOT-MIX ASPHALT BASE COURSE, 8"	SQ YD	328	328	0	0
40600100	BITUMINOUS MATERIALS (PRIME COAT)	GALLON	3424	3424	0	0
40600300	AGGREGATE (PRIME COAT)	TON	69	69	0	0
40600827	POLYMERIZED LEVELING BINDER (MACHINE METHOD), IL-4.75, N50	TON	925	925	0	0
40600895	CONSTRUCTING TEST STRIP	EACH	2	2	0	0
40600982	HOT-MIX ASPHALT SURFACE REMOVAL - BUTT JOINT	SQ YD	883	883	0	0
40600985	PORTLAND CEMENT CONCRETE SURFACE REMOVAL - BUTT JOINT	SQ YD	307	307	0	0
40603335	HOT-MIX ASPHALT SURFACE COURSE, MIX "D", N50	TON	1447	1447	0	0
42001300	PROTECTIVE COAT	SQ YD	1003	1003	0	0
42300200	PORTLAND CEMENT CONCRETE DRIVEWAY PAVEMENT, 6 INCH	SQ YD	37	0	0	37
42400100	PORTLAND CEMENT CONCRETE SIDEWALK 4 INCH	SQ FT	3085	3085	0	0
42400300	PORTLAND CEMENT CONCRETE SIDEWALK 6 INCH	SQ FT	195	195	0	0
42400800	DETECTABLE WARNINGS	SQ FT	308	308	0	0
	PAVEMENT REMOVAL				0	
		SQ YD	442	442		0
44000159	HOT-MIX ASPHALT SURFACE REMOVAL, 2 1/2"	SQ YD	3168	3168	0	0
44000200	DRIVEWAY PAVEMENT REMOVAL	SQ YD	60	0	0	60

			T	70% FED - 3	0% LOCAL	100% LOCAL
PAY ITEM	DESCRIPTION	UNIT	TOTAL QUANTITY	ROADWAY RESURFACING 0005	TRAINEES 0042	UTILITIES 004
44000500	COMBINATION CURB AND GUTTER REMOVAL	FOOT	1290	1290	0	0
44000600	SIDEWALK REMOVAL	SQ FT	3082	3082	0	0
44201313	CLASS C PATCHES, TYPE I, 7 INCH	SQ YD	10	10	0	0
44201749	CLASS D PATCHES, TYPE I, 9 INCH	SQ YD	110	110	0	0
44201753	CLASS D PATCHES, TYPE II, 9 INCH	SQ YD	350	350	0	0
44201757	CLASS D PATCHES, TYPE III, 9 INCH	SQ YD	270	270	0	0
44201759	CLASS D PATCHES, TYPE IV, 9 INCH	SQ YD	1360	1360	0	0
44213200	SAW CUTS	FOOT	10750	10750	0	0
55100100	STORM SEWER REMOVAL 4"	FOOT	20	0	0	20
55100400	STORM SEWER REMOVAL 10"	FOOT	70	0	0	70
55100700	STORM SEWER REMOVAL 15"	FOOT	60	0	0	60
56100600	WATER MAIN 6"	FOOT	99	0	0	99
56100700	WATER MAIN 8"	FOOT	166	0	0	166
56100900	WATER MAIN 12"	FOOT	1327	0	0	1327
56400500	FIRE HYDRANTS TO BE REMOVED	EACH	6	0	0	6
56400820	FIRE HYDRANT WITH AUXILIARY VALVE AND VALVE BOX	EACH	8	0	0	8
60109520	PIPE UNDERDRAINS, FABRIC LINED TRENCH 6"	FOOT	234	234	0	0
60248700	VALVE VAULTS, TYPE A, 4'-DIAMETER, TYPE 1 FRAME, CLOSED LID	EACH	2	0	0	2
60248900	VALVE VAULTS, TYPE A, 5'-DIAMETER, TYPE 1 FRAME, CLOSED LID	EACH	4	0	0	4
60604400	COMBINATION CONCRETE CURB AND GUTTER, TYPE B-6.18	FOOT	1762	1762	0	0
67100100		L SUM	1	1	0	0
70102620		L SUM	1	1	0	0
70106800		CAL MO	16	16	0	0
	SIGN PANEL - TYPE 1	SQ FT	22	22	0	0
72400100	REMOVE SIGN PANEL ASSEMBLY - TYPE A	EACH	4	0	0	4
72400500		EACH	4	0	0	4
72800100	TELESCOPING STEEL SIGN SUPPORT	FOOT	102	0	0	102
78000200		FOOT	5087	5087	. 0	0
78000400	THERMOPLASTIC PAVEMENT MARKING - LINE 6"	FOOT	904	904	0	0
78000400		FOOT	132	132	0	0
78000650		FOOT	148		0	0
7 80000850	INCOMOFLABILO PAVEMENT MARAING - LINE 24"	F001	148	148	U	U

CONSTRUCTION CODE
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-		ALIENTE AND ALIE	F.A. RTE.	SECTION	COUNTY	SHEETS	SHEE NO.		
-		SUMMARY OF QU	ANTITIES		1236	08-00100-00-PV	LAKE	35	4
-			Y				CONTRAC	T NO. 6	63697
	SCALE: N.T.S.	SHEET NO. 1 OF 2 SHEETS	STA.	TO STA.	FED. R	OAD DIST. NO. 7 ILLINOIS FED. A	ID PROJECT		

70% FED - 30% LOCAL 100% LOCAL ROADWAY TOTAL ROADWAY IRAINEES O043 UTILITIES 0043 0005 PAY ITEM DESCRIPTION A2006420 TREE, QUERCUS ALBA (WHITE OAK), 2-1/2" CALIPER, BALLED AND BURLAPPED EACH X0839900 SANITARY SEWER REMOVAL 6" FOOT 20 20 X0840000 SANITARY SEWER REMOVAL 8" FOOT 70 70 ★ X2130010 EXPLORATION TRENCH, SPECIAL 200 FOOT 200 X4400100 PORTLAND CEMENT CONCRETE SURFACE REMOVAL (VARIABLE DEPTH) SQ YD 9056 9056 X5610004 DUCTILE IRON WATER MAIN FITTINGS POUND 6375 6375 0 X5610700 WATER MAIN REMOVAL FOOT 140 140 X5620040 WATER SERVICE CONNECTION 2" EACH X5620116 WATER SERVICE CONNECTION (SHORT) EACH 8 X5620118 WATER SERVICE CONNECTION (LONG) EACH X6030310 FRAMES AND LIDS TO BE ADJUSTED (SPECIAL) EACH 27 XX001047 VALVE VAULTS TO BE ABANDONED EACH XX001490 GATE VALVES, 8* EACH XX003032 GATE VALVES, 12" EACH 4 XX003516 | CONNECTIONS TO EXISTING WATER MAINS (NON-PRESSURE) -8" EACH 0 XX004774 BRICK DRIVEWAY REMOVAL AND REPLACEMENT sq FT 39 39 * XX005107 CONNECTIONS TO EXISTING WATER MAINS (NON-PRESSURE) -12" EACH XX006247 SANITARY SEWER REMOVAL FOOT 20 20 Z0013798 CONSTRUCTION LAYOUT L SUM Z0018500 DRAINAGE STRUCTURES TO BE CLEANED EACH 26 26 Z0018911 DRILL AND GROUT #6 TIE BARS EACH 741 741 Z0042002 POROUS GRANULAR EMBANKMENT, SUBGRADE CU YD 400 400 Z0056602 STORM SEWER (WATER MAIN REQUIREMENTS) 4 INCH FOOT 20 20 Z0056606 STORM SEWER (WATER MAIN REQUIREMENTS) 10 INCH FOOT 70 70 Z0056610 STORM SEWER (WATER MAIN REQUIREMENTS) 15 INCH FOOT 60 60 Z0056700 SANITARY SEWER 4" FOOT 20 20 Z0056800 SANITARY SEWER 6" FOOT 20 20 Z0056900 SANITARY SEWER 8" FOOT 70 70 Z0076600 TRAINEES HOUR 500 500 XX008656 TRACE WIRE FOOT 2866 2866 * XXOO8657 WATER MAIN, DUCTILE IRON PIPE, CLASS 52, 12", DIRECTIONALLY DRILLED FOOT 1129 1129 * XX008658 WATER MAIN, DUCTILE IRON PIPE, CLASS 52, 8", DIRECTIONALLY DRILLED FOOT 244


* SPECIALTY ITEMS

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STATE OF ILLINOIS
DEPARTMENT OF TRANSPORTATION

CONSTRUCTION CODE
FEDERAL PARTICIPATION NON-PARTICIPATING

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	SUMMARY OF QU	ANTITLES		1236	08-00100	-00-PV	LAKE	35	5
							CONTRACT	NO.	63697
E: N.T.S.	SHEET NO. 2 OF 2 SHEETS	STA.	TO STA.	FED. R	DAD DIST. NO. 7 I	ILLINOIS FED. A	D PROJECT		

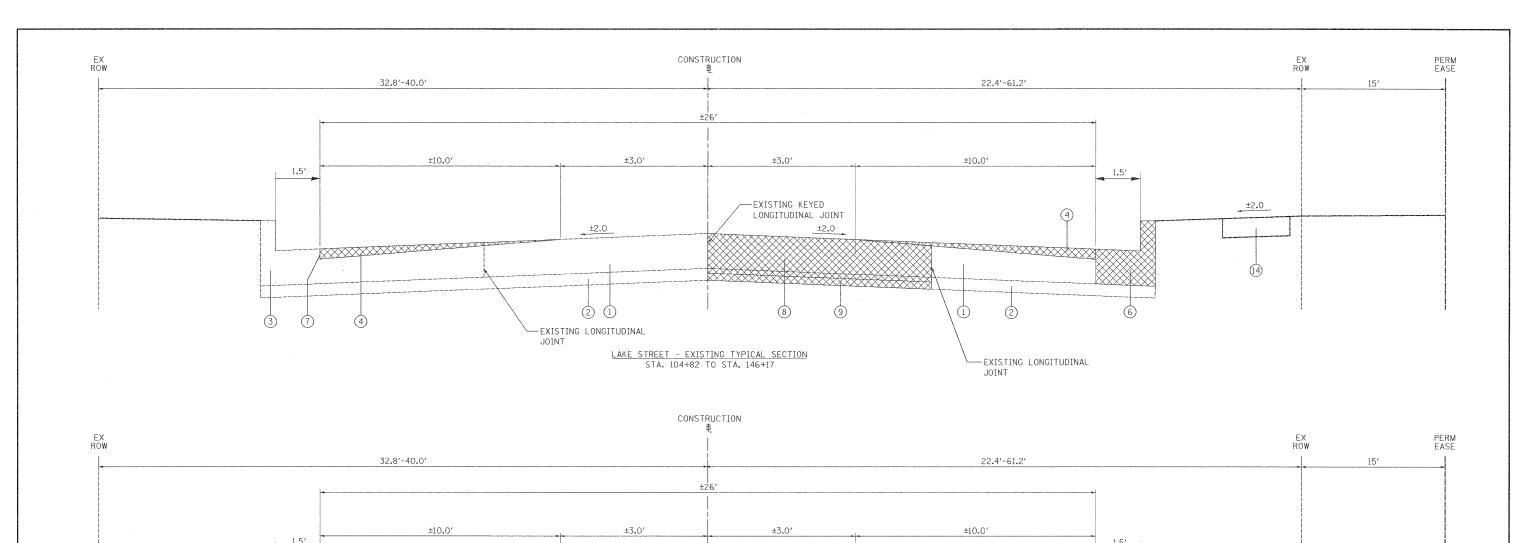

LAKE STREET - PROPOSED TYPICAL SECTION STA. 104+82 TO STA. 146+17

LEGEND

- 1 EXISTING P.C.C. PAVEMENT, 7"
- 2 EXISTING GRANULAR SUB-BASE
- (3) EXISTING MONOLITHIC 6" BARRIER CURB
- (4) PORTLAND CEMENT CONCRETE SURFACE REMOVAL (VARIABLE DEPTH) (X4400100)
- (5) HOT-MIX ASPHALT SURFACE REMOVAL, 2 1/2" (44000159)
- (6) COMBINATION CURB AND GUTTER REMOVAL (44000500)
 COMBINATION CONCRETE CURB AND GUTTER, TYPE B-6.18 (60604400)
 (AT LOCATIONS SHOWN ON PLANS AND AS DIRECTED BY THE ENGINEER)
- 7 SAW CUTS (44213200) (2 1/4" AT PCC SURFACE REMOVAL)
- 8 CLASS C PATCH, TYPE 1, 7 INCH (44201313) OR CLASS D PATCH, 9 INCH (44201749, 44201753, 44201757, 44201759) (SEE PLAN SHEETS FOR LOCATION AND TYPES)

- REMOVAL AND DISPOSAL OF UNSUITABLE MATERIAL (20201200)
- 10 POROUS GRANULAR EMBANKMENT, SUBGRADE (Z0042002)
- #6 EPOXY COATED TIE BARS, 24" LONG @ 24" C-C, DRILLED & GROUTED IN PLACE INCLUDED IN THE COST OF COMBINATION CONCRETE CURB AND GUTTER, TYPE B-6.18 (60604400)
- (12) 1" POLYMERIZED LEVELING BINDER (MACHINE METHOD), IL-4.75, N50 (40600827)
- (13) 1 1/2" HOT-MIX ASPHALT SURFACE COURSE, MIX "D", N50 (40603335)
- (14) EXISTING SIDEWALK, 4"

(12) (13)

(15) PORTLAND CEMENT CONCRETE SIDEWALK, 4"



REMOVAL

NOTES:

(11)

LOCATIONS AND DEPTH OF REMOVAL AND DISPOSAL OF UNSUITABLE MATERIAL WILL BE DETERMINED BY THE ENGINEER AS FIELD CONDITIONS REQUIRE.

CONTRACTOR SHALL MILL HMA SURFACE BEFORE PATCHING.

HOT-MIX ASPHALT MIXTURE REQUIREMENTS	
MIXTURE TYPE	AIR VOIDS
PAVEMENT OVERLAY	
HOT-MIX ASPHALT SURFACE COURSE, MIX "D", N50	4% @ 50 GYR.
POLYMERIZED LEVELING BINDER (MACHINE METHOD), IL-4.75, N50	3.5% @ 50 GYR.
COMMERCIAL DRIVEWAYS	
HOT-MIX ASPHALT SURFACE COURSE, MIX "D", N50	4% @ 50 GYR.
HOT-MIX ASPHALT BASE COURSE, 8" (HMA BINDER IL-19mm) (IN 3 LIFTS)	4% @ 50 GYR.

2.0


THE UNIT WEIGHT USED TO CALCULATE ALL HMA SURFACE MIXTURE QUANTITIES IS 112 LBS/SQ YD/IN.

THE "AC TYPE" FOR POLYMERIZED HMA MIXES SHALL BE "SBS/SBR PG 76-22" AND FOR NON-POLYMERIZED HMA THE "AC TYPE" SHALL BE "PG 64-22" UNLESS MODIFIED BY DISTRICT ONE SPECIAL PROVISIONS. FOR "PERCENT OF RAP" SEE SPECIAL PROVISIONS.


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TVDIOAL OPOTIONO							SECTION	COUNTY	TOTAL	SHEET NO.
TYPICAL SECTIONS						1236	08-00100-00-PV	LAKE	35	6
	r			,				CONTRACT	NO.	63697
SCALE: N.T.S.	SHEET NO. 1	OF 2	SHEETS	STA. 104+82	TO STA. 146+17	FED, RC	DAD DIST, NO. 7 ILLINOIS FED. A	ID PROJECT		



LAKE STREET - EXISTING TYPICAL SECTION STA. 400+66 TO STA. 413+06

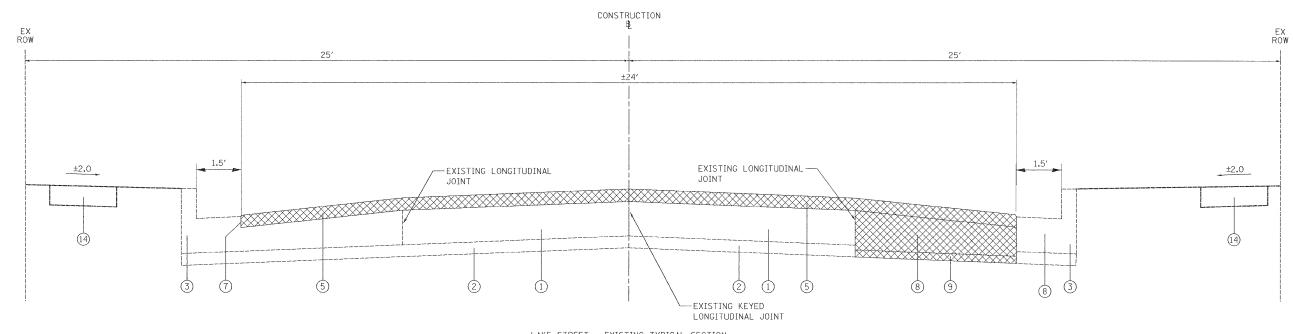

LEGEND

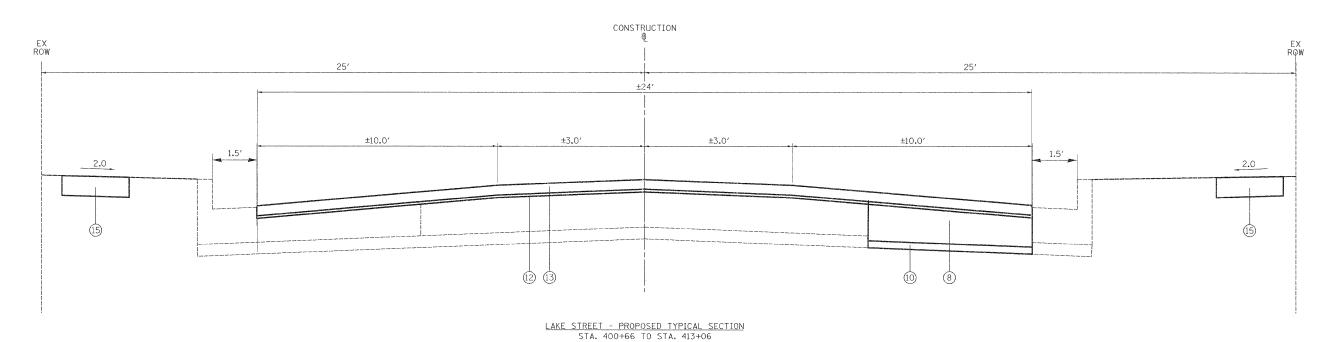- 1 EXISTING P.C.C. PAVEMENT, 7"
- 2 EXISTING GRANULAR SUB-BASE
- (3) EXISTING MONOLITHIC 6" BARRIER CURB
- 4 PORTLAND CEMENT CONCRETE SURFACE REMOVAL (VARIABLE DEPTH) (X4400100)
- (5) HOT-MIX ASPHALT SURFACE REMOVAL, 2 1/2" (44000159)
- (6) COMBINATION CURB AND GUTTER REMOVAL (44000500)
 COMBINATION CONCRETE CURB AND GUTTER, TYPE B-6.18 (60604400)
 (AT LOCATIONS SHOWN ON PLANS AND AS DIRECTED BY THE ENGINEER)
- 7 SAW CUTS (44213200) (2 1/4" AT PCC SURFACE REMOVAL)
- (8) CLASS C PATCH, TYPE 1, 7 INCH (44201313)
 OR CLASS D PATCH, 9 INCH (44201749, 44201753, 44201757, 44201759)
 (SEE PLAN SHEETS FOR LOCATION AND TYPES)

- (9) REMOVAL AND DISPOSAL OF UNSUITABLE MATERIAL (20201200)
- (10) POROUS GRANULAR EMBANKMENT, SUBGRADE (Z0042002)
- (1) *6 EPOXY COATED TIE BARS, 24" LONG @ 24" C-C, DRILLED & GROUTED IN PLACE INCLUDED IN THE COST OF COMBINATION CONCRETE CURB AND GUTTER, TYPE B-6.18
- (12) 1" POLYMERIZED LEVELING BINDER (MACHINE METHOD), IL-4.75, N50 (40600827)
- (13) 1 1/2" HOT-MIX ASPHALT SURFACE COURSE, MIX "D", N50 (40603335)
- (4) EXISTING SIDEWALK, 4"
- (15) PORTLAND CEMENT CONCRETE SIDEWALK, 4"



REMOVAL

OTES:

LOCATIONS AND DEPTH OF REMOVAL AND DISPOSAL OF UNSUITABLE MATERIAL WILL BE DETERMINED BY THE ENGINEER AS FIELD CONDITIONS REQUIRE.


CONTRACTOR SHALL MILL HMA SURFACE BEFORE PATCHING.

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	F.A. RTE.	SECTION	COUNTY	TOTAL SHEETS	SHEET NO.
TYPICAL SECTIONS	1236	08-00100-00-PV	LAKE	35	7
			CONTRACT	NO. 6	3697
SCALE: N.T.S. SHEET NO. 2 OF 2 SHEETS STA. 400+66 TO STA. 413+06	FED. RO	DAD DIST. NO. 7 ILLINOIS FED. AT	D. PROJECT		







LAKE STREET

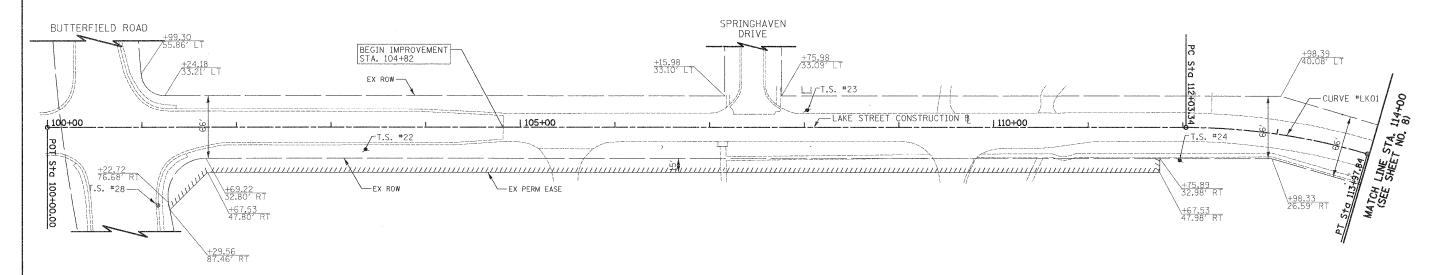EXISTING LAKE STREET (WEST) CONSTRUCTION BASELINE


DESCRIPTION	STATION	NORTHING	EASTING
B.O.A.	100+00.00	6093.57	-2464.41
P.C.	112+03.34	6135.99	-1261.82
P.I.	113+01.27	6139.44	-1163.95
P.T.	113+97.84	6114.94	-1069.13
P.C.	133+99.44	5623.79	871.27
P.I.	134+50.94	5611.15	921.19
P.T.	135+02.41	5595.96	970.39
P.C.	136+71.31	5546.15	1131.79
P.I.	138+02.29	5507.52	1256.94
P.T.	139+24.47	5550.39	1380.70
P.C.	141+90.75	5637.56	1632.32
P.I.	142+48.16	5656.35	1686.56
P.T.	143+05.21	5664.51	1743.37
E.O.A.	146+66.28	5715.87	2100.77


PROP. CURVE LK01 PI STA. = 113+01.27 Δ = 16° 30′ 35″ (RT) D = 8° 29′ 18″ R = 675.00′ T = 97.93′ L = 194.50′ E = 7.07′ e = N/A P.C. STA. = 112+03.34 P.T. STA. = 113+97.84

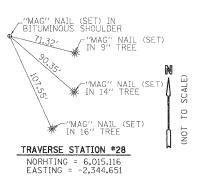

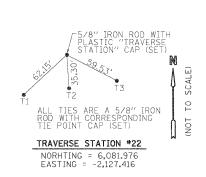

SCALE:

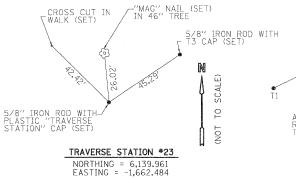

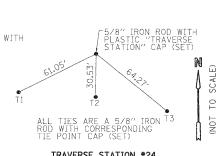

TRAVERSE STATION *24

NORTHING = 6,100.953
EASTING = -1,266.984


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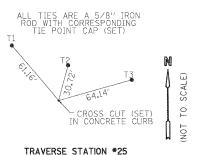
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ALIGNMENT, TIES, BENCHMARKS AND ROW	1236	08-00100-00-PV
1" = 50' SHEET NO. 1 OF 4 SHEETS STA. 100+00 TO STA. 114+00		AD DIST, NO. 7 ILLINOIS

ED. RO	OAD DIST, N	10. 7	ILLINOIS	FED.	AID	PROJECT		
						CONTRACT	NO. 6	3697
236	08-	0010	0-00-PV	′		LAKE	35	8
TE.		SEC.	TION			COUNTY	SHEETS	SHEE!






LAKE STREET

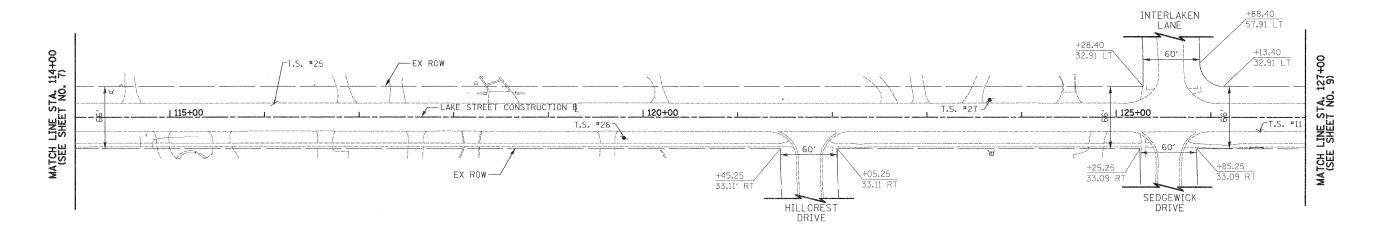


NORHTING = 6,077,217

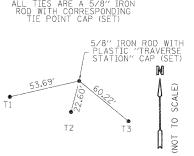


TRAVERSE STATION *26

NORTHING = 5,950.900
EASTING = -510.333

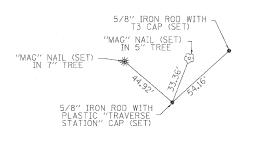

TRAVERSE STATION #27

NORTHING = 5,895.310
EASTING = -125.760

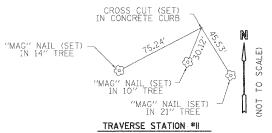


NORTHING = 5,792.890 EASTING = 142.836

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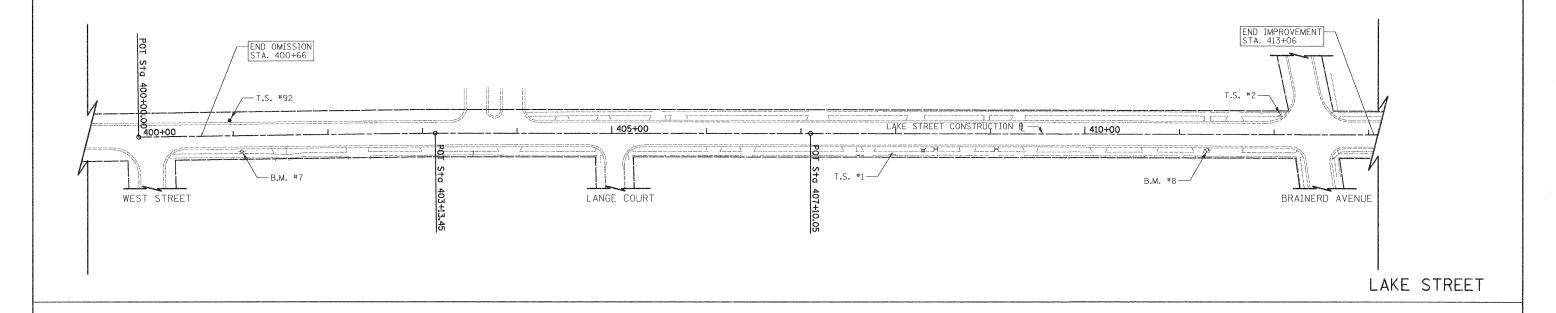
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-	F.A.U. SECTION							COUNTY TOTAL SH SHEETS				
	1236	236 08-00100-00-PV							LAKE	35	9	
									CONTRACT	NO.	63697	
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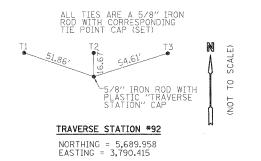






EXISTING LAKE STREET (EAST) CONSTRUCTION BASELINE

DESCRIPTION	STATION	NORTHING	EASTING
B.O.A.	400+00.00	5672.31	3694.33
P.O.T.	403+13.45	5676.53	4007.75
P.O.T.	407+10.05	5676.74	4404.35
E.O.A.	413+27.96	5675.81	5022.25

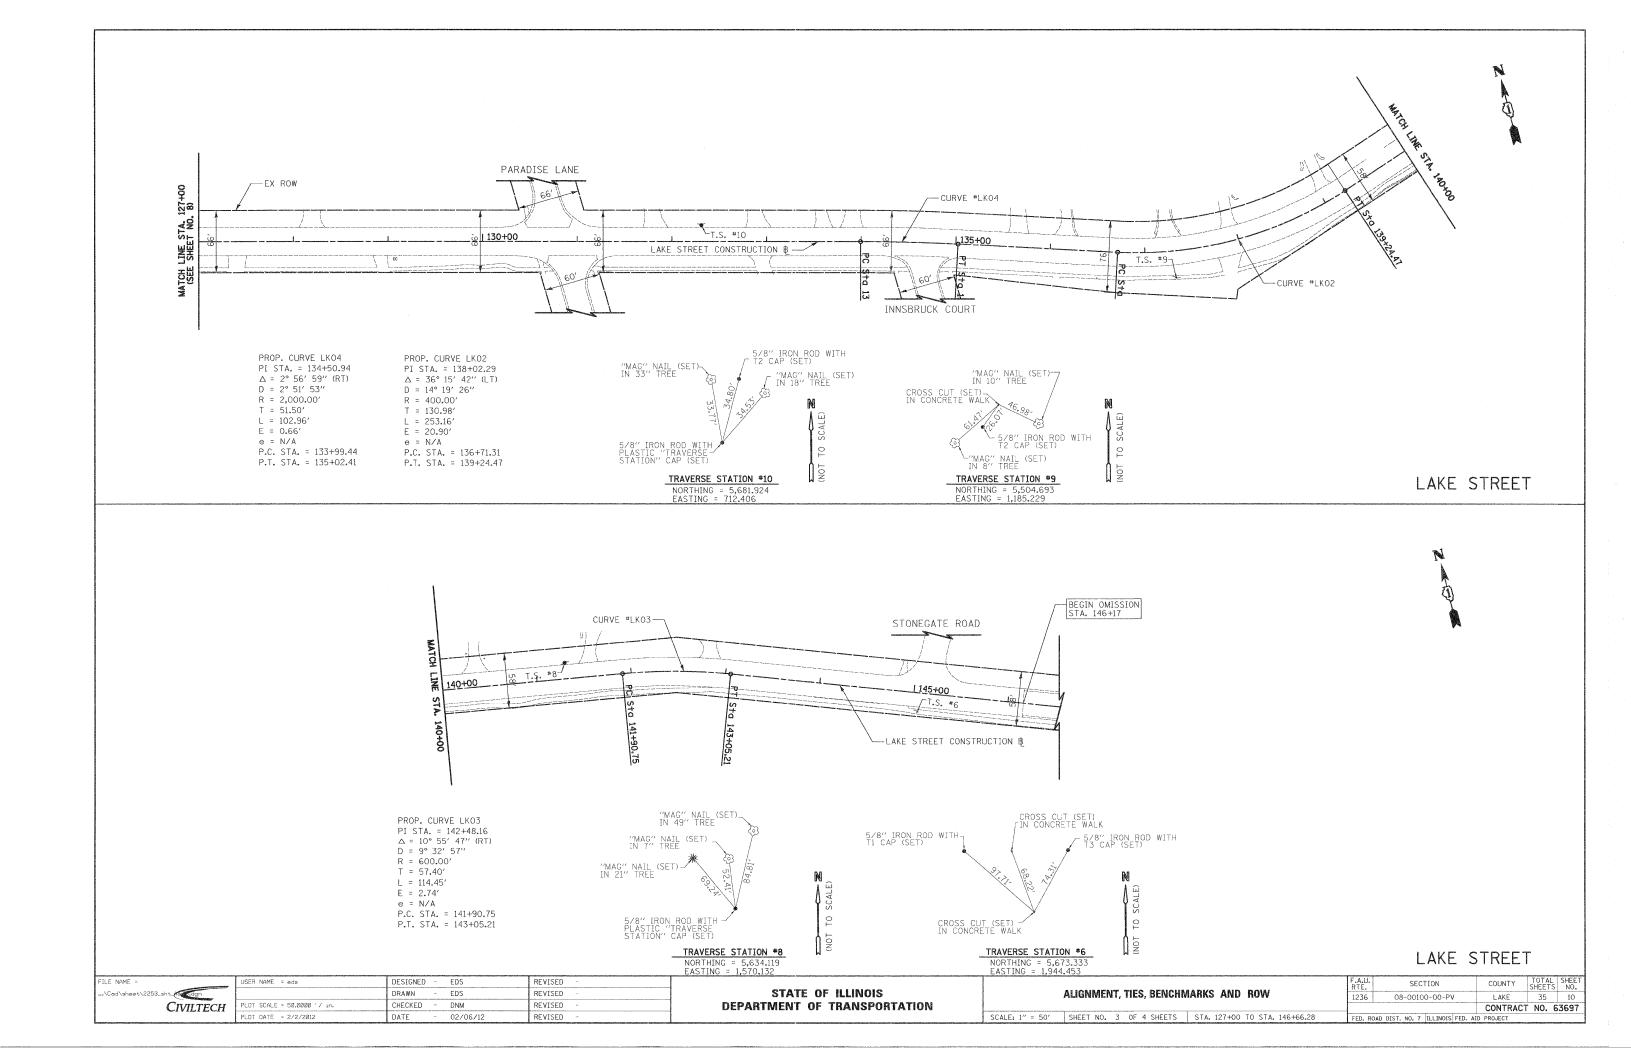NUMBER	STA. & OFFSET FROM PR &	DESCRIPTION	ELEVATION
B.M. #7	401+08.86 16.55 RT	RAILROAD SPIKE IN FIRST POWER POLE EAST OF WEST STREET ON SOUTH SIDE OF LAKE STREET.	708.40
B.M. #8 411+29.38 16.43 RT		RAILROAD SPIKE SET IN SECOND POWER POLE WEST OF BRAINERD AVENUE ON SOUTH SIDE OF LAKE STREET.	708.92



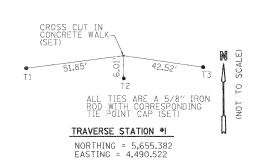

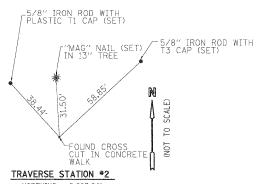


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NORTHING	=	5,697.24	41
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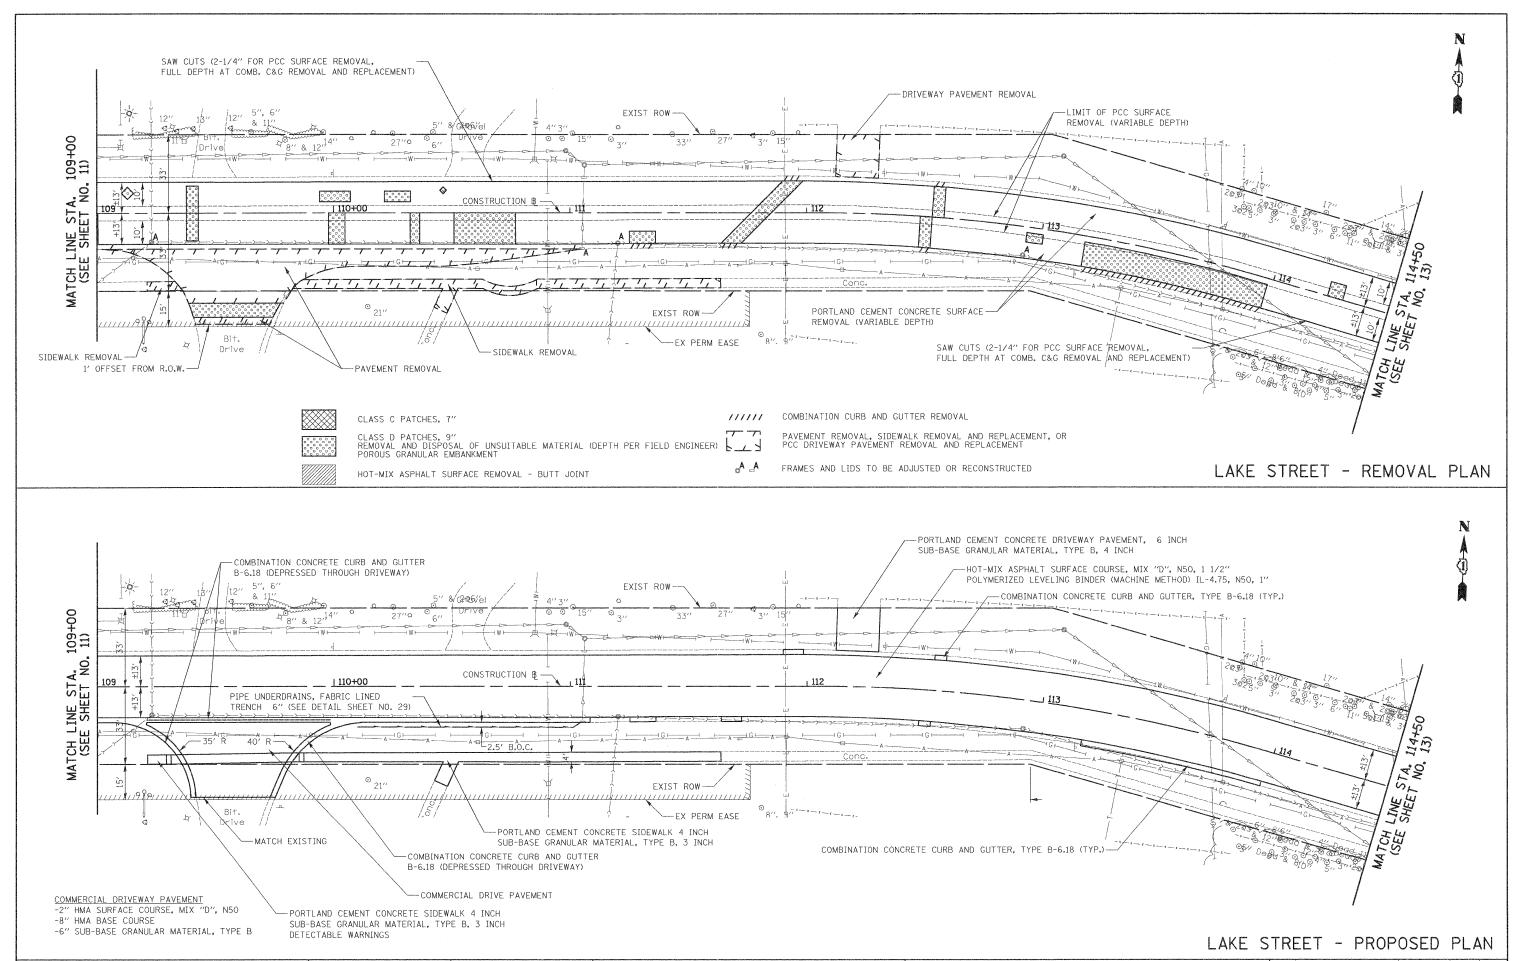
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	SCALE: 1" = 50'	SHEET NO. 4 C)F 4					413+27.96

F.A.U. SECTION							COUNTY	TOTAL SHEETS	SHEET NO.	
1236 08-00100-00-PV							LAKE	35	11	
							Т	CONTRACT	NO. E	3697
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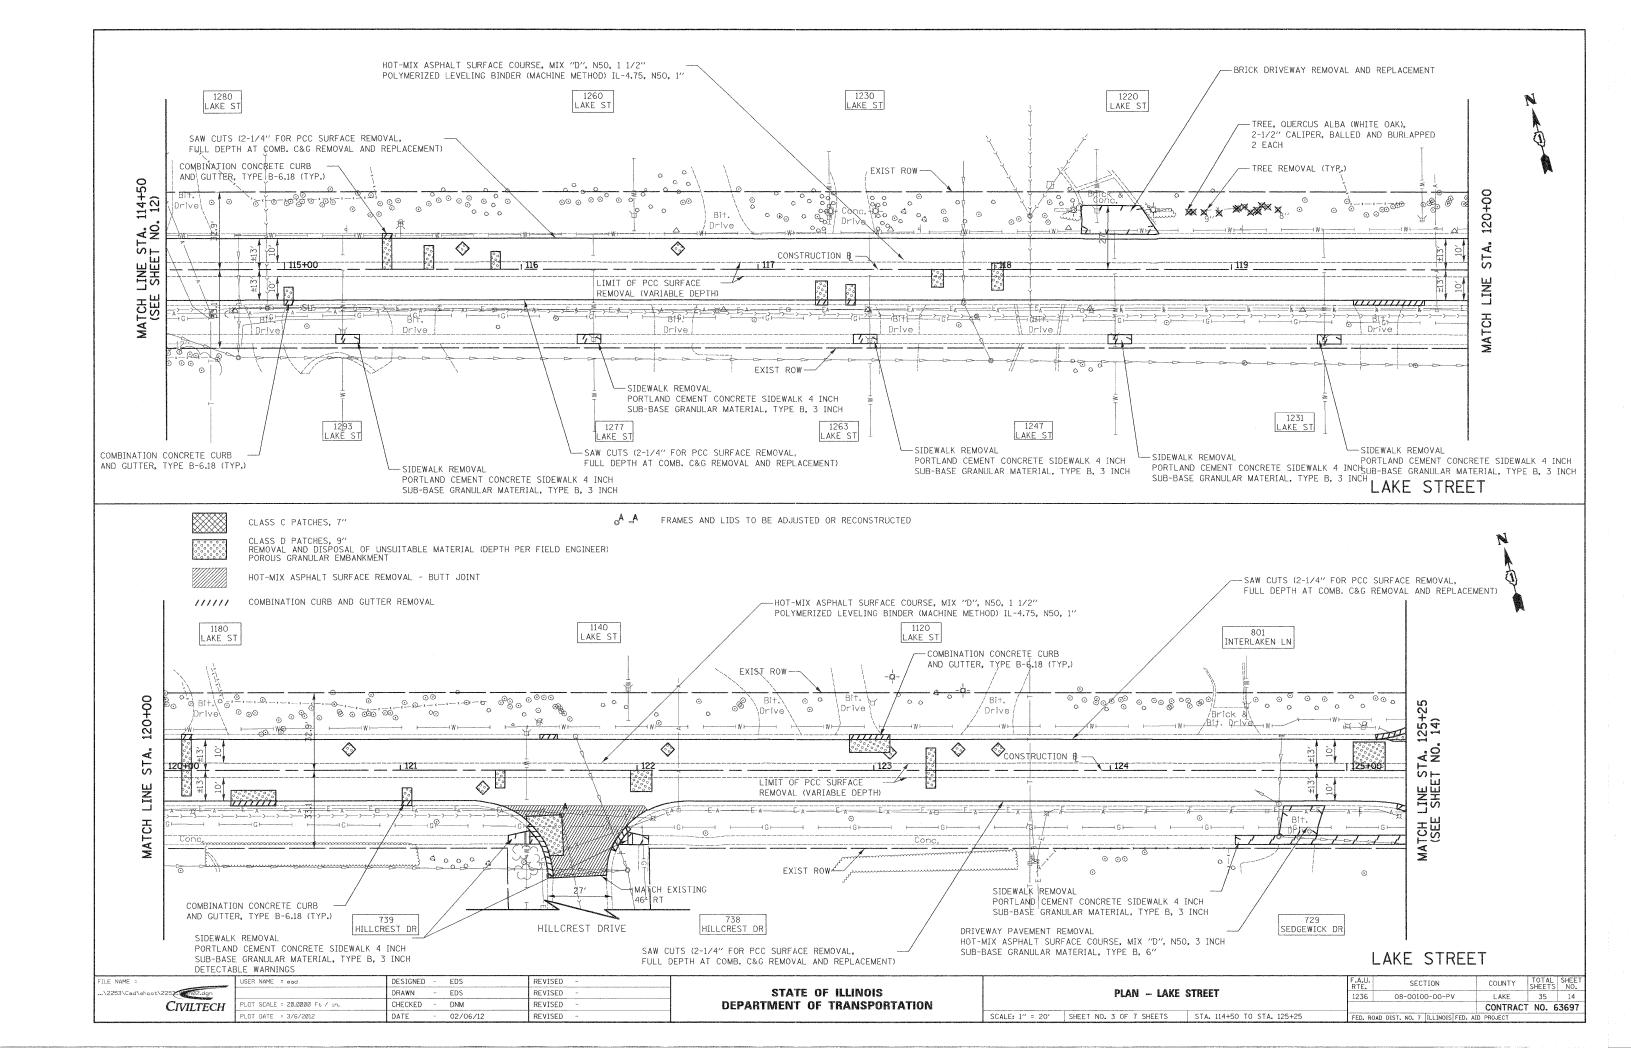
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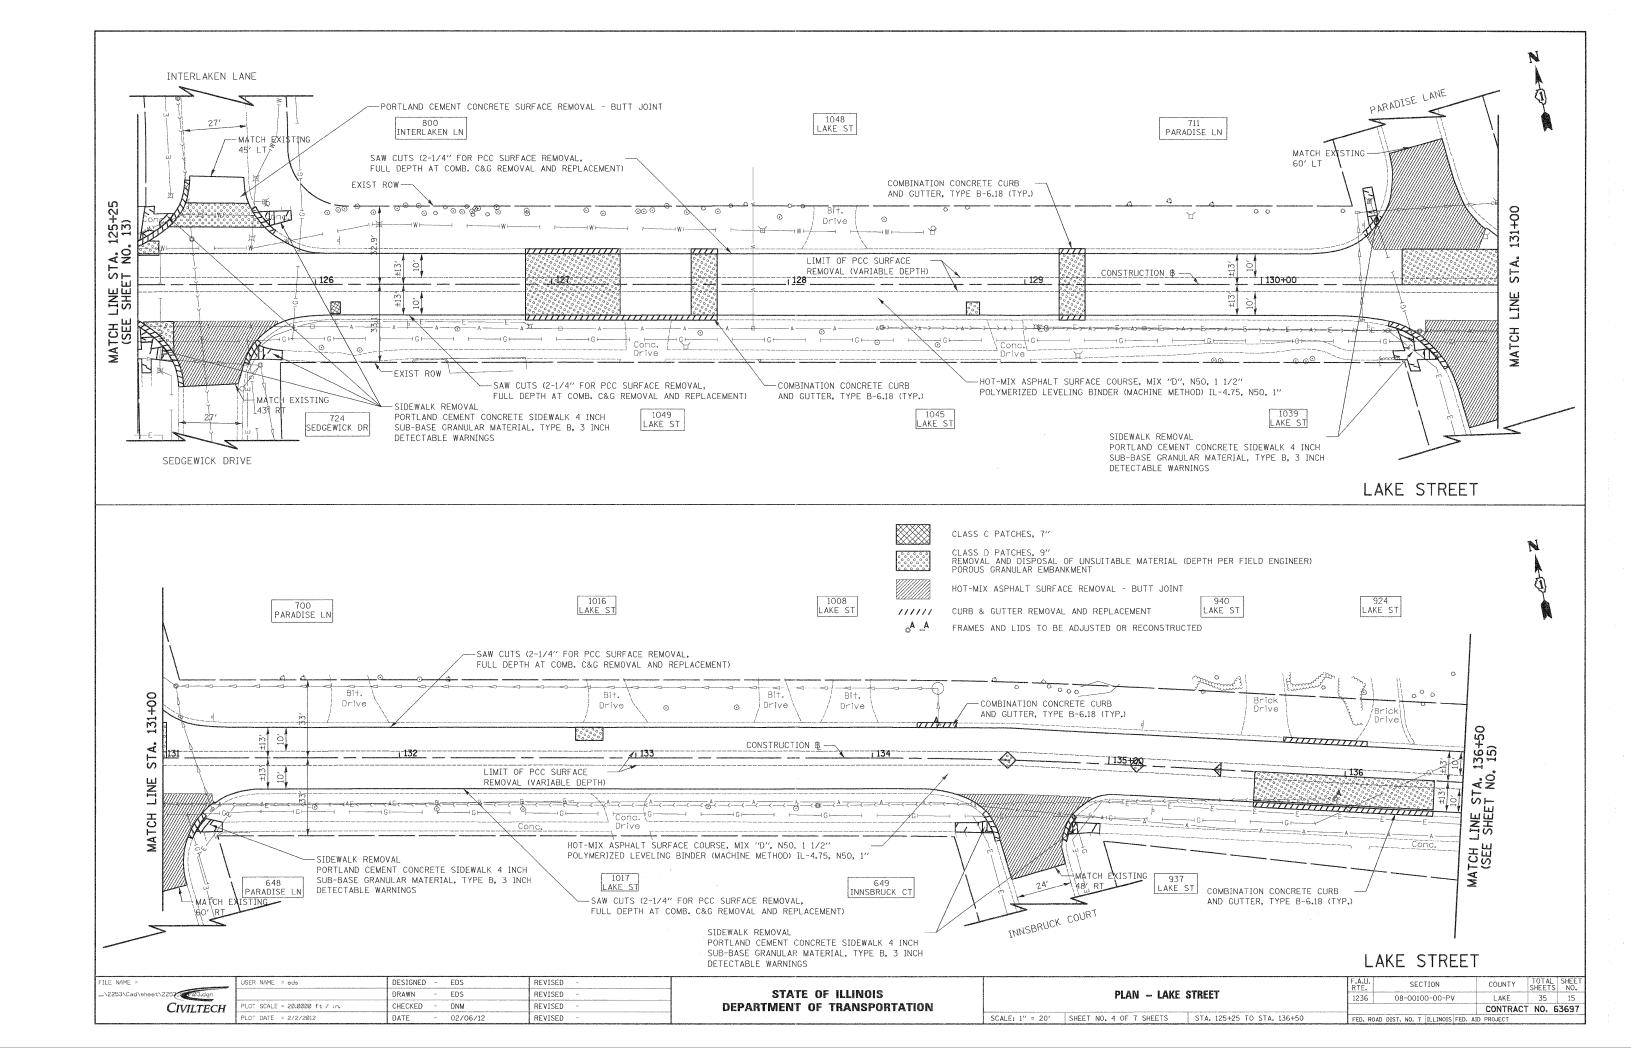
STATE OF ILLINOIS
DEPARTMENT OF TRANSPORTATION


PLAN - LAKE STREET


SCALE: 1" = 20' SHEET NO. 2 OF 7 SHEETS STA. 109+00 TO STA. 114+50

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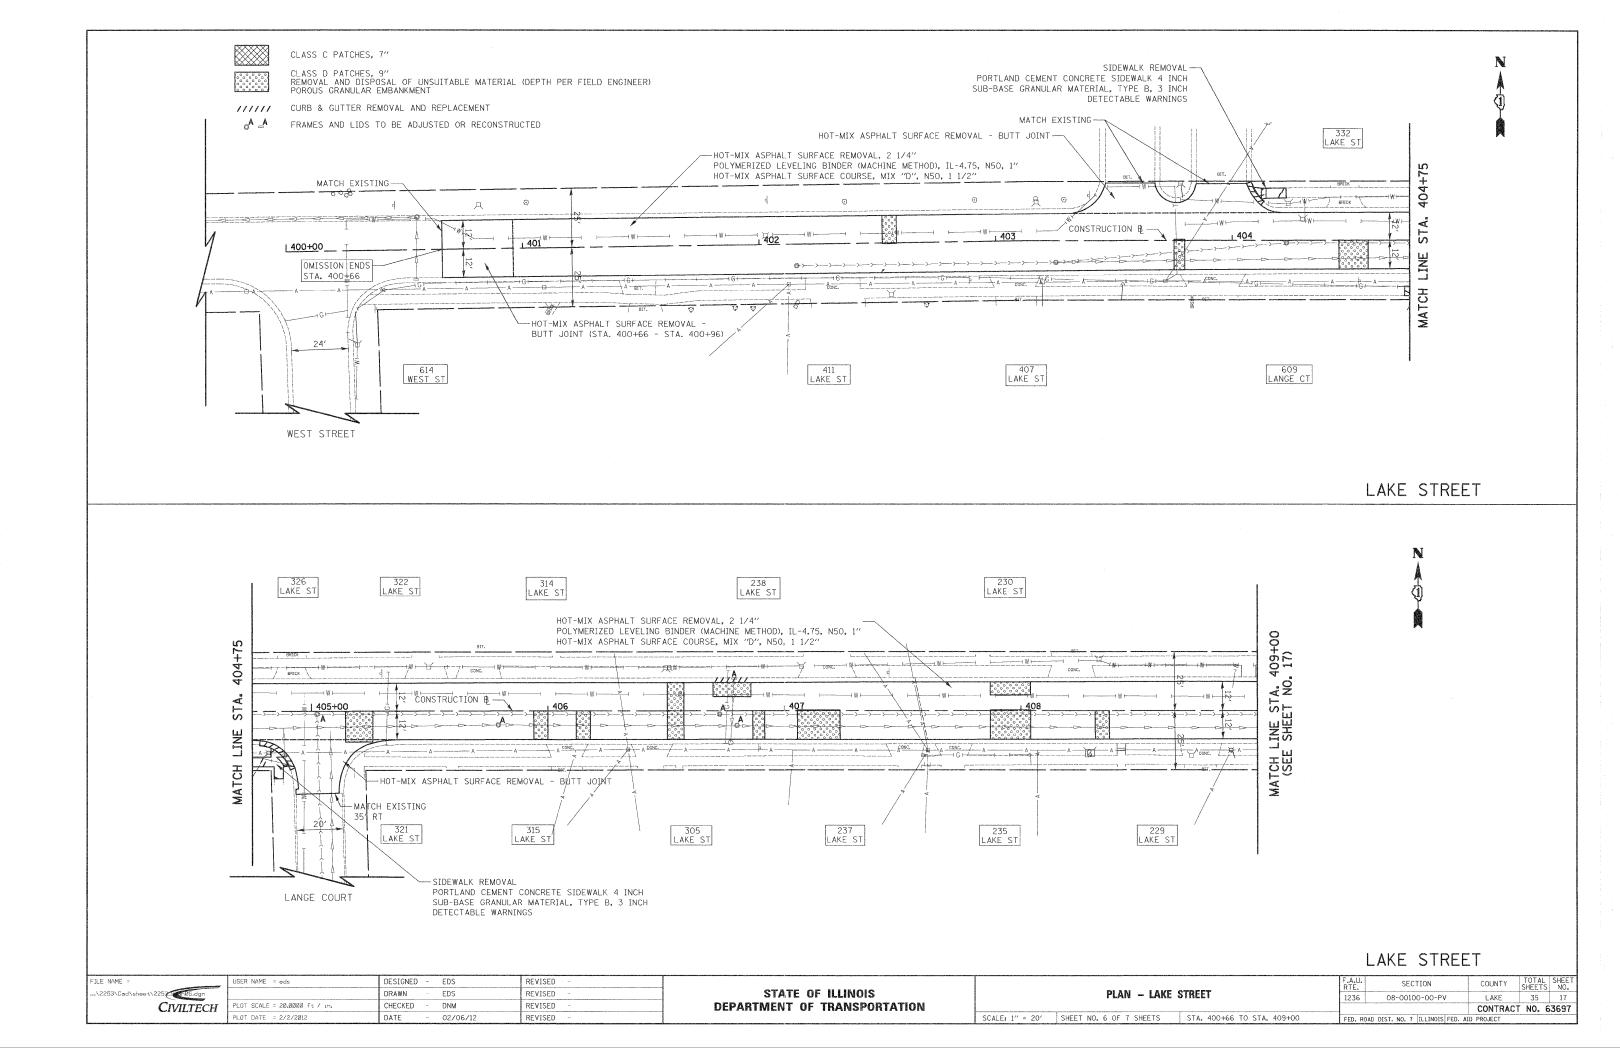


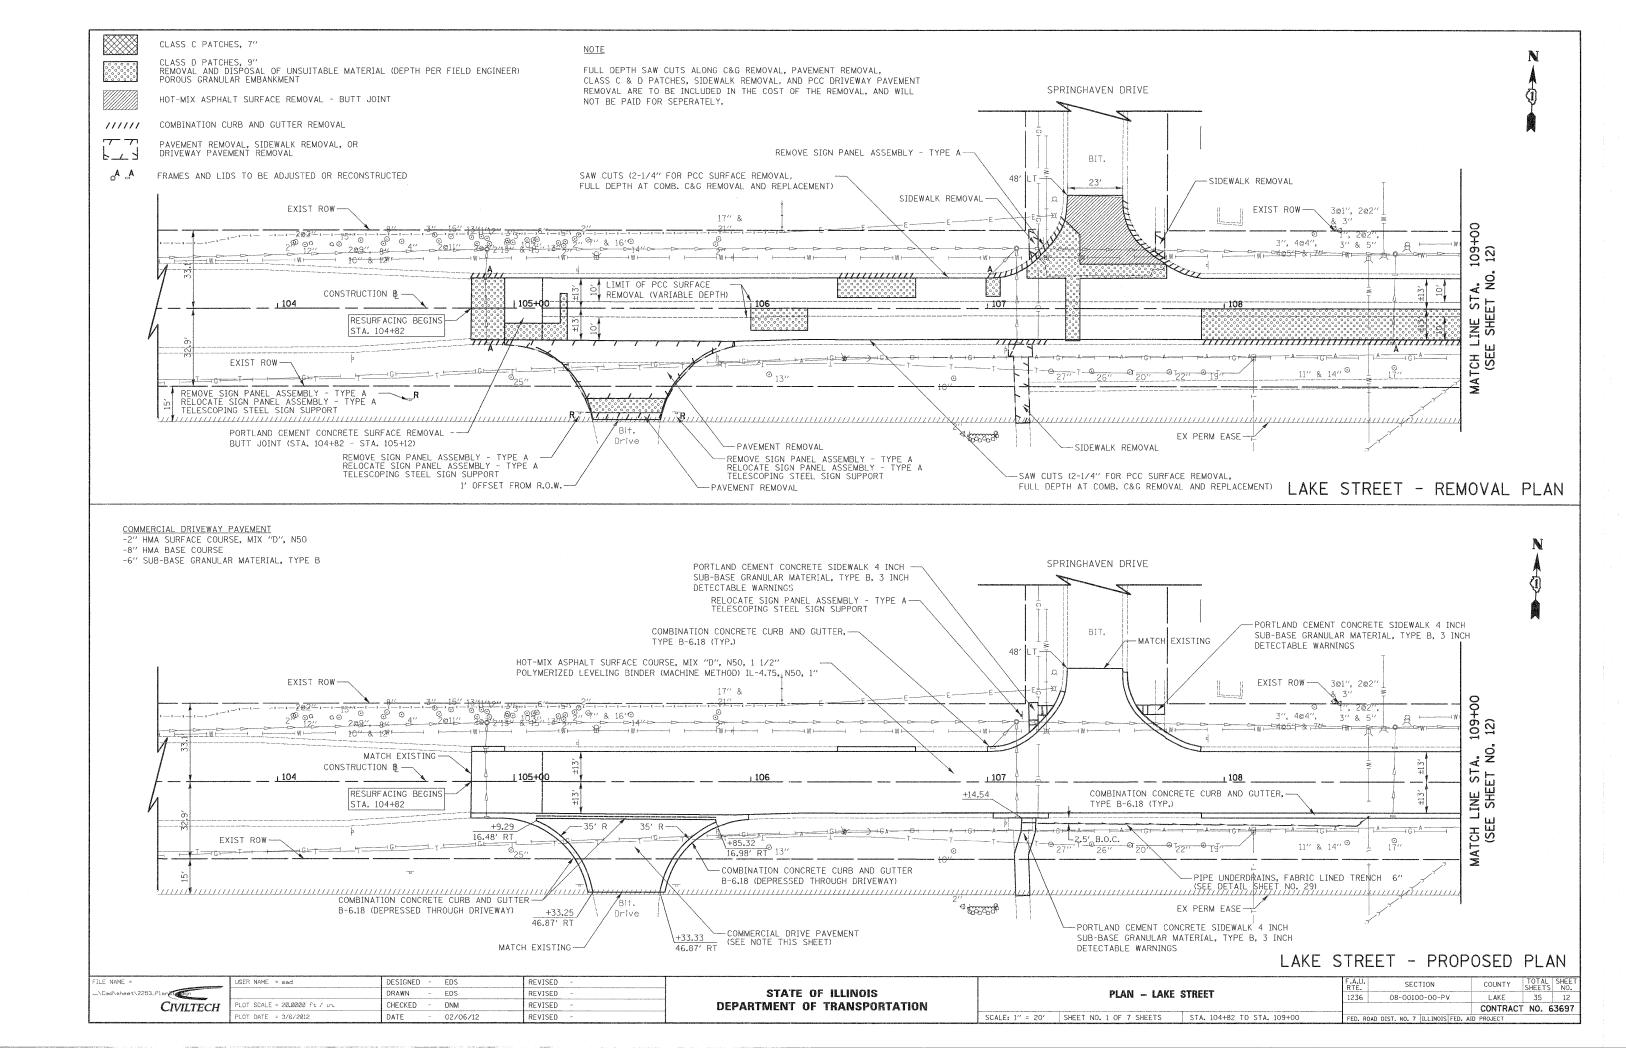




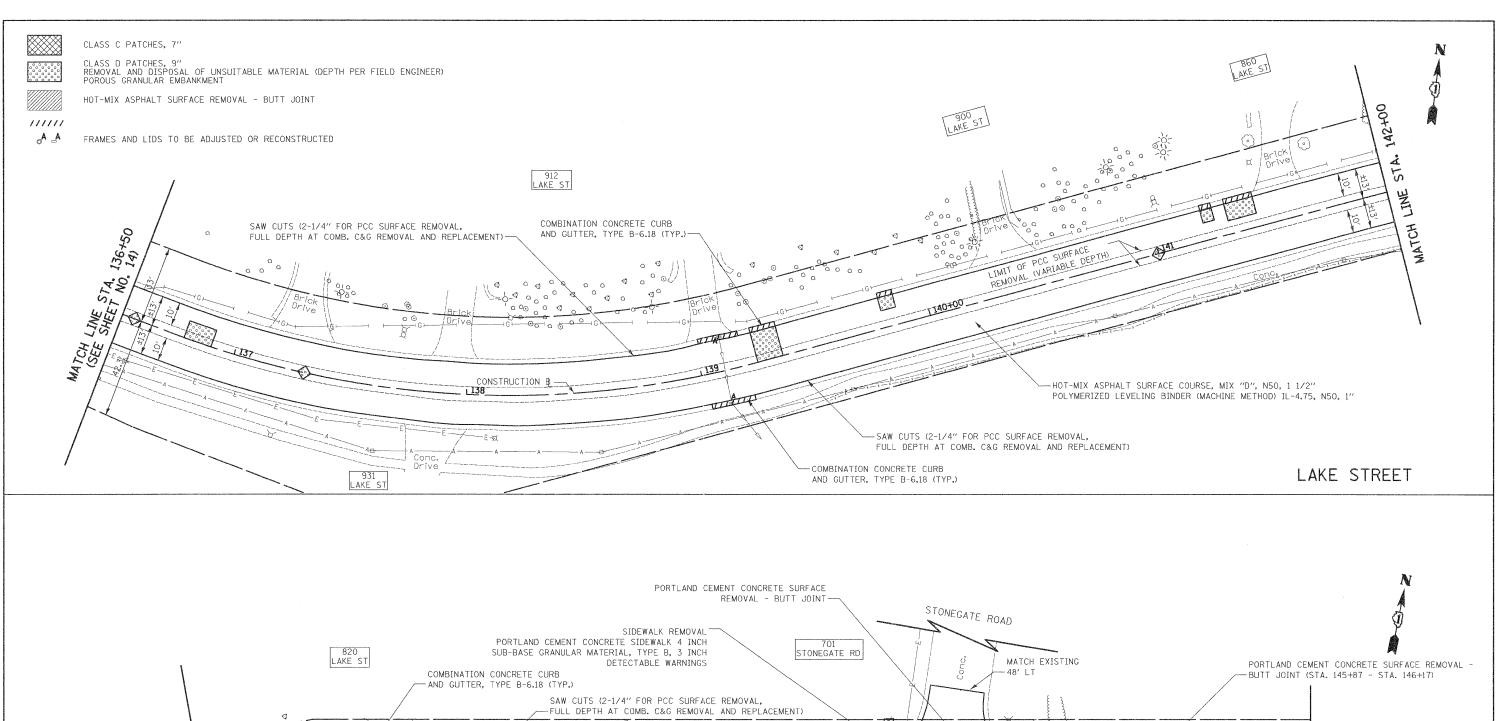
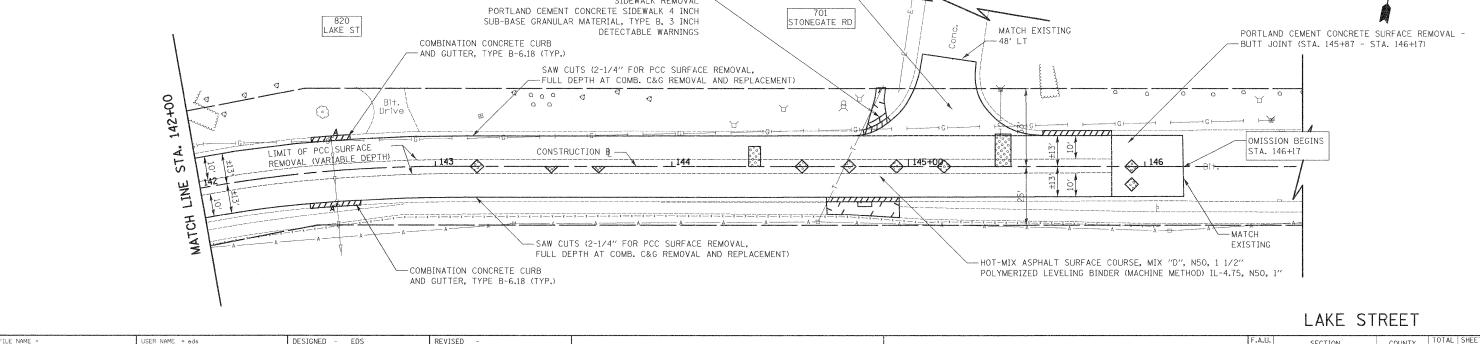
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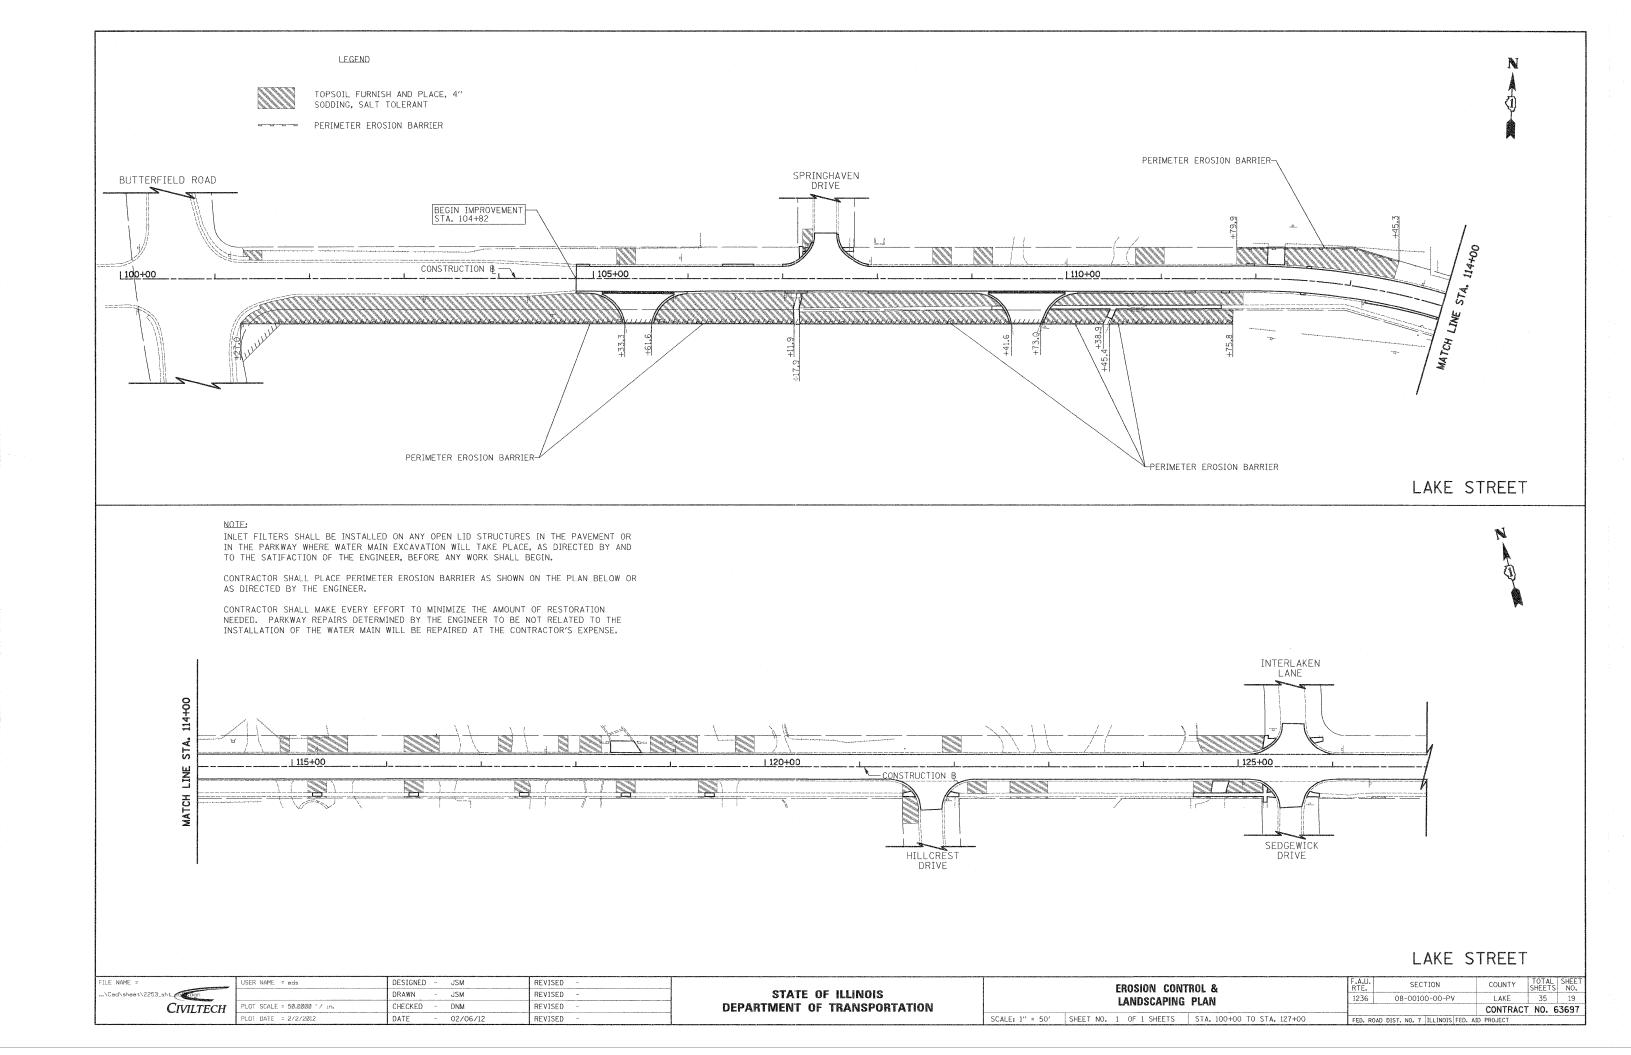



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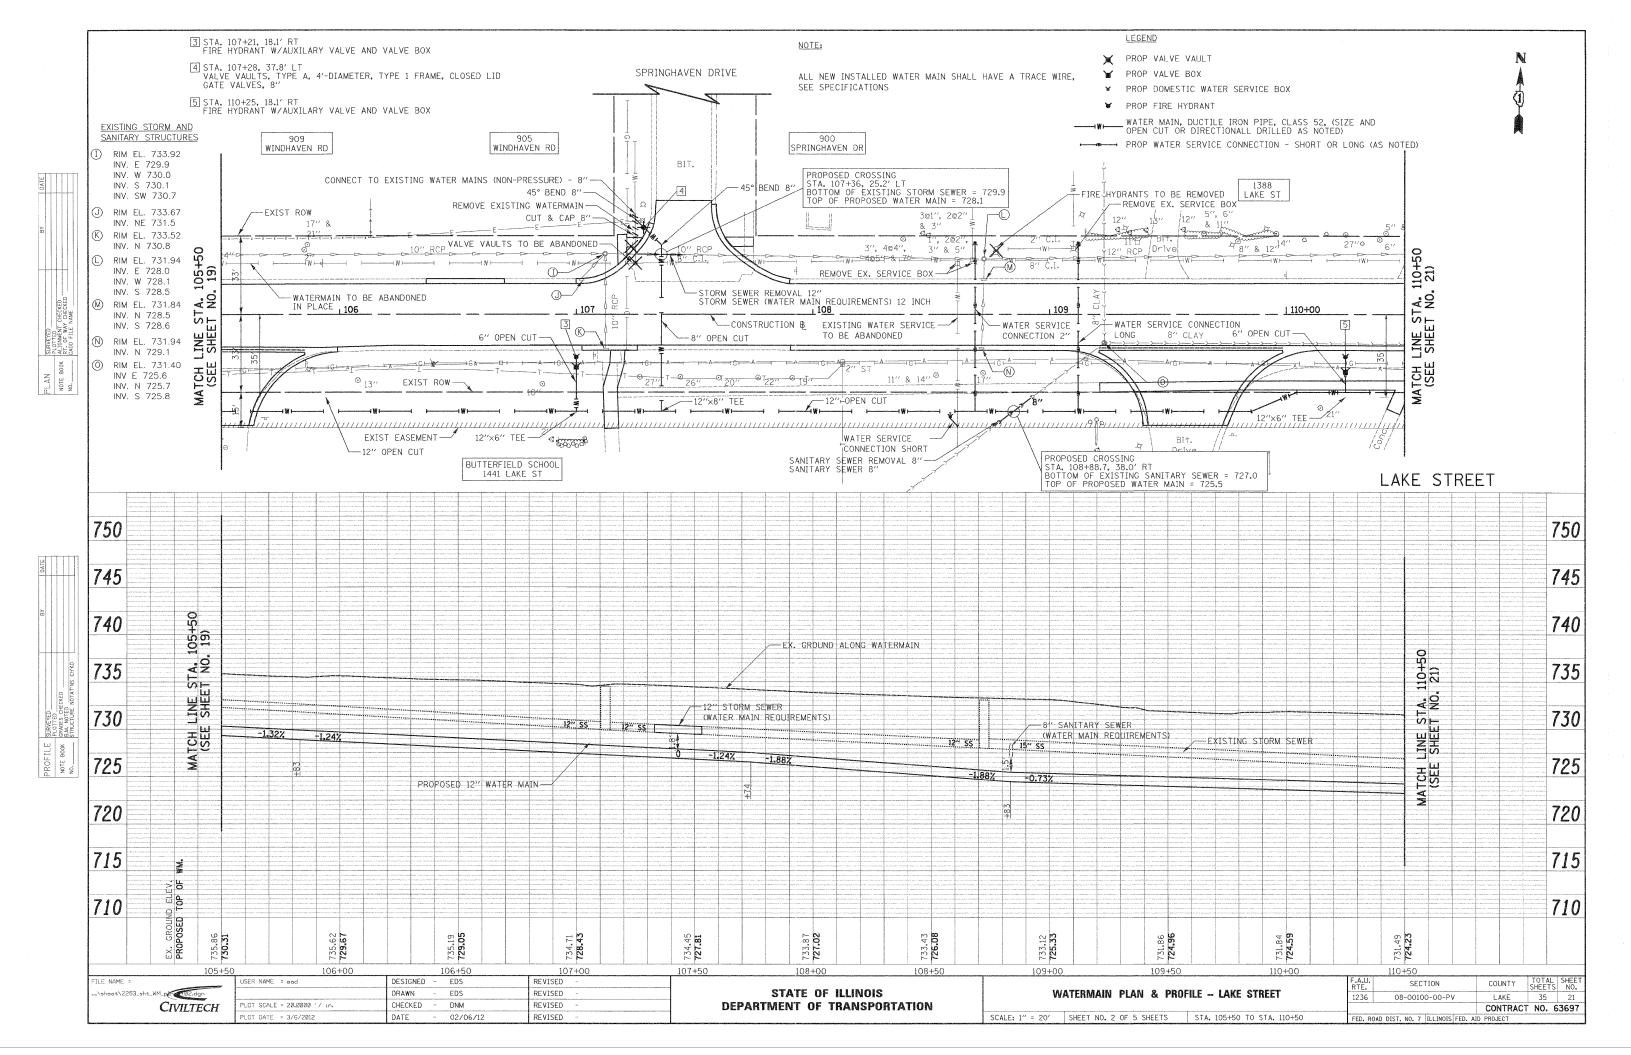
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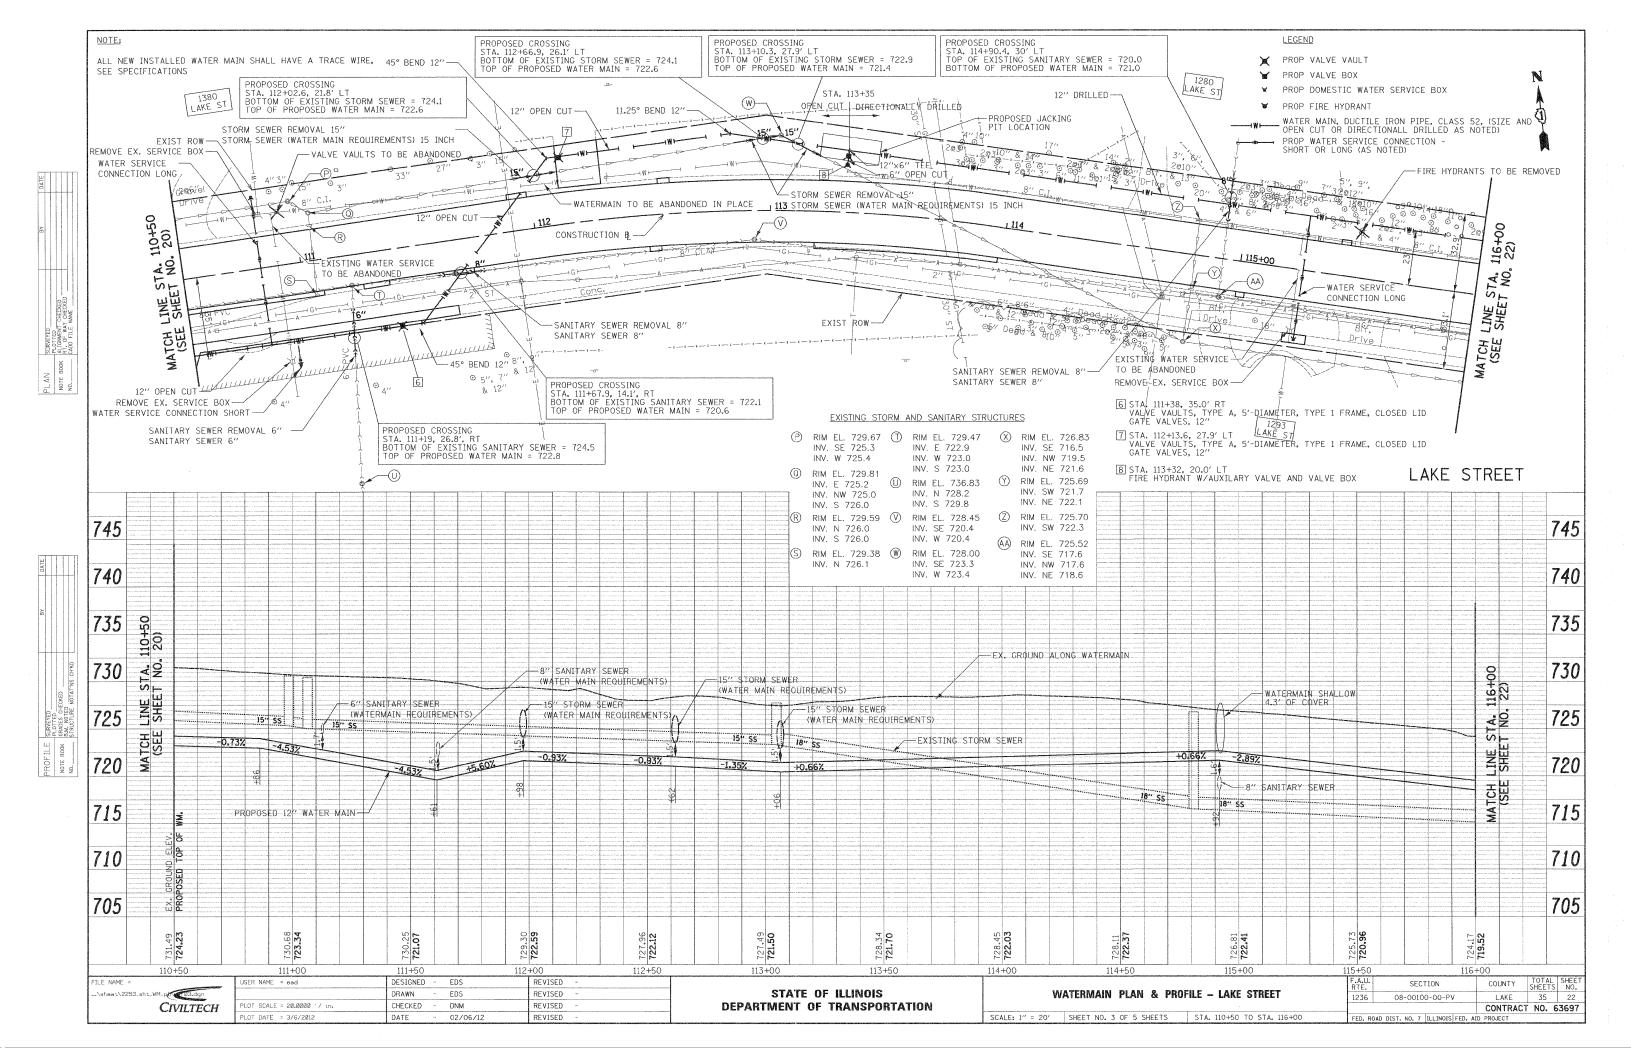
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DEPARTMENT	OF	TRANSPORTATION

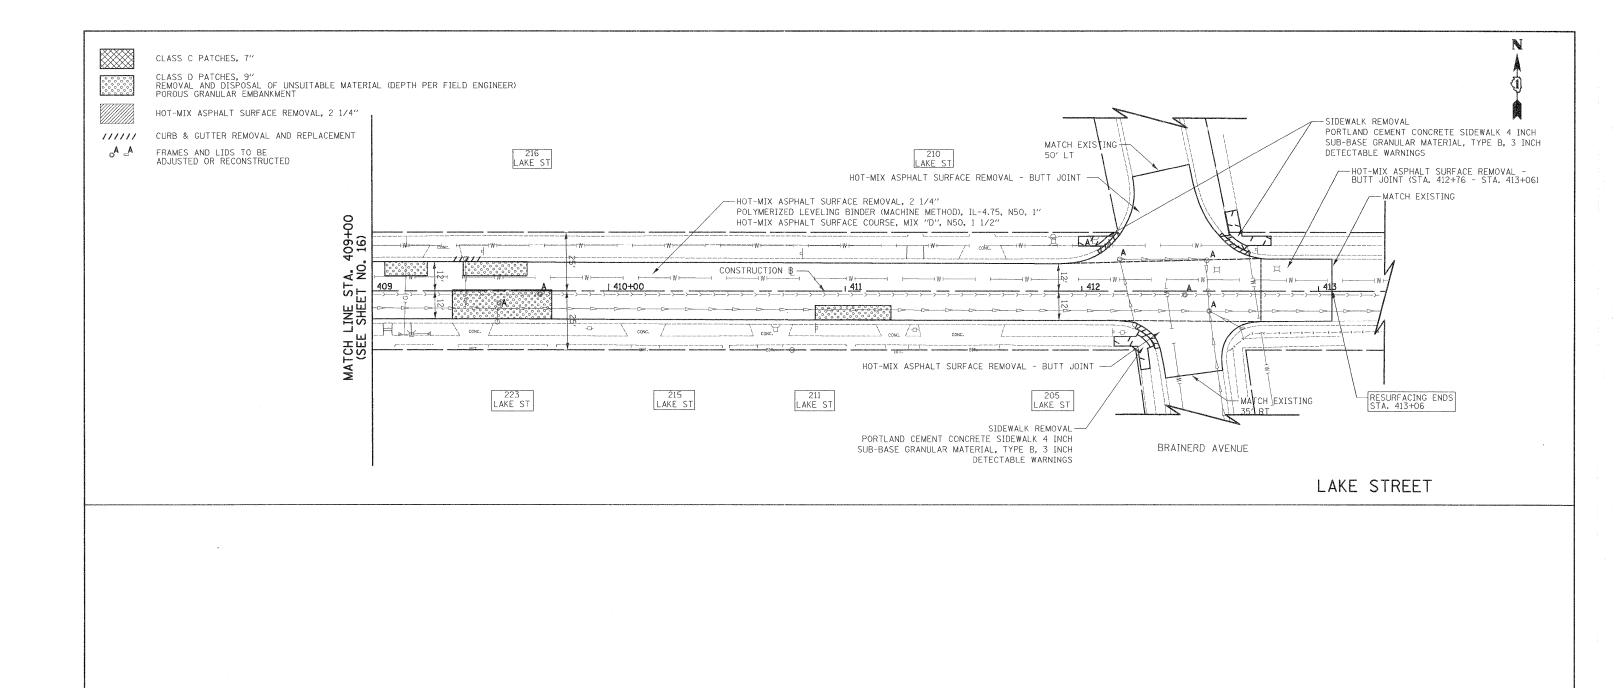
		a row the row had been	F.A.U. RTE.	SECTION	COUNTY	TOTAL SHEETS	SHEET NO.
	PLAN – LAKE :	STREET	1236	08-00100-00-PV	LAKE	35	18
					CONTRACT	NO. 6	3697
LE: 1" = 20'	SHEET NO. 7 OF 7 SHEETS	STA. 409+00 TO STA, 413+06	FED. RO	AD DIST, NO. 7 ILLINOIS FED. A	ID PROJECT		










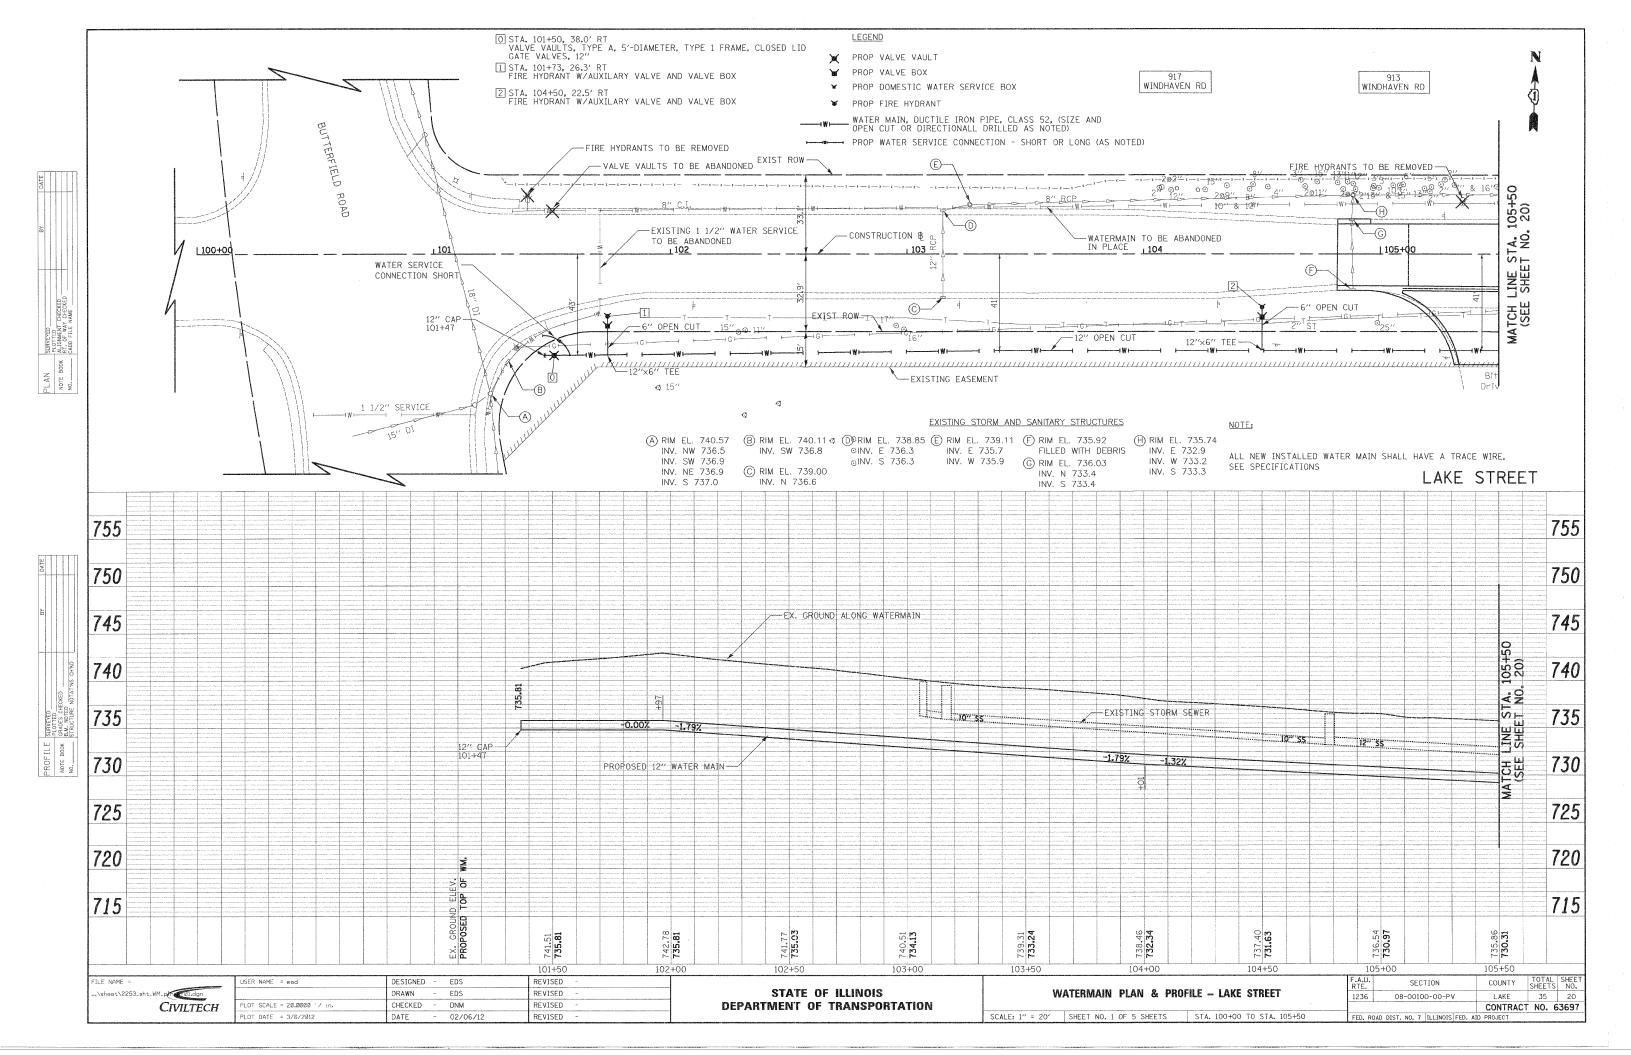

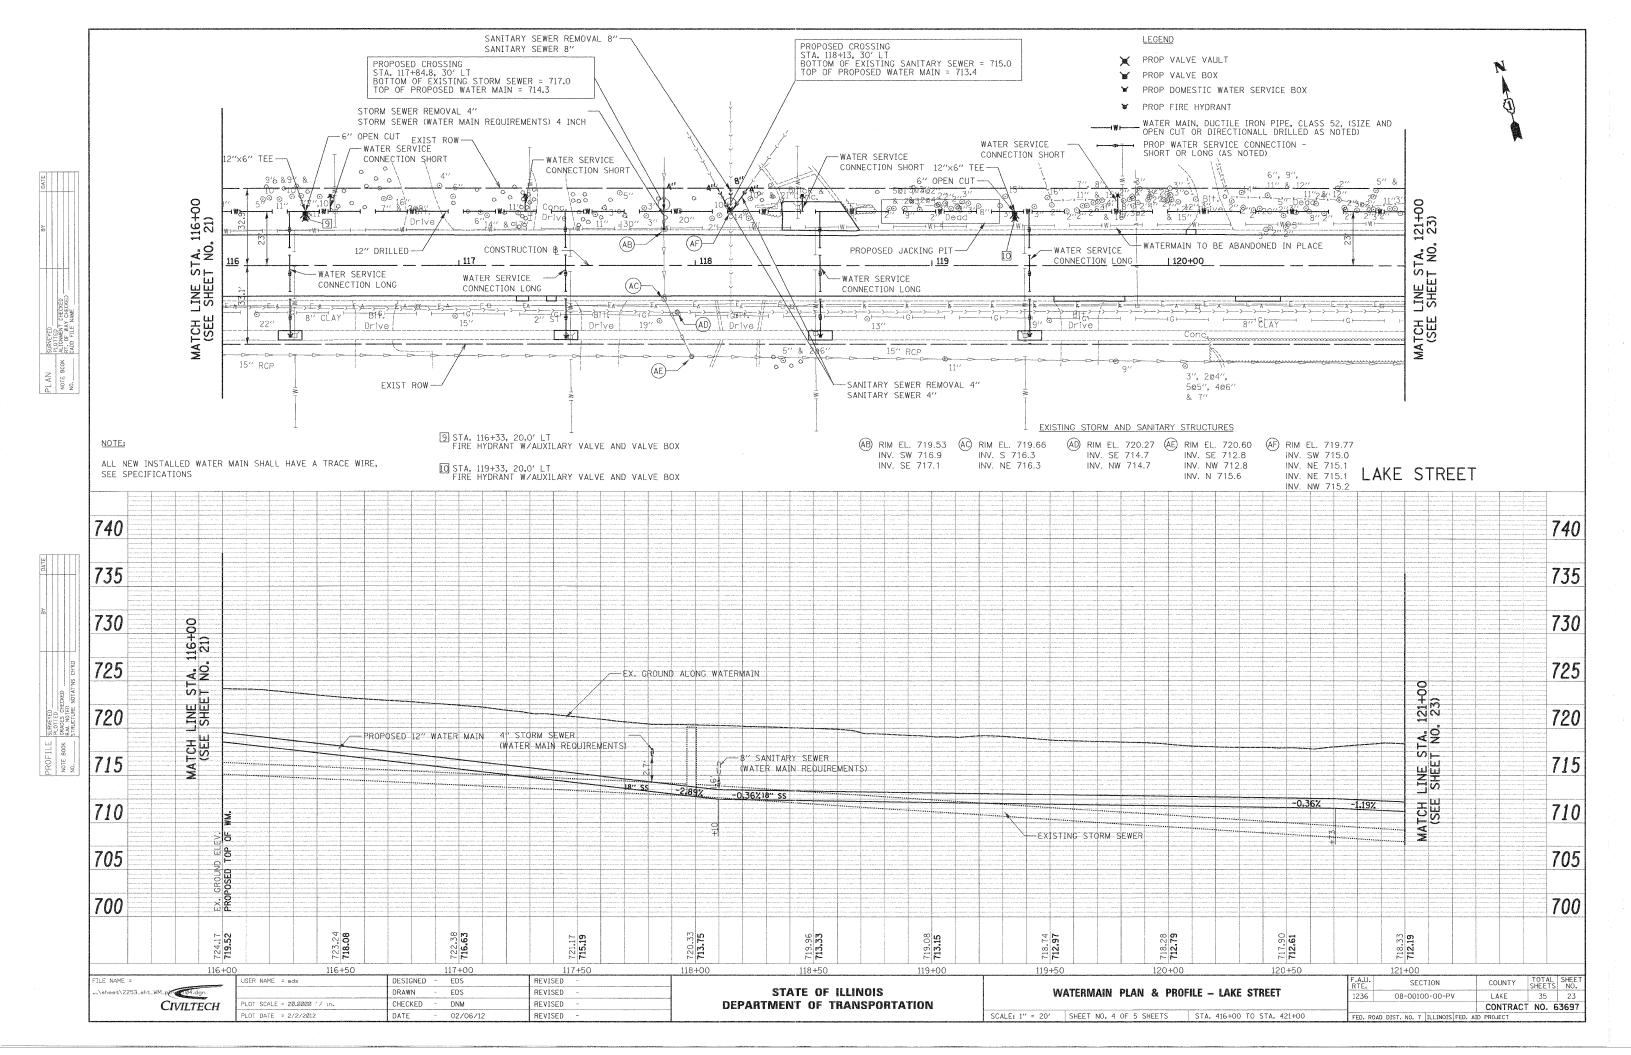


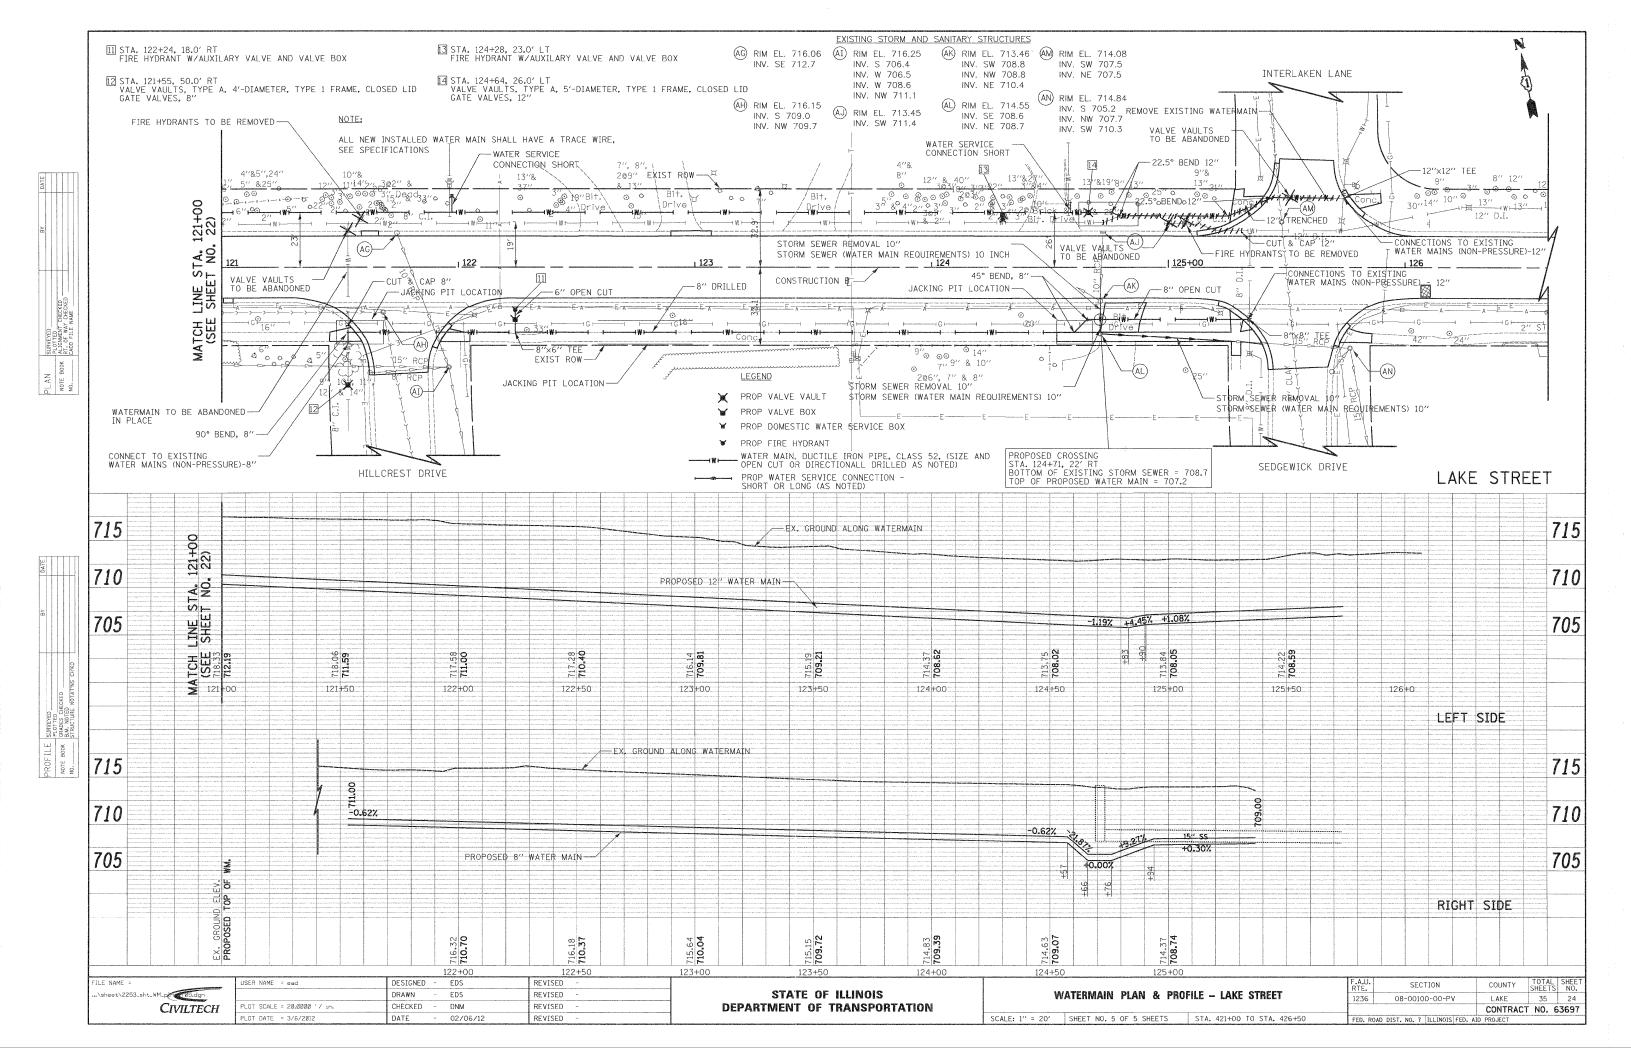

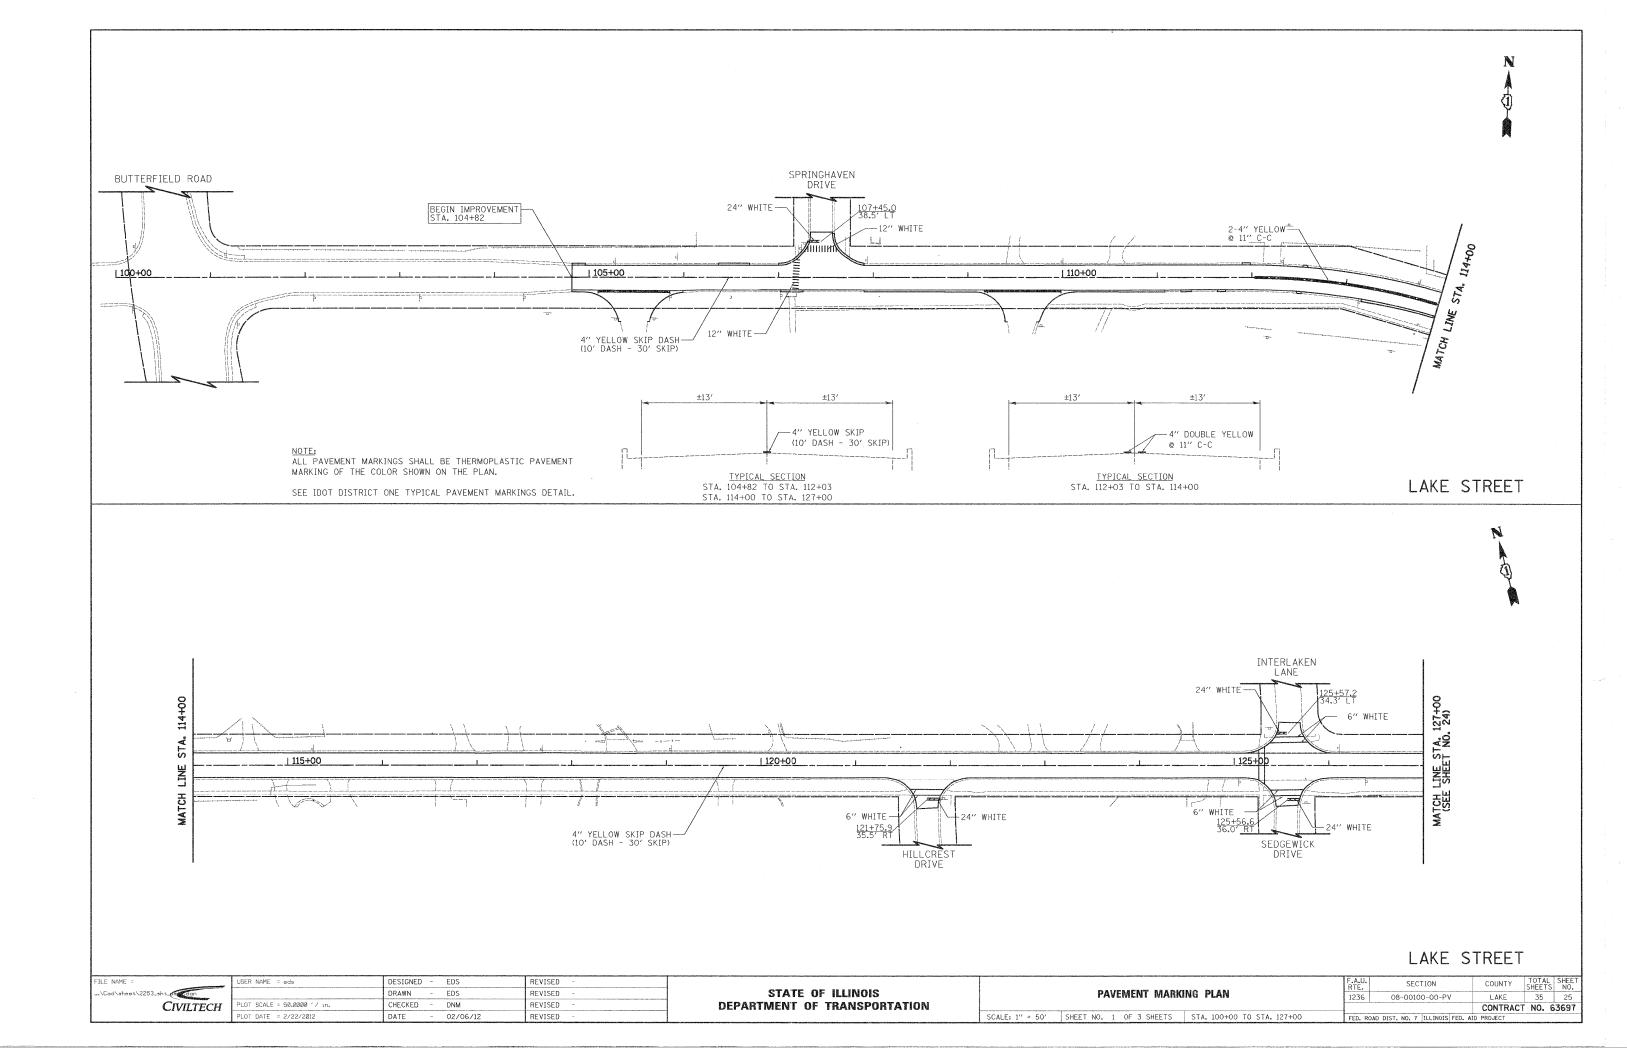

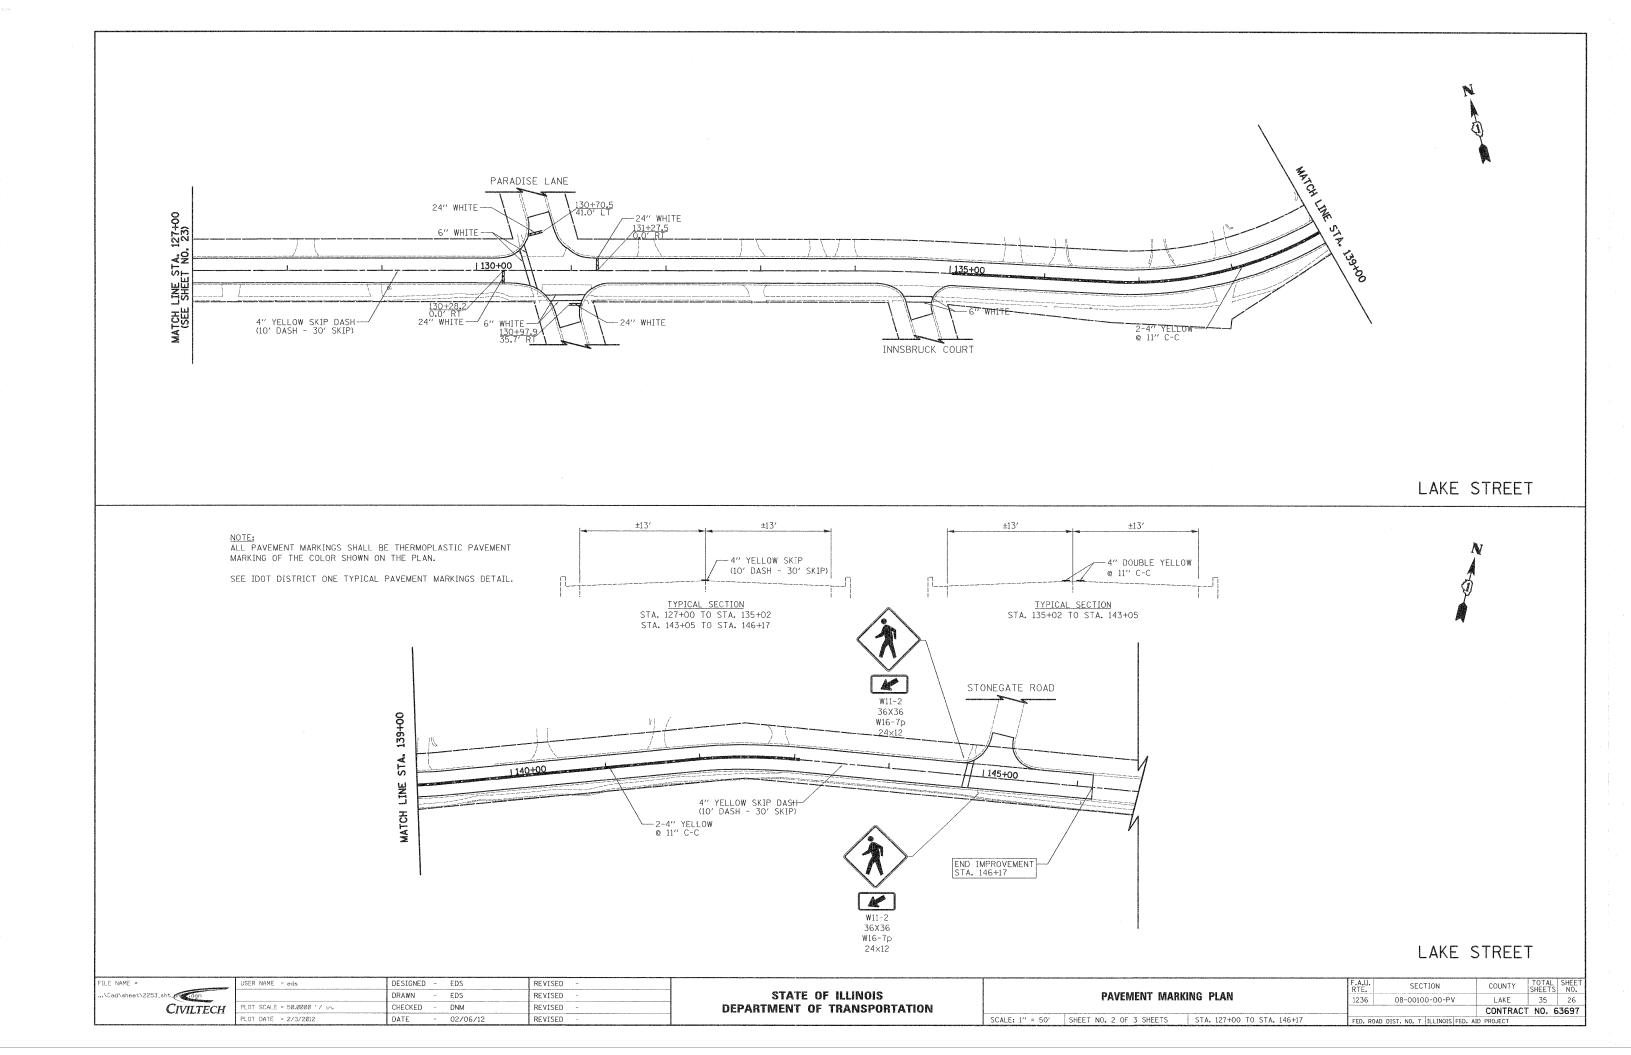




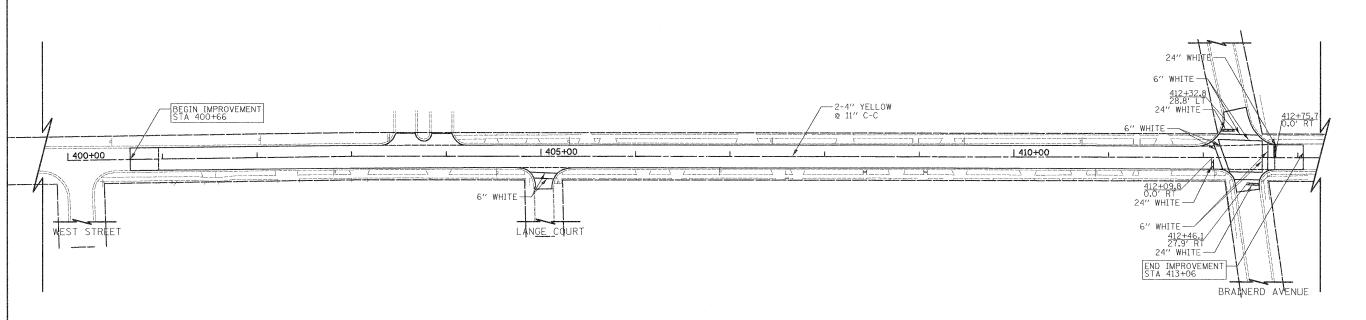

LAKE STREET

NOTE: ALL PAVEMENT MARKINGS SHALL BE THERMOPLASTIC PAVEMENT MARKING OF THE COLOR SHOWN ON THE PLAN.

SEE IDOT DISTRICT ONE TYPICAL PAVEMENT MARKINGS DETAIL.

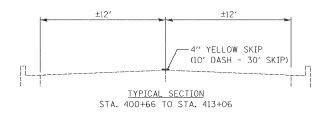


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STATI	E OF	ILLINOIS
DEPARTMENT	OF	TRANSPORTATION

			F.A.U. RTE.	SECTION	COUNTY	TOTAL SHEETS	SHEET NO.
PAVEMENT MARKING PLAN				08-00100-00-PV	LAKE	35	27
		T			CONTRACT	NO. 6	3697
SCALE: 1" = 50'	SHEET NO. 3 OF 3 SHEETS	STA. 400+00 TO STA. 413+06	FED. RO	OAD DIST, NO. 7 ILLINOIS FED. A	ID PROJECT		



GENERAL NOTES:

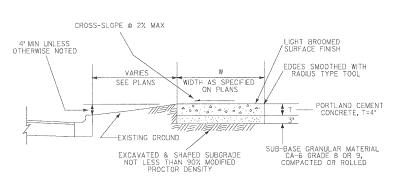- i. At locations where sidewalk is subjected to wheeltraffic and/or constructed across access drive entrances, the New P.C.C. Sidewalk Section shallbe thickened to 6' across the width of the driveway. This work shallbe considered as incidental, and no additional compensation will be allowed.
- Placing, finishing and curing of P.C.C. SIdewalk shallmeet the requirements of Sections 424 of the Standard Specifications for Road and Bridge Construction. Use 6 1/2 bag mix with 4% air entrainment.
- 3. Slab or panel contraction (control) joints shall be as follows:


For 4' Sidewalk width = 5' O.C. Joint Spacing 5' Sidewalk width = 5' O.C. Joint Spacing 6' Sidewalk width = 6' O.C. Joint Spacing 8' Sidewalk width = 8' O.C. Joint Spacing

- 4. Transverse expansion joints shall consist of preformed joint filler of thickness as follows:

 1/2" between sidewalk and structures, standards, poles
 3/4" at sidewalk intervals of not more thean 50 feet & abutting concrete curbing or pavement.
- If excavation or undercutting of subgrade has been made deeper than necessary, the base shallbe brought to proper grade by the addition of well-compacted bedding material without any extra compensation due the Contractor.


TYPICAL SECTION - P.C.C. SIDEWALK

ENGINEERING DIVISION CELL LIBRARY DTLS.CEL CELL NAME _____DTLOOI STANDARD NO. <u>OOI</u> VILLAGE OF LIBERTYVILLE

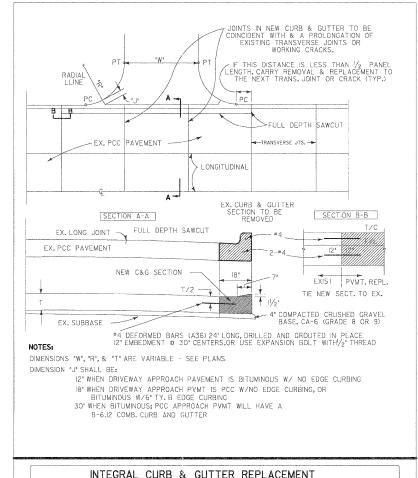

INTEGRAL CURB & GUTTER REPLACEMENT FOR NEW OR REPLACEMENT DRIVEWAY

ENGINEERING DIVISION CELL LIBRARY DTLS.CEL CELL NAME ______DTL003 STANDARD NO. <u>003</u> VILLAGE OF LIBERTYVILLE

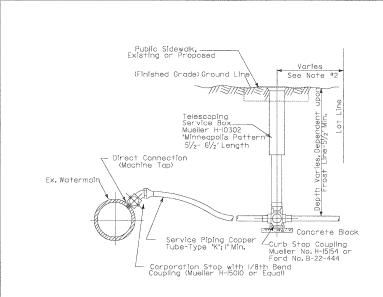

Notes:

- Compacted Granular Trench Backfillis Required where any Portion of Excavation Activity is Within Three (3) Feet Horizontally of Existing or Proposed Pavements, Driveways, or Sidewalks.
- 2. Where Public Sidewalk is Present or Proposed, B-Box Shall Be Centered Within Width of Sidewalk
- 3. When Water Services are Installed as Replacements for an Existing Service, Village Water Maintenance Personnel Shall Make the Tap for Services 2'in Diameter or Smaller.

WATER SERVICE INSTALLATION

ENGINEERING DIVISION CELL LIBRARY DTLS.CEL VILLAGE OF LIBERTYVILLE


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STATE	OF	ILLINOIS
DEPARTMENT	OF	TRANSPORTATION


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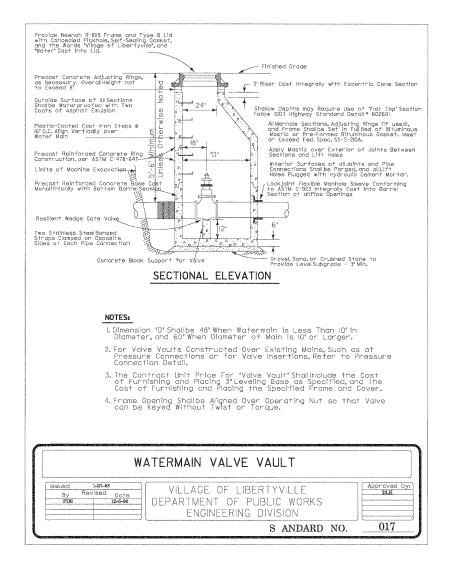
		F.A.U RTE.	SECTION	COUNTY	TOTAL SHEETS	SHEET NO.
CONSTRUCTION D	ETAILS	1236	08-00100-00-PV	LAKE	35	28
		_		CONTRACT	NO. E	3697
SHEET NO. 1 OF 4 SHEETS	STA. TO STA.		OAD DIST. NO. 7 ILLINOIS FED. AT			



ENGINEERING DIVISION CELL LIBRARY DTLS.CEL

VILLAGE OF LIBERTYVILLE

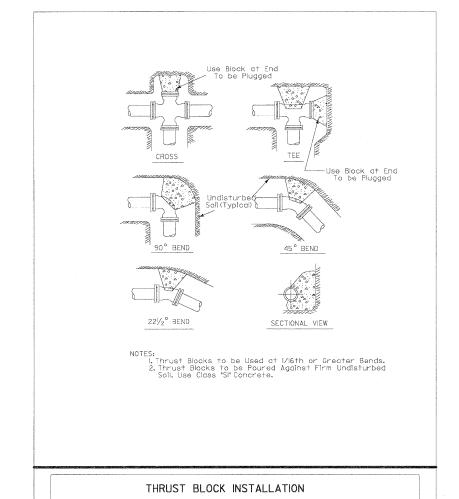

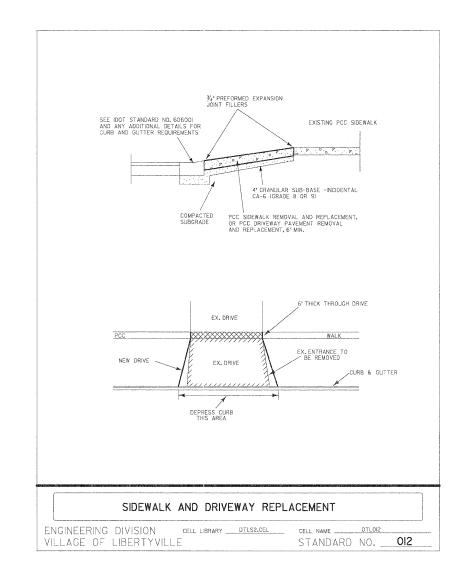





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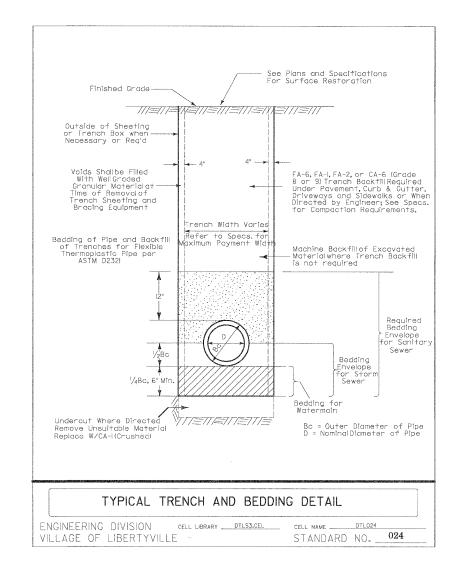
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STANDARD NO. <u>010</u>

STATE OF ILLINOIS
DEPARTMENT OF TRANSPORTATION






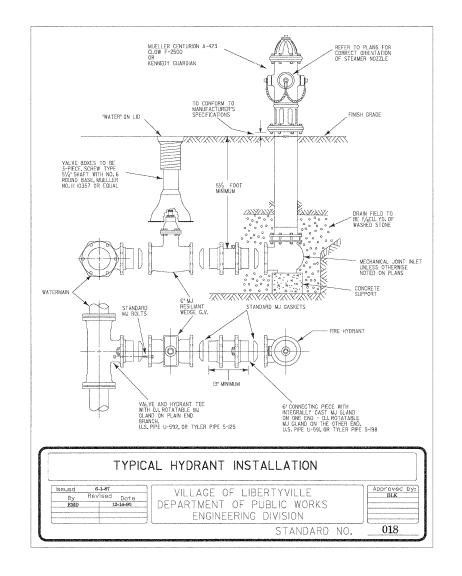


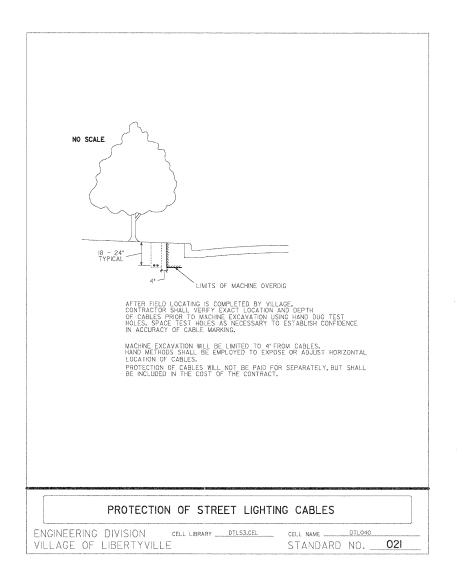


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-	F.A.L CONSTRUCTION DETAILS							SECTION	COUNTY	TOTAL SHEETS	OTAL SHEET HEETS NO.	
-		C	INSTRU	CHUM	DETAILS		1236	08-00100-00-PV	LAKE	35	30	
1		,							CONTRACT	NO. E	63697	
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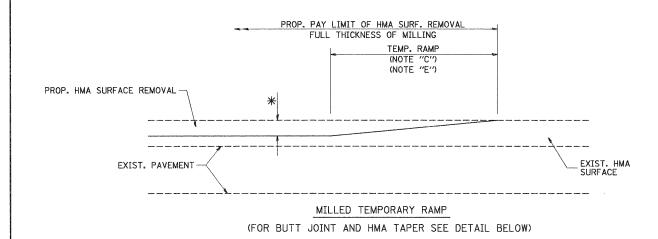


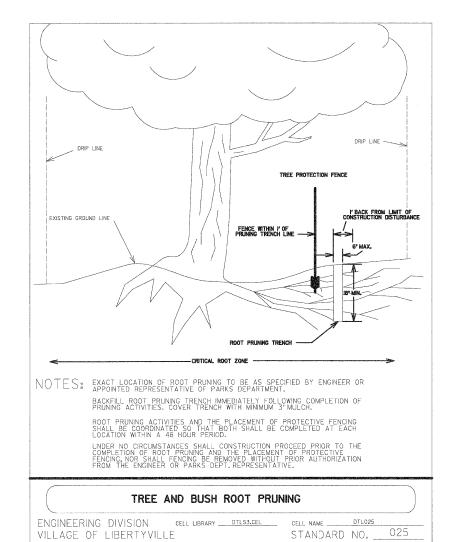


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		F.A.U RTE.	SECTION	COUNTY	TOTAL	SHEET NO.
į	CONSTRUCTION DETAILS	1236	08-00100-00-PV	LAKE	35	31
		_		CONTRACT	NO.	63697
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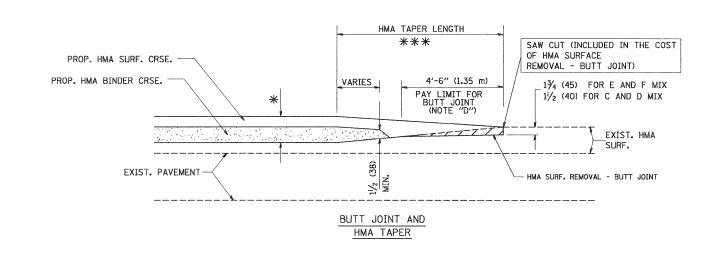
OPTION 1

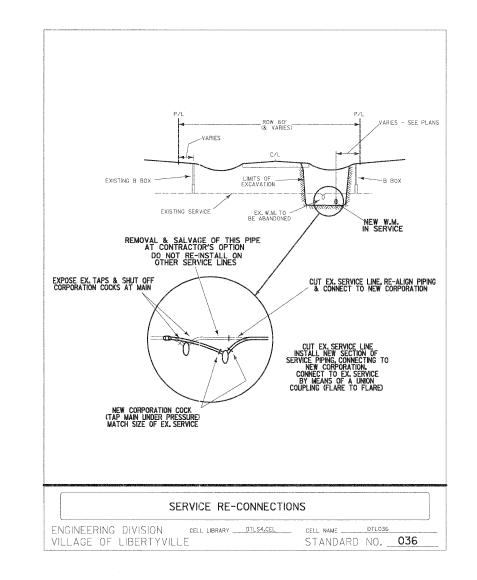

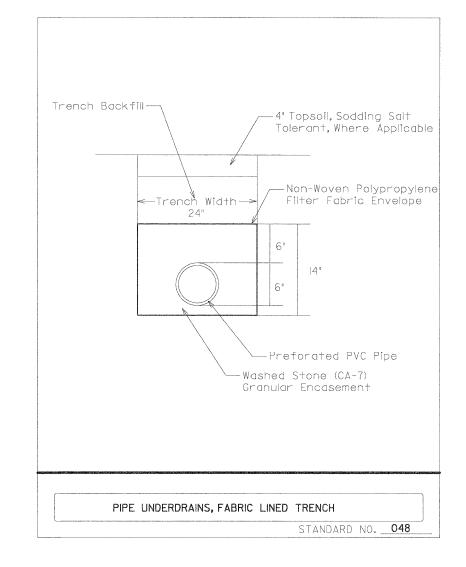
(FOR BUTT JOINT AND HMA TAPER SEE DETAIL BELOW)


OPTION 2

TYPICAL TEMPORARY RAMP

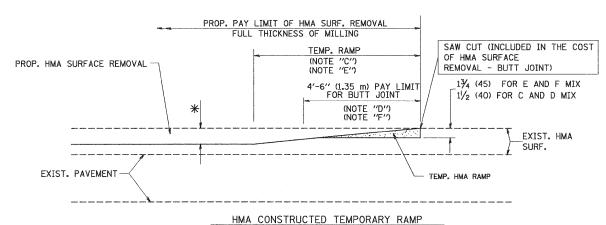

TYPICAL BUTT JOINT AND HMA TAPER FOR MILLING AND RESURFACING

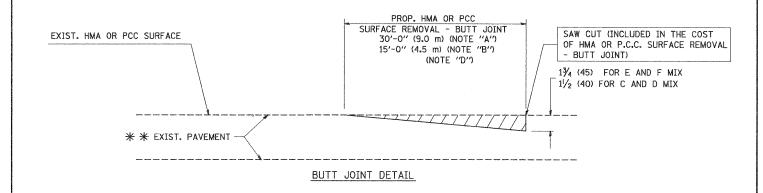

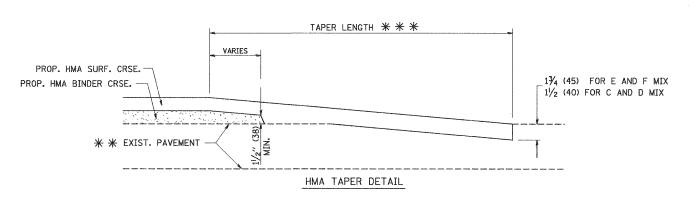

TYPICAL BUTT JOINT AND HMA TAPER FOR RESURFACING ONLY

* * PC CONCRETE, HMA OR HMA RESURFACED PAVEMENT.

NOTES


- A: MAINLINE ROADWAYS AND MAJOR SIDE ROADS.
- B: MINOR SIDE ROADS.
- C: THE TEMP. RAMP SHALL BE CONSTRUCTED IMMEDIATELY UPON REMOVAL OF THE EXISTING HMA SURFACE.
- D: THE BUTT JOINT SHALL BE CONSTRUCTED IMMEDIATELY PRIOR TO PLACING THE PROPOSED HMA COURSES.
- E: TAPER THE TEMP, RAMP AT A RATE OF 3'-0" (900 mm) PER 1 INCH (25 mm) OF MILLING THICKNESS.
- F: INSTALLATION AND REMOVAL OF THE 4'-6" (1.35 m) TEMP. RAMP IS INCLUDED IN COST OF HMA SURFACE REMOVAL BUTT JOINT
- G: SEE ARTICLE 406.08 AND 406.14 OF THE STANDARD SPECIFICATIONS FOR "HMA AND/OR PCC SURFACE REMOVAL, BUTT JOINT".
- * SEE TYPICAL SECTIONS FOR MILLING THICKNESS.

BASIS OF PAYMENT:

THE BUTT JOINT WILL BE PAID FOR AT THE CONTRACT UNIT PRICE PER SQUARE YARD (SQUARE METER) FOR "HOT-MIX ASPHALT SURFACE REMOVAL - BUTT JOINT" OR FOR "PORTLAND CEMENT CONCRETE SURFACE REMOVAL- BUTT JOINT".

ALL DIMENSIONS ARE IN INCHES (MILLIMETERS) UNLESS OTHERWISE SHOWN.

FILE NAME = USER NAME = gaglianobt DESIGNED - M. DE YONG REVISED R. SHAH 10-25-94 TOTAL SHEE SECTION COUNTY BUTT JOINT AND STATE OF ILLINOIS REVISED A. ABBAS 03-21-97 HMA TAPER DETAILS CHECKED **DEPARTMENT OF TRANSPORTATION** PLOT SCALE = 50.0000 '/ IN. REVISED M. GOMEZ 04-06-01 CONTRACT NO. 63697 BD400-05 BD32 SCALE: NONE DATE 06-13-90 REVISED -R. BORO 01-01-07 SHEET NO. 1 OF 1 SHEETS STA. FED. ROAD DIST. NO. 1 ILLINOIS FED. AID PROJECT

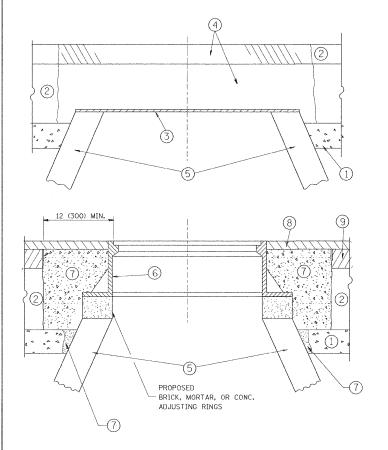

NOTES:

EXISTING BROKEN FRAMES AND LIDS SHALL BE REMOVED AND DISPOSED OF BY THE CONTRACTOR AND SHALL BE REPLACED AS DIRECTED BY THE ENGINEER. REPLACEMENT FRAMES AND LIDS WILL BE PAID FOR IN ACCORDANCE WITH ARTICLE 109.04 OF THE STANDARD SPECIFICATIONS UNLESS A SEPARATE PAY ITEM HAS BEEN PROVIDED.

IF THE EXISTING LIDS ARE OPEN, THE FRAME WILL BE ADJUSTED TO THE ELEVATION OF THE MILLED PAVEMENT SURFACE PRIOR TO THE MILLING OPERATION. THE FRAME WILL NOT BE REMOVED AND COVERED BY THE METAL PLATE.

CITY OF CHICAGO CASTINGS ARE THE PROPERTY OF THE CITY AND THE CONTRACTOR SHALL NOTIFY THE CITY FOR REMOVAL AND DISPOSITION OF THE CASTINGS.

THE METAL PLATE USED TO COVER THE STRUCTURE SHALL REMAIN THE PROPERTY OF THE CONTRACTOR.

WHEN STRUCTURES ARE TO BE ADJUSTED OR RECONSTRUCTED, THE LOWERING AND RAISING OF THE FRAMES AND LIDS WILL NOT BE PAID FOR SEPARATELY BUT WILL BE INCLUDED IN THE COST OF THE CORRESPONDING PAY ITEM.

CONSTRUCTION PROCEDURES

STAGE 1 (BEFORE PAVEMENT MILLING)

- A) REMOVE A MINIMUM OF 12 (300) OF THE PAVEMENT FROM
- AROUND THE STRUCTURE.

 B) REMOVE THE EXISTING FRAME AND LID FROM THE STRUCTURE.
- C) COVER THE STRUCTURE OPENING WITH A 36 (900) DIAMETER METAL PLATE.
- D) BACKFILL WITH CRUSHED STONE AND A MINIMUM 11/2 (40) THICK HMA SURFACE MIX APPROVED BY THE ENGINEER.

STAGE 2 (AFTER PAVEMENT MILLING)

- A) REMOVE THE HMA SURFACE MIX AND CRUSHED STONE.
- B) INSTALL THE FRAME AND LID; ADJUST THE FRAME TO ITS FINAL SURFACE ELEVATION.
- C) THE SURROUNDING SPACE SHALL BE FILLED WITH CLASS PP-1*
 CONCRETE TO THE ELEVATION OF THE SURFACE OF THE EXISTING
 BASE COURSE OR THE BINDER COURSE.
- *UNLESS OTHERWISE SPECIFIED IN THE PLANS.

THE PROCEDURE EXPLAINED ABOVE SHALL CONFORM TO THE APPLICABLE PORTIONS OF SECTIONS 353, 406, 602, AND 603 OF THE STANDARD SPECIFICATIONS EXCEPT THAT "THE CONTRACTOR SHALL ADJUST THE STRUCTURES TO THE FINISHED PAVEMENT ELEVATION NO MORE THAN 5 CALENDAR DAYS PRIOR TO PLACEMENT OF THE FINAL LIFT OF SURFACE UNLESS APPROVED BY THE ENGINEER."

LEGEND

- 1 SUB-BASE GRANULAR MATERIAL
- (6) FRAME AND LID (SEE NOTES)
- 2 EXISTING PAVEMENT
- (7) CLASS PP-1* CONCRETE
- 3 36 (900) DIAMETER METAL PLATE
- (8) PROPOSED HMA SURFACE COURSE
- 4 PROPOSED CRUSHED STONE AND HMA SURFACE MIX
- (5) EXISTING STRUCTURE
- (9) PROPOSED HMA BINDER COURSE

LOCATION OF STRUCTURES:

THE CONTRACTOR WILL BE REQUIRED TO KEEP A RECORD OF THE LOCATIONS OF THE BURIED STRUCTURES ACCORDING TO THE STATION AND DISTANCE LEFT OR RIGHT OF THE CENTERLINE OF PAVEMENT. UPON COMPLETION OF THE WORK, THE CONTRACTOR WILL DELIVER THE RECORD TO THE ENGINEER.

BASIS OF PAYMENT:

REMOVING FRAMES AND LIDS ON DRAINAGE AND UTILITY STRUCTURES IN THE PAVEMENT PRIOR TO MILLING, AND ADJUSTING TO FINAL GRADE PRIOR TO PLACING THE SURFACE COURSE, WILL BE PAID FOR AT THE CONTRACT UNIT PRICE EACH FOR "FRAMES AND LIDS TO BE ADJUSTED (SPECIAL)."

THIS WORK WILL NOT BE PAID FOR WHEN DRAINAGE AND UTILITY STRUCTURES ARE SPECIFIED FOR PAYMENT AS STRUCTURE RECONSTRUCTION.

NEW FRAMES AND LIDS, WHEN SPECIFIED, WILL BE PAID FOR SEPARATELY.

DETAILS FOR FRAMES AND LIDS ADJUSTMENT WITH MILLING

ALL DIMENSIONS ARE IN INCHES (MILLIMETERS) UNLESS OTHERWISE SHOWN


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	PLOT DATE = 12/6/2011	DATE - 10-25-94	REVISED - R. BORO 12-06-11

STATE OF ILLINOIS
DEPARTMENT OF TRANSPORTATION

		D	ETAILS	FOR			
FRAMES	AND	LIDS	ADJUS	TMENT	WITH	MILLING	
 							-

F.A. SECTION COUNTY TOTAL SHEETS NO. 35 33 35 33 BD600-03 (BD-8) CONTRACT NO. 63697


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CURB OR CURB AND GUTTER REMOVAL AND REPLACEMENT

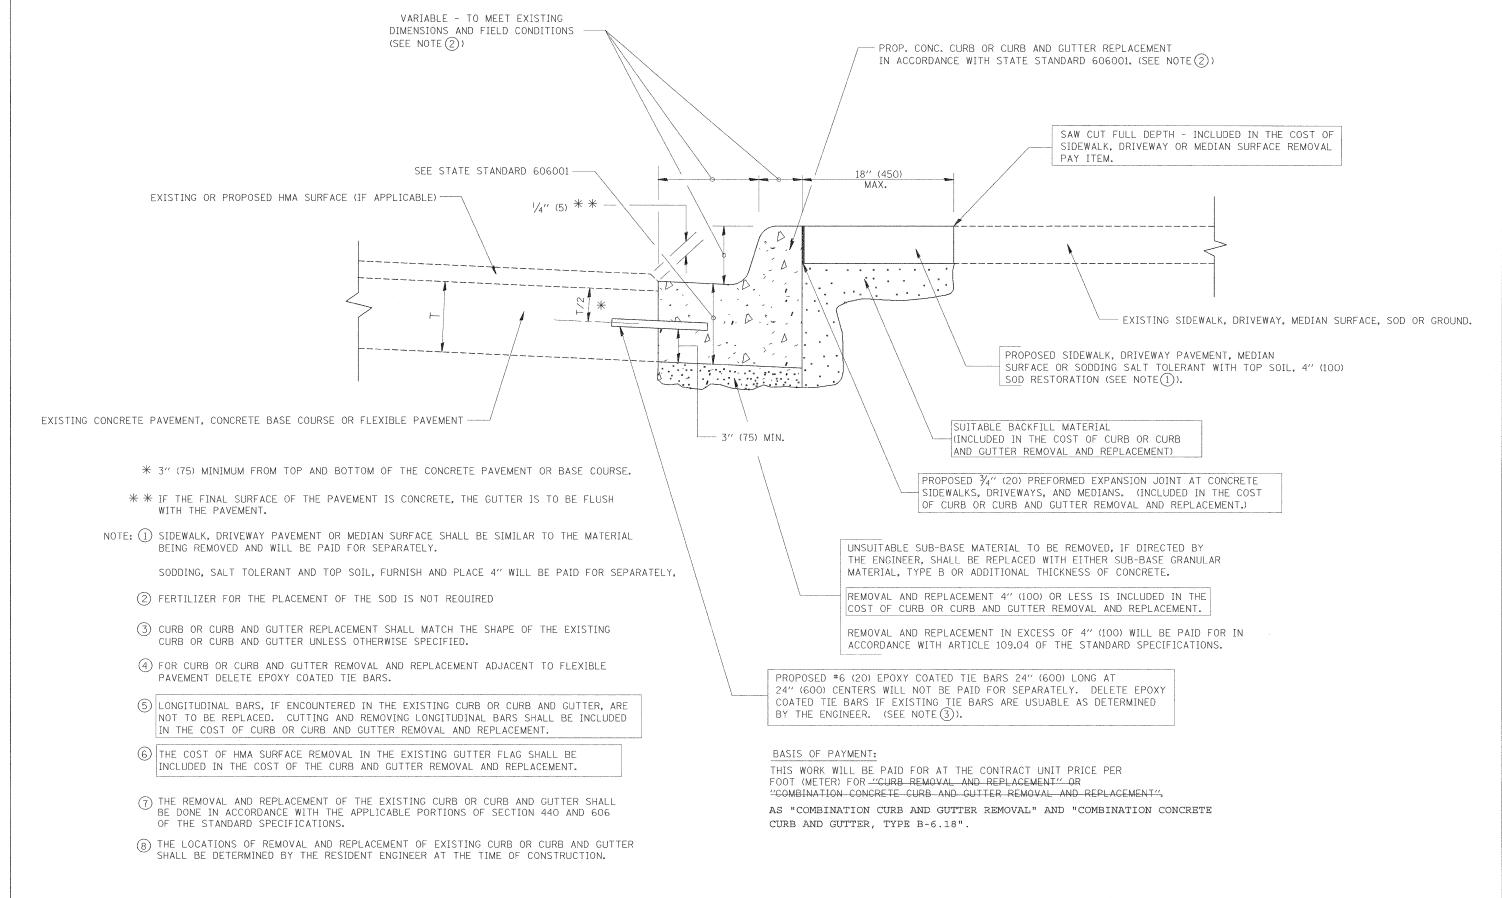
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UNLESS OTHERWISE SHOWN.

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c:\pw_work\pwidot\drivakosgn\d0108315\bd	24.dgn	DRAWN -	REVISED - A. ABBAS 03-21-97	STATE OF ILLINOIS		35 34
	PLOT SCALE = 50.000 '/ IN.	CHECKED ~	REVISED - M. GOMEZ 01-22-01	DEPARTMENT OF TRANSPORTATION	REMOVAL AND REPLACEMENT	BD600-06 (BD-24) CONTRACT NO. 63697
	PLOT DATE = 12/15/2009	DATE - 03-11-94	REVISED - R. BORO 12-15-09		SCALE: NONE SHEET NO. 1 OF 1 SHEETS STA. TO STA.	FED. ROAD DIST. NO. ! ILLINOIS FED. AID PROJECT




TYPICAL CROSSWALK MARKING

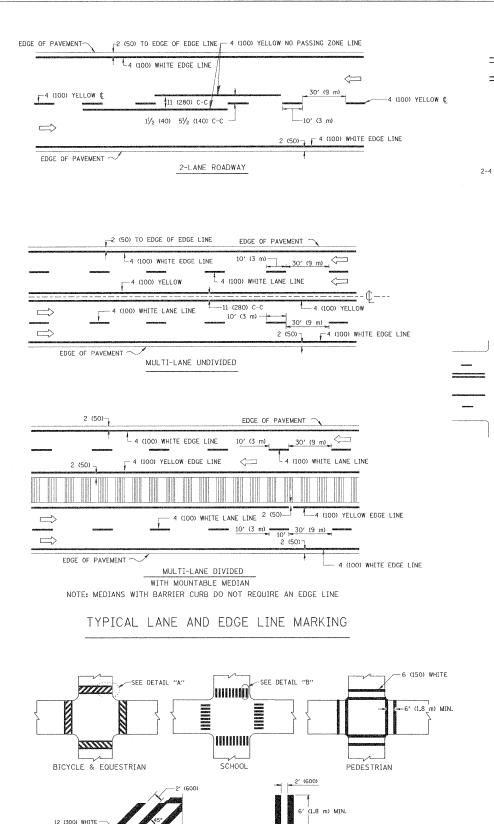DETAIL "A"

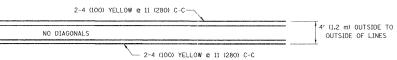


4' (1.2 m) WIDE MEDIANS ONLY

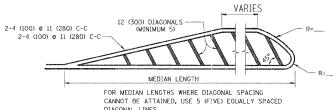


DIAGONAL LINE SPACING: 50' (15 m) C-C (LESS THAN 30MPH (50 km/h))
75' (25 m) C-C 30MPH (50 km/h) TO 45MPH (70 km/h))
150' (45 m) C-C (MORE THAN 45MPH (70 km/h))

MEDIANS OVER 4' (1.2 m) WIDE

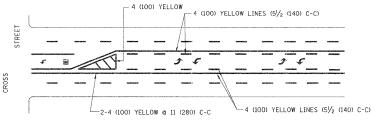


A MINIMUM OF TWO PAIRS OF TURN ARROWS SHALL BE USED, WHITE IN COLOR. ADDITIONAL PAIRS SHALL BE PLACED AT 200' (60 m) TO 300' (90 m) INTERVALS.

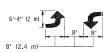

MEDIAN WITH TWO-WAY LEFT TURN LANE

TYPICAL PAINTED MEDIAN MARKING

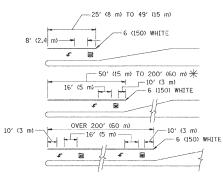



FULL SIZE LETTERS 8' (2.4 m) AND ARROWS SHALL BE USED. \P_1 AREA = 15.6 SQ. FT. (1.5 m²) \P_1 AREA = 20.8 SQ. FT. (1.9 m²)

* TURN LANES IN EXCESS OF 400' (120 m) IN LENGTH MAY HAVE AN ADDITIONAL SET OF ARROW - "ONLY" INSTALLED MIDWAY BETWEEN THE OTHER TWO SETS OF ARROW - "ONLY".

TYPICAL LEFT (OR RIGHT) TURN LANE

TYPICAL TURN LANE MARKING

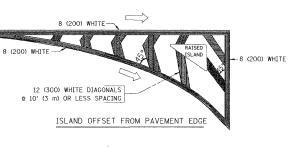

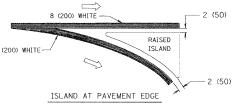

TYPICAL ISLAND MARKING

TYPE OF MARKING	WIDTH OF LINE	PATTERN	COLOR	SPACING / REMARKS
CENTERLINE ON 2 LANE PAVEMENT	4 (100)	SKIP-DASH	YELLOW	10' (3 m) LINE WITH 30' (9 m) SPACE
CENTERLINE ON MULTI-LANE UNDIVIDED PAVEMENT	2 @ 4 (100)	SOLID	YELLOW	11 (280) C-C
NO PASSING ZONE LINES: FOR ONE DIRECTION FOR BOTH DIRECTIONS	4 (100) 2 @ 4 (100)	SOLID SOLID	YELLOW YELLOW	5½ (140) C-C FROM SKIP-DASH CENTERLINE 11 (280) C-C OMIT SKIP-DASH CENTERLINE BETWEEN
LANE LINES	4 (100) 5 (125) ON FREEWAYS	SKIP-DASH SKIP-DASH	WHITE WHITE	10' (3 m) LINE WITH 30' (9 m) SPACE
DOTTED LINES (EXTENSIONS OF CENTER, LANE OR TURN LANE MARKINGS)	SAME AS LINE BEING EXTENDED	SKIP-DASH	SAME AS LINE BEING EXTENDED	2' (600) LINE WITH 6' (1.8 m) SPACE
EDGE LINES	4 (100)	SOLID	YELLOW-LEFT WHITE-RIGHT	OUTLINE MOUNTABLE MEDIANS IN YELLOW; EDGE LINES ARE NOT USED NEXT TO BARRIER CURB
TURN LANE MARKINGS	6 (150) LINE; FULL SIZE LETTERS & SYMBOLS (8' (2,4m))	SOLID	WHITE.	SEE TYPICAL TURN LANE MARKING DETAIL
TWO WAY LEFT TURN MARKING	2 @ 4 (100) EACH DIRECTION	SKIP-DASH AND SOLID	YELLOW	10' (3 m) LINE WITH 30' (9 m) SPACE FOR SKIP-DASH; 5½ (140) C-C BETWEEN SOLID LINE AND SKIP-DASH LINE
	8' (2.4m) LEFT ARROW	IN PAIRS	WHITE	SEE TYPICAL TWO-WAY LEFT TURN MARKING DETAIL
CROSSWALK LINES (PEDESTRIAN) A. DIAGONALS (BIKE & EQUESTRIAN) B. LONGITUDINAL BARS (SCHOOL)	2 @ 6 (150) 12 (300) @ 45° 12 (300) @ 90°	SOLID SOLID SOLID	WHITE WHITE WHITE	NOT LESS THAN 6' (1.8 m) APART 2' (600) APART 2' (600) APART SEE TYPICAL CROSSWALK MARKING DETAILS.
STOP LINES	24 (600)	SOLID	WHITE	PLACE 4' (1.2 m) IN ADVANCE OF AND PARALLEL TO CROSSWALK, IF PRESENT. OTHERWISE, PLACE AT DESIRED STOPPING POINT. PARALLEL TO CROSSROAD CENTERLINE, WHERE POSSIBLE
PAINTED MEDIANS	2 @ 4 (100) WITH 12 (300) DIAGONALS	SOLID	YELLOW: TWO WAY TRAFFIC	11 (280) C-C FOR THE DOUBLE LINE
	0 45° NO DIAGONALS USED FOR 4' (1.2 m) WIDE MEDIANS		WHITE: ONE WAY TRAFFIC	SEE TYPICAL PAINTED MEDIAN MARKING.
CORE MARKING AND CHANNELIZING LINES	8 (200) WITH 12 (300) DIAGONALS @ 45°	SOLID	WHITE	DIACONALS: 15' (4.5 m) C-C (LESS THAN 30MPH (50 km/h)) 20' (6 m) C-C 30MPH (50 km/h) TO 45MPH (70 km/h)) 30' (9 m) C-C (OVER 45MPH (70 km/h))
RAILROAD CROSSING	24 (600) TRANSVERSE LINES; "RR" IS 6' (1.8 m) LETTERS; 16 (400) LINE FOR "X"	SOLID	WHITE	SEE STATE STANDARD 780001 AREA OF: "R"=3.6 SQ. FT. (0.33 m²) EACH "X"=54.0 SQ. FT. (5.0 m²)
SHOULDER DIAGONALS	12 (300) @ 45°	SOLID	WHITE - RIGHT YELLOW - LEFT	50' (15 m) C-C (LESS THAN 30MPH (50 km/h)) 75' (25 m) C-C (30 MPH (50 km/h) TO 45MPH (70 km/h)) 150' (45 m) C-C (0VER 45MPH (70 km/h))

FOR FURTHER DETAILS ON PAVEMENT MARKING REFER TO STANDARD SPECIFICATIONS FOR ROAD AND BRIDGE CONSTRUCTION AND STATE STANDARD 780001.

All dimensions are in inches (millimeters) unless otherwise shown.

FILE NAME =	USER NAME = drivakosgn	DESIGNED	-	EVERS	REVISED	-T.	RAMMACHER	10-27-94
c:\pw_work\pwidot\drivakosgn\dØ108315\tc	l3.dgn	DRAWN	-		REVISED	- C.	JUCIUS	09-09-09
	PLOT SCALE = 50.000 '/ IN.	CHECKED	-		REVISED	-		
	PLOT DATE = 9/9/2009	DATE	-	03-19-90	REVISED	-		

-12 (300) WHITE

DETAIL "B"

STATE	E OF	ILLINOIS
DEPARTMENT	OF	TRANSPORTATION

DISTRICT ONE R						SECTION	COUNTY	TOTAL SHEETS	SHEET NO.
TYPICAL PAVEMENT MARKINGS								35	35
	IIIIML I	JA FINSTINS	MMINIMIA			TC-13	CONTRACT	NO. 6	3697
SCALE: NONE	SHEET NO. 1 OF 1	SHEETS	STA.	TO STA.	FED. R	DAD DIST. NO. 1 ILLINOIS FED. AI	ID PROJECT		