STATE OF ILLINOIS

DEPARTMENT OF TRANSPORTATION

DIVISION OF HIGHWAYS

FOR INDEX OF SHEETS, SEE SHEET NO. 2

PROPOSED HIGHWAY PLANS


F.A.P. 870 / IL ROUTE 53 (LINCOLN AVE.) OVER ST JOSEPH'S CREEK BRIDGE REPLACEMENT
SECTION 534R-B
PROJECT NO. ACBRF-0870(014)

DuPAGE COUNTY C-91-170-11

TRAFFIC DATA:

EXISTING ADT IL ROUTE 53 = 25,500 (2002) PROPOSED ADT IL ROUTE 53: 35,505 (2021) POSTED SPEED = 35 MPH

PROJECT IS LOCATED IN THE VILLAGE OF LISLE

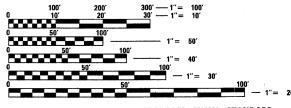


FULL SIZE PLANS HAVE BEEN PREPARED USING STANDARD ENGINEERING SCALES. REDUCED SIZED PLANS WILL NOT CONFORM TO STANDARD SCALES. IN MAKING MEASUREMENTS ON REDUCED PLANS, THE ABOVE SCALES MAY BE USED.

.....

JOINT UTILITY LOCATION INFORMATION FOR EXCAVATION 1-800-892-0123 OR 811

CONTRACT NO. 60M83

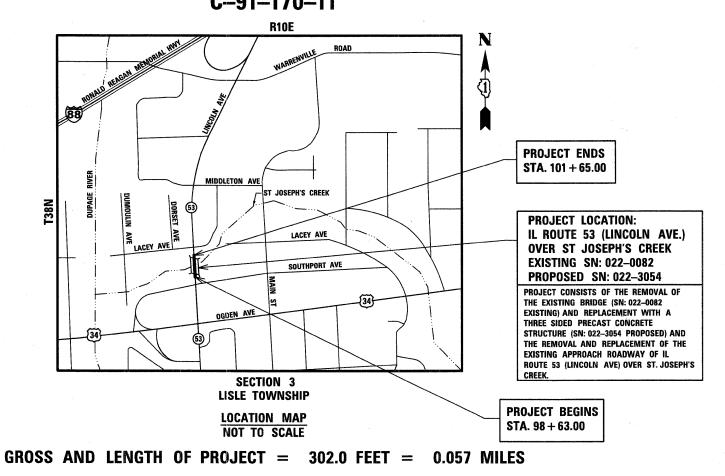

PROJECT MANAGER ISSAM RAYYAN, PE (847) 705-4550 PROJECT ENGINEER ROBERT T. BORO, PE (847) 705-4178

P:312-606-0910 F:312-606-0415

F.A.P. SECTION COUNTY TOTAL SHEET NO.

870 534R-B DUPAGE 751 1

FED ROAD DIST NO. 1 ILLINOIS CONTRACT NO. 60M83

D-91-170-11



STATE OF ILLINOIS
DEPARTMENT OF TRANSPORTATION
DIVISION OF HIGHWAYS

SUBMITTED DETOBER 20 20 11

DEPUTY DIRECTOR OF HIGHWAYS, REGION ENGINEER

MAICH 33 20 12

JOHN BALAMONIUM. E. J.

ACTING ENGINEER OF DESIGN AND ENVIRONMENT

MAICH 33 20 12

William R. Flux or

acting DIRECTOR OF HIGHWAYS, CHIEF ENGINEER

PRINTED BY THE AUTHORITY OF THE STATE OF ILLINOIS



TED W. LACHUS, P.E. EXPIRES 11–30–2011 8-26-2011 DATE

A Rev. 4-12-12

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- 000001-06 STANDARD SYMBOLS, ABBREVIATIONS AND PATTERNS
- 001006 DECIMAL OF AN INCH AND OF A FOOT
- 280001-06 TEMPORARY EROSION CONTROL SYSTEMS
- 420401-08 BRIDGE APPROACH PAVEMENT CONNECTOR
- 424001-06 CURB RAMPS FOR SIDEWALKS
- 515001-03 NAME PLATE FOR BRIDGES
- 602601-02 PRECAST REINFORCED CONCRETE FLAT SLAB TOP
- 604001-03 FRAME AND LIDS TYPE 1
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- 631026-05 TRAFFIC BARRIER TERMINAL, TYPE 5
- 631031-10 TRAFFIC BARRIER TERMINAL, TYPE 6
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- 701321-12 LANE CLOSURE, 2L, 2W, BRIDGE REPAIR WITH BARRIER
- 701606-08 URBAN LANE CLOSURE, MULTILANE, 2W WITH MOUNTABLE MEDIAN
- 701701-08 URBAN LANE CLOSURE, MULTILANE INTERSECTION
- 701901-02 TRAFFIC CONTROL DEVICES
- 704001-07 TEMPORARY CONCRETE BARRIER
- 886001-01 DETECTOR LOOP INSTALLATIONS

GENERAL NOTES:

- THESE PLANS HAVE BEEN PREPARED FROM INFORMATION ACQUIRED FROM EXISTING PLANS AND NOTES RECEIVED FROM IDOT FIELD MAINTENANCE ENGINEERS.
- 2. PLAN DIMENSIONS AND DETAILS RELATIVE TO EXISTING PLANS ARE SUBJECT TO VARIATIONS FOUND IN THE FIELD. THE CONTRACTOR SHALL FIELD VERIFY EXISTING DIMENSIONS AND DETAILS AFFECTING NEW CONSTRUCTION AND MAKE NECESSARY ADJUSTMENTS PRIOR TO CONSTRUCTION OR ORDERING MATERIALS. ANY ADJUSTMENTS PROPOSED BY THE CONTRACTOR MUST BE APPROVED BY THE ENGINEER. SUCH VARIATIONS SHALL NOT BE CAUSE FOR ADDITIONAL COMPENSATION FOR A CHANGE IN THE SCOPE OF THE WORK, HOWEVER, THE CONTRACTOR WILL BE PAID FOR THE QUANTITY ACTUALLY FURNISHED BASED UPON THE UNIT PRICE.
- 3. FORTY- EIGHT HOURS BEFORE STARTING EXCAVATION, THE CONTRACTOR WILL CALL J.U.L.I.E. (1-800-892-0123) OR 811 FOR LOCATIONS OF THE EXISTING UTILITIES.
- 4. THE CONTRACTOR WILL NOT BE ALLOWED TO SET UP A YARD OR FIELD OFFICE ON STATE PROPERTY WITHOUT WRITTEN PERMISSION FROM THE DEPARTMENT.
- 5. SAW CUTTING PRIOR TO ANY REMOVAL ITEMS NOTED ON THE PLANS OR DIRECTED BY THE ENGINEER SHALL BE CONSIDERED INCLUDED IN THE COST OF THE ITEMS BEING REMOVED.
- 6. DO NOT SCALE PLANS FOR CONSTRUCTION DIMENSIONS.
- 7. THE CONTRACTOR SHALL USE CARE IN REMOVING OR EXCAVATING NEAR ALL EXISTING ITEMS WHICH WILL REMAIN. ANY DAMAGE DONE TO EXISTING ITEMS BY THE CONTRACTOR SHALL BE REPAIRED AT THE CONTRACTOR'S EXPENSE.
- 8. WHEN ARTIFICIAL LIGHTING IS UTILIZED IN NIGHT OPERATIONS, THE CONTRACTOR SHALL EXERCISE THE UTMOST PRECAUTION IN PREVENTING ADVERSE VISIBILITY TO THE MOTORING PUBLIC AS WELL AS ADJOINING RESIDENTIAL AREAS.
- 9. THE CONTRACTOR SHALL OBTAIN ALL NECESSARY PERMITS, AS REQUIRED, PRIOR TO COMMENCING WITH CONSTRUCTION.
- 10. THE CONTRACTOR SHALL TAKE ALL NECESSARY MEASURES TO ASSURE THAT NO DEBRIS FALLS INTO ST. JOSEPH'S CREEK. THE COST OF THIS WORK SHALL BE INCLUDED IN THE VARIOUS PAY ITEMS.
- 11. THE CONTRACTOR SHALL CONTACT THE TRAFFIC CONTROL SUPERVISOR AT (847) 705-4470 A MINIMUM OF 72 HOURS PRIOR TO THE PLACEMENT OF ANY TEMPORARY TRAFFIC CONTROL DEVICES.
- 12. THE ENGINEER SHALL CONTACT DON CHIARUG, THE AREA TRAFFIC FIELD ENGINEER, AT (847) 741-9857 A MINIMUM OF TWO (2) WEEKS PRIOR TO THE PLACEMENT OF PERMANENT PAVEMENT MARKINGS.
- 13. ALL DAMAGE TO EXISTING PAVEMENT MARKINGS OUTSIDE THE PROPOSED IMPROVEMENTS SHOWN ON THE PLANS SHALL BE REPLACED AT THE CONTRACTOR'S EXPENSE.
- 14. ACCESS SHALL BE PROVIDED AT ALL TIMES TO PROPERTIES ABUTTING THE PROPOSED IMPROVEMENT.
- 15. BEFORE BEGINNING ANY WORK, THE CONTRACTOR SHALL RETAIN AND RECORD FOR FUTURE REFERENCE, ALL EXISTING PAVEMENT MARKING LINES (AND RAISED REFLECTIVE MARKERS) IN ORDER THAT THESE LOCATIONS CAN BE RE-ESTABLISHED FOR STRIPING. EXACT LOCATIONS OF ALL PAVEMENT MARKINGS SHALL BE AS DIRECTED BY THE ENGINEER.
- 16. TEMPORARY FENCE SHOULD BE ERECTED ALONG THE DRIPLINE OF EXISTING TREES TO REMAIN WITHIN THE LIMITS OF CONSTRUCTION. AFTER TREES ARE SAFELY FENCED NOTHING IS TO BE STORED, DRIVEN, OR DISTURBED INSIDE THE FENCE. REMOVE PROTECTIVE TEMPORARY FENCE ONLY AFTER ALL CONSTRUCTION WORK HAS BEEN COMPLETED.
- 17. THE CONTRACTOR SHALL USE CARE IN GRADING OR EXCAVATING NEAR ANY AND ALL EXISTING ITEMS WHICH WILL NOT BE REMOVED. ANY DAMAGE DONE TO EXISTING ITEMS BY THE CONTRACTOR SHALL BE REPAIRED BY THE CONTRACTOR AT THE CONTRACTOR'S OWN EXPENSE.
- 18. THE CONTRACTOR SHALL TAKE ALL NECESSARY PRECAUTIONS FOR THE PROTECTION OF EXISTING PLANT MATERIAL FOR WHICH THE CONTRACT DOES NOT PROVIDE REMOVAL. THE PROTECTION OF EXISTING PLANT MATERIAL AND THE REPAIR OR REPLACEMENT OF EXISTING PLANT MATERIAL DAMAGED BY THE CONTRACTOR SHALL BE DONE IN ACCORDANCE WITH THE REQUIREMENTS OF SECTION 201 OF THE STANDARD SPECIFICATIONS.
- 19. ANY AREA WHERE THERE IS NO PROPOSED GRADING THE EXISTING GROUND COVER SHALL REMAIN.

GENERAL NOTES (CONT'D):

- 20. THE GENERAL CONTRACTOR IS REQUIRED TO HIRE AN ENVIRONMENTAL FIRM TO CONTINUOUSLY MONITOR FOR WORKER SAFETY AND SOIL CONTAMINATION AT SEVERAL AREAS. SEE SPECIAL PROVISION AND SUPPLEMENTAL SPECIFICATIONS FOR DETAILS.
- 21. THIS PROJECT REQUIRES A US ARMY CORPS OF ENGINEERS 404 PERMIT. THE PERMIT ISSUED TO THE DEPARTMENT DOES NOT COVER THE IN STREAM WORK BY THE CONTRACTOR. THEREFORE AFTER AWARD, THE CONTRACTOR WILL NEED TO SUBMIT THE WORK PLAN TO THE CORPS. THE CORPS WILL NOT BE PROVIDING AN APPROVAL UNLESS STATED OTHERWISE IN THE PERMIT AND IN STREAM WORK CAN COMMENCE AT THE CONTRACTOR'S DISCRETION. GUIDELINES ON ACCEPTABLE IN STREAM WORK TECHNIQUES CAN BE FOUND ON THE CORPS WERSITE.

HTTP://WWW.LRC.USACE.ARMY.MIL/

COMMITMENTS

NONE -

FILE NAME = ...\D160M83-sht-gennotes.dgn

:::Primera

 DESIGNED
 RJD
 REVISED

 DRAWN
 GEW
 REVISED

 CHECKED
 RJD
 REVISED

 DATE
 10/4/2011
 REVISED

STATE OF ILLINOIS
DEPARTMENT OF TRANSPORTATION

IL ROUTE 53 OVER ST JOSEPH'S CREEK INDEX OF SHEETS, STATE STANDARDS, GENERAL NOTES AND COMMITMENTS

| SHEET NO. 1 OF 1 SHEETS | STA. TO

SCALE: N/A

Rev. 4-12-12

SUMMARY OF QUANTITIES

		801.FED. / 201.STATE CONSTRUCTION TYPE CODE			
CODED PAY ITEM NUMBER	PAY ITEM	UNIT	TOTAL QUANTITIES	ROADWAY 0004	BRIDGE REPLACEMENT 0011
20100110	TREE REMOVAL (6 TO 15 UNITS DIAMETER)	UNIT	72	72	
20101000	TEMPORARY FENCE	FOOT	86	86	
20101200	TREE ROOT PRUNING	EACH	5	5	
20101300	TREE PRUNING (1 TO 10 INCH DIAMETER)	EACH	5	5	
20101700	SUPPLEMENTAL WATERING	UNIT	1	1	
20200100	EARTH EXCAVATION	CU YD	512	512	
20201200	REMOVAL AND DISPOSAL OF UNSUITABLE MATERIAL	CU YD	266	266	
20300100	CHANNEL EXCAVATION	CU YD	44	44	
20400800	FURNISHED EXCAVATION	CU YD	62	62	
20700220	POROUS GRANULAR EMBANKMENT	CU YD	7		7
20800150	TRENCH BACKFILL	CU YD	27	27	
21101615	TOPSOIL FURNISH AND PLACE, 4"	SQ YD	2514	2514	
25000210	SEEDING, CLASS 2A	ACRE	0.25	0.25	
25000312	SEEDING, CLASS 4A	ACRE	0.50	0.50	
25000314	SEEDING, CLASS 4B	ACRE	0.25	0.25	
25000400	NITROGEN FERTILIZER NUTRIENT	POUND	12	12	
25000600	POTASSIUM FERTILIZER NUTRIENT	POUND	12	12	
25100115	MULCH, METHOD 2	ACRE	0.75	0.75	
25100630	EROSION CONTROL BLANKET	SQ YD	2514	2514	
28000250	TEMPORARY EROSION CONTROL SEEDING	POUND	52	52	
28000305	TEMPORARY DITCH CHECKS	FOOT	28	28	
28000400	PERIMETER EROSION BARRIER	FOOT	804	804	
28000510	INLET FILTERS	EACH	3	3	
28100107	STONE RIPRAP, CLASS A4	SQ YD	697		697
28200200	FILTER FABRIC	SQ YD	697		697

			URBAN	80'. FEO. 20'. STATE CONSTRUCTION TYPE CODE		
ODED PAY ITEM NUMBER	PAY ITEM	UNIT	TOTAL QUANTITIES	ROADWAY 0004	BRIDGE REPLACEMEN [*] 0011	
31101400	SUBBASE GRANULAR MATERIAL, TYPE B 6"	SQ YD	497	497		
35501317	HOT-MIX ASPHALT BASE COURSE, 8 1/4"	SQ YD	680	680		
10600100	BITUMINOUS MATERIALS (PRIME COAT)	GALLON	469	469		
10600300	AGGREGATE (PRIME COAT)	TON	8	8		
10600635	LEVELING BINDER (MACHINE METHOD), N70	TON	131	131		
10600895	CONSTRUCTING TEST STRIP	EACH	1	1		
40603240	POLYMERIZED HOT-MIX ASPHALT BINDER COURSE, IL-19.0, N90	TON	280	280		
40603595	POLYMERIZED HOT-MIX ASPHALT SURFACE COURSE, MIX "F", N90	TON	227	227		
12400200	PORTLAND CEMENT CONCRETE SIDEWALK 5 INCH	SQ FT	1607	1607		
14000100	PAVEMENT REMOVAL	SQ YD	£ 787	787]/\		
14000157	HOT-MIX ASPHALT SURFACE REMOVAL, 2"	SQ YD	1231	1231		
44000500	COMBINATION CURB AND GUTTER REMOVAL	FOOT	833	833		
44000600	SIDEWALK REMOVAL	SQ FT	1416	1416		
44003100	MEDIAN REMOVAL	SQ FT	2328	2328		
50100100	REMOVAL OF EXISTING STRUCTURES	EACH	1		1	
50104400	CONCRETE HEADWALL REMOVAL	EACH	2	2		
50200100	STRUCTURE EXCAVATION	CU YD	362		362	
50300225	CONCRETE STRUCTURES	CU YD	228.5		228.5	
50300255	CONCRETE SUPERSTRUCTURE	CUYD	10.5		10.5	
50300300	PROTECTIVE COAT	SQ YD	59		59	
50800105	REINFORCEMENT BARS	POUND	17300	w.a	17300	
50800205	REINFORCEMENT BARS, EPOXY COATED	POUND	9550		9550	
50800515	BAR SPLICERS	EACH	84		84	
50900105	ALUMINUM RAILING, TYPE L	FOOT	49		49	
51500100	NAME PLATES	EACH	1		, 1	

^{*} INDICATES SPECIALTY ITEMS

FILE NAME =

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##Primera

 DESIGNED	-	RJD	REVISED	-
DRAWN	~	GEW	REVISED	-
CHECKED	-	RJD	REVISED	-
DATE	**	12/12/2011	REVISED	_

STATE OF ILLINOIS
DEPARTMENT OF TRANSPORTATION

		A Rev. 4.12.12					
IL ROUTE 53 OVER ST JOSEPH'S CREEK	F.A.P. RTE.	SECTION	COUNTY TOTAL SHEE SHEETS NO.				
SUMMARY OF QUANTITIES	870	534R-B	DuPAGE 51 3 CONTRACT NO. 60M83				
LE: N/A SHEET NO. 1 OF 3 SHEETS STA. TO S	TA.	ILLINOIS FE	D. AID PROJECT				

SUMMARY OF QUANTITIES

801. FED. 201. STATE
CONSTRUCTION TYPE CODE

			URBAN	CONSTRUCTION TYPE CODE		
CODED PAY ITEM NUMBER	PAY ITEM	UNIT	TOTAL QUANTITIES	ROADWAY 0004	BRIDGE REPLACEMENT 0011	
87300925	ELECTRIC CABLE IN CONDUIT, TRACER, NO. 14 1C	FOOT	2378	2378		
87301305	ELECTRIC CABLE IN CONDUIT, LEAD-IN, NO. 14 1 PAIR	FOOT	328	328		
	1					
87900200	DRILL EXISTING HANDHOLE	EACH	2	2		
88600100	DETECTOR LOOP, TYPE I	FOOT	163	163		
	\$					
89000100	TEMPORARY TRAFFIC SIGNAL INSTALLATION	EACH	1	1		
		FOOT	0050			
89502300	REMOVE ELECTRIC CABLE FROM CONDUIT	FOOT	2056	2056		
	TREE AFOOLULUS OLARDA (OLUG BUOKEVE) OLGAN IRED BALLED AND BUIDLARDED	EACH	12	12		
A2002016	TREE, AESCULUS GLABRA (OHIO BUCKEYE), 2" CALIPER, BALLED AND BURLAPPED	EACH	12	12		
X0324719	CHECK VALVE 18"	EACH	1	1		
A03247 19	CHECK VALVE TO		,	1		
X2502014	SEEDING, CLASS 4A (MODIFIED)	ACRE	0.50	0.50		
X2302014	OLLDING, OLAGO AA (MODII ILD)	THORKE	0.00	0.00		
X7010216	TRAFFIC CONTROL AND PROTECTION, (SPECIAL)	L SUM	1	1		
X1.010210						
X7030030	WET REFLECTIVE TEMPORARY TAPE TYPE III, 4 INCH	FOOT	7831	7831		
/// ***********************************						
X7030055	WET REFLECTIVE TEMPORARY TAPE TYPE III, 24 INCH	FOOT	52	52		
					Δ	
30300112	AGGREGATE SUBGRADE IMPROVEMENT , /Z"	SQ YD	774	774	4\)	
~~~						
Z0004552	APPROACH SLAB REMOVAL	SQ YD	352	352		
Z0013798	CONSTRUCTION LAYOUT	L SUM	1	1		
Z0028462	GEOTEXTILE RETAINING WALL	SQ FT	115		115	
Z0030250	IMPACT ATTENUATORS, TEMPORARY (NON-REDIRECTIVE), TEST LEVEL 3	EACH	2	2		
Z0030350	IMPACT ATTENUATORS, RELOCATE (NON-REDIRECTIVE), TEST LEVEL 3	EACH	2	2		
		20.57				
Z0030850	TEMPORARY INFORMATION SIGNING	SQ FT	52	52		
70060456	TEMPODA DV DAVEMENT	80 VD	357	357		
Z0062456	TEMPORARY PAVEMENT	SQ YD	331	331		
Z0073002	TEMPORARY SOIL RETENTION SYSTEM	SQ FT	444		444	
20073002	TENTOWANT SOIL RETENTION STOTEN	OWEI	714		177	
Z0073510	TEMPORARY TRAFFIC SIGNAL TIMING	EACH	1	1	Marie 2011 1 1 1 1 1 1 1 1 1 1 1 1 1 1 1 1 1	
20073310	TENNI OTARA HARITO OTOMAE HIMINO	L/ 1011		· ·		
70038137	THREE-SIDED PRECAST CONCRETE STRUCTURES 28'X 10'	FOOT	83.3		83.3	
	PECIALTY ITEMS					

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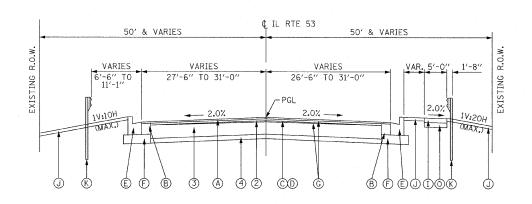
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	DRAWN	-	GEW	REVISED	-	
	CHECKED	-	RJD	REVISED	-	
	DATE	-	12/12/2011	REVISED	-	

STATE OF ILLINOIS
DEPARTMENT OF TRANSPORTATION

					A Rev. 4-12-12			
IL ROUTE 53 OVE	F.A.P. RTE.	SECTION	COUNTY	TOTAL SHEETS	SHEET NO.			
CUBARAADV	0F 0U	ABITITICO		870	534R-B	DuPAGE	51	5
SUMMARY			CONTRACT	NO. 6	58MO			
SCALE: N/A SHEET NO. 3 OF 3	SHEETS	STA.	TO STA.		ILLINOIS FED. A	ID PROJECT		


STA. 98+63 TO STA. 99+84 STA. 100+16 TO STA. 101+65



STA. 98+63 TO STA. 99+55.30 STA. 100+45 TO STA. 101+65


PROPOSED TYPICAL SECTION

HOT-MIX ASPHALT MIXTURE REQUIREMENTS	
MIXTURE TYPE	AIR VOIDS
HMA SURFACE COURSE	
POLYMERIZED HMA SURFACE COURSE, MIX "F", N90 (IL-9.5mm) 2"	4% @ 90 Gyr.
HMA BINDER COURSE	
HMA BASE COURSE (HMA BINDER COURSE, IL-19.0, N90) 8 1/4"	4% @ 90 Gyr.
LEVELING BINDER	
LEVELING BINDER (MACHINE METHOD), N70 (IL-9.5mm) 3/4"- 2 1/4"	4% @ 70 Gyr.
POLYMERIZED HMA BINDER COURSE, IL-19.0, N90 2 1/4"- 5 1/2"	4% @ 90 Gyr.
MEDIAN	
HMA SURFACE COURSE, MIX "D", N50 4" (IL-9.5mm)	4% @ 50 Gyr.
TEMPORARY PAVEMENT	
HMA SURFACE COURSE, MIX "D", N50 (IL-9.5mm) 2"	4% @ 50 Gyr.
HMA BINDER, IL-19mm, N50 8"	4% @ 50 Gyr.
IF THE CONTRACTOR CHOOSES TO USE CONCRETE FOR THE TEMPORARY P, THICKNESS SHALL BE 10".	AVEMENT THE
THE UNIT WEIGHT USED TO CALCULATE ALL HMA SURFACE MIXTURE QUANT 112 LBS/SQ YD/IN.	TITIES IS:
The "AC Type" for Polymerized HMA Mixes SHALL BE "SBS/SBR PG 70 -22" AND	
FOR NON-POLYMERIZED HMA THE "AC TYPE" shall be "PG 64 -22" UNLESS mot ONE Special Provisions.	dified by District

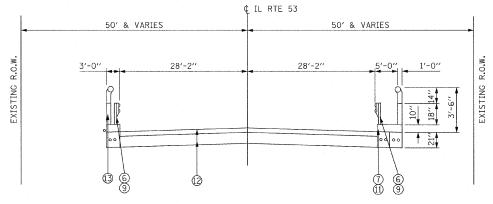

#### EXISTING TYPICAL SECTION

STA. 99+84 TO STA. 100+16

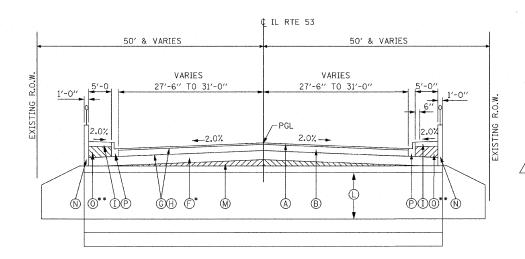

#### PROPOSED TYPICAL SECTION

STA. 99+55.30 TO STA. 100+45

* AGGREGATE SUBGRADE IMPROVEMENT MAY VARY FROM 12" OVER THE PROPOSED THREE-SIDED STRUCTURE.

** ANY VARIANCE IN THICKNESS OF SUBBASE GRANULAR MATERIAL, TYPE B 6" OVER THE PROPOSED THREE-SIDED STRUCTURE WILL BE INCIDENTAL TO SUBBASE GRANULAR MATERIAL, TYPE B 6".

SCALE: NTS

#### LEGEND

#### EXISTING CONDITIONS

- 1 HMA SURFACE COURSE, 1 1/2"
- 2 HMA BINDER COURSE, 3"
- 3) HMA BASE COURSE, 11"
- 4 AGGREGATE BASE
- (5) CURB & GUTTER TYPE B-6. 12
- 6 STEEL PLATE BEAM GUARDRAIL
- 7 P.C.C SIDEWALK
- (8) HMA SURFACE REMOVAL 2"
- GUARDRAIL REMOVAL
- O COMBINATION CURB AND GUTTER REMOVAL
- (1) SIDEWALK REMOVAL
- ② CONCRETE BRIDGE STRUCTURE
- (3) P.C.C PARAPET WALL

#### PROPOSED CONDITIONS

- A POLYMERIZED HMA SURFACE COURSE, MIX "F", N90 2"
- B) HMA BASE COURSE (HMA BINDER COURSE, IL-19.0, N90) 81/4"
- © LEVELING BINDER (MACHINE METHOD), N70 (3/4"-2 1/4")
- (IN TWO LIFTS)

  D POLYMERIZED HMA BINDER COURSE, IL-19.0, N90 (2 1/4"-5 1/2")
- © COMBINATION CURB & GUTTER TYPE B-6.12
- F AGGREGATE SUBGRADE IMPROVEMENT 12"
  - (G) BITUMINOUS MATERIALS (PRIME COAT)
  - (H) AGGREGATE (PRIME COAT)
  - T P.C.C. SIDEWALK 5"
  - ① PARKWAY RESTORATION:
    EROSION CONTROL BLANKET
    SEEDING, CLASS 2A OR CLASS 4A (MODIFIED), (SEE PLANS)
    TOPSOIL FURNISH AND PLACE, 4"
  - K STEEL PLATE BEAM GUARDRAIL, TYPE A, 6 FOOT POST
  - THREE SIDED PRECAST CONCRETE STRUCTURE 28' X 10'
  - M) POROUS GRANULAR EMBANKMENT, SUBGRADE
  - (N) PARAPET AND ALUMINUM RAILING, TYPE L
  - SUBBASE GRANULAR MATERIAL, TYPE B 6"
  - P COMBINATION CURB & GUTTER TYPE B-8.12

FILE NAME = ...\D160M83-sht-typical.dgn

**:::**Primera

FOR "PERCENT OF RAP/RAS" SEE DISTRICT ONE SPECIAL PROVISIONS.

 DESIGNED
 - ADW
 REVISED
 - ⚠ 3/27/2012
 JRB

 DRAWN
 - GEW
 REVISED

 CHECKED
 - RJD
 REVISED


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 - 12/12/2011
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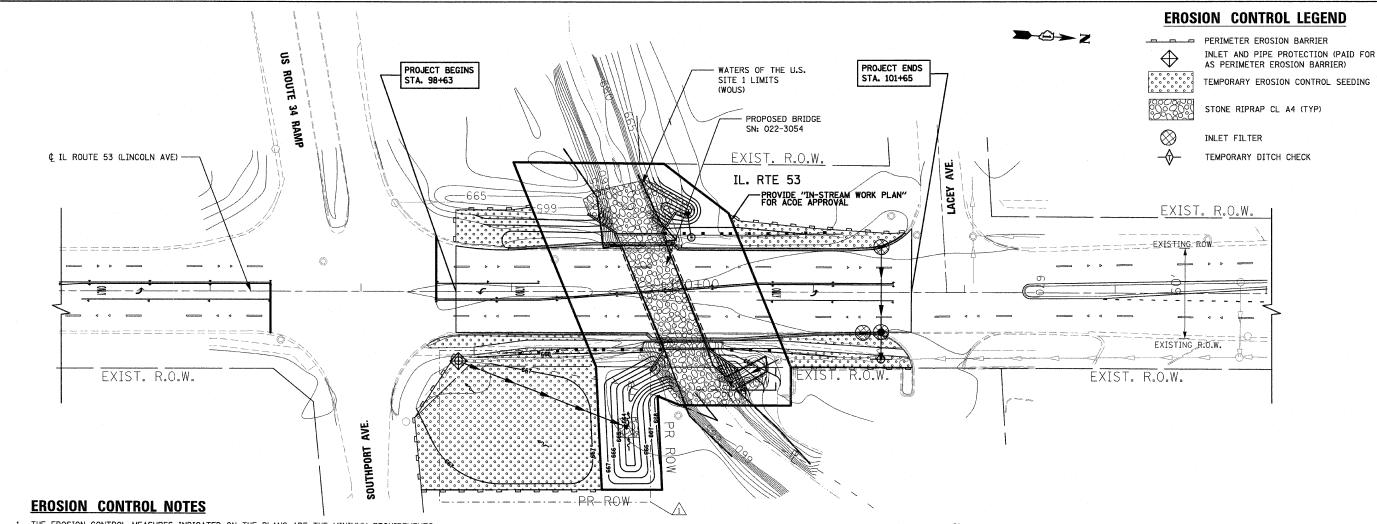
STATE OF ILLINOIS
DEPARTMENT OF TRANSPORTATION

IL ROUTE 53 OVER ST JOSEPH'S CREEK

EXISTING AND PROPOSED TYPICAL SECTIONS

SHEET NO. 1 OF 1 SHEETS STA. TO STA.



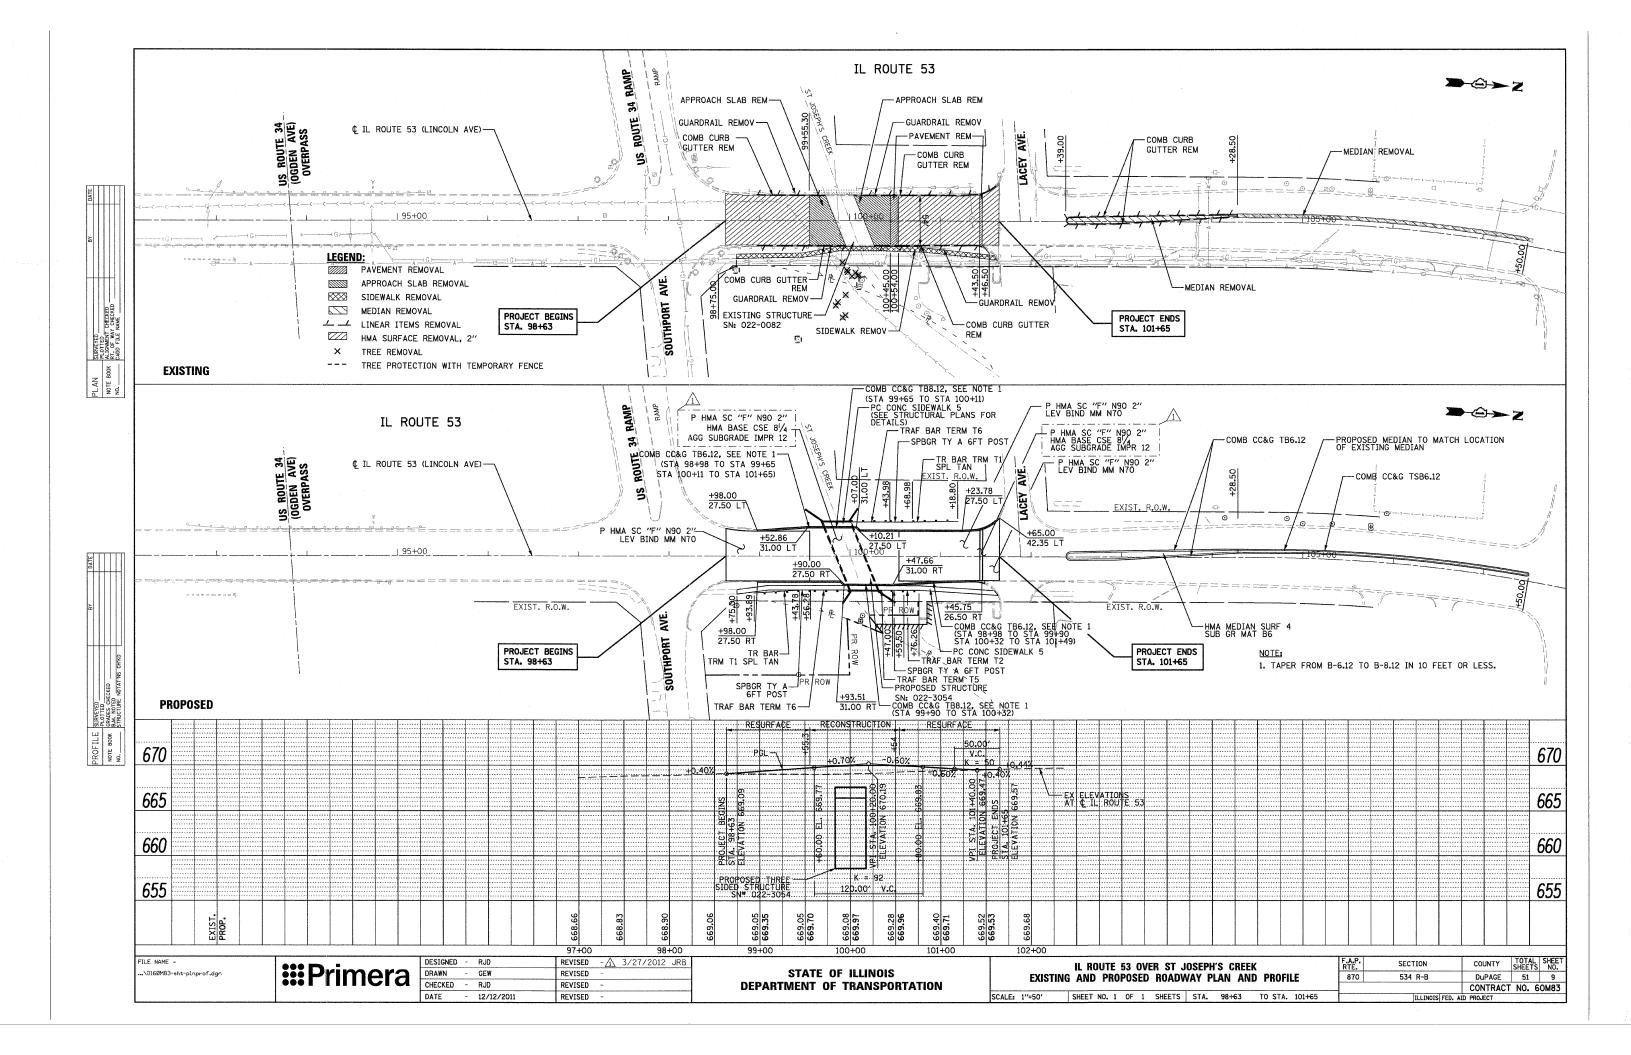

- THE EROSION CONTROL MEASURES INDICATED ON THE PLANS ARE THE MINIMUM REQUIREMENTS. ADDITIONAL MEASURES MAY BE REQUIRED, AS DIRECTED BY THE ENGINEER.
- 2. THE CONTRACTOR SHALL TAKE ALL PRECAUTIONS TO PREVENT POLLUTION OF STORM WATER AND SHALL FOLLOW IEPA & IDOT CONSTRUCTION MEMORANDUM NO. 02-60.
- 3. ALL VEGETATIVE AND STRUCTURAL EROSION CONTROL PRACTICES SHALL BE CONSTRUCTED AND MAINTAINED IN ACCORDANCE WITH THE MINIMUM STANDARDS AND SPECIFICATIONS OF THE "ILLINOIS PROCEDURES AND STANDARDS FOR URBAN SOIL EROSION AND SEDIMENTATION CONTROL" AND THE "STANDARDS AND SPECIFICATIONS FOR SOIL EROSION AND SEDIMENT CONTROL" OF THE ILLINOIS ENVIRONMENTAL PROTECTION AGENCY.
- 4. SOIL DISTURBANCE SHALL BE CONDUCTED IN SUCH A MANNER AS TO MINIMIZE EROSION. SOIL STABILIZATION MEASURES SHALL CONSIDER THE TIME OF YEAR, SITE CONDITIONS AND THE USE OF TEMPORARY OR PERMANENT MEASURES.
- 5. THE MAINTENANCE AND REPAIR OR REPLACEMENT OF EROSION CONTROL ITEMS, WHEN DIRECTED BY THE ENGINEER, WILL NOT BE PAID FOR SEPARATELY, BUT SHALL BE INCLUDED IN THE COST OF THE ASSOCIATED PAY ITEMS.
- 6. ALL STORM SEWER FACILITIES THAT ARE OR WILL BE FUNCTIONING DURING CONSTRUCTION SHALL BE PROTECTED, FILTERED OR OTHERWISE TREATED TO REMOVE SEDIMENT. MUD AND SEDIMENT DEPOSITS SHALL BE REMOVED FROM THE ROADWAY AT THE END OF EACH WORK DAY BY SHOVELING AND/OR SWEEPING.
- 7. INLET FILTERS SHALL BE PLACED ON ALL CATCH BASINS, INLETS, AND MANHOLES WITH OPEN GRATES.
- 8. THE CONTRACTOR SHALL APPLY TEMPORARY EROSION CONTROL SEEDING TO ALL ERODIBLE BARE EARTH AREAS EVERY 7 DAYS AFTER THE EARTH IS EXPOSED. APPLICATION RATE USED: 100 LB/ACRE
- BROADCASTING OF THE SEED BY MACHINE, HAND METHODS, HYDRAULIC SEEDING OR OTHER METHODS APPROVED BY THE ENGINEER WILL BE ALLOWED FOR TEMPORARY EROSION CONTROL SEEDING.
- 10. TOPSOIL AND FERTILIZER NUTRIENTS ARE NOT REQUIRED FOR TEMPORARY EROSION CONTROL SEEDING.

- 11. SEED BED PREPARATION WILL NOT BE REQUIRED FOR TEMPORARY EROSION CONTROL SEEDING IF THE SOIL IS IN A LOOSE CONDITION. LIGHT DISKING SHALL BE DONE IF THE SOIL IS HARD PACKED OR CAKED.
- 12. MULCH WILL NOT BE REQUIRED AFTER TEMPORARY EROSION CONTROL SEEDING HAS BEEN COMPLETED ON AREAS WITH SLOPES FLATTER THAN 1:3 (V:H) THAT ARE TEMPORARY SEEDED BEFORE NOVEMBER 2.
- 13. MULCH, METHOD 2 (PROCEDURE 2) SHALL BE PLACED IN ACCORDANCE WITH THE REQUIREMENT OF THE STANDARD SPECIFICATIONS AFTER TEMPORARY EROSION CONTROL SEEDING HAS BEEN COMPLETED ON AREAS WITH SLOPES STEEPER THAN 1:3 (V:H) THAT ARE TEMPORARY SEEDED BEFORE NOVEMBER 2.
- 14. EROSION CONTROL BLANKET SHALL BE PLACED IN ACCORDANCE WITH THE REQUIREMENTS OF THE STANDARD SPECIFICATIONS AFTER TEMPORARY EROSION CONTROL SEEDING HAS BEEN COMPLETED ON ALL AREAS THAT ARE TEMPORARY SEEDED ON OR AFTER NOVEMBER 2.
- 15. ALL PERIMETER EROSION BARRIER SHALL BE INSTALLED WITHIN THE TEMPORARY EASEMENT, PROPOSED RIGHT-OF-WAY OR EXISTING RIGHT-OF-WAY.
- 16. EROSION CONTROL ITEMS ARE CONSIDERED TO BE HIGH PRIORITY ITEMS ON THIS CONTRACT. THE ENGINEER WILL IMPLEMENT ALL PROVISIONS OF THE SPECIFICATION NECESSARY TO ASSURE THAT EROSION CONTROL ITEMS ARE CONSTRUCTED AND MAINTAINED IN A TIMELY WAY. ALL EROSION CONTROL MEASURES SHALL BE INSTALLED PRIOR TO BEGINNING ANY CONSTRUCTION ACTIVITIES WHICH WILL POTENTIALLY CREATE ERODABLE CONDITIONS.
- 17. THE CONTRACTOR SHALL INSTALL PERIMETER EROSION BARRIER PRIOR TO STRIPPING VEGETATION.
- 18. TEMPORARY DITCH CHECKS AND INLET AND PIPE PROTECTION SHALL BE INSTALLED IMMEDIATELY AFTER DISTURBANCE.
- 19. THE CONTRACTOR SHALL MAINTAIN ALL EROSION CONTROL DEVICES AT ALL TIMES. EROSION CONTROL DEVICES SHALL BE INSPECTED AT LEAST ONCE EVERY SEVEN (7) CALENDAR DAYS AND WITHIN TWENTY-FOUR (24) HOURS OF THE END OF A STORM THAT IS 0.5 INCHES OR GREATER, OR EQUIVALENT SNOWFALL. ADDITIONALLY, DURING WINTER MONTHS, MEASURES SHOULD BE INSPECTED AFTER SIGNIFICANT SNOWMELTS.

SCALE: 1" = 30'

20. THE IDOT EROSION AND SEDIMENT CONTROL FIELD GUIDE FOR CONSTRUCTION INSPECTION AND THE ILLINOIS URBAN MANUAL, PRACTICE STANDARD, DEWATERING CODE 813 SHALL BE FOLLOWED WHEN DEWATERING THE CONSTRUCTION SITE.

- 21. THE CONTRACTOR SHALL ADDRESS ALL EROSION CONTROLS COMMENTS/MAINTENANCE REQUESTS BY THE ENGINEER WITH A 24 HOURS NOTIFICATION TIME FRAME FROM THE TIME OF RECEIPT OF COMMENTS BY THE ENGINEER.
- 22. THE CONTRACTOR WILL PROVIDE AN IN-STREAM WORK PLAN FOR REVIEW BY THE ENGINEER, AND WRITTEN APPROVAL BY THE USACE, PRIOR TO STARTING ANY WORK WITHIN THE IN-STREAM WORK AREA.
- 23. THE USE OF HAY OR STRAW BALES FOR ANY EROSION AND SEDIMENT CONTROL MEASURES IS NOT PERMITTED.
- 24. J-HOOKS PER IDOT STANDARD 280001 SHALL BE INSTALLED DURING THE INSTALLATION OF THE PERIMETER EROSION BARRIER WHERE NEEDED.
- 25. PERMANENT SEEDING AND EROSION CONTROL BLANKET SHALL BE INSTALLED ON ALL DISTURBED AREAS IMMEDIATELY FOLLOWING FINAL GRADING
- 26. STOCKPILES OF SOIL AND OTHER ERODIBLE MATERIALS TO REMAIN IN PLACE MORE THAN THREE (3) DAYS SHALL BE FURNISHED WITH EROSION AND SEDIMENT CONTROL MEASURES (I.E. PERIMETER EROSION BARRIER). STOCKPILES TO REMAIN IN PLACE FOR 7 DAYS OR MORE SHALL RECEIVE TEMPORARY SEEDING.
- 27. IF DEWATERING SERVICES ARE USED, ADJOINING PROPERTIES AND DISCHARGE LOCATIONS SHALL BE PROTECTED FROM EROSION. DISCHARGE SHALL BE ROUTED THROUGH AN EFFECTIVE SEDIMENT CONTROL MEASURE (I.E. SEDIMENT TRAP, SEDIMENT BASIN, OR OTHER APPROPRIATE MEASURE).


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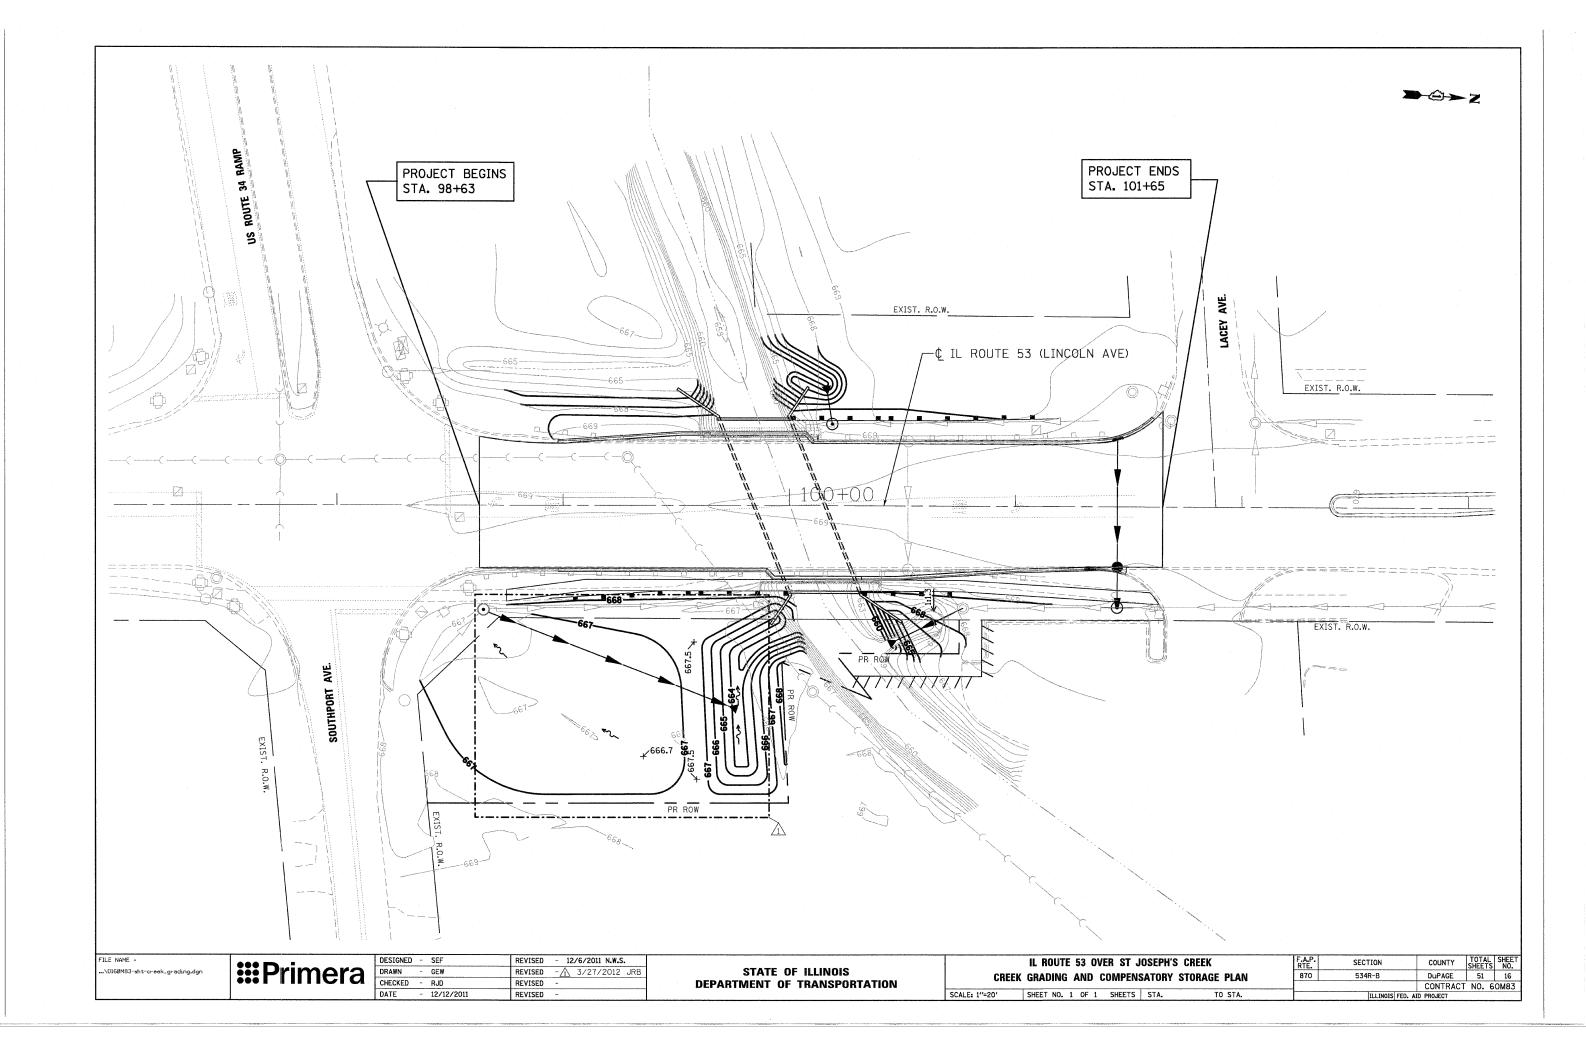
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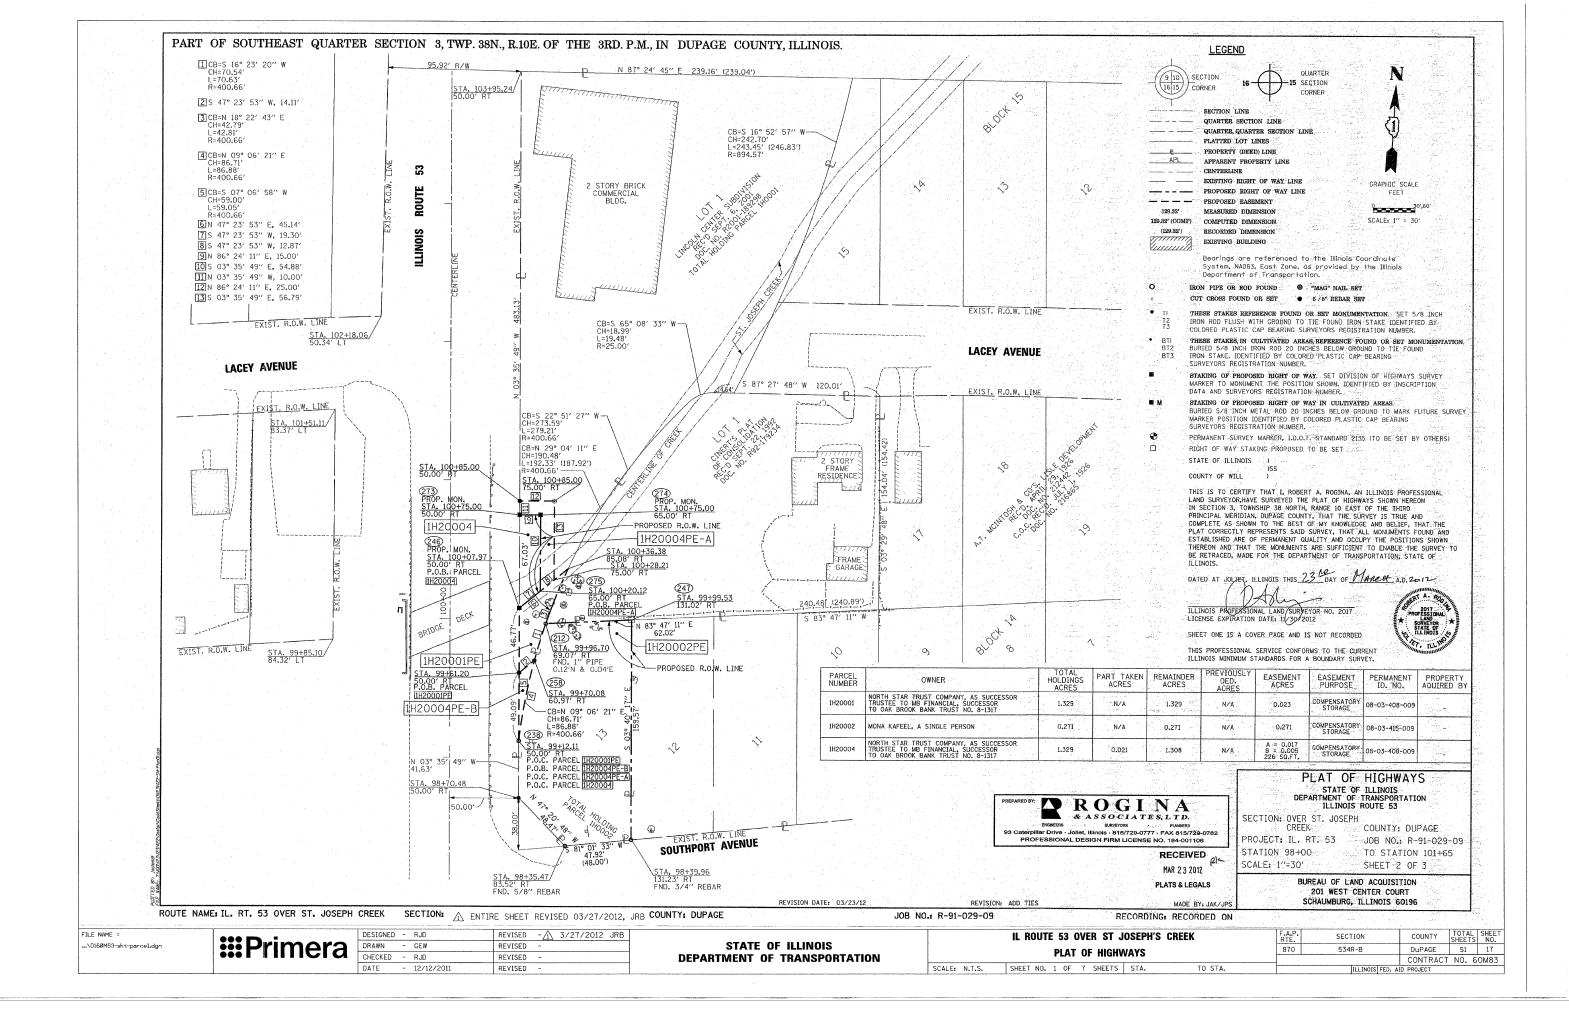
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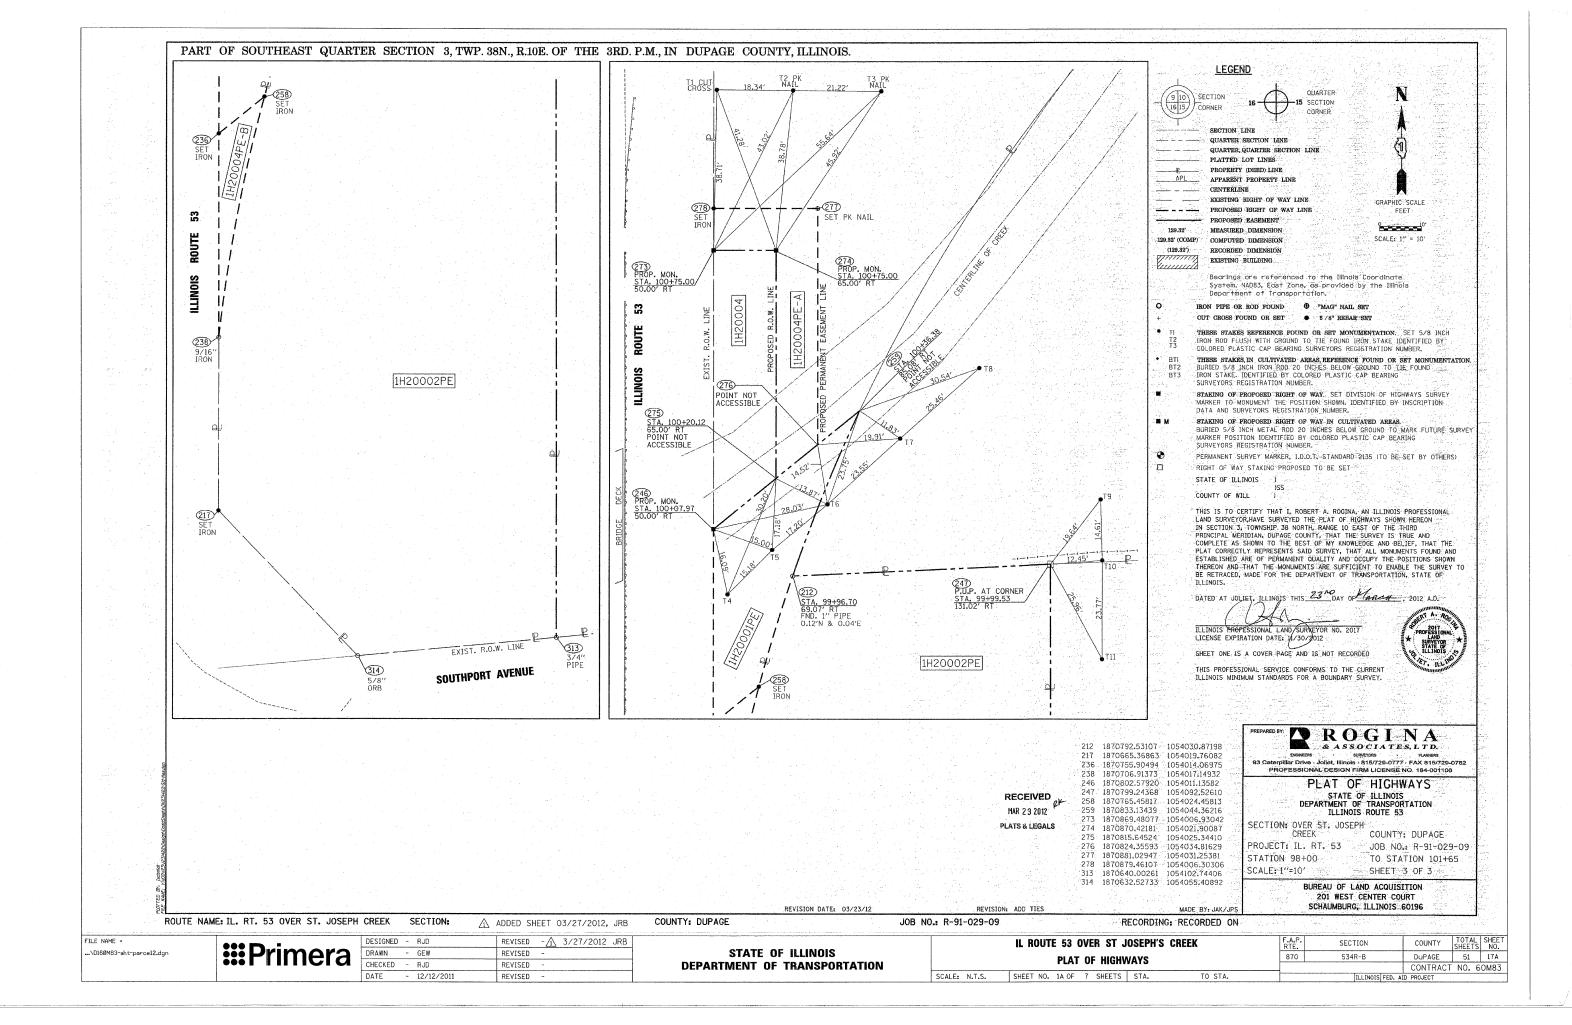
STATE OF ILLINOIS
DEPARTMENT OF TRANSPORTATION


IL ROUTE 53 OVER ST JOSEPH'S C	F.A.P. RTE.	SECTION	COUNTY	TOTAL	SHEE NO.	
EROSION CONTROL PLAN	870	534R-B	DuPAGE	- 51	14	
,			CONTRACT	NO. 6	SOM83	
SHEET NO. 1 OF 1 SHEETS STA.	TO STA.		ILLINOIS FED. A	D PROJECT		








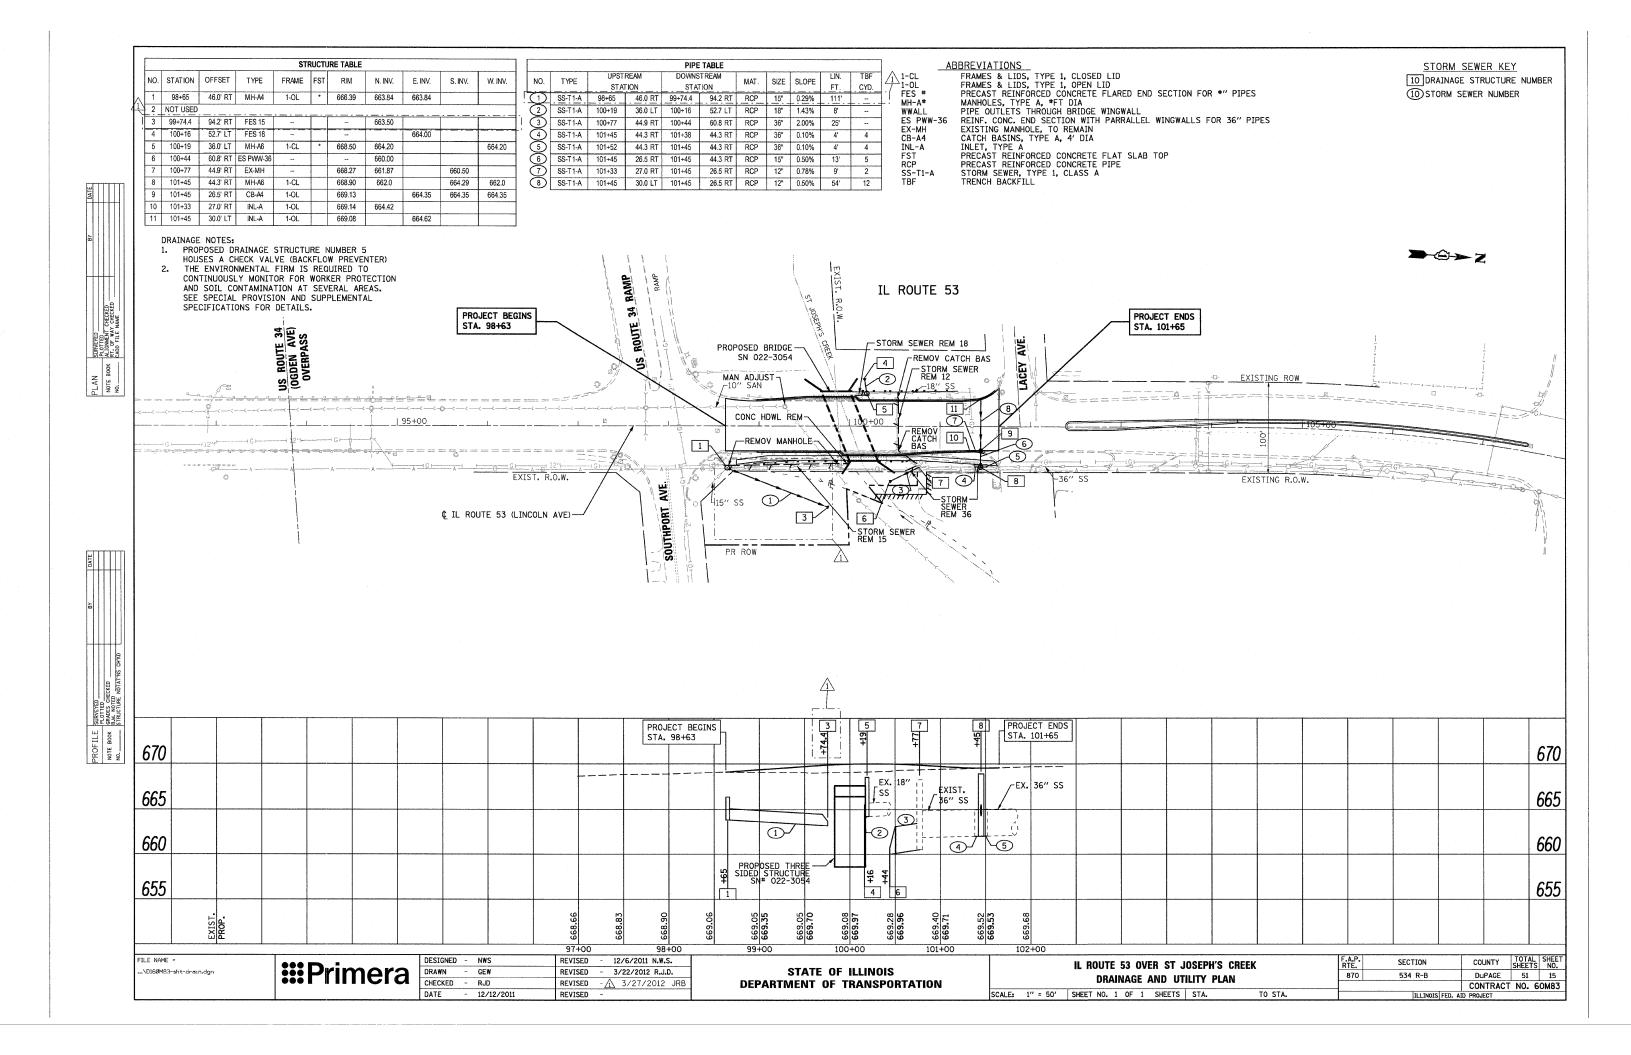

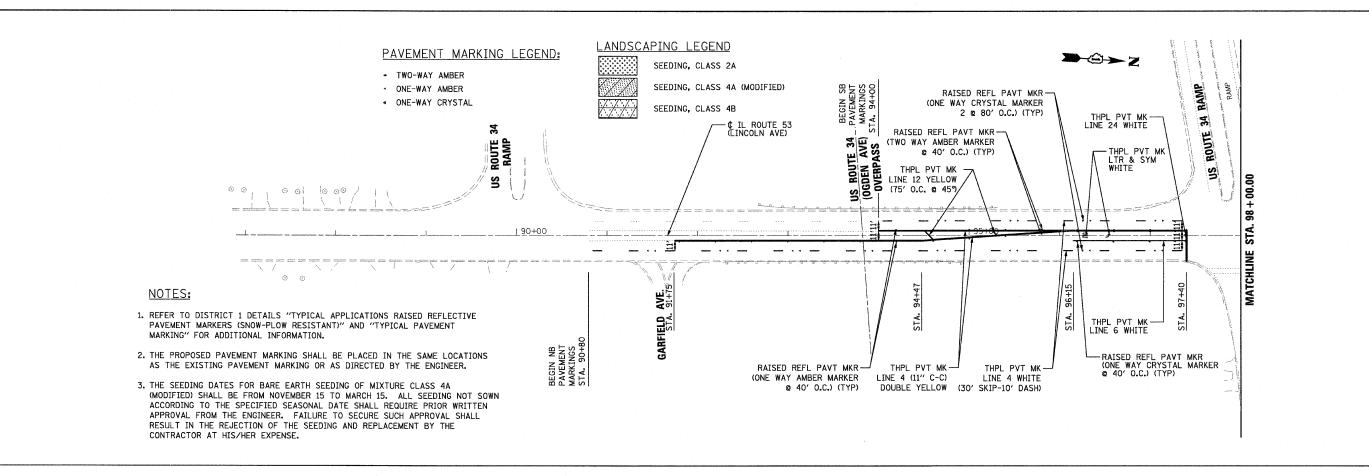

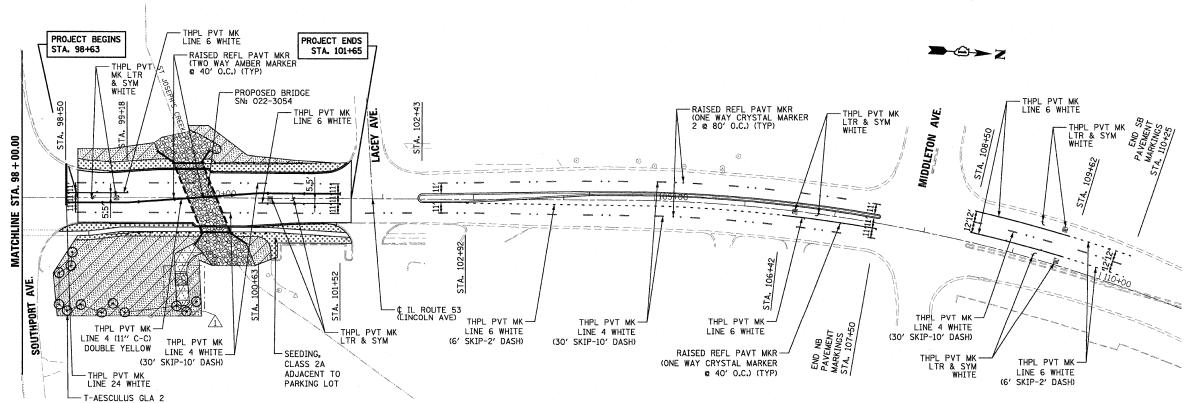

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CHECKED	-	RJD	REVISED	-		
DATE		12/12/2011	REVISED	-		

STATE OF ILLINOIS
DEPARTMENT OF TRANSPORTATION

SCALE: 1" = 50'

	IL ROUTE 53 OVER ST JOSEPH'S CREEK						F.A.P. RTE.	SECTION		
PA	PAVEMENT MARKING AND LANDSCAPING PLAN					870	534R-B			
	SHEET	NO.	1	0F	1	SHEETS	STA. 90+80	TO STA. 110+25	┪	ILLINOIS F

COUNTY TOTAL SHEETS NO.

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CONTRACT NO. 60M83