INDEX OF SHEETS

DAN RYAN EXPRESSWAY:

NB 95TH STREET ENTRANCE RAMP

EB 1-57 TO 1-94 CROSS-CONNECTOR

WB 1-94 TO 1-57 CROSS-CONNECTOR

NB MICHIGAN AVENUE ENTRANCE RAMP

NB I-94 (DAN RYAN)

NR 1-57

SB I-57

NB I-94 (BISHOP FORD)

SB I-94 (DAN RYAN)

SB I-94 (BISHOP FORD)

SB 87TH STREET EXIT RAMP

SB 95TH STREET EXIT RAMP

SB 87TH STREET ENTRANCE RAMP

SB WENTWORTH AVE. EXIT RAMP

FOR INDEX OF SHEETS, SEE SHEET NO. 2

PROJECT LOCATED IN THE CITY OF CHICAGO

ADT (2010)

94,200

58.000

9.000

22,800

24.900

140,500

69.390

12,590

13.350

11,900

4.770

STATE OF ILLINOIS DEPARTMENT OF TRANSPORTATION **DIVISION OF HIGHWAYS**

PROPOSED HIGHWAY PLANS

F.A.I. ROUTE 94 (DAN RYAN EXPRESSWAY) **SECTION 2005-048 L** I-57 INTERCHANGE TO 83RD STREET HIGH MAST LIGHT TOWER SERVICE PADS

COOK COUNTY

DESIGN SPEED POSTED SPEED

60 MPH

60 MPH

45 MPH

45 MPH

50 MPH

50 MPH

60 MPH

60 MPH

60 MPH

45 MPH

45 MPH

45 MPH

45 MPH

55 MPH

55 MPH

40 MPH

50 MPH

55 MPH

55 MPH 55 MPH


40 MPH

40 MPH

40 MPH

PROJECT DESCRIPTION

PROJECT INCLUDES THE CONSTRUCTION OF CONCRETE SERVICE PADS AROUND 31 HIGH MAST LIGHT TOWERS LOCATIONS.

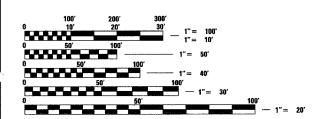

FULL SIZE PLANS HAVE BEEN PREPARED USING STANDARD ENGINEERING SCALES; REDUCED SIZED PLANS WILL NOT CONFORM TO STANDARD SCALES, IN MAKING MEASUREMENTS ON REDUCED PLANS, THE ABOVE SCALES MAY BE USED

CHICAGO UTILITY ALERT NETWORK (312) 744-7000

CTA CONTACT: MARVIN A. WATSON, GENERAL MANAGER, CONSTRUCTION (312) 681-3860

CONTRACT NO. 60A23

F.A.I. 94 (RYAN) PROJECT LIMIT C-91-290-05 STA. 1284+04 (SB I-94) R. 14 E. T. 38 N. T. 37 N. F.A.I. 57 PROJECT LIMIT STA. 121 + 76 (SB I-57) 1-94 (BISHOP FORD FWY)

> **LOCATION MAP** 1/2 MILE 1 MILE GROSS LENGTH OF PROJECT = 11804.64 FT. = 2.236 MI.


SCALE: 1" = 1/2 MILE NET LENGTH OF PROJECT = 11804.64 FT. = 2.236 MI.

F.A.I. 94 (RYAN) PROJECT LIMIT STA, 2211+12 (NB I-94)

F.A.I. 94 (FORD) PROJECT LIMIT STA. 2002 + 83 (NB I-94)

32957 01-08-07

TOTAL SHEE SECTION COUNTY 94 2005-048 L соок 85 1 FED. ROAD DIST. NO. ILLINOIS FED. AID PROJECT D-91-290-05

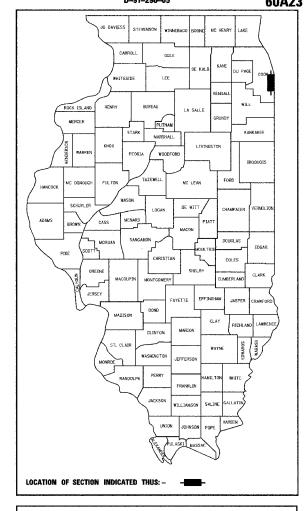

STATE OF ILLINOIS **DEPARTMENT OF TRANSPORTATION** DIVISION OF HIGHWAYS

CONTRACT 40B

TY:LININTERNATIONAL PRINTED BY THE AUTHORITY OF THE STATE OF ILLINOIS

INDEX OF SHEETS

SHEET NO.	TITLE
1	COVER SHEET
2	INDEX OF SHEETS, INDEX OF STATE STANDARDS, GENERAL NOTES, COMMITMENTS, & GRADING AND ACCESS ASSUMPTIONS
3	SUMMARY OF QUANTITIES
4 - 5	SCHEDULE OF QUANTITIES
6	HIGH MAST LIGHT TOWER SERVICE PAD DETAIL WITH & WITHOUT CURB
7	HIGH MAST LIGHT TOWER SERVICE PAD GRADING DETAIL
8 - 34	EROSION CONTROL PLANS
35	EROSION CONTROL DETAILS
36 - 62	LANDSCAPING PLANS
63 - 64	BE-501 DIST 1, HIGH MAST LIGHT TOWER FOUNDATION DETAILS
65	TC-17 TRAFFIC CONTROL DETAILS FOR FREEWAY SHOULDER CLOSURES RAMP CLOSURES
66	TC-18 DIST 1, SIGNING FOR FLAGGING OPERATIONS AT WORK ZONE OPENINGS
67	TC-22 DIST 1, TEMPORARY INFORMATION SIGNING
68 - 70	ALIGNMENT (FOR INFORMATION ONLY)
71 - 74	SURVEY TIES FOR CONTROL POINTS (FOR INFORMATION ONLY)
75	ROADWAY CROSS SECTIONS - SB I-57 (FOR INFORMATION ONLY)
76	ROADWAY CROSS SECTIONS - NB I-57 (FOR INFORMATION ONLY)
77 - 78	ROADWAY CROSS SECTIONS - SB I-94 (FORD) (FOR INFORMATION ONLY)
79 - 80	ROADWAY CROSS SECTIONS - SB I-94 (DR) (FOR INFORMATION ONLY)
81 - 82	ROADWAY CROSS SECTIONS - NB I-94 (FORD) (FOR INFORMATION ONLY)
83	ROADWAY CROSS SECTIONS - NB I-94 (DR) (FOR INFORMATION ONLY)
84	ROADWAY CROSS SECTIONS - EB I-57 TO I-94 CONNECTOR (FOR INFORMATION ONLY)
85	ROADWAY CROSS SECTIONS - WB I-94 TO I-57 CONNECTOR (FOR INFORMATION ONLY)

INDEX OF STATE STANDARDS

STANDARD NO.	TITLE
280001-03	TEMPORARY EROSION CONTROL SYSTEMS
606001- 03	CONCRETE CURB TYPE B AND COMBINATION CONCRETE CURB AND GUTTER
701101- <i>01</i>	OFF-ROAD OPERATIONS, MULTILANE, LESS THAN 15' AWAY, FOR SPEEDS > 45 MPH
702001-06	TRAFFIC CONTROL DEVICES
	,

COMMITMENTS:

NONE

GRADING ASSUMPTIONS:

- ALL FINAL GRADING FOR THE TOWER AND PAD WILL BE COMPLETED BY THE ASSIGNED HMLT FOUNDATION CONTRACTOR (*62583, *62694, OR *62695) PRIOR TO THE CONSTRUCTION OF EACH LIGHT TOWER SERVICE PAD.
- 2. ANY MINOR GRADING ADJUSTMENTS REQUIRED WILL BE PAID FOR AS SHAPING AND GRADING AT HIGH MAST LIGHT TOWER.
- 3. PRIOR TO CONSTRUCTIOIN OF ANY HIGH MAST LIGHT TOWER SERVICE PAD, THE ENGINEER AND CONTRACTOR MUST JOINTLY VERIFY THAT THE GROUND RODS, GROUND WELLS AND GROUND WIRES HAVE BEEN INSTALLED BY OTHER CONTRACTS (*62583, *62894 & *62695).

RTÉ.	SECTION	ı	COUN	TY	SHEETS	NO.
94	2005-048	L	COO	K	85	2
STA.	+	7	O STA.		+	
FED. RO	AD DIST. NO.	ILLIN	OIS FED.	AID	PROJECT	•

60A23

GENERAL NOTES:

- THE CONTRACTOR SHALL NOT SET UP A YARD OR FIELD OFFICE ON IDOT PROPERTY WITHOUT WRITTEN PERMISSION FROM IDOT.
- 2. THE CONTRACTOR SHALL TAKE ALL NECESSARY SAFETY PRECAUTIONS TO PROTECT AND PROVIDE ACCESS TO ABUTTING PROPERTY, UTILITIES, PEDESTRIANS, AND VEHICULAR TRAFFIC.
- 3. NIGHT OPERATIONS: WHEN ARTIFICIAL LIGHTING IS UTILIZED IN NIGHT OPERATIONS, THE CONTRACTOR SHALL EXERCISE THE UTMOST PRECAUTION IN PREVENTING ADVERSE VISIBILITY TO THE MOTORING PUBLIC AS WELL AS THE ADJOINING RESIDENTIAL AREAS.
- 4. ALL ELEVATIONS SHOWN ARE BASED ON THE CHICAGO CITY DATUM OF 0.00, WHICH IS 579.19 FEET ABOVE MEAN TIDE NEW YORK. (NAVD 88)
- 5. ANY DAMAGE DONE TO EXISTING ITEMS BY THE CONTRACTOR SHALL BE REPAIRED BY THE CONTRACTOR AT THE CONTRACTOR'S OWN EXPENSE. THIS SHALL INCLUDE ALL PLANTINGS (SHRUBS, IVY, ETC.) OTHER THAN THE SEEDING PROVIDED FOR IN THIS CONTRACT. DAMAGED PLANTINGS SHALL BE REMOVED AND REPLACED AT THE CONTRACTORS EXPENSE.
- 6. THE CONTRACTOR SHALL HAVE ACCESS TO THE FIELD OFFICE IN CONTRACT #62583.
- . A 'BOXED' NOTE INDICATES AN ITEM OF WORK THAT IS NOT PAID FOR SEPERATELY, BUT IS PAID FOR AS PART OF ANOTHER ITEM LISTED IN THE SUMMARY OF QUANTITIES.

CONTRACTOR ACCESS ASSUMPTIONS:

- FOR HMLT'S 6MAB2 & 60EF2, ACCESS IS ASSUMED TO BE FROM THE EXPRESSWAY.
 THE LIGHTING CONTRACTOR (#625B3) HAS COMPLETED INSTALLATION OF THESE
 TOWERS AS OF NOVEMBER 2005.
- 2. FOR HMLT'S 5PIJ3 & 5PIJ2, ACCESS IS ASSUMED TO BE FROM THE EXPRESSWAY. THE LIGHTING CONTRACTOR (*62583) HAS COMPLETED INSTALLATION OF THESE TOWERS AS OF DECEMBER 2005.
- 3. FOR HMLT'S 6AIJI, 6ACD1, 5MMN5 & 6MMN1, ACCESS IS ASSUMED TO BE FROM THE EXPRESSWAY. THE LIGHTING CONTRACTOR (*62583) HAS COMPLETED INSTALLATION OF THESE TOWERS AS OF MARCH 2006.
- 4. FOR HMLT'S 6AGH2, 5MKL2, 6MKL1, 6MMN2, & 6MMN3, ACCESS IS ASSUMED TO BE FROM THE EXPRESSWAY. THE LIGHTING CONTRACTOR (*62583) HAS COMPLETED INSTALLATION OF THESE TOWERS AS OF MAY 2006.
- 5. FOR HMLT'S 5MCD3, 5MCD2, 6MCD1, & 5AGH5, ACCESS IS ASSUMED TO BE FROM THE EXPRESSWAY. THE LIGHTING CONTRACTOR (*62583) HAS COMPLETED INSTALLATION OF THESE TOWERS AS OF JUNE 2006.
- 6. FOR HMLT 60IJ1, & 60KL2, ACCESS IS ASSUMED TO BE FROM THE EXPRESSWAY. THE LIGHTING CONTRACTOR (*62583) HAS COMPLETED THE INSTALLATION OF THIS TOWER AS OF AUGUST 2006.
- 7. FOR HMLT 60MN4, ACCESS IS ASSUMED TO BE FROM THE EXPRESSWAY. THE LIGHTING CONTRACTOR (*62583) IS SCHEDULED TO COMPLETE THE INSTALLATION IF THIS TOWER BY OCTOBER 2006.
- 8. FOR HMLT'S 50AB2 & 6MAB3, ACCESS IS ASSUMED TO BE FROM THE EXPRESSWAY. THE LIGHTING CONTRACTOR (*62583) IS SCHEDULED TO COMPLETE THE INSTALLATION OF THESE TOWERS BY NOVEMBER 2006.
- 9. FOR HMLT 6AGH4, ACCESS IS ASSUMED TO BE PROVIDED FROM HMLT 5AGH5. THE LIGHTING CONTRACTOR (*62583) HAS COMPLETED INSTALLATION OF THIS TOWER AS OF JUNE 2006.
- 10. FOR HMLT 60KL1, ACCESS IS ASSUMED TO BE PROVIDED FROM HMLT 60IJ1. THE LIGHTING CONTRACTOR (*62583) HAS COMPLETED THE INSTALLATION OF THIS TOWER AS OF AUGUST 2006.
- 11. FOR HMLT 6ACD2, ACCESS IS ASSUMED TO BE FROM AROUND THE BARRIER AT THE NEAREST AVAILABLE LOCATION. THE LICHTING CONTRACTOR (*62583) HAS COMPLETED THE INSTALLATION OF THIS TOWER AS OF NOVEMBER 2005.
- 12. FOR HMLT 6PAB4, ACCESS IS ASSUMED TO BE FROM AROUND THE BARRIER AT THE NEAREST AVAILABLE LOCATION. THE LIGHTING CONTRACTOR (*62583) HAS COMPLETED THE INSTALLATION OF THIS TOWER AS OF DECEMBER 2005.
- 13. FOR HMLT 6AGH1, ACCESS IS ASSUMED TO BE FROM AROUND THE BARRIER AT THE NEAREST AVAILABLE LOCATION. THE LIGHTING CONTRACTOR (*62583) HAS COMPLETED INSTALLATION OF THIS TOWER AS OF MARCH 2006.
- 14. FOR HMLT'S 5MKL3 & 6MMN4, ACCESS IS ASSUMED TO BE FROM AROUND THE BARRIER AT THE NEAREST AVAILABLE LOCATION. THE LIGHTING CONTRACTOR (*62583) HAS COMPLETED INSTALLATION OF THESE TOWERS AS OF MAY 2006.
- 15. FOR HMLT 6MIJ1, ACCESS IS ASSUMED TO BE FROM AROUND THE BARRIER AT THE NEAREST AVAILABLE LOCATION. THE LIGHTING CONTRACTOR (*62583) HAS COMPLETED INSTALLATION OF THIS TOWER AS OF JUNE 2006
- 16. FOR HMLT 60IJ4, ACCESS IS ASSUMED TO BE FROM AROUND THE BARRIER AT THE NEAREST AVAILABLE LOCATION. THE LIGHTING CONTRACTOR (*62583) HAS COMPLETED INSTALLATION OF THIS TOWER AS OF AUGUST 2006.

REVISION		ILLINOIS DEPARTMENT OF TRANSPORTATION F.A.I. 94 (DAN RYAN EXPRESSWAY					
NAME	DATE	_ '\'	TINOTO DEL	AKIMENI	A NI EV	DDE	LALION
		r.A.					
			I-57	to 71s	st ST	REET	•
		IN	IDEX OF	SHEETS.	INDEX	OF S	TATE
		CTANE	ADDC C	ENERAL N	IATES	COLA	ATTMENIT
		& (GRADING	AND ACC	ESS AS	SSUMF	PTIONS
		COALE.	NONE		DD AWAI	DV.	000

DATE: JANUARY 9, 2007

CHECKED BY:

TYLIN INTERNATIONAL

PROJECT: HIGH MAST LIGHT TOWER SERVICE PADS COOK COUNTY / CITY OF CHICAGO


CODE NUMBER	ITEM DESCRIPTION	UNIT	TOTAL	URBAN 100% STATE
				DAN RYAN YOO7
21101615	TOPSOIL FURNISH AND PLACE, 4"	SQ YD	5270	5270
21101825	COMPOST FURNISH AND PLACE 6"	SQ YD	1700	1700
25000210	SEEDING, CLASS 2A	ACRE	6.50	6.50
25000400	NITROGEN FERTILIZER NUTRIENT	POUND	585	585
25000500	PHOSPHORUS FERTILIZER NUTRIENT	POUND	585	585
25000600	POTASSIUM FERTILIZER NUTRIENT	POUND	585	585
25001800	SEEDING, CLASS 4 (MODIFIED)	ACRE	0,50	0,50
25100630	EROSION CONTROL BLANKET	SQ YD	33631	33631
25200200	SUPPLEMENTAL WATERING	UNIT	1762	1762
28000250	TEMPORARY EROSION CONTROL SEEDING	POUND	700	700
28000300	TEMPORARY DITCH CHECKS	EACH	16	16
28000510	INLET FILTERS	EACH	85	85
50300300	PROTECTIVE COAT	SQ YD	594	594
60600605	CONCRETE CURB, TYPE B	FOOT	132	132
67100100	MOBILIZATION	L SUM	1	1
70101800	TRAFFIC CONTROL AND PROTECTION (SPECIAL)	L SUM	1	1
70103815	TRAFFIC CONTROL SURVEILLANCE	CALDA	15	15
X0322256	TEMPORARY INFORMATION SIGNING	SQ FT	154	154
X0323426	SEDIMENT CONTROL, DRAINAGE STRUCTURE, INLET FILTER CLEANING	EACH	170	170
X0323973	SEDIMENT CONTROL, SILT FENCE	F00T	4987	4987
X0323974	SEDIMENT CONTROL, SILT FENCE MAINTENANCE	FOOT	1247	1247
X0324433	LIGHT TOWER SERVICE PAD, 6"	SQ FT	4247	4247
X0324698	APPLY DUST SUPPRESSION AGENTS	UNIT	3	3
X0325132	SHAPING AND GRADING AT HIGH MAST LIGHT TOWER	SQ YD	693	693
X2500322	SEEDING, CLASS 5A (MODIFIED)	ACRE	0.50	0.50
X7011015	TRAFFIC CONTROL AND PROTECTION (EXPRESSWAYS)	L SUM	1	1
V701E000				
X7015000	CHANGEABLE MESSAGE SIGN	CAL MO	3	3

* - SPECIALTY ITEMS

60A23

BELTIATALIA		
REVISIONS		ILLINOIS DEPARTMENT OF TRANSPORTATION
NAME	DATE	F.A.I. 94 (DAN RYAN EXPRESSWAY)
		I-57 to 71st STREET
	_	CHANADY OF CHANTETER
······································		SUMMARY OF QUANTITIES

PROJECT: HIGH MAST LIGHT TOWER SERVICE PADS COOK COUNTY / CITY OF CHICAGO

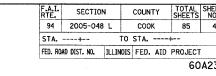



		51, E.994h
t; t; to a a a to a	D. P.S. St. W. 98710.	(1) WB I-94 TO I-57 CONNECTOR (2) EB I-57 TO I-94 CONNECTOR
57. 85. 95. 95. 95. 95. 95. 95. 95. 95. 95. 9	50AB2 6AGH4	
1,57TH	6MAB2 E37th SAGH5 6ACD2 S	5t. N
	GAIJI GACDI GMMN4 FIL. (2)	51. 5.98th 5.98th 5.98th 6.00 5.00 5.00 5.00 5.00 5.00 5.00 5.00
87AN		5mCD3
ST. #J001h	FL GAGHI GAGHZ 5MMN5 GMMN3 GMMN2 GMMN1 GMKLI GMKLI	BISHOP FORD FREEWAY SCALUGET NO. 12 12 12 12 12 12 12 12 12 12 12 12 12

HMLT	LOCA	TION	FOUNDATION INSTALLATION	TOWER INSTALLATION	CURB	DATE COMPLETED	LIGHT TOWER SERVICE PAD, 6"	CONCRETE CURB, TYPE B	PROTECTIVE COAT (SQ YD)
	STATION	OFFSET	CONTRACT	CONTRACT			(SQ FT)	(FT)	·
6AIJ1	122+78.00	LT 75.30'	62583	62583		March 2006	137		20
	ļ								
6ACD1	127+38.00	LT 75.80'	62583	62583		March 2006	137		20
6ACD2	132+00.00	LT 76.00'	62583	62583		November 2005	137		20
6AGH1	230+00.00	RT 74.70'	62583	62583		March 2006	137		20
6AGH2	235+02.00	RT 38.98′	62583	62583		May 2006	137		20
5MMN5	415+50.00	RT 63.60'	62583	62583		March 2006	137		20
5MCD3	2003+83.00	RT 76.00'	62583	62583		June 2006	137		20
5MCD2	2008+53.00	RT 76.00'	62583	62583		June 2006	137		20
5MKL3	1128+20.00	LT 64.00'	62583	62583		May 2006	137		20
5MKL2	1132+90.00	LT 64.00'	62583	62583		May 2006	137		20
6MCD1	2013+46.57	RT 76.00'	62583	62583		June 2006	137		20
6MIJ1	2018+51.77	RT 76.00'	62583	62583		June 2006	. 137		20
6MKL1	1137+59.00	LT 64.00'	62583	62583		May 2006	137		20
6MMN1	1142+55.00	LT 64,00'	62583	62583		March 2006	137		20
6MMN2	1147+05.36	LT 68.94'	62583	62583		May 2006	137		20
6ммиз	424+23.00	RT 59.60'	62583	62583		May 2006	137		20
6MMN4	420+53.00	LT 66.50'	62583	62583		May 2006	137		20
5AGH5	330+51.23	RT 38.98′	62583	62583		June 2006	137		20
6AGH4	1163+25.72	LT 54.61'	62583	62583		June 2006	137	:	20
6MAB2	2036+88.37	RT 80.37′	62583	62583		November 2005	137		20
6MAB3	2040+43.45	LT 38.86'	62583	62583		November 2006	137		20
60EF2	254+56.00	RT 67.68'	62583	62583		November 2005	137		20
50AB2	150+31.48	LT 75.28′	62583	62583		November 2006	137		20

REVISIONS	THE INOTE DEPARTMENT OF TRANSPORTATION					
NAME DATE	F.A.I. 94 (DAN RYAN EXPRESSWAY) I-57 to 71st STREET					
	SCHEDULE OF QUANTITIES					

SCALE: NONE

E; NONE DRAWN BY: CE


JANUARY 9, 2007 CHECKED BY: TO

TYL	IN	INT	ERN	ATIO	JANC
-----	----	-----	-----	------	------

PROJECT: HIGH MAST LIGHT TOWER SERVICE PADS COOK COUNTY / CITY OF CHICAGO

COUNTY 85 5 STA. ---+- TO STA. ---+FED. ROAD DIST. NO. | ILLINOIS | FED. AID PROJECT



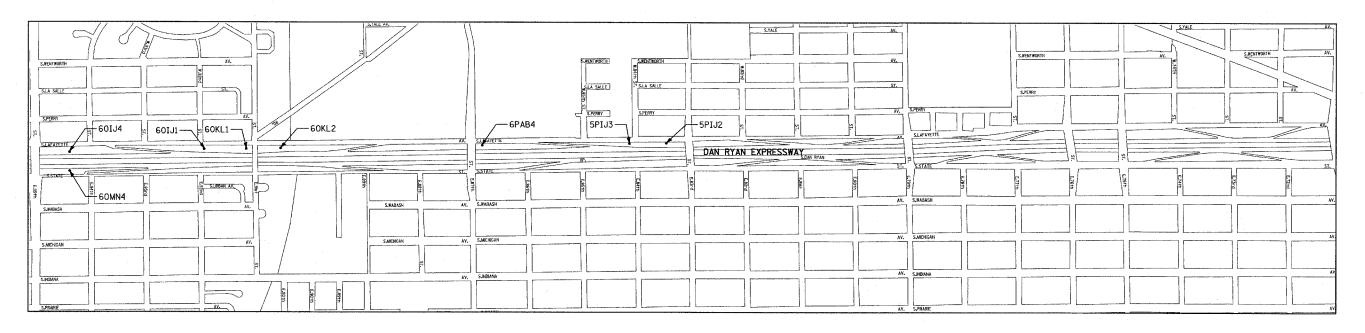


H M LT	LOCA	TION	FOUNDATION INSTALLATION	TOWER INSTALLATION	CURB	DATE COMPLETED	LIGHT TOWER SERVICE PAD, 6"	CONCRETE CURB, TYPE B	PROTECTIVE COAT
	STATION	OFFSET	CONTRACT	CONTRACT			(SQ FT)	(FT)	
60IJ4	1210+23.00	LT 84.00'	62583	62583	X	August 2006	137	22	26
60IJ1	1226+66.25	LT 100.24'	62583	62583	X	August 2006	137	- 22	26
60KL1	1231+80.69	LT 96.37'	62583	62583	X	August 2006	137	22	26
60KL2	1235+99.92	LT 97.71'	62583	62583		August 2006	137		20
6PAB4	1260+65.65	LT 101.04'	62583	62583	Х	December 2005	137	22	26
5PIJ3	1278+64.66	LT 99.85'	62583	62583	Х	December 2005	137	22	26
5PIJ2	1283+15.45	LT 100.12'	62583	62583		December 2005	137		20
60MN4	2210+40.00	RT 84.00'	62583	62583	Х	October 2006	137	22	26


ILLINOIS DEPARTMENT OF TRANSPORTATION
F.A.I. 94 (DAN RYAN EXPRESSWAY)
I-57 to 71st STREET SCHEDULE OF QUANTITIES SHEET 2 OF 2

SCALE: NONE

DRAWN BY: CBS DATE: JANUARY 9, 2007 CHECKED BY: TGB



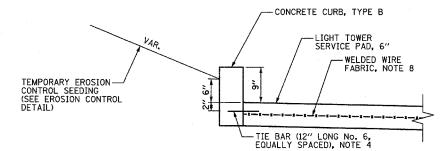

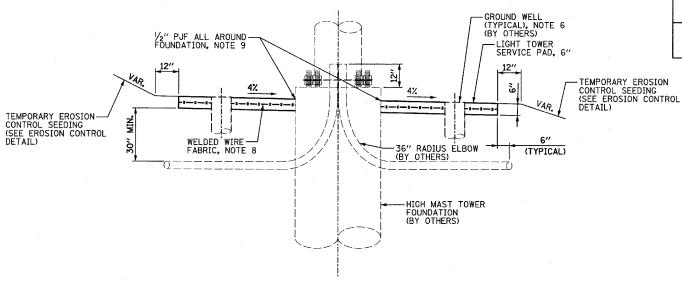

ELEVATION - SHOWN WITHOUT CURB

GROUND MOUNTED HIGH MAST LIGHT TOWER SERVICE PAD DETAIL

1. SEE IDOT STANDARD DRAWING BE501 FOR ADDITIONAL HIGH MAST LIGHT TOWER

RTE. SECTION

2. 4" PVC SLEEVES PROVIDED BY THE FOUNDATION CONTRACTOR SHOULD EXTEND 6 INCHES BEYOND THE PROPOSED SERVICE PAD. IF THE CONTRACTOR DISCOVERS ANY SLEEVE TO BE UNACCEPTABLE IT SHALL BE BROUGHT TO THE ATTENTION OF THE ENGINEER.

COUNTY TOTAL SHEET NO.

- 3. SEE SCHEDULE FOR LOCATIONS WHERE CONCRETE CURB, TYPE B IS REQUIRED.
- 4. TIE BARS WILL NOT BE PAID FOR SEPARATELY BUT WILL BE INCLUDED IN THE COST OF CONCRETE CURB, TYPE B.
- 5. SEE IDOT STANDARD 606001 FOR DIMENSIONS OF CONCRETE CURB, TYPE B.
- 6. GROUND WELLS 5'-0" AS MEASURED FROM THE CENTER LINE OF THE HIGH MAST TOWER TO THE CENTER LINE OF THE WELL TO BE INSTALLED BY OTHERS. THE CONTRACTOR IS RESPONSIBLE FOR MINOR VERTICAL ADJUSTMENTS OF THE GROUND WELLS (6" OR LESS) TO MEET THE FINAL ELEVATION OF THE SERVICE PAD. IF THE GROUND WELLS NEED TO BE ADJUSTED MORE THAN 6" THE CONTRACTOR SHALL NOTIFY THE ENGINEER.
- 7. WELDED WIRE FABRIC WILL NOT BE PAID FOR SEPARATELY BUT WILL BE INCLUDED IN THE COST OF LIGHT TOWER SERVICE PAD, 6". FABRIC SHALL BE 6 X 6, W4.5 X W4.5 AND PLACED AT MID-DEPTH OF THE PAD.
- 8. PREFORMED JOINT FILLER WILL NOT BE PAID FOR SEPARATELY BUT WILL BE INCLUDED IN THE COST OF LIGHT TOWER SERVICE PAD, 6".

DATE

ILLINOIS DEPARTMENT OF TRANSPORTATION F.A.I. 94 (DAN RYAN EXPRESSWAY) I-57 to 71st STREET

HIGH MAST LIGHT TOWER SERVICE PAD DETAIL WITH & WITHOUT CURB

SCALE: N.T.S.

DRAWN BY:

DATE: JANUARY 9, 2007 CHECKED BY:

TY:LIN INTERNATIONAL

TO ADJACENT

TIE BAR, 12" LONG No. 6-EQUALLY SPACED, IF APPLICABLE, NOTE 4

-CONCRETE CURB, TYPE B, IF APPLICABLE, NOTE 3

GROUND WELL (TYPICAL), NOTE 6 (BY OTHERS)

-4" PVC SLEEVE (TYPICAL), NOTE 2 (BY OTHERS)

TO ADJACENT

-11/4" UNIT DUCT (TYPICAL) (BY OTHERS)

-LIGHT POLE (BY OTHERS)

-44" CONCRETE FOUNDATION (BY OTHERS)

-30" DIA. BOLT CIRCLE (BY OTHERS)

5'-0" RADIUS


-LIGHT TOWER

PLAN

SERVICE PAD, 6"


PARTIAL ELEVATION - SHOWN WITH CURB NOTE 3


60A23

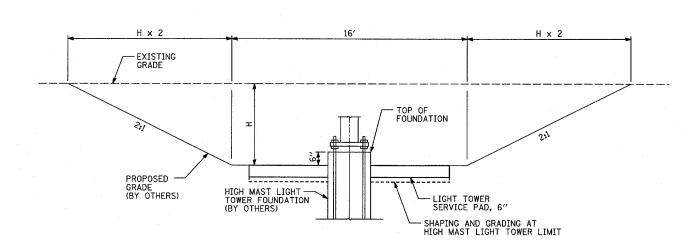


CUT GRADING DETAIL

SECTION A-A

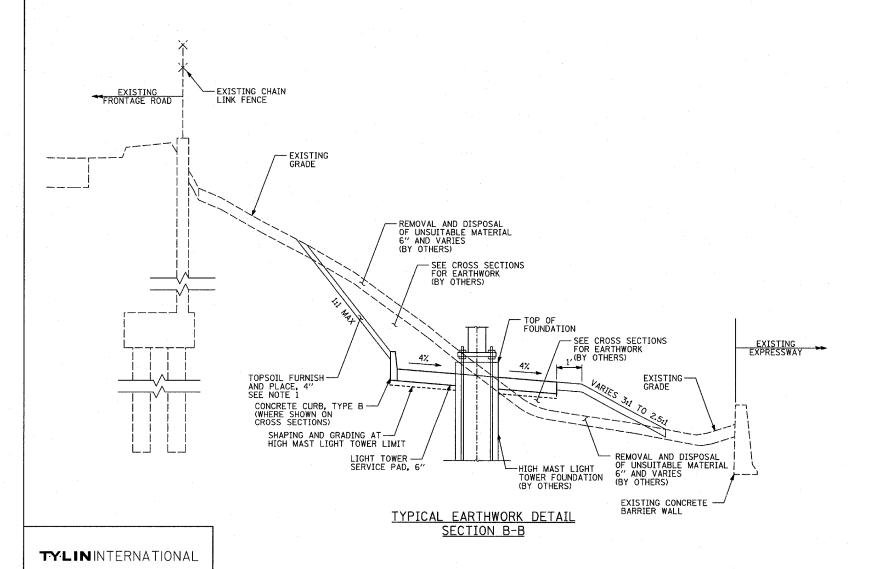

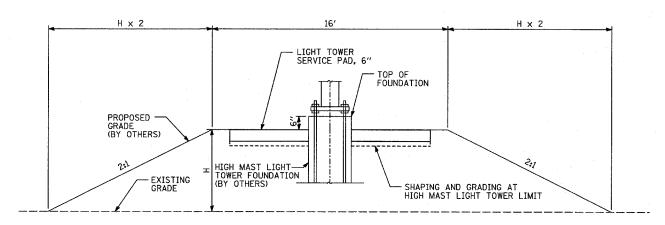

FILL GRADING DETAIL SECTION A-A

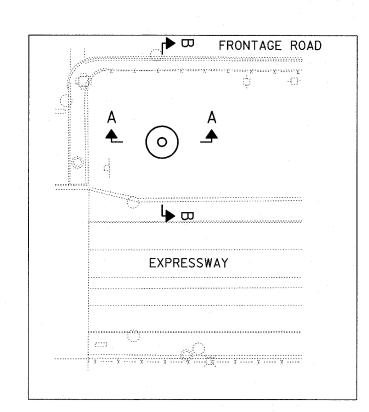



NOTES:


- 1. TOPSOIL PLACEMENT IS NOT SHOWN ON THE PLANS, HOWEVER, A QUANTITY OF 4" TOPSOIL HAS BEEN PROVIDED AT EACH HMLT SERVICE PAD LOCATION TO ALLOW RESTORATION OF THE SITE TO PREVIOUS CONDITIONS AS LEFT BY CONTRACTS 62583, 62593 & 62304. THE QUANTITY IS BASED ON A 15' WIDE BAND MEASURED FROM THE OUTER LIMITS OF THE PAD. TOPSOIL PLACEMENT SHALL ONLY BE COMPLETED WHEN APPROVED BY THE ENGINEER.
- 2. COMPOST PLACEMENT IS NOT SHOWN ON THE PLANS, HOWEVER, A QUANTITY OF 6" COMPOST HAS BEEN PROVIDED AT HMLT 6MMN4, 60IJ4, 60IJ1, 60KL1, 60KL2, 6PAB4, 5PIJ3, 5PIJ2, 60EF2, & 60MMN TO ALLOW RESTORATION OF SITE TO PREVIOUS CONDITIONS AS LEFT BY CONTRACTS 62583, 62593 & 62304. THE QUANTITY WAS CALCULATED USING THE SAME METHOD AS IN NOTE 1. COMPOST PLACEMENT SHALL ONLY BE COMPLETED WHEN APPROVED BY THE ENGINEER.

TYPICAL PLAN

REVISIONS NAME DATE	ILLINOIS DEPARTMENT OF TRANSPORTATION F.A.I. 94 (DAN RYAN EXPRESSWAY I-57 to 71st STREET					
	HIGH MAST LIGHT PAD GRADIN					
	SCALE: 1"=20"	DRAWN BY: RTM				
	DATE: JANUARY 9, 2007	CHECKED BY: TGB				

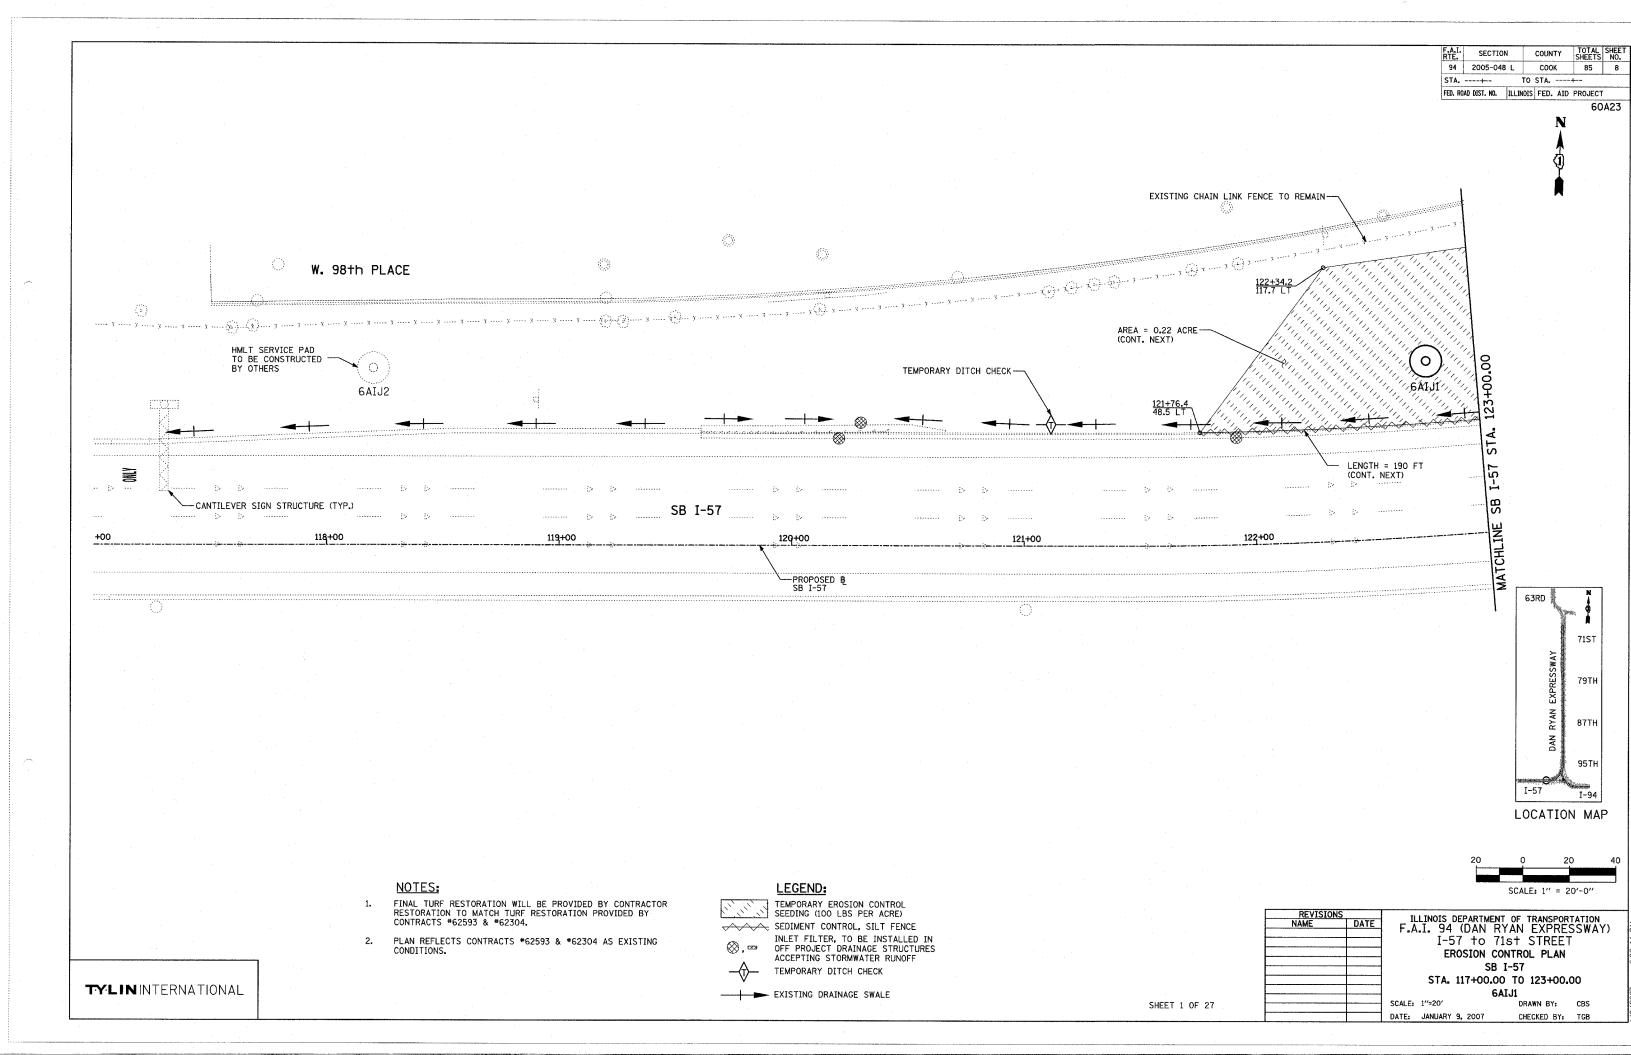

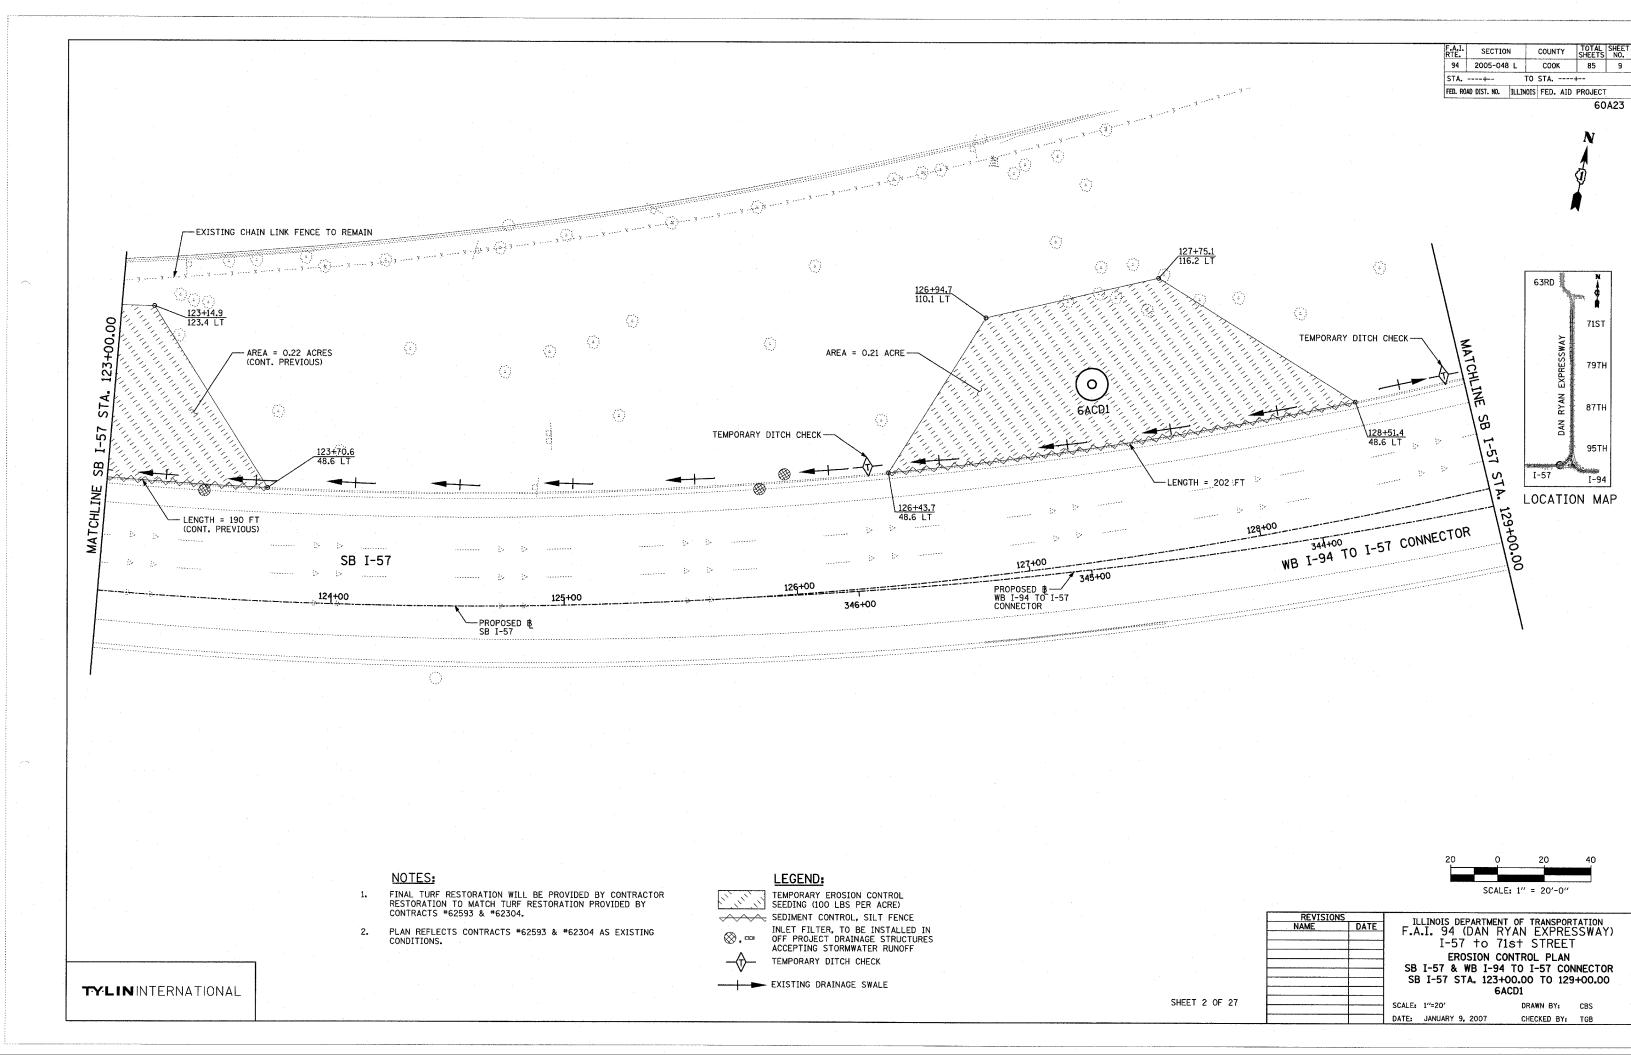


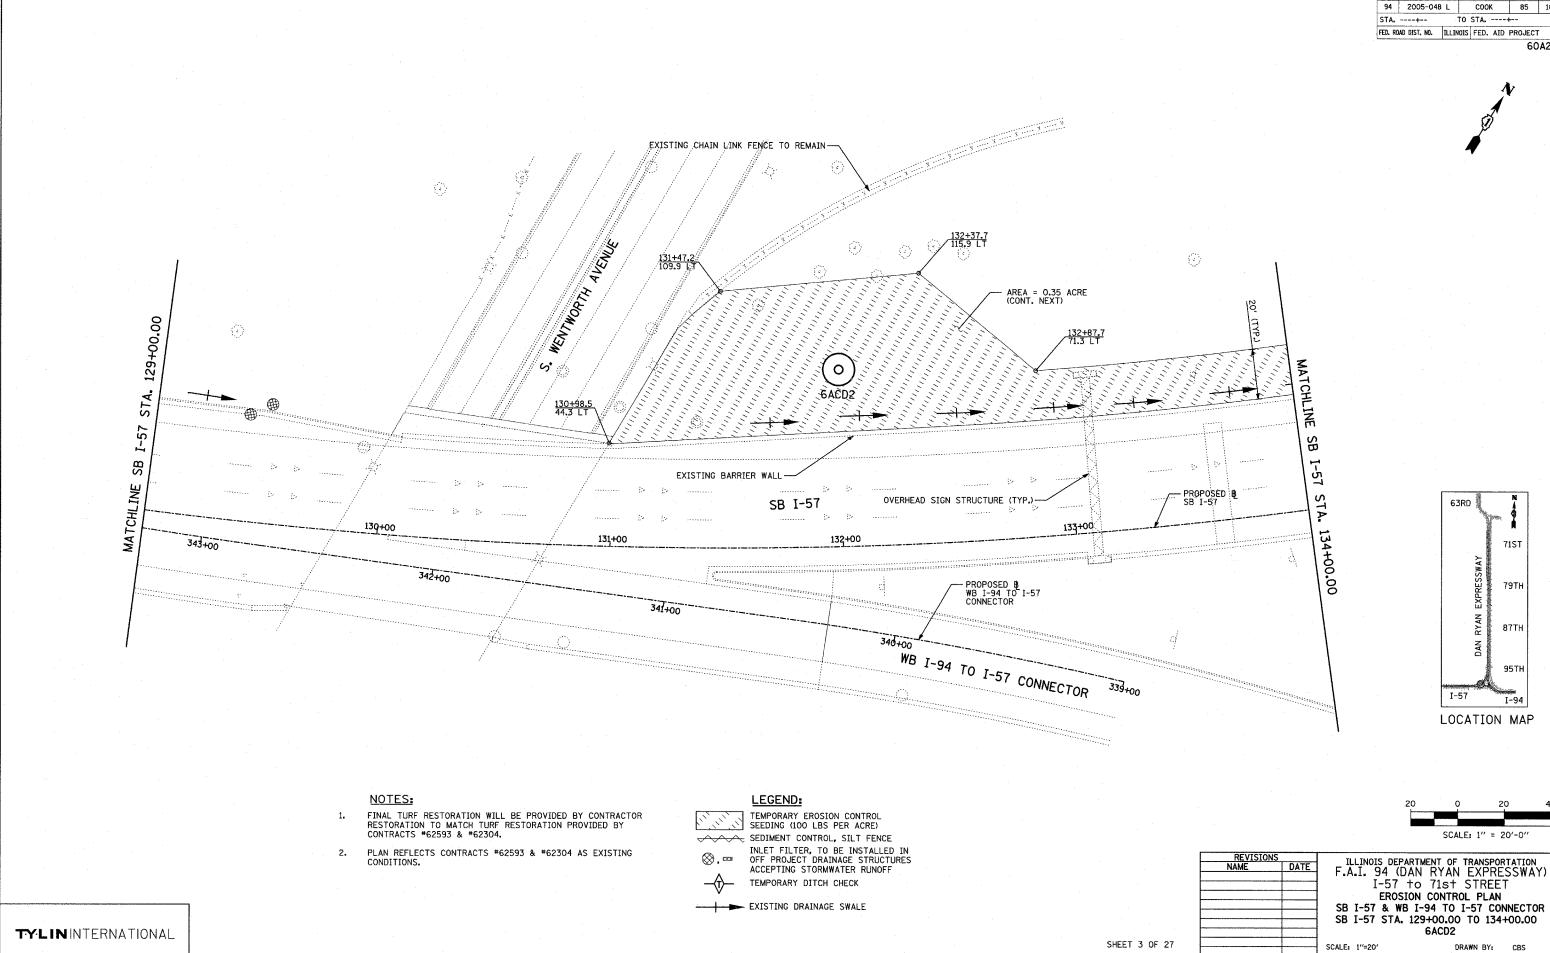


F.A.I. SECTION COUNTY TOTAL SHEET NO. COOK 85 10

DATE: JANUARY 9, 2007

CHECKED BY: TGB

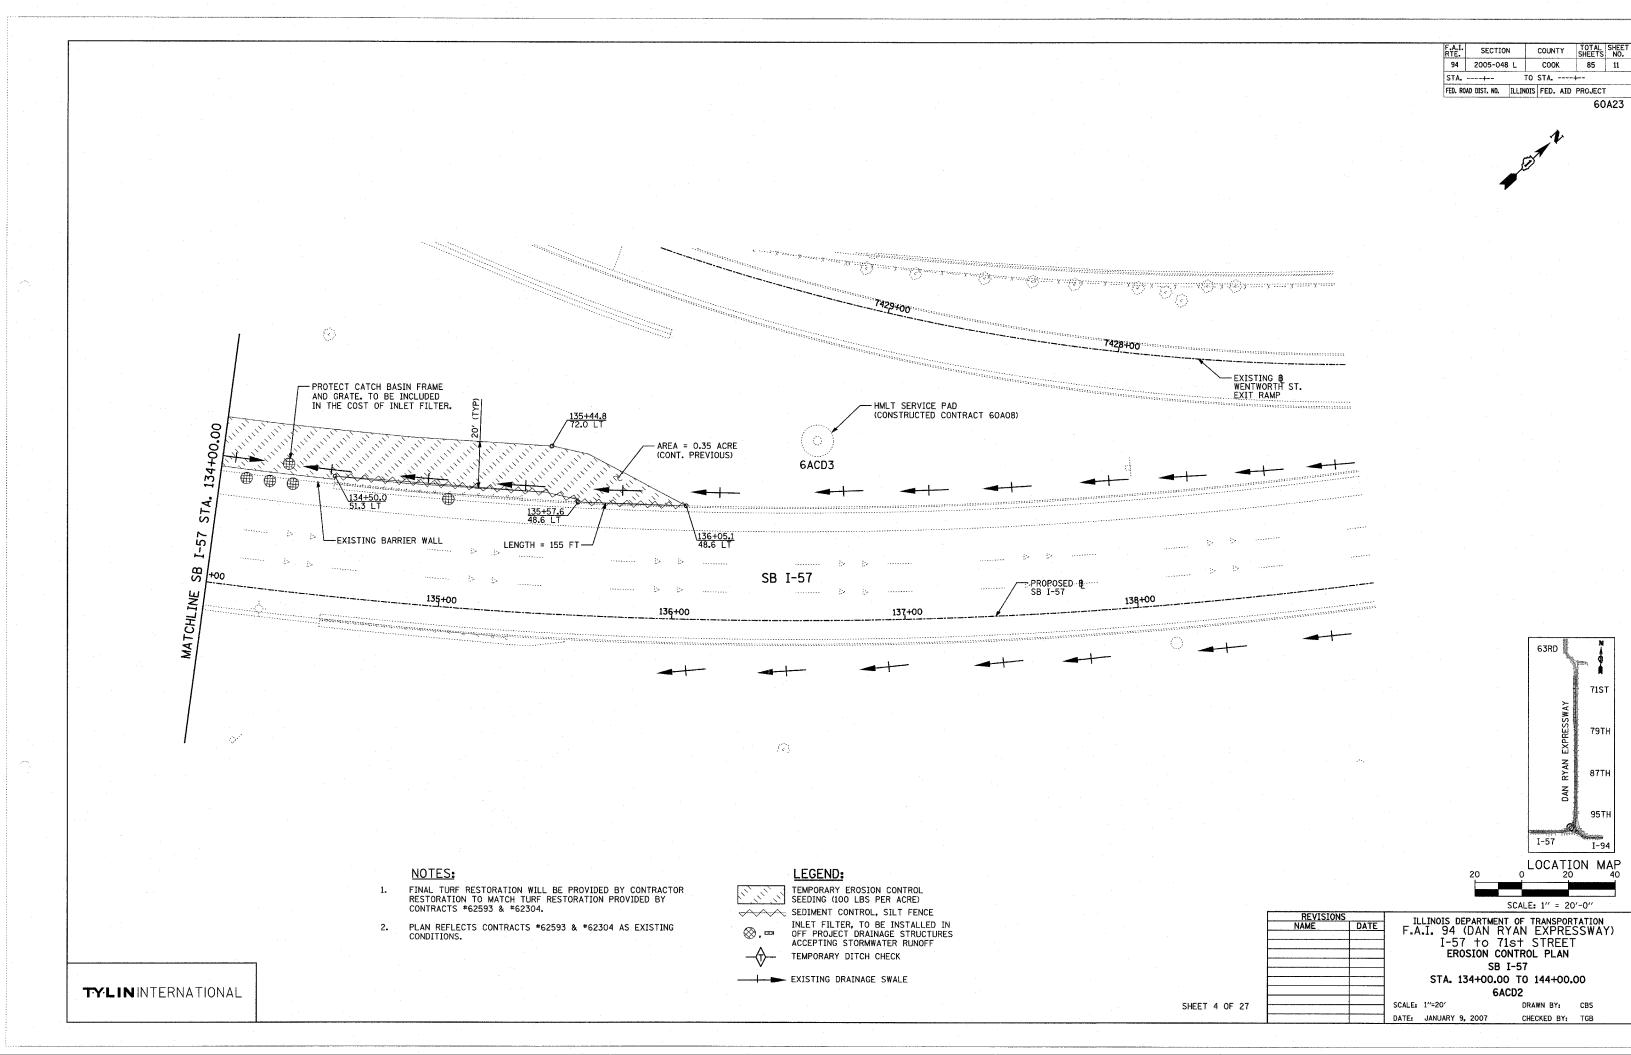

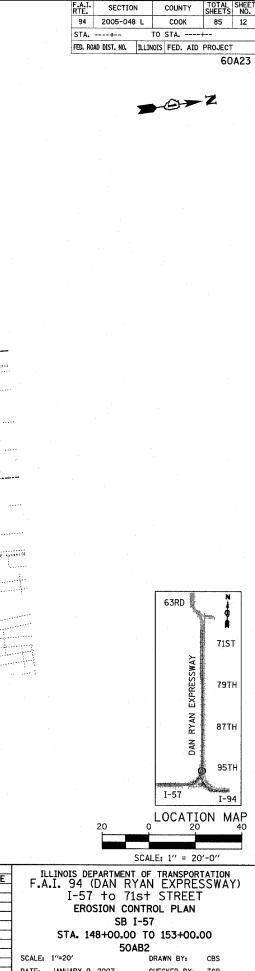

LAFAYETTE AVE. ···· y ····· y EXISTING CHAIN LINK FENCE TO REMAIN -AREA = 0.21 ACRE (E) (3) TEMPORARY DITCH CHECK SB I-57 LENGTH = 205 FT - PROPOSED B SB I-57 OVERHEAD SIGN STRUCTURE (TYP.)-1172+00 149+00 1173+00 159+00 SB I-94 (BISHOP FORD FWY) CTA RED LINE

NOTES:

- FINAL TURF RESTORATION WILL BE PROVIDED BY CONTRACTOR RESTORATION TO MATCH TURF RESTORATION PROVIDED BY CONTRACTS #62593 & #62304.
- PLAN REFLECTS CONTRACTS *62593 & *62304 AS EXISTING CONDITIONS.

LEGEND:


TEMPORARY EROSION CONTROL SEEDING (100 LBS PER ACRE) SEDIMENT CONTROL, SILT FENCE INLET FILTER, TO BE INSTALLED IN OFF PROJECT DRAINAGE STRUCTURES ACCEPTING STORMWATER RUNOFF TEMPORARY DITCH CHECK


EXISTING DRAINAGE SWALE

TY:LININTERNATIONAL


SHEET 5 OF 27


DATE: JANUARY 9, 2007 CHECKED BY: TGB

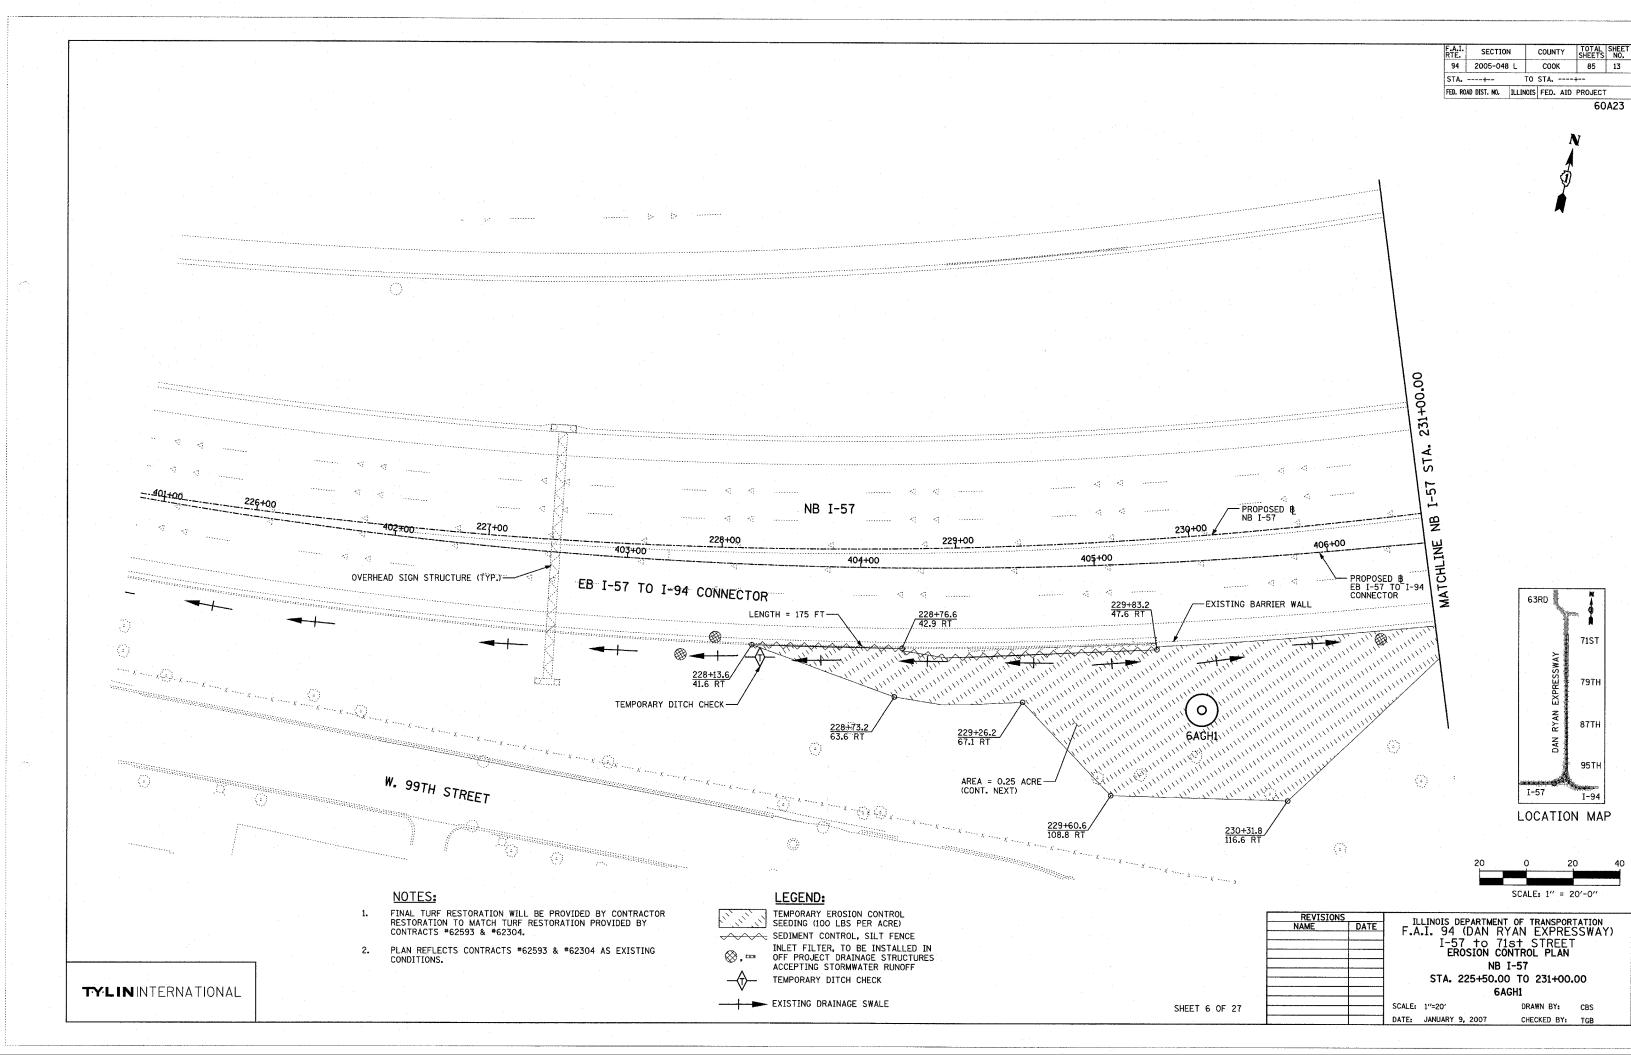


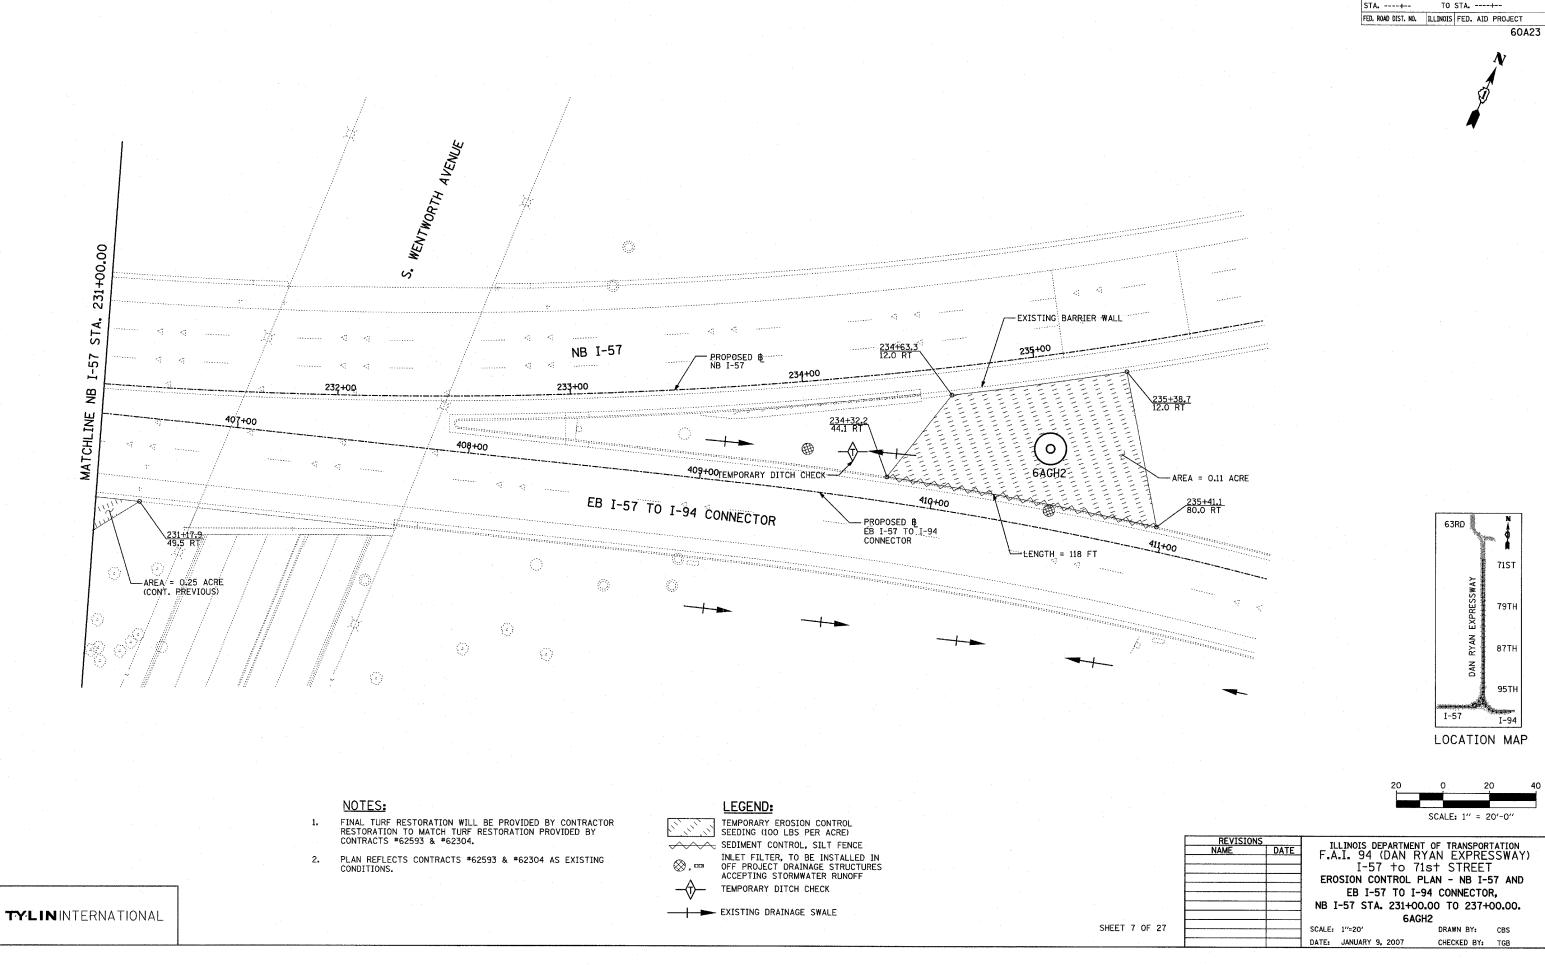


SECTION COUNTY 94 2005-048 L соок 85 14 STA. ----+--TO STA. ---+--

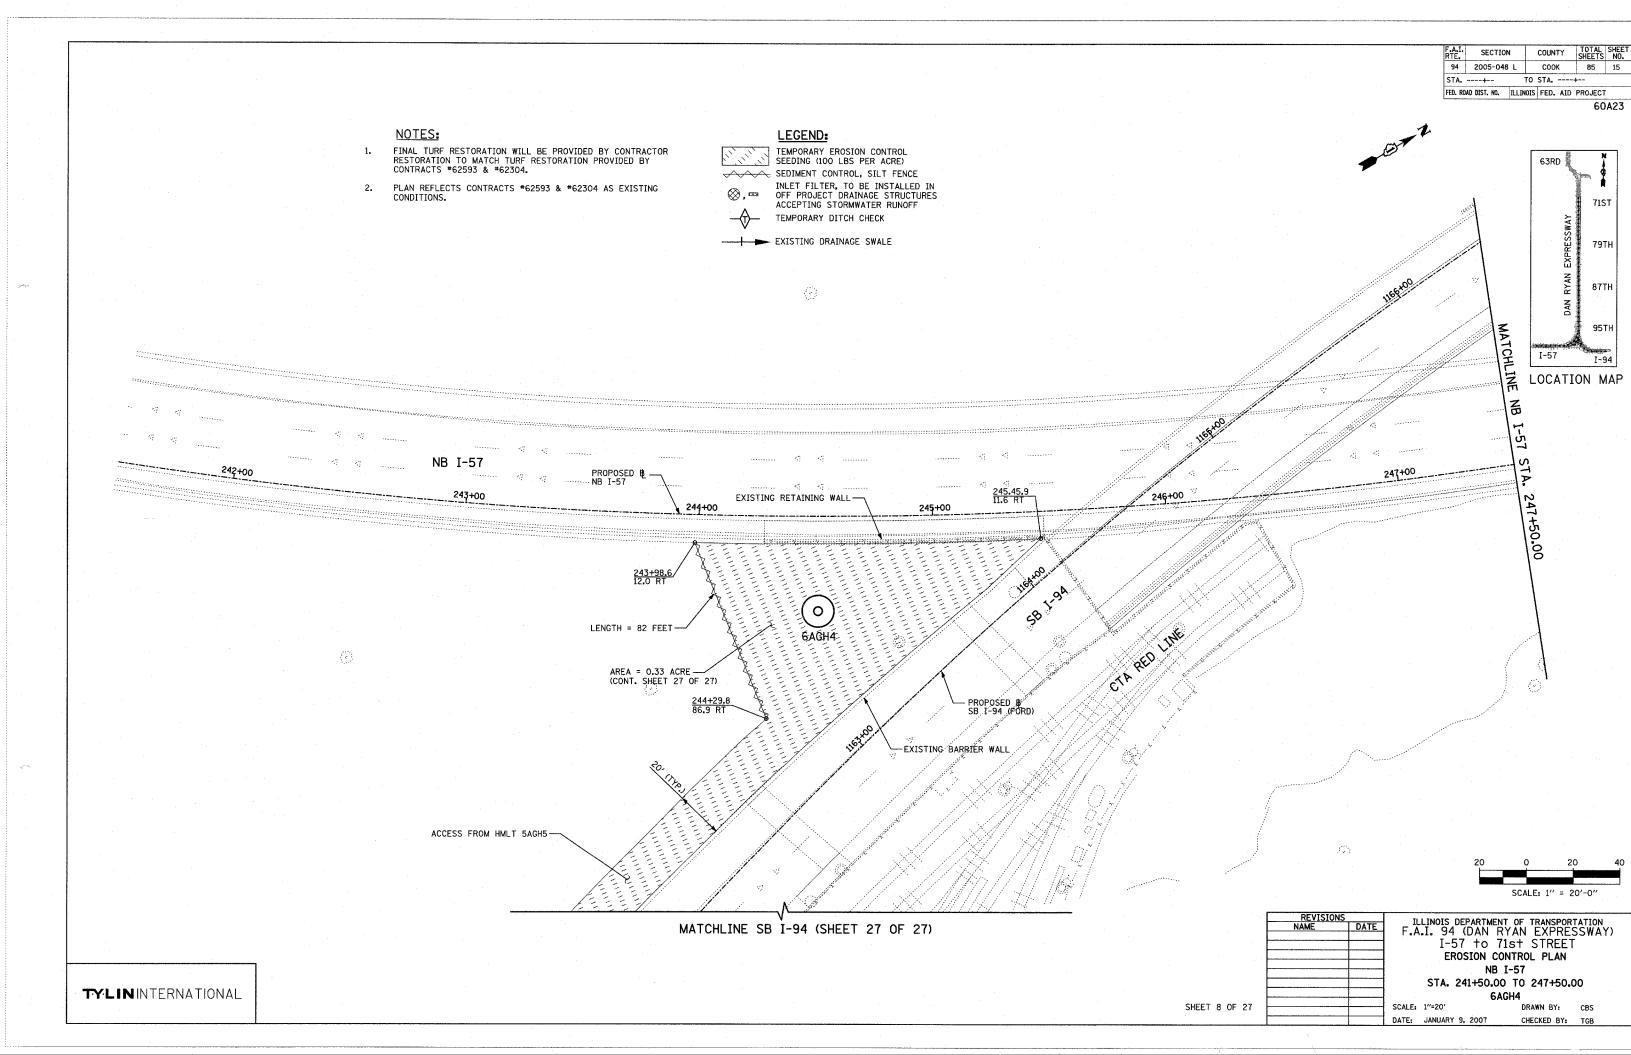

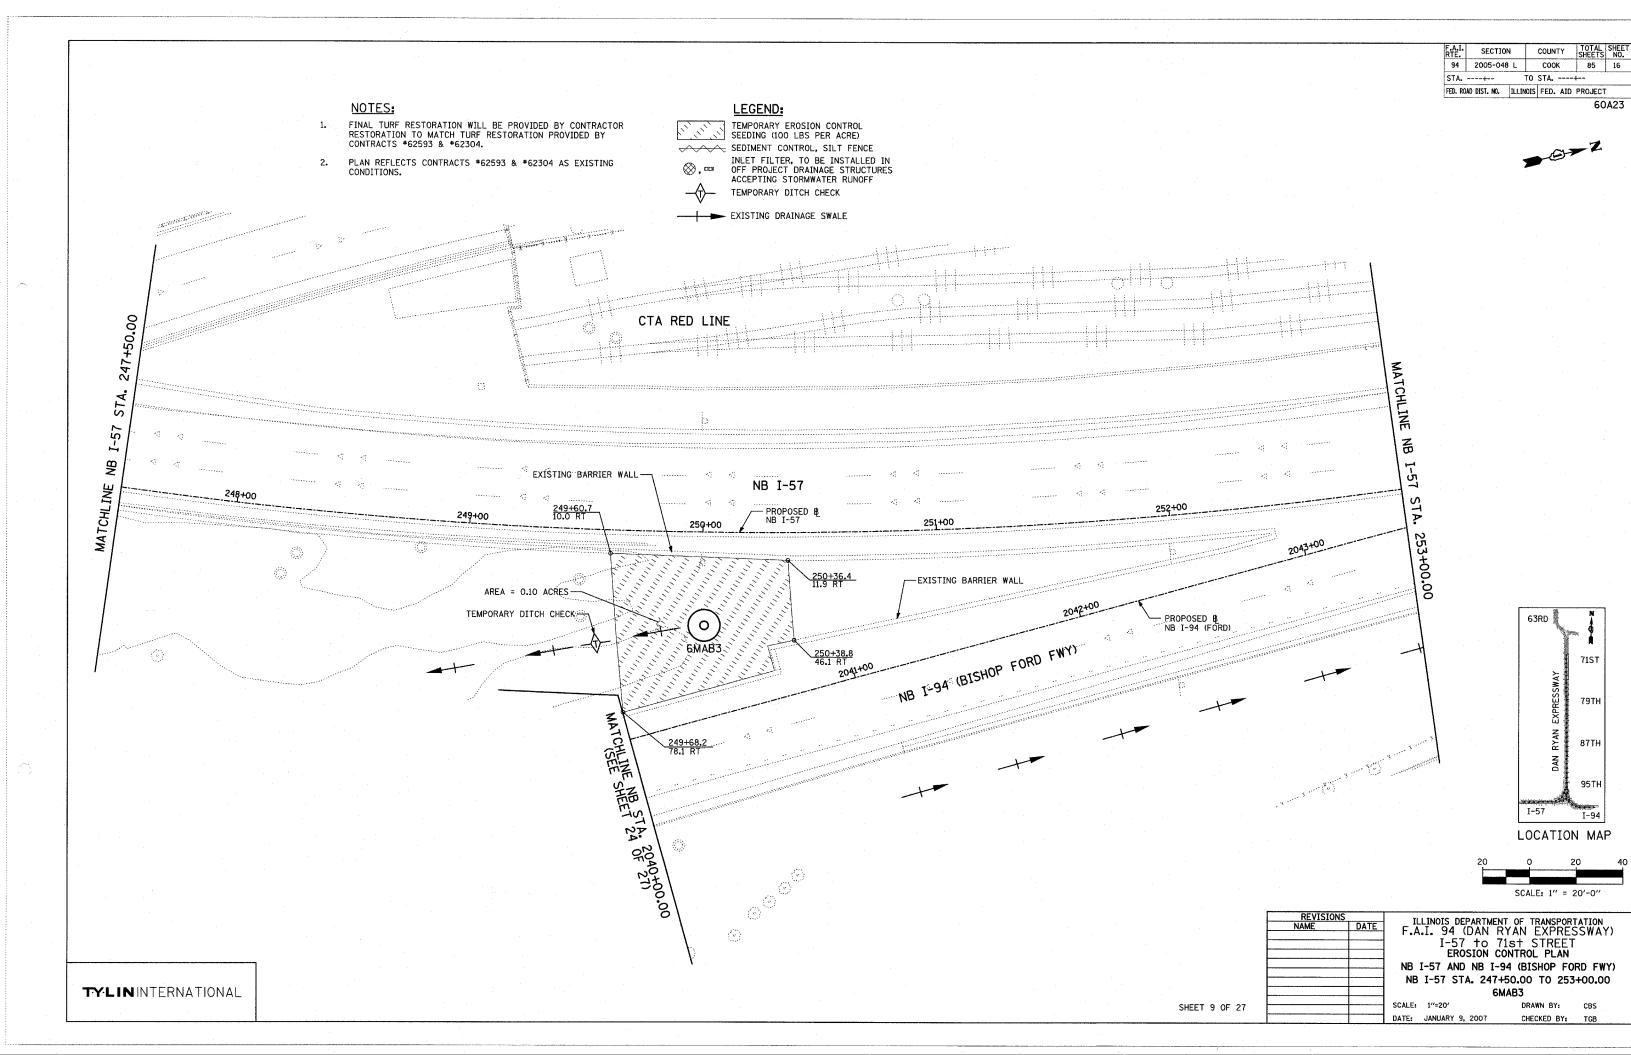

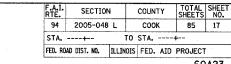



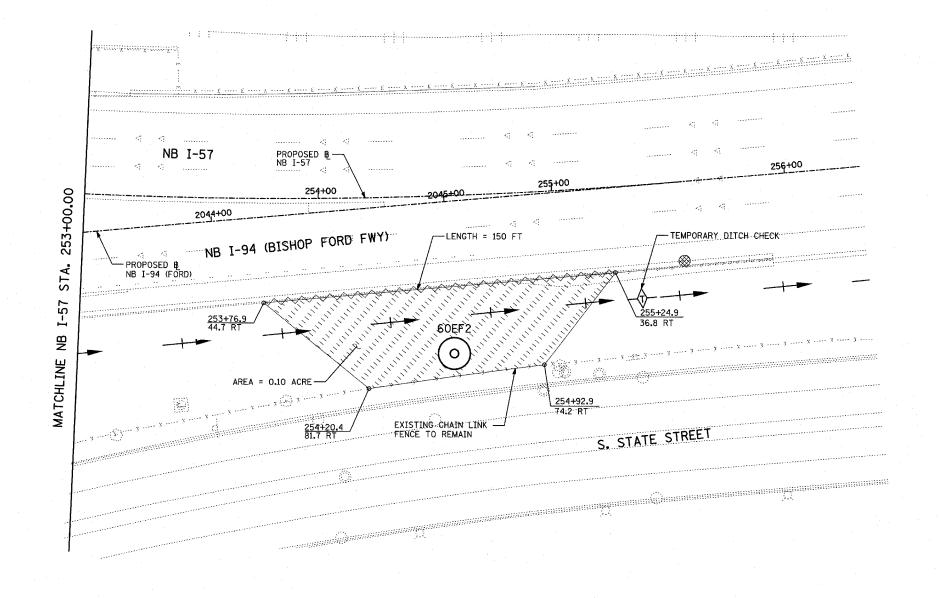

- FINAL TURF RESTORATION WILL BE PROVIDED BY CONTRACTOR RESTORATION TO MATCH TURF RESTORATION PROVIDED BY CONTRACTS #62593 & #62304.
- PLAN REFLECTS CONTRACTS #62593 & #62304 AS EXISTING CONDITIONS.

LEGEND:



TEMPORARY EROSION CONTROL SEEDING (100 LBS PER ACRE) SEDIMENT CONTROL, SILT FENCE




INLET FILTER, TO BE INSTALLED IN OFF PROJECT DRAINAGE STRUCTURES ACCEPTING STORMWATER RUNOFF



TEMPORARY DITCH CHECK

EXISTING DRAINAGE SWALE

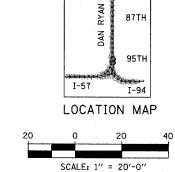


63RD


71ST


79TH

REVISIONS DAT	ILLINOIS DEPARTMENT OF TRANSPORTATION F.A.I. 94 (DAN RYAN EXPRESSWAY)		
		1st STREET	
	EROSION CO	NTROL PLAN	
	NB I-57 AND NB	3 I-94, NB I-57	
	☐ STA. 253+00.00 TO NB	I-94 STA. 2207+00.00	
	60EF2		
	SCALE: 1"=20"	DRAWN BY: CBS	
	DATE: JANUARY 9 2007	CHECKED BY. TOD	

SHEET 10 OF 27

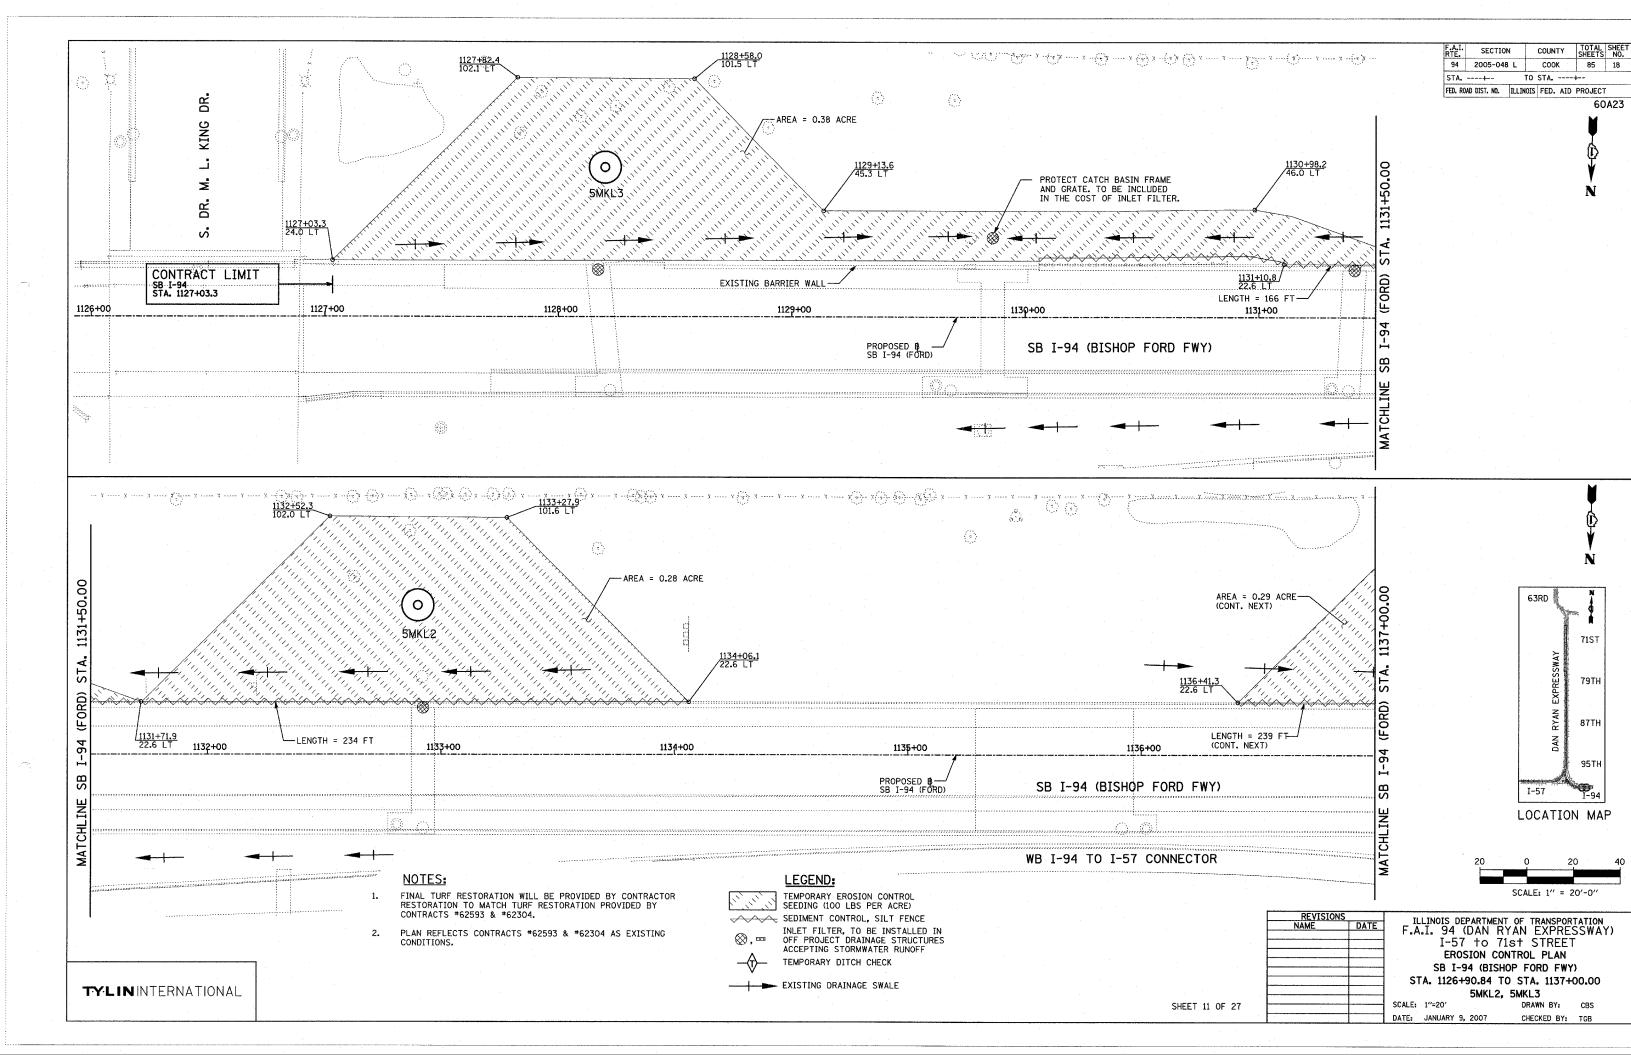

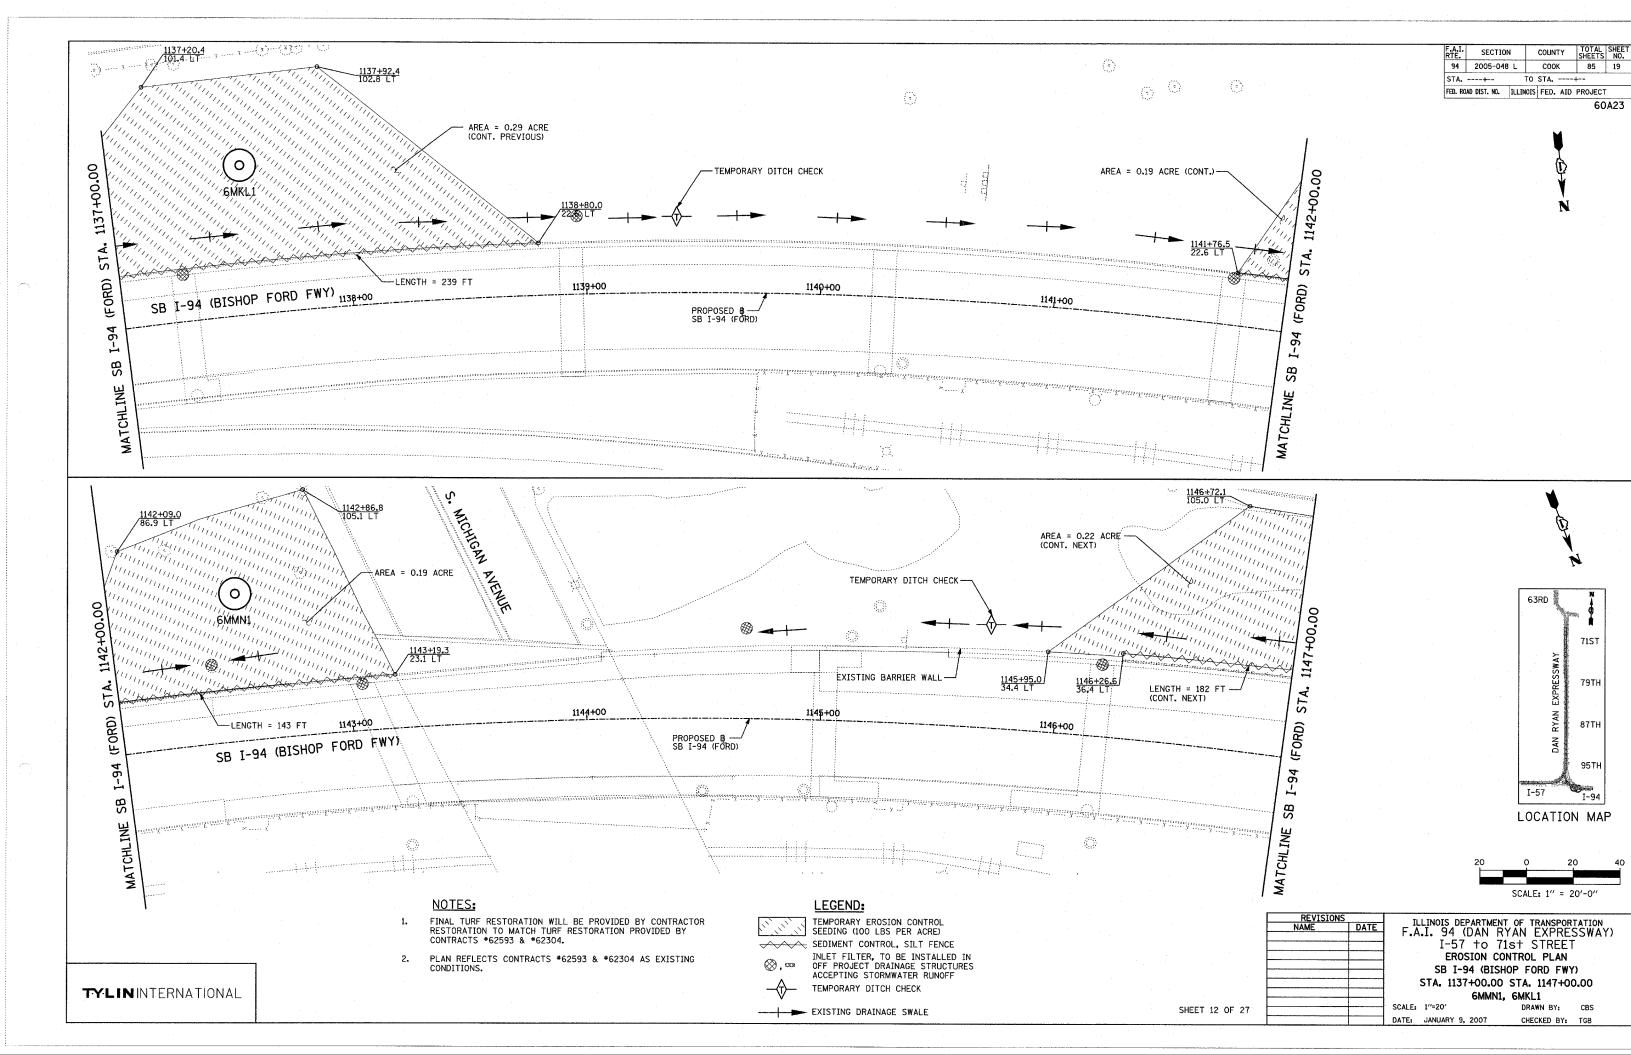

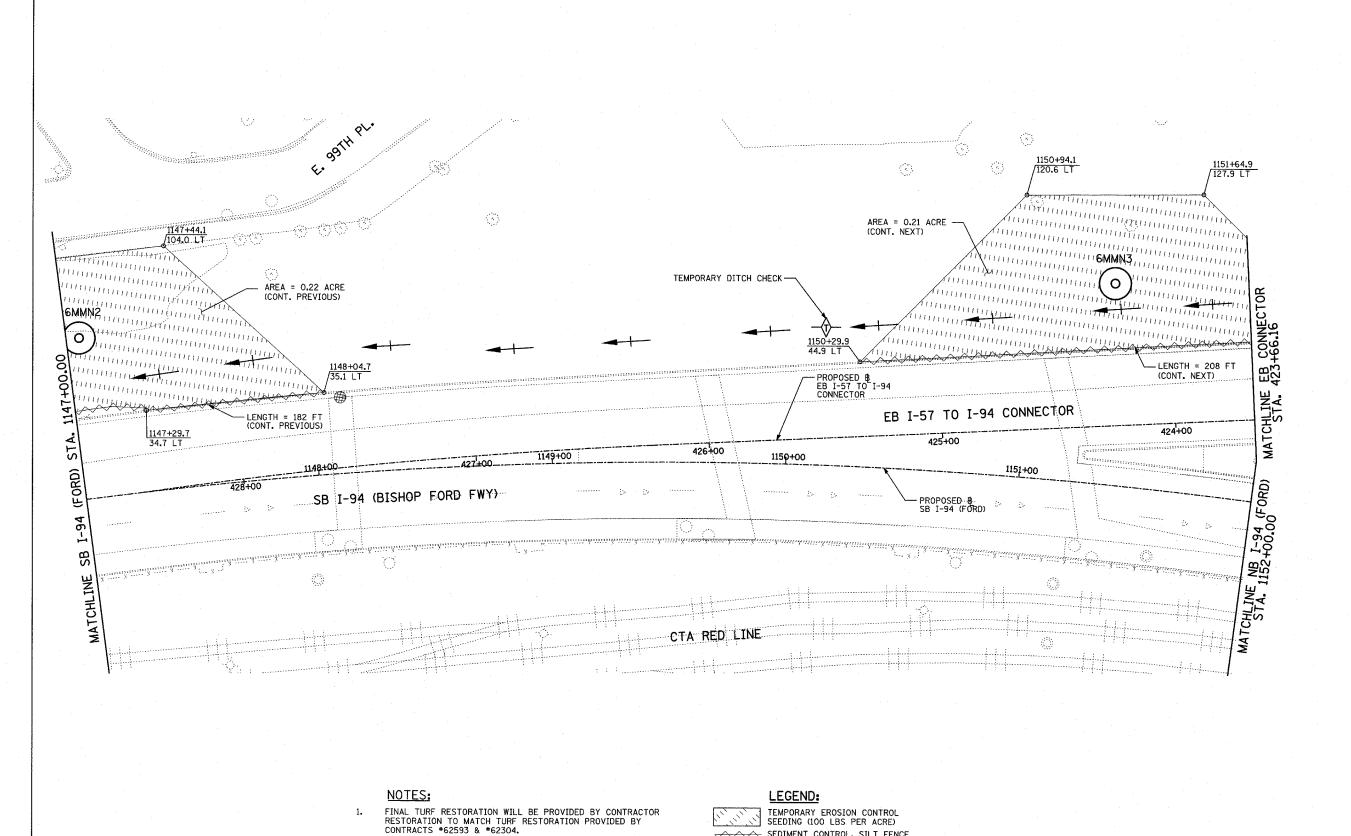

PLAN REFLECTS CONTRACTS *62593 & *62304 AS EXISTING CONDITIONS.

SEDIMENT CONTROL, SILT FENCE

TEMPORARY DITCH CHECK

FXISTING DRAINAGE SWALE

INLET FILTER, TO BE INSTALLED IN OFF PROJECT DRAINAGE STRUCTURES ACCEPTING STORMWATER RUNOFF

SECTION COUNTY 2005-048 L соок STA. ---+--TO STA. ----+--FED. ROAD DIST. NO. ILLINOIS FED. AID PROJECT

60A23

79TH 87TH LOCATION MAP

ILLINOIS DEPARTMENT OF TRANSPORTATION F.A.I. 94 (DAN RYAN EXPRESSWAY) I-57 to 71st STREET EROSION CONTROL PLAN

SB I-94 (BISHOP FORD FWY) & EB I-94 TO
I-57 CONNECTOR - SB I-94 STA.

1147+00.00 TO EB CONNECTOR STA. 423+66.16


DATE: JANUARY 9, 2007


SCALE: 1"=20'

DRAWN BY: CBS CHECKED BY: TGB


SHEET 13 OF 27

TYLININTERNATIONAL

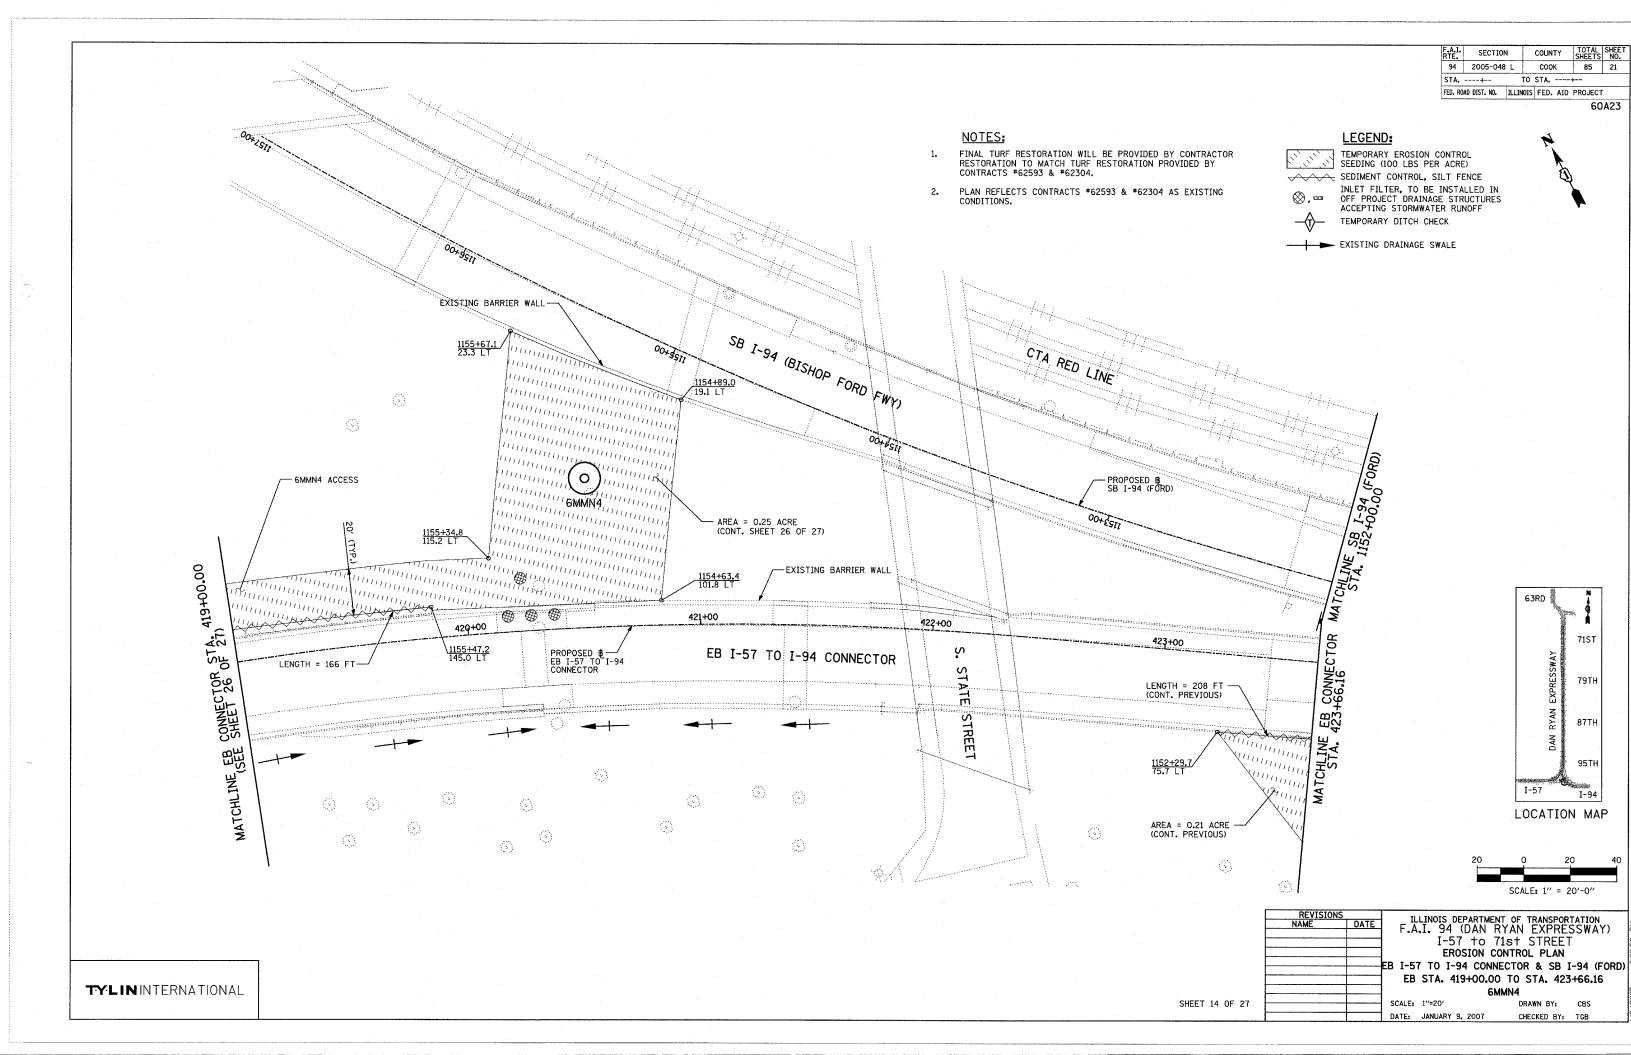

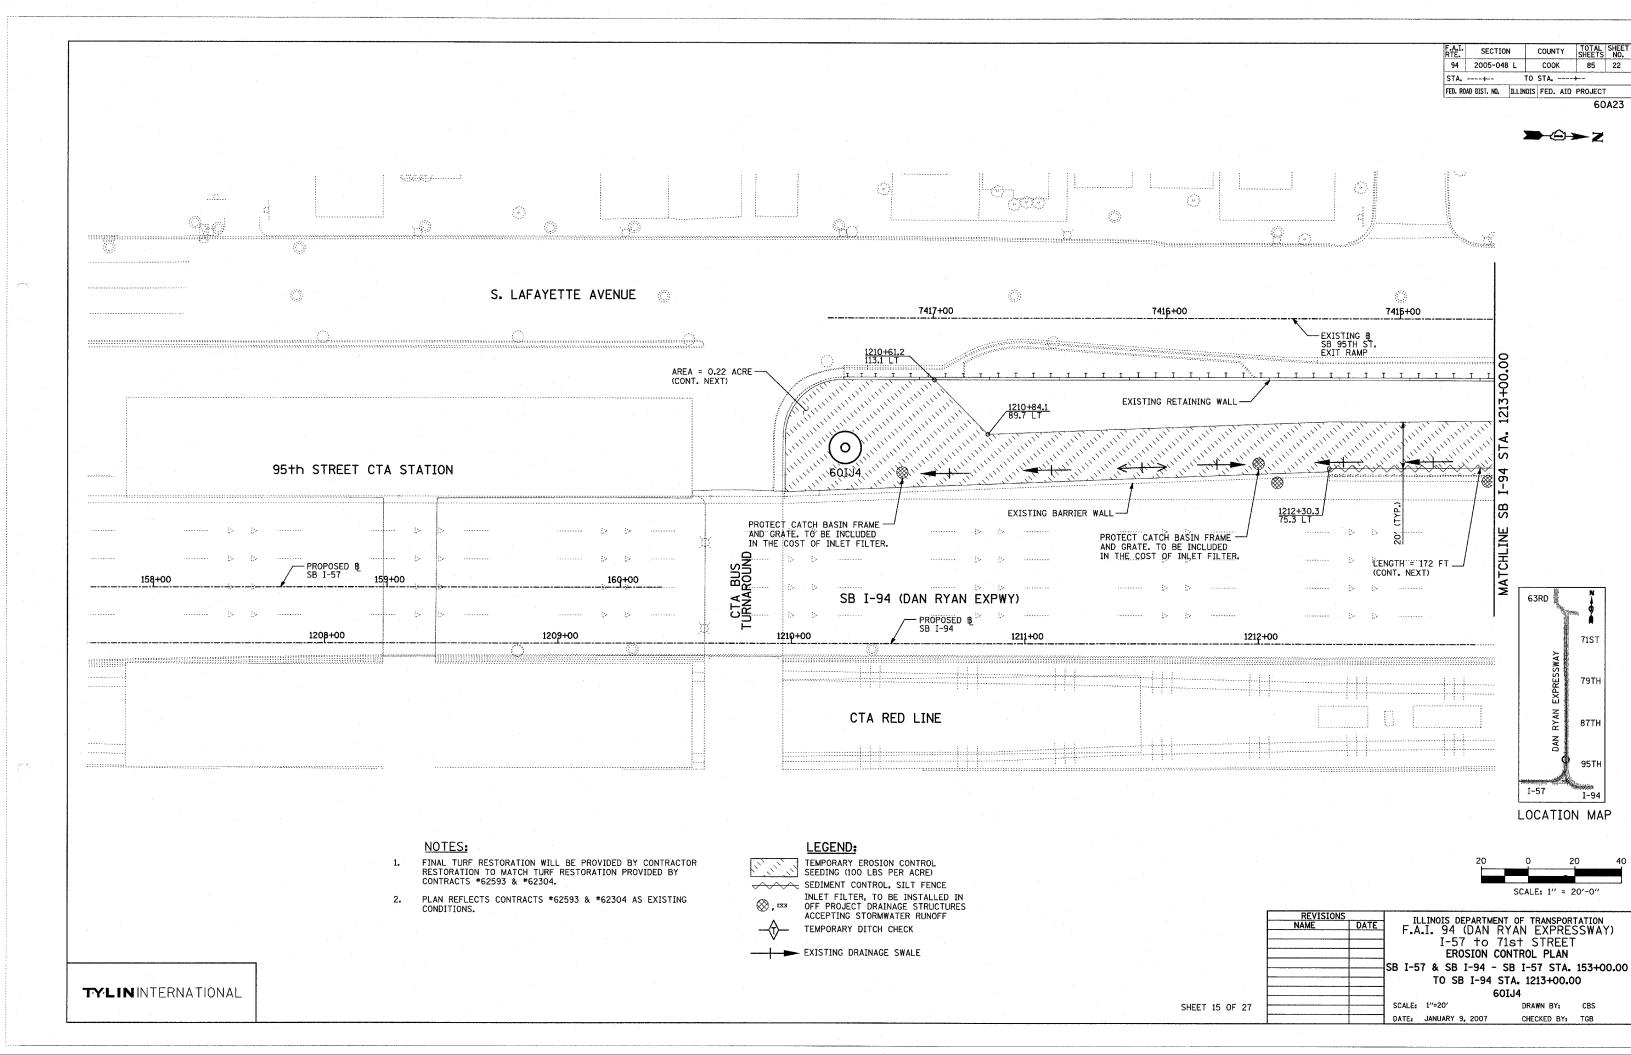


SECTION COUNTY 94 2005-048 L соок 85 23 TO STA. ----+--FED. ROAD DIST. NO. ILLINOIS FED. AID PROJECT 60A23

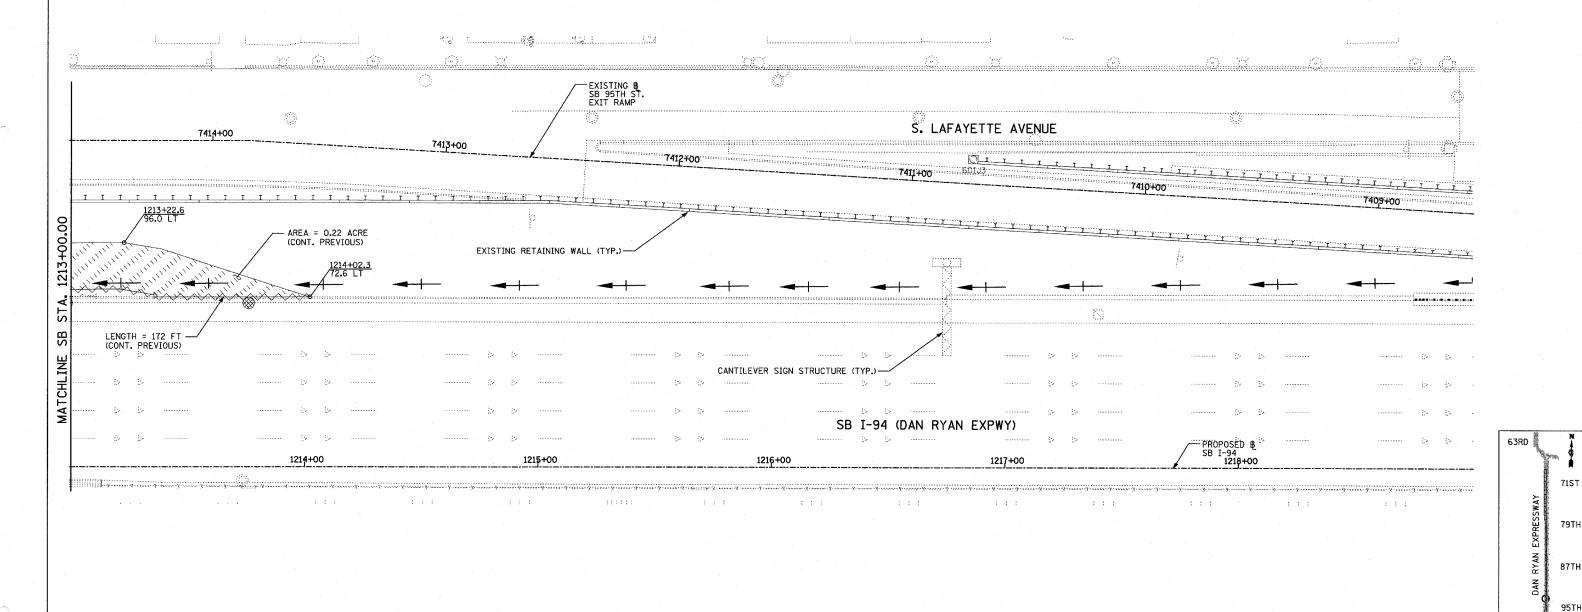

NOTES:

- FINAL TURF RESTORATION WILL BE PROVIDED BY CONTRACTOR RESTORATION TO MATCH TURF RESTORATION PROVIDED BY CONTRACTS #62593 & #62304.
- PLAN REFLECTS CONTRACTS #62593 & #62304 AS EXISTING CONDITIONS.

LEGEND:

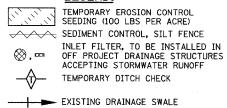

SCALE: 1" = 20'-0"

ILLINOIS DEPARTMENT OF TRANSPORTATION F.A.I. 94 (DAN RYAN EXPRESSWAY) DATE I-57 to 71st STREET EROSION CONTROL PLAN SB I-94 (DAN RYAN EXPRESSWAY) STA. 1213+00.00 TO 1219+00.00 60IJ4


SHEET 16 OF 27


TY:LIN INTERNATIONAL

SCALE: 1"=20"


DRAWN BY: CBS DATE: JANUARY 9, 2007 CHECKED BY: TGB


LOCATION MAP

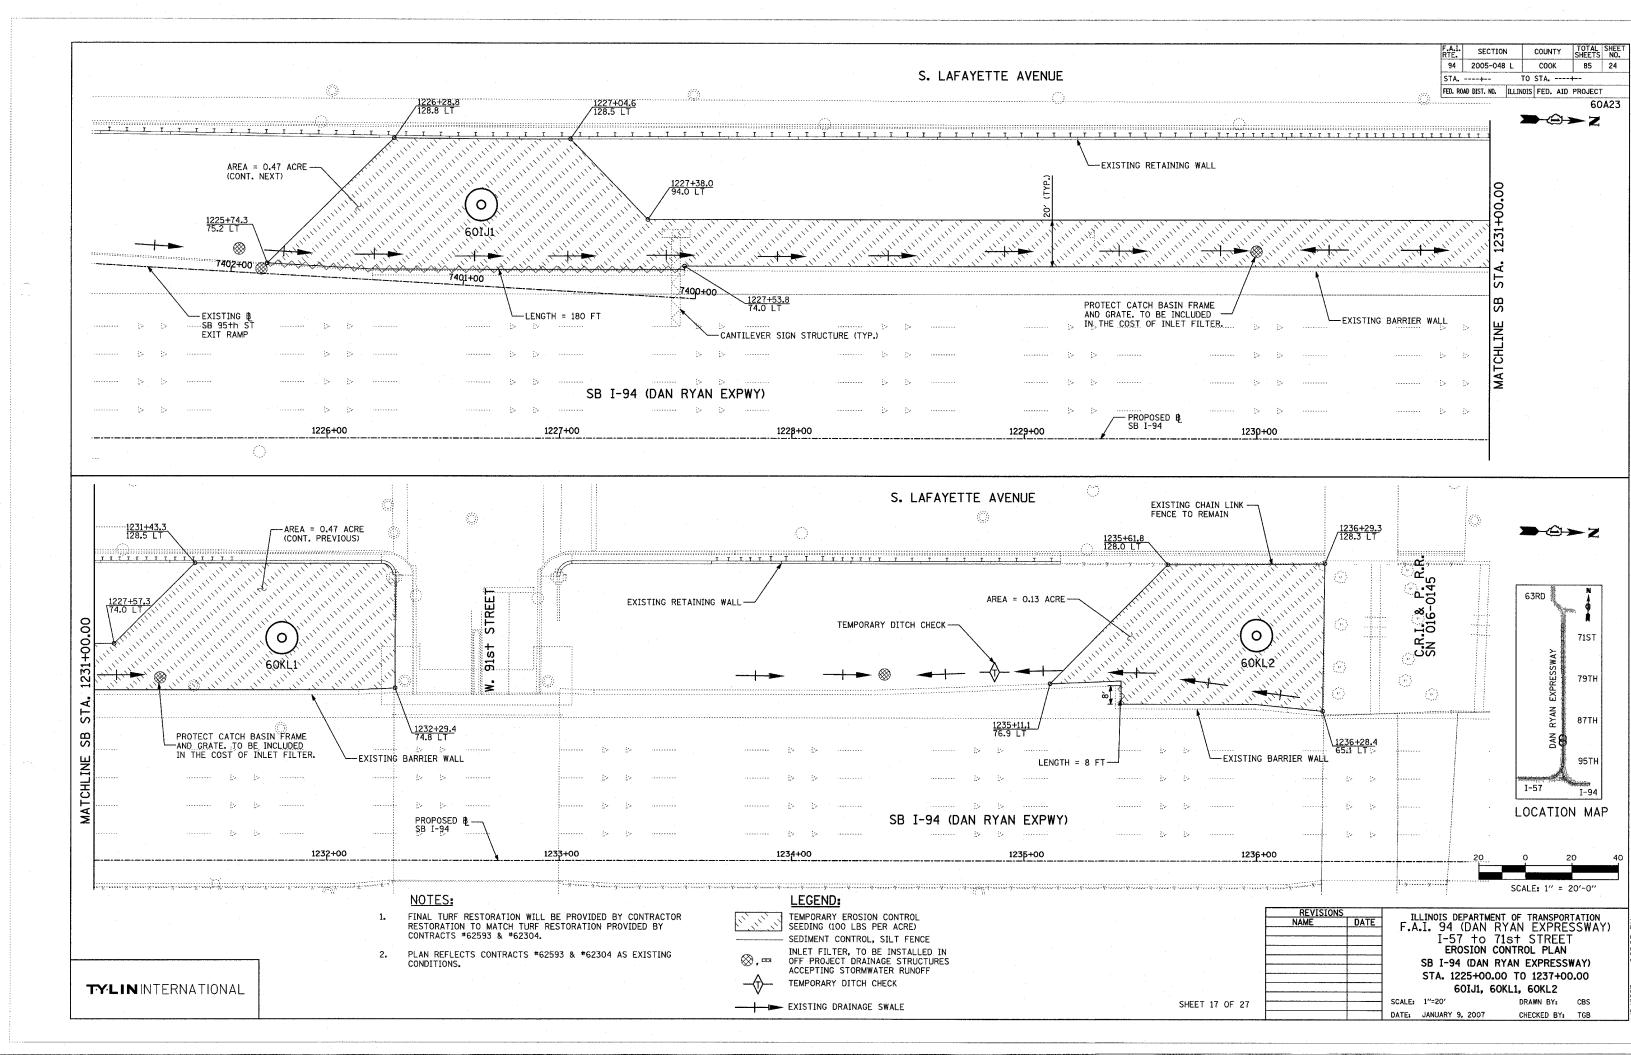

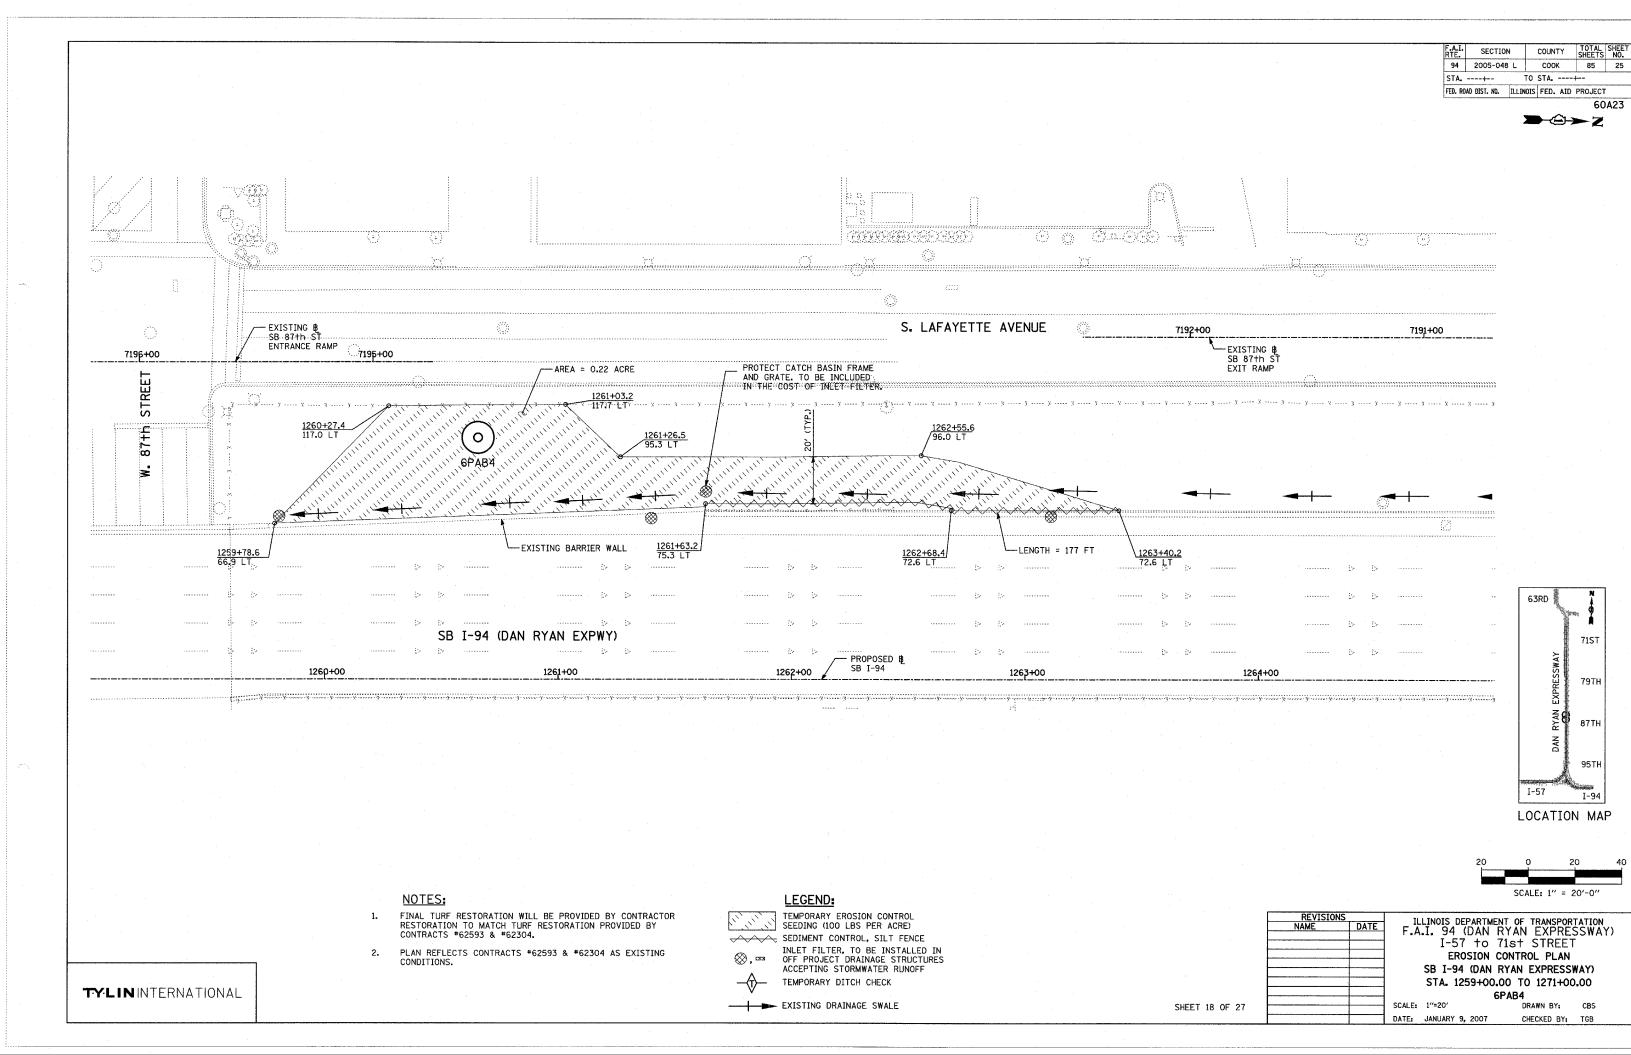

COOK 85 26 94 2005-048 L STA. ----+--TO STA. ----+--FED. ROAD DIST. NO. ILLINOIS FED. AID PROJECT

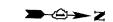


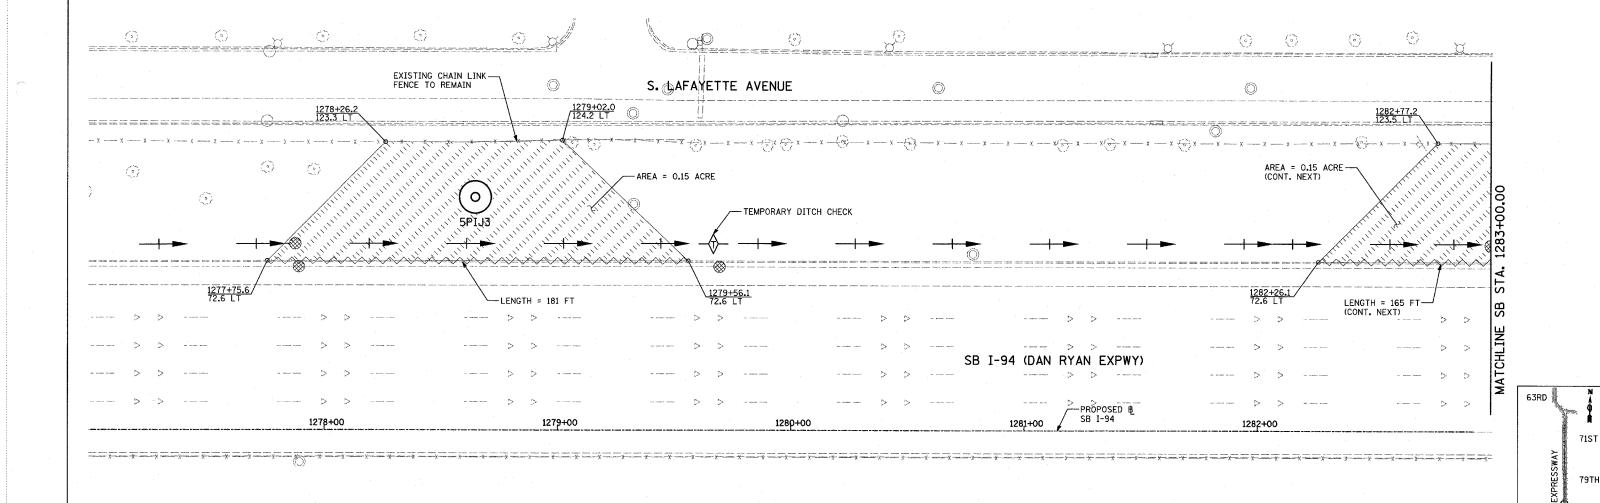

NOTES:

- FINAL TURF RESTORATION WILL BE PROVIDED BY CONTRACTOR RESTORATION TO MATCH TURF RESTORATION PROVIDED BY CONTRACTS #62593 & #62304.
- 2. PLAN REFLECTS CONTRACTS #62593 & #62304 AS EXISTING CONDITIONS.

LEGEND:

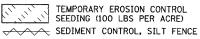

INLET FILTER, TO BE INSTALLED IN OFF PROJECT DRAINAGE STRUCTURES
ACCEPTING STORMWATER RUNOFF TEMPORARY DITCH CHECK



EXISTING DRAINAGE SWALE

ILLINOIS DEPARTMENT OF TRANSPORTATION F.A.I. 94 (DAN RYAN EXPRESSWAY)

I-57 to 71st STREET EROSION CONTROL PLAN SB I-94 (DAN RYAN EXPRESSWAY) STA. 1271+00.00 TO 1283+00.00 5PIJ3

TY:LIN INTERNATIONAL

SHEET 19 OF 27

DATE: JANUARY 9, 2007


DRAWN BY: CBS


87Th

95TH

LOCATION MAP

SCALE: 1" = 20'-0"

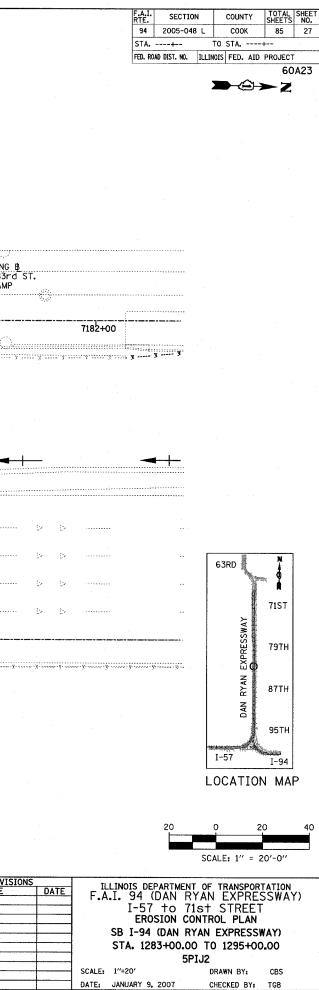

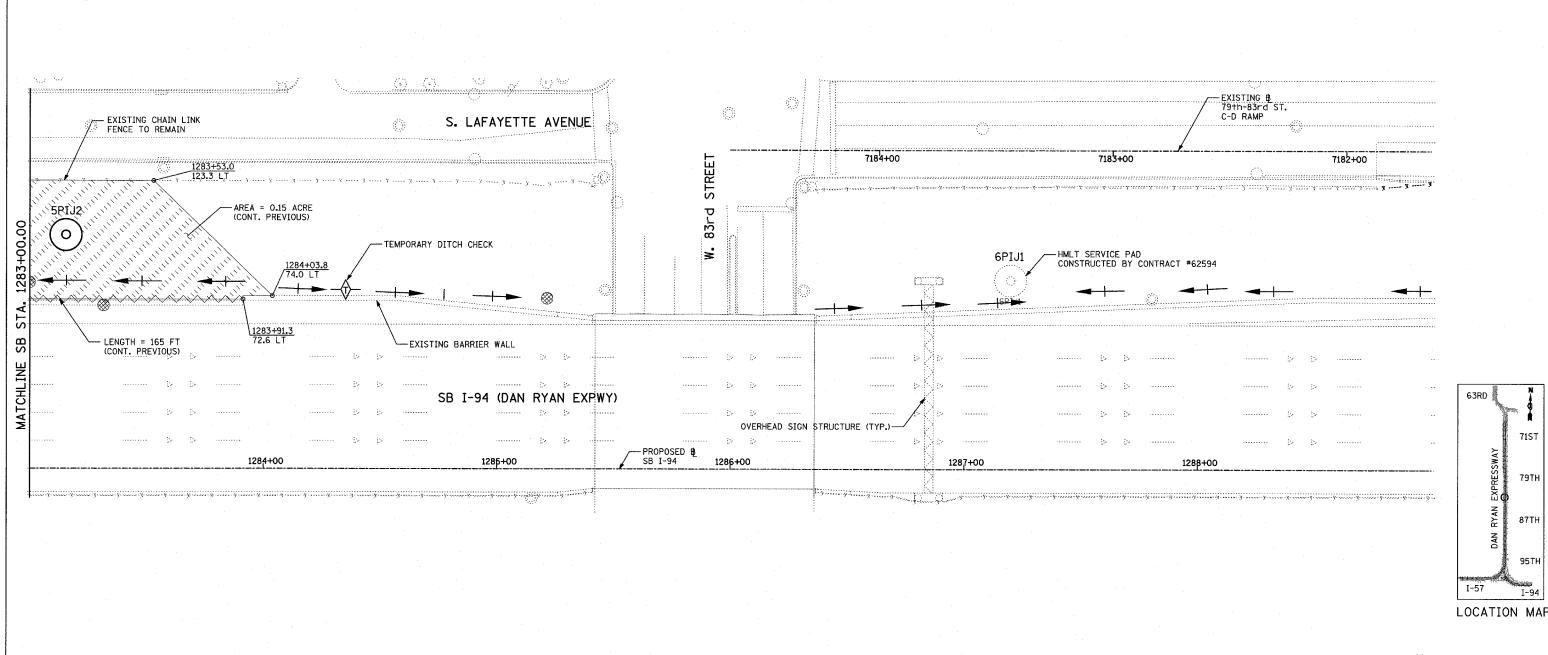

LEGEND:

EXISTING DRAINAGE SWALE

TEMPORARY EROSION CONTROL SEEDING (100 LBS PER ACRE)

INLET FILTER, TO BE INSTALLED IN OFF PROJECT DRAINAGE STRUCTURES ACCEPTING STORMWATER RUNOFF

SHEET 20 OF 27

SEDIMENT CONTROL, SILT FENCE


TEMPORARY DITCH CHECK


NOTES:

TYLIN INTERNATIONAL

FINAL TURF RESTORATION WILL BE PROVIDED BY CONTRACTOR RESTORATION TO MATCH TURF RESTORATION PROVIDED BY CONTRACTS #62593 & #62304.

PLAN REFLECTS CONTRACTS #62593 & #62304 AS EXISTING CONDITIONS.

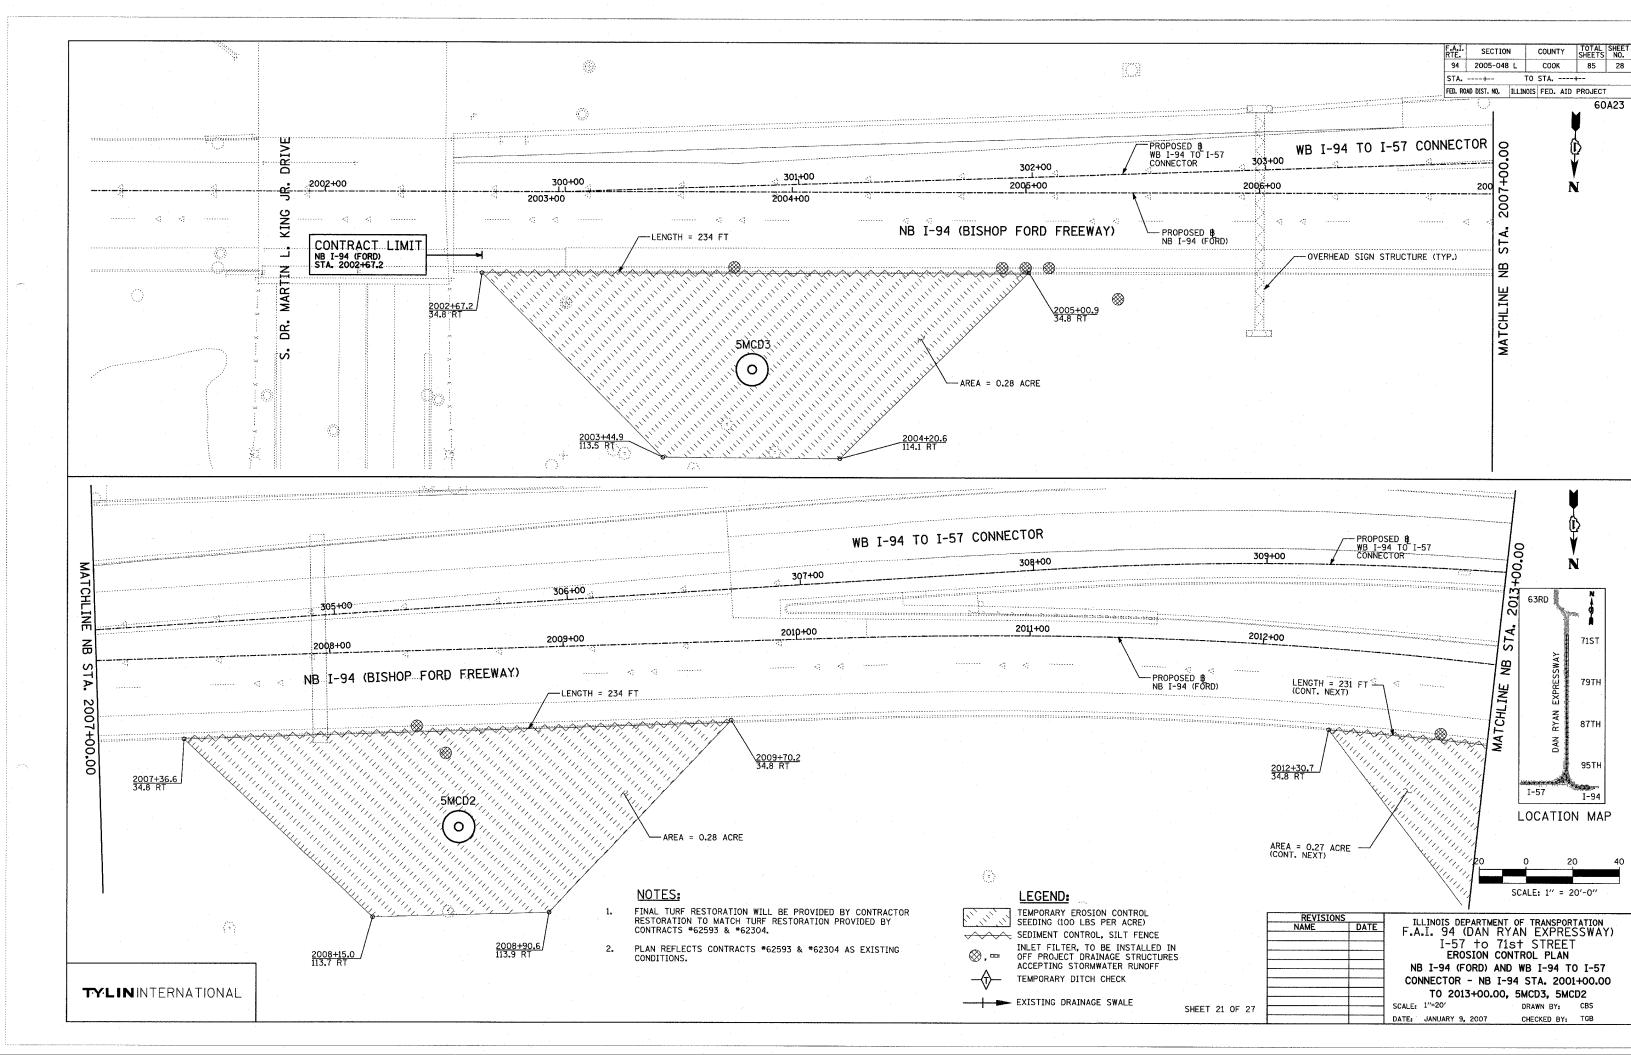

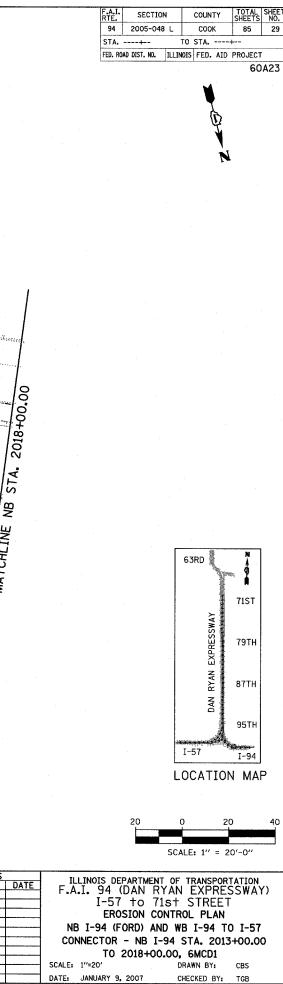

60A23

LEGEND:

(3)

FINAL TURF RESTORATION WILL BE PROVIDED BY CONTRACTOR RESTORATION TO MATCH TURF RESTORATION PROVIDED BY CONTRACTS *62593 & *62304.

AREA = 0.27 ACRE (CONT. PREVIOUS)

PLAN REFLECTS CONTRACTS #62593 & #62304 AS EXISTING CONDITIONS.

TEMPORARY EROSION CONTROL SEEDING (100 LBS PER ACRE) SEDIMENT CONTROL, SILT FENCE

WB I-94 TO I-57 CONNECTOR

2015+00

NB I-94 (BISHOP FORD FREEWAY)

INLET FILTER, TO BE INSTALLED IN OFF PROJECT DRAINAGE STRUCTURES ACCEPTING STORMWATER RUNOFF TEMPORARY DITCH CHECK

(3)

313+00

2016+00

LENGTH = 173 FT-

SHEET 22 OF 27

PROPOSED B WB I-94 TO I-57 CONNECTOR

2017+00

-PROPOSED B NB I-94 (FORD)

EXISTING BARRIER WALL-

AREA = 0.33 ACRE-(CONT. NEXT)


315+00

TY:LININTERNATIONAL

LENGTH = 231 FT (CONT. PREVIOUS)

F.A.I. SECTION TOTAL SHEET SHEETS NO. COUNTY 94 2005-048 L соок 85 30 STA. ---+--TO STA. ----+--FED. ROAD DIST. NO. ILLINOIS FED. AID PROJECT 60A23



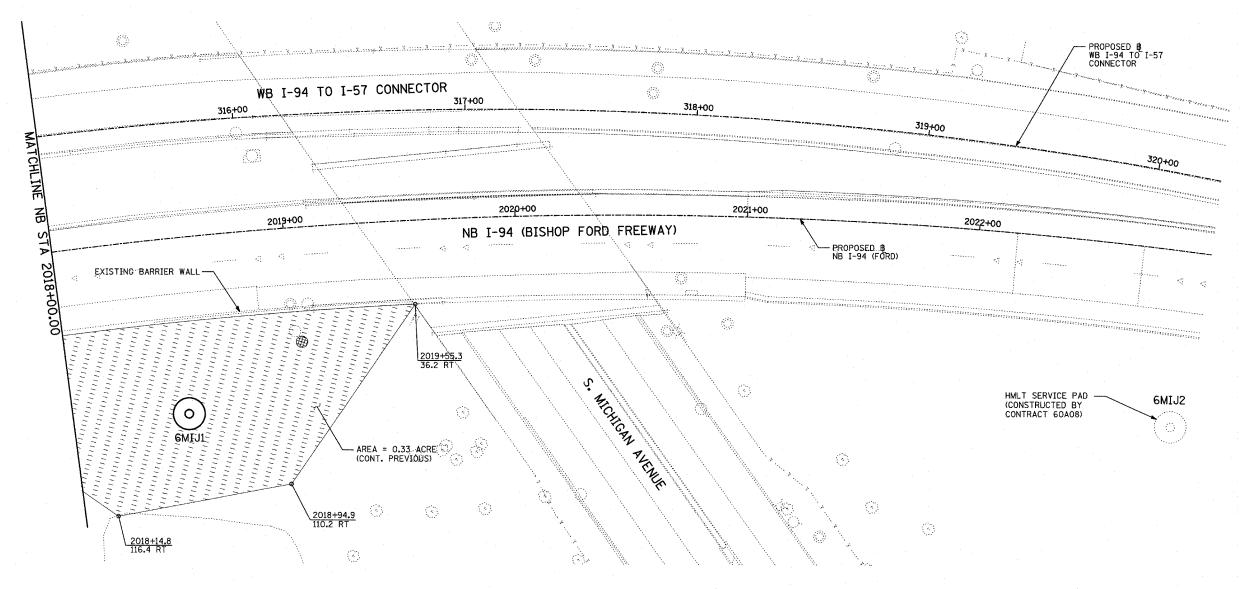

63RD 71ST 79TH I-57 LOCATION MAP

SCALE: 1" = 20'-0"

NOTES:

- FINAL TURF RESTORATION WILL BE PROVIDED BY CONTRACTOR RESTORATION TO MATCH TURF RESTORATION PROVIDED BY CONTRACTS *62593 & *62304.
- PLAN REFLECTS CONTRACTS #62593 & #62304 AS EXISTING CONDITIONS.

LEGEND:

TEMPORARY EROSION CONTROL SEEDING (100 LBS PER ACRE) SEDIMENT CONTROL, SILT FENCE

INLET FILTER, TO BE INSTALLED IN OFF PROJECT DRAINAGE STRUCTURES ACCEPTING STORMWATER RUNOFF TEMPORARY DITCH CHECK

EXISTING DRAINAGE SWALE

LEA1210N2	ı	
NAME	DATE	
		ŀ
		sc
		- SU


SHEET 23 OF 27


ILLINOIS DEPARTMENT OF TRANSPORTATION F.A.I. 94 (DAN RYAN EXPRESSWAY) I-57 to 71st STREET **EROSION CONTROL PLAN** NB I-94 (FORD) AND WB I-94 TO I-57 CONNECTOR - NB I-94 STA. 2018+00.00 TO 2023+00.00, 6MIJ1

CALE: 1"=20" DATE: JANUARY 9, 2007


DRAWN BY: CBS CHECKED BY: TGB

TYLININTERNATIONAL

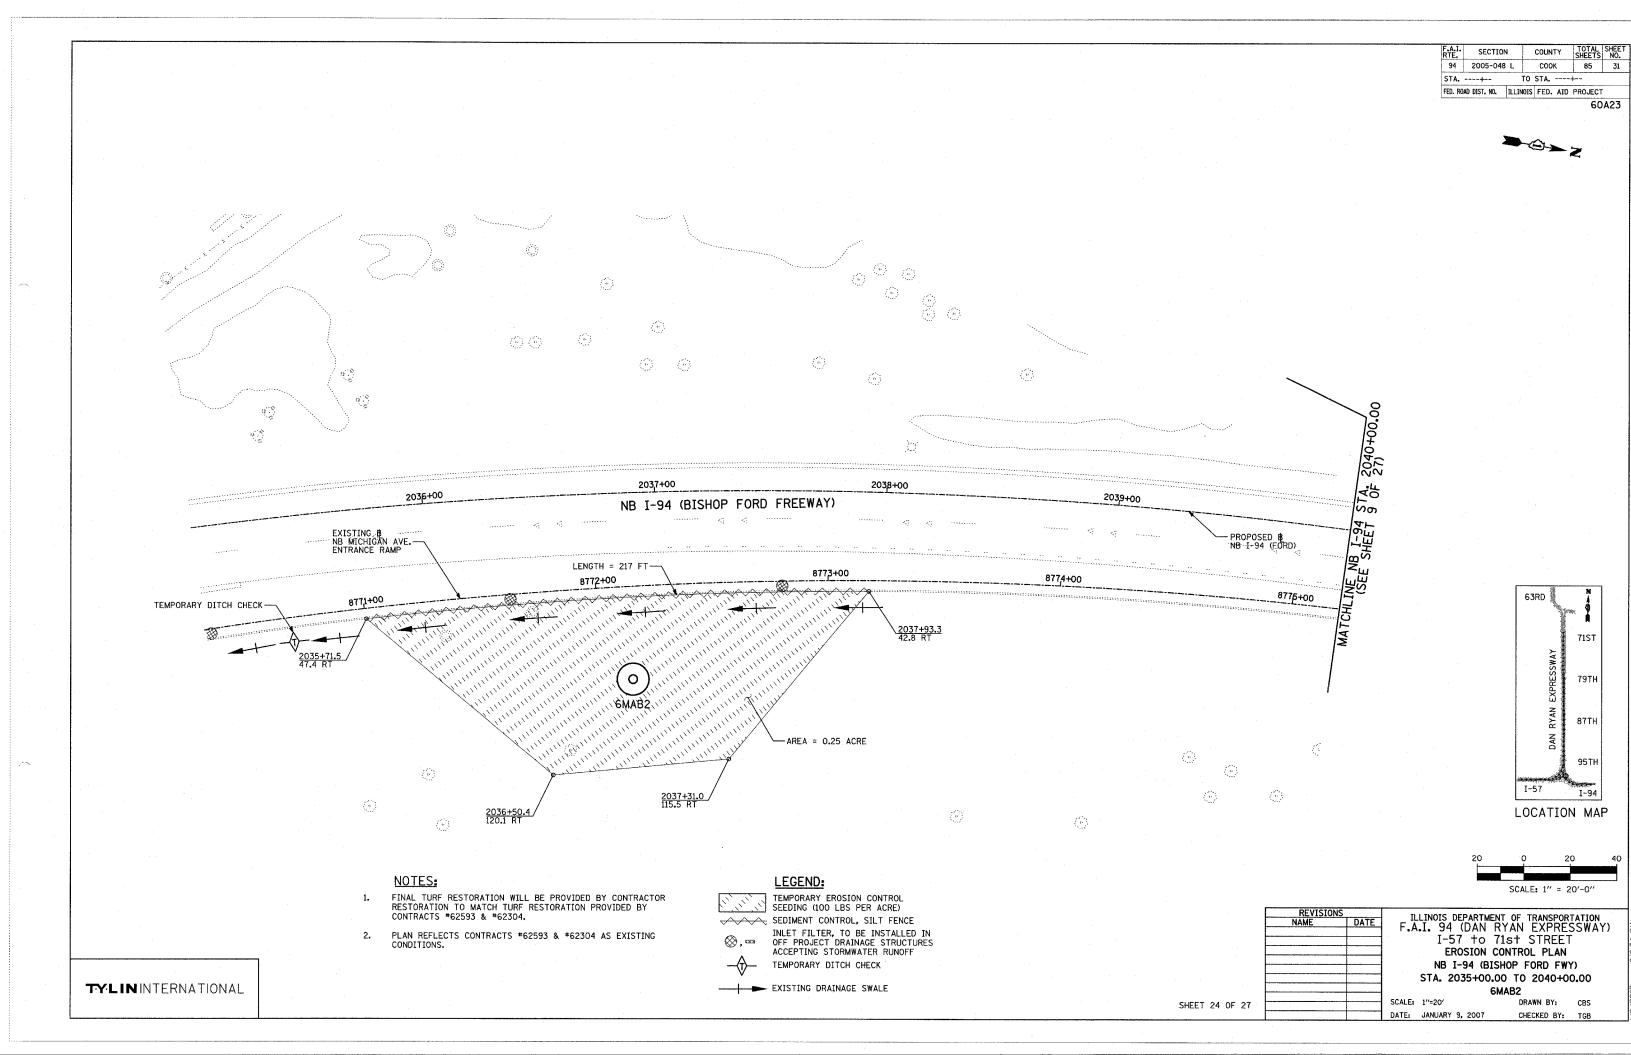

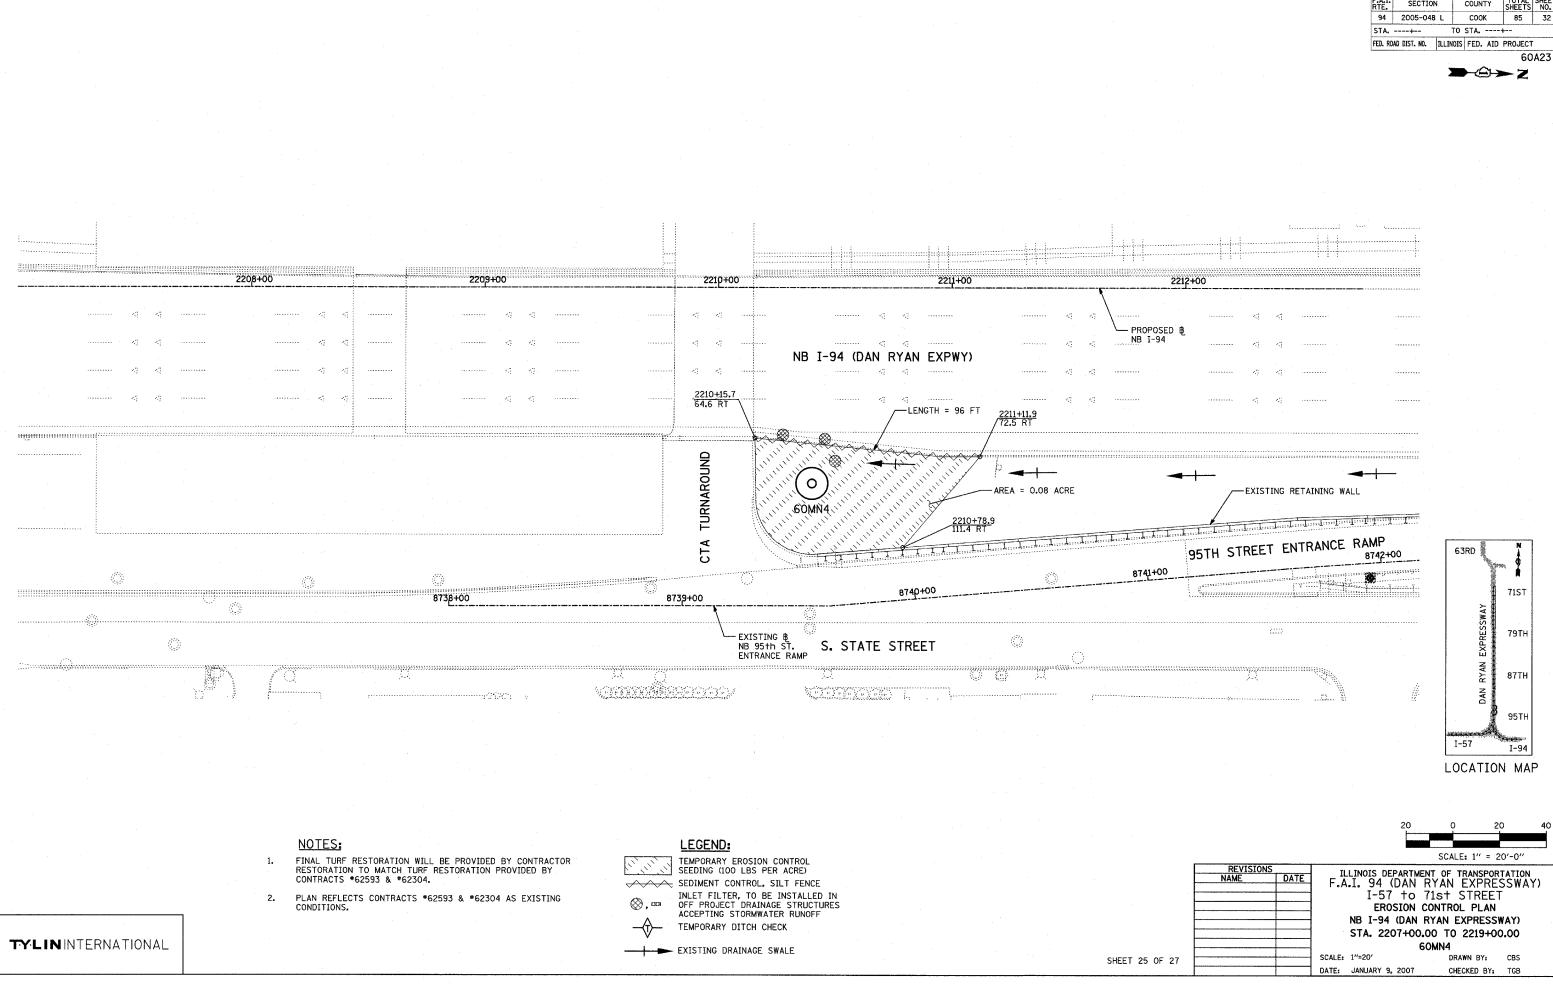

F.A.I. SECTION
94 2005-048 L TOTAL SHEET SHEETS NO. 85 32 COUNTY

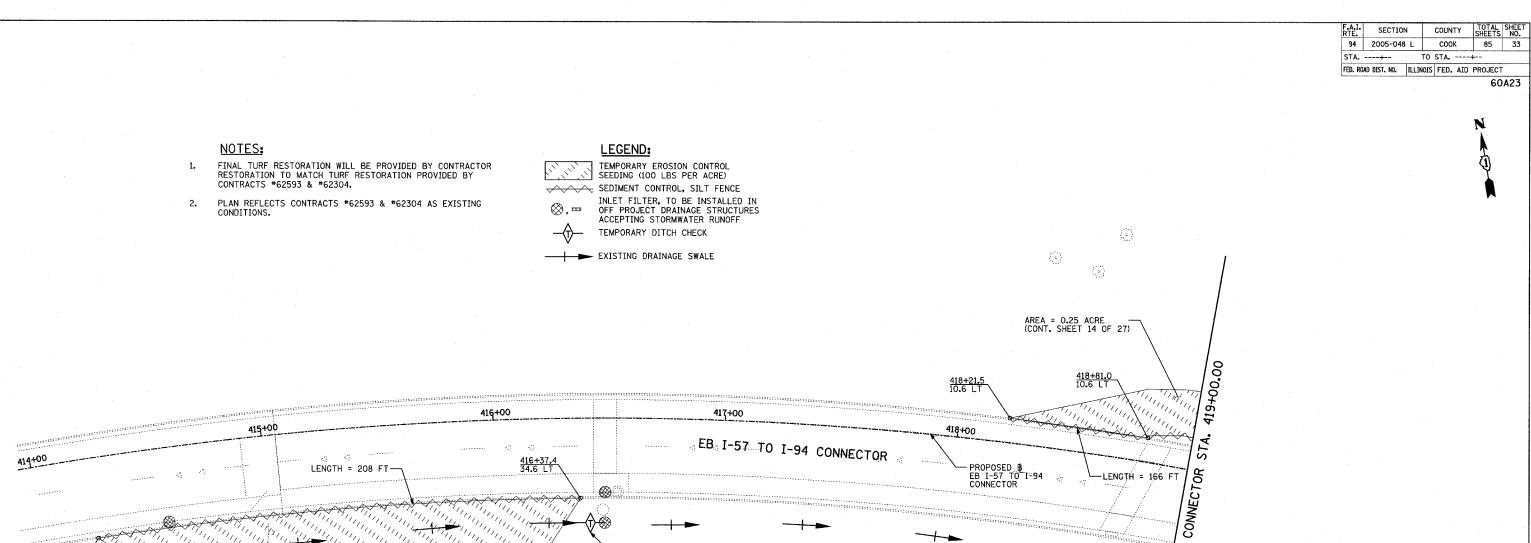

TEMPORARY DITCH CHECK

AREA = 0.22 ACRE

79TH LOCATION MAP

SCALE: 1" = 20'-0"

REVISIONS DATE

MATCHLINE

ILLINOIS DEPARTMENT OF TRANSPORTATION F.A.I. 94 (DAN RYAN EXPRESSWAY) I-57 to 71st STREET EROSION CONTROL PLAN EB I-57 TO I-94 CONNECTOR STA. 413+94.00 TO STA. 419+00.00 5MMN5

SCALE: 1"=20" DATE: JANUARY 9, 2007

DRAWN BY: CBS CHECKED BY: TGB

SHEET 26 OF 27


(3)

S. LAFAYETTE

TYLININTERNATIONAL

(<u>)</u>

414+24.2 34.6 RT

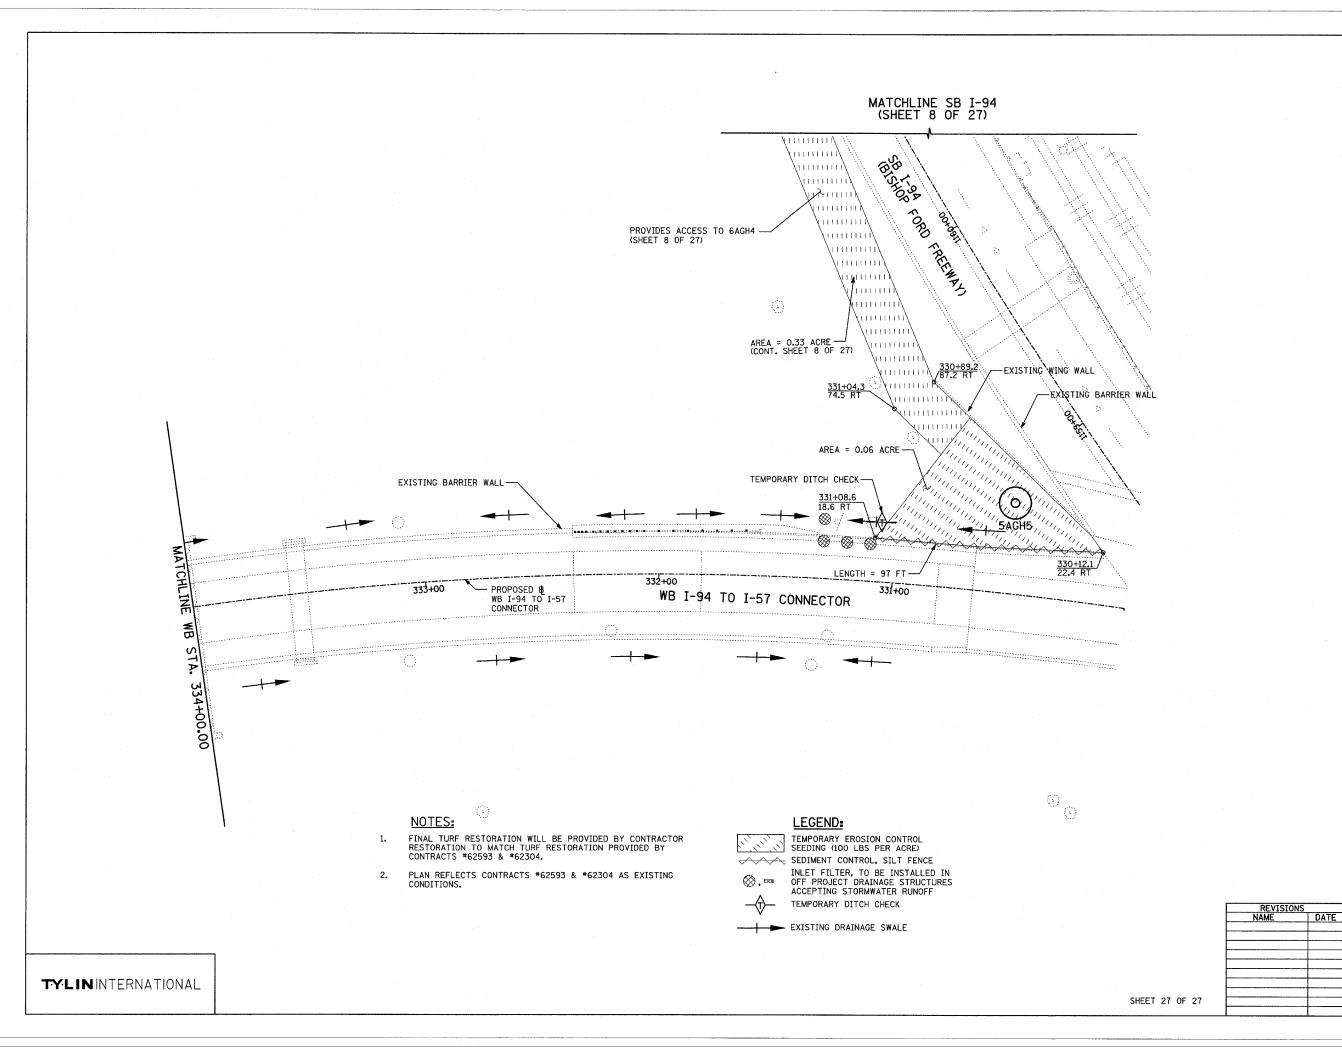


COUNTY TOTAL SHEET NO. SECTION COOK 85 34 94 2005-048 L STA. ----+--TO STA, ----+--FED. ROAD DIST. NO. ILLINOIS FED. AID PROJECT

63RD 79TH 87TH 95TH I-57 I-94 LOCATION MAP

ILLINOIS DEPARTMENT OF TRANSPORTATION F.A.I. 94 (DAN RYAN EXPRESSWAY) I-57 to 71st STREET EROSION CONTROL PLAN WB I-94 TO I-57 CONNECTOR STA. 330+00.00 TO 334+00.00

SCALE: 1"=20' DATE: JANUARY 9, 2007 DRAWN BY: CBS CHECKED BY: TGB

SCALE: 1" = 20'-0"

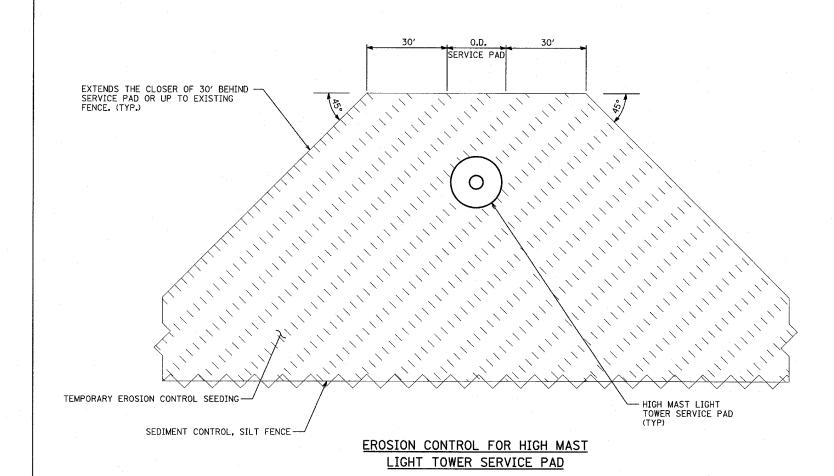

60A23

NOTES:

- 1. THE CONTRACTOR MUST COORDINATE THE USE, REPAIR, AND REMOVAL OF ANY EXISTING EROSION CONTROL ITEMS FROM PREVIOUS CONTRACTS LOCATED WITHIN THE PROPOSED LIMITS OF THIS CONTRACT AT THE APPROVAL OF THE ENGINEER. HOWEVER, QUANTITIES FOR FULL REPLACEMENT OF ALL EROSION CONTROL ITEMS HAVE BEEN INCLUDED IF NECESSARY.
- 2. THE CONTRACTOR MAY ONLY MOVE EXISTING EROSION CONTROL ITEMS WITH THE PERMISSION OF THE ENGINEER.

DRAWN BY: CBS

CHECKED BY: TGB


REVISIONS
NAME DATE
F.A.I. 94 (DAN RYAN EXPRESSWAY)
I-57 to 71st STREET

EROSION CONTROL DETAILS

DATE: JANUARY 9, 2007

SCALE: NO SCALE

TYLININTERNATIONAL

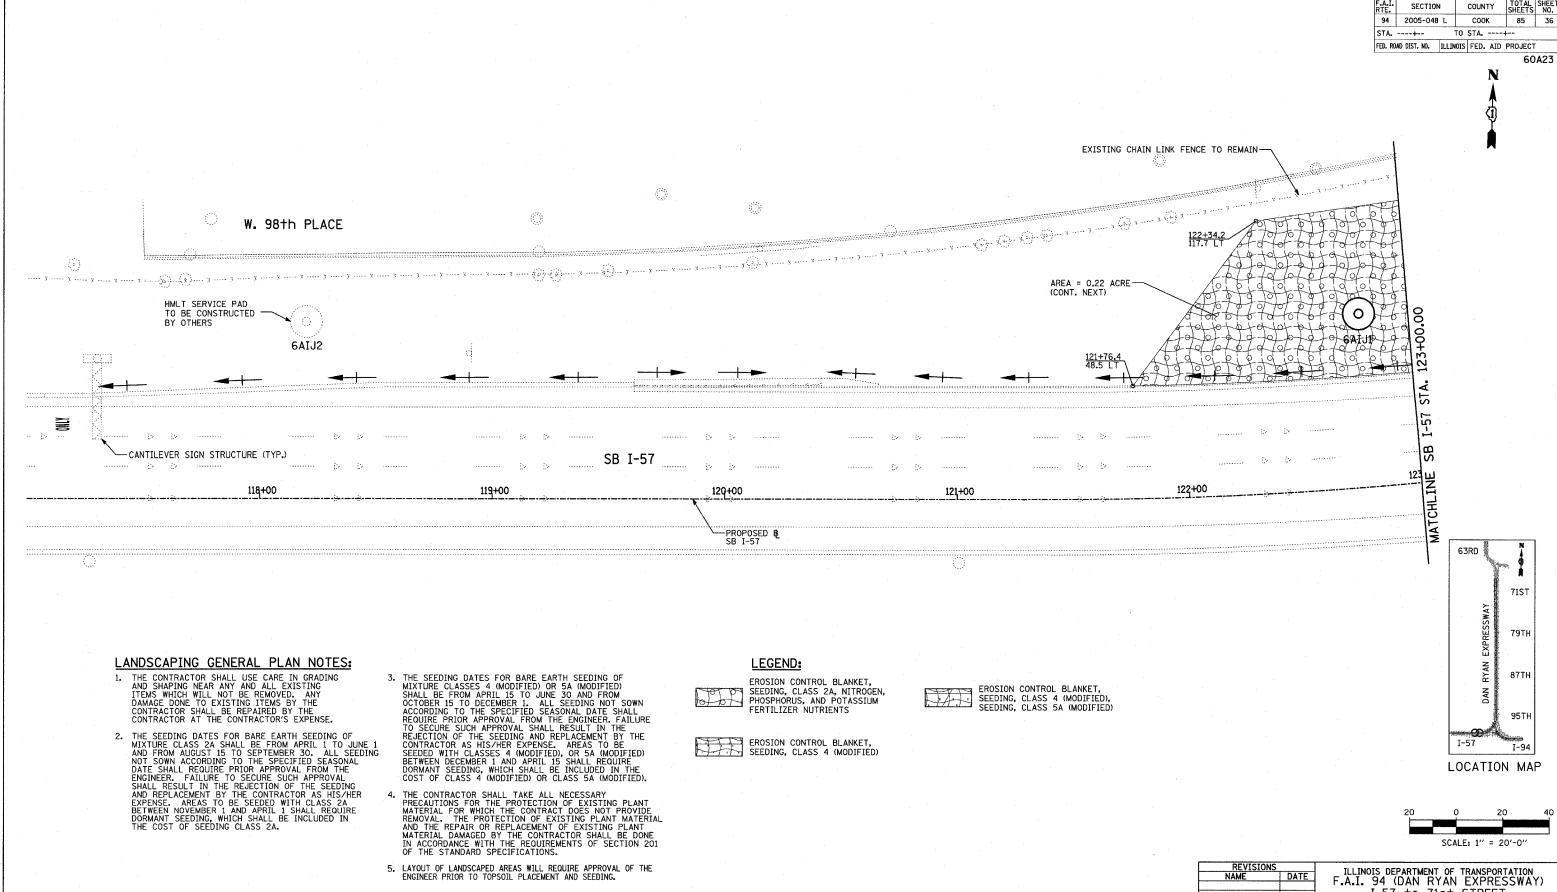

I-57 to 71st STREET

LANDSCAPING PLAN

SB I-57


STA. 117+00.00 TO 123+00.00

(SHEET 1 OF 27)

SCALE: 1"=20' DRAWN BY: CBS

DATE: JANUARY 9, 2007 CHECKED BY: TGB


TYLININTERNATIONAL

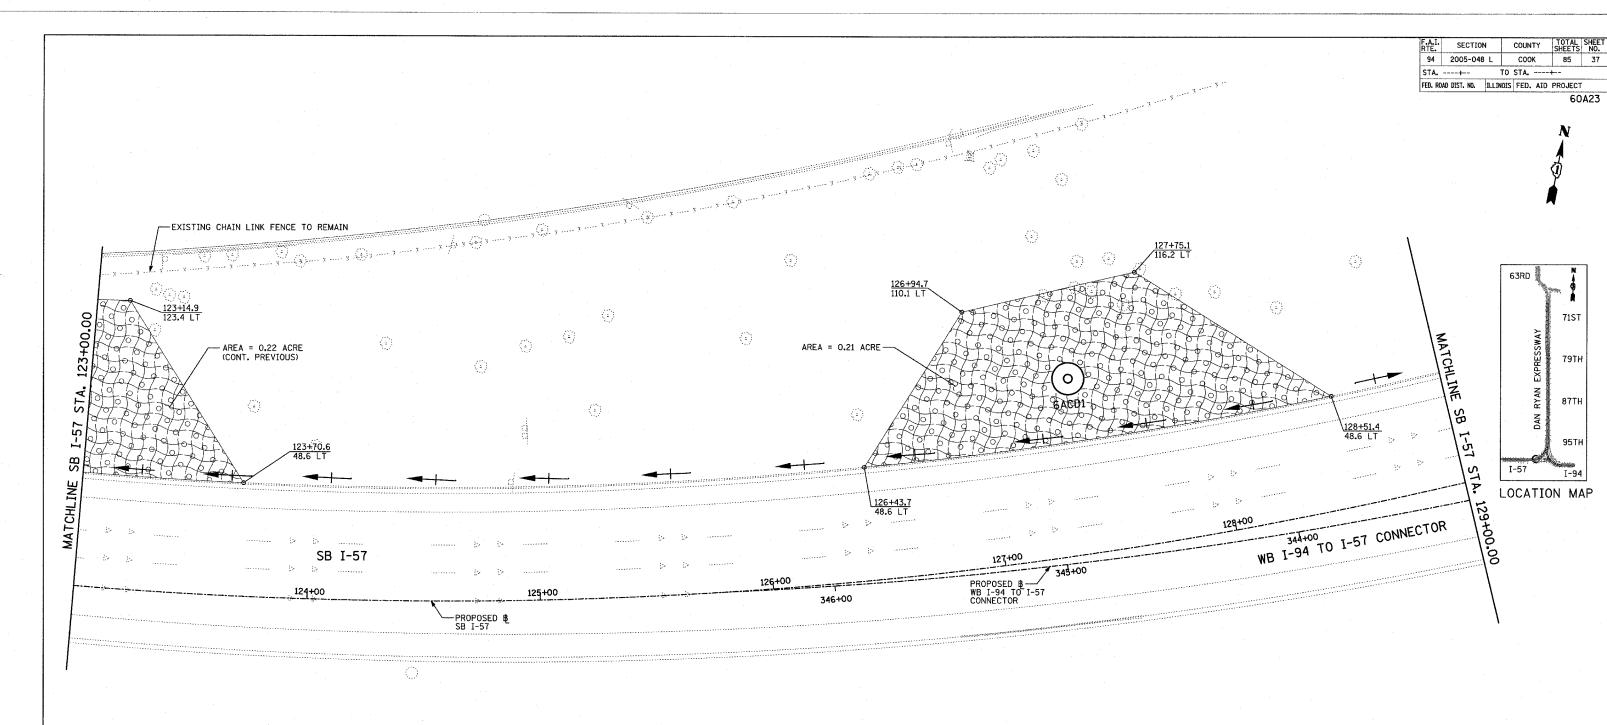


LANDSCAPING GENERAL PLAN NOTES:

- 1. THE CONTRACTOR SHALL USE CARE IN GRADING AND SHAPING NEAR ANY AND ALL EXISTING ITEMS WHICH WILL NOT BE REMOVED. ANY DAMAGE DONE TO EXISTING ITEMS BY THE CONTRACTOR SHALL BE REPAIRED BY THE CONTRACTOR AT THE CONTRACTOR
- 2. THE SEEDING DATES FOR BARE EARTH SEEDING OF MIXTURE CLASS 2A SHALL BE FROM APRIL 1 TO JUNE 1 AND FROM AUGUST 15 TO SEPTEMBER 3O. ALL SEEDING NOT SOWN ACCORDING TO THE SPECIFIED SEASONAL DATE SHALL REQUIRE PRIOR APPROVAL FROM THE ENGINEER. FAILURE TO SECURE SUCH APPROVAL SHALL RESULT IN THE REJECTION OF THE SEEDING AND REPLACEMENT BY THE CONTRACTOR AS HIS/HER EXPENSE. AREAS TO BE SEEDED WITH CLASS 2A BETWEEN NOVEMBER 1 AND APRIL 1 SHALL REQUIRE DORMANT SEEDING, WHICH SHALL BE INCLUDED IN THE COST OF SEEDING CLASS 2A.
- 3. THE SEEDING DATES FOR BARE EARTH SEEDING OF MIXTURE CLASSES 4 (MODIFIED) OR 5A (MODIFIED) SHALL BE FROM APRIL 15 TO JUNE 30 AND FROM OCTOBER 15 TO DECEMBER 1. ALL SEEDING NOT SOWN ACCORDING TO THE SPECIFIED SEASONAL DATE SHALL REQUIRE PRIOR APPROVAL FROM THE ENGINEER. FAILURE TO SECURE SUCH APPROVAL SHALL RESULT IN THE REJECTION OF THE SEEDING AND REPLACEMENT BY THE CONTRACTOR AS HIS/HER EXPENSE. AREAS TO BE SEEDED WITH CLASSES 4 (MODIFIED), OR 5A (MODIFIED) BETWEEN DECEMBER 1 AND APRIL 15 SHALL REQUIRE DORMANT SEEDING, WHICH SHALL BE INCLUDED IN THE COST OF CLASS 4 (MODIFIED) OR CLASS 5A (MODIFIED).
 - 4. THE CONTRACTOR SHALL TAKE ALL NECESSARY
 PRECAUTIONS FOR THE PROTECTION OF EXISTING PLANT
 MATERIAL FOR WHICH THE CONTRACT DOES NOT PROVIDE
 REMOVAL. THE PROTECTION OF EXISTING PLANT MATERIAL
 AND THE REPAIR OR REPLACEMENT OF EXISTING PLANT
 MATERIAL DAMAGED BY THE CONTRACTOR SHALL BE DONE
 IN ACCORDANCE WITH THE REQUIREMENTS OF SECTION 201
 OF THE STANDARD SPECIFICATIONS.
 - 5. LAYOUT OF LANDSCAPED AREAS WILL REQUIRE APPROVAL OF THE ENGINEER PRIOR TO TOPSOIL PLACEMENT AND SEEDING.


LEGEND:

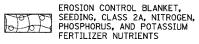

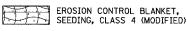



EROSION CONTROL BLANKET, SEEDING, CLASS 4 (MODIFIED), SEEDING, CLASS 5A (MODIFIED)

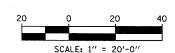

CHECKED BY: TGB


DATE: JANUARY 9, 2007

LEGEND:

EROSION CONTROL BLANKET, SEEDING, CLASS 2A, NITROGEN, PHOSPHORUS, AND POTASSIUM FERTILIZER NUTRIENTS

EROSION CONTROL BLANKET, SEEDING, CLASS 4 (MODIFIED), SEEDING, CLASS 5A (MODIFIED)

EROSION CONTROL BLANKET, SEEDING, CLASS 4 (MODIFIED)

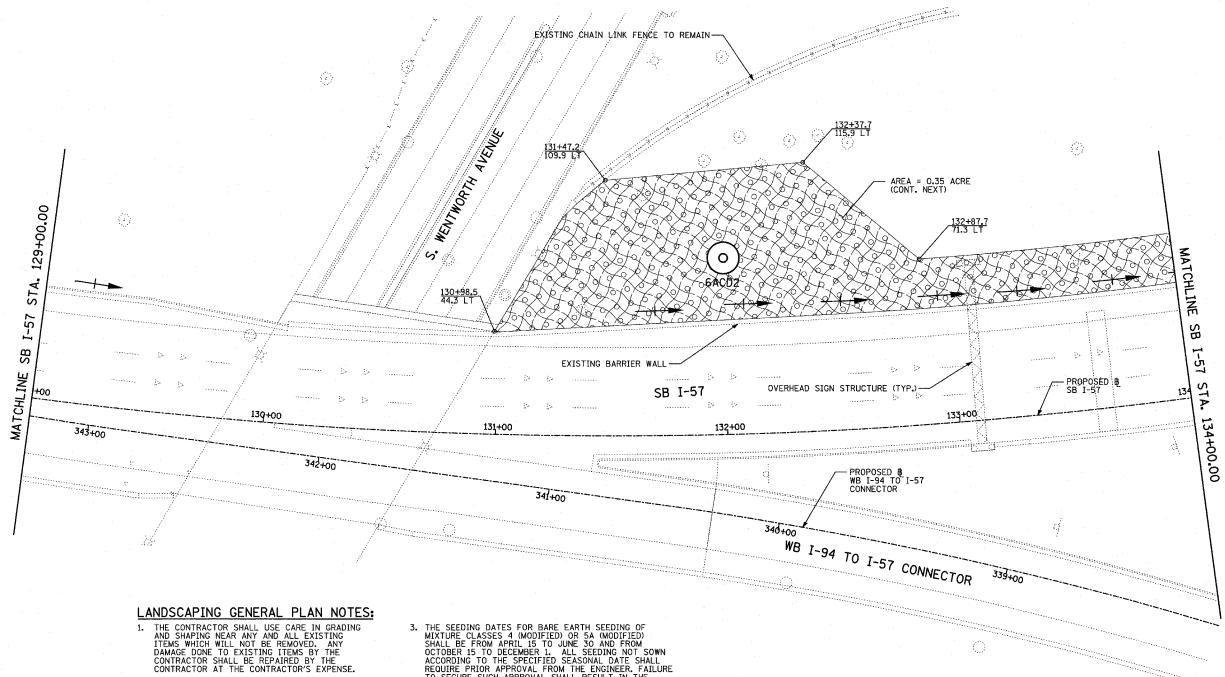

TOTAL SHEET SHEETS NO. F.A.I. SECTION 94 2005-048 L COUNTY COOK 85 38 STA. ----+--TO STA. ----+--FED. ROAD DIST. NO. ILLINOIS FED. AID PROJECT

60A23

71ST 79TH 87TH 95TF I-57 LOCATION MAP

SCALE: 1" = 20'-0"

ILLINOIS DEPARTMENT OF TRANSPORTATION F.A.I. 94 (DAN RYAN EXPRESSWAY) I-57 to 71st STREET LANDSCAPING PLAN

SB I-57 & WB I-94 TO I-57 CONNECTOR SB I-57 STA. 129+00.00 TO 134+00.00 (SHEET 3 OF 27)


SCALE: 1"=20" DATE: JANUARY 9, 2007

DRAWN BY: CBS CHECKED BY: TGB

- 2. THE SEEDING DATES FOR BARE EARTH SEEDING OF MIXTURE CLASS 2A SHALL BE FROM APRIL 1 TO JUNE 1 AND FROM AUGUST 15 TO SEPTEMBER 30. ALL SEEDING NOT SOWN ACCORDING TO THE SPECIFIED SEASONAL DATE SHALL REQUIRE PRIOR APPROVAL FROM THE ENGINEER. FAILURE TO SECURE SUCH APPROVAL SHALL RESULT IN THE REJECTION OF THE SEEDING AND REPLACEMENT BY THE CONTRACTOR AS HIS/HER EXPENSE. AREAS TO BE SEEDED WITH CLASS 2A BETWEEN NOVEMBER 1 AND APRIL 1 SHALL REQUIRE DORMANT SEEDING, WHICH SHALL BE INCLUDED IN THE COST OF SEEDING CLASS 2A.
- 3. THE SEEDING DATES FOR BARE EARTH SEEDING OF MIXTURE CLASSES 4 (MODIFIED) OR 5A (MODIFIED) SHALL BE FROM APRIL 15 TO JUNE 30 AND FROM OCTOBER 15 TO DECEMBER 1. ALL SEEDING NOT SOWN ACCORDING TO THE SPECIFIED SEASONAL DATE SHALL REQUIRE PRIOR APPROVAL FROM THE ENGINEER. FAILURE TO SECURE SUCH APPROVAL SHALL RESULT IN THE REJECTION OF THE SEEDING AND REPLACEMENT BY THE CONTRACTOR AS HIS/HER EXPENSE. AREAS TO BE SEEDED WITH CLASSES 4 (MODIFIED), OR 5A (MODIFIED) BETWEEN DECEMBER 1 AND APRIL 15 SHALL REQUIRE DORMANT SEEDING, WHICH SHALL BE INCLUDED IN THE COST OF CLASS 4 (MODIFIED) OR CLASS 5A (MODIFIED).
 - 4. THE CONTRACTOR SHALL TAKE ALL NECESSARY PRECAUTIONS FOR THE PROTECTION OF EXISTING PLANT MATERIAL FOR WHICH THE CONTRACT DOES NOT PROVIDE REMOVAL. THE PROTECTION OF EXISTING PLANT MATERIAL AND THE REPAIR OR REPLACEMENT OF EXISTING PLANT MATERIAL DAMAGED BY THE CONTRACTOR SHALL BE DONE IN ACCORDANCE WITH THE REQUIREMENTS OF SECTION 201 OF THE STANDARD SPECIFICATIONS.
 - LAYOUT OF LANDSCAPED AREAS WILL REQUIRE APPROVAL OF THE ENGINEER PRIOR TO TOPSOIL PLACEMENT AND SEEDING.

F.A.I.	SECTION	COUNTY	TOTAL	SHEE'S	NO.
94	2005-048	COOK	85	39	
STA. ----+-	TO STA. ----+-				
FED. ROAD DIST. NO.	ILLINOIS	FED. AID	PROJECT		
60A23					




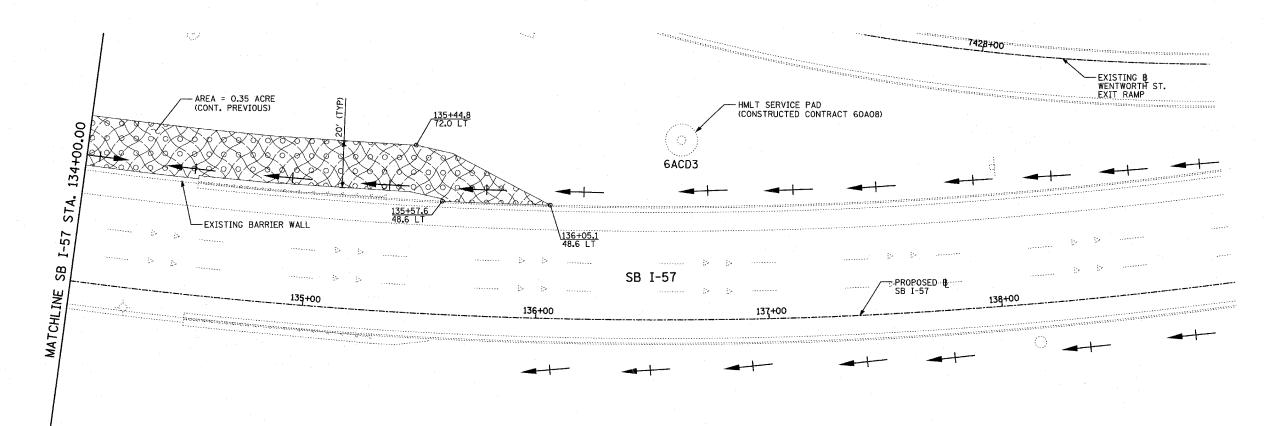


LANDSCAPING GENERAL PLAN NOTES:

- 1. THE CONTRACTOR SHALL USE CARE IN GRADING AND SHAPING NEAR ANY AND ALL EXISTING ITEMS WHICH WILL NOT BE REMOVED. ANY DAMAGE DONE TO EXISTING ITEMS BY THE CONTRACTOR SHALL BE REPAIRED BY THE CONTRACTOR AT THE CONTRACTOR
- 2. THE SEEDING DATES FOR BARE EARTH SEEDING OF MIXTURE CLASS 2A SHALL BE FROM APRIL 1 TO JUNE 1 AND FROM AUGUST 15 TO SEPTEMBER 30. ALL SEEDING NOT SOWN ACCORDING TO THE SPECIFIED SEASONAL DATE SHALL REQUIRE PRIOR APPROVAL FROM THE ENGINEER. FAILURE TO SECURE SUCH APPROVAL SHALL RESULT IN THE REJECTION OF THE SEEDING AND REPLACEMENT BY THE CONTRACTOR AS HIS/HER EXPENSE. AREAS TO BE SEEDED WITH CLASS 2A BETWEEN NOVEMBER 1 AND APRIL 1 SHALL REQUIRE DORMANT SEEDING, WHICH SHALL BE INCLUDED IN THE COST OF SEEDING CLASS 2A.
- 3. THE SEEDING DATES FOR BARE EARTH SEEDING OF MIXTURE CLASSES 4 (MODIFIED) OR 5A (MODIFIED) SHALL BE FROM APRIL 15 TO JUNE 30 AND FROM OCTOBER 15 TO DECEMBER 1. ALL SEEDING NOT SOWN ACCORDING TO THE SPECIFIED SEASONAL DATE SHALL REQUIRE PRIOR APPROVAL FROM THE ENGINEER. FAILURE TO SECURE SUCH APPROVAL SHALL RESULT IN THE REJECTION OF THE SEEDING AND REPLACEMENT BY THE CONTRACTOR AS HIS/HER EXPENSE. AREAS TO BE SEEDED WITH CLASSES 4 (MODIFIED), OR 5A (MODIFIED) BETWEEN DECEMBER 1 AND APRIL 15 SHALL REQUIRE DORMANT SEEDING, WHICH SHALL BE INCLUDED IN THE COST OF CLASS 4 (MODIFIED) OR CLASS 5A (MODIFIED).
 - 4. THE CONTRACTOR SHALL TAKE ALL NECESSARY PRECAUTIONS FOR THE PROTECTION OF EXISTING PLANT MATERIAL FOR WHICH THE CONTRACT DOES NOT PROVIDE REMOVAL. THE PROTECTION OF EXISTING PLANT MATERIAL AND THE REPAIR OR REPLACEMENT OF EXISTING PLANT MATERIAL DAMAGED BY THE CONTRACTOR SHALL BE DONE IN ACCORDANCE WITH THE REQUIREMENTS OF SECTION 201 OF THE STANDARD SPECIFICATIONS.
 - 5. LAYOUT OF LANDSCAPED AREAS WILL REQUIRE APPROVAL OF THE ENGINEER PRIOR TO TOPSOIL PLACEMENT AND SEEDING.


LEGEND:

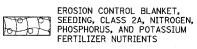

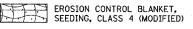



EROSION CONTROL BLANKET, SEEDING, CLASS 4 (MODIFIED), SEEDING, CLASS 5A (MODIFIED)

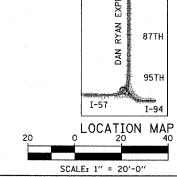

71ST

79TH

REVISIO NAME	NS	TI I
NAME	DATE	ILI F.A.
		SCALE:

ILLINOIS DEPARTMENT OF TRANSPORTATION
F.A.I. 94 (DAN RYAN EXPRESSWAY)
I-57 to 71st STREET
LANDSCAPING PLAN
SB I-57

STA. 134+00.00 TO 144+00.00 (SHEET 4 OF 27)

SCALE: 1"=20'
DATE: JANUARY 9, 2007

DRAWN BY: CBS
CHECKED BY: TGB

SECTION 94 2005-048 L COOK STA. ---+--TO STA. ----+-FED. ROAD DIST. NO. ILLINOIS FED. AID PROJECT

60A23


LAFAYETTE AVE. --- y ----- y -----EXISTING CHAIN LINK FENCE TO REMAIN -AREA = 0.21 ACRE SB I-94 (DAN RYAN EXPWY) SB I-57 - PROPOSED & SB I-57 OVERHEAD SIGN STRUCTURE (TYP.)-1172+00 149+00 152+00 1173+00 159+00 151+00 SB I-94 (BISHOP FORD FWY) - PROPOSED # SB I-57 (FORD)


LANDSCAPING GENERAL PLAN NOTES:

- THE CONTRACTOR SHALL USE CARE IN GRADING AND SHAPING NEAR ANY AND ALL EXISTING ITEMS WHICH WILL NOT BE REMOVED. ANY DAMAGE DONE TO EXISTING ITEMS BY THE CONTRACTOR SHALL BE REPAIRED BY THE CONTRACTOR AT THE CONTRACTOR'S EXPENSE.
- 2. THE SEEDING DATES FOR BARE EARTH SEEDING OF MIXTURE CLASS 2A SHALL BE FROM APRIL 1 TO JUNE 1 AND FROM AUGUST 15 TO SEPTEMBER 30. ALL SEEDING NOT SOWN ACCORDING TO THE SPECIFIED SEASONAL DATE SHALL REQUIRE PRIOR APPROVAL FROM THE ENGINEER. FAILURE TO SECURE SUCH APPROVAL SHALL RESULT IN THE REJECTION OF THE SEEDING AND REPLACEMENT BY THE CONTRACTOR AS HIS/HER EXPENSE. AREAS TO BE SEEDED WITH CLASS 2A BETWEEN NOVEMBER 1 AND APRIL 1 SHALL REQUIRE DORMANT SEEDING, WHICH SHALL BE INCLUDED IN THE COST OF SEEDING CLASS 2A.
- 3. THE SEEDING DATES FOR BARE EARTH SEEDING OF MIXTURE CLASSES 4 (MODIFIED) OR 5A (MODIFIED) SHALL BE FROM APRIL 15 TO JUNE 30 AND FROM OCTOBER 15 TO DECEMBER 1. ALL SEEDING NOT SOWN ACCORDING TO THE SPECIFIED SEASONAL DATE SHALL REQUIRE PRIOR APPROVAL FROM THE ENGINEER. FAILURE TO SECURE SUCH APPROVAL SHALL RESULT IN THE REJECTION OF THE SEEDING AND REPLACEMENT BY THE CONTRACTOR AS HIS/HER EXPENSE. AREAS TO BE SEEDED WITH CLASSES 4 (MODIFIED), OR 5A (MODIFIED) BETWEEN DECEMBER 1 AND APRIL 15 SHALL REQUIRE DORMANT SEEDING, WHICH SHALL BE INCLUDED IN THE COST OF CLASS 4 (MODIFIED) OR CLASS 5A (MODIFIED).

- THE CONTRACTOR SHALL TAKE ALL NECESSARY PRECAUTIONS FOR THE PROTECTION OF EXISTING PLANT MATERIAL FOR WHICH THE CONTRACT DOES NOT PROVIDE REMOVAL. THE PROTECTION OF EXISTING PLANT MATERIAL AND THE REPAIR OR REPLACEMENT OF EXISTING PLANT MATERIAL DAMAGED BY THE CONTRACTOR SHALL BE DONE IN ACCORDANCE WITH THE REQUIREMENTS OF SECTION 201 OF THE STANDARD SPECIFICATIONS.
- 5. LAYOUT OF LANDSCAPED AREAS WILL REQUIRE APPROVAL OF THE ENGINEER PRIOR TO TOPSOIL PLACEMENT AND SEEDING.

LEGEND:

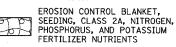


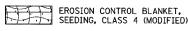



CTA RED LINE

EROSION CONTROL BLANKET, SEEDING, CLASS 4 (MODIFIED), SEEDING, CLASS 5A (MODIFIED)

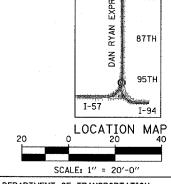

63RD

7151

TILITMOTS DE		REVISIONS
ILLINOIS DE F.A.I. 94	DATE	NAME
I-57		VIII. 40-44-11-11-11-11-11-11-11-11-11-11-11-11-
STA. 1		
214. I		


DEPARTMENT OF TRANSPORTATION (DAN RYAN EXPRESSWAY) 7 to 71st STREET LANDSCAPING PLAN SB I-57


148+00.00 TO 153+00.00 (SHEET 5 OF 27)

SCALE: 1"=20' DATE: JANUARY 9, 2007

TYLININTERNATIONAL

CHECKED BY: TGB

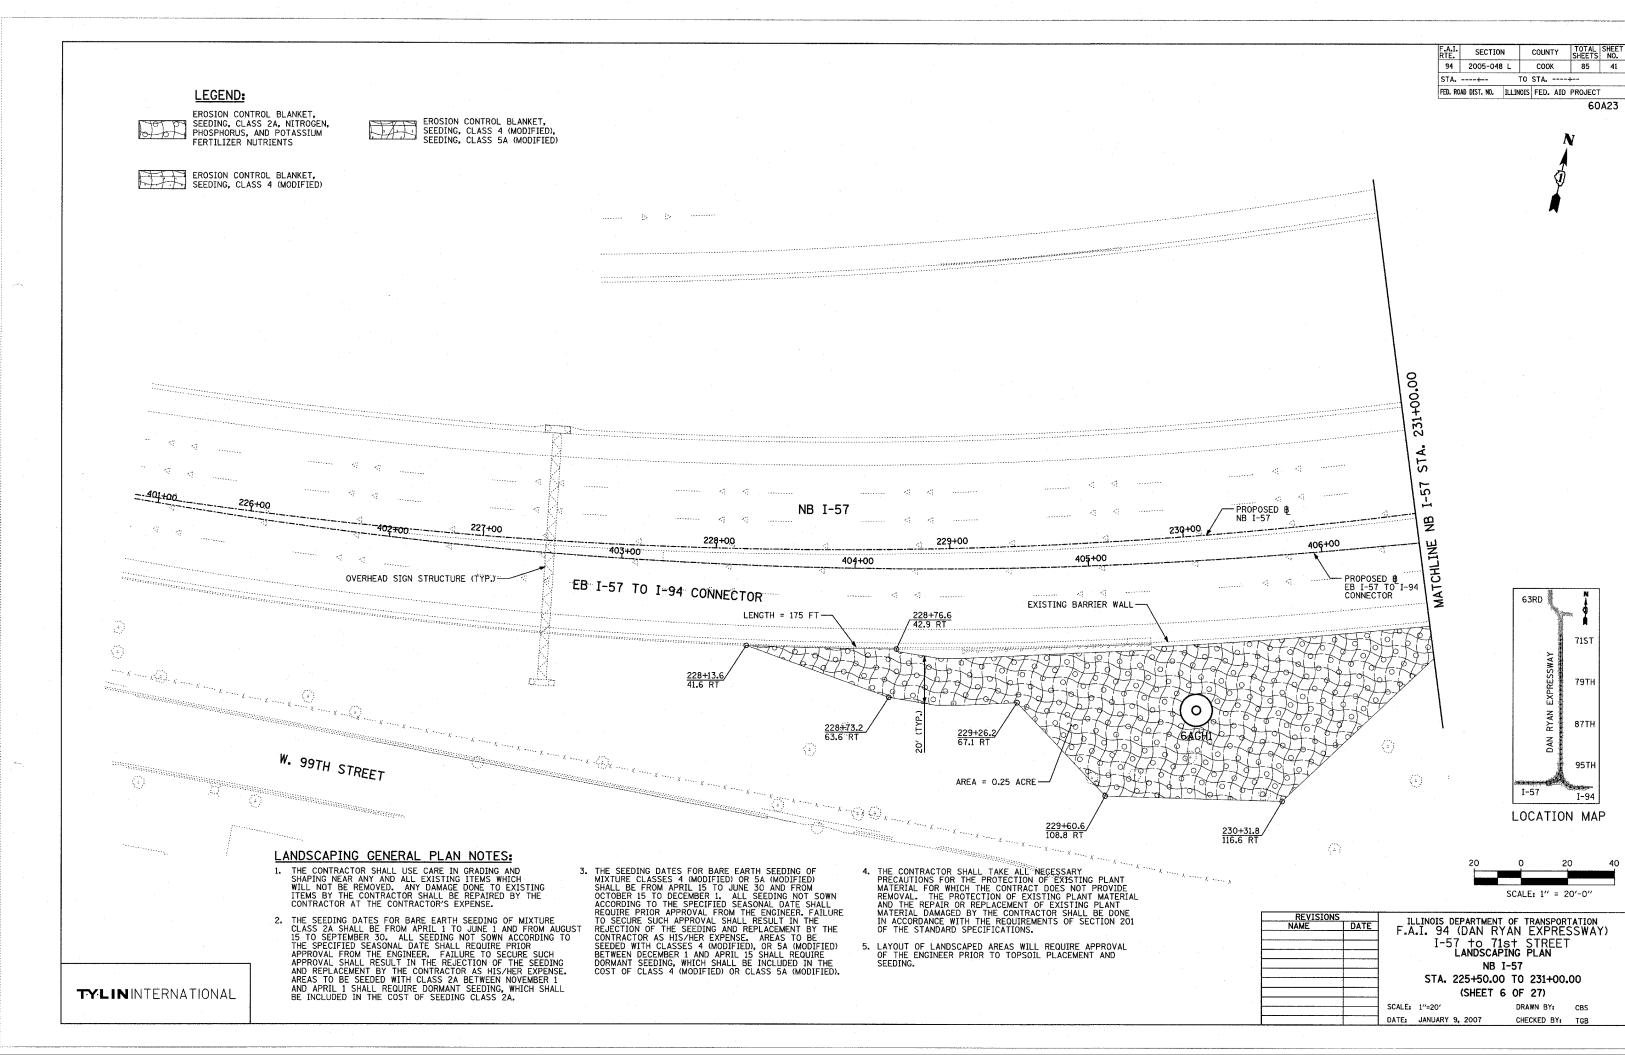

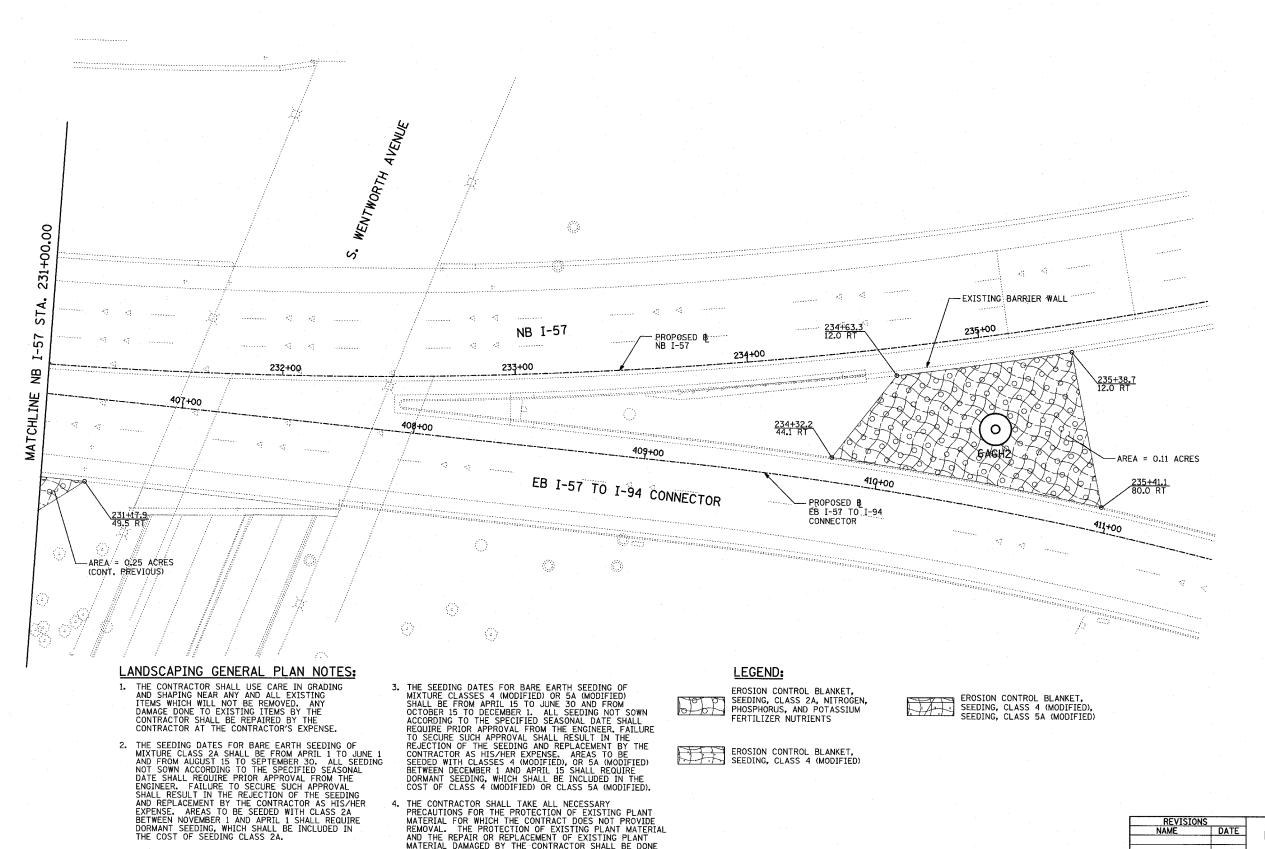

TOTAL SHEET SHEETS NO. RTE. SECTION COUNTY соок 94 2005-048 L 85 42 STA. ---+--TO STA. ----+ FED. ROAD DIST. NO. ILLINOIS FED. AID PROJECT

60A23

63RD 71ST I-57 I-94 LOCATION MAP

ILLINOIS DEPARTMENT OF TRANSPORTATION
F.A.I. 94 (DAN RYAN EXPRESSWAY) I-57 to 71st STREET LANDSCAPING PLAN - NB I-57 AND EB I-57 TO I-94 CONNECTOR, NB I-57 STA. 231+00.00 TO 236+00.00.

(SHEET 7 OF 27) SCALE: 1"=20"

DATE: JANUARY 9, 2007

REVISIONS NAME


DRAWN BY: CHECKED BY: TGB


SCALE: 1" = 20'-0"


TYLININTERNATIONAL

THE CONTRACTOR SHALL TAKE ALL NECESSARY PRECAUTIONS FOR THE PROTECTION OF EXISTING PLANT MATERIAL FOR WHICH THE CONTRACT DOES NOT PROVIDE REMOVAL. THE PROTECTION OF EXISTING PLANT MATERIAL AND THE REPAIR OR REPLACEMENT OF EXISTING PLANT MATERIAL DAMAGED BY THE CONTRACTOR SHALL BE DONE IN ACCORDANCE WITH THE REQUIREMENTS OF SECTION 201 OF THE STANDARD SPECIFICATIONS.


5. LAYOUT OF LANDSCAPED AREAS WILL REQUIRE APPROVAL OF THE ENGINEER PRIOR TO TOPSOIL PLACEMENT AND SEEDING.

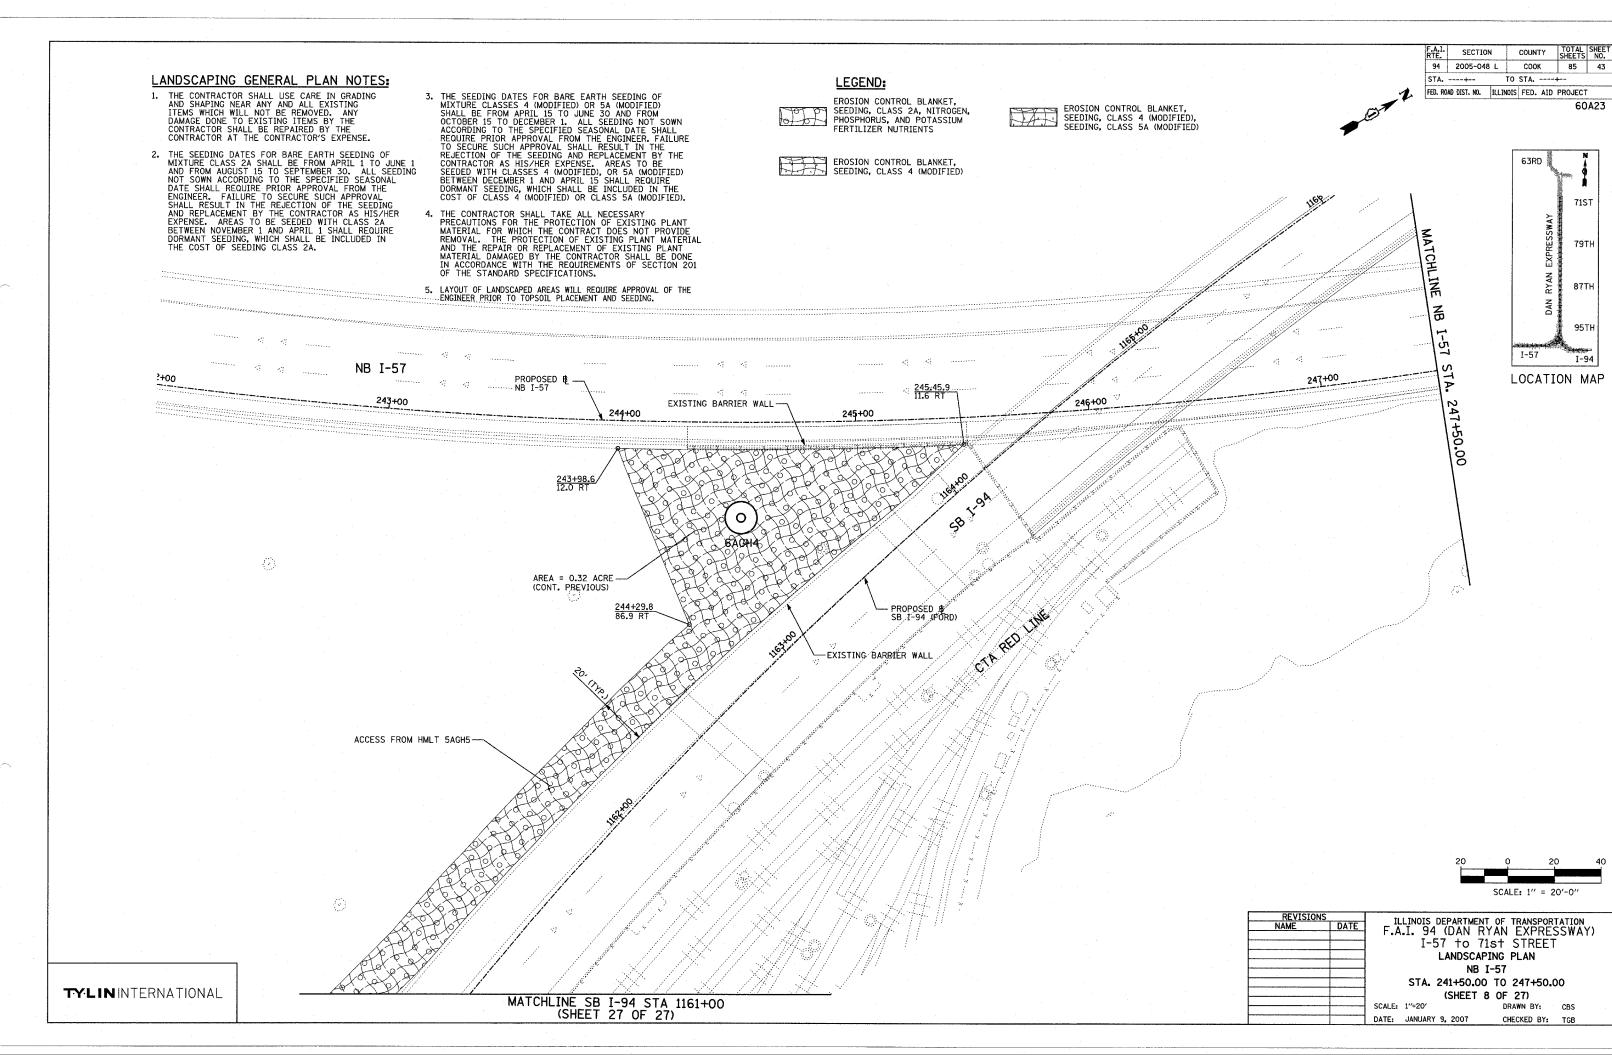

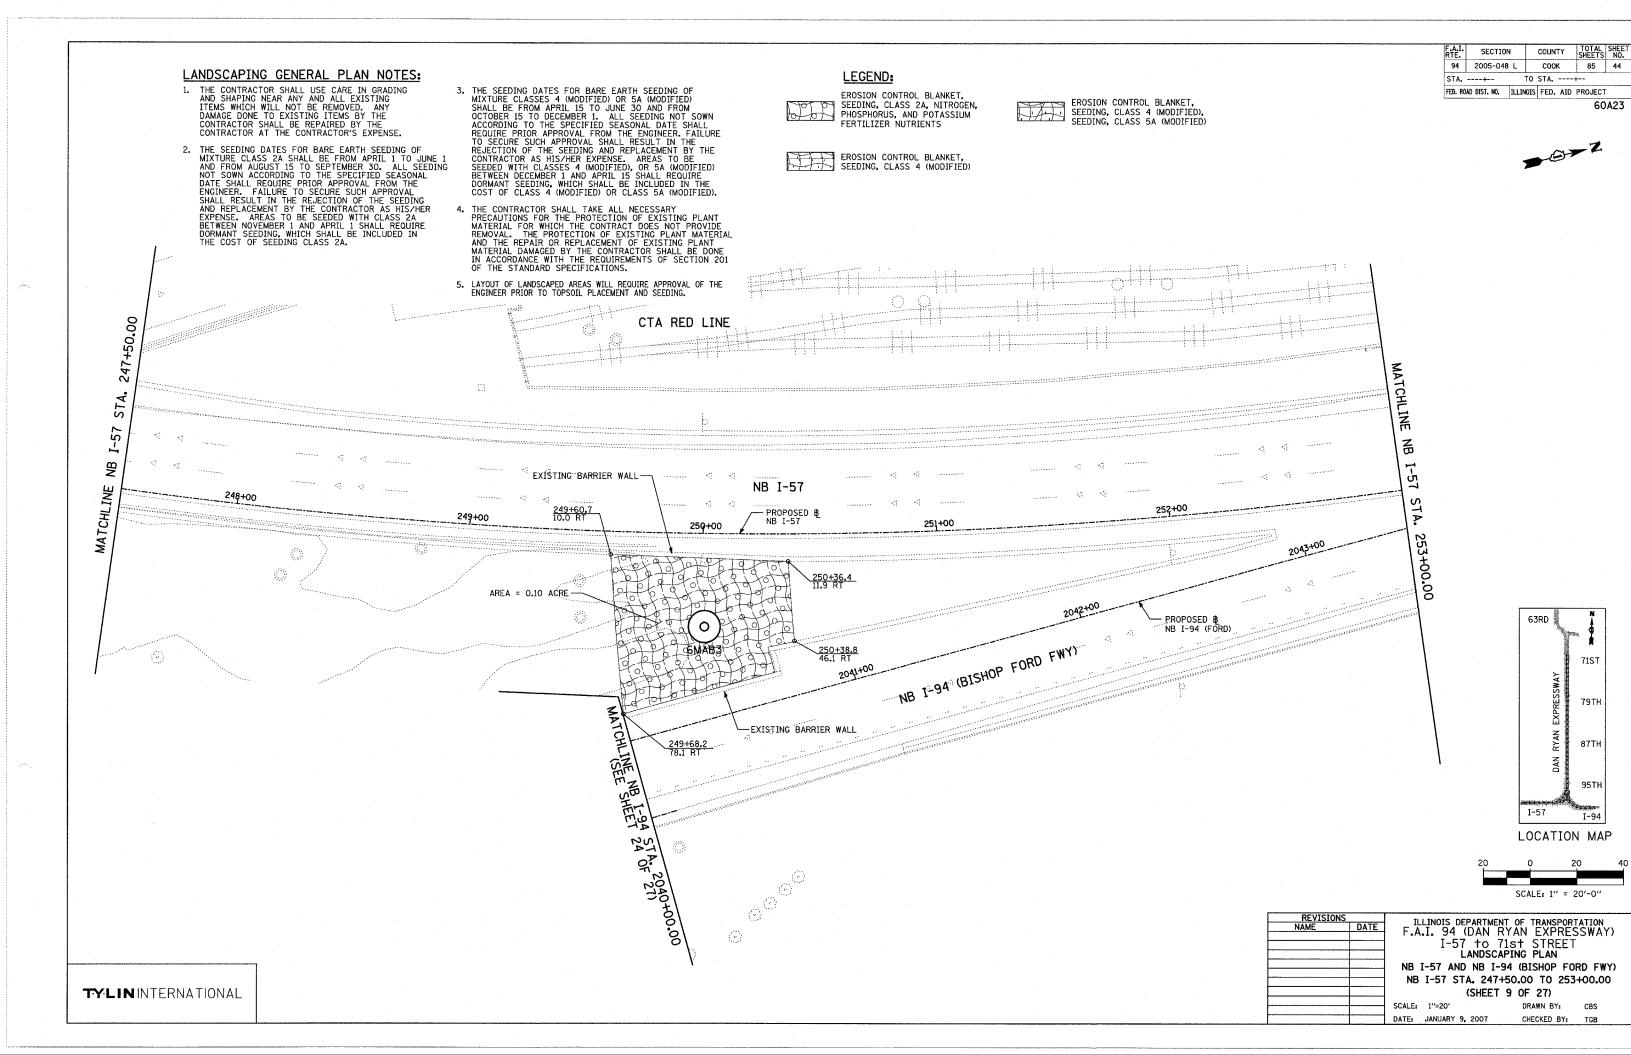

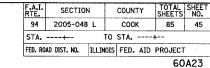



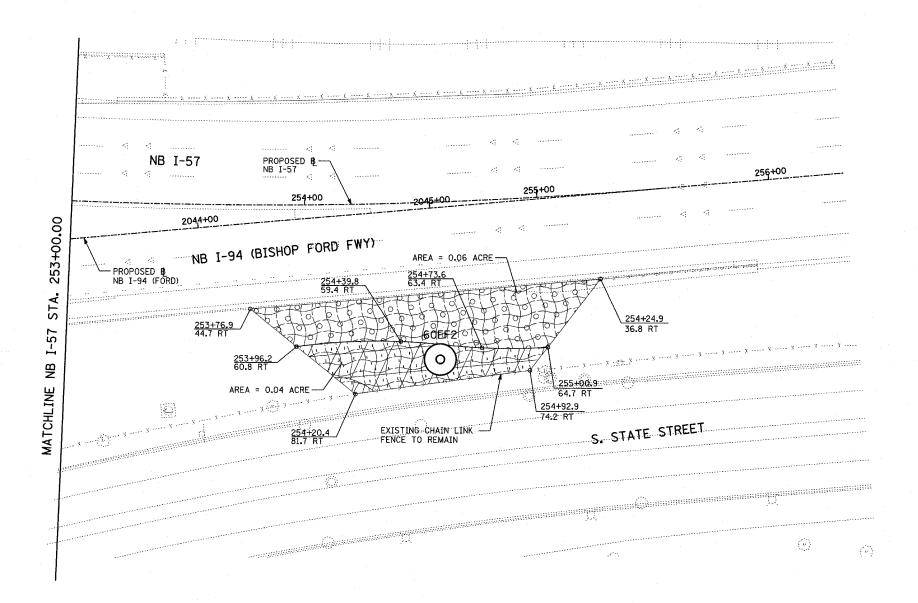

LANDSCAPING GENERAL PLAN NOTES:


- 1. THE CONTRACTOR SHALL USE CARE IN GRADING AND SHAPING NEAR ANY AND ALL EXISTING ITEMS WHICH WILL NOT BE REMOVED. ANY DAMAGE DONE TO EXISTING ITEMS BY THE CONTRACTOR SHALL BE REPAIRED BY THE CONTRACTOR AT THE CONTRACTOR
- 2. THE SEEDING DATES FOR BARE EARTH SEEDING OF MIXTURE CLASS 2A SHALL BE FROM APRIL 1 TO JUNE 1 AND FROM AUGUST 15 TO SEPTEMBER 30. ALL SEEDING NOT SOWN ACCORDING TO THE SPECIFIED SEASONAL DATE SHALL REQUIRE PRIOR APPROVAL FROM THE ENGINEER, FAILURE TO SECURE SUCH APPROVAL SHALL RESULT IN THE REJECTION OF THE SEEDING AND REPLACEMENT BY THE CONTRACTOR AS HIS/HER EXPENSE. AREAS TO BE SEEDED WITH CLASS 2A BETWEEN NOVEMBER 1 AND APRIL 1 SHALL REQUIRE DORMANT SEEDING, WHICH SHALL BE INCLUDED IN THE COST OF SEEDING CLASS 2A.
- 3. THE SEEDING DATES FOR BARE EARTH SEEDING OF MIXTURE CLASSES 4 (MODIFIED) OR 5A (MODIFIED) SHALL BE FROM APRIL 15 TO JUNE 30 AND FROM OCTOBER 15 TO DECEMBER 1. ALL SEEDING NOT SOWN ACCORDING TO THE SPECIFIED SEASONAL DATE SHALL REQUIRE PRIOR APPROVAL FROM THE ENGINEER. FAILURE TO SECURE SUCH APPROVAL SHALL RESULT IN THE REJECTION OF THE SEEDING AND REPLACEMENT BY THE CONTRACTOR AS HIS/HER EXPENSE. AREAS TO BE SEEDED WITH CLASSES 4 (MODIFIED), OR 5A (MODIFIED) BETWEEN DECEMBER 1 AND APRIL 15 SHALL REQUIRE DORMANT SEEDING, WHICH SHALL BE INCLUDED IN THE COST OF CLASS 4 (MODIFIED) OR CLASS 5A (MODIFIED).
 - 4. THE CONTRACTOR SHALL TAKE ALL NECESSARY
 PRECAUTIONS FOR THE PROTECTION OF EXISTING PLANT
 MATERIAL FOR WHICH THE CONTRACT DOES NOT PROVIDE
 REMOVAL. THE PROTECTION OF EXISTING PLANT MATERIAL
 AND THE REPAIR OR REPLACEMENT OF EXISTING PLANT
 MATERIAL DAMAGED BY THE CONTRACTOR SHALL BE DONE
 IN ACCORDANCE WITH THE REQUIREMENTS OF SECTION 201
 OF THE STANDARD SPECIFICATIONS OF THE STANDARD SPECIFICATIONS.
 - 5. LAYOUT OF LANDSCAPED AREAS WILL REQUIRE APPROVAL OF THE ENGINEER PRIOR TO TOPSOIL PLACEMENT AND SEEDING.

LEGEND:

EROSION CONTROL BLANKET, SEEDING, CLASS 2A, NITROGEN, PHOSPHORUS, AND POTASSIUM FERTILIZER NUTRIENTS


EROSION CONTROL BLANKET, SEEDING, CLASS 4 (MODIFIED), SEEDING, CLASS 5A (MODIFIED)


EROSION CONTROL BLANKET, SEEDING, CLASS 4 (MODIFIED)

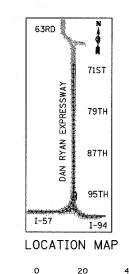

SCALE: 1" = 20'-0"

REVISIONS NAME ILLINOIS DEPARTMENT OF TRANSPORTATION F.A.I. 94 (DAN RYAN EXPRESSWAY) I-57 to 71st STREET LANDSCAPING PLAN NB I-57 AND NB I-94, NB I-57 STA. 253+00.00 TO NB I-94 STA. 2207+00.00 (SHEET 10 OF 27) DRAWN BY: DATE: JANUARY 9, 2007 CHECKED BY: TGB

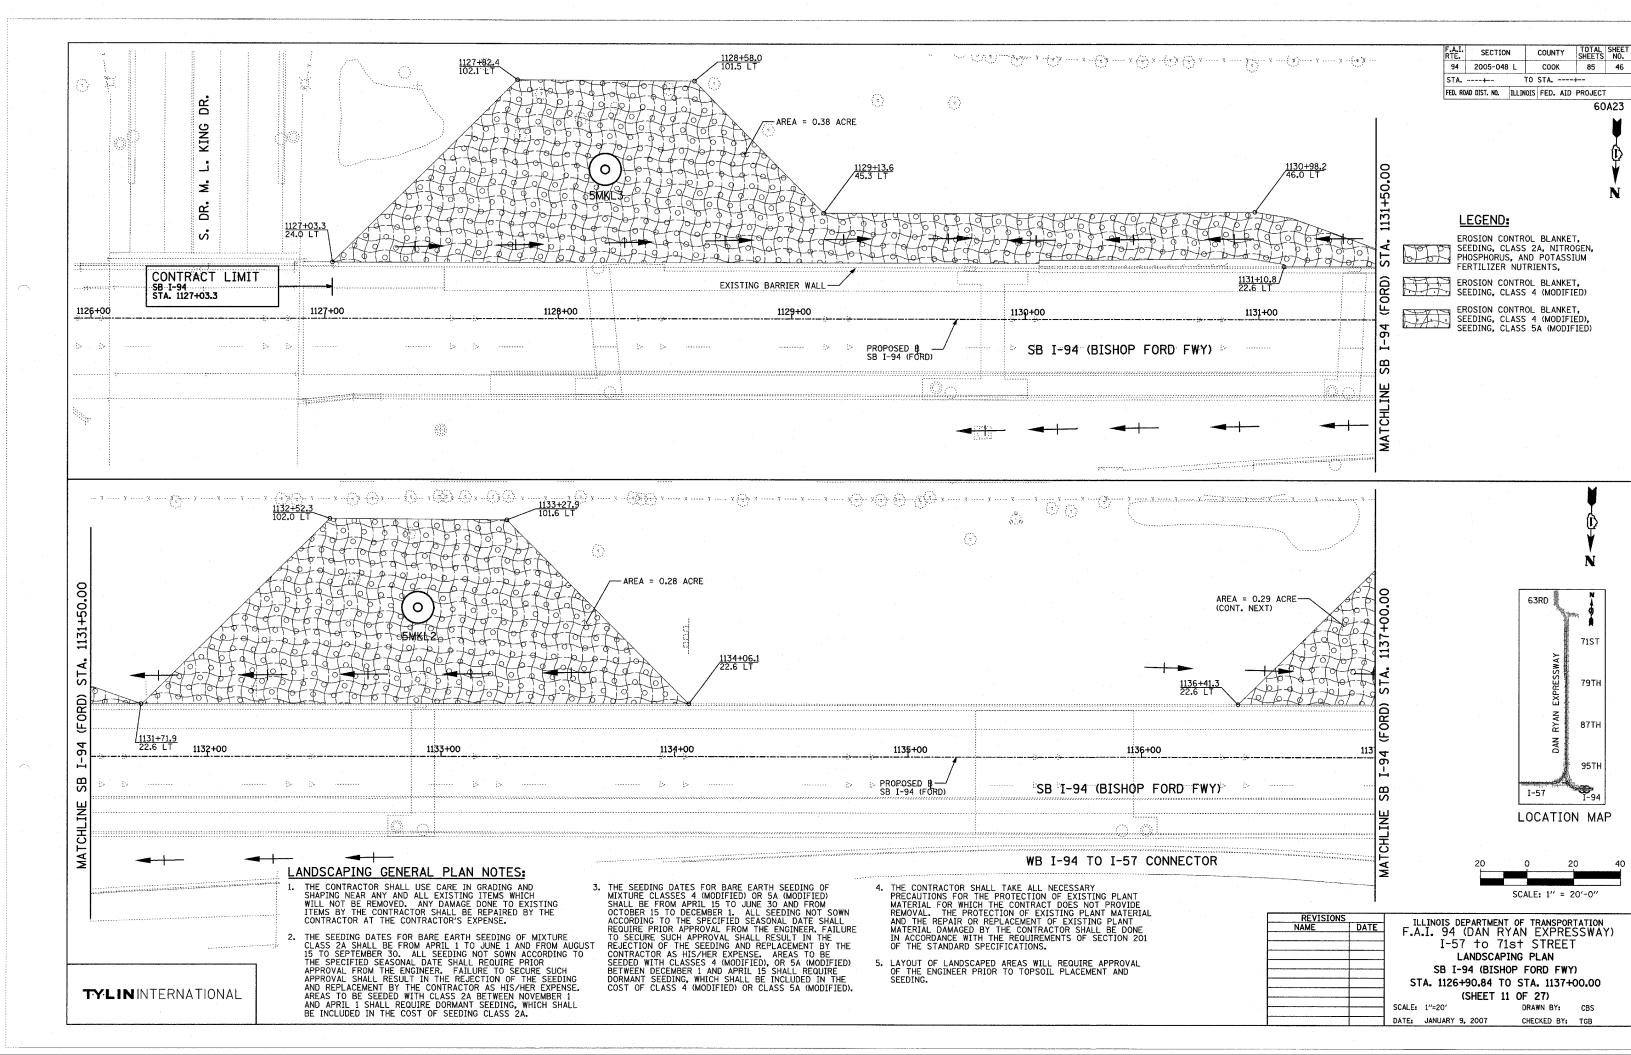

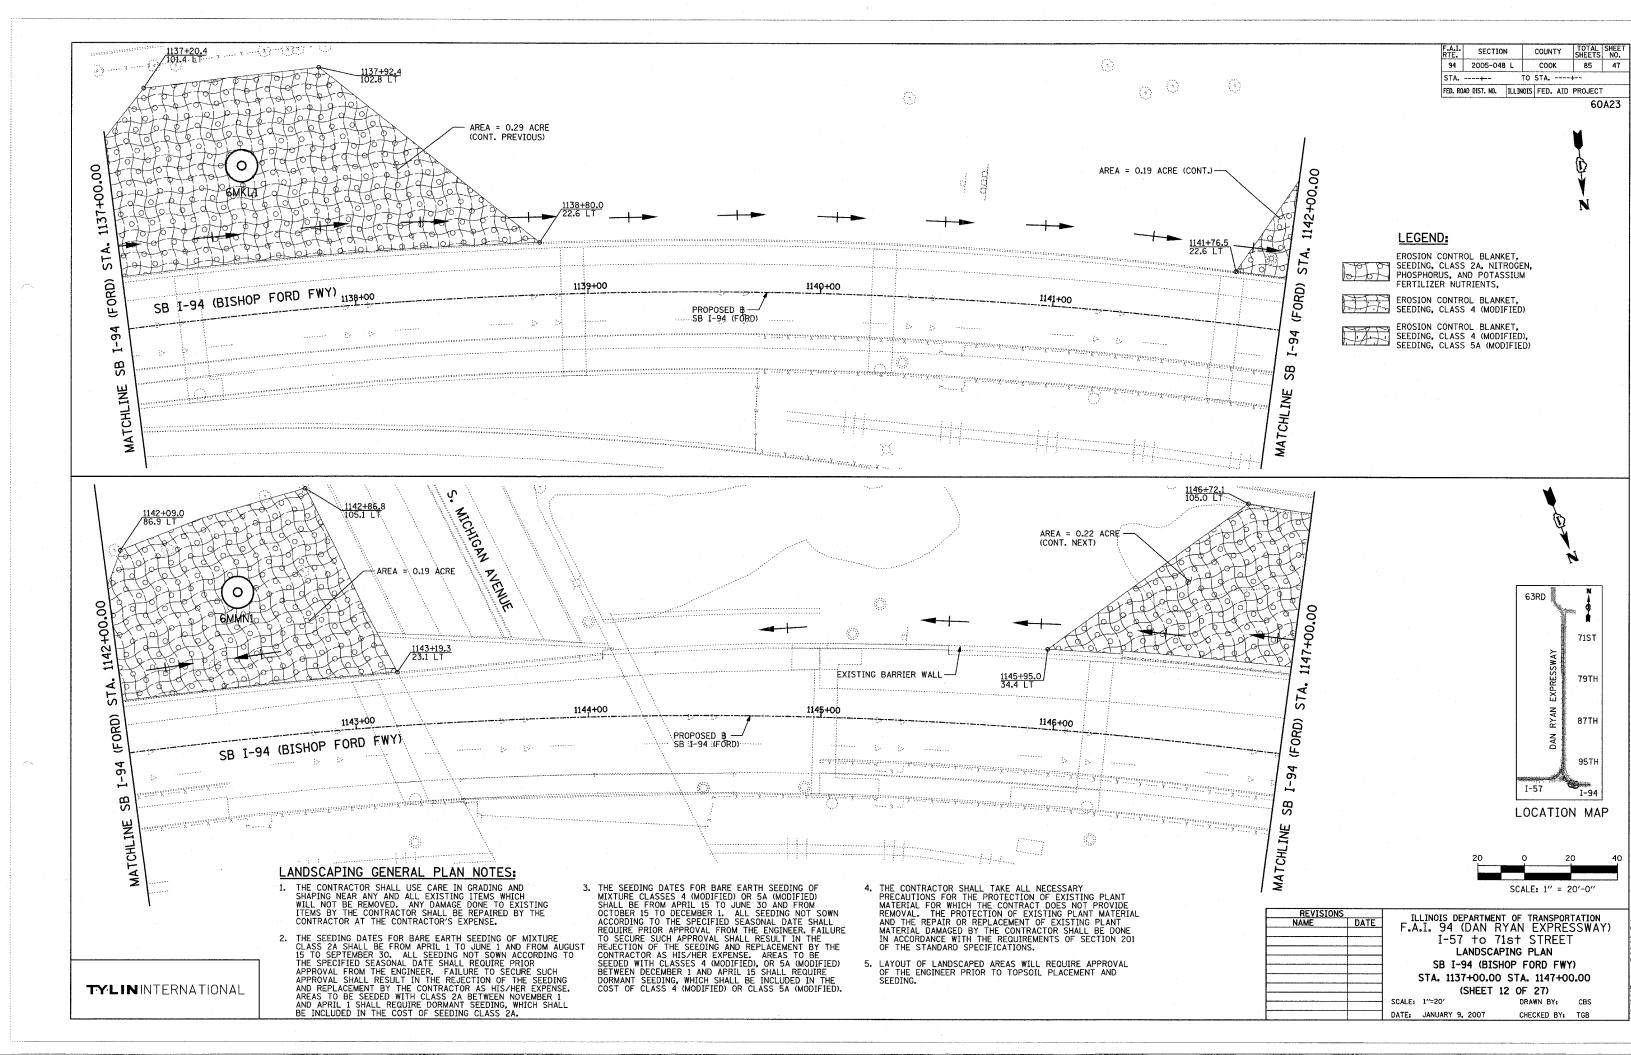

TOTAL SHEE SHEETS NO. SECTION COUNTY COOK 94 2005-048 L 85 48 STA. ----+--TO STA. ----+--FED. ROAD DIST. NO. ILLINOIS FED. AID PROJECT




60A23

LEGEND:

EROSION CONTROL BLANKET, SEEDING, CLASS 2A, NITROGEN, PHOSPHORUS, AND POTASSIUM FERTILIZER NUTRIENTS,


EROSION CONTROL BLANKET, SEEDING, CLASS 4 (MODIFIED)

EROSION CONTROL BLANKET, SEEDING, CLASS 4 (MODIFIED), SEEDING, CLASS 5A (MODIFIED)

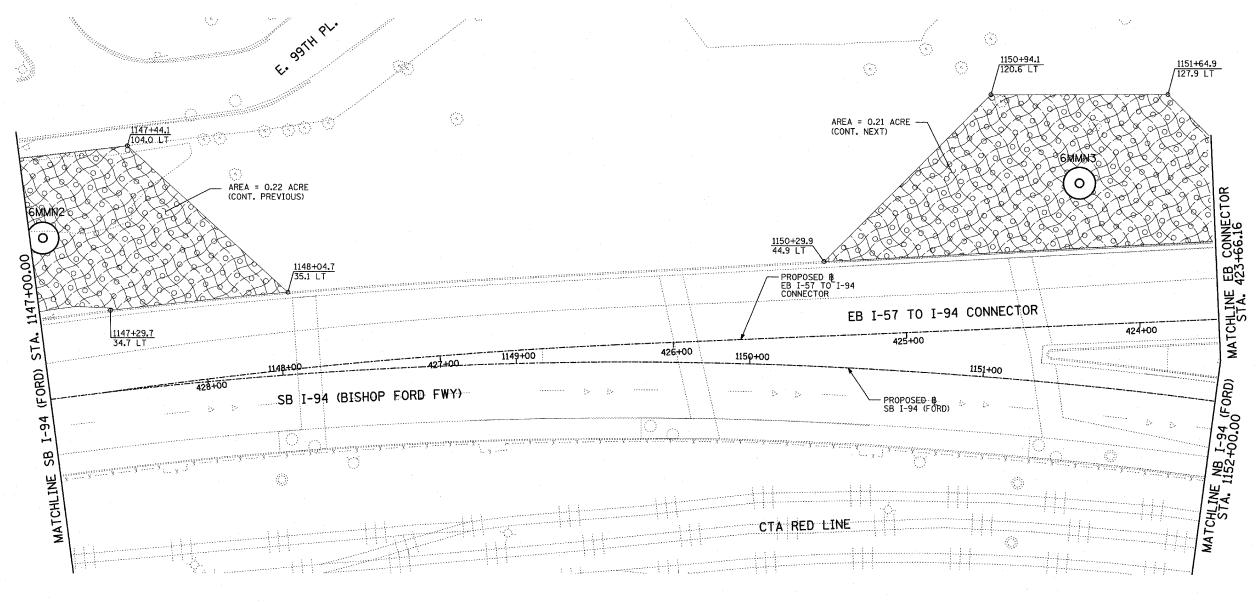


LANDSCAPING GENERAL PLAN NOTES:

- 1. THE CONTRACTOR SHALL USE CARE IN GRADING AND SHAPING NEAR ANY AND ALL EXISTING ITEMS WHICH WILL NOT BE REMOVED. ANY DAMAGE DONE TO EXISTING ITEMS BY THE CONTRACTOR SHALL BE REPAIRED BY THE CONTRACTOR AT THE CONTRACTOR
- 2. THE SEEDING DATES FOR BARE EARTH SEEDING OF MIXTURE CLASS 2A SHALL BE FROM APRIL 1 TO JUNE 1 AND FROM AUGUST 15 TO SEPTEMBER 30. ALL SEEDING NOT SOWN ACCORDING TO THE SPECIFIED SEASONAL DATE SHALL REQUIRE PRIOR APPROVAL FROM THE ENGINEER. FAILURE TO SECURE SUCH APPROVAL SHALL RESULT IN THE REJECTION OF THE SEEDING AND REPLACEMENT BY THE CONTRACTOR AS HIS/HER EXPENSE. AREAS TO BE SEEDED WITH CLASS 2A BETWEEN NOVEMBER 1 AND APRIL 1 SHALL REQUIRE DORMANT SEEDING, WHICH SHALL BE INCLUDED IN THE COST OF SEEDING CLASS 2A.
- 3. THE SEEDING DATES FOR BARE EARTH SEEDING OF MIXTURE CLASSES 4 (MODIFIED) OR 5A (MODIFIED) SHALL BE FROM APRIL 15 TO JUNE 30 AND FROM OCTOBER 15 TO DECEMBER 1. ALL SEEDING NOT SOWN ACCORDING TO THE SPECIFIED SEASONAL DATE SHALL REQUIRE PRIOR APPROVAL FROM THE ENGINEER. FAILURE TO SECURE SUCH APPROVAL SHALL RESULT IN THE REJECTION OF THE SEEDING AND REPLACEMENT BY THE CONTRACTOR AS HIS/HER EXPENSE. AREAS TO BE SEEDED WITH CLASSES 4 (MODIFIED), OR 5A (MODIFIED) BETWEEN DECEMBER 1 AND APRIL 15 SHALL REQUIRE DORMANT SEEDING, WHICH SHALL BE INCLUDED IN THE COST OF CLASS 4 (MODIFIED) OR CLASS 5A (MODIFIED).
 - THE CONTRACTOR SHALL TAKE ALL NECESSARY PRECAUTIONS FOR THE PROTECTION OF EXISTING PLANT MATERIAL FOR WHICH THE CONTRACT DOES NOT PROVIDE REMOVAL. THE PROTECTION OF EXISTING PLANT MATERIAL AND THE REPAIR OR REPLACEMENT OF EXISTING PLANT MATERIAL DAMAGED BY THE CONTRACTOR SHALL BE DONE IN ACCORDANCE WITH THE REQUIREMENTS OF SECTION 201 OF THE STANDARD SPECIFICATIONS.
 - 5. LAYOUT OF LANDSCAPED AREAS WILL REQUIRE APPROVAL OF THE ENGINEER PRIOR TO TOPSOIL PLACEMENT AND SEEDING.

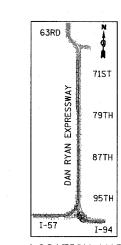

LOCATION MAP

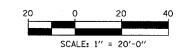



LEA1910M2		I THE TMATE DEE	PARTMENT OF TRANSPORTATION
NAME	DATE		
744,000	1 3.3.7	F.A.I. 94 (I	DAN RYAN EXPRESSWAY)
		I-57	to 71st STREET
		Î LA	ANDSCAPING PLAN
			OP FORD FWY) & EB I-94 TO
		I-57 CON	NECTOR - SB I-94 STA.
			EB CONNECTOR STA. 423+66.16
] (9	SHEET 13 OF 27)
1.		60115 44-004	551W1 5V 666

SCALE: 1"=20'

DRAWN BY: CHECKED BY: TGB

DATE: JANUARY 9, 2007

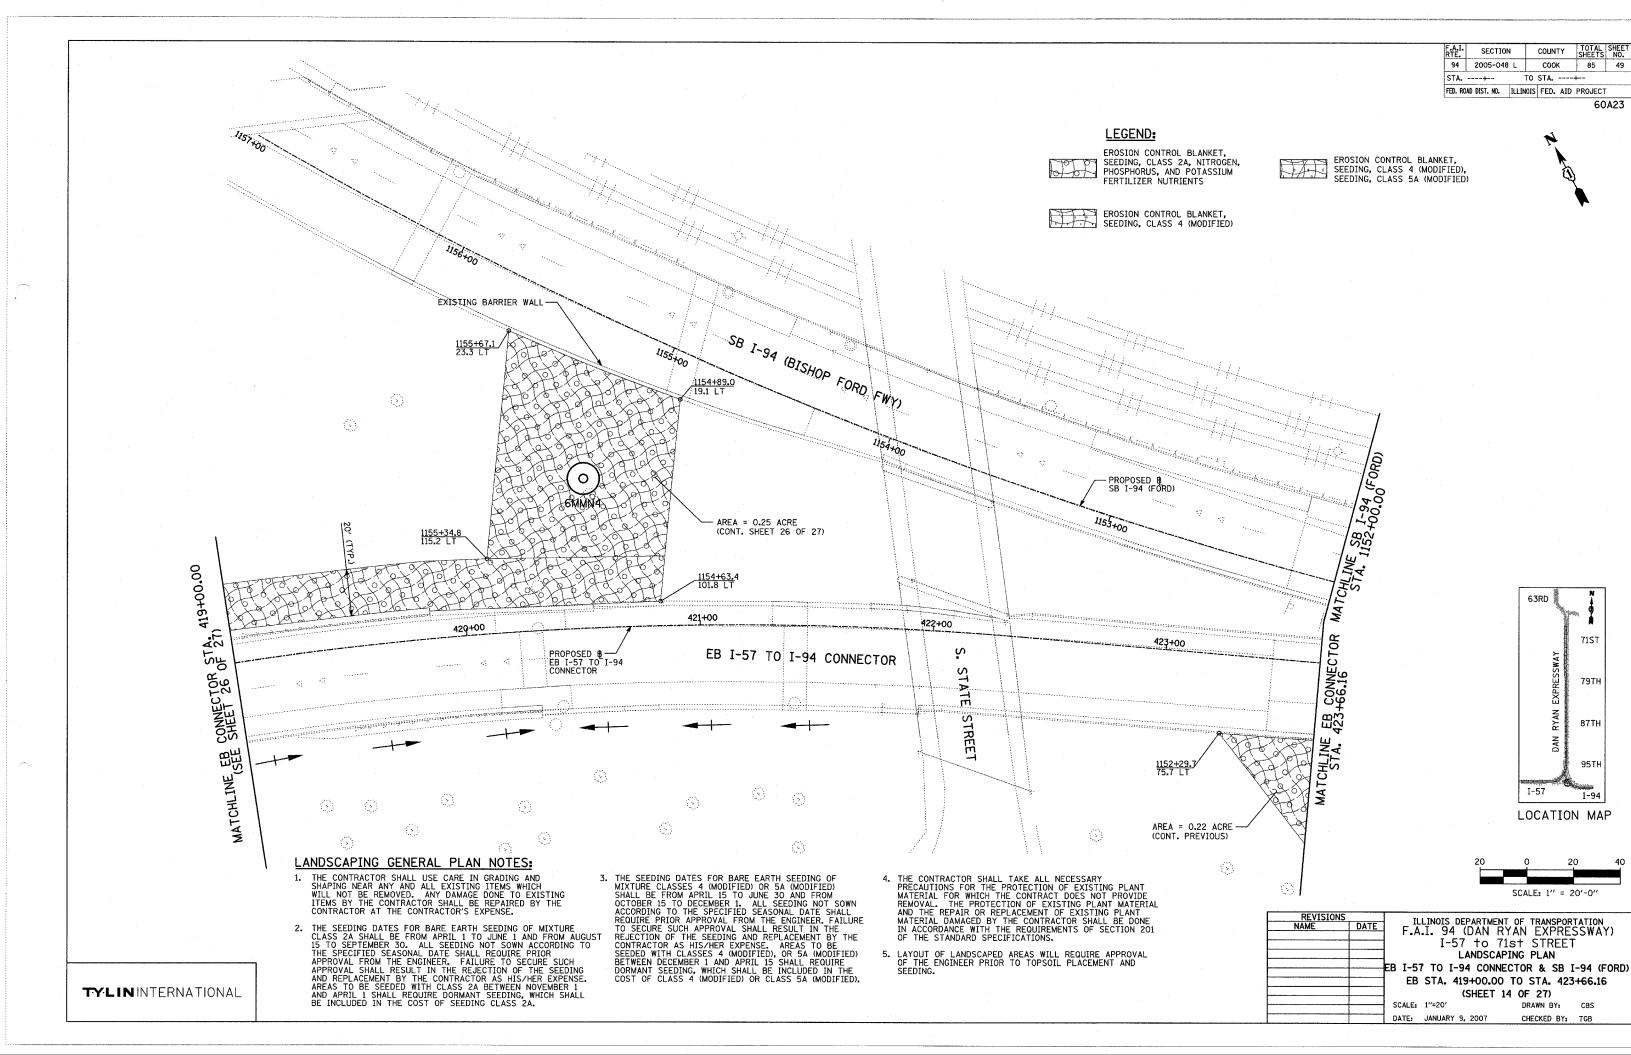

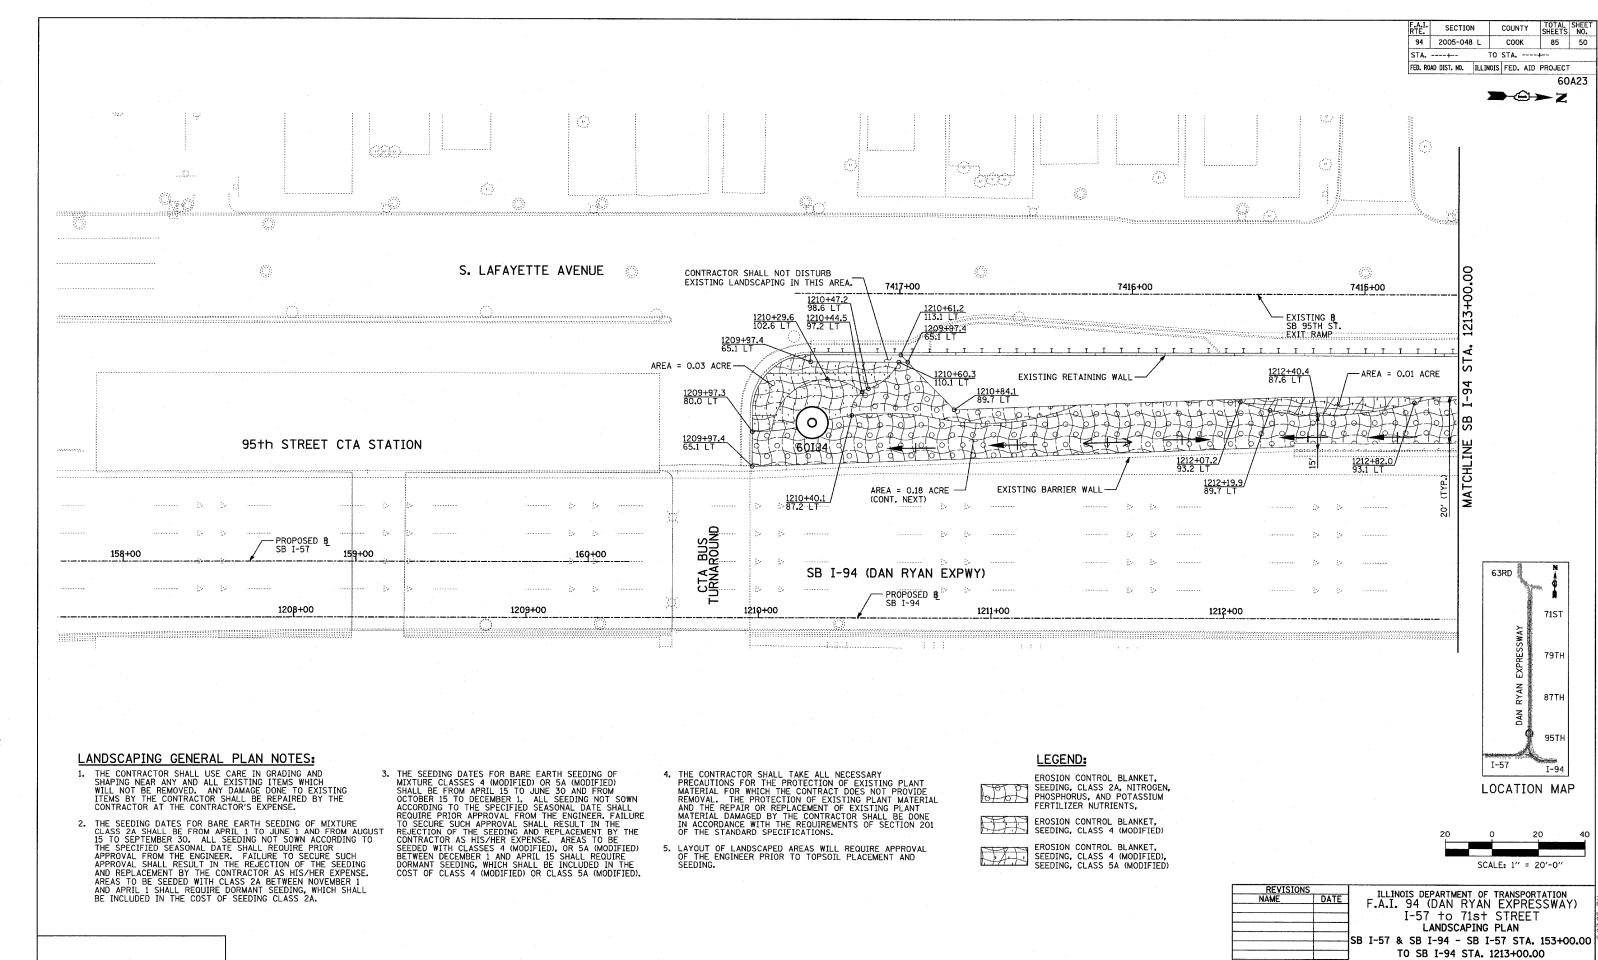

(SHEET 15 OF 27)

DRAWN BY:


CHECKED BY: TGB

SCALE: 1"=20'

DATE: JANUARY 9, 2007

COUNTY TOTAL SHEE SHEETS NO. SECTION соок 2005-048 L STA. ---+--TO STA. ----+--FED. ROAD DIST. NO. ILLINOIS FED. AID PROJECT

→©→Z

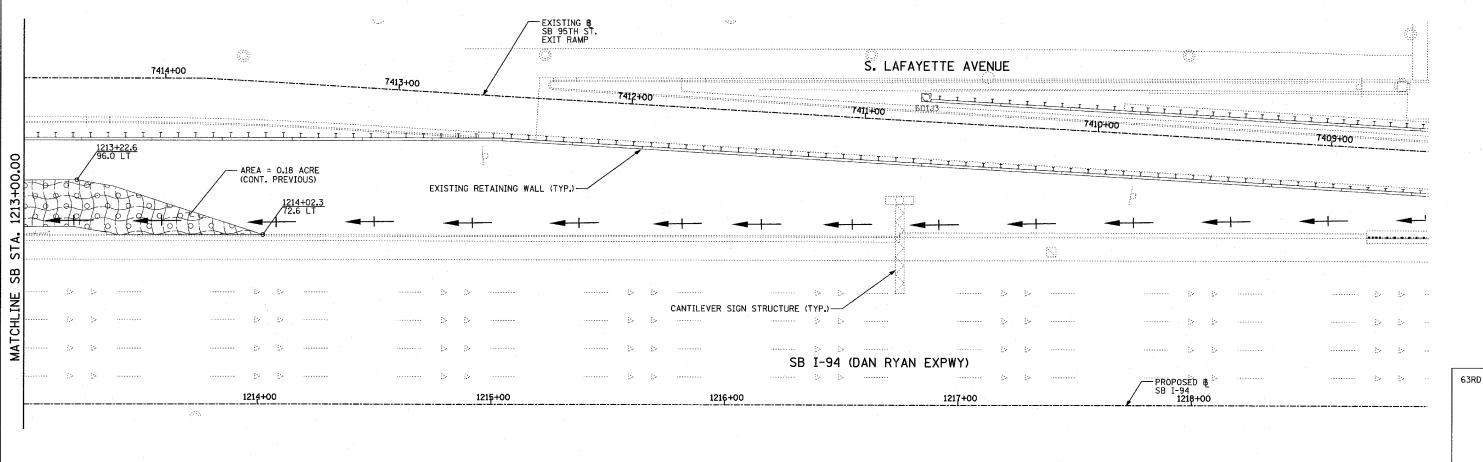

LANDSCAPING GENERAL PLAN NOTES:

- THE CONTRACTOR SHALL USE CARE IN GRADING AND SHAPING NEAR ANY AND ALL EXISTING ITEMS WHICH WILL NOT BE REMOVED. ANY DAMAGE DONE TO EXISTING ITEMS BY THE CONTRACTOR SHALL BE REPAIRED BY THE CONTRACTOR AT THE CONTRACTOR'S EXPENSE.
- 2. THE SEEDING DATES FOR BARE EARTH SEEDING OF MIXTURE CLASS 2A SHALL BE FROM APRIL 1 TO JUNE 1 AND FROM AUGUST 15 TO SEPTEMBER 30. ALL SEEDING NOT SOWN ACCORDING TO THE SPECIFIED SEASONAL DATE SHALL REQUIRE PRIOR APPROVAL FROM THE ENGINEER. FAILURE TO SECURE SUCH APPROVAL SHALL RESULT IN THE REJECTION OF THE SEEDING AND REPLACEMENT BY THE CONTRACTOR AS HIS/HER EXPENSE. AREAS TO BE SEEDED WITH CLASS 2A BETWEEN NOVEMBER 1 AND APRIL 1 SHALL REQUIRE DORMANT SEEDING, WHICH SHALL BE INCLUDED IN THE COST OF SEEDING CLASS 2A.
- 3. THE SEEDING DATES FOR BARE EARTH SEEDING OF MIXTURE CLASSES 4 (MODIFIED) OR 5A (MODIFIED) SHALL BE FROM APRIL 15 TO JUNE 30 AND FROM OCTOBER 15 TO DECEMBER 1. ALL SEEDING NOT SOWN ACCORDING TO THE SPECIFIED SEASONAL DATE SHALL ACCORDING TO THE SPECIFIED SEASONAL DATE SHALL REQUIRE PRIOR APPROVAL FROM THE ENGINEER, FAILURE TO SECURE SUCH APPROVAL SHALL RESULT IN THE REJECTION OF THE SEEDING AND REPLACEMENT BY THE CONTRACTOR AS HIS/HER EXPENSE. AREAS TO BE SEEDED WITH CLASSES 4 (MODIFIED), OR 54 (MODIFIED) BETWEEN DECEMBER 1 AND APRIL 15 SHALL REQUIRE DORMANT SEEDING, WHICH SHALL BE INCLUDED IN THE COST OF CLASS 4 (MODIFIED) OR CLASS 54 (MODIFIED).
 - 4. THE CONTRACTOR SHALL TAKE ALL NECESSARY PRECAUTIONS FOR THE PROTECTION OF EXISTING PLANT MATERIAL FOR WHICH THE CONTRACT DOES NOT PROVIDE REMOVAL. THE PROTECTION OF EXISTING PLANT MATERIAL AND THE REPAIR OR REPLACEMENT OF EXISTING PLANT MATERIAL DAWAGED BY THE CONTRACTOR SHALL BE DONE IN ACCORDANCE WITH THE REQUIREMENTS OF SECTION 201 OF THE STANDARD SPECIFICATIONS.
 - 5. LAYOUT OF LANDSCAPED AREAS WILL REQUIRE APPROVAL OF THE ENGINEER PRIOR TO TOPSOIL PLACEMENT AND SEEDING.

LEGEND:




EROSION CONTROL BLANKET, SEEDING, CLASS 2A, NITROGEN, PHOSPHORUS, AND POTASSIUM FERTILIZER NUTRIENTS






EROSION CONTROL BLANKET, SEEDING, CLASS 4 (MODIFIED SEEDING, CLASS 4 (MODIFIED)

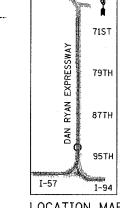

LOCATION MAP




REVISIONS	ILLINOIS DEPARTMENT OF TRANSPORTATION
NAME DATE	F.A.I. 94 (DAN RYAN EXPRESSWAY)
1	
	I-57 to 71st STREET
	LANDSCAPING PLAN
	2,11000,1110 , 2,111
	SB I-94 (DAN RYAN EXPRESSWAY)
	STA. 1213+00.00 TO 1225+00.00
	(SHEET 16 OF 27)
1	·-···
	SCALE: 1"=20' DRAWN BY: CBS
	DATE. IAMIIADY 9 2007 CUECVED DV. TCD

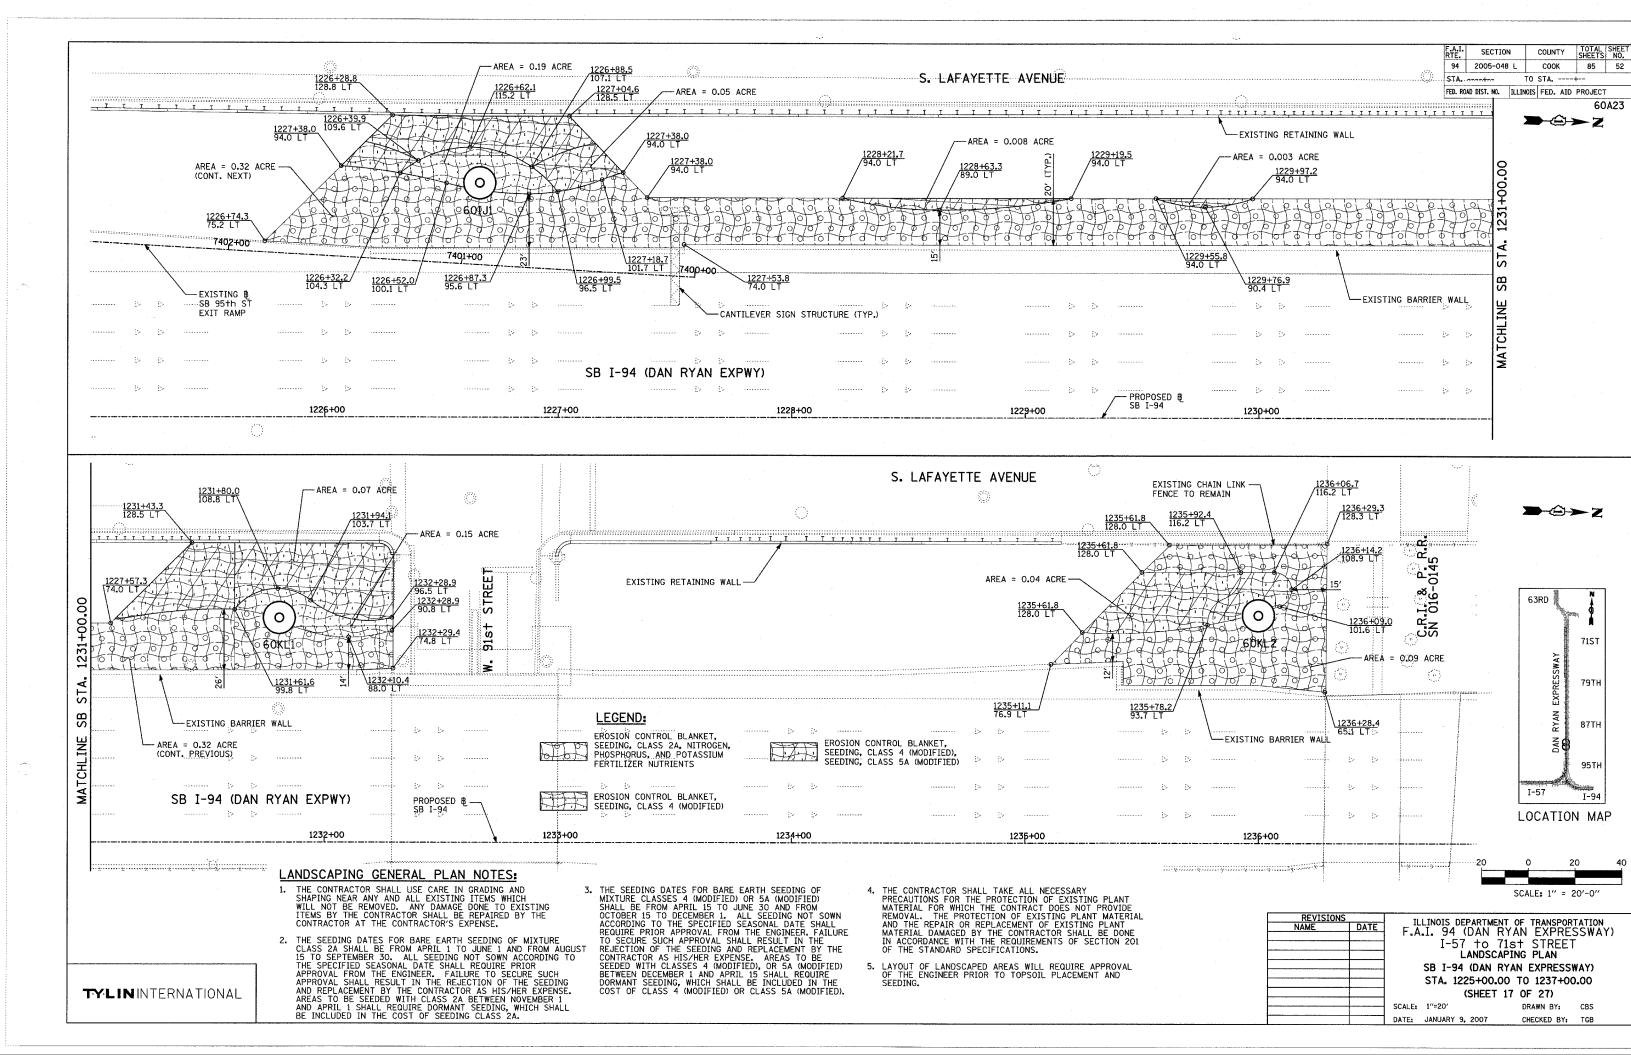

SECTION COUNTY 94 2005-048 L COOK STA. ----+--TO STA. ----+--

FED. ROAD DIST. NO. ILLINOIS FED. AID PROJECT




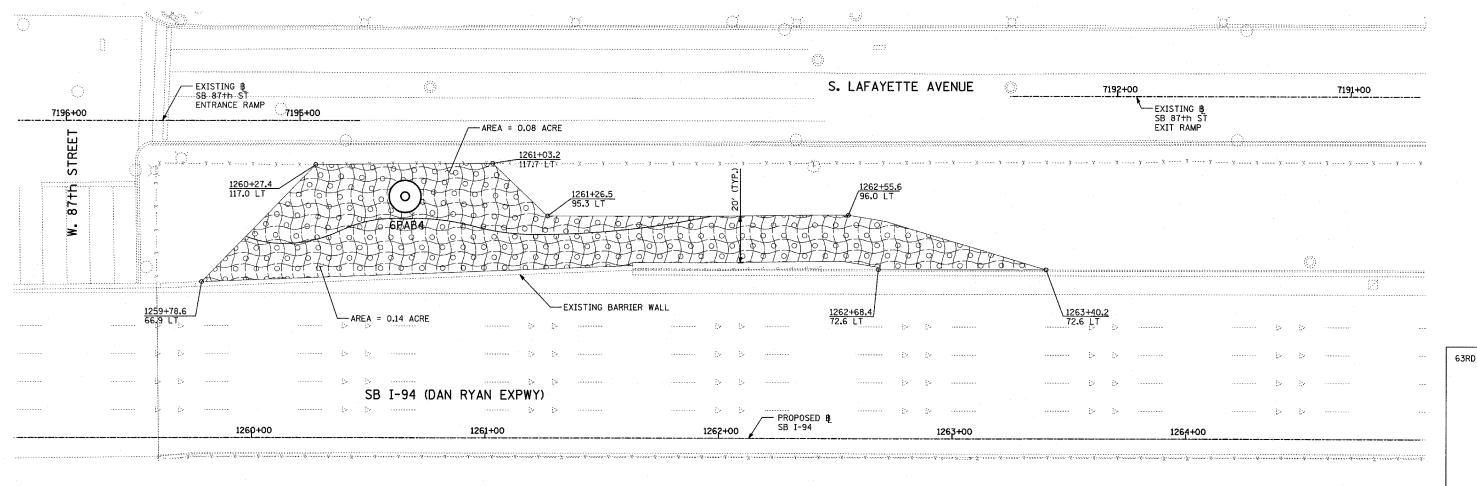


LANDSCAPING GENERAL PLAN NOTES:

- 1. THE CONTRACTOR SHALL USE CARE IN GRADING AND SHAPING NEAR ANY AND ALL EXISTING ITEMS WHICH WILL NOT BE REMOVED. ANY DAMAGE DONE TO EXISTING ITEMS BY THE CONTRACTOR SHALL BE REPAIRED BY THE CONTRACTOR AT THE CONTRACTOR
- 2. THE SEEDING DATES FOR BARE EARTH SEEDING OF MIXTURE CLASS 2A SHALL BE FROM APRIL 1 TO JUNE 1 AND FROM AUGUST 15 TO SEPTEMBER 30. ALL SEEDING NOT SOWN ACCORDING TO THE SPECIFED SEASONAL DATE SHALL REQUIRE PRIOR APPROVAL FROM THE ENGINEER. FAILURE TO SECURE SUCH APPROVAL SHALL RESULT IN THE REJECTION OF THE SEEDING AND REPLACEMENT BY THE CONTRACTOR AS HIS/HER EXPENSE. AREAS TO BE SEEDED WITH CLASS 2A BETWEEN NOVEMBER 1 AND APRIL 1 SHALL REQUIRE DORMANT SEEDING, WHICH SHALL BE INCLUDED IN THE COST OF SEEDING CLASS 2A.
- 3. THE SEEDING DATES FOR BARE EARTH SEEDING OF MIXTURE CLASSES 4 (MODIFIED) OR 5A (MODIFIED) SHALL BE FROM APRIL 15 TO JUNE 30 AND FROM OCTOBER 15 TO DECEMBER 1. ALL SEEDING NOT SOWN ACCORDING TO THE SPECIFIED SEASONAL DATE SHALL REQUIRE PRIOR APPROVAL FROM THE ENGINEER, FAILURE TO SECURE SUCH APPROVAL SHALL RESULT IN THE REJECTION OF THE SEEDING AND REPLACEMENT BY THE CONTRACTOR AS HIS/HER EXPENSE. AREAS TO BE SEEDED WITH CLASSES 4 (MODIFIED), OR 5A (MODIFIED) BETWEEN DECEMBER 1 AND APRIL 15 SHALL REQUIRE DORMANT SEEDING, WHICH SHALL BE INCLUDED IN THE COST OF CLASS 4 (MODIFIED) OR CLASS 5A (MODIFIED).
 - 4. THE CONTRACTOR SHALL TAKE ALL NECESSARY PRECAUTIONS FOR THE PROTECTION OF EXISTING PLANT MATERIAL FOR WHICH THE CONTRACT DOES NOT PROVIDE REMOVAL. THE PROTECTION OF EXISTING PLANT MATERIAL AND THE REPAIR OR REPLACEMENT OF EXISTING PLANT MATERIAL DAMAGED BY THE CONTRACTOR SHALL BE DONE IN ACCORDANCE WITH THE REQUIREMENTS OF SECTION 201 OF THE STANDARD SPECIFICATIONS.
 - 5. LAYOUT OF LANDSCAPED AREAS WILL REQUIRE APPROVAL OF THE ENGINEER PRIOR TO TOPSOIL PLACEMENT AND SEEDING.


LEGEND:

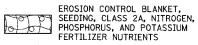

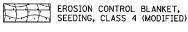




EROSION CONTROL BLANKET, SEEDING, CLASS 4 (MODIFIED). SEEDING, CLASS 5A (MODIFIED)

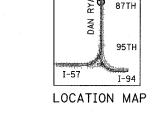

71ST

79TH

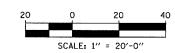


REVISIONS	ILLINOIS DEPARTMENT OF TRANSPORTATION
NAME DATE	F.A.I. 94 (DAN RYAN EXPRESSWAY)
	I "W"I" 34 (DAN KIAN EXELESSWAI)
	I-57 to 71st STREET
	LANDSCAPING PLAN
· i	OR TOLERON DULL EVERTORIUM
	SB I-94 (DAN RYAN EXPRESSWAY)
	STA. 1259+00.00 TO 1271+00.00
	(SHEET 18 OF 27)
	SCALE: 1"=20' DRAWN BY: CBS
į .	SCALE: 1 -20 DRAWN BI: CB3
	DATE: JANUARY 9, 2007 CHECKED BY: TGB

SECTION COUNTY 94 2005-048 L COOK 85 54 STA. ----+--TO STA. ----+--FED. ROAD DIST. NO. ILLINOIS FED. AID PROJECT



60A23

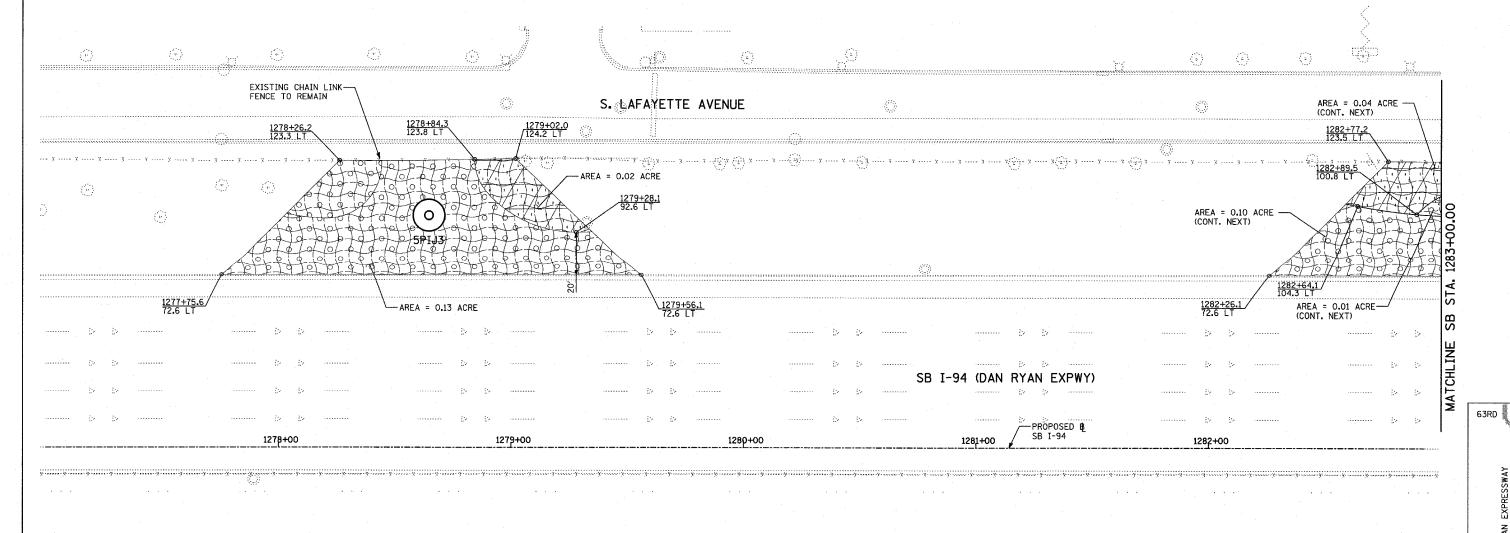

LANDSCAPING GENERAL PLAN NOTES:

- 1. THE CONTRACTOR SHALL USE CARE IN GRADING AND SHAPING NEAR ANY AND ALL EXISTING ITEMS WHICH WILL NOT BE REMOVED. ANY DAMAGE DONE TO EXISTING ITEMS BY THE CONTRACTOR SHALL BE REPAIRED BY THE CONTRACTOR AT THE CONTRACTOR'S EXPENSE.
- 2. THE SEEDING DATES FOR BARE EARTH SEEDING OF MIXTURE CLASS 2A SHALL BE FROM APRIL 1 TO JUNE 1 AND FROM AUGUST 15 TO SEPTEMBER 30. ALL SEEDING NOT SOWN ACCORDING TO THE SPECIFIED SEASONAL DATE SHALL REQUIRE PRIOR APPROVAL FROM THE ENGINEER. FAILURE TO SECURE SUCH APPROVAL SHALL RESULT IN THE REJECTION OF THE SEEDING AND REPLACEMENT BY THE CONTRACTOR AS HIS/HER EXPENSE. AREAS TO BE SEEDED WITH CLASS 2A BETWEEN NOVEMBER 1 AND APRIL 1 SHALL REQUIRE DORMANT SEEDING, WHICH SHALL BE INCLUDED IN THE COST OF SEEDING CLASS 2A.
- 3. THE SEEDING DATES FOR BARE EARTH SEEDING OF MIXTURE CLASSES 4 (MODIFIED) OR 5A (MODIFIED) SHALL BE FROM APRIL 15 TO JUNE 30 AND FROM OCTOBER 15 TO DECEMBER 1. ALL SEEDING NOT SOWN ACCORDING TO THE SPECIFIED SEASONAL DATE SHALL REQUIRE PRIOR APPROVAL FROM THE ENGINEER, FAILURE TO SECURE SUCH APPROVAL SHALL RESULT IN THE REJECTION OF THE SEEDING AND REPLACEMENT BY THE CONTRACTOR AS HIS/HER EXPENSE. AREAS TO BE SEEDED WITH CLASSES 4 (MODIFIED), OR 5A (MODIFIED) BETWEEN DECEMBER 1 AND APRIL 15 SHALL REQUIRE DORMANT SEEDING, WHICH SHALL BE INCLUDED IN THE COST OF CLASS 4 (MODIFIED) OR CLASS 5A (MODIFIED).
 - 4. THE CONTRACTOR SHALL TAKE ALL NECESSARY PRECAUTIONS FOR THE PROTECTION OF EXISTING PLANT MATERIAL FOR WHICH THE CONTRACT DOES NOT PROVIDE REMOVAL. THE PROTECTION OF EXISTING PLANT MATERIAL AND THE REPAIR OR REPLACEMENT OF EXISTING PLANT MATERIAL DAMAGED BY THE CONTRACTOR SHALL BE DONE IN ACCORDANCE WITH THE REQUIREMENTS OF SECTION 201 OF THE STANDARD SPECIFICATIONS.
 - 5. LAYOUT OF LANDSCAPED AREAS WILL REQUIRE APPROVAL OF THE ENGINEER PRIOR TO TOPSOIL PLACEMENT AND SEEDING.

LEGEND:



EROSION CONTROL BLANKET, SEEDING, CLASS 2A, NITROGEN, PHOSPHORUS, AND POTASSIUM FERTILIZER NUTRIENTS



EROSION CONTROL BLANKET, SEEDING, CLASS 4 (MODIFIED), SEEDING, CLASS 5A (MODIFIED)



EROSION CONTROL BLANKET, SEEDING, CLASS 4 (MODIFIED)



I-57

71ST

79TH

95TH


I-94

SCALE: 1" = 20'-0" REVISIONS


VEA1210M2		71	LINOIS DEPARTMEN	IT OF TRANSPOR	TATION
NAME	DATE				
		F.A	.I. 94 (DAN F	(YAN EXPRE	55WAY)
			I-57 to 7	1st STREET	<u>-</u>
			LANDSCA	PING PLAN	
			SB I-94 (DAN F	YAN EXPRESSI	WAY)
			STA. 1271+00.0	0 TO 1283+00	.00
			(SHEET	19 OF 27)	
	ļ	SCALE:	1"=20"	DRAWN BY:	CBS
	-	DATE:	IANUARY C 2007	CHECKED DY	TOD

SECTION COUNTY 94 2005-048 L соок 55 85 STA. ----+--TO STA. ----+--FED. ROAD DIST. NO. ILLINOIS FED. AID PROJECT

> 60A23 **→ ② → Z**

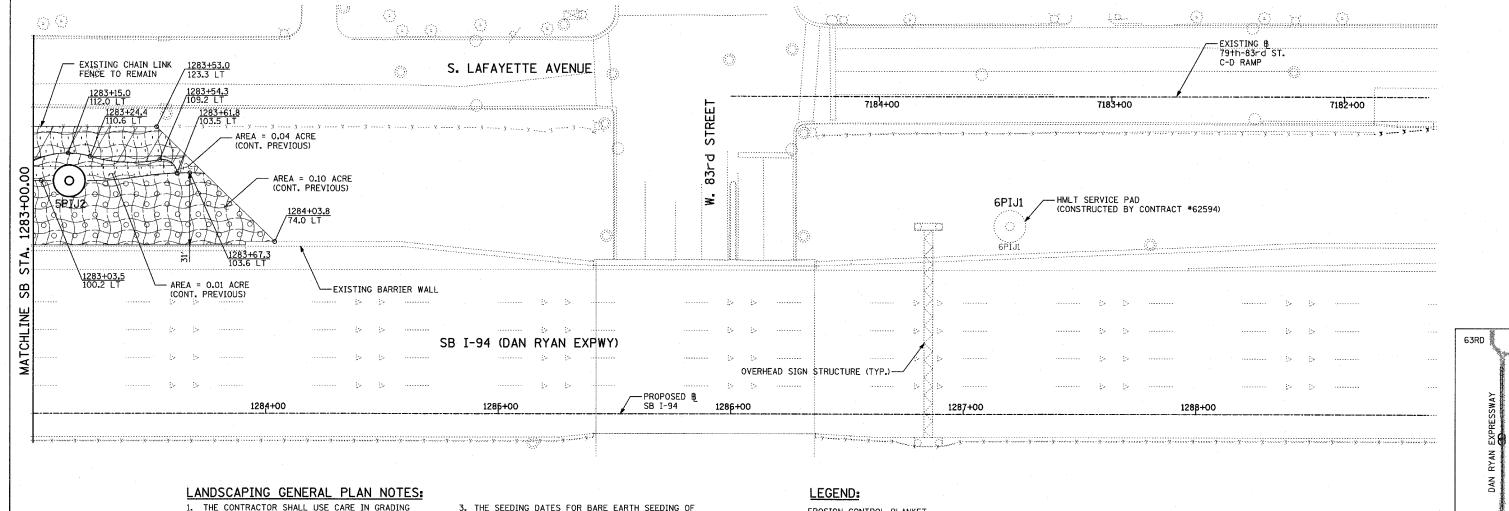

- 1. THE CONTRACTOR SHALL USE CARE IN GRADING AND SHAPING NEAR ANY AND ALL EXISTING ITEMS WHICH WILL NOT BE REMOVED. ANY DAMAGE DONE TO EXISTING ITEMS BY THE CONTRACTOR SHALL BE REPAIRED BY THE CONTRACTOR SHALL BE REPAIRED BY THE CONTRACTOR AT THE CONTRACTOR'S EXPENSE.
- 2. THE SEEDING DATES FOR BARE EARTH SEEDING OF MIXTURE CLASS 2A SHALL BE FROM APRIL 1 TO JUNE 1 AND FROM AUGUST 15 TO SEPTEMBER 30. ALL SEEDING NOT SOWN ACCORDING TO THE SPECIFIED SEASONAL DATE SHALL REQUIRE PRIOR APPROVAL FROM THE ENGINEER. FAILURE TO SECURE SUCH APPROVAL SHALL RESULT IN THE REJECTION OF THE SEEDING AND REPLACEMENT BY THE CONTRACTOR AS HIS/HER EXPENSE. AREAS TO BE SEEDED WITH CLASS 2A BETWEEN NOVEMBER 1 AND APRIL 1 SHALL REQUIRE DORMANT SEEDING, WHICH SHALL BE INCLUDED IN THE COST OF SEEDING CLASS 2A.
- 3. THE SEEDING DATES FOR BARE EARTH SEEDING OF MIXTURE CLASSES 4 (MODIFIED) OR 5A (MODIFIED) SHALL BE FROM APRIL 15 TO JUNE 30 AND FROM OCTOBER 15 TO DECEMBER 1. ALL SEEDING NOT SOWN ACCORDING TO THE SPECIFIED SEASONAL DATE SHALL REQUIRE PRIOR APPROVAL FROM THE ENGINEER. FAILURE TO SECURE SUCH APPROVAL SHALL RESULT IN THE REJECTION OF THE SEEDING AND REPLACEMENT BY THE CONTRACTOR AS HIS/HER EXPENSE. AREAS TO BE SEEDED WITH CLASSES 4 (MODIFIED) OR 5A (MODIFIED) BETWEEN DECEMBER 1 AND APRIL 15 SHALL REQUIRE DORMANT SEEDING, WHICH SHALL BE INCLUDED IN THE COST OF CLASS 4 (MODIFIED) OR CLASS 5A (MODIFIED).
 - 4. THE CONTRACTOR SHALL TAKE ALL NECESSARY PRECAUTIONS FOR THE PROTECTION OF EXISTING PLANT MATERIAL FOR WHICH THE CONTRACT DOES NOT PROVIDE REMOVAL. THE PROTECTION OF EXISTING PLANT MATERIAL AND THE REPAIR OR REPLACEMENT OF EXISTING PLANT MATERIAL DAMAGED BY THE CONTRACTOR SHALL BE DONE IN ACCORDANCE WITH THE REQUIREMENTS OF SECTION 201 OF THE STANDARD SPECIFICATIONS.
 - LAYOUT OF LANDSCAPED AREAS WILL REQUIRE APPROVAL OF THE ENGINEER PRIOR TO TOPSOIL PLACEMENT AND SEEDING.

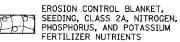



EROSION CONTROL BLANKET, SEEDING, CLASS 4 (MODIFIED)



EROSION CONTROL BLANKET, SEEDING, CLASS 4 (MODIFIED), SEEDING, CLASS 5A (MODIFIED)




LOCATION MAP

I-57

71ST

REVISIONS		TI	LINOIS DEPARTM	ENT OF	TRANSPOR	TATION
NAME	DATE	ר ג'י	.I. 94 (DAN		EVDDE	CCMVV
· ·		1 . ~				
			I-57 to	71s†	STREET	Ī
			LANDS	CAPING	PLAN	
			SB I-94 (DAN	RYAN	EXPRESS	WAY)
	i					
			STA. 1283+00	.00 TO) 1295+0(0.00
			(SHEET	20 0	F 27)	
		SCALE:	1"=20"	D	RAWN BY:	CBS
	i			-	2	
		DATE:	JANUARY 9, 2007	С	HECKED BY:	TGB

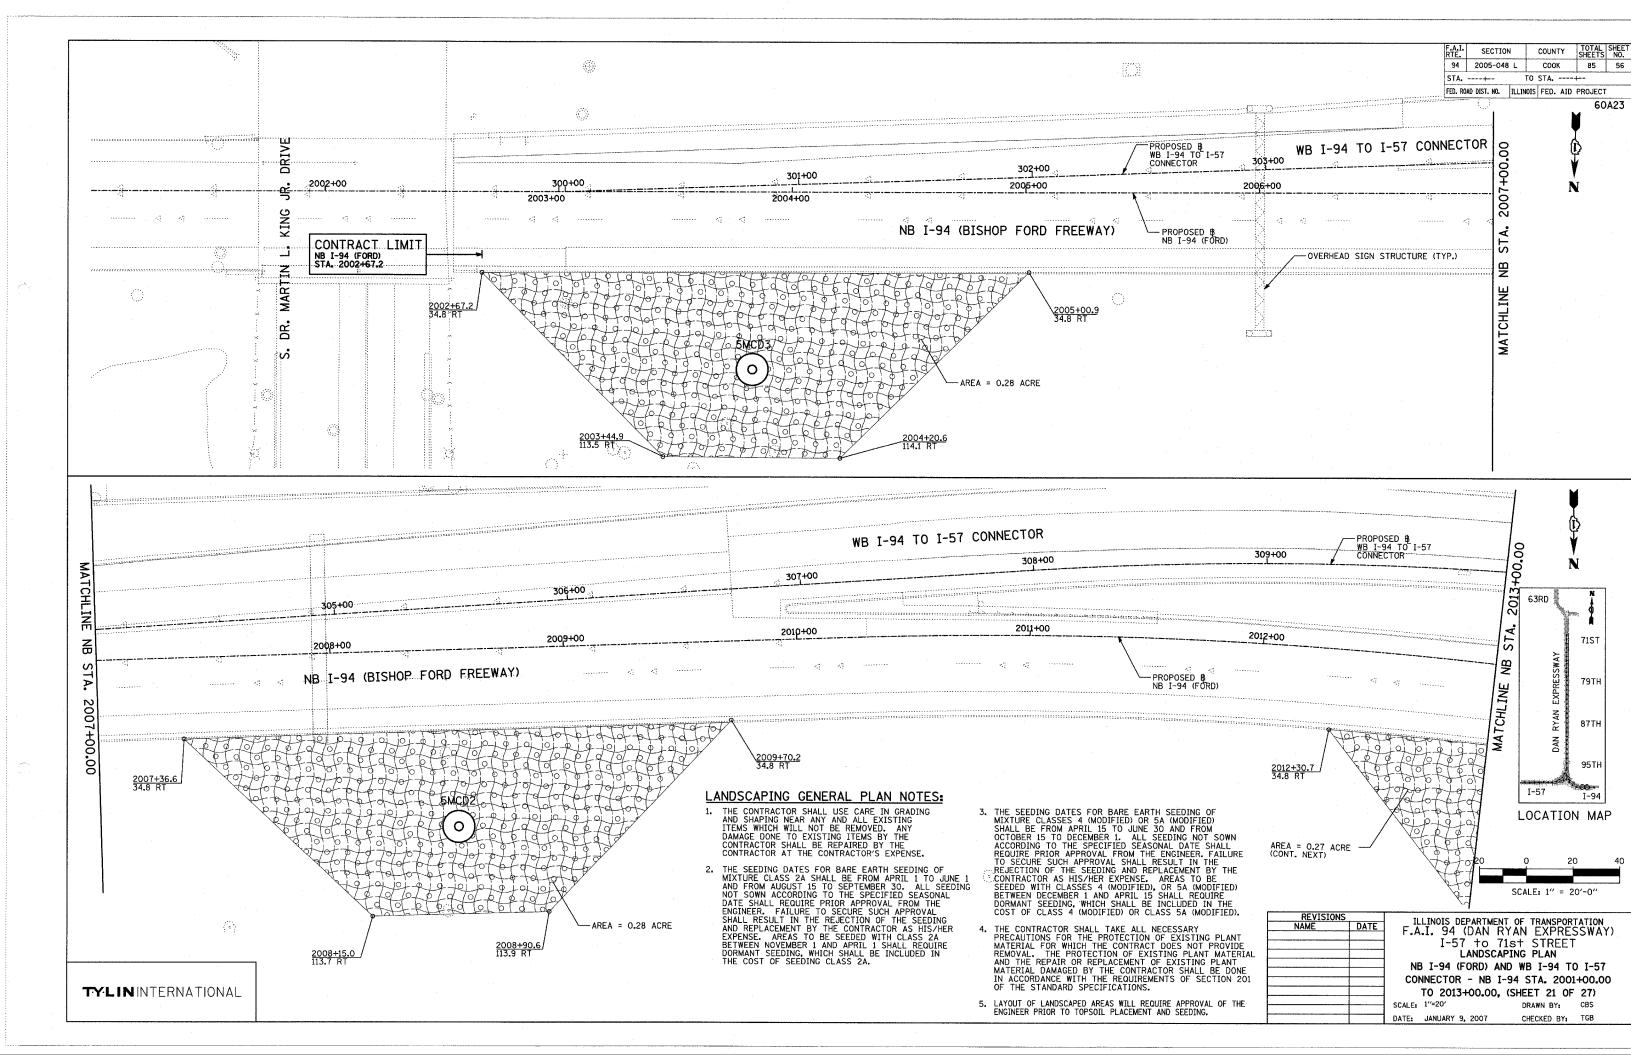

LEGEND:

EROSION CONTROL BLANKET, SEEDING, CLASS 2A, NITROGEN, PHOSPHORUS, AND POTASSIUM FERTILIZER NUTRIENTS, TOPSOIL FURNISH AND PLACE, 4"

EROSION CONTROL BLANKET, SEEDING, CLASS 4 (MODIFIED), SEEDING, CLASS 5A (MODIFIED) TOPSOIL FURNISH AND PLACE, 12" COMPOST FURNISH AND PLACE, 6"


EROSION CONTROL BLANKET, SEEDING, CLASS 4 (MODIFIED), TOPSOIL FURNISH AND PLACE, 12" COMPOST FURNISH AND PLACE, 6"

NITROGEN, PHOSPHORUS, AND POTASSIUM FERTILIZER NUTRIENTS, TOPSOIL FURNISH AND PLACE, 12" COMPOST FURNISH AND PLACE, 6" 4" MULCH BED PRE-EMERGENT GRANULAR HERBICIDE

TOTAL SHEE SHEETS NO. SECTION COUNTY COOK 94 2005-048 L 57 85 STA. ---+--TO STA. ----FED. ROAD DIST. NO. ILLINOIS FED. AID PROJECT

60A23



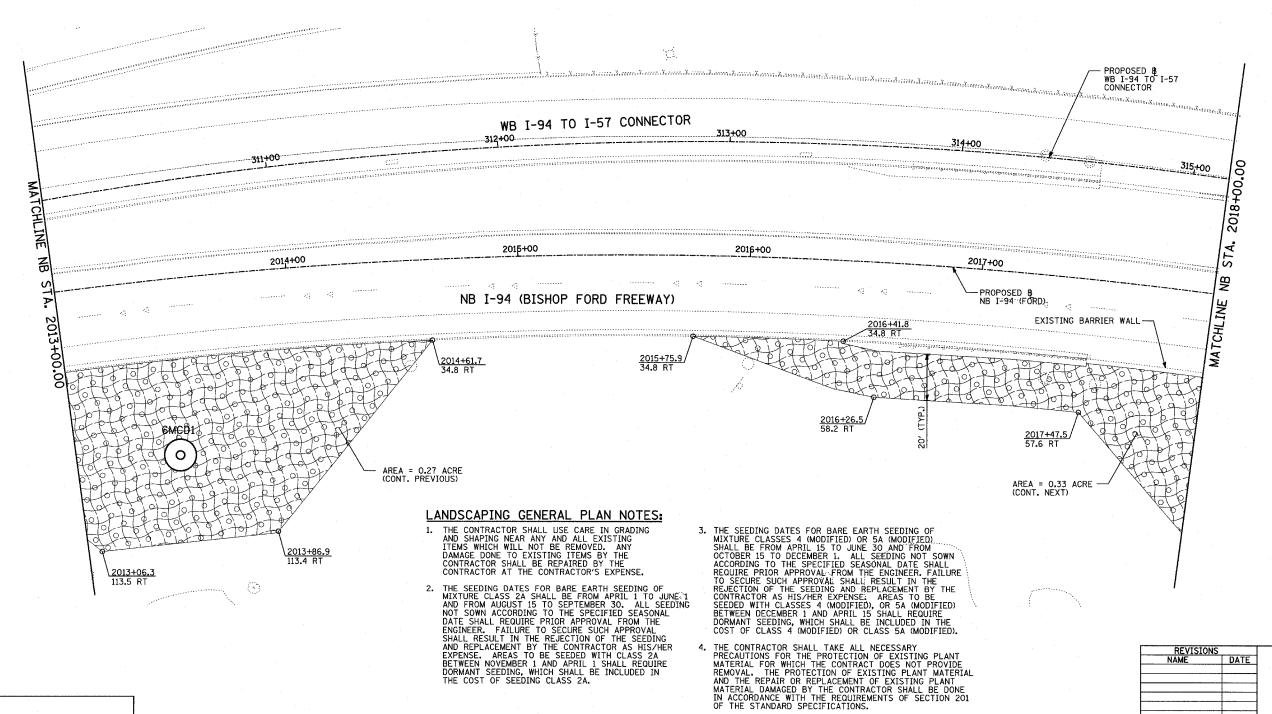

5. LAYOUT OF LANDSCAPED AREAS WILL REQUIRE APPROVAL OF THE ENGINEER PRIOR TO TOPSOIL PLACEMENT AND SEEDING.

63RD 71ST **79TH** 1-57 I-94 LOCATION MAP

SCALE: 1" = 20'-0"

ILLINOIS DEPARTMENT OF TRANSPORTATION F.A.I. 94 (DAN RYAN EXPRESSWAY) I-57 to 71st STREET LANDSCAPING PLAN NB I-94 (FORD) AND WB I-94 TO I-57 CONNECTOR - NB I-94 STA. 2013+00.00

TO 2018+00.00 (SHEET 22 OF 27) SCALE: 1"=20' DRAWN BY: CBS DATE: JANUARY 9, 2007 CHECKED BY: TGB

LEGEND:


EROSION CONTROL BLANKET, SEEDING, CLASS 2A, NITROGEN, PHOSPHORUS, AND POTASSIUM FERTILIZER NUTRIENTS

EROSION CONTROL BLANKET. SEEDING, CLASS 4 (MODIFIED), SEEDING, CLASS 5A (MODIFIED)

EROSION CONTROL BLANKET, SEEDING, CLASS 4 (MODIFIED)

SECTION COUNTY 94 2005-048 L СООК 85 58 STA. ---+--TO STA. ----+--FED. ROAD DIST. NO. ILLINOIS FED. AID PROJECT



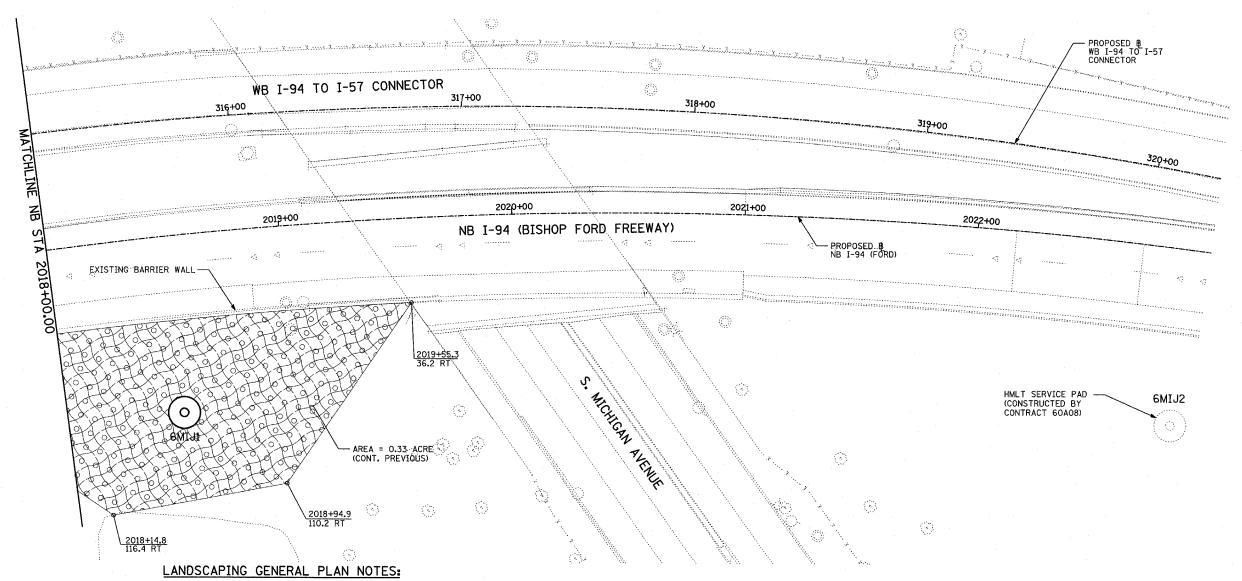

87TH 95TH I-57 I-94 LOCATION MAP

71ST

79TF

1. THE CONTRACTOR SHALL USE CARE IN GRADING AND SHAPING NEAR ANY AND ALL EXISTING ITEMS WHICH WILL NOT BE REMOVED. ANY DAMAGE DONE TO EXISTING ITEMS BY THE CONTRACTOR SHALL BE REPAIRED BY THE CONTRACTOR AT THE CONTRACTOR'S EXPENSE.

2. THE SEEDING DATES FOR BARE EARTH SEEDING OF MIXTURE CLASS 2A SHALL BE FROM APRIL 1 TO JUNE 1 AND FROM AUGUST 15 TO SEPTEMBER 3O. ALL SEEDING NOT SOWN ACCORDING TO THE SPECIFIED SEASONAL DATE SHALL REQUIRE PRIOR APPROVAL FROM THE ENGINEER. FAILURE TO SECURE SUCH APPROVAL SHALL RESULT IN THE REJECTION OF THE SEEDING AND REPLACEMENT BY THE CONTRACTOR AS HIS/HER EXPENSE. AREAS TO BE SEEDED WITH CLASS 2A BETWEEN NOVEMBER 1 AND APRIL 1 SHALL REQUIRE DORMANT SEEDING, WHICH SHALL BE INCLUDED IN THE COST OF SEEDING CLASS 2A.

3. THE SEEDING DATES FOR BARE EARTH SEEDING OF MIXTURE CLASSES 4 (MODIFIED) OR 5A (MODIFIED) SHALL BE FROM APRIL 15 TO JUNE 30 AND FROM OCTOBER 15 TO DECEMBER 1. ALL SEEDING NOT SOWN ACCORDING TO THE SPECIFIED SEASONAL DATE SHALL REQUIRE PRIOR APPROVAL FROM THE ENGINEER, FAILURE TO SECURE SUCH APPROVAL SHALL RESULT IN THE SECURE OF THE SEEDING AND REPLACEMENT BY THE CONTRACTOR AS HIS/HER EXPENSE. AREAS TO BE SEEDED WITH CLASSES 4 (MODIFIED), OR 5A (MODIFIED) BETWEEN DECEMBER 1 AND APRIL 15 SHALL REQUIRE DORMANT SEEDING, WHICH SHALL BE INCLUDED IN THE COST OF CLASS 4 (MODIFIED) OR CLASS 5A (MODIFIED).

4. THE CONTRACTOR SHALL TAKE ALL NECESSARY PRECAUTIONS FOR THE PROTECTION OF EXISTING PLANT MATERIAL FOR WHICH THE CONTRACT DOES NOT PROVIDE REMOVAL. THE PROTECTION OF EXISTING PLANT MATERIAL AND THE REPAIR OR REPLACEMENT OF EXISTING PLANT MATERIAL DAMAGED BY THE CONTRACTOR SHALL BE DONE IN ACCORDANCE WITH THE REQUIREMENTS OF SECTION 201 OF THE STANDARD SPECIFICATIONS.

LAYOUT OF LANDSCAPED AREAS WILL REQUIRE APPROVAL OF THE ENGINEER PRIOR TO TOPSOIL PLACEMENT AND SEEDING.

20	o	20	
-			
	SCALE:	1" = 20'-0'	•
DEDARTMEN	IT OF TOA	NCDODTATIO	

63RD


REVISIONS		ILLINOIS DEPARTMENT OF TRANSPORTATION
NAME	DATE	F.A.I. 94 (DAN RYAN EXPRESSWAY)
		I-57 to 71st STREET
		LANDSCAPING PLAN
	1	NB I-94 (FORD) AND WB I-94 TO I-57
		CONNECTOR - NB I-94 STA. 2018+00.00
		TO 2023+00.00, (SHEET 23 OF 27)
		•
		SCALE: 1"=20' DRAWN BY: CBS
		DATE: JANUARY 9, 2007 CHECKED BY: TGB

EROSION CONTROL BLANKET, SEEDING, CLASS 2A, NITROGEN, PHOSPHORUS, AND POTASSIUM FERTILIZER NUTRIENTS

EROSION CONTROL BLANKET, SEEDING, CLASS 4 (MODIFIED), SEEDING, CLASS 5A (MODIFIED)


EROSION CONTROL BLANKET, SEEDING, CLASS 4 (MODIFIED)

DOX Z

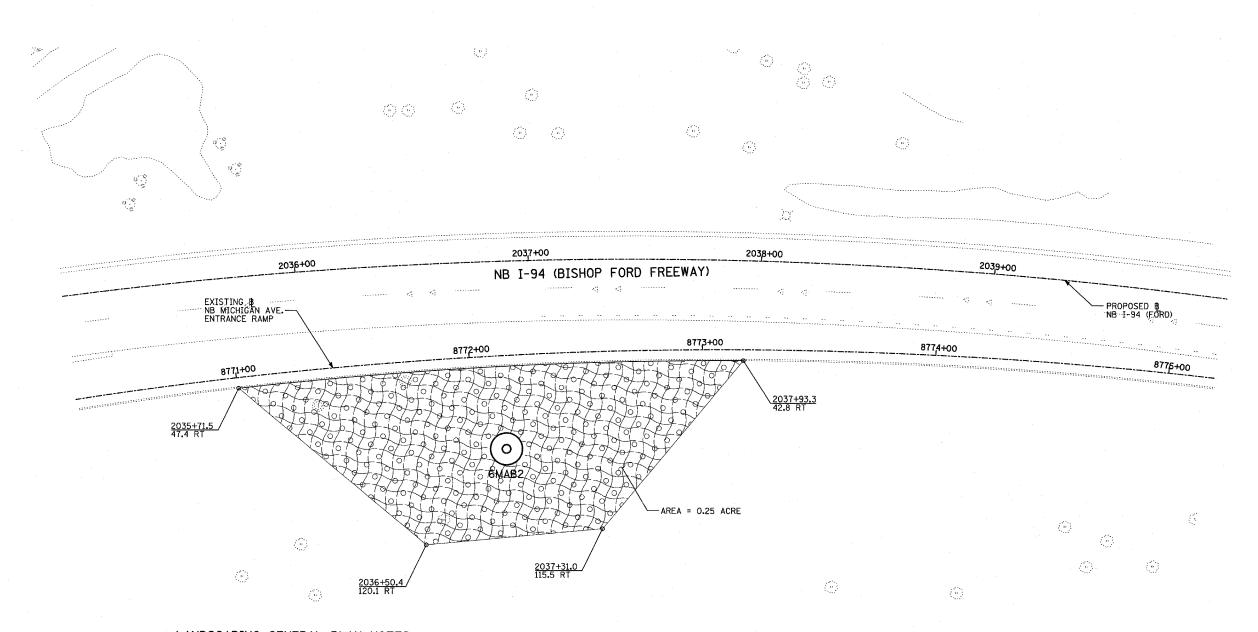

LANDSCAPING GENERAL PLAN NOTES:

- 1. THE CONTRACTOR SHALL USE CARE IN GRADING AND SHAPING NEAR ANY AND ALL EXISTING ITEMS WHICH WILL NOT BE REMOVED. ANY DAMAGE DONE TO EXISTING ITEMS BY THE CONTRACTOR SHALL BE REPAIRED BY THE CONTRACTOR AT THE CONTRACTOR'S EXPENSE.
- 2. THE SEEDING DATES FOR BARE EARTH SEEDING OF MIXTURE CLASS 2A SHALL BE FROM APRIL 1 TO JUNE 1 AND FROM AUGUST 15 TO SEPTEMBER 30. ALL SEEDING NOT SOWN ACCORDING TO THE SPECIFIED SEASONAL DATE SHALL REQUIRE PRIOR APPROVAL FROM THE ENGINEER. FAILURE TO SECURE SUCH APPROVAL SHALL RESULT IN THE REJECTION OF THE SEEDING AND REPLACEMENT BY THE CONTRACTOR AS HIS/HER EXPENSE. AREAS TO BE SEEDED WITH CLASS 2A BETWEEN NOVEMBER 1 AND APRIL 1 SHALL REQUIRE DORMANT SEEDING, WHICH SHALL BE INCLUDED IN THE COST OF SEEDING CLASS 2A.
- 3. THE SEEDING DATES FOR BARE EARTH SEEDING OF MIXTURE CLASSES 4 (MODIFIED) OR 5A (MODIFIED) SHALL BE FROM APRIL 15 TO JUNE 30 AND FROM OCTOBER 15 TO DECEMBER 1. ALL SEEDING NOT SOWN ACCORDING TO THE SPECIFIED SEASONAL DATE SHALL REQUIRE PRIOR APPROVAL FROM THE ENGINEER. FAILURE TO SECURE SUCH APPROVAL SHALL RESULT IN THE STELECTION OF THE SEEDING AND REPLACEMENT BY THE CONTRACTOR AS HIS/HER EXPENSE. AREAS TO BE SEEDED WITH CLASSES 4 (MODIFIED), OR 5A (MODIFIED) BETWEEN DECEMBER 1 AND APRIL 15 SHALL REQUIRE DORMANT SEEDING, WHICH SHALL BE INCLUDED IN THE COST OF CLASS 4 (MODIFIED) OR CLASS 5A (MODIFIED).
- 4. THE CONTRACTOR SHALL TAKE ALL NECESSARY PRECAUTIONS FOR THE PROTECTION OF EXISTING PLANT MATERIAL FOR WHICH THE CONTRACT DOES NOT PROVIDE REMOVAL. THE PROTECTION OF EXISTING PLANT MATERIAL AND THE REPAIR OR REPLACEMENT OF EXISTING PLANT MATERIAL DAMAGED BY THE CONTRACTOR SHALL BE DONE IN ACCORDANCE WITH THE REQUIREMENTS OF SECTION 201 OF THE STANDARD SPECIFICATIONS.
- 5. LAYOUT OF LANDSCAPED AREAS WILL REQUIRE APPROVAL OF THE ENGINEER PRIOR TO TOPSOIL PLACEMENT AND SEEDING.

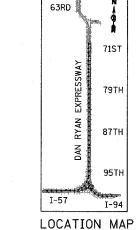


20 0 20 4 SCALE: 1" = 20'-0"

REVISIONS
NAME DATE

ILLINOIS DEPARTMENT OF TRANSPORTATION
F.A.I. 94 (DAN RYAN EXPRESSWAY)
I-57 to 71st STREET
LANDSCAPING PLAN
NB I-94 (BISHOP FORD FWY)
STA. 2035+00.00 TO 2040+00.00
(SHEET 24 OF 27)
SCALE: 1"=20' DRAWN BY: CBS
DATE: JANUARY 9, 2007 CHECKED BY: TGB

F.A.I. RTE. SECTION COUNTY COOK 2005-048 L 85 STA. ---+--TO STA. ----+--FED. ROAD DIST. NO. | ILLINOIS | FED. AID PROJECT


> 60A23 **→**©→z

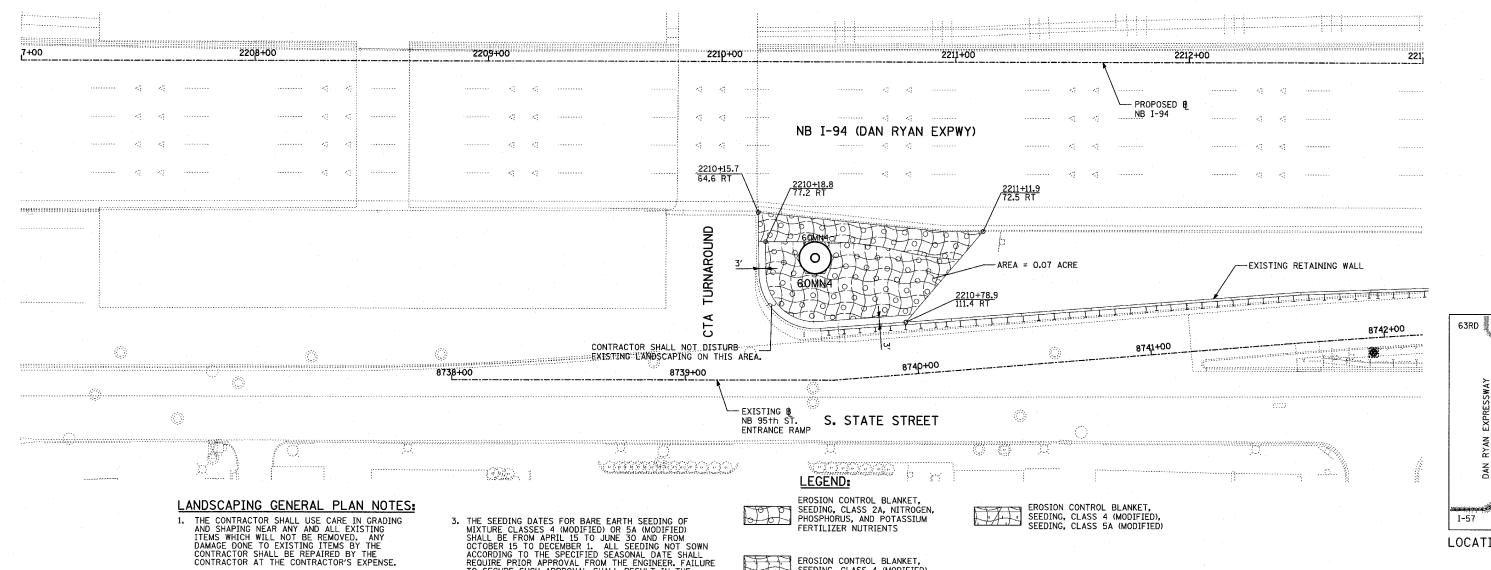

- 2. THE SEEDING DATES FOR BARE EARTH SEEDING OF MIXTURE CLASS 2A SHALL BE FROM APRIL 1 TO JUNE 1 AND FROM AUGUST 15 TO SEPTEMBER 30. ALL SEEDING NOT SOWN ACCORDING TO THE SPECIFIED SEASONAL DATE SHALL REQUIRE PRIOR APPROVAL FROM THE ENGINEER. FAILURE TO SECURE SUCH APPROVAL SHALL RESULT IN THE REJECTION OF THE SEEDING AND REPLACEMENT BY THE CONTRACTOR AS HIS/HER EXPENSE. AREAS TO BE SEEDED WITH CLASS 2A BETWEEN NOVEMBER 1 AND APRIL 1 SHALL REQUIRE DORMANT SEEDING, WHICH SHALL BE INCLUDED IN THE COST OF SEEDING CLASS 2A.
- 3. THE SEEDING DATES FOR BARE EARTH SEEDING OF MIXTURE CLASSES 4 (MODIFIED) OR 5A (MODIFIED) SHALL BE FROM APRIL 15 TO JUNE 30 AND FROM OCTOBER 15 TO DECEMBER 1. ALL SEEDING NOT SOWN ACCORDING TO THE SPECIFIED SEASONAL DATE SHALL REQUIRE PRIOR APPROVAL FROM THE ENGINEER. FAILURE TO SECURE SUCH APPROVAL SHALL RESULT IN THE REJECTION OF THE SEEDING AND REPLACEMENT BY THE CONTRACTOR AS HIS/HER EXPENSE. AREAS TO BE SEEDED WITH CLASSES 4 (MODIFIED), OR 5A (MODIFIED) BETWEEN DECEMBER 1 AND APRIL 15 SHALL REQUIRE DORMANT SEEDING, WHICH SHALL BE INCLUDED IN THE COST OF CLASS 4 (MODIFIED) OR CLASS 5A (MODIFIED).
 - 4. THE CONTRACTOR SHALL TAKE ALL NECESSARY PRECAUTIONS FOR THE PROTECTION OF EXISTING PLANT MATERIAL FOR WHICH THE CONTRACT DOES NOT PROVIDE REMOVAL. THE PROTECTION OF EXISTING PLANT MATERIAL AND THE REPAIR OR REPLACEMENT OF EXISTING PLANT MATERIAL DAMAGED BY THE CONTRACTOR SHALL BE DONE IN ACCORDANCE WITH THE REQUIREMENTS OF SECTION 201 OF THE STANDARD SPECIFICATIONS.
 - 5. LAYOUT OF LANDSCAPED AREAS WILL REQUIRE APPROVAL OF THE ENGINEER PRIOR TO TOPSOIL PLACEMENT AND SEEDING.



EROSION CONTROL BLANKET, SEEDING, CLASS 4 (MODIFIED)

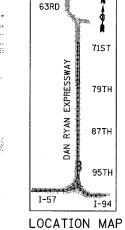

CHECKED BY: TGB

SCALE: 1" = 20'-0"

REVISIONS ILLINOIS DEPARTMENT OF TRANSPORTATION F.A.I. 94 (DAN RYAN EXPRESSWAY) I-57 to 71st STREET LANDSCAPING PLAN NB I-94 (DAN RYAN EXPRESSWAY) STA. 2207+00.00 TO 2219+00.00 (SHEET 25 OF 27) SCALE: 1"=20' DRAWN BY:

DATE: JANUARY 9, 2007

LANDSCAPING GENERAL PLAN NOTES:

- THE CONTRACTOR SHALL USE CARE IN GRADING AND SHAPING NEAR ANY AND ALL EXISTING ITEMS WHICH WILL NOT BE REMOVED. ANY DAMAGE DONE TO EXISTING ITEMS BY THE CONTRACTOR SHALL BE REPAIRED BY THE CONTRACTOR AT THE CONTRACTOR'S EXPENSE.
- THE SEEDING DATES FOR BARE EARTH SEEDING OF MIXTURE CLASS 2A SHALL BE FROM APRIL 1 TO JUNE 1 AND FROM AUGUST 15 TO SEPTEMBER 30. ALL SEEDING NOT SOWN ACCORDING TO THE SPECIFIED SEASONAL DATE SHALL REQUIRE PRIOR APPROVAL FROM THE ENGINEER. FAILURE TO SECURE SUCH APPROVAL SHALL RESULT IN THE REJECTION OF THE SEEDING AND REPLACEMENT BY THE CONTRACTOR AS HIS/HER EXPENSE. AREAS TO BE SEEDED WITH CLASS 2A BETWEEN NOVEMBER 1 AND APRIL 1 SHALL REQUIRE DORMANT SEEDING, WHICH SHALL BE INCLUDED IN THE COST OF SEEDING CLASS 2A.

415+06.0

415+00

- 3. THE SEEDING DATES FOR BARE EARTH SEEDING OF MIXTURE CLASSES 4 (MODIFIED) OR 5A (MODIFIED) SHALL BE FROM APRIL 15 TO JUNE 30 AND FROM OCTOBER 15 TO DECEMBER 1. ALL SEEDING NOT SOWN ACCORDING TO THE SPECIFIED SEASONAL DATE SHALL REQUIRE PRIOR APPROVAL SHALL RESULT IN THE TO SECURE SUCH APPROVAL SHALL RESULT IN THE REJECTION OF THE SEEDING AND REPLACEMENT BY THE CONTRACTOR AS HIS/HER EXPENSE. AREAS TO BE SEEDED WITH CLASSES 4 (MODIFIED), OR 5A (MODIFIED) BETWEEN DECEMBER 1 AND APRIL 15 SHALL REQUIRE DORMANT SEEDING, WHICH SHALL BE INCLUDED IN THE COST OF CLASS 4 (MODIFIED) OR CLASS 5A (MODIFIED).
- 4. THE CONTRACTOR SHALL TAKE ALL NECESSARY
 PRECAUTIONS FOR THE PROTECTION OF EXISTING PLANT
 MATERIAL FOR WHICH THE CONTRACT DOES NOT PROVIDE
 REMOVAL. THE PROTECTION OF EXISTING PLANT MATERIAL
 AND THE REPAIR OR REPLACEMENT OF EXISTING PLANT
 MATERIAL DAMAGED BY THE CONTRACTOR SHALL BE DONE
 IN ACCORDANCE WITH THE REQUIREMENTS OF SECTION 201
 OF THE STANDARD SPECIFICATIONS THE STANDARD SPECIFICATIONS.
- 5. LAYOUT OF LANDSCAPED AREAS WILL REQUIRE APPROVAL OF THE ENGINEER PRIOR TO TOPSOIL PLACEMENT AND SEEDING.

416+00

0

416+37.4 34.6 LT

AREA = 0.22 ACRE

(3)

LEGEND:

EROSION CONTROL BLANKET, SEEDING, CLASS 2A, NITROGEN, PHOSPHORUS, AND POTASSIUM FERTILIZER NUTRIENTS



EROSION CONTROL BLANKET,



SEEDING, CLASS 4 (MODIFIED), SEEDING, CLASS 5A (MODIFIED)

85 61

60A23

SECTION

2005-048 L

94

STA. ---+--


COUNTY


COOK

TO STA. ----+--

FED. ROAD DIST. NO. ILLINOIS FED. AID PROJECT

EROSION CONTROL BLANKET, SEEDING, CLASS 4 (MODIFIED SEEDING, CLASS 4 (MODIFIED)

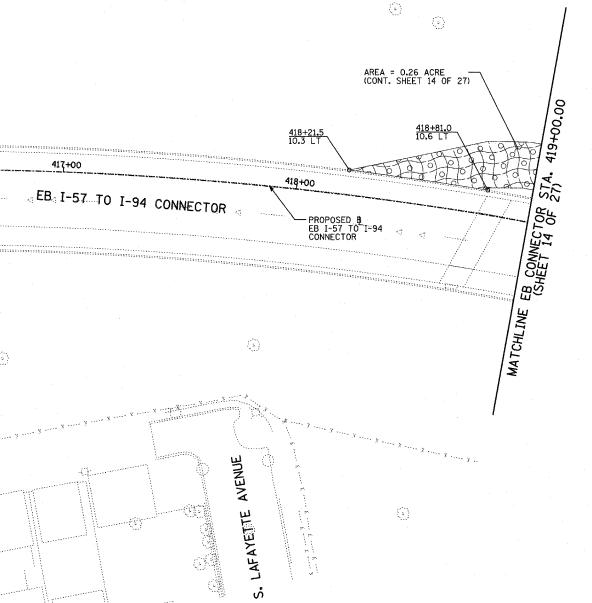

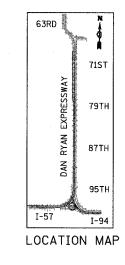

REVISIONS ILLINOIS DEPARTMENT OF TRANSPORTATION F.A.I. 94 (DAN RYAN EXPRESSWAY) I-57 to 71st STREET LANDSCAPING PLAN EB I-57 TO I-94 CONNECTOR STA. 415+06.00 TO STA. 419+00.00

SCALE: 1"=20"

DATE: JANUARY 9, 2007

(SHEET 26 OF 27) DRAWN BY: CHECKED BY: TGB

SCALE: 1" = 20'-0"

TYLININTERNATIONAL

414+24.2 34.6 RT

LANDSCAPING GENERAL PLAN NOTES:

- 1. THE CONTRACTOR SHALL USE CARE IN GRADING AND SHAPING NEAR ANY AND ALL EXISTING ITEMS WHICH WILL NOT BE REMOVED. ANY DAMAGE DONE TO EXISTING ITEMS BY THE CONTRACTOR SHALL BE REPAIRED BY THE CONTRACTOR AT THE CONTRACTOR
- 2. THE SEEDING DATES FOR BARE EARTH SEEDING OF MIXTURE CLASS 2A SHALL BE FROM APRIL 1 TO JUNE 1 AND FROM AUGUST 15 TO SEPTEMBER 30. ALL SEEDING NOT SOWN ACCORDING TO THE SPECIFIED SEASONAL DATE SHALL REQUIRE PRIOR APPROVAL FROM THE ENGINEER. FAILURE TO SECURE SUCH APPROVAL SHALL RESULT IN THE REJECTION OF THE SEEDING AND REPLACEMENT BY THE CONTRACTOR AS HIS/HER EXPENSE. AREAS TO BE SEEDED WITH CLASS 2A BETWEEN NOVEMBER 1 AND APRIL 1 SHALL REQUIRE DORMANT SEEDING, WHICH SHALL BE INCLUDED IN THE COST OF SEEDING CLASS 2A.

MATCHL

딂

57

334+00.00


- 3. THE SEEDING DATES FOR BARE EARTH SEEDING OF MIXTURE CLASSES 4 (MODIFIED) OR 5A (MODIFIED) SHALL BE FROM APRIL 15 TO JUNE 30 AND FROM OCTOBER 15 TO DECEMBER 1. ALL SEEDING NOT SOWN ACCORDING TO THE SPECIFIED SEASONAL DATE SHALL REQUIRE PRIOR APPROVAL FROM THE ENGINEER. FAILURE TO SECURE SUCH APPROVAL SHALL RESULT IN THE REJECTION OF THE SEEDING AND REPLACEMENT BY THE CONTRACTOR AS HIS/HER EXPENSE. AREAS TO BE SEEDED WITH CLASSES 4 (MODIFIED), OR 5A (MODIFIED) BETWEEN DECEMBER 1 AND APRIL 15 SHALL REQUIRE DORMANT SEEDING, WHICH SHALL BE INCLUDED IN THE COST OF CLASS 4 (MODIFIED) OR CLASS 5A (MODIFIED).
- 4. THE CONTRACTOR SHALL TAKE ALL NECESSARY PRECAUTIONS FOR THE PROTECTION OF EXISTING PLANT MATERIAL FOR WHICH THE CONTRACT DOES NOT PROVIDE REMOVAL. THE PROTECTION OF EXISTING PLANT MATERIAL AND THE REPAIR OR REPLACEMENT OF EXISTING PLANT MATERIAL DAMAGED BY THE CONTRACTOR SHALL BE DONE IN ACCORDANCE WITH THE REQUIREMENTS OF SECTION 201 OF THE STANDARD SPECIFICATIONS.
- 5. LAYOUT OF LANDSCAPED AREAS WILL REQUIRE APPROVAL OF THE ENGINEER PRIOR TO TOPSOIL PLACEMENT AND SEEDING.

EXISTING BARRIER WALL-

333+00

PROPOSED B WB I-94 TO I-57

CONNECTOR

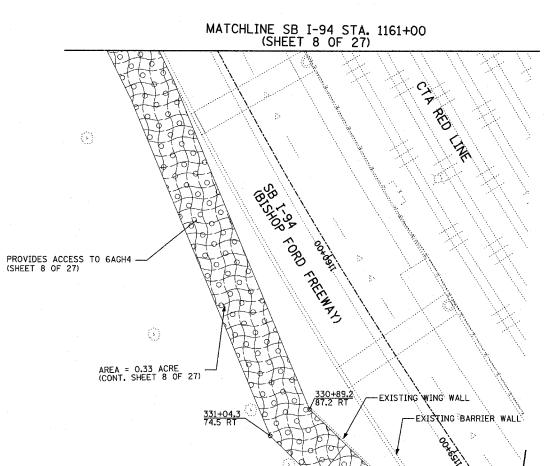

AREA = 0.06 ACRE

331+00

331+08.6 18.6 RT

332+00

WB I-94 TO I-57 CONNECTOR

LEGEND:

EROSION CONTROL BLANKET, SEEDING, CLASS 2A, NITROGEN, PHOSPHORUS, AND POTASSIUM FERTILIZER NUTRIENTS,


EROSION CONTROL BLANKET, SEEDING, CLASS 4 (MODIFIED)

330+00.00

МВ

MATCHL

EROSION CONTROL BLANKET, SEEDING, CLASS 4 (MODIFIED), SEEDING, CLASS 5A (MODIFIED)

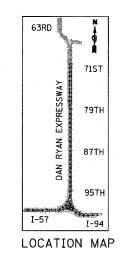

SCALE: 1" = 20'-0"


REVISIONS		TI	LINOIS DEPARTMEN	T OF TRANSPORT	TATION
NAME	DATE	Fλ	.I. 94 (DAN R	YAN FYPRE	(VAW2
		1 */		· · · · · · · · · · · · · · · · · · ·	
			1-57 to 7	1st STREET	
			LANDSCAP	ING PLAN	
	1		WD T 04 T0 T	E7 00111E0E0	_
			WB I-94 TO I-	-5 CONNECTO	ĸ
	1		STA. 326+00.00	TO 334+00.0	00
			(SHEET 2	7 OF 27)	
		SCALE:	1"=20"	DRAWN BY:	CBS
		DATE:	JANUARY 9, 2007	CHECKED BY:	TGB


CONTRACT NO. COUNTY TOTAL SHEET NO. SECTION 85 63 STA. TO STA. FED. ROAD DIST. NO. ILLINOIS FED. AID PROJECT


60A23

LIGHT TOWER FOUNDATION DEPTH "D"

		S	OIL CONDITIONS			
MOUNTING HEIGHT	SOFT CLAY Qu = 0.375 TON/SQ. FT	MEDIUM CLAY Qu = 0.75 TON/SQ. FT	STIFF CLAY Qu = 1.50 TON/SQ. FT	LOOSE SAND Ø = 34°	MEDIUM SAND Ø = 37.5°	DENSE SAND Ø = 40°
27m	8.779m	6.035m	4.389m	4.389m	3.840m	3.429m
(90 ft)	(29 ft)	(20 ft)	(15 f†)	(15 ft)	(13 f†)	(12 ft)
30m	9.754m	6.706m	4.877m	4.877m	4.267m	3.81m
(100 ft)	(32 ft)	(22 ft)	(16 f+)	(16 ft)	(14 ft)	(13 ft)
33m	10.719m	7.377m	5.365m	5.365m	4.694m	4.191m
(110 ft)	(35 f+)	(24 ft)	(18 f†)	(18 f†)	(15 f†)	(14 f†)
36m	11.705m	8.046m	5.652m	5.652m	5.120m	4.572m
(120 ft)	(38 ft)	(26 ft)	(19 ft)	(19 ft)	(17 ft)	(16 ft)

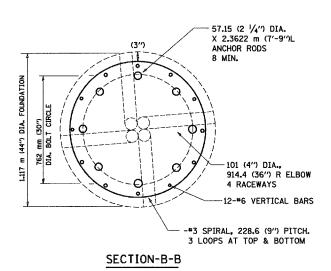


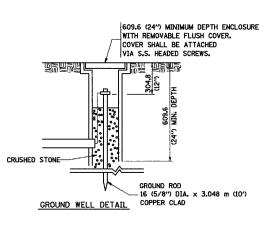

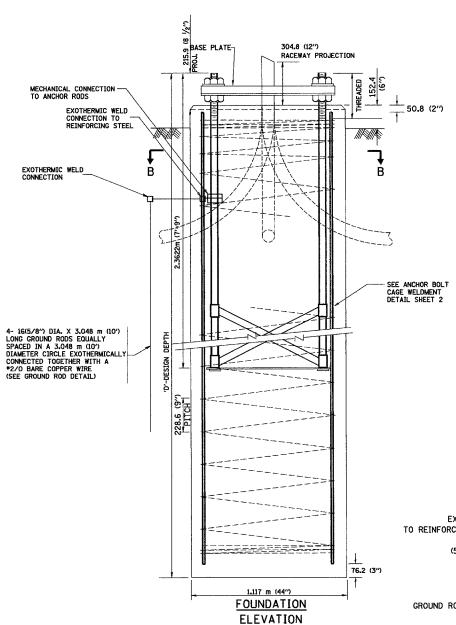

DESIGN NOTES

- (1) ALL DIMENSIONS IN MILLIMETERS (INCHES) UNLESS OTHERWISE SHOWN
- (2) THE ANCHOR RODS SHALL BE VERTICAL NO ADJUSTMENT SHALL BE ALLOWED AFTER THE FOUNDATION IS PLACED.
- (3) THE GAP BETWEEN THE FOUNDATION AND THE BASE PLATE SHALL BE ENCLOSED WITH A STAINLESS STEEL SCREEN FASTENED WITH A STAINLESS STEEL BAND.
- (4) THE TOP OF THE FOUNDATION TO 450 (18") BELOW GRADE SHALL BE FORMED.
- (5) SURFACE WATER WILL NOT BE PERMITTED TO ENTER THE HOLE AND ALL WATER WHICH MAY HAVE INFILTRATED INTO THE HOLE SHALL BE REMOVED BEFORE PLACING CONCRETE.
- (6) THE LIGHT TOWER SHALL NOT BE ERECTED UNTIL AFTER THE CONCRETE HAS BEEN CURED ACCORDING TO ARTICLE 1020.13.
- (7) ANCHOR RODS SHALL BE STRAIGHT AND SHALL BE ACCORDING TO AASHTO M 314 OR ASTM F1554, GRADE 725(GRADE 105) AND GALVANIZED ACCORDING TO ARTICLE 1006.9.
- (8) ANCHOR ROD INFORMATION SHALL BE SUBMITTED FOR APPROVAL AND SHALL BE FULLY COORDINATED FOR APPROVAL WITH TOWER MANUFACTURER REQUIREMENTS.
- (9) REINFORCEMENT BARS SHALL BE ACCORDING TO ARTICLE 1006.10
- (IO) TWO ANCHOR RODS OPPOSITE EACH OTHER SHALL HAVE THE ANCHOR ROD THREADS PEENED AFTER NUTS ARE INSTALLED.

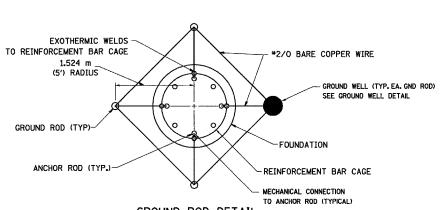

GROUND ROD DETAIL


HIGH MAST LIGHT TOWER
27m TO 36m (90FT TO 120FT) FOUNDATION DETAIL SHEET 1 OF 2
E VERT. DRAWN BY 12-2/15/2006 CHECKED BY

REVISION DATE: 12/15/05

CONTRACT NO. SECTION COUNTY -57 (2,25") DIA. ANCHOR ROD STA. TO STA. TOP 609 (24") HOT DIPPED GALVANIZED, AASHTO M232 FED. ROAD DIST. NO. ILLINOIS FED. AID PROJECT 60A23

NOTES

- 1. ALL DIMENSIONS IN MILLIMETERS (INCHES) UNLESS OTHERWISE SHOWN
- 2. ANCHOR RODS SHALL BE STRAIGHT AND SHALL BE ACCORDING TO AASHTO M 314 OR ASTM F1554, GRADE 725 (GRADE 105) AND GALVANIZED ACCORDING TO ARTICLE 1006.09.
- 3. ANCHOR ROD INFORMATION SHALL BE SUBMITTED FOR APPROVAL AND SHALL BE FULLY COORDINATED WITH TOWER MANUFACTURERS REQUIREMENTS.

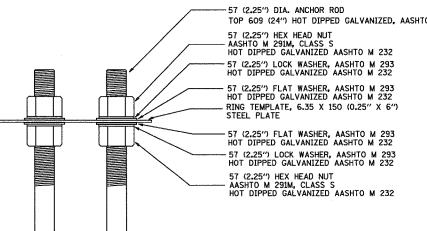


SEE BOLT CAGE TOP DETAIL


SEE BOLT CAGE BOTTOM DETAIL

ANCHOR BOLT CAGE

BOLT CAGE TOP

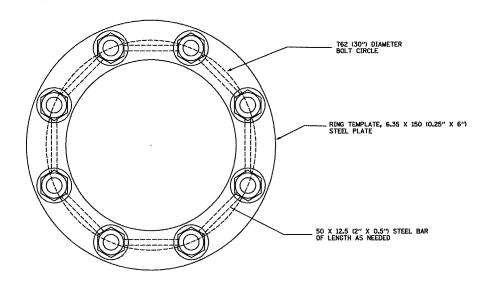

SECTION A-A

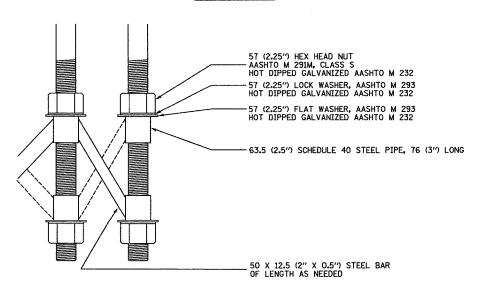


BOLT CAGE BOTTOM

DATE NAME SCALE NAME

ILLINOIS DEPARTMENT OF TRANSPORTATION HIGH MAST LIGHT TOWER 27m TO 36m (90FT TO 120FT) FOUNDATION DETAIL SHEET 2 OF 2 SCALE: VERT. DRAWN BY CHECKED BY BEO8 (BE501) DATE: 2/15/2006

REVISION DATE: 04/12/05

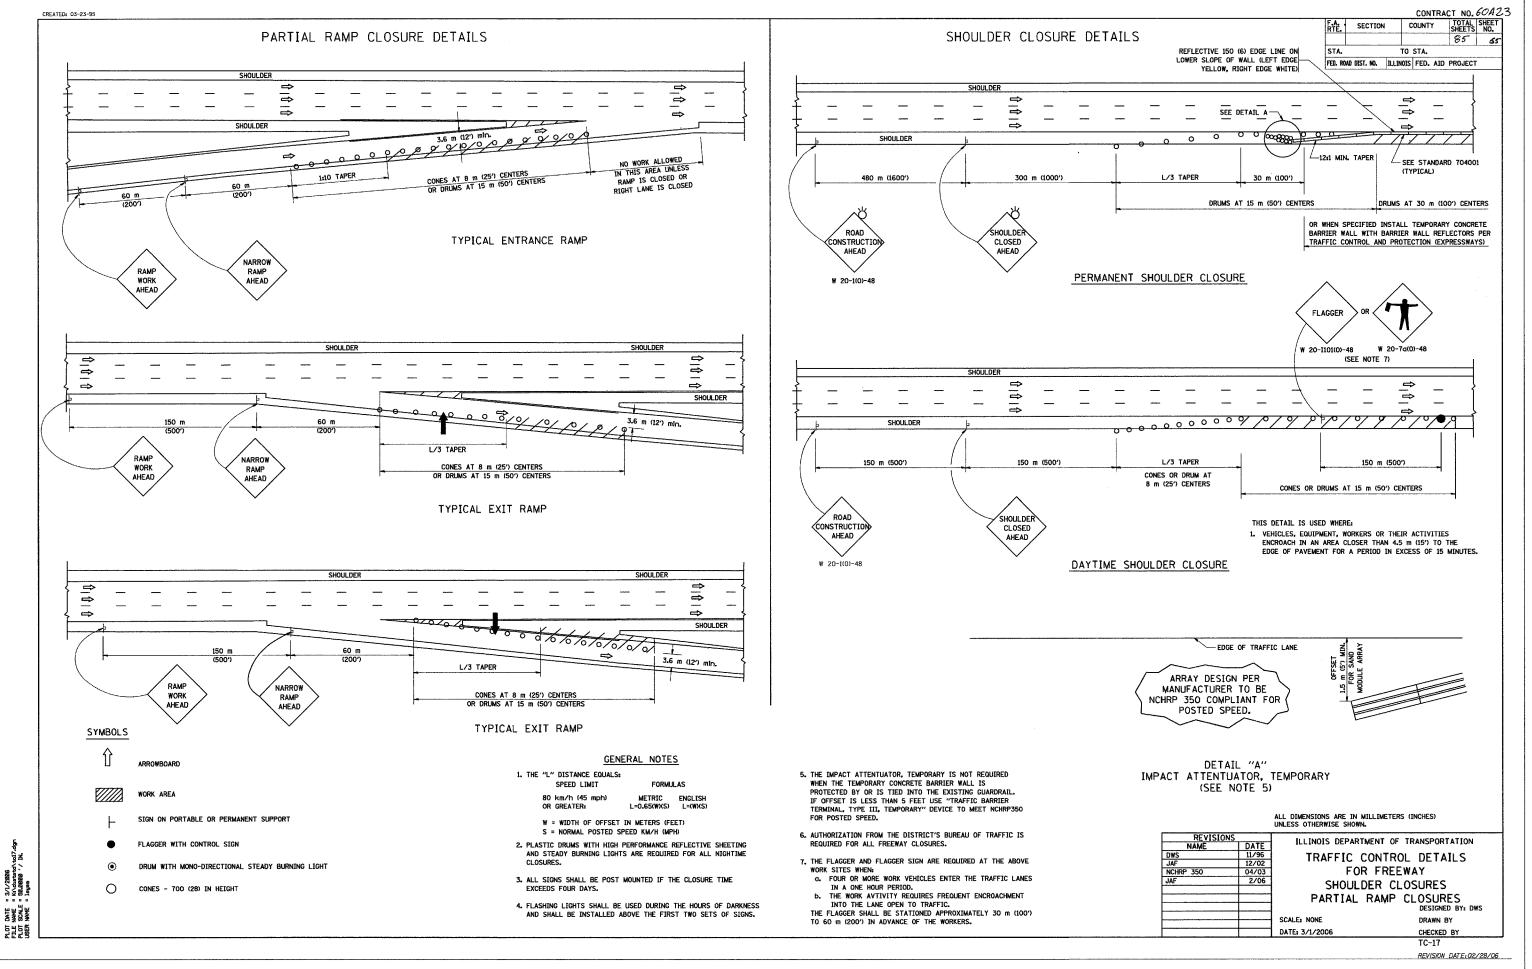



CONTRACT NO. 60A23

F.A. SECTION COUNTY TOTAL SHEET NO. 85 66 STA. TO STA. FED. ROAD DIST. NO. ILLINOIS FED. AID PROJECT

WORK ZONE EXIT OPENING

SIGNING FOR FLAGGING OPERATIONS AT WORK ZONE OPENINGS

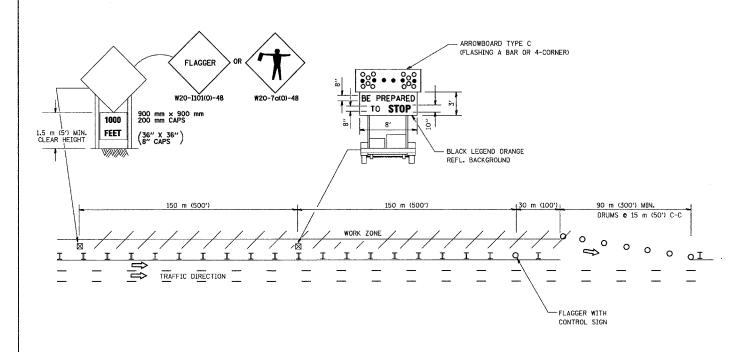

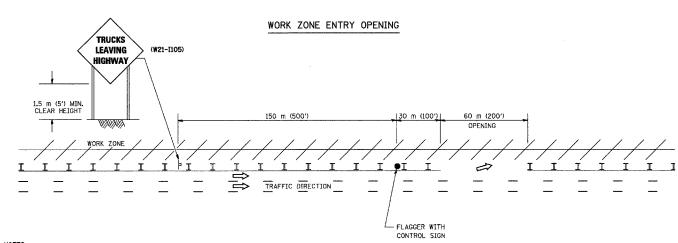

- NOTES:
- 1. The Arrowboard, the Flagger Ahead trailer mounted sign, and the Trucks Leaving Highway sign shall be removed or turned away from traffic and the exit and entry openings shall be closed when the flagging operation ceases.
- 2. Work Zone Exit Openings should be a minimum of one half mile apart.
- 3. Exiting the work zone at any place other than at a Work Zone Exit Opening will

4. All vehicles shall enter the work zone at entry openings, using their turn signals to warn motorists


ALL DIMENSIONS ARE IN MILLIMETERS (INCHES) UNLESS OTHERWISE SHOWN


ILLINOIS DEPARTMENT OF TRANSPORTATION SIGNING FOR FLAGGING OPERATIONS AT WORK ZONE OPENINGS


> SCALE: NONE DATE: 3/1/2006


DRAWN BY CADD CHECKED BY


TC-18 REVISION DATE: 02/28/06

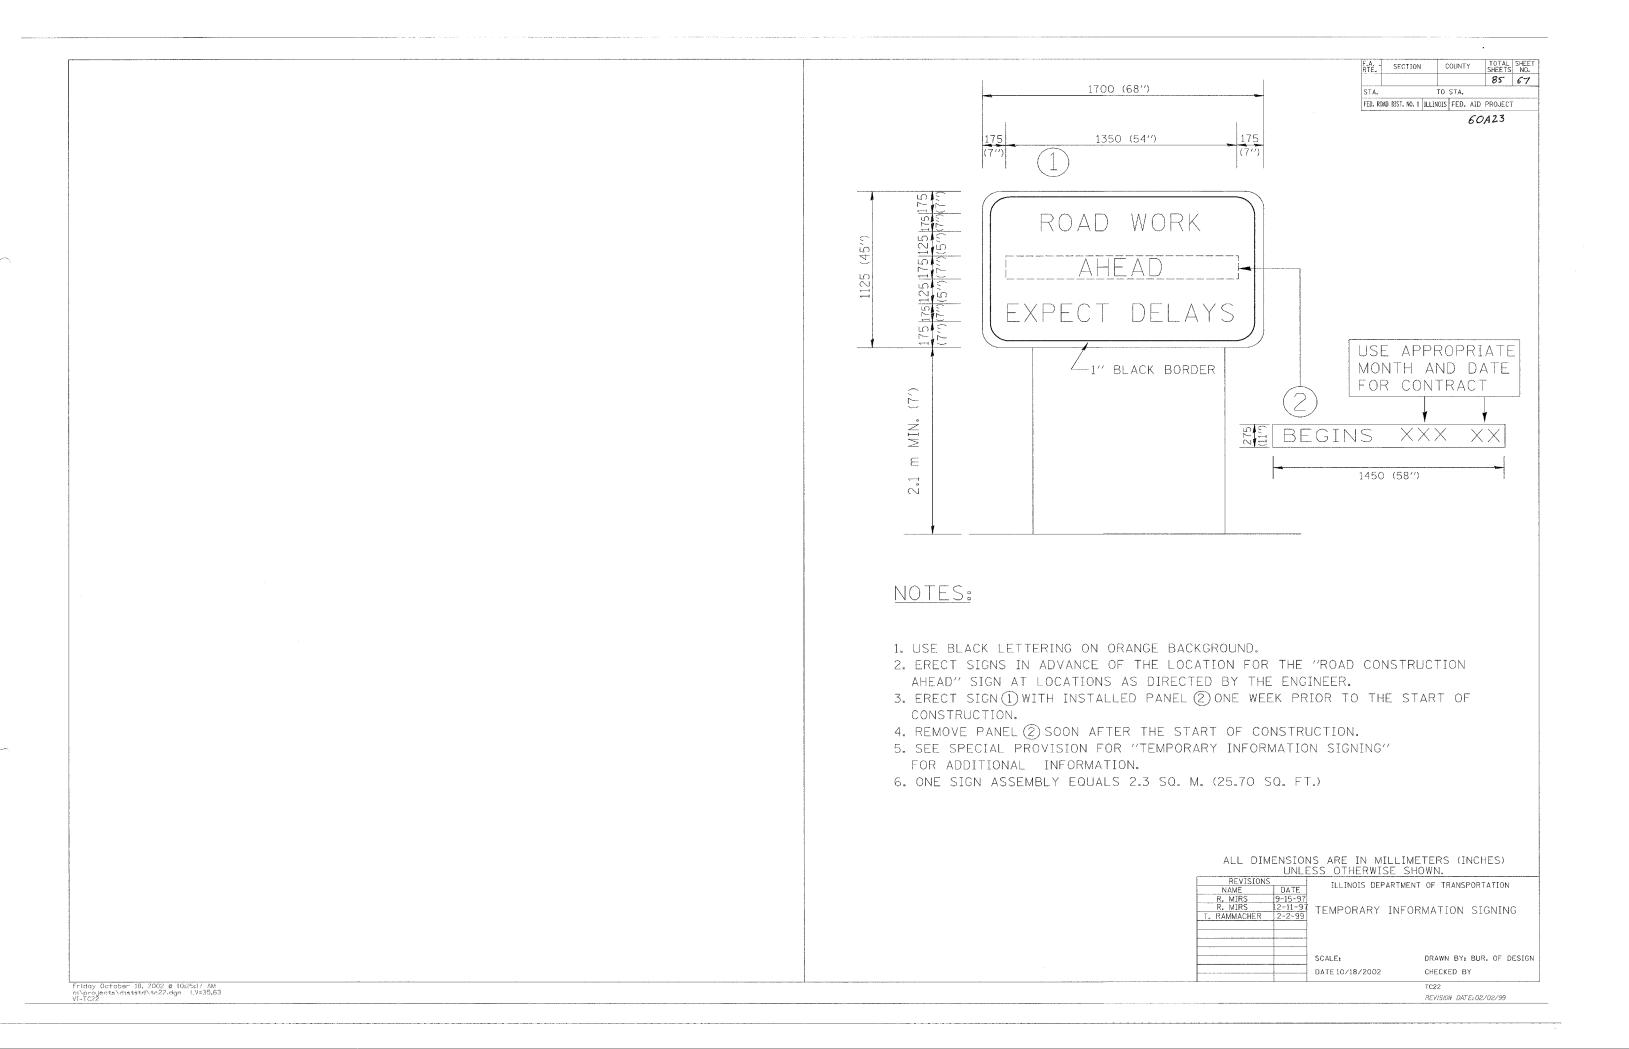


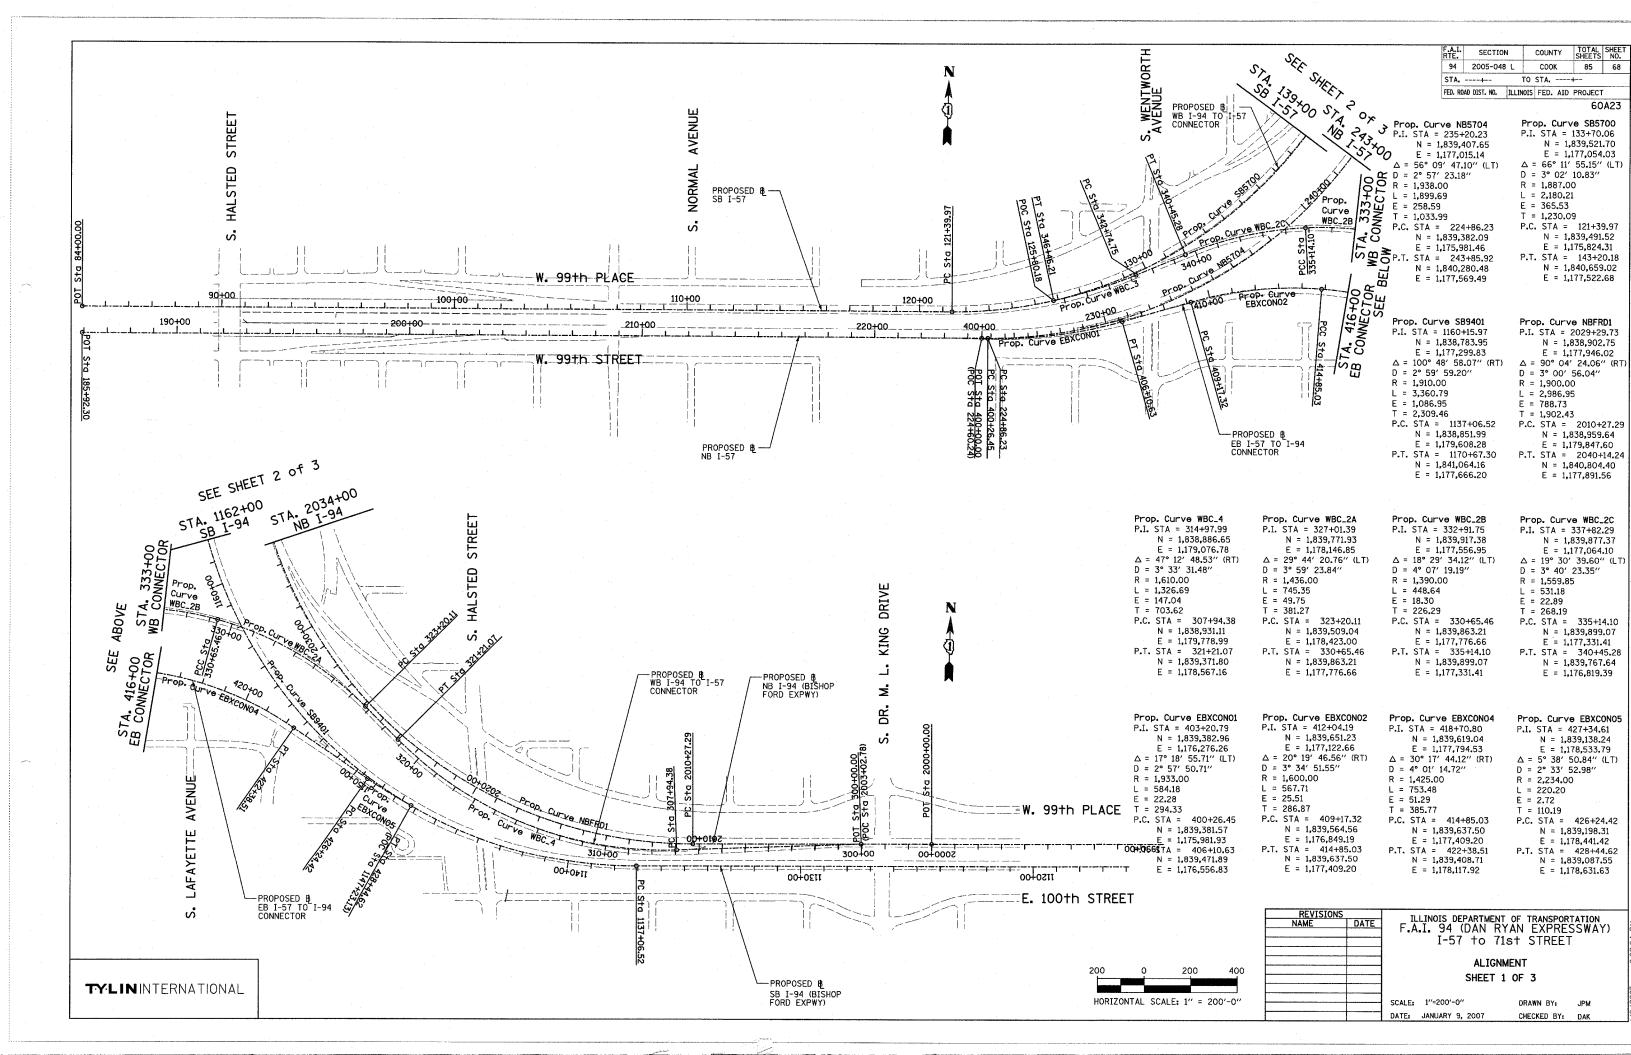

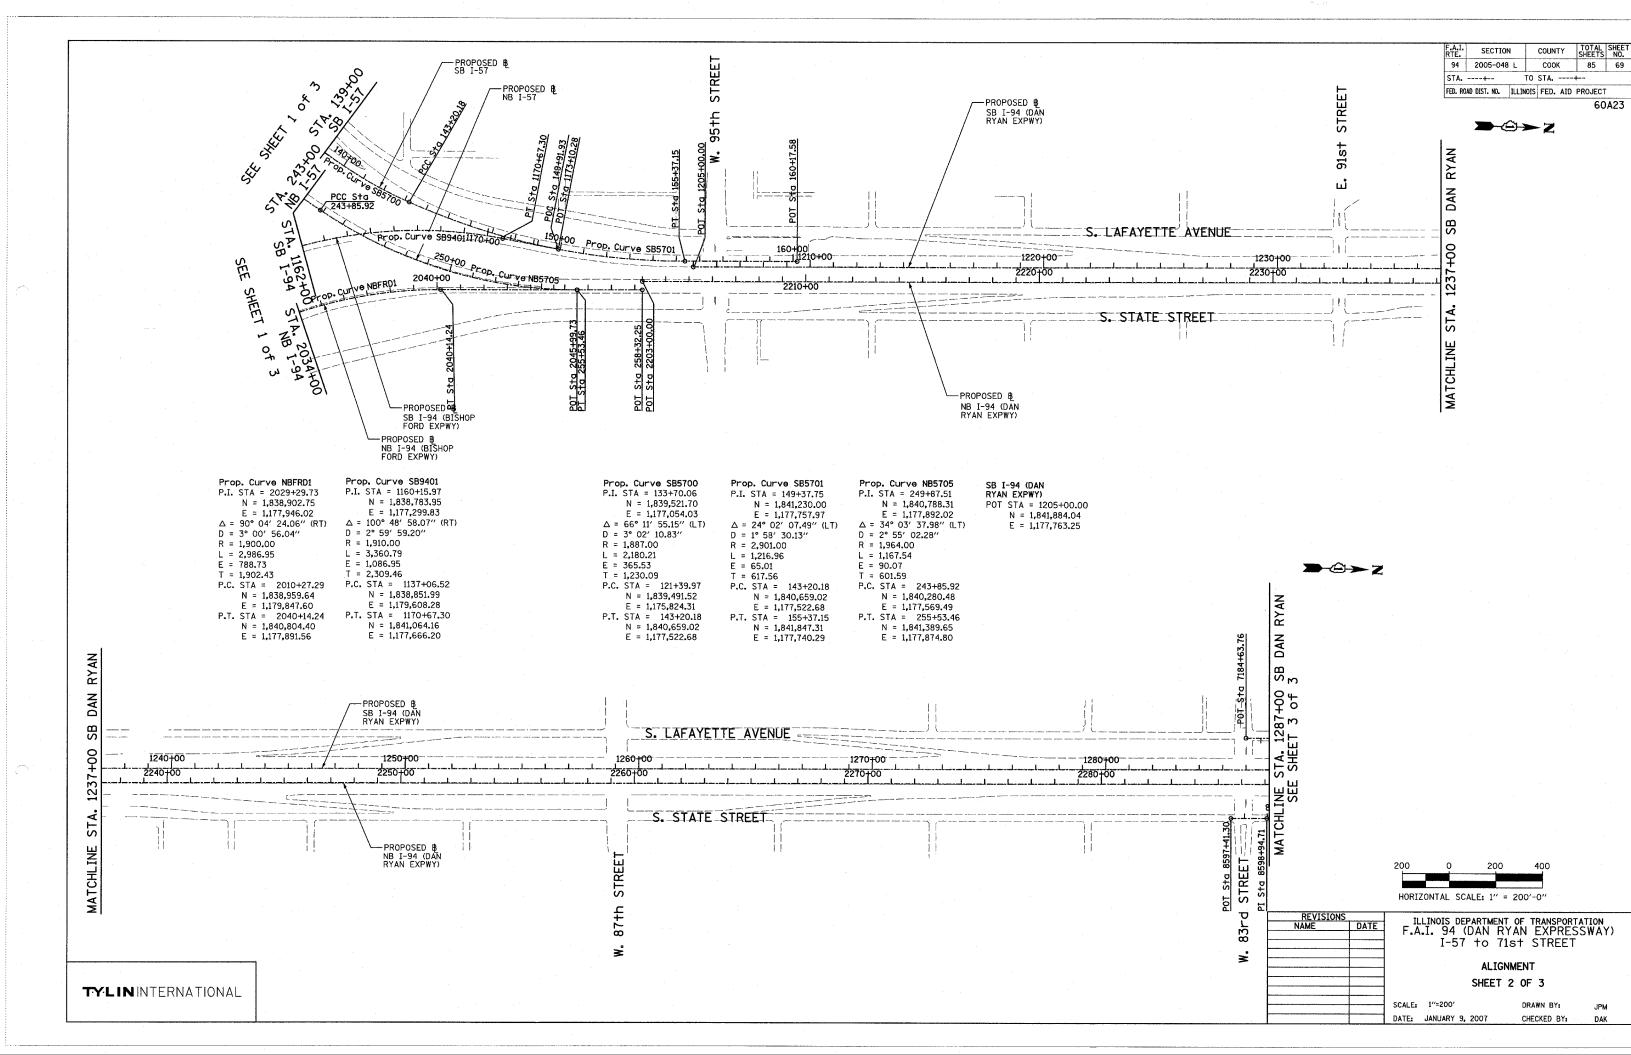

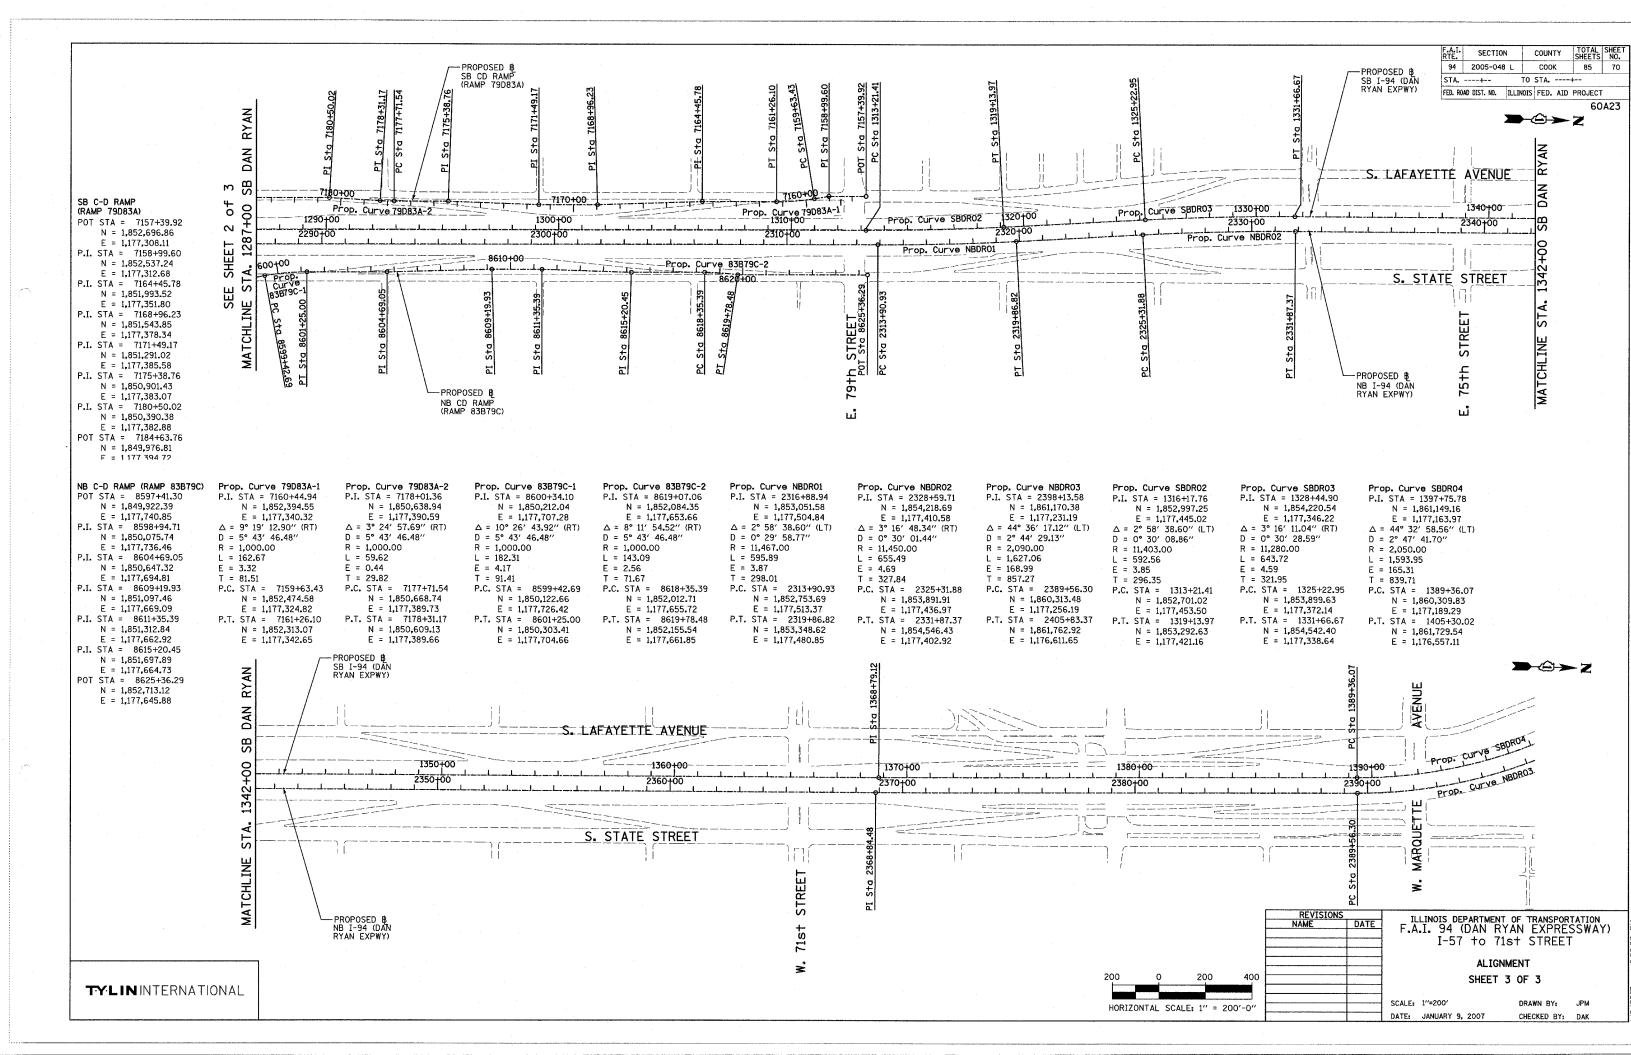

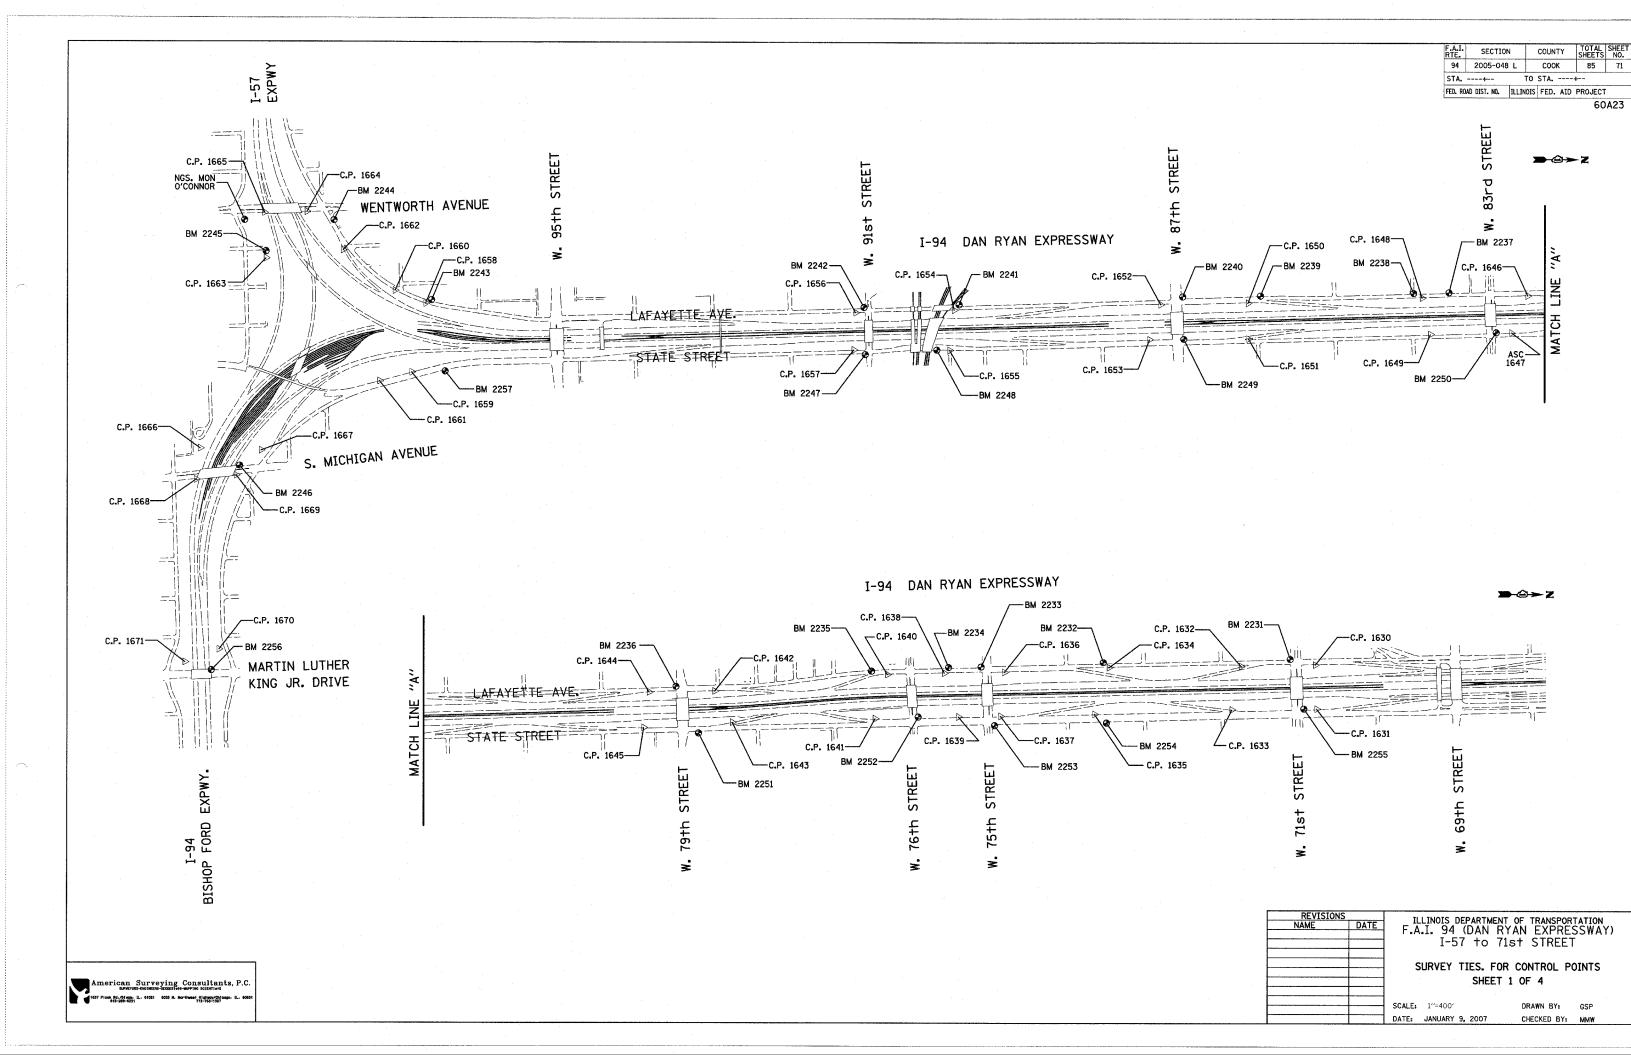

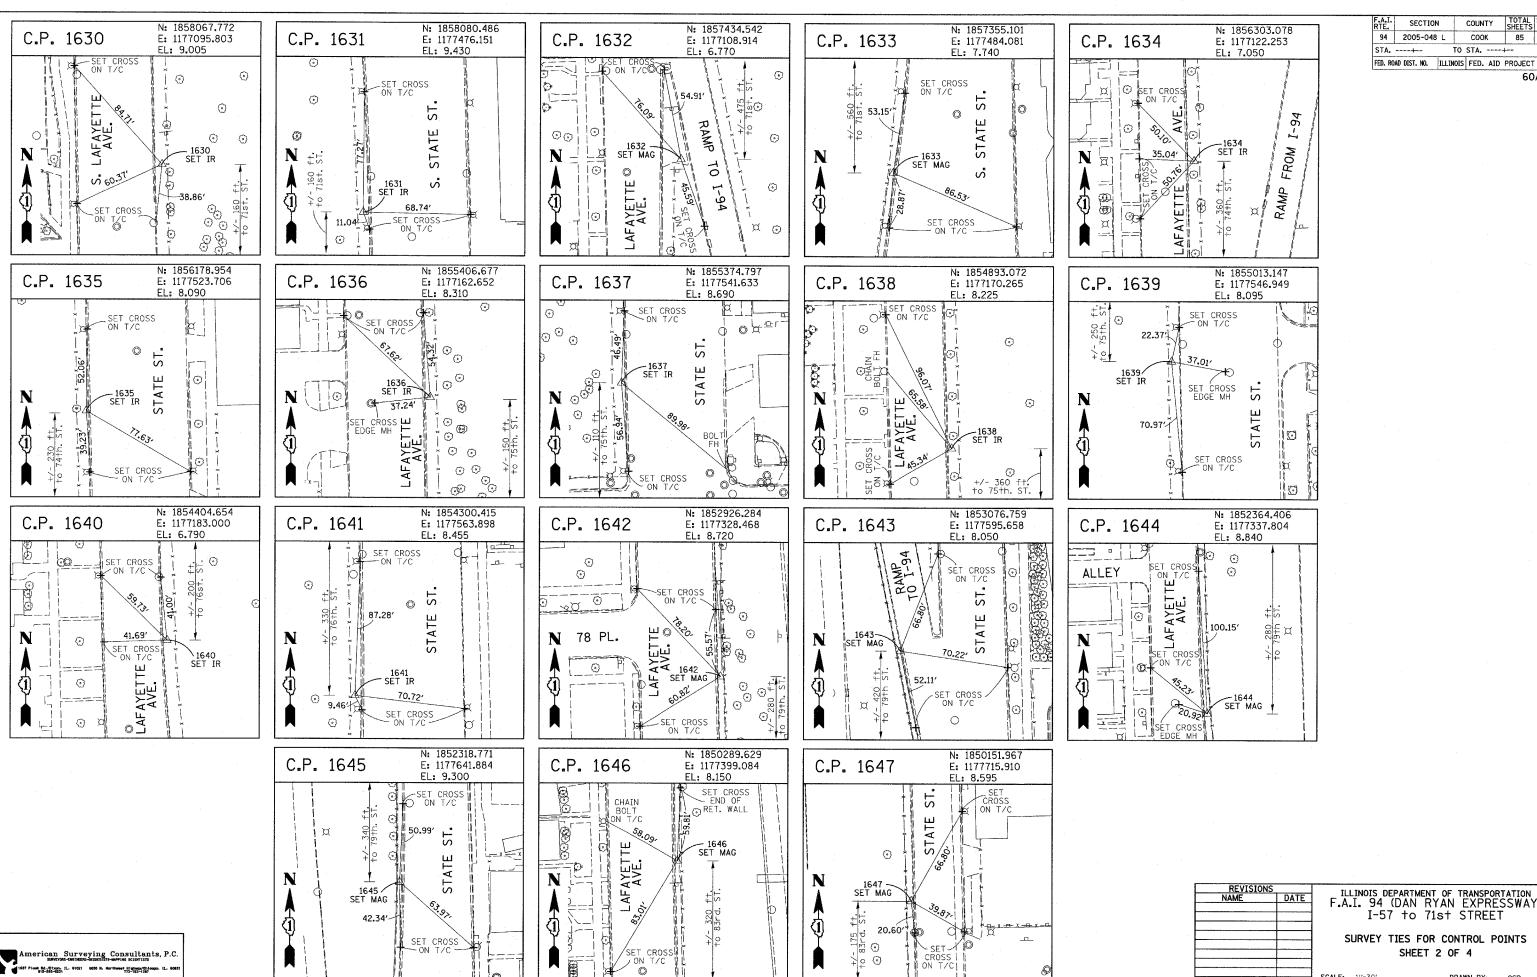

ILLINOIS DEPARTMENT OF TRANSPORTATION F.A.I. 94 (DAN RYAN EXPRESSWAY) I-57 to 71st STREET SURVEY TIES FOR CONTROL POINTS SHEET 2 OF 4

COUNTY TOTAL SHEE SHEETS NO.


60A23

COOK

TO STA. ----+--

SECTION

DRAWN BY: GSP DATE: JANUARY 9, 2007 CHECKED BY: MMW

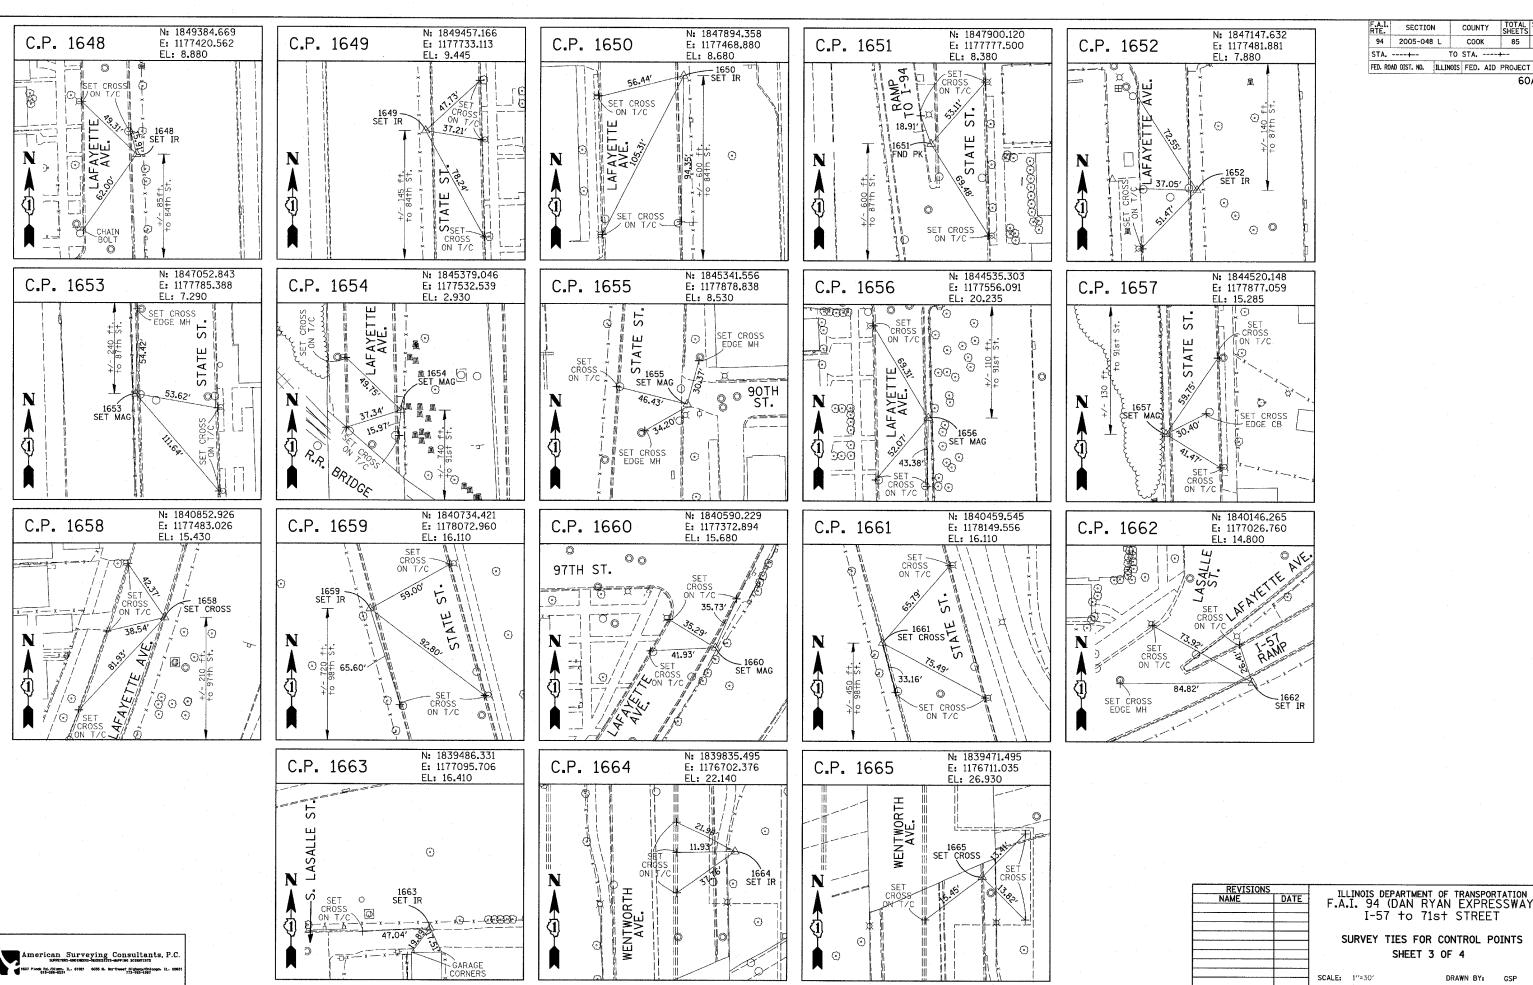

ILLINOIS DEPARTMENT OF TRANSPORTATION F.A.I. 94 (DAN RYAN EXPRESSWAY) I-57 to 71st STREET SURVEY TIES FOR CONTROL POINTS SHEET 3 OF 4

DATE: JANUARY 9, 2007

DRAWN BY: GSP CHECKED BY: MMW


COUNTY


соок


TO STA. ----+--


85 73


60A23

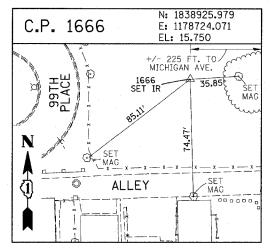

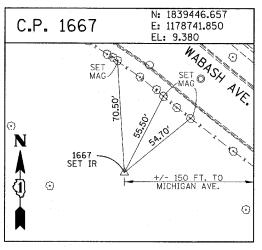

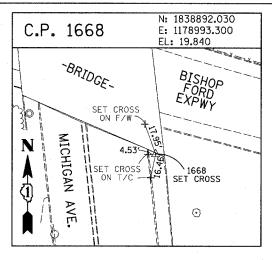


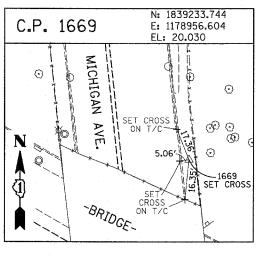

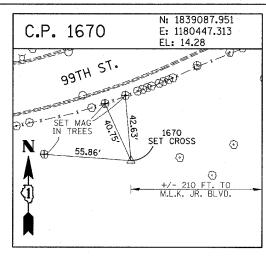

COUNTY TOTAL SHEET NO. F.A.I. SECTION 94 2005-048 L COOK 85 74 STA. ---+--TO STA. ----+--FED. ROAD DIST. NO. ILLINOIS FED. AID PROJECT

60A23

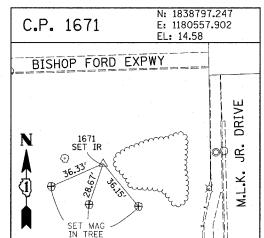

PROJECT BENCHMARKS CITY OF CHICAGO DATUM

BM 2232 ELEVATION= 8.46 FEET SET CROSS ON CHAIN BOLT OF FIRST FIRE HYDRANT SOUTH OF 73RD STREET ON THE WEST SIDE OF LAFAYETTE AVENUE, APPROXIMATELY 330 FEET SOUTH OF 73RD STREET.

BM 2233 ELEVATION= 9.90 FEET SET CROSS ON NORTHWEST BOLT OF FIRE HYDRANT ON THE NORTHWEST CORNER OF 75TH STREET AND LAFAYETTE AVENUE.

BM 2234 ELEVATION= 9.56 FEET
SET CROSS ON CHAIN BOLT OF FIRST FIRE HYDRANT SOUTH OF 75TH STREET
ON THE WEST SIDE OF LAFAYETTE AVENUE. APPROXIMATELY 320 FEET SOUTH
OF 75TH STREET.

BM 2235 ELEVATION= 7.50 FEET
SET CROSS ON CHAIN BOLT OF FIRST FIRE HYDRANT SOUTH OF 76TH STREET
ON THE WEST SIDE OF LAFAYETTE. APPROXIMATELY 330 FEET SOUTH OF
76TH STREET.

BM 2236 ELEVATION= 10.41 FEET SET CROSS ON WEST BOLT OF FIRE HYDRANT ON THE SOUTHWEST CORNER OF 79TH STREET AND LAFAYETTE AVENUE.

BM 2237 ELEVATION= 9.20 FEET SET CROSS ON CHAIN BOLT OF FIRST FIRE HYDRANT NORTH OF 83RD STREET ON THE WEST SIDE OF LAFAYETTE AVENUE, APPROXIMATELY 350 FEET NORTH OF 83RD STREET.

BM 2238 ELEVATION= 10.04 FEET
SET CROSS ON CHAIN BOLT OF FIRE HYDRANT OF THE NORTHWEST CORNER OF
4TH STREET AND LAFAYETTE AVENUE.

BM 2239 ELEVATION= 9.59 FEET
SET CROSS ON CHAIN BOLT OF SECOND FIRE HYDRANT NORTH OF 87TH STREET
ON THE WEST SIDE OF LAFAYETTE AVENUE, APPROXIMATELY 720 FEET OF
NORTH OF 87TH STREET.

BM 2240 ELEVATION= 9.49 FEET SET CROSS ON THE NORTHWEST BOLT OF FIRE HYDRANT ON THE SOUTHWEST CORNER OF 78TH STREET AND LAFAYETTE AVENUE.

BM 2241 ELEVATION= 3.63 FEET
SET SQUARE CUT ON TOP OF CURB NEXT TO LIGHT POLE ON THE NORTHWEST
CORNER OF LAFAYETTE AVENUE AND RAILROAD BRIDGE. APPROXIMATELY 770
FEET NORTH OF 91ST STREET.

BM 2242 ELEVATION= 22.82 FEET
SET CROSS ON CHAIN BOLT OF FIRE HYDRANT ON THE SOUTHWEST CORNER OF 91ST STREET AND LAFAYETTE

BM 2243 ELEVATION= 15.68 FEET
SET SQUARE CUT ON THE TOP OF CURB NEXT TO THIRD LIGHT POLE NORTH OF
97TH STREET ON THE WEST SIDE OF LAFAYETTE AVENUE. APPROXIMATELY
260 FEET NORTH OF 97TH STREET.

BM 2244 ELEVATION= 15.94 FEET
SET SQUARE CUT ON TOP OF CURB NEXT TO LIGHT POLE ON THE NORTH SIDE
OF 98TH STREET. APPROXIMATELY 120 FEET EAST OF WENTWORTH AVENUE.

BM 2245 ELEVATION= 16.35 FEET
SET SQUARE CUT ON THE EAST END OF CURB AT THE NORTHEAST CORNER OF
FIRST ALLEY NORTH OF 99TH STREET. APPROXIMATELY 35 FEET EAST OF LASALLE
STREET.

BM 2246 ELEVATION= 20.00 FEET
SET SQUARE CUT WITH CROSS ON TOP OF ABUTMENT WALL ON THE NORTHWEST
CORNER OF STATE STREET BRIDGE OVER THE BISHOP FORD EXPRESSWAY.
APPROXIMATELY 20 FEET NORTH OF THE NORTH EDGE OF THE BRIDGE.

BM 2247 ELEVATION= 14.81 FEET
SET CROSS ON NORTHEAST BOLT OF BASE FOR TRAFFIC SIGNAL AND LIGHT AT
THE SOUTHEAST CORNER OF 91ST AND STATE STREET.

BM 2248 ELEVATION= 9.77 FEET
SET CROSS ON CHAIN BOLT OF FIRST FIRE HYDRANT NORTH OF RAILROAD BRIDGE
ON THE EAST SIDE OF STATE STREET. APPROXIMATELY 110 FEET SOUTH OF

BM 2249 ELEVATION= 9.67 FEET SET CROSS ON CHAIN BOLT OF FIRE HYDRANT ON THE NORTHWEST CORNER OF 87TH AND STATE STREET.

BM 2250 ELEVATION= 10.03 FEET SET CROSS ON CHAIN BOLT OF FIRE HYDRANT ON THE NORTHWEST CORNER OF 83RD ST. AND STATE STREET.

BM 2251 ELEVATION= 10.95 FEET FOUND CROSS ON EAST BOLT OF FIRE HYDRANT ON THE EAST SIDE OF STATE STREET. APPROXIMATELY 135 FEET NORTH OF 79TH STREET.

BM 2252 ELEVATION= 10.02 FEET SET CROSS ON WEST BOLT OF FIRE HYDRANT ON THE NORTHWEST CORNER OF STATE STREET AND 76TH STREET.

BM 2253 ELEVATION= 9.07 FEET SET CROSS ON EAST BOLT OF FIRE HYDRANT ON THE NORTHEAST CORNER OF 75TH STREET AND STATE STREET.

BM 2254 ELEVATION= 9.17 FEET
SET CROSS ON CHAIN BOLT OF FIRST FIRE HYDRANT SOUTH OF 73RD STREET
ON THE EAST SIDE OF STATE STREET. APPROXIMATELY 330 FEET SOUTH OF
73RD STREET.

BM 2255 ELEVATION= 11.25 FEET SET CROSS ON CHAIN BOLT OF FIRE HYDRANT ON THE NORTHWEST CORNER OF 71ST STREET AND STATE STREET.

BM 2256 ELEVATION= 16.36 FEET
SET SQUARE CUT ON TOP OF ABUTMENT WALL ON THE NORTHWEST CORNER OF
MARTIN LUTHER KING DRIVE BRIDGE OVER THE BISHOP FORD EXPRESSWAY.
APPROXIMATELY 1 FOOT NORTH OF THE NORTH END OF THE BRIDGE.

BM 2257 ELEVATION= 18.25 FEET
SET CROSS ON NORTHEAST BOLT OF LIGHT POLE BASE ON THE EAST SIDE OF
STATE STREET. APPROXIMATELY 970 FEET SOUTH OF 95TH STREET.

BM 2258 ELEVATION= 10.53 FEET SET CROSS ON NORTHWEST BOLT OF LIGHT BASE ON NORTHWEST CORNER OF 71ST STREET AND LAFAYETTE AVENUE.

TI I		REVISIONS
ILI F.A.	DATE	NAME
		<u> </u>
s		
SCALE.		


LLINOIS DEPARTMENT OF TRANSPORTATION
A.I. 94 (DAN RYAN EXPRESSWAY) I-57 to 71st STREET


SURVEY TIES FOR CONTROL POINTS SHEET 4 OF 4


DATE: JANUARY 9, 2007


DRAWN BY: CHECKED BY:


American Surveying Consultants, P.C. 1637 Plock Rd./Dixon. IL. 61021 6035 N. Northwest Highway/Chicogo, IL. 6061 815-248-6231

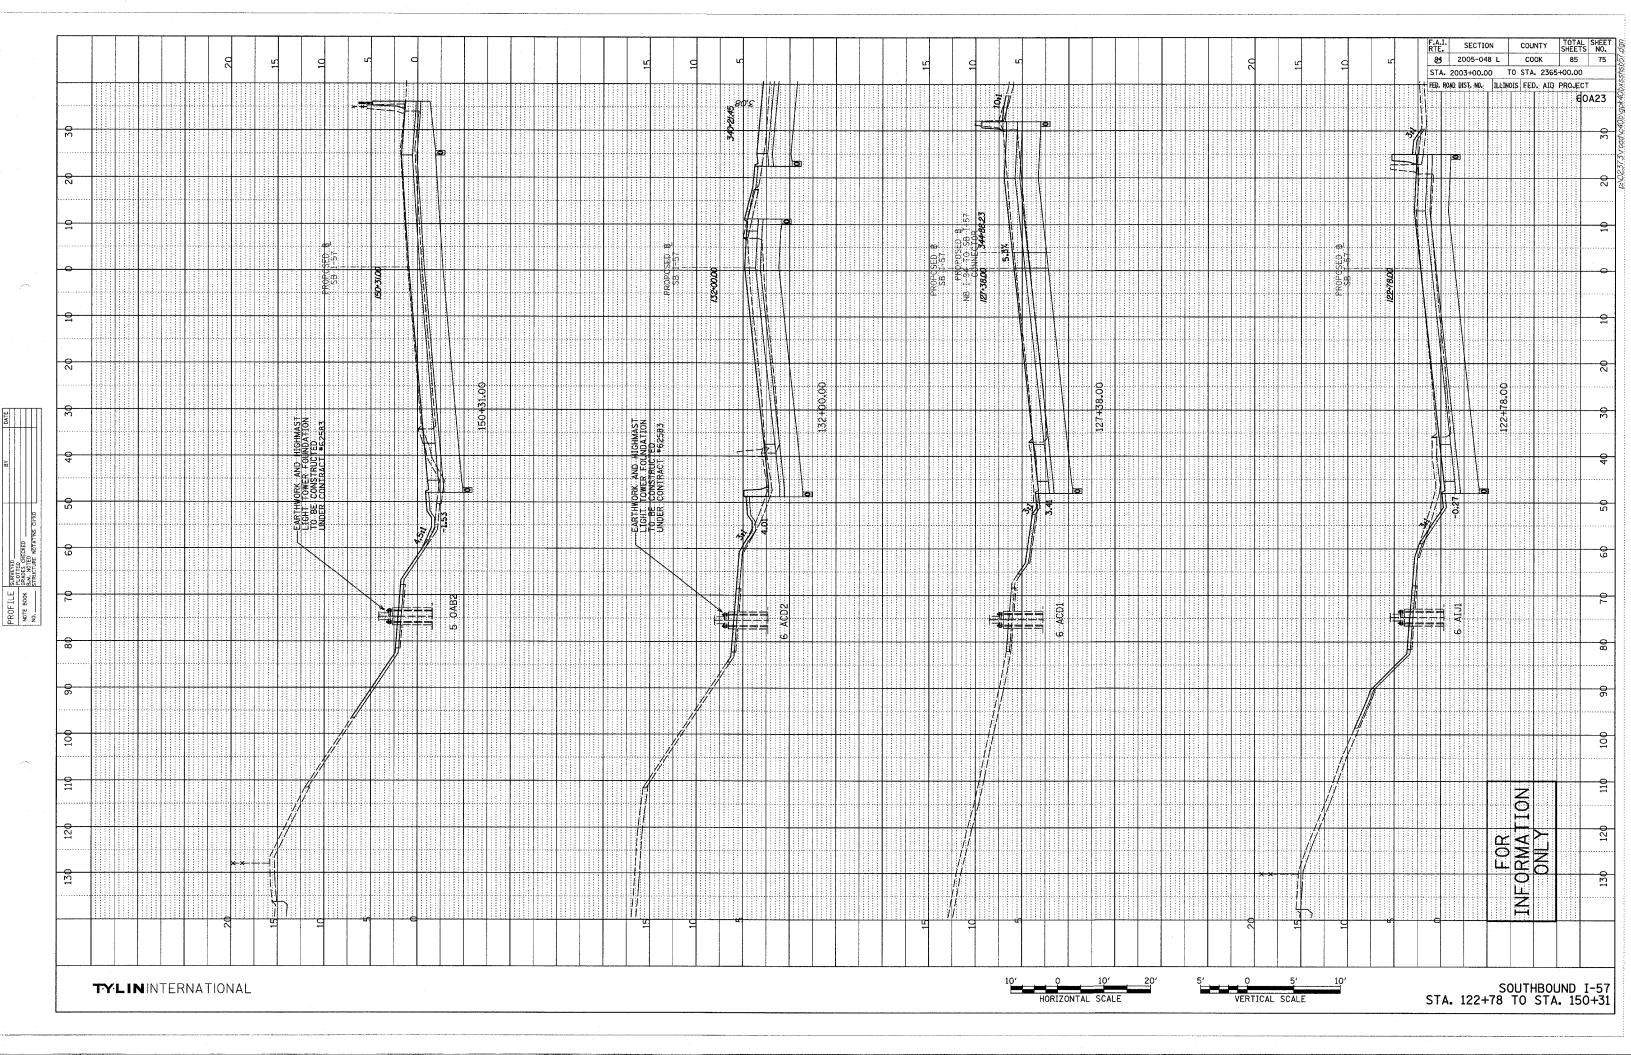


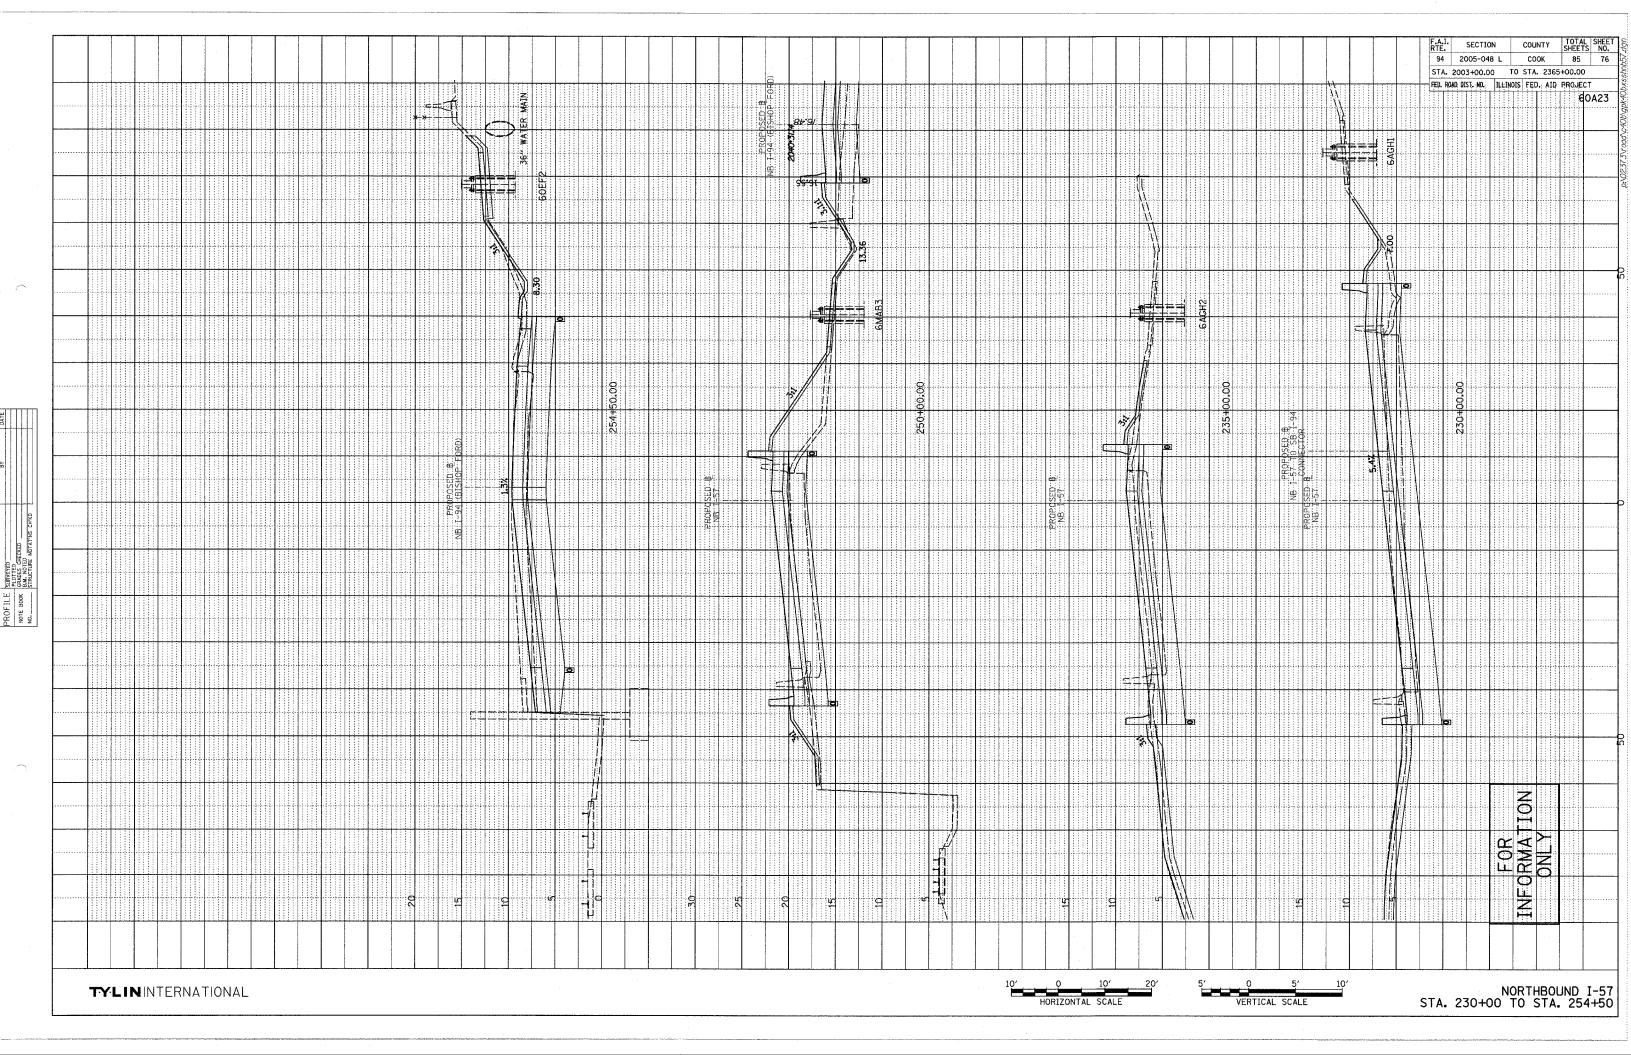


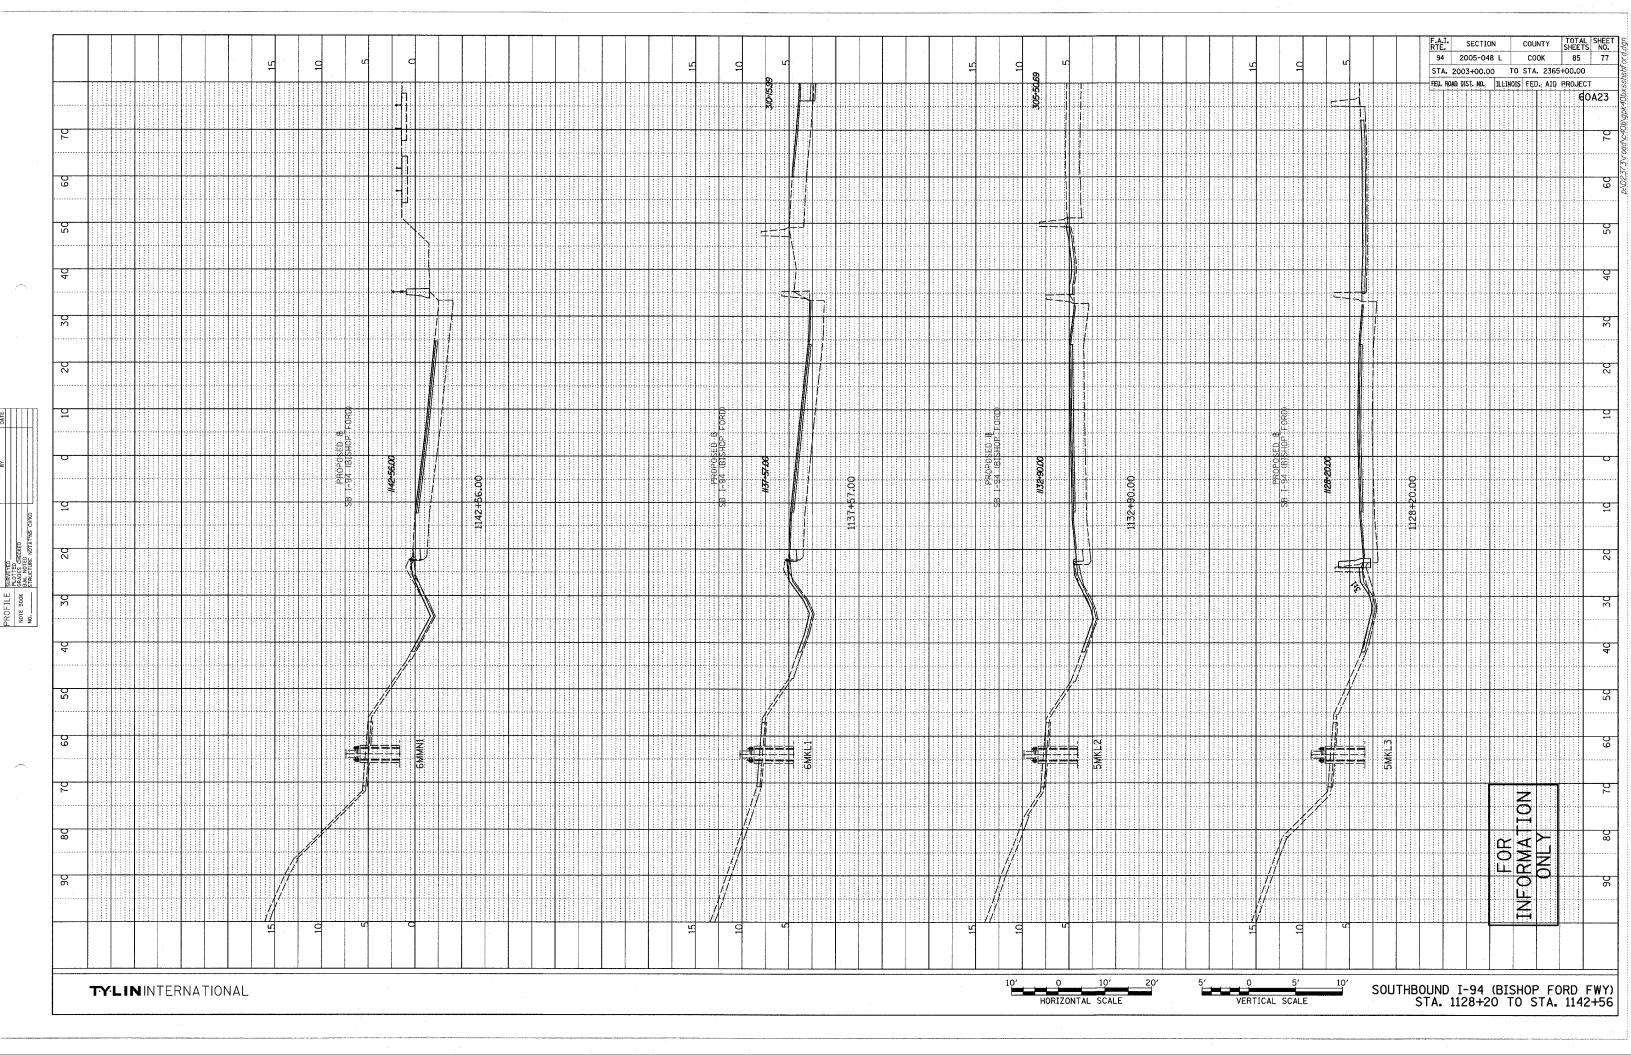


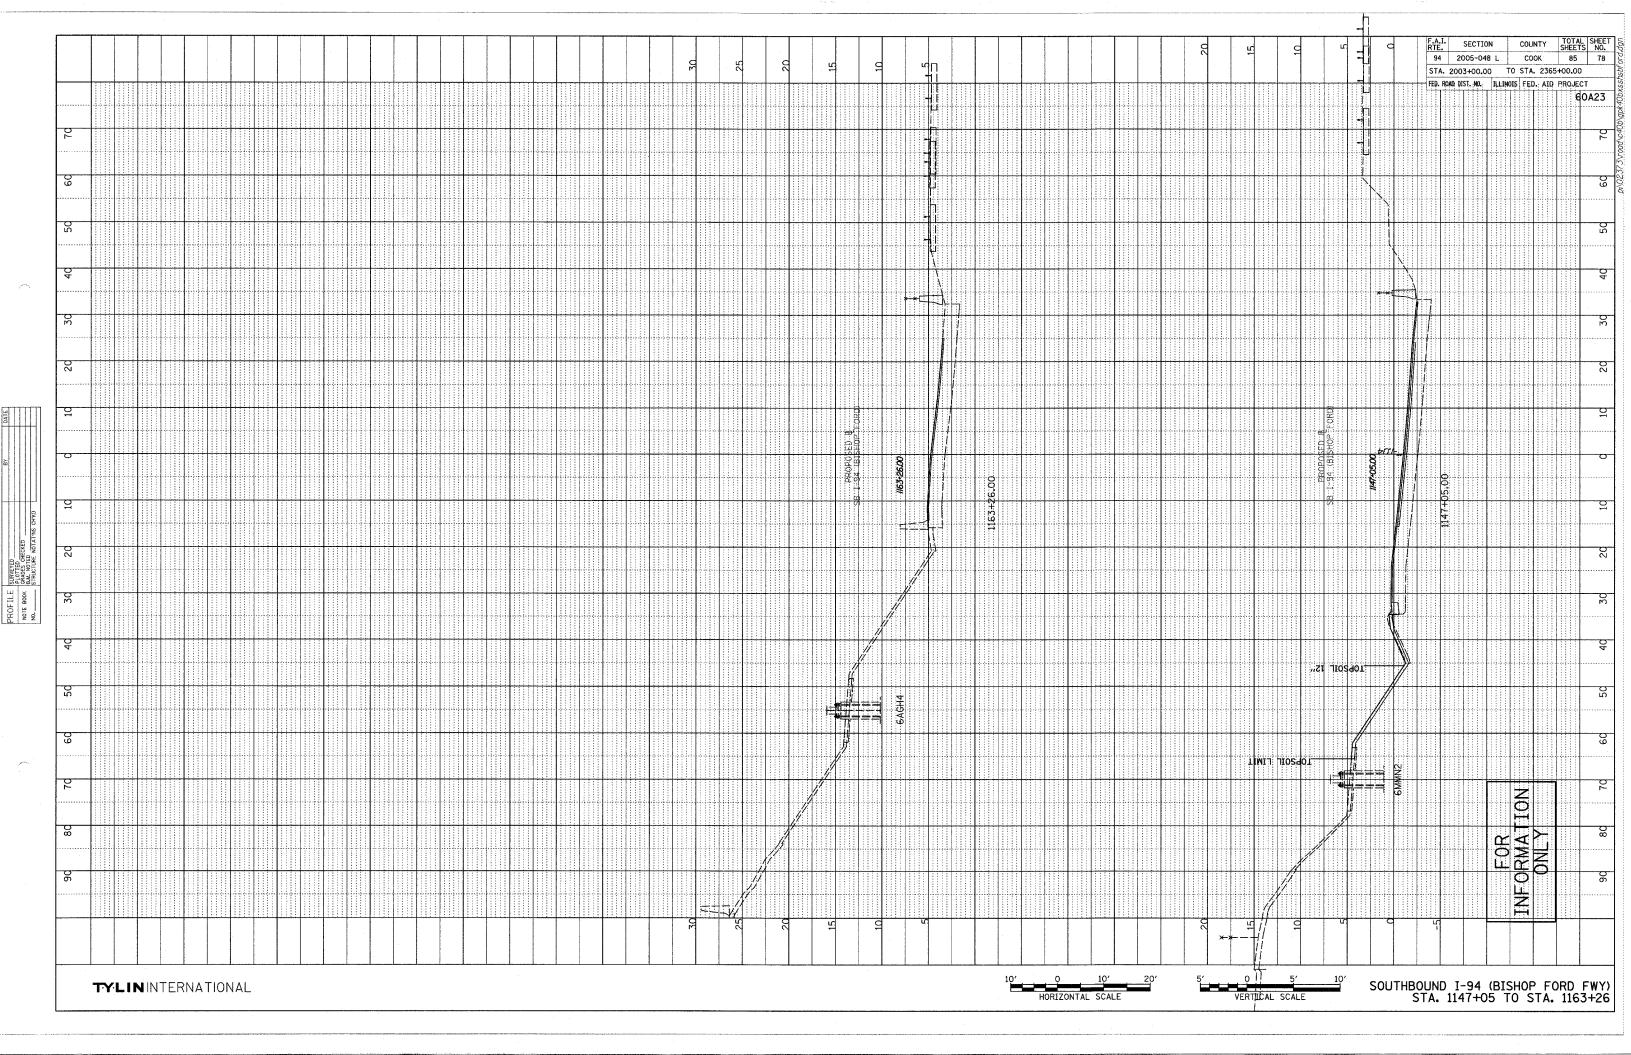


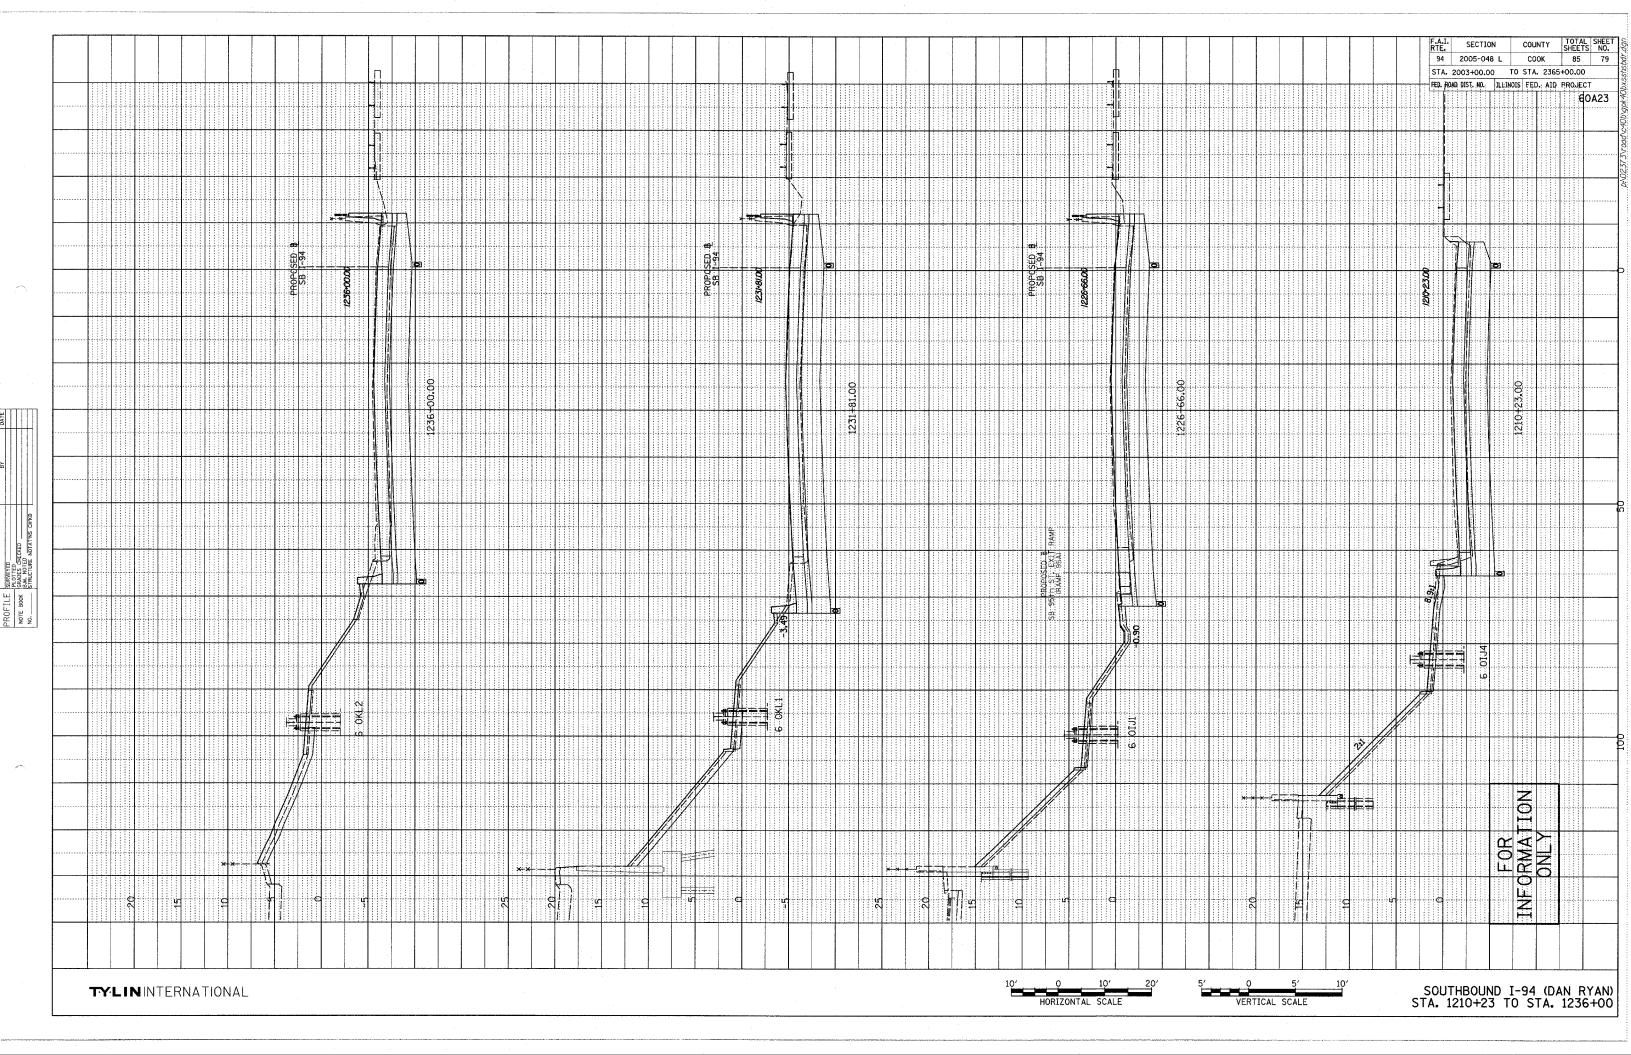

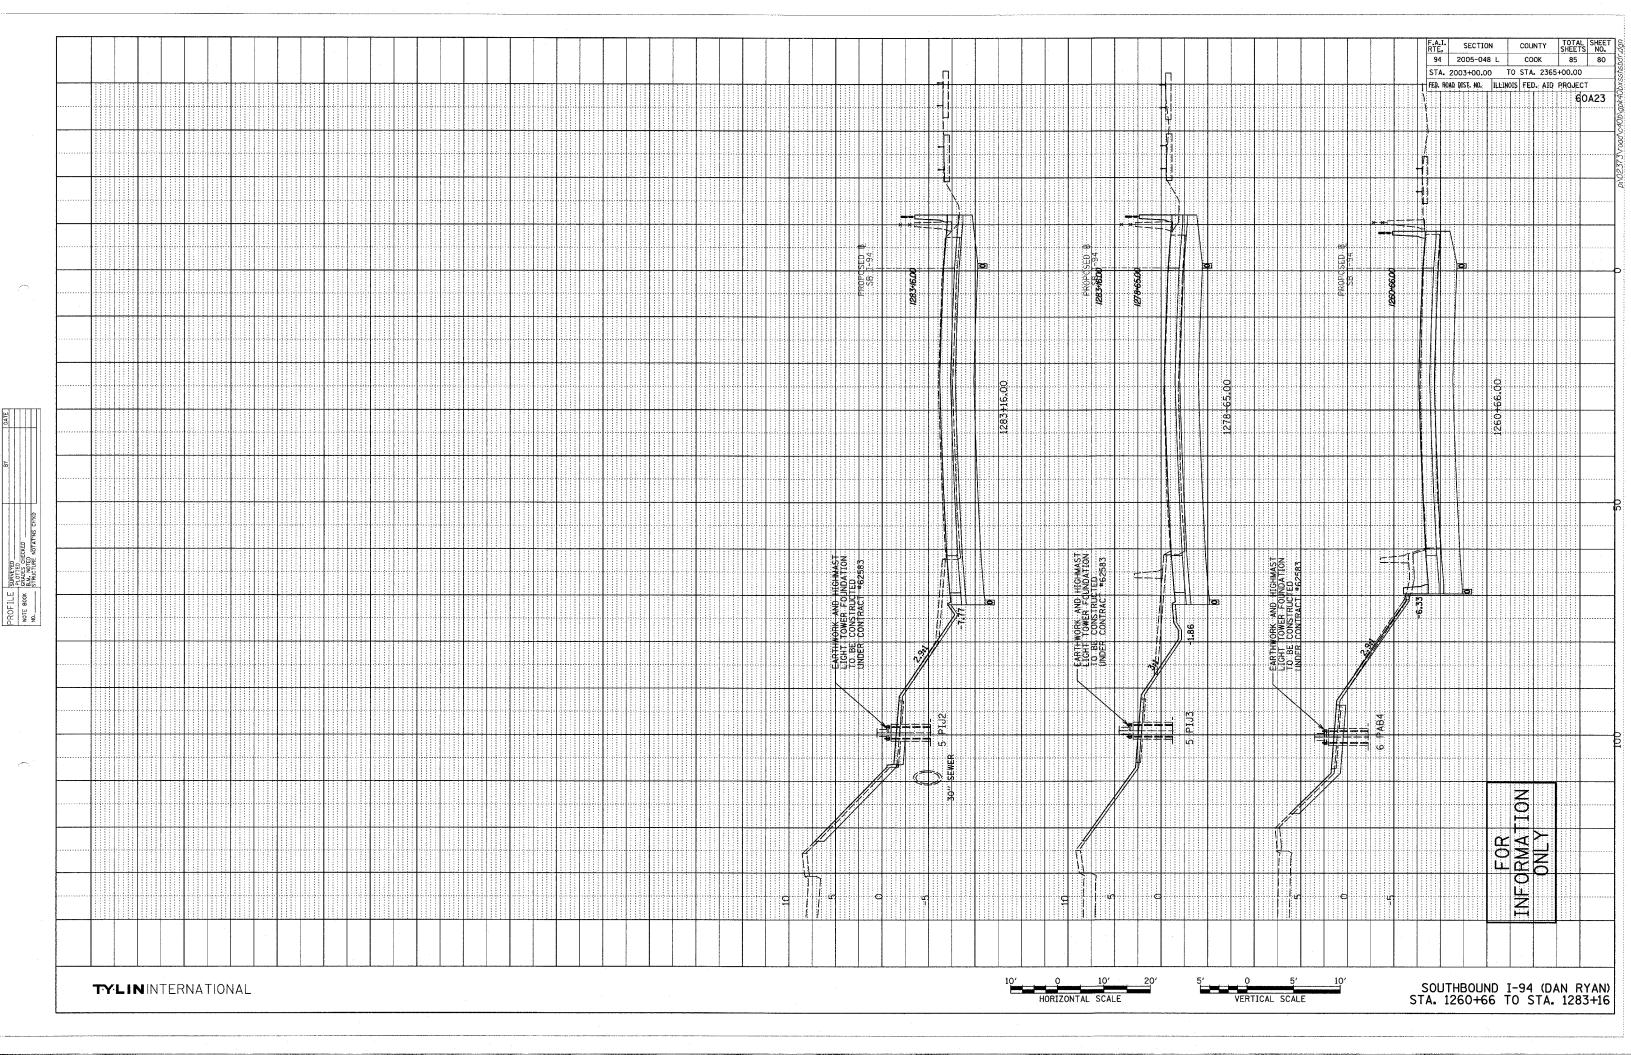

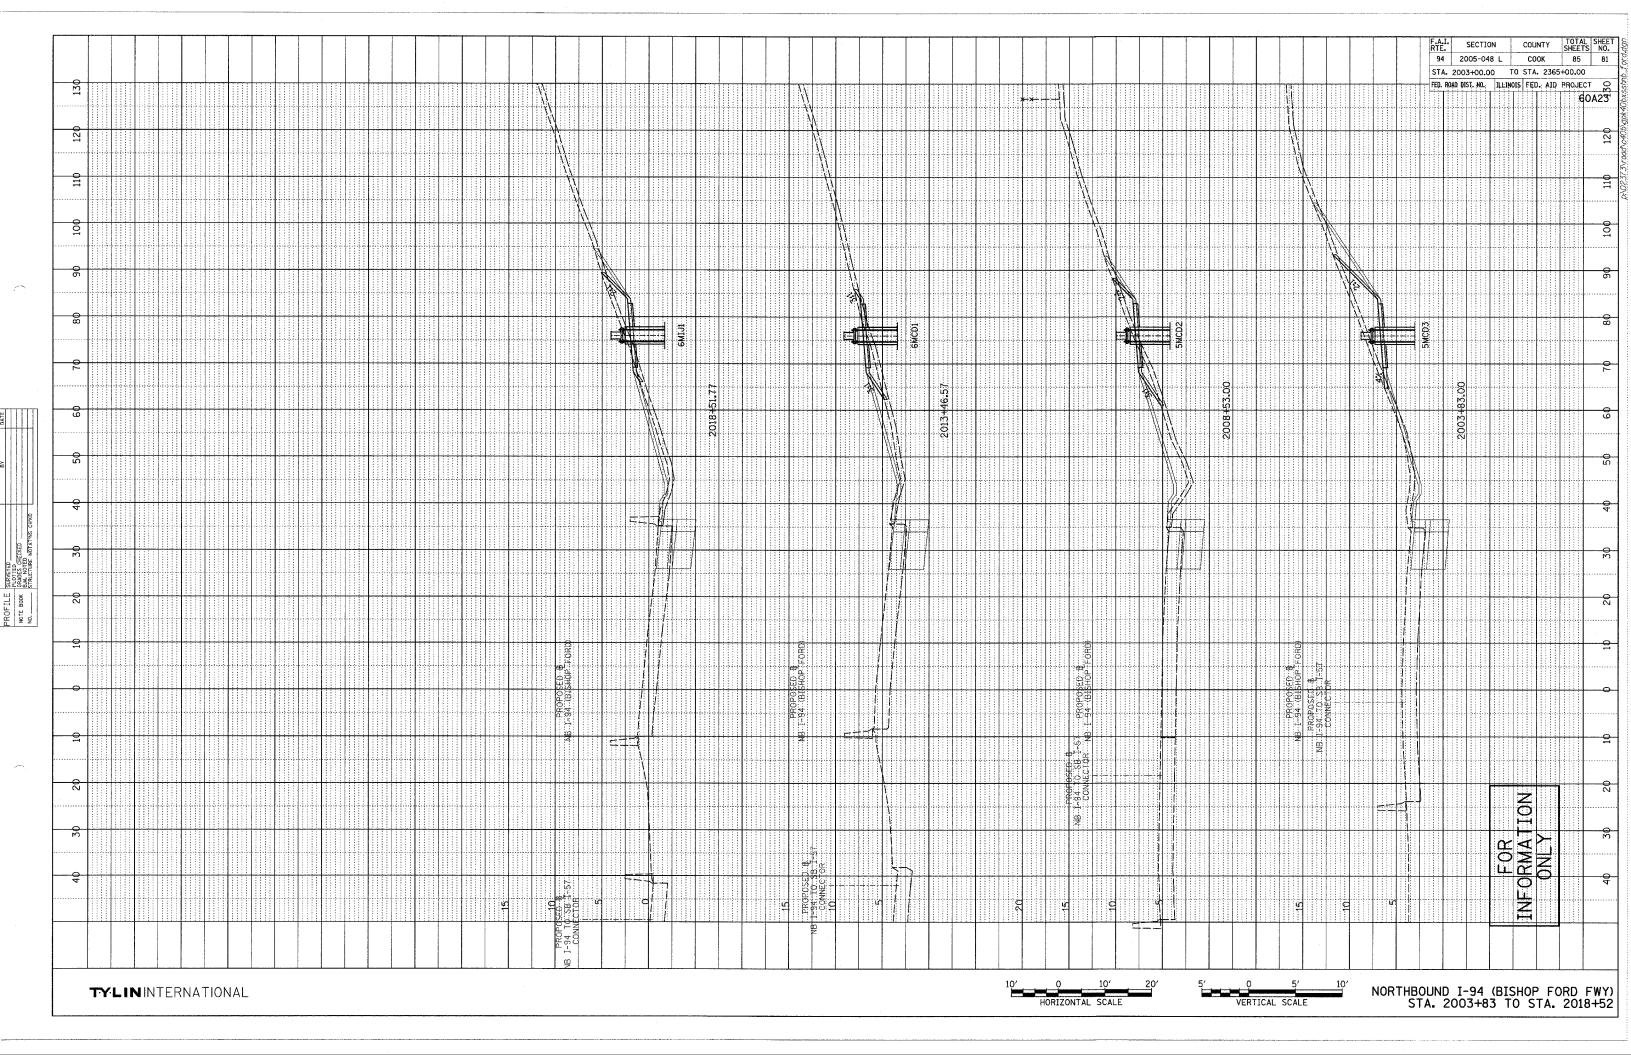

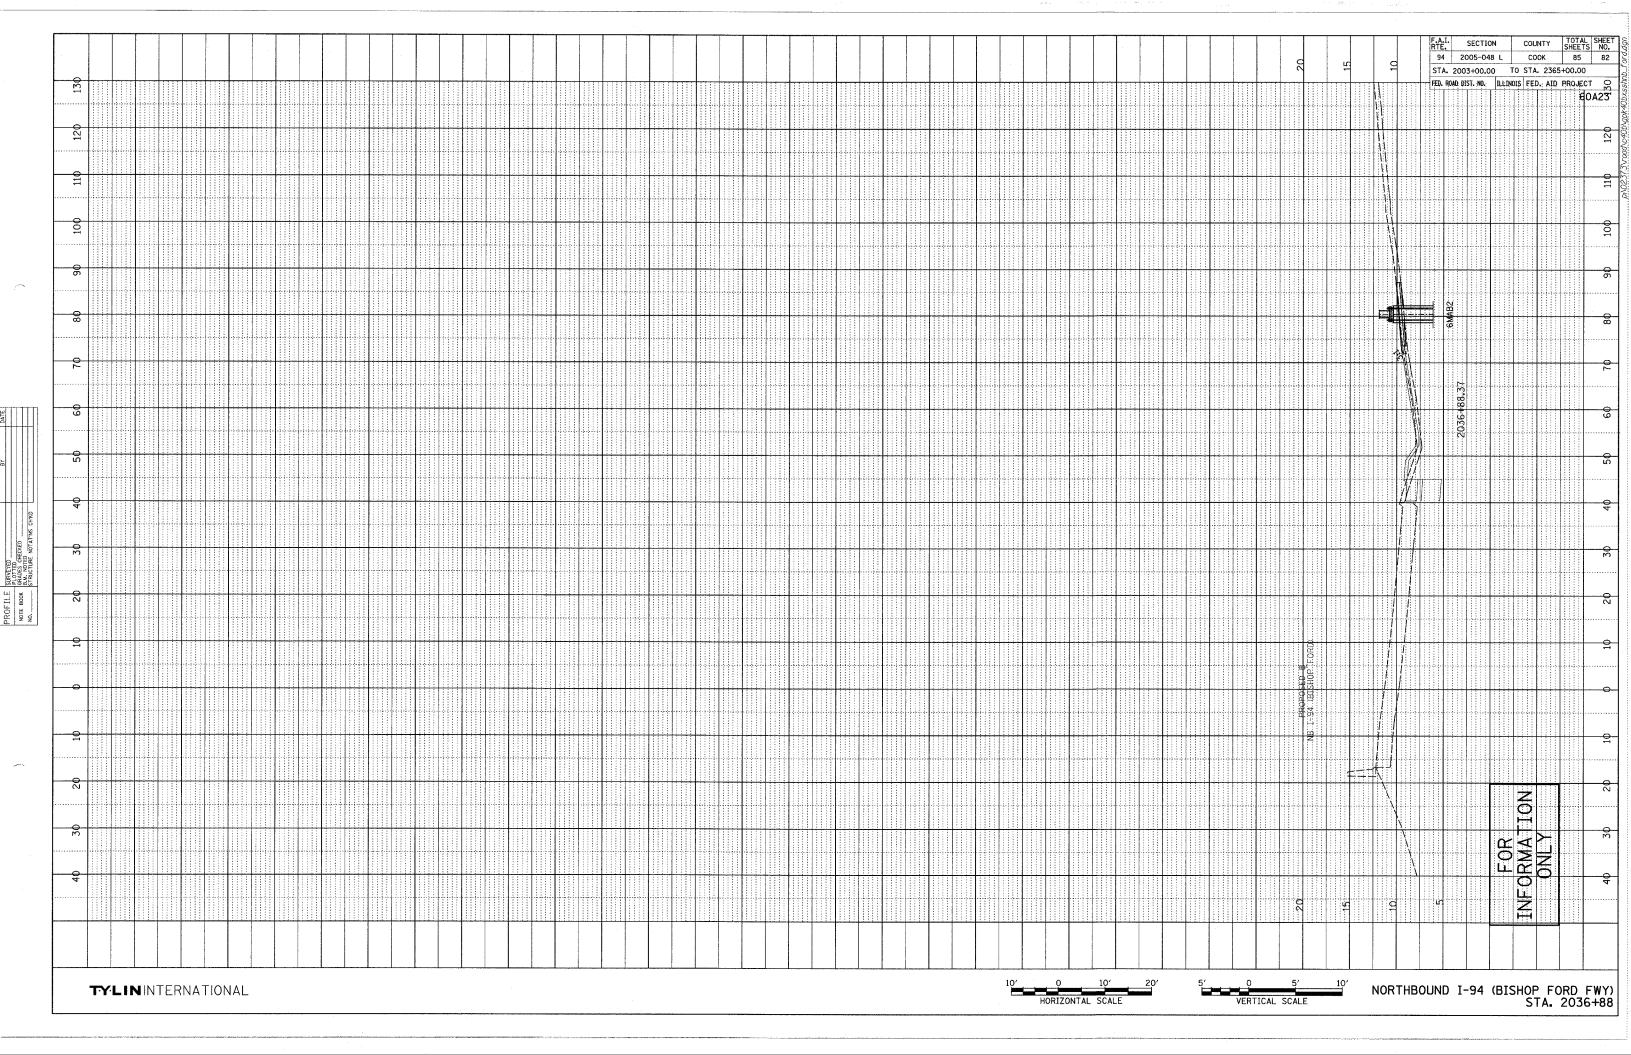

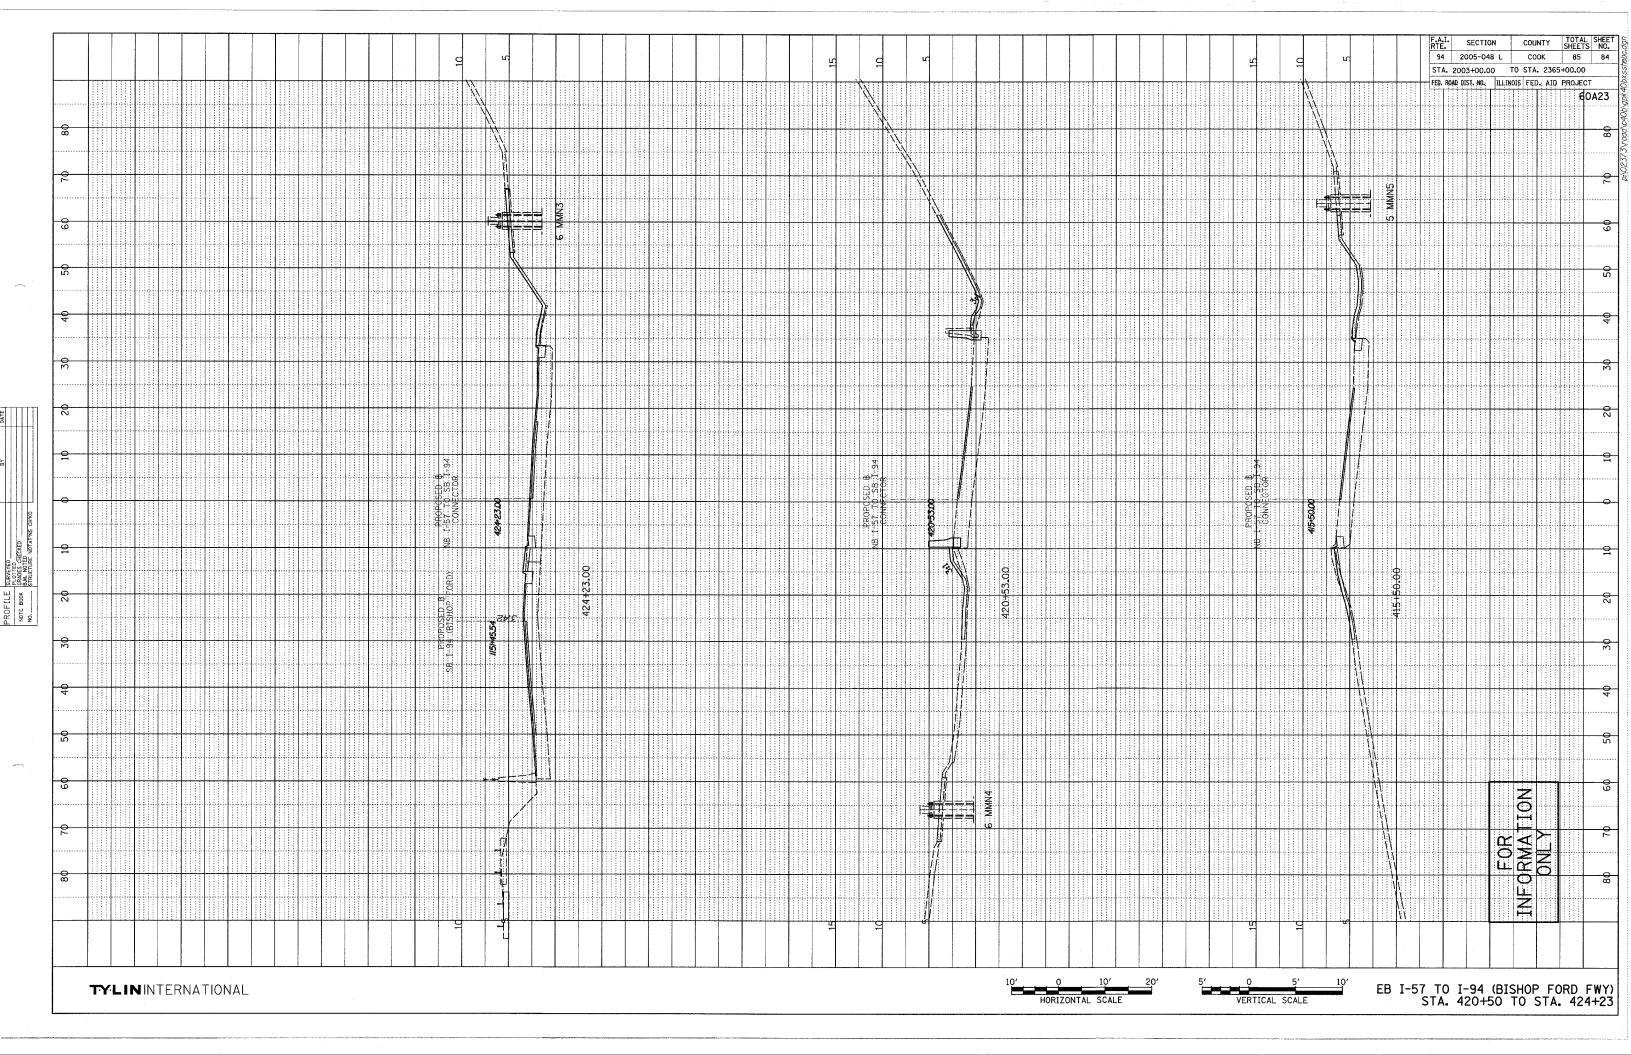

_									
	09 02 08	0 40 30	20 10	0 10	20 3	30 40	20	70 80	•
							-		
E									
5′									
								7	
10′			Ç	ğ					
			9	CONNECTOR		+			
-10					133	•			-10
		ţ.		330-5000					
					-13.35	5 A6H5			STA. FED. RO
									2003+ AD DIST.
			330 EEO 90						00.00 No.: I
	HOK TOK		3						TO
	INFURMA LUN								STA.
									365+00
									OTAL HEETS 85 0.00 OJECT
	80 70 60 50	30	20 10						