FOR INDEX OF SHEETS, SEE SHEET NO. 3 04-26-2024 LETTING ITEM 182

**DESIGN DESIGNATION** 

I-80 - PRINCIPLE ARTERIAL SYSTEM INTERSTATE 4040(30) INTERSTATE 134.3 (CRC-20)

**RICHARDS ST - 1385(35) MINOR ARTERIAL 16.90(FD-20)** 

TRAFFIC DATA

I-80 CENTER ST TO RICHARDS ST **EXISTING ADT: 80,400 (2019)** 

I-80 RICHARDS ST TO BRIGGS ST **EXISTING ADT: 79.700 (2019)** 

RICHARDS ST

**EXISTING ADT: 8,800 (2016) DESIGN ADT: 18,700 (2050)** 

RICHARDS ST EB I-80 EXIT RAMP **EXISTING ADT: 3,500 (2017) DESIGN ADT: 7,800 (2040)** 

RICHARDS ST EB I-80 ENTRANCE RAMP **EXISTING ADT: 2,145 (2017) DESIGN ADT: 3.200 (2040)** 

RICHARDS ST WB I-80 EXIT RAMP **EXISTING ADT: 2,238 (2017) DESIGN ADT: 3,300 (2040)** 

RICHARDS ST WB I-80 ENTRANCE RAMP **EXISTING ADT: 4,326 (2017) DESIGN ADT: 7,300 (2040)** 

I-80 POSTED SPEED LIMIT: 55 MPH

RICHARDS ST DESIGN SPEED LIMIT NORTH OF I-80: 30 MPH RICHARDS ST DESIGN SPEED LIMIT SOUTH OF I-80: 35 MPH

5TH AVE

I-80 OVER US 6, RR.

& DES PLAINES RIVER

STA. 5 + 51

STA. 112 + 50

**EB STRUCTURE NO. 099-0056** 

**WB STRUCTURE NO. 099-0057** 

RICHARDS RAMP D

RICHARDS RAMP A

**RECONSTRUCTION ENDS** 


**RECONSTRUCTION ENDS** 

STA. 102 + 06

**RESURFACING ENDS** 

RICHARDS ST POSTED SPEED LIMIT: 30 MPH

PROJECT IS LOCATED IN THE CITY OF JOLIET AND JOLIET TOWNSHIP

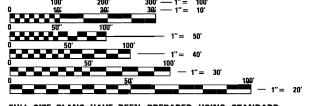

FULL SIZE PLANS HAVE BEEN PREPARED USING STANDARD ENGINEERING SCALES. REDUCED SIZED PLANS WILL NOT CONFORM TO STANDARD SCALES. IN MAKING MEASUREMENTS ON REDUCED PLANS, THE ABOVE SCALES MAY BE USED.

JOINT UTILITY LOCATION INFORMATION FOR EXCAVATION 1-800-892-0123 OR 811

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MEADE ELECTRIC CO. DISTRICT ONE ELECTRICAL MAINTENANCE CONTRACTOR FOR LOCATING IDOT ELECTRICAL EQUIPMENT AND UNDERGROUND CABLES 773-287-7672

PROJECT ENGINEER: SUNG BYUN (847) 705-4288 PROJECT MANAGER: KIM HARVEY (847) 705-4055 CONTRACT NO. 62380

# STATE OF ILLINOIS DEPARTMENT OF TRANSPORTATION

# **PROPOSED** HIGHWAY PLANS


FAU 354 (RICHARDS STREET) AT HICKORY CREEK N OF I-80 & FAI 80 (I-80) AT DES PLAINES RIVER / US 6 SECTION 99-4B-2-BR BRIDGE SUPERSTRUCTURE REHABILITATION, BRIDGE WIDENING, PIER REPAIR AND BRIDGE REPAIR **HBFP-NHPP-09EG(812) WILL COUNTY** 

C-91-030-02

GROSS & NET LENGTH = 1,835 FT. = 0.348 MILE

GROSS & NET LENGTH = 782 FT. = 0.148 MILE

I-80 DES PLAINES RIVER BRIDGE REPAIRS

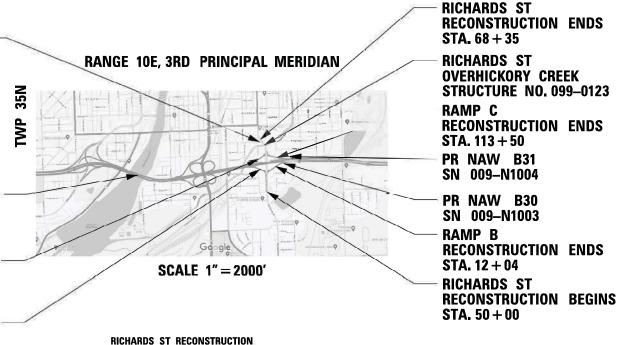

ILLINOIS CONTRACT NO. 62380 \* 320 + 1 = 321 TOTAL SHEETS

D-91-205-19















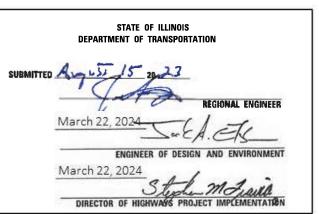



PRINTED BY THE AUTHORITY OF THE STATE OF ILLINOIS


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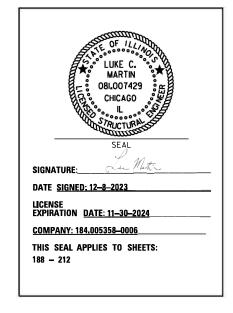
C-91-030-22




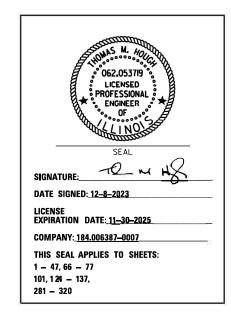

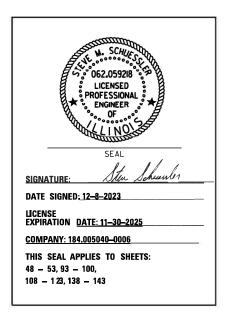

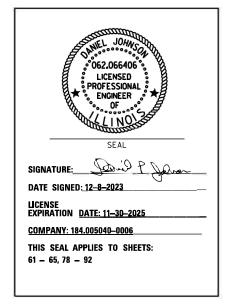

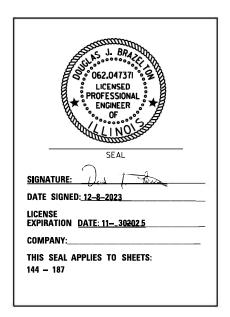

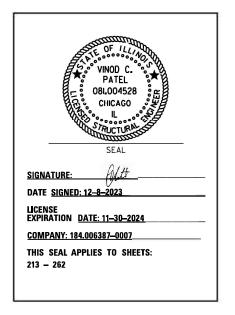

SHEET

SCALE: N.T.S.



USER NAME = AVILAC	DESIGNED CMA	REVISED -
	DRAWN - CMA	REVISED -
PLOT SCALE = 0.16666667 ' / IN.	CHECKED BRH	REVISED -
PLOT DATE = 1/26/2024	DATE	REVISED -

STATE OF ILLINOIS **DEPARTMENT OF TRANSPORTATION** 

RICHARDS STREET					F.A.U. SECTION			COUNTY TOTAL SH		
PROFESSIONAL SEALS				354	54 99-4B-2-BR			WILL	320	2
I HOI La	PRUFESSIUNAL SEALS							CONTRACT	NO. 62	380
OF	SHEETS	STA.	TO STA.		ILLINOIS FED. AID PROJECT					

### INDEX OF SHEETS

### HIGHWAY STANDARDS

	NDEX OF SHEETS		HIGHWAY STANDARDS		
SHEET NO.	DESCRIPTION	000001-08	STANDARD SYMBOLS, ABBREVIATIONS AND PATTERNS	873001-02	TRAFFIC SIGNAL GROUNDING & BONDING
	1 COVER SHEET	001001-02	AREAS OF REINFORCEMENT BARS	877011-10	STEEL COMB, MAST ARM ASSEMBLY AND POLE 16' THROUGH 55'
	2 PROFESSIONAL SEALS	001006	DECIMAL OF AN INCH AND OF A FOOT	878001-11	CONCRETE FOUNDATION DETAILS
	3 INDEX OF SHEETS AND STANDARDS	280001-07	TEMPORARY EROSION CONTROL SYSTEMS	880006-01	TRAFFIC SIGNAL MOUNTING DETAILS
	4 GENERAL NOTES	420001-10	PAVEMENT JOINTS	886001-01	DETECTOR LOOP INSTALLATIONS
5 -	25 SUMMARY OF QUANTITIES	420101-07	24' (7.2M) JOINTED PCC PAVEMENT	886006-01	TYPICAL LAYOUTS FOR DETECTION LOOPS
26 -	27 SCHEDULE OF QUANTITIES	420106-07	36' (10,8 M) JOINTED PCC PAVEMENT	877001-08	STEEL MAST ARM ASSEMBLY AND POLE 16' THROUGH 55'
	28 EARTHWORK SUMMARY	420401-13	PAVEMENT CONNECTOR (PCC) FOR BRIDGE APPROACH SLAB		
	32 TYPICAL SECTIONS	515001-04	NAME PLATE FOR BRIDGES		
33 -	35 ALIGNMENT, TIES AND BENCHMARKS	542001-06	CONCRETE END SECTIONS FOR PIPE CULVERTS 15" (375 MM) THRU 84" (2100 MM) DIAMETER		
	38 REMOVAL PLANS	542301-03	PRECAST REINFORCED CONCRETE FLARED END SECTION		
	42 ROADWAY PLAN AND PROFILE	542311-07	TRAVERSABLE PIPE GRATE FOR CONCRETE END SECTION		
43 -	46 ROADWAY DETAILS	601001-05	PIPE UNDERDRAINS		IDOT DISTRICT ONE DETAILS
	47 PAVEMENT JOINTING AND ELEVATIONS	601101-02	CONCRETE HEADWALL FOR PIPE UNDERDRAINS	BD-32	BUTT JOINT AND HMA TAPER DETAILS
	53 ADA RAMP DETAILS	602001-02	CATCH BASIN, TYPE A	BD-51	BENCHING DETAIL FOR EMBANKMENT
54 -	60 BRIDGE REPAIR PLANS AND STAGING DETAILS	602401-07	PRECAST MANHOLE, TYPE A 4' (1.22 m) DIAMETER	BD-52	DETAIL OF PAVEMENT SEPERATION, JOINT FOR JOINTED PAVEMENTS AT INTERSECTIONS
	61 SUGGESTED STAGING AND TRAFFIC CONTROL GENERAL NOTES	602402-03	PRECAST MANHOLE, TYPE A 5' (1.52 m) DIAMETER	TC-08	ENTRANCE AND EXIT RAMP CLOSURE DETAILS
	66 SUGGESTED STAGING AND TRAFFIC CONTROL - TYPICAL SECTIONS	602406-11	PRECAST MANHOLE, TYPE A 6' (1.83 m) DIAMETER	TC-09	TRAFFIC CONTROL DETAILS FOR FREEWAY SINGLE & MULTI-LANE WEAVE
	87 SUGGESTED STAGING AND TRAFFIC CONTROL - STAGING PLANS	602411-09	PRECAST MANHOLE, TYPE A 7' (2.13 m) DIAMETER	TC-10	TRAFFIC CONTROL AND PROTECTION FOR SIDE ROADS, INTERSECTIONS, AND DRIVEWAYS
88 -	92 DETOUR PLANS	602601-06	PRECAST REINFORCED CONCRETE FLAT SLAB TOP	TC-11	TYPICAL APPLICATIONS RAISED REFLECTIVE PAVEMENT MARKERS (SNOW-PLOW RESISTANT)
	93 EROSION AND SEDIMENT CONTROL SCHEDULE	602701-02	MANHOLE STEPS	TC-12	MULTI-LANE FREEWAY PAVEMENT MARKING DETAILS
	94 EROSION AND SEDIMENT CONTROL GENERAL NOTES	604001-05	FRAME AND LIDS, TYPE 1	TC-13	DISTRICT ONE TYPICAL PAVEMENT MARKINGS
	100 EROSION AND SEDIMENT CONTROL PLANS	604006-05	FRAME AND GRATE TYPE 3	TC-14	TRAFFIC CONTROL AND PROTECTION AT TURN BAYS (TO REMAIN OPEN TO TRAFFIC)
	101 HICKORY CREEK IN-STREAM WORKPLAN	604036-03	GRATE, TYPE 8	TC-16	SHORT-TERM PAVEMENT MARKING LETTERS AND SYMBOLS
	107 SUE UTILITIES	604081-06	FRAMES AND GRATES TYPE 22	TC-17	TRAFFIC CONTROL DETAILS FOR FREEWAY SHOULDER CLOSURES AND PARTIAL RAMP CLOSURES
	DRAINAGE AND UTILITY PLAN AND PROFILE	604091-05	FRAME AND GRATE TYPE 24	TC-18	FREEWAY/EXPRESSWAY SIGNING FOR FLAGGING OPERATIONS AT WORK ZONE OPENINGS
	120 DRAINAGE STRUCTURE AND PIPE SCHEDULE	606001-08	CONCRETE CURB TYPE B AND COMBINATION CONCRETE CURB AND GUTTER	TC-21	DETOUR SIGNING FOR CLOSING STATE HIGHWAYS
	123 DRAINAGE DETAILS	606301-04	PC CONCRETE ISLANDS AND MEDIANS	TC-22	ARTERIAL ROAD INFORMATION SIGN
	126 PAVEMENT MARKING PLANS	630001-13	STEEL PLATE BEAM GUARDRAIL	TC-26	DRIVEWAY ENTRANCE SIGNING
	128 SIGNING PLANS	630116	BACK SIDE PROTECTION OF GUARDRAIL	TC-28	RAILROAD CROSSING REPAIR DETOUR SIGNING
	133 EXISTING AND PROPOSED SIGN SCHEDULES	630301-09	SHOULDER WIDENING FOR TYPE 1 (SPECIAL) GUARDRAIL TERMINALS		
	<ul><li>135 SIGN DETAILS</li><li>137 SIGN ELEVATION DETAILS</li></ul>	631031-18	TRAFFIC BARRIER TERMINAL, TYPE 6		
		631033-09	TRAFFIC BARRIER TERMINAL, TYPE 6B		
	143 LANDSCAPE PLANS 151 STANDARD TRAFFIC SIGNAL DETAILS	701001-02	OFF-RD OPERATIONS, 2L, 2W, MORE THAN 15' (4.5 m) AWAY		
	177 TRAFFIC SIGNAL PLANS	701006-05	OFF-RD OPERATIONS, 2L, 2W, 15' (4.5 m) TO 24" (600 mm) FROM PAVEMENT EDGE		
	187 LIGHTING PLANS	701101-05	OFF-RD OPERATIONS, MULTILANE, 15' (4.5m) TO 24" (600mm) FROM PAVEMENT EDGE		
	212 NOISE WALL PLANS	701106-02	OFF-RD OPERATIONS, MULTILANE, MORE THAN 15' (4.5m) AWAY		
	262 STRUCTURAL PLANS SN. 099-0123	701301-04	LANE CLOSURE, 2L, 2W, SHORT TIME OPERATIONS		
	280 DISTRICT ONE DETAILS	701311-03	LANE CLOSURE 2L, 2W MOVING OPERATIONS-DAY ONLY		
	283 EARTHWORK SCHEDULE	701400-12	APPROACH TO LANE CLOSURE, FREEWAY/EXPRESSWAY		
	298 RICHARDS STREET CROSS SECTIONS	701401-13	LANE CLOSURE, FREEWAY/EXPRESSWAY		
	311 RAMP CROSS SECTIONS	701406-13	LANE CLOSURE, FREEWAY/EXPRESSWAY, DAY OPERATIONS ONLY		
312 -		701411-09	LANE CLOSURE, MULTILANE AT ENTRANCE OR EXIT RAMP, FOR SPEEDS ≥ 45 MPH		
J12 -	520 1.00 GROSS SECTIONS	701427-05	LANE CLOSURE, MULTILANE, INTERMITTENT OR MOVING OPER., FOR SPEEDS LESS THAN OR EQUAL TO 40 MPH		

C:\TRANSYSTEM	
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NAME:	exp.

USER NAME = SUIC	DESIGNED	-	CMA	REVISED	-
	DRAWN	-	FYW	REVISED	-
PLOT SCALE = 0.16666667 / IN.	CHECKED	-	BRH	REVISED	-
PLOT DATE = 1/25/2024	DATE	-		REVISED	-

STATE OF ILLINOIS **DEPARTMENT OF TRANSPORTATION** 

SCALE: NTS

TRAFFIC CONTROL SETUP AND REMOVAL FREEWAY/EXPRESSWAY

URBAN LANE CLOSURE, MULTILANE, 1W OR 2W WITH NONTRAVERSABLE MEDIAN

URBAN SINGLE LANE CLOSURE, MULTILANE, 2W WITH MOUNTABLE MEDIAN

TWO LANE CLOSURE, FREEWAY/EXPRESSWAY

URBAN LANE CLOSURE, MULTILANE INTERSECTION

METAL POSTS FOR SIGNS, MARKERS AND DELINEATORS

APPLICATIONS OF TYPES A&B METAL POSTS (FOR SIGNS & MARKERS)

STANDARD PHASE DESIGNATION DIAGRAMS AND PHASE SEQUENCES

GUARDRAIL AND BARRIER WALL REFLECTOR MOUNTING DETAILS

SIDEWALK, CORNER OR CROSSWALK CLOSURE

TRAFFIC CONTROL DEVICES

TEMPORARY CONCRETE BARRIER

SIGN PANEL MOUNTING DETAILS

OBJECT AND TERMINAL MARKERS

TELESCOPING STEEL SIGN SUPPORT

ELECTRICAL SERVICE INSTALLATION DETAIL

RACEWAYS EMBEDDED IN STRUCTURE

UNINTERRUPTABLE POWER SUPPLY (UPS)

TYPICAL PAVEMENT MARKINGS

HANDHOLES

DOUBLE HANDHOLES

SIGN PANEL ERECTION DETAILS

URBAN LANE CLOSURE, 2L, 2W, UNDIVIDED

			F.A.U. RTE	SECTION	COUNTY	TOTAL SHEETS	SHEE NO.		
INDEX OF SHEETS AND STANDARDS			354	99-4B-2-BR	WILL	320	3		
					CONTRACT	NO. 62	380		
HEET	OF	SHEETS	STA	TO STA.		ILLINOIS FED A	ID PROJECT		

701428-01

701446-11

701501-06

701601-09

701606-10 701701-10

701801-06

701901-09

704001-08

720001-01

720006-04

720011-01

725001-01

728001-01

729001-01

780001-05

782006-01

805001-01 812001-01

814001-03

814006-03

857001-01

862001-01

### **GENERAL NOTES**

- THE CONTRACTOR WILL NOT BE ALLOWED TO SET UP A YARD OR FIELD OFFICE ON STATE PROPERTY WITHOUT WRITTEN PERMISSION FROM THE DEPARTMENT.
- 2. ALL MILLED SURFACES SHALL BE A UNIFORM CROSS SLOPE PER LANE AND FREE OF RIDGES BETWEEN PASSES. ANY DEVIATIONS SHALL BE CORRECTED AT NO COST TO THE DEPARTMENT.
- 3. ALL PAVEMENT PATCHING LOCATIONS WILL BE DETERMINED IN THE FIELD BY THE ENGINEER. NORTHBOUND RICHARDS ST SHALL BE PATCHED PRIOR TO STAGE I.
- SIDEWALK REMOVAL AND P.C.C. SIDEWALK 5" LOCATIONS SHALL BE DETERMINED BY THE ENGINEER.
- 5. DRAINAGE ADJUSTMENT OR RECONSTRUCTION LOCATIONS WILL BE DETERMINED IN THE FIELD BY THE ENGINEER.
- 6. IT SHALL BE THE CONTRACTOR'S RESPONSIBILITY TO VERIFY ALL DIMENSIONS AND CONDITIONS EXISTING IN THE FIELD PRIOR TO CONSTRUCTION AND ORDERING OF MATERIALS.
- FRAMES AND LIDS/ GRATES ADJUSTMENT OF PRIVATE UTILITIES WITHIN THE LIMITS OF THE IMPROVEMENTS SHALL BE DONE BY THEIR RESPECTIVE OWNERS AND ARE NOT PART OF THIS CONTRACT.
- 8. STORM SEWER CONSTRUCTED UNDER THE ROADWAY SHALL BE BACKFILLED ACCORDING TO METHOD 1 OF ARTICLE 550.07 OF THE STANDARD SPECIFICATIONS.
- THE CONTRACTOR SHALL BE REQUIRED TO KEEP A RECORD OF THE LOCATIONS OF THE BURIED AND PLATED STRUCTURES ACCORDING TO THE STATION AND DISTANCE LEFT OR RIGHT OF THE CENTERLINE OF PAVEMENT. UPON COMPLETION OF THE WORK, THE CONTRACTOR SHALL DELIVER THE RECORD TO THE ENGINEER.
- 10. EXISTING BROKEN FRAMES AND LIDS/ GRATES SHALL BE REMOVED AND DISPOSED OF BY THE CONTRACTOR AND SHALL BE REPLACED AS DIRECTED BY THE ENGINEER. REPLACEMENT FRAMES AND LIDS/ GRATES WILL BE PAID FOR ACCORDING TO ARTICLE 109.04 OF THE STANDARD SPECIFICATIONS UNLESS A SEPARATE PAY ITEM HAS BEEN PROVIDED.
- 11. FOR WORK OUTSIDE THE LIMITS OF BRIDGE APPROACH PAVEMENT, ALL REFERENCES IN THE HIGHWAY STANDARDS AND STANDARD SPECIFICATIONS FOR REINFORCEMENT, DOWEL BARS AND TIE BARS IN PAVEMENT, SHOULDERS, CURB, GUTTER, COMBINATION CURB AND GUTTER AND MEDIAN, AND CHAIR SUPPORTS FOR CRC PAVEMENT, SHALL BE EPOXY COATED. UNLESS NOTED ON THE PLAN.
- 12. THE ENGINEER SHALL CONTACT PACE AT <u>TRANSPORTATION.ENGINEER@PACEBUS.COM</u> A MINIMUM OF TWO WEEKS IN ADVANCE OF THE START OF CONSTRUCTION.
- 13. THE CONTRACTOR SHALL CONTACT THE DISTRICT ONE TRAFFIC CONTROL SUPERVISOR, AT (847) 705-4470 (ARTERIAL) (847) 705-4151 (EXPRESSWAYS) A MINIMUM OF 72 HOURS IN ADVANCE OF BEGINNING WORK.
- 14. TWO (2) WEEKS PRIOR TO PLACING PERMANENT PAVEMENT MARKINGS, THE ENGINEER SHALL CONTACT THE ARTERIAL TRAFFIC FIELD ENGINEER ERIC CAMPOS AT ERIC.CAMPOS@ILLINOIS.GOV FOR ARTERIAL ROADWAYS, AND THE EXPRESSWAY TRAFFIC FIELD ENGINEER REGINA COOPER AT REGINA.COOPER2@ILLINOS.GOV FOR EXPRESSWAYS OR CALL THE BUREAU OF TRAFFIC AT (847) 705-4151.
- 15. THE CONTRACTOR WILL NOT BE ALLOWED TO PROCEED WITH ANY PLANTING WORK UNTIL ALL UTILITY OWNERS FIELD LOCATE THEIR FACILITIES WHICH MAY INTERFERE WITH CONSTRUCTION OPERATIONS.
- 16. THE ACTUAL LOCATION OF PROPOSED LANDSCAPING WILL BE ADJUSTED IN THE FIELD TO AVOID UTILITIES.
- 17. THE CONTRACTOR SHALL BE RESPONSIBLE FOR THE NOTIFICATION OF ALL EMERGENCY SERVICES, SCHOOL DISTRICTS, IDOT'S COMMUNICATIONS CENTER, SPRINGFIELD TRUCK PERMIT SECTION AND OTHER AGENCIES AFFECTED BY THE ROAD CLOSURE. THE CONTRACTOR SHALL ALSO BE RESPONSIBLE FOR POSTING SIGNS THAT WILL INDICATE THE DATES CLOSURES WILL BE IN PLACE.
- 18. CONTRACTOR SHALL NOT SCALE DIMENSIONS FROM THE CONTRACT PLANS FOR
- 19. ALL ELEVATIONS IN THE PLANS ARE BASED UPON THE NORTH AMERICAN VERTICAL DATUM OF 1988 (NAVD88), UNLESS OTHERWISE NOTED. HORIZONTAL DATUM IS REFERENCED TO ILLINOIS STATE PLAN COORDINATE SYSTEM, EAST ZONE, NAD83 (2011) INI ISS OTHERWISE NOTED.
- 20. SEVENTY-TWO (72) HOURS BEFORE STARTING EXCAVATION, THE CONTRACTOR SHALL CALL JULIE AT 1-800-892-0123 OR \$11 TO HAVE THE LOCATION OF EXISTING UNDERGROUND UTILITIES MARKED IN THE FIELD.
- 21. IDOT FACILITIES ARE NOT LOCATED BY JULIE OR DIGGER. IDOT ELECTRICAL FACILITIES INCLUDING ROADWAY LIGHTING, FIBER OPTIC, ITS EQUIPMENT, TRAFFIC SIGNAL FACILITIES ARE LOCATED BY THE DEPARTMENT'S ELECTRICAL MAINTENANCE CONTRACTOR. AS OF THE LETTING DATE, CONTACT MEADE ELECTRIC COMPANY AT 773-287-7672.
- 22. ALL ROADWAY WIDTHS AND RADII SHOWN ON THE PLANS ARE TO THE EDGE OF PAVEMENT UNLESS OTHERWISE NOTED.
- 23. THE CONTRACTOR SHALL BE RESPONSIBLE FOR THE PROTECTION OF ALL UNDERGROUND OR SURFACE UTILITIES EVEN THOUGH THEY MAY NOT BE SHOWN IN THE PLANS. ANY UTILITY THAT IS DAMAGED DURING CONSTRUCTION SHALL BE REPAIRED OR REPLACED TO THE SATISFACTION OF THE ENGINEER. THIS WORK WILL BE AT THE CONTRACTOR'S EXPENSE.
- 24. THE LOCATIONS OF PUBLIC OR PRIVATE UTILITIES SHOWN ON THE PLAN ARE APPROXIMATE AND THEIR ACCURACY IS NOT GUARANTEED. THE CONTRACTOR SHALL VERIFY THE EXACT LOCATION AND ELEVATION OF ALL UTILITIES. THE CONTRACTOR SHALL REPORT ANY ENCOUNTERED DISCREPANCIES TO THE ENGINEER AT ONCE. THE

- 25. DRAINAGE GRADES SHALL BE VERIFIED IN FIELD PRIOR TO INSTALLATION OF DRAINAGE ITEMS
- 26. THE THICKNESS OF THE HOT-MIX ASPHALT MIXTURE SHOWN ON THE PLANS IS THE NOMINAL THICKNESS. DEVIATIONS FROM THE NOMINAL THICKNESS WILL BE PERMITTED WHEN SUCH DEVIATIONS OCCUR DUE TO IRREGULARITIES IN THE EXISTING SURFACE OR BASE ON WHICH THE HOT-MIX ASPHALT MIXTURE IS PLACED.
- 27. CONTACT THE ROADSIDE DEVELOPMENT UNIT AT 847-705-4171 AT LEAST TWO (2) WEEKS IN ADVANCE OF WEED CONTROL AND FORESTRY WORK TO IDENTIFY & MARK TREES TO SAYE WITHIN CLEARING AREA.
- 28. THE DEPARTMENT HAS NOT OBTAINED PERMITS FOR OFFSITE BORROW, WASTE USE (BWU) AREAS. PRIOR TO WORKING IN BWU AREAS, IF THE CONTRACTOR CHOOSES TO USE A CTIVITIES REQUIRING PERMITS, IT IS THE CONTRACTOR'S RESPONSIBILITY TO SECURE THE PROPER PERMITS. IN ADDITION TO THE BORROW REVIEW (BDE 2289) AND USE/WASTE REVIEW (BDE 2290) SUBMITTALS, THE CONTRACTOR SHALL SUBMIT AN EROSION AND SEDIMENT CONTROL (ESC) PLAN FOR EVERY BWU SITE TO THE DEPARTMENT FOR ACCEPTANCE. GUIDELINES FOR ACCEPTABLE BWU PRACTICES CAN BE FOUND IN SECTION 11.G.1 AND 2 OF THE SWPPP. THE COST OF MATERIALS AND LABOR NECESSARY TO COMPLY WITH THE ABOVE PROVISIONS TO PREPARE AND IMPLEMENT ESC PLANS SHALL BE INCLUDED IN THE CONTRACT UNIT PRICE FOR THE APPLICABLE PAY ITFMS.
- 29. WHEN ARTIFICIAL LIGHTING IS USED IN NIGHT OPERATIONS THE CONTRACTOR SHALL EXERCISE THE UTMOST PRECAUTIONS IN PREVENTING ADVERSE VISIBILITY TO THE MOTORING PUBLIC, AIR TRAFFIC AND ADJOINING COMMERCIAL AREAS.
- 30. THE PAVEMENT ELEVATIONS SHOWN ON THE PLANS ARE FINISHED GRADES OR SURFACE COLURSE, LINI ESS OTHERWISE INDICATED.
- 31. TEN (10) FOOT TRANSITIONS SHALL BE USED TO MATCH PROPOSED ITEMS OF WORK TO EXISTING ITEMS IN THE FIELD, UNLESS OTHERWISE SHOWN. THE TRANSITIONS SHALL BE PAID FOR AT THE CONTRACT UNIT PRICE FOR THE PROPOSED ITEM OF WORK SPECIFIED.
- 32. ANY AGGREGATE SUBGRADE IMPROVEMENT CONTAMINATED OR DAMAGED BY THE CONTRACTOR'S VEHICLES OR EQUIPMENT IS TO BE REMOVED AND REPLACED AS DIRECTED BY THE ENGINEER AT THE CONTRACTOR'S EXPENSE.
- 33. SUBGRADE STABILITY SHALL BE VERIFIED BY PROOF ROLLING WITH A FULLY LOADED TANDEM-AXLE TRUCK.
- 34. SUFFICIENT DRAINAGE FACILITIES SHALL BE MAINTAINED THROUGHOUT CONSTRUCTION TO FACILITATE SURFACE RUNOFF. WHEN ANY LOOSE MATERIAL IS DEPOSITED IN THE FLOW LINE OF DITCHES, GUTTER, OR DRAINAGE STRUCTURES SO THAT THE NATURAL FLOW OF WATER IS OBSTRUCTED, IT SHALL BE REMOVED AT THE CLOSE OF EACH WORKING DAY. IT SHALL BE THE CONTRACTOR'S RESPONSIBILITY TO PLAN HIS OPERATIONS, WITH THE APPROVAL OF THE ENGINEER IN THE FIELD, SO AS TO UTILIZE THE FACILITIES PROVIDED TO PREVENT LOCAL FLOODING AND ENSURE PROPER SURFACE RUNOFF. MINOR DITCH GRADING AND ANY BULKHEADING AS DIRECTED BY THE ENGINEER, NECESSARY TO PROVIDE FOR THE INTERIM DRAINAGE SHALL BE INCLUDED IN THE CONTRACT UNIT PRICE FOR EARTH EXCAVATION.
- 35. ALL STORM SEWERS, PIPE CULVERTS, CATCH BASINS, MANHOLES, INLETS AND SIMILAR STRUCTURES NEWLY CONSTRUCTED, ADJUSTED OR RECONSTRUCTED UNDER THE CONTRACT SHALL BE CLEANED OF ANY ACCUMULATION OF SILT, DEBRIS, OR FOREIGN MATTER OF ANY KIND AND SHALL BE FREE FROM SUCH ACCUMULATIONS AT THE TIME OF FINAL INSPECTION. THE COST OF ANY CLEANING REQUIRED TO COMPLY WITH THIS REQUIREMENT SHALL BE INCLUDED IN THE CONTRACT UNIT PRICE OF THE APPLICABLE
- 36. PIPE UNDERDRAINS SHALL BE INSTALLED ACCORDING TO SECTION 601 OF THE STANDARD SPECIFICATIONS AND STANDARD 601001-05. TOP OF PIPE UNDERDRAINS SHALL BE PLACED A MINIMUM OF 6" BELOW THE AGGREGATE SUBGRADE LAYER. THE COST OF MAKING PIPE UNDERDRAIN CONNECTIONS TO DRAINAGE STRUCTURES SHALL BE INCLUDED IN THE COSTS OF THE PIPE UNDERDRAINS.
- 37. THE CONTRACTOR SHALL VERIFY EXISTING OUTLET STRUCTURE LOCATION AND INVERTS PRIOR TO STARTING UPSTREAM STORM SEWER CONNECTION AND CONSTRUCTION.
- 38. PROPOSED RIM AND INVERT ELEVATIONS ARE BASED ON EXISTING THEORETICAL GRADES. ACTUAL FINAL GRADES ARE SUBJECT TO NOMINAL VARIATIONS. ADJUSTMENTS OF PROPOSED CASTINGS TO FINAL GRADES IS INCLUDED IN THE COST OF THE RELATED DRAINAGE STRUCTURE. ADJUSTMENT OF THE PROPOSED PIPE INVERTS TO FINAL GRADES IS INCLUDED IN THE COST OF THE RELATED DRAINAGE PIPE.
- 39. AGGREGATE SUBGRADE IMPROVEMENT SHALL BE USED TO REPLACE ANY UNSUITABLE SOILS BELOW THE BOTTOM OF THE IMPROVED SUBGRADE LAYER THAT ARE ENCOUNTERED IN THE FIELD DURING CONSTRUCTION. THE NEED FOR REMOVAL AND REPLACEMENT SHALL BE DETERMINED BY THE GEOTECHNICAL ENGINEER OR SOILS INSPECTOR. ALL POTENTIALLY UNSTABLE SOILS SHALL BE TESTED WITH A CONE PENETROMETER AND TREATED IN ACCORDANCE WITH ARTICLE 301.04 OF THE SSRBC AND THE UNDERCUT GUIDELINES IN THE IDOT SUBGRADE STABILITY MANUAL. ANY MATERIAL NOT NEEDED FOR UNDERCUT REPLACEMENT AT THE TIME OF CONSTRUCTION SHALL BE DELETED FROM THE CONTRACT WITH NO EXTRA COMPENSATION TO THE CONTRACTOR.
- 40. GEOTECHNICAL FABRIC FOR GROUND STABILIZATION AND/OR AGGREGATE SUBGRADE IMPROVEMENT (CU YD) HAVE BEEN PROVIDED FOR USE AT LOCATIONS INDICATED FOR SOILS THAT TEND TO BE UNSTABLE AND/ OR UNSUITABLE. THE ACTUAL NEED FOR REMOVAL AND REPLACEMENT WITH ABOVE ITEM WILL BE DETERMINED IN THE FIELD AT THE TIME OF CONSTRUCTION BY THE GEOTECHNICAL ENGINEER. ALL POTENTIALLY UNSTABLE SOILS SHOULD BE TESTED WITH A STATIC OR DYNAMIC CONE PENETROMETER AND TREATED IN ACCORDANCE WITH ARTICLE 301.04 OF THE SSRBC AND IDOT SUBGRADE STABILITY MANUAL. IF UNSTABLE AND/OR UNSUITABLE SOILS ARE NOT ENCOUNTERED, THEN THE QUANTITY SHALL BE DEDUCTED AND NO ADDITIONAL COMPENSATION WILL BE DUE TO THE CONTRACTOR.
- 41. THE AGGREGATE GRADATION FOR THE AGGREGATE SUBGRADE IMPROVEMENT 12" LOWER LIFT SHALL BE CS1 OR RR1.

- 42. ROCK EXCAVATION IS EXPECTED TO BE REQUIRED FOR CONSTRUCTION OF A PORTION OF PROPOSED DRAINAGE SYSTEM (STORM SEWER AND STRUCTURES). AN APPROXIMATE QUANTITY OF ROCK EXCAVATION BASED OFF PLAN BORINGS IS INCLUDED IN THE PLANS BUT SHOULD BE CONFIRMED BY THE ENGINEER IN THE FIELD. ROCK EXCAVATION RELATED TO CONSTRUCTION OF THE PROPOSED DRAINAGE SYSTEM WILL BE PAID FOR PER ARTICLE 502.12 OF THE IDOT SSRBC.
- 43. PAY ITEMS 42000401 PCC PVT 9" (JOINTED) & 48300400 PCC SHOULDERS 9" SHALL BE CONSTRUCTED FOLLOWING THE EXTENDED LIFE CONCRETE PAVEMENT SPECIAL PROVISION.
- 44. TOPSOIL SHALL NOT BE STOCKPILED WITHIN THE LIMITS OF CONSTRUCTION; THE LOCATIONS OF TOPSOIL STOCKPILES WITHIN THE RIGHT-OF-WAY MUST BE APPROVED BY THE FINGINEER.
- 45. THE CONTRACTOR SHALL PROCURE ALL VINE PLANTINGS WITHIN FOUR (4) WEEKS OF AWARD OF THE CONTRACT TO ENSURE THAT THERE WILL BE ADEQUATE QUANITITIES AVAILABLE FOR PLANTING SEASON.
- 46. BUTT JOINTS SHALL BE INSTALLED AT THE ENDS OF ALL RESURFACING (WHERE RESURFACING MEETS EXISTING PAVEMENT) ACCORDING TO THE "BUTT JOINT AND HOT-MIX ASPHALT TAPER DETAILS" SHEET INCLUDED IN THE PLANS, UNLESS OTHERWISE SPECIFIED.
- 47. THE "ARTERIAL ROAD INFORMATION SIGN (TC-22)" IS APPLICABLE ONLY TO ARTERIAL ROADS AND SHALL NOT BE APPLIED TO EXPRESSWAYS.
- 48. THIS PROJECT REQUIRES A US ARMY CORPS OF ENGINEERS (USACE) 404 PERMIT THAT WILL BE SECURED BY THE DEPARTMENT. AS A CONDITION OF THIS PERMIT, THE CONTRACTOR WILL NEED TO SUBMIT AN IN-STREAM WORK PLAN TO THE DEPARTMENT FOR APPROVAL, GUIDELINES ON ACCEPTABLE IN-STREAM WORK TECHNIQUES CAN BE FOUND ON THE USACE WEBSITE. THE USACE DEFINES AND DETERMINES IN-STREAM WORK, THE COST OF ALL MATERIALS AND LABOR NECESSARY TO COMPLY WITH THE ABOVE PROVISIONS TO PREPARE AND IMPLEMENT AN INSTREAM WORK PLAN WILL NOT BE PAID FOR SEPERATELY, BUT SHALL BE CONSIDERED AS INCLUDED IN THE UNIT BID PRICES OF THE CONTRACT AND NO ADDITIONAL COMPENSATION WILL BE ALLOWED.
- 49. INTERSEEDING, CLASS 2A IS TO BE USED TO RENOVATE AREAS WHERE EXISTING TURF IS IN POOR CONDITION. EXACT LOCATIONS WILL BE DETERMINED DURING CONSTRUCTION BY THE ENGINEER.
- 50. A QUANTITY OF 4,405 CUYD OF FURNISHED EXCAVATION HAS BEEN INCLUDED IN THE CONTRACT TO BALANCE THE LOSS OF THE NON-SPECIAL WASTE DISPOSAL QUANTITY. IF TESTING DETERMINES THAT SOME OF THE NON-SPECIAL WASTE MATERIAL CAN BE USED ON SITE AS EMBANKMENT, THE EXCESSS FURNISHED EXCAVATION SHALL BE DEDUCTED AND NO ADDITIONAL COMPENSATION WILL BE DUE TO THE CONTRACTOR. THE CONTRACTOR SHALL OBTAIN THE APPROVAL OF THE ENGINEER PRIOR TO PLACING FURNISHED EXCAVATION.

- 51. THE CONTRACTOR SHALL CONTACT KALPANA KANNNAN-HOSADURGA, THE DISTRICT ONE TRAFFIC CONTROL SUPERVISOR at KALPANA.KANNAN-HOSADURGA@ILLINOIS.GOV A MINIMUM OF 72 HOURS IN ADVANCE OF BEGINNING WORK.
- 52. THE CONTRACTOR SHALL OBTAIN COAST GUARD APPROVAL FOR ANY WORK THAT MAY INTERFERE WITH NAVIGATIONAL OPERATIONS OF THE NAVIGABLE WATERS. A WORK PLAN SHALL BE PREPARED BY THE CONTRACTOR, REVIEWED AND APPROVED BY THE ENGINEER AND BE SUBMITTED BY THE ENGINEER TO THE COAST GUARD AT THE ADDRESS LISTED BELOW FOR APPROVAL.

BRIDGE ADMINISTRATOR
US COAST GUARD

NINTH COAST GUARD DISTRICT

1240 F. NINTH ST.

CLEVELAND, OH 44199-2060

### COMMITMENTS:

- 1. TO AVOID AND MINIMIZE IMPACTS TO THE NORTHERN LONG-EARED BAT (NLEB), NO TREE CLEARING SHALL OCCUR FROM APRIL 1 TO OCTOBER 31. IF THE WORK IS SCHEDULED TO OCCUR BETWEEN APRIL 1 AND OCTOBER 31. OF ANY YEAR, THE BRIDGE/CULVERT SHALL BE INSPECTED FOR THE PRESENCE OF NORTHERN LONG-EARED BAT NO MORE THAN 7 DAYS PRIOR TO THE START OF CONSTRUCTION ACTIVITY TO ENSURE BATS HAVE NOT STARTED TO USE THE AREA OF THE BRIDGE PROPOSED FOR WORK. IF THAT SPECIES IS FOUND TO BE USING THE STRUCTURE, THE PERMITTEE SHALL IMMEDIATELY CONTACT THE DEPARTMENT AND CCM TO ASK FOR FURTHER GUIDANCE. WORK SHALL NOT COMMENCE UNTIL CONSULTATION WITH THESE TWO GROUPS HAS BEEN SATISFIED.
- A PROJECT SPECIFIC DUST CONTROL PLAN WILL BE DEVELOPED PRIOR TO CONSTRUCTION AND AS PART OF THE REQUIRED PRE-CONSTRUCTION CONTRACTOR DOCIMENTS.

RICHARDS STREET HOT-MIX ASPHALT MIX	TURE REQUIREMENTS	
MIXTURE TYPE	AIR VOIDS @ NDES	QUALITY MANAGEMENT
RICHARD STREET RAMPS AT 1-80		
STABILIZED SUBBASE - HMA (HMA BINDER IL-19 mm) (4")	3.0% @ 50 GYR.	QC/QA
PAVEMENT RECONSTRUCTION (HOT-MIX ASPHALT PAVEMENT (FULL-DEP	TH), 10 3/4") (SEE NOTE 4)	
POLYMERIZED HMA SURFACE COURSE, IL-9.5, MIX "E", N70 (2")	4.0% @ 70 GYR.	QC/QA
POLYMERIZED HMA BINDER COURSE, IL-19.0, N90 (2 1/4")	4.0% @ 90 GYR.	QC/QA
HMA BINDER COURSE, IL-19.0, N90 (6 1/2")	4.0% @ 90 GYR.	QCP
5TH STREET RESURFACING (SEE NOTE 5)		
POLYMERIZED HMA SURFACE COURSE, IL-9.5, MIX "E", N70 (2")	4.0% @ 70 GYR.	QC/QA
LINDEN AVE REPLACEMENT		
HOT-MIX ASPHALT SURFACE COURSE, MIX "D", IL-9.5, N50 (1.5")	4.0% @ 50 GYR.	QC/QA
HOT-MIX ASPHALT BINDER COURSE, IL-19.0, N50 (2.5")	4.0% @ 50 GYR.	QC/QA
MULTI-USE PATH		
HOT-MIX ASPHALT SURFACE COURSE, MIX "D", IL-9.5, N50 (1.5")	4.0% @ 50 GYR.	QC/QA
HOT-MIX ASPHALT BINDER COURSE, IL-9.5, N50 (2")	4.0% @ 50 GYR.	QC/QA
PATCHING		
CLASS D PATCHES (HMA BINDER IL-19 mm)	4.0% @ 70 GYR.	QC/QA
TEMPORARY PAVEMENT		
HMA SURFACE COURSE, MIX "D", IL-9.5, N70 (2")	4.0% @ 70 GYR.	QC/QA
TEMP PAVEMENT (HMA BINDER IL-19 mm) (8")	4.0% @ 70 GYR.	QC/QA
QMP DESIGNATIONS: QUALITY CONTROL/ QUALITY ASSURANCE (QC/QA);	QUALITY CONTROL FOR PERFOR	RMANCE (QCP).

### MIXTURE TABLE NOTES

SHEET

SCALE:

- $1. \ \ THE \ UNIT \ WEIGHT \ USED \ TO \ CALCULATE \ ALL \ HOT-MIX \ ASPHALT \ SURFACE \ MIXTURE \ QUANTITIES \ IS \ 112 \ LBS/SQ \ YD/IN.$
- THE "AC TYPE" FOR POLYMERIZED HMA MIXES SHALL BE "SBS/SBR PG 76-22" AND FOR NON-POLYMERIZED HMA
  THE "AC TYPE" SHALL BE "PG 64-22" UNLESS MODIFIED BY RECLAIMED MATERIALS SPECIFICATIONS.
- 3. PC CONCRETE TEMPORARY PAVEMENT SHALL CONSIST OF CLASS PV CONCRETE MEETING THE REQUIREMENTS OF ART. 1020 OF THE STANDARD SPECIFICATIONS; THICKNESS SHALL BE 8". TEMPORARY PCC PAVEMENT DOES NOT REQUIRE DOWEL BARS. ALL TEMPORARY PAVEMENT SHALL BE PROVIDED OVER 4"SUBBASE GRANULAR MATERIAL, TYPE C.
- 4. THE LONGITUDINAL JOINT SEALANT SHALL BE PLACED UNDER AND OVER THE P HMA BC IL-19.0 N90
- 5. LONGITUDINAL JOINT SEALANT SHALL BE PLACED ABOVE THE MILLED SURFACE.



USER NAME = SUIC	DESIGNED - CM/	A	REVISED	-
	DRAWN - FYV	/	REVISED	-
PLOT SCALE = 0.16666667 / IN.	CHECKED - BRH	1	REVISED	-
PLOT DATE = 1/25/2024	DATE -		REVISED	-

STATE OF ILLINOIS
DEPARTMENT OF TRANSPORTATION

RICHA	ARDS STE	REET		F.A.U. RTE	SEC <sup>-</sup>	TION		COUNTY	TOTAL SHEETS	SHEE NO.
GENERAL NOTES		354 99-4B-2-BR			WILL	320	4			
GLIVI	LIIAL NO	ILO						CONTRACT	NO. 62	380
OF	SHEETS	STA	TO STA			II I INIOIC	CED A	D DDOLECT		

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	INSYSTEMS\PW_LOCAL\TRANSYSTEMS-PW-01\DMS09883\62380-SHT-SOQ-01.DGN	
	S-PW-01\DMS09883\6	
	L\TRANSYSTEMS.	
	VPW_LOCAL\	
=	NSYSTEMS	

20201200	REMOVA	L AND DISPOSAL OF UNSUITABLE MA	TERIAL		CUYD	1,113	1,113									]
20400800	FURNISH	IED EXCAVATION			CUYD	4,405	4,405									1
																1
20700220	POROUS	GRANULAR EMBANKMENT			CUYD	77	777									
20800150	TRENCH	BACKFILL			CUYD	1,639	1,639									
																-
21001000	GEOTEC	HNICAL FABRIC FOR GROUND STABII	LIZATION		SQ YD	2,540	2,540									1
																-
21101505	TOPSOIL	EXCAVATION AND PLACEMENT			CUYD	2,437	2,437									-
25000210	SEEDING	G, CLASS 2A			ACRE	3.25	3.25									
																1
25000310	SEEDING	G, CLASS 4			ACRE	3.50	3.00									1
																1
25000400	NITROGE	EN FERTILIZER NUTRIENT			POUND	593	593									1
																1
*	SPECIAL	TY ITEM						<u> </u>	<u> </u>		<u> </u>					ا
•	J. LCIAL															
••		USER NAME = AVILAC	DESIGNED - CMA	REVISED -									F.A.U. RTE.	SECTION	COUNTY S	TOTAL SHEET SHEETS NO.
*exp	<b>,</b> †		DRAWN - FYW	REVISED -			STATE OF ILLING	IS			RICHARDS STREET SUMMARY OF QUANTITIES		RTE. 354		S S	SHEETS NO.
$\triangle V D$	<b>'•</b>	PLOT SCALE = 0.16666667 ' / IN.	CHECKED - BRH	REVISED -			DEPARTMENT OF TRANS				S	354	99-4B-2-BR	CONTRACT N	320 5 NO 62380	
	'n	PLOT DATE = 1/29/2024	i	- REVISED -			DEFAILURE OF THAIRD ON TATION			SCALE: SHEET OF SHEETS STA.			<b>-</b>		LONTRACTIV	10. 02300

BRIDGE REPAIR | NOISE ABATMENT | NOISE ABATMENT |

WALL

SN 099-N1004

0020

90% FED

10% STATE

WALL

SN 099-N1003

90% FED

10% STATE

HIGHWAY

LIGHTING

0021

80% FED

20% STATE

RICHARDS ST

EB RAMPS

0021

80% FED

20% STATE

146

CODE

\* 20101100

\* 20101200

\* 20101300

\* 20101350

20200100

20200200

20101000 TEMPORARY FENCE

TREE TRUNK PROTECTION

TREE ROOT PRUNING

EARTH EXCAVATION

ROCK EXCAVATION

TREE PRUNING (1TO 10 INCH DIAMETER)

TREE PRUNING (OVER 10 INCH DIAMETER)

ITEM DESCRIPTION

	DRAWN - FYW	REVISED -	STATE OF ILLINOIS
LOT SCALE = 0.16666667 ' / IN.	CHECKED - BRH	REVISED -	DEPARTMENT OF TRANSPOR
OT DATE = 1/29/2024	DATE -	REVISED -	

URBAN

TOTAL

116

20

20

25

25

12,313

3,552

QUANTITY

UNIT

FOOT

EACH

EACH

EACH

EACH

CUYD

CUYD

ROADWAY

URBAN

80% FED

20% STATE

116

20

20

25

25

12,313

3,406

ROADWAY

MAINTENANCE

URBAN

0004

100% STATE

BRIDGE

REHAB

SN 099-0123

0013

80% FED

20% STATE

SN 099-0056

SN 009-0057

0013

90% FED

10% STATE

	RTE.	SEC					
		SUMMARY	OF OIL	ANTITIES		354	99-4
		OUMINAITI	01 40	ANTITIES	<u> </u>		
SCALE:	SHEET	OF	SHEETS	STA.	TO STA.		

TRAFFIC SIGNALS

RICHARDS ST

WB RAMPS

0021

80% FED

20% STATE

RICHARDS ST INTERCONNECT

0021

80% FED

20% STATE

0021

100% JOLIET

PROTECTION DISTRICT

FIRE

<b>*</b> ехр.
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CODE

25003210

28000250

28000305

28000400

28000510

25000600 POTASSIUM FERTILIZER NUTRIENT

INTERSEEDING, CLASS 2A

TEMPORARY DITCH CHECKS

PERIMETER EROSION BARRIER

INLET FILTERS

TEMPORARY EROSION CONTROL SEEDING

ITEM DESCRIPTION

USER NAME = AVILAC	DESIGNED	-	CMA	REVISED	-
	DRAWN	-	FYW	REVISED	-
PLOT SCALE = 0.16666667 ' / IN.	CHECKED	-	BRH	REVISED	-
PLOT DATE = 1/29/2024	DATE	-		REVISED	-

### STATE OF ILLINOIS **DEPARTMENT OF TRANSPORTATION**

URBAN

TOTAL

QUANTITY

593

1.00

679

1,173

76

UNIT

POUND

ACRE

POUND

FOOT

FOOT

EACH

ROADWAY

URBAN

80% FED

20% STATE

593

1.00

679

1,173

76

ROADWAY

MAINTENANCE

URBAN

100% STATE

BRIDGE

REHAB

SN 099-0123

0013

80% FED

20% STATE

SN 099-0056

SN 009-0057

0013

90% FED

10% STATE

BRIDGE REPAIR | NOISE ABATMENT | NOISE ABATMENT

WALL

SN 099-N1004

0020

90% FED

10% STATE

WALL

SN 099-N1003

90% FED

10% STATE

HIGHWAY

LIGHTING

0021

80% FED

20% STATE

RICHARDS ST

EB RAMPS

0021

80% FED

20% STATE

	RTE.	SECT <b>I</b> O					
		SUMMARY	OF OIL	<b>ANTITIE</b>	e	354	99-4B-2-
		JUNINAIII	01 40	AIVIIIIL.			
SCALE:	SHEET OF SH				TO STA.		ILI

TOTAL SHEET NO. COUNTY WILL 320 6 CONTRACT NO. 62380 ILLINOIS FED. AID PROJECT

TRAFFIC SIGNALS

RICHARDS ST INTERCONNECT

0021

80% FED

20% STATE

0021

100% JOLIET

FIRE

PROTECTION DISTRICT

RICHARDS ST

WB RAMPS

80% FED

20% STATE

28001100	TEMPORARY EROSION CONTROL BLANKET	SQYD	53,480	53,480				
28001200	TEMPORARY HEAVY DUTY EROSION CONTROL BLANKET	SQ YD	8,066	8,066				
28100105	STONE RIPRAP, CLASS A3	SQ YD	352	352				
28100107	STONE RIPRAP, CLASS A4	SQYD	20	20				
28100109	STONE RIPRAP, CLASS A5	SQYD	105	105				
28200200	FILTER FABRIC	SQYD	648	648				
28500400	ARTICULATED BLOCK REVETMENT MAT	SQYD	51	51				
30300001	AGGREGATE SUBGRADE IMPROVEMENT	CUYD	447	447				
30300112	AGGREGATE SUBGRADE IMPROVEMENT 12"	SQYD	17,186	17,186				
31101200	SUBBASE GRANULAR MATERIAL, TYPE B 4"	SQYD	359	359				
*	SPECIALTY ITEM					·		

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												TRAFFIC	SIGNALS	
			URBAN	ROADWAY URBAN	ROADWAY MAINTENANCE URBAN	BRIDGE REHAB SN 099-0123	SN 099-0056 SN 009-0057	WALL SN 099-N1003	WALL SN 099-N1004	Highway Lighting	RICHARDS ST EB RAMPS	RICHARDS ST WB RAMPS	RICHARDS ST EVP	INTERCONNECT
				0004	0004	0013	0013	0020	0020	0021	0021	0021	0021	0021
CODE NO.	ITEM DESCRIPTION	UNIT	TOTAL QUANTITY	80% FED 20% STATE	100% STATE	80% FED 20% STATE	90% FED 10% STATE	90% FED 10% STATE	90% FED 10% STATE	80% FED 20% STATE	80% FED 20% STATE	80% FED 20% STATE	100% JOLIET FIRE PROTECTION DISTRICT	80% FED 20% STATE
31102100	SUBBASE GRANULAR MATERIAL, TYPE C 4"	SQ YD	633	633										
31200100	STABILIZED SUBBASE 4"	SQYD	183	183										
							1							<u> </u>
31200500	STABILIZED SUBBASE - HOT-MIX ASPHALT, 4"	SQ YD	2,727	2,727										
35101800	AGGREGATE BASE COURSE, TYPE B 6"	SQYD	312	312										<u> </u>
40600290	BITUMINOUS MATERIALS (TACK COAT)	POUND	944	944										
40600370	LONGITUDINAL JOINT SEALANT	FOOT	6,775	6,775										
40600982	HOT-MIX ASPHALT SURFACE REMOVAL - BUTT JOINT	SQ YD	38	38										
40603080	HOT-MIX ASPHALT BINDER COURSE, IL-19.0, N50	TON	48	48										
								1						
40603230	POLYMERIZED HOT-MIXASPHALT BINDER COURSE, IL-19.0, N50	TON	35	35										
40604060	HOT MY ACRUALT CURRACE COURSE II. O.E. MIV "D" NEO	TON	55				<u> </u>	1			1			<u> </u>
40604060	HOT-MIX ASPHALT SURFACE COURSE, IL-9.5, MIX "D", N50	TON	55	55										
40604172	POLYMERIZED HOT-MIX ASPHALT SURFACE COURSE, IL-9.5, MIX "E", N70	TON	402	402										
40701896	HOT-MIX ASPHALT PAVEMENT (FULL-DEPTH), 10 3/4"	SQ YD	10,813	10,813										
42000080	PAVEMENT CONNECTOR (PCC) FOR BRIDGE APPROACH SLAB	SQ YD	330	330										
42000401	PORTLAND CEMENT CONCRETE PAVEMENT 9" (JOINTED)	SQYD	2,540	2,540										
														<u> </u>
42001300	PROTECTIVE COAT	SQYD	7,235	7,235										
42400200	PORTLAND CEMENT CONCRETE SIDEWALK 5 INCH	SQFT	15,506	15,506										<u> </u>
-2400200	. SALD AND SEMENT CONTINUE CONTINUES	J JULIA	10,000	10,000										

\* SPECIALTY ITEM



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PLOT SCALE = 0.16666667 ' / IN.	CHECKED -	BRH	REVISED	-
PLOT DATE = 1/29/2024	DATE -		REVISED	-

		RICHA	RDS ST	REET		F.A.U. RTE.	SECT	ION		COUNTY	TOTAL SHEETS	SHEET NO.
	SUMMARY OF QUANTITIES						99-4B	-2-BR		WILL	320	7
										CONTRACT	NO. 623	380
	SHEET	OF	SHEETS	STA.	TO STA.			ILLINOIS	FED. All	O PROJECT		T i

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			URBAN	ROADWAY URBAN	ROADWAY MAINTENANCE URBAN	BRIDGE REHAB SN 099-0123	BRIDGE REPAIR SN 099-0056 SN 009-0057	NOISE ABATMENT WALL SN 099-N1003	NOISE ABATMENT WALL SN 099-N1004	HIGHWAY LIGHTING	RICHARDS ST EB RAMPS	RICHARDS ST WB RAMPS	RICHARDS ST EVP	INTERCONNECT	
				0004	0004	0013	0013	0020	0020	0021	0021	0021	0021	0021	
CODE NO.	ITEM DESCRIPTION	UNIT	TOTAL QUANTITY	80% FED 20% STATE	100% STATE	80% FED 20% STATE	90% FED 10% STATE	90% FED 10% STATE	90% FED 10% STATE	80% FED 20% STATE	80% FED 20% STATE	80% FED 20% STATE	100% JOLIET FIRE PROTECTION DISTRICT	80% FED 20% STATE	
42400800	DETECTABLE WARNINGS	SQ FT	220	220											
44000100	PAVEMENT REMOVAL	SQYD	15,875	15,875											
44000157	HOT-MIX ASPHALT SURFACE REMOVAL, 2"	SQYD	399	399											
44000200	DRIVEWAY PAVEMENT REMOVAL	SQYD	44	44											
44000500	COMBINATION CURB AND GUTTER REMOVAL	FOOT	7,012	7,012										<u> </u>	
		-													
44000600	SIDEWALK REMOVAL	SQ FT	15,613	15,613				1						<u> </u>	
44003100	MEDIAN REMOVAL	SQ FT	21,960	21,960										<u> </u>	
44004000	PAVED DITCH REMOVAL	FOOT	115	115											
														<u> </u>	
44004250	PAVED SHOULDER REMOVAL	SQ YD	363	363											
44004000	OLADA DI DATOLIFA TUDE IL ANIMOLI	00.40													
44201803	CLASS D PATCHES, TYPE II, 13 INCH	SQ YD	52	52										<u> </u>	
44201807	CLASS D PATCHES, TYPE III, 13 INCH	SQ YD	78	78										<u> </u>	
44201809	CLASS D PATCHES, TYPE IV, 13 INCH	SQ YD	78	78											
48101498	AGGREGATE SHOULDERS, TYPE B 4"	SQYD	832	832											
48101610	AGGREGATE SHOULDERS, TYPE B 9"	SQYD	71	71										<u> </u>	
48300400	PORTLAND CEMENT CONCRETE SHOULDERS 9"	SQYD	368	368											
						<u> </u>								<u> </u>	
50101500	REMOVAL OF EXISTING SUPERSTRUCTURES	EACH	1 			1								<u> </u>	
	SPECIALTY ITEM	1													

	RICHAR	DS ST	REET		F.A.U. RTE.	SECTION	COUNTY	SHEETS	SHEET NO.		
	SUMMARY	NE NII	ANTITIES		354	99-4B-2-BR	WILL	320	8		
	JUNINAITI	01 40	ANTITILO		CONTRACT NO. 62380						
SHEET	OF	SHEETS	STA.	TO STA.		ILLINOIS   FED. AI	D PROJECT				

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												TRAFFIC	SIGNALS	
			URBAN	ROADWAY URBAN	ROADWAY MAINTENANCE URBAN	BRIDGE REHAB SN 099-0123	SN 099-0056 SN 009-0057	WALL SN 099-N1003	NOISE ABATMENT WALL SN 099-N1004	HIGHWAY LIGHTING	RICHARDS ST EB RAMPS	RICHARDS ST WB RAMPS	RICHARDS ST EVP	INTERCONNECT
				0004	0004	0013	0013	0020	0020	0021	0021	0021	0021	0021
CODE NO.	ITEM DESCRIPTION	UNIT	TOTAL QUANTITY	80% FED 20% STATE	100% STATE	80% FED 20% STATE	90% FED 10% STATE	90% FED 10% STATE	90% FED 10% STATE	80% FED 20% STATE	80% FED 20% STATE	80% FED 20% STATE	100% JOLIET FIRE PROTECTION DISTRICT	80% FED 20% STATE
50102400	CONCRETE REMOVAL	CUYD	137.6			137.6								
50104650	SLOPE WALL REMOVAL	SQYD	198			198								
50200100	STRUCTURE EXCAVATION	CUYD	478			478								
50200400	ROCK EXCAVATION FOR STRUCTURES	CUYD	2,656	2,532						72	40	12		
50300100	FLOOR DRAINS	EACH	2			2								
		<u> </u>												
50300225	CONCRETE STRUCTURES	CUYD	242.1			242.1								<u> </u>
50300255	CONCRETE SUPERSTRUCTURE	CUYD	499.8			499.8								<u> </u>
50300260	BRIDGE DECK GROOVING	SQYD	1,510			1,510								
		<u> </u>										1		<u> </u>
50300280	CONCRETE ENCASEMENT	CUYD	2.0			2.0								
50300300	PROTECTIVE COAT	SQYD	2,565			2,565								
		<u> </u>												
50301350	CONCRETE SUPERSTRUCTURE (APPROACHSLAB)	CUYD	266.0			266.0								
50500105	FURNISHINGAND ERECTING STRUCTURAL STEEL	L SUM	1			1								
50500505	STUD SHEAR CONNECTORS	EACH	10,376			10,376								
50800205	REINFORCEMENT BARS, EPOXY COATED	POUND	330,420			330,420								
50800515	BAR SPLICERS	EACH	903			903								
50900105	ALUMINUM RAILING, TYPE L	FOOT	216			216								
													<u> </u>	

\* SPECIALTY ITEM



USER NAME = AVILAC	DESIGNED - CMA	REVISED -
	DRÁWN - FYW	REVISED -
PLOT SCALE = 0.16666667 ' / IN.	CHECKED - BRH	REVISED -
PLOT DATE = 1/29/2024	DATE -	REVISED -

		RICHA	RDS ST	REET	F.A.U. RTE.	SECTION	COUNTY	TOTAL	SHEET NO.		
		SUMMARY	OF QU	ANTITIES	354	99-4B-2-BR	WILL	320	9		
		OUMINAITI	01 40	ANTITIES		CONTRACT NO. 62380					
)	SHEET OF SHEETS STA. TO STA.						] ILLINOIS ] FED. AI	D PROJECT			

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											TRAFFIC SIGNALS			
			URBAN	ROADWAY URBAN	ROADWAY MAINTENANCE URBAN	BRIDGE REHAB SN 099-0123	BRIDGE REPAIR SN 099-0056 SN 009-0057	NOISE ABATMENT WALL SN 099-N1003	NOISE ABATMENT WALL SN 099-N1004	HIGHWAY LIGHTING	RICHARDS ST EB RAMPS	RICHARDS ST WB RAMPS	RICHARDS ST EVP	INTERCONNECT
1 1				0004	0004	0013	0013	0020	0020	0021	0021	0021	0021	0021
CODE NO.	ITEM DESCRIPTION	UNIT	TOTAL QUANTITY	80% FED 20% STATE	100% STATE	80% FED 20% STATE	90% FED 10% STATE	90% FED 10% STATE	90% FED 10% STATE	80% FED 20% STATE	80% FED 20% STATE	80% FED 20% STATE	100% JOLIET FIRE PROTECTION DISTRICT	80% FED 20% STATE
50901720	BICYCLE RAILING	FOOT	210			210								
50901750	PARAPET RAILING	FOOT	210			210								
51100300	SLOPE WALL 6 INCH	SQ YD	217			217								
51201400	FURNISHING STEEL PILES HP10X42	FOOT	88			88								<u> </u>
01201400	750000 1100 01222 1 1220 111 10012	1001												1
51202305	DRIVING PILES	FOOT	88			88								
51204650	PILE SHOES	EACH	4			4								
											İ			
51500100	NAME PLATES	EACH	3			1		1	1					<u> </u>
52000110	PREFORMED JOINT STRIP SEAL	FOOT	180			180								
52100010	ELASTOMERIC BEARING ASSEMBLY, TYPE I	EACH	39			39								
52100520	ANCHOR BOLTS, 1"	EACH	78			78								
52100530	ANCHOR BOLTS, 11/4"	EACH	26			26								
52200020	TEMPORARY SOIL RETENTION SYSTEM	SQ FT	209			209								
54213660	PRECAST REINFORCED CONCRETE FLARED END SECTIONS 15"	EACH	4	4										
54213669	PRECAST REINFORCED CONCRETE FLARED END SECTIONS 24"	EACH	1	1										
														<u> </u>
54213687	PRECAST REINFORCED CONCRETE FLARED END SECTIONS 42"	EACH	1	1										
54213705	PRECAST REINFORCED CONCRETE FLARED END SECTIONS 60"	EACH	1	1										
			1 1		1						1		<del> </del>	<del>                                     </del>

\* SPECIALTY ITEM



USER NAME = AVILAC	DESIGNED	-	CMA	KEVISED	-
	DRAWN	-	FYW	REVISED	-
PLOT SCALE = 0.16666667 ' / IN.	CHECKED	-	BRH	REVISED	-
PLOT DATE = 1/29/2024	DATE	-		REVISED	-

STATE OF ILLINOIS DEPARTMENT OF TRANSPORTATION

								F.A.U. RTE.	SEC <sup>-</sup>	TION		COUNTY	TOTAL SHEETS	SHEET NO.
			SUMMARY	OF OIL	ANTITIES		ĺ	354	99-4B	-2-BR		WILL	320	10
			SOMMAN	OI GO	ANTITIES							CONTRACT	NO. 623	380
	SCALE: N.T.S.	ALE: N.T.S. SHEET OF SHEETS STA. TO STA.								ILLINOIS	FED. AII	D PROJECT		

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			URBAN	ROADWAY URBAN	ROADWAY MAINTENANCE URBAN	BRIDGE REHAB SN 099-0123	BRIDGE REPAIR SN 099-0056 SN 009-0057	NOISE ABATMENT WALL SN 099-N1003	NOISE ABATMENT WALL SN 099-N1004	HIGHWAY LIGHTING	RICHARDS ST EB RAMPS	RICHARDS ST WB RAMPS	RICHARDS ST EVP	INTERCONNEC
				0004	0004	0013	0013	0020	0020	0021	0021	0021	0021	0021
CODE NO.	ITEM DESCRIPTION	UNIT	TOTAL QUANTITY	80% FED 20% STATE	100% STATE	80% FED 20% STATE	90% FED 10% STATE	90% FED 10% STATE	90% FED 10% STATE	80% FED 20% STATE	80% FED 20% STATE	80% FED 20% STATE	100% JOLIET FIRE PROTECTION DISTRICT	80% FED 20% STATE
54261324	CONCRETE END SECTION, STANDARD 542001, 24", 1:3	EACH	1	1										
54261418	CONCRETE END SECTION, STANDARD 542001, 18", 1:4	EACH	1	1										
54261436	CONCRETE END SECTION, STANDARD 542001, 36", 1:4	EACH	1	1										
550A0340	STORM SEWERS, CLASS A, TYPE 2 12"	FOOT	10	10										
550A0360	STORM SEWERS, CLASS A, TYPE 2 15"	FOOT	2,656	2,656										
550A0380	STORM SEWERS, CLASS A, TYPE 2 18"	FOOT	456	456										
550A0410	STORM SEWERS, CLASS A, TYPE 2 24"	FOOT	266	266										
550A0430	STORM SEWERS, CLASS A, TYPE 2 30"	FOOT	217	217										
			1											
550A0450	STORM SEWERS, CLASS A, TYPE 2 36"	FOOT	403	403										
550A0500	STORM SEWERS, CLASS A, TYPE 2 60"	FOOT	48	48										
			1											
550A0770	STORM SEWERS, CLASS A, TYPE 3 42"	FOOT	40	40			1							
55100500	STORM SEWER REMOVAL 12"	FOOT	534	534			1							
			 				1							
55100700	STORM SEWER REMOVAL 15"	FOOT	361	361										<u> </u>
55100900	STORM SEWER REMOVAL 18"	FOOT	261	261										
			<u> </u> 	_										
55101800	STORM SEWER REMOVAL 42"	FOOT	8	8										
58600101	GRANULAR BACKFILL FOR STRUCTURES	CUYD	453			453								
		1												<u> </u>

STATE OF ILLINOIS DEPARTMENT OF TRANSPORTATION

TRAFFIC SIGNALS

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			URBAN	ROADWAY URBAN	ROADWAY MAINTENANCE URBAN	BRIDGE REHAB SN 099-0123	BRIDGE REPAIR SN 099-0056 SN 009-0057	NOISE ABATMENT WALL SN 099-N1003	NOISE ABATMENT WALL SN 099-N1004	HIGHWAY LIGHTING	RICHARDS ST EB RAMPS	RICHARDS ST WB RAMPS	RICHARDS ST EVP	INTERCONNECT
				0004	0004	0013	0013	0020	0020	0021	0021	0021	0021	0021
CODE NO.	ITEM DESCRIPTION	UNIT	TOTAL QUANTITY	80% FED 20% STATE	100% STATE	80% FED 20% STATE	90% FED 10% STATE	90% FED 10% STATE	90% FED 10% STATE	80% FED 20% STATE	80% FED 20% STATE	80% FED 20% STATE	100% JOLIET FIRE PROTECTION DISTRICT	80% FED 20% STATE
59000200	EPOXY CRACK INJECTION	FOOT	104			104								
59100100	GEOCOMPOSITE WALL DRAIN	SQYD	1,372			218		524	630					
60100060	CONCRETE HEADWALLS FOR PIPE DRAINS	EACH	1	1										
											<u> </u>			
60108200	PIPE UNDERDRAINS 6" (SPECIAL)	FOOT	267	267										
60108206	PIPE UNDERDRAINS, TYPE 2, 6"	FOOT	3,895	3,895										
60146304	PIPE UNDERDRAINS FOR STRUCTURES 4"	FOOT	2,656			247		1,067	1,342					
60200305	CATCH BASINS, TYPE A, 4'-DIAMETER, TYPE 3 FRAME AND GRATE	EACH	10	10										
60200805	CATCH BASINS, TYPE A, 4'-DIAMETER, TYPE 8 GRATE	EACH	2	2										
60201340	CATCH BASINS, TYPE A, 4'-DIAMETER, TYPE 24 FRAME AND GRATE	EACH	37	37										
60204505	CATCH BASINS, TYPE A, 5'-DIAMETER, TYPE 8 GRATE	EACH	1	1										
60205040	CATCH BASINS, TYPE A, 5'-DIAMETER, TYPE 24 FRAME AND GRATE	EACH	11	11										
60207605	CATCH BASINS, TYPE C, TYPE 8 GRATE	EACH	5	5										
60218400	MANHOLES, TYPE A, 4'-DIAMETER, TYPE 1 FRAME, CLOSED LID	EACH	2	2										
552.5400		27011	-											
60221100	MANHOLES, TYPE A, 5'-DIAMETER, TYPE 1 FRAME, CLOSED LID	EACH	1	1										
60224039	MANHOLES, TYPE A, 6'-DIAMETER, TYPE 24 FRAME AND GRATE	EACH	6	6										
00227000		LAOIT												1
60224446	MANHOLES, TYPEA, 7'-DIAMETER, TYPE 1 FRAME, CLOSED LID	EACH	3	3										
		İ				İ								1

		RICHAI	RDS ST	REET		F.A.U. RTE.	SEC	TION		COUNTY	SHEETS	SHEET NO.
		CHMMARV	OF OIL	ANTITIES		354	99-4B	-2-BR		WILL	320	12
		JUMINALLI	01 40	ANTITIES						CONTRACT	NO 62	380
SCALE: SHEET OF SHEETS STA. TO STA.						ILLINOIS   FED. AID PROJECT						
		SHEET	SUMMARY	SUMMARY OF QU	SUMMARY OF QUANTITIES	SUMMARY OF QUANTITIES	SUMMARY OF QUANTITIES 354	SUMMARY OF QUANTITIES  354 99-4B	SUMMARY OF QUANTITIES  354 99-4B-2-BR	SUMMARY OF QUANTITIES  354 99-4B-2-BR	SUMMARY OF QUANTITIES  354 99-4B-2-BR WILL CONTRACT	SUMMARY OF QUANTITIES  354 99-4B-2-BR WILL 320  CONTRACT NO. 62

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			URBAN	ROADWAY URBAN	ROADWAY MAINTENANCE URBAN	BRIDGE REHAB SN 099-0123	BRIDGE REPAIR SN 099-0056 SN 009-0057	NOISE ABATMENT WALL SN 099-N1003	NOISE ABATMENT WALL SN 099-N1004	HIGHWAY LIGHTING	RICHARDS ST EB RAMPS	RICHARDS ST WB RAMPS	RICHARDS ST EVP	INTERCONNECT
				0004	0004	0013	0013	0020	0020	0021	0021	0021	0021	0021
CODE NO.	ITEM DESCRIPTION	UNIT	TOTAL QUANTITY	80% FED 20% STATE	100% STATE	80% FED 20% STATE	90% FED 10% STATE	90% FED 10% STATE	90% FED 10% STATE	80% FED 20% STATE	80% FED 20% STATE	80% FED 20% STATE	100% JOLIET FIRE PROTECTION DISTRICT	80% FED 20% STATE
60224449	MANHOLES, TYPE A, 7'-DIAMETER, TYPE 24 FRAME AND GRATE	EACH	1	1										
60255500	MANHOLES TO BE ADJUSTED	EACH	1	1										
60260900	INLETS TO BE ADJUSTED WITH NEW TYPE 6 FRAME AND GRATE	EACH	1	1										
60264140	INLETS TO BE RECONSTRUCTED WITH NEW TYPE 24 FRAME AND GRATE	EACH	1	1										
60500040	REMOVING MANHOLES	EACH	6	6										
60500050	REMOVING CATCH BASINS	EACH	17	17										
60602800	CONCRETE GUTTER, TYPE B	FOOT	1,062	1,062										
60603800	COMBINATION CONCRETE CURB AND GUTTER, TYPE B-6.12	FOOT	948	948										
60605000	COMBINATION CONCRETE CURB AND GUTTER, TYPE B-6.24	FOOT	5,981	5,981										
60605900	COMBINATION CONCRETE CURB AND GUTTER, TYPE B-9.12	FOOT	300	300										
60608600	COMBINATION CONCRETE CURB AND GUTTER, TYPE M-6,06	FOOT	225	225										
0000000	COMBINATION CONCRETE CONTRACTOR THE IMPOSE	1001	220											
60610400	COMBINATION CONCRETE CURB AND GUTTER, TYPE M-6.24	FOOT	203	203										
60618300	CONCRETE MEDIAN SURFACE, 4 INCH	SQ FT	2,005	2,005										
		_												
60620000	CONCRETE MEDIAN, TYPE SB-6.24	SQ FT	317	317										
60622800	CONCRETE MEDIAN, TYPE SM-6.12	SQ FT	2,772	2,772										
60920018	PIPE CULVERTS TO BE CLEANED 18"	FOOT	110		110									

\* SPECIALTY ITEM



USER NAME = AVILAC	DESIGNED - CMA	REVISED -
	DRAWN - FYW	REVISED -
PLOT SCALE = 0.16666667 ' / IN.	CHECKED - BRH	REVISED -
PLOT DATE = 1/29/2024	DATE -	REVISED -

STATE OF ILLINOIS
DEPARTMENT OF TRANSPORTATION

	RICHAR	DS ST	REET		F.A.U. RTE.	SECTION	COUNTY	TOTAL SHEETS	SHEET NO.
	SUMMARY	OF OIL	ANTITIE	e ĺ	354	99-4B-2-BR	WILL	320	13
	OUMINAITI	01 40	ANTITIE				CONTRACT	NO. 62	380
SHEET	OF	SHEETS	STA.	TO STA.		ILLINOIS   FE	D. AID PROJECT		

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CODE NO.	ITEM DESCRIPTION	UNIT	TOTAL QUANTITY	80% FED 20% STATE	100% STATE	80% FED 20% STATE	90% FED 10% STATE	90% FED 10% STATE	90% FED 10% STATE	80% FED 20% STATE	80% FED 20% STATE	80% FED 20% STATE	100% JOLIET FIRE PROTECTION DISTRICT	80% FED 20% STATE
63000001	STEEL PLATE BEAM GUARDRAIL, TYPE A, 6 FOOT POSTS	FOOT	550	550										
63100045	TRAFFIC BARRIER TERMINAL, TYPE 2	EACH	2	2										
63100085	TRAFFIC BARRIER TERMINAL, TYPE 6	EACH	2	2										
63100089	TRAFFIC BARRIER TERMINAL, TYPE 6B	EACH	2	2										
63100105	TRAFFIC BARRIER TERMINAL, TYPE 10	EACH	2	2										
63100167	TRAFFIC BARRIER TERMINAL, TYPE 1 (SPECIAL) TANGENT	EACH	3	3										
63100169	TRAFFIC BARRIER TERMINAL, TYPE 1 (SPECIAL) FLARED	EACH	1	1										
63200310	GUARDRAIL REMOVAL	FOOT	1,096	1,096										
66400305	CHAIN LINK FENCE, 6'	FOOT	1,637	1,637										
66402700	CHAIN LINK GATES, 6' X 4' SINGLE	EACH	5	5										
66900200	NON-SPECIAL WASTE DISPOSAL	CUYD	4,405	4,405										
66900530	SOIL DISPOSAL ANALYSIS	EACH	10	10										
66901001	REGULATED SUBSTANCES PRE-CONSTRUCTION PLAN	L SUM	1	1										
66901003	REGULATED SUBSTANCES FINAL CONSTRUCTION REPORT	L SUM	1	1										
66901006	REGULATED SUBSTANCES MONITORING	CAL DA	100	100										
67100100	MOBILIZATION	L SUM		1										

URBAN

ROADWAY

URBAN

ROADWAY

MAINTENANCE

URBAN

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BRIDGE

REHAB

SN 099-0123

0013

SN 099-0056

SN 009-0057

0013

BRIDGE REPAIR | NOISE ABATMENT | NOISE ABATMENT |

WALL

SN 099-N1004

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WALL

SN 099-N1003

HIGHWAY

LIGHTING

0021

		RICHAI	RDS STI	REET		F.A.U. RTE.	SECT	ION		COUNTY	TOTAL SHEETS	SHEET NO.
		SUMMARY	OF OU	ANTITIES		354	99-4B-	2-BR		WILL	320	14
		JUMINALLI	01 40	ANTITIES						CONTRACT	NO 623	380
SCALE:	SHEET	OF	SHEETS	STA.	TO STA.			ILLINOIS	FED. AID	O PROJECT		

TRAFFIC SIGNALS

RICHARDS ST WB RAMPS

RICHARDS ST

EB RAMPS

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RICHARDS ST INTERCONNECT EVP

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USER NAME = AVILAC	DESIGNED - CMA	REVISED -
	DRAWN - FYW	REVISED -
PLOT SCALE = 0.16666667 ' / IN.	CHECKED - BRH	REVISED -
PLOT DATE = 1/29/2024	DATE -	REVISED -

STATE OF ILLINOIS
DEPARTMENT OF TRANSPORTATION

	RICHARDS STREET							COUNTY	TOTAL	SHEET NO.	
	SUMMARY OF QUANTITIES							WILL	320	15	
		SUMMAN	OI UU	ANTITIES			CONTRACT NO. 6238				
SCALE: SHEET OF SHEETS STA. TO STA.							] ILLINOIS ] FED. A	D PROJECT			

												TRAFFIC	SIGNALS	NALS		
			URBAN	ROADWAY URBAN	ROADWAY MAINTENANCE URBAN	BRIDGE REHAB SN 099-0123	BRIDGE REPAIR SN 099-0056 SN 009-0057	NOISE ABATMENT WALL SN 099-N1003	NOISE ABATMENT WALL SN 099-N1004	HIGHWAY LIGHTING	RICHARDS ST EB RAMPS	RICHARDS ST WB RAMPS	RICHARDS ST EVP	INTERCONNECT		
				0004	0004	0013	0013	0020	0020	0021	0021	0021	0021	0021		
CODE NO.	ITEM DESCRIPTION	UNIT	TOTAL QUANTITY	80% FED 20% STATE	100% STATE	80% FED 20% STATE	90% FED 10% STATE	90% FED 10% STATE	90% FED 10% STATE	80% FED 20% STATE	80% FED 20% STATE	80% FED 20% STATE	100% JOLIET FIRE PROTECTION DISTRICT	80% FED 20% STATE		
70107025	CHANGEABLE MESSAGE SIGN	CAL DA	1,440	1,440												
70300100	SHORT TERM PAVEMENT MARKING	FOOT	2,857	2,857												
70300150	SHORT TERM PAVEMENT MARKING REMOVAL	SQ FT	14,930	14,930												
70301100	TEMPORARY PAVEMENT MARKING LETTERS AND SYMBOLS - EPOXY	SQ FT	166	166												
70301120	TEMPORARY PAVEMENT MARKING - LINE 4" - EPOXY	FOOT	3,840	3,840												
70001120	TEM STORY TAXBULATION BINES BINES BISSA	1001	0,040	0,040												
70301140	TEMPORARY PAVEMENT MARKING-LINE 8"- EPOXY	FOOT	2,000	2,000												
70303120	TEMPORARY PAVEMENT MARKING - LINE 4* - MODIFIED URETHANE	FOOT	22,938	22,938												
70303160	TEMPORARY PAVEMENT MARKING - LINE 12"- MODIFIED URETHANE	FOOT	90	90												
70307100	TEMPORARY PAVEMENT MARKING LETTERS AND SYMBOLS - TYPE IV TAPE	SQ FT	814	814												
70307120	TEMPORARY PAVEMENT MARKING - LINE 4" - TYPE IV TAPE	FOOT	46,744	46,744												
70307130	TEMPORARY PAVEMENT MARKING - LINE 6" - TYPE IV TAPE	FOOT	2,892	2,892												
70307140	TEMPORARY PAVEMENT MARKING-LINE 8"- TYPE IV TAPE	FOOT	1,252	1,252												
70307160	TEMPORARY PAVEMENT MARKING - LINE 12"- TYPE IV TAPE	FOOT	2,630	2,630												
7.5557.105			2,300	2,500												
70307210	TEMPORARY PAVEMENT MARKING - LINE 24"- TYPE IV TAPE	FOOT	444	444												
70400100	TEMPORARY CONCRETE BARRIER	FOOT	375	375												
70400405	DINNING TEMPODADY CONCRETE PARRIER	EACU	404	404												
70400125	PINNING TEMPORARY CONCRETE BARRIER	EACH	104	104												
	CDEC(A) TV/TEA										I	<u> </u>	<u> </u>			

\* SPECIALTY ITEM

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			URBAN	ROADWAY URBAN	ROADWAY MAINTENANCE URBAN	BRIDGE REHAB SN 099-0123	SN 099-0056 SN 009-0057	NOISE ABATMENT WALL SN 099-N1003	WALL SN 099-N1004	HIGHWAY LIGHTING	RICHARDS ST EB RAMPS	RICHARDS ST WB RAMPS	RICHARDS ST EVP	INTERCONNECT
				0004	0004	0013	0013	0020	0020	0021	0021	0021	0021	0021
CODE NO.	ITEM DESCRIPTION	UNIT	TOTAL QUANTITY	80% FED 20% STATE		80% FED 20% STATE	90% FED 10% STATE	90% FED 10% STATE	90% FED 10% STATE	80% FED 20% STATE	80% FED 20% STATE	80% FED 20% STATE	100% JOLIET FIRE PROTECTION DISTRICT	80% FED 20% STATE
70400200	RELOCATE TEMPORARY CONCRETE BARRIER	FOOT	350	350										
70600275	impact attenuators, temporary (severe use, narrow), test level 2	EACH	2	2										
70600355	IMPACT ATTENUATORS, RELOCATE (SEVERE USE), TEST LEVEL 2	EACH	2	2										
72000100	SIGN PANEL - TYPE 1	SQFT	346	330							8	8		
72000200	SIGN PANEL - TYPE 2	SQFT	20	20										
72000300	SIGN PANEL - TYPE 3	SQFT	623	623										
72400100	REMOVE SIGN PANEL ASSEMBLY - TYPE A	EACH	2	2										
70.4000.40	DEMONS COMPANYS. TYPE 4	00.57	050	050										<u> </u>
72400310	REMOVE SIGN PANEL - TYPE 1	SQFT	259	259										<del>                                     </del>
72400320	REMOVE SIGN PANEL - TYPE 2	SQFT	20	20										
														<u> </u>
72400330	REMOVE SIGN PANEL - TYPE 3	SQFT	400	400										
72400710	RELOCATE SIGN PANEL - TYPE 1	SQFT	6	6										
72501000	TERMINAL MARKER - DIRECT APPLIED	EACH	4	4										
72700100	STRUCTURAL STEEL SIGN SUPPORT - BREAKAWAY	POUND	4,723	4,723										
72800100	TELESCOPING STEEL SIGN SUPPORT	FOOT	350	350										
73400100	CONCRETE FOUNDATIONS	CUYD	12,2	12,2										
							1							
73700100	REMOVE GROUND MOUNTED SIGN SUPPORT	EACH	8	8										

STATE OF ILLINOIS DEPARTMENT OF TRANSPORTATION

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CODE NO.	ITEM DESCRIPTION	UNIT	TOTAL QUANTITY	80% FED 20% STATE	100% STATE	80% FED 20% STATE	90% FED 10% STATE	90% FED 10% STATE	90% FED 10% STATE	80% FED 20% STATE	80% FED 20% STATE	80% FED 20% STATE	100% JOLIET FIRE PROTECTION DISTRICT	80% FED 20% STATE
73700200	REMOVE CONCRETE FOUNDATION - GROUND MOUNT	EACH	8	8										
78000100	THERMOPLASTIC PAVEMENT MARKING - LETTERS AND SYMBOLS	SQ FT	218	218										
78000200	THERMOPLASTIC PAVEMENT MARKING - LINE 4"	FOOT	5,631	5,631										
* 78000400	THERMOPLASTIC PAVEMENT MARKING - LINE 6"	FOOT	729	729										
78000500	THERMOPLASTIC PAVEMENT MARKING - LINE 8"	FOOT	2,032	2,032										
* 78000600	THERMOPLASTIC PAVEMENT MARKING - LINE 12"	FOOT	213	213										
* 78000650	THERMOPLASTIC PAVEMENT MARKING - LINE 24"	FOOT	146	146										
* 78004635	PREFORMED PLASTIC PAVEMENT MARKING, TYPE D - STANDARD - LINE 7"	FOOT	105	105										
* 78008210	POLYUREA PAVEMENT MARKING TYPE I-LINE 4"	FOOT	36	36										
* 78008230	POLYUREA PAVEMENT MARKING TYPE I - LINE 6"	FOOT	225	225										
* 78008240	POLYUREA PAVEMENT MARKING TYPE I-LINE 8"	FOOT	2,087	2,087										
* 78008250	POLYUREA PAVEMENT MARKING TYPE I - LINE 12"	FOOT	805	805										
* 78009000	MODIFIED URETHANE PAVEMENT MARKING - LETTERS AND SYMBOLS	SQ FT	218	218										
* 78009004	MODIFIED URETHANE PAVEMENT MARKING - LINE 4"	FOOT	795	795										
* 78009005	MODIFIED URETHANE PAVEMENT MARKING - LINE 5"	FOOT	11	11										
* 78009006	MODIFIED URETHANE PAVEMENT MARKING - LINE 6"	FOOT	370	370										
*	SPECIALTY ITEM													

ROADWAY MAINTENANCE

URBAN

0004

URBAN

ROADWAY

URBAN

0004

BRIDGE REHAB SN 099-0123

0013

SN 099-0056

SN 009-0057

0013

BRIDGE REPAIR | NOISE ABATMENT | NOISE ABATMENT |

WALL

SN 099-N1004

0020

WALL

SN 099-N1003

0020

USER NAME = AVILAC

REVISED -

DESIGNED - CMA

	RICHA	RTE.	SECTION		COUNTY	SHEETS	NO.			
		SUMMARY	OF OIL	354	99-4B-2-BR		WILL	320	17	
	OUMINAITI				CONTRACT	NO. 623	380			
SCALE: SHEET OF SHEETS STA. TO STA.					ILLINOIS FED. AID PROJECT					

TRAFFIC SIGNALS

RICHARDS ST WB RAMPS

0021

RICHARDS ST EB RAMPS

0021

HIGHWAY

LIGHTING

0021

RICHARDS ST INTERCONNECT EVP

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			URBAN	ROADWAY URBAN	ROADWAY MAINTENANCE URBAN	BRIDGE REHAB SN 099-0123	BRIDGE REPAIR SN 099-0056 SN 009-0057	NOISE ABATMENT WALL SN 099-N1003	NOISE ABATMENT WALL SN 099-N1004	Highway Lighting	RICHARDS ST EB RAMPS	RICHARDS ST WB RAMPS	RICHARDS ST EVP	INTERCONNECT
				0004	0004	0013	0013	0020	0020	0021	0021	0021	0021	0021
CODE NO.	ITEM DESCRIPTION	UNIT	TOTAL QUANTITY	80% FED 20% STATE	100% STATE	80% FED 20% STATE	90% FED 10% STATE	90% FED 10% STATE	90% FED 10% STATE	80% FED 20% STATE	80% FED 20% STATE	80% FED 20% STATE	100% JOLIET FIRE PROTECTION DISTRICT	80% FED 20% STATE
78009008	MODIFIED URETHANE PAVEMENT MARKING - LINE 8"	FOOT	1,094	1,094										
											1			
78009012	MODIFIED URETHANE PAVEMENT MARKING - LINE 12"	FOOT	1,070	1,070										<u> </u>
78009024	MODIFIED URETHANE PAVEMENT MARKING - LINE 24"	FOOT	150	150										
78011040	GROOVING FOR RECESSED PAVEMENT MARKING 8"	FOOT	105	105										
78100100	RAISED REFLECTIVE PAVEMENT MARKER	EACH	126	126										
								ŧ			ł	ł		
78100300	REPLACEMENT REFLECTOR	EACH	80	80										
78200005	GUARDRAIL REFLECTORS, TYPE A	EACH	4	4										
78200006	GUARDRAIL REFLECTORS, TYPE B	EACH	48	48										
78200011	BARRIER WALL REFLECTORS, TYPE C	EACH	62	62										
78300200	RAISED REFLECTIVE PAVEMENT MARKER REMOVAL	EACH	71	71										
78300201	PAVEMENT MARKING REMOVAL - GRINDING	SQ FT	2,612	2,612										
78300202	PAVEMENT MARKING REMOVAL - WATER BLASTING	SQ FT	3,283	3,283										
78300202	FAVENIENT MARKING REMOVAL - WATER BLASTING	SQFI	3,263	3,263										
81028200	UNDERGROUND CONDUIT, GALVANIZED STEEL, 2" DIA.	FOOT	1,410								463	767		180
81028220	UNDERGROUND CONDUIT, GALVANIZED STEEL, 3" DIA.	FOOT	293								164	129		
81028240	UNDERGROUND CONDUIT, GALVANIZED STEEL, 4" DIA,	FOOT	1,712							440	640	632		
01028240	ONDERGROUND COMBUIT, GALVANIZED STEEL, 4 DIA.	1001	1,712							440	040	032		
81100605	CONDUIT ATTACHED TO STRUCTURE, 2" DIA., PVC COATED GALVANIZED STEEL	FOOT	269								135	134		

\* SPECIALTY ITEM



USER NAME = AVILAC	DESIGNED -	_	CIMA	KEVISED	-
	DRAWN -		FYW	REVISED	-
PLOT SCALE = 0.16666667 ' / IN.	CHECKED -		BRH	REVISED	-
PLOT DATE = 1/29/2024	DATE -			REVISED	-

l			RICH	ARDS STI	F.A.U.	SECTION		COUNTY	SHEETS	SHEET NO.		
ı			SUMMAR	RY OF QUA	354	99-4B-2-BR		WILL	320	18		
Ļ			JUNINA	0. 40	AITIIILO		Ţ			CONTRAC	T NO. 62	380
L	SCALE:	SHEET	OF	SHEETS	STA.	TO STA.	ILLINOIS FED. AID PROJECT					

TRAFFIC SIGNALS

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PLOT DATE = 1/29/2024	DATE	-		REVISED	-

STATE OF ILLINOIS
DEPARTMENT OF TRANSPORTATION

		RICHA	RDS ST	F.A.U. RTE.	SECTIO	ON	COUNTY	TOTAL	SHEET NO.		
		SUMMARY	OF OIL	354	99-4B-2	WILL	320	19			
	'	SUIVIIVIANI	UI UU				CONTRACT	NO. 623	380		
SCALE:	SHEET	OF	SHEETS	STA.	TO STA.		į IL	LLINOIS FED. AID	PROJECT		

TRAFFIC SIGNALS

BRIDGE BRIDGE REPAIR NOISE ABATMENT NOISE ABATMENT HIGHWAY RICHARDS ST RICHARDS ST RICHARDS ST INTERCONNECT

			URBAN	URBAN 0004	MAINTENANCE URBAN 0004	REHAB SN 099-0123	SN 099-0056 SN 009-0057	WALL SN 099-N1003	WALL SN 099-N1004	LIGHTING 0021	EB RAMPS	WB RAMPS	EVP 0021	0021
CODE NO.	ITEM DESCRIPTION	UNIT	TOTAL QUANTITY	80% FED 20% STATE	100% STATE	80% FED 20% STATE	90% FED 10% STATE	90% FED 10% STATE	90% FED 10% STATE	80% FED 20% STATE	80% FED 20% STATE	80% FED 20% STATE	100% JOLIET FIRE PROTECTION DISTRICT	80% FED 20% STATE
81200230	CONDUIT EMBEDDED IN STRUCTURE, 2" DIA., PVC	FOOT	432							432				
81300550	JUNCTION BOX, STAINLESS STEEL, ATTACHED TO STRUCTURE, 12" X 12" X 6"	EACH	4							4				
81300830	JUNCTION BOX, STAINLESS STEEL, ATTACHED TO STRUCTURE, 18" X 18" X 8"	EACH	4								2	2		
81400100	HANDHOLE	EACH	17								8	9		
81400200	HEAVY-DUTY HANDHOLE	EACH	2								1	1		
81400300	DOUBLE HANDHOLE	EACH	5								3	2		
81603081	UNIT DUCT, 600V, 3-1C NO.2, 1/C NO.4 GROUND, (XLP-TYPE USE), 11/2" DIA. POLYETHYLENE	FOOT	4,756							4,756				
81702110	ELECTRIC CABLE IN CONDUIT, 600V (XLP-TYPE USE) 1/C NO. 10	FOOT	1,350							1,350				
81702140	ELECTRIC CABLE IN CONDUIT, 600V (XLP-TYPE USE) 1/C NO. 4	FOOT	432							432				
81702150	ELECTRIC CABLE IN CONDUIT, 600V (XLP-TYPE USE) 1/C NO. 2	FOOT	1,296							1,296				
82110008	LUMINAIRE, LED, ROADWAY, OUTPUT DESIGNATION H	EACH	31							31				
83009600	LIGHT POLE,ALUMINUM, 45 FT. M.H., 15 FT. MAST ARM	EACH	25							25				
83600200	LIGHT POLE FOUNDATION, 24" DIAMETER	FOOT	225							225				
83800205	BREAKAWAY DEVICE, TRANSFORMER BASE, 15 INCH BOLT CIRCLE	EACH	25							25				
84200500	REMOVAL OF LIGHTING UNIT, SALVAGE	EACH	16							16				
84200804	REMOVAL OF POLE FOUNDATION	EACH	16							16				

ROADWAY

URBAN ROADWAY

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			URBAN	ROADWAY URBAN	ROADWAY MAINTENANCE URBAN	BRIDGE REHAB SN 099-0123	BRIDGE REPAIR SN 099-0056 SN 009-0057	NOISE ABATMENT WALL SN 099-N1003	NOISE ABATMENT WALL SN 099-N1004	HIGHWAY LIGHTING	RICHARDS ST EB RAMPS	RICHARDS ST WB RAMPS	RICHARDS ST EVP	INTERCONNECT
ı l				0004	0004	0013	0013	0020	0020	0021	0021	0021	0021	0021
CODE NO.	ITEM DESCRIPTION	UNIT	TOTAL QUANTITY	80% FED 20% STATE	100% STATE	80% FED 20% STATE	90% FED 10% STATE	90% FED 10% STATE	90% FED 10% STATE	80% FED 20% STATE	80% FED 20% STATE	80% FED 20% STATE	100% JOLIET FIRE PROTECTION DISTRICT	80% FED 20% STATE
87300925	ELECTRIC CABLE IN CONDUIT, TRACER, NO. 14 1C	FOOT	826											826
87301215	ELECTRIC CABLE IN CONDUIT, SIGNAL NO. 14 2C	FOOT	2,861								1,451	1,410		
87301225	ELECTRIC CABLE IN CONDUIT, SIGNAL NO. 14 3C	FOOT	3,809								1,924	1,885		
87301245	ELECTRIC CABLE IN CONDUIT, SIGNAL NO. 14 5C	FOOT	4,673								2,437	2,236		
87301255	ELECTRIC CABLE IN CONDUIT, SIGNAL NO.14 7C	FOOT	1,453								688	765		
87301305	ELECTRIC CABLE IN CONDUIT, LEAD-IN, NO. 14 1 PAIR	FOOT	4,709								2,222	2,487		
87301805	ELECTRIC CABLE IN CONDUIT, SERVICE, NO. 6 2C	FOOT	394								45	349		
												I		
87301900	ELECTRIC CABLE IN CONDUIT, EQUIPMENT GROUNDING CONDUCTOR, NO. 6 1C	FOOT	2,084				<u> </u>				959	1,125		
87502500	TRAFFIC SIGNAL POST, GALVANIZED STEEL 16 FT.	EACH	6								3	3		
87700140	STEEL MAST ARM ASSEMBLY AND POLE, 20 FT.	EACH	1									1		
87700180	STEEL MAST ARM ASSEMBLY AND POLE, 28 FT.	EACH	1								1			
07700000	OTEST COMPINATION MAGE ADMARGENDIN AND DOLE 40 ST	FACIL										4		
87702820	STEEL COMBINATION MAST ARM ASSEMBLY AND POLE 18 FT.	EACH	1									1		
87702850	STEEL COMBINATION MAST ARM ASSEMBLY AND POLE 24 FT.	EACH	1								1			
87702860	STEEL COMBINATION MAST ARM ASSEMBLY AND POLE 26 FT.	EACH	2								1	1		
87702920	STEEL COMBINATION MAST ARMASSEMBLY AND POLE 38 FT.	EACH	2								1	1		
07000400	CONCERTS FOURIDATION TYPE A	5005									40	40		
87800100	CONCRETE FOUNDATION, TYPE A	FOOT	32								16	16		<u> </u>

\* SPECIALTY ITEM



USER NAME = AVILAC	DESIGNED - CMA	REVISED -
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PLOT SCALE = 0.16666667 ' / IN.	CHECKED - BRH	REVISED -
PLOT DATE = 1/29/2024	DATE -	REVISED -

STATE OF ILLINOIS
DEPARTMENT OF TRANSPORTATION

	RICHA	RDS ST	REET		F.A.U. RTE.	SECTION		COUNTY	TOTAL SHEETS	SHEET NO.
	SUMMARY	/ NE NII	ANTITIES	ŧ [	354	99-4B-2-BR		WILL	320	20
	SOMMAN	01 40	ANTITIES					CONTRACT	NO. 62	380
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			URBAN	ROADWAY URBAN	ROADWAY MAINTENANCE URBAN	BRIDGE REHAB SN 099-0123	BRIDGE REPAIR SN 099-0056 SN 009-0057	NOISE ABATMENT WALL SN 099-N1003	NOISE ABATMENT WALL SN 099-N1004	Highway Lighting	RICHARDS ST EB RAMPS	RICHARDS ST WB RAMPS	RICHARDS ST EVP	INTERCONNEC
				0004	0004	0013	0013	0020	0020	0021	0021	0021	0021	0021
CODE NO.	ITEM DESCRIPTION	UNIT	TOTAL QUANTITY	80% FED 20% STATE	100% STATE	80% FED 20% STATE	90% FED 10% STATE	90% FED 10% STATE	90% FED 10% STATE	80% FED 20% STATE	80% FED 20% STATE	80% FED 20% STATE	100% JOLIET FIRE PROTECTION DISTRICT	80% FED 20% STATE
87800150	CONCRETE FOUNDATION, TYPE C	FOOT	8								4	4		
87800400	CONCRETE FOUNDATION, TYPE E 30-INCH DIAMETER	FOOT	84								39	45		1
87800415	CONCRETE FOUNDATION, TYPE E 36-INCH DIAMETER	FOOT	29								13	16		
88030020	SIGNAL HEAD, LED, 1-FACE, 3-SECTION, MAST-ARM MOUNTED	EACH	16								8	8		
88030050	SIGNAL HEAD, LED, 1-FACE, 3-SECTION, BRACKET MOUNTED	EACH	8								4	4		
00000000	GIGNAL TEAD, EED, 14 AGE, GOLGTION, BINGOLLI MOUNTED	LAGIT										<u> </u>		
88030070	SIGNAL HEAD, LED, 1-FACE, 4-SECTION, BRACKET MOUNTED	EACH	3								1	2		
88030100	SIGNAL HEAD, LED, 1-FACE, 5-SECTION, BRACKET MOUNTED	EACH	2								1	1		
88030110	SIGNAL HEAD, LED, 1-FACE, 5-SECTION, MAST-ARM MOUNTED	EACH	2								1	1		
			İ											
88102717	PEDESTRIAN SIGNAL HEAD, LED, 1-FACE, BRACKET MOUNTED WITH COUNTDOWN TIMER	EACH	16								8	8		
88200410	TRAFFIC SIGNAL BACKPLATE, LOUVERED, FORMED PLASTIC	EACH	18								9	9		
88500100	INDUCTIVE LOOP DETECTOR	EACH	15								8	7		
00000400	DETECTOR LOOP TYPE I	FOOT	500								000	204		
88600100	DETECTOR LOOP, TYPE I	FOOT	526								262	264		
89000100	TEMPORARY TRAFFIC SIGNAL INSTALLATION	EACH	2								1	1		
89501400	RELOCATE EXISTING EMERGENCY VEHICLE PRIORITY SYSTEM, DETECTOR UNIT	EACH	4										4	
89501410	RELOCATE EXISTING EMERGENCY VEHICLE PRIORITY SYSTEM, PHASING UNIT	EACH	2										2	
89502300	REMOVE ELECTRIC CABLE FROM CONDUIT	FOOT	16,392							14,742				1,650
						1					1			

USER NAME = AVILAC	DESIGNED	-	CMA	REVISED	-
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PLOT DATE = 1/29/2024	DATE	-		REVISED	-

			RICHA	RDS ST	REET		F.A.U. RTE.	SECTION	N	COUNTY	SHEETS	SHEET NO.
			SUMMARY	OF OII	ANTITIES		354	99-4B-2-B	3R	WILL	320	21
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	SCALE:	SHEET	OF	SHEETS	STA.	TO STA.		ILLII	INOIS FED.	AID PROJECT		i

TRAFFIC SIGNALS

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			1 1		URBAN	SN 099-0123	SN 009-0057	SN 099-N1003	SN 099-N1004				1 1	
				0004	0004	0013	0013	0020	0020	0021	0021	0021	0021	0021
CODE NO.	ITEM DESCRIPTION	UNIT	TOTAL QUANTITY	80% FED 20% STATE	100% STATE	80% FED 20% STATE	90% FED 10% STATE	90% FED 10% STATE	90% FED 10% STATE	80% FED 20% STATE	80% FED 20% STATE	80% FED 20% STATE	100% JOLIET FIRE PROTECTION DISTRICT	80% FED 20% STATE
89502375	REMOVE EXISTING TRAFFIC SIGNAL EQUIPMENT	EACH	3								1	1		1
				  -										ı
89502380	REMOVE EXISTING HANDHOLE	EACH	19								9	10		
89502382	REMOVE EXISTING DOUBLE HANDHOLE	EACH	4								2	2		
89502385	REMOVE EXISTING CONCRETE FOUNDATION	EACH	20								10	10		
00002000														
E20210G1	VINE-PARTHENOCISSUS QUINQUEFOLIA ENGEL MANNII (ENGELMANNII VIRGINIA CREEPER), 1-GALLON POT	EACH	1,167	1,167										
K1003660	MOWING CYCLES	EACH	7	7										
K1004595	PRUNING FOR SAFETY AND EQUIPMENT CLEARANCE	LSUM	1	1										
X0301423	NOISE ABATEMENT WALL, GROUND MOUNTED	SQ FT	50,043					16,638	33,405					
X0324085	EMERGENCY VEHICLE PRIORITY SYSTEM LINE SENSOR CABLE, NO. 20 3/C	FOOT	881										881	
X0324599	RODAND CLEAN EXISTING CONDUIT	FOOT	100											100
X0325222	WEED CONTROL, BASAL TREATMENT	GALLON	5	5										
X0327120	WEED CONTROL, NATIVE LANDSCAPE ENHANCEMENT	ACRE	1.00	1.00										
			<del>                                     </del>											
X0327638	STREAM GAUGE	EACH	1			1								
X0328020	CENTRACS LICENSE EXPANSION	EACH	2											2
X1400102	OUTDOOR RATED NETWORK CABLE	FOOT	260								129	131		
X1400108	FULL-ACTUATED CONTROLLER AND TYPE SUPER R CABINET (SPECIAL)	EACH	2								1	1		
1		1	1			I	ı	I	1	1	I		1	

URBAN

ROADWAY

URBAN

ROADWAY

MAINTENANCE

URBAN

BRIDGE

REHAB

SN 099-0123

SN 099-0056

BRIDGE REPAIR | NOISE ABATMENT | NOISE ABATMENT |

WALL

WALL

SN 009-0057 SN 099-N1003 SN 099-N1004

HIGHWAY

LIGHTING

RICHARDS ST

EB RAMPS

 USER NAME
 = AVILAC
 DESIGNED
 CMA
 REVISED

 DRAWN
 FYW
 REVISED

 PLOT SCALE
 = 0.16666667 '/IN.
 CHECKED
 BRH
 REVISED

 PLOT DATE
 = 1/29/2024
 DATE
 REVISED

STATE OF ILLINOIS
DEPARTMENT OF TRANSPORTATION

TRAFFIC SIGNALS

RICHARDS ST

WB RAMPS

RICHARDS ST INTERCONNECT

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SYSTEMS\PW_LOCAL\TRANSYSTEMS-PW-01\DMS09883\62380-SHT-SOQ-19.DG	ı
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										TRAFFIC SIGNALS			
		URBAN	ROADWAY URBAN	ROADWAY MAINTENANCE URBAN	BRIDGE REHAB SN 099-0123	BRIDGE REPAIR SN 099-0056 SN 009-0057	NOISE ABATMENT WALL SN 099-N1003	NOISE ABATMENT WALL SN 099-N1004	HIGHWAY LIGHTING	RICHARDS ST EB RAMPS	RICHARDS ST WB RAMPS	RICHARDS ST EVP	INTERCONNECT
			0004	0004	0013	0013	0020	0020	0021	0021	0021	0021	0021
ITEM DESCRIPTION	UNIT	TOTAL QUANTITY	80% FED 20% STATE	100% STATE	80% FED 20% STATE	90% FED 10% STATE	90% FED 10% STATE	90% FED 10% STATE	80% FED 20% STATE	80% FED 20% STATE	80% FED 20% STATE	100% JOLIET FIRE PROTECTION DISTRICT	80% FED 20% STATE
SERVICE INSTALLATION, GROUND MOUNTED, METERED	EACH	2								1	1		
DEMOTE CONTROL FRANCES OVERTH	54011					1	1						
REMOTE CONTROLLED VIDEO SYSTEM	EACH	2								1	1		<u> </u>
LAYER II (DATALINK) SWITCH	EACH	2											2
TERMINATE FIBER IN CABINET	EACH	12											12
SPLICE FIBER IN CABINET	EACH	12											12
PEDESTRIAN SIGNAL POST, 10 FT.	EACH	6								3	3		
EIREPORTICINTERCONNECT CENTER 24 PORT	EACH												2
TIBEROF HORNEROUNEOF GENTER, 241 ORT	LAGIT												
TREE REMOVAL, ACRES (SPECIAL)	ACRE	1.00	1.00										
COFFERDAM (TYPE 1) (IN-STREAM/WETLAND WORK)	EACH	2	2										
REMOVE EXISTING FLARED END SECTION	EACH	2	2										
ABANDONAND FILL EXISTING STORM SEWER	FOOT	79	79										
PROPOSED STORM SEWER CONNECTION TO EXISTING MANHOLE	EACH	3	3										<u> </u>
MANHOLES, TYPE A, 6'-DIAMETER, WITH 2 TYPE 1 FRAME, CLOSED LID, RESTRICTOR PLATE	EACH	1	1										
MANHOLES, TYPE A, 7'-DIAMETER, WITH SPECIAL FRAME AND GRATE	EACH	1	1										
CATCH BASINS, TYPE A, 5'-DIAMETER, TYPE 22 FRAME AND GRATE (SPECIAL)	EACH	1	1										
CANITADY MANUAL EC TO DE AD ILICTED	FACU		-										
SANITAKT MANHULES TU BE AUJUSTED	EACH	3	3							1	1		
	SERVICE INSTALLATION, GROUND MOUNTED, METERED  REMOTE CONTROLLED VIDEO SYSTEM  LAYER II (DATALINK) SWITCH  TERMINATE FIBER IN CABINET  SPLICE FIBER IN CABINET  PEDESTRIAN SIGNAL POST, 10 FT.  FIBEROPTIC INTERCONNECT CENTER, 24 PORT  TREE REMOVAL, ACRES (SPECIAL)  COFFERDAM (TYPE 1) (IN-STREAM/WETLAND WORK)  REMOVE EXISTING FLARED END SECTION  ABANDONAND FILL EXISTING STORM SEWER  PROPOSED STORM SEWER CONNECTION TO EXISTING MANHOLE  MANHOLES, TYPE A, 6-DIAMETER, WITH 2 TYPE 1 FRAME, CLOSED LID, RESTRICTOR PLATE  MANHOLES, TYPE A, 7-DIAMETER, WITH SPECIAL FRAME AND GRATE	SERVICE INSTALLATION, GROUND MOUNTED, METERED  EACH  REMOTE CONTROLLED VIDEO SYSTEM  EACH  LAYER II (DATALINK) SWITCH  EACH  TERMINATE FIBER IN CABINET  EACH  SPLICE FIBER IN CABINET  EACH  PEDESTRIAN SIGNAL POST, 10 FT.  EACH  FIBER OPTIG INTERCONNECT CENTER, 24 PORT  EACH  TREE REMOVAL, ACRES (SPECIAL)  ACRE  COFFERDAM (TYPE 1) (IN-STREAM/WETLAND WORK)  EACH  REMOVE EXISTING FLARED END SECTION  EACH  ABANDON AND FILL EXISTING STORM SEWER  FOOT  PROPOSED STORM SEWER CONNECTION TO EXISTING MANHOLE  EACH  MANHOLES, TYPE A, 6-CHAMETER, WITH 2 TYPE 1 FRAME, CLOSED LID, RESTRICTOR PLATE  EACH  MANHOLES, TYPE A, 5-CHAMETER, WITH SPECIAL FRAME AND GRATE  EACH  CATCH BASINS, TYPE A, 5-CHAMETER, WITH SPECIAL FRAME AND GRATE (SPECIAL)  EACH  CATCH BASINS, TYPE A, 5-CHAMETER, WITH SPECIAL FRAME AND GRATE (SPECIAL)  EACH  CATCH BASINS, TYPE A, 5-CHAMETER, WITH SPECIAL FRAME AND GRATE (SPECIAL)  EACH	SERVICE INSTALLATION, GROUND MOUNTED, METERED  SERVICE INSTALLATION, GROUND MOUNTED, METERED  EACH 2  REMOTE CONTROLLED VIDEO SYSTEM  EACH 2  LAYER II (DATALINK) SWITCH  EACH 2  TERMINATE FIBER IN CABINET  EACH 12  SPLICE FIBER IN CABINET  EACH 12  PEDESTRIAN SIGNAL POST, 10 FT.  EACH 6  FIBEROPTIC INTERCONNECT CENTER, 24 PORT  TREE REMOVAL, ACRES (SPECIAL)  ACRE 1.00  COPFERDAM (TYPE 1) (IN-STREAMWETLAND WORK)  EACH 2  REMOVE EXISTING FLARED END SECTION  ABANDON AND FILL EXISTING STORM SEWER  PROPOSED STORM SEWER CONNECTION TO EXISTING MANHOLE  MANHOLES, TYPE A, 6-DIAMETER, WITH 2 TYPE 1 FRAME, CLOSED LID, RESTRICTOR PLATE  MANHOLES, TYPE A, 7-DIAMETER, WITH 2 PEZE FRAME AND GRATE (SPECIAL)  EACH 1  MANHOLES, TYPE A, 7-DIAMETER, WITH 5 PECIAL FRAME AND GRATE (SPECIAL)  EACH 1  CATCH BASINS, TYPE A, 5-DIAMETER, WITH 5 PECIAL FRAME AND GRATE (SPECIAL)  EACH 1  CATCH BASINS, TYPE A, 5-DIAMETER, WITH 5 PECIAL FRAME AND GRATE (SPECIAL)  EACH 1  CATCH BASINS, TYPE A, 5-DIAMETER, WITH 5 PECIAL FRAME AND GRATE (SPECIAL)  EACH 1  CATCH BASINS, TYPE A, 5-DIAMETER, WITH 5 PECIAL FRAME AND GRATE (SPECIAL)  EACH 1  CATCH BASINS, TYPE A, 5-DIAMETER, TYPE 22 FRAME AND GRATE (SPECIAL)  EACH 1  CATCH BASINS, TYPE A, 5-DIAMETER, TYPE 22 FRAME AND GRATE (SPECIAL)  EACH 1	LINEAR DESCRIPTION	TITEM DESCRIPTION	Part   Part   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			RICHA	RDS ST	REET		F.A.U. RTE.	SECTION		COUNTY	SHEETS	NO.
			SUMMARY	OF OIL	ANTITIES		354	99-4B-2-BR		WILL	320	23
Ų			JOHNNAIN	01 40	ANTITIES					CONTRACT	NO 623	380
	SCALE:	SHEET	SHEET OF SHEETS STA. TO STA.					) ILLINO	S FED. AI	D PROJECT		

TRAFFIC SIGNALS

	00-20	
	TRANSYSTEMS\PW_LOCAL\TRANSYSTEMS-PW-01\DMS09883\62380-SHT-SOQ-20	
	2380-	
	MS09883\6	
	MS09	
	S-PW-01\D	
	MS-PV	
	SYSTEM	
	AL\TRANS	
	OCAL\	
	PW_LO	
	TEMS	
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				0004	0004	0013	0013	0020	0020	0021	0021	0021	0021	0021
CODE NO.	ITEM DESCRIPTION	UNIT	TOTAL QUANTITY	80% FED 20% STATE	100% STATE	80% FED 20% STATE	90% FED 10% STATE	90% FED 10% STATE	90% FED 10% STATE	80% FED 20% STATE	80% FED 20% STATE	80% FED 20% STATE	100% JOLIET FIRE PROTECTION DISTRICT	80% FED 20% STATE
X6330103	REMOVE AND RE-ERECT TRAFFIC BARRIER TERMINAL, TYPE 1 SPECIAL, TANGENT	EACH	1	1										
X6700410	ENGINEER'S FIELD OFFICE, TYPE A (SPECIAL)	CAL MO	23	23					1		l			
V704004C	TRAFFICOCOUTROL AND DECEMENTAL (OPERIAL)	1.000												<u> </u>
X7010216	TRAFFICCONTROLAND PROTECTION, (SPECIAL)	L SUM	1	1										
X7011015	TRAFFIC CONTROL AND PROTECTION (EXPRESSWAYS)	L SUM	1	1										
X7013820	TRAFFIC CONTROL SURVEILLANCE, EXPRESSWAYS	CAL DA	548	548										
V7020050	DAVISED DESI FOTIVE DAVISMENT MARKED DESI FOTOD DEMOVAL	FACIL	90											<u> </u>
X7830050	RAISED REFLECTIVE PAVEMENT MARKER, REFLECTOR REMOVAL	EACH	80	80										
X7830052	RAISED REFLECTIVE PAVEMENT MARKER, REFLECTOR REPLACEMENT	EACH	130	130										
		İ												
X8250091	COMBINATION LIGHTING CONTROLLER	EACH	2							2				
X8620200	LININTERDUDTARI E DOMER CURRI V CRECIAL	EACH									1	1		<u> </u>
A8620200	UNINTERRUPTABLE POWER SUPPLY, SPECIAL	EACH	2								'	'		<u> </u>
X8710029	FIBER OPTIC CABLE 24 FIBERS, SINGLE MODE	FOOT	826											826
X8760200	ACCESSIBLE PEDESTRIAN SIGNALS	EACH	16								8	8		
V0700040	CONSISTS FOUND AT OUR A 40 MOUNTED	FOOT									40	40		
X8780012	CONCRETE FOUNDATION, TYPEA 12-INCH DIAMETER	FOOT	24								12	12		
X8860107	PREFORMED DETECTOR LOOP	FOOT	583								328	255		
X8040108	ELECTRIC METER	EACH	2								1	1		
70004005	STRUCTURAL STEEL REDAIR	BOLIND	2 200				2 200							<u> </u>
Z0001905	STRUCTURAL STEEL REPAIR	POUND	2,280				2,280							
Z0004552	APPROACH SLAB REMOVAL	SQYD	318	318										

ROADWAY MAINTENANCE URBAN

URBAN

ROADWAY

URBAN

BRIDGE REHAB SN 099-0123

SN 099-0056 SN 009-0057

BRIDGE REPAIR NOISE ABATMENT NOISE ABATMENT WALL WALL

SN 099-N1003

SN 099-N1004

USER NAME = AVILAC

REVISED -

DESIGNED - CMA

١			RICHA	RDS ST	REET		F.A.U. RTE.	SECT	TION		COUNTY	SHEETS	NO.
-			SUMMARY	OF OIL	ANTITIES		354	99-4B	-2-BR		WILL	320	24
١			SOMMAN	01 40	ANTITIES						CONTRACT	NO 62	380
	SCALE: SHEET OF SHEETS			STA.	TO STA.			ILLINOIS	FED. AII	PROJECT			

TRAFFIC SIGNALS

RICHARDS ST WB RAMPS

RICHARDS ST INTERCONNECT EVP

RICHARDS ST EB RAMPS

HIGHWAY

LIGHTING

				URBAN	ROADWAY URBAN	ROADWAY MAINTENANCE URBAN	BRIDGE REHAB SN 099-0123	BRIDGE REPAIR NOISE ABATMEN SN 099-0056 WALL SN 009-0057 SN 099-N1003	WALL	HIGHWAY LIGHTING	RICHARDS ST EB RAMPS	RICHARDS ST WB RAMPS	RICHARDS ST EVP	INTERCONNECT
					0004	0004	0013	0013 0020	0020	0021	0021	0021	0021	0021
	CODE NO.	ITEM DESCRIPTION	UNIT	TOTAL QUANTITY	80% FED 20% STATE	100% STATE	80% FED 20% STATE	90% FED 90% FED 10% STATE 10% STATE	90% FED 10% STATE	80% FED 20% STATE	80% FED 20% STATE	80% FED 20% STATE	100% JOLIET FIRE PROTECTION DISTRICT	80% FED 20% STATE
	Z0012754	STRUCTURAL REPAIR OF CONCRETE (DEPTH EQUAL TO OR LESS THAN 5 INCHES)	SQ FT	328			328							
	Z0013797	STABILIZED CONSTRUCTION ENTRANCE	SQYD	915	915									
	Z0013798	CONSTRUCTION LAYOUT	LSUM	1	1									
	Z0018004	DRAINAGE SCUPPERS, DS-12	EACH	11			11							
	Z0022800	FENCE REMOVAL	FOOT	4,404	4,404									
*	Z0030850	TEMPORARY INFORMATION SIGNING	SQ FT	729	729									
*	Z0033020	LUMINAIRE SAFETY CABLE ASSEMBLY	EACH	31						31				
*	Z0033028	MAINTENANCE OF LIGHTING SYSTEM	CAL MO	18						18				
*	Z0033056	OPTIMIZE TRAFFIC SIGNAL SYSTEM	EACH	1										1
*	Z0062456	TEMPORARY PAVEMENT	SQ YD	359	359									
	Z0073345	SLEEPERSLAB	FOOT	451	451									
*	Z0073510	TEMPORARY TRAFFIC SIGNAL TIMING	EACH	9	7						1	1		
Ø	Z0076600	TRAINEES	HOUR	2,000	2,000									
Ø	Z0076604	TRAINEES - TRAINING PROGRAM GRADUATE	HOUR	2,000	2,000									
			İ								İ			

NAME: C:\TRANSYSTEMS\PW\_LOCAL\

\* SPECIALTY ITEM Ø 0042

Ø 0042

TOTAL SHEET NO.

USER NAME = AVILAC	DESIGNED	-	CMA	REVISED	-
	DRAWN	-	CMA	REVISED	-
PLOT SCALE = 0.16666667 ' / IN.	CHECKED	-	BRH	REVISED	-
PLOT DATE = 1/29/2024	DATE	-		REVISED	-

STATE OF ILLINOIS DEPARTMENT OF TRANSPORTATION

SCALE:

RICHARDS STREET						SECTION	COUNTY	SHEETS	NO.
	SUMMARY	UE UII	ANTITIES		354	99-4B-2-BR	WILL	320	25
	JUMINATI	01 40	ANTITIES				CONTRACT	NO 623	380
SHEET	OF	SHEETS	STA.	TO STA.		ILLINOIS FED. AI	D PROJECT		

TRAFFIC SIGNALS

### SCHEDULE OF QUANTITIES

20101000	TEMPORA	RY FENCE			TOTAL	116	FOOT
	FROM	TO	TREE	LENGTH PER TREE		SUE	BTOTALS
LOCATION	STA.	STA.	EACH	FOOT			
RICHARDS ST	49+91,38		1	10			10
	50+05.48		1	10			10
	50+36.46		1	10			10
5TH AVE	102+13.13		1	10			10
RAMP A	112+16.50	112+92.38					75.8

30300112	AGGREGATE SUBG	GRADE IMPRO	OVEMENT 12"	TOTAL	17,186	SQ YD
		AREA			SUB <sup>.</sup>	TOTALS
LOCATION		SQ FT				
HMA PAVEMENT S	SUBTOTAL	11155.6	(40701896 + 40604060 LINDEN ST)		11,	155.6
PCC PAVEMENT 9	" JOINTED SUBTOTAL	2540.0			2,	540.0
PCC SHOULDER 9	" TIED SUBTOTAL	368.0				368.0
CONC MEDIAN, TY	Y SM-6.12 SUBTOTAL	308.0				308.0
CONC MEDIAN SU	IRFACE, 4" SUBTOTAL	222.8				222.8
CC C & G, TY B-6.	12 SUBTOTAL	135.8	(LINDEN ST ONLY)			135.8
CC C & G, TY B-6.	24 SUBTOTAL	1716.5			1,	,716.5
CC C & G, TY B-9.	24 SUBTOTAL	86.1				86.1
1' EXTENSION AR	EA AT THE EDGE	653.3				653.3

31102100	SUBBASE GRANUL	AR MATERIAL, TYPE C 4"	TOTAL	633	SQ YD
		AREA		SUE	BTOTALS
LOCATION		SQ YD			
PCC SHOULDER 9'	'TIED SUBTOTAL	368			368.0
CURB AREA ALONG	G RAMPS SUBTOTAL	264.8			264.8

31200100	STABILIZED SUE	BBASE 4"			TOTAL	183	SQ YD
	FROM	TO	OFFSET	AREA		SUI	BTOTALS
LOCATION	STA.	STA.	LT/RT	SQ FT			
RICHARDS ST	47+54,24	48+25,00	LT/RT	507.1			56.3
RICHARDS ST	48+25.00	50+00.00	LT/RT	1137.5			126.4

31200500	STABILIZED SUBBASE - HO	OT-MIX ASPHALT, 4"	TOTAL	2 727 SO VD
	AR	EA	TOTAL	50BTOTALS
LOCATION	SQ	YD		
PCC PAVEMENT 9	' JOINTED SUBTOTAL 25	40		2,540.0
1' EXTENSION AR	EA 180	6.8		186.8

35101800	AGGREGATE BAS	AGGREGATE BASE COURSE, TYPE B 6"					SQ YD
	FROM	TO	OFFSET	AREA		SUI	BTOTALS
LOCATION	STA.	STA.	LT/RT	SQ YD			
RICHARDS ST	61+83.14	64+53.80	RT	311.6			311.6

40600982	HOT-MIX ASPHAL	T SURFACE REM	JOINT	TOTAL	38	SQ YD	
	FROM	TO	OFFSET	AREA		SU	BTOTALS
LOCATION	STA.	STA.	LT/RT	SQ FT			
5TH AVE	101+42,42	101+85.51	LT	21.1			21.1
5TH AVE	102+06.19	102+10.69	LT/RT	17.1			17.1

40604060	HOT-MIX ASP	HALT SURFAC	"D", N50	TOTAL	55	TON		
	FROM	ТО	AREA	AREA	THICKNESS		SUE	TOTALS
LOCATION	STA.	STA.	SQ FT	SQ YD	IN			
RICHARDS ST	61+83.14	64+53.80	2804.3	311.6	1.5			26.2
LINDEN ST	102+00.00	109+73.16	3083.5	342.6	1.5			28.8

40701896	HOT-MIX ASPHAI	T PAVEMENT (F	ULL-DEPTH), 10 3/4"	TOTAL	10,813	SQ YD
	FROM	TO			SUB	TOTALS
LOCATION	STA.	STA.				
RICHARDS ST	50+00,00	59+00.00			5,	,699,8
RICHARDS ST	59+00.00	64+48.13			3,	,608.3
RICHARDS ST	67+02,00	68+35.00			1,	,505.0

42000080	PAVEMENT CONF	NECTOR (PCC) FO	OR BR <b>I</b> DGE API	PROACH SLAB	TOTAL	330	SQ YD
	FROM	TO	OFFSET			SUB	TOTALS
LOCATION	STA.	STA.	SQ FT				
RICHARDS ST	64+45.16	64+54.38	LT/RT				68.6
RICHARDS ST	66+41.22	67+02.00	LT/RT				261.8

42000401	PORTLAND CEME	NT CONCRETE PA	VEMENT 9" (JOINTED)	TOTAL	2,540	SQ YD
	FROM	TO			SUB	TOTALS
LOCATION	STA.	STA.				
RAMP A	112+50.00	114+20.44				822.4
RAMP B	10+29,54	12+04.00				712.8
RAMP C	113+49.99	114+80.03				538.6
RAMP D	4+38.73	5+51.42				466.7

42400200	PORTLAND CEME	NT CONCRETE S	IDEWALK 5 INCH	TOTAL	15,506	SQ FT
	FROM	TO	OFFSET		SUBT	OTALS
LOCATION	STA,	STA,	LT/RT			
RICHARDS ST	50+00.00	54+77.24	LT		2,:	399.9
RICHARDS ST	50+00.00	54+83.87	RT		2,	452.2
RICHARDS ST	55+51.81	59+00.00	LT		2,	003.2
RICHARDS ST	55+66.45	59+00.00	RT		1,	898.3
RICHARDS ST	59+00,00	61+05.95	LT		1,	087.8
RICHARDS ST	59+00.00	61+19.78	RT		1,	167.3
RICHARDS ST	61+83.04	64+62.34	LT		1,	346.8
RICHARDS ST	66+46.51	68+35.00	RT			653.2
RICHARDS ST	66+89.51	67+09.65	LT		1,	077.9
RICHARDS ST	SIDEWALKS ON	ISLANDS	RT/LT		!	561.4
RICHARDS ST	47+66.33	47+86.33	LT			143.1
RICHARDS ST	47+82.56	48+02.56	RT			147.5
5TH AVE	101+83.68	102+16.02	RT			377.7
5TH AVE	102+02.19	102 + 18.53	LT			190.1
1						

44000100	PAVEMENT REMO	VAL			TOTAL	15,516 SQ Y	′D
	FROM	TO	OFFSET	AREA		SUBTOTA	LS
LOCATION	STA.	STA.	LT/RT	SQ FT			
RICHARDS ST	50+00.00	59+00.00	LT/RT	72681		8,076	
RICHARDS ST	59+00.00	64+67.30	LT/RT	47622			)
RICHARDS ST	66+68.83	68+35.00	LT/RT	16279		1,809	n
LINDEN AVE	102+00.00	109+73.16	RT	3066.0		· ·	
						34:	1

44000157	HOT-MIX ASPHAL	HOT-MIX ASPHALT SURFACE REMOVAL, 2"					SQ YD
	FROM	TO	OFFSET	AREA		SUE	BTOTALS
LOCATION	STA,	STA.	LT/RT	SQ FT			
5TH AVE	101+41.34	102+06.19	LT/RT	3591.5			399.1

44000200	DRIVEWAY PAVE	MENT REMOVAL			TOTAL	44	SQ YD
	FROM	TO	OFFSET	AREA		SUE	BTOTALS
LOCATION	STA.	STA.	LT/RT	SQ FT			
RICHARDS ST	67+80.62	68+25,63	RT	398			44

44000500	COMBINATION CU	DD AND CUTTED	DEMOVAL			
44000300				TOTAL	7,012	FOOT
	FROM	TO	OFFSET		SUB	TOTALS
LOCATION	STA.	STA.	LT/RT			
RICHARDS ST	50+00,00	55+43.78	LT			634.9
RICHARDS ST	55+45.21	59+00.00	LT			405.6
RICHARDS ST	50+00.00	55+20.00	RT			556.4
RICHARDS ST	55+45,21	59+00.00	RT			401.9
RICHARDS ST	59+00.00	61+21.08	LT			280.9
RICHARDS ST	61+53.66	64+96.11	LT			346.9
RICHARDS ST	59+00.00	61+27.66	RT			271.4
RICHARDS ST	61+32.84	64+82.56	RT			428.2
RICHARDS ST	66+20.00	68+35.00	RT			212.3
5TH AVE	100+00.00	101+43.24	LT			170.3
5TH AVE	101+84.71	102+06.62	LT			58.9
5TH AVE	101+06.14	101+41.62	RT			84.8
MEDIAN	47+54.24	55+40.78	LT/RT		1	,577.8
MEDIAN	61+24.98	64+96.11	LT/RT			729.6
MEDIAN	67+66.99	68+35.00	LT/RT			158.2
RAMP A ISLAND	54+51.29	55+16.10	LT			163.7
RAMP B ISLAND	54+80.19	55+38.71	RT			185.1
RAMP C ISLAND	61+47.60	62+09.24	RT			162.6
RAMP D ISLAND	61+34.32	61+86.17	LT			182.6

44000600	SIDEWALK REMO	VAL		TOTAL	15,613	SQ FT
	FROM	TO	OFFSET		SUB	TOTALS
LOCATION	STA.	STA.	LT/RT			
RICHARDS ST	50+00.00	54+77.24	LT		2,	,295.0
RICHARDS ST	50+00.00	54+83.87	RT		2,	,304.7
RICHARDS ST	55+51.81	59+00.00	LT		1,	,667.0
RICHARDS ST	55+66,45	59+00.00	RT		1,	,642,8
RICHARDS ST	59+00.00	61+05.95	LT		1,	,046.2
RICHARDS ST	59+00.00	61+19.78	RT		1,	,120.2
RICHARDS ST	61+83.04	64+62.34	LT		1,	,500.0
RICHARDS ST	61+84.09	64+82.66	RT		1,	,562.2
RICHARDS ST	66+89.51	67+09.65	LT			881.9
RICHARDS ST SB	66+46.51	68+35.00	RT			847.7
RICHARDS ST NB	47+66.33	47+86.33	LT			90.5
RICHARDS ST NB	47+82.56	48+02.56	RT			95.6
5TH AVE	101+83.68	102+16.02	RT			380.0
5TH AVE	102+02.19	102+18.53	LT			179.3

44003100	MEDIAN REMOVAL			TOTAL	21,960	SQ FT
	FROM	TO	OFFSET		SUB	TOTALS
LOCATION	STA.	STA.	LT/RT			
RICHARDS ST	47+54.24	55+40.78	LT/RT		10,	,772.5
RAMP A ISLAND	54+51.29	55+16.10	LT			680.6
RAMP B ISLAND	54+80.19	55+38,71	RT		1,	,010,5
RICHARDS ST	56+06.57	59+00.00	LT/RT		1,	,504.2
RICHARDS ST	59+00.00	60+75.55	LT/RT			912.3
RAMP C ISLAND	61+47.60	62+09.24	RT			798.3
RAMP D ISLAND	61+34.32	61+86.17	LT			812.5
RICHARDS ST	61+24.98	64+96.11	LT/RT		4,	617.9
RICHARDS ST	66+41.30	66+68.83	LT/RT			84.8
RICHARDS ST	67+66.99	68+35.00	LT/RT			766.4

44004250	PAVED SHOULDE	R REMOVAL			TOTAL	363	SQ YD
	FROM	TO	OFFSET	AREA		SUE	TOTALS
LOCATION	STA.	STA.	LT/RT	SQ FT			
RAMP A	112+50.00	113+70.48	LT	853.6			94.8
RAMP A	112+50.00	113+43.02	RT	697.6			77.5
RAMP B	11+30.23	12+04.00	LT	458.1			50.9
RAMP B	11+30.00	12+04.00	RT	444.0			49.3
RAMP C	113+50.00	114+28.49	LT	280.9			31.2
RAMP C RAMP D	113+50,00	114+06.27	RT	215.8			24.0
RAMP D	05+12.92	05+51.42	LT	276.1			30.7
NAME D	05+40.47	05+51.42	RT	43.5			4.8

48101498	AGGREGATE SHO	DULDERS, TYPE E	3 4"	TOTAL	832	SQ YD
	FROM	TO	OFFSET		SUE	STOTALS
LOCATION	STA.	STA.	LT/RT			
RAMP B NAW 30	10+00.00	19+89,90	RT			831,9

USER NAME = SUIC	DESIGNED - CMA	REVISED -
	DRAWN - FYW	REVISED -
PLOT SCALE = 0.16666667 / IN.	CHECKED - BRH	REVISED -
PLOT DATE = 1/26/2024	DATE -	REVISED -

STATE	: OF	ILLINOIS
DEPARTMENT	OF	TRANSPORTATION

SHEET

RICH	ARDS ST	REET		F.A.U. RTE.	SECTION		COUNTY	TOTAL SHEETS	SHEET NO.
SCHEDUL	F OF OIL	ANTITIES		354	99-4B-2-BR		WILL	320	26
SUILDUL	L 01 Q0	AIVITILO					CONTRACT	NO. 62	380
OF	SHEETS	STA	TO STA.		ILLINOIS	EED AL	D DDOIECT		

### SCHEDULE OF QUANTITIES

48101610	AGGREGATE SHO	ULDERS, TYPE B	9"		TOTAL	71	SQ YD
	FROM	TO	OFFSET	AREA		SU	BTOTALS
LOCATION	STA.	STA.	LT/RT	SQ FT			
RAMP B	11+19.43	12+04.00	LT	176.6			19.6
RAMP B	11+36.22	12+04.00	RT	169.1			18.8
RAMP C	113+50.00	114+25,81	LT	150.8			16.8
RAMP D	05+36.13	05+51.42	LT	29.2			3.2
RAMP D	04+97.64	05+51.42	RT	116.4			12.9

48300400	PORTLAND CEME	NT CONCRETE S	HOULDERS 9	9"	TOTAL	368	SQ YD
	FROM	TO	OFFSET	AREA		SUE	STOTALS
LOCATION	STA.	STA.	LT/RT	SQ YD			
RAMP A	112+50.00	113+22.43	LT	66.4			66.4
RAMP A	112+50.00	113+67.82	RT	101.9			101.9
RAMP B	11+35.60	12+04.00	LT	29,6			29.6
KAMP D	10+83.66	12+04.00	RT	74.8			74.8
RAMP B	113+50.00	114+31.42	LT	35.4			35.4
RAMP C	113+50.00	113+97.83	RT	16.6			16.6
RAMP C	05+36.13	05+51,42	LT	5.8			5.8
RAMP D	04+97.64	05+51.42	RT	37.1			37.1
RAMP D							

60602800	CONCRETE GUTT	CONCRETE GUTTER, TYPE B				1,062	FOOT
	FROM	TO	OFFSET			SUB	TOTALS
LOCATION	STA.	STA.	LT/RT				
RAMP B NAW 30	10+00.00	19+88.90	RT			1	,061.7

60603800	COMBINATION CO	COMBINATION CONCRETE CURB AND GUTTER, TYPE B-6.12				FOOT
	FROM	FROM TO OFFSET			SUE	TOTALS
LOCATION	STA.	STA.	LT/RT			
RICHARDS ST	67+75	68+35	LT			65.5
RICHARDS ST	67+75	68+35	RT			58.1
5TH AVE	101+19.71	101+43.07	LT			43.9
5TH AVE	101+33,27	101+41,60	RT			8.4
LINDEN ST	102+00	109+73.55	LT		772.0	

60605000 COMBINATION CONCRETE CURB AND GUTTER, TYPE B-6.24				TOTAL	5,981 FOOT	
	FROM	TO	OFFSET			SUBTOTALS
LOCATION	STA.	STA.	LT/RT			
RICHARDS ST	48+25.03	55+36,54	LT	(Median)		1,140.3
RICHARDS ST	48+25.03	55+36.54	RT	(Median)		711.6
RICHARDS ST	50+00.00	54+21.65	LT			421.6
RICHARDS ST	50+00.00	54+25.00	RT			425.5
RICHARDS ST	55+96.28	57+75.00	LT			220.7
RICHARDS ST	55+62.07	57+85.00	RT			214.5
RICHARDS ST	59+40.00	61+06.84	LT			177.8
RICHARDS ST	59+50.00	61+16.26	RT			183.2
RICHARDS ST	61+30.49	64+54.38	LT			214.1
RICHARDS ST	61+29.66	64+54.38	LT	(Median)		326.6
RICHARDS ST	61+29.66	64+54.38	RT	(Median)		336.0
RICHARDS ST	62+47.84	64+54.38	RT			216.2
RICHARDS ST	66+53.72	68+35.00	LT			182.9
RAMP A	112+50.00	114+46.81	LT			155.4
RAMP A	112+50.00	114+00.00	RT			218.5
RAMP B	10+13.40	12+04.00	LT			204.6
RAMP B	10+82.72	12+04.00	RT			67.7
RAMP C	114+25.00	114+73.26	LT			47.5
RAMP C	113+50.00	115+03.28	RT			187.7
RAMP D	4+25.74	4+97.64	LT			63,8
RAMP D	4+83.74	5+36.13	RT			84.5
5TH AVE	100+20.63	101+43.07	LT			101.7
	101+06.06	101+41.60	RT			78.5

60605900	COMBINATION C	COMBINATION CONCRETE CURB AND GUTTER, TYPE B-9.1					FOOT
	FROM	FROM TO OFFSET			SUE	TOTALS	
LOCATION	STA.	STA.	LT/RT				
RICHARDS ST	57+75.00	59+25.00	LT				150
RICHARDS ST	57+85.00	59+35.00	RT				150

X2010350

RICHARDS SOUTH OF RAMP A
RICHARDS SOUTH OF RAMP B
RICHARDS NORTH OF RAMP C
RICHARDS SOUTH OF HICKORY CREEK
RICHARDS NORTH OF HICKORY CREEK
STH AVE AND RICHARDS SW CORNER

TREE REMOVAL, ACRES (SPECIAL)

OFFSET LT/RT

LT RT RT LT LT RT LT

AREA SQ FT 13656.4 4442.5 3569.5 12571.5 5631.2 4537.8

TOTAL 1.00 ACRE
SUBTOTALS

0.31 0.10 0.08 0.29 0.13 0.10

60618300	CONCRETE MEDI	IAN SURFACE, 4 <b>I</b>	NCH	TOTAL	2,005	SQ FT
	FROM	TO OFFSET			SUB	TOTALS
OCATION	STA.	STA.	LT/RT			
RAMP A ISLAND	54+90.40	55+16.23	LT			220.9
RAMP B ISLAND	55+91.16	55+33.89	RT			534.1
RAMP C ISLAND	61+44.46	61+67.32	RT			254.6
RAMP D ISLAND	61+37,71	61+72.75	LT			312.4
RICHARDS ST	67+75,00	68+35,00	LT/RT		68	

60620000	CONCRETE MED	CONCRETE MEDIAN, TYPE SB-6.24		317	SQ FT
	FROM	TO		SUE	TOTALS
LOCATION	STA.	STA.			
RICHARDS ST	47+54,24	48+25.03			317.0

60622800	CONCRETE MED	AN, TYPE SM-6.12	TOTAL	2,772	SQ FT	
	FROM	ТО		SUBTOTAL		
LOCATION	STA.	STA.				
RICHARDS ST	56+09.00	59+00.00		1,	,742.1	
RICHARDS ST	59+00.00	60+74.17		1,029.7		

63200310	GUARDRAIL REMO	OVAL		TOTAL	1,096	FOOT
	FROM TO		OFFSET		SUB	TOTALS
LOCATION	STA.	STA.	LT/RT			
RICHARDS ST	63+63.43	64+96.11	LT			109.9
RICHARDS ST	63+51.91	64+82.56	RT			140.2
RICHARDS ST	100+16.13	101+14.65	LT			105.4
RICHARDS ST	66+24.96	67+61.79	RT			138.8
LINDEN ST	104+36.24	110+00.00	RT			561.2
LINDEN ST	101+06.23	101+47.45	RT			40.7

66400305	CHAIN LINK FENCE,	6'		TOTAL 1,637 FOOT
	FROM	TO	OFFSET	SUBTOTALS
LOCATION	STA.	STA.	LT/RT	
RICHARDS ST	50+00.00	52+85.61	RT	290.1
RICHARDS ST	50+00.00	55+12.84	LT	613,1
RICHARDS ST	62+13.00	64+90.00	RT	344.5
RICHARDS ST	61+91.24	65+00.00	LT	368.1
RICHARDS ST	65+96.79	66+10.00	RT	15.5
RICHARDS ST	66+50.53	66+60.00	LT	6.1

66402700	CHAIN LINK GATES, 6' X 4' SINGLE			TOTAL	5	EACH
	FROM	TO	OFFSET		SU	BTOTALS
LOCATION	STA.	STA.	LT/RT			
RICHARDS ST	52+85.61		RT			1
RICHARDS ST	65+96.79		RT			1
RICHARDS ST	66+50,53		LT			1
LINDEN AVE	755+00.41		LT			1
RAMP B	19+90.00		LT			1

USER NAME = SUIC	DESIGNED - CMA	REVISED -
	DRAWN - FYW	REVISED -
PLOT SCALE = 0.16666667 / IN.	CHECKED - BRH	REVISED -
PLOT DATE = 1/26/2024	DATE -	REVISED -

STATE OF ILLINOIS **DEPARTMENT OF TRANSPORTATION** 

SCALE:

SHEET

RICHARDS STREET SCHEDULE OF QUANTITIES		F.A.U. RTE	SECTION		COUNTY	TOTAL SHEETS	SHEET NO.				
		354	99-4B-2-BR			WILL	320	27			
						CONTRACT	NO. 62	380			
OF	SHEETS	STA.	TO	O STA.			ILLINOIS	FED. AI	D PROIECT		

	EARTHWORK SUMMARY BY ROADWAY SEGMENT								
ROADWAY SEGMENT	EARTH EXCAVATION	ROCK EXCAVATION	EXCAVATION AVAILABLE FOR EMBANKMENT (SHRINKAGE - 15%)	EMBANKMENT	EARTHWORK WASTE (+) OR SHORTAGE (-)	TOPSOIL EXCAVATION (SEE NOTE 1)	TOPSOIL PLACEMENT	TOPSOIL WASTE (+) OR SHORTAGE (-)	
	(CU YD)	(CU YD)	(CU YD)	(CU YD)	(CU YD)	(CU YD)	(CU YD)	(CU YD)	
RICHARDS STREET	6157.2	715.9	5233.6	402.8	4830.8	915.9	1036.0	-120.2	
RICHARDS STREET RAMP A	659.7	0.0	560.8	7.4	553.3	56.6	33.7	23.0	
RICHARDS STREET RAMP B	504.6	323.8	428.9	50.8	378.1	74.9	85.6	-10.6	
RICHARDS STREET RAMP C	506.9	11.1	430.9	238.7	192.3	464.6	251.7	212.9	
RICHARDS STREET RAMP D	179.6	0.0	152.6	12.6	140.1	35.9	8.7	27.2	
5TH AVE	348.2	0.0	296.0	9.6	286.4	26.4	16.0	10.4	
I-80	316.3	0.0	268.8	88.0	180.8	371.2	230.5	140.7	
RAMP C DETENTION BASIN	3640.3	854.8	3094.3	191.4	2902.9	491.2	294.9	196.3	
ROCK EX CONTINGENCY	0.0	1500.0	0.0	0.0	0.0	0.0	0.0	0.0	
GRAND TOTAL:	12312.9	3405.6	10465.9	1001.3	9464.7	2436.6	1956.9	479.7	

	EARTHWORK SUMMARY BY STAGE								
STAGE	EARTH EXCAVATION	ROCK EXCAVATION	EXCAVATION AVAILABLE FOR EMBANKMENT (SHRINKAGE - 15%)	EMBANKMENT	EARTHWORK WASTE (+) OR SHORTAGE (-)	TOPSOIL EXCAVATION (SEE NOTE 1)	TOPSOIL PLACEMENT	TOPSOIL WASTE (+) OR SHORTAGE (-)	
	(CU YD)	(CU YD)	(CU YD)	(CU YD)	(CU YD)	(CU YD)	(CU YD)	(CU YD)	
PRE-STAGE SUBTOTAL:	0.0	375.0	0.0	0.0	0.0	0.0	0.0	0.0	
STAGE 1 SUBTOTAL:	4346.0	643.2	3694.1	151.4	3542.7	633.7	410.4	223.3	
STAGE 2 SUBTOTAL:	7966.9	2012.4	6771.8	849.8	5922.0	1802.9	1546.6	256.4	
STAGE 3 SUBTOTAL:	0.0	375.0	0.0	0.0	0.0	0.0	0.0	0.0	

FURNISHED EXCAVATION = PRE-STAGE EW + STAGE 1 + STAGE 2 + STAGE 3 EW SHORTAGE + NON-SPECIAL WASTE (ESTIMATED)

	0.0	0.0	0.0	0.0	4405.0	=	4405.0	
--	-----	-----	-----	-----	--------	---	--------	--

TOPSOIL BALANCE = TOPSOIL EXCAVATION - TOPSOIL PLACEMENT

2436.6	1956.9	=	479.7
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### NOTES


1. "TOPSOIL EXCAVATION AND PLACEMENT" WILL BE MEASURED FOR PAYMENT BASED ON THE TOTAL VOLUME OF TOPSOIL EXCAVATED. THE CONTRACTOR SHALL REMOVE AND PROPERLY DISPOSE OF WASTE TOPSOIL FROM THE PROJECT SITE. THE COST TO REMOVE AND DISPOSE OF THIS MATERIAL SHALL BE INCLUDED IN THE BID UNIT PRICE PER CUBIC YARD FOR "TOPSOIL EXCAVATION AND PLACEMENT.

2. AS APPROVED BY THE ENGINEER, EXCAVATED TOPSOIL MAY BE STOCKPILED IN THE RICHARDS STREET RAMP INTERCHANGE INFIELD AREAS PRIOR TO FINAL PLACEMENT.

<b>*</b> ехр.
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USER NAME = SUIC	DESIGNED -	REVISED -
	DRAWN -	REVISED -
PLOT SCALE = 0.16666667 / IN.	CHECKED -	REVISED -
PLOT DATE = 1/25/2024	DATE -	REVISED -

	RICHA	ARDS ST	REET		F.A.U. RTE	SEC	TION		COUNTY	TOTAL SHEETS	SHEET NO.
EARTHWORK SUMMARY				354	99 <b>-</b> 4B	-2-BR		WILL	320	28	
	LAIIIIVV	OHK 301	VIIVIAIII						CONTRACT	NO. 62	380
SHEET	OF	SHEETS	STA.	TO STA.			ILLINOIS	FED. All	D PROJECT		

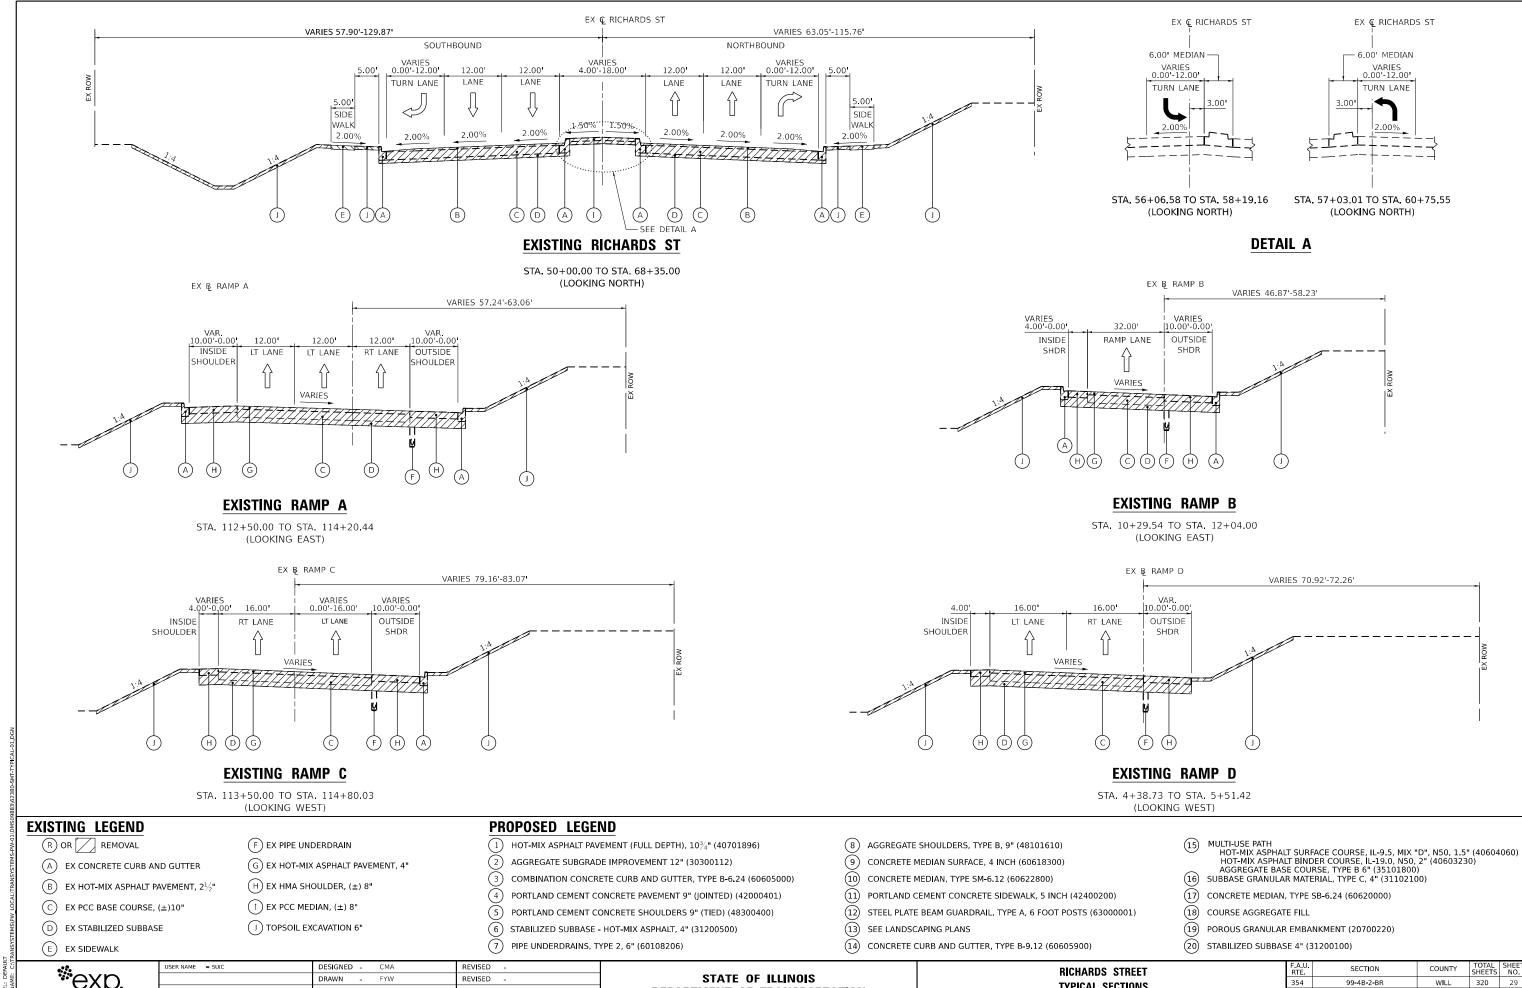

**DEPARTMENT OF TRANSPORTATION** 

TYPICAL SECTIONS

TO STA.

SCALE: N.T.S.


SHEET

CONTRACT NO. 62380

CHECKED -


PLOT DATE = 1/25/2024

REVISED

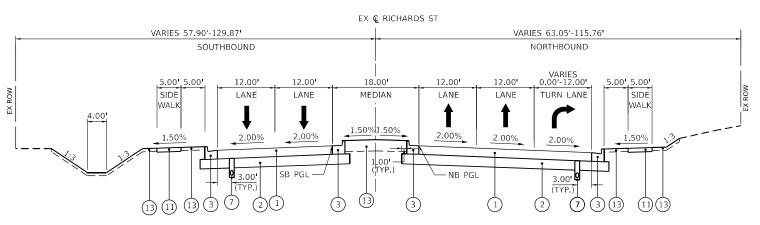


### PROPOSED RICHARDS ST

STA, 50+00.00 TO STA, 55+38.37 (LOOKING NORTH)

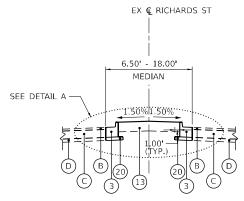


### PROPOSED RICHARDS ST


STA. 48+25.00 TO STA. 50+00.00 (LOOKING NORTH)

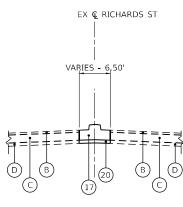

### **DETAIL A**

STA. 47+54.24 TO STA. 48+25.00 (LOOKING NORTH)

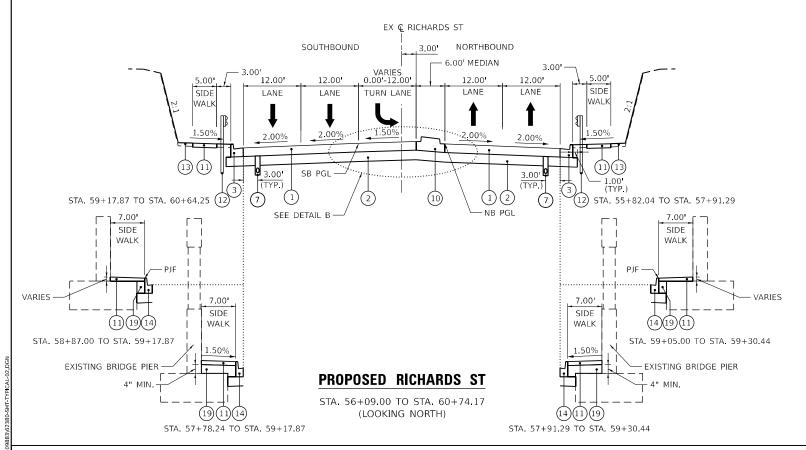

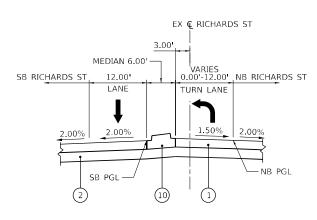

### **DETAIL B**

STA. 57+67.00 TO STA. 60+74.17 (LOOKING NORTH)

1. POROUS GRANULAR EMBANKMENT SHALL BE LIMITED TO FINE AGGREGATE PER ART. 1003.04 OF THE STANDARD SPECFICATIONS.

### **EXISTING LEGEND**

- R OR REMOVAL
- (A) EX CONCRETE CURB AND GUTTER
- B EX HOT-MIX ASPHALT PAVEMENT, 2½"
- © EX PCC BASE COURSE, (±)10"
- D EX STABILIZED SUBBASE
- E EX SIDEWALK

- (F) EX PIPE UNDERDRAIN
- G EX HOT-MIX ASPHALT PAVEMENT, 4"
- (H) EX HMA SHOULDER, (±) 8"
- (1) EX PCC MEDIAN,  $(\pm)$  8"
- ( ) TOPSOIL EXCAVATION 6"

### PROPOSED LEGEND

- 1) HOT-MIX ASPHALT PAVEMENT (FULL DEPTH), 10<sup>3</sup>/<sub>4</sub>" (40701896)
- AGGREGATE SUBGRADE IMPROVEMENT 12" (30300112)
- COMBINATION CONCRETE CURB AND GUTTER, TYPE B-6.24 (60605000)
- PORTLAND CEMENT CONCRETE PAVEMENT 9" (JOINTED) (42000401)
- PORTLAND CEMENT CONCRETE SHOULDERS 9" (TIED) (48300400)
- (6) STABILIZED SUBBASE - HOT-MIX ASPHALT, 4" (31200500)
- PIPE UNDERDRAINS, TYPE 2, 6" (60108206)

- (8) AGGREGATE SHOULDERS, TYPE B, 9" (48101610)
- CONCRETE MEDIAN SURFACE, 4 INCH (60618300)
- (10) CONCRETE MEDIAN, TYPE SM-6.12 (60622800)
- PORTLAND CEMENT CONCRETE SIDEWALK, 5 INCH (42400200)
- (12) STEEL PLATE BEAM GUARDRAIL, TYPE A, 6 FOOT POSTS (63000001)
- (13) SEE LANDSCAPING PLANS
- (14) CONCRETE CURB AND GUTTER, TYPE B-9.12 (60605900)

SCALE: N.T.S.

- - HOULT-USE PAIN
    HOT-MIX ASPHALT SURFACE COURSE, IL-9.5, MIX "D", N50, 1.5" (40604060)
    HOT-MIX ASPHALT BINDER COURSE, IL-19.0, N50, 2" (40603230)
    AGGREGATE BASE COURSE, TYPE B 6" (35101800)
    SUBBASE GRANULAR MATERIAL, TYPE C, 4" (31102100)
- CONCRETE MEDIAN, TYPE SB-6.24 (60620000)
- (18) COURSE AGGREGATE FILL
- (19) POROUS GRANULAR EMBANKMENT (20700220)
- (20) STABILIZED SUBBASE 4" (31200100)





USER NAME = SUIC	DESIGNED - CMA	REVISED -
	DRAWN - FYW	REVISED -
PLOT SCALE = 20.000 / IN	CHECKED - BRH	REVISED -
PLOT DATE = 1/25/2024	DATE -	REVISED -

STATE OF ILLINOIS **DEPARTMENT OF TRANSPORTATION** 

RICHARDS STREET						
	TVPI	CAL SECT	ONG		354	
		JAL GLUI	ONO			
SHEET	OF	SHEETS	STA.	TO STA.		

SECTION COUNTY 99-4B-2-BR WILL 320 CONTRACT NO. 62380

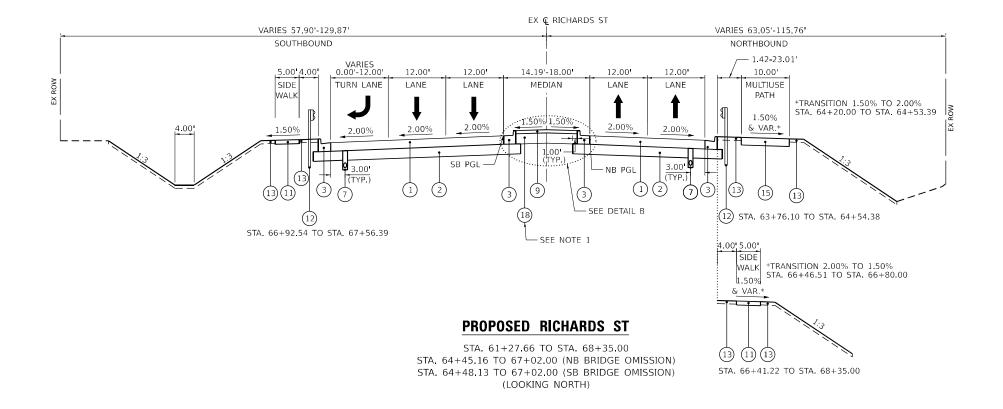

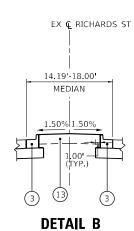

STA, 61+27,66 TO STA, 64+58,16 (LOOKING NORTH)

1. COARSE AGGREGATE FILL SHALL BE CONSTRUCTED IN ACCORDANCE WITH ART. 606.09 OF THE STANDARD SPECIFICATIONS. THE COST OF THIS WORK SHALL BE INCLUDED IN THE CONTRACT UNIT PRICE FOR CONCRETE MEDIAN SURFACE 4".

### **EXISTING LEGEND**

- R OR REMOVAL
- (A) EX CONCRETE CURB AND GUTTER
- B EX HOT-MIX ASPHALT PAVEMENT, 2½"
- © EX PCC BASE COURSE, (±)10"
- D EX STABILIZED SUBBASE
- E EX SIDEWALK

- F EX PIPE UNDERDRAIN
- G EX HOT-MIX ASPHALT PAVEMENT, 4"
- H EX HMA SHOULDER, (±) 8"
  - I EX PCC MEDIAN, (±) 8"
  - ( J ) TOPSOIL EXCAVATION 6"

### PROPOSED LEGEND

- 1) HOT-MIX ASPHALT PAVEMENT (FULL DEPTH), 10¾" (40701896)
- AGGREGATE SUBGRADE IMPROVEMENT 12" (30300112)
- COMBINATION CONCRETE CURB AND GUTTER, TYPE B-6.24 (60605000)
- PORTLAND CEMENT CONCRETE PAVEMENT 9" (JOINTED) (42000401)
- PORTLAND CEMENT CONCRETE SHOULDERS 9" (TIED) (48300400)
- (6) STABILIZED SUBBASE HOT-MIX ASPHALT, 4" (31200500)
- PIPE UNDERDRAINS, TYPE 2, 6" (60108206)

- (8) AGGREGATE SHOULDERS, TYPE B, 9" (48101610)
- CONCRETE MEDIAN SURFACE, 4 INCH (60618300)
- (10) CONCRETE MEDIAN, TYPE SM-6.12 (60622800)
- PORTLAND CEMENT CONCRETE SIDEWALK, 5 INCH (42400200)
- (12) STEEL PLATE BEAM GUARDRAIL, TYPE A, 6 FOOT POSTS (63000001)
- (13) SEE LANDSCAPING PLANS
- (14) CONCRETE CURB AND GUTTER, TYPE B-9.12 (60605900)

SCALE: N.T.S.

320

CONTRACT NO. 62380

- (17) CONCRETE MEDIAN, TYPE SB-6.24 (60620000)
- (18) COURSE AGGREGATE FILL
- (19) POROUS GRANULAR EMBANKMENT (20700220)
- (20) STABILIZED SUBBASE 4" (31200100)

TO STA.




USER NAME = SUIC	DESIGNED - CMA	REVISED -
	DRAWN - FYW	REVISED -
PLOT SCALE = 20.000 / IN	CHECKED - BRH	REVISED -
PLOT DATE = 1/25/2024	DATE -	REVISED -

STATE OF ILLINOIS **DEPARTMENT OF TRANSPORTATION** 


		ARDS ST		
SHEET	OF	SHEETS	STA.	

COUNTY 99-4B-2-BR WILL

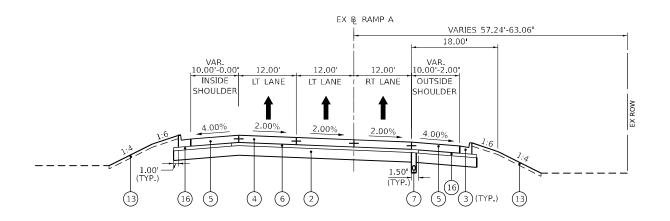

### PROPOSED RAMP A

STA. 112+50.00 TO STA. 114+20.44 (LOOKING EAST)

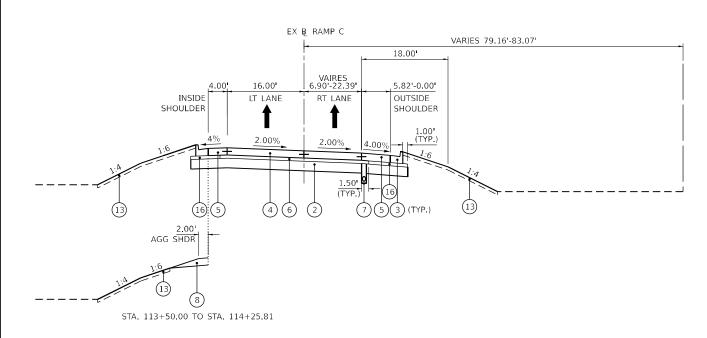

### VARIES 70.92'-72.26' 4.00'-0.00' 8.30'-0.00' INSIDE OUTSIDE 16.00'-VARIES SHOULDER SHOULDER RAMP LANE RAMP LANE VAR 2.00% 2.00 2.00'-3.76' AGG SHDR AGG SHDR

PROPOSED RAMP B

STA. 10+29.54 TO STA. 12+04.00

(LOOKING EAST)

EX & RAMP D

EX BE RAMP B

16 00'

RAMP LANE

18.00'

6.00'-0.00'

SHOULDER

(7)(5)(3) END STA. 11+55.00

OUTSIDE

46.87'-58.23'

### PROPOSED RAMP D

STA. 4+38.73 TO STA. 5+51.42 (LOOKING WEST)

## PROPOSED RAMP C

STA. 113+49.99 TO STA. 114+80.03 (LOOKING WEST)

### **EXISTING LEGEND**

- R OR REMOVAL
- (A) EX CONCRETE CURB AND GUTTER
- B EX HOT-MIX ASPHALT PAVEMENT, 2½"
- © EX PCC BASE COURSE, (±)10"
- D EX STABILIZED SUBBASE
- E EX SIDEWALK

- F EX PIPE UNDERDRAIN
- G EX HOT-MIX ASPHALT PAVEMENT, 4"
- H EX HMA SHOULDER, (±) 8"
- I EX PCC MEDIAN, (±) 8"
- ( ) TOPSOIL EXCAVATION 6"

### PROPOSED LEGEND

- 1) HOT-MIX ASPHALT PAVEMENT (FULL DEPTH), 10<sup>3</sup>/<sub>4</sub>" (40701896)
- AGGREGATE SUBGRADE IMPROVEMENT 12" (30300112)
- COMBINATION CONCRETE CURB AND GUTTER, TYPE B-6.24 (60605000)
- PORTLAND CEMENT CONCRETE PAVEMENT 9" (JOINTED) (42000401)
- PORTLAND CEMENT CONCRETE SHOULDERS 9" (TIED) (48300400)
- (6) STABILIZED SUBBASE HOT-MIX ASPHALT, 4" (31200500) PIPE UNDERDRAINS, TYPE 2, 6" (60108206)

(8) AGGREGATE SHOULDERS, TYPE B, 9" (48101610)

4.00'-2.58'

SHOULDER

INSIDE

16

STA. 11+78.13 TO STA. 12+04.00

2.00'-4.00' AGG SHDR

16.00'

RAMP LANE

CONCRETE MEDIAN SURFACE, 4 INCH (60618300)

STA. 5+36.13 TO STA. 5+51.42

- (10) CONCRETE MEDIAN, TYPE SM-6.12 (60622800)
- PORTLAND CEMENT CONCRETE SIDEWALK, 5 INCH (42400200)
- (12) STEEL PLATE BEAM GUARDRAIL, TYPE A, 6 FOOT POSTS (63000001)

SHEET

- (13) SEE LANDSCAPING PLANS
- (14) CONCRETE CURB AND GUTTER, TYPE B-9.12 (60605900)

SCALE: N.T.S.

STA. 4+97.99 TO STA. 5+51.42


- (15) MULTI-USE PATH
  HOT-MIX ASPHALT SURFACE COURSE, IL-9.5, MIX "D", N50, 1.5" (40604060)
  HOT-MIX ASPHALT BINDER COURSE, IL-19.0, N50, 2" (40603230)
  AGGREGATE BASE COURSE, TYPE B 6" (35101800)
  SUBBASE GRANULAR MATERIAL, TYPE C, 4" (31102100)
- (17) CONCRETE MEDIAN, TYPE SB-6.24 (60620000)
- (18) COURSE AGGREGATE FILL
- (19) POROUS GRANULAR EMBANKMENT (20700220)
- (20) STABILIZED SUBBASE 4" (31200100)

\*exp.

USER NAME = SUIC	DESIGNED - CMA	REVISED -
	DRAWN - FYW	REVISED -
PLOT SCALE = 20.000 / IN.	CHECKED - BRH	REVISED -
PLOT DATE = 1/25/2024	DATE -	REVISED -

STATE OF ILLINOIS **DEPARTMENT OF TRANSPORTATION**  RICHARDS STREET TYPICAL SECTIONS TO STA.

COUNTY 99-4B-2-BR WILL 320 CONTRACT NO. 62380

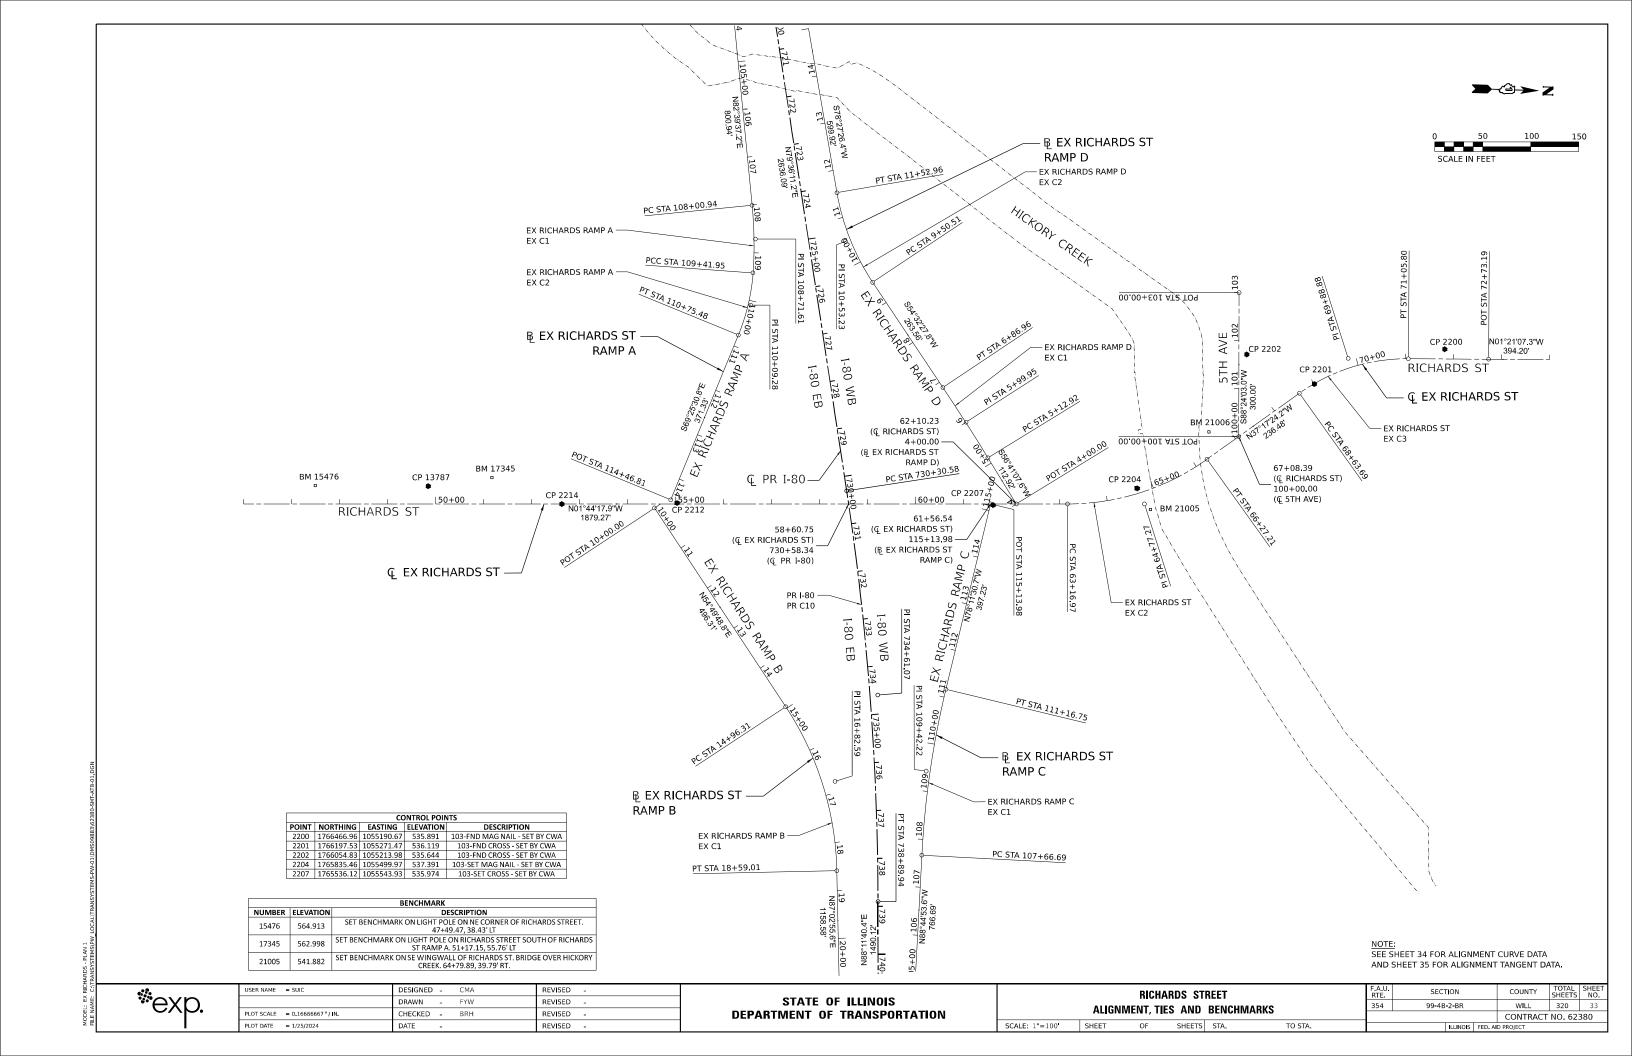

										ı	EXISTIN	IG CURV	E AND	COORE	INATE	DATA							
															DESIGN	F	C.	F	기	F	PT	С	C
BASELINE	CURVE	PC STA.	PI STA.	PT STA.		Delta		D	•	Т	L	R	е	S.E. RUN	SPEED	NORTH	EAST	NORTH	EAST	NORTH	EAST	NORTH	EAST
EX I-80	C7	646+90.94	650+09.78	653+22.76	18°	59' 25.	3° 3°	0'	20.5"	318.83	631.82	1,906.24				1764807.5720	1047263.2782	1764820.2780	1047581.8580	1764935.9621	1047878.9636	1766712.2977	1047187.3115
EX I-80	C8	656+24.66	663+29.24	669+74.51	40°	32' 56.	3° 3°	0'	14.4"	704.58	1,349.85	1,907.33				1765045.5025	1048160.2908	1765301.1490	1048816.8550	1765068.5702	1049481.9406	1763268.1511	1048852.3384
EX I-80	C9	683+90.00	688+56.23	693+01.53	29°	40' 17.	4" 3°	15'	18.4"	466.23	911.53	1,760.16				1764601.3205	1050818.0940	1764447.4200	1051258.1900	1764531.5585	1051716.7646	1766262.8189	1051399.1159
EX I-80	C10	731+71.69	736+02.18	740+31.06	8°	35' 27.	5" 1°	0'	0.0"	430.49	859.37	5,731.06				1765229.9900	1055523.3840	1765307.6790	1055946.8060	1765321.2420	1056377.0830	1759593.0270	1056557.6440
EX RICHARDS ST	C1	40+89.30	42+67.18	44+37.70	28°	31' 1.2	" 8°	11'	6.0"	177.89	348.40	700.00				1763481.0720	1055688,8980	1763634.7290	1055599,2690	1763812.5350	1055593.8730	1763833.7690	1056293.5500
EX RICHARDS ST	C2	63+16.97	64+77.27	66+27.21	35°	33' 7.2	" 11°	27'	32.4"	160.30	310.25	500.00				1765690.9380	1055536.8650	1765851.1650	1055532.0030	1765978.6960	1055434.8850	1765675.7710	1055037.0960
EX RICHARDS ST	C3	68+63.69	69+88.88	71+05.80	35°	56' 16.	3" 14°	50'	34.8"	125.19	242.11	386.00				1766166.8330	1055291.6150	1766266.4300	1055215.7690	1766391.5830	1055212.8160	1766400.6910	1055598.7080
EX RICHARDS RAMP A	C1	108+00.94	108+71.61	109+41.95	9°	41' 56.	1" 6°	52'	40.8"	70.67	141.01	833.00				1765015.0030	1054934.6790	1765024.0310	1055004.7740	1765021.1220	1055075.3880	1764188.8280	1055041.0960
EX RICHARDS RAMP A	C2	109+41.95	110+09.28	110+75.48	18°	12' 54.			31.2"	67.33	133.53	420.00				1765021.1220	1055075.3880	1765018.3500	1055142.6620	1764994.6880	1055205.6980	1764601.4780	1055058.0980
EX RICHARDS RAMP B	C1	14+96.31	16+82.59	18+59.01	32°	13' 8.4	" 8°	52'	58.8"	186.28	362.70	645.00				1765116.6960	1055977.0280	1765223.9950	1056129.3050	1765233.5860	1056315.3410	1764589.4410	1056348.5490
EX RICHARDS RAMP C	C1	107+66,69	109+42,22	111+16,75	10°	33' 21.	5" 3°	0'	57.6"	175,53	350.06	1,900.00				1765409.5490	1056277.8480	1765413,3830	1056102,3610	1765449,3030	1055930,5480	1767309.0950	1056319,3550

	PROPOSED CURVE AND COORDINATE DATA																		
											DESIGN	PC		PI		PT			C
BASELINE	CURVE	PC STA.	PI STA.	PT STA.	Delta	D	Т	L	R e	S.E. RU	N SPEED	NORTH	EAST	NORTH	EAST	NORTH	EAST	NORTH	EAST
PR I-80	C10	730+30.58	734+61.07	738+89.94	8° 35' 27.6"	1° 0.0' 0.0"	430.49	859.36	5,731.00 3.309	6 248	70	1765229.9910	1055523,3880	1765307.6790	1055946.8060	1765321.2420	1056377.0780	1759593.0870	1056557.6380

USER NAME = SUIC	DESIGNED - CMA	REVISED -
	DRAWN - FYW	REVISED -
PLOT SCALE = 0.16666667 '/IN.	CHECKED - BRH	REVISED -
PLOT DATE = 1/25/2024	DATE -	REVISED -

STATE OF ILLINOIS DEPARTMENT OF TRANSPORTATION

		RICH/	ARDS STI	REET		F.A.U RTE
		רוו	RVE DAT	٠,		354
		- 00	IIVE DAI	^		
SCALE: NTS	SHEET	OF	SHEETS	STA.	TO STA.	

COUNTY TOTAL SHEET NO.
WILL 320 34 SECTION 99-4B-2-BR CONTRACT NO. 62380

| ILLINOIS | FED. AID PROJECT

					EXISTING	G TANGE	NT ALIGNI	MENT DA	ATA					
			DESIGN							F	T	POT		
BASELINE	PT STA.	POT STA.	SPEED			BEARING			DISTANCE	NORTH	EAST	NORTH	EAST	
EX I-80	653+22.76	656+24.66	70	N	68°	43'	31.8"	E	301.90	1764935.9621	1047878.9636	1765045.5025	1048160.2908	
EX I-80	669+74.51	683+90.00	70	S	70°	43'	31.4"	E	1,415.50	1765068.5702	1049481.9406	1764601.3205	1050818.0940	
EX I-80	693+01.53	731+71.69	70	N	79°	36'	10.8"	E	3,870.16	1764531.5580	1051716.7650	1765229.9900	1055523.3840	
EX I-80	740+31.06	755+21.19	70	N	88°	11'	42.0"	E	1,490.14	1765321.2420	1056377.0830	1765321.2420	1056377.0830	
EX FIFTHAVE	100+00.00	103+00.00	25	S	88°	24'	3.6"	W	300.00	1766043.2790	1055385.7040	1766034.9070	1055085.8200	
EX RICHARDS ST	36+22.25	40+89.30	35	N	30°	15'	18.0"	W	467.05	1763077.6390	1055924.2220	1763481.0720	1055688.8980	
EX RICHARDS ST	44+37.70	63+16.97	35	N	1°	44'	16.8"	W	1,879.27	1763812.5350	1055593.8730	1765690.9380	1055536.8650	
EX RICHARDS ST	66+27.21	68+63.69	35	N	37°	17'	24.0"	W	236.48	1765978.6960	1055434.8850	1766166.8330	1055291.6150	
EX RICHARDS ST	71+05.80	75+00.00	35	N	1°	21'	7.2"	W	394.20	1766391.5830	1055212.8160	1766785.6690	1055203.5140	
EX RICHARDS RAMP A	100+00.00	108+00.94		N	82°	39'	36.0"	E	800.94	1764912,6810	1054140.3010	1765015.0030	1054934.6790	
EX RICHARDS RAMP A	110+75.48	114+46.81		S	69°	25'	30.0"	E	371.33	1764994.6880	1055205.6980	1764864.1910	1055553.3450	
EX RICHARDS RAMP B	10+00.00	14+96.31		N	54°	49'	48.0"	E	496.31	1764830.8200	1055571.3190	1765116.6960	1055977.0280	
EX RICHARDS RAMP B	18+59.01	30+17.58		N	87°	2'	56.4"	E	1,158.58	1765233.5860	1056315.3410	1765293.2360	1057472.3800	
EX RICHARDS RAMP C	100+00.00	107+66.69		N	88°	44'	52.8"	W	766.69	1765392.8000	1057044.3550	1765409.5490	1056277.8480	
EX RICHARDS RAMP C	111+16.75	115+13.98		N	78°	11'	31.2"	W	397.23	1765449.3030	1055930.5480	1765530.5890	1055541.7280	
EX RICHARDS RAMP D	4+00.00	5+12.92		S	56°	41'	6.0"	W	112.92	1765584.2550	1055540.1000	1765522.2330	1055445.7330	


	PROPOSED TANGENT ALIGNMENT DATA													
			DESIGN							Р	т	POT		
BASELINE	PT STA.	POT STA.	SPEED			BEARING			DISTANCE	NORTH	EAST	NORTH	EAST	
PR I-80	703+94.49	730+30.58	70	N	79°	36'	10.8"	E	2,636.09	1764754.2660	1052930.5750	1765229.9910	1055523.3880	
PR I-80	738+89.94	753+80.07	70	N	88°	11'	42"	Е	1,490.13	1765321.2420	1056377.0780	1765368.1890	1057866.4630	


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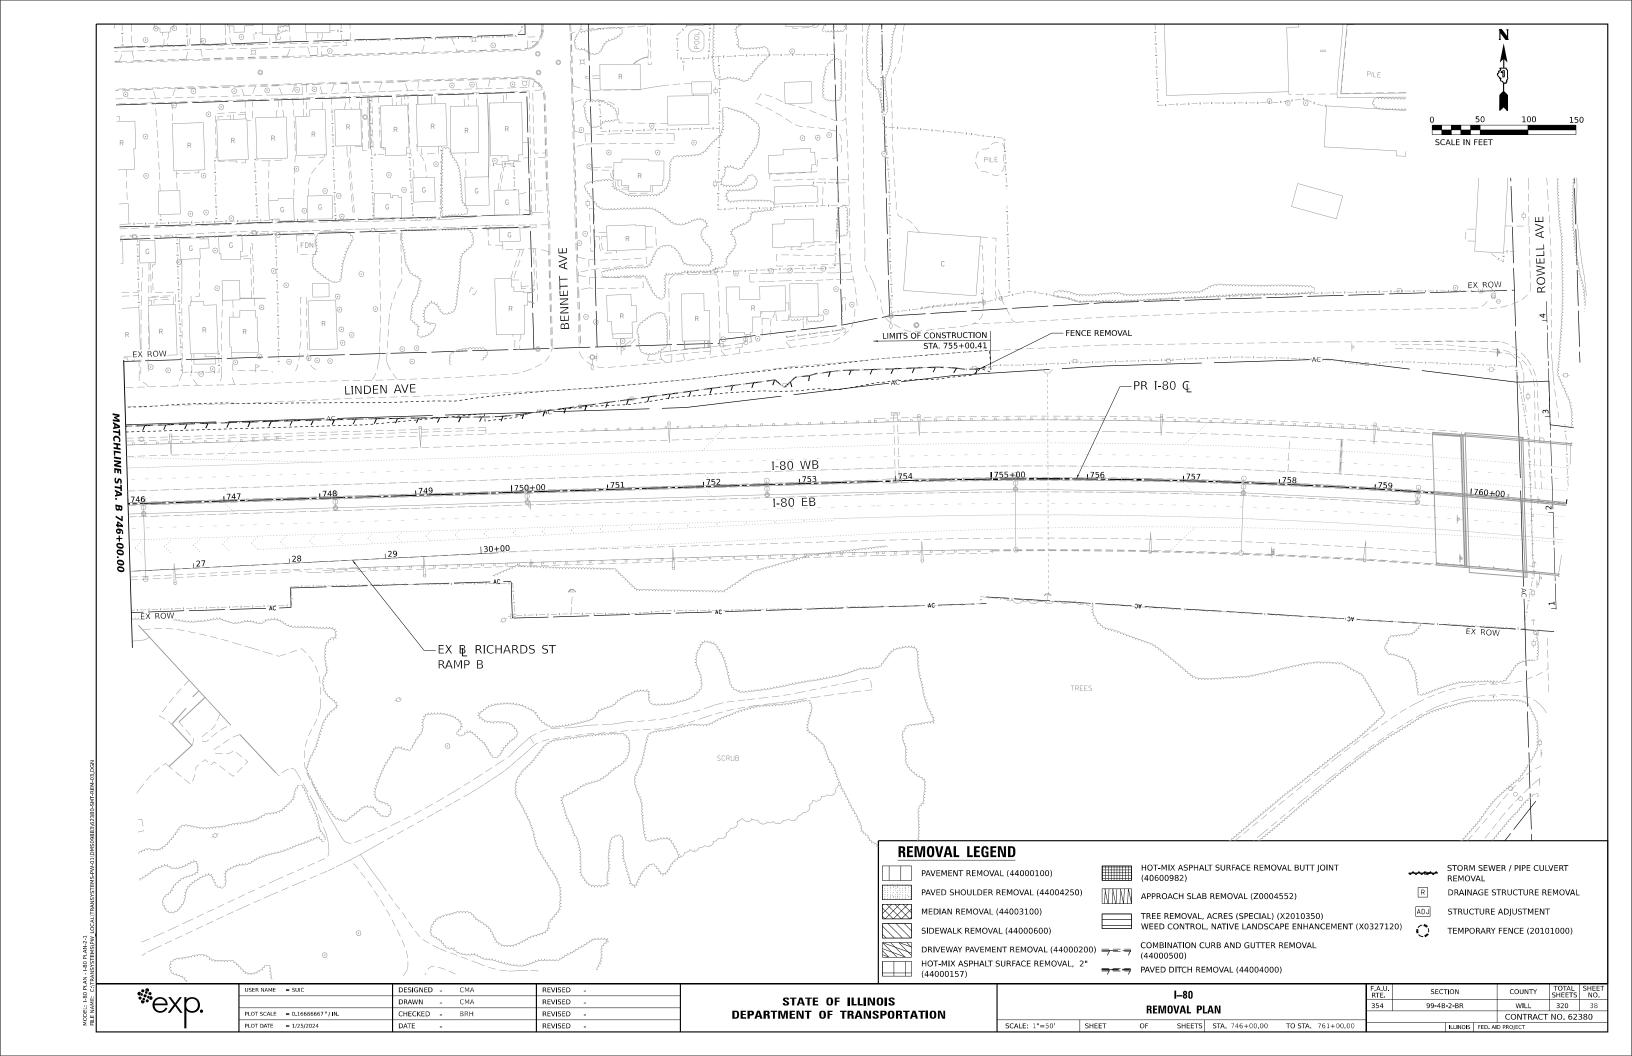
STATE OF ILLINOIS DEPARTMENT OF TRANSPORTATION


RICHARDS STREET TANGENT DATA SCALE: NTS SHEET OF SHEETS STA. TO STA. F.A.U. RTE. 354 COUNTY TOTAL SHEET NO.
WILL 320 35 SECTION COUNTY 99-4B-2-BR CONTRACT NO. 62380


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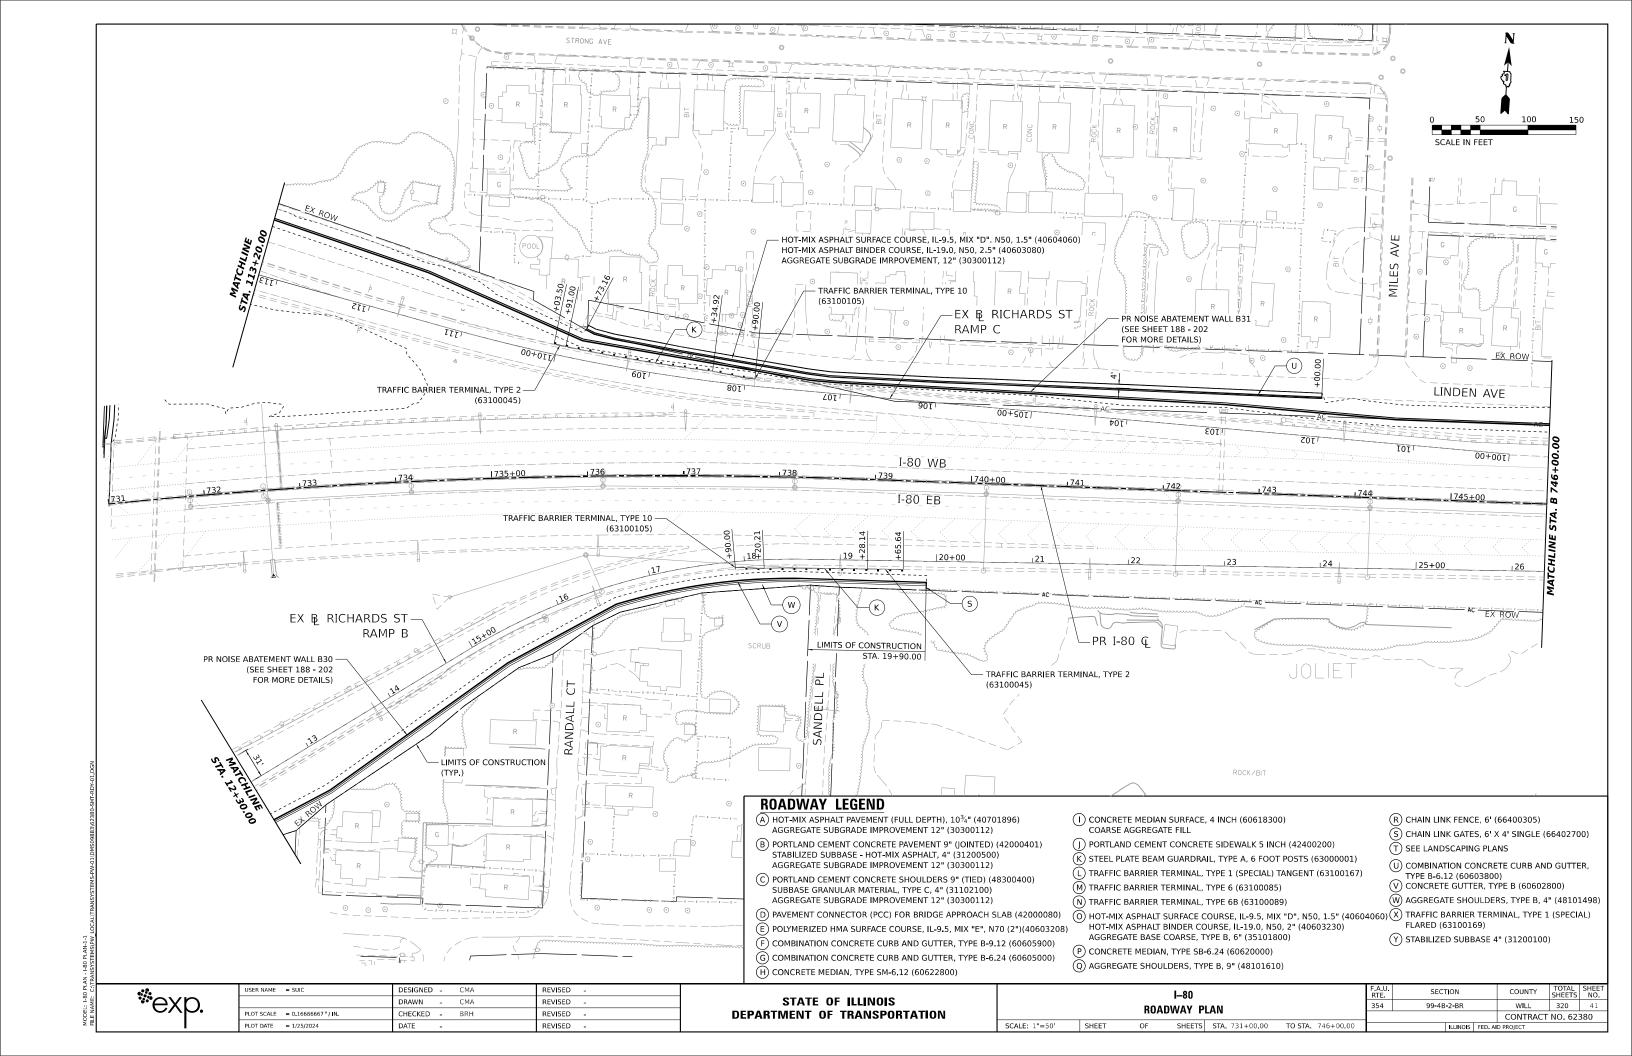





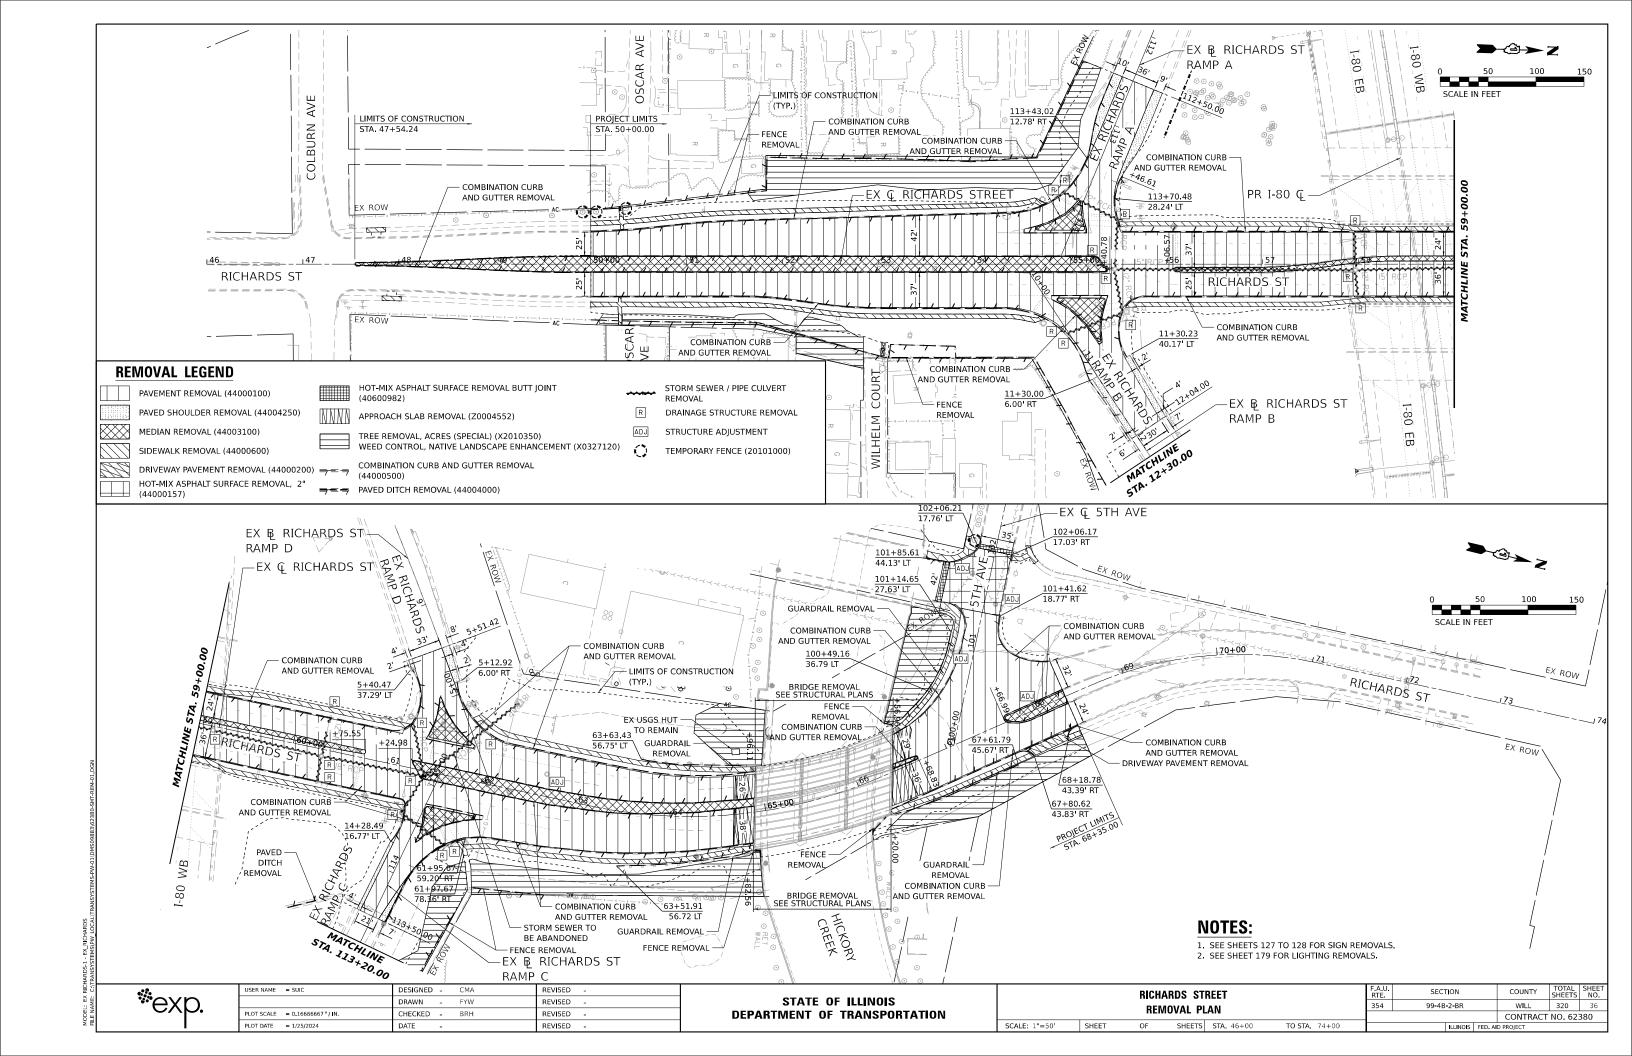


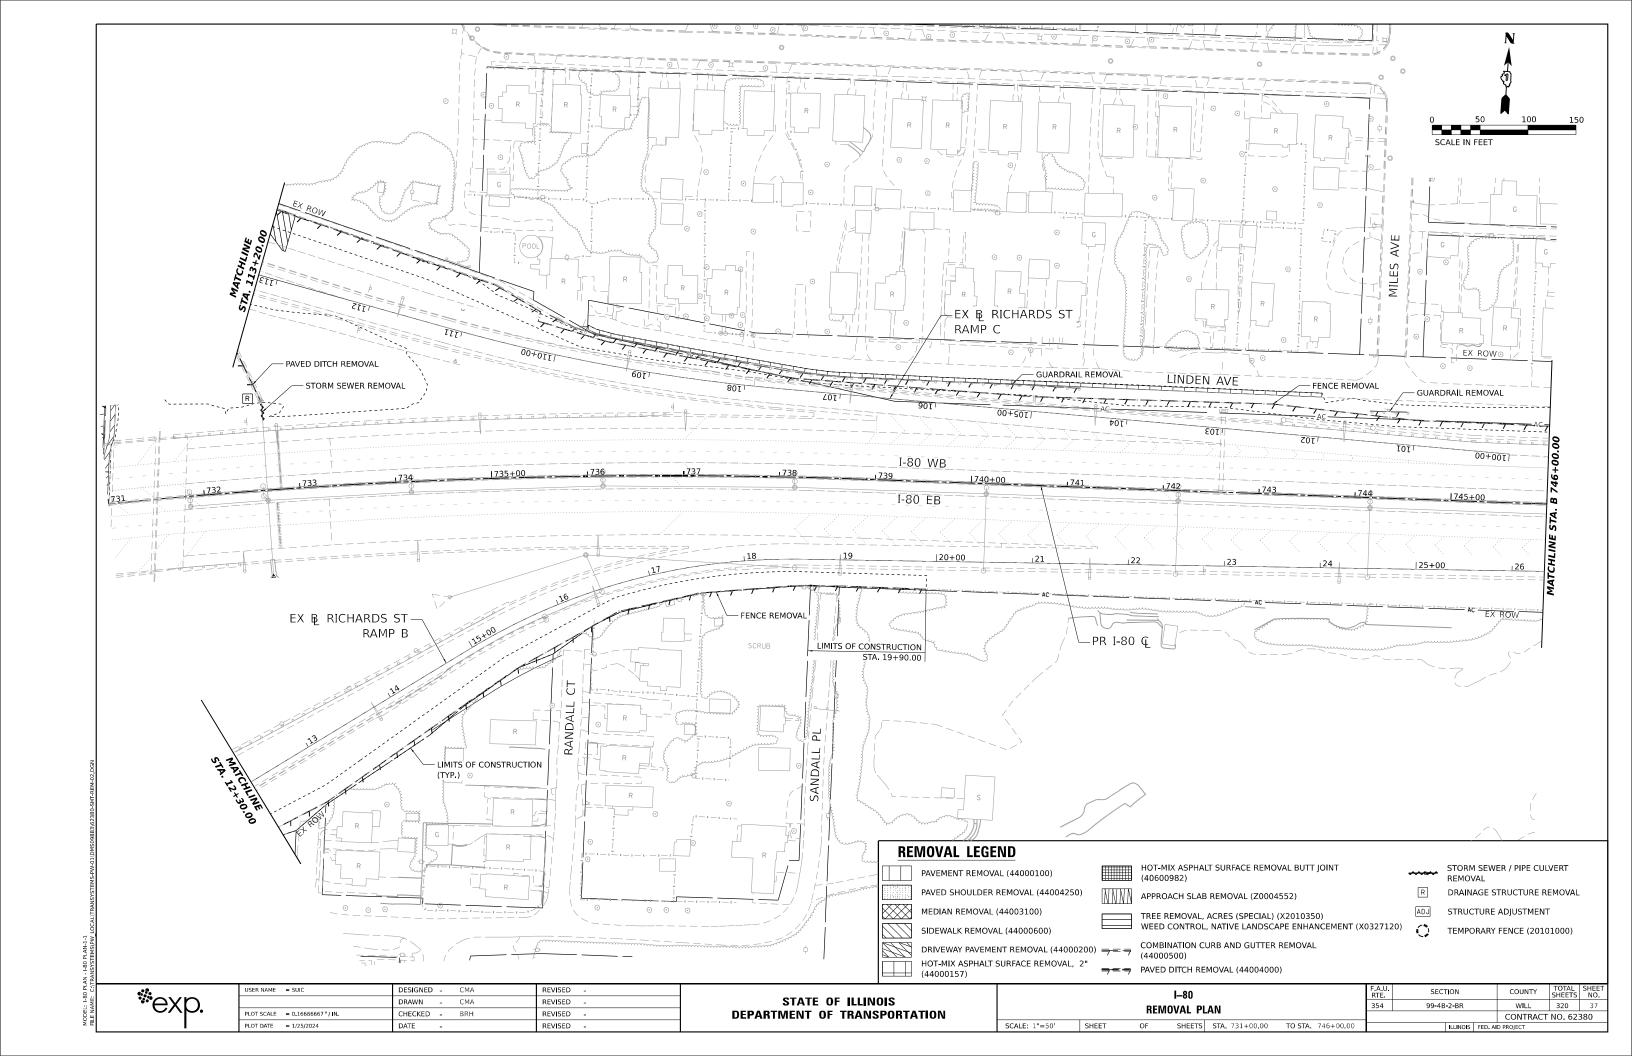


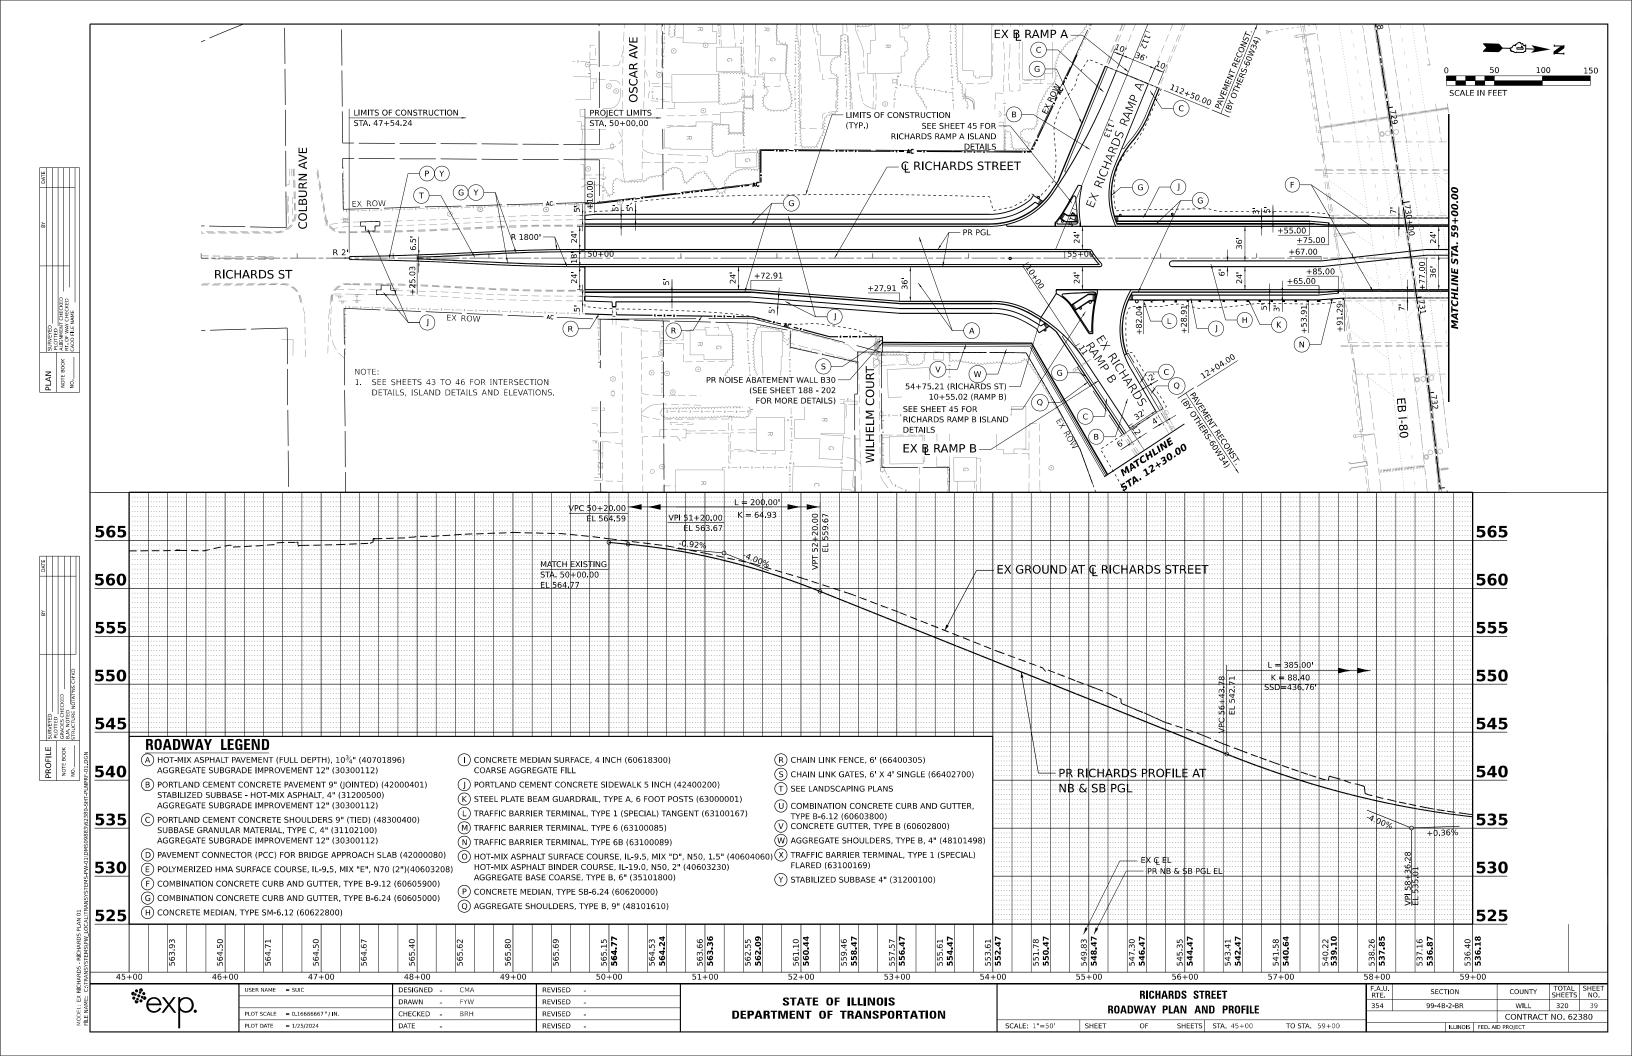

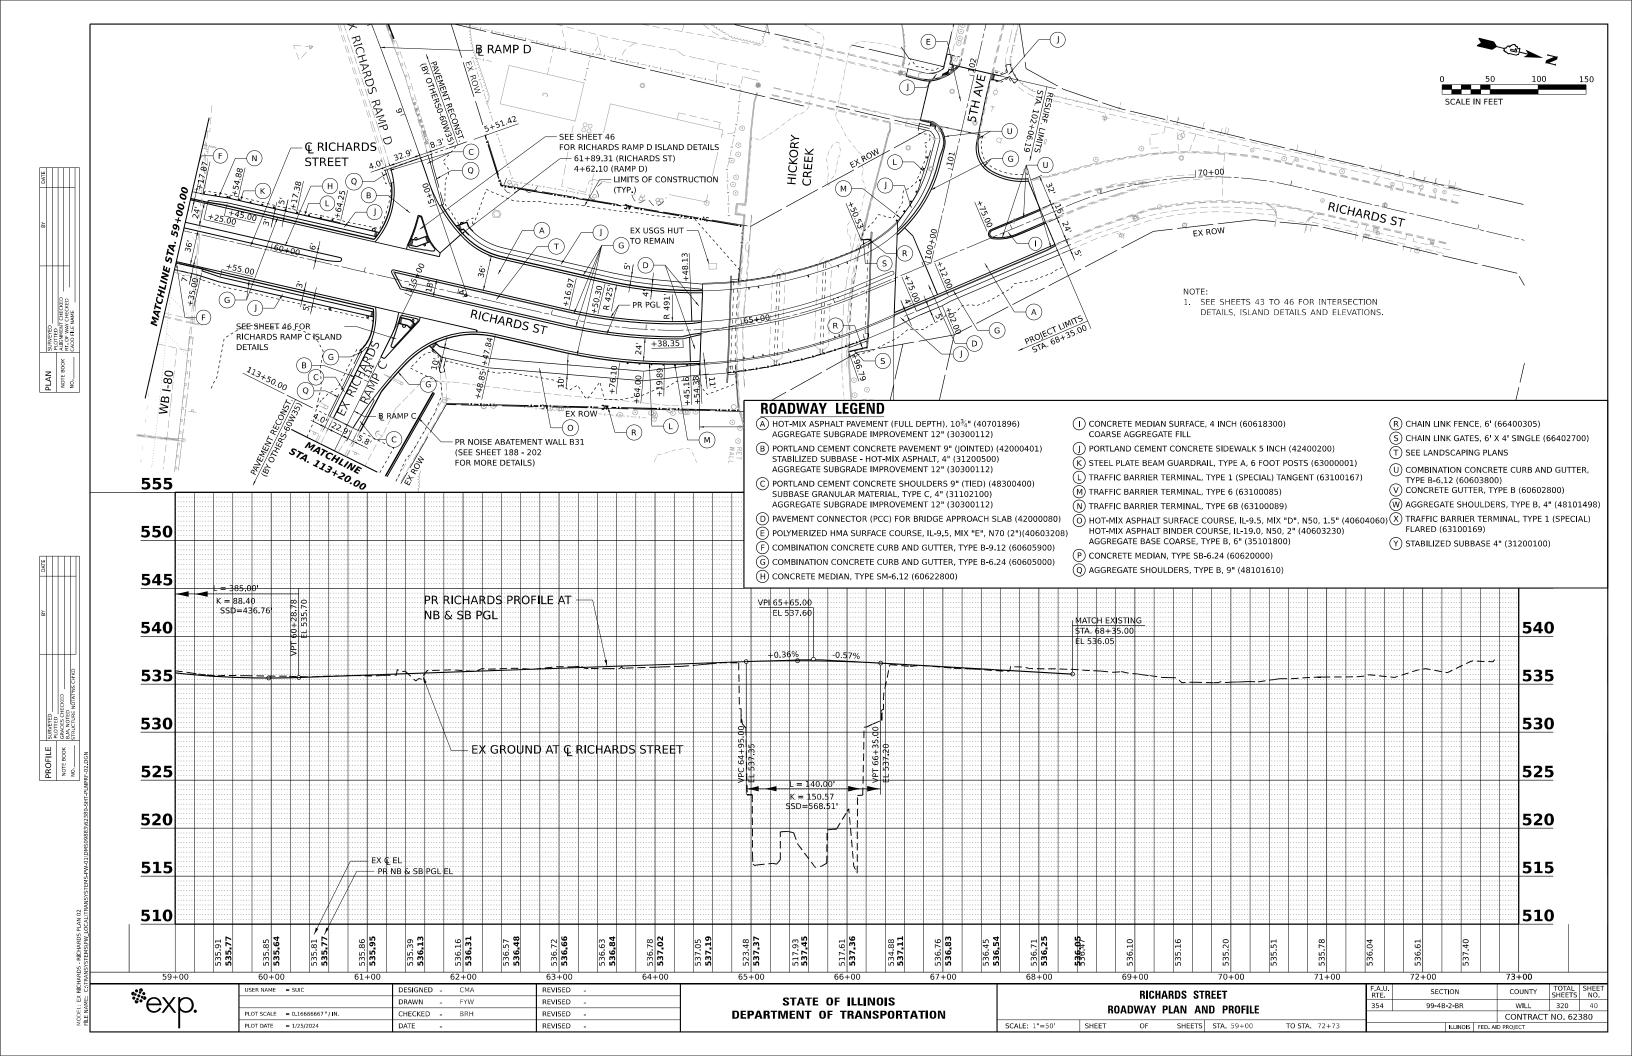

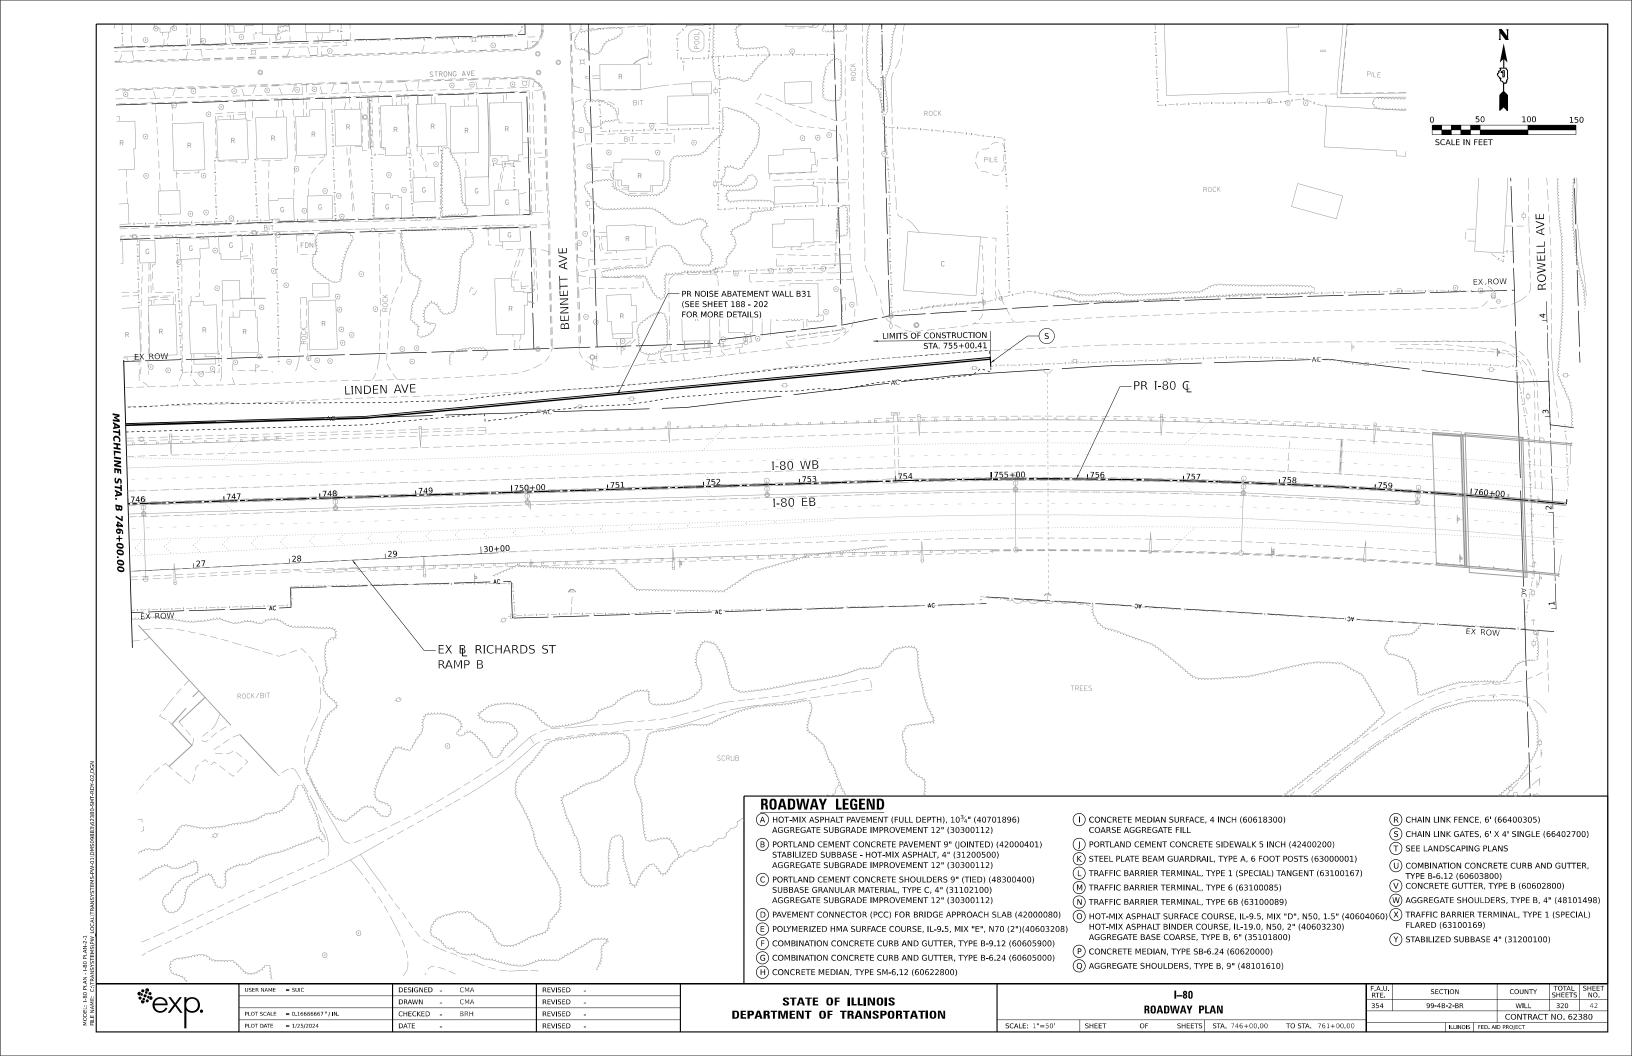


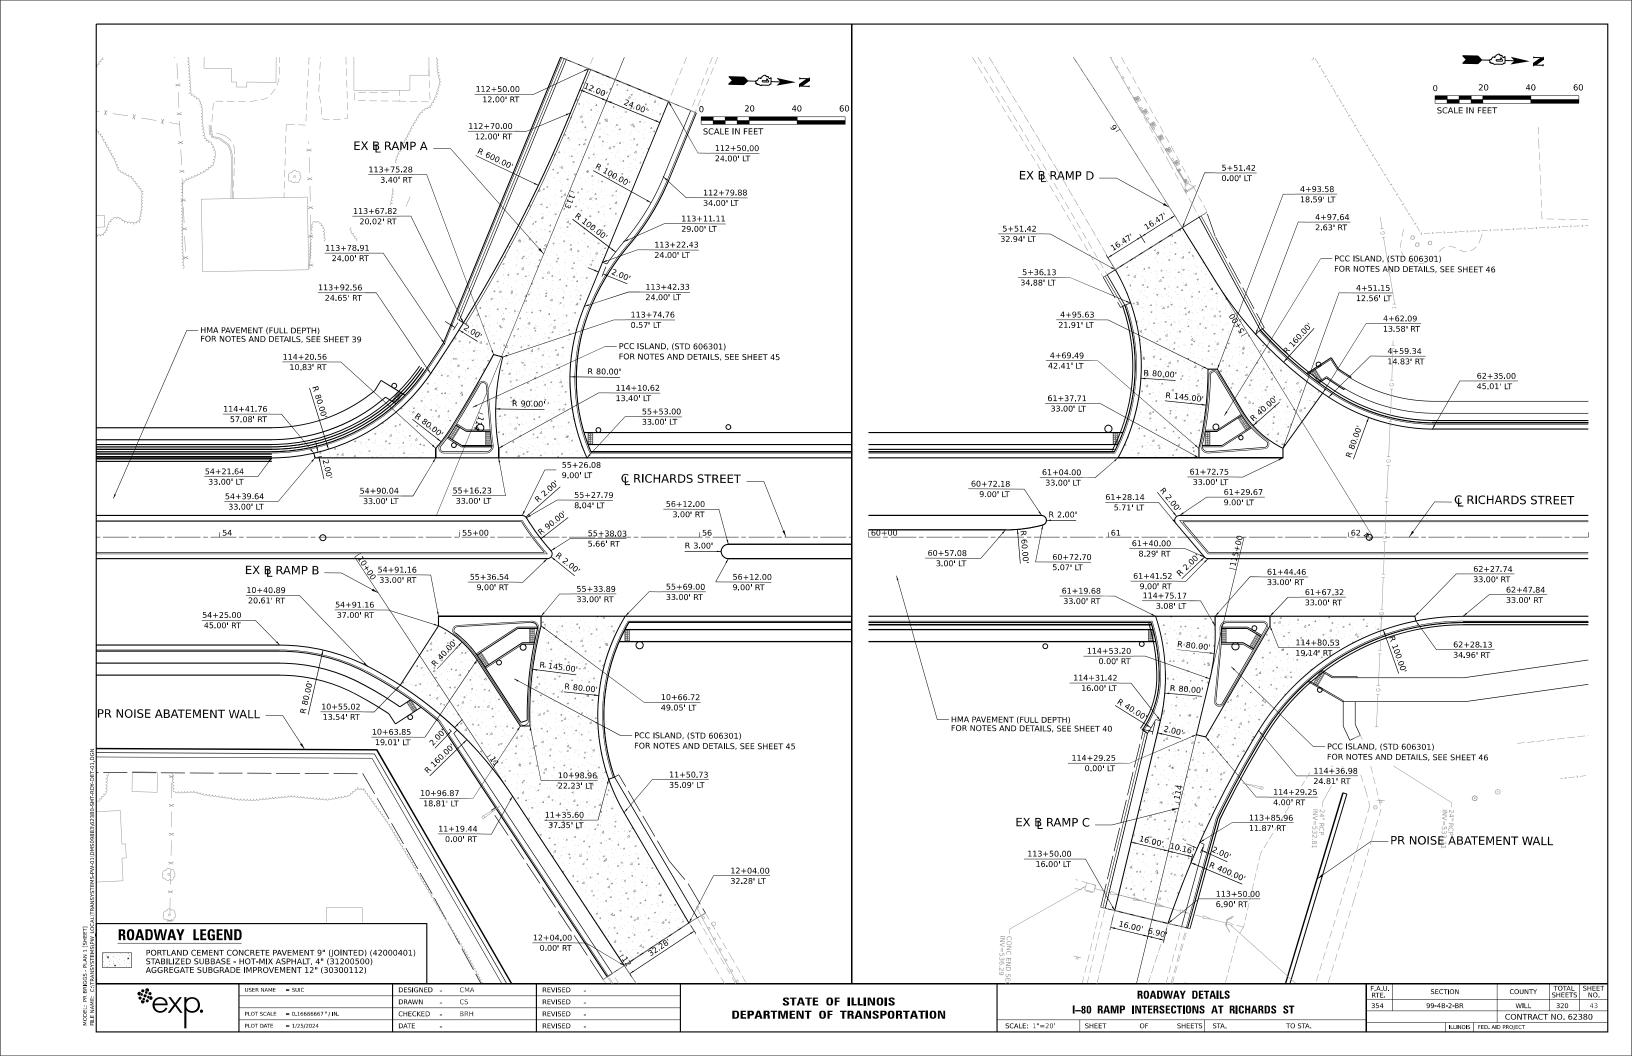


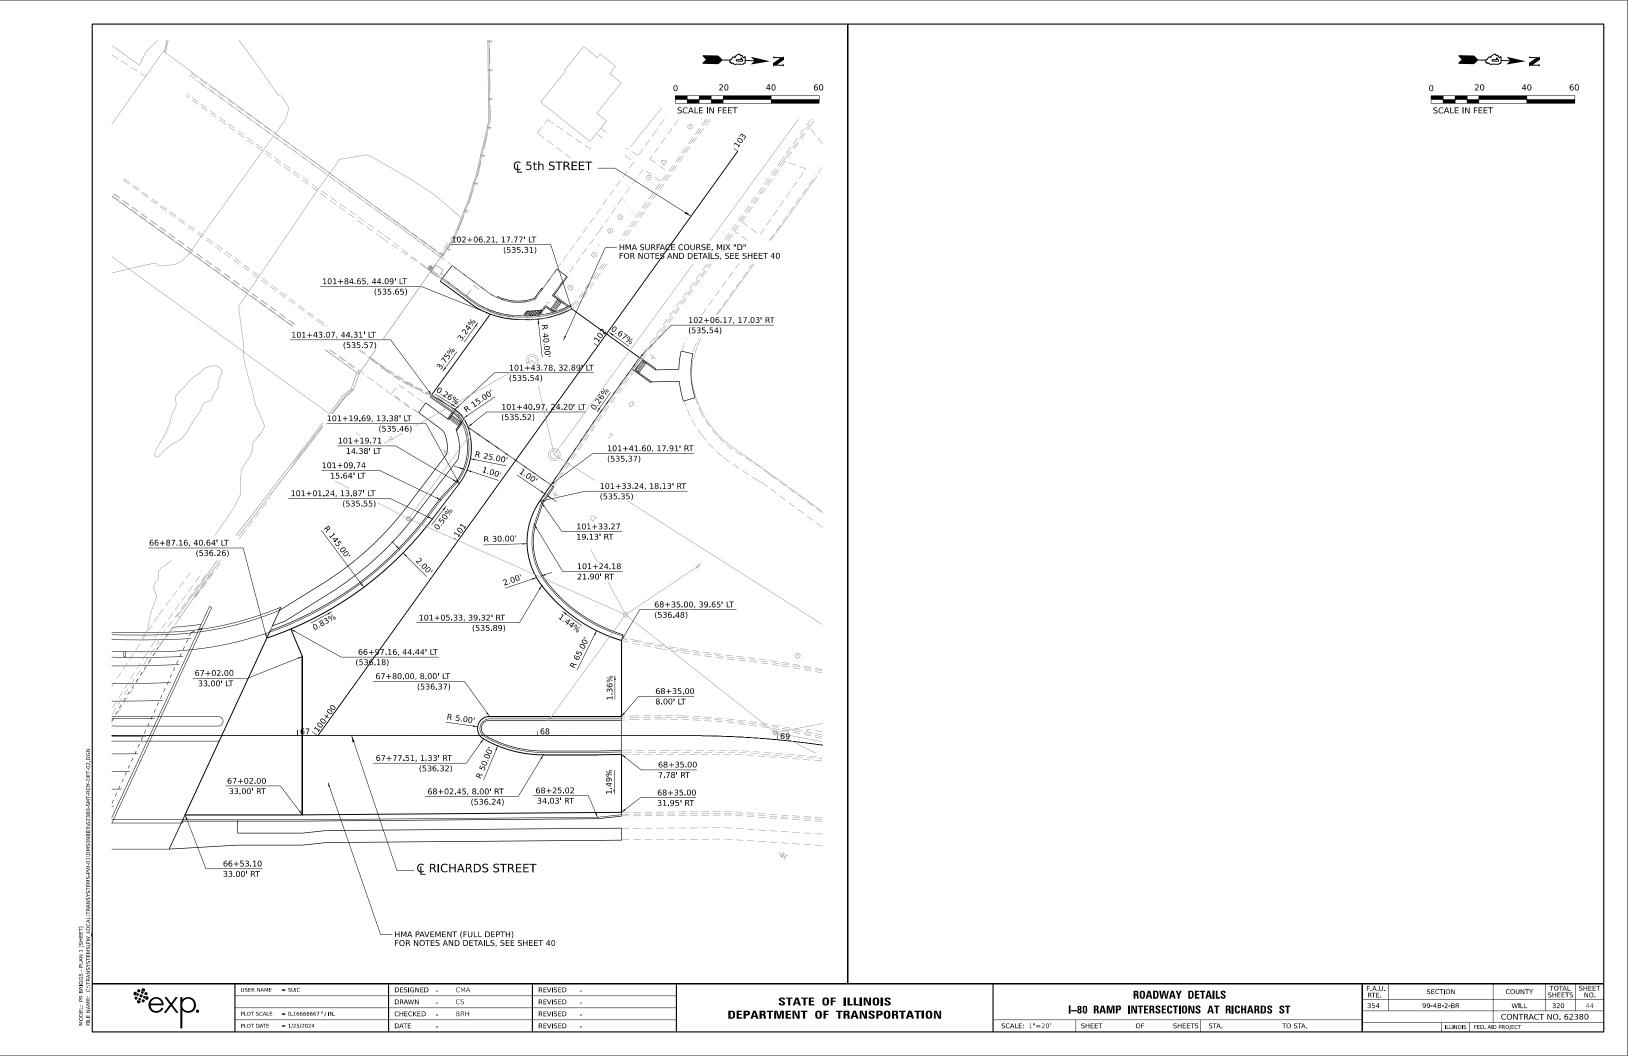



# 113+75.28 3.40' RT 113+74.76 0.57' LT SEE NOTE 2 & 3 113+88.82 4.50' RT CONC MED SURF, 4" COMB CC&G TM6.06 PC CONC CURB TB (TYP.) 114+13.15 VARY GUTTER WIDTH FROM 2' TO 4' PAID FOR AS COMB CC&G TM6.24

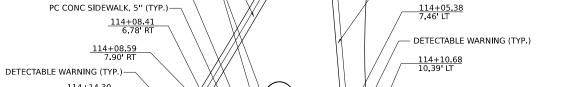

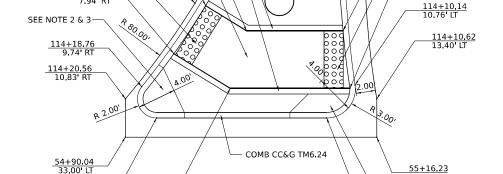


# **ISLAND DETAIL AT RICHARDS ST AND RAMP A**

RICHARDS STREET

(SCALE 1"=5")

SEE NOTE 2 & 3

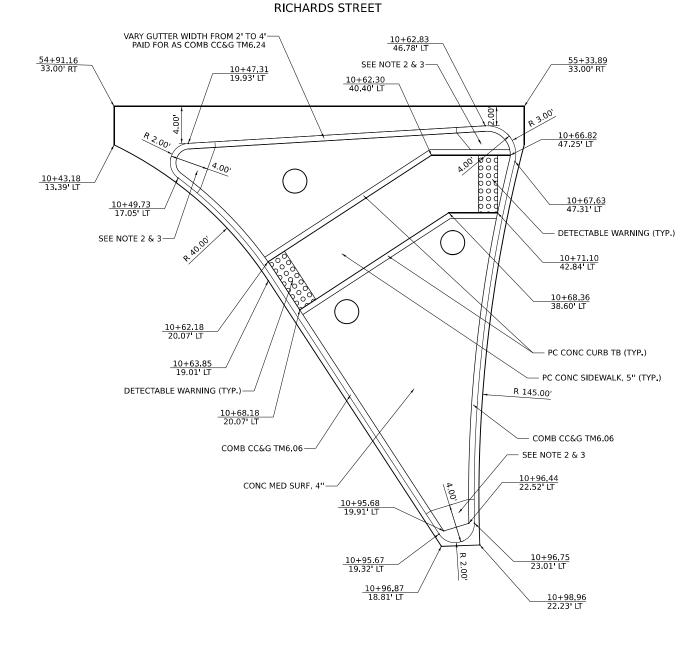

# **ISLAND DETAIL AT RICHARDS ST AND RAMP B**

(SCALE 1"=5")

#### NOTES

- 1. SEE IDOT STANDARD 606301 FOR THE DETAILS (INTERMEDIATE ISLAND) NOT SHOWN HERE.
- 2. NOSE OF CURBED CORNER ISLAND SHALL NOT BE RAMPED.
- THIS PORTION OF THE ISLAND IS CONSTRUCTED AS INTEGRAL COMB CC&G TM6.24 AND THE COST SHALL BE INCLUDED IN THE CONTRACT UNIT PRICE OF COMB CC&G TM6.24.
- 4. SEE SHEETS 48 TO 53 FOR ADA DETAILS.



114+21.18 7.06' RT

> 114+15.41 1.14' RT


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STATI	E 01	F ILLINOIS
DEPARTMENT	OF	TRANSPORTATION

	RICHARDS STREET							SECT	ION	COUNTY	TOTAL SHEETS	
ı		354	99-4B-	WILL	320	45						
ı			CONTRACT NO. 62380									
ı	SCALE: N.T.S.	SHEET	OF	SHEETS	STA.	TO STA.		ILLINOIS FED. AID PROJECT				






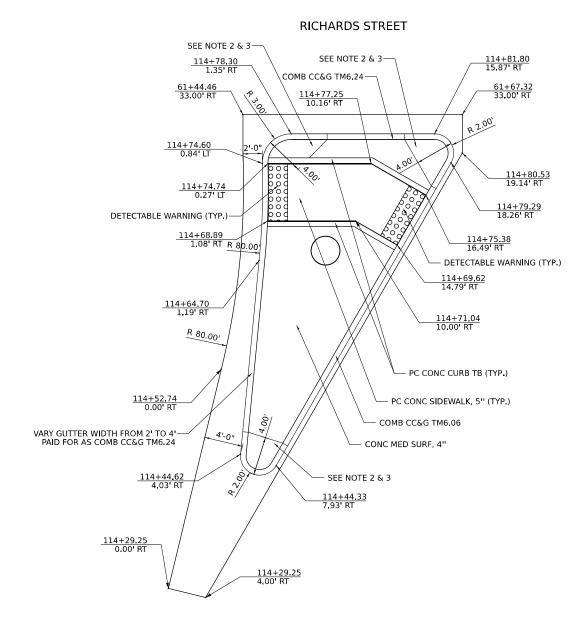

# ISLAND DETAIL AT RICHARDS ST AND RAMP C

(SCALE 1"=5")

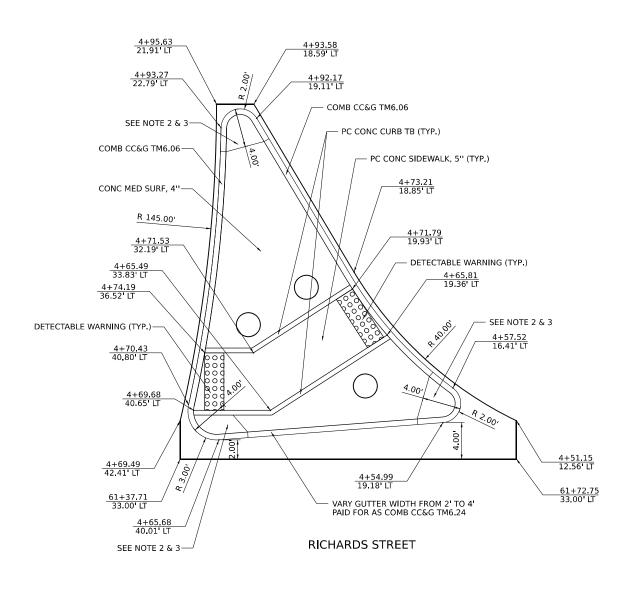

# ISLAND DETAIL AT RICHARDS ST AND RAMP D

(SCALE 1"=5")

NOTES


1. SEE SHEET 45 FOR NOTES.


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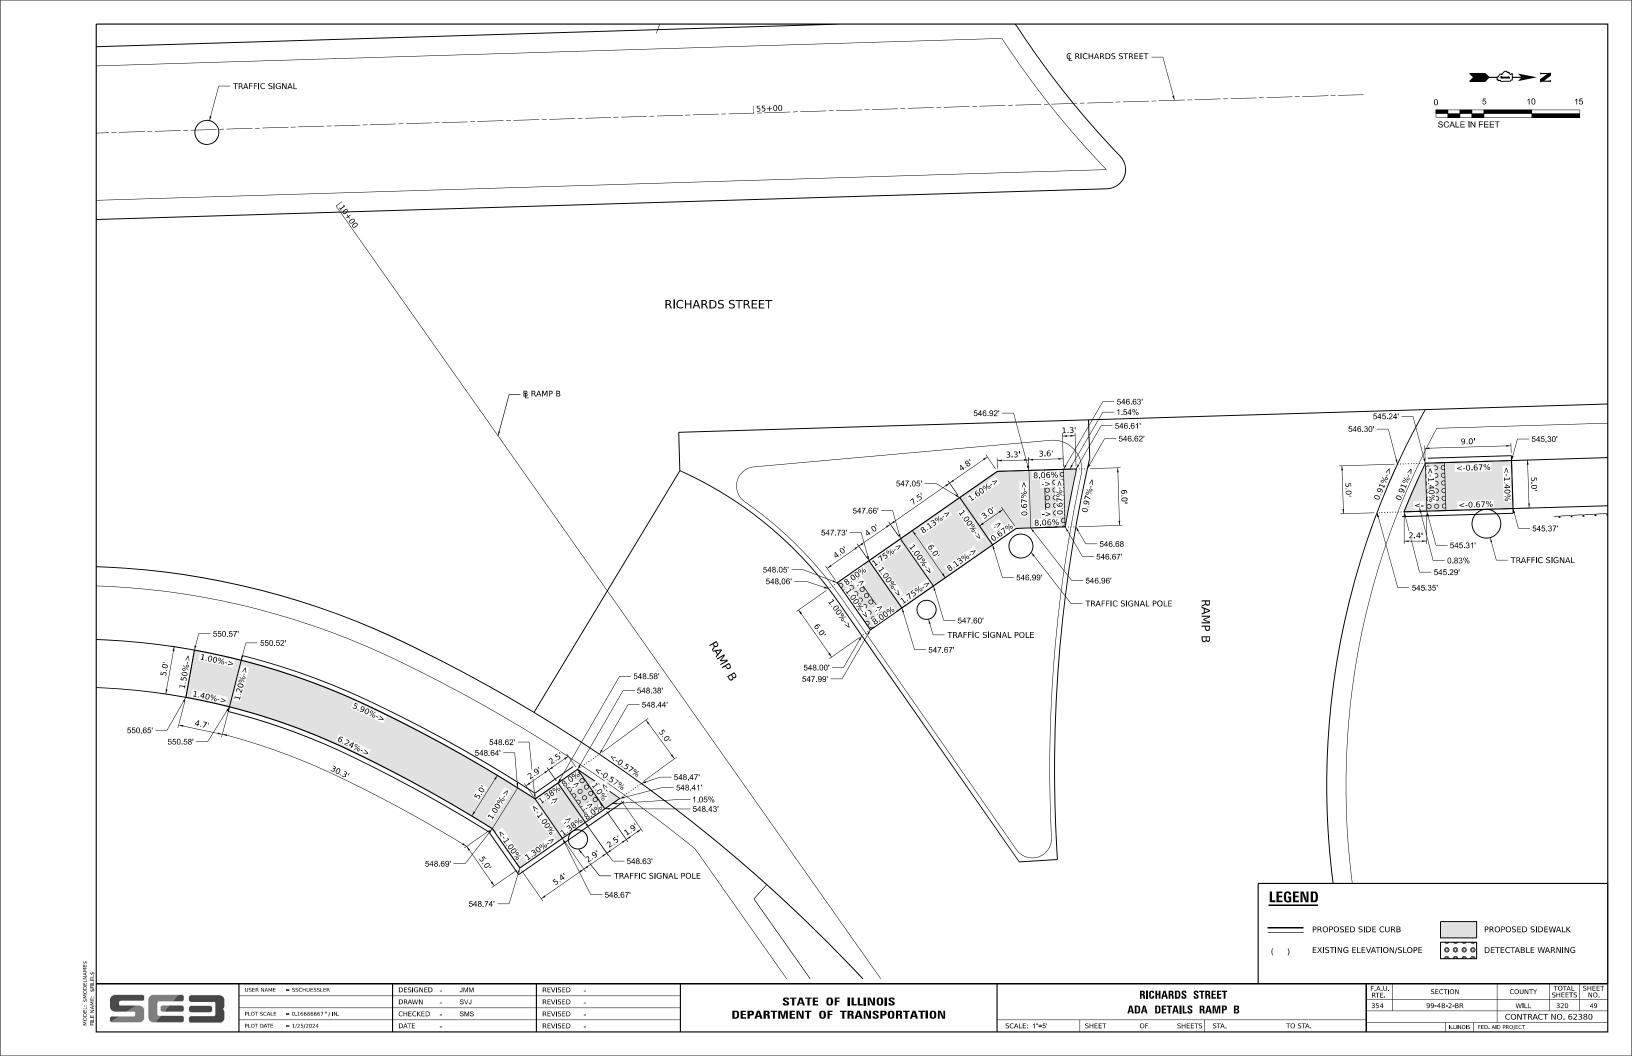
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	DRAWN - CS	5	REVISED	-
PLOT SCALE = 0.16666667 / IN.	CHECKED - DE	DH	REVISED	-
PLOT DATE = 1/25/2024	DATE -		REVISED	-


STATE OF ILLINOIS
DEPARTMENT OF TRANSPORTATION


RICHARDS STREET										
INTERSECTION ISLAND DETAILS										
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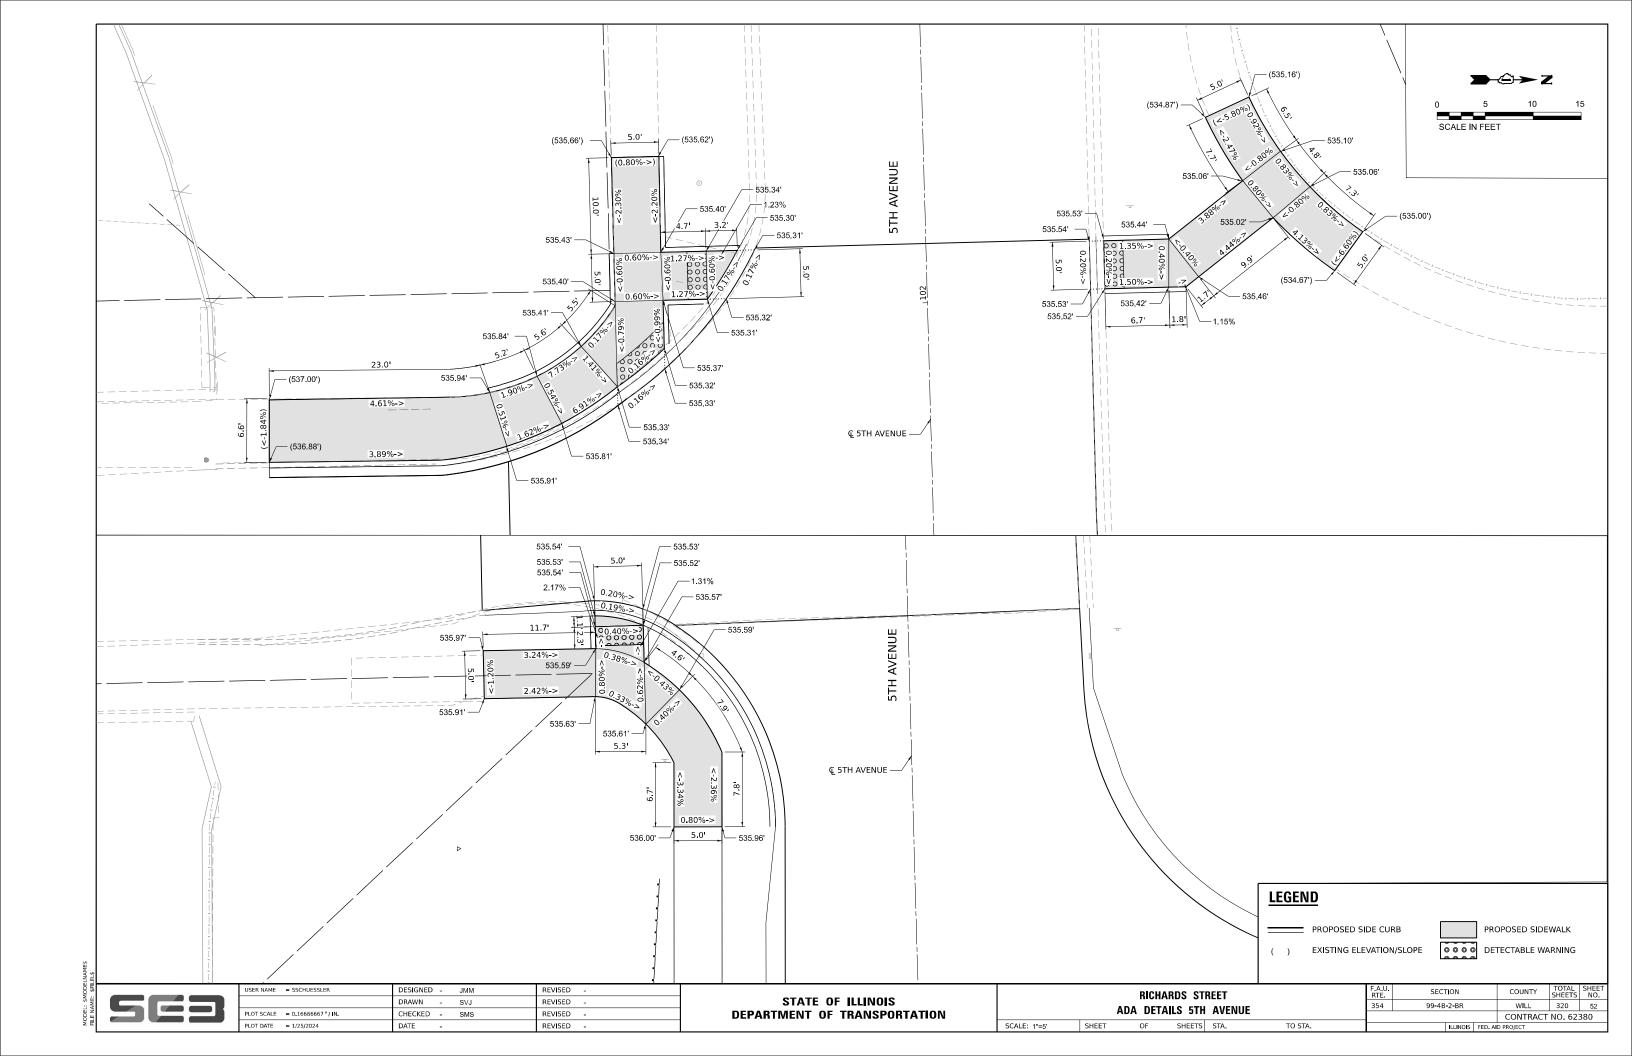





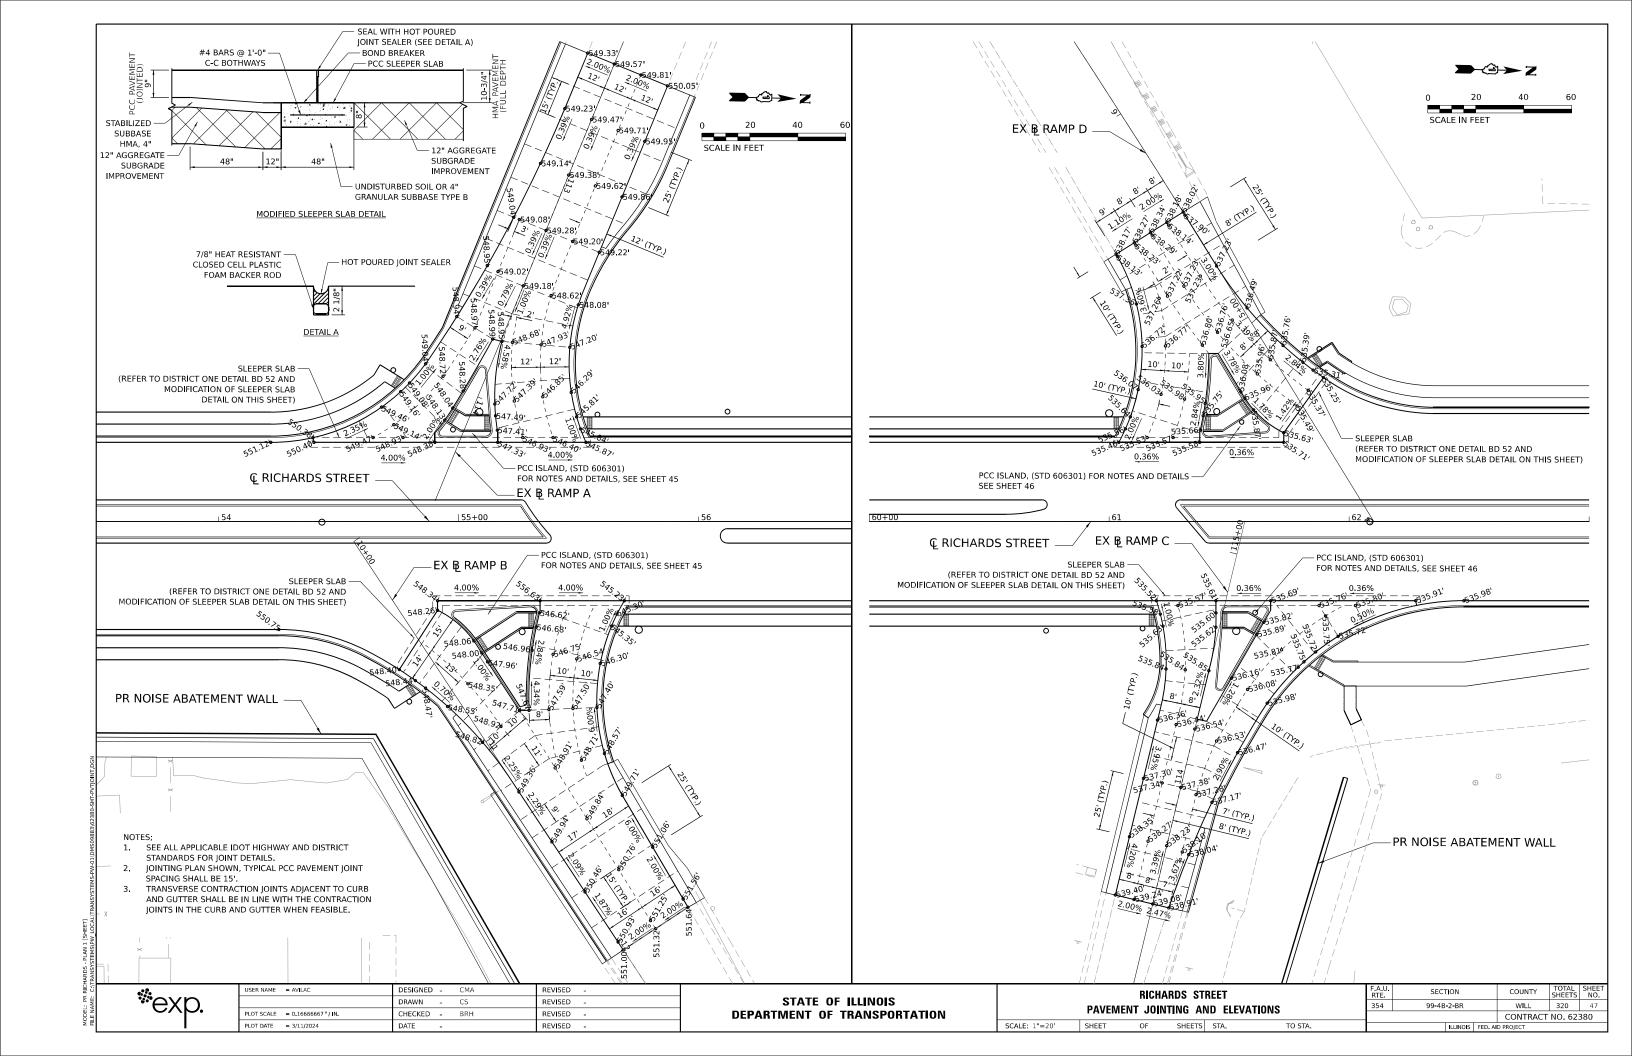


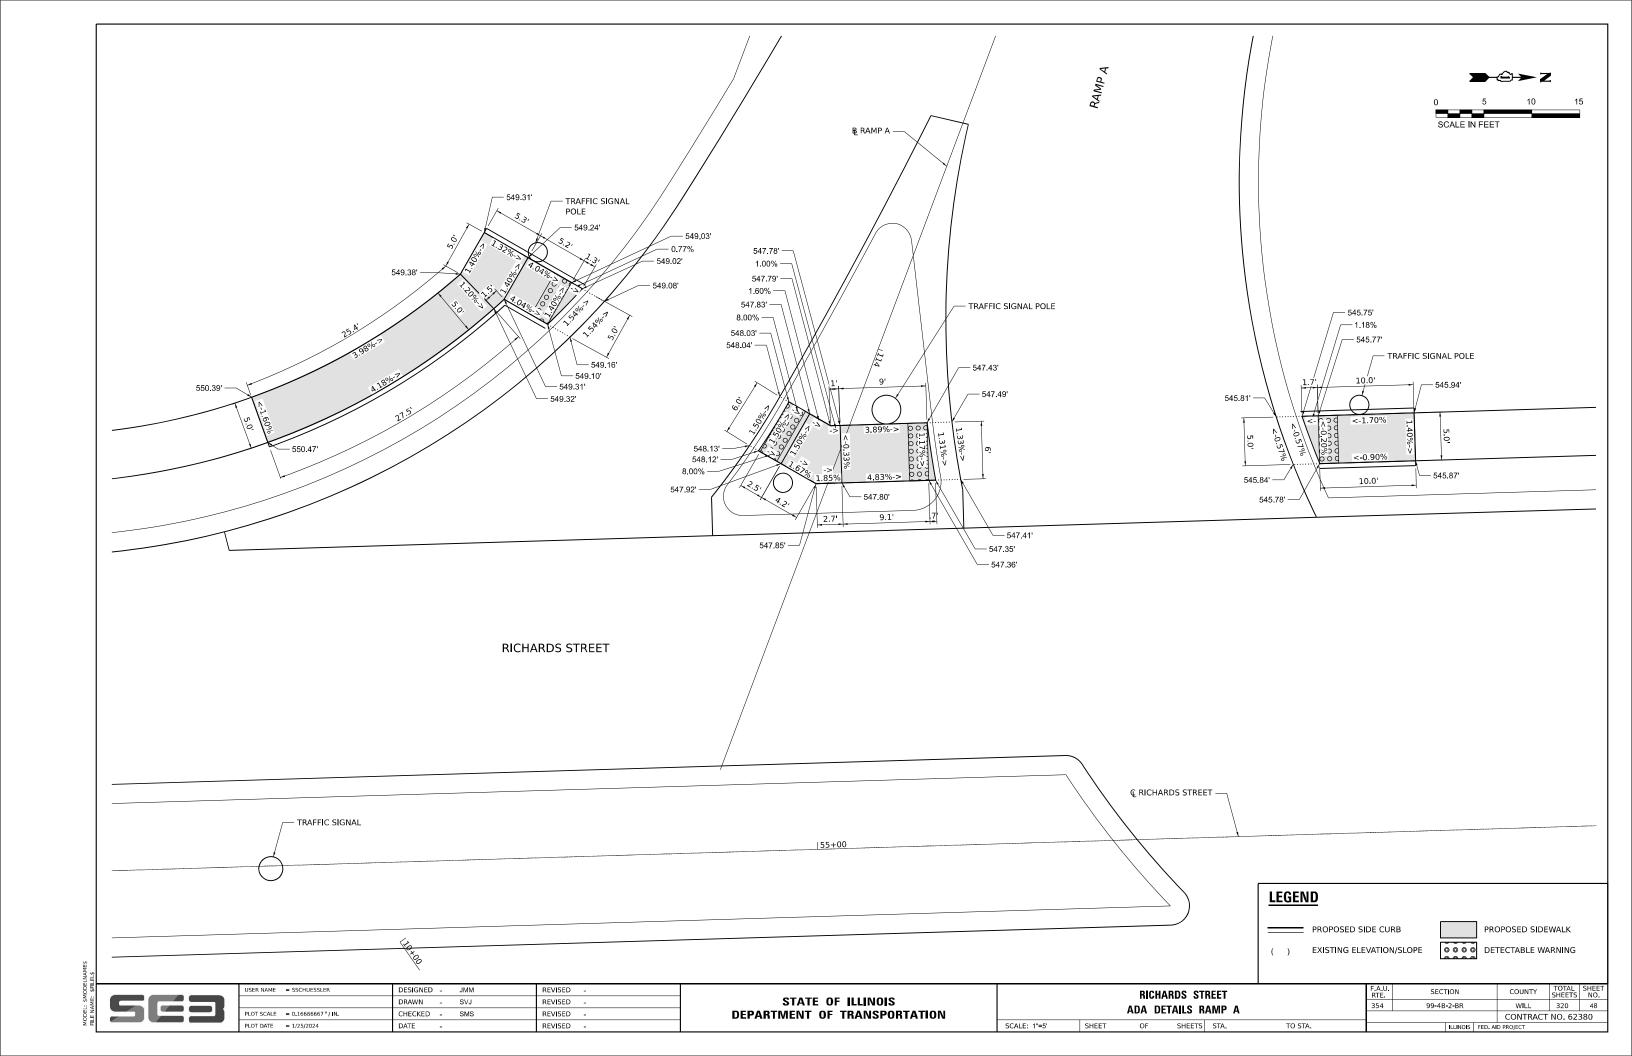

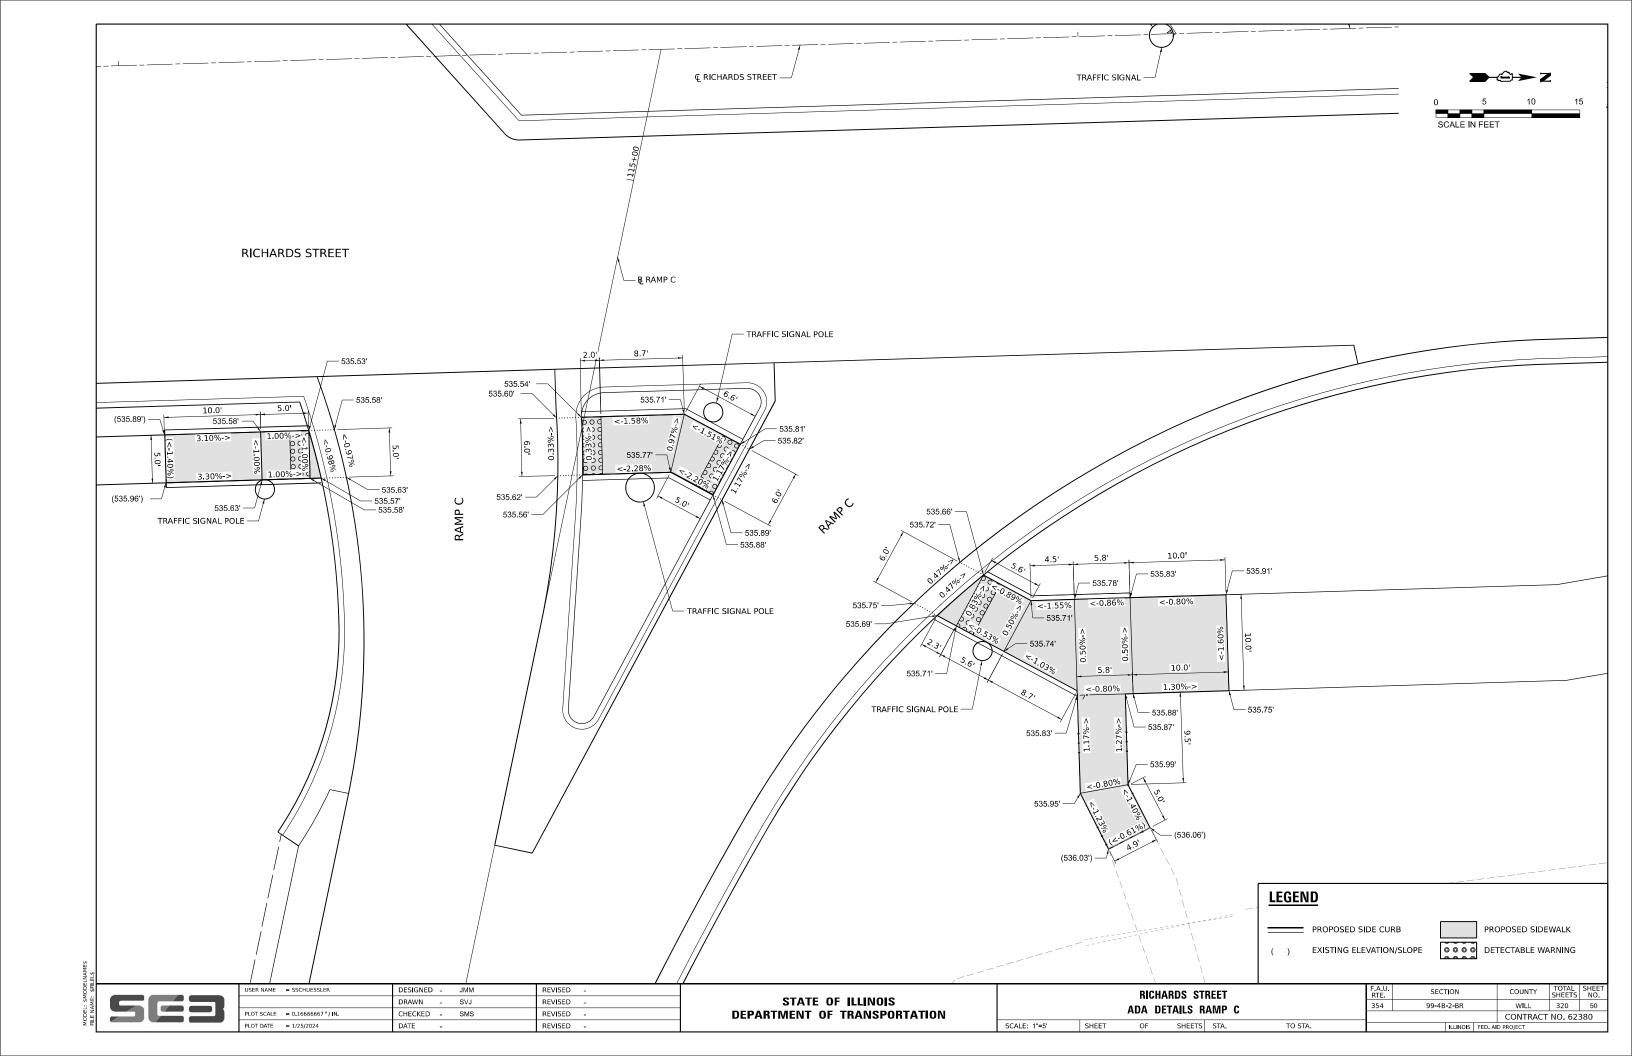

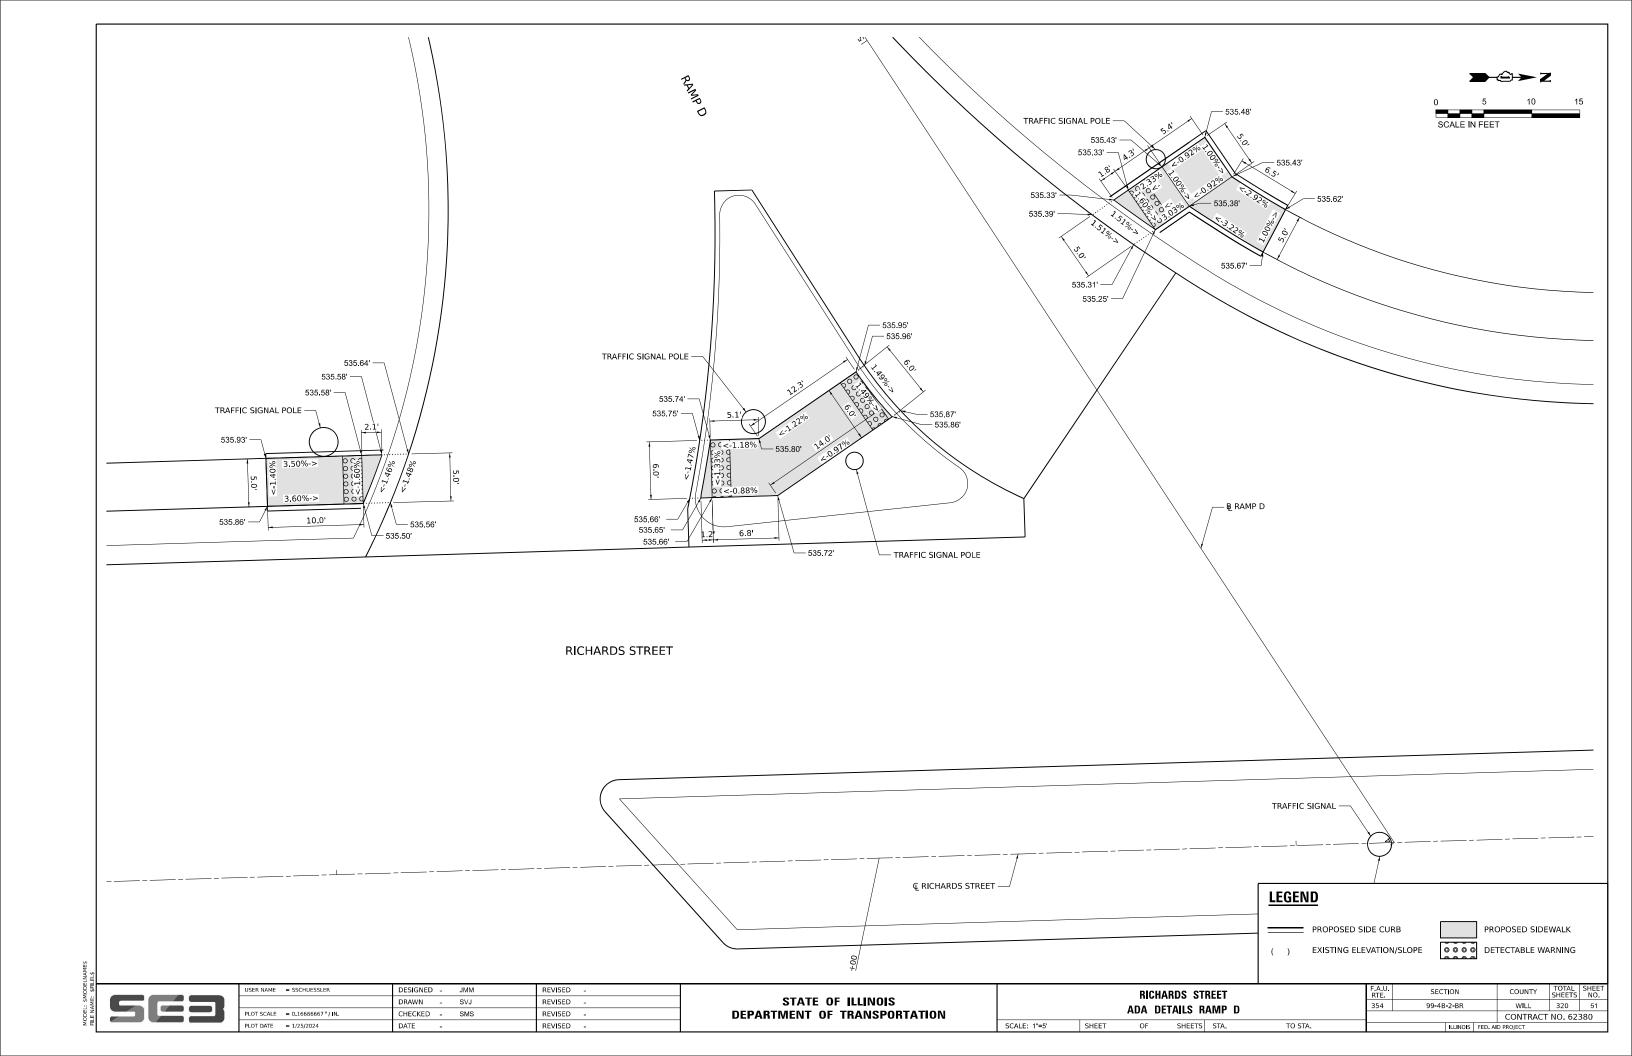

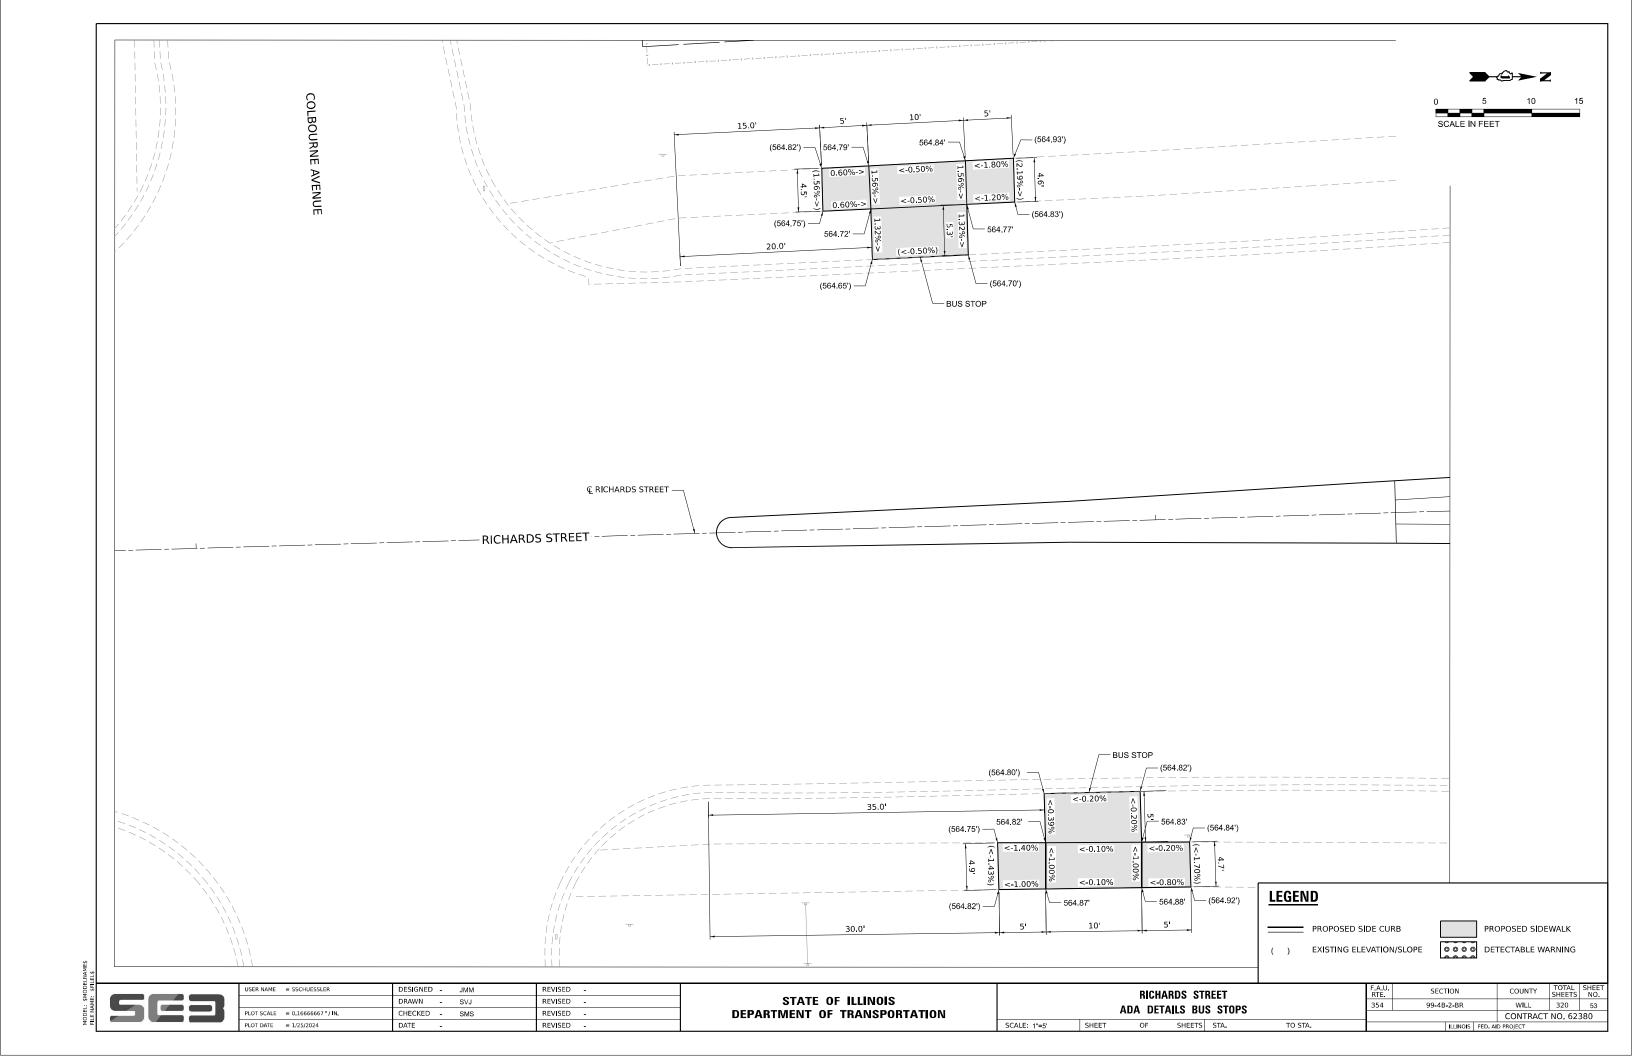

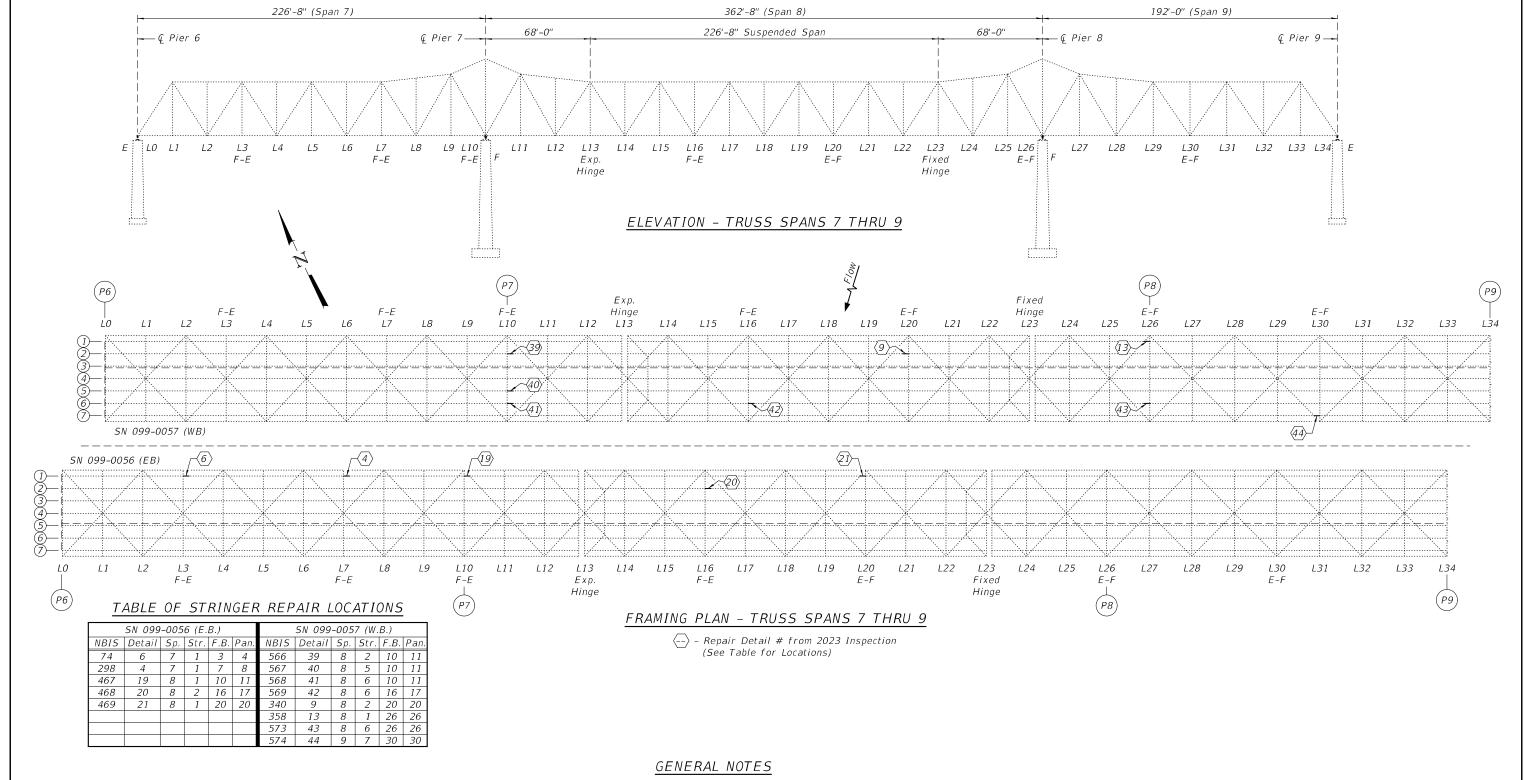

All structural steel shall conform to AASHTO Classification M-270 Gr. 36, unless otherwise noted.

Plan dimensions and details relative to existing plans are subject to nominal construction variations. The Contractor shall field verify existing dimensions and details affecting new construction and make necessary approved adjustments prior to construction or ordering of materials. Such variations shall not be cause for additional compensation for a change in scope of the work, however, the Contractor will be paid for the quantity actually furnished at the unit price bid for the work. Fasteners shall be high strength bolts. Bolts ¾"0, open holes 1¾6"0, unless

Diaphragm connection holes shall be  $^{15}\!\!/_{16}$ "Ø for  $^{3}\!\!/_{4}$ "Ø bolts. Two hardened washers shall be required at diaphragm connections.

otherwise noted.

The existing structural steel coating contains lead. The Contractor shall take appropriate precautions to deal with the presence of lead on this project.

The Inorganic Zinc Rich Primer / Acrylic / Acrylic Paint System shall be used for shop and field painting of new structural steel except where otherwise noted. The color of the final finish coat shall be Reddish Brown, Munsell No. 2.5YR 3/4.

Existing structural steel that will be in contact with new structural steel shall be cleaned and painted prior to erection as required by the special provision "Cleaning and Painting Contact Surface Areas of Existing Steel Structures".


Cost of removal and re-installation of all members necessary to complete the work as detailed on the plans and as specified in the Special Provisions shall be included with Structural Steel Repair.

# TOTAL BILL OF MATERIAL

ITEM	UNIT	QUANTITY
Structural Steel Repair	Pound	2280
·		

# Expires: November 30, 2024

DESIGNED - Jeffrey S. Burke CHECKED - Adrian T. Halloway	EXAMINED	ENGINEER OF STRUCTURAL SERVICES,	DATE - MARCH 19, 2024	STATE OF ILLINOIS	FRAMING PLAN & ELEVATION F.A.I. ROUTE 80 OVER DES PLAINES RIVER
DRAWN - STEFFEN	PASSED	tayn F. Arhiff	REVISED -	DEPARTMENT OF TRANSPORTATION	SN 099-0056 (E.B.) & -0057 (W.B.)
CHECKED - JSB ATH		ENGINEER OF BRIDGES AND STRUCTURES	REVISED -		SHEET NO. 1 OF 7 SHEETS

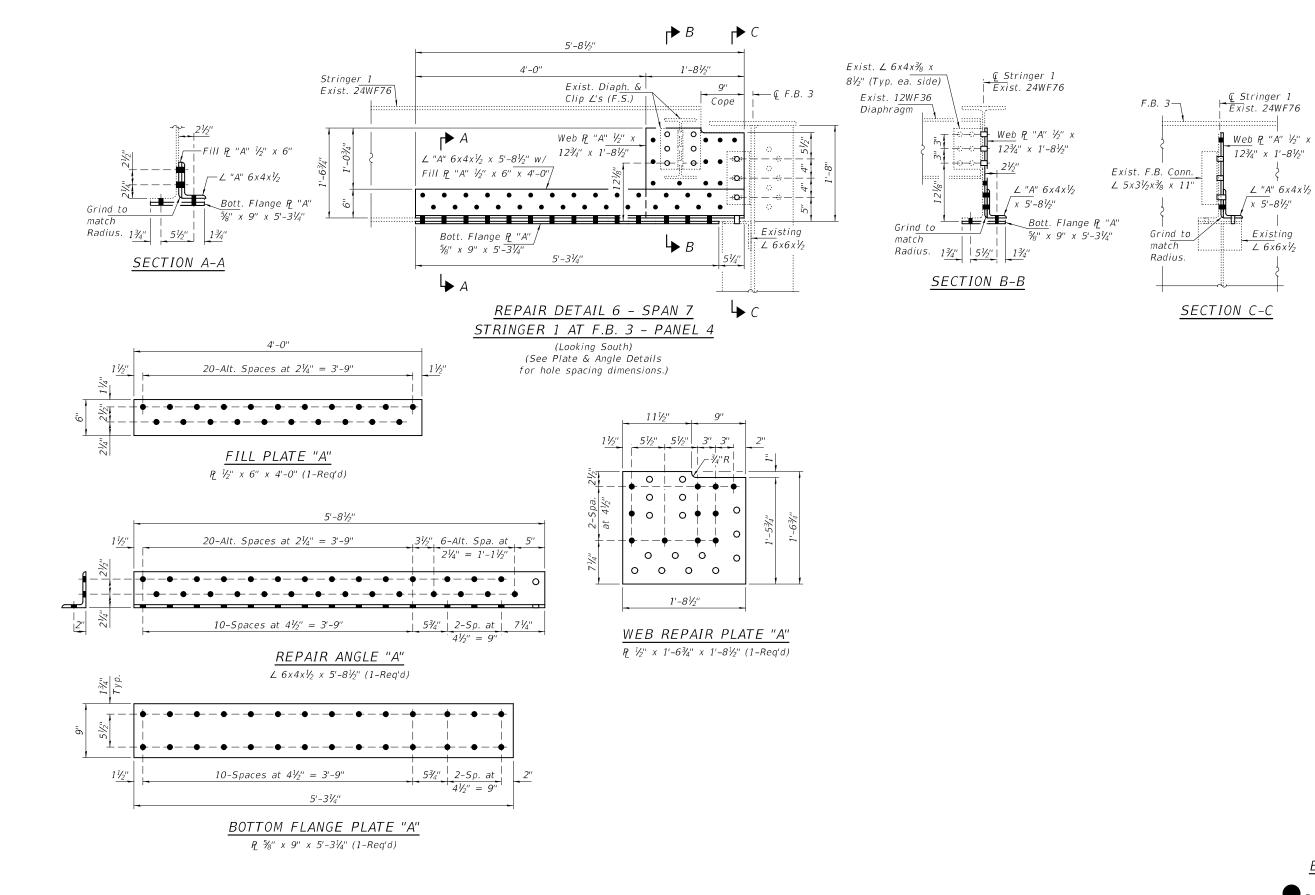



# BOLT HOLE LEGEND

- Shop Drilled Holes in new steel.

 Field Drilled holes in new steel using existing holes as template.

 DESIGNED - JSB	EXAMINED		DATE - MARCH 19, 2024	07477 07 11 11 10 10	STRINGER REPAIR DETAILS	RTE	SECTION	COUNTY	SHEETS	NO.
CHECKED - ATH	_	ENGINEER OF STRUCTURAL SERVICES		STATE OF ILLINOIS	SN 099-0056 (E.B.)	80	99-4B-2-BR	WILL	320	55
DRAWN - STEFFEN	PASSED	Jayne +. Allh	REVISED -	DEPARTMENT OF TRANSPORTATION	2W 099-0000 (E.D.)			CONTRAC	T NO. 62	380
CHECKED - JSB ATH		ENGINEER OF BRIDGES AND STRUCTURES	REVISED -		SHEET NO. 2 OF 7 SHEETS		ILLINOIS FED. A	ID PROJECT		

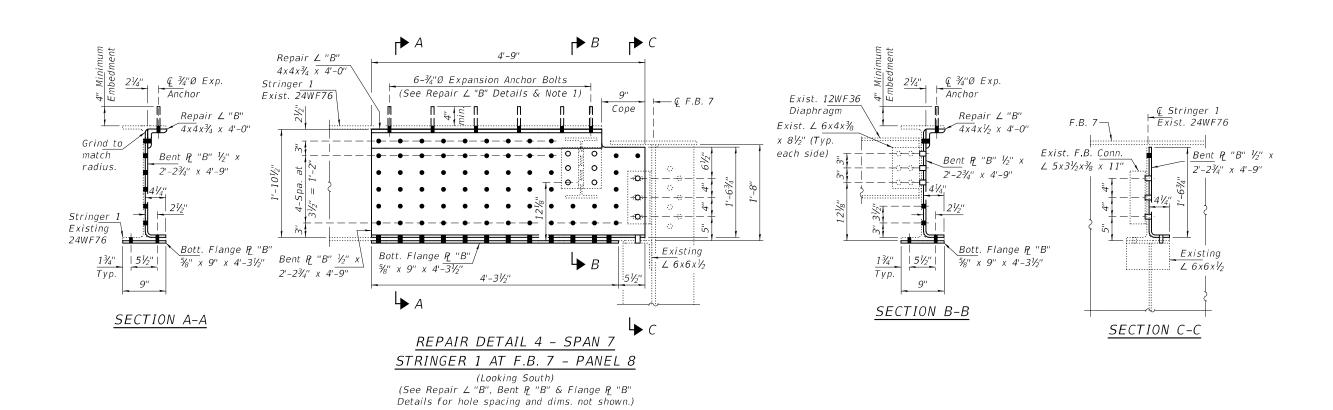

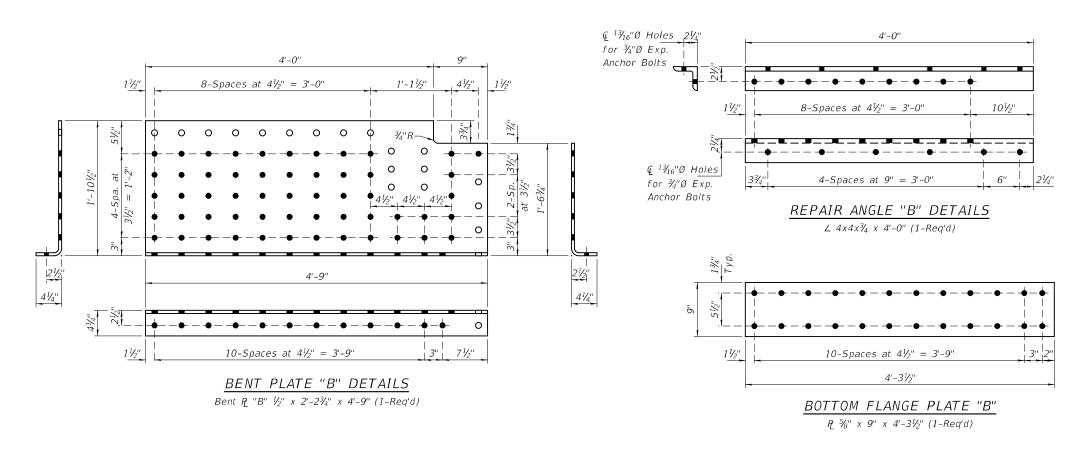


# NOTES


1. Field drill <sup>1</sup>½<sub>16</sub>"Ø holes 4" min. into existing concrete and install ¾'"Ø Expansion Anchor Bolts with min. pull out capacity of 1.5 kips. Expansion Anchor Bolts shall be carbon steel. Cost included with Structural Steel Repair.

# BOLT HOLE LEGEND

- Shop Drilled Holes in new steel.
- ) Field Drilled holes in new steel using existing holes as template.

DESIGNED - JSB	EXAMINED		DATE - MARCH 19, 2024	07475 07 11 11 10 10	STRINGER REPAIR DETAILS	RTE.	SECTION	COUNTY	SHEETS	NO.
CHECKED - ATH	_	ENGINEER OF STRUCTURAL SERVICES		STATE OF ILLINOIS	SN 099-0056 (E.B.)	80	99-4B-2-BR	WILL	320	56
DRAWN - STEFFEN	PASSED	Jayne + Jeliff	REVISED -	DEPARTMENT OF TRANSPORTATION	2M 033-0030 (E.D.)			CONTRACT	T NO. 623	380
CHECKED - JSB ATH		ENGINEER OF BRIDGES AND STAUCTURES	REVISED -		SHEET NO. 3 OF 7 SHEETS		ILLINOIS FED. A	NID PROJECT		

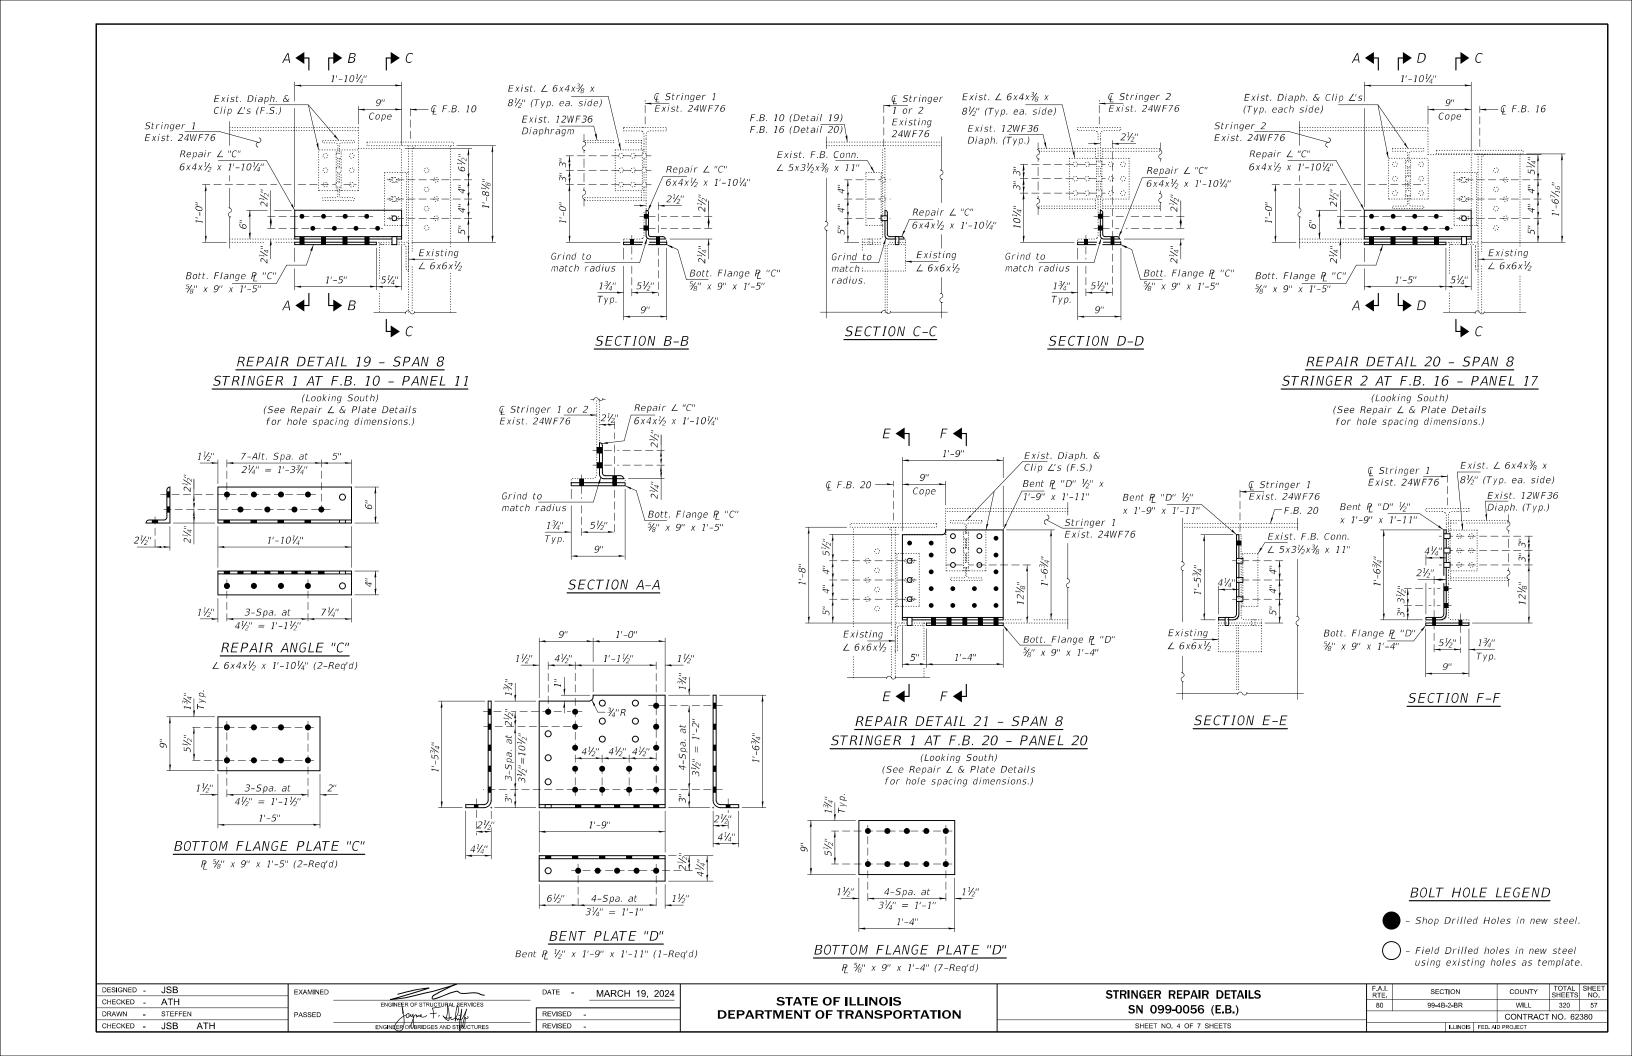

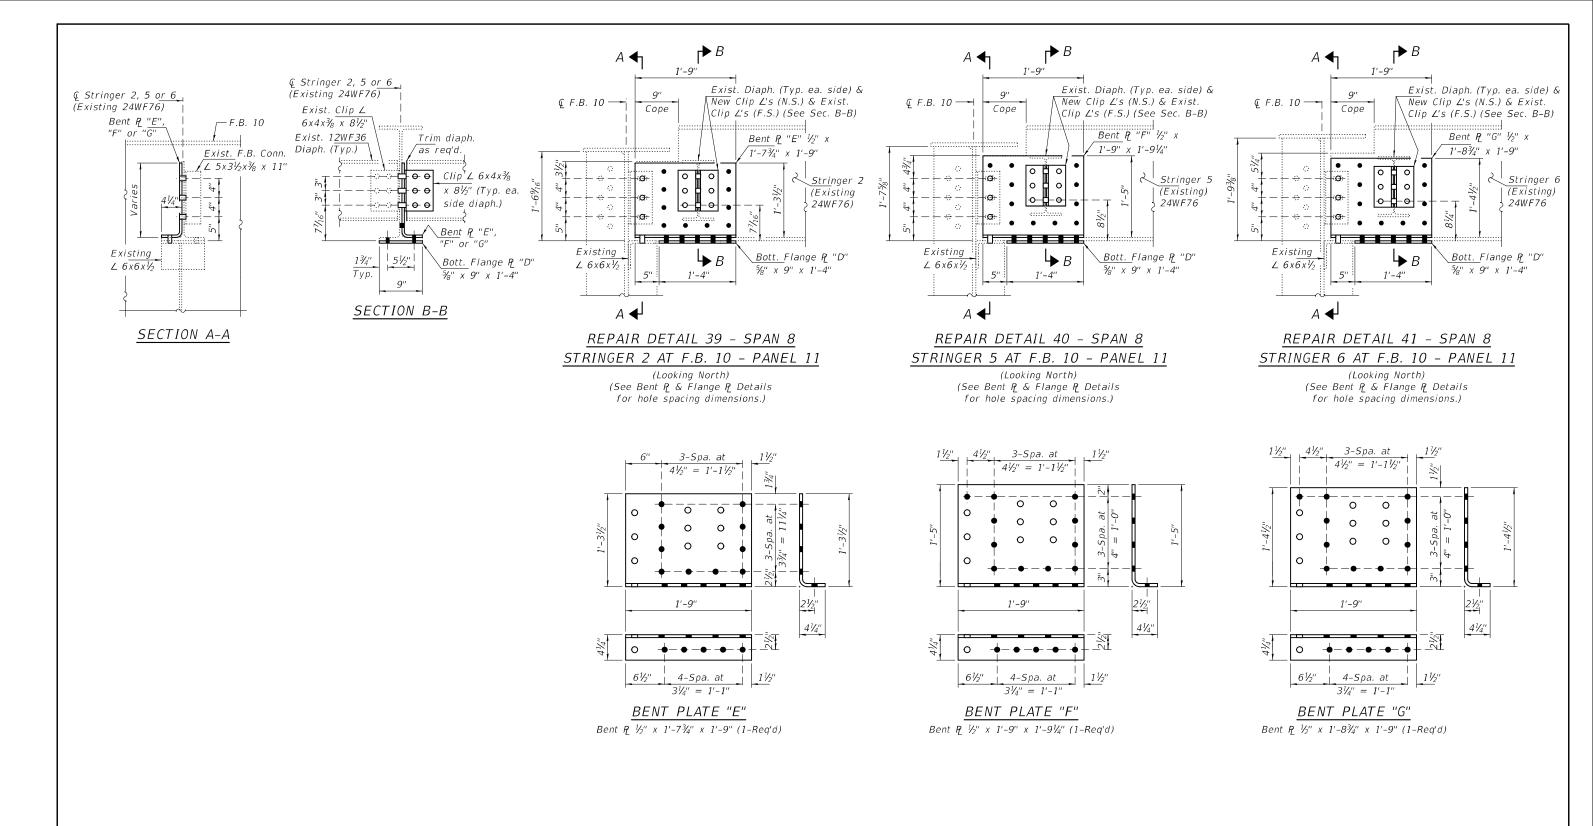

Note:

SECTION

99-4B-2-BR

For Bottom Flange R "D" Details, see sheet 4 of 7.

# **BOLT HOLE LEGEND**

- Shop Drilled Holes in new steel.

 Field Drilled holes in new steel using existing holes as template.

COUNTY

WILL 320 58

CONTRACT NO. 62380


DESIGNED - JSB
CHECKED - ATH
DRAWN - STEFFEN
CHECKED - JSB ATH
CHECKED - JSB ATH

EXAMINED
PASSED


DATE - MARCH 19, 2024
STATE OF ILLINOIS
DEPARTMENT OF TRANSPORTATION
SHEET NO. 5 OF 7 SHEETS

STRINGER REPAIR DETAILS
REVISED 80

REVISED SHEET NO. 5 OF 7 SHEETS

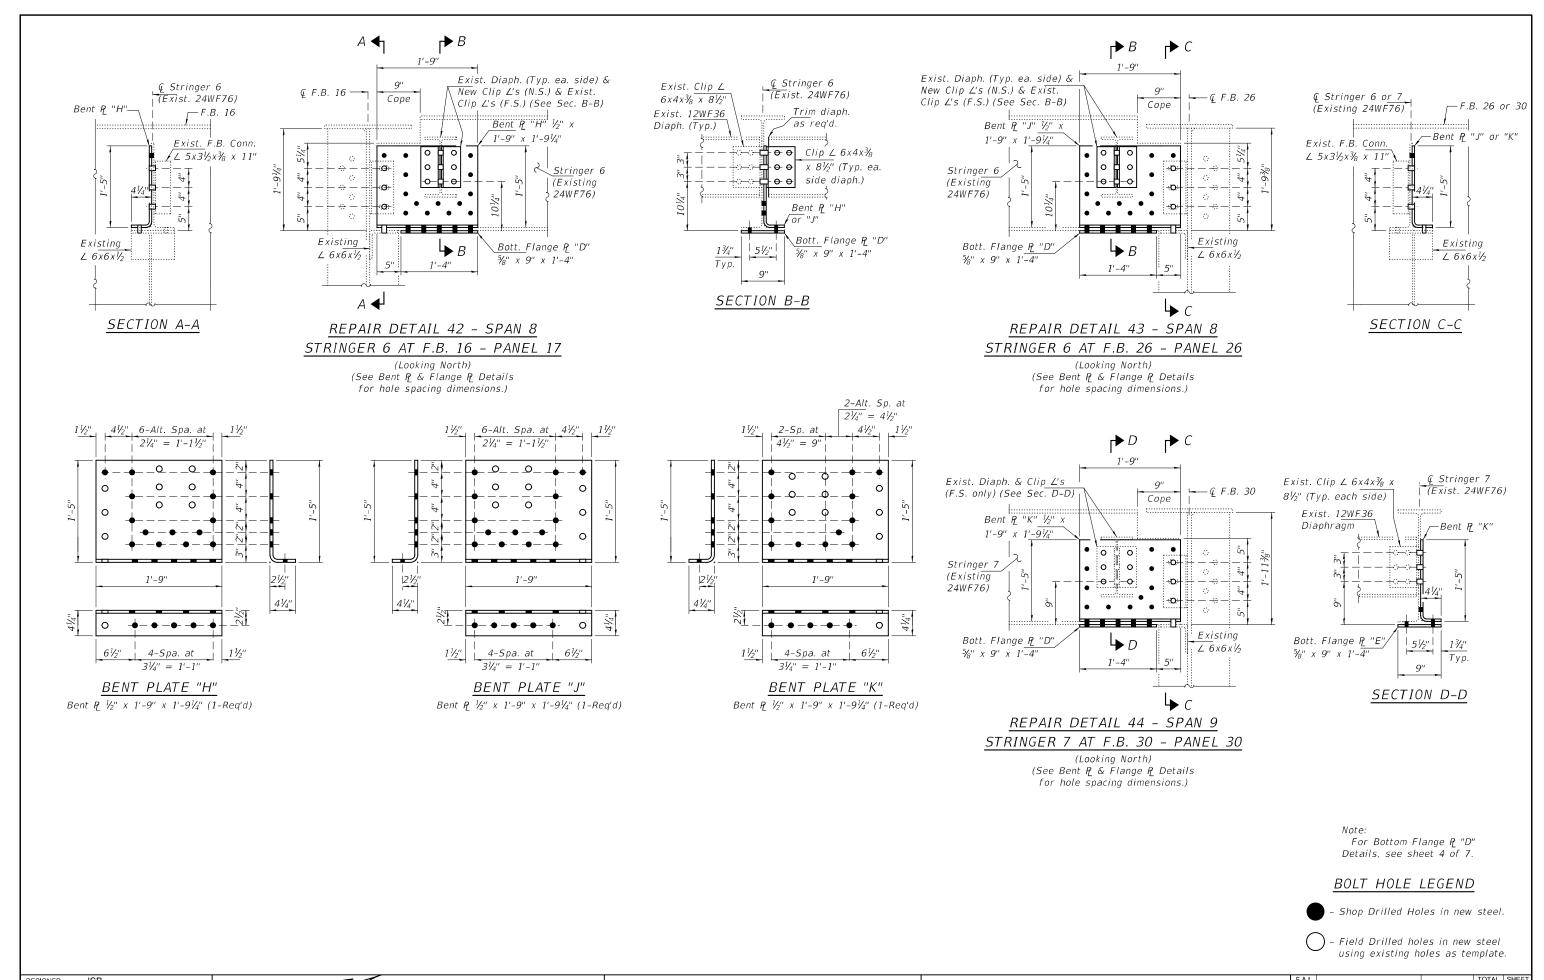

DESIGNED - JSB	EXAMINED		DATE - MARCH 19, 2024	CTATE OF HILINOIC	STRINGER REPAIR DETAILS	RTE	SECTION	COUNTY	SHEETS	3 NO.
CHECKED - ATH	<b>⊣</b> '	ENGINEER OF STRUCTURAL SERVICES		STATE OF ILLINOIS	SN 099-0057 (W.B.)	80	99-4B-2-BR	WILL	320	59
DRAWN - STEFFEN	PASSED	Jayne + Jeliff	REVISED -	DEPARTMENT OF TRANSPORTATION	3N 099-0037 (W.D.)			CONTRAC	T NO. 62	2380
CHECKED - JSB ATH	-	ENGINEER OF BRIDGES AND STRUCTURES	REVISED -		SHEET NO. 6 OF 7 SHEETS		ILLINOIS I	FED. AID PROJECT		

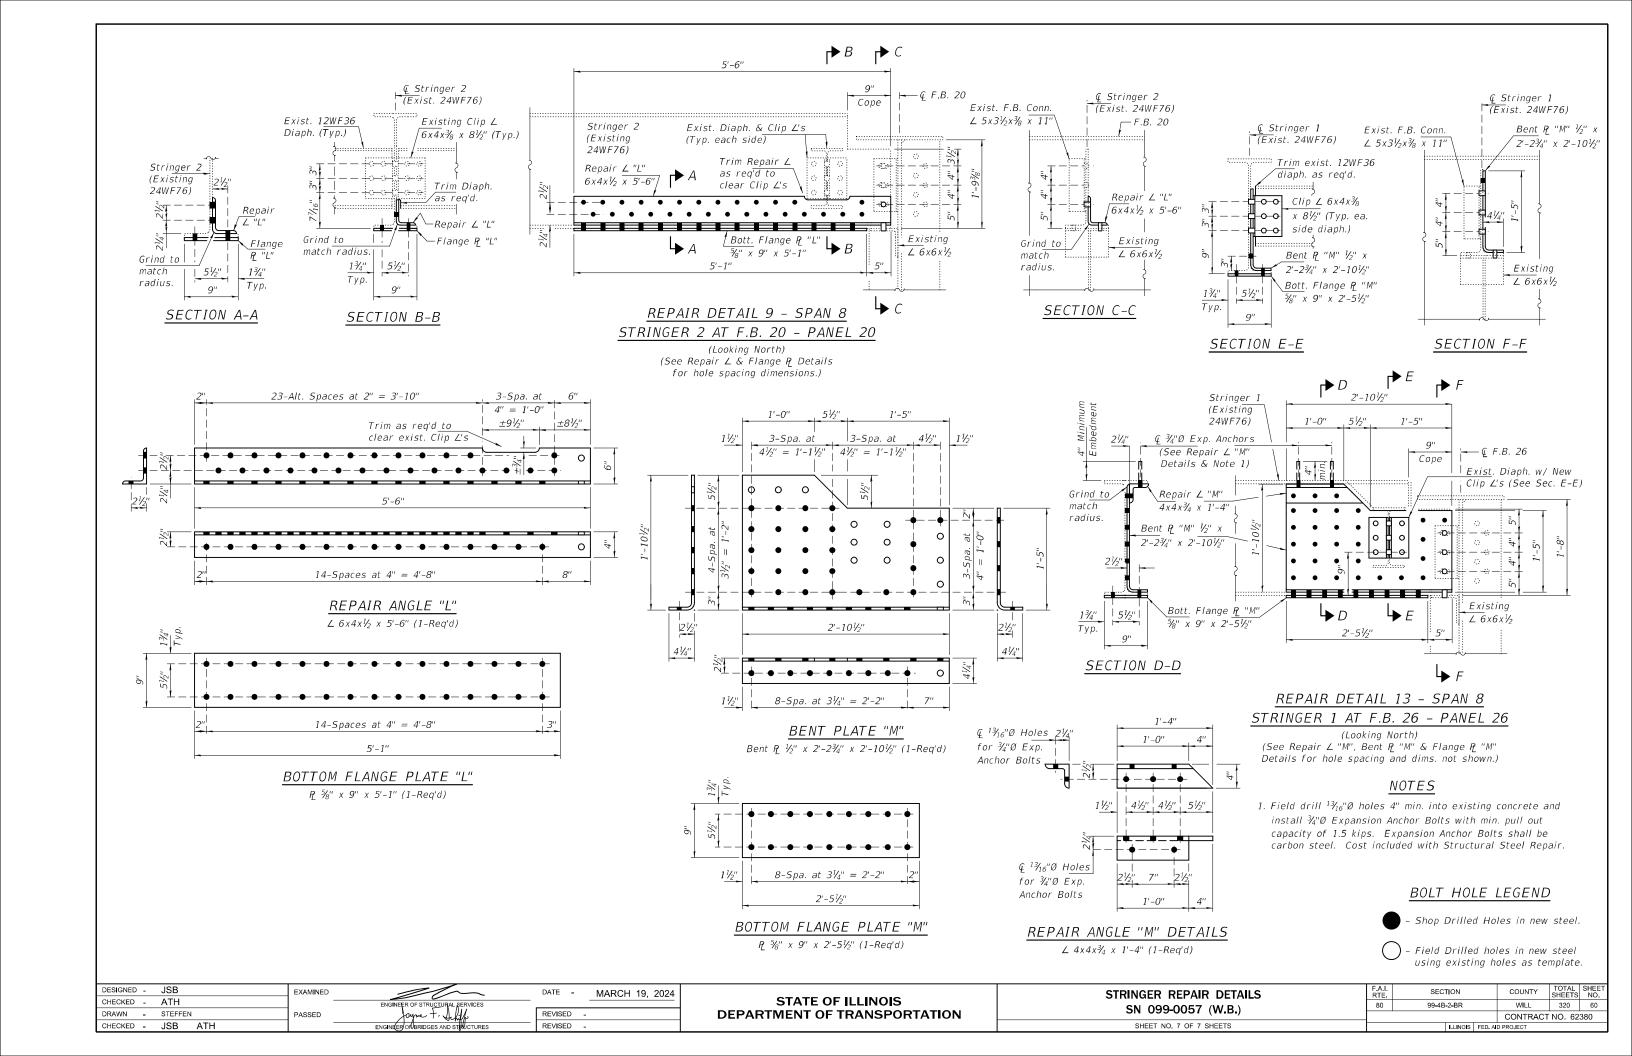

# MAINTENANCE OF TRAFFIC GENERAL NOTES

- THE CONTRACTOR MUST COORDINATE ALL LANE CLOSURES WITH THE ENGINEER.
- WORK IS TO BE PERFORMED IN ACCORDANCE WITH THE "KEEPING THE EXPRESSWAY OPEN TO TRAFFIC" (KEOTT) AND PER STATE HIGHWAY STANDARDS AND DISTRICT 1 DETAILS FOR TRAFFIC CONTROL. ALL TRAFFIC CONTROL DEVICES AND SIGNAGE REQUIRED ON THE I-80 EXPRESSWAY, RICHARDS STREET, AND RAMPS SHALL BE IN ACCORDANCE WITH THE APPLICABLE IDOT DISTRICT 1 DETAILS, IDOT HIGHWAY STANDARDS, AND THESE CONTRACT DRAWINGS, ALL WORK SHOWN IS TO BE INCLUDED IN "TRAFFIC CONTROL AND PROTECTION (EXPRESSWAYS)" AND 'TRAFFIC CONTROL AND PROTECTION, (SPECIAL)" UNLESS OTHERWISE NOTED.
- THE CONTRACTOR SHALL REQUEST AND GAIN THE APPROVAL FROM THE CORRIDOR CONSTRUCTION MANAGER (CCM) AND ILLINOIS DEPARTMENT OF TRANSPORTATION'S EXPRESSWAY TRAFFIC OPERATIONS ENGINEER AT WWW.IDOTICS.COM.TWENTY-FOUR (24) HOURS. IN ADVANCE OF ALL DAILY LANE RAMP, AND SHOULDER CLOSURES AND 7 DAYS IN ADVANCE OF ALL PERMANENT AND WEEKEND CLOSURES ON ALL FREEWAYS AND/OR EXPRESSWAYS IN DISTRICT ONE. THIS ADVANCE NOTIFICATION IS CALCULATED BASED ON WORKWEEK OF MONDAY THROUGH FRIDAY AND SHALL NOT INCLUDE WEEKENDS OR HOLIDAYS. REFER TO THE KEOTT SPECIAL PROVISION FOR TRAFFIC CONTROL REQUIREMENTS FOR STAGE CHANGES AND FULL STOPS
- LANE CLOSURES, RAMP CLOSURES, SIGNING, PAVEMENT MARKING, AND BARRICADE PLACEMENT SHALL BE IN ACCORDANCE WITH THE LATEST HIGHWAY STANDARD DRAWINGS AND IDOT DISTRICT 1 STANDARD DETAILS AS
- ALL TEMPORARY SIGNS AND SIGN SUPPORTS SHALL BE IN COMPLIANCE WITH ARTICLE 701.14 OF THE SSRBC AND THE SPECIAL PROVISIONS, INCLUDING WORK ZONE TRAFFIC CONTROL DEVICES (BDE)
- EXISTING PAVEMENT MARKINGS THAT CONFLICT WITH THE STAGING SHALL BE REMOVED. THE REMOVAL WILL BE MEASURED IN SQUARE FEET AND PAID FOR AS "PAVEMENT MARKING REMOVAL GRINDING" OR "PAVEMENT MARKING REMOVAL WATER BLASTING" AS NECESSARY. GRINDING IS PROHIBITED ON ALL PAVEMENT NOT BEING
- CHECK BARRICADES SHALL BE USED WHEN APPLICABLE: CONES WILL NOT BE ALLOWED. TYPE I, TYPE II, AND TYPE III BARRICADES SHALL BE WEIGHTED IN A MANNER APPROVED BY THE MANUFACTURER SO THEY ARE NOT MOVED BY
- ANY EXISTING SIGNS DENOTED WITHIN THE PLAN SET THAT DO NOT APPLY TO THE REVISED TRAFFIC PATTERNS SHALL BE REMOVED OR COVERED AS DIRECTED BY THE ENGINEER. THE COVERING OR REMOVAL OF GROUND MOUNTED AND OVERHEAD SIGNS SHALL BE NON-DESTRUCTIVE IN NATURE, WILL NOT BE MEASURED FOR PAYMENT AND SHALL BE CONSIDERED INCLUDED IN THE CONTRACT UNIT PRICE OF "TRAFFIC CONTROL AND PROTECTION (EXPRESSWAYS)" AND "TRAFFIC CONTROL AND PROTECTION, (SPECIAL)"
- TEMPORARY CONCRETE BARRIER SHALL BE CONTINUOUSLY PINNED ALONG THE TRAFFIC SIDE WHERE A HAZARD EXISTS WITHIN 2 FEET BEHIND THE BARRIER. ANY REBAR IN CONFLICT WITH THE BARRIER WALL PINNING SHALL BE LANCED AT THE EXPENSE OF THE CONTRACTOR. PINNING OF THE TEMPORARY CONCRETE BARRIER WILL BE PAID FOR AT THE CONTRACT UNIT PRICE FOR "PINNING TEMPORARY CONCRETE BARRIER"
- 10. INSTALL POST MOUNTED VERTICAL PANELS WITH MONO-DIRECTIONAL STEADY BURNING LIGHTS ALONG THE SHOULDER WHEN TRAFFIC IS 3 FEET OR LESS FROM THE OUTSIDE EDGE OF SHOULDER. ALL TEMPORARY CONCRETE BARRIER INSTALLATIONS SHALL COMPLY WITH THE SAFETY ENGINEERING POLICY MEMORANDUM 4-21. SEE MEMO
- ADVANCE SIGNING PER IDOT DISTRICT 1 DETAIL TC-22 SHALL BE INCLUDED IN ADVANCE OF ROAD WORK IN BOTH DIRECTIONS ALONG RICHARDS STREET. THESE SIGNS WILL BE PAID FOR AT THE CONTRACT UNIT PRICE FOR "TEMPORARY INFORMATION SIGNING" OR "CHANGEABLE MESSAGE SIGN"
- 12. THE CONTRACTOR IS RESPONSIBLE FOR COORDINATING AND PROVIDING ACCESS POINTS TO THE WORK ZONE ACCESS POINTS MUST BE APPROVED BY THE ENGINEER PRIOR TO INSTALLATION AND MUST BE ACCORDING TO THE CONTRACT SPECIAL PROVISIONS AND DISTRICT 1 DETAIL TC-18. ANY SIGNING OR ADDITIONAL TRAFFIC CONTROL DEVICES REQUIRED TO PROVIDE CONTRACTOR ACCESS TO THE WORK ZONE IS INCLUDED IN THE COST OF "TRAFFIC CONTROL AND PROTECTION (EXPRESSWAYS)" AND "TRAFFIC CONTROL AND PROTECTION, (SPECIAL)" AND WILL NOT BE PAID FOR SEPARATELY. ACCOMMODATIONS AND PROVISIONS FOR ADDITIONAL ENTRANCES SHALL BE AT THE EXPENSE OF THE CONTRACTOR
- 13. SAW CUTTING WILL NOT BE MEASURED FOR PAYMENT SHALL BE CONSIDERED INCLUDED IN THE CONTRACT UNIT
- "RELOCATE TEMPORARY CONCRETE BARRIER" WILL BE MEASURED FOR PAYMENT WHEN THE BARRIER IS RELOCATED AND USED AS A TRAFFIC CONTROL DEVICE. THERE MAY BE SOME INSTANCES WHEN THE EXISTING FEMPORARY CONCRETE BARRIER REQUIRES RELOCATION DUE TO THE CONTRACTOR'S ACTIVITIES, BUT THE BARRIER WILL NOT BE USED FOR MAINTENANCE OF TRAFFIC DURING THAT STAGE. THIS BARRIER WILL NOT BE MEASURED OR PAYMENT UNTIL IT IS USED AS A TRAFFIC CONTROL DEVICE IN A SUBSEQUENT STAGE
- 15. THE CONTRACTOR SHALL CONTACT THE DISTRICT ONE ARTERIAL TRAFFIC CONTROL SUPERVISOR AT 847-705-4470 AND THE DISTRICT ONE EXPRESSWAY TRAFFIC CONTROL SUPERVISOR AT 847-705-4155 THREE BUSINESS DAYS IN ADVANCE OF BEGINNING WORK
- 16. THE CONTRACTOR SHALL NOTIFY THE DISTRICT ONE EXPRESSWAY OPERATIONS ENGINEER 14 DAYS IN ADVANCE OF ALL FULL STOPS AND STAGE CHANGES IN ACCORDANCE WITH THE KEOTT CONTRACT SPECIAL PROVISION.
- FOR CONSTRUCTION EXCAVATION REMOVAL LIMITS BETWEEN STAGES, THE CONTRACTOR SHALL NOT REMOVE AGGREGATE SUBGRADE BEHIND BARRIER WALL ADJACENT TO THE CUT LINE UNTIL THEY ARE READY TO CONSTRUCT SUBGRADE IMPROVEMENT.
- 18. THE CONTRACTOR IS DIRECTED TO THE FACT THAT OTHER SEPARATE CONTRACTS ARE, OR MAY BE, IN FORCE THAT INTERSECT THE LIMITS OF THIS PROJECT. THE CONTRACTOR SHALL COOPERATE WITH THE OTHER CONTRACTORS AND CCM IN THE PHASING AND PERFORMANCE OF THIS WORK SO AS NOT TO DELAY, INTERRUPT, OR HINDER THE PROGRESS OR COMPLETION OF THE WORK BEING PERFORMED BY OTHER CONTRACTORS. NO ADDITIONAL COMPENSATION WILL BE ALLOWED FOR COMPLIANCE WITH THE ABOVE REQUIREMENTS, NOR FOR ANY DELAYS OR INCONVENIENCES RESULTING FROM THE ACTIVITIES OF OTHER CONTRACTORS. SHOULD A CONFLICT ARISE BETWEEN THE CONTRACTORS WITH RESPECT TO SEQUENCE OF CONSTRUCTION OR MAINTENANCE OF TRAFFIC REQUIREMENTS, SAID CONFLICTS SHALL BE RESOLVED BY, OR AT THE DIRECTION OF THE ENGINEER
- 19. IMPLEMENTATION OF STAGES MAY HAVE RESTRICTIONS, AND THE CONTRACTOR SHALL REFER TO THE "WORK RESTRICTIONS" SPECIAL PROVISION FOR ADDITIONAL DETAILS
- 20. TEMPORARY PAVEMENT CROSS SLOPES SHALL MATCH THE CROSS SLOPE OF THE ADJACENT EXISTING OR PROPOSED PAVEMENT UNLESS OTHERWISE DIRECTED BY THE ENGINEER OR AS OTHERWISE SHOWN ON THE PLANS.
- ALL TEMPORARY PAVEMENT MARKINGS SHOWING DETERIORATION AFTER 7 DAYS SHALL BE REPLACED BY THE CONTRACTOR AS DIRECTED BY THE ENGINEER. SUFFICIENT QUANTITIES FOR ONE PLACEMENT AND ONE REPLACEMENT HAVE BEEN PROVIDED FOR EACH STAGE. ALL MARKINGS THAT REQUIRE REPLACEMENT AFTER THE FIRST REPLACEMENT SHALL BE REPLACED BY THE CONTRACTOR AT HIS OWN EXPENSE

- 22. THE CONTRACTOR IS RESPONSIBLE FOR COORDINATING THE PLACEMENT AND MESSAGES FOR ALL CHANGEABLE MESSAGE SIGNS WITH THE ENGINEER. THE FOLLOWING ANTICIPATED LOCATIONS FOR PORTABLE MESSAGE SIGNS ARE PROVIDED FOR INFORMATION ONLY: EB I-80, WB I-80, NB RICHARDS STREET, SB RICHARDS ST., 5TH AVENUE. CHANGEABLE MESSAGE SIGNS SHALL BE USED IN ADVANCE OF RAMP WORK. USE PCMS TO PROVIDE ADVANCED 2-WEEK NOTICE PRIOR TO BEGINNING OF WORK ALONG I-80, AND NEW TRAFFIC SIGNAL TURN-ON EVENTS TO WARN MOTORISTS OF UPCOMING EVENT. THE SIGNS SHALL BE RÉMOVED TWO WEEK THEREAFTER UNLESS THE SIGNS ARE NEEDED AGAIN FOR SUBSEQUENT FUTURE EVENT THAT WILL OCCUR WITHIN 2 WEEKS ON THE SAME APPROACH OF THE AFFECTED ROADWAY. THESE SIGNS WILL BE PAID FOR AT THE CONTRACT UNIT PRICE FOR "CHANGEABLE MESSAGE SIGN'
- 23. MOVING OPERATIONS ALONG I-80 PER IDOT STANDARD 701426 WILL NOT BE PERMITTED UNLESS AUTHORIZED BY THE EXPRESSWAY TRAFFIC OPERATIONS ENGINEER.
- THE CONTRACTOR SHALL INSTALL AND MAINTAIN PROPOSED AND TEMPORARY DRAINAGE SYSTEMS AND EROSION CONTROL MEASURES DURING STAGE CONSTRUCTION THROUGHOUT THE DURATION OF THE PROJECT. THIS WORK SHALL BE INCLUDED IN THE COST OF THE PAY ITEMS ASSOCIATED WITH THE APPLICABLE DRAINAGE SYSTEMS AND EROSION CONTROL MEASURES. SEE TEMPORARY DRAINAGE AND EROSION CONTROL PLANS
- 25. TRAFFIC CONDITIONS, CRASHES, AND OTHER UNFORESEEN EMERGENCY CONDITIONS MAY REQUIRE THE ENGINEER TO RESTRICT, MODIFY, OR REMOVE LANE CLOSURES OR CHANNELIZATION SHOWN ON THE PLANS. THE CONTRACTOR SHALL MAKE THE NECESSARY ADJUSTMENTS AS DIRECTED BY THE ENGINEER WITHOUT DELAY COMPLIANCE WITH THIS REQUIREMENT SHALL BE CONSIDERED INCLUDED IN THE CONTRACT UNIT PRICE OF THE TRAFFIC CONTROL AND PROTECTION ITEMS. NO ADDITIONAL COMPENSATION WILL BE ALLOWED.
- 26. THE MAINTENANCE OF TRAFFIC PLANS SHALL SERVE AS A GUIDE FOR THE SAFE DIVERSION OF TRAFFIC DURING EXECUTION OF THIS CONTRACT. THE CONTRACTOR MAY MODIFY THE MAINTENANCE OF TRAFFIC PLANS TO MEET CONSTRUCTION NEEDS BUT NOT AT THE EXPENSE OF PUBLIC SAFETY OR CONVENIENCE, ANY CHANGES TO THE TRAFFIC CONTROL SHALL BE SUBMITTED TO THE ENGINEER FOR REVIEW AND APPROVAL. THE ENGINEER SHALL BE INFORMED IN WRITING A MINIMUM OF 48 HOURS IN ADVANCE OF ANY CHANGE TO THE MAINTENANCE OF TRAFFIC PLANS.
- 27. TRAFFIC CONTROL DEVICES INCLUDING, BUT NOT LIMITED TO: DRUMS, VERTICAL PANELS, AND BARRICADES IMMEDIATELY ADJACENT TO THE EDGE OF TRAVELED WAY SHALL BE EQUIPPED WITH LIGHTS PER STANDARD SPECIFICATIONS ARTICLE 701.16, UNLESS OTHERWISE INDICATED.
- 28. TYPE II BARRICADES SHALL BE USED IN LIEU OF DRUMS IN LOCATIONS WHERE TYPE II MUST BE PLACED IN EXCAVATED AREAS DUE TO LIMITED SPACE. THESE BARRICADES SHALL HAVE LEG EXTENSIONS INSTALLED SUCH THAT THE TOP OF THE BARRICADE IS IN COMPLIANCE WITH IDOT HIGHWAY STANDARD 701901. DRUMS AND BARRICADES SHALL NOT BE PLACED TOGETHER WITHIN AN INDIVIDUAL RUN OF DEVICES.
- 29. TEMPORARY CONCRETE BARRIERS SHALL BE EQUIPPED WITH TYPE "C" REFLECTORS, IN ACCORDANCE WITH HIGHWAY STANDARDS 704001 AND 782006.
- THE CONTRACTOR SHALL INSTALL AND COVER ALL TEMPORARY SIGNING BEFORE EXISTING SIGNS ARE REMOVED THE CONTRACTOR SHALL RELOCATE EXISTING SIGNS AS INDICATED ON THE PLANS. THIS WORK SHALL NOT BE PAID FOR SEPARATELY BUT IS INCLUDED IN "TRAFFIC CONTROL AND PROTECTION (EXPRESSWAYS) AND "TRAFFIC
- 31. THE CONTRACTOR SHALL INSTALL AND COVER ALL PERMANENT SIGNING BEFORE TEMPORARY SIGNS ARE REMOVED. THE COST OF THIS WORK SHALL BE INCLUDED IN THE COST FOR SIGN PANEL, OF THE TYPE SPECIFIED.
- ALL EXISTING GUIDE SIGNS (I.E. STREET NAME SIGNS, ADVANCE STREET NAME SIGNS, ROUTE MARKERS, ETC.) SHALL BE MAINTAINED AND VISIBLE TO TRAFFIC DURING CONSTRUCTION
- 33. ALL STATIONS AND OFFSETS ARE PROVIDED FROM THE PROPOSED SHEET BASELINE UNLESS OTHERWISE NOTED
- 34. PRIOR TO INSTALLING ANY POST MOUNTED SIGNS, THE CONTRACTOR SHALL CONTACT J.U.L.I.E. AND IDOT DISTRICT 1 EMC TO LOCATE ANY IDOT FACILITIES.
- 35. ADD TEMPORARY PAVEMENT MARKING LINE 6" TO TEMPORARY AND PROPOSED CONCRETE BARRIER WHEN 1 -FOOT OR LESS FROM PAVEMENT MARKING LINE.
- 36. DROP-OFFS ADJACENT TO THE TRAVEL LANE SHALL BE KEPT TO A MINIMUM. PROTECTION OF THE DROP-OFF SHALL BE ACCORDING TO THE IDOT BUREAU OF SAFETY PROGRAMS AND ENGINEERING, SAFETY ENGINEERING POLICY MEMORANDUM 4-21. TEMPORARY CONCRETE BARRIER WALL IS SHOWN ON THE PLANS WHERE THE DROP-OFF REQUIREMENTS FOR USING BARRICADES CANNOT BE MET. THE CONTRACTOR SHALL BE RESPONSIBLE FOR ENSURING THAT THE DROP-OFFS ALONG THE REMAINING AREAS MEET THE OFFSET, HEIGHT, AND DURATION REQUIREMENTS TO USE BARRICADES. THIS MAY REQUIRE THE CONTRACTOR TO REPLACE OR PLACE SUFFICIENT MATERIAL IN THE EXCAVATION TO REDUCE THE DROP-OFF TO BE COMPLIANT WITH THE REQUIREMENTS FOR USE OF BARRICADES. NO ADDITIONAL COMPENSATION SHALL BE ALLOWED TO COMPLY WITH THIS REQUIREMENT.
- PAVEMENT MARKING TAPE, TYPE IV SHOWN ON THE PLANS FOR ANY CONSTRUCTION STAGE THAT THE CONTRACTOR PROPOSED TO EXTEND OVER THE WINTER PERIOD SHALL MEAN MODIFIED URETHANE PAVEMENT MARKING AND WILL BE PAID FOR THEIR RESPECTIVE UNIT PRICE.
- TEMPORARY INFORMATION SIGNS ON TEMPORARY SUPPORTS SHALL BE PROVIDED FOR ALL COMMERCIAL DRIVEWAYS THAT ARE LOCATED WITHIN A WORK AREA. THIS WORK SHALL BE PAID FOR PER D1 DETAIL TC-26. THESE SIGNS SHALL BE RELOCATED AS REQUIRED FOR EACH CONSTRUCTION STAGE AND SHALL BE PLACED AS DIRECTED BY THE ENGINEER. THE SIGN RELCATION WORK WILL NOT BE PAID FOR SEPARATELY AND SHALL BE INCLUDED IN THE CONTRACT UNIT PRICE PER SQUARE FOOT FOR TEMPORARY INFORMATION SIGNING.
- 39. THE "ROAD CONSTRUCTION AHEAD" SIGNS SHALL REMAIN INSTALLED UNTIL THE COMPLETION OF THE PROJECT OR WHEN NO ROADWAY HAZARDS REMAIN WITHIN THE WORK ZONE
- 40. SEE FOLLOWING SHEET FOR ADDITIONAL MAINTENANCE OF TRAFFIC GENERAL NOTES

# MAINTENANCE OF TRAFFIC STAGING DESCRIPTION

#### I-80 DES PLAINES RIVER BRIDGE REPAIR STAGE I AND II

#### CONSTRUCTION

1. CONSTRUCT THE I-80 DES PLAINES RIVER BRIDGE REPAIRS AS SHOWN IN THE PLANS

#### TRAFFIC

- 1. I-80 LANE CLOSURES, INCLUDING THOSE SHOWN IN THE PLANS, TO COMPLETE THE DES PLAINES RIVER BRIDGE REPAIRS WILL ONLY BE PERMITTED DURING THE ALLOWABLE LANE CLOSURE HOURS SHOWN IN THE KEEPING THE EXPRESSWAY OPEN TO TRAFFIC SPECIAL PROVISION.
- 2. RICHARDS STREET ENTRANCE AND EXIT RAMPS TO/FROM I-80 ARE TO BE CLOSED AS NOTED IN RICHARDS STREET STAGE 1.
- 3. CENTER ST AND CHICAGO ST ENTRANCE AND EXIT RAMPS TO/FROM I-80 ARE TO REMAIN OPEN.

#### RICHARDS STREET PRE-STAGE

#### CONSTRUCTION

- 1. CONSTRUCT TEMPORARY PAVEMENT AT THE SOUTH MEDIAN AS SHOWN IN THE PLANS
- 2. PERFORM PAVEMENT PATCHING ALONG NORTHBOUND RICHARDS STREET. PAVEMENT PATCHES ARE RESTRICTED TO OFF-PEAK HOURS. SEE "KEEPING ARTERIAL ROADWAYS OPEN TO TRAFFIC (LANE CLOSURES ONLY)" FOR OFF-PEARK HOURS.

- 1. REDUCE TRAFFIC TO ONE LANE IN EACH DIRECTION AS TRAFFIC APPROACHES WORK ZONE AREA, AS SHOWN IN THE PLANS.
- 2. RAMPS ARE OPEN

# RICHARDS STREET STAGE 1: CONSTRUCTION

- 1. CONSTRUCT PROPOSED SOUTHBOUND BRIDGE, PAVEMENT, CURB AND GUTTER, SIDEWALK, AND RAISED MEDIAN, AS SHOWN IN THE PLANS.
- 2. CONSTRUCT PROPOSED RAMPS A AND D, AS SHOWN IN THE PLANS.

- 1. SHIFT TRAFFIC LANES TO THE NORTHBOUND EXISTING PAVEMENT
- 2. CLOSE RAMPS. ALL RAMPS ARE CLOSED. IMPLEMENT DETOUR ROUTES FOR ALL RAMPS AND 5TH AVENUE SEE MOT PLANS AND DETOUR SHEETS.
- 3. CLOSE SOUTHBOUND SIDEWALK. KEEP EXISTING NORTHBOUND SIDEWALK OPEN FOR PEDESTRIANS ALONG NORTHBOUND EXISTING PAVEMENT.

#### **RICHARDS STREET STAGE 2:**

#### CONSTRUCTION

- 1. CONSTRUCT PROPOSED NORTHBOUND BRIDGE, PAVEMENT, CURB AND GUTTER, SIDEWALK, NOISE ABATEMENT WALLS, AND RAISED MEDIAN, AS SHOWN IN THE PLANS. SEE SPECIAL PROVISIONS FOR NOISE ABATEMENT WALL CONSTRUCTION WORK
- 2. CONSTRUCT PROPOSED RAMPS B AND C, AS SHOWN IN THE PLANS.

#### **TRAFFIC**

- 1 SHIFT TRAFFIC LANES TO THE SOUTHBOUND PROPOSED PAVEMENT
- 2. RE-OPEN 5TH AVENUE. ALL RAMPS REMAIN CLOSED. SEE MOT PLANS AND DETOUR SHEETS.
- 3. CLOSE NORTHBOUND SIDEWALK. OPEN PROPOSED SIDEWALK FOR PEDESTRIAN ACCESS ALONG SOUTHBOUND PROPOSED PAVEMENT
- 4. CONTRACTOR TO ACCESS NOISE ABATEMENT WALL WORK ZONE VIA LINDEN AVENUE, RICHARDS STREET AND/OR CLOSED RAMPS, UTILIZING APPLICABLE STANDARDS AND DETAILS, INCLUDING 701001, 701006, 701501, AND TC-10

#### RICHARDS STREET STAGE 3:

## CONSTRUCTION

- 1. CONSTRUCT MEDIAN AT BRIDGE, AS SHOWN IN THE PLANS.
- 2. LANDSCAPING AND RESTORATION WORK IN THE MEDIAN OF RICHARDS STREET IS RESTRICTED TO OFF-PEAK HOURS. SEE "KEEPING ARTERIAL ROADWAYS OPEN TO TRAFFIC (LANE CLOSURES ONLY)" FOR OFF-PEARK HOURS.
- 3. PLACE HMA SURFACE COURSE ON RICHARDS STREET.

#### TRAFFIC

SCALE:

- 1. REDUCE TRAFFIC TO ONE LANE IN EACH DIRECTION AS TRAFFIC APPROACHES WORK ZONE AREA, AS SHOWN IN THE PLANS.
- 2. OPEN RAMPS A, B, C, AND D, ALL RAMPS ARE OPEN, AS SHOWN IN PLANS.
- REDUCE LEFT TURN LANE ON RAMP A TO ONE LEFT TURN LANE, AS SHOWN IN THE PLANS.
- 4. INSIDE AND OUTSIDE LANE CLOSURES SHALL BE ALTERNATED SÚCH THAT WORK ONLY OCCURS ON ONE SIDE OF THE TRAVELLED WAY.




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PLOT DATE = 2/15/2024	DATE -		REVISED	-

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		RICHA	RDS ST	F.A.U. RTE				TOTAL SHEETS	ľ		
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SHEET NO.

# MAINTENENCE OF TRAFFIC GENERAL NOTES (CONTINUED) AND TEMPORARY PAVEMENT DETAIL

# TEMPORARY CONCRETE BARRIER PINNING CRITERIA

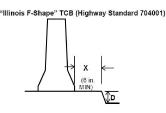

D			X (Distance Behind T	CB)	
(Drop-off)	X < 6 in.	6 in. ≤ X < 12 in.	12 in. ≤ X < 24 in.	24 in. ≤ X < 37 in.	37 in. ≤ X
> 2 in., except as below	Not Allowed	Pinned	Subject to Results of Risk Assessment	Not Pinned	Not Pinned
Edge of Bridge Deck, Approach Slab or similar	Not Allowed	Pinned	Pinned	Pinned	Not Pinned

# DROP-OFF BETWEEN TRAVEL LANES

	> 1.5 (38) to 2.5 (64)		n/a	UNEVEN <sup>67</sup> LANES Signs
	LITT OT HIMA	> 2.5 (64) to 4 (100)	Notched wedge <sup>3/</sup> longitudinal joint	UNEVEN 6/ LANES Signs
< 45 mph	Milled Edge or Vertical Edge	> 1.5 (38) to 4 (100)	Temporary wedge or <sup>3/</sup> tapered edge, 1:3 min.	UNEVEN 6/ LANES Signs
	All	> 4 (100) to 12 (300) 2/	Lane closure with 4/ channelizing devices	n/a
	All	> 12 (300)	Lane closure with temp. <sup>5/</sup> longitudinal traffic barrier	n/a

# RICHARDS STREET TEMPORARY PAVEMENT DETAIL


10" FULL DEPTH TEMPORARY HMA PAVEMENT

4" SUBBASE GRANULAR MATERIAL

8" TEMPORARY PCC PAVEMENT

4" SUBBASE GRANULAR MATERIAL TYPE B

# TYPICAL SECTIONS

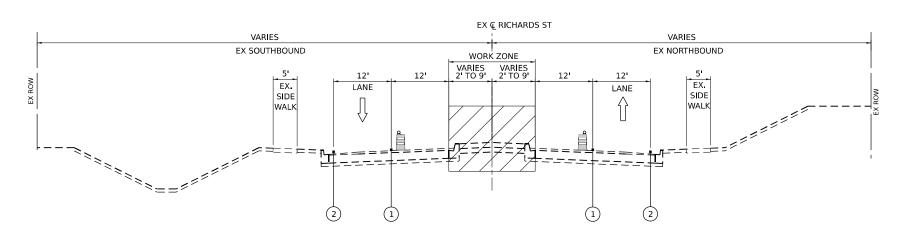

# PRE-STAGE

(LOOKING NORTH) STA. 47+50 TO STA. 50+30

# **STAGING LEGEND**



TEMPORARY PAVEMENT



DIRECTION OF TRAFFIC EXISTING GUARDRAIL



TRAFFIC DRUM WITH LIGHTS ACCORDING TO ART, 701.16

TEMPORARY CONCRETE BARRIER WITH TYPE C REFLECTORS PER STD 704001 AND 782006



- (A) EXISTING PAVEMENT MARKING
- B PAVEMENT MARKING PREVIOUSLY PLACED
- © PROPOSED PAVEMENT MARKING
- 1) TEMPORARY PAVEMENT MARKING LINE 4" TYPE IV TAPE (SOLID YELLOW) (70307120)
- 2 TEMPORARY PAVEMENT MARKING LINE 4" TYPE IV TAPE (SOLID WHITE) (70307120)
- 3 TEMPORARY PAVEMENT MARKING LINE 4" TYPE IV TAPE (WHITE, 2' DASH, 6' SKIP) (70307120)
- 4 TEMPORARY PAVEMENT MARKING LINE 4" TYPE IV TAPE (DOUBLE YELLOW AT 11" C-C) (70307120)

- 5 TEMPORARY PAVEMENT MARKING LINE 6" TYPE IV TAPE (SOLID WHITE) (70307130)
- (6) TEMPORARY PAVEMENT MARKING LINE 8" TYPE IV TAPE (WHITE GORE LINE) (70307140)
- 7) TEMPORARY PAVEMENT MARKING LINE 12" TYPE IV TAPE (YELLOW DIAGONAL @ 75' C-C) (70307160)
- (8) TEMPORARY PAVEMENT MARKING LINE 12" TYPE IV TAPE (WHITE DIAGONAL @ 75' C-C) (70307160)
- 9 TEMPORARY PAVEMENT MARKING LINE 12" TYPE IV TAPE (WHITE CHEVRON @ 30' C-C) (70307160)
- (10) TEMPORARY PAVEMENT MARKING LINE 24" TYPE IV TAPE (SOLID WHITE) (70307210)
- (11) TEMPORARY PAVEMENT MARKING LETTERS AND SYMBOLS TYPE IV TAPE (70307100)




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	DRAWN -	MQ	REVISED	-
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PLOT DATE = 1/25/2024	DATE -		REVISED	-

# STATE OF ILLINOIS **DEPARTMENT OF TRANSPORTATION**

			RICHA	RDS ST	REET			
	SUGGESTE	D MAIN	NTENANCE	OF TRA	FFIC -	- TYPICAL SI	ECTIONS	_
SCALE:		SHEET	OF	SHEETS	STA.	TO	STA.	-

F.A.U. RTE	SECTION		COUNTY	TOTAL SHEETS	SHEET NO.
354	99-4B-2-BR	99-4B-2-BR		320	62
·		CONTRACT	NO. 62	380	
	ILLINOIS FE	D. Al	D PROJECT		

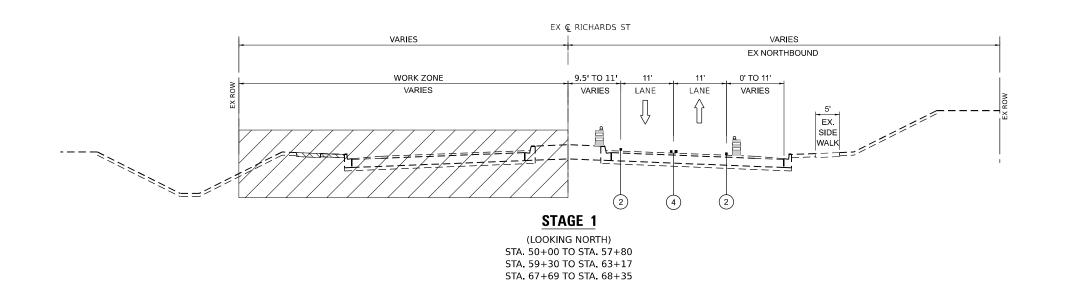

FOR BRIDGE TYPICALS SEE STRUCTURAL PLAN SHEETS.

ALL RAMPS AND ASSOCIATED TURN LANES CLOSED DURING THIS STAGE.


SOUTHBOUND SIDEWALK CLOSED DURING THIS STAGE.

# **STAGING LEGEND**




TEMPORARY PAVEMENT

EXISTING GUARDRAIL

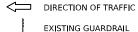

TRAFFIC DRUM WITH LIGHTS ACCORDING TO ART, 701.16 UNLESS OTHERWISE INDICATED

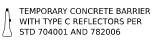



- (A) EXISTING PAVEMENT MARKING
- B PAVEMENT MARKING PREVIOUSLY PLACED
- © PROPOSED PAVEMENT MARKING
- 1) TEMPORARY PAVEMENT MARKING LINE 4" MODIFIED URETHANE (SOLID YELLOW) (70303120)
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- (3) TEMPORARY PAVEMENT MARKING LINE 4" MODIFIED URETHANE (WHITE, 2' DASH, 6' SKIP) (70303120)
- TEMPORARY PAVEMENT MARKING LINE 4" MODIFIED URETHANE (DOUBLE YELLOW AT 11" C-C) (70303120)

- 5 TEMPORARY PAVEMENT MARKING LINE 6" MODIFIED URETHANE (SOLID WHITE) (70303130)
- 6 TEMPORARY PAVEMENT MARKING LINE 8" MODIFIED URETHANE (WHITE GORE LINE) (70303140)
- 7 TEMPORARY PAVEMENT MARKING LINE 12" MODIFIED URETHANE (YELLOW DIAGONAL @ 75' C-C) (70303160)
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- (10) TEMPORARY PAVEMENT MARKING LINE 24" MODIFIED URETHANE (SOLID WHITE) (70303210)
- (11) TEMPORARY PAVEMENT MARKING LETTERS AND SYMBOLS MODIFIED URETHANE (70303100)





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STATE OF ILLINOIS **DEPARTMENT OF TRANSPORTATION** 

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SECTION COUNTY 99-4B-2-BR WILL 320 63 CONTRACT NO. 62380



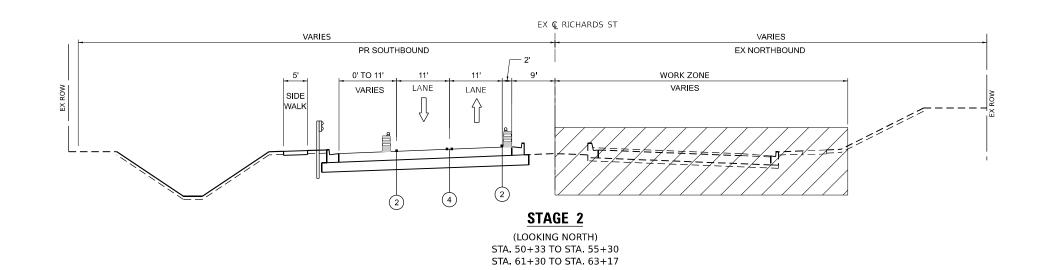

# **STAGING LEGEND**

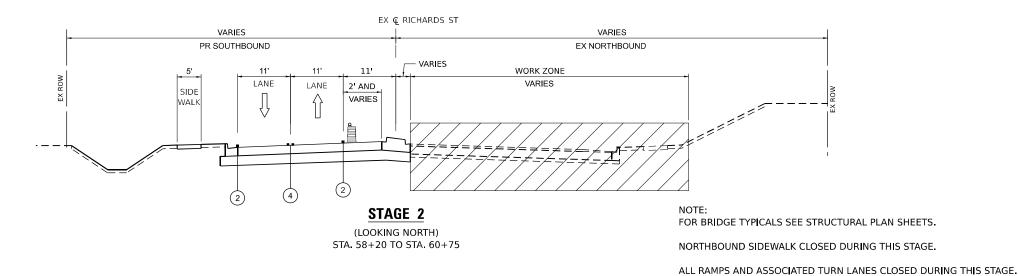




TEMPORARY PAVEMENT



DIRECTION OF TRAFFIC EXISTING GUARDRAIL



TRAFFIC DRUM WITH LIGHTS ACCORDING TO ART, 701.16 UNLESS OTHERWISE INDICATED

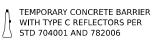



- (A) EXISTING PAVEMENT MARKING
- B PAVEMENT MARKING PREVIOUSLY PLACED
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- 1) TEMPORARY PAVEMENT MARKING LINE 4" TYPE IV TAPE (SOLID YELLOW) (70307120)
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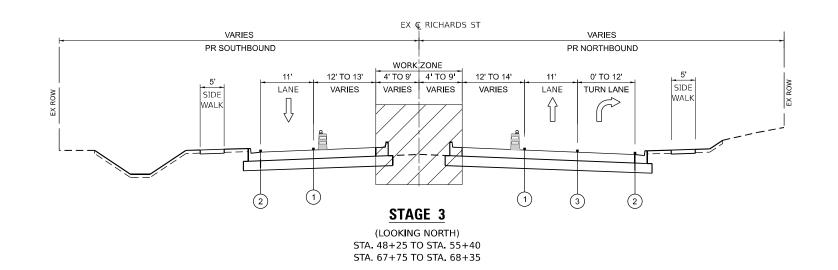



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# STATE OF ILLINOIS **DEPARTMENT OF TRANSPORTATION**

		RICHA	ARDS ST	REET		F.A.U. RTE	SECTION
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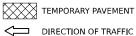




FOR BRIDGE TYPICALS SEE STRUCTURAL PLAN SHEETS.

# **STAGING LEGEND**

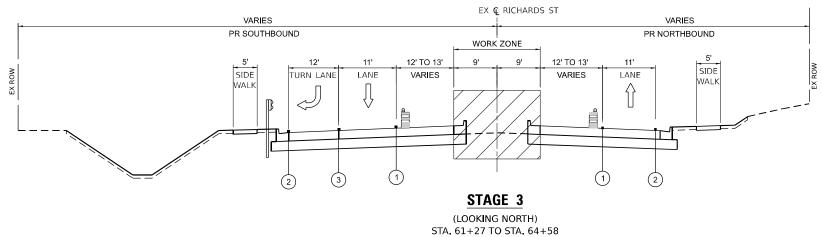




DIRECTION OF TRAFFIC EXISTING GUARDRAIL



TRAFFIC DRUM WITH LIGHTS ACCORDING TO ART, 701.16 UNLESS OTHERWISE INDICATED

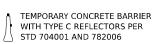



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- B PAVEMENT MARKING PREVIOUSLY PLACED
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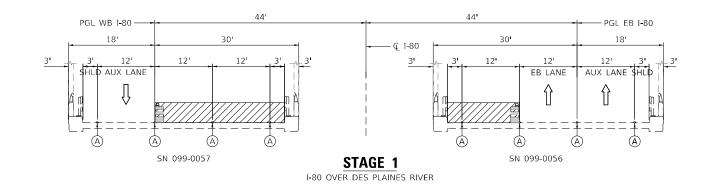
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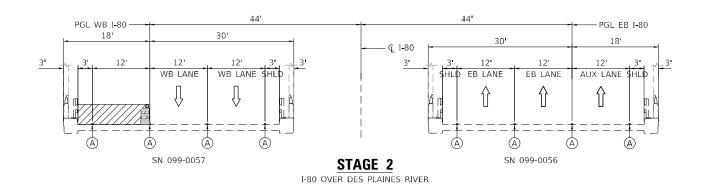


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# STATE OF ILLINOIS **DEPARTMENT OF TRANSPORTATION**

			RICH	ARDS ST	REET		F.A.U. RTE	SECT	ION		COUNTY	TOTAL SHEETS	SHEET NO.
1	SUGGESTED MAINTENANCE OF TRAFFIC – TYPICAL SECTIONS					354 99-4B-2-BR WILL		320	65				
		LD MAIN	LIVAIVOL	. 01 1117	1110	- III JUAL SEUTJONS					CONTRACT	NO. 62	380
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# NOTES

1. WORK ON THE EB AND WB LANES IN STAGE 1 CAN BE DONE CONCURRENTLY OR INDEPENDENTLY.

# STAGING LEGEND



WORK AREA



DIRECTION OF TRAFFIC



EXISTING GUARDRAIL




WITH LIGHTS ACCORDING TO
ART. 701.16 UNLESS OTHERWISE INDICATED







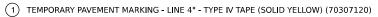

- 2 TEMPORARY PAVEMENT MARKING LINE 4" TYPE IV TAPE (SOLID WHITE) (70307120)
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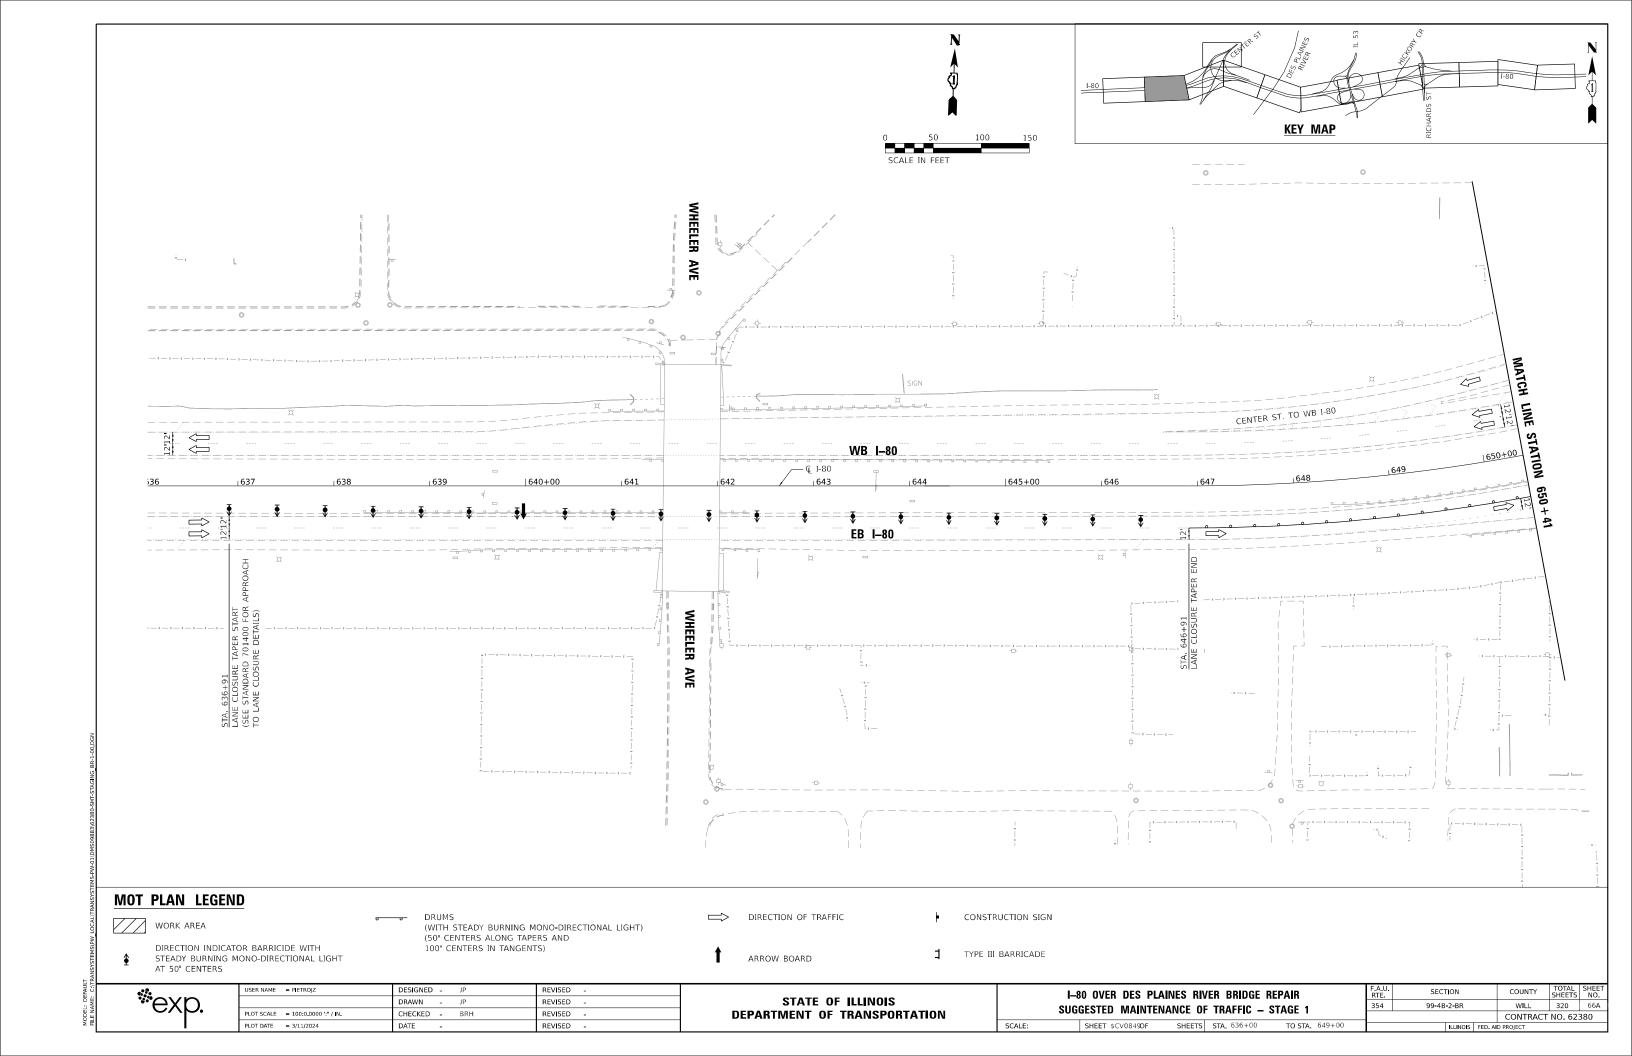



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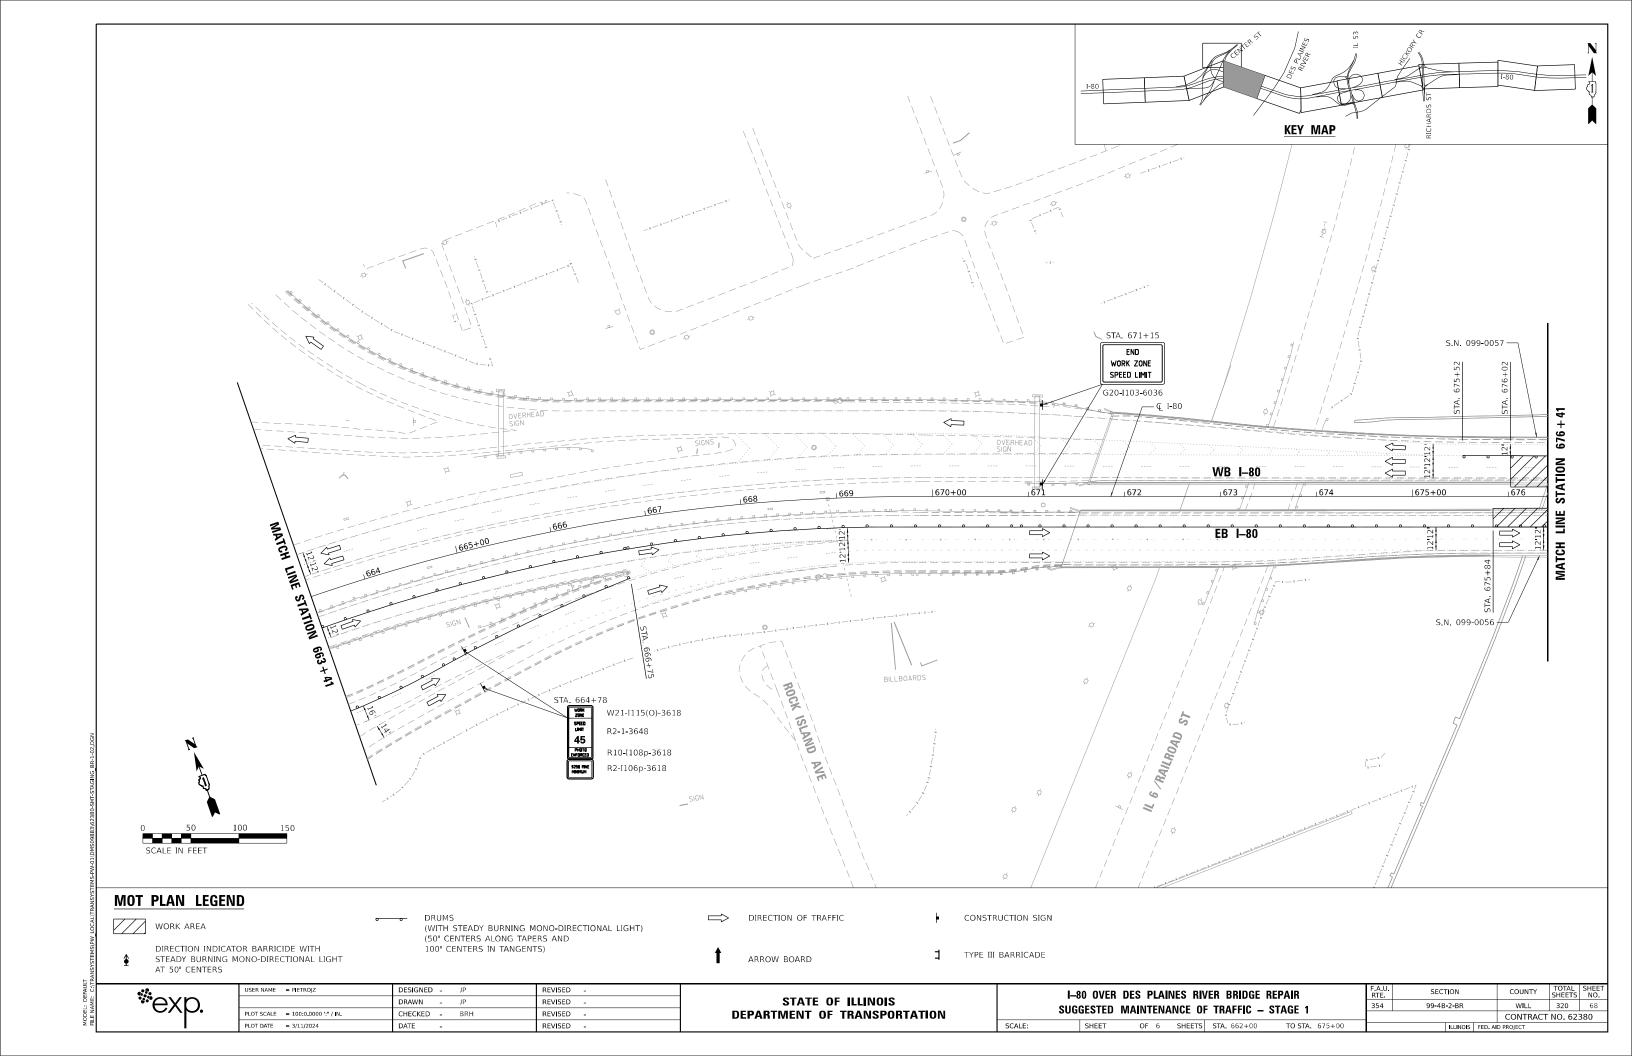
# STATE OF ILLINOIS **DEPARTMENT OF TRANSPORTATION**


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SCALE:	SHEET	OF	SHEETS	STA.	TO STA.


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		CONTRACT NO. 62380					
ILLINOIS FED AID PROJECT							







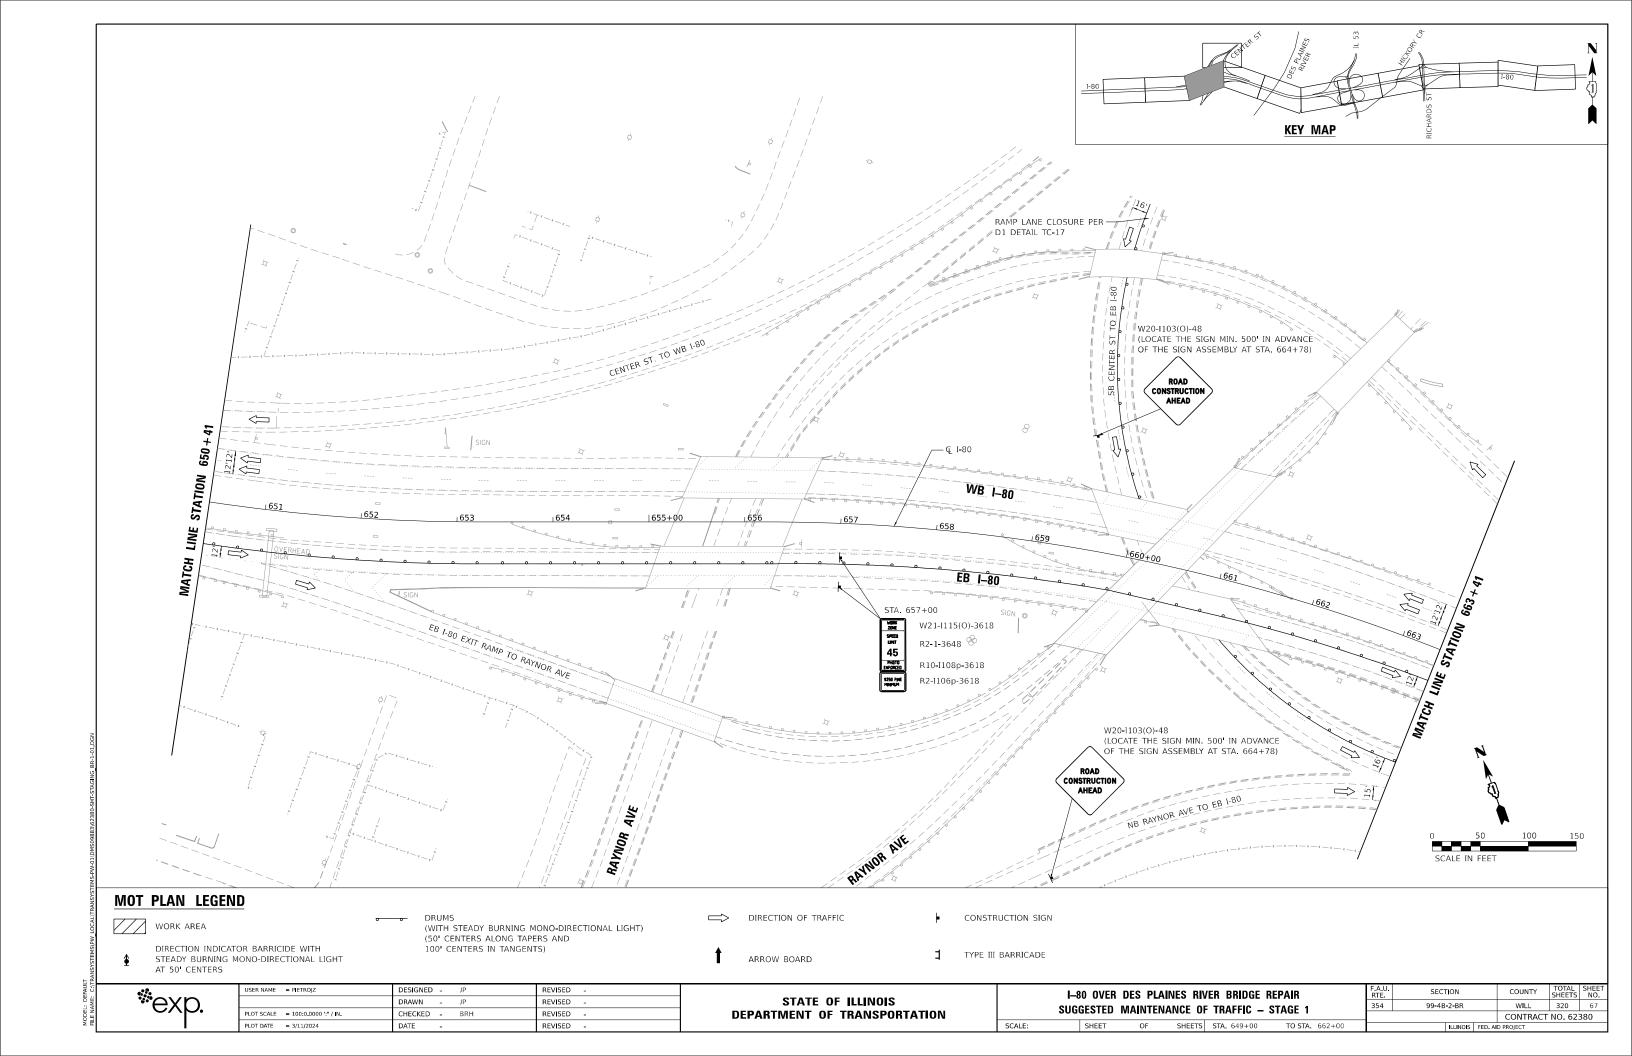


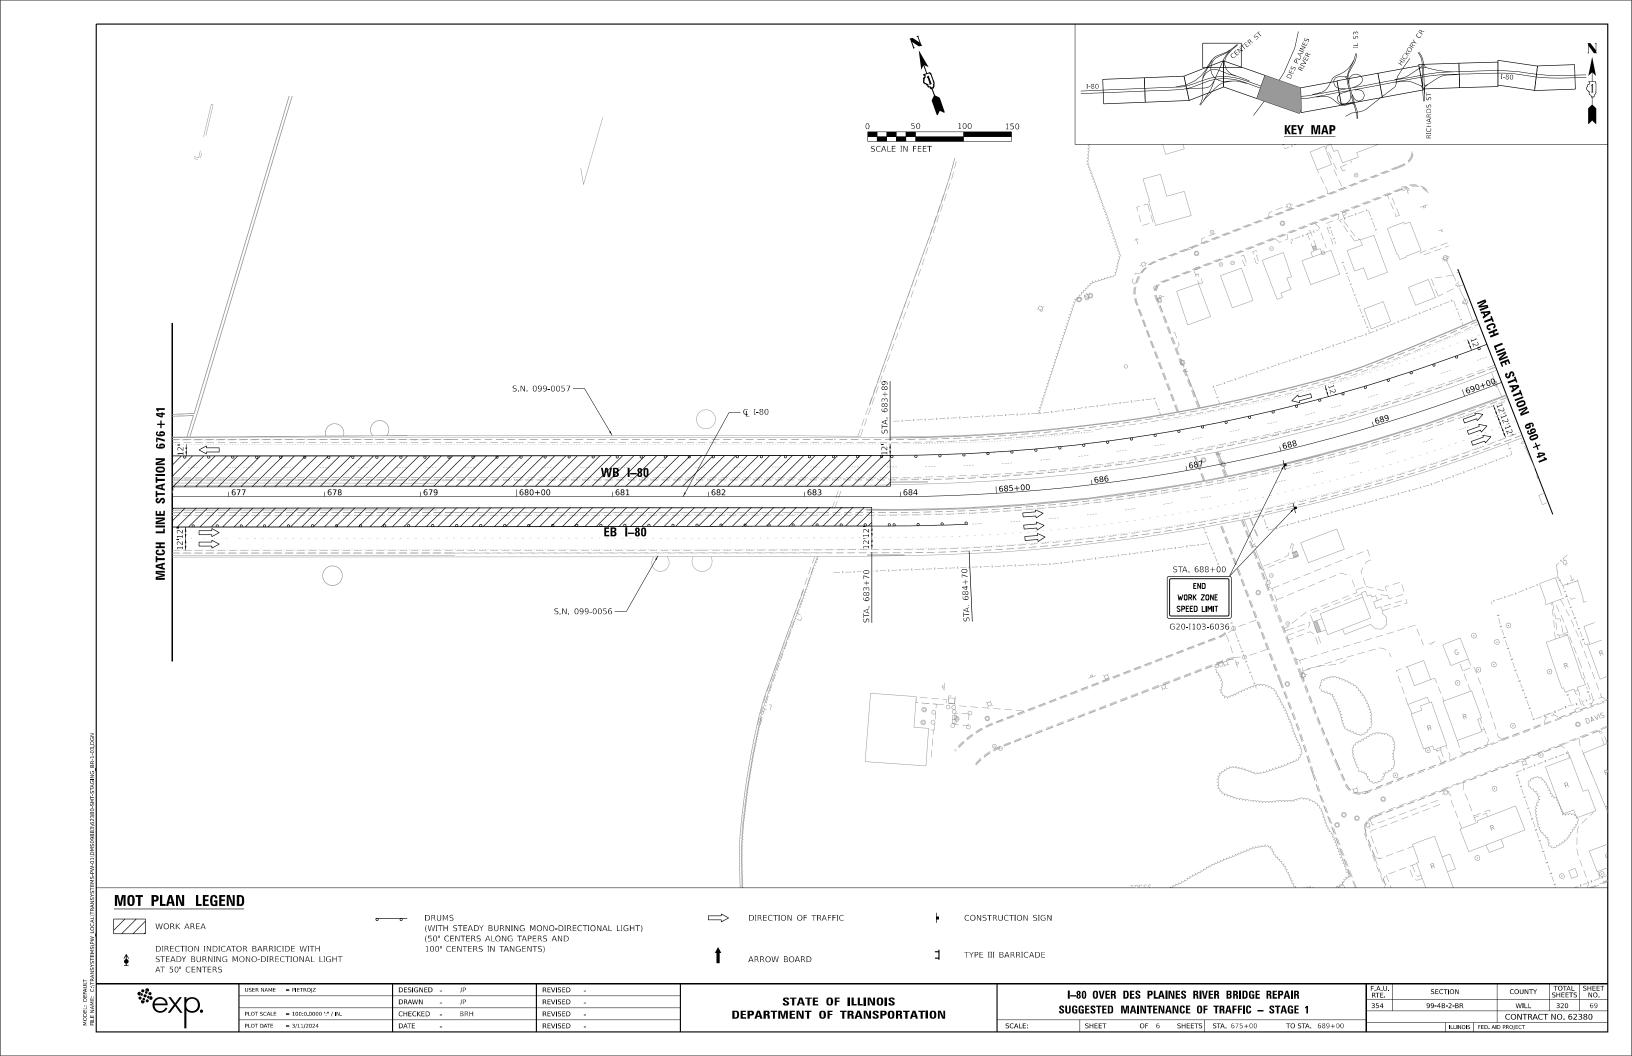


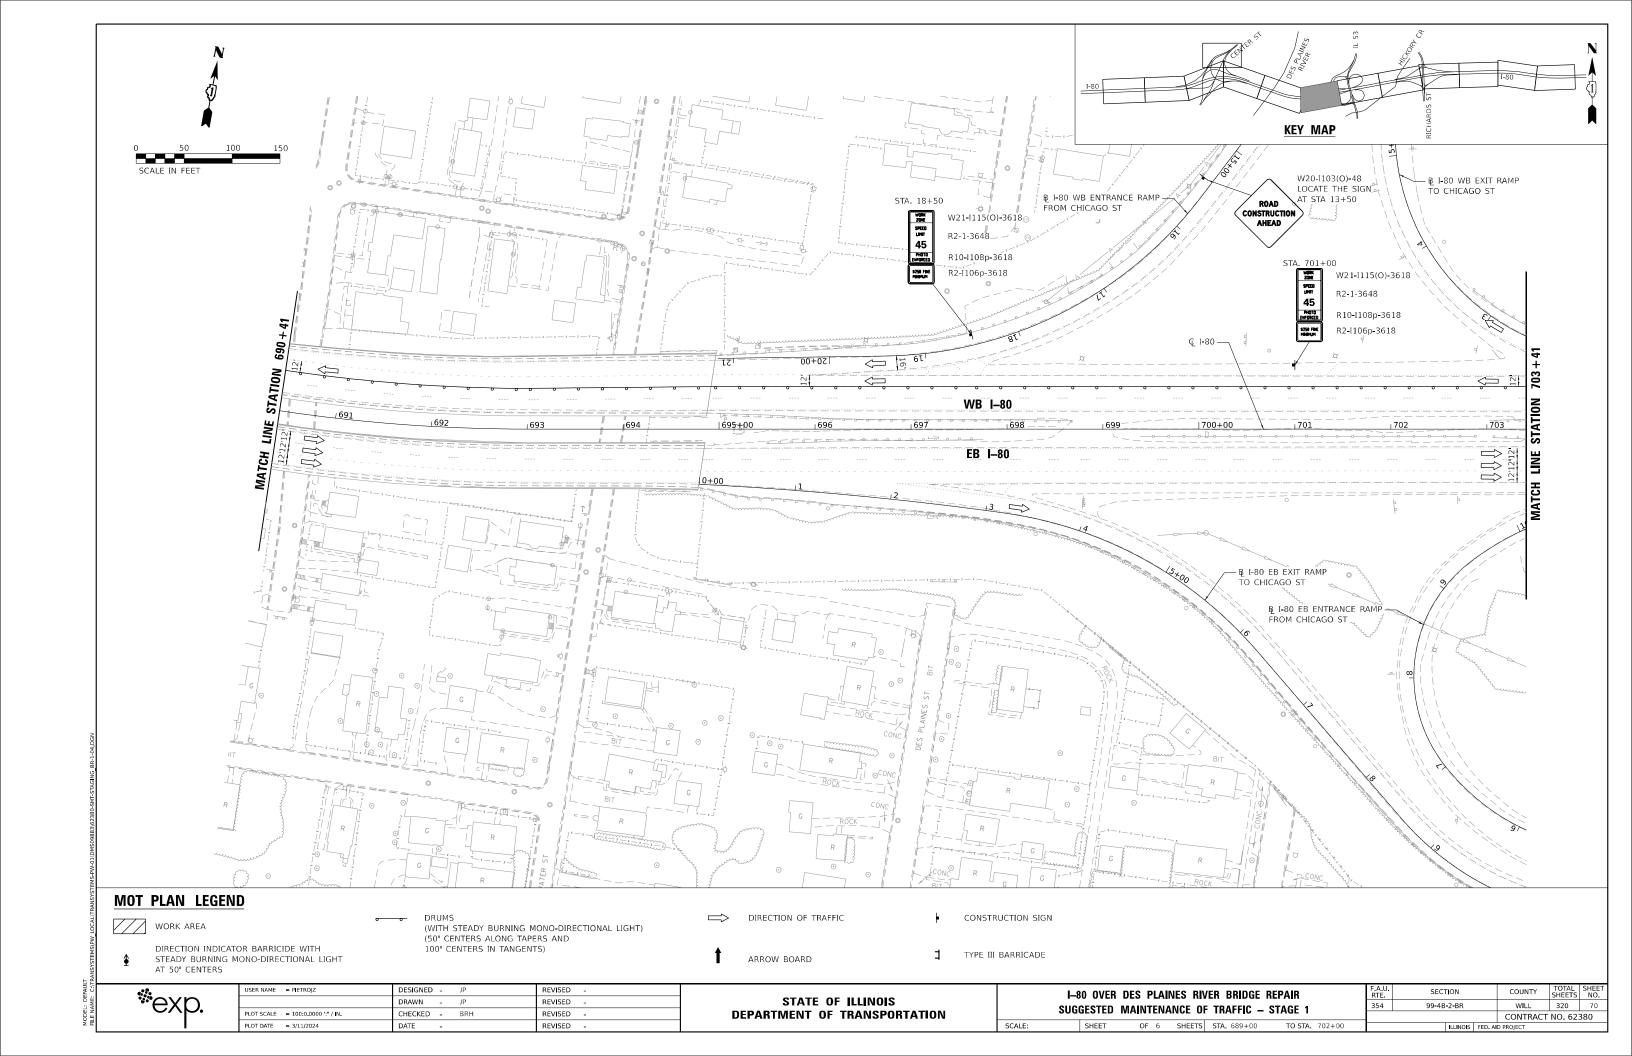


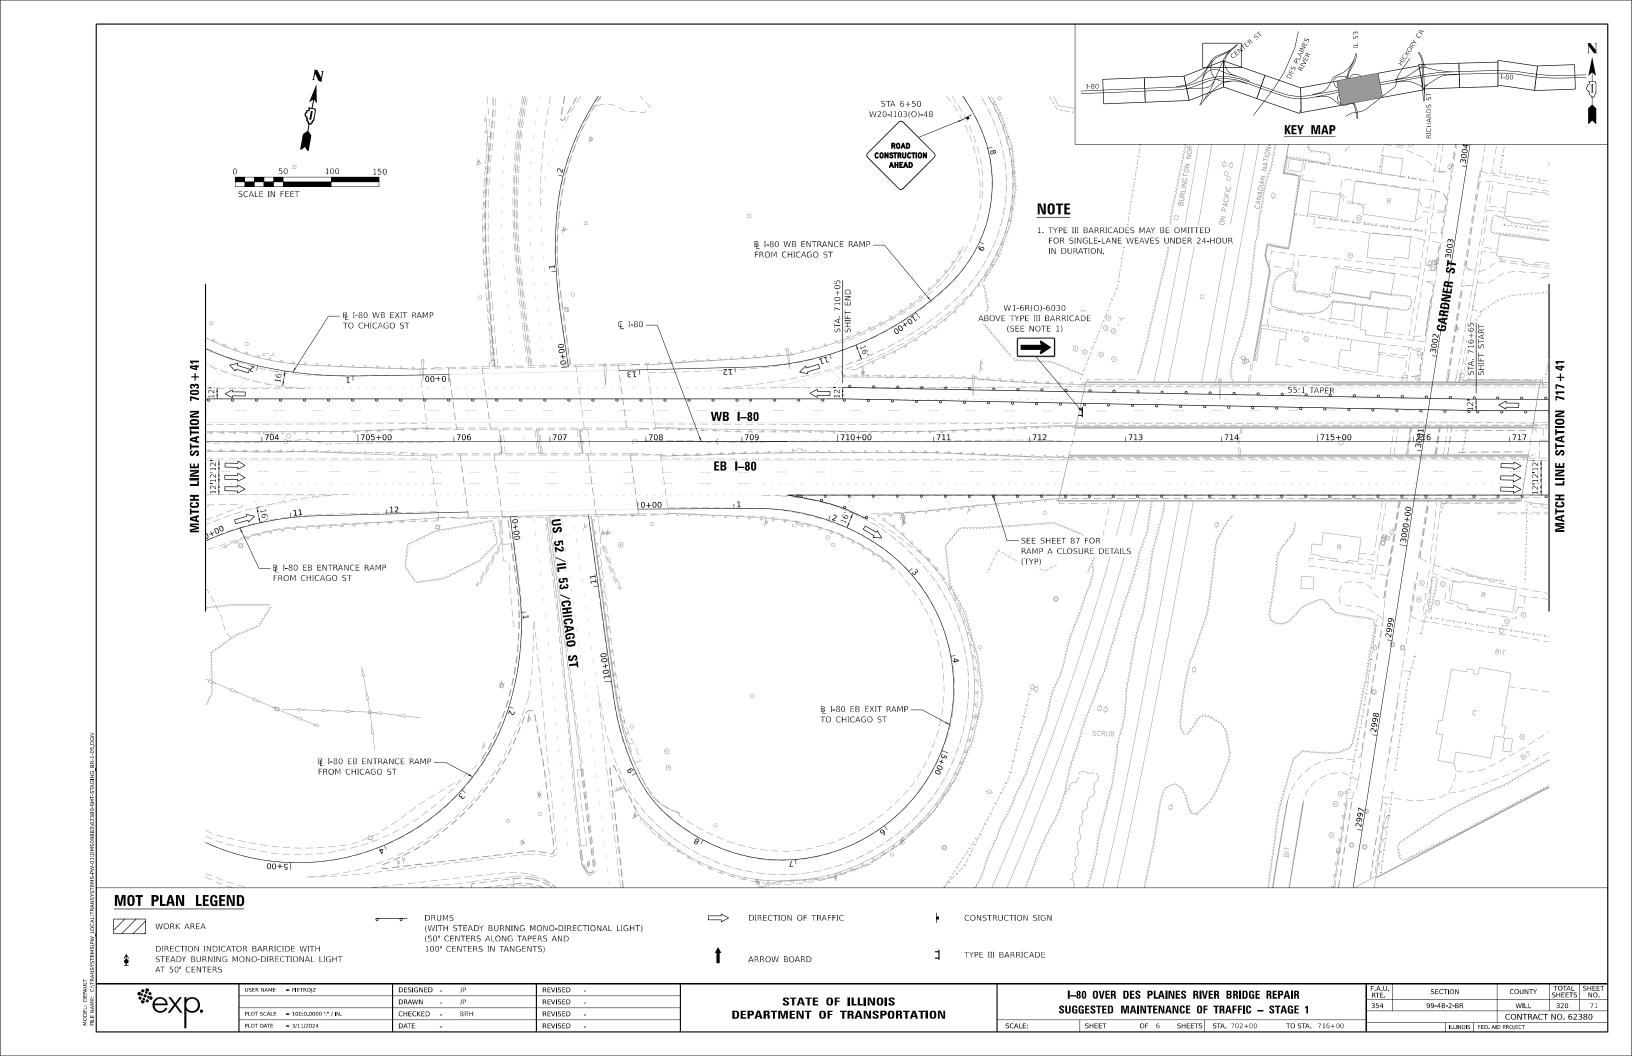


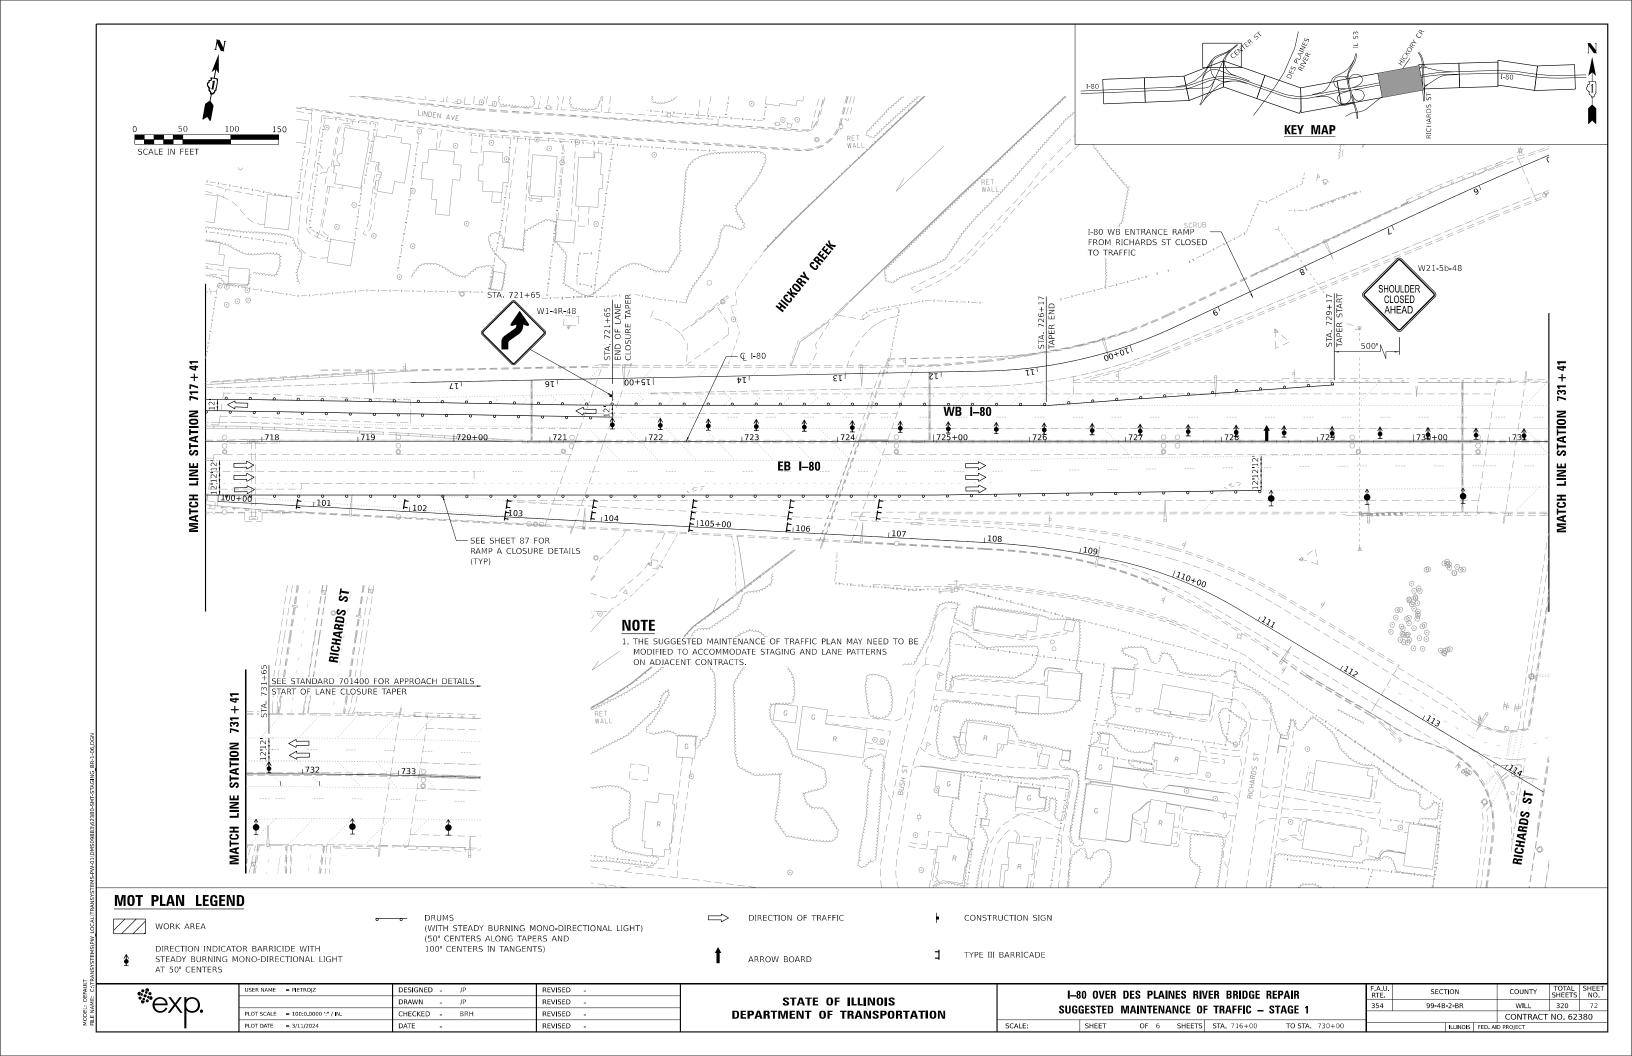


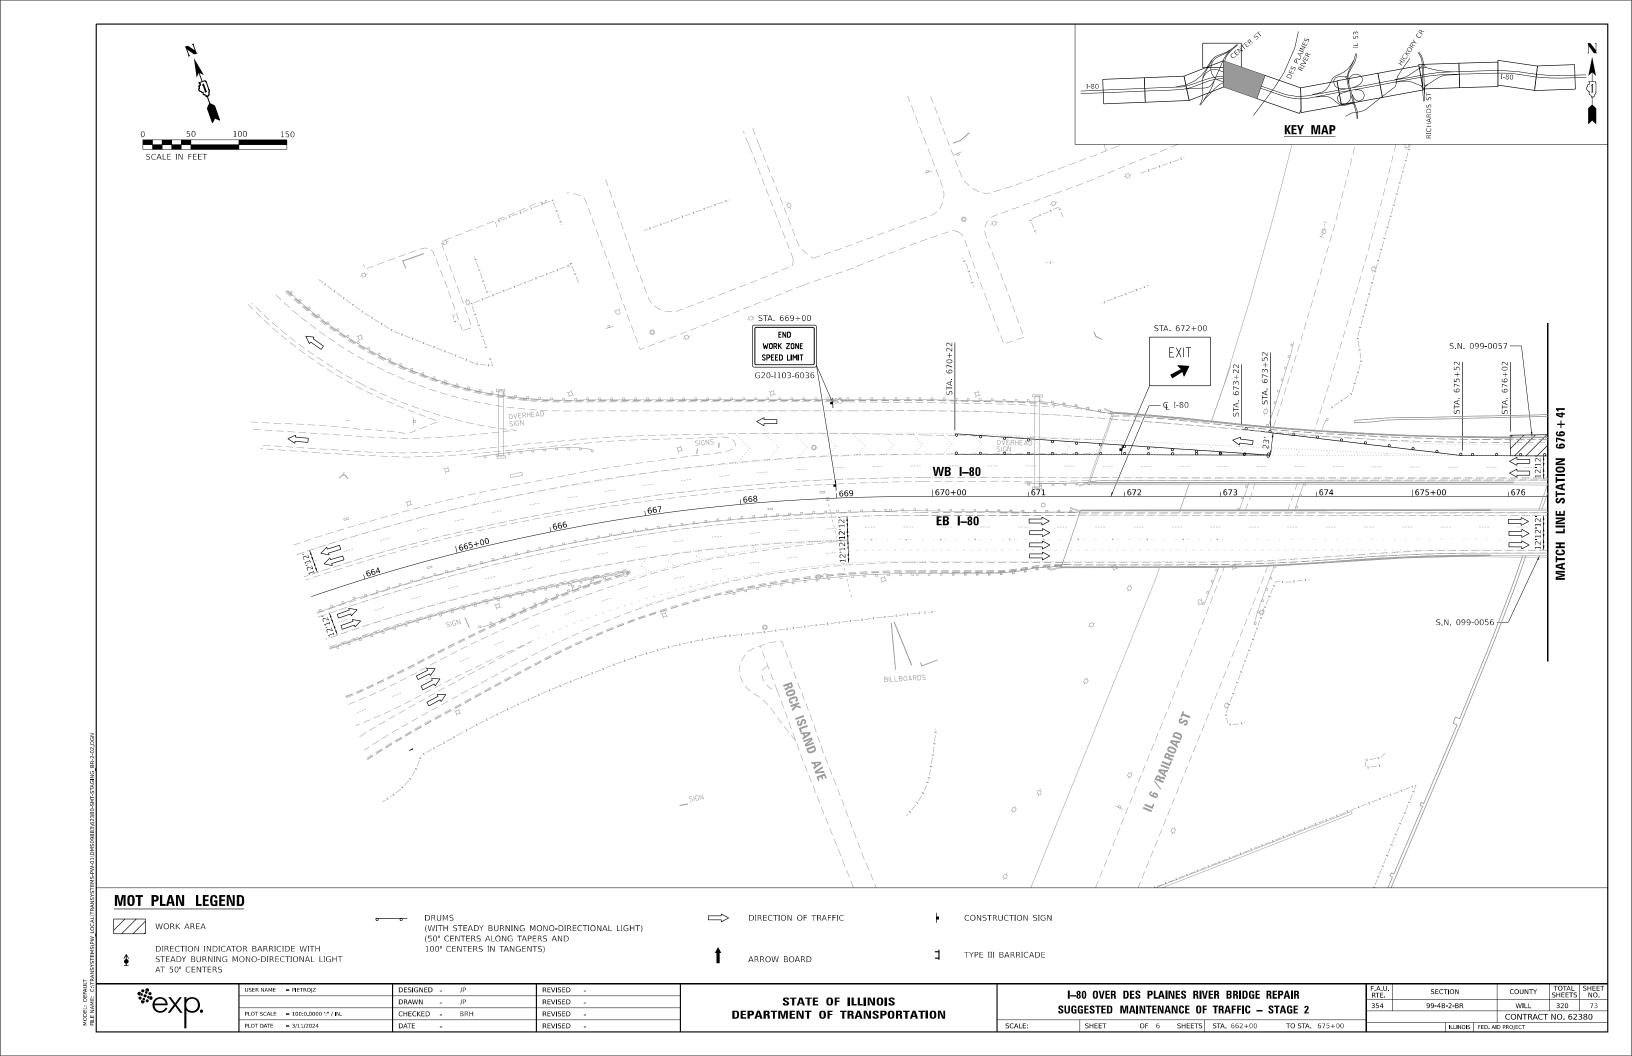


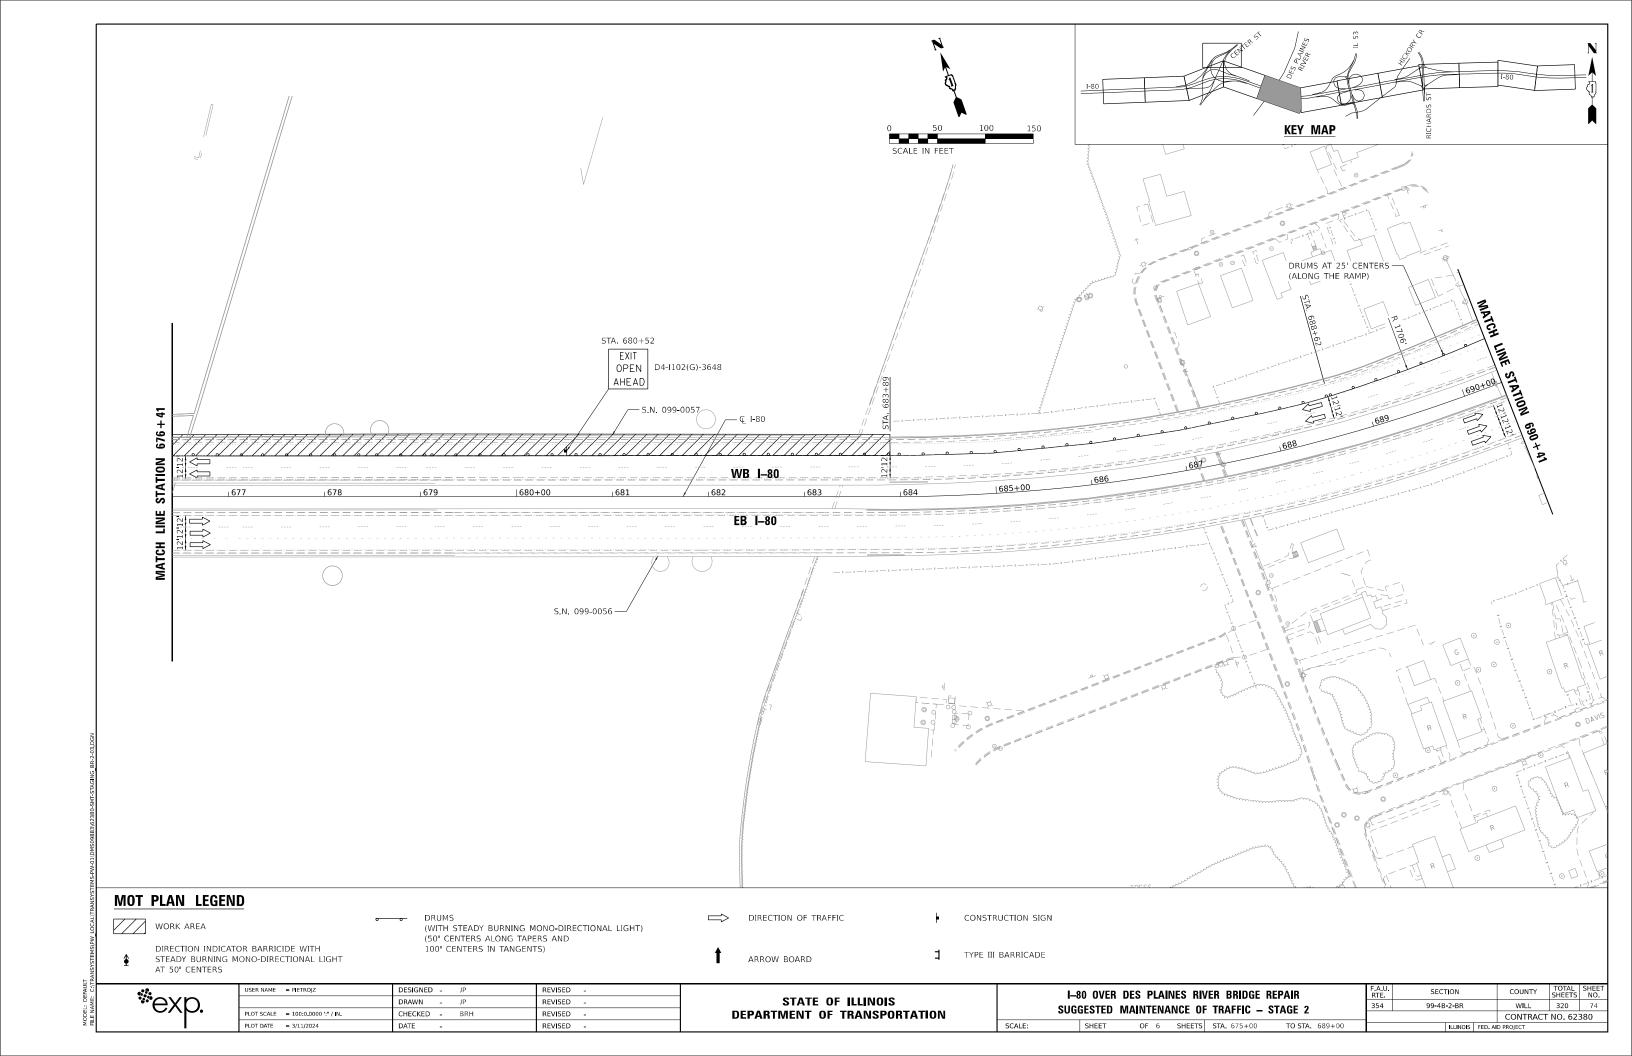


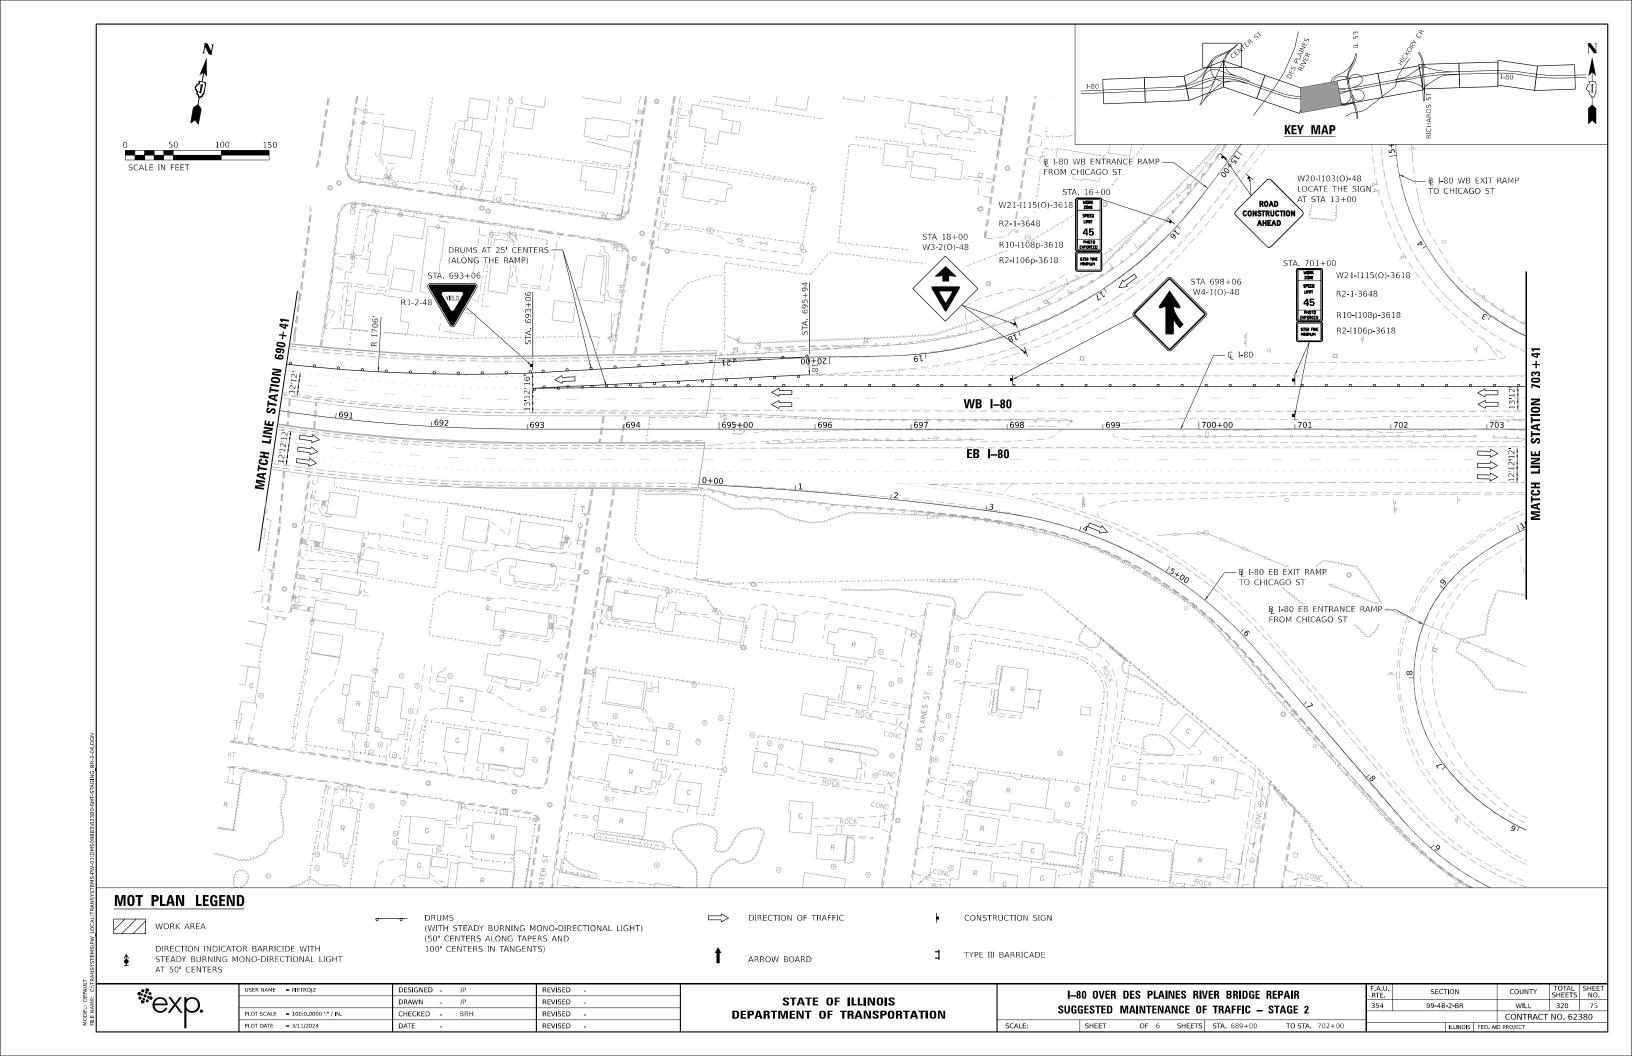


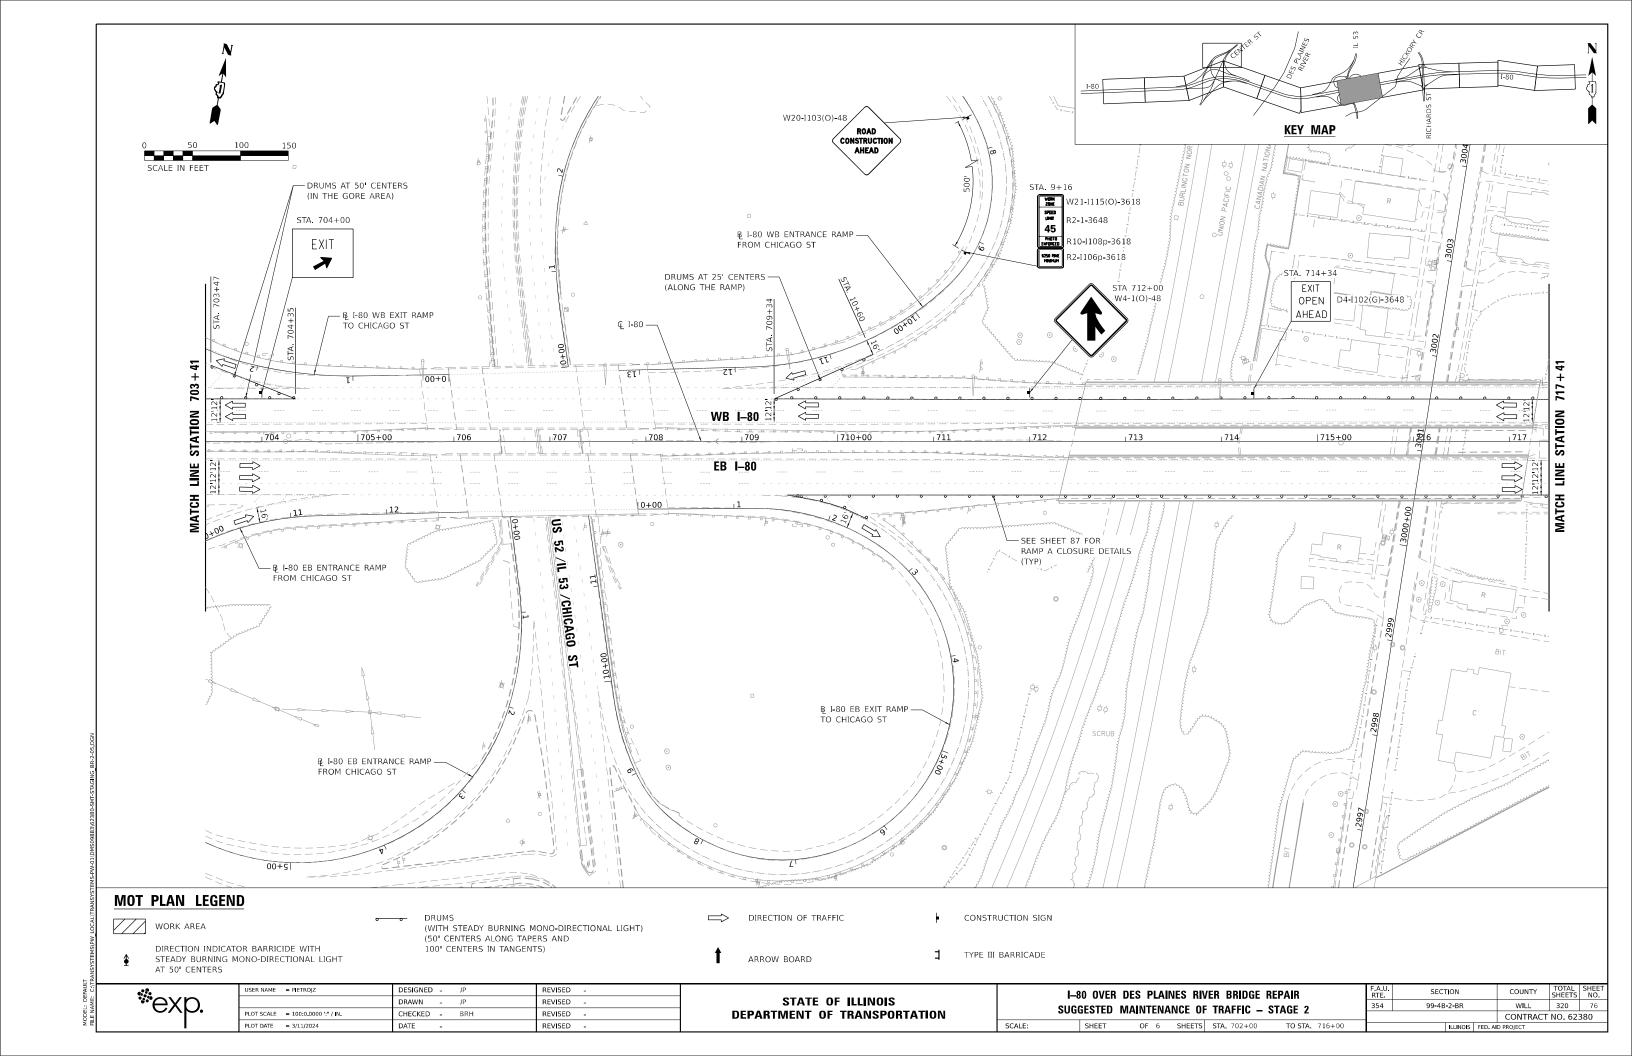


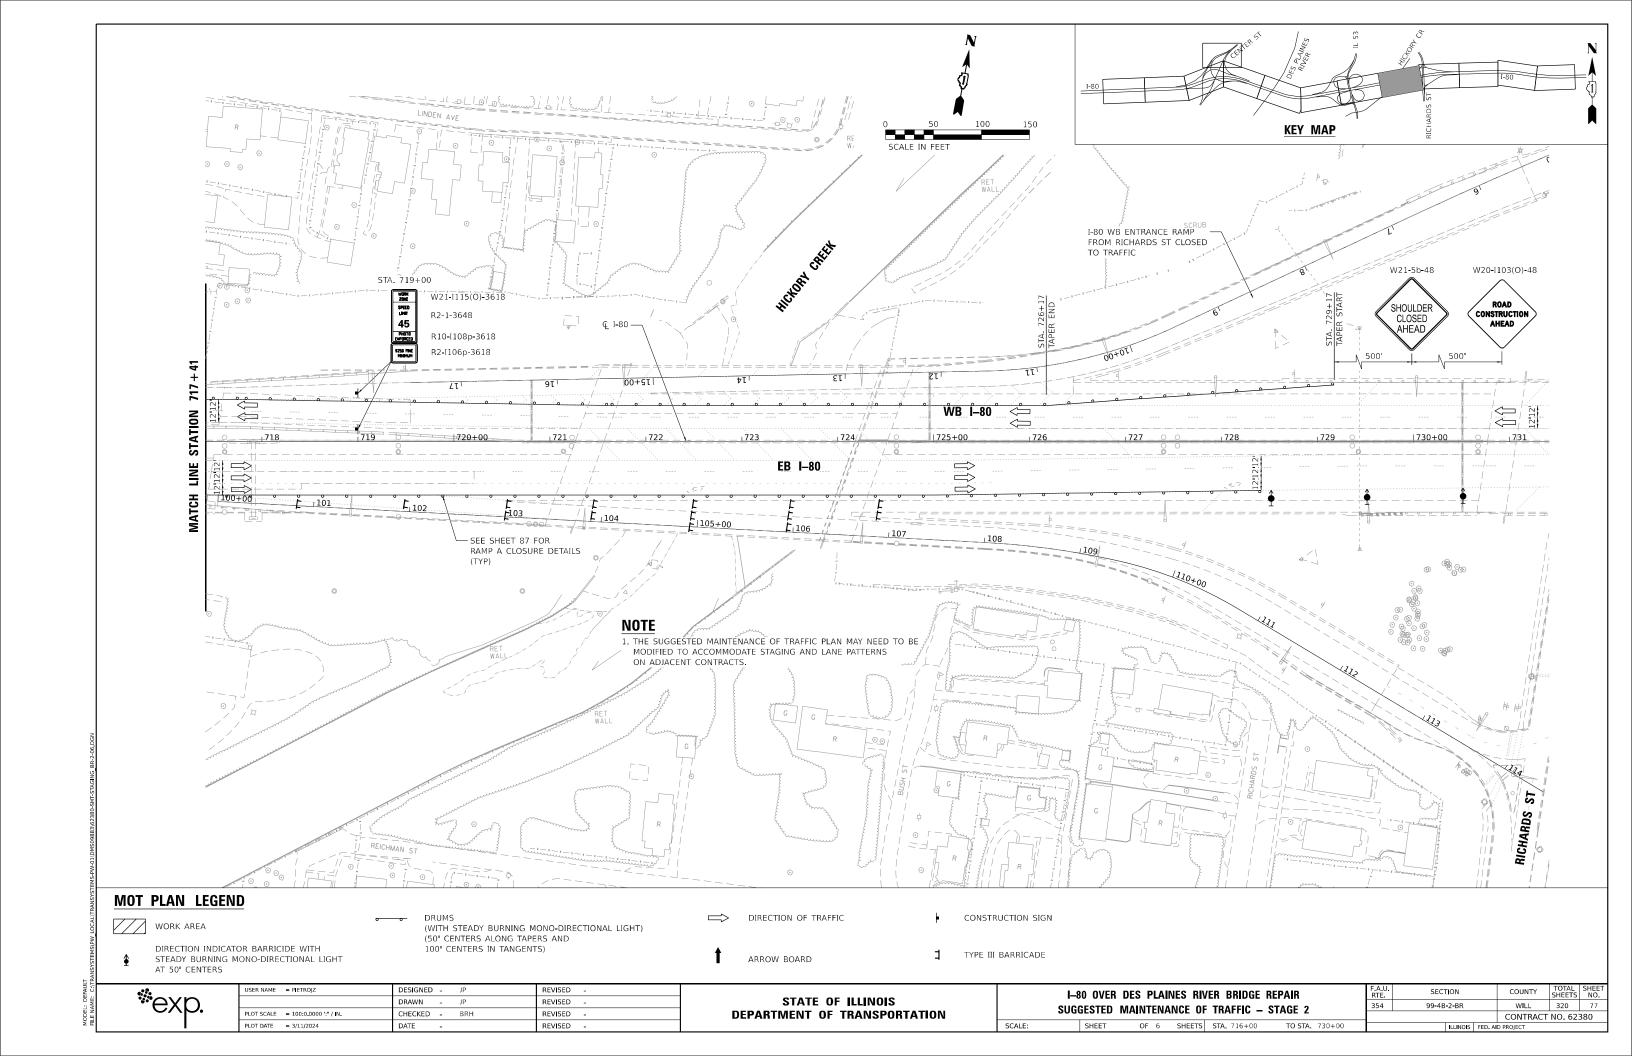


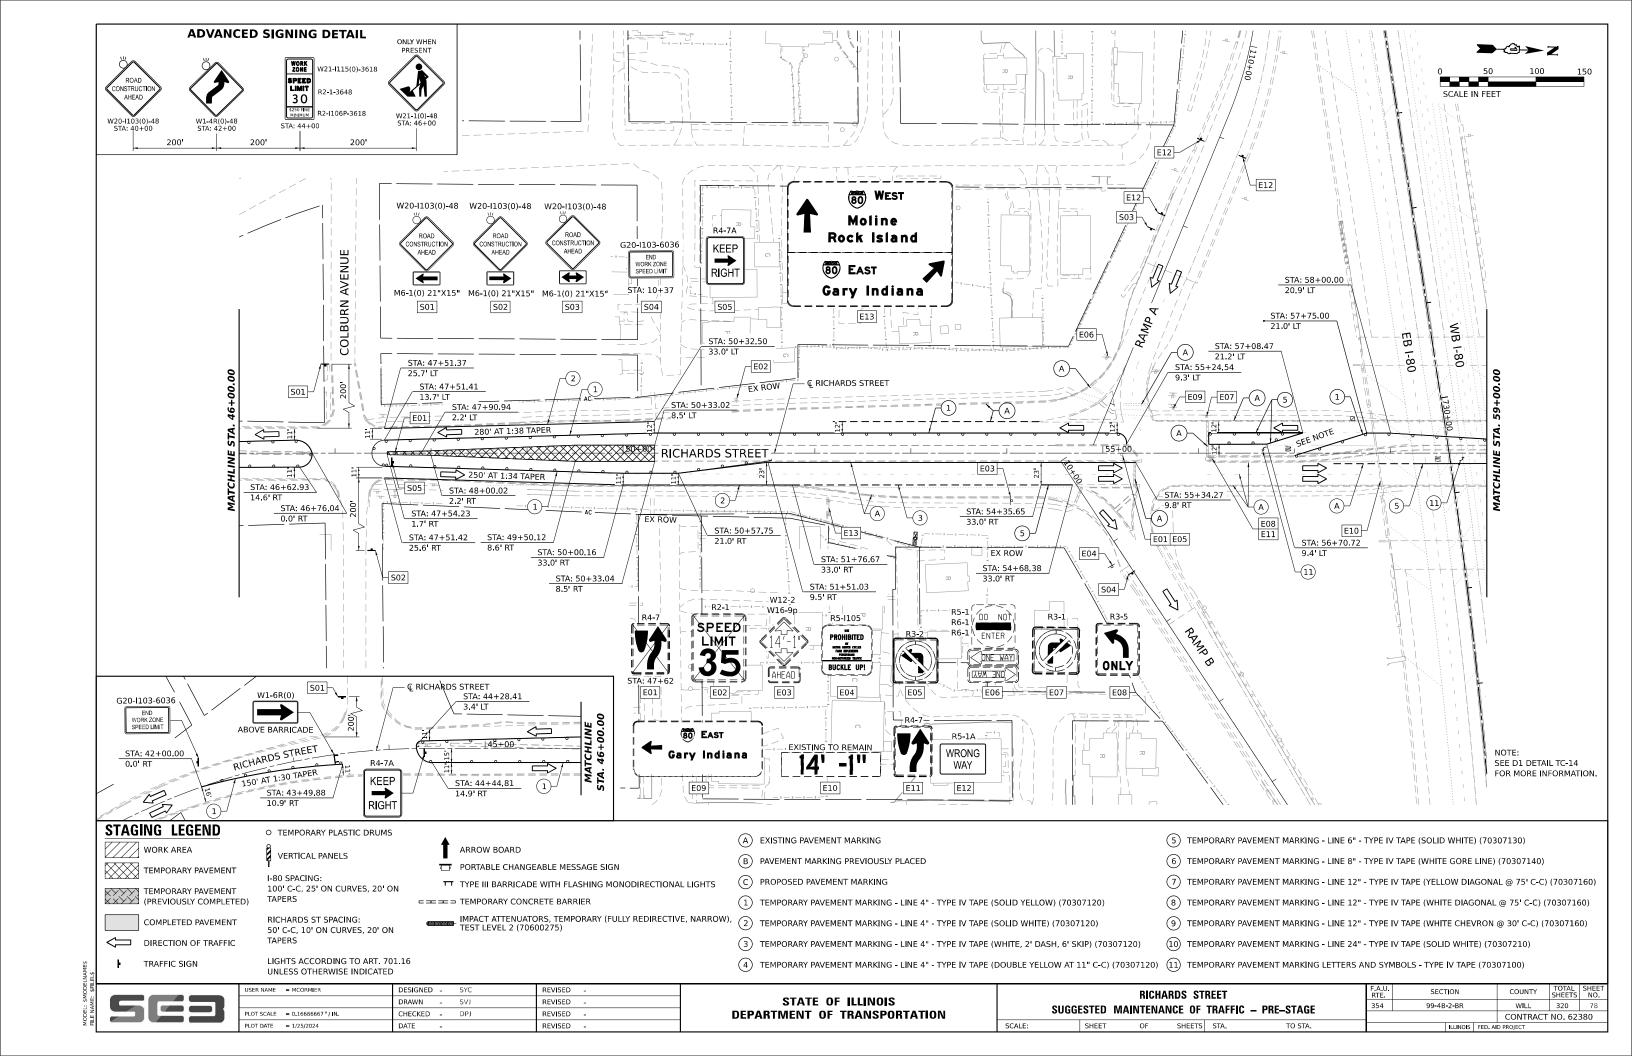


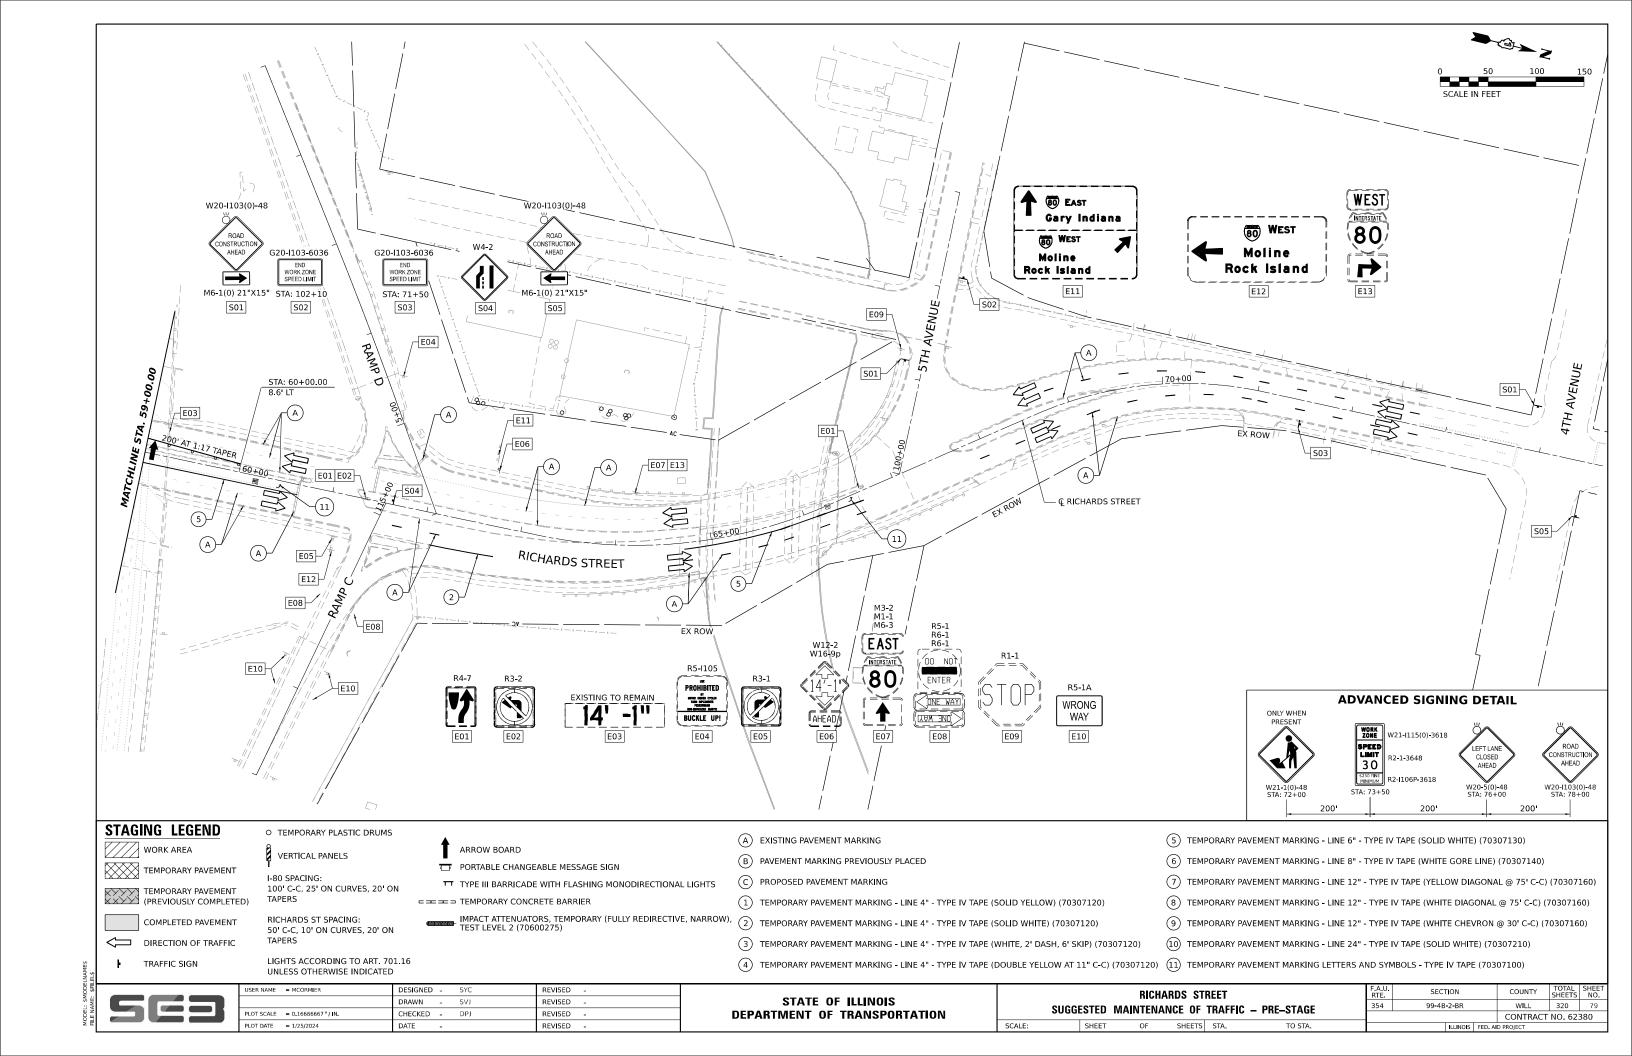


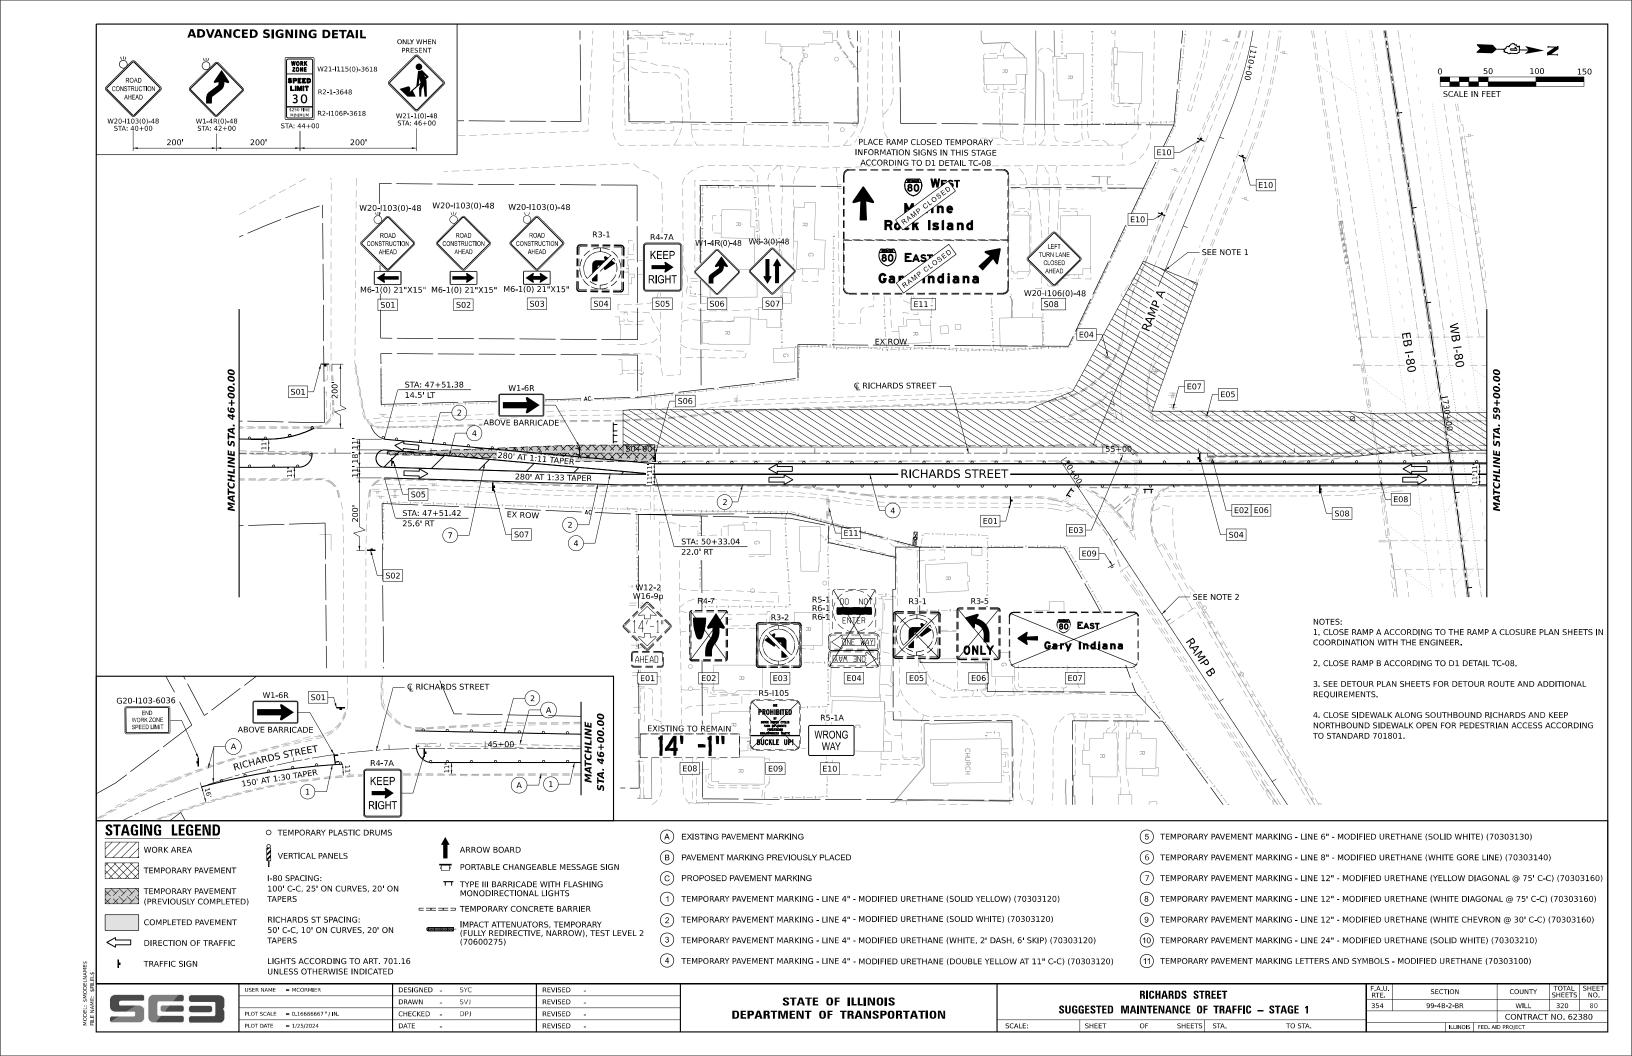


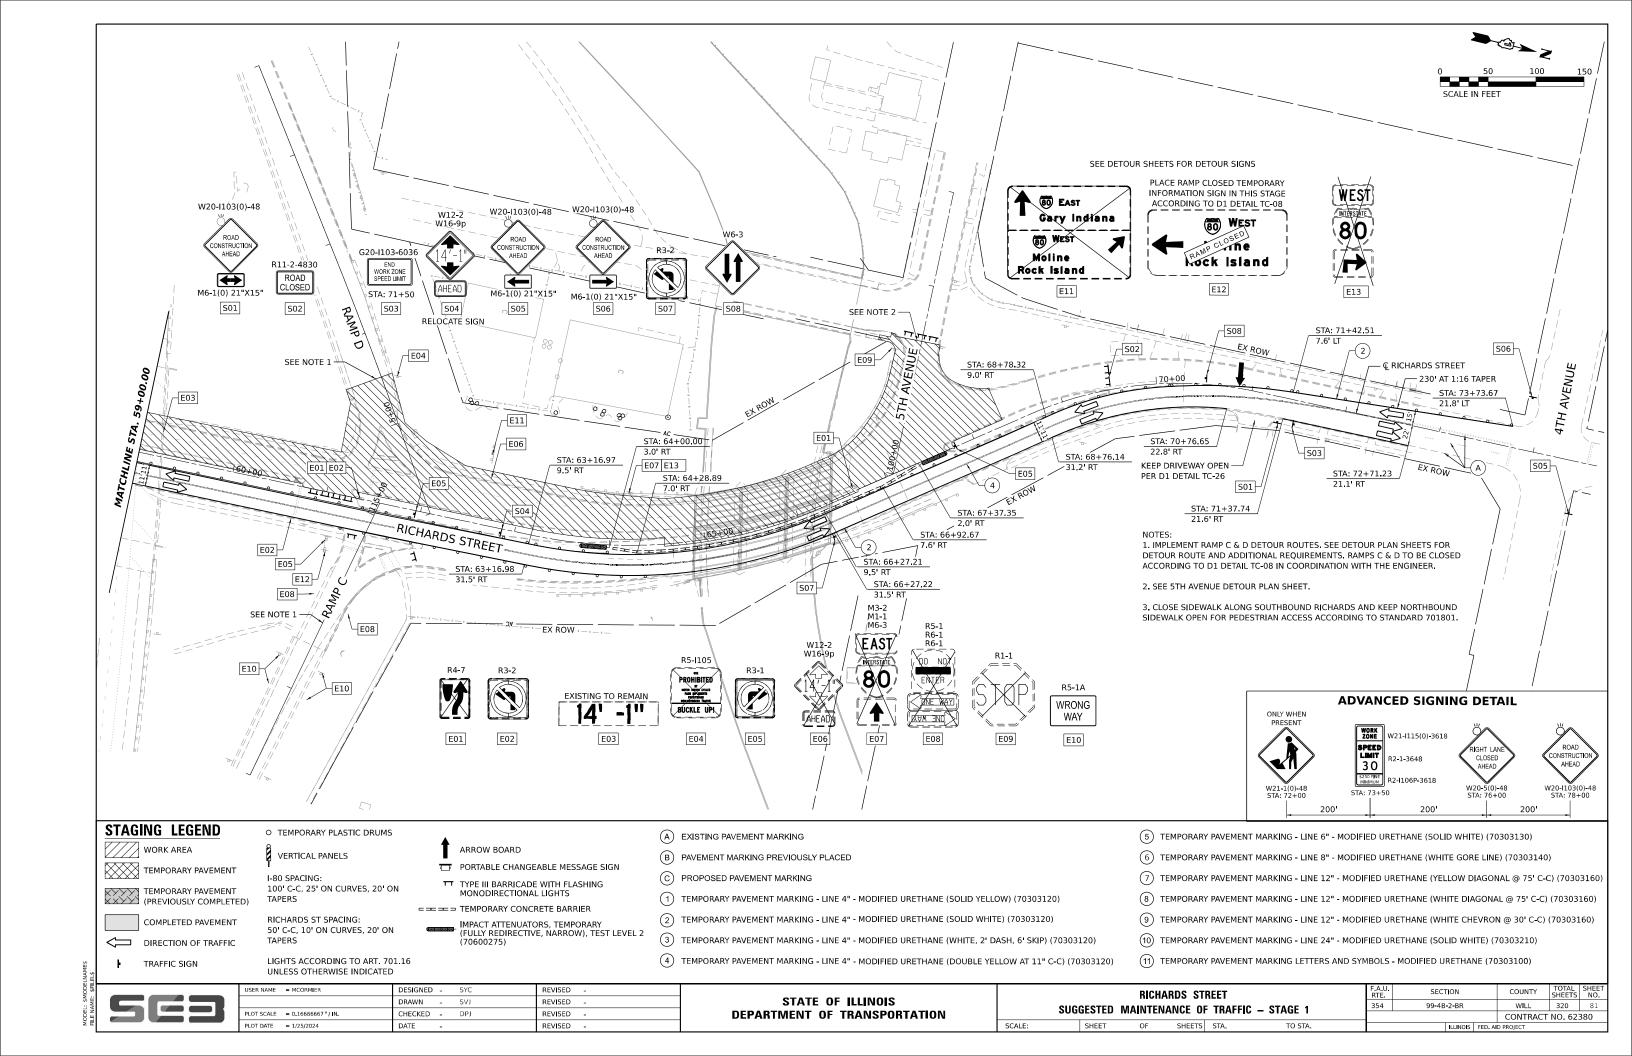

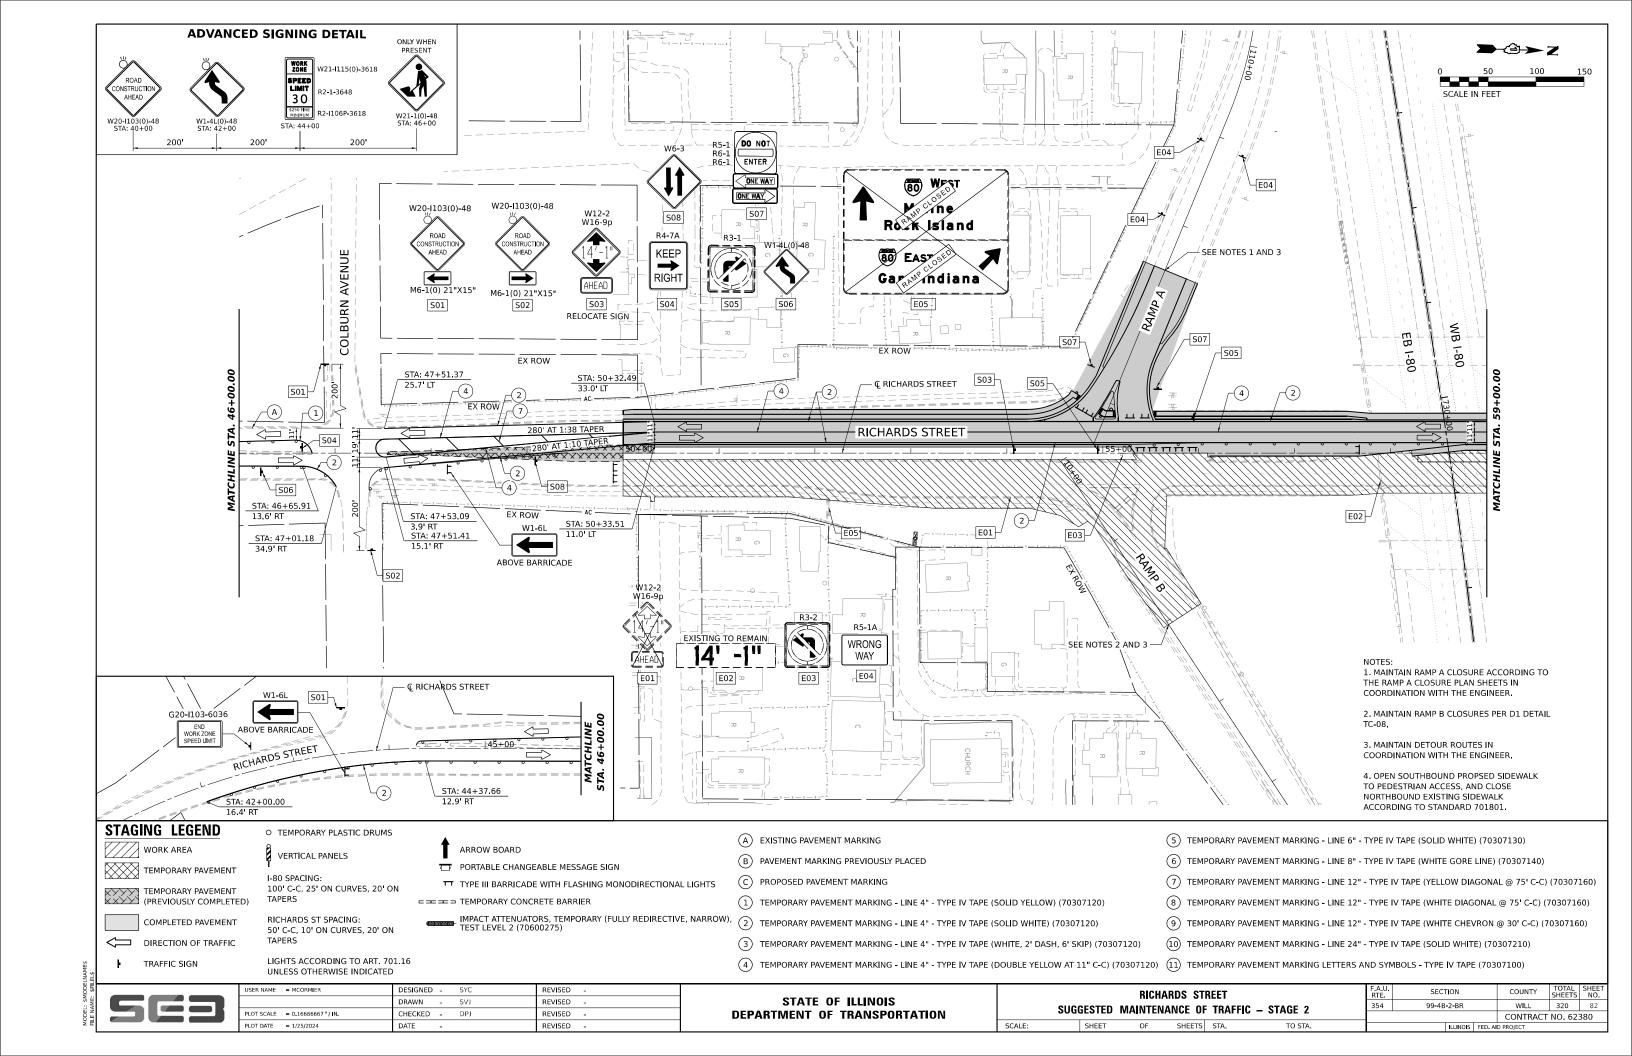

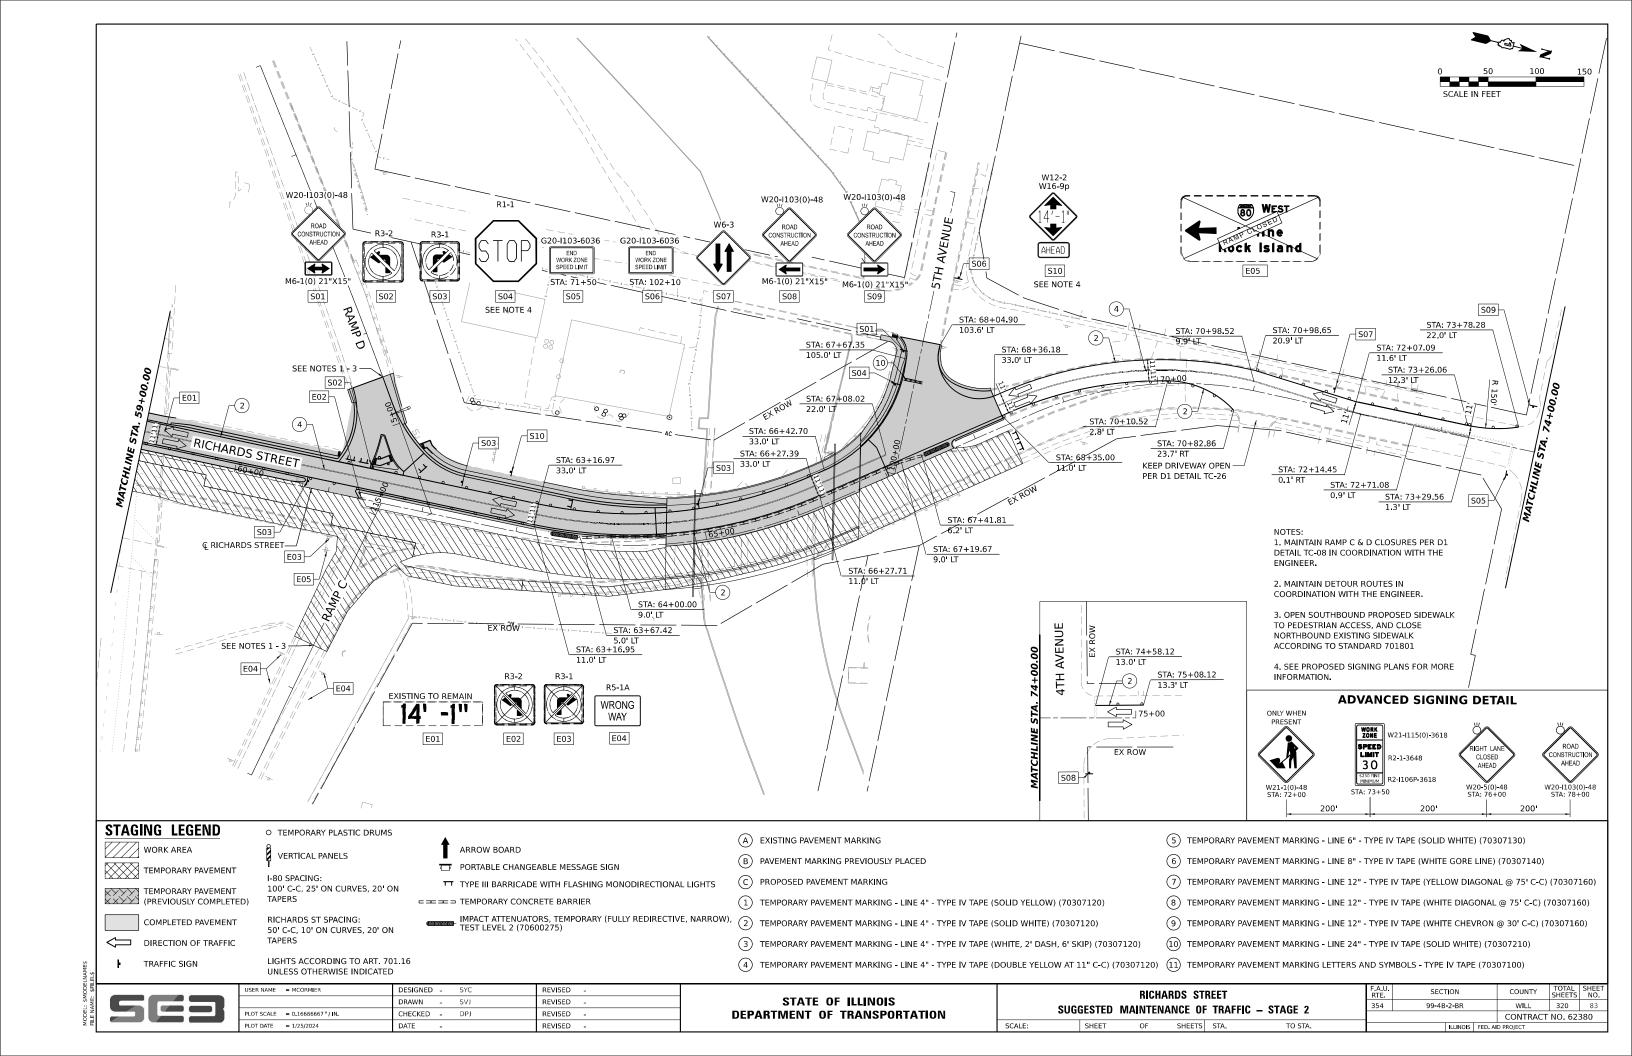

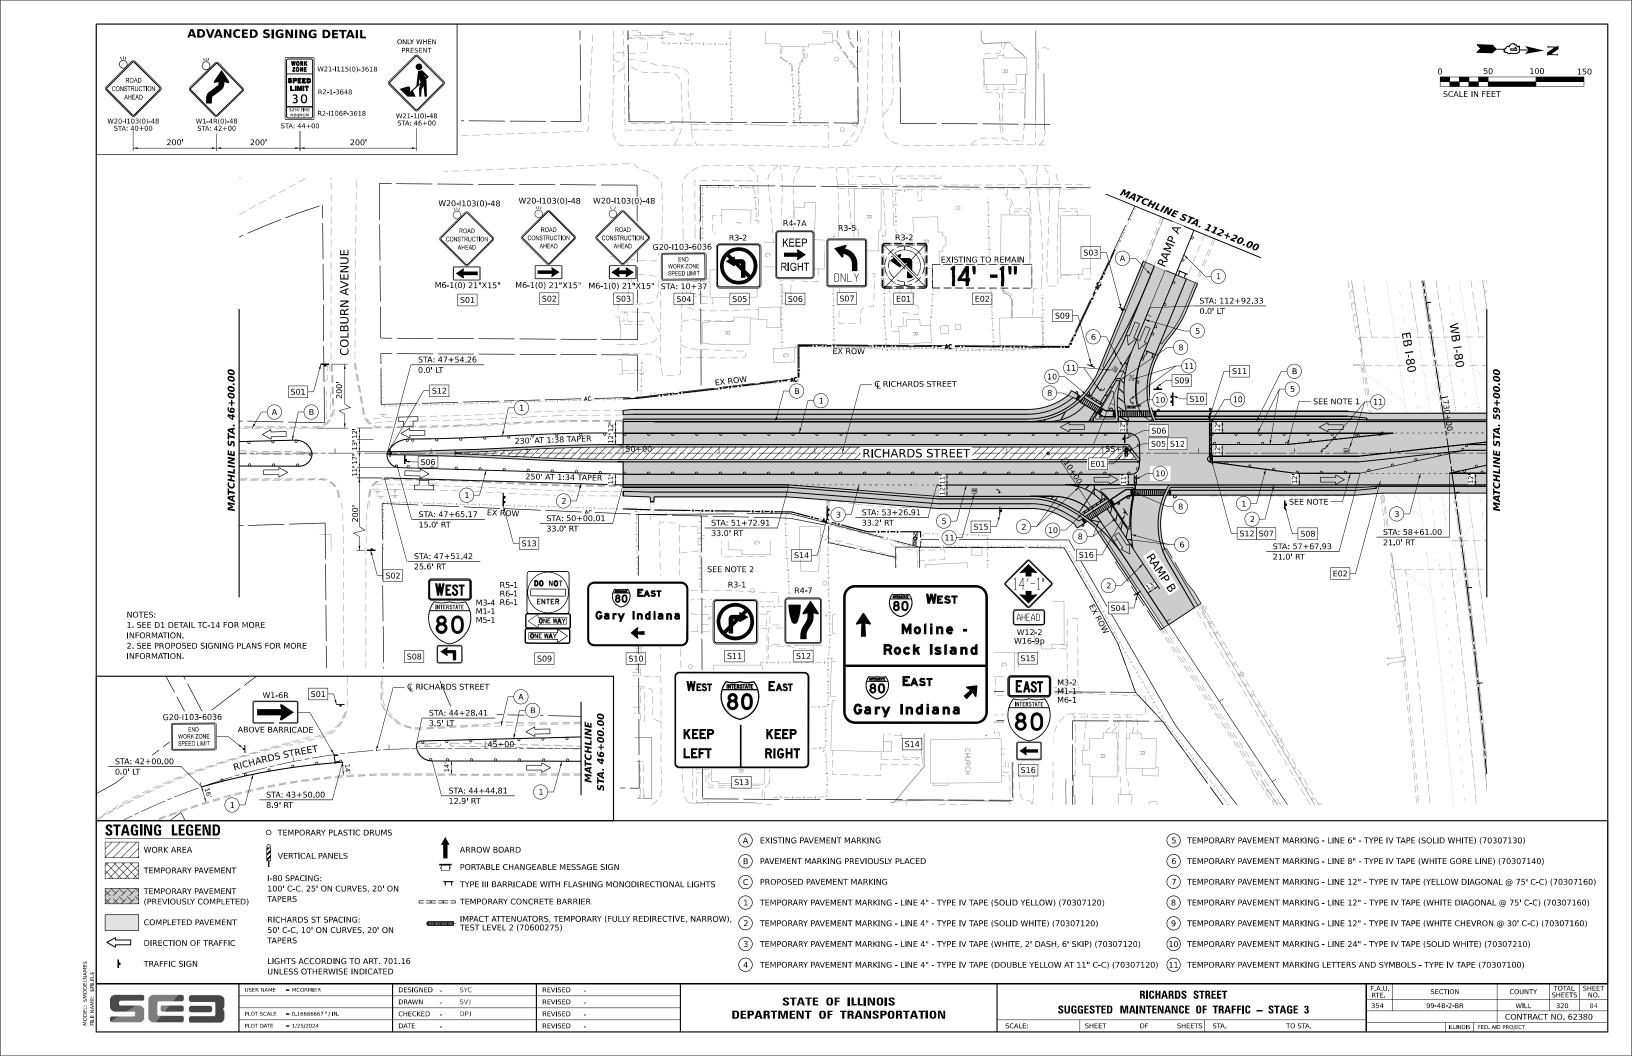

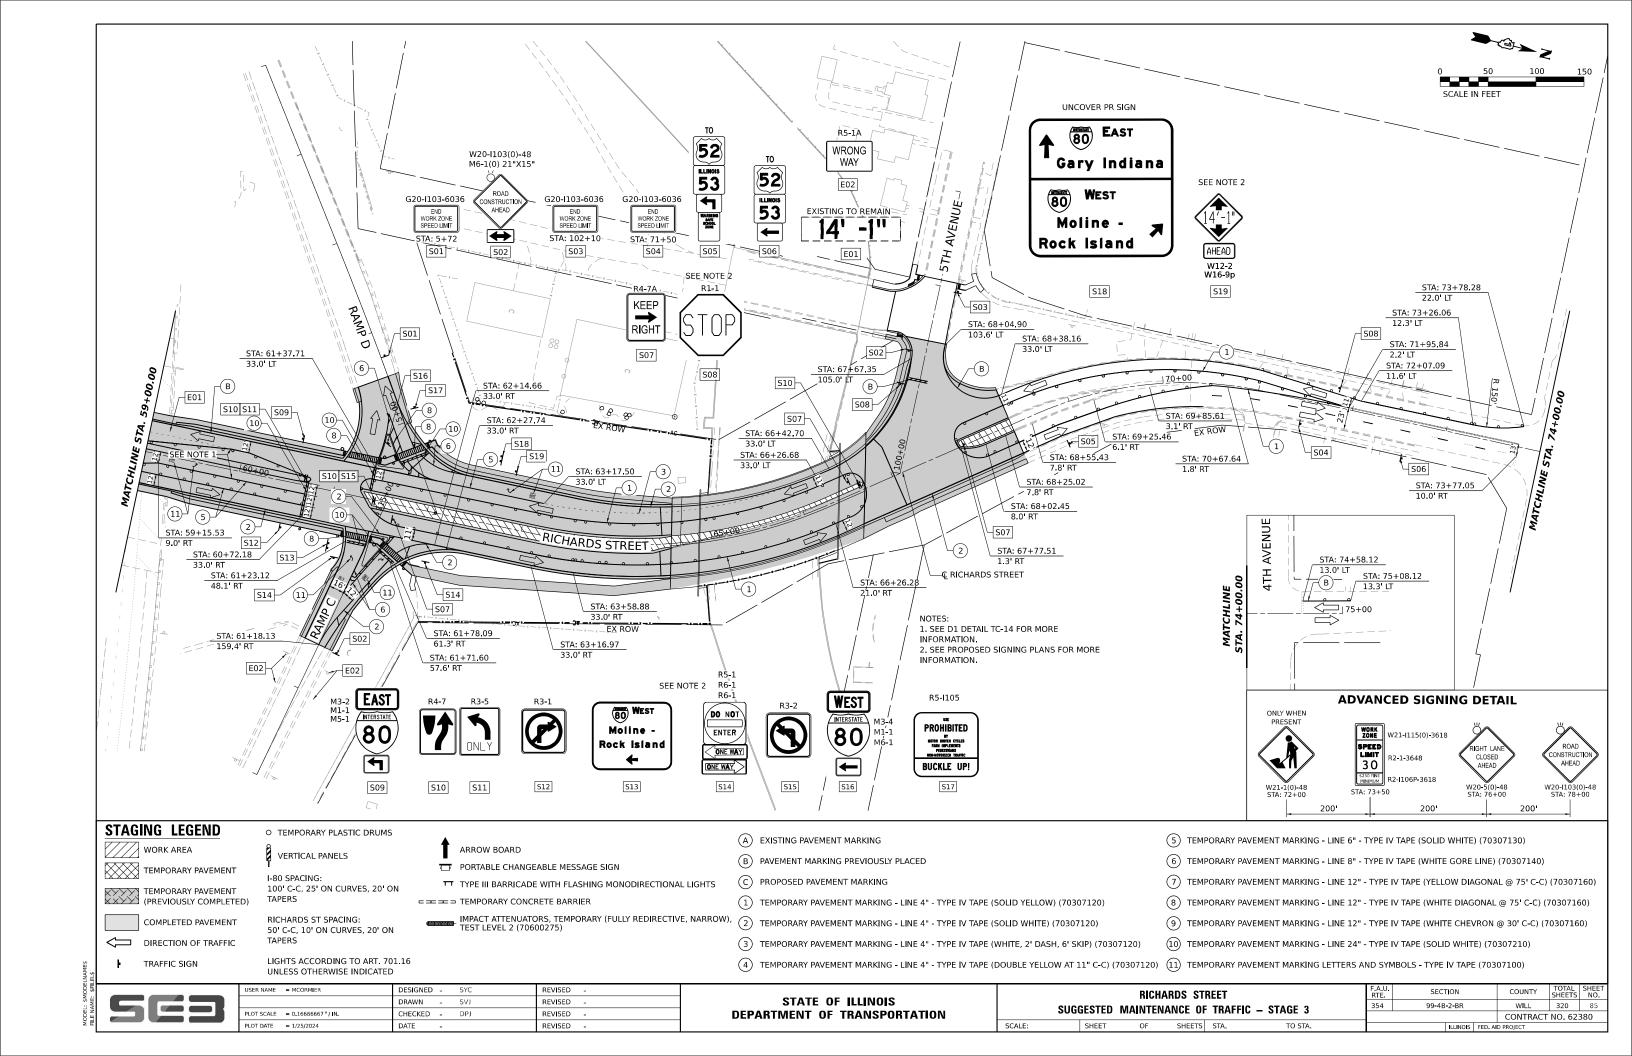





TEMPORARY PAVEMENT (PREVIOUSLY COMPLETED)

O TEMPORARY PLASTIC DRUMS

VERTICAL PANELS

I-80 SPACING: 100' C-C, 25' ON CURVES, 20' ON TAPERS

RICHARDS ST SPACING: 50' C-C, 10' ON CURVES, 20' ON

UNLESS OTHERWISE INDICATED

LIGHTS ACCORDING TO ART. 701.16

ARROW BOARD

PORTABLE CHANGEABLE MESSAGE SIGN

TYPE III BARRICADE WITH FLASHING MONODIRECTIONAL LIGHTS

\_ E03

=== TEMPORARY CONCRETE BARRIER

R5-1A WRONG WAY

E03

A E03

MATCHLINE STA. 112+20.00

IMPACT ATTENUATORS, TEMPORARY (FULLY REDIRECTIVE, NARROW), (2) TEMPORARY PAVEMENT MARKING - LINE 4" - TYPE IV TAPE (SOLID WHITE) (70307120)

A EXISTING PAVEMENT MARKING

STA: 109+22.76

STA: 110+61 53 STA: 110+61.12 0.0' LT

- B PAVEMENT MARKING PREVIOUSLY PLACED
- C PROPOSED PAVEMENT MARKING
- 1 TEMPORARY PAVEMENT MARKING LINE 4" TYPE IV TAPE (SOLID YELLOW) (70307120)

WB 1-80

EB 1-80

- 3 TEMPORARY PAVEMENT MARKING LINE 4" TYPE IV TAPE (WHITE, 2' DASH, 6' SKIP) (70307120)
- 4 TEMPORARY PAVEMENT MARKING LINE 4" TYPE IV TAPE (DOUBLE YELLOW AT 11" C-C) (70307120) 11 TEMPORARY PAVEMENT MARKING LETTERS AND SYMBOLS TYPE IV TAPE (70307100)

- 5 TEMPORARY PAVEMENT MARKING LINE 6" TYPE IV TAPE (SOLID WHITE) (70307130)
- 6 TEMPORARY PAVEMENT MARKING LINE 8" TYPE IV TAPE (WHITE GORE LINE) (70307140)
- 7) TEMPORARY PAVEMENT MARKING LINE 12" TYPE IV TAPE (YELLOW DIAGONAL @ 75' C-C) (70307160)
- 8 TEMPORARY PAVEMENT MARKING LINE 12" TYPE IV TAPE (WHITE DIAGONAL @ 75' C-C) (70307160)
- 9 TEMPORARY PAVEMENT MARKING LINE 12" TYPE IV TAPE (WHITE CHEVRON @ 30' C-C) (70307160)
- 10 TEMPORARY PAVEMENT MARKING LINE 24" TYPE IV TAPE (SOLID WHITE) (70307210)





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	DRAWN - SVJ	REVISED -
PLOT SCALE = 0.16666667 / IN.	CHECKED - DPJ	REVISED -
PLOT DATE = 1/25/2024	DATE -	REVISED -

STATE OF ILLINOIS **DEPARTMENT OF TRANSPORTATION** 


SECTION RICHARDS STREET RAMP A 99-4B-2-BR WILL 320 86 SUGGESTED MAINTENANCE OF TRAFFIC - STAGE 3 CONTRACT NO. 62380 SHEETS STA.


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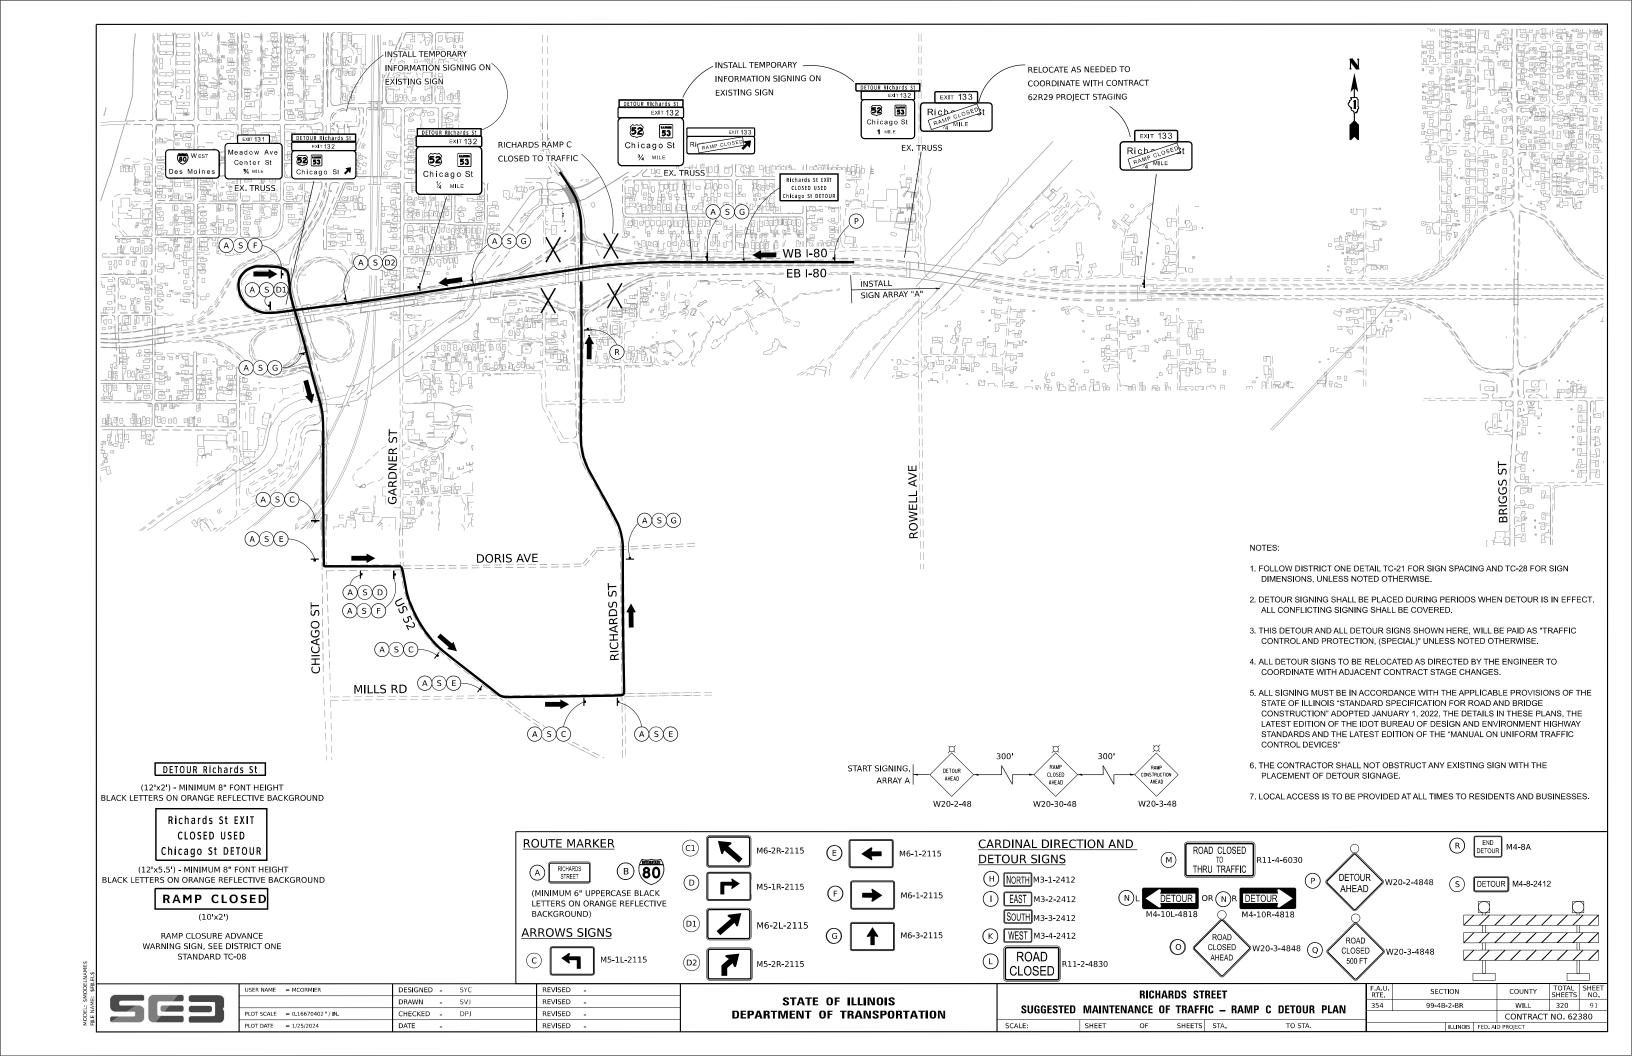


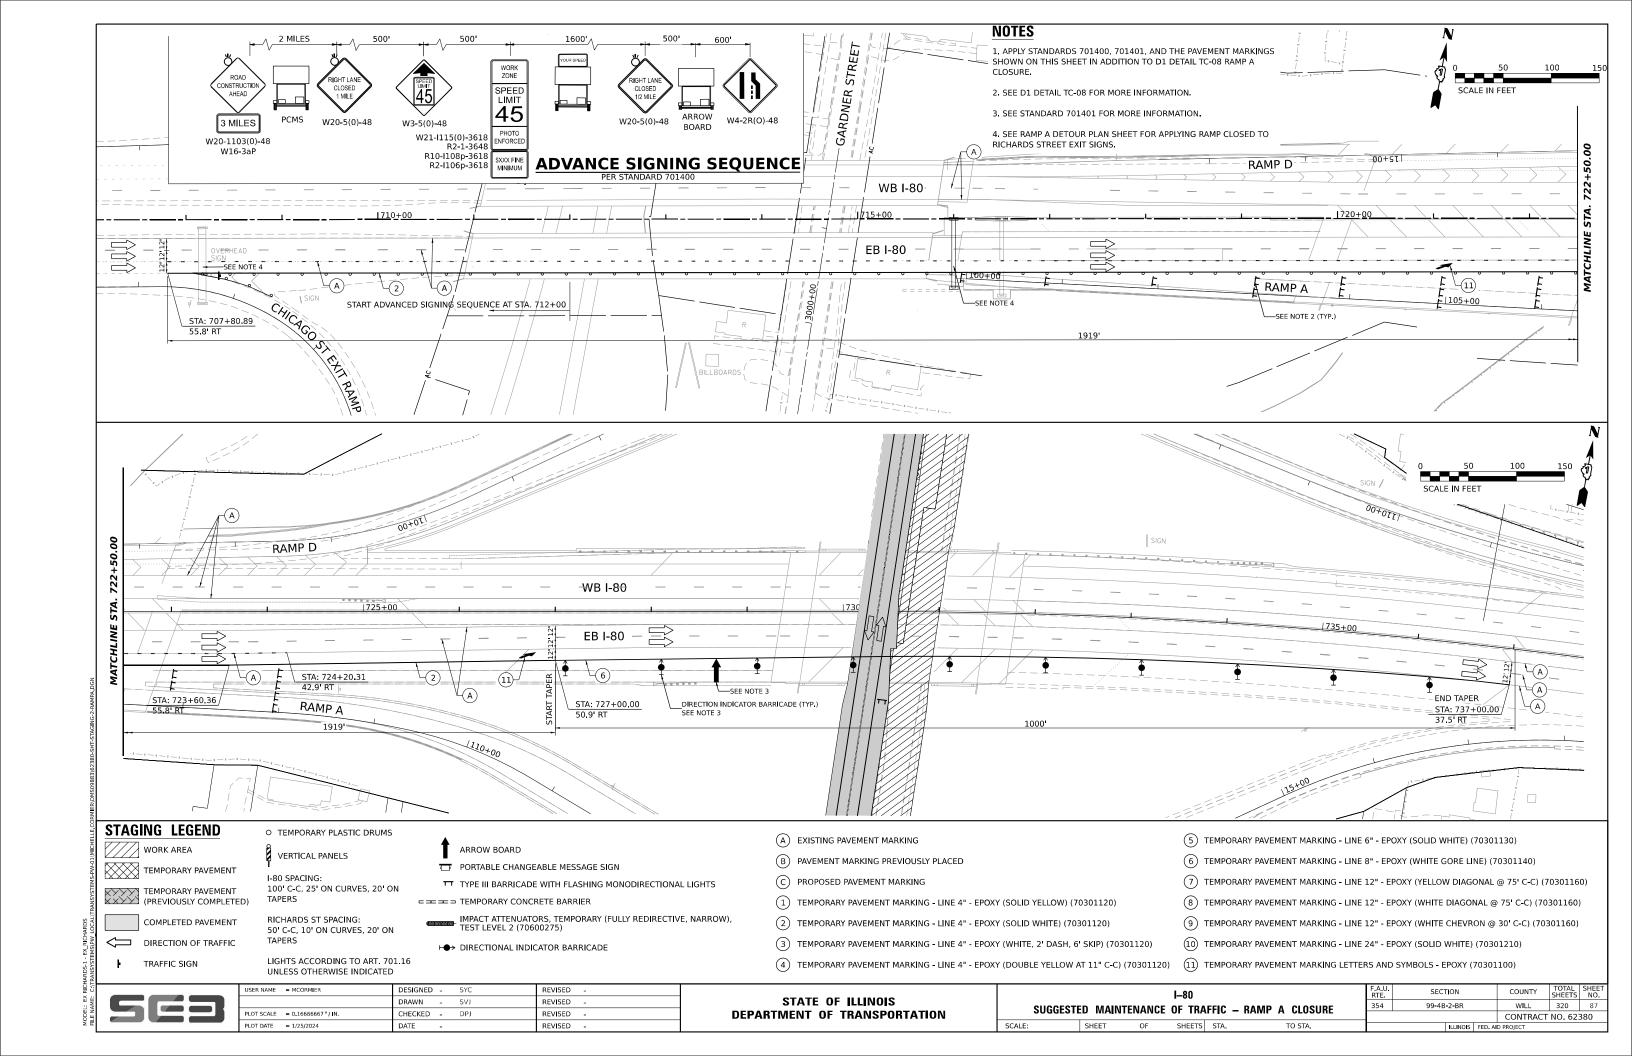


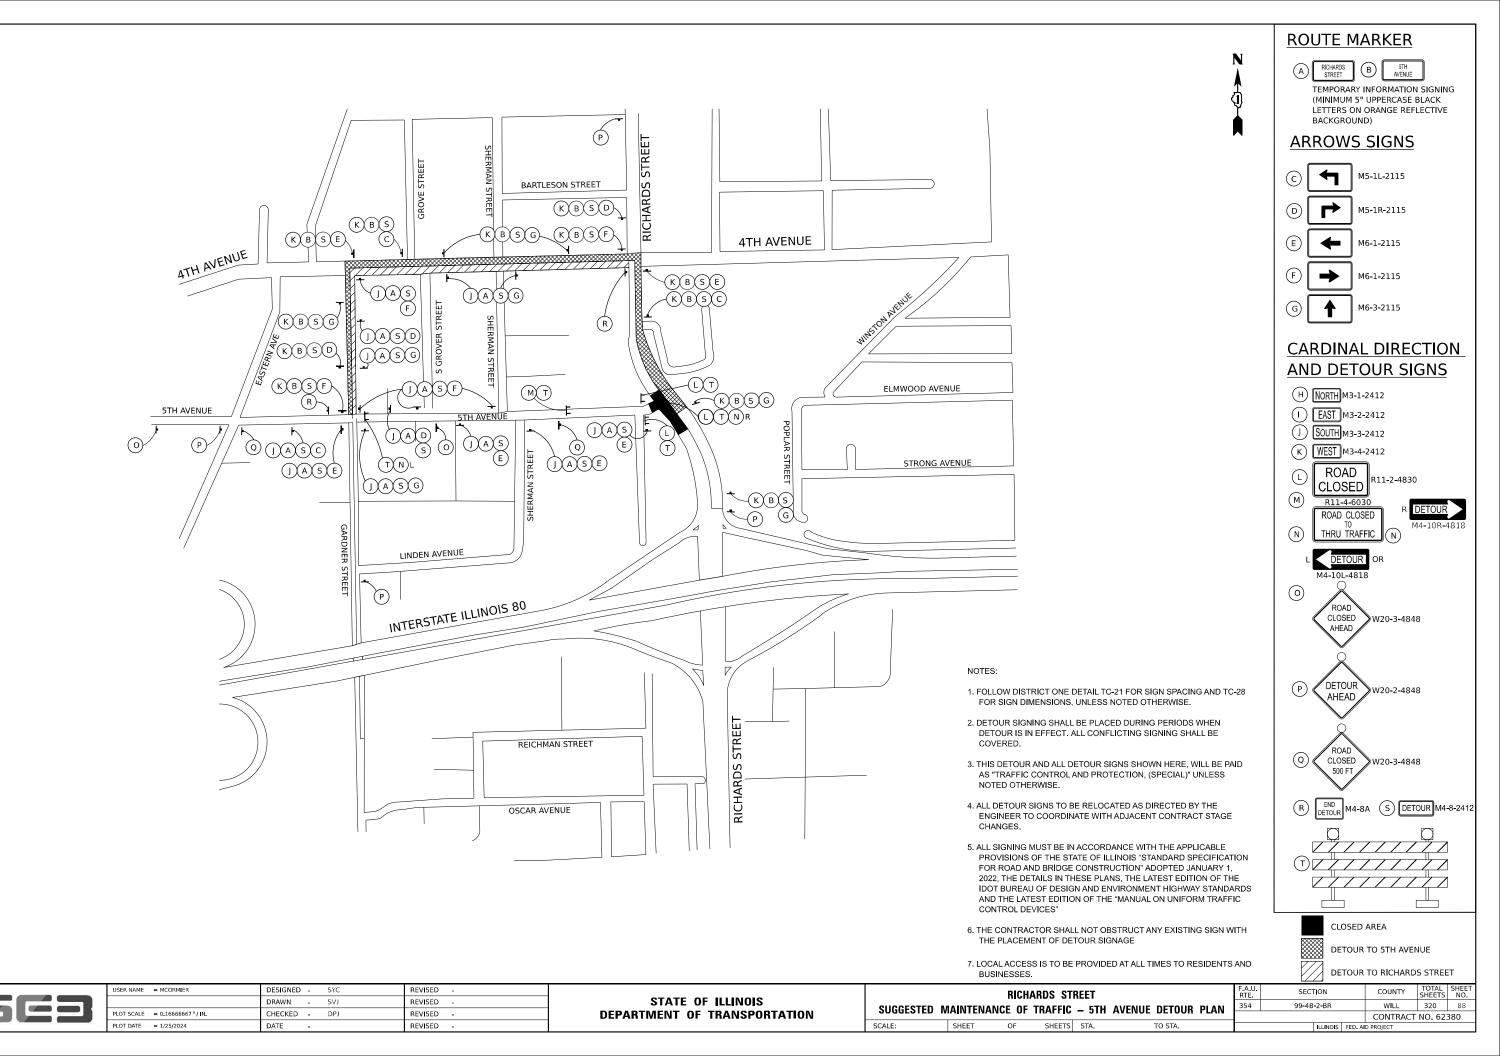FILE NAME: \$FILEL\$



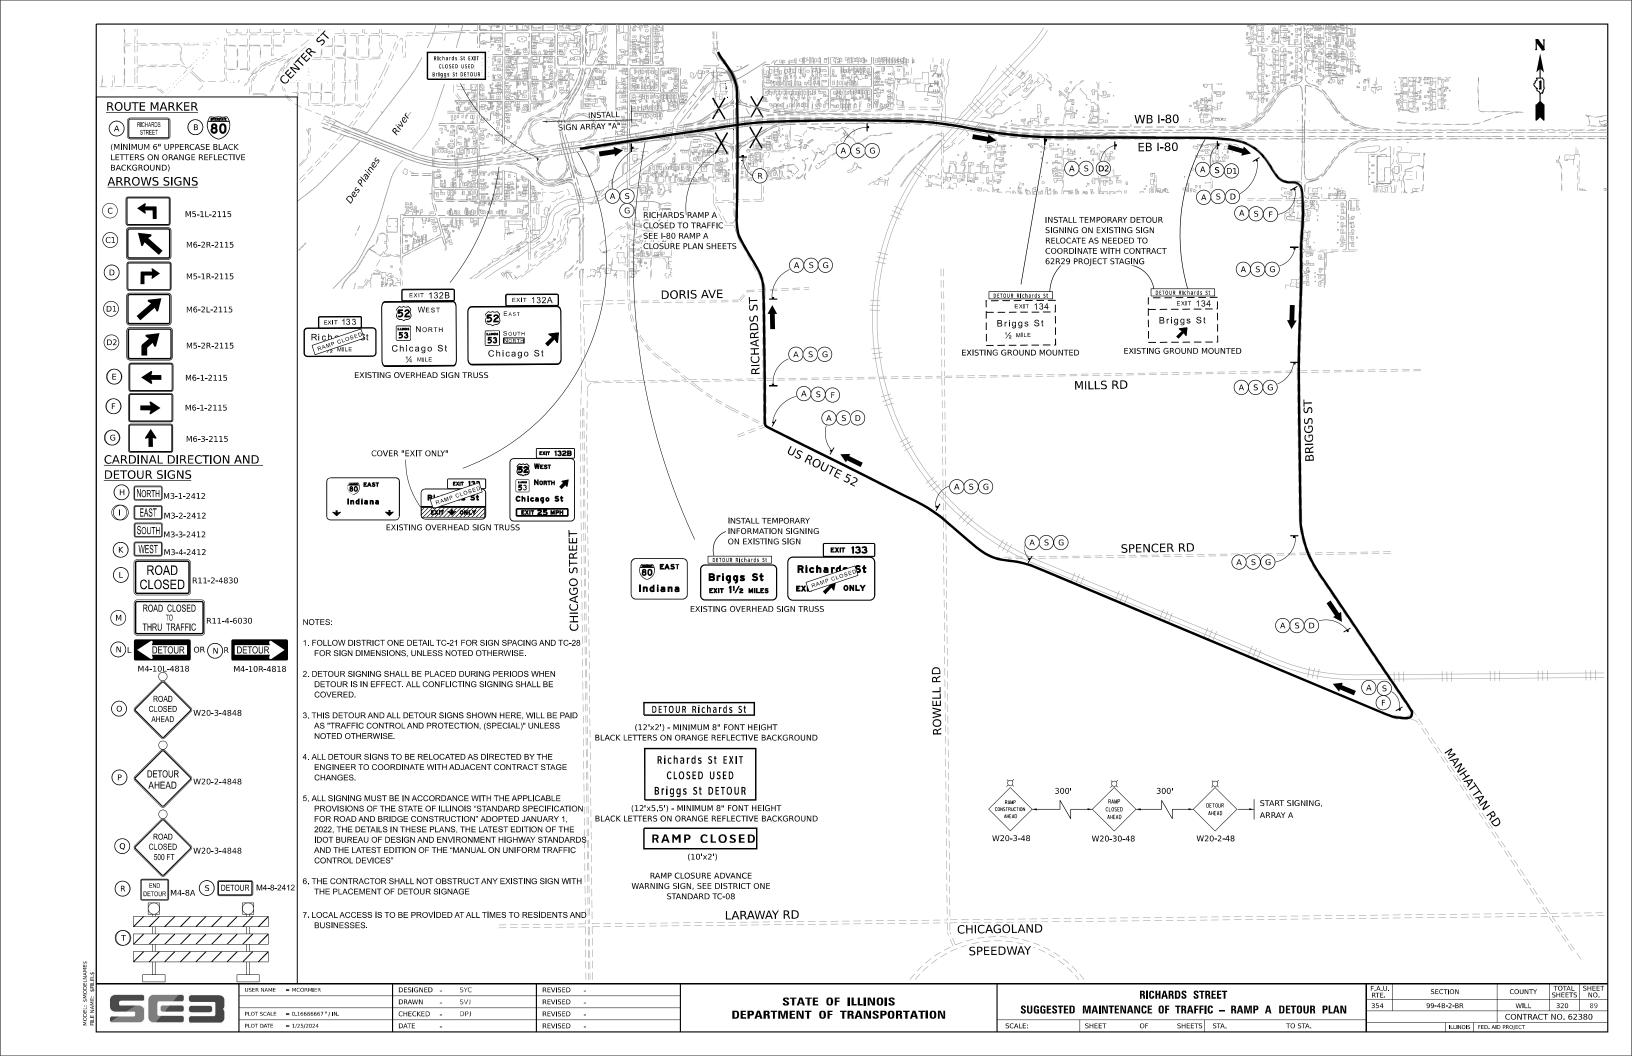

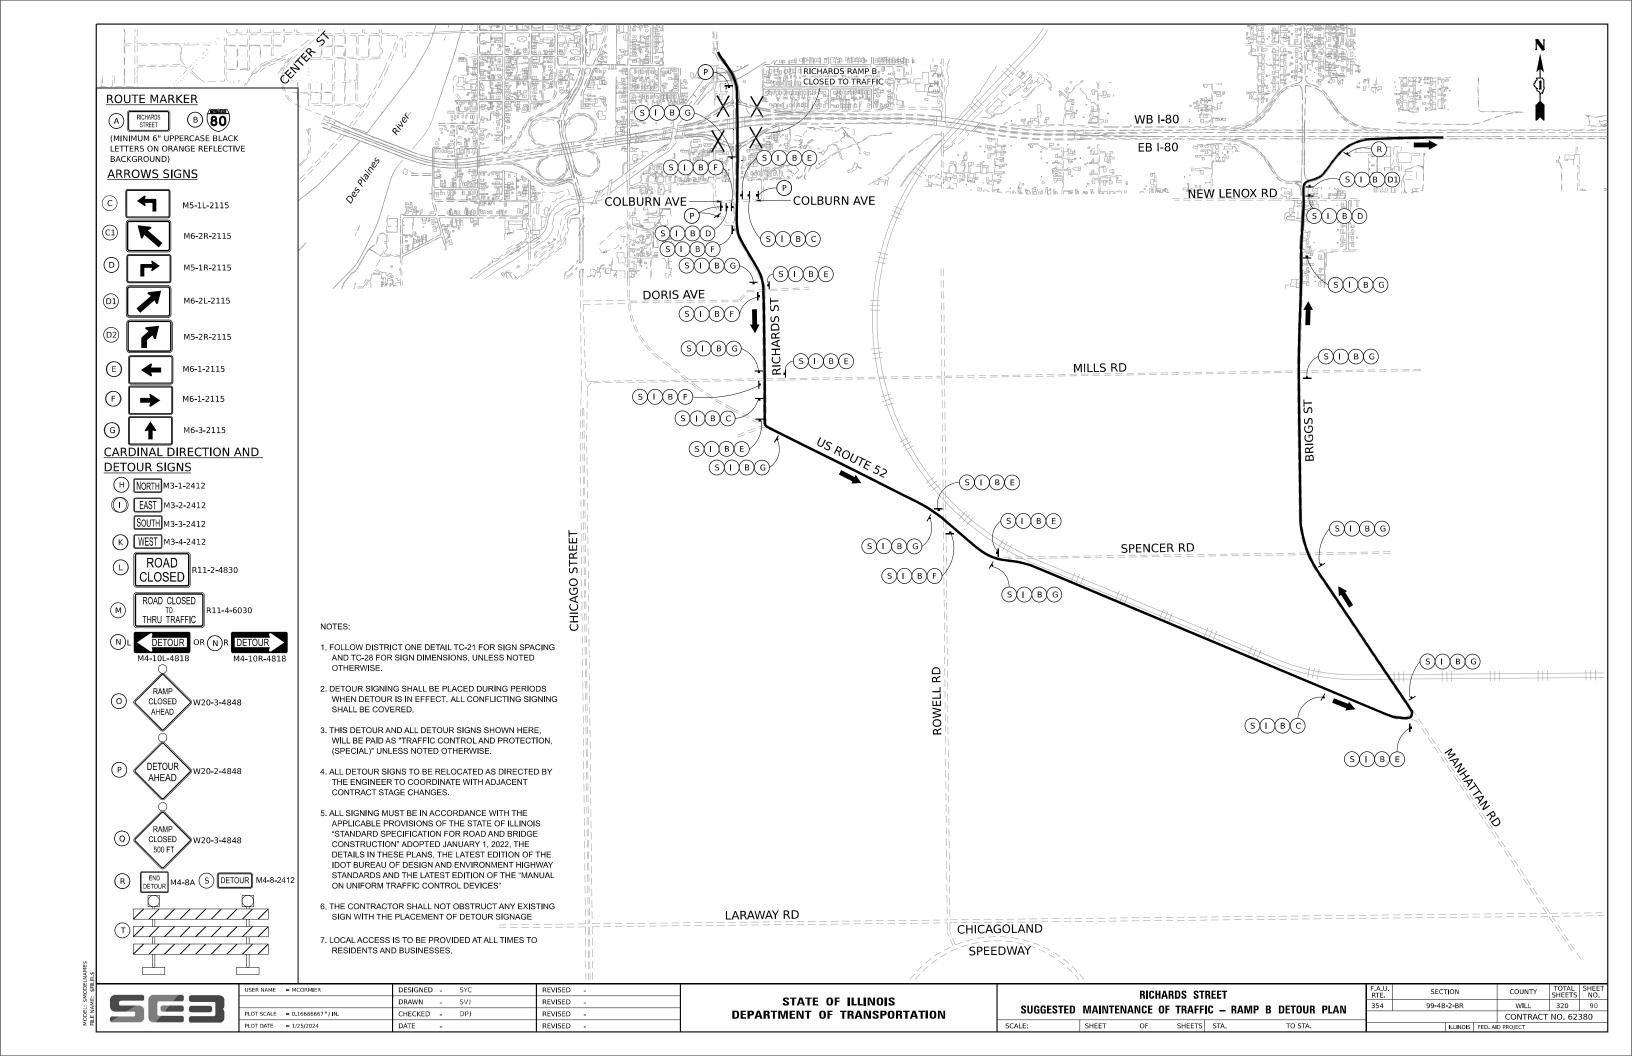

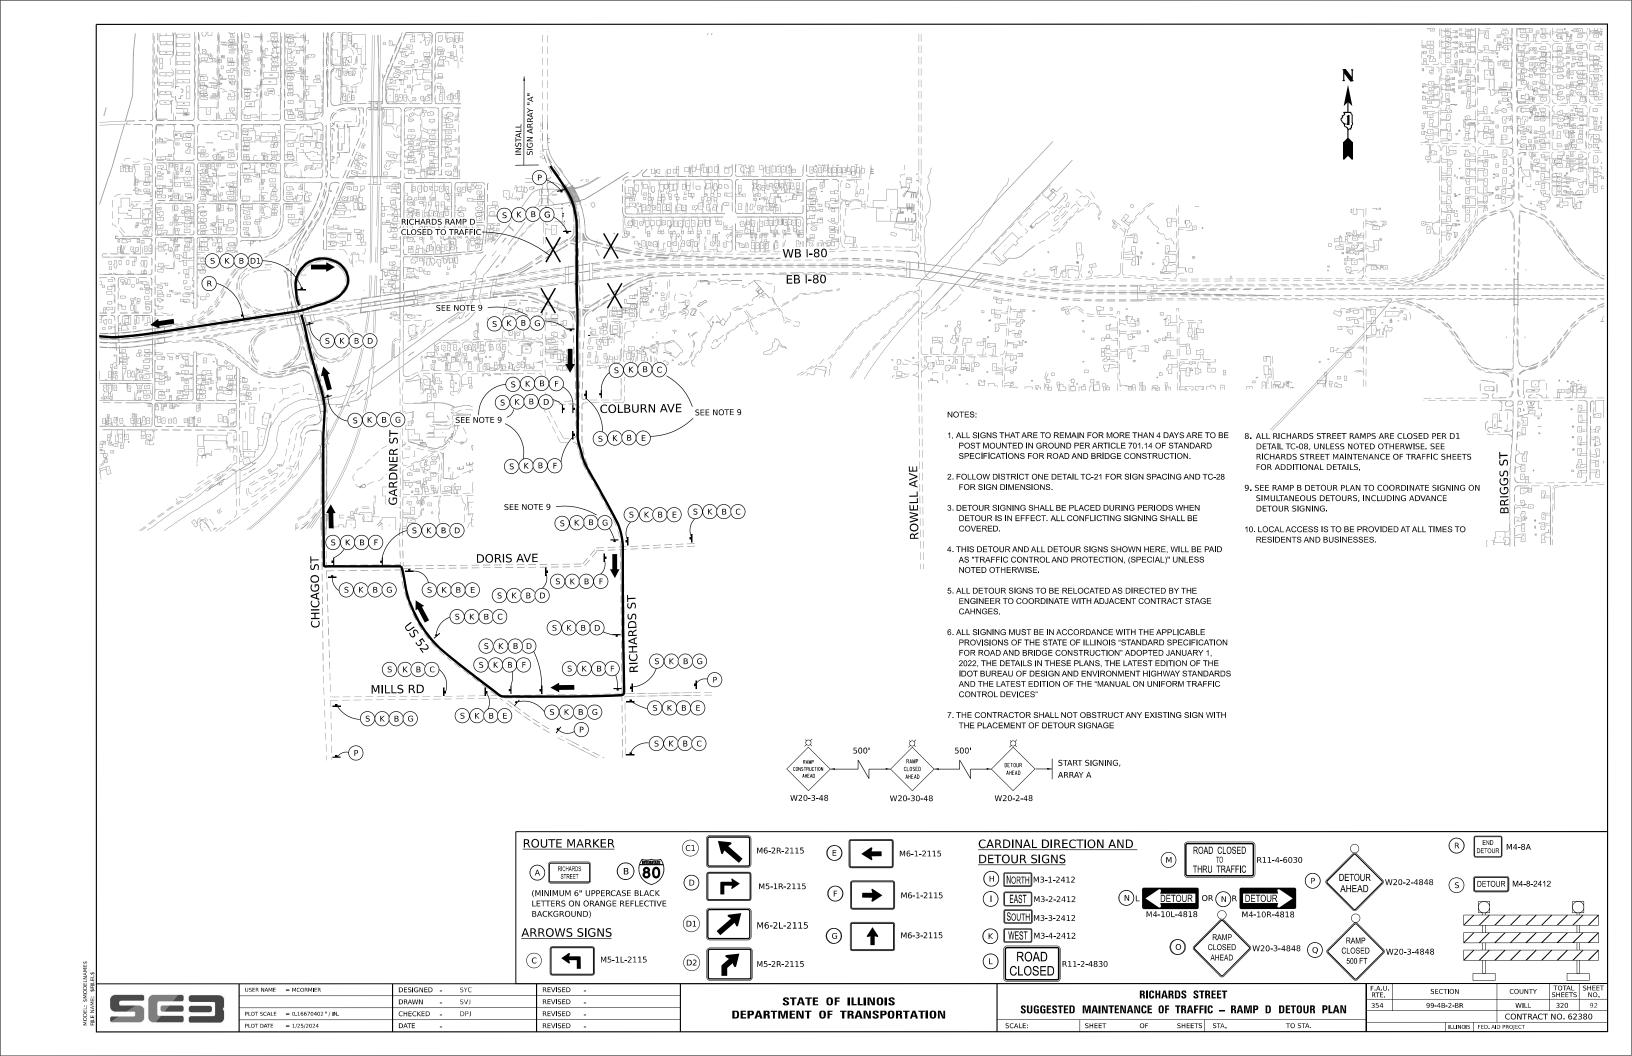

LOCATION	TEMPORARY EROSION CONTROL SEEDING	TEMPORARY DITCH CHECK	PERIMETER EROSION BARRIER	INLET FILTER	TEMPORARY EROSION CONTROL BLANKET	TEMPORARY HEAVY DUTY EROSION CONTROL BLANKET
	28000250	28000305	28000400	28000510	28001100	28001200
	POUND	FOOT	FOOT	EACH	SQ YD	SQ YD
RICHARDS ST STA 47+48 LT TO STA 55+42 LT	81	160	-	9	2,390	1,334
RICHARDS ST STA 48+25 CL TO STA 55+30 CL	19	-	-	-	918	-
RICHARDS ST STA 47+64 RT TO RAMP B STA 12+30 RT	62	-	-	12	2,817	-
RAMP B STA 12+30 RT TO RAMP B STA 20+05 RT	50	-	-	3	2,396	-
RICHARDS ST STA 55+52 LT TO STA 57+77 LT	27	-	-	4	1,281	-
RICHARDS ST STA 55+10 RT TO STA 57+91 RT	12	-	-	6	516	-
RICHARDS ST STA 59+18 LT TO STA 61+43 LT	17	-	-	6	756	-
RICHARDS ST STA 59+35 RT TO STA 61+20 RT	87	60	-	5	2,842	1,269
RICHARDS ST STA 61+41 LT TO STA 65+20 LT	56	60	362	6	2,114	516
RICHARDS ST STA 61+50 CL TO STA 64+57 CL	10	-	-	-	455	-
RICHARDS ST STA 61+48 RT TO STA 64+87 RT	34	70	65	7	366	1,218
RICHARDS ST STA 66+48 LT TO STA 68+98 LT	26	-	146	4	963	-
RICHARDS ST STA 65+95 RT TO STA 72+64 RT	27	-	600	1	1,148	-
RICHARDS STREET RAMP C 114+62 RT TO I-80 STA 755+10 LT	167	540	-	13	4,380	3,600
I-80 STA 717+12 RT TO STA 720+56 RT	4	-	-	-	-	129
TOTAL	679	890	1,173	76	23,342	8,066

\$FILE	
FILE NAME:	5E3

USER NAME = SSCHUESSLER	DESIGNED - JMM	REVISED -
	DRAWN - SVJ	REVISED -
PLOT SCALE = 0.166667 / IN.	CHECKED - SMS	REVISED -
PLOT DATE = 1/25/2024	DATE -	REVISED -

STATI	E OF	F ILLINOIS
DEPARTMENT	OF	TRANSPORTATION

SCALE:

	RICHARDS STREET EROSION AND SEDIMENT CONTROL SCHEDULE					F.A.U. RTE	SECTION	COUNTY	TOTAL SHEETS	SHEET NO.
FC	EROSION AND SEDIMENT CONTROL SCHEDULE						4 99-4B-2-BR WILL		320	93
Li								CONTRACT	NO. 62	380
	SHEET	OF	SHEETS	STA.	TO STA.		ILLINOIS FED.	AID PROJECT		

## EROSION AND SEDIMENT CONTROL GENERAL NOTES

- THE WORK DESCRIBED ON THESE DRAWINGS ARE AN INTEGRAL PART OF THE STORM WATER POLLUTION PREVENTION PLAN USED TO OBTAIN A NPDES PERMIT FROM IEPA FOR THE CONSTRUCTION OF THIS PROJECT.
- THE PURPOSE OF THE EROSION AND SEDIMENT CONTROL MEASURES INCLUDED FOR
  THIS PROJECT IS TO LIMIT THE SEDIMENT POLLUTION IMPACT OF ANY STORM WATER
  DISCHARGES THAT ORIGINATE ON THIS SITE OR OFF-SITE FLOWS THAT FLOW OVER THE
  DISTURBED AREAS ON DOWNSTREAM AREAS.
- 3. IT IS THE RESPONSIBILITY OF THE CONTRACTOR TO INSURE THAT SEDIMENT TRANSPORT OFF THE SITE IS REDUCED BY A COMBINATION OF MINIMIZATION OF EROSION AT THE SOURCE AND INSTALLATION OF SPECIFIC MEASURES TO CONTROL OR REDUCE THE TRANSPORT OF SEDIMENT. A COPY OF THE EROSION AND SEDIMENT CONTROL SCHEDULE BEING IMPLEMENTED BY THE CONTRACTOR SHALL BE ON THE CONSTRUCTION SITE AT ALL TIMES.
- 4. TO THE MAXIMUM EXTENT POSSIBLE, ALL FLOWS ORIGINATING OFF THE CONSTRUCTION SITE WILL BE DIVERTED AROUND DISTURBED AREAS OR WILL BE CONVEYED THROUGH THE SITE IN A MANNER THAT UNTREATED ON-SITE RUNOFF DOES NOT MIX WITH THE OFF-SITE RUNOFF.
- ALL RUNOFF ORIGINATING ON DISTURBED AREAS ASSOCIATED WITH THIS PROJECT WILL PASS THROUGH ONE OR MORE MEASURES THAT WILL MINIMIZE THE OFF-SITE SEDIMENT IMPACTS OF THE CONSTRUCTION ACTIVITY,
- 6. ALL PERMANENT STORM WATER CONTROL MEASURES, AND RUNOFF CONTROL MEASURES REQUIRED TO KEEP OFF-SITE RUNOFF FROM FLOWING OVER THE CONSTRUCTION AREA WILL BE INSTALLED BEFORE CLEARING AND STRIPPING OF THE SITE PROCEEDS. PRIOR TO PROCEEDING WITH GENERAL EARTHWORK ON A PROJECT THE CONTRACTOR WILL OBTAIN APPROVAL OF HIS PROPOSED EARTHWORK AND STABILIZATION SCHEDULE.
- 7. A MAXIMUM OF 10 ACRES MAY BE IN SOME STAGE OF GRADING AT A SINGLE TIME. ADDITIONAL AREAS (UP TO 10 ACRES) MAY BE CLEARED BUT WILL NOT BE STRIPPED OF VEGETATION UNTIL THE GRADED AREAS HAVE BEEN PROTECTED FROM EROSION THROUGH INSTALLATION OF EITHER TEMPORARY OR PERMANENT MEASURES. WHENEVER POSSIBLE, THE GRADING WILL BE COMPLETED TO THE DESIGN GRADE AND THE PERMANENT VEGETATION PLAN IMPLEMENTED PRIOR TO STARTING GRADING ACTIVITIES ON THE NEXT SITE.
  - (A) WHEN BALANCING EARTHWORK (BORROW FROM A CUT USED AS FILL AT A LOCATION DISTANT FROM THE CUT) THE ENGINEER WILL CONSIDER ALLOWING MORE THAN 10 ACRES OF GRADING AT A TIME. THE 10 ACRES LIMITATION DOES NOT INCLUDE HAUL ROADS, BRIDGE CONSTRUCTION WORK AREAS AND STORAGE AREAS
  - (B) VARIATIONS TO THE ABOVE MAY BE CONSIDERED BY THE ENGINEER UNDER ALL THE FOLLOWING CONDITIONS:
    - IF THE CONTRACTOR FALLS BEHIND SCHEDULE THROUGH NO FAULT OF HIS OWN.
    - THE CONTRACTOR MUST PRESENT A SCHEDULE DEMONSTRATING THE NEED FOR SUCH VARIATION IN ORDER TO COMPLETE THE WORK ON TIME.
    - THE CONTRACTOR MUST COMPLY WITH ALL OTHER CONTRACT
    - REQUIREMENTS.
- 8. DISTURBED AREAS ARE TO BE PROTECTED FROM EROSION IN A TIMELY MANNER. UPON COMPLETION OF GRADING OR CONSTRUCTION, THE AREA WILL BE STABILIZED (USING PERMANENT MEASURES WHEN POSSIBLE) WITHIN 1 CALENDAR DAY. TEMPORARY STABILIZATION THROUGH USE OF GROUND COVER, MULCHING, OR OTHER APPROVED MEASURES WILL BE INSTALLED WHENEVER SITE DEVELOPMENT WORK, GRADING OR OTHER EARTH DISTURBING ACTIVITIES CEASE TO BE CONTINUOUS FOR A PERIOD EXCEEDING 14 CALENDAR DAYS. THE 1/14 DAY REQUIREMENT IS TAKEN TO MEAN THAT THE STABILIZATION OPERATION IS COMPLETE OR NEARING COMPLETION IN THE DEFINED TIME.
- STABILIZATION MEASURES SHOULD BE INSTALLED ON CUT OR FILL SLOPES IN ACCORDANCE WITH THE ILR10 PERMIT REGARDLESS OF HEIGHT OF CUT OR FILL SLOPE. ONCE THE STABILIZATION MEASURES ARE INSTALLED, THE PLACEMENT OF FILL OR EXCAVATION ACTIVITIES ARE ALLOWED TO PROCEED.
- 10. THE CONTRACTOR SHALL DESIGNATE ONE OF HIS EMPLOYEES AS RESPONSIBLE FOR IMPLEMENTATION OF THE EROSION AND SEDIMENT CONTROL PLAN ON ALL DISTURBEDAREAS. THIS PERSON IS TO BE KNOWLEDGEABLE ABOUT INSTALLATION AND MAINTENANCE OF THE REQUIRED MEASURES. THIS EMPLOYEE IS TO HAVE THE AUTHORITY TO CARRY OUT THE IMPLEMENTATION OF ANY INSTRUCTIONS CONCERNING THE EROSION AND SEDIMENT CONTROL PLAN GIVEN BY THE ENGINEER, ALL MEASURES WILL BE INSPECTED BY THIS INDIVIDUAL AND THE ENGINEER ON A REGULAR BASIS (AT LEAST ONCE EVERY 7 DAYS) AND AFTER RAINFALL EVENTS GREATER THAN 1/2 INCH OR EQUIVALENT SNOWFALL AND AFTER EACH SIGNIFICANT SNOWMELT.
- 11. ALL EROSION AND SEDIMENT CONTROL MEASURES SHALL BE MAINTAINED DURING THE CONSTRUCTION SEASON AS WELL AS THE WINTER MONTHS AND OTHER TIMES WHEN THE PROJECT IS CLOSED DOWN. ALL EROSION AND SEDIMENT CONTROL MEASURES WILL BE MAINTAINED IN ACCORDANCE WITH THE IDOT EROSION AND SEDIMENT CONTROL FIELD GUIDE FOR CONSTRUCTION INSPECTION (DATED JULY 1, 2010) AND IDOT'S BEST MANAGEMENT PRACTICES:

(HTTP://WWW.IDOT.ILLINOIS.GOV/ASSETS/UPLOADS/FILES/TRANSPORTATION-SYSTEM/MANUALS-GUIDES-&HANDBOOKS/HIGHWAYS/ENVIRONMENT/EROSION%20AND %20SEDIMENT%20CONTROL%20FIELD%20GUIDE%20FOR%20CONSTRUCTION%20 INSPECTION.PDF)


- 12. SALVAGED TOPSOIL SHALL BE PLACED ON WELL DRAINED LAND AWAY FROM INTERMITTENT AND LIVE STREAMS OR WETLANDS WITH THE APPROPRIATE RUNOFF CONTROL AND SEDIMENT CONTROL MEASURES INSTALLED AROUND THE STORAGE SITE AND STABILIZED IMMEDIATELY AFTER FINAL SHAPING OF THE PILE IN ACCORDANCE WITH MULCH, METHOD 2. THE CONTRACTOR WILL PROVIDE AN ADEQUATE QUANTITY OF SILT FENCE TO CONTROL THE PERIMETER OF THE STOCKPILE.
- 13. MATERIALS EXCAVATED FOR THE CONSTRUCTION OR CLEANOUT OF SEDIMENT TRAPS OR SEDIMENT BASINS SHALL NOT BE STOCKPILED IN THE VICINITY OF THE TRAP OR BASIN. IT WILL EITHER BE PLACED IN AN EMBANKMENT OR WASTED AS DIRECTED BY THE FINGINFER.
- 14. EXCAVATION TO BE USED FOR EMBANKMENTS SHALL NOT BE STOCKPILED UNLESS PERIMETER CONTROLS ARE UTILIZED. WHEN THIS MATERIAL IS STOCKPILED FOR THE CONVENIENCE OF THE CONTRACTOR THE COST OF THE CONTROLS ARE BORNE BY THE CONTRACTOR. IF THE MATERIAL IS STOCKPILED AT THE DIRECTION OF THE ENGINEER THE DEPARTMENT WILL ASSUME THE COST OF THE CONTROLS.
- 15. SEDIMENT LADEN DEWATERING DISCHARGE MUST BE DIRECTED TO AN APPROVED SEDIMENT TRAPPING MEASURE PRIOR TO RELEASE FROM THE SITE,
- 16. WHEN THE CONTRACTOR REQUESTS A CHANGE TO POSTPONE COMPLETION OF THE EXCAVATION OF A SPECIFIC AREA AS A CONTINUOUS OPERATION AND PLACING THE TOPSOIL AS DEFINED IN THE STANDARD SPECIFICATIONS, THE ENGINEER MAY ALLOW THE CONTRACTOR TO STABILIZE THE AREA USING TEMPORARY STABILIZATION WITH STRAW MULCH PROVIDING THE FOLLOWING CONDITIONS ARE MET:

  (A) ALL AREAS BEING STABILIZED ARE 3:1 SLOPES OR FLATTER.

  (B) THE CONTRACTOR BEARS THE COST OF PREPARING THE SEED BED AND STABILIZING THE AREA WITH TEMPORARY STABILIZATION WITH STRAW MULCH.

  (C) ALL REQUIRED SEDIMENT CONTROL MEASURES FOR THE SECTION OF ROAD IN QUESTION HAVE BEEN INSTALLED AND ARE BEING MAINTAINED.
- 17. SEEDING USAGE
  TEMPORARY EROSION CONTROL SEEDING USED ON SHORT TERM TEMPORARY
  SEEDING. CLASS 2A SALT TOLERANT ROADSIDE MIX USED FOR NEW CONSTRUCTION
  OF LIMITED ACCESS ROUTES INTENDED TO BE MOWED BY IDOT.
- 18. TOP SOIL PLACEMENT
  TOPSOIL WILL BE PLACED ON FINAL SLOPES WHICH WILL NOT BE DISTURBED BY
  FUTURE CONSTRUCTION, TOPSOIL WILL NOT BE PLACED ON SURFACES WHICH WILL BE
  PAVED IN THE FUTURE, NOR ON TEMPORARY SLOPES.
- 19. INLET FILTERS ARE REQUIRED FOR THE STRUCTURES SHOWN ON THE PLANS. STRUCTURE OPENINGS VARY SUCH THAT FIELD MEASUREMENT AND/OR CONTRACTOR DESIGN WILL BE REQUIRED. COST OF DESIGN, LABOR AND MATERIALS WILL NOT BE PAID FOR SEPARATELY, BUT WILL BE INCLUDED IN THE CONTRACT UNIT PRICE PER EACH FOR "INLET FILTERS".
- 20. THE CONSTRUCTION LIMITS WILL BE STAKED BY THE CONTRACTOR PRIOR TO COMMENCING CONSTRUCTION. THE CONSTRUCTION LIMITS MAY BE ADJUSTED BY THE ENGINEER TO PRESERVE TREES AND NO ADDITIONAL COMPENSATION WILL BE PAID TOTHE CONTRACTOR FOR CHANGED CONSTRUCTION LIMITS.
- 21. THE RESIDENT ENGINEER SHALL HAVE FINAL DETERMINATION OF THE PLACEMENT AND LOCATION OF THE SEDIMENT CONTROL SILT FENCE,
- 22. SEE EROSION AND SEDIMENT CONTROL PLANS FOR PLACEMENT OF ALL EROSION AND SEDIMENT CONTROL PAY ITEMS.
- 23. SEE PROPOSED DRAINAGE PLANS FOR TEMPORARY AND FINAL DRAINAGE STRUCTURE, STORM SEWER AND PIPE CULVERT INFORMATION.
- 24. SEE EXISTING DRAINAGE AND UTILITY PLANS FOR INFORMATION CONCERNING THE REMOVAL, ADJUSTMENT, RECONSTRUCTION, ETC. OF EXISTING STRUCTURE AND PIPES.
- 25. THE ACTUAL NEED FOR TEMPORARY DRAINAGE FACILITIES, AS WELL AS THE STAGING OF THE PERMANENT DRAINAGE SYSTEM CONSTRUCTION, MAY BE MODIFIED BY THE ENGINEER, WHO SHALL BE CONSULTED BEFORE THE INSTALLATION.
- 26. EROSION CONTROL MEASURES SHALL BE REMOVED ONLY WHERE INDICATED ON THE PLANS. COST OF REMOVAL SHALL NOT BE PAID FOR SEPARATELY, BUT WILL BE INCLUDED IN THE CONTRACT UNIT PRICE FOR THE TYPE OF MEASURE INDICATED ON THE PLANS.
- 27. LOCATIONS OF STABILIZED CONSTRUCTION ENTRANCES/EXITS SHALL BE DETERMINED BY THE CONTRACTOR AND APPROVED BY THE ENGINEER. THE INSTALLATION OF THE ENTRANCE/EXITS SHALL BE IN ACCORDANCE WITH THE ILLINOIS URBAN MANUAL OR AS DIRECTED BY THE ENGINEER. AN ESTIMATED QUANTITY FOR STABILIZED CONSTRUCTION ENTRANCES HAS BEEN PROVIDED IN THE CONTRACT.
- 28. WHEN STORM SEWER IS UNDER CONSTRUCTION, CONTRACTOR SHALL PROVIDE A PLAN ACCEPTABLE TO THE ENGINEER TO PREVENT EROSION AND SEDIMENTATION FROM RUNOFF ENTERING OR EXITING THE STORM SEWER CONSTRUCTION.

- 29. THE CONTRACTOR SHOULD PROVIDE TO THE ENGINEER A PLAN TO ENSURE THAT A STABILIZED FLOW LINE WILL BE PROVIDED DURING STORM SEWER CONSTRUCTION. THE USE OF A STABILIZED FLOW LINE BETWEEN INSTALLED STORM SEWER AND OPEN DISTURBANCE WILL REDUCE THE POTENTIAL FOR THE OFFSITE DISCHARGE OF SEDIMENT-BEARING WATERS, ESPECIALLY WHEN RAIN IS FORECASTED, SO THAT FLOW WILL NOT ERODE. LACK OF APPROVED PLAN OR FAILURE TO COMPLY WILL RESULT IN AN ESC DEFICIENCY DEDUCTION.
- 30. ANY LOOSE MATERIAL DEPOSITED IN THE FLOW LINE OF DRAINAGE STRUCTURES, WHICH OBSTRUCTS THE NATURAL FLOW OF WATER, SHALL BE REMOVED AT THE CLOSE OF EACH WORKING DAY. PRIOR TO ACCEPTANCE OF THE IMPROVEMENT, ALL DRAINAGE STRUCTURES SHALL BE FREE OF DIRT AND DEBRIS. THIS WORK WILL NOT BE PAID FOR SEPARATELY BUT SHALL BE CONSIDERED IN THE COST OF EARTH EXCAVATION.
- 31. UNDER NO CIRCUMSTANCES SHALL THE CONTRACTOR PROLONG FINAL GRADING AND SHAPING SO THAT THE ENTIRE PROJECT CAN BE PERMANENTLY SEEDED AT ONE TIME.
- 32. EROSION CONTROL ITEMS ARE CONSIDERED TO BE A HIGH PRIORITY ON THIS CONTRACT. THE CONTRACTOR IS RESPONSIBLE FOR INSTALLATION OF ANY ADDITIONAL EROSION CONTROL MEASURES NECESSARY TO PREVENT EROSION AND SEDIMENTATION AS DETERMINED BY THE ENGINEER.
- 33. UNDER NO CIRCUMSTANCES SHALL THE CONTRACTOR PROLONG FINAL GRADING AND SHAPING SO THAT THE ENTIRE PROJECT CAN BE PERMANENTLY SEEDED AT ONE TIME.

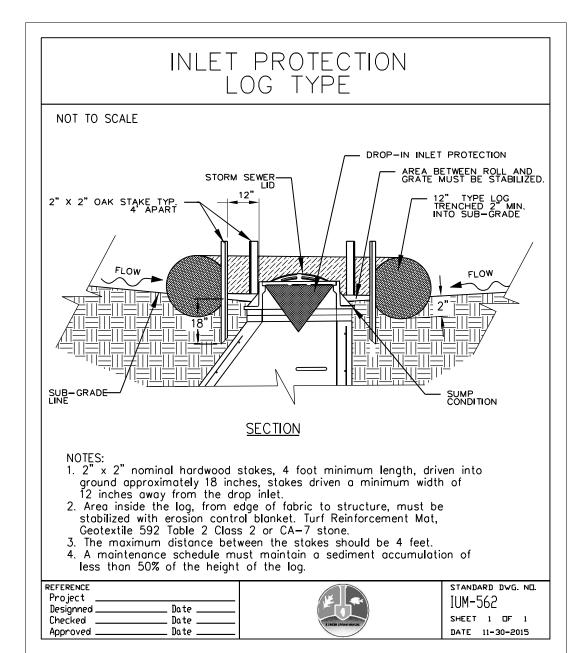



SCALE:

		RICH	ARDS ST	REET			F.
ene	ROSION AND SEDIMENT CONTROL GENERAL NOTES						3
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	F.A.U RTE	SECTION	COUNTY	TOTAL SHEETS	SHEET NO.	
	354	99-4B-2-BR		WILL	320	94
_				CONTRACT	NO. 62	380
ILLINOIS FED. AII				D PROJECT		

