04-26-2024 LETTING ITEM 085

INDEX OF SHEETS COVER SHEET

3-7

10-17

18-21 22

23-49

GENERAL NOTES

DETOUR PLAN

BRIDGE PLANS

HIGHWAY STANDARDS

DESIGN DESIGNATION I-55: INTERSTATE

ADT: 35,500 (2022)

7.700

ADT: 4,850 (2021)

SU: 240

MU: 200

IL 104: MINOR ARTERIAL

SU:

MU:

701006-05 701402-12 701451-05 701101-05 701411-09 701901-09

SUMMARY OF QUANTITIES

SCHEDULE OF QUANTITIES

TRAFFIC CONTROL PLAN - 1-55

TRAFFIC CONTROL PLAN - IL 104

MAXIMUM WIDTH SIGNING DETAIL

000001-08 701106-02 701426-09 704001-08 642001-03 701326-04 701428-01 780001-05 701001-02 701400-12 701446-11 782006-01

781001**-**04

 \circ

 \circ

0

0

STATE OF ILLINOIS DEPARTMENT OF TRANSPORTATION

D-96-082-22

55 (84-5-1VHB)BDR,BP,BJR,BRR SANGAMON 49 1

COUNTY

ILLINOIS CONTRACT NO. 72189

SECTION

PROPOSED HIGHWAY PLANS

PROJECT HBFP-3AP8(540) **BRIDGE REPAIR SANGAMON COUNTY** BEGIN IMPROVEMENT

FAI ROUTE 55 (I-55) SECTION (84-5-1VHB)BDR,BP,BJR,BRR C-96-024-23 R5W

STA. 514 + 50.35 (I-55) SN 084-0109 (NB) SN 084-0110 (SB) RD JOAN DR BOBBY DR (104)Illinois Cr. END IMPROVEMENT E DIVERNON STA. 517 + 28.60 (I-55)

Divernon

LOCATION OF SECTION INDICATED THUS: -

FULL SIZE PLANS HAVE BEEN PREPARED USING STANDARD ENGINEERING SCALES. REDUCED SIZED PLANS WILL NOT CONFORM TO STANDARD SCALES. IN MAKING MEASUREMENTS ON REDUCED PLANS. THE ABOVE SCALES MAY BE USED.

JOINT UTILITY LOCATION INFORMATION FOR EXCAVATORS 1-800-892-0123 OR 811

PROJECT ENGINEER: JON KELLEY (217) 785-2739 PROJECT MANAGER: ED KERN (217) 524-7547

CONTRACT NO. 72189

REGISTERED **PROFESSIONAL** ENGINEER ARON M. SCHAFER

REGISTERED PROFESSIONAL ENGINEER STATE OF ILLINOIS NO. 062-065354 LICENSE EXPIRES NOVEMBER 30, 2025

LOCATION MAP GROSS LENGTH = 278.25 FT. = 0.053 MILE NET LENGTH = 278.25 FT. = 0.053 MILE



Engineers • Architects • Surveyors

Pawnee_

E DIVERNON

19

DESIGN FIRM NO. 184-2738

STATE OF ILLINOIS DEPARTMENT OF TRANSPORTATION March 22, 202

> PRINTED BY THE AUTHORITY OF THE STATE OF ILLINOIS

> > REV. - MS

GENERAL NOTES

- FOR HORIZONTAL CONTROL AND CENTERLINE ALIGNMENT METADATA PLEASE CONTACT IDOT DISTRICT 6 CHIEF OF SURVEYS AT 217-782-8707.
- NOTIFY THE BUREAU OF OPERATIONS AT 217-785-5306, 21 DAYS BEFORE ANY ROAD CLOSURE OR WIDTH RESTRICTIONS AND 7 DAYS BEFORE IMPLEMENTING ANY TRAFFIC CONTROL.

APPLICATION RATES

STONE RIPRAP
BITUMINOUS MATERIALS - TACK COAT

(EXISTING HMA, MILLED SURFACE, CONCRETE, MILLED/TINED CONCRETE)
BITUMINOUS MATERIALS - TACK COAT

(BETWEEN HMA LIFTS, IL 4.75, BRICK)
HMA SURFACE/BINDER (112 LBS)

1.75 TON/CU YD 0.05 LBS/SQ FT

0.025 LBS/SQ FT

0.056 TONS/(SQ YD * IN)

MIX TABLES

MIXTURE USE	HMA BASE COURSE WIDENING (LOWER LIFTS)	HMA BASE COURSE WIDENING (TOP LIFT)			
PG	PG 64-22	PG 64-22			
DESIGN AIR VOIDS	4.0% @ N50	4.0% @ N50			
MIXTURE COMPOSITION	IL-19.0	IL-9.5			
FRICTION AGGREGATE	N/A	MIX "C"			
QUALITY MANAGEMENT	QC/QA	QC/QA			
SUBLOT SIZE	N/A	N/A			

MIXTURE USE	HMA SURFACE COURSE (I-55 SHOULDERS)
PG	PG 64-22
DESIGN AIR VOIDS	4.0% @ N70
MIXTURE COMPOSITION	IL-9.5
FRICTION AGGREGATE	MIX "D"
QUALITY MANAGEMENT	QC/QA
SUBLOT SIZE	N/A
MIXTURE WEIGHT	112 LB/SY*IN
MATERIAL TRANSFER DEVICE REQUIRED	NO

STATE OF ILLINOIS **DEPARTMENT OF TRANSPORTATION DIVISION OF HIGHWAYS** DISTRICT 6 January, 8 20 24 **EXAMINED ENGINEER OF OPERATIONS** January, 16 20 24 **EXAMINED** ENGINEER OF PROJECT IMPLEMENTATION January, 22 20 24 **EXAMINED**

TO STA.

ENGINEER OF PROGRAM DEVELOPMENT

KLINGNER & ASSOCIATES, P.C. ngineers • Architects • Surveyors 616 N.24TH ST. QUINCY, ILLINOIS 62301 217.223.3670 STATE OF ILLINOIS DESIGN FIRM NO. 184-2738

DESIGNED -REVISED DRAWN REVISED CHECKED REVISED PLOT DATE = 2/9/2024 REVISED DATE

STATE OF ILLINOIS **DEPARTMENT OF TRANSPORTATION**

COMMITMENTS

F.A.I. ROUTE 55 **GENERAL NOTES** SHEET 1 OF 1 SHEETS STA.

SCALE: NONE

SECTION COUNTY 55 (84-5-1VHB)BDR,BP,BJR,BRR SANGAMON 49 2 CONTRACT NO. 72189

				PPS# 6-01454-0100				
				0.00/ 5.55	PPS# 6-0	1454-0100		
				90% FED				
				10% STATE				
CODE			TOTAL	BR I DGE				
	ITEM	UNIT	TOTAL	0047				
NO.	- · <u>-</u> · ·		QUANTITY				 	
				SN 084-0109/0110				
20200500	EARTH EXCAVATION (WIDENING)	CU YD	204	204				
20700110	DODOUG CRANILLAD EMPANYATENT	TON	205	205				
20700110	POROUS GRANULAR EMBANKMENT	TON	295	295				
28100805	STONE DUMPED RIPRAP, CLASS A3	TON	26	26				
20100003	STONE DOMED KITKAT, CLASS AS	1011	20	20				
		+					+	
35600724	HOT-MIX ASPHALT BASE COURSE WIDENING, 12"	SQ YD	1,833	1,833				
	·	1 ,	,	,				
]	
		1						
40600290	BITUMINOUS MATERIALS (TACK COAT)	POUND	391	391				
44000157	HOT-MIX ASPHALT SURFACE REMOVAL, 2"	SQ YD	869	869				
44004250	PAVED SHOULDER REMOVAL	SQ YD	1,833	1,833				
44004230	FAVED SHOULDEN REMOVAL	30 10	1,033	1,033				
48203100	HOT-MIX ASPHALT SHOULDERS	TON	98	98				
50102400	CONCRETE REMOVAL	CU YD	39.7	39.7				
50104650	SLOPE WALL REMOVAL	SQ YD	313	313				
<u> </u>		1					+	
50157200	DROTECTIVE CHIELD	SQ YD	1 477	1 477]	
50157300	PROTECTIVE SHIELD	טו טכ	1,477	1,477				
		1						
		1					 	
50300100	FLOOR DRAINS	EACH	16	16				
-							 	
50300225	CONCRETE STRUCTURES	CU YD	27.4	27.4				
50300255	CONCRETE SUPERSTRUCTURE	CU YD	41.2	41.2				
<u> </u>		+					 	

WLINGS P.C.

A S S O CIA TE S. P.C.

Engineers · Architects · Surveyors

STATE OF ILLNOIS DENOIS FIRM NO. 104-2738

USER NAME = ebb	DESIGNED -	REVISED -
	DRAWN -	REVISED -
PLOT SCALE = 40.0000 / in.	CHECKED -	REVISED -
PLOT DATE = 2/9/2024	DATE -	REVISED -

STATI	OF ILLINOIS	
DEPARTMENT	OF TRANSPORTAT	ION

							F.A.I. RTE	SECTION	1		
	SUMMARY OF QUANTITIES							55	(84-5-1VHB)BDR,B	P,I	
SCALE:	NONE	SHEET	1	OF	5	SHEETS	STA.	TO STA.		ILLII	NO!

F.A.I. RTE	SECT	ION		COUNTY	TOTAL SHEETS	SHEET NO.
55	(84-5-1VHB)BD	R,BP,BJ	R,BRR	SANGAMON	49	3
				CONTRACT	NO. 72	2189
		ILLINOIS	FED. AI	D PROJECT		

		PPS# 6-01454-0100					
				90% FED	PP5# 0-U	1454-0100	
				10% STATE			
		1	1				
CODE	1.7504		TOTAL	BRIDGE			
NO.	ITEM	UNIT	OUANTITY	0047			
			Q 37 1	SN 084-0109/0110			
		60.1/5					
50300300	PROTECTIVE COAT	SQ YD	3,825	3,825			
50500405	FURNISHING AND ERECTING STRUCTURAL STEEL	POUND	22,707	22,707			
		1					
50800205	REINFORCEMENT BARS, EPOXY COATED	POUND	9,750	9,750			
ļ							
50800515	BAR SPLICERS	EACH	56	56			
E1100100	CLOPE WALL A INCL	SQ YD	212	212			
51100100	SLOPE WALL 4 INCH	30 10	313	313			
52000110	PREFORMED JOINT STRIP SEAL	FOOT	257	257			
		<u> </u> 					
52100010	ELASTOMERIC BEARING ASSEMBLY, TYPE I	EACH	42	42			
52100520	ANCHOR BOLTS, 1"	EACH	84	84			
				-			
59300100	CONTROLLED LOW-STRENGTH MATERIAL	CU YD	50	50			
39300100	CONTROLLED LOW-STRENGTH MATERIAL	00 15	50	30			
			2.505	2.505			
64200116	SHOULDER RUMBLE STRIPS, 16 INCH	FOOT	2,605	2,605			
67000400	ENGINEER'S FIELD OFFICE, TYPE A	CAL MO	12	12			
		-					
67100100	MOBILIZATION	L SUM	1	1			
70100420	TRAFFIC CONTROL AND PROTECTION, STANDARD 701411	EACH	2	2			
		-					
	<u> </u>	-	<u> </u>			<u> </u>	
70100500	TRAFFIC CONTROL AND PROTECTION, STANDARD 701326	L SUM	1	1			
		ļ					
70100815	TRAFFIC CONTROL AND PROTECTION, STANDARD 701446	L SUM	1	1]
	TRAITIC CONTROL AND TROTECTION, STANDARD 701440			<u> </u>		<u> </u>	
							

BASSOCIATES, P.C.
Engineers · Architects · Surveyors
616 N24714 ST. QUINCY, ILLINGS 62901 217 223-3570
STATE OF ILLINGS 10500 FRIM NO. 1642-738

USER NAME = ebb	DESIGNED -	REVISED -
	DRAWN -	REVISED -
PLOT SCALE = 40.0000 ' / in.	CHECKED -	REVISED -
PLOT DATE = 2/9/2024	DATE -	REVISED -

STATI	OF ILLINOIS	
DEPARTMENT	OF TRANSPORTA	ΓΙΟΝ

I		F.A.I. ROUTE !	F.A.I. RTE.	SECTION	COUNTY	TOTAL SHEETS		
ı		SUMMARY OF QUA	ANTITIES	55	(84-5-1VHB)BDR,BP,BJR,BR	R SANGAMON	49	4
ļ						CONTRACT	NO. 72	2189
ı	SCALE: NONE	SHEET 2 OF 5 SHEETS	STA. TO STA.		ILLINOIS FED.	AID PROJECT		

			PPS# 6-01454-0100				
				90% FED 10% STATE			
CODE			TOTAL	BRIDGE			
CODE	ITEM	UNIT	TOTAL	0047			
NO.			QUANTITY	SN 084-0109/0110			
				_			
70100820	TRAFFIC CONTROL AND PROTECTION, STANDARD 701451	L SUM	1	1			
70102015	TRAFFIC CONTROL CURVETH ANCE	CAL DA	F	-			
70103815	TRAFFIC CONTROL SURVEILLANCE	CAL DA	5	5			
70107025	CHANGEABLE MESSAGE SIGN	CAL DA	200	200			
70107025	CHANGEABLE MESSAGE SIGN	CAL DA	200	200			
		<u> </u>					
70200100	NIGHTTIME WORK ZONE LIGHTING	L SUM	1	1			
1 3233100							
						1	
70400100	TEMPORARY CONCRETE BARRIER	FOOT	1,700	1,700			
			,	,			
70400200	RELOCATE TEMPORARY CONCRETE BARRIER	FOOT	1,838	1,838			
		<u> </u>					
70600260	IMPACT ATTENUATORS, TEMPORARY (FULLY REDIRECTIVE, NARROW), TEST LEVEL 3	EACH	4	4			
			_	_			
70600332	IMPACT ATTENUATORS, RELOCATE (FULLY REDIRECTIVE, NARROW), TEST LEVEL 3	EACH	5	5			
k 78009005	 MODIFIED URETHANE PAVEMENT MARKING - LINE 5"	FOOT	9,824	9,824			
K 78009005	MODIFIED ORETHANE PAVEMENT MARKING - LINE 3	1001	9,024	9,024			
k 78100100	RAISED REFLECTIVE PAVEMENT MARKER	EACH	90	90			
•		1					
			<u> </u>			<u> </u>	
78300200	RAISED REFLECTIVE PAVEMENT MARKER REMOVAL	EACH	90	90			
		+					
		1	<u> </u>				
78300202	PAVEMENT MARKING REMOVAL - WATER BLASTING	SQ FT	3,008	3,008			
		1					
	CUPTAGE FILLED (CDECUL)	CALLOSS	_	_			
X0326444	SURFACE FILLER (SPECIAL)	GALLON	5	5			
		<u>L</u>					
X5030250	BRIDGE DECK GROOVING (LONGITUDINAL)	SQ YD	2,718	2,718			
73030230	BINDOL DECK GROOVING (ECNOTIODINAL)	30 15	2,710	2,710			
SPECIALT	/ ITEM						

REV. - MS

* SPECIALTY ITEM

نة		USER NAME = ebb	DESIGNED	-
NAME:	& ASSOCIATES, P.C.		DRAWN	-
щ	Engineers • Architects • Surveyors	PLOT SCALE = 40.0000 ' / in.	CHECKED	-
Ē	616 N.24TH ST. QUINCY, ILLINOIS 62301 217.223.3670 STATE OF ILLINOIS DESIGN FIRM NO. 184-2738	PLOT DATE = 2/9/2024	DATE	-

STATE OF ILLINOIS
DEPARTMENT OF TRANSPORTATION

REVI SED

REVISED

REVISED -

REVISED -

SCALE: NONE SHEET 3 OF 5 SHEETS STA.	l	F.A.I. ROUTE 55										
SCALE: NONE SHEET 3 OF 5 SHEETS STA.	l				SU	MM/	\RY	OF QU	ANTITIES			
	Ī	SCALE:	NONE	SHEET	3	OF	5	SHEETS	STA.			

TO STA.

					CONSTRUC	TION CODE	
						1454-0100	
				90% FED			T
				10% STATE			
				BRIDGE			
CODE	ITEM	UNIT	TOTAL	0047			+
NO.	116	ONTI	QUANTITY				
				SN 084-0109/0110			
X5030550	PROTECTIVE COAT (SPECIAL)	SQ YD	805	805			
V2020220	PROTECTIVE COAT (SPECIAL)	30 10	803	803			
		E.A.G.I.	_	_			
X7010208	TRAFFIC CONTROL AND PROTECTION, STANDARD 701402 (SPECIAL)	EACH	2	2			
							+
X7010216	TRAFFIC CONTROL AND PROTECTION, (SPECIAL)	L SUM	1	1			
							+
		1					+
X7200201	WIDTH RESTRICTION SIGNING	L SUM	1	1			
			_				
Z0001899	JACK AND REMOVE EXISTING BEARINGS	EACH	42	42			
20001699	JACK AND REMOVE EXISTING BEAKINGS	LACII	42	42			
		T					
Z0012754	STRUCTURAL REPAIR OF CONCRETE (DEPTH EQUAL TO OR LESS THAN 5 INCHES)	SQ FT	1,102	1,102			
							+
Z0001903	STRUCTURAL STEEL REMOVAL	POUND	9,555	9,555			
Z0007101	CONTAINMENT AND DISPOSAL OF LEAD PAINT CLEANING RESIDUES NO. 1	L SUM	1	1			
			_	_			
Z0007102	CONTAINMENT AND DISPOSAL OF LEAD PAINT CLEANING RESIDUES NO. 2	L SUM	1	1			
2000/102	CONTAINMENT AND DISPOSAL OF LEAD FAINT CLEANING RESIDUES NO. 2	L 30141	1	1			
Z0010501	CLEANING AND PAINTING STEEL BRIDGE NO. 1	L SUM	1	1			
							+
		+				 	+
Z0010502	CLEANING AND PAINTING STEEL BRIDGE NO. 2	L SUM	1	1			
		1				-	
		1					+
Z0012148	BRIDGE DECK SCARIFICATION 3"	SQ YD	3,742	3,742			
		1	· ·	·			
Z0012170	BRIDGE DECK MICROSILICA CONCRETE OVEDLAV 3 1/4"	SQ YD	3,742	3,742			
20012170	BRIDGE DECK MICROSILICA CONCRETE OVERLAY 3 1/4"		3,742	3,742			<u> </u>
		1.					
Z0013798	CONSTRUCTION LAYOUT	L SUM	1	1			
		+				+	+
		1	L			I	

A A S O C I A T E S, P. C.

Engineers - Architects - Surveyors
STATE OF ILLNOS 52301 217.223,5670
STATE OF ILLNOS 52301 78M NO. 169-2738

USER NAME = ebb	DESIGNED -	REVISED -
	DRAWN -	REVISED -
PLOT SCALE = 40.0000 / in.	CHECKED -	REVISED -
PLOT DATE = 2/9/2024	DATE -	REVISED -

STATE OF ILLINOIS
DEPARTMENT OF TRANSPORTATION

							F.A.I. RTE	SECTION	
		SU	MM/	ARY	OF QU	ANTITIES		55	(84-5-1VHB)BDR,BI
SCALE: NONE	SHEET	4	OF	5	SHEETS	STA.	TO STA.		ILLIN

 F.A.I. RTE.
 SECTION
 COUNTY
 TOTAL SHEETS
 SHEETS NO.

 55
 (84-5-1VHB)BDR,BJR,BRR
 SANGAMON
 49
 6

 CONTRACT NO. 72189

 ILLINOIS
 FED. AID PROJECT

tation\CADD Sheets\72189-sht_Sum

220146\Work Order 03 - 1-55 over IL 104 Bridge Repairs\Transpo

						CONSTRUC	TION CODE	
					90% FED	PP5# 6-U	1454-0100	
					90% FED			
_				1	10% STATE			
	CODE			TOTAL	BRIDGE			
		ITEM	UNIT	OUANTITY	0047			
	NO.			QUANTITY	SN 084-0109/0110			
\vdash					31 084-0109/0110			
_								
	Z0016001	DECK SLAB REPAIR (FULL DEPTH, TYPE I)	SQ YD	9	9			
	20010001	SEEK SEAS RELATION (LOCE SELTIN, THE 1)	30 15					
	Z0016002	DECK SLAB REPAIR (FULL DEPTH, TYPE II)	SQ YD	90	90			
-								
	Z0016702	DETOUR SIGNING	L SUM	1	1			
	20010702	DETOUR SIGNING	L 30141	1	1			
\vdash			+					
	Z0029090	DIAMOND GRINDING (BRIDGE SECTION)	SQ YD	3,579	3,579			
\perp								
	70040655	DAU DOAD DROTECTIVE LIABULTY INCLUDANCE	I CLIM	-	1	·		
	Z0048665	RAILROAD PROTECTIVE LIABILITY INSURANCE	L SUM	1	1			
	Z0076600	TDAINEES	HOUR	1500	1500			
	20070000	TRAINEES	HOOK	1500	1500			
-								
	Z0076604	TRAINEES TRAINING PROGRAM GRADUATE	HOUR	1500	1500			
F								
\vdash								
H			+				+	
\perp			1					
H			+				+	
L								
Г								
\vdash			+					
L								
Г								
1				1				1
_	042							

REV. - MS

& ASSOCIATES, P.C.
Engineers - Architects - Surveyors
60 N24TH ST. OUNCY, ILLINGS 82302 17, 222, 3270
STATE OF ILLINGS SESSIFIEM DO 1882-738

SER NAME = ebb	DESIGNED -	REVISED -
	DRAWN -	REVISED -
LOT SCALE = 40.0000 / in.	CHECKED -	REVISED -
LOT DATE = 2/9/2024	DATE -	REVISED -

TRAFFIC CONTROL AND PROTECTION

			70400100	70400200	70600260	70600332
LOCATION	STATION T	O STATION	TEMP CONCRETE BARRIER	RELOCATE TEMP CONC BARRIER	IMPACT ATTENUATORS TEMP FRN, TL3	IMPACT ATTN RELOCATE FRN, TL3
			FOOT	FOOT	EACH	EACH
STAGE 1						
I-55 NB	514+50.00	519+86.70	537.5		1	
I - 55 SB	511+92.10	517+29.00	537.5		1	
IL 104	98+69.00	101+29.50	262.5		1	
IL 104	99+32.50	101+93.00	262.5		1	
STAGE 2						
I-55 NB	514+50.00	519+74.40		525.0		1
I - 55 SB	512+04.60	517+29.00		525.0		1
IL 104	98+21.00	101+29.50	50	262.5		1
IL 104	99+29.50	102+38.00	50	262.5		1
STAGE 3		•		•		
IL 104	98+69.00	101+29.50		262.5		1
TOTALS			1700	1838	4	5

HMA ASPHALT BASE COURSE WIDENING

٦	2	Λ	Λ	1	0

				20200500	35600724	44004250
CTATION T	O CTATION	SIDE WIDTH		EARTH EXCAVATION	HMA ASPHALT BASE	PAVED SHOULDER
STATION	O STATION	SIDE	WIDIH	(WIDENING)	COURSE WIDENING 12"	REMOVAL
			FOOT	CU YD	SQ YD	SQ YD
IL 104						
95+67.00	103+92.00	RT/OUTSIDE	10.0	101.9	916.7	916.7
96+67.00	104+92.00	LT/OUTSIDE	10.0	101.9	916.7	916.7
TOTAL				203.8	1833.3	1833.3
USE	•	•		204	1833	1833

RAISED REFLECTIVE PAVEMENT MARKERS

78100100

			78100100	78300200
			RAISED	RAISED
CTATION T	O STATION	SIDE	REFLECTIVE	REFLECTIVE
STATION I	O STATION	SIDE	PAVEMENT	PAVEMENT
			MARKER	MARKER REMOVAL
			EACH	EACH
I-55				
509+13.10	514+51.00	LT/RT	28	28
517+29.00	521+36.30	LT/RT	22	22
510+42.80	514+51.00	LT/RT	22	22
517+29.00	520+52.80	LT/RT	18	18
TOTALS			90	90

PAVEMENT MARKING REMOVAL - WATER BLASTING

78300202

STATION TO STATION		SIDE DESCRIPTION		WHITE	YELLOW
		SIDE	DESCRIPTION	SQ FT	SQ FT
I-55					
509+13.10	532+84.00	LT	EDGE LINE (SOLID)	461.4	115.8
514+51.00	532+84.00	LT	CENTERLINE (DASHED)	493.9	
495+42.80	520+52.80	RT	EDGE LINE (SOLID)	612.9	115.8
495+42.80	520+52.80	RT	CENTERLINE (DASHED)	520.2	
IL 104					
96+67.00	104+92.00	LT	EDGE LINE (SOLID)	343.8	
95+67.00	103+92.00	RT	EDGE LINE (SOLID)	343.8	
TOTAL				2776.0	231.6
USE				30	80

MODIFIED URETHANE PAVEMENT MARKING - LINE 5"

78009005

STATION TO STATION		SIDE DESCRIPTION		WHITE	YELLOW
		SIDE	DESCRIPTION	FOOT	FOOT
I-55					
509+13.10	532+84.00	LT	EDGE LINE (SOLID)	1938.5	1223.2
509+13.10	532+84.00	LT	CENTERLINE (DASHED)	1185.5	
495+42.80	520+52.80	RT	EDGE LINE (SOLID)	1567.6	1010.0
495+42.80	520+52.80	RT	CENTERLINE (DASHED)	1248.5	
IL 104					
96+67.00	104+92.00	LT	EDGE LINE (SOLID)	825.0	
95+67.00	103+92.00	RT	EDGE LINE (SOLID)	825.0	
TOTAL				7590.1	2233.2
USE			·	98	24

HMA SURFACE REMOVAL, 2"

44000157

STATION TO STATION SIDE	WIDTH	DEPTH	AREA
JIAHON TO STATION SIDE			7111271
	FOOT	INCH	SQ YD
I-55			
509+13.10 514+51.00 LT INSIDE	3	2	179.0
517+29.00 521+36.30 LT INSIDE	3	2	135.8
509+13.10 513+36.90 LT OUTISDE	3	2	141.3
517+29.00 521+36.30 LT OUTSIDE	3	2	135.8
510+42.80 511+39.50 RT OUTSIDE	3	2	32.23
510+42.80 514+51.00 RT INSIDE	3	2	135.7
517+29.00 520+52.80 RT INSIDE	3	2	107.9
TOTAL			868.3
USE			869

SHOULDER RUMBLE STRIPS, 16 INCH

64200116

CTATION	CIDE	LENGTH
STATION	SIDE	FOOT
514+51.00	LT INSIDE	536.9
521+36.30	LT INSIDE	407.3
513+36.90	LT OUTISDE	423.8
521+36.30	LT OUTSIDE	407.3
511+39.50	RT OUTSIDE	96.7
514+51.00	RT INSIDE	407.2
520+52.80	RT INSIDE	323.8
•		2605.0
		2605
	521+36.30 513+36.90 521+36.30 511+39.50 514+51.00	514+51.00 LT INSIDE 521+36.30 LT INSIDE 513+36.90 LT OUTISDE 521+36.30 LT OUTSIDE 511+39.50 RT OUTSIDE 514+51.00 RT INSIDE


HMA SHOULDERS

48203100

STATION TO	O STATION	SIDE	TON
I-55			
509+13.10	514+51.00	LT INSIDE	20.0
517+29.00	521+36.30	LT INSIDE	15.2
509+13.10	513+36.90	LT OUTISDE	15.8
517+29.00	521+36.30	LT OUTSIDE	15.2
510+42.80	511+39.50	RT OUTSIDE	3.6
510+42.80	514+51.00	RT INSIDE	15.2
517+29.00	520+52.80	RT INSIDE	12.1
TOTAL			97.1
USE			98

ER NAME = aschafer	DESIGNED -	REVISED -
	DRAWN -	REVISED -
OT SCALE = 40.0000 / in.	CHECKED -	REVISED -
DT DATE = 2/7/2024	DATE -	REVISED -

F.A.I. ROUTE 55							F.A.I. RTE	SECTION		COUNTY	TOTAL SHEETS	SHEET NO.	
SCHEDULE OF QUANTITIES						55	(84-5-1VHB)BDR,BP,BJR,	,BRR	SANGAMON	49	8		
CONEDULE OF GOMETITIES									CONTRACT	NO. 72	2189		
SCALE:	NONE	SHEET 1	OF	1	SHEETS	STA.	TO STA.		ILLINOIS	FED. AI	D PROJECT		

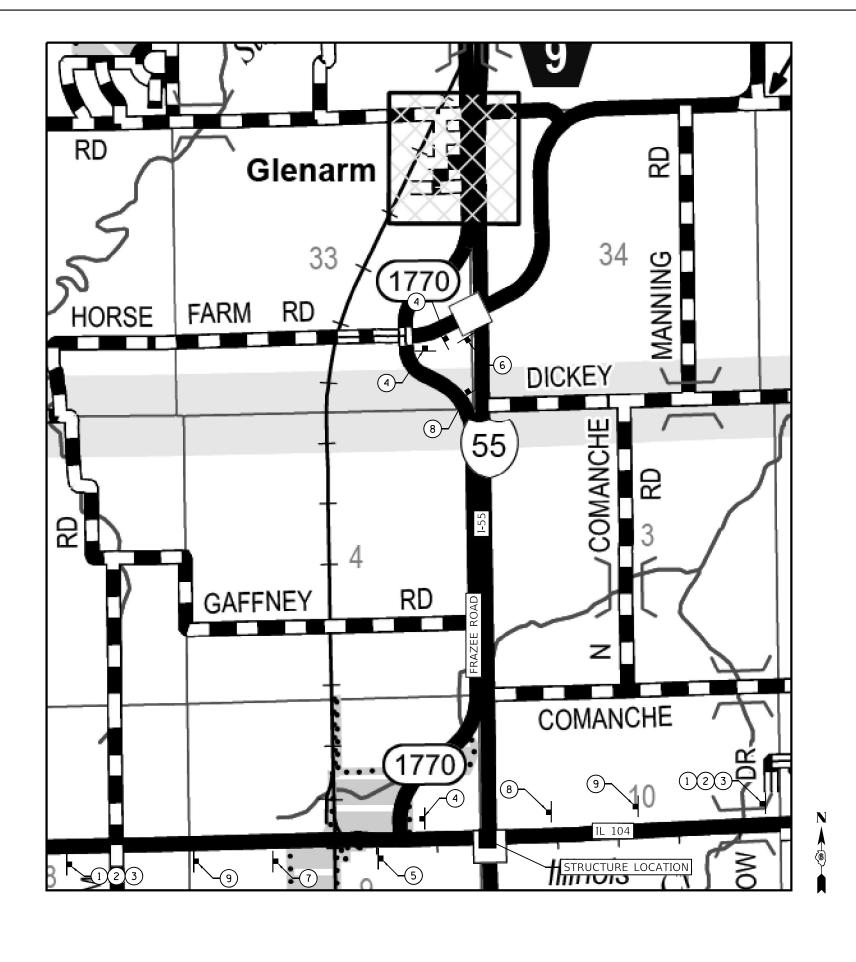

GENERAL NOTES

- 1) FLAGS SHALL BE USED AT EACH DETOUR SIGN LOCATION.
- 2) SEE SHEETS 10-17 FOR DETAILS OF TRAFFIC CONTROL AND PROTECTION ON I-55.
- 3) ALL SIGNS SHALL BE FURNISHED, ERECTED, AND MAINTAINED BY THE CONTRACTOR.
- 4) THE LONGITUDINAL DIMENSIONS MAY BE ADJUSTED TO FIT FIELD CONDITIONS.
- 5) ALL SIGNS SHALL BE REMOVED WHEN NOT REQUIRED FOR FUTURE USE.
- 6) FURNISHING, ERECTING, MAINTAINING, AND REMOVAL OF THE SIGNS SHOWN SHALL BE PAID FOR ACCORDING TO THE CONTRACT UNIT COST PER LUMP SUM FOR "DETOUR SIGNING".
- 7) THE EXACT LOCATIONS OF ALL TRAFFIC CONTROL ITEMS SHALL BE APPROVED BY THE ENGINEER.
- 8) IF SIGNS ARE NOT IN USE THEY SHALL BE COVERED.
- IDOT DISTRICT 6 BUREAU OF OPERATIONS (217-785-5306) SHALL BE NOTIFIED 21 DAYS PRIOR TO ANY RAMP CLOSURE REQUIRING DETOUR

SIGNAGE LEGEND

1 - R11-3(O) - 60"x30" 2 EACH

4 — M4-8 (O) M3-3 (W) M1-1

M6-1R (O)

3 EACH

DETOUR

SOUTH

55

- 2 R11-3(O) 60"x30" 2 EACH
- 3 R11-3(O) 60"x30" 2 EACH

I-55 RAMP SOUTH

CLOSED

0.5 MILES AHEAD

6 – M4-8a (O) M3-3 (W) M1-1

1 EACH

END DETOUR

SOUTH


55

LOCATE ON SB RAMP AT THE GLENARM EXIT

- I-55 RAMP SOUTH CLOSED **3 MILES AHEAD**
- I-55 RAMP SOUTH CLOSED
- 1.5 MILES AHEAD
- 5 M4-8 (O) M3-3 (W) M1-1 1 EACH





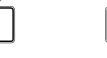



8 – M4-8 (O) M3-3 (W)



M5-1L (O)

55















9 — M20-2 (O) 2 EACH




KLINGNER	
& ASSOCIATES, P.C.	
Engineers · Architects · Surveyors	
616 N.24TH ST. QUINCY, ILLINOIS 62301 217 223 3670	Γ

USER NAME = aschafer	DESIGNED -	REVISED -
	DRAWN -	REVISED -
PLOT SCALE = 5000.0000 / in.	CHECKED -	REVISED -
PLOT DATE = 2/7/2024	DATE -	REVISED -

STATE OF ILLINOIS **DEPARTMENT OF TRANSPORTATION**

		F.A.I. ROUTE 55 Detour Plan					
SCALE: none	SHEET	1	OF	1	SHEETS	STA.	

F.A.I. RTE	SECTION			COUNTY	TOTAL SHEETS	SHEE NO.
55	(84-5-1VHB)BDR,BF	P,BJ	R,BRR	SANGAMON	49	9
		CONTRACT	NO. 72	2189		
	TUTNE	OIC	EED A	ID DROJECT		

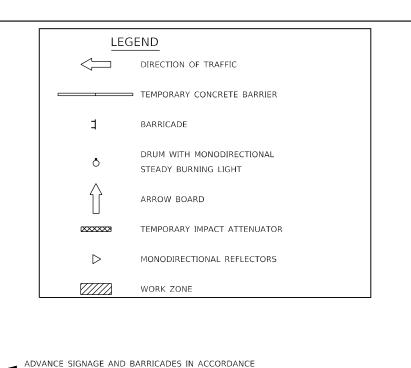

THE FOLLOWING STAGE CONSTRUCTION SEQUENCE IS FOR INFORMATION ONLY. THE CONTRACTOR IS RESPONSIBLE FOR PLANNING AND EXECUTING THIS PROJECT WHICH SHALL BE SUBJECT TO THE APPROVAL OF THE ENGINEER.

PRE-STAGE 1:

UTILIZE TRAFFIC CONTROL AND PROTECTION STANDARD 701400, 701411, AND 701446. MEDIAN AND OUTSIDE SHOULDERS:

REMOVE CONFLICTING RUMBLE STRIPS (HMA SURFACE REMOVAL 2" - 3FT WIDE)
INSTALL HMA SHOULDERS (TONS)

STAGE 1:

SET-UP STAGE 1 TRAFFIC CONTROL

CLOSE RAMP B, UTILIZE TRAFFIC CONTROL AND PROTECTION STANDARD 701451.

CONSTRUCT EAST HALF OF SN 084-0109 IMPROVEMENTS.

CONSTRUCT WEST HALF OF SN 0840110 IMPROVEMENTS.

UTILIZE TRAFFIC CONTROL AND PROTECTION STANDARDS 701400, 701402, AND 701411.

EXISTING GUARDRAIL TO REMAIN IN PLACE.

REMOVE STAGE 1 TRAFFIC CONTROL.

GENERAL NOTES

DRUMS WITH STEADY BURNING LIGHTS, TEMPORARY PAVEMENT MARKINGS, ARROW BOARDS, SIGNS, REFLECTORS/MARKERS, AND INDICATOR BARRICADES WITH STEADY BURNING LIGHTS, SHALL BE INCLUDED IN THE COST OF THE PAY ITEM "TRAFFIC CONTROL AND PROTECTION, STANDARD 701402 (SPECIAL)".

EXISTING SHOULDER IS ADEQUATE FOR SUPPORTING TAPERED TRAFFIC SINCE THE SHOULDER WAS STRENGTHENED ON PREVIOUS CONTRACT.

THIS WORK SHALL SUPPLEMENT AND BE IN ACCORDANCE WITH HIGHWAY STANDARD 701402. ADVANCE SIGNAGE AND BARRICADES IN ACCORDANCE WITH HIGHWAY STANDARDS 701400.

RAMP B CLOSURE AND ADVANCE SIGNAGE IN ACCORDANCE WITH HIGHWAY STANDARD 701451 AND RAMP C TRAFFIC CONTROL AND PROTECTION IN ACCORDANCE WITH HIGHWAY STANDARD 701411.


HIGHWAY STANDARD 701446 TO BE UTILIZED IF THERE IS NIGHT WORK.


THE CONTRACTOR SHALL PLACE MAX WIDTH SIGNS BEFORE IMPLEMENTING ANY STAGE TRAFFIC CONTROL.

REMOVE ALL CONFLICTING PAVEMENT MARKINGS. ARIEL SPEED MARKERS HAVE BEEN PLACED IN THE NB LANES, NORTH OF INTERCHANGE. THE EXACT LOCATIONS OF THE ARIEL MARKERS SHALL BE VERIFIED BY FIELD PERSONNEL. IF THE ARIEL MARKERS ARE WITHIN SECTIONS REQUIRING PAVEMENT MARKING REMOVAL WATER BLASTING, THE ARIEL MARKERS SHALL NOT BE REMOVED IN ANY WAY.

LANE-REDUCTION PAVEMENT ARROWS THAT CONFLICT WITH STAGED TRAFFIC MARKINGS SHALL BE COVERED WITH BLACKOUT TAPE. THE COST OF ALL BLACKOUT TAPE AND REMOVAL SHALL BE INLCUDED IN THE COST OF THE PAY ITEM "TRAFFIC CONTROL AND PROTECTION, STANDARD 701402 (SPECIAL)".

TRAFFIC CONTROL MAY BE ADJUSTED DUE TO FIELD CONDITIONS APPROVED BY ENGINEER.

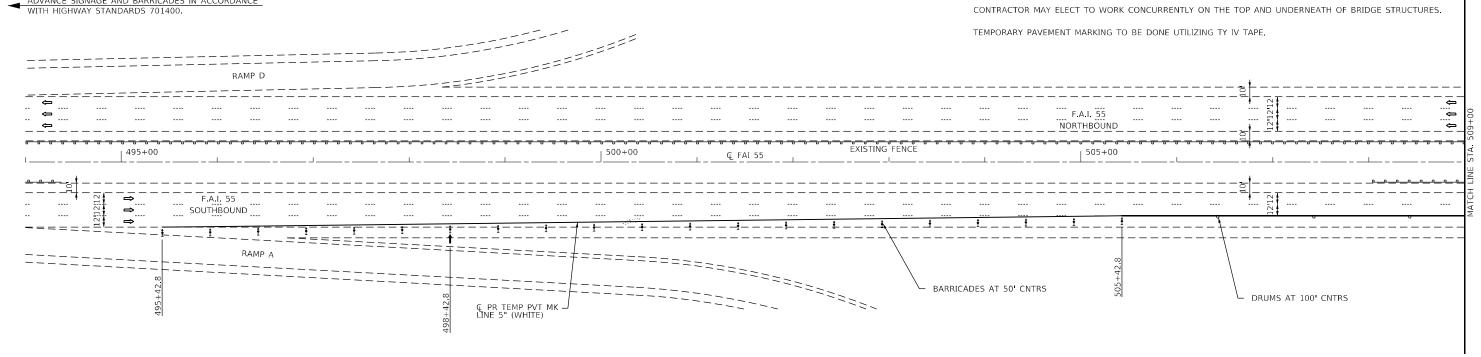

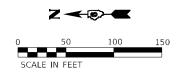


: P:\C	KLINGNER	US
IAME:	& ASSOCIATES, P.C.	
LE N	Engineers • Architects • Surveyors	PLO
Ē	616 N.24TH ST. QUINCY, ILLINOIS 62301 217.223.3670 STATE OF ILLINOIS DESIGN FIRM NO. 184-2738	PLO


USER NAME = aschafer	DESIGNED -	REVISED -
	DRAWN -	REVISED -
PLOT SCALE = 100.0000 / in.	CHECKED -	REVISED -
PLOT DATE = 2/7/2024	DATE -	REVISED -

STATE OF ILLINOIS
DEPARTMENT OF TRANSPORTATION

F.A.I. ROUTE 55							
TRAFFIC CONTROL PLAN (STAGE 1)							
SCALE: 1"=50'	SHEET 1	OF 4	SHEETS	STA. 494+00.00	TO STA. 509+00.00		

F.A.I. RTE	SECTION			COUNTY	TOTAL SHEETS	SHEET NO.
55	(84-5-1VHB)BDR,BP,BJR,BRR			SANGAMON	49	10
				CONTRACT	NO. 72	2189
		LIMOTC	EED A	ID DDOLECT		

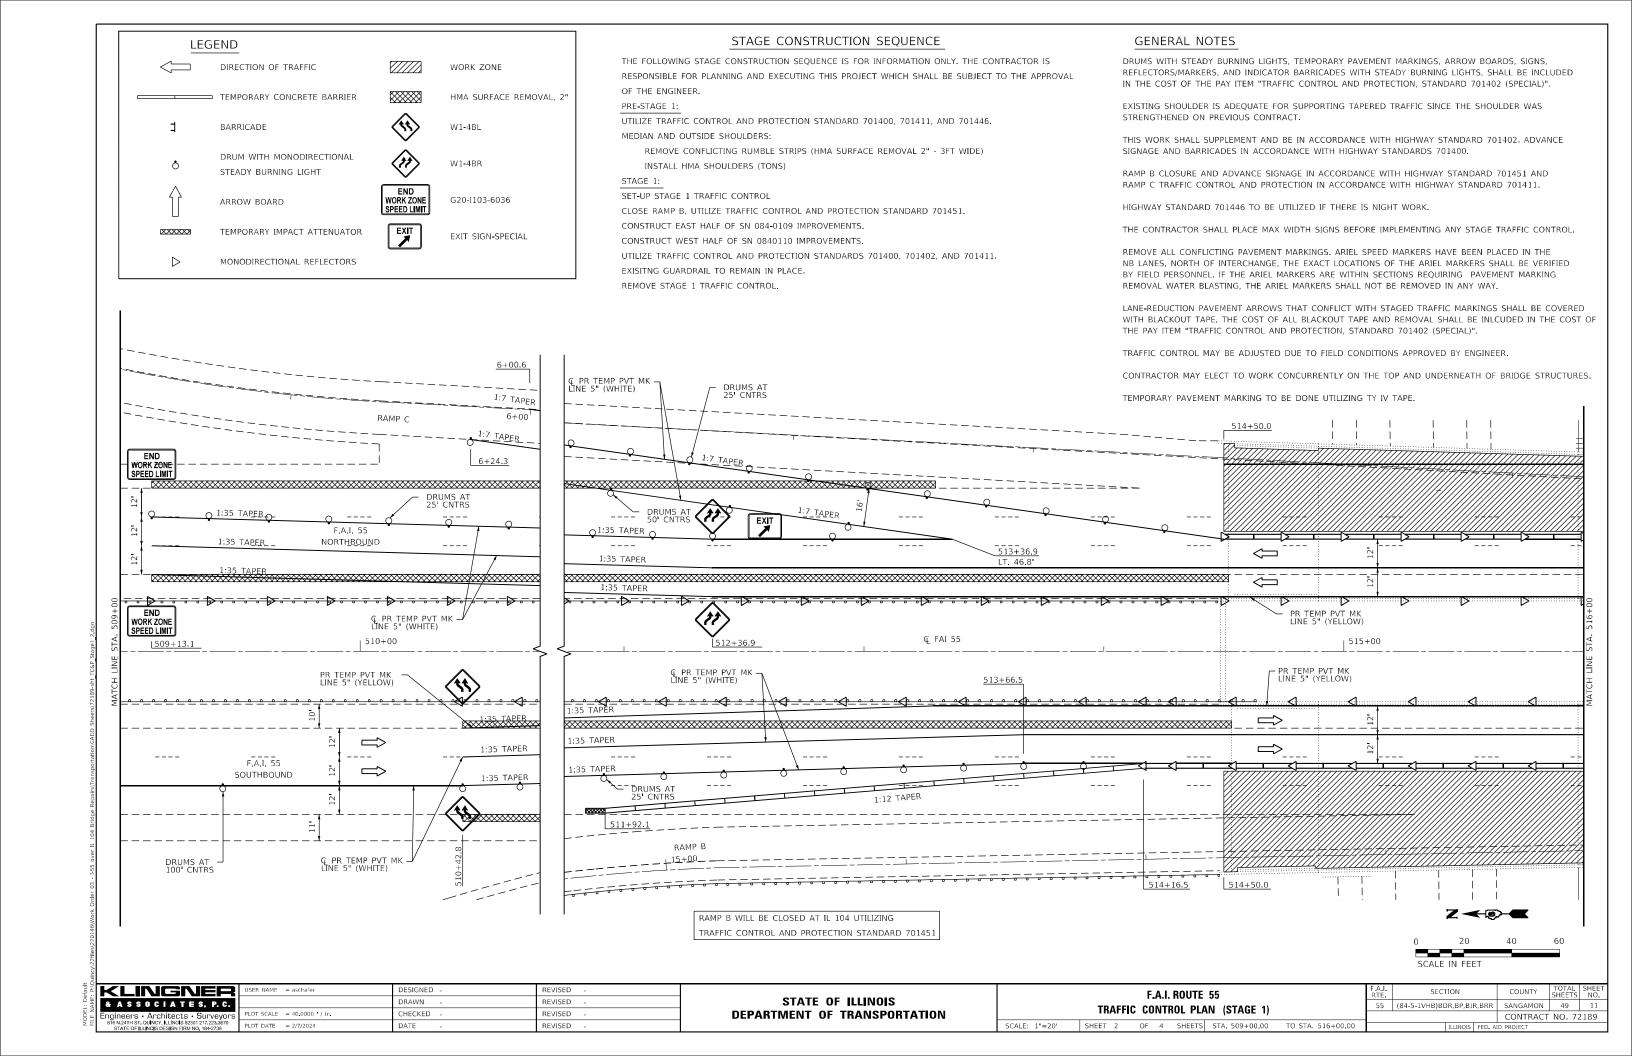

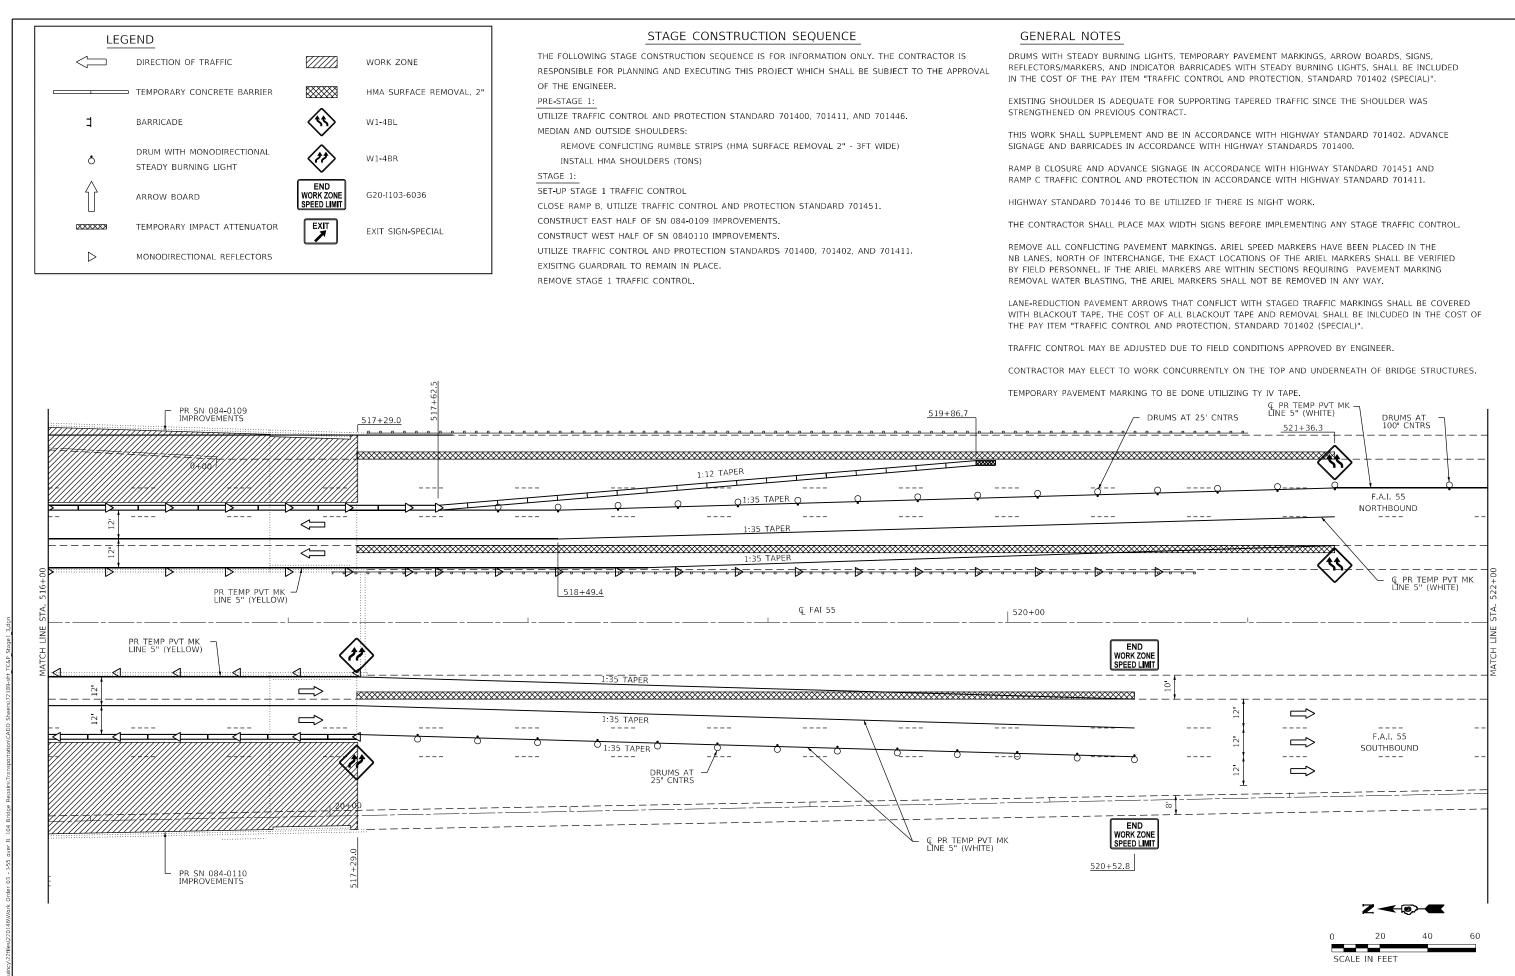


& ASSOCIATES, P.C.
Engineers · Architects · Surveyors
616 N.241 N.S. C. Olivo, ILLINOS 8230 217.223,9870
STATE OF ILLINOS 8230 FIRM NO, 184-2738

STATE OF ILLINOIS
DEPARTMENT OF TRANSPORTATION

F.A.I. ROUTE 55

TRAFFIC CONTROL PLAN (STAGE 1)

SHEET 3 OF 4 SHEETS STA. 516+00.00 TO STA. 522+00.00

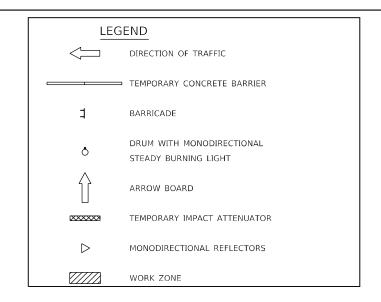

THE FOLLOWING STAGE CONSTRUCTION SEQUENCE IS FOR INFORMATION ONLY. THE CONTRACTOR IS RESPONSIBLE FOR PLANNING AND EXECUTING THIS PROJECT WHICH SHALL BE SUBJECT TO THE APPROVAL OF THE ENGINEER.

PRE-STAGE 1:

UTILIZE TRAFFIC CONTROL AND PROTECTION STANDARD 701400, 701411, AND 701446.

MEDIAN AND OUTSIDE SHOULDERS:

REMOVE CONFLICTING RUMBLE STRIPS (HMA SURFACE REMOVAL 2" - 3FT WIDE)

INSTALL HMA SHOULDERS (TONS)

STAGE 1:

SET-UP STAGE 1 TRAFFIC CONTROL

CLOSE RAMP B, UTILIZE TRAFFIC CONTROL AND PROTECTION STANDARD 701451.

CONSTRUCT EAST HALF OF SN 084-0109 IMPROVEMENTS.

CONSTRUCT WEST HALF OF SN 0840110 IMPROVEMENTS.

UTILIZE TRAFFIC CONTROL AND PROTECTION STANDARDS 701400, 701402, AND 701411.

EXISITNG GUARDRAIL TO REMAIN IN PLACE.

REMOVE STAGE 1 TRAFFIC CONTROL.

GENERAL NOTES

DRUMS WITH STEADY BURNING LIGHTS, TEMPORARY PAVEMENT MARKINGS, ARROW BOARDS, SIGNS, REFLECTORS/MARKERS, AND INDICATOR BARRICADES WITH STEADY BURNING LIGHTS, SHALL BE INCLUDED IN THE COST OF THE PAY ITEM "TRAFFIC CONTROL AND PROTECTION, STANDARD 701402 (SPECIAL)".

EXISTING SHOULDER IS ADEQUATE FOR SUPPORTING TAPERED TRAFFIC SINCE THE SHOULDER WAS STRENGTHENED ON PREVIOUS CONTRACT.

THIS WORK SHALL SUPPLEMENT AND BE IN ACCORDANCE WITH HIGHWAY STANDARD 701402. ADVANCE SIGNAGE AND BARRICADES IN ACCORDANCE WITH HIGHWAY STANDARDS 701400.

RAMP B CLOSURE AND ADVANCE SIGNAGE IN ACCORDANCE WITH HIGHWAY STANDARD 701451 AND RAMP C TRAFFIC CONTROL AND PROTECTION IN ACCORDANCE WITH HIGHWAY STANDARD 701411.

HIGHWAY STANDARD 701446 TO BE UTILIZED IF THERE IS NIGHT WORK.

THE CONTRACTOR SHALL PLACE MAX WIDTH SIGNS BEFORE IMPLEMENTING ANY STAGE TRAFFIC CONTROL.


REMOVE ALL CONFLICTING PAVEMENT MARKINGS. ARIEL SPEED MARKERS HAVE BEEN PLACED IN THE NB LANES, NORTH OF INTERCHANGE. THE EXACT LOCATIONS OF THE ARIEL MARKERS SHALL BE VERIFIED BY FIELD PERSONNEL. IF THE ARIEL MARKERS ARE WITHIN SECTIONS REQUIRING PAVEMENT MARKING REMOVAL WATER BLASTING, THE ARIEL MARKERS SHALL NOT BE REMOVED IN ANY WAY.


LANE-REDUCTION PAVEMENT ARROWS THAT CONFLICT WITH STAGED TRAFFIC MARKINGS SHALL BE COVERED WITH BLACKOUT TAPE. THE COST OF ALL BLACKOUT TAPE AND REMOVAL SHALL BE INLCUDED IN THE COST OF THE PAY ITEM "TRAFFIC CONTROL AND PROTECTION, STANDARD 701402 (SPECIAL)".

TRAFFIC CONTROL MAY BE ADJUSTED DUE TO FIELD CONDITIONS APPROVED BY ENGINEER.

CONTRACTOR MAY ELECT TO WORK CONCURRENTLY ON THE TOP AND UNDERNEATH OF BRIDGE STRUCTURES.

TEMPORARY PAVEMENT MARKING TO BE DONE UTILIZING TY IV TAPE.

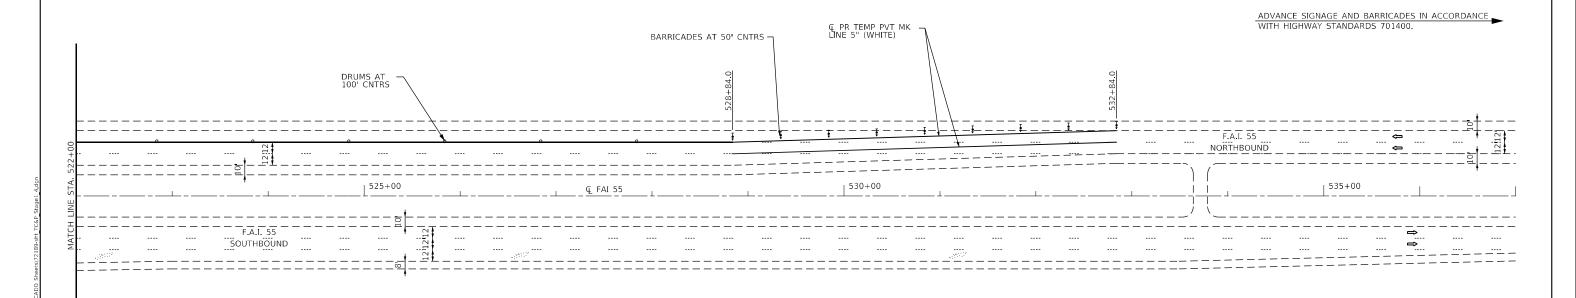

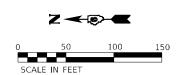


. 3		
	KLINGNER	US
NAME:	& ASSOCIATES, P.C.	
E	Engineers · Architects · Surveyors	PL
Ē	616 N.24TH ST. QUINCY, ILLINOIS 62301 217 223 3670 STATE OF ILLINOIS DESIGN FIRM NO. 184-2738	PL

SER NAME = aschafer	DESIGNED -	REVISED -	Ī
	DRAWN -	REVISED -	
OT SCALE = 100.0000 / in	CHECKED -	REVISED -	
OT DATE = 2/7/2024	DATE -	REVISED -	

STATE OF ILLINOIS
DEPARTMENT OF TRANSPORTATION

F.A.I. ROUTE 55								
TRAFFIC CONTROL PLAN (STAGE 1)								
SCALE: 1"=50'	SHEET 4	OF	4	SHEETS	STA. 522+00.00	TO STA. 537+00.00		

F.A.I. RTE	SECTION			COUNTY	TOTAL SHEETS	SHEET NO.
55	(84-5-1VHB)BDR,BP,BJR,BRR			SANGAMON	49	13
				CONTRACT	NO. 72	2189
		ILLINOIS	FED. A	D PROJECT		

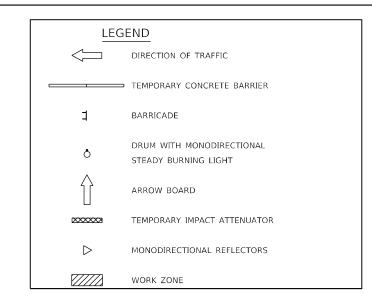

THE FOLLOWING STAGE CONSTRUCTION SEQUENCE IS FOR INFORMATION ONLY. THE CONTRACTOR IS RESPONSIBLE FOR PLANNING AND EXECUTING THIS PROJECT WHICH SHALL BE SUBJECT TO THE APPROVAL OF THE ENGINEER.

STAGE 2:

SET-UP STAGE 2 TRAFFIC CONTROL.

CONSTRUCT WEST HALF OF SN 084-0109 IMPROVEMENTS.

CONSTRUCT EAST HALF OF SN 0840110 IMPROVEMENTS.

UTILIZE TRAFFIC CONTROL AND PROTECTION STANDARDS 701400, 701402, AND 701411.

EXISTING GUARDRAIL TO REMAIN IN PLACE.

REMOVE STAGE 2 TRAFFIC CONTROL.

OPEN RAMP B.

STAGE 3:

INSTALL PAVEMENT MARKINGS.

UTILIZE TRAFFIC CONTROL AND PROTECTION STANDARD 701426.

INSTALL SHOULDER RUMBLE STRIPS, 16 INCH.

GENERAL NOTES

DRUMS WITH STEADY BURNING LIGHTS, TEMPORARY PAVEMENT MARKINGS, ARROW BOARDS, SIGNS, REFLECTORS/MARKERS, AND INDICATOR BARRICADES WITH STEADY BURNING LIGHTS, SHALL BE INCLUDED IN THE COST OF THE PAY ITEM "TRAFFIC CONTROL AND PROTECTION, STANDARD 701402 (SPECIAL)".

EXISTING SHOULDER IS ADEQUATE FOR SUPPORTING TAPERED TRAFFIC SINCE THE SHOULDER WAS STRENGTHENED ON PREVIOUS CONTRACT.

THIS WORK SHALL SUPPLEMENT AND BE IN ACCORDANCE WITH HIGHWAY STANDARD 701402. ADVANCE SIGNAGE AND BARRICADES IN ACCORDANCE WITH HIGHWAY STANDARDS 701400.

RAMP B CLOSURE AND ADVANCE SIGNAGE IN ACCORDANCE WITH HIGHWAY STANDARD 701451 AND RAMP C TRAFFIC CONTROL AND PROTECTION IN ACCORDANCE WITH HIGHWAY STANDARD 701411.

HIGHWAY STANDARD 701446 TO BE UTILIZED IF THERE IS NIGHT WORK.

THE CONTRACTOR SHALL PLACE MAX WIDTH SIGNS BEFORE IMPLEMENTING ANY STAGE TRAFFIC CONTROL.


REMOVE ALL CONFLICTING PAVEMENT MARKINGS. ARIEL SPEED MARKERS HAVE BEEN PLACED IN THE NB LANES, NORTH OF INTERCHANGE. THE EXACT LOCATIONS OF THE ARIEL MARKERS SHALL BE VERIFIED BY FIELD PERSONNEL. IF THE ARIEL MARKERS ARE WITHIN SECTIONS REQUIRING PAVEMENT MARKING REMOVAL WATER BLASTING, THE ARIEL MARKERS SHALL NOT BE REMOVED IN ANY WAY.

LANE-REDUCTION PAVEMENT ARROWS THAT CONFLICT WITH STAGED TRAFFIC MARKINGS SHALL BE COVERED WITH BLACKOUT TAPE. THE COST OF ALL BLACKOUT TAPE AND REMOVAL SHALL BE INLCUDED IN THE COST OF THE PAY ITEM "TRAFFIC CONTROL AND PROTECTION, STANDARD 701402 (SPECIAL)".

TRAFFIC CONTROL MAY BE ADJUSTED DUE TO FIELD CONDITIONS APPROVED BY ENGINEER.

CONTRACTOR MAY ELECT TO WORK CONCURRENTLY ON THE TOP AND UNDERNEATH OF BRIDGE STRUCTURES.

TEMPORARY PAVEMENT MARKING TO BE DONE UTILIZING TY IV TAPE.

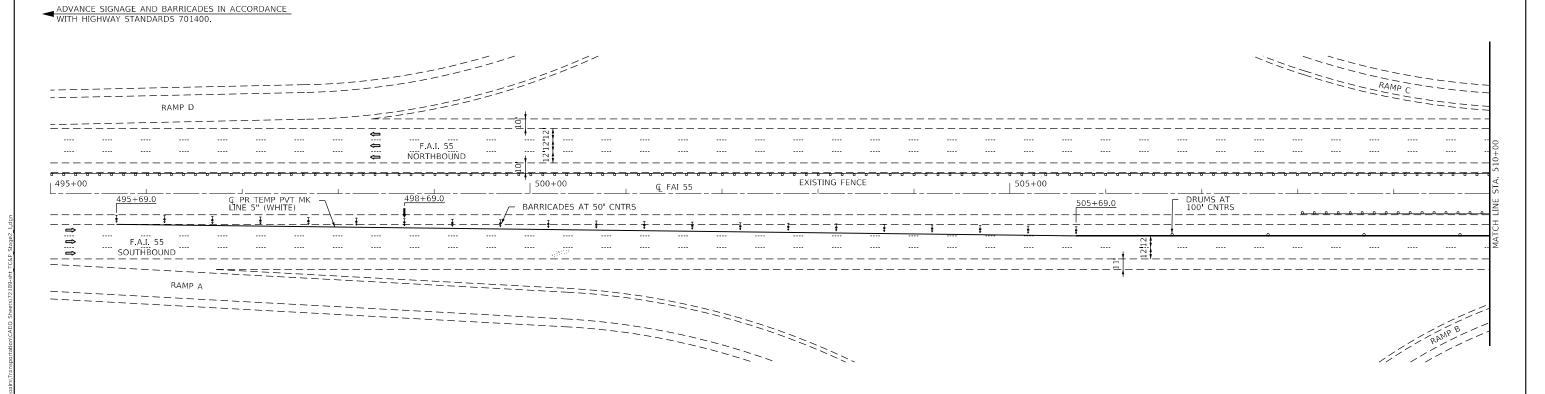

50 100 150

SCALE IN FEET


0		
);:	KLINGNER	D.
NAME:	& ASSOCIATES, P.C.	
щ	Engineers • Architects • Surveyors	PΙ
Ξ	616 N.24TH ST. QUINCY, ILLINOIS 62301 217.223.3670 STATE OF ILLINOIS DESIGN FIRM NO. 184-2738	PL


R NAME = aschafer	DESIGNED -	REVISED -
	DRAWN -	REVISED -
T SCALE = 100.0000 ' / in.	CHECKED -	REVISED -
PT DATE = 2/7/2024	DATE -	REVISED -


STATE OF ILLINOIS
DEPARTMENT OF TRANSPORTATION

F.A.I. ROUTE 55								
	TRAFFIC CONTROL PLAN (STAGE 2)							
SCALE: 1"=50'	SHEET 1	OF	4	SHEETS	STA. 495+00.00	TO STA. 510+00.00		

A I. RTE	SECT	LION		COUNTY	TOTAL SHEETS	SHEET NO.		
55	(84-5-1VHB)BDR,BP,BJR,BRR			SANGAMON	49	14		
			CONTRACT	NO. 72	2189			
	THINDS EED AID BROIECT							

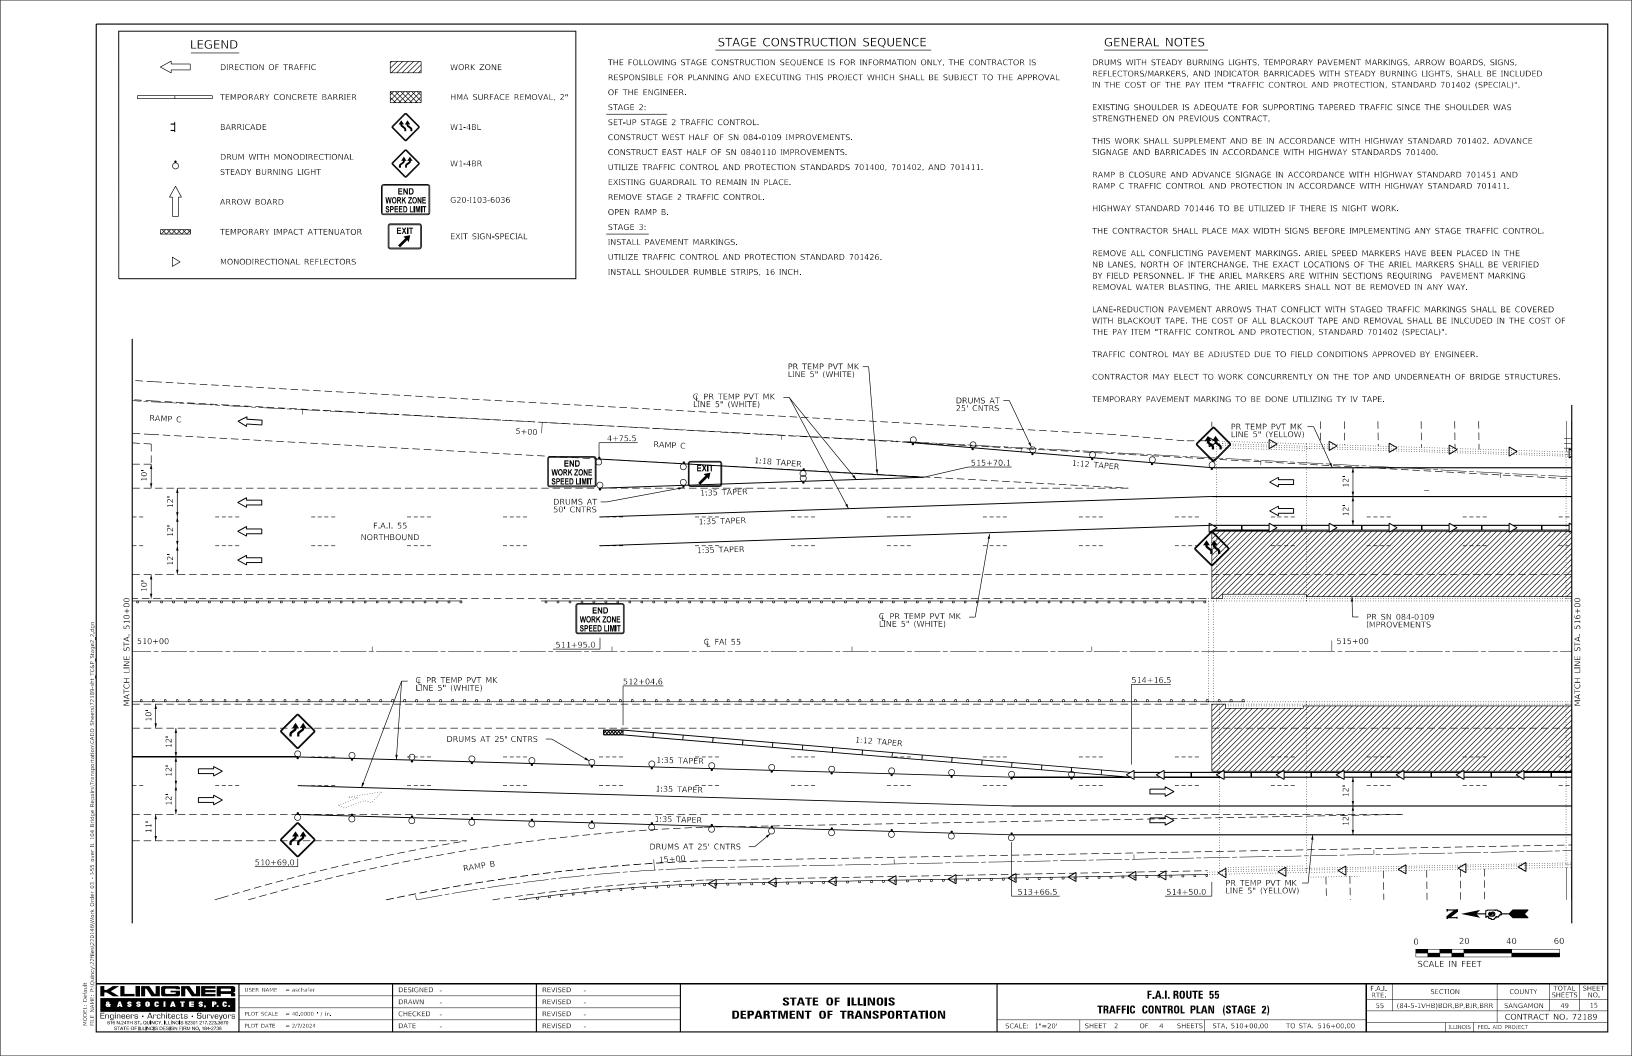

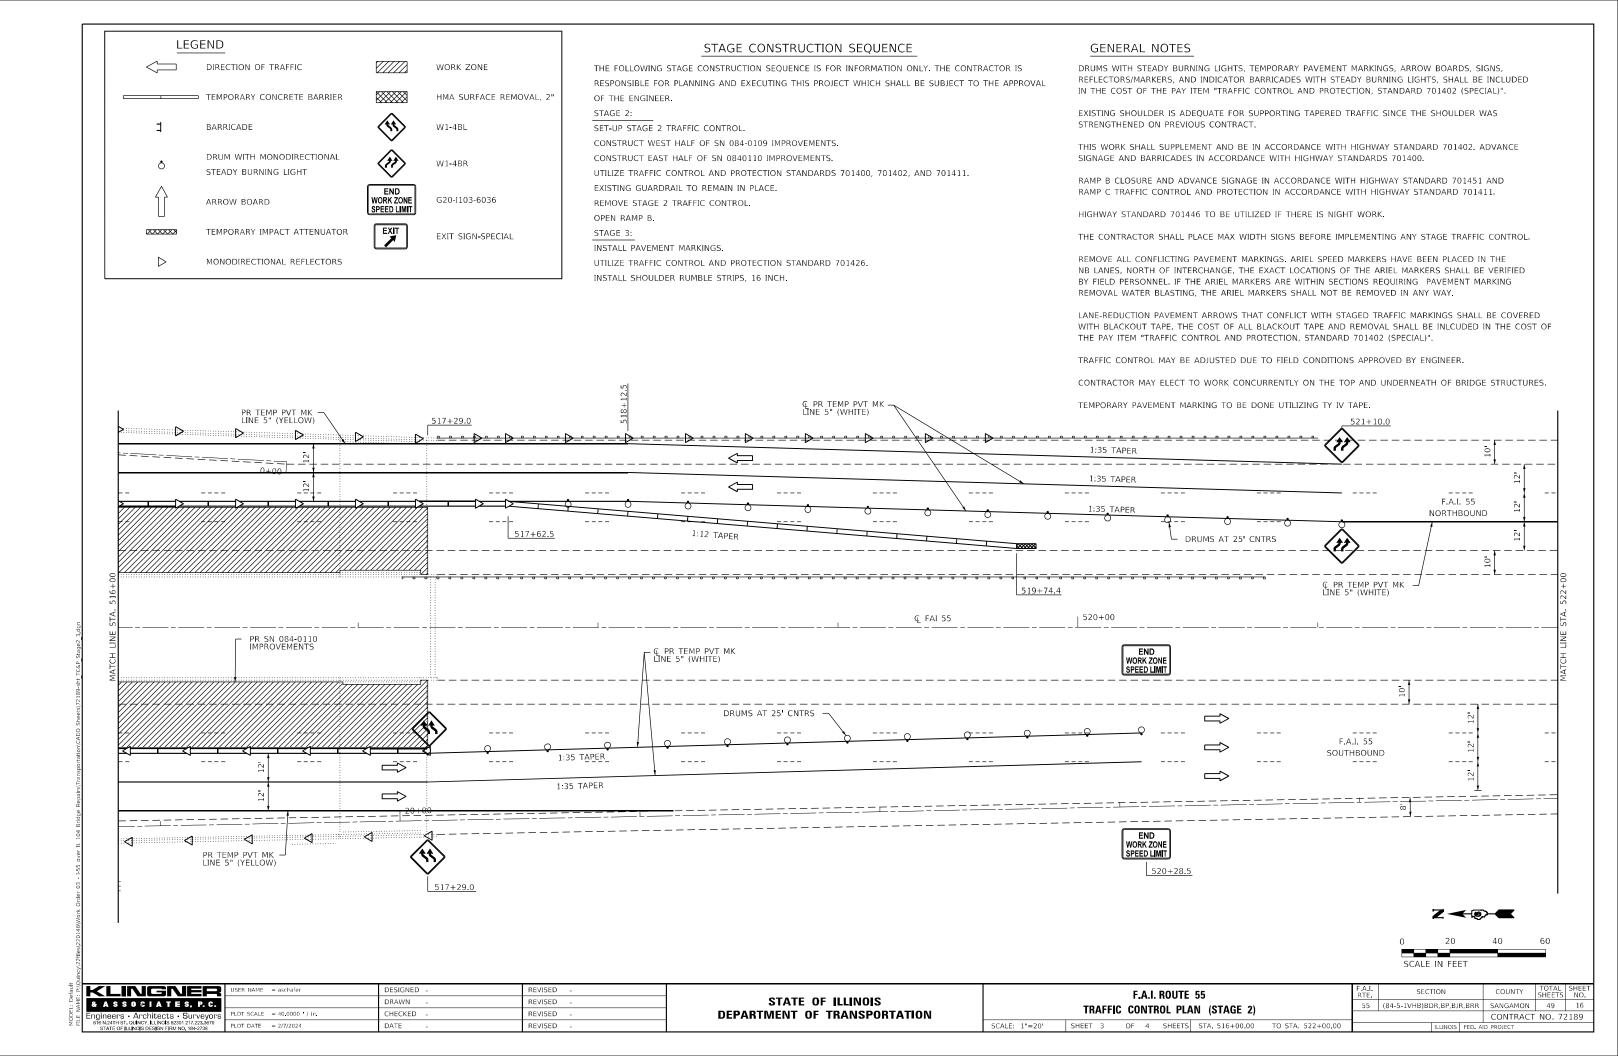

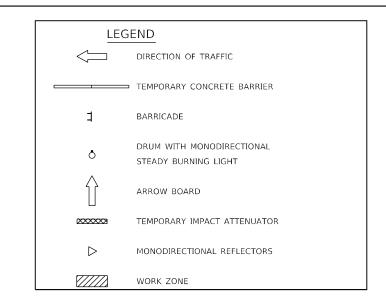

THE FOLLOWING STAGE CONSTRUCTION SEQUENCE IS FOR INFORMATION ONLY. THE CONTRACTOR IS RESPONSIBLE FOR PLANNING AND EXECUTING THIS PROJECT WHICH SHALL BE SUBJECT TO THE APPROVAL OF THE ENGINEER.

STAGE 2:

SET-UP STAGE 2 TRAFFIC CONTROL.

CONSTRUCT WEST HALF OF SN 084-0109 IMPROVEMENTS.

CONSTRUCT EAST HALF OF SN 0840110 IMPROVEMENTS.

UTILIZE TRAFFIC CONTROL AND PROTECTION STANDARDS 701400, 701402, AND 701411.

EXISTING GUARDRAIL TO REMAIN IN PLACE.

REMOVE STAGE 2 TRAFFIC CONTROL.

OPEN RAMP B.

STAGE 3:

INSTALL PAVEMENT MARKINGS.

UTILIZE TRAFFIC CONTROL AND PROTECTION STANDARD 701426.

INSTALL SHOULDER RUMBLE STRIPS, 16 INCH.

GENERAL NOTES

DRUMS WITH STEADY BURNING LIGHTS, TEMPORARY PAVEMENT MARKINGS, ARROW BOARDS, SIGNS, REFLECTORS/MARKERS, AND INDICATOR BARRICADES WITH STEADY BURNING LIGHTS, SHALL BE INCLUDED IN THE COST OF THE PAY ITEM "TRAFFIC CONTROL AND PROTECTION, STANDARD 701402 (SPECIAL)".

EXISTING SHOULDER IS ADEQUATE FOR SUPPORTING TAPERED TRAFFIC SINCE THE SHOULDER WAS STRENGTHENED ON PREVIOUS CONTRACT.

THIS WORK SHALL SUPPLEMENT AND BE IN ACCORDANCE WITH HIGHWAY STANDARD 701402. ADVANCE SIGNAGE AND BARRICADES IN ACCORDANCE WITH HIGHWAY STANDARDS 701400.

RAMP B CLOSURE AND ADVANCE SIGNAGE IN ACCORDANCE WITH HIGHWAY STANDARD 701451 AND RAMP C TRAFFIC CONTROL AND PROTECTION IN ACCORDANCE WITH HIGHWAY STANDARD 701411.

HIGHWAY STANDARD 701446 TO BE UTILIZED IF THERE IS NIGHT WORK.


THE CONTRACTOR SHALL PLACE MAX WIDTH SIGNS BEFORE IMPLEMENTING ANY STAGE TRAFFIC CONTROL.

REMOVE ALL CONFLICTING PAVEMENT MARKINGS. ARIEL SPEED MARKERS HAVE BEEN PLACED IN THE NB LANES, NORTH OF INTERCHANGE. THE EXACT LOCATIONS OF THE ARIEL MARKERS SHALL BE VERIFIED BY FIELD PERSONNEL. IF THE ARIEL MARKERS ARE WITHIN SECTIONS REQUIRING PAVEMENT MARKING REMOVAL WATER BLASTING, THE ARIEL MARKERS SHALL NOT BE REMOVED IN ANY WAY.

LANE-REDUCTION PAVEMENT ARROWS THAT CONFLICT WITH STAGED TRAFFIC MARKINGS SHALL BE COVERED WITH BLACKOUT TAPE. THE COST OF ALL BLACKOUT TAPE AND REMOVAL SHALL BE INLCUDED IN THE COST OF THE PAY ITEM "TRAFFIC CONTROL AND PROTECTION, STANDARD 701402 (SPECIAL)".

WITH HIGHWAY STANDARDS 701400.

TRAFFIC CONTROL MAY BE ADJUSTED DUE TO FIELD CONDITIONS APPROVED BY ENGINEER.

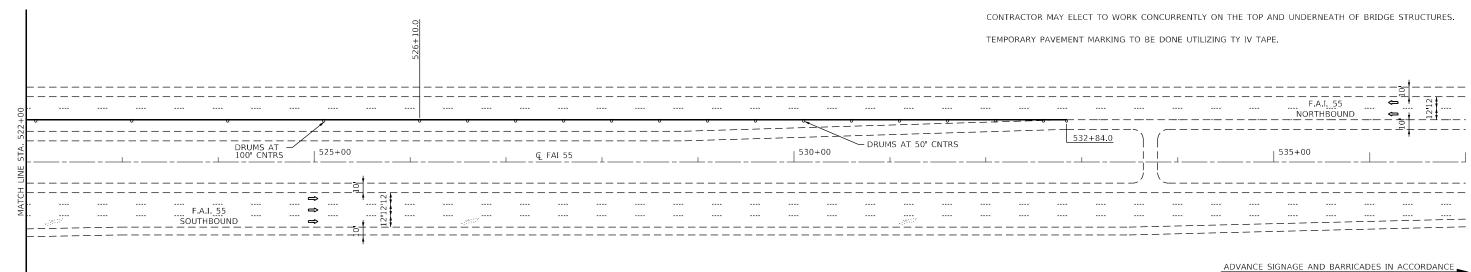

50 100 150

SCALE IN FEET

0		
. P.	KLINGNER	USE
NAME:	& ASSOCIATES, P.C.	
щ	Engineers • Architects • Surveyors	PLO
Ξ	616 N.24TH ST. QUINCY, ILLINOIS 62301 217.223.3670 STATE OF ILLINOIS DESIGN FIRM NO. 184-2738	PLC

SER NAME = aschafer	DESIGNED -	REVISED -
	DRAWN -	REVISED -
OT SCALE = 100.0000 / in	CHECKED -	REVISED -
OT DATE = 2/7/2024	DATE -	REVISED -

STATE OF ILLINOIS					
DEPARTMENT OF TRANSPORTATION					

F.A.I. ROUTE 55							
	TRAFFIC CONTROL PLAN (STAGE 2)						
SCALE: 1"=50'	SHEET 4	OF	4	SHEETS	STA. 522+00.00	TO STA. 537+00.00	

F.A.I. RTE	SECT	ПОИ		COUNTY	TOTAL SHEETS	SHEET NO.
55	(84-5-1VHB)BDR,BP,BJR,BRR			SANGAMON	49	17
			CONTRACT	NO. 72	2189	
		TURNOTC	ID DDOJECT			

LEGEND DIRECTION OF TRAFFIC O DRUM WITH STEADY BURNING LIGHT TEMPORARY IMPACT ATTENUATOR TEMPORARY CONCRETE BARRIER WORK ZONE MONODIRECTIONAL REFLECTORS

STAGE CONSTRUCTION SEQUENCE

THE FOLLOWING STAGE CONSTRUCTION SEQUENCE IS FOR INFORMATION ONLY. THE CONTRACTOR IS RESPONSIBLE FOR PLANNING AND EXECUTING THIS PROJECT WHICH SHALL BE SUBJECT TO THE APPROVAL OF THE ENGINEER

PRE-STAGE 1:

UTILIZE TRAFFIC CONTROL PROTECTION STANDARD 701326.

REMOVE EXISTING SHOULDERS OF EASTBOUND AND WESTBOUND OUTSIDE LANES.

CONSTRUCT HOT-MIX ASPHALT BASE COURSE 12" ALONG EASTBOUND (STA. 95+67.00 TO 103+92.00)

AND WESTBOUND OUTSIDE LANES (STA. 96+67.00 TO 104+92.00)

SET UP STAGE 1 TRAFFIC CONTROL.

STAGE 1:

COMPLETE NORTH END ABUTMENT REPAIRS AND SLOPE REPAIRS,

COMPLETE REPAIRS ON SN 084-0109 AND 084-0110 STRUCTURES NORTH AND SOUTH ENDS.

PAINT STRUCTURE AT NORTH ABUTMENT.

PAINT NORTH END OF SN 084-0109 AND 084-0110 STRUCTURES.

REMOVE STAGE 1 TRAFFIC CONTROL.

GENERAL NOTES

DRUMS WITH STEADY BURNING LIGHTS, TEMPORARY PAVEMENT MARKINGS, BARRIER REFLECTORS, SIGNS, AND FLAGGERS, SHALL BE INCLUDED IN THE COST OF THE PAY ITEM "TRAFFIC CONTROL AND PROTECTION, (SPECIAL)"


THE CONTRACTOR SHALL PLACE MAX WIDTH SIGNS BEFORE IMPLEMENTING ANY STAGE TRAFFIC CONTROL.

REMOVE ALL CONFLICTING PAVEMENT MARKINGS.

TRAFFIC CONTROL MAY BE ADJUSTED DUE TO FIELD CONDITIONS APPROVED BY ENGINEER.

CONTRACTOR MAY ELECT TO WORK CONCURRENTLY ON THE TOP AND UNDERNEATH OF BRIDGE STRUCTURES.

TEMPORARY PAVEMENT MARKING TO BE DONE UTILIZING TY IV TAPE.

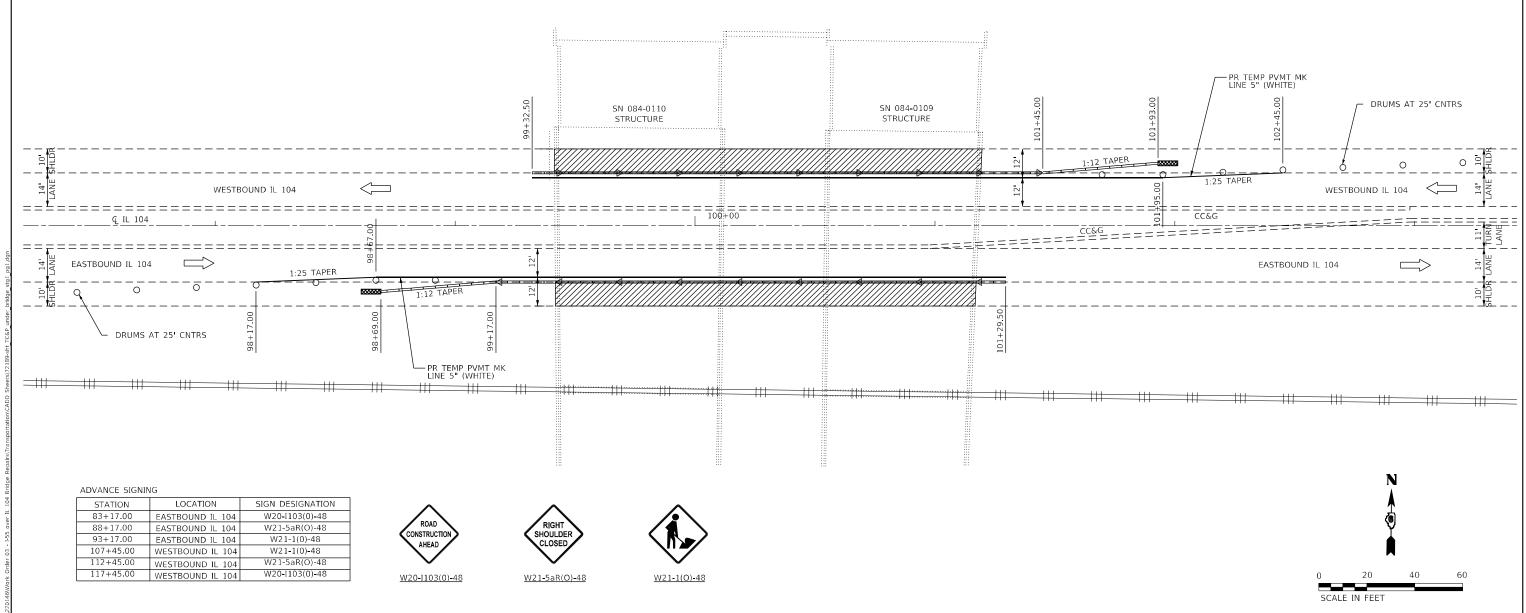


3		
<u></u>	KLINGNER	ι
AME	& ASSOCIATES, P.C.	
Z H	Engineers · Architects · Surveyors	Р
Ē	616 N.24TH ST. QUINCY, ILLINOIS 62301 217.223.3670 STATE OF ILLINOIS DESIGN FIRM NO. 184-2738	Р
		_

SER NAME = aschafer	DESIGNED -	REVISED -
	DRAWN -	REVISED -
OT SCALE = 40.0000 / in.	CHECKED -	REVISED -
OT DATE = 2/8/2024	DATE -	REVISED -

STATE OF ILLINOIS
DEPARTMENT OF TRANSPORTATION

IL 104								
	TRAFFIC CONTROL PLAN (STAGE 1)							
SCALE: 1"=20'	SHEET 1	OF	1	SHEETS	STA. 97+20.00	TO STA. 103+40.00		

F.A.I. RTE.	SECT	:TION		COUNTY	TOTAL SHEETS	SHEET NO.
55	(84-5-1VHB)BD	-1VHB)BDR,BP,BJR,BRR		SANGAMON	49	18
			CONTRACT	NO. 7	2189	
ILLINOIS FED. A				D PROJECT		

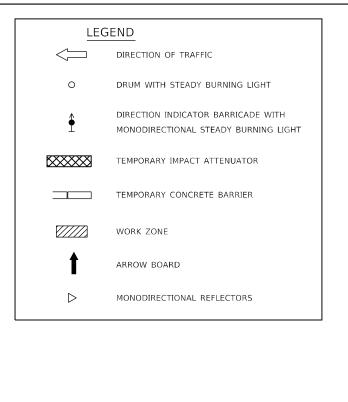

THE FOLLOWING STAGE CONSTRUCTION SEQUENCE IS FOR INFORMATION ONLY. THE CONTRACTOR IS RESPONSIBLE FOR PLANNING AND EXECUTING THIS PROJECT WHICH SHALL BE SUBJECT TO THE APPROVAL

STAGE 2:

SET UP STAGE 2 TRAFFIC CONTROL.

PAINT STEEL AT MIDDLE SECTIONS OF SN 084-0109 AND 084-0110 STRUCTURES.

REMOVE STAGE 2 TRAFFIC CONTROL.

GENERAL NOTES

DRUMS WITH STEADY BURNING LIGHTS, TEMPORARY PAVEMENT MARKINGS, BARRIER REFLECTORS, SIGNS, AND FLAGGERS, SHALL BE INCLUDED IN THE COST OF THE PAY ITEM "TRAFFIC CONTROL AND PROTECTION, (SPECIAL)"


THE CONTRACTOR SHALL PLACE MAX WIDTH SIGNS BEFORE IMPLEMENTING ANY STAGE TRAFFIC CONTROL.

REMOVE ALL CONFLICTING PAVEMENT MARKINGS.

TRAFFIC CONTROL MAY BE ADJUSTED DUE TO FIELD CONDITIONS APPROVED BY ENGINEER.

CONTRACTOR MAY ELECT TO WORK CONCURRENTLY ON THE TOP AND UNDERNEATH OF BRIDGE STRUCTURES.

TEMPORARY PAVEMENT MARKING TO BE DONE UTILIZING TY IV TAPE.

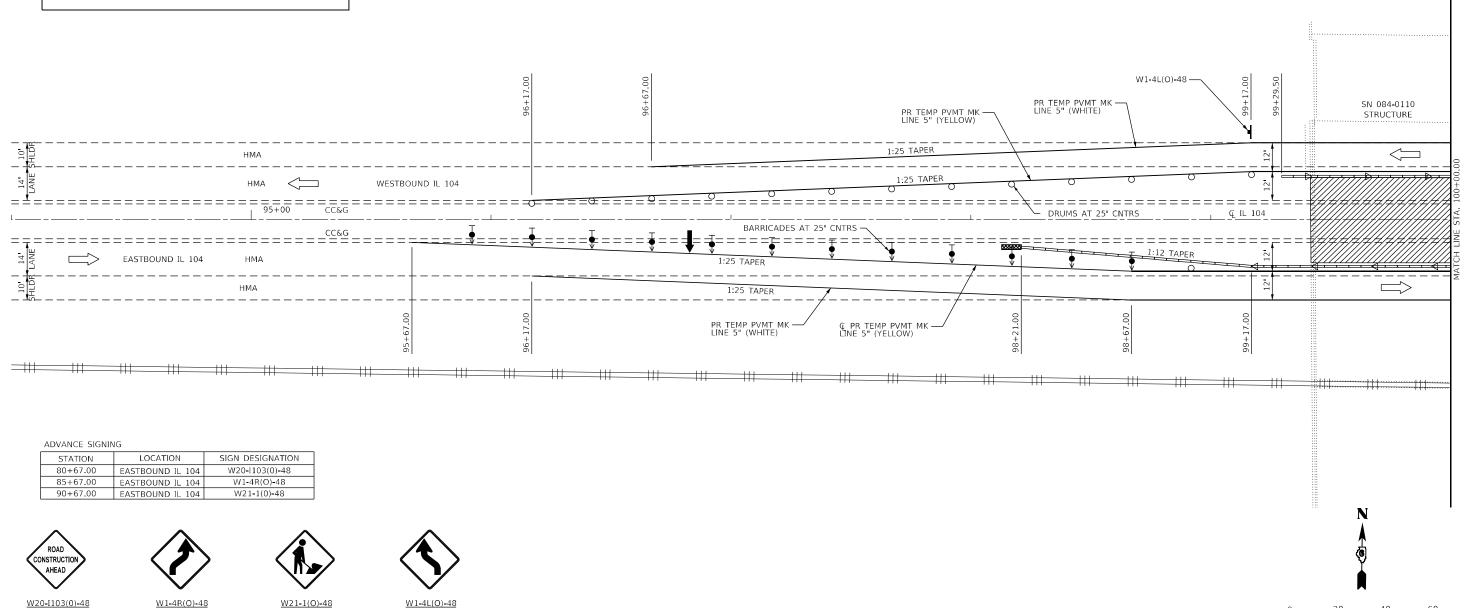

KLINGNER & ASSOCIATES, P.C.

LOT DATE = 2/7/2024 DATE

DESIGNED REVISED DRAWN REVISED CHECKED REVISED REVISED

STATE OF ILLINOIS **DEPARTMENT OF TRANSPORTATION**


IL 104 TRAFFIC CONTROL PLAN (STAGE 2) SHEET 1 OF 2 SHEETS STA. 94+00.00 TO STA. 100+00.00

SCALE: 1"=20"

SECTION 55 (84-5-1VHB)BDR,BP,BJR,BRR SANGAMON 49 19 CONTRACT NO. 72189

SCALE IN FEET

40

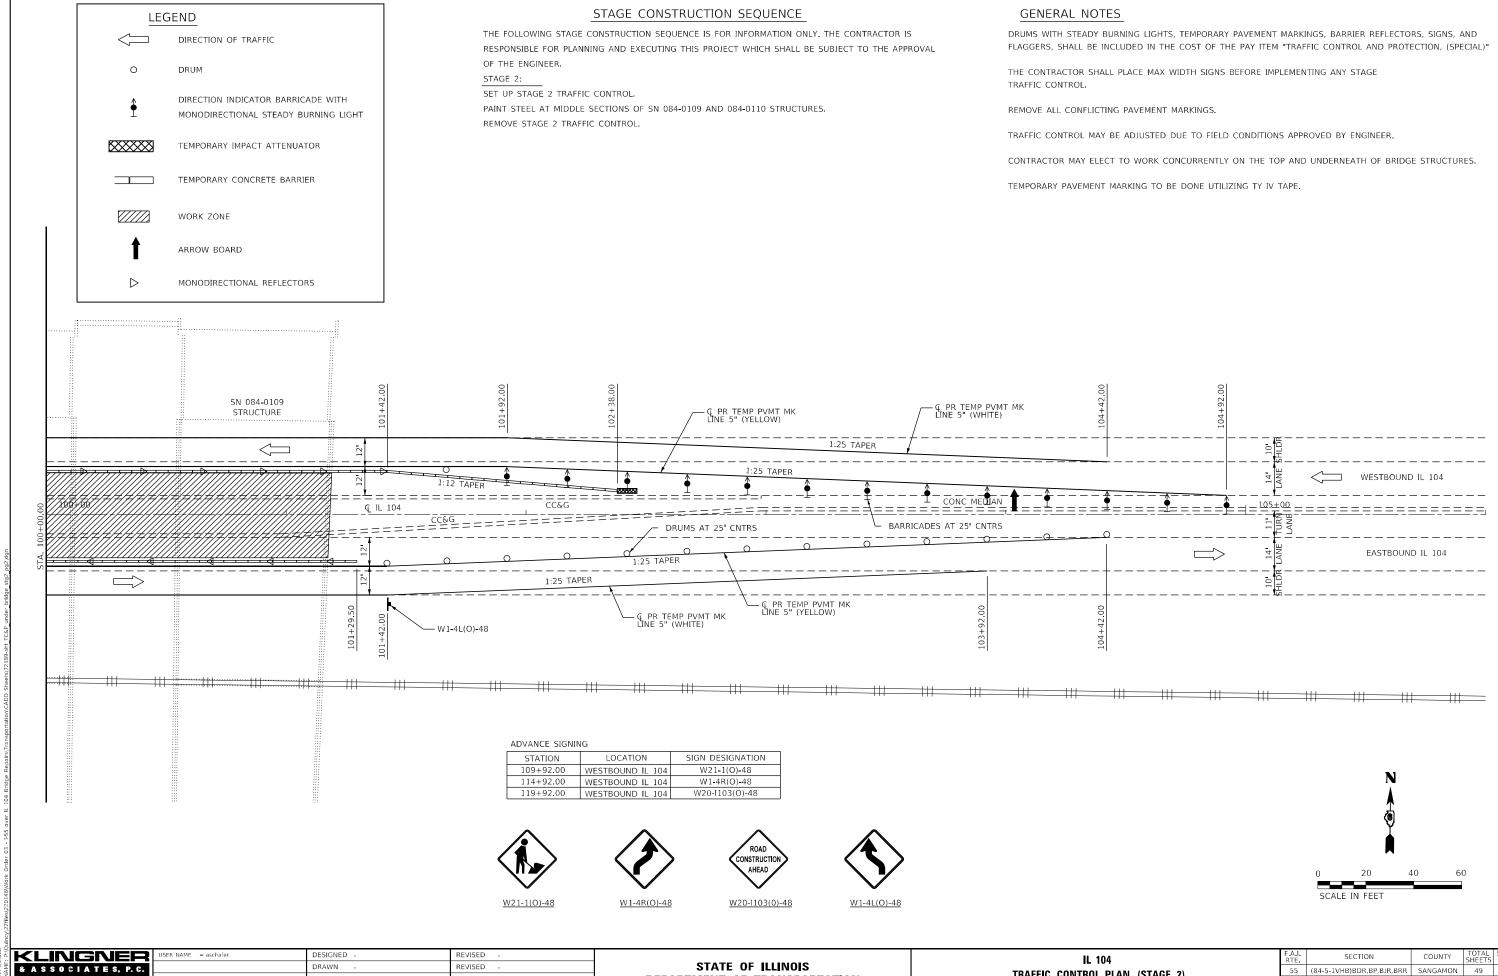


CHECKED REVISED PLOT DATE = 2/7/2024 REVISED DATE

STATE OF ILLINOIS **DEPARTMENT OF TRANSPORTATION**

TRAFFIC CONTROL PLAN (STAGE 2) SCALE: 1"=20" SHEET 2 OF 2 SHEETS STA. 100+00.00 TO STA. 106+00.00

55 (84-5-1VHB)BDR,BP,BJR,BRR SANGAMON 49 20 CONTRACT NO. 72189

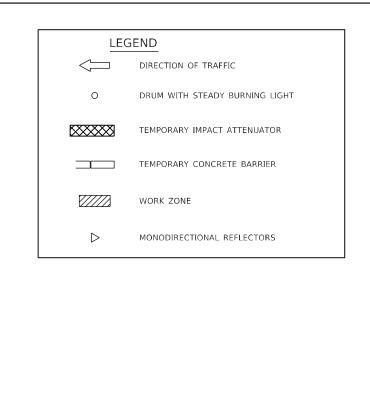

THE FOLLOWING STAGE CONSTRUCTION SEQUENCE IS FOR INFORMATION ONLY. THE CONTRACTOR IS RESPONSIBLE FOR PLANNING AND EXECUTING THIS PROJECT WHICH SHALL BE SUBJECT TO THE APPROVAL

STAGE 3:

SET UP STAGE 3 TRAFFIC CONTROL.

PAINT STEEL AT SOUTH SECTIONS OF SN 084-0109 AND 084-0110 STRUCTURES.

REMOVE STAGE 3 TRAFFIC CONTROL.

GENERAL NOTES

DRUMS WITH STEADY BURNING LIGHTS, TEMPORARY PAVEMENT MARKINGS, BARRIER REFLECTORS, SIGNS, AND FLAGGERS, SHALL BE INCLUDED IN THE COST OF THE PAY ITEM "TRAFFIC CONTROL AND PROTECTION, (SPECIAL)"


THE CONTRACTOR SHALL PLACE MAX WIDTH SIGNS BEFORE IMPLEMENTING ANY STAGE TRAFFIC CONTROL.

REMOVE ALL CONFLICTING PAVEMENT MARKINGS.

TRAFFIC CONTROL MAY BE ADJUSTED DUE TO FIELD CONDITIONS APPROVED BY ENGINEER.

CONTRACTOR MAY ELECT TO WORK CONCURRENTLY ON THE TOP AND UNDERNEATH OF BRIDGE STRUCTURES.

TEMPORARY PAVEMENT MARKING TO BE DONE UTILIZING TY IV TAPE.

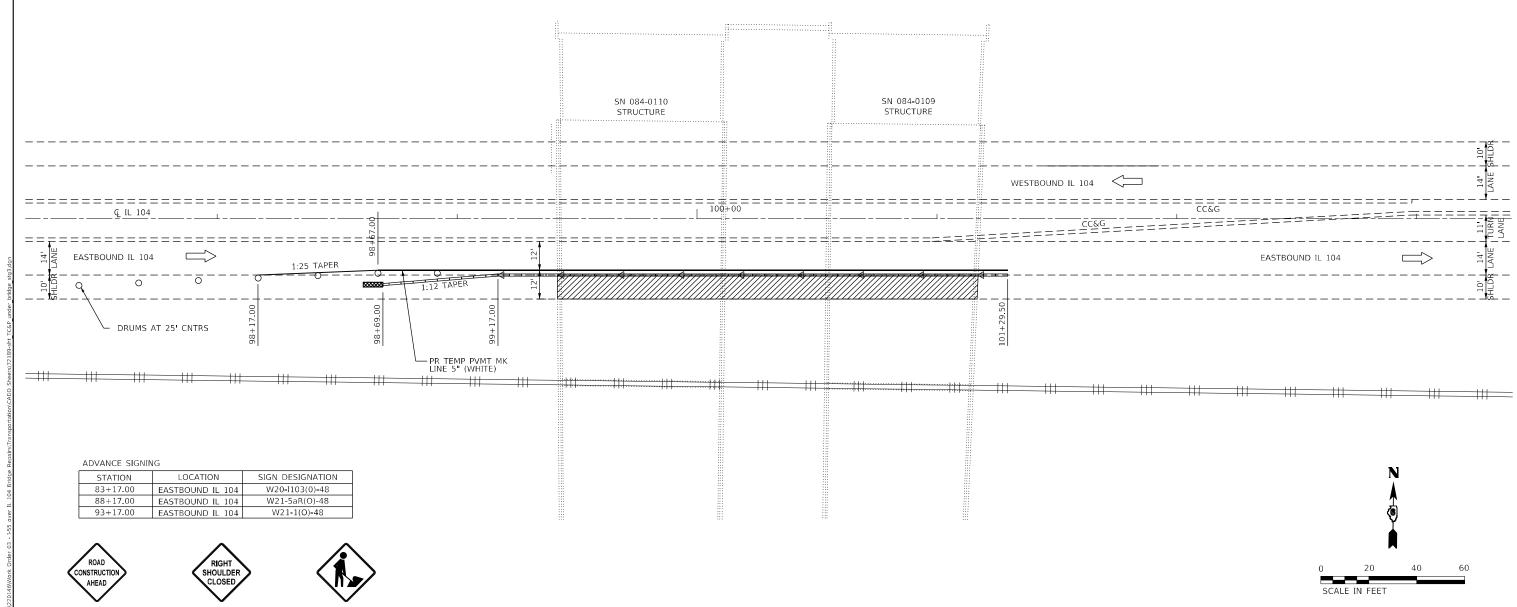

KLINGNER & ASSOCIATES, P.C.

W20-I103(0)-48

W21-5aR(O)-48

DESIGNED -REVISED DRAWN REVISED CHECKED REVISED LOT DATE = 2/7/2024 REVISED DATE


W21-1(O)-48

STATE OF ILLINOIS **DEPARTMENT OF TRANSPORTATION**

IL 104 TRAFFIC CONTROL PLAN (STAGE 3) SHEET 1 OF 1 SHEETS STA. 97+20.00

SCALE: 1"=20'

SECTION 55 (84-5-1VHB)BDR,BP,BJR,BRR SANGAMON 49 21 CONTRACT NO. 72189 TO STA. 103+40.00

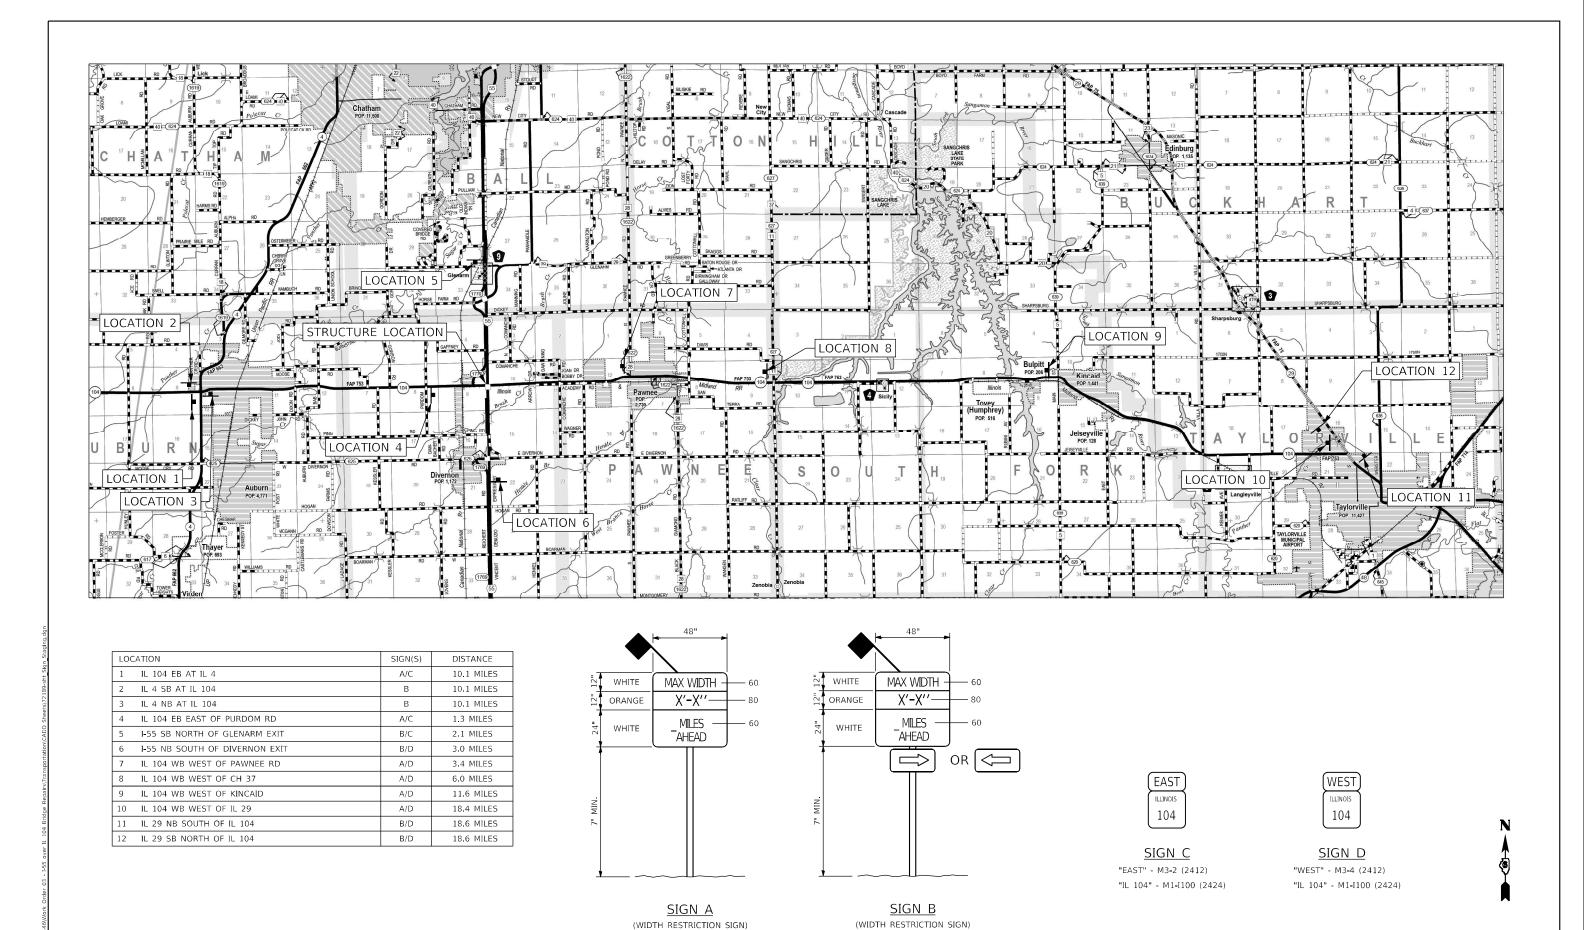

& ASSOCIATES, P.C.
Engineers · Architects · Surveyors
66 N24TH ST. OUNCY, LLINGS 62801 217.223,3670
STATE OF LINGS DESIGN FRIM NO. 184-2738

STATE OF ILLINOIS
DEPARTMENT OF TRANSPORTATION

F.A.I. ROUTE 55

MAXIMUM WIDTH SIGNING DETAIL

SCALE: 1"=5280' SHEET 1 OF 1 SHEETS STA. N/A TO STA. N/A

 F.A.I. RTE.
 SECTION
 COUNTY
 TOTAL SHEETS
 SHEETS

 55
 (84-5-1VHB)BDR,BP,BJR,BRR
 SANGAMON
 49
 22

 CONTRACT
 NO. 72 189

SCALE IN FEET

5280 10560 15840

Existing S.N. 084-0109: The existing structure was originally built in 1972 under Section 84-5-1-VHB and rehabilitated in 1986, 1989, and 2003 is a two span continuous, composite INDEX OF SHEETS multi-girder structure with vaulted abutments. The vaulted slabs are supported on PPC girders. The structure has an overall length of 278'-3" back-to-back of approach bents and an General Plan and Elevation out-to-out width that varies from 58'-01%" to 66'-61/4". Existing S.N. 084-0110: The existing structure was originally built in 1972 under Section 84-5-1-VHB and rehabilitated in 1986 and 2003 is a two span continuous, composite, multi-girder structure with vaulted abutments. The vaulted slabs are supported on PPC girders. The structure has an overall length of 277'-0" back-to-back of approach bents and an analysis of the structure with the structure of the structure with the structure of the structure with the structure General Notes and Details Staging 5-10 Superstructure Details out-to-out width that varies from 66'-51/4" to 71'-101/2". Preformed Joint Strip Seal 11 All work will be performed utilizing staged construction with two lanes open to traffic in each direction at all times. 12 Temporary Concrete Barrier 13-14 Deck Patching 278'-3" Back to Back of Approach Bents (SN 084-0109) Deck Drain Details 15 277'-0" Back to Back of Approach Bents (SN 084-0110) 37'-51/5" (SN 084-0109) Parapet Repair Details 16 36'-21/5" (SN 084-0110) Framing Plan 36'-21/2" 204'-7" Back to Back Abutments Structural Steel Repair Details 18-19 Jack and Remove Existing Bearings Abutment Bearing Details Abutment Repair Details Ex. 42" Web Girder 22-23 24-25 Pier Repair Details ± 34'-8" Limits of Slope Wall Repair Details ± 66'-0" Limits of Protective Shield Bar Splicer Assembly and Mechanical Splicer Details Protective Shield LOADING HS20-44 (New Const.) Existing Concrete Slopewall, typ. DESIGN SPECIFICATIONS (New Const.) -Existing Ground 2002 AASHTO Standard Specifications for Highway Bridges, 17th Edition ELEVATION ← & Survey S.B.I. 104 10'-0" 10'-0" - @ Track Shoulder Shoulder 55'-3" min. 36'-0" min. 14'-0' 14'-0" 18'-0" SEISMIC DATA clearance clearance Lane Median Lane 39'-3" Seismic Performance Category (SPC) = A Face of S. Abut. --5'-0" 8'-0" Shidr Horizontal Bedrock Acceleration Coefficient (A) = 0.057g Ex. floor Site Coefficient (5) = 1.2drain, typ. * Limits of Bridge Deck DESIGN STRESSES Scarification 3" FIELD UNITS (Exist. Construction) SN 084-0109 ** Limits of Expansion Joint € N.B. F.A.I. 55 (1-55) $f'_{c} = 3,000 \text{ psi (Superstructure)}$ Conc. Removal and Replacement f'c = 3,500 psi (Curb, Parapet, Substructure) $f_r = 36,000 \text{ psi (Structural Steel)}$ $f_{\rm v} = 40,000$ psi (Reinforcement) Bk. of S. Abut. Bk. of N. Abut Sta. 516+92.39 Sta. 515+98.10 FIELD UNITS (New Construction) Sta. 514+87.81 British W. SCA f = 4,000 psi (Superstructure)HIRETON M. SCAM $f^{c} = 3,500 \text{ psi (Substructure)}$ JOT928
JENSED
JRUCTURAL
ENGINEER Bk. of S. $f_y = 50,000 \text{ psi (Structural Steel)}$ Bk. of N. Appr Sta. 516+54.60 F.A.I. 55 Appr. Bent $f_y = 60,000 \text{ psi (Reinforcement)}$ IMRR-Taylorville 10' ← F.A.I. 55 (1-55) Median Bent Sta. 514+50.35 89°17'20.08"-Sta. 517+28.60 90° Subdivision-MO 120.42 Bk. of S. Bk. of N. Appr. Sta. 515+28.68 F.A.I. 55 10'-0" Appr. Bent Bent Sta. 514+51.60 Sta. 100+33.00 S.B.I. IL 104 Sta. 517+28.60 ∠ P.G. Bk. of S. Abut. Bk. of N. Abut. – Ç S.B. F.A.I. 55 (I-55) Sta. 516+92.39 Sta. 515+98.10 Sta. 514+87.81 9 Aaron M Sch SN 084-0110 Licensed Structural Engineer State of Illinois No. 081-007926 License Expires 11/30/2024 Range 5W - 3rd. PM GENERAL PLAN & ELEVATION Bk. S. Bk. N -Bk. S. Abut F.A.I. ROUTE 55 (1-55) OVER Bk. N. Abut. Appr. Bent Appr. Bent F.A.P. ROUTE 753 (IL 104) & I&M RAILROAD * 34'-10½' * 200'-3" SECTION (84-5-1VHB)BDR,BP,BJR,BRR ** ± 3'-0--** ± 3'-0 * 36'- 1½" (SN 084-0109) 94'-31/5" 110'-31/2' * 34'-101/2" (N 084-0110) SANGAMON COUNTY 278'-3" Back to Back of Approach Bents (SN 084-0109) STATION 515+28.68 277'-0" Back to Back of Approach Bents (SN 084-0110) 37'-51/3" (SN 084-0109) SN 084-0109 & 084-0110 PLANZ - (5)-(E 36'-2½" (SN 084-0110) LOCATION SKETCH SECTION **GENERAL PLAN AND ELEVATION** KLINGNER USER NAME : DESIGNED - AMS REVISED (84-5-1VHR)BOR BP BJR BRR

& ASSOCIATES, P.C. Ineers - Architects - Surveyors

CHECKED -R.IP REVISED AMS REVISED REVISED PLOT DATE = CHECKED - RJP

STATE OF ILLINOIS **DEPARTMENT OF TRANSPORTATION** STRUCTURE NO. 084-0109 & 084-0110 SHEET 1 OF 27 SHEETS

COUNTY SHEETS NO.
SANGAMON 49 23 CONTRACT NO. 72189

SCOPE OF WORK

- 1. Set-up traffic control for Stage I Construction.
- 2. Remove concrete deck to install new expansion joints and scarify existing microsilica concrete overlay.
- Remove existing rocker expansion bearings at the abutments and replace with elastomeric bearings.
- 4. Perform structural steel repairs to beam ends and end diaphragms.
- 5. Complete substructure concrete repairs and construct concrete pier wall extension.
- 6. Install new expansion joints and re-construct concrete deck, parapet, and abutment face at expansion joint location.
- 7. Perform concrete deck and concrete parapet patching and repairs. Seal parapets with elastomeric sealant.
- 8. Construct Microsilica overlay and grind smooth.
- 9. Set-up traffic control for Stage II Costruction and repeat steps 2-8.
- 10. Complete blast and paint of the superstructure.

Cleaning and Painting Structural Steel

Work shall consist of blasting and painting all structural steel. Galvanized bearings and structural steel encountered at the abutments shall be protected from normal blasting operations and shall have surfaces prepared per the applicable sections of the special provisions for "Cleaning and Painting Steel Structures". The color of the final finish coat for the outside and bottom of the fascia beams shall be Interstate Green, Munsell No. 7.5G 4/8. All other surfaces shall be Gray, Munsell No 5B 7/1. Containment and disposal of lead paint cleaning residues shall be utilized. Air monitors will be required.

GENERAL NOTES

Fasteners shall be ASTM 3125 grade A325 Type 1, mechanically galvanized bolts. Bolts $\frac{3}{4}$ " Ø, holes $\frac{1}{16}$ " Ø, unless otherwise noted.

No field welding is permitted except as specified in the contract documents. Reinforcement bars designated (E) shall be epoxy coated.

Prior to pouring the new concrete deck, all heavy or loose rust, loose mill scale, and other loose or potentially detrimental foreign material shall be removed from the surfaces in contact with concrete. Tightly adhered paint may remain unless otherwise noted. Removal shall be accomplished by methods that will not damage the steel and the cost will be included in the pay item covering removal of the existing concrete.

As directed by the Engineer, existing construction accessories welded to the top flange of beams and girders shall be removed. The weld areas shall be ground flush and inspected for cracks using magnetic particle testing (MT) or dye penetrant testing (PT) by qualified personnel approved by the Engineer.

Any cracks that cannot be removed by grinding V_4 inch deep shall be identified and reported to the Bureau of Bridges and Structures for further disposition. The cost of removing welded accessories, grinding and inspecting weld areas and grinding cracks will be paid for according to Article 109.04 of the Standard Specifications.

Plan dimensions and details relative to existing plans are subject to nominal construction variations. The Contractor shall field verify existing dimensions and details affecting new construction and make necessary approved adjustments prior to construction or ordering of materials. Such variations shall not be cause for additional compensation for a change in scope of the work, however, the Contractor will be paid for the quantity actually furnished at the unit price bid for the work.

Concrete Sealer shall be applied to the new concrete surfaces on the front face of abutment backwalls.

All new Structural Steel and bearing assemblies shall be hot-dipped galvanized. See special provisions for "Hot dip galvanizing for Structural Steel".

The existing structural steel coating contains lead. The Contractor shall take appropriate precautions to deal with the presence of lead on this project.

Protective Coat shall be applied to top of deck.

Protective Coat (Special) shall be applied to the inside and outisde faces and top of the parapets.

Synthetic Fibers are not required in Bridge Deck Microsilica Concrete Overlay.

Contractor to notify G&W Public Projects Department 30 days prior to starting construction. G&W flagging services will be required for all work within G&W right-of-way.

The contractor must not use the railroad right of way for storage of materials or equipment during construction. The railroad's right of way must remain clear at all times. The contractor must plan and perform the work in a manner such that the railroad tracks at the project location remain fully capable of operating rail traffic throughout the work period and rail traffic is not delayed or otherwise impacted due to the work being performed.

All work performed on, above, or adjacent to railroad property shall be in accordance with the Public Project Manual, current edition. Work plans shall be submitted for review to the Railroad for tasks related to site access, soil and water management, ballast protection, demolition, debris shield, paint containment, pier repairs, jacking, and all other work that presents potentially affects railroad property or operations. All work plans shall be prepared and submitted to the Railroad in adherence with the Public Project Manual, Section 1.11 Construction Submission Criteria

TOTAL BILL OF MATERIAL


	ITEM	UNIT	SUPER	SUB	TOTAL
	Porous Granular Embankment	Ton		295	295
	Stone Dumped Riprap, Class A3	Ton		26	26
	Concrete Removal	Cu. Yd.	39.7		39.7
	Slope Wall Removal	Sq. Yd.		313	313
	Protective Shield	Sq. Yd.	1,477		1,477
	Floor Drains	Each	16		16
	Concrete Structures	Cu. Yd.		27.4	27.4
	Concrete Superstructure	Cu. Yd.	41.2		41.2
	Bridge Deck Grooving (Longitudinal)	Sq. Yd.	2,718		2,718
	Protective Coat	Sq. Yd.	3,825		3,825
	Furnishing and Erecting Structural Steel	Pound	22,707		22,707
	Reinforcement Bars, Epoxy Coated	Pound	7,630	2,120	9,750
	Bar Splicers	Each	56		56
	Slope Wall 4 Inch	Sq. Yd.		313	313
	Preformed Joint Strip Seal	Foot	257		257
	Elastomeric Bearing Assembly, Type I	Each	42		42
	Anchor Bolts, 1"	Each	84		84
	Controlled Low-Strength Material	Cu. Yd.		50	50
	Surface Filler (Special)	Gallon	5		5
	Protective Coat (Special)	Sq. Yd.	805		805
	Jack and Remove Existing Bearings	Each	42		42
	Structural Repair of Concrete (Depth equal to or less than 5 inches)	Sq. Ft.	506	596	1,102
	Structural Steel Removal	Pound	9,555		9,555
*	Containment and Disposal of Lead Paint Cleaning Residues No. 1	L Sum	1		1
**	Containment and Disposal of Lead Paint Cleaning Residues No. 2	L Sum	1		1
*	Cleaning and Painting Steel Bridge No. 1	L Sum	1		1
**	Cleaning and Painting Steel Bridge No. 2	L Sum	1		1
	Bridge Deck Scarification 3"	Sq. Yd.	3,742		3,742
	Bridge Deck Microsilica Concrete Overlay 3 1/4"	Sq. Yd.	3,742		3,742
	Deck Slab Repair (Full Depth, Type I)	Sq. Yd.	9		9
	Deck Slab Repair (Full Depth, Type II)	Sq. Yd.	90		90
	Diamond Grinding (Bridge Section)	Sq. Yd.	3,579		3,579
	Railroad Protective Liability Insurance	L Sum	1		1
	* Bridge No. 1 - S.N. 084-0109				

- * Bridge No. 1 S.N. 084-0109
- ** Bridge No. 2 S.N. 084-0110

JIINCY/ZZIIIES/ZZU14b\Work Urder U3 = 1-55 over IL 104 Bridge RepairS/Transportation\Structure Draw

STAGE I CONSTRUCTION
(Looking North SN 084-0109)

* Prior to grinding

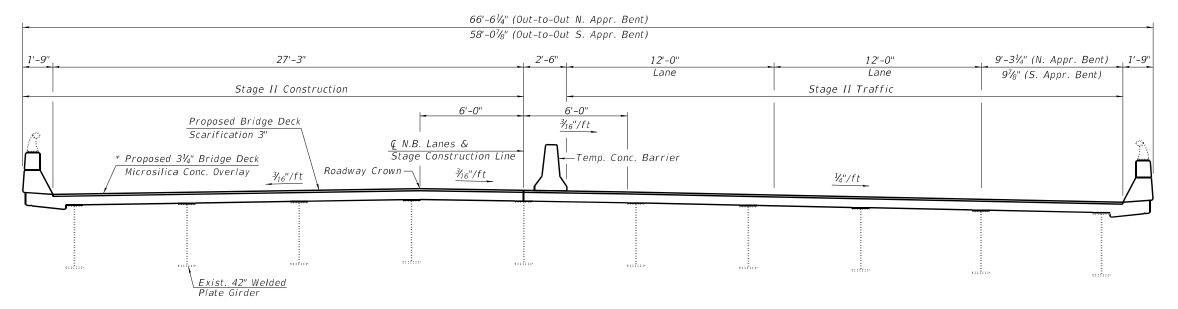

STAGE II CONSTRUCTION


(Looking North SN 084-0109)

\geq		
۵.	KLINGNER	L
NAME:	& ASSOCIATES, P.C.	
_	Engineers • Architects • Surveyors	ш
FILE	616 N.24TH ST. QUINCY, ILLINOIS 62301 217.223.3670 STATE OF ILLINOIS DESIGN FIRM NO. 184-2738	ш

USER NAME =	DESIGNED - AMS	REVISED -
	CHECKED - RJP	REVISED -
PLOT SCALE =	DRAWN - AMS	REVISED -
PLOT DATE =	CHECKED - RJP	REVISED -

STAGING STRUCTURE NO. 084-0109 & 084-0110		SECTION	COUNTY	TOTAL SHEETS	SHEET NO.
		(84-5-1VHB)BDR,BP,BJR,BF	R SANGAMON	49	25
			CONTRA	ACT NO.	72189
SHEET 3 OF 27 SHEETS		ILLINOIS FE	D. AID PROJECT		

STAGE I CONSTRUCTION
(Looking North SN 084-0110)

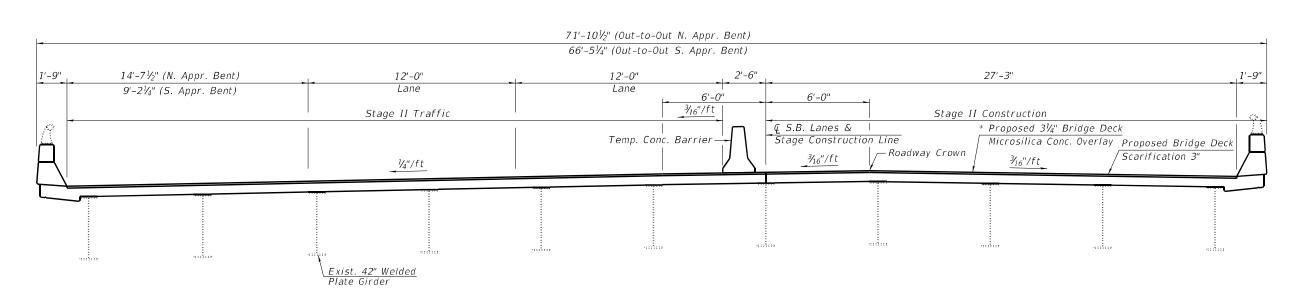

STAGE II CONSTRUCTION (Looking North SN 084-0110)

& ASSOCIATES, P.C.
Engineers - Architects - Surveyors
state of illnigs besign firm no. 184-2738

 USER NAME
 =
 DESIGNED
 AMS
 REVISED

 CHECKED
 RJP
 REVISED

 PLOT SCALE
 =
 DRAWN
 AMS
 REVISED

 PLOT DATE
 =
 CHECKED
 RJP
 REVISED

STATE OF ILLINOIS
DEPARTMENT OF TRANSPORTATION

STAGING
STRUCTURE NO. 084-0109 & 084-0110

SHEET 4 OF 27 SHEETS

 F.A.I. RTE.
 SECTION
 COUNTY SHEETS
 TOTAL SHEETS
 SHEETS NO.

 55
 (84-5-1VHB)BDR,BP,BJR,BRR
 SANGAMON
 49
 26


 CONTRACT NO. 72189

* Prior to grinding

EXISTING CROSS SECTION THRU EXPANSION JOINT

(Looking North SN 084-0109)

* Prior to grinding

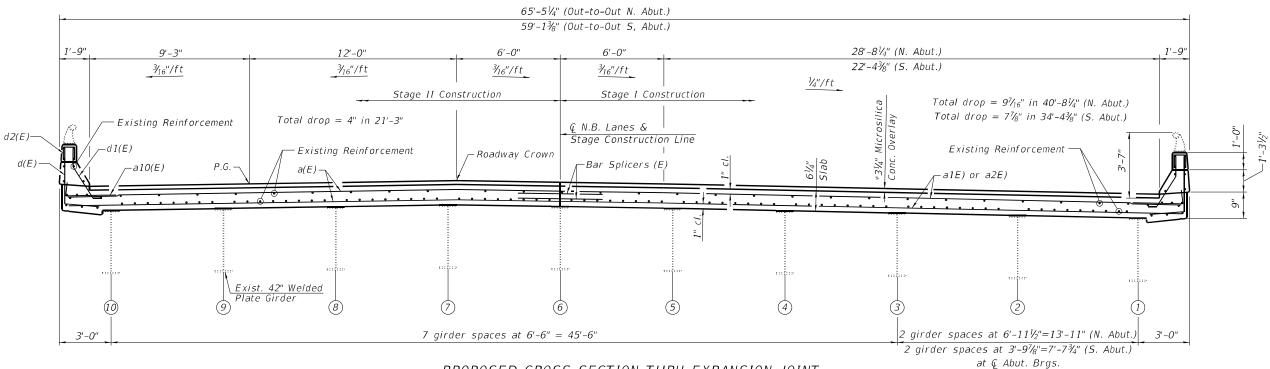

PROPOSED CROSS SECTION THRU EXPANSION JOINT

(Looking North SN 084-0109)

The longitudinal reinforcement bars in the area of slab, parapet, and curb removal shall remain in place and shall be cleaned and incorporated into new construction. Any reinforcement bars that are damaged during concrete removal shall be replaced as directed by the Engineer. Cost included with Concrete Removal.


	KLINGNER	
NAME	& ASSOCIATES, P.C.	
Z	Engineers · Architects · Surveyors	
H	616 N.24TH ST. QUINCY, ILLINOIS 62301 217.223.3670 STATE OF ILLINOIS DESIGN FIRM NO. 184-2738	_


ч	USER NAME =	DESIGNED -	AMS	REVISED -
1		CHECKED -	RJP	REVISED -
6	PLOT SCALE =	DRAWN -	AMS	REVISED -
	PLOT DATE =	CHECKED -	RJP	REVISED -

STATE OF ILLINOIS **DEPARTMENT OF TRANSPORTATION**

SUPERSTRUCTURE DETAILS STRUCTURE NO. 084-0109 & 084-0110 SHEET 5 OF 27 SHEETS

SECTION 55 (84-5-1VHB)BDR,BP,BJR,BRR SANGAMON 49 27 CONTRACT NO. 72189

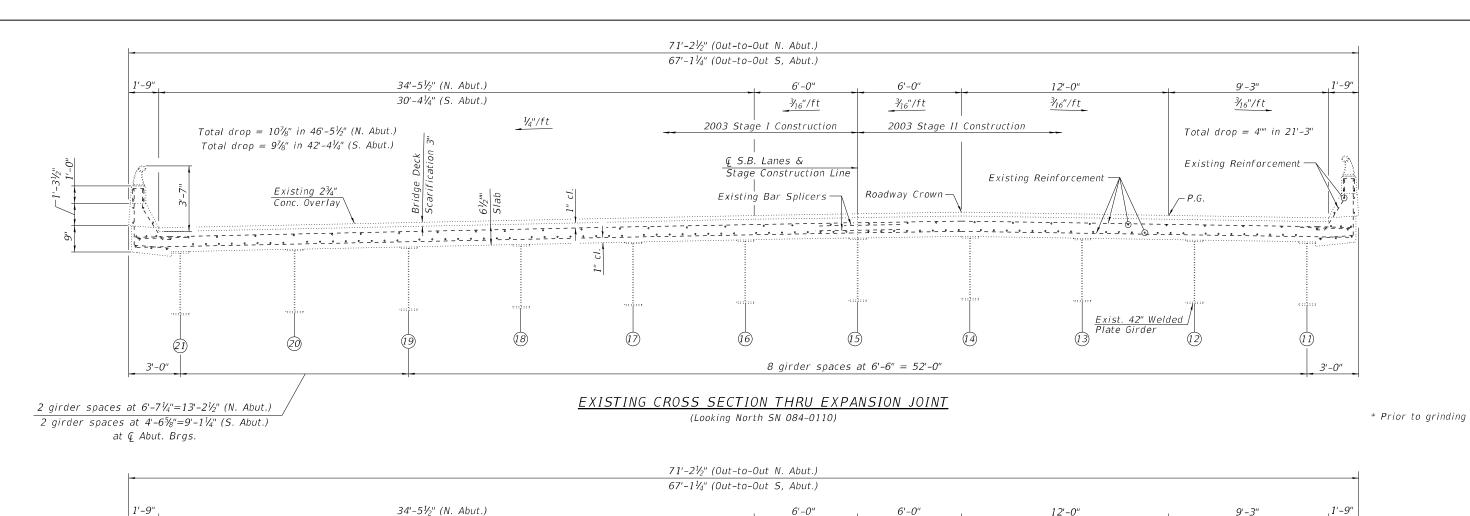

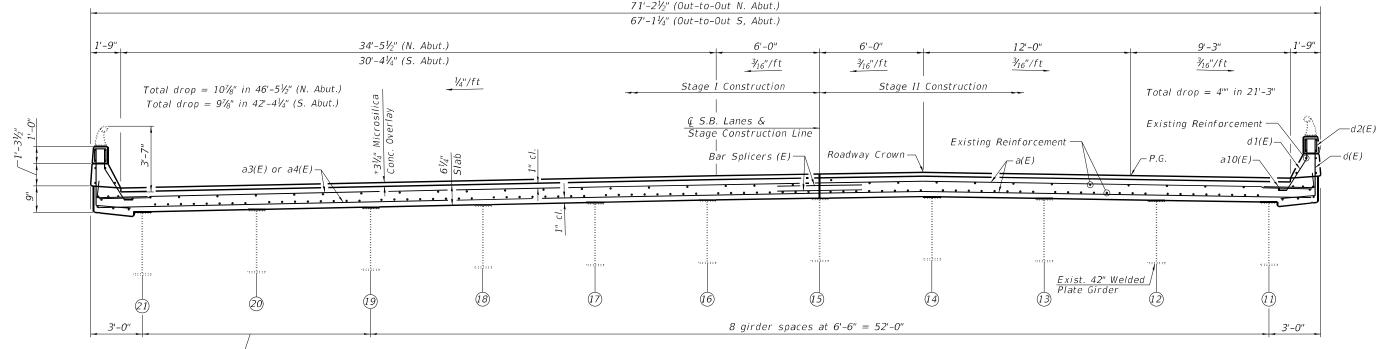

2 girder spaces at 4'-6%"=9'-1¼" (S. Abut.)

at Q Abut. Brgs.

PROPOSED CROSS SECTION THRU EXPANSION JOINT

(Looking North SN 084-0110)

Note:

The longitudinal reinforcement bars in the area of slab, parapet, and curb removal shall remain in place and shall be cleaned and incorporated into new construction. Any reinforcement bars that are damaged during concrete removal shall be replaced as directed by the Engineer. Cost included with Concrete Removal.

2 girder spaces at $6'-7\frac{1}{4}"=13'-2\frac{1}{2}"$ (N. Abut.)

U	KLINGNER	L
AME	& ASSOCIATES, P.C.	L
FILE N	Engineers • Architects • Surveyors 616 N.24TH ST. QUINCY, ILLINOIS 62301 217.223.3670 STATE OF ILLINOIS DESIGN FIRM NO. 184-2738	

-	OOLIT IVANIL -	DEGIGIALD -	AWIO	I KLVIOLD -
Ē		CHECKED -	RJP	REVISED -
rs	PLOT SCALE =	DRAWN -	AMS	REVISED -
)	PLOT DATE =	CHECKED -	RJP	REVISED -

STATE OF ILLINOIS
DEPARTMENT OF TRANSPORTATION

 SUPERSTRUCTURE DETAILS
 F.A.I. RTE.
 SECTION


 STRUCTURE NO. 084-0109 & 084-0110
 55
 (84-5-1VHB)BDR.BP.BJF

 SHEET 6 OF 27 SHEETS
 ILLINOIS

 F.A.I. RTE.
 SECTION
 COUNTY
 TOTAL SHEETS
 SHEETS NO.

 55
 (84-5-1VHB)BDR,BP,BJR,BRR
 SANGAMON
 49
 28

 CONTRACT NO. 72189

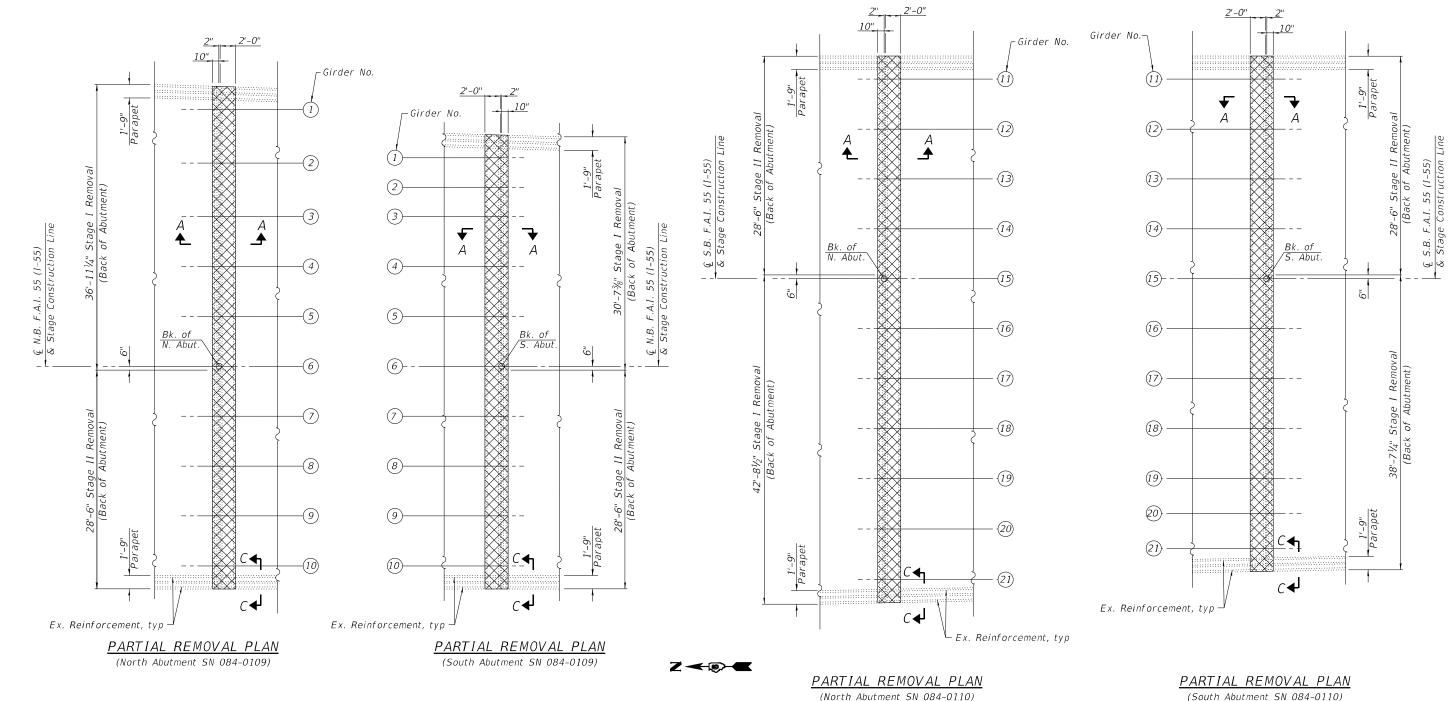

Cost of removing the existing expansion joint will be included in "Concrete Removal".

Perimeter of concrete removal areas shall be saw cut $rac{y_0}{2}$ prior to removal of the concrete.

The contractor may elect to remove and re-erect the existing aluminum railing for ease of construction, upon completion of repairs, the contractor shall reconnect the existing railing to the newly formed concrete parapet utilizing the existing mounting brackets. The base of the rail post shall be placed with 1/8" fabric bearing pad and sealed with polyurethane sealant. Cost included in "Concrete Removal".


Existing reinforcement bars protruding from the existing concrete shall be cleaned, straightened and incorporated into the new concete. Any reinforcement bars that are damaged during construction, shall be repaired or replaced using an appropriate bar splicer or mechanical system. Cost included in "Concrete Removal".

Existing reinforcement bars parallel to the expansion joint shall be removed. Cost included in

For Sections A-A and C-C, bar details & Bill of Material, see Sheet 10 of 27.

Because of the proximity of the removal line to the beam flange, the contractor must exercise care when completing the concrete removal operations, so as not to damage the girder.

LEGEND

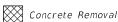


KLINGNER & ASSOCIATES, P.C. ngineers • Architects • Surveyor 616 N.24TH ST. OUINCY, ILLINOIS 62301 217.223.3670 STATE OF ILLINOIS DESIGN FIRM NO. 184-2738

USER NAME =	DESIGNED - AMS	REVISED -
	CHECKED - RJP	REVISED -
PLOT SCALE =	DRAWN - AMS	REVISED -
PLOT DATE =	CHECKED - RJP	REVISED -


STATE OF ILLINOIS DEPARTMENT OF TRANSPORTATION

SECTION SUPERSTRUCTURE DETAILS STRUCTURE NO. 084-0109 & 084-0110 SHEET 7 OF 27 SHEETS

COUNTY 55 (84-5-1VHB)BDR,BP,BJR,BRR SANGAMON 49 29 CONTRACT NO. 72189

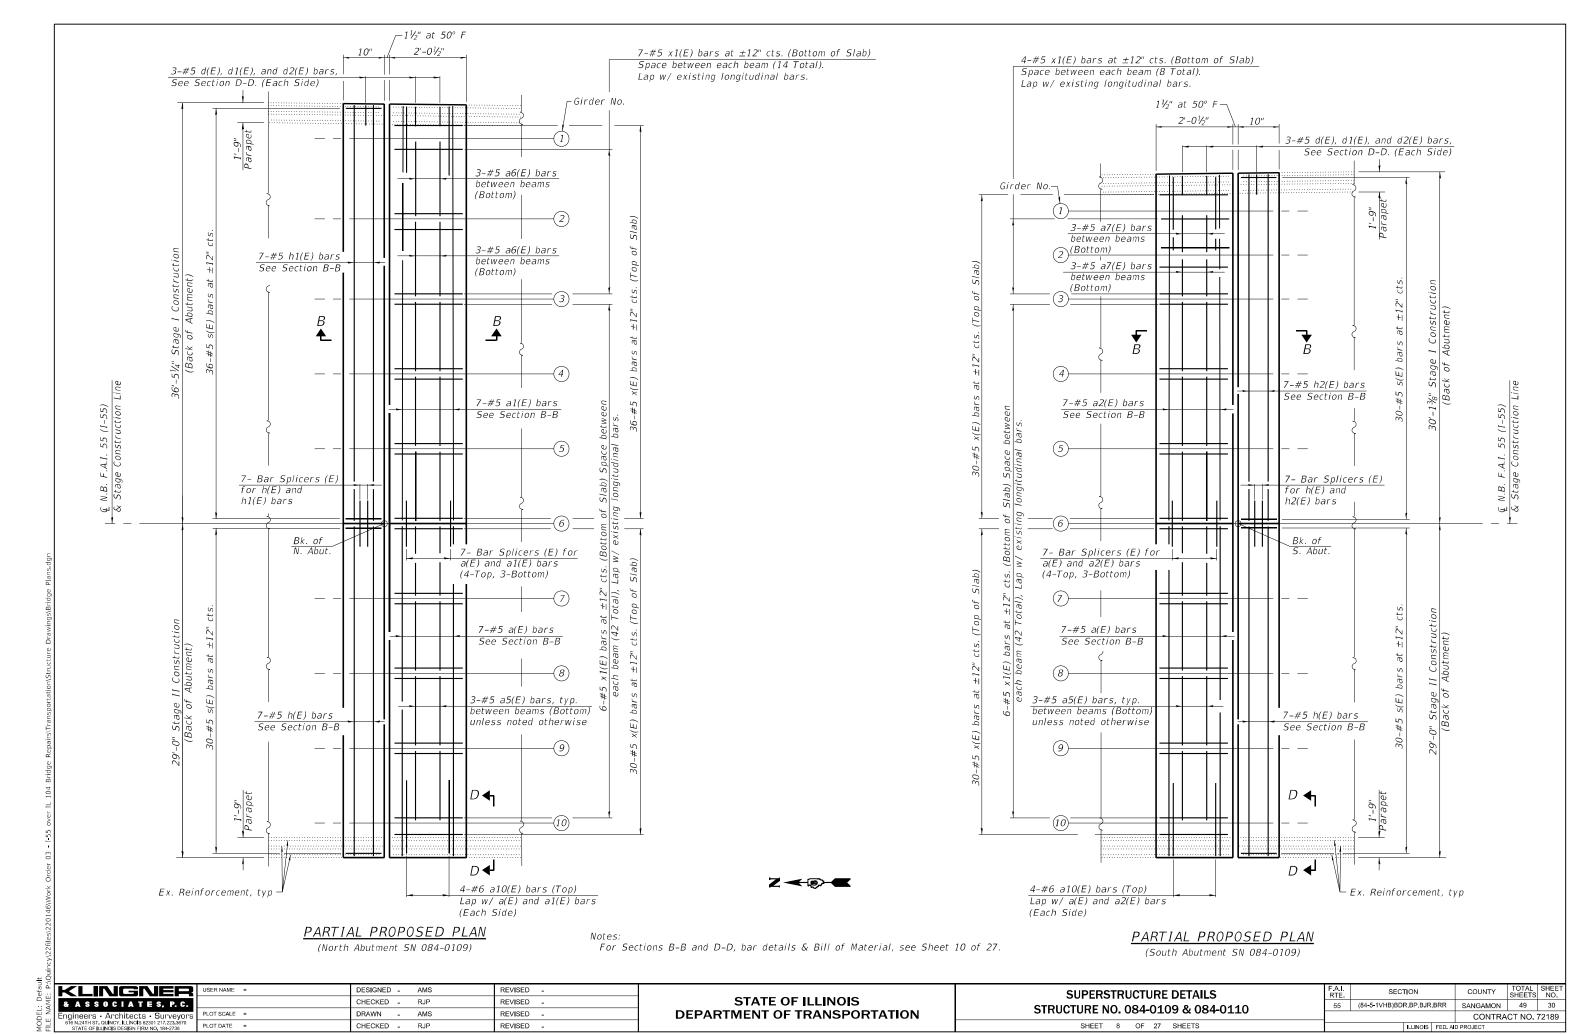

2/7/2024 7:41:05 A

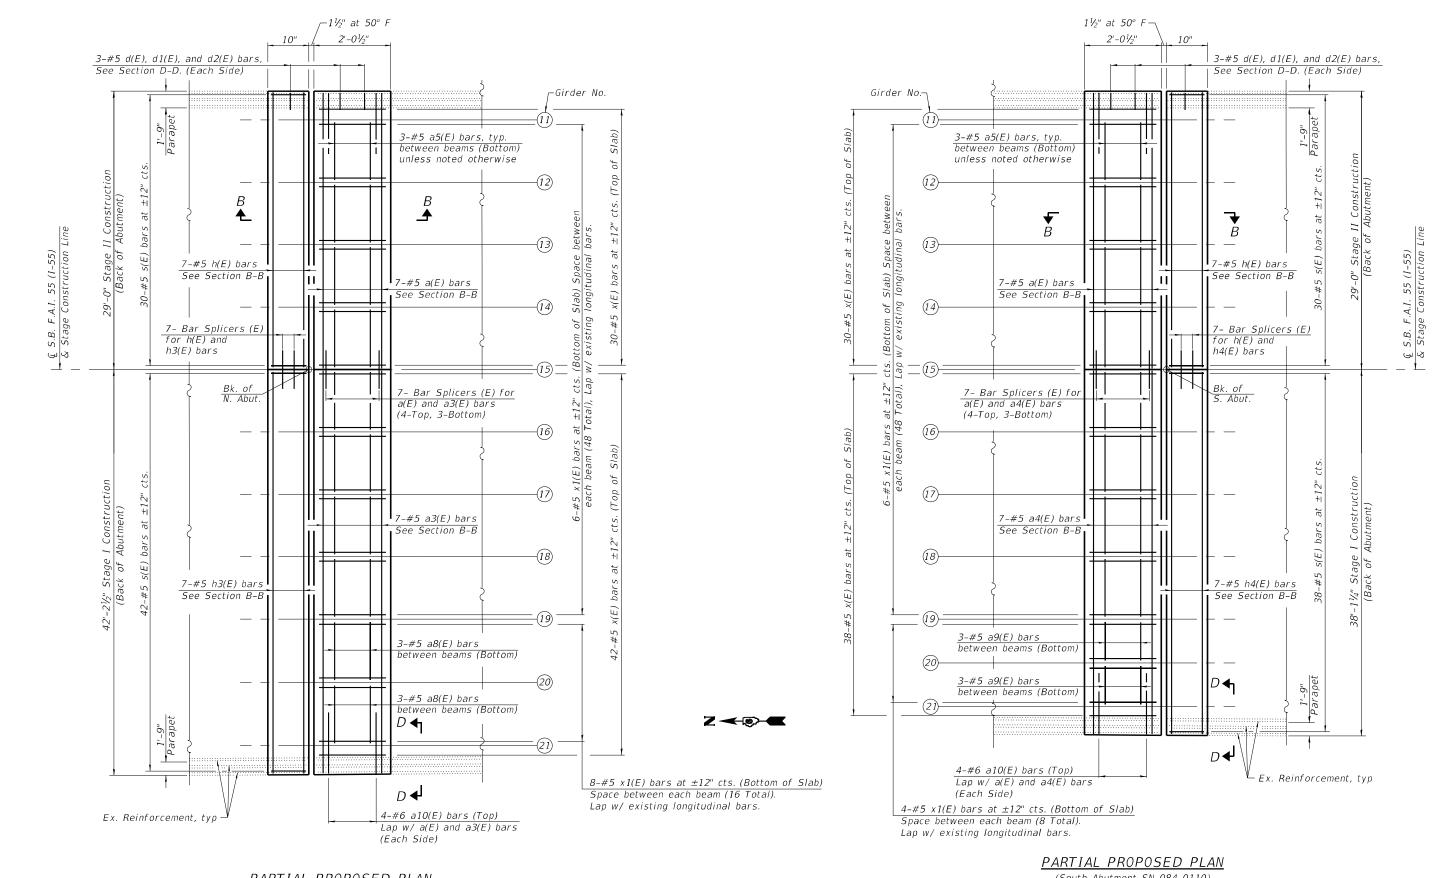

PARTIAL PROPOSED PLAN

(North Abutment SN 084-0110)


Notes: For Sections B-B and D-D, bar details & Bill of Material, see Sheet 10 of 27. (South Abutment SN 084-0110)

-		
	KLINGNER	_
	& ASSOCIATES, P.C.	
-	Engineers · Architects · Surveyors	F
	616 N.24TH ST. QUINCY, ILLINOIS 62301 217 223 3670 STATE OF ILLINOIS DESIGN FIRM NO. 184-2738	F

USER NAME = DESIGNED - AMS REVISED CHECKED - RJP REVISED -PLOT SCALE = DRAWN REVISED PLOT DATE = CHECKED -REVISED .


STATE OF ILLINOIS DEPARTMENT OF TRANSPORTATION

SECTION COUNTY SUPERSTRUCTURE DETAILS 55 (84-5-1VHB)BDR,BP,BJR,BRR SANGAMON 49 31 STRUCTURE NO. 084-0109 & 084-0110 CONTRACT NO. 72189 SHEET 9 OF 27 SHEETS

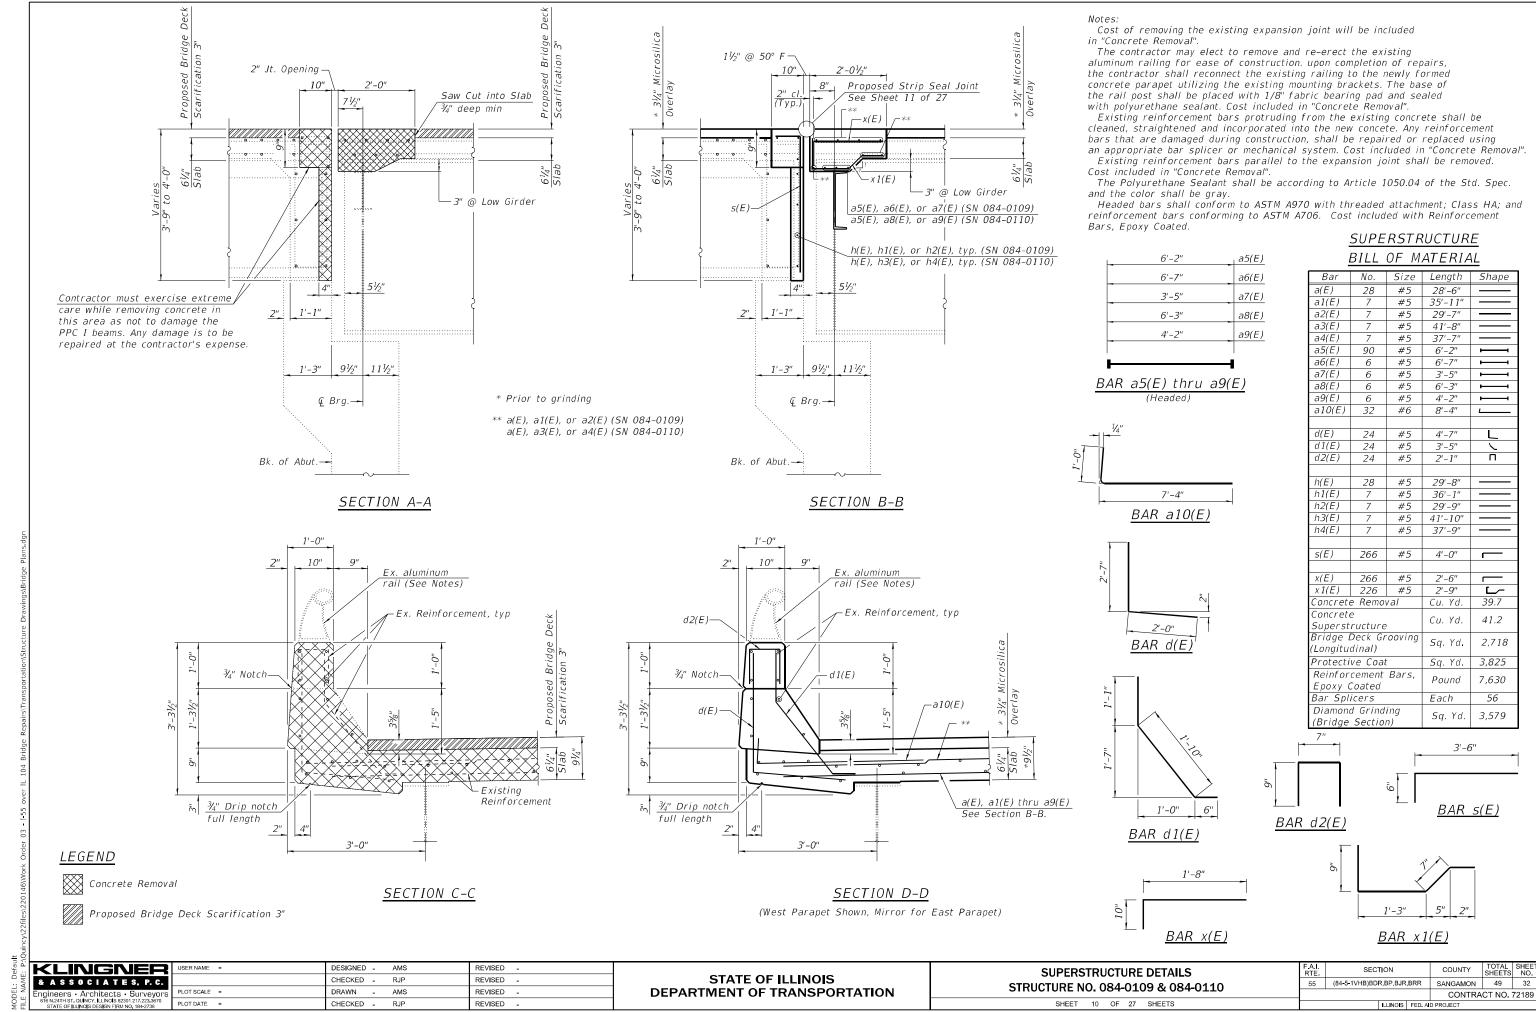

2/8/2024 1:54:09

SHOWING ROLLED RAIL JOINT

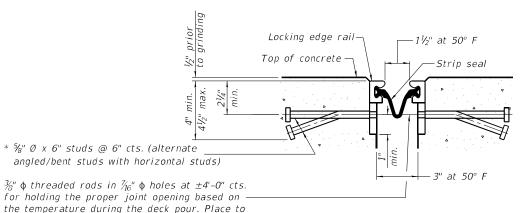


SHOWING WELDED RAIL JOINT


SECTION A-A

miss studs. All rods shall be burned, or sawed

off flush with the plates after concrete is set.

* Granular or solid flux filled headed studs conforming to Article 1006.32 of the Std. Specs., automatically end welded.

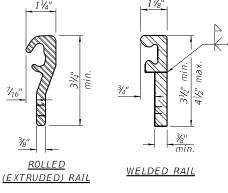

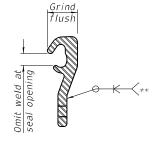


LOCKING EDGE RAILS

** Back gouge not required if complete joint penetration is verified by mock-up.

LOCKING EDGE RAIL SPLICE

The inside of the locking edge rail groove shall be free of weld residue. Rolled rail shown, welded rail similar.

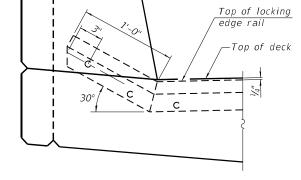

TYPICAL END TREATMENT AT CURB

Notes:

The strip seal shall be made continuous and shall have a minimum thickness of $\frac{1}{2}$. The configuration of the strip seal shall match the configuration of the locking edge rails. Open or "webbed" strip seal gland configurations are not permitted. The gland shall be sized for a maximum rated movement of 4 inches.

The locking edge rails depicted are configured for typical applications and are conceptual only. The actual configuration of the locking edge rails and matching strip seal may vary from manufacturer to manufacturer provided they fit the application and meet the minimum anchorage shown. Flanged edge rails, however, will not be allowed.

The manufacturer's recommended installation methods shall be followed.

All steel components shall be galvanized after fabrication according to Article 520.03 of the Standard Specifications.

The Maximum space between locking edge rail segments shall be $\frac{3}{16}$ " and sealed with a suitable sealant; however, any rail joint within 10' measured perpendicular to the face of the curb or parapet shall be welded as shown in the locking edge rail splice detail.

Cost of embedded plates and anchorage studs included with Preformed Joint Strip Seal.

The concrete opening below the strip seal will vary based on the locking edge rail chosen by the Contractor. Deck and parapet lengths shown elsewhere in the plans are dimensioned to the concrete opening, not the joint opening, and are based on the rolled locking edge rail. If the Contractor elects to use a different locking edge rail, dimensional adjustments may be required.

BILL OF MATERIAL

rtem	UTITE	I otal
Preformed Joint Strip Seal	Foot	257

& ASSOCIATES, P.C.
Engineers · Architects · Surveyors
is Nath ST. culvey, ILLNois 82301 217,223,3670
pt.

 USER NAME
 =
 DESIGNED
 AMS
 REVISED

 CHECKED
 RJP
 REVISED

 PLOT SCALE
 =
 DRAWN
 AMS
 REVISED

 PLOT DATE
 =
 CHECKED
 RJP
 REVISED

STATE OF ILLINOIS
DEPARTMENT OF TRANSPORTATION

PREFORMED JOINT STRIP SEAL STRUCTURE NO. 084-0109 & 084-0110

SHEET 11 OF 27 SHEETS

 F.A.I. RTE.
 SECTION
 COUNTY
 TOTAL SHEETS
 SHEET NO.

 55
 (84-5-1VHB)BDR,BP,BJR,BRR
 SANGAMON
 49
 33

 CONTRACT NO. 72189

2/8/2024 1:54:28 P

ajt. NOvinery/22/files/22014/6\West Order 03 = 1-

When "A" is 3'-1" or less, the temporary concrete barrier shall be restrained to the new slab according to Detail I, II or III. No restraint is required when "A" is greater than 3'-1".

Temporary Concrete Barrier See Standard 704001 6" min. min. Drill 3-11/4" Ø Holes in existing slab for 1" Ø restraining pins. Traffic side only. Cost of restraining pins are included with Temporary Concrete Barrier. No restraint * When hot-mix asphalt wearing surface is present, embedment

→ Stage removal line

1'-101/2"

EXISTING SLAB

shall be 3" plus the wearing surface depth.

← Ç ¾" Ø Holes

EXISTING DECK BEAM

10"

- Stage removal line


1'-101/2"


US Std. 11/16" I.D. x 21/2" O.D. x approx. 8 gauge thick washer

NEW SLAB OR NEW DECK BEAM

SECTIONS THRU SLAB OR DECK BEAM

is required when "A" is greater than 3'-1".

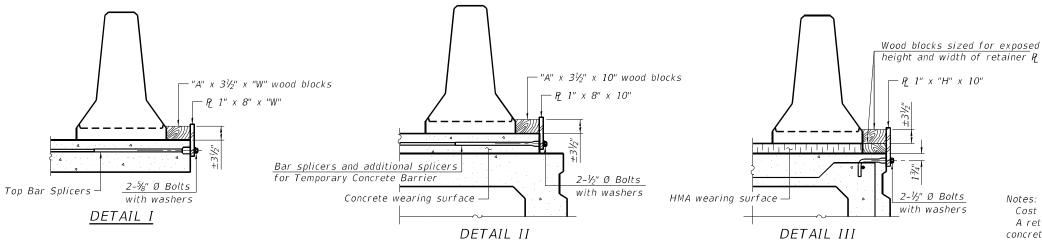


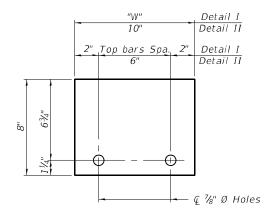

RAILING CRITERIA

NCHRP 350 Test Level Railing Weight (plf) 440 STEEL RETAINER P 1" x 8" x "W"

STEEL RETAINER P 1" x "H" x 10" (Detail III) (Detail I and II)

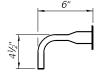

RESTRAINING PIN

BAR SPLICER FOR #4 BAR - DETAIL III

Cost of retainer assembly is included with Temporary Concrete Barrier. A retainer assembly shall be located at the approximate \cline{Q} of each temporary

The retainer plate shall not be removed until the concrete on the adjacent stage is ready to be poured. For Detail III applications the retainer plate shall not be removed until just prior to placing the adjacent beam.

1x8 UNC

1" Ø pin

When the 'A' dimension is less than $1\frac{1}{2}$ ", the wood block shall be omitted and the barrier shall be placed in direct contact with the steel retainer plate. For deck beam applications the minimum required 'A' distance is 6" to accommodate the shear key clamping device.


- Detail I Installation for a new bridge deck or bridge slab.
- Detail II Installation for a new deck beam with an initial concrete wearing surface. Additional bar splicers shall be provided at 6'-0" centers and paired with the bar splicers of the concrete wearing surface reinforcement to accommodate the installation of the retainer assemblies. The cost of the additional bar splicers is included with the concrete wearing surface.
- Detail III Installation for a new deck beam with no initial wearing surface or with an initial hot-mix asphalt (HMA) wearing surface present. The deck beam directly beneath the temporary concrete barrier shall be fabricated with bar splicer inserts in the side of the beam, as detailed, to accommodate the installation of the retainer assemblies. A pair of bar splicers, 6" apart, shall be placed at 6'-0" centers along the length of the beam. The cost of the bar splicers is included with the deck beam.

10-12-2021 KLINGNER

DESIGNED - AMS REVISED -& ASSOCIATES, P.C. CHECKED - RJP REVISED -REVISED ngineers • Architects • Surveyor 616 N.24TH ST. QUINCY, ILLINOIS 62301 217,223,3670 STATE OF ILLINOIS DESIGN FIRM NO. 184-2738 CHECKED - RJP REVISED -

STATE OF ILLINOIS DEPARTMENT OF TRANSPORTATION

SECTION **TEMPORARY CONCRETE BARRIER** 55 (84-5-1VHB)BDR,BP,BJR,BRR SANGAMON 49 34 STRUCTURE NO. 084-0109 & 084-0110 CONTRACT NO. 72189 SHEET 12 OF 27 SHEETS

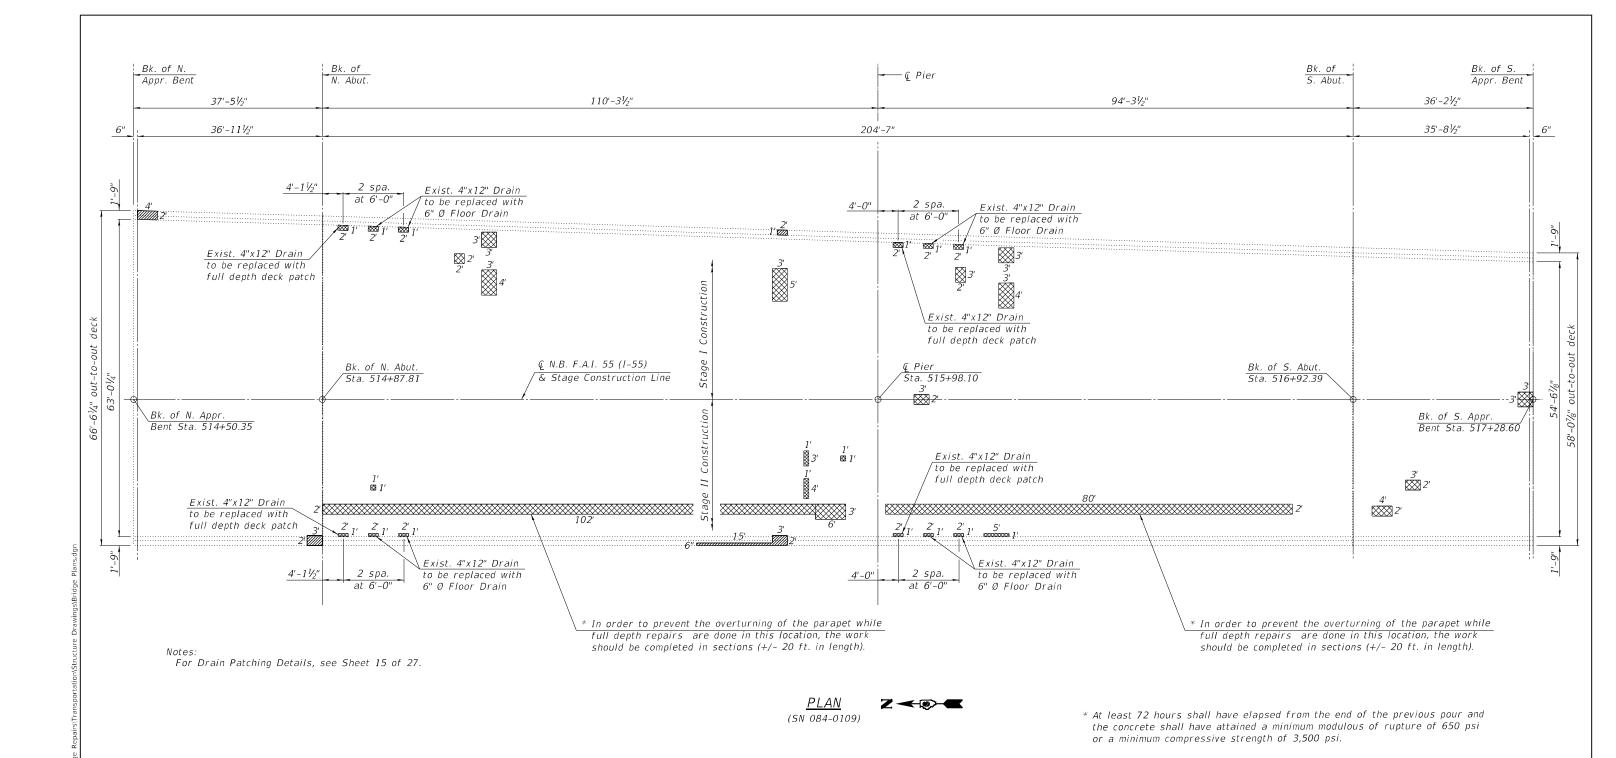

LEGEND

Structural Repair of Concrete (Depth Equal to or Less than 5 inches) (Bottom of deck, under existing parapet)




Deck Slab Repair (Full Depth) (Areas of Deck Slab Repair are estimated. The Resident Engineer shall show actual locations of deck slab repair on the "As-Built" Plans.

Note: Partial Depth Repair shall be achieved by bridge deck scarification and filled with microsilicia concrete overlay. Cost included in "Bridge Deck Scarification 3" " and "Bridge Deck Microsilicia Concrete Overlay 3½" "

BILL OF MATERIAL

Item	Unit	Total
Deck Slab Repair (Full Depth, Type I)	Sq. Yd.	5
Deck Slab Repair (Full Depth, Type II)	Sq. Yd.	42
Structural Repair of Concrete (Depth Equal to or Less than 5 Inches)	Sq. Ft.	30

KLINGNER JSER NAME = DESIGNED - AMS REVISED -SECTION COUNTY **DECK PATCHING STATE OF ILLINOIS** & ASSOCIATES, P.C. CHECKED - RJP REVISED -55 (84-5-1VHB)BDR,BP,BJR,BRR SANGAMON 49 35 STRUCTURE NO. 084-0109 & 084-0110 DRAWN - AMS REVISED -**DEPARTMENT OF TRANSPORTATION** ngineers • Architects • Surveyor 616 N.24TH ST. OUINCY, ILLINOIS 62301 217.223.3670 STATE OF ILLINOIS DESIGN FIRM NO. 184-2738 CONTRACT NO. 72189 SHEET 13 OF 27 SHEETS PLOT DATE = CHECKED - RJP REVISED -

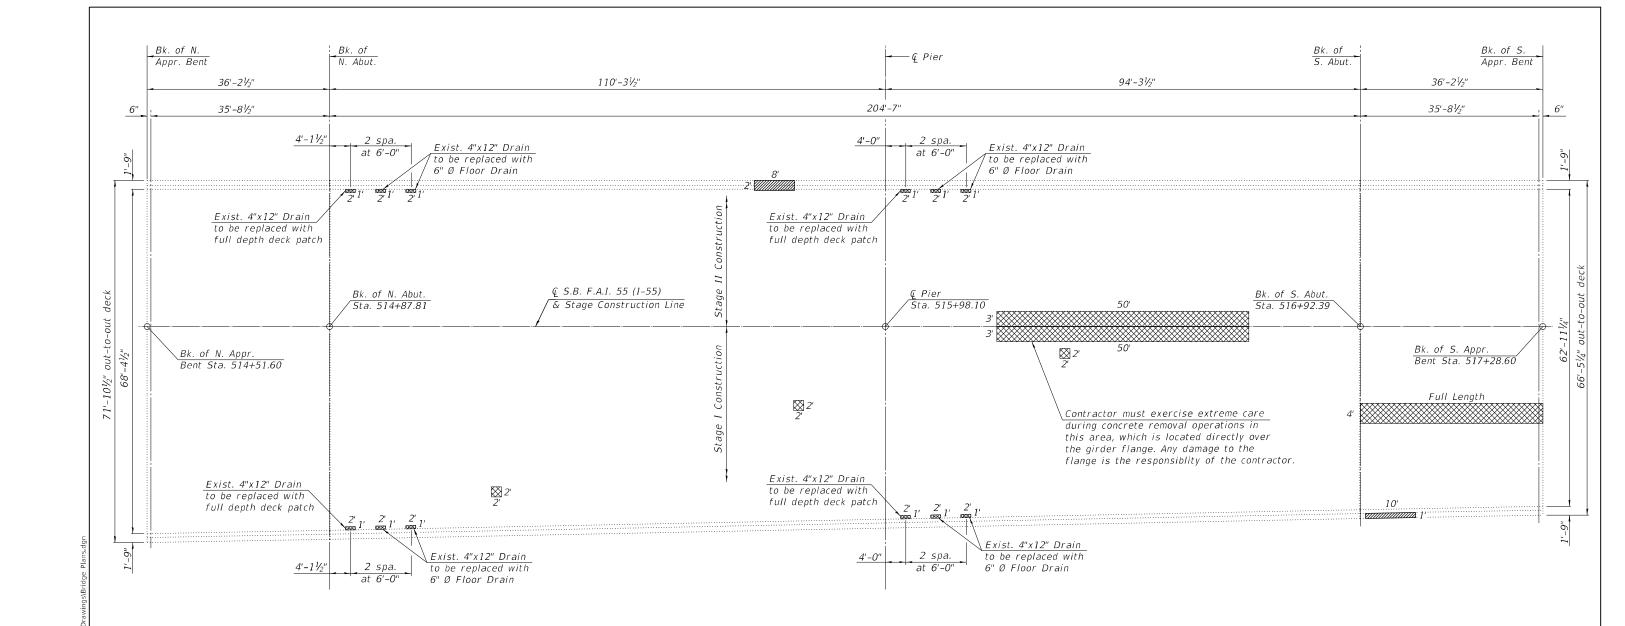

Notes:

For Drain Patching Details, see Sheet 15 of 27.

LEGEND

Structural Repair of Concrete (Depth Equal to or Less than 5 inches) (Bottom of deck, under existing parapet)



Deck Slab Repair (Full Depth) (Areas of Deck Slab Repair are estimated. The Resident Engineer shall show actual locations of deck slab repair on the "As-Built" Plans.

Note: Partial Depth Repair shall be achieved by bridge deck scarification and filled with microsilicia concrete overlay. Cost included in "Bridge Deck Scarification 3" " and "Bridge Deck Microsilicia Concrete Overlay 31/4" "

BILL OF MATERIAL

Item	Unit	Total
Deck Slab Repair (Full Depth, Type I)	Sq. Yd.	4
Deck Slab Repair (Full Depth, Type II)	Sq. Yd.	48
Structural Repair of Concrete (Depth Equal to or Less than 5 Inches)	Sq. Ft.	26

KLINGNER & ASSOCIATES, P.C. Engineers • Architects • Surveyor:
616 N.24TH ST. QUINCY, ILLINGIS 62301 217.223.3670
STATE OF ILLINGIS DESIGN FIRM NO. 184-2738

JSER NAME = DESIGNED - AMS REVISED -CHECKED - RJP REVISED -DRAWN - AMS REVISED -PLOT DATE = CHECKED - RJP REVISED -

STATE OF ILLINOIS **DEPARTMENT OF TRANSPORTATION**

<u>PLAN</u>

(SN 084-0110)

Z - (5)- (E

DECK PATCHING STRUCTURE NO. 084-0109 & 084-0110 SHEET 14 OF 27 SHEETS


SECTION COUNTY 55 (84-5-1VHB)BDR,BP,BJR,BRR SANGAMON 49 36 CONTRACT NO. 72189


EXISTING DECK DRAIN REMOVAL

PROPOSED DECK DRAIN

►B

** Deck Slab Repair (Full Depth, Type I)

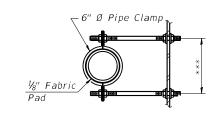


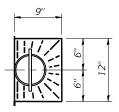

SECTION C-C

TOP PLAN

***Dimension as required by Pipe Clamp

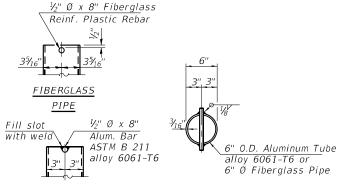

<u>ALUMINUM</u> TUBE


<u>TOP PLAN</u> (Showing Aluminum Tube)

Fiberglass pipe shall conform to ASTM D 2996, with short-time rupture strength hoop tensile stress of 30,000 p.s.i. minimum.

Remove Ex 4"x12" Aluminum
Drain & Supporting Bracket
Cost included in "Deck Slab
Repair (Full Depth Type I)"

SECTION A-A

(For Locations See Sheets 13 and 14 of 27)

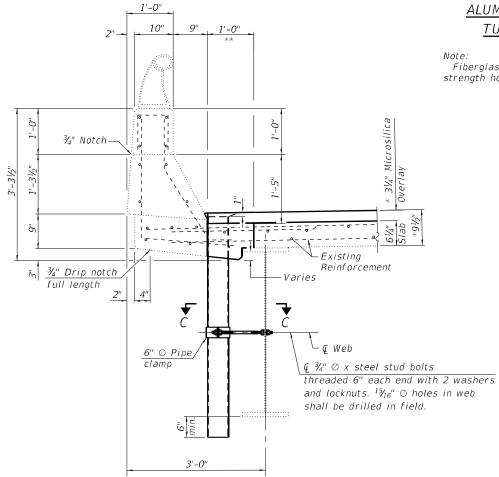

<u>SECTION B-B</u>

(For Locations See Sheets 13 and 14 of 27)

* Prior to grinding

Notes

Hatched areas indicate concrete sections to be removed and replaced. Perimeters of concrete removal areas shall be saw cut ¾" prior to the removal of concrete.

Existing reinforcement bars shown are to be cleaned and incorporated into the new construction,

BILL OF MATERIAL

Item	Unit	Total
Floor Drains	Each	16

& A S S O C I A T E S, P. C.
Engineers · Architects · Surveyors
161 N.241451. QUINCY LILNOIS SEQUE 217.223.3670
STATE OF LILNOIS DESIGN FIRM NO. 184-2788

 USER NAME
 =
 DESIGNED
 AMS
 REVISED

 CHECKED
 RJP
 REVISED

 PLOT SCALE
 =
 DRAWN
 AMS
 REVISED

 PLOT DATE
 =
 CHECKED
 RJP
 REVISED

STATE OF ILLINOIS
DEPARTMENT OF TRANSPORTATION

DECK DRAIN DETAILS


STRUCTURE NO. 084-0109 & 084-0110

SHEET 15 OF 27 SHEETS

 F.A.I. RTE.
 SECTION
 COUNTY
 TOTAL SHEETS
 SHEETS NO.

 55
 (84-5-1VHB)BDR.BP,BJR,BRR
 SANGAMON
 49
 37

 CONTRACT NO. 72189

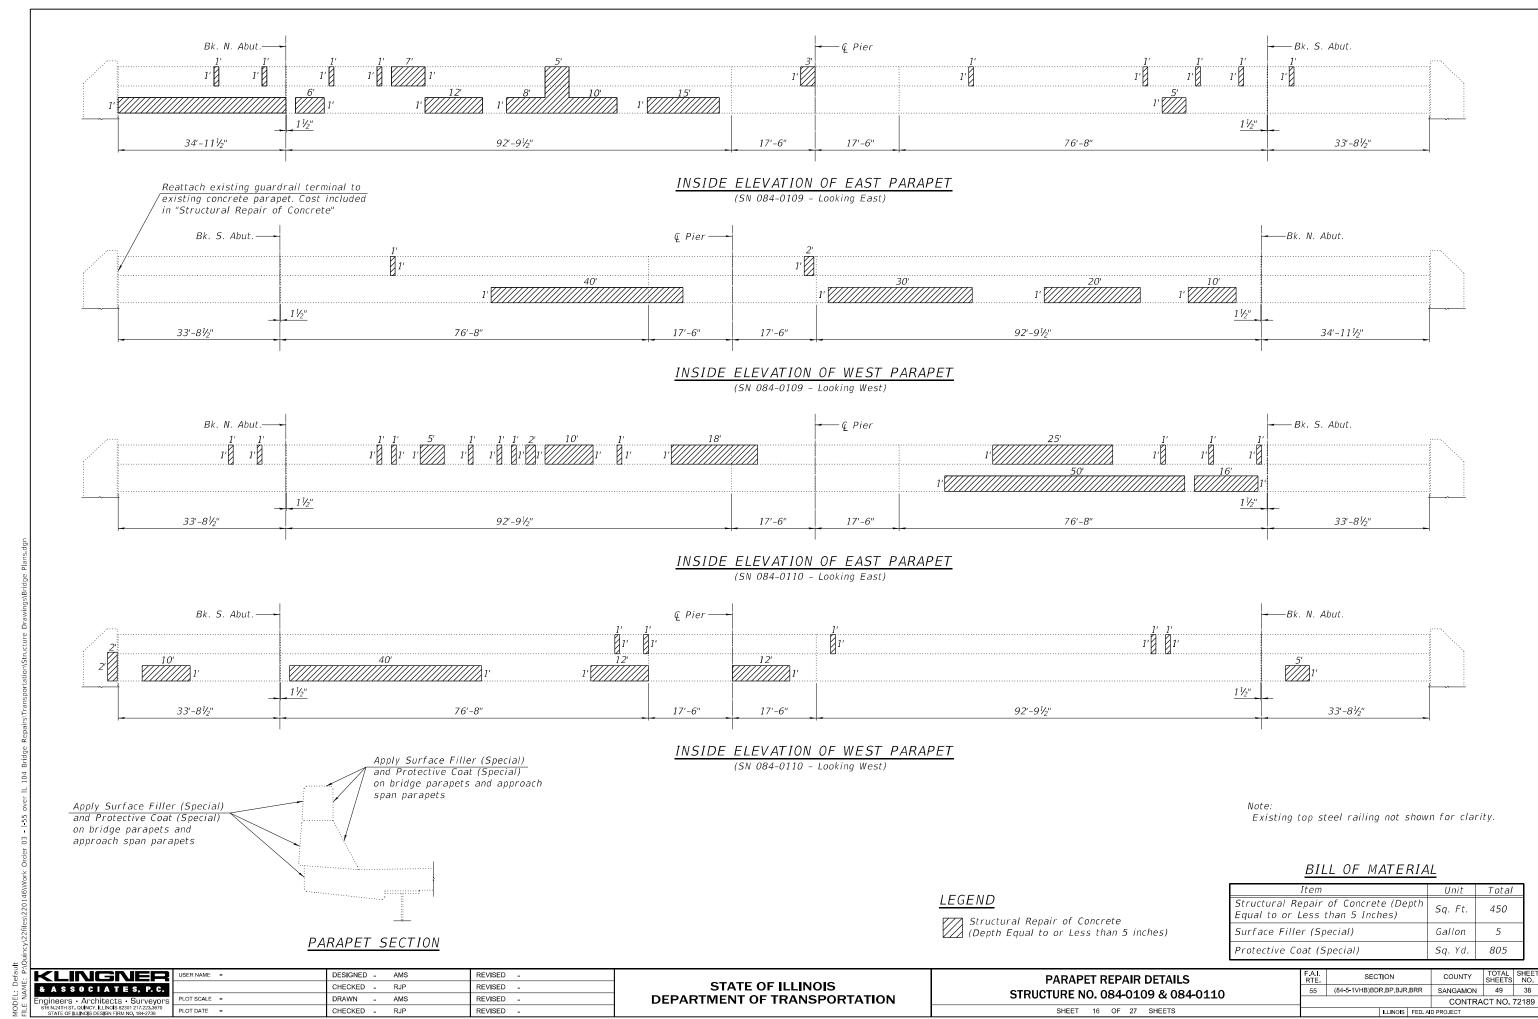


2/7/2024 7:44:04 /





2/7/2024 7:44:22 AM

GIRDER ELEVATION

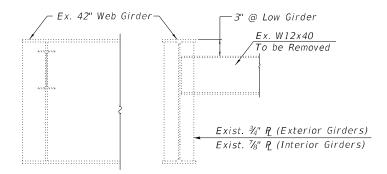

EXISTING END DIAPHRAGM, D

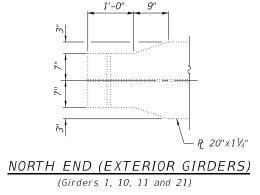

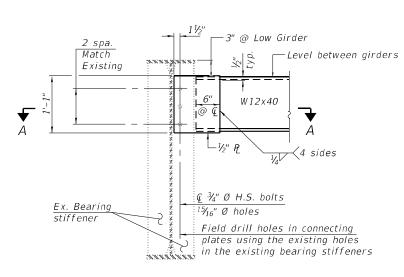


END DIAPHRAGM REPAIR DETAIL

All Girders - S. Abut. & Interior Girders - N. Abut.

Two hardened washers required for each set of oversized holes.

New W12x40 diaphragms and connecting plates shall be hot-dipped galvanized.

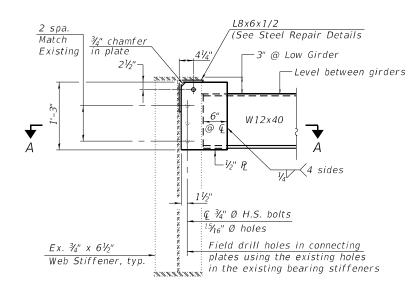


END DIAPHRAGM REPAIR DETAIL

Exterior Girders - N. Abut.

Note:

Two hardened washers required for each set of oversized holes.

New W12x40 diaphragms and connecting plates shall be hot-dipped galvanized.

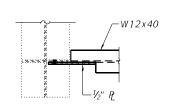

SECTION A-A

For Bill of Material, see Sheet 19 of 27.


KLINGNER & ASSOCIATES, P.C. Engineers • Architects • Surveyor 616 N.24TH ST. OUINCY, ILLINOIS 62301 217.223.3670 STATE OF ILLINOIS DESIGN FIRM NO. 184-2738

DESIGNED - AMS REVISED -CHECKED - RJP REVISED -DRAWN -REVISED PLOT DATE = CHECKED -REVISED

STATE OF ILLINOIS DEPARTMENT OF TRANSPORTATION


STRUCTURAL STEEL REPAIR DETAILS STRUCTURE NO. 084-0109 & 084-0110 SHEET 18 OF 27 SHEETS

SECTION COUNTY 55 (84-5-1VHB)BDR,BP,BJR,BRR SANGAMON 49 40 CONTRACT NO. 72189

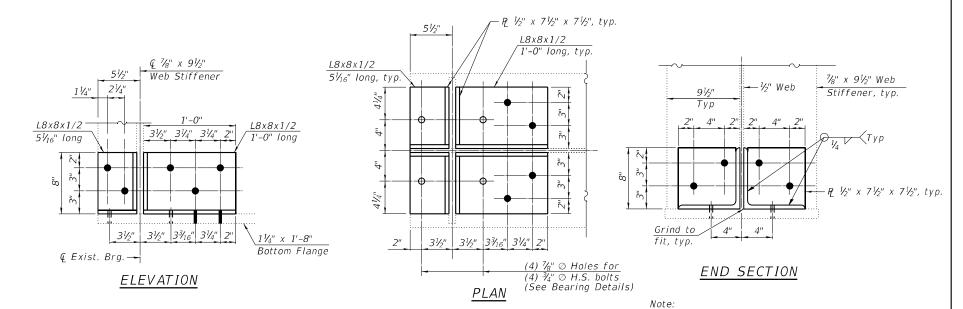

REPAIR DETAIL A Interior Girders - N. Abut (5 Locations)

At locations where there are holes on the web a sealer compatible with structural steel should be used prior to installing the stengthening angles. Cost of the sealer included in "Furnishing and Erecting Structural Steel".

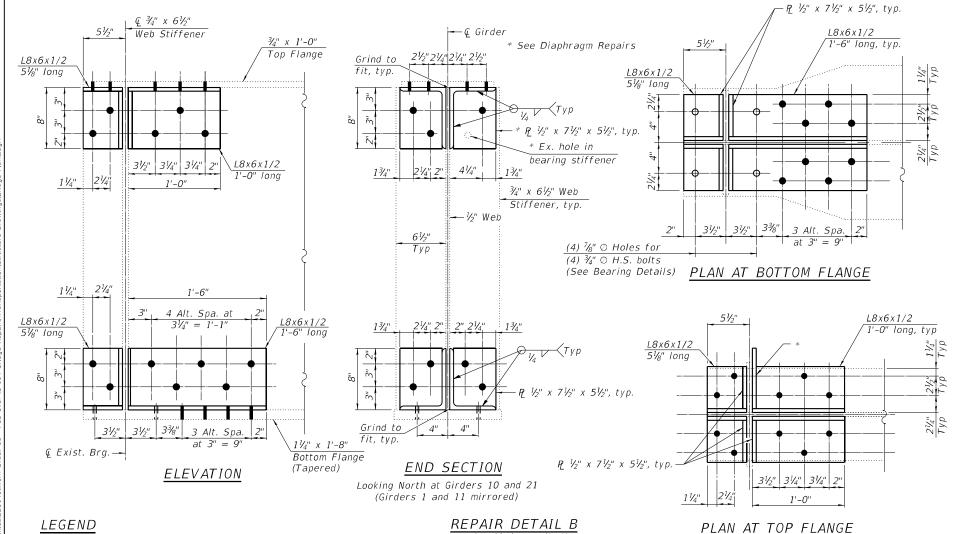

Exterior Girders - N. Abut.


(4 Locations)


SOUTH ABUTMENT (SN 084-0109)


Girder	Α	В	С	D
1	12"	2 Spa. at 31/4"	31/8"	1 Spa. at 31/4"
6	12"	2 Spa. at 31/4"	31/8"	1 Spa. at 31/4"
8	12"	2 Spa. at 31/4"	31/8"	1 Spa. at 31/4"
9	12"	2 Spa. at 31/4"	31/8"	1 Spa. at 31/4"
10	12"	2 Spa. at $3\frac{1}{4}$ "	31/8"	1 Spa. at 31/4"

SOUTH ABUTMENT (SN 084-0110)

	Girder	Α	В	С	D
	11	12"	2 Spa. at 3¼"	31/8"	1 Spa. at 3⅓"
	12	12"	2 Spa. at 3¼"	31/8"	1 Spa. at 3⅓"
	13	12"	2 Spa. at 3¼"	31/8"	1 Spa. at 31⁄4"
	14	24"	6 Spa. at 31/8"	33/8"	5 Spa. at 3"
	15	24"	6 Spa. at 31/8"	3¾"	5 Spa. at 3"
	16	12"	2 Spa. at 31/4"	31/8"	1 Spa. at 3⅓"
	17	12"	2 Spa. at 3½"	31/8"	1 Spa. at 31/4"
	18	18"	4 Spa. at 3¼"	3¾"	3 Spa. at 3"
	19	30"	8 Spa. at 31/8"	33/8"	7 Spa. at 3"
	20	30"	8 Spa. at 3½"	33/8"	7 Spa. at 3"

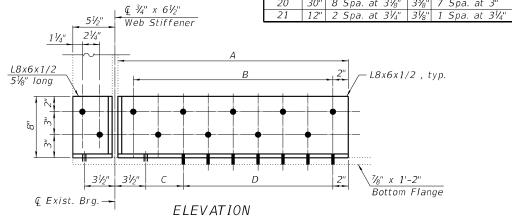

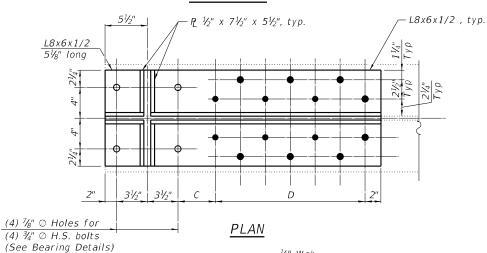

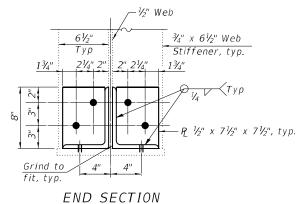

REPAIR DETAIL C

Interior and Exterior Girders - S. Abut. (16 Locations)

BILL OF MATERIAL

	Item	Unit	Lotal
	Structural Steel Removal	Pound	9,555
	Furnishing and Erecting Structural Steel	Pound	13,915
,			

KLINGNER & ASSOCIATES, P.C. ngineers • Architects • Surveyor 616 N.24TH ST. OUINCY, ILLINOIS 62301 217.223.3670 STATE OF ILLINOIS DESIGN FIRM NO. 184-2738

Field drill using new steel as template

DESIGNED - AMS REVISED . CHECKED - RJP REVISED -DRAWN REVISED PLOT DATE = CHECKED -REVISED

STATE OF ILLINOIS DEPARTMENT OF TRANSPORTATION

* See Diaphragm Repairs

STRUCTURAL STEEL REPAIR DETAILS STRUCTURE NO. 084-0109 & 084-0110 SHEET 19 OF 27 SHEETS

SECTION COUNTY (84-5-1VHB)BDR,BP,BJR,BRR SANGAMON 49 41 CONTRACT NO. 72189

EXISTING BEARING REMOVAL DETAIL

(Dimensions at Rt L's)

JACK AND REMOVE EXISTING BEARINGS PROCEDURES

The Contractor shall submit for approval by the Engineer plans for jacking, prior to commencing any work at the bearings. The maximum reactions (per bearing) are as follows:

North Abutment:
Dead Load = 49.2 kips
Live Load = 38.0 kips
Impact = 11 kips
Total = 98.2 kips
Misimum Tock Capacity Minimum Jack Capacity = 60 Tons South Abutment: .n Abutment: Dead Load = 37.7 kips Live Load = 37.3 kips Impact = 11 kips Total = 86.0 kips Minimum Jack Capacity = 50 Tons

- Top of deck elevations shall be measured prior to jacking and shall remain the same after bearings are in place.
- There shall be at least one jack per bearing and the jack shall be placed close to the bearing. After jacking, the beams shall be blocked in position until after the completion of the installation of new bearings.
- 4. Burn the existing anchor bolts flush with the concrete surface, grind smooth, and seal with epoxy. The rollers and top and bottom plates shall be removed. The top plate shall be removed using the air-arc method. Grind smooth all weld material remaining on the bottom flange. Cost of removing anchor bolts, rockers, top plates, and bottom plates shall be included with "Jack and Remove Existing Bearings."
- 5. The new elastomeric bearings shall be in place, prior to lowering the jacks.

BILL OF MATERIAL

Item			Unit	Total	
Jack and	Remove	Existing	Bearings	Each	42


KLINGNER & ASSOCIATES, P.C. U Z Engineers • Architects • Surveyors
O U S TATE OF ILLINOIS 62301 217.223,3670
STATE OF ILLINOIS DESIGN FIRM NO. 184-2738

JSER NAME = DESIGNED - AMS REVISED -CHECKED - RJP REVISED . DRAWN AMS REVISED PLOT DATE = CHECKED -RJP REVISED

STATE OF ILLINOIS DEPARTMENT OF TRANSPORTATION JACK AND REMOVE EXISTING BEARINGS STRUCTURE NO. 084-0109 & 084-0110 SHEET 20 OF 27 SHEETS

SECTION COUNTY 55 (84-5-1VHB)BDR,BP,BJR,BRR SANGAMON 49 42 CONTRACT NO. 72189

ELEVATION AT ABUTMENTS TYPE I ELASTOMERIC BEARING

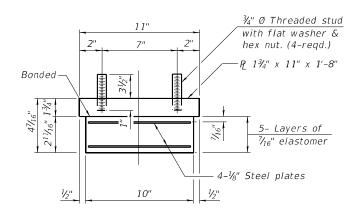



BEARING ASSEMBLY

(North Abut. Interior Girders)

Note:

Shim plates shall not be placed under bearing assembly.

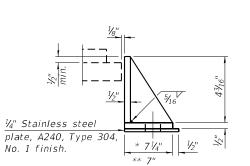

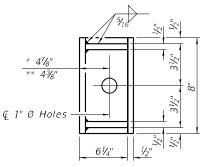


SIDE RETAINER

Equivalent rolled angle with stiffeners will be allowed in lieu of welded plates.

- * N. Abut. Interior Girders
- ** N. Abut. Exterior Girders and S. Abut.


* N. Abut. Interior Girders

** N. Abut. Exterior Girders and S. Abut.

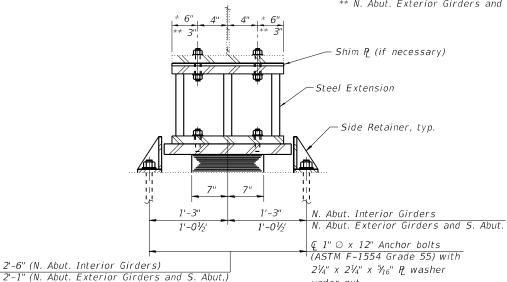

under nut

SECTION A-A

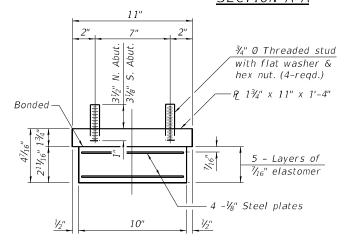

BEARING ASSEMBLY

(South Abut, and North Abut, Exterior Girders) Note:

Shim plates shall not be placed under bearing assembly.

Anchor bolts shall be ASTM F1554 all-thread (or an Engineer-approved alternate material) of the grade(s) and diameter(s) specified. The corresponding specified grade of AASHTO M314 anchor bolts may be used in lieu of ASTM F1554.


Side retainers, and stainless steel plates shall be included in the cost of Elastomeric Bearing Assembly, Type I. Girders shall be braced for stability during erection and remain braced until deck is poured and cured.


Anchor bolts and side retainers at all supports shall be installed as each member is erected unless an equivalent temporary means of lateral restraint is used.

Prior to ordering any material, the Contractor shall verify in the field all bearing heights and shim thickness

All (embedded and separate) bearing plates, side retainers, extensions, anchor bolts, nuts, washers and pintles shall be galvanized according to AASHTO M111 or M232 as applicable unless noted otherwise.


Two 1/8 in. adjusting shims shall be provided for each bearing in addition to all other plates or shims and placed as shown on bearing details.

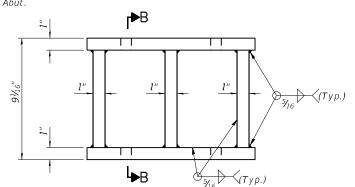


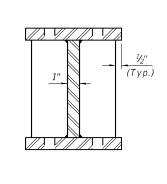


ELEVATION - STEEL EXTENSION

SECTION B-B

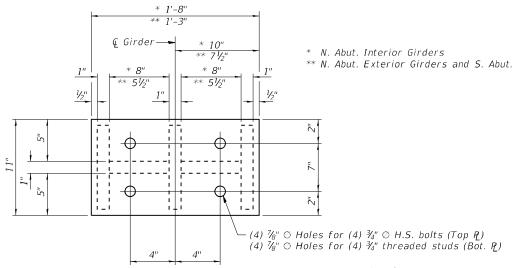

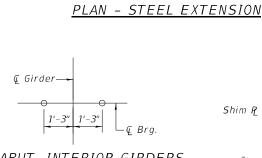




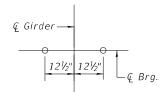

N. ABUT. EXTERIOR GIRDERS AND S. ABUT.

ANCHOR BOLT LAYOUT DETAIL

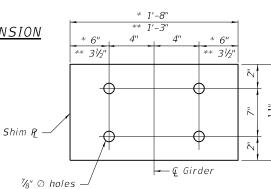

Note:

Shim plates shall be placed above bearing assembly top plate.

FOUR ABUTMENTS BILL OF MATERIAL

SHIM R - ABUTMENTS

Unit	Total
Each	42
Each	84
Pound	8,792
	Each Each


KLINGNER & ASSOCIATES, P.C. ngineers • Architects • Surveyor 616 N.24TH ST. QUINCY, ILLINOIS 62301 217.223.3670 STATE OF ILLINOIS DESIGN FIRM NO. 184-2738

JSER NAME = DESIGNED - AMS REVISED CHECKED - RJP REVISED DRAWN REVISED PLOT DATE = CHECKED -REVISED

STATE OF ILLINOIS DEPARTMENT OF TRANSPORTATION

ABUTMENT BEARING DETAILS STRUCTURE NO. 084-0109 & 084-0110 SHEET 21 OF 27 SHEETS

SECTION COUNTY (84-5-1VHB)BDR,BP,BJR,BRR SANGAMON 49 43 CONTRACT NO. 72189

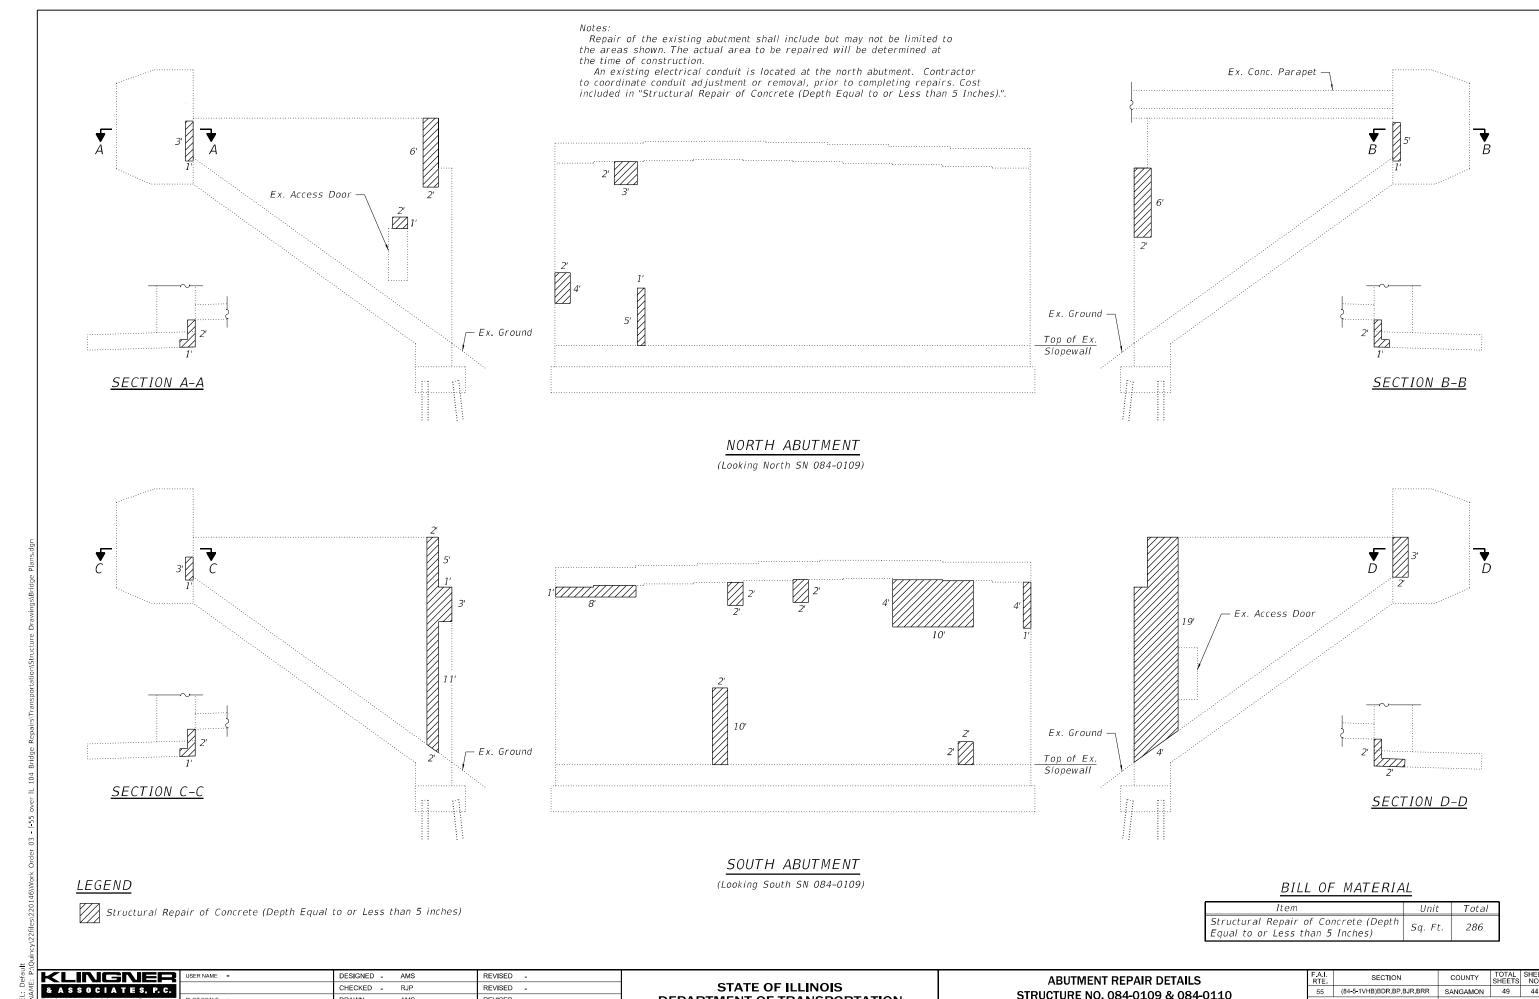


Engineers • Architects • Surveyor:
616 N.24TH ST. OUINCY, ILLINOIS 62301 217.223,3670
STATE OF ILLINOIS DESIGN FIRM NO. 184-2738

CHECKED - RJP REVISED -DRAWN REVISED CHECKED - RJP REVISED -

STATE OF ILLINOIS **DEPARTMENT OF TRANSPORTATION**

ABUTMENT REPAIR DETAILS STRUCTURE NO. 084-0109 & 084-0110 SHEET 22 OF 27 SHEETS

SECTION 55 (84-5-1VHB)BDR,BP,BJR,BRR SANGAMON 49 44 CONTRACT NO. 72189

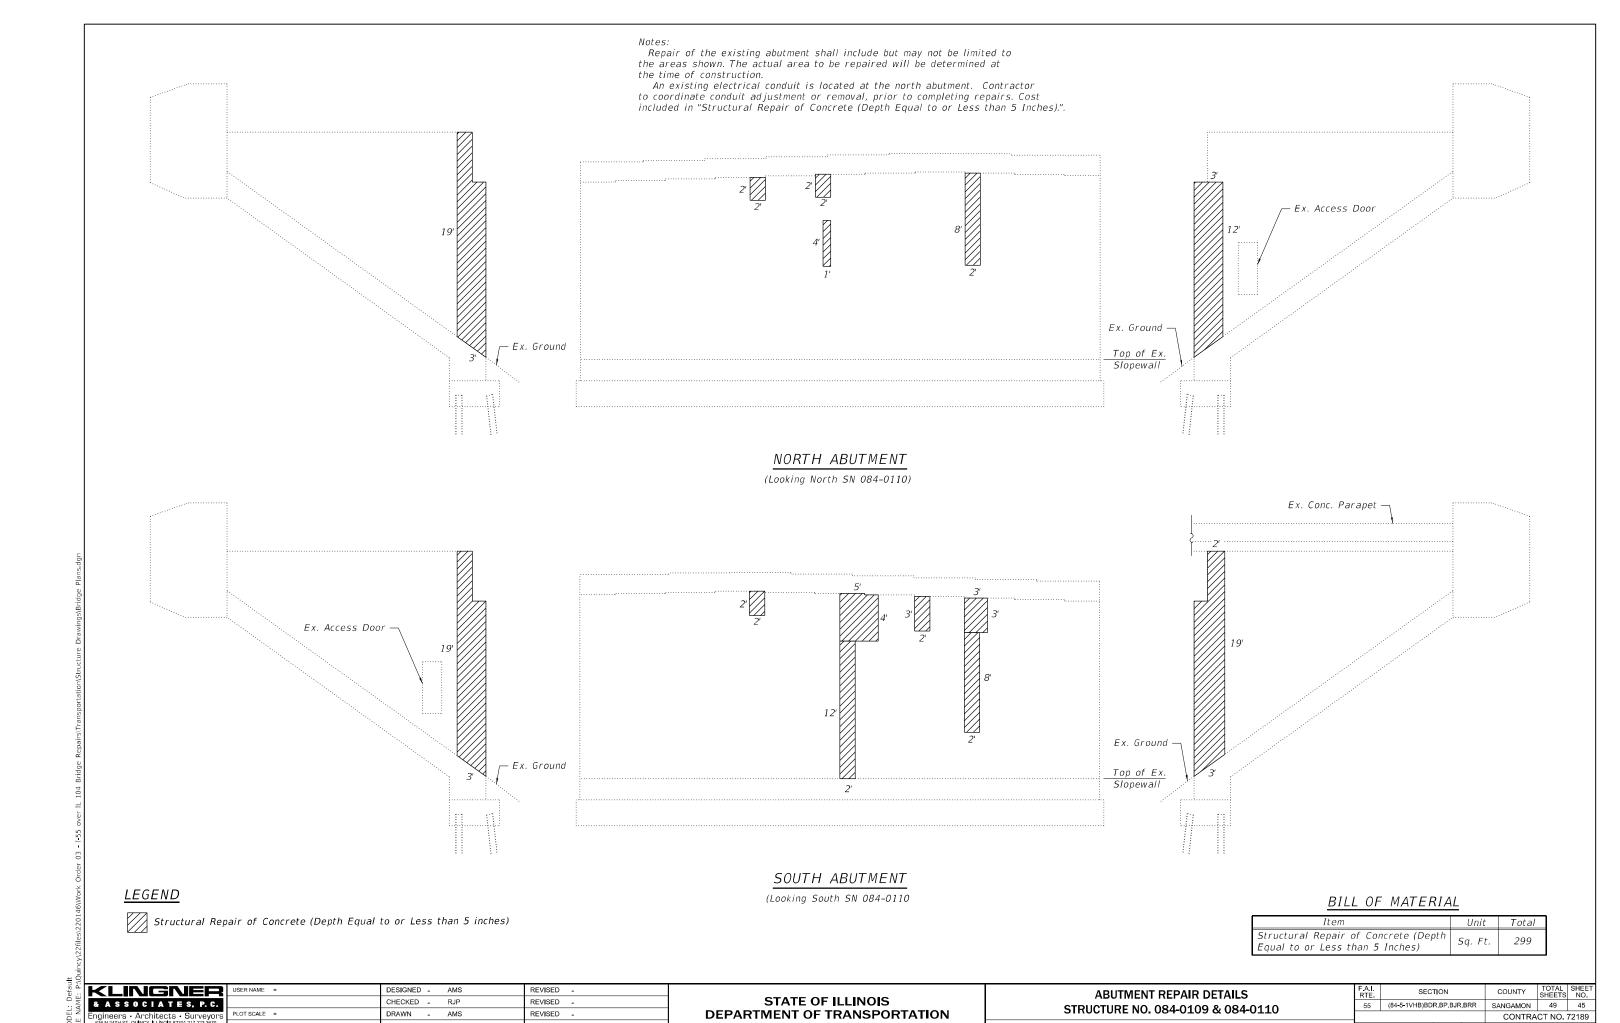

55 (84-5-1VHB)BDR,BP,BJR,BRR SANGAMON 49 45

CONTRACT NO. 72189

STRUCTURE NO. 084-0109 & 084-0110

SHEET 23 OF 27 SHEETS

Engineers • Architects • Surveyors 616 N.24TH ST. OUNCY, ILLINOIS 62301 217.223.3670 STATE OF ILLINOIS DESIGN FIRM NO. 184-2738

CHECKED - RJP

DRAWN - AMS

CHECKED - RJP


REVISED -

REVISED -


REVISED




Structural Repair of Concrete (Depth Equal to or Less than 5 inches)

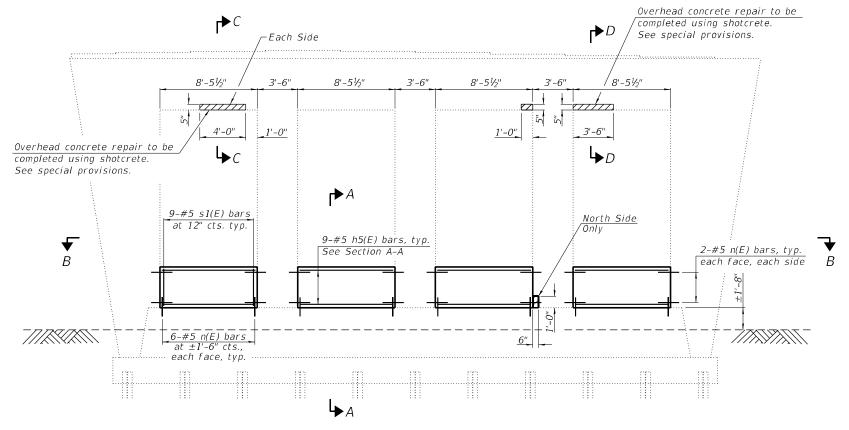




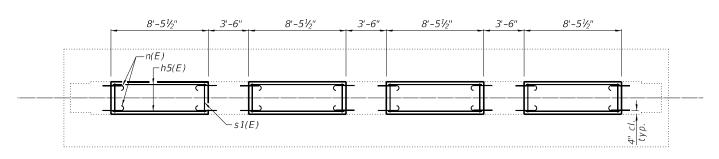


SECTION B-B

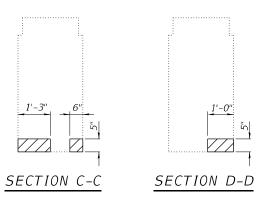

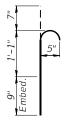

BAR n(E)

Epoxy grout n(E) bars in 9" min. deep holes according to Article 584 of the Standard Specifications Cost included with Reinforcement Bars, Epoxy Coated

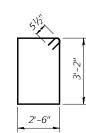

s1(E)

4" cl., typ. —

SECTION A-A

n(E) or h5(E)-

 $BAR \ s1(E)$

BILL OF MATERIAL

Bar	No.	Size	Length	Shape
h5(E)	36	#5	8'-1"	
n(E)	80	#5	2'-5"	
s1(E)	36	#5	12'-3"	
Reinforce Epoxy Coa		Pound	970	
Concrete Structures			Cu. Yd.	12.4
Structural Concrete (to or Less	Depth Ed	Sq. Ft.	11	


& ASSOCIATES, P.C. Engineers • Architects • Surveyor:
616 N.24TH ST. QUINCY, ILLINGIS 62301 217.223.3670
STATE OF ILLINGIS DESIGN FIRM NO. 184-2738


2	USER NAME =	DESIGNED -	AMS	REVISED	-
Ī		CHECKED -	RJP	REVISED	-
s	PLOT SCALE =	DRAWN -	AMS	REVISED	-
	PLOT DATE =	CHECKED -	RJP	REVISED	-

STATE OF ILLINOIS **DEPARTMENT OF TRANSPORTATION**

STRUCT					TAILS 09 & 084-0110
	SHEET	24	OF	27	SHEETS

F.A.I. RTE	SECTION	COUNTY	TOTAL SHEETS	SHEET NO.	
55	(84-5-1VHB)BDR,BP,BJR,BRR	SANGAMON	49	46	
		CONTRA	CT NO.	72189	
ILLINOIS FED. AID PROJECT					

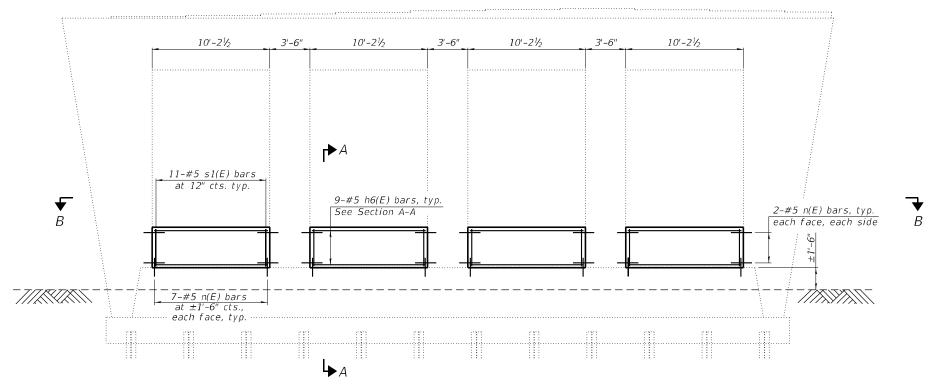


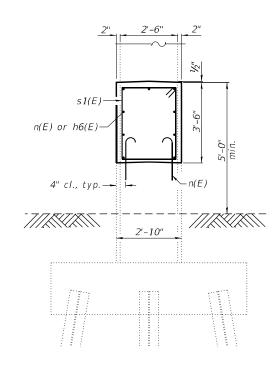


SECTION A-A

PIER ELEVATION

(Looking North SN 084-0110)

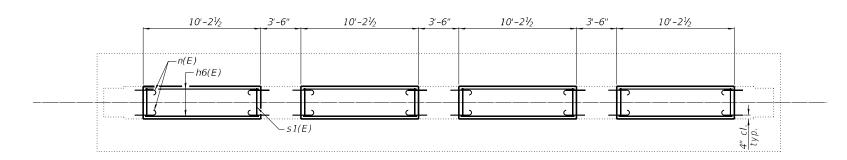


SECTION B-B

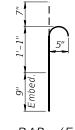

BAR n(E)

Epoxy grout n(E) bars in 9" min. deep holes according to Article 584 of the Standard Specifications Cost included with Reinforcement Bars, Epoxy Coated

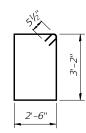

BAR s1(E)

BILL OF MATERIAL

Bar	No.	Size	Length	Shape
h6(E)	36	#5	9'-10"	
n(E)	88	#5	2'-5"	ſ
s1(E)	44	#5	12'-3"	
Reinfoi Epoxy		Bars,	Pound	1,150
Concre	te Stru	ictures	Cu. Yd.	15.0

& ASSOCIATES, P.C. Engineers • Architects • Surveyors 616 N.24TH ST. OUNCY, ILLINOIS 62301 217.223.3670 STATE OF ILLINOIS DESIGN FIRM NO. 184-2738


DESIGNED - AMS REVISED -CHECKED - RJP REVISED -REVISED PLOT DATE = CHECKED - RJP REVISED -

STATE OF ILLINOIS DEPARTMENT OF TRANSPORTATION

PIER REPAIR DETAILS STRUCTURE NO. 084-0109 & 084-0110 SHEET 25 OF 27 SHEETS

KIE. SECTION COUNTY TOTAL SHEETS NO.

55 (84-5-1VHB)BDR,BP,BJR,BRR SANGAMON 49 47

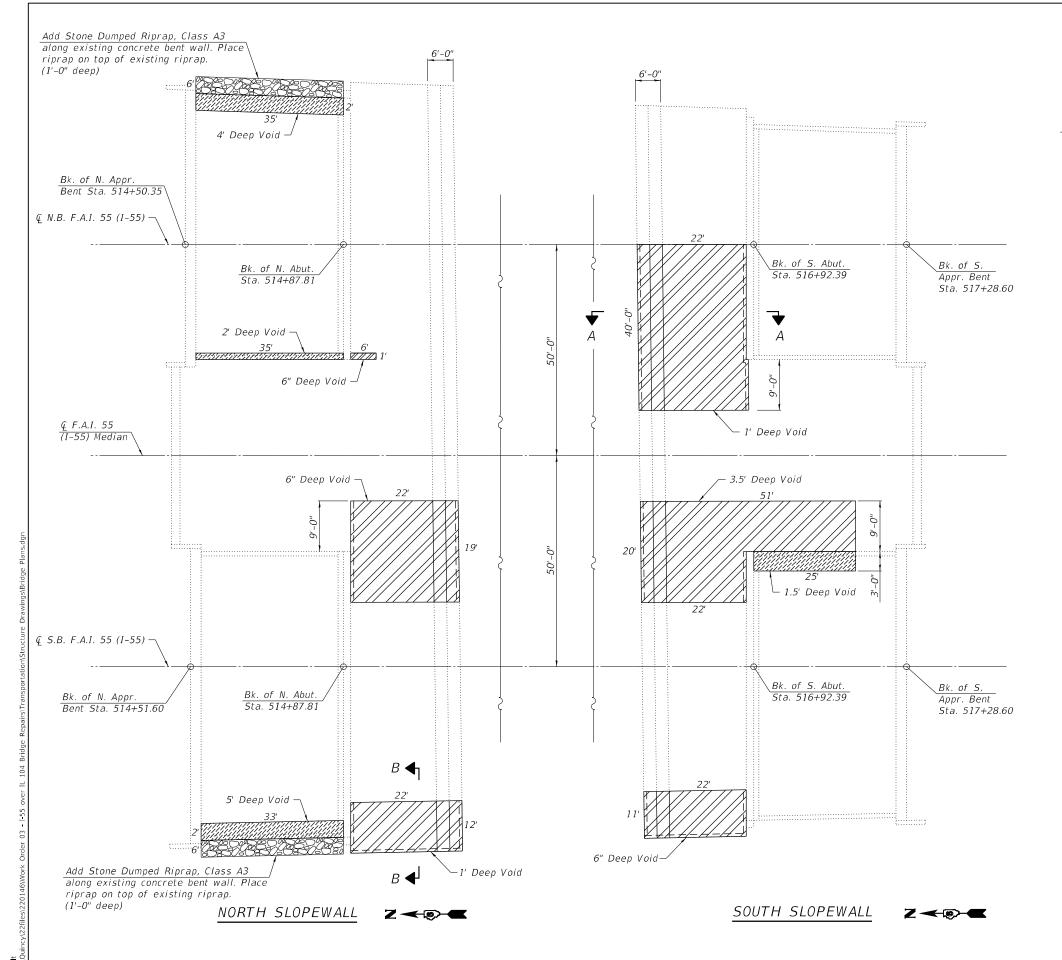


REVISED .


REVISED -

REVISED -

REVISED

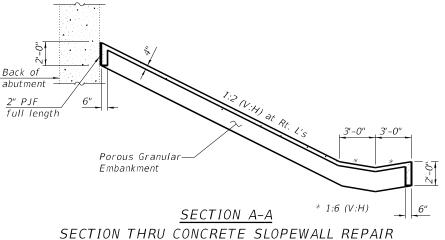

Concrete slope wall shall match Ex. concrete slopewall at Ex. joint

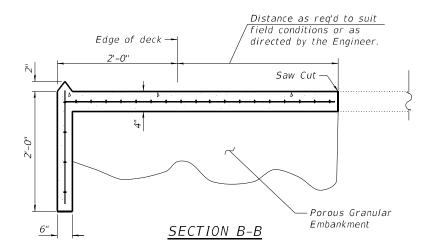

Slopewall shall be reinforced with welded wire fabric, 6" x 6" - W4.0 x W4.0, weighing 58 lbs. per 100 sq. ft. Cost included in "Slopewall Repair". Any voids shall be filled with Porous Granular Embankment prior to replacement of new Slope Wall. For additional information, see Special Provisions.

LEGEND

Slopewall Removal and Slope Wall 4"

Fill Void with Controlled Low Strength Material

BILL OF MATERIAL

	Item	Unit	Total
*	Stone Dumped Riprap, Class A3	Ton	26
	Slopewall Removal	Sq. Yd.	313
	Slope Wall 4 Inch	Sq. Yd.	313
	Controlled Low-Strength Material	Cu. Yd.	50
	Porous Granular Embankment	Ton	295

* Bedding and fabric not required

KLINGNER & ASSOCIATES, P.C. ngineers • Architects • Surveyor 616 N.24TH ST. QUINCY, ILLINOIS 62301 217,223,3670 STATE OF ILLINOIS DESIGN FIRM NO. 184-2738

PLOT DATE =

DESIGNED - AMS CHECKED - RJP DRAWN CHECKED -

STATE OF ILLINOIS **DEPARTMENT OF TRANSPORTATION**

SLOPE WALL REPAIR DETAILS STRUCTURE NO. 084-0109 & 084-0110 SHEET 26 OF 27 SHEETS

SECTION COUNTY (84-5-1VHB)BDR,BP,BJR,BRR SANGAMON 49 48 CONTRACT NO. 72189


STANDARD BAR SPLICER ASSEMBLY PLAN

(All components shall be provided from one supplier)

Threaded splicer bar length = min. lap length + $1\frac{1}{2}$ " + thread length

* Epoxy not required on Bar Splicer Assembly components used in conjunction with black bars.


Location	Bar size	No. assemblies required	Minimum lap length
SN 084-0109 (N. Abut.) - Abutment	#5	7	3'-6"
SN 084-0109 (N. Abut.) - Deck	#5	7	3'-6"
SN 084-0109 (S. Abut.) - Abutment	#5	7	3'-6"
SN 084-0109 (S. Abut.) - Deck	#5	7	3'-6"
SN 084-0110 (N. Abut.) - Abutment	#5	7	3'-6"
SN 084-0110 (N. Abut.) - Deck	#5	7	3'-6"
SN 084-0110 (S. Abut.) - Abutment	#5	7	3'-6"
SN 084-0110 (S. Abut.) - Deck	#5	7	3'-6"

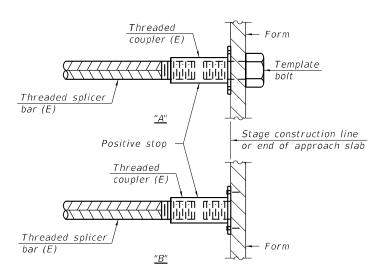

INSTALLATION AND SETTING METHODS

"A": Set bar splicer assembly by means of a template bolt.
"B": Set bar splicer assembly by nailing to wood forms or cementing to steel forms.

(E): Indicates epoxy coating.

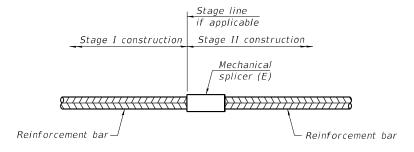

STANDARD MECHANICAL SPLICER

Location	Bar size	No. assemblies required

Notes:

Splicer bars shall be deformed with threaded ends and have a minimum 60 ksi yield strength.

All reinforcement shall be lapped and tied to the splicer bars.

Bar splicer assemblies shall be epoxy coated according to the requirements for reinforcement bars. See Section 508 of the Standard Specifications. See approved list of bar splicer assemblies and mechanical splicers for alternatives.

BSD-1

1-1-2020

ı		
	KLINGNER	USE
	& ASSOCIATES, P.C.	
	Engineers · Architects · Surveyors	PLC
	616 N.24TH ST. QUINCY, ILLINOIS 62301 217 223 3670	PLC

USER NAME =	DESIGNED - AMS	REVISED -
	CHECKED - RJP	REVISED -
PLOT SCALE =	DRAWN - AMS	REVISED -
PLOT DATE =	CHECKED - RJP	REVISED -

2/7/2024 7:47:36 AM