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STATE OF ILLINOIS **DEPARTMENT OF TRANSPORTATION**

COOK 20 1

FOR INDEX OF SHEETS, SEE SHEET NO. 2

DESIGN DESIGNATION: MAJOR COLLECTOR

FAU ROUTE 1281: TECHNY ROAD

2022 ADT: 7,500 VPD

SPEED LIMIT: VARIES 30-35 MPH

IMPROVEMENT LOCATED IN: VILLAGE OF NORTHBROOK

NORTHBROOK MAINTENANCE YARD 1916 TECHNY RD, NORTHBROOK

PROPOSED HIGHWAY PLANS

FAU 1281: TECHNY RD. **NORTHBROOK MAINTENANCE YARD** 1916 TECHNY RD, NORTHBROOK SECTION: 2023 NB012 Lot **PARKING IMPROVEMENT COOK COUNTY**

C-91-172-23

R12E



LOCATION MAP (NOT TO SCALE) NORTHFIELD TOWNSHIP GROSS LENGTH = NA (SPOT IMPROVEMENT) NET LENGTH = N/A (SPOT IMPROVEMENT)





DATE SIGNED: 01-31-24 EXP. DATE: 11-30-25



MAEN A FARHAT, SE IL Lic. No.: 081-008545 Expires: 11/30/2024


D-91-122-23





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REV-SEP

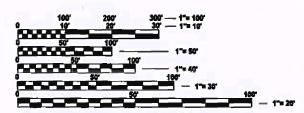

ENGINEERING SCALES. REDUCED SIZED PLANS WILL NOT CONFORM TO STANDARD SCALES, IN MAKING MEASUREMENTS ON REDUCED PLANS, THE ABOVE SCALES MAY BE USED.

JOINT UTILITY LOCATION INFORMATION FOR EXCAVATION 1-800-892-0123 OR 811

PROJECT ENGINEER: MR. RODRIGO LEDEZMA (847) 705-4580 PROJECT MANAGER: MR. J. ALAIN MIDY, PE, (847) 221-3056

CONTRACT NO. 62U87

INDEX OF SHEETS

SHEET NO.	DESCRIPTION
1	COVER SHEET
2	INDEX OF SHEETS, STATE HIGHWAY STANDARDS, AND GENERAL NOTES
3-5	SUMMARY OF QUANTITIES
6	TYPICAL SECTIONS AND DETAILS
7	EXISTING SITE CONDITION AND PROPOSED REMOVAL
8	PROPOSED SITE PLAN
9	PROPOSED PAVEMENT PLAN
10	PROPOSED GRADING PLAN
11	EROSION CONTROL PLAN
12-15	STRUCTURE PLANS
16	BD-01 DRIVEWAY DETAILS - DISTANCE BETWEEN R.O.W. AND FACE OF CURB
	OR EDGE OF SHOULDER GREATER THAN OR EQUAL TO 15' (4.5 M)
17	BD-07 STORM SEWER CONNECTION TO EXISTING SEWER
18	BD-08 FRAMES AND LIDS ADJUSTMENT WITH MILLING
19	TC-10 TRAFFIC CONTROL AND PROTECTION FOR SIDE ROADS, INTERSECTIONS, AND DRIVEWAYS
20	PD-01 PROJECT DETAIL FOR SINGLE PERPENDICULAR CURB RAMPS

LIST OF STATE HIGHWAY STANDARDS

STANDARD NO.	TITLE
000001-08	STANDARD SYMBOLS, ABBREVIATIONS, AND PATTERNS
001006	DECIMAL OF AN INCH AND OF A FOOT
280001-07	TEMPORARY EROSION CONTROL SYSTEMS
602001-02	CATCH BASIN TYPE A
602401-07	PRECAST MANHOLE TYPE A 4' DIAMETER
604001-05	FRAME AND LIDS TYPE 1
530001-13	STEEL PLATE BEAM GUARDRAIL
630006 - 01	NON-BLOCKED STEEL PLATE BEAM GUARDRAIL
664001-02	CHAIN LINK FENCE
701502-09	URBAN LANE CLOSURE, 2L, 2W, WITH BIDIRECTIONAL LEFT TURN LANE
704001-08	TEMPORARY CONCRETE BARRIER

GENERAL NOTES

- 1. ALL CONSTRUCTION SHALL BE DONE IN ACCORDANCE WITH THE STANDARD SPECIFICATIONS FOR ROAD AND BRIDGE CONSTRUCTION ADOPTED JANUARY 1, 2022 HEREIN AFTER REFERRED TO AS THE STANDARD SPECIFICATIONS, THE SUPPLEMENTAL SPECIFICATIONS AND RECURRING SPECIAL PROVISIONS ADOPTED JANUARY 1, 2024, THE LATEST EDITION OF THE ILLINOIS MANUAL ON UNIFORM TRAFFIC CONTROL DEVICES FOR STREETS AND HIGHWAYS, THE DETAILS IN THE PLANS, AND THE SPECIAL PROVISIONS INCLUDED IN THE CONTRACT DOCUMENTS.
- 2. BEFORE STARTING ANY EXCAVATION, THE CONTRACTOR SHALL CALL "J.U.L.I.E." AT (800) 892-0123 OR 811 FOR FIELD LOCATIONS OF BURIED UTILITY FACILITIES. 48 HOUR NOTICE IS REQUIRED.
- 3. THE CONTRACTOR SHALL COORDINATE CONSTRUCTION ACTIVITIES WITH UTILITY COMPANIES, COOK COUNTY, AND THE VILLAGE OF NORTHBROOK.
- 4. THE CONTRACTOR WILL NOT BE ALLOWED TO SET UP A YARD OR FIELD OFFICE ON STATE PROPERTY WITHOUT WRITTEN PERMISSION FROM THE DEPARTMENT.
- 5. IT SHALL BE THE CONTRACTOR'S RESPONSIBILITY TO VERIFY ALL DIMENSIONS AND CONDITIONS EXISTING IN THE FIELD PRIOR TO CONSTRUCTION AND ORDERING OF MATERIALS.
- 6. FRAMES AND GRATES ADJUSTMENT OF PRIVATE UTILITIES WITHIN THE LIMITS OF THE IMPROVEMENTS SHALL BE DONE BY THEIR RESPECTIVE OWNERS AND ARE NOT PART OF THIS CONTRACT.
- 7. THE CONTACT FOR THIS MAINTENANCE YARD IS MORGAN ROSHAN. THEY CAN BE REACHED AT ROSHAN.MORGAN@ILLINOIS.GOV
- 8. DO NOT SCALE PLANS FOR CONSTRUCTION DIMENSIONS.
- 9. THE CONTRACTOR SHALL BE REQUIRED TO PROVIDE ACCESS TO ABUTTING PROPERTY AT ALL TIMES DURING THE CONSTRUCTION OF THE PROJECT.
- 10. EXISTING BROKEN FRAMES AND LIDS SHALL BE REMOVED AND DISPOSED OF BY THE CONTRACTOR AND SHALLBE REPLACED AS DIRECTED BY THE ENGINEER. REPLACEMENT FRAMES AND LIDS WILL BE PAID FOR ACCORDING TO ARTICLE 109.04 OF THE STANDARD SPECIFICATIONS, UNLESS A SEPARATE PAY ITEM HAS BEEN PROVIDED.
- 11. THE CONTRACTOR SHALL USE CARE IN GRADING OR EXCAVATING NEAR ANY AND ALL EXISTING ITEMS THAT WILL NOT BE REMOVED INCLUDING PREVIOUSLY SEEDED AREAS. ANY DAMAGE DONE TO EXISTING ITEMS BY THE CONTRACTOR SHALL BE REPAIRED AT THE CONTRACTOR'S OWN EXPENSE TO THE SATISFACTION OF THE ENGINEER.
- 12. ANY LOOSE MATERIAL DEPOSITED IN THE FLOW LINE OF DRAINAGE STRUCTURES WHICH OBSTRUCTS THE NATURAL FLOW OF WATER SHALL BE REMOVED AT THE CLOSE OF EACH WORKING DAY. PRIOR TO ACCEPTANCE OF THE IMPROVEMENT, ALL DRAINAGE STRUCTURES SHALL BE FREE OF DIRT AND DEBRIS. THIS WORK WILL NOT BE PAID FOR SEPARATELY, BUT SHALL BE CONSIDERED AS INCLUDED IN THE UNIT BID PRICES OF THE CONTRACT.
- 13. CONTRACTOR SHALL VERIFY EXISTING PIPE SLOPE AND CONSTRUCT NEW PIPE SEGMENTS ACCORDINGLY. COST OF FITTINGS & ADAPTERS, AND ANY INCIDENTALS FOR COMPLETE CONSTRUCTION SHALL BE INCLUDED IN THE PRICE BID FOR OTHER ITEMS OF WORK, ALL ANNULAR SPACES IN STRUCTURES SHALL BE FILLED WITH NON-SHRINK GROUT.
- 14. TRENCH BACKFILL UNDER PAVEMENT IN SECTION A SHALL INCLUDE SUBGRADE PREPARARTION MEETING THE COMPACTION AND STABILITY REQUIREMENTS OF SECTION 301 OF STANDARD SPECIFICATIONS FOR ROAD AND BRIDGE CONSTRUCTION. COST FOR THIS WORK SHALL BE INCLUDED IN THE PRICE BID FOR TRENCH BACKFILL.
- 15. CONTRACTOR SHALL VERIFY PIPE SIZE BEFORE ORDERING PIPE MATERIALS.
- 16. THE SUBGRADE STABILITY SHALL BE VERIFIED BY PROOF ROLLING WITH A LOADED TANDEM-AXLE TRUCK.
- 17. GEOTECHNICAL FABRIC FOR GROUND STABILIZATION AND/OR AGGREGATE SUBGRADE IMPROVEMENT (CU YD) HAVE BEEN PROVIDED FOR USE AT THE LOCATIONS INDICATED FOR SOILS THAT TEND TO BE UNSTABLE AND/OR UNSUITABLE. THE ACTUAL NEED FOR REMOVAL AND REPLACEMENT WITH ABOVE ITEM WILL BE DETERMINED IN THE FIELD AT THE TIME OF CONSTRUCTION BY THE GEOTECHNICAL ENGINEER. ALL POTENTIALLY UNSTABLE SOILS SHOULD BE TESTED WITH A STATIC OR DYNAMIC CONE PENETROMETER AND TREATED IN ACCORDANCE WITH ARTICLE 301.04 OF THE SSRBC AND IDOT SUBGRADE STABILITY MANUAL. IF UNSTABLE AND/OR UNSUITABLE SOILS ARE NOT ENCOUNTERED, THEN THE QUANTITY SHALL BE DEDUCTED AND NO ADDITIONAL COMPENSATION WILL BE DUE TO THE CONTRACTOR.

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USER NAME = akoller	DESIGNED -	DC/MMA	REVISED -
	DRAWN -	AK/MMA	REVISED -
PLOT SCALE = 100.0000 ' / in.	CHECKED -	DC	REVISED -
PLOT DATE = 2/27/2024	DATE -	02/08/2024	REVISED -

STATE OF ILLINOIS
DEPARTMENT OF TRANSPORTATION

I	INDEX OF SHE	ETS, STA	TE HIGH	NAY STA	NDARD		F.A.U. RTE.	SECTION	COUNTY	TOTAL SHEETS	SHEET NO.
I		NODT	UDDOOK	MAINTE	NANCE	VADD	1281	202 NB012 LOT	соок	20	2
ļ		NUNI	HDNUUK	IVIAIIVIE			CONTRACT	NO. 6	2U87		
I	SCALE: NONE	SHEET	OF	SHEETS	STA.	TO STA.		ILLINOIS FED. AI	D PROJECT		

CONSTR. CODE 100% STATE

				NONE
CODE			TOTAL	0044
NO.	ITEM	UNIT	QUANTITY	URBAN
20200100	EARTH EXCAVATION	CU YD	3099	3099
20800150	TRENCH BACKFILL	CU YD	43	43
21001000	GEOTECHNICAL FABRIC FOR GROUND STABILIZATION	SQ YD	622	622
21101615	TOPSOIL FURNISH AND PLACE, 4"	SQ YD	374	374
25200110	SODDING, SALT TOLERANT	SQ YD	374	374
25200200	SUPPLEMENTAL WATERING	UNIT	6	6
28000250	TEMPORARY EROSION CONTROL SEEDING	POUND	7	7
28000400	PERIMETER EROSION BARRIER	FOOT	2585	2585
28000510	INLET FILTERS	EACH	11	11
28001100	TEMPORARY EROSION CONTROL BLANKET	SQ YD	303	303
30300001	AGGREGATE SUBGRADE IMPROVEMENT	CU YD	207	207
31101400	SUBBASE GRANULAR MATERIAL, TYPE B 6"	SQ YD	12430	12430
40600275	BITUMINOUS MATERIALS (PRIME COAT)	POUND	27453	27453
40600290	BITUMINOUS MATERIALS (TACK COAT)	POUND	3797	3797

* SPECIALTY ITEMS

CONSTR. CODE 100% STATE

				NONE				
CODE			TOTAL	0044				
NO.	ITEM	UNIT	QUANTITY	URBAN				
40603085	HOT-MIX ASPHALT BINDER COURSE, IL-19.0, N70	TON	2305	2305				
40604062	HOT-MIX ASPHALT SURFACE COURSE, IL-9.5, MIX "D",	TON	1156	1156				
	1070							
42001300	PROTECTIVE COAT	SQ YD	320	320				
42400200	PORTLAND CEMENT CONCRETE SIDEWALK 5 INCH	SQ FT	225	225				
42400800	DETECTABLE WARNINGS	SQ FT	20	20				
44000100	PAVEMENT REMOVAL	SQ YD	4210	4210				
44000164	HOT-MIX ASPHALT SURFACE REMOVAL, 3 3/4"	SQ YD	1558	1558				
44000300	CURB REMOVAL	FOOT	32	32				
44000600	SIDEWALK REMOVAL	SQ FT	225	225				
44001980	CONCRETE BARRIER REMOVAL	FOOT	97	97				
44201335	CLASS C PATCHES, TYPE IV, 8 INCH	SQ YD	288	288				
44201737	CLASS D PATCHES, TYPE I, 8 INCH	SQ YD	344	344				
44201741	CLASS D PATCHES, TYPE II, 8 INCH	SQ YD	344	344				
44201745	CLASS D PATCHES, TYPE III, 8 INCH	SQ YD	344	344				
	I	1	<u> </u>					

* SPECIALTY ITEMS



USER NAME = jschumann	DESIGNED	-	DC/AK/MMA	REVISED -
	DRAWN	-	DC/AK/MMA	REVISED -
PLOT SCALE = 100.0000 ' / in.	CHECKED	-	DC	REVISED -
PLOT DATE = 2/9/2024	DATE	-	02/08/2024	REVISED -

STATE OF ILLINOIS DEPARTMENT OF TRANSPORTATION

SUMMARY OF QUANTITIES									SECTION	COUNTY	COUNTY TOTAL SHEETS	
NORTHBROOK MAINTENANCE YARD								1281	202 NB012 LOT	соок	20	3
	INUI	піпі	onuu	ו אינ	VIAINTE	VANCE	TAND			CONTRACT	NO. 6	2U87
SCALE: NONE SHEET 1 OF 3 SHEETS STA. TO STA.							(ILLINOIS (FED. A	ID PROJECT				

COUNTY TOTAL SHEET NO.

COOK 20 3

CODE			TOTAL	NONE 0044
NO.	ITEM	UNIT	QUANTITY	URBAN
44201747	CLASS D. DATGUES, TVDS IV	50 VD	244	2.4.4
44201747	CLASS D PATCHES, TYPE IV, 8 INCH	SQ YD	344	344
50200100	STRUCTURE EXCAVATION	CU YD	86	86
30200100	STRUCTURE EXCAVATION	CO ID	80	
50300225	CONCRETE STRUCTURES	CU YD	1	1
50800205	REINFORCEMENT BARS, EPOXY COATED	POUND	3440	3440
52200900	CONCRETE STRUCTURES (RETAINING WALL)	CU YD	23	23
55040300	STORM STUERS CLASS A TYPE 2 10 II	FOOT	22	
550A0380	STORM SEWERS, CLASS A, TYPE 2 18"	FOOT	33	33
55100900	STORM SEWER REMOVAL 18"	FOOT	33	33
58600101	GRANULAR BACKFILL FOR STRUCTURES	CU YD	13	13
58700300	CONCRETE SEALER	SQ FT	2897	2897
59100100	GEOCOMPOSITE WALL DRAIN	SQ YD	15	15
60200105	CATCH BASINS, TYPE A, 4'-DIAMETER, TYPE 1 FRAME, OPEN LID	EACH	1	1
	ANNUAL SC. TVDS A. A.I. DIAMSTED. TVDS A SDAMS			
60218400	MANHOLES, TYPE A, 4'-DIAMETER, TYPE 1 FRAME, CLOSED LID	EACH	1	1
60250200	CATCH BASINS TO BE ADJUSTED	EACH	5	5
60250400	CATCH BASINS TO BE ADJUSTED WITH NEW TYPE 1 FRAME, OPEN LID	EACH	5	5

* SPECIALTY ITEMS

CONSTR. CODE

	CODE NO.	ITEM	UNİT	TOTAL QUANTITY	NONE 0044 URBAN
	60252800	CATCH BASINS TO BE RECONSTRUCTED	EACH	1	1
ĺ					
	60255410	CATCH BASINS TO BE CLEANED	EACH	6	6
	60500105	FILLING MANHOLES	EACH	1	1
	63000001	STEEL PLATE BEAM GUARDRAIL, TYPE A, 6 FOOT POSTS	FOOT	46	46
	63200310	GUARDRAIL REMOVAL	FOOT	26	26
	66400305	CHAIN LINK FENCE, 6'	FOOT	674	674
	66900200	NON-SPECIAL WASTE DISPOSAL	CU YD	0	
	66900530	SOIL DISPOSAL ANALYSIS	EACH	0	
	66901001	REGULATED SUBSTANCES PRE-CONSTRUCTION PLAN	L SUM	0	
	66901003	REGULATED SUBSTANCES FINAL CONSTRUCTION REPORT	L SUM	0	
	66901006	REGULATED SUBSTANCES MONITORING	CAL DA	0	
	67100100	MOBILIZATION	L SUM	1	1
	70102622	TRAFFIC CONTROL AND PROTECTION, STANDARD 701502	L SUM	1	1
	70400100	TEMPORARY CONCRETE BARRIER	FOOT	75	75
	70400125	PINNING TEMPORARY CONCRETE BARRIER	EACH	36	36
	78000100	THERMOPLASTIC PAVEMENT MARKING - LETTERS AND SYMBOLS	SQ FT	6	6

* SPECIALTY ITEMS



USER NAME =	= jschumann	DESIGNED	-	DC/AK/MMA	REVISED	-
		DRAWN	-	DC/AK/MMA	REVISED	=
PLOT SCALE =	= 100.0000 ' / in.	CHECKED	-	DC	REVISED	-
PLOT DATE =	= 2/9/2024	DATE	-	02/08/2024	REVISED	-

	SUMMARY OF QUANTITIES	F,A.U. RTE.	SECTION		COUNTY	TOTAL SHEETS	
	NORTHBROOK MAINTENANCE YARD	1281	202 NB012 LOT		соок	20	4
	NONTHDROOK WAINTENANCE TAND	_			CONTRAC	T NO. 6	2U87
SCALE: NONE	SHEET 2 OF 3 SHEETS STA. TO STA.		(ILLINOIS (FED. AID	PROJECT		

CONSTR. CODE

	CODE NO.	ITEM	UNİT	TOTAL QUANTITY	NONE 0044 URBAN
*	78000200	THERMOPLASTIC PAVEMENT MARKING - LINE 4"	FOOT	945	945
	X0300019	REMOVE AND REINSTALL PARKING BLOCKS	EACH	11	11
	X0301339	REMOVE EXISTING PARKING BLOCKS	EACH	24	24
	X0301430	PRECAST CONCRETE PARKING BLOCK	EACH	24	24
	X6026050	SANITARY MANHOLES TO BE ADJUSTED	EACH	2	2
	X6640302	CHAIN LINK FENCE REMOVAL (SPECIAL)	FOOT	674	674
	X6700407	ENGINEER'S FIELD OFFICE, TYPE A (D1)	CAL MO	12	12
	Z0012754	STRUCTURAL REPAIR OF CONCRETE (DEPTH EQUAL TO OR LESS THAN 5 INCHES)	SQ FT	116	116
	Z0013798	CONSTRUCTION LAYOUT	L SUM	1	1

* SPECIALTY ITEMS


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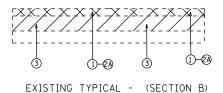
USER NAME = jschumann	DESIGNED	-	DC/AK/MMA	REVISED -
	DRAWN	-	DC/AK/MMA	REVISED -
PLOT SCALE = 100.0000 ' / in.	CHECKED	-	DC	REVISED -
PLOT DATE = 2/9/2024	DATE	-	02/08/2024	REVISED -


STATE OF ILLINOIS DEPARTMENT OF TRANSPORTATION

SU				TOTAL SHEETS				
NODTU	NORTHBROOK MAINTENANCE YARD						20	5
NONTHE	DRUUK IVIA			CONTRACT	NO. 62	2U87		
SCALE: NONE SHEET 3	OF 3 S	EETS STA.	TO STA.		ILLINOIS FED. A	ID PROJECT		


NORTHBROOK MAINTENANCE YARD




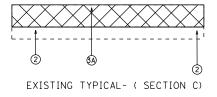


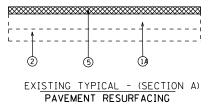


NORTHBROOK MAINTENANCE YARD

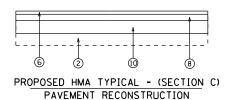

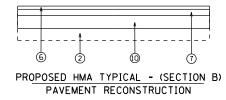

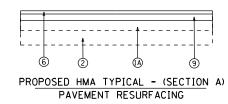

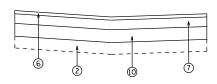

PROPOSED HMA TYPICAL - (SECTION A-A)

PAVEMENT RECONSTRUCTION

SEE SHEET 9 FOR SECTION

(1) EXISTING HMA PAVEMENT 6"±

① EXISTING HMA PAVEMENT 4¾"±

LEGEND

- Constitute that the contract of
- ② EXISTING SUBGRADE
- PROPOSED PAVEMENT REMOVAL
- 3 PROPOSED SUBGRADE REMOVAL (EARTH EXCAVATION)- 6"
- A PROPOSED SUBGRADE REMOVAL (EARTH EXCAVATION)- 10½"
- (5) PROPOSED HMA SURFACE REMOVAL, 3¾"
- § PROPOSED HOT-MIX ASPHALT SURFACE COURSE, IL-9.5, MIX "D", N70, $1\frac{1}{2}$ "
- PROPOSED HOT-MIX ASPHALT BINDER COURSE, IL-19.0, N70, 3½"
- 8 PROPOSED HOT-MIX ASPHALT BINDER COURSE, IL-19.0, N70, 3"
- 9 PROPOSED HOT-MIX ASPHALT BINDER COURSE, IL-19.0, N70, 2¼"
- PROPOSED SUBBASE GRANULAR MATERIAL TYPE B, 6"

NOTES

PROPOSED HMA LOCATIONS AND PCC SECTIONS DO NOT HAVE THE SAME TOTAL DEPTH OF EXCAVATION. PLEASE BE AWARE OF ELEVATIONS WHILE EXCAVATING.

HOT-MIX ASPHALT MIXTURE REQUIREMENTS	QUALITY MANAGEMENT	
MIXTURE TYPE	AIR VOIDS(%) © N _{DES} .	PROGRAM (QMP)
PAVEMENT RECONSTRUCTION		
HOT-MIX ASPHALT SURFACE COURSE, IL-9.5, MIX "D", N70, 11/2"	4% @ 70 GYR	QC/QA
HOT-MIX ASPHALT BINDER COURSE, IL-19.0, N70, 31/4"	4% @ 70 GYR	QC/QA
HOT-MIX ASPHALT BINDER COURSE, IL-19.0, N70, 3"	4% @ 70 GYR	QC/QA
PAVEMENT RESURFACING		
HOT-MIX ASPHALT SURFACE COURSE, IL-9.5, MIX "D", N70, 11/2"	4% © 70 GYR	QC/QA
HOT-MIX ASPHALT BINDER COURSE, IL-19.0, N70, 2 1/4"	4% @ 70 GYR	QC/QA
CLASS D PATCHES, TYPE I, II, III		
HOT-MIX ASPHALT BINDER COURSE, IL-19.0, N70, 8"	4% @ 70 GYR	QC/QA
OMP DESIGNATION: QUALITY CONTROL/QUALITY ASSURANCE(QA/QC); QUALITY CONTROL PAY FOR PERFORMANCE(PFP)	FOR PERFORMANO	CE(QCP);

THE UNIT WEIGHT USED TO CALCULATE ALL HMA SURFACE MIXTURE QUANTITIES IS 112 LBS/SQ YD/IN.


THE "AC TYPE" FOR POLYMERIZED HMA MIXES SHALL BE "SBS/SBR PG 76-22" AND FOR NON-POLYMERIZED HMA THE "AC TYPE" SHALL BE "PG 64-22" UNLESS MODIFIED BY RECLAIMED MATERIALS SPECIFICATIONS.

SCALE: NONE

USER NAME = jdavis	DESIGNED	-	MMA	REVISED -
	DRAWN	-	MMA	REVISED -
PLOT SCALE = 0.200000 / in	CHECKED	-	DC	REVISED -
PLOT DATE = 2/9/2024	DATE	-	02/08/2024	REVISED -

TY	PIC/	AL S	ECT	IONS A	ND DETA	AILS	F.A.U. RTE	SECTION	COUNTY	TOTAL SHEETS	SHEET NO.
NO	NORTHBROOK MAINTENANCE YARD					/ADD	1281	202 NB012 LOT	COOK	20	6
NU						IAND			CONTRACT NO. 62U87		
SHEET 1 OF 1 SHEETS STA.				STA.	TO STA.		ILLINOIS FED. A	D PROJECT			



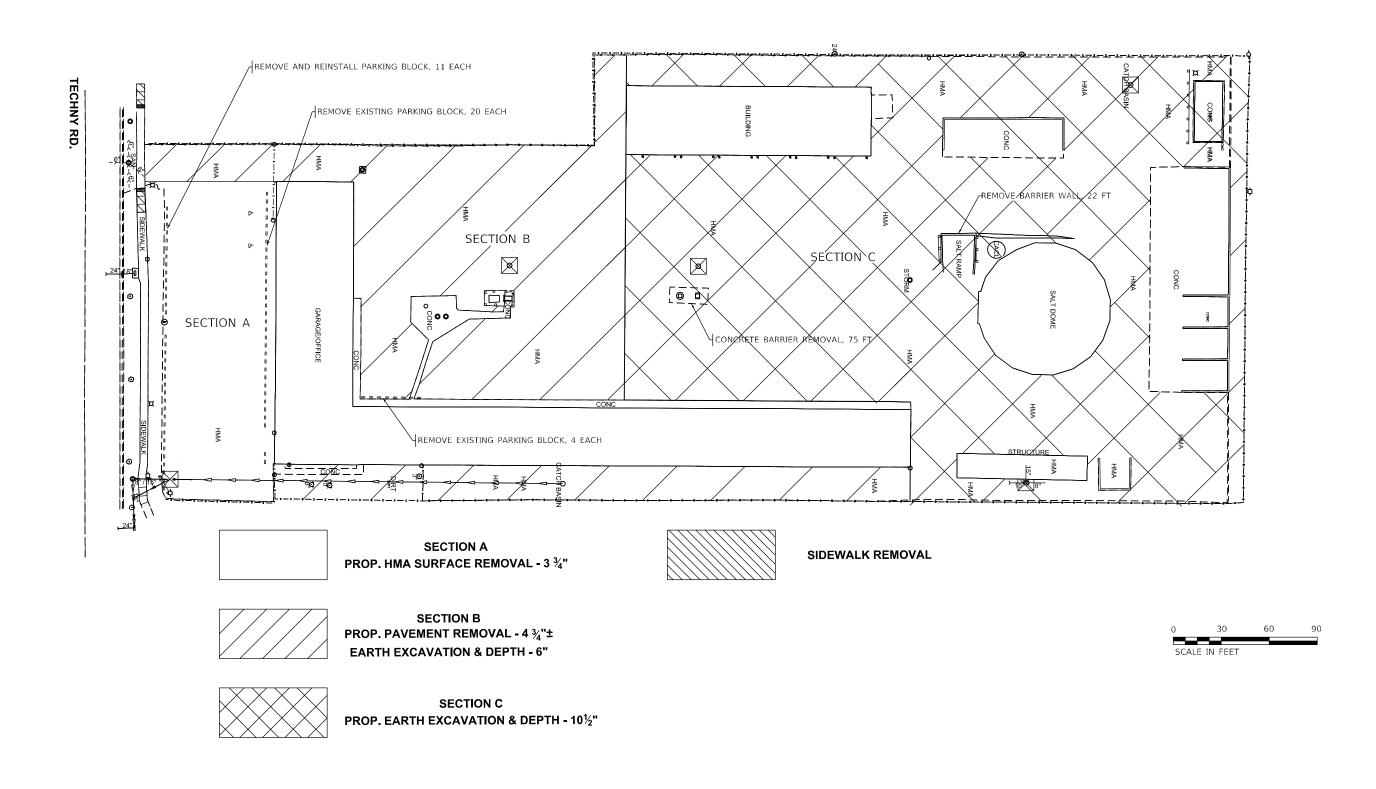


A c c u r a t e

STATE OF ILLINOIS DEPARTMENT OF TRANSPORTATION

 EXISTING
 SITE
 CONDITION
 AND
 PROPOSED
 REMOVAL
 F.A.U. RTE.
 SECT

 NORTHBROOK
 MAINTENANCE YARD
 1281
 202 NBC

 SCALE: 1"=30'
 SHEET
 1
 OF
 5
 SHEETS
 STA.
 TO STA.
 TO STA.

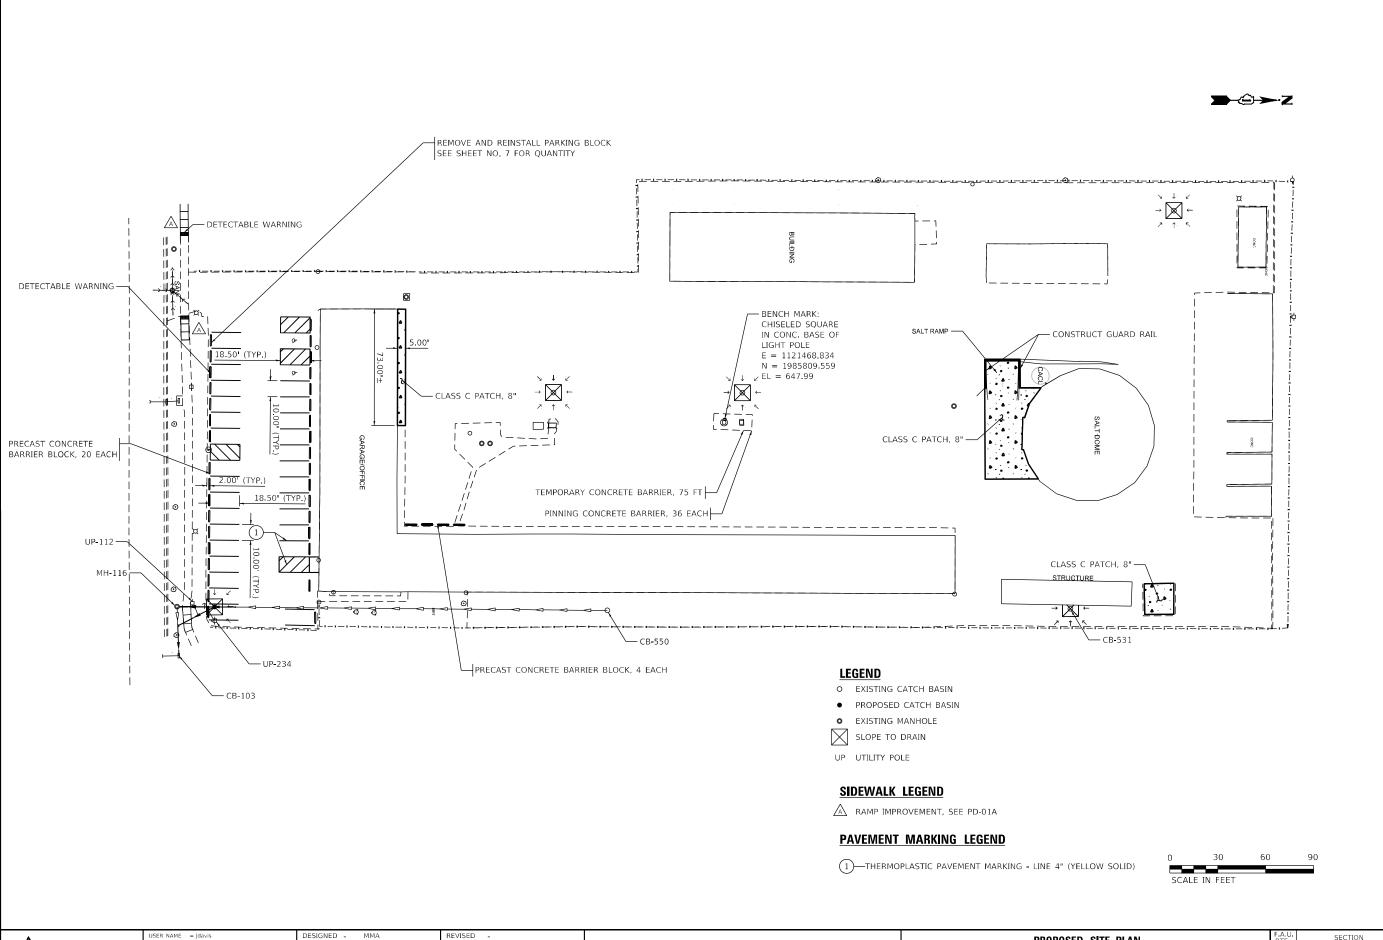

Ccurate

DRAWN -MMA REVISED -REVISED -

STATE OF ILLINOIS **DEPARTMENT OF TRANSPORTATION**

PROPOSED SITE PLAN NORTHBROOK MAINTENANCE YARD SHEET 2 OF 5 SHEETS STA.

SCALE: 1"=30'

COUNTY FOTAL SHEETS NO.
COOK 20 8 SECTION 202 NB012 LOT

CONTRACT NO. 62U87

→ PROP. HMA SURFACE COURSE MIX "D", N70, IL-9.5 MM,1½" PROP. HMA BINDER COURSE, IL-19.0, N70, 3" PROP. SUBBASE GRANULAR MATERIAL, TYPE B, 6" PROP. HMA SURFACE COURSE MIX "D", N70, IL-9.5 MM,1½" PROP. HMA BINDER COURSE, IL-19.0, N70,2¼" © **□** SECTION A 00 || ⊚ | [|] iii | ال ال — CLASS D PATCH, ||₀ - EEEE 0 0 REMOVE AND REPLACE FENCE (6 FEET HIGH) PER IDOT STD. 664001-02 PROP. HMA SURFACE COURSE MIX "D", N70, IL-9.5 MM,1½" PROP. HMA BINDER COURSE, IL-19.0, N70, 3"
PROP. SUBBASE GRANULAR MATERIAL, TYPE B, 6" SECTION A CLASS C PATCHES, TYPE IV, 8 INCH PROP. HMA PAVEMENT RESURFACING PROP. HMA SURFACE COURSE MIX "D", N70, IL-9.5 MM, 1½" PROP. HMA BINDER COURSE, IL-19.0, N70, 3" PROP. SUBBASE GRANULAR MATERIAL, TYPE B, 6" SECTION B PROP. HMA PAVEMENT RECONSTRUCTION SECTION C PROP. HMA PAVEMENT RECONSTRUCTION

A c c u r a t e

 USER NAME
 = malkufahy
 DESIGNED
 MMA
 REVISED

 PLOT SCALE
 = 60,0000 / in.
 CHECKED
 DC
 REVISED

 PLOT DATE
 = 2/8/2024
 DATE
 02/08/2024
 REVISED

STATE OF ILLINOIS DEPARTMENT OF TRANSPORTATION PROPOSED PAVEMENT PLAN


NORTHBROOK MAINTENANCE YARD

SCALE: 1"=30' SHEET 3 OF 5 SHEETS STA. TO STA.

→②→ Z — SEE TYPICAL SECTION, SHEET 6 (648.66) 648.70 (648.80) 648.82 (648.66) (648.66) (649.00) (648.77) (649.10) (648.45) ⊕ 648.42 ⊕ ←0.11%± ⊕648.48 → (647.90) 647.57 (648.42) (648.46) $\bigoplus -\bigoplus$ (648.49) (648.35) ► > 648.40 648.47 (648.41) (648.29) (648.54) ⊕ − ⊕ (648.34) ⊕ (648.46) (648.43) 648.50 (647.51) (647.20) (647.28) (647.28) (647.20) (647.28) (648.22) (647.87) (648.46) (647.82) (647.85) (648.12)(6<u>48.19)</u> ① (647.90) 647.90 - BENCH MARK: **⊕** 648.29 ⊕ 648,46 CHISELED SQUARE IN CONC. BASE OF (647.75) 647.62 648.04 LIGHT POLE E = 1121468.834RIM EL.=EX. 647.18 N = 1985809.559 EL = 647.99 (646.87) 646.54 PROP. 646.84 MH-513 — (648.18) 😝 648.09 F UNKNOWN RIM EL. 647.34 F_ UNKNOWN **(h**) 648.09 24"||18"| (647.25) (647.41) **(648.29)** (648.47) (648.22) RIM EL.-EX. 646.87 PROP. 646.54 FL UNKNOWN UP-112 -ABANDON 18" RCP ↓0.5%± (648.04) **(**648.09) (648.31) FILL EX MH-116 RIM EL. 646.03 $\begin{array}{c}
(648.02) \\
- \bigoplus \bigoplus (647.86) \\
(647.99)
\end{array}$ (647.97) (648.00) - — — — — — — — — — $- \oplus^{(648.09)} \oplus^{(648.04)} - \oplus^{(648.06)} - \cdots$ (648.06) (648.07) - + - - - + - -F_ (N) 641.53 (648.36) ቪ (E) 641.43 648.06 (648.61) (648.08)(648.15) (647.92) MANHOLE TYPE A -STRUCTURE (648.06) ↓ 646.20 (648.04)h(648.08) 4¹ DIA, TYPE I CLOSED LID RIM EL. 645.00 F_ (N) 641.01 F_ (E) 641.01 (647.26) 647.77 - CB-550 RIM EL. 647.58 (648.62) (SEE SHEET 2, NOTE 13) RIM EL. 647.37 F_ UNKNOWN FL (S) UNKNOWN -18" RCP, 12 LF **LEGEND** 18" RCP, 19 LF (SEE SHEET 2, SEE NOTES 14 & 15) EXISTING 18"/15" STORM PIPE O EXISTING CATCH BASIN PROPOSED CATCH BASIN CATCH BASIN TYPE A RIM EL. 646.20 4" TREE EXISTING MANHOLE FL (N) 641.60 SLOPE TO DRAIN (SEE SHEET 2, NOTE 13) ● (*** **) EXISTING EL. PROPOSED EL. EX CB-103 -- UP-234 RIM EL= 644.06 UP UTILITY POLE F_ (W)= 640.30 FL (S)= 639.36 — 18" RCP, 26 LF SCALE IN FEET DESIGNED -SECTION PROPOSED GRADING PLAN DRAWN -STATE OF ILLINOIS MMA REVISED ccurate 202 NB012 LOT COOK 20 10 NORTHBROOK MAINTENANCE YARD REVISED **DEPARTMENT OF TRANSPORTATION** CONTRACT NO. 62U87

SHEET 4 OF 5 SHEETS STA.



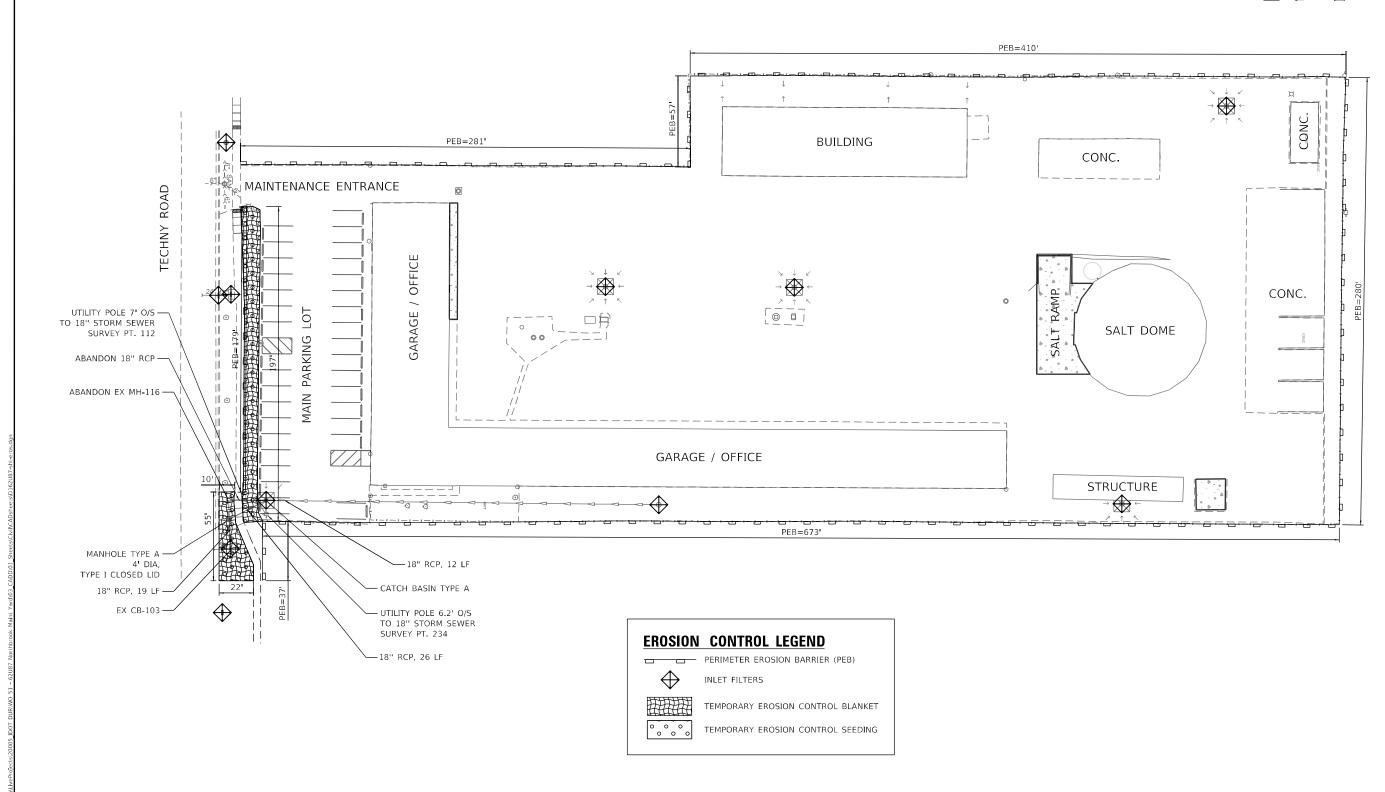

A c c u r a t e

 USER NAME
 = malkufahy
 DESIGNED
 JS
 REVISED


 PLOT SCALE
 = 60,0000 ' / in.
 CHECKED
 DC
 REVISED


 PLOT DATE
 = 2/8/2024
 DATE
 02/08/2024
 REVISED

STATE OF ILLINOIS DEPARTMENT OF TRANSPORTATION EROSION CONTROL PLAN
NORTHBROOK MAINTENANCE YARD

SHEET 5 OF 5 SHEETS STA

SCALE: 1"=30" SHEET 5 OF 5 SHEETS STA. TO STA. | ILLINOIS FED. AID PROJECT

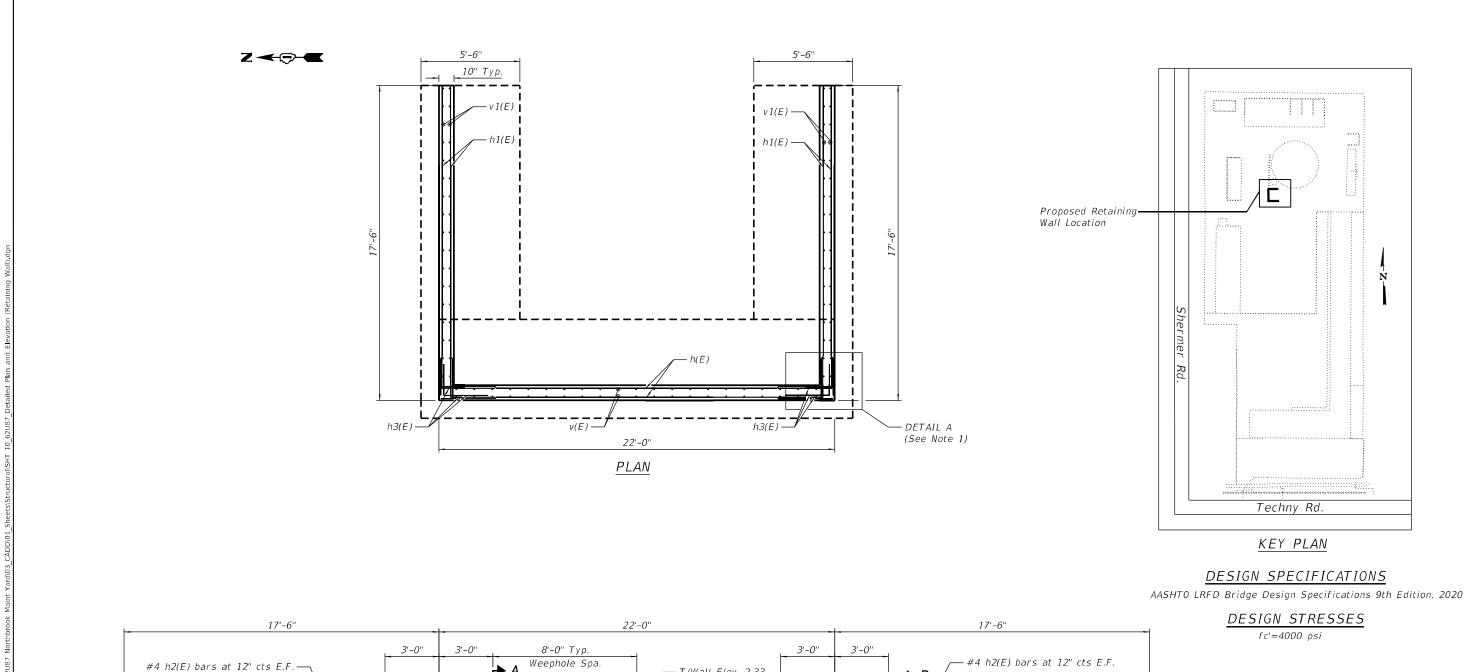

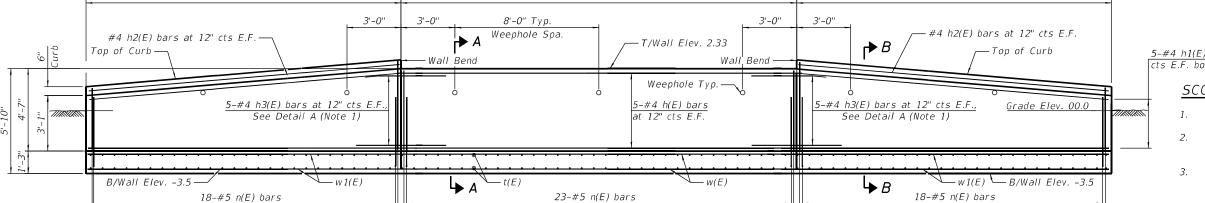

DEVELOPED ELEVATION

at 12" cts E.F.

23-#5 v(E) bars

at 12" cts, lap with bars n(E) (See Note 3)

at 12" cts E.F.

18-#5 v1(E) bars

at 12" cts, lap with bars n(E) (See Note 3)

* Bend top h3(E) bars in field to fit.

at 12" cts E.F.

18-#5 v1(E) bars

at 12" cts, lap with bars n(E) (See Note 3)

5-#4 h1(E) bars at 12" Max. cts E.F. both sidse fan to fit


SCOPE OF WORK


- 1. Remove existing structure.
- 2. Construct a proposed retaining wall shown on plans.
- 3. Remove and replace existing Guardrail. For Guardrail replacement see roadway plans.

NOTES:

- 1. See sheet S-11 for Sections AA, BB, Foundation plan, and Detail A.
- 2. Order v1(E) bars full length, cut in the field and use remaining bars on opposite face.

DESIGNED - RH REVISED -SECTION **DETAILED PLAN AND ELEVATION (RETAINING WALL)** STATE OF ILLINOIS CHECKED - MAF REVISED -1281 202 NB012 LOT COOK 20 12 **DEPARTMENT OF TRANSPORTATION** DRAWN - RH REVISED -CONTRACT NO. 62U87 PLOT DATE = CHECKED - MAF SHEET 1 OF 2 SHEETS REVISED -3:49:58 PM

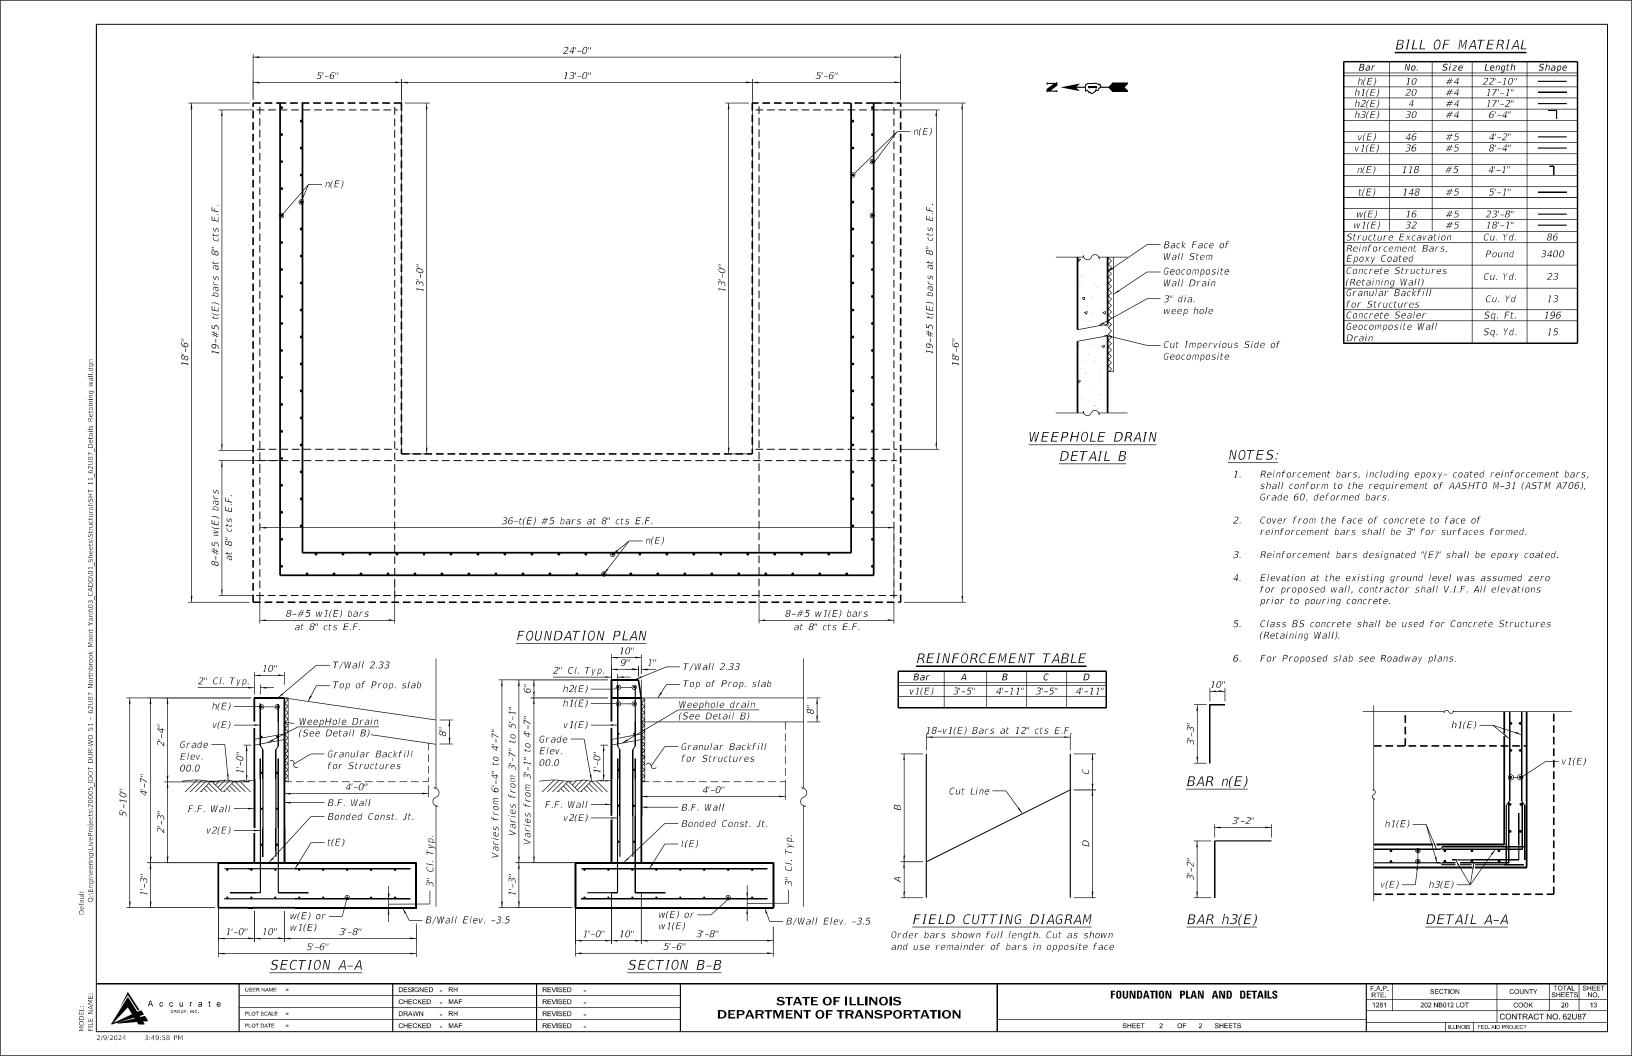

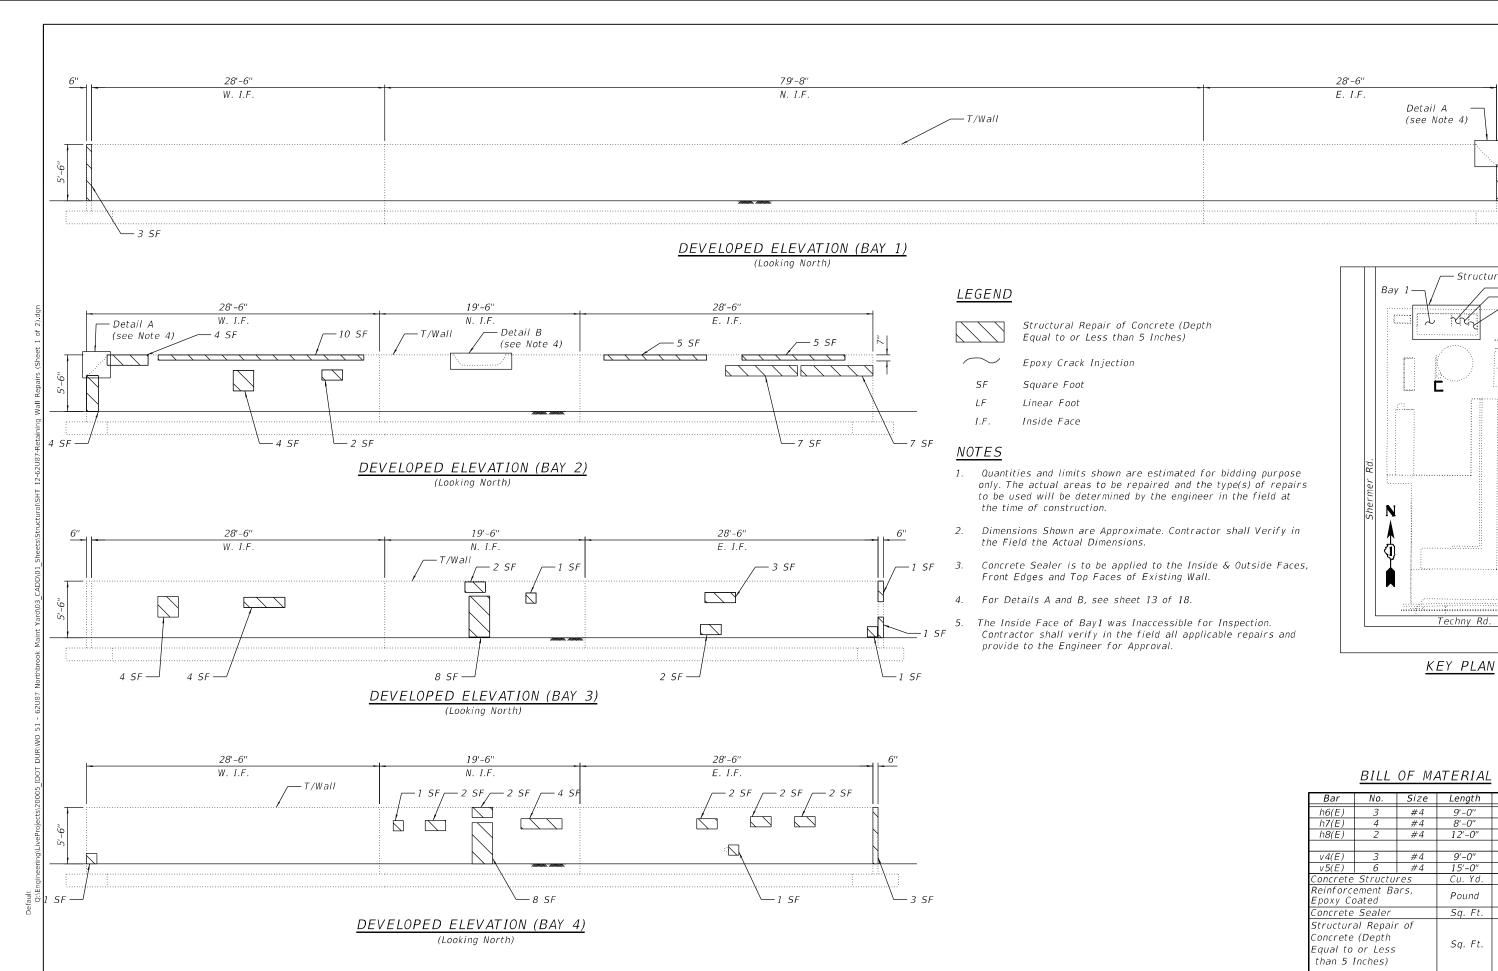

SECTION **EXISTING RETAINING WALL REPAIR (SHEET 1 OF 2)** 202 NB012 LOT COOK 20 14 1281 (SHEET 1 OF 2) CONTRACT NO. 62U87

– Structure Location — Вау 2 — Вау 3

9'-0''

15'-0"

Pound

Sa. Ft.

Sq. Ft.

40

3521

116

STATE OF ILLINOIS **DEPARTMENT OF TRANSPORTATION**

SHEET 1 OF 2 SHEETS

5:43:57 PM

PLOT DATE =

DESIGNED - AE

CHECKED - MAF

DRAWN - AE


CHECKED - MAF

REVISED -

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REVISED -




2/8/2024 5

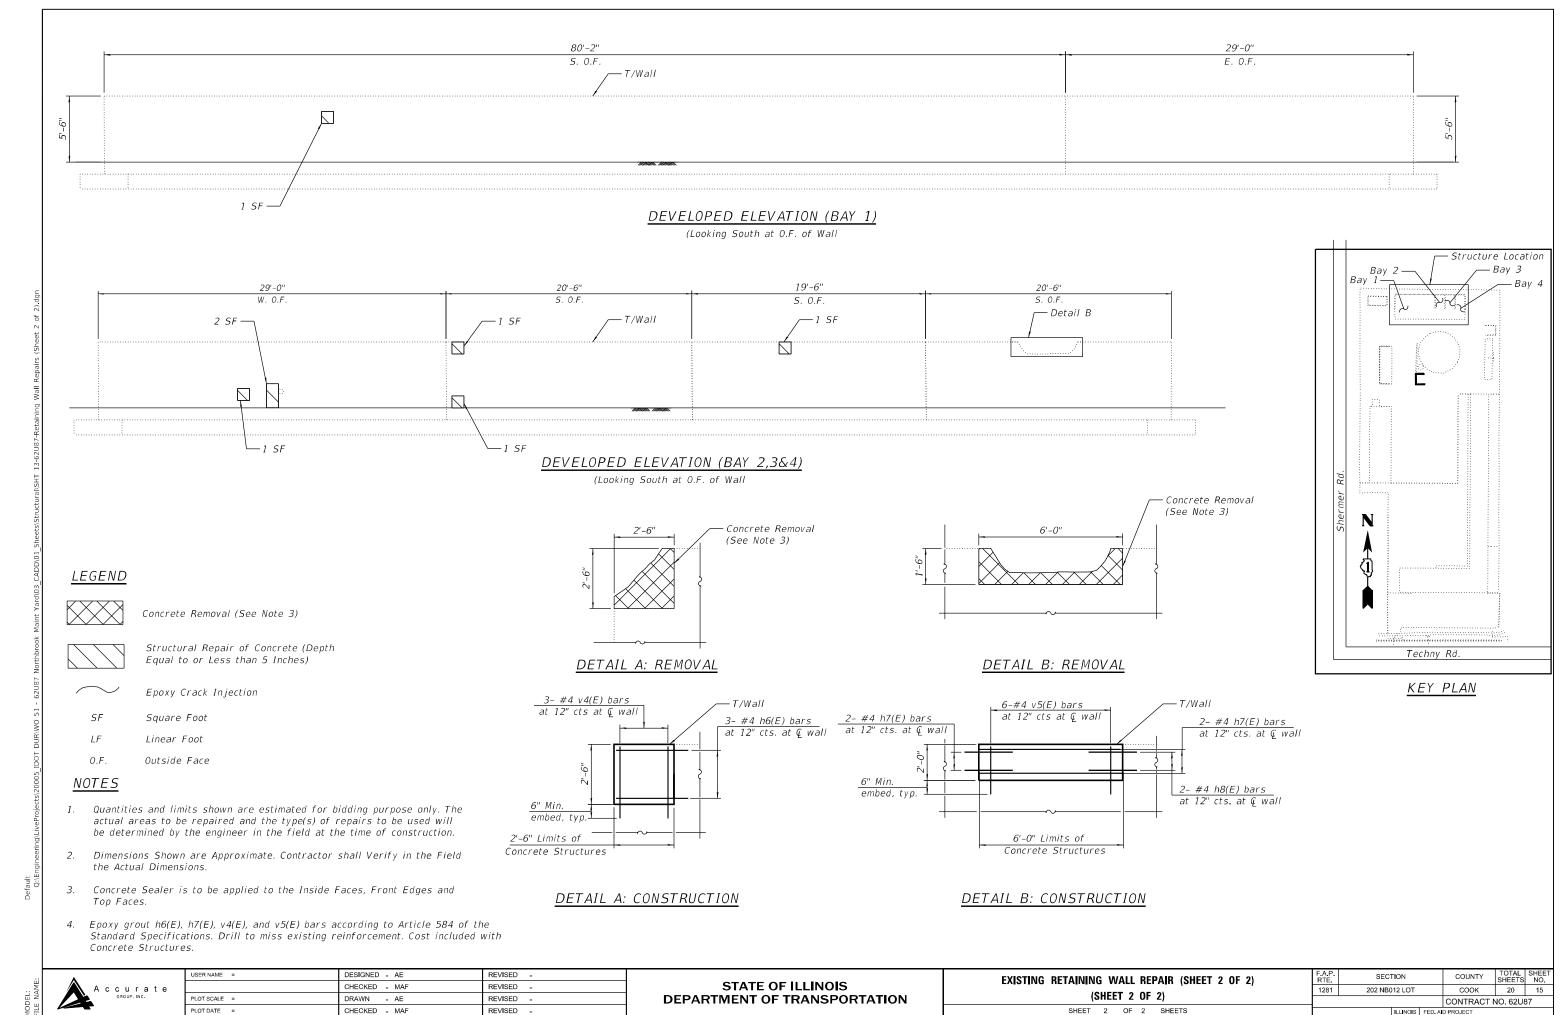
4 5:43:59 PM


WITH CONCRETE CURB, TYPE B

- SEE NOTE 3 EXISTING DRIVEWAY OR PARKING LOT EXISTING CURB (TYP.) --12 (300) & VAR. - R.O.W. LINE PCC PCC SIDEWALK SIDEWALK - CONCRETE CURB TYPE B (TYP.) PARKWAY (TYP.) -R=15' (4.5 m) (TYP.) MIN. - CURB & GUTTER TRANSITION (TYP.) R=10' (3.0 m) TYP. MIN. 12 (300) STUB COMBINATION CURB & GUTTER FLOW LINE OF GUTTER DEPRESSED CURB PAVEMENT

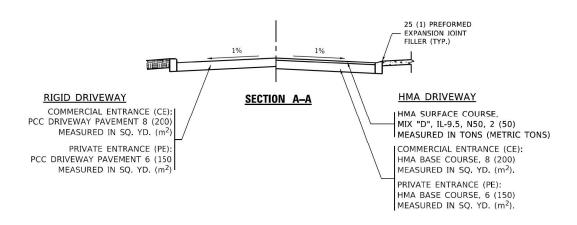

WITH CONCRETE CURB, TYPE B

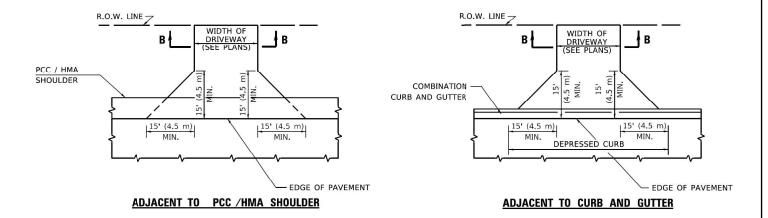

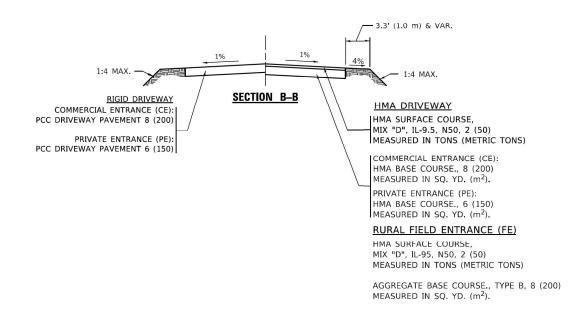

GENERAL NOTES

- DRIVEWAY SLOPES, LOCATIONS, & GEOMETRIC LAYOUT SHALL BE IN ACCORDANCE WITH THE LATEST EDITION OF THE "HANDBOOK FOR POLICY ON PERMITS FOR ACCESS DRIVEWAYS TO STATE HIGHWAYS".
 FOR FURTHER LAYOUT REQUIREMENTS, REFER TO ILLUSTRATIONS IN THE PERMIT HANDBOOK. DRIVEWAYS SHALL BE REPLACED IN KIND, UNLESS OTHERWISE NOTED ON THE PLANS.
- COMMERCIAL DRIVEWAYS SHALL BE CONSTRUCTED WITH CONCRETE CURB, TYPE B RETURNS EXCEPT WHEN THE SIDEWALK EDGE IS 4 FEET (1.2 METERS) OR LESS FROM THE BACK OF CURB, CONSTRUCT A FLARE DRIVEWAY WITHOUT CURB.


ALL DIMENSIONS ARE IN INCHES (MILLIMETERS) UNLESS OTHERWISE NOTED.

USER NAME = Lawrence,DeManche	DESIGNED - R. SHAH	REVISED - R. BORO 06-11-08
	DRAWN -	REVISED - R. BORO 09-06-11
PLOT SCALE = 100.0000 ' / in.	CHECKED -	REVISED - K. SMITH 08-28-19
PLOT DATE = 11/18/2022	DATE - 11-04-95	REVISED - K SMITH 11-18-22

STATE OF ILLINOIS
DEPARTMENT OF TRANSPORTATION


DR	I R.O.W.				
AND	FACE OF	CURB 8	k EDGE OF	SHOULDER	≥ 15′(4.5m)
SCALE: NONE	SHEET 1	l OF	1 SHEETS	STA.	TO STA.


F.A.U. RTE.	SECT	ПОИ	COUNTY	TOTAL SHEETS	SHEET NO.	
1281	202 NB	COOK	20	16		
В	D400-01 (BD-	– 01)	CONTRACT	NO. 62	2U87	
ILLINOIS FED. AI				ID PROJECT		

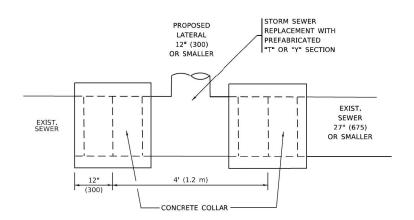


DETAIL "A"

LATERAL CONNECTION TO EXISTING SEWER OF 27" (675) OR SMALLER

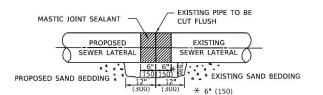

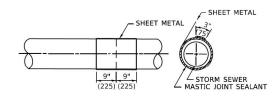

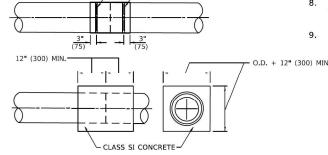

METAL BINDING

DETAIL "B"


CLASS SI CONCRETE COLLAR

CONSTRUCTION SEQUENCE

- 1. CUT THE EXISTING END OF THE PIPE SO AS TO PRESENT A FLUSH BUTT JOINT. BRUSH AND CLEAN ALL PIPES.
- 2. APPLY THE MASTIC JOINT SEALANT TO THE FIRST 6" (150) OF EACH PIPE.
- 3. BUTT THE PIPES TOGETHER LEAVING A MINIMUM OF 12' x 6' (300 x 150) DEEP EXCAVATION UNDER AND AROUND EACH PIPE END.
- 4. CUT A PIECE OF SHEET METAL GAGE NO. 19 1.1 (0.0418) 18" (450) WIDE BY THE OUTSIDE CIRCUMFERANCE OF THE PIPE PLUS 3" (75) LONG.
- WRAP THE SHEET METAL AROUND THE PIPES, 9" (225) ON EACH SIDE OF THE JOINT, STARTING AT THE TOP OF THE PIPE.
- 6. LAP THE SHEET METAL AT LEAST 3" (75) AT THE TOP OF THE PIPE AND PLACE THE MASTIC JOINT SEALANT BETWEEN THE LAP.
- 7. PLACE TWO METAL BANDS AROUND THE SHEET METAL AND TIGHTEN.
- WIPE OFF ANY EXCESS MASTIC JOINT SEALANT THAT OOZES OUT FROM BETWEEN THE SHEET METAL AND THE PIPES.

SCALE: NONE

9. PLACE CLASS SI CONCRETE AROUND THE

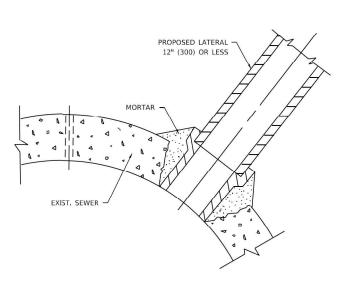

DETAIL "C"

PROPOSED LATERAL CONNECTION TO EXISTING SEWER OF 30" (750) OR LARGER

NOTES:

MATERIAL

MATERIAL USED FOR THE TEE OR WYE SECTION SHALL BE COMPATIBLE WITH THE EXISTING STORM SEWER OR THE PROPOSED STORM SEWER.

CONSTRUCTION METHODS

- I. THIS WORK SHALL BE CONSTRUCTED IN CONFORMANCE WITH THE APPLICABLE PORTIONS OF SECTION 550 OF THE STANDARD SPECIFICATIONS.
- II. CONNECTION TO AN EXISTING STORM SEWER SHALL BE BY EITHER OF THE FOLLOWING METHODS: A) PROPOSED STORM SEWER CONNECTION TO EXISTING SEWER OF 27" (675) OR SMALLER SEE
 - B) PROPOSED STORM SEWER CONNECTION TO EXISTING SEWER OF 30" (750) OR LARGER SEE

IF THE EXISTING SEWER PIPE IS CRACKED, BROKEN OR OTHERWISE DAMAGED BY THE CONTRACTOR IN MAKING THE CIRCULAR OPENING, THE CONTRACTOR SHALL REPLACE THAT SECTION OF PIPE WITH PIPE EQUAL AND SIMILAR IN ALL RESPECTS TO THE PIPE IN THE EXISTING SEWER, IN A CAREFUL WORKMANLIKE MANNER, WITHOUT EXTRA COMPENSATION.

GENERAL

- 1. CARE MUST BE TAKEN TO PREVENT DEBRIS FROM ENTERING THE SEWER. ALL DEBRIS WHICH ENTERS THE SEWER MUST BE REMOVED. THE SEWER MUST BE LEFT CLEAN AND UNOBSTRUCTED UPON COMPLETION OF THE CONTRACT.
- 2. CARE MUST BE TAKEN TO PREVENT ANY PART OF THE NEW PIPE CONNECTION FROM PROJECTING INTO THE EXISTING SEWER.

BASIS OF PAYMENT

- 1. TEE OR WYE CONNECTIONS SHALL BE PAID FOR AT THE CONTRACT UNIT PRICE EACH FOR STORM SEWER TEE OR WYE OF THE TYPE AND SIZE SPECIFIED IN THE PLANS, THIS PRICE SHALL INCLUDE ALL EXCAVATION OF THE TRENCH, REMOVAL OF THE EXISTING STORM SEWER, FURNISHING AND INSTALLING THE SPECIFIED TEE OR WYE SECTION, FURNISHING AND INSTALLING THE REQUIRED CONCRETE COLLAR, AND ALL OTHER MATERIAL NECESSARY TO COMPLETE THIS WORK AS SHOWN AND SPECIFIED.
- 2. REMOVAL AND REINSTALLATION OF EXISTING STORM SEWER ADJACENT TO THE PROPOSED TEE OR WYE SECTION, FOR THE PURPOSE OF FACILITATING THE INSTALLATION OF THE TEE OR WYE SECTION, WILL NOT BE PAID FOR SEPARATELY BUT SHALL BE INCLUDED IN THE UNIT PRICE BID FOR THE WORK.
- 3. TRENCH BACKFILL, EXCAVATION IN ROCK AND REMOVAL AND REPLACEMENT OF UNSUITABLE MATERIAL BELOW PLAN BEDDING GRADE WILL BE PAID FOR SEPARATELY.
- 4. CONCRETE COLLAR FOR CONNECTING A PROPOSED STORM SEWER TO AN EXISTING STORM SEWER WILL NOT BE PAID PAID FOR SEPARATELY BUT SHALL BE INCLUDED IN THE COST OF THE PROPOSED STORM SEWER.


* ALL DIMENSIONS ARE IN INCHES (MILLIMETERS) UNLESS OTHERWISE SHOWN.

USER NAME = Lawrence.DeManche	DESIGNED - M. DE YONG	REVISED - R. SHAH 09-09-94
	DRAWN -	REVISED - R. SHAH 10-25-94
PLOT SCALE = 100.0000 ' / in.	CHECKED -	REVISED - R. SHAH 06-12-96
PLOT DATE = 11/18/2022	DATE - 07-25-90	REVISED - K. SMITH 11-18-22

STATE OF ILLINOIS **DEPARTMENT OF TRANSPORTATION**

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F.A.U. RTE.	SECTION		COUNTY	TOTAL SHEETS			
1281	202 NB012 LOT			COOK	20	17	
BD500-01 (BD-07)				CONTRACT NO. 62U87			
		TLLINOIS	FFD A	ID PROJECT			

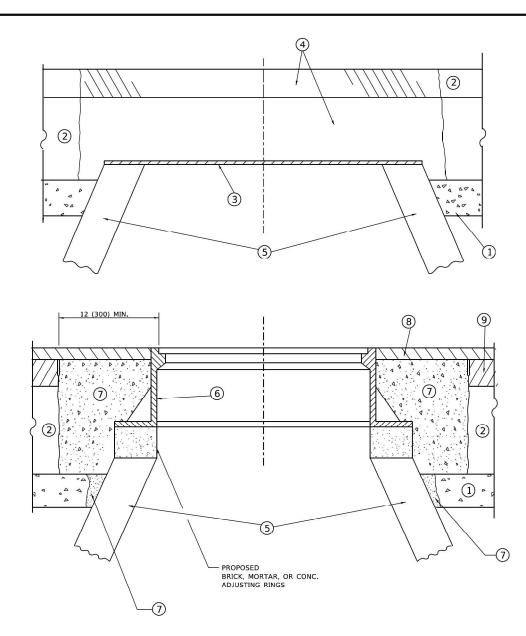

DETAILS FOR FRAMES AND LIDS ADJUSTMENT WITH MILLING

<u>NOTES</u>

- 1. EXISTING BROKEN FRAMES AND LIDS SHALL BE REMOVED AND DISPOSED OF BY THE CONTRACTOR AND SHALL BE REPLACED AS DIRECTED BY THE ENGINEER. REPLACEMENT FRAMES AND LIDS WILL BE PAID FOR IN ACCORDANCE WITH ARTICLE 109.04 OF THE STANDARD SPECIFICATIONS UNLESS A SEPARATE PAY ITEM HAS BEEN PROVIDED.
- IF THE EXISTING LIDS ARE OPEN, THE FRAME WILL BE ADJUSTED TO THE ELEVATION OF THE MILLED PAVEMENT SURFACE PRIOR TO THE MILLING OPERATION. THE FRAME WILL NOT BE REMOVED AND COVERED BY THE METAL PLATE.
- 3. CITY OF CHICAGO CASTINGS ARE THE PROPERTY OF THE CITY AND THE CONTRACTOR SHALL NOTIFY THE CITY FOR REMOVAL AND DISPOSITION OF THE CASTINGS.
- THE METAL PLATE USED TO COVER THE STRUCTURE SHALL REMAIN THE PROPERTY OF THE CONTRACTOR.
- THE CONTRACTOR SHALL REMOVE ALL TRAFFIC CONTROL DEVICES BY THE END OF EACH WORK SHIFT.

STATE OF ILLINOIS DEPARTMENT OF TRANSPORTATION

I LAIL.

A) REMOVE A MINIMUM OF 12 (300) OF THE PAVEMENT FROM

- B) REMOVE THE EXISTING FRAME AND LID FROM THE STRUCTURE.
 C) COVER THE STRUCTURE OPENING WITH A 36 (900) DIAMETER
 METAL PLATE.
- D) BACKFILL WITH CRUSHED STONE AND HMA SURFACE MIX APPROVED BY THE ENGINEER. (MIN. 3 (80) HMA TO REMAIN AFTER MILLING).

STAGE 2 (AFTER PAVEMENT MILLING)

CONSTRUCTION PROCEDURES

STAGE 1 (BEFORE PAVEMENT MILLING)

AROUND THE STRUCTURE.

- A) REMOVE THE HMA SURFACE MIX AND CRUSHED STONE.
- B) INSTALL THE FRAME AND LID; ADJUST THE FRAME TO ITS FINAL SURFACE ELEVATION.
- C) THE SURROUNDING SPACE SHALL BE FILLED WITH CLASS PP-2* CONCRETE TO THE ELEVATION OF THE SURFACE OF THE EXISTING BASE COURSE OR THE BINDER COURSE.
- *UNLESS OTHERWISE SPECIFIED IN THE PLANS.

THE PROCEDURE EXPLAINED ABOVE SHALL CONFORM TO THE APPLICABLE PORTIONS OF SECTIONS 353, 406, 602, AND 603 OF THE STANDARD SPECIFICATIONS EXCEPT THAT "THE CONTRACTOR SHALL ADJUST THE STRUCTURES TO THE FINISHED PAVEMENT ELEVATION NO MORE THAN 5 CALENDAR DAYS PRIOR TO PLACEMENT OF THE FINAL LIFT OF SURFACE UNLESS APPROVED BY THE ENGINEER."

LEGEND

1 SUB-BASE GRANULAR MATERIAL

(6) FRAME AND LID (SEE NOTES)

(2) EXISTING PAVEMENT

(7) CLASS PP-2* CONCRETE

(3) 36 (900) DIAMETER METAL PLATE

8 PROPOSED HMA SURFACE COURSE

4 PROPOSED CRUSHED STONE AND HMA SURFACE MIX

(9) PROPOSED HMA BINDER COURSE

(5) EXISTING STRUCTURE


LOCATION OF STRUCTURES

THE CONTRACTOR WILL BE REQUIRED TO KEEP A RECORD OF THE LOCATIONS OF THE BURIED STRUCTURES ACCORDING TO THE STATION AND DISTANCE LEFT OR RIGHT OF THE CENTERLINE OF PAVEMENT. UPON COMPLETION OF THE WORK, THE CONTRACTOR WILL DELIVER THE RECORD TO THE ENGINEER.

BASIS OF PAYMENT

- 1. REMOVING FRAMES AND LIDS ON DRAINAGE AND UTILITY STRUCTURES IN THE PAVEMENT PRIOR TO MILLING, AND ADJUSTING TO FINAL GRADE PRIOR TO PLACING THE SURFACE COURSE, WILL BE PAID FOR AT THE CONTRACT UNIT PRICE EACH FOR "FRAMES AND LIDS TO BE ADJUSTED (SPECIAL)."
- THIS WORK WILL NOT BE PAID FOR WHEN DRAINAGE AND UTILITY STRUCTURES ARE SPECIFIED FOR PAYMENT AS STRUCTURE RECONSTRUCTION.
- NEW FRAMES AND LIDS, WHEN SPECIFIED, WILL BE PAID FOR SEPARATELY.
- 4. WHEN STRUCTURES ARE TO BE ADJUSTED OR RECONSTRUCTED, THE LOWERING AND RAISING OF THE FRAMES AND LIDS WILL NOT BE PAID FOR SEPARATELY BUT WILL BE INCLUDED IN THE COST OF THE CORRESPONDING PAY ITEM.

ALL DIMENSIONS ARE IN INCHES (MILLIMETERS) UNLESS OTHERWISE SHOWN

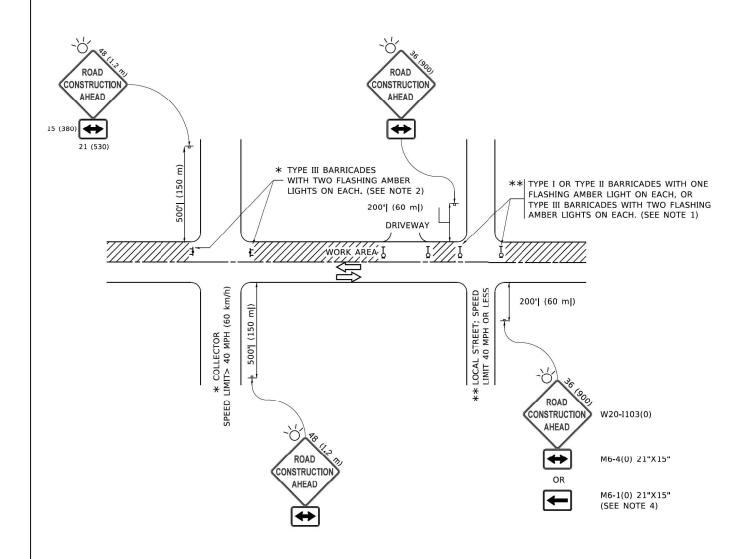

NOTES:

- 1. SIDE ROAD WITH A SPEED LIMIT OF 40 MPH (60 km/h) OR LESS AS SHOWN ON THE DRAWING AND AS DIRECTED BY THE ENGINEER:
- a) ONE "ROAD CONSTRUCTION AHEAD" SIGN 36 x 36 (900x900) WITH A FLASHER MOUNTED ON IT APPROXIMATELY 200' (60 m) IN ADVANCE OF THE MAIN ROUTE.
- b) THE CLOSED PORTION OF THE MAIN ROUTE SHALL BE PROTECTED BY BLOCKING WITH TYPE I, TYPE II OR TYPE III BARRICADES, 1/3 OF THE CROSS SECTION OF THE CLOSED PORTION.
- 2. SIDE ROAD WITH A SPEED LIMIT GREATER THAN 40 MPH (60 km/h) AS SHOWN ON THE DRAWING AND AS DIRECTED BY THE ENGINEER:
- a) ONE "ROAD CONSTRUCTION AHEAD" SIGN 48 x 48 (1.2 m x 1.2 m) WITH A FLASHER MOUNTED ON IT APPROXIMATELY 500' (150 m) IN ADVANCE OF THE MAIN ROUTE.
- THE CLOSED PORTION OF THE MAIN ROUTE SHALL BE PROTECTED BY
 b) BLOCKING WITH TYPE III BARRICADES, 1/2 OF THE CROSS SECTION
 OF THE CLOSED PORTION.
- 3. CONES MAY BE SUBSTITUTED FOR BARRICADES OR DRUMS AT HALF THE SPACING DURING DAY OPERATIONS. CONES SHALL BE A MINIMUM OF 28 (710)
- WHEN THE SIDE ROAD LIES BETWEEN THE BEGINNING OF THE MAINLINE
 4. SIGNING AND THE WORK ZONE, A SINGLE HEADED ARROW (M6-1) SHALL
 BE USED IN LIEU OF THE DOUBLE HEADED ARROW (M6-4).

SCALE: NONE

- 5. WHEN WORK IS BEING PERFORMED ON A SIDE ROAD OR DRIVEWAY, FOLLOW THE APPLICABLE STANDARD(S). THE DIRECTIONAL ARROW (M6-1 OR M6-4) SHALL BE COVERED OR REMOVED WHEN NO LONGER CONSISTENT WITH THE TRAFFIC CONTROL SET-UP.
- 6. ADVANCE WARNING SIGNS ARE TO BE OMITTED ON DRIVEWAYS UNLESS OTHERWISE SPECIFIED IN THE PLANS OR BY THE ENGINEER
- THE TRAFFIC CONTROL AND PROTECTION FOR SIDE ROADS, INTERSECTIONS, AND DRIVEWAYS SHALL BE INCLUDED IN THE COST OF SPECIFIED TRAFFIC CONTROL STANDARDS OR ITEMS.

All dimensions are in inches (millimeters) unless otherwise shown.

USER NAME = footemj	DESIGNED - L.H.A.	REVISED - A. HOUSEH 10-15-96
	DRAWN -	REVISED - T. RAMMACHER 01-06-00
PLOT SCALE = 50.0000 ' / in.	CHECKED -	REVISED - A. SCHUETZE 07-01-13
PLOT DATE = 3/4/2019	DATE - 06-89	REVISED _ A. SCHUETZE 09-15-16

STATE	OF	ILLINOIS
DEPARTMENT	OF T	TRANSPORTATION

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F.A.U. RTE.	SECTION	COUNTY	TOTAL SHEETS	SHE	
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	TC-10	CONTRACT	NO. 62	2U8	
	ILLINOIS	FED. A	ID PROJECT		

