INDEX OF SHEETS

SHEET NO.	ITEM A STATE OF THE STATE OF TH
1	COVER SHEET
2	GENERAL NOTES
3	SUMMARY OF QUANTITIES
4	TYPICAL SECTIONS
5	SCHEDULE OF QUANTITIES
6	PLAN AND PROFILE
7	TRAFFIC CONTROL AND PROTECTION
8-9	INTERSECTION DETAILS
10	PAVEMENT MARKINGS
11-13	TRAFFIC SIGNAL PLANS
14	DETAILS
15-16	CROSS SECTIONS

STATE OF ILLINOIS

DEPARTMENT OF TRANSPORTATION

DIVISION OF HIGHWAYS

PLANS FOR PROPOSED

CITY OF EDWARDSVILLE E. SCHWARZ STREET (FAU 8878) INTERSECTION IMPROVEMENTS

SECTION: 06-00097-00-PV

PROJECT: CMM-5011 (228)

JOB NO.: C-98-316-07

MADISON COUNTY

000001-05 720006-01 424001-05 780001-01 442201-03 814001-01

STANDARDS

 442201~03
 814001-01

 604006-03
 857001

 604066-01
 878001-06


 606001-03
 880006

PROJECT LOCATION .

701701-05 886001 701801-03 886006

701901 BLR 18-4

20001 BLR 21-7

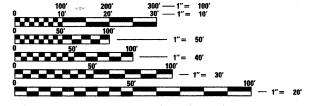


FULL SIZE PLANS HAVE BEEN PREPARED USING STANDARD ENGINEERING SCALES. REDUCED SIZED PLANS WILL NOT CONFORM TO STANDARD SCALES. IN MAKING MEASUREMENTS ON REDUCED PLANS, THE ABOVE SCALES MAY BE USED.

J.U.L.I.


0

JOINT UTILITY LOCATION INFORMATION FOR EXCAVATION 1-800-892-0123 OR 811


ROADWAY CLASSIFICATION: URBAN COLLECTOR ADT: 4,800 (2008) ADT: 6,400 (2028)

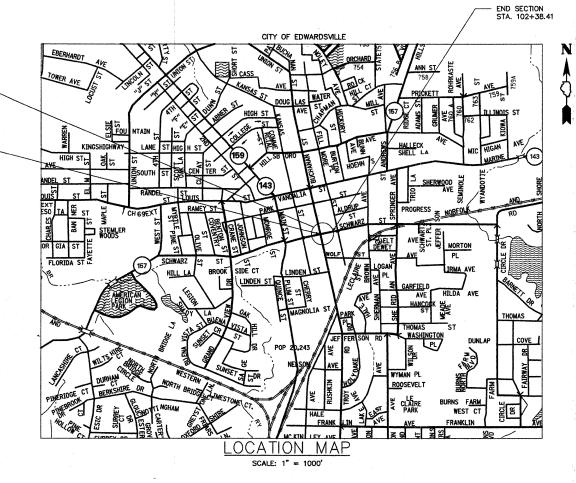


NET LENGTH OF PROJECT: 219.97' (0.042 MILES)

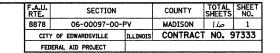



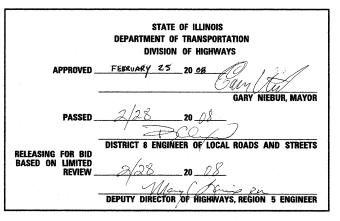



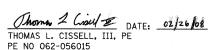



EXPIRES 11/30/09

26050

GENERAL NOTES

- THE ILLINOIS DEPARTMENT OF TRANSPORTATION (IDOT) HIGHWAY STANDARDS WITH THE REVISION NUMBER LISTED ON THE COVER SHEET OF THE PLANS SHALL APPLY TO THIS PROJECT.
- 2. UNDERGROUND FACILITIES, STRUCTURES AND UTILITIES HAVE BEEN PLOTTED FROM AVAILABLE SURVEYS AND RECORDS. THEIR LOCATIONS MUST BE CONSIDERED TO BE APPROXIMATE ONLY. IT IS POSSIBLE THERE MAY BE OTHERS, THE EXISTENCE OF WHICH IS NOT PRESENTLY KNOWN OR. SHOWN. IT IS THE CONTRACTOR'S RESPONSIBILITY TO DETERMINE THEIR EXISTENCE AND EXACT LOCATION AND TO AVOID DAMAGE THERETO. ILLINOIS LAW REQUIRES A MINIMUM 48-HOUR NOTICE TO ALL UTILITY COMPANIES BEFORE DIGGING, FIELD LOCATIONS OF UNDERGROUND FACLITIES MAY BE OBTAINED BY CALLING THE JULILE. SYSTEM AT 800-892-0123 AND PROVIDING 48 HOURS ADVANCE NOTICE. NON-JULILE. MEMBERS MAY BE CONTACTED DIRECT. AGENCIES KNOWN TO HAVE FACILITIES WITHIN THE PROJECT LIMITS ARE LISTED BELOW.
- 3. ANY FACILITIES OR APPURITENANCES WHICH ARE THE PROPERTY OF ANY PUBLIC UTILITY LOCATED WITHIN THE LIMITS OF CONSTRUCTION SHALL BE RELOCATED OR ADJUSTED BY THEIR RESPECTIVE OWNERS. THE CONTRACTOR SHALL NOTIFY AND COOPERATE WITH THE OWNERS OF ANY SUCH FACILITY IN THEIR REMOVAL AND REARRANGEMENT OPERATIONS IN ORDER THAT THESE OPERATIONS AND THE CONSTRUCTION OF THIS PROJECT MAY PROGRESS IN A REASONABLE MANNER. ALL ROADSIDE OBJECTS (UTILITY POLES, FRE HYDRANTS, SIGNS, ETC.) SHALL BE RELOCATED TO PROVIDE A MINIMUM OF 2 FEET CLEARANCE, MEASURED FROM THE FACE OF CURB TO THE NEAR EDGE OF THE OBJECT.
- 4. THE FOLLOWING UTILITY COMPANIES MAY HAVE FACILITIES LOCATED WITHIN THE LIMITS OF CONSTRUCTION WHICH MAY REQUIRE ADJUSTMENT, RELOCATION OR REMOVAL. ALL ARE MEMBERS OF J.U.L.I.E., UNLESS NOTED OTHERWISE.

AT & T (TELEPHONE) 203 GOETHE STREET COLLINSVILLE, IL 62234 (618) 346-6400

CHARTER COMMUNICATIONS (CABLE TV) 210 WEST DIVISION STREET MARYVILLE, IL 62062 (618) 345-8121

CITY OF EDWARDSVILLE (WATER, SEWER & TRAFFIC SIGNALS) 118 HILLSBORD AVENUE EDWARDSVILLE, IL 62025 (618) 692-7535

AMEREN IP (GAS & ELECTRIC) 2600 NORTH CENTER MARYVILLE, IL 62062 (618) 346-1287

- 5. THE ABOVE INFORMATION REPRESENTS THE BEST INFORMATION AVAILABLE TO THE LOCAL AGENCY AND IS ONLY INCLUDED FOR THE CONVENIENCE OF THE BIDDER. IT IS UNDERSTOOD AND AGREED THAT THE CONTRACTOR HAS TAKEN THE FOREGOING INTO CONSIDERATION IN PREPARING HIS/HER BID, AND NO ADDITIONAL COMPENSATION WILL BE ALLOWED FOR ANY DELAYS OR INCONVENIENCE CAUSED BY SAME.
- 6. THE CONTRACTOR SHALL PROVIDE BLOCKOUTS IN THE PROPOSED SIDEWALK FOR PLACEMENT OF SIGN POSTS AND MALBOX SUPPORTS, AS DIRECTED BY THE ENGINEER FOUR-INCH DIAMETER PVC SLEEVES SHALL BE PLACED AT ALL LOCATIONS WHERE SIGN POSTS WILL BE INSTALLED WITHIN THE LIMITS OF THE SIDEWALK. THE VOID SPACE BETWEEN THE POST AND THE SLEEVE SHALL BE FILLED WITH COLD MIX ASPHALT PATCHING MATERIAL. THIS WORK WILL NOT BE PAID FOR SEPARATELY, BUT SHALL BE INCLUDED IN THE CONTRACT UNIT PRICE OF THE VARIOUS CONCRETE ITEMS FOR WHICH THE BLOCKOUTS ARE REQUIRED, AND NO ADDITIONAL COMPENSATION WILL BE ALLOWED.
- THE CONTRACTOR SHALL VERIFY ALL DIMENSIONS AND CONDITIONS IN THE FIELD PRIOR TO ORDERING MATERIALS AND COMMENCING CONSTRUCTION.
- 8. THE CONTRACTOR SHALL STAGE ALL WORK IN SUCH A WAY AS TO MAINTAIN INGRESS AND EGRESS TO TO ALLEYS EAST OF JACK-IN-THE-BOX AND SWING CITY MUSIC AT ALL TIMES DURING CONSTRUCTION, EXCEPT AS SPECIFIED IN THE SPECIAL PROVISIONS.
- 9. THE CONTRACTOR SHALL FERTILIZE, SEED AND MULCH ALL EARTH SURFACES DISTURBED BY CONSTRUCTION. SEE THE SEEDING SCHEDULE FOR ESTIMATED PLAN QUANTITIES.
- 10. THE CONTRACTOR SHALL CONFINE ALL OPERATIONS TO THE AREA LOCATED WITHIN THE RIGHT OF WAYLINES, SHOWN ON THE PLANS. ANY AREA DISTURBED BEYOND THESE LIMITS SHALL BE RESTORED TO ITS ORIGINAL CONDITION AT THE CONTRACTOR'S EXPENSE.
- 11. WHEN THE MILLING OPERATION COMMENCES, "ROUGH GROOVED SURFACE" (W8-1106-(0)-48) SIGNS SHALL BE PLACED BY THE CONTRACTOR AT EACH END OF THE SECTION, AND EACH INTERSECTING SIDE ROAD. THE COST OF THIS WORK WILL NOT BE PAID FOR SEPARATELY, BUT SHALL BE CONSIDERED AS INCLUDED IN THE CONTRACT UNIT PRICE FOR HOT-MIX ASPHALT SURFACE REMOVAL, VARIABLE DEPTH.

- 12. THE CONTRACTOR SHALL NOTE THE LOCATION OF ALL MANHOLE AND VALVE VAULT FRAMES AND LIDS LOCATED WITHIN THE RESURFACING LIMITS. APPROPRIATE CARE SHALL BE TAKEN TO PROTECT THESE ITEMS DURING MILLING OPERATIONS.
- 13. THE THICKNESS OF THE HOT MIX ASHPALT MIXTURES SHOWN ON THE PLANS IS THE NOMINAL THICKNESS. DEVIATIONS FROM THE NOMINAL THICKNESS WILL BE PERMITTED WHEN SUCH DEVIATIONS OCCUR DUE TO IRREGULARTIES IN THE EXISTING SURFACE OR BASE ON WHICH THE BITUMINOUS MIXTURES ARE PLACED.
- 14. THE CONTRACTOR SHALL INCLUDE THE COST OF MAKING CONNECTIONS TO EXISTING DRAINAGE STRUCTURES IN THE CONTRACT UNIT PRICE FOR THE STORM SEWER ITEMS INVOLVED.
- 15. ALL EXISTING ROADWAY FEATURES SUCH AS PAVEMENT, CURB, SIDEWALK, DRIVEWAY PAVEMENT, CULVERTS, HEADWALLS, RIPRAP, FENCING, RETAINING WALLS, ETC. WHICH INTERFERE WITH THE PROPOSED CONSTRUCTION SHALL BE REMOVED BY THE CONTRACTOR UNLESS NOTED OTHERWISE ON THE PLANS. ALL MISCELLANEOUS FEATURES WHICH ARE TO BE REMOVED AND FOR WHICH THERE IS NO SPECIFIC PAY ITEM, WILL NOT BE MEASURED SEPARATELY FOR PAYMENT. THE COST OF THIS REMOVAL WORK SHALL BE INCLUDED IN THE CONTRACT UNIT PRICE BID FOR EARTH EXCAVATION.
- 6. ALL DRAINAGE STRUCTURES CONSTRUCTED, ADJUSTED OR RECONSTRUCTED UNDER THE. CONTRACT, SHALL BE CLEANED OF ANY ACCUMULATION OF SILT, DEBRIS OR FOREIGN MATTER AT THE END OF EACH WORKING DAY AND AT THE TIME OF FINAL INSPECTION. THE COST OF THIS WORK WILL NOT BE PAID FOR SEPARATELY, BUT SHALL BE CONSIDERED AS INCLUDED IN THE. CONTRACT UNIT PRICES BID FOR THE VARIOUS DRAINAGE STRUCTURE ITEMS INCLUDED IN THE CONTRACT.
- THE CONTRACTOR SHALL APPLY TEMPORARY PAVEMENT MARKINGS TO THE FINAL ASPHALT SURFACE LAYER. A QUANTITY FOR TEMPORARY PAVEMENT MARKING EQUAL TO THE AMOUNT OF PERMANENT PAVMENT MARKING TIMES THE NUMBER OF REQUIRED APPLICATIONS (1) HAS BEEN INCLUDED IN THE PLANS.
- 18. THE CONTRACTOR SHALL PLACE ALL TEMPORARY PAVEMENT MARKINGS IN SUCH A MANNER SO AS NOT TO INTERFERE WITH THE PLACEMENT OF PERMANENT PAVEMENT MARKINGS.
- 19. THE PAVEMENT MARKING LOCATIONS SHOWN IN THE PLANS ARE APPROXIMATE. PROPOSED CROSSWALKS AND STOP BARS SHALL BE ADJUSTED BY THE CONTRACTOR, IF NECESSARY, TO MATCH FIELD CONDITIONS.
- 20. SEE THE SPECIAL PROVISIONS FOR OTHER INCIDENTAL CONSTRUCTION ITEMS AND OPERATIONS WHICH ARE TO BE INCLUDED WITH AND PAID FOR UNDER CERTAIN SPECIFICATION PAY ITEMS.
- 21. THE FOLLOWING ITEMS AND APPROXIMATE QUANTITIES ARE INCLUDED IN THE "SUMMARY OF QUANTITIES" IN ORDER TO ESTABLISH A UNIT COST FOR WORK WHICH MAY BE REQUIRED TO CONSTRUCT THIS SECTION. THE ACTUAL QUANTITY OF EACH ITEM SHALL BE DETERMINED BY THE ENGINEER IN THE FIELD

 AGGREGATE FOR TEMPORARY ACCESS
 16
 TON

 LOCATING UNDERGROUND CABLE
 100
 FT

 SEEDING SPECIAL
 100
 SQ YD

 PAVEMENT PATCHING (FULL DEPTH)
 50
 SQ YD

22. THE FOLLOWING SYMBOLS, ABBREVIATIONS AND PATTERNS SUPPLEMENT OR SUPERCEDE HIGHWAY STANDARD 000001:

BO BY OTHERS (USED IN CONJUNCTION WITH TBA & TBR)
CONSTRUCTION
CONSTRU

CP CONTROL POINT
DND DO NOT DISTURB
ESMT EASEMENT
ELEV ELEVATION
PERM PERMANENT
PVC POLYVINYL CHLO

PVC POLYVINYL CHLORIDE PIPE
TCE TEMPORARY CONSTRUCTION EASEMENT

TBRL TO BE RELOCATED

TYP TYPICAL

SCALE:

Summary of Commitments to Adjacent Property Owners

Guirinary	or Communents to Adjacent Fit	perty Owners	
Parcel No.	Owner	Commitment	
	1 .	If the building or owner's property is	
		damaged during construction, and the	١.
44.0 45.44.40.404.000	Diameter Author D	damage is a result of the contractor's	
14-2-15-11-16-401-006	Risavy, Arthur F.	operations, the contractor shall restore the	
*		property to its original condition at no cost	
		to the owner.	

	the state of the s			
FILE NAME =	USER NAME = \$USER\$	DESIGNED - TLC	REVISED	T
H:\P\26050\Microstation V8\650gn001.dgn		DRAWN - TGV	REVISED	1
	PLOT SCALE = 20.00000 '/ IN.	CHECKED - AJG	REVISED	7
4	PLOT DATE = 2/26/2008	DATE - 12/20/07	REVISED	7

 05115541 110		F.A.U. RTE.	SECTION	COUNTY	TOTAL SHEETS	SHEET NO.
GENERAL NOTES		8878	06-00097-00-PV	MADISON	17	2
		E. SC	HWARZ ST. INT. IMPROVEMENTS	CONTRACT	r NO. 9	7333
 SHEET NO. 1 OF 1 SHEETS		CITY OF	F EDWARDSVILLE ILLINOIS FED.	AID PROJECT CH	M-5011 (22	28)

SUMMARY OF QUANTITIES

I000-2A


CODE NO.	ITEM	UNIT	TOTAL QUANTITIES
20200500	EARTH EXCAVATION (WIDENING)	CUYD	35
31100300	SUB-BASE GRANULAR MATERIAL, TYPE A 4"	SQ YD	104
35100500	AGGREGATE BASE COURSE, TYPE A 6"	SQ YD	72
35400500	PORTLAND CEMENT CONCRETE BASE COURSE WIDENING 10"	SQ YD	82
40201000	AGGREGATE FOR TEMPORARY ACCESS	TON	16
40600100	BITUMINOUS MATERIALS (PRIME COAT)	GALLON	59
40600300	AGGREGATE (PRIME COAT)	TON	2
40603315	HOT-MIX ASPHALT SURFACE COURSE, MIX "C", N70	TON	86
40800050	INCIDENTAL HOT-MIX ASPHALT SURFACING	TON	12
42400100	PORTLAND CEMENT CONCRETE SIDEWALK 4 INCH	SQFT	1,729
42400440	PORTLAND CEMENT CONCRETE SIDEWALK 6 INCH, SPECIAL	SQFT	350
42400800	DETECTABLE WARNINGS	SQFT	52
44000198	HOT-MIX ASPHALT SURFACE REMOVAL, VARIABLE DEPTH	SQ YD	698
44000200	DRIVEWAY PAVEMENT REMOVAL	SQ YD	7
44000300	CURB REMOVAL	FOOT	390
44000600	SIDEWALK REMOVAL	SQFT	2,000
44212899	PAVEMENT PATCHING (FULL DEPTH)	SQ YD	50
44300200	STRIP REFLECTIVE CRACK CONTROL TREATMENT	FOOT	44
56109210	WATER VALVES TO BE ADJUSTED	EACH	
60255500	MANHOLES TO BE ADJUSTED	EACH	:
60263100	INLETS TO BE RECONSTRUCTED WITH NEW TYPE 3 FRAME AND GRATE	EACH	
60264100	INLETS TO BE RECONSTRUCTED WITH NEW TYPE	EACH	
60500060	REMOVING INLETS	EACH	
60600605	CONCRETE CURB, TYPE B	FOOT	44
67100100	MOBILIZATION	L SUM	
70101700	TRAFFIC CONTROL AND PROTECTION	LSUM	
70300220	TEMPORARY PAVEMENT MARKING - LINE 4"	FOOT	53
70301000	WORK ZONE PAVEMENT MARKING REMOVAL	SQFT	17
72000100	SIGN PANEL - TYPE 1	SQFT	1

				I000-2A
	CODE NO.	ПЕМ	UNIT	TOTAL QUANTITIES
	72000105	SIGN PANEL - TYPE 1 (SPECIAL)	SQFT	2
,	* 78000100	THERMOPLASTIC PAVEMENT MARKING - LETTERS AND SYMBOLS	SQFT	47
	* 78000200	THERMOPLASTIC PAVEMENT MARKING - LINE 4"	FOOT	530
,	78000400	THERMOPLASTIC PAVEMENT MARKING - LINE 6"	FOOT	73
	* 78000600	THERMOPLASTIC PAVEMENT MARKING - LINE 12"	FOOT	21
	* 78000650	THERMOPLASTIC PAVEMENT MARKING - LINE 24"	FOOT	59
	* 81012600	CONDUIT IN TRENCH, 2" DIA., PVC	FOOT	47
	* 81400115	HANDHOLE TO BE ADJUSTED	EACH	1
	¥ 81900200	TRENCH AND BACKFILL FOR ELECTRICAL WORK	FOOT	47
	* 87301215	ELECTRIC CABLE IN CONDUIT, SIGNAL NO. 14 2C	FOOT	1,030
	¥ 87301225	ELECTRIC CABLE IN CONDUIT, SIGNAL NO. 14 3C	FOOT	1,086
	¥ 87301245	ELECTRIC CABLE IN CONDUIT, SIGNAL NO. 14 5C	FOOT	1,157
1	¥ 87301255	ELECTRIC CABLE IN CONDUIT, SIGNAL NO. 14 7C	FOOT	690
)	* 87301305	ELECTRIC CABLE IN CONDUIT, LEAD-IN, NO. 14 1 PAIR	FOOT	846
)	* 87800100	CONCRETE FOUNDATION, TYPE A	FOOT	3
Y031-1F	¥ 87900200	DRILL EXISTING HANDHOLE	EACH	1
	¥ 88040160	SIGNAL HEAD, POLYCARBONATE, LED, 1-FACE, 5- SECTION, MAST ARM MOUNTED	EACH	2
1	¥ 88200100	TRAFFIC SIGNAL BACKPLATE	EACH	2
1	¥ 88500100	INDUCTIVE LOOP DETECTOR	EACH	2
	¥ 88600100	DETECTOR LOOP, TYPE I	FOOT	374
	¥ 89501150	RELOCATE EXISTING TRAFFIC SIGNAL POST	EACH	1
	¥ 89502200	MODIFY EXISTING CONTROLLER	EACH	1
	* 89502300	REMOVE ELECTRIC CABLE FROM CONDUIT	FOOT	4,809
	¥ 89502375	REMOVE EXISTING TRAFFIC SIGNAL EQUIPMENT	EACH	1
/	¥ 89502385	REMOVE EXISTING CONCRETE FOUNDATION	EACH	1
	XX000648	SEEDING, SPECIAL	SQ YD	100
* Y031-	IF XX005431	LOCATING UNDERGROUND UTILITY	EACH	100
- A		CONSTRUCTION LAYOUT	L SUM	1
	• SF	PECIALTY ITEMS		


FILE NAME =	USER NAME = \$USER\$	DESIGNED	-	TLC	REVISED	-	
H:\P\26050\Microstation V8\650sq01.dgn		DRAWN	-	TGV	REVISED	-	
	PLOT SCALE = 20.0000 '/ IN.	CHECKED	-	AJG	REVISED	-	
	PLOT DATE = 2/26/2008	DATE	-	12/20/07	REVISED	-	

STATE	: OI	: ILLINOIS
DEPARTMENT	OF	TRANSPORTATION

	SUMMARY OF QUANTITIES SHEET NO. 1 OF 1 SHEETS		F.A.U. RTE.	SECTION	COUNTY	TOTAL SHEETS	SHEET NO.
	SUMMARY OF QU	ANTITIES	8878	06-00097-00-PV	MADISON	17	3
			E. SC	HWARZ ST. INT. IMPROVEMENTS	CONTRACT	NO. 9	7333
SCALE:	SHEET NO. 1 OF 1 SHEETS		CITY O	F EDWARDSVILLE ILLINOIS FED	. AID PROJECT C	MM-5011 (228)
		/					

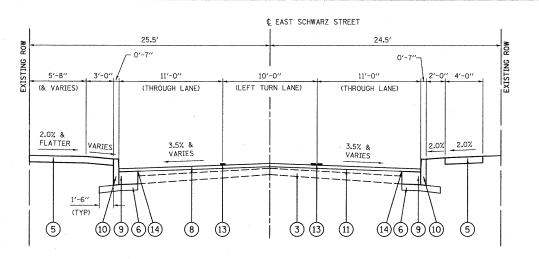

PROPOSED EAST SCHWARZ STREET STA. 100+18.44 to STA. 101+22.47

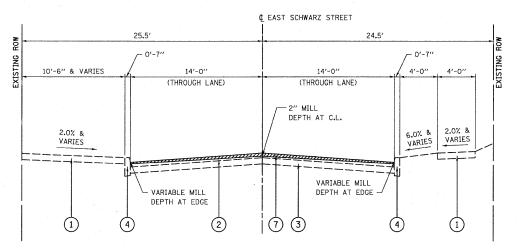

EXISTING EAST SCHWARZ STREET MILLED

STA. 100+18.44 to STA. 102+38.41
(NOT TO SCALE)

SURFACE COURSE

PG 70-22

4% @ NDES = 70

IL 9.5

MIXTURE C

- 1 EXISTING PORTLAND CEMENT CONCRETE SIDEWALK
- 2 EXISITING HOT-MIX ASPHALT OVERLAY, VARIABLE DEPTH

LEGEND

ASPHALT MIXTURE REQUIREMENTS

20 YR ESAL'S:

MIXTURE USE

MIX COMPOSITION


FRICTION AGG

(GRADATION MIXTURE)

RAP% (MAX) DESIGN AIR VOIDS


AC/PG

- 3 EXISTING ASHPHALT AND BRICK ROADWAY
- 4 EXISTING CONCRETE BARRIER CURB
- 5) PROPOSED PORTLAND CEMENT CONCRETE SIDEWALK, 4 INCH
- 6 PROPOSED SUBBASE GRANULAR MATERIAL, TYPE A, 4 INCH
- 7 PROPOSED HOT-MIX ASPHALT SURFACE REMOVAL, VARIABLE DEPTH
- (8) PROPOSED HOT-MIX ASPHALT SURFACE COURSE, 2 INCH, MIX C, N70
- PROPOSED PORTLAND CEMENT CONCRETE BASE COURSE WIDENING, 10 INCH CONTRACTOR SHALL CONSTUCT MONOLYTHICALLY WITH THE CONCRETE CURB, ACCORDING TO ARTICLE 606.07.
- (10) PROPOSED CONCRETE CURB, TYPE B-6
- 11) PROPOSED BITUMINOUS MATERIALS (PRIME AND AGGREGATE COAT)
- (12) PROPOSED INCIDENTAL HOT-MIX ASPHALT, 3 INCH
- (13) PROPOSED THERMOPLASTIC PAVEMENT MARKING, 4 INCH
- 14) PROPOSED STRIP REFLECTIVE CRACK CONTROL TREATMENT
- 15) PROPOSED AGGREGATE BASE COURSE, TYPE A 6"

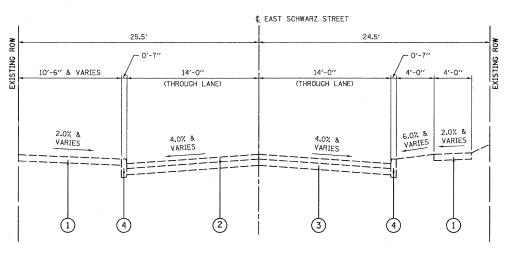


EXISTING EAST SCHWARZ STREET


STA. 100+18.44 +o STA. 102+38.41 (NOT TO SCALE)

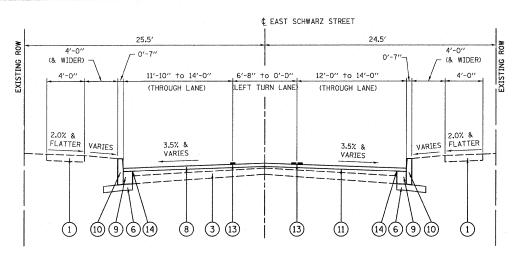

PROPOSED EAST SCHWARZ STREET STA. 101+88.21 to STA. 102+38.41 (NOT TO SCALE)

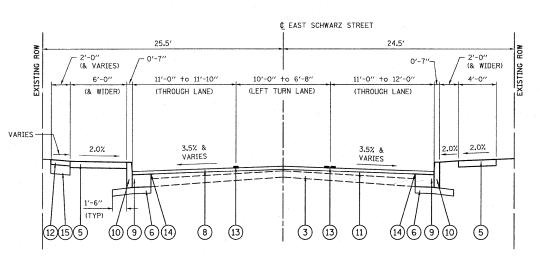

PROPOSED EAST SCHWARZ STREET STA. 101+63.41 to STA. 101+88.21 (NOT TO SCALE)

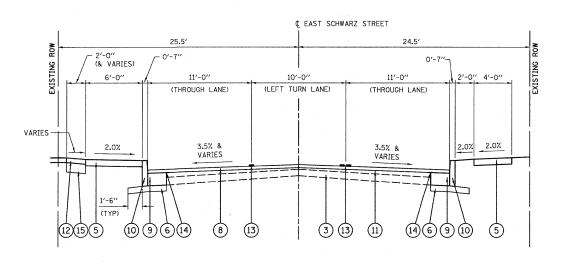

PROPOSED EAST SCHWARZ STREET STA. 101+22.47 to STA. 101+63.41

										· · · · · · · · · · · · · · · · · · ·		
FILE NAME =	USER NAME = \$USER\$	DESIGNED -	TLC	REVISED -					F.A.U.	SECTION	COUNTY	TOTAL SHEET
H:\P\26050\Microstation V8\650_typicals.c	lgn	DRAWN -	TGV	REVISED -	 STATE OF ILLINOIS	TYPICAL SECTIONS 8878 06-00097-00-PV MADISON 16 4					16 4	
	PLOT SCALE = 20.00000 '/ IN.	CHECKED -	AJG	REVISED -	 DEPARTMENT OF TRANSPORTATION				ļ	ARZ ST. INT. IMPROVEMENTS		T NO. 97333
	PLOT DATE = 2/25/2008	DATE -	12/20/07	REVISED -		SCALE: N.T.S.	SHEET NO. 1 OF 1 SHEETS	STA. 100+18.44 TO STA. 102+38.41				CMM-5011 (228)

PAVEMENT SCHEDULE

			SUB GRAN	PCC BASE	BIT MATLS	AGG	HMASC	HMA SURF	STRIP REF
STATION	STATION	OFFSET	MAT A 4	CSE W 10	PR CT	PRCT	"C" N70	REM VAR DP	CR CON TR
			31100300 (SQ YD)	35400500 (SQ YD)	40600100 (GALLON)	40600300 (TON)	40603315 (TON)	44000198 (SQ YD)	44300200 (FOOT)
100+19.01	102+32.48	RT	59	49					227
100+18.49	102+26.82	LT	45	33					217
100+18.01	102+38.41				59	2	86	698	
TOTAL			104	82	59	2	86	698	444

PAVEMENT NOTES:

1. HMA SURFACE COURSE "C" N70 QUANTITY IS CALCULATED AT A RATE OF 112 LB / SQ YD/INCH.

SIDEWALK SCHEDULE

			PC CONC	DETECTABLE	PCC CONC	SIDEWALK
STATION	STATION	OFFSET	SIDEWALK 4	WARNINGS	SIDEWALK	REM
			(NOTE 1)	(NOTE 2)	6 SP	
			42400100	42400800	42400440	44000600
			(SQ FT)	(SQ FT)	(SQ FT)	(SQFT)
100+19.04	101+78.61	LT	1,221	16	89	1,295
100+19.60	101+78.66	RT	508	20	200	655
101+97.17	102+01.56	RT		8	22	22
102+01.75	102+08.75	LT		8	39	28
TOTAL			1,729	52	350	2,000

SIDEWALK NOTES:

- NOTES:
 SIDEWALK RAMPS ACCESSIBLE TO THE DISABLED ARE REQUIRED, AND SHALL BE PAID FOR AS PCC CONCRETE SIDEWALK, 6" SPECIAL. CURB FOR SIDEWALK RAMPS SHALL BE INCLUDED IN THIS QUANTITY. SEE HIGHWAY STANDARD 424001 FOR SIDEWALK RAMP DETAILS. DETECTABLE WARNING MATERIAL SHALL BE RED, PRECAST CONCRETE WITH TRUNCATED DOMES.

CURB & GUTTER SCHEDULE

COILD	3 OO 1 1			
STATION	STATION	OFFSET	CURB REM	CONC CURB TB
			44000300 (FOOT)	60600605 (FOOT)
E. SCHWARZ	STREET			
100+18.32	101+79.19	LT	155	177
100+19.01	101+79.16	RT	167	174
101+97.31	102+38.41	RT	39	47
102+02.11	102+38.41	LT	37	44
TOTAL		<u> </u>	398	442

- CURB AND GUTTER NOTES:

 1. PROPOSED CURB & GUTTER SHALL BE WARPED TO MATCH
 - EXISTING CURBS IN 10' LINEAL FEET (MIN.).
 - PROPOSED CURB & GUTTER JOINTS AND DETAILS SHALL CONFORM TO HIGHWAY STANDARD 606001.

ENTRANCE SCHEDULE

			ENTRANCE	ENTRANCE	ENTRANCE	EXISTING	AGG BASE	AGG TEMP	INCIDENTAL	DRIVEWAY	
STA	TION	OFFSET	TYPE	WIDTH	DEPTH	SURFACE TYPE	CSE A 6	ACCESS	HMA SURF	PAVEMENT REM	
				M.,	"D"						
(NOTE 1)				(NOTE 1)					(NOTE 2)	(NOTE 3)	
							35100500	40201000	40800050	44000200	
				(FOOT)	(FOOT)		(SQ YD)	(TON)	(TON)	(SQ YD)	
101+	-26.27	LT	C.E.	15.3	10.3	ASPHALT	. 11			11	
101+22.47	101+79.19	LT	PARKING LOT	56.7	2	ASPHALT	13		3	11	
101+	88.21	LT	ALLEY	24.1	10.9	ASPHALT	26	9	5	30	
101+88.21		RT	ALLEY	21.8	11.7	ASPHALT	22	7	4	25	
TOTAL			 				72	16	12	77	

- PRIOR TO CONSTRUCTION, THE CONTRACTOR SHALL CONTACT EACH PROPERTY OWNER AND VERIFY THE LOCATION AND WIDTH OF ALL ENTRANCES.

 INCIDENTAL HIMA SURFACING QUANTITY IS CALCULATED AT A RATE OF 112 LB / SQ YD/INCH.

 DRIVEWAY PAVEMENT REMOVAL INCLUDES CURB REMOVAL FOR ENTRANCES AT STATION 101+26.77 LT

PAVEMENT MARKING SCHEDULE

		TEMP PVT MK	WORK ZONE	THPL PVT	THPL PVT	THPL PVT	THPL PVT	THPL PVT
STATION	STATION	LINE 4	PVTMK	MK LTRS	MK LINE 4	MK LINE 6	MK LINE 12	MK LINE 24
			REM	& SYMB				
				(NOTE 1)	(NOTE 1)	(NOTE 1)	(NOTE 1)	(NOTE 1)
		70300220	70301000	78000100	78000200	78000400	78000600	78000650
		(FOOT)	(SQ FT)	(SQ FT)	(FOOT)	(FOOT)	(FOOT)	(FOOT)
100+18.45	100+26.95					73		59
100+31.70	102+38.41	534	178	47	530		21	
TOTAL		534	178	47	530	73	21	59

PAVEMENT MARKING NOTES:

SEE HIGHWAY STANDARD 780001 FOR PAVEMENT MARKING DETAILS.

EARTHWORK SCHEDULE

STATION	STATION	OFFSET	EARTH EXCAVATION (WIDENING) (NOTE 3) 20200500 (CU YD)	EARTH EXCAVATION ADJUSTED FOR SHRINKAGE (NOTE 1) (CU YD)	EARTHWORK BALANCE WASTE (+) OR SHORTAGE (-) (NOTE 2) (CU YD)
100+19.01	102+38.41	RT	20	15	15
100+18.32	102+38.41	LT	15	12	12
TOTAL			35	27	27

- EARTHWORK NOTES:


 1. ESTIMATED SHRINKAGE FACTOR = 25%.
 2. APPROXIMATE EARTHWORK BALANCE IS SHOWN FOR INFORMATION ONLY.
 - EARTH EXCAVTION MAY NOT BE SUITABLE FOR USE AS EMBANKMENT AND SHALL BE REMOVED FROM THE RIGHT-OF-WAY. THE CITY RESERVES THE RIGHT TO EVALUATE BE REMOVED FROM THE RIGHT-OF-WAY. THE CITY RESERVES THE RIGHT TO EVALUATE EXCAVATED MATERIAL TO DETERMINE IF IT IS SUITABLE FOR EMBANKMENT (SEE SPECIAL PROVISIONS). AN APPROXIMATE EARTH-WORK BALANCE AND QUANTITY IS SHOWN FOR INFORMATION ONLY.

 ALL EARTH SURFACES SHALL BE COVERED WITH AT LEAST 4" OF CLEAN EARTH MATERIAL.

FILE NAME =	USER NAME = \$USER\$	DESIGNED -	TLC	REVISED
H:\P\26050\M1crostation V8\650sq01.dgn		DRAWN -	TGV	REVISED
	PLOT SCALE = 20.00000 '/ IN.	CHECKED -	AJG	REVISED
	PLOT DATE = 2/25/2008	DATE -	12/20/07	REVISED

STATE OF ILLINOIS **DEPARTMENT OF TRANSPORTATION**

COULDING OF CHARTETICS	F.A.U. RTE.	SECTION	COUNTY TOTAL SHEETS		SHEET NO.
SCHEDULE OF QUANTITIES	8878	06-00097-00-PV	MADISON	16	5
	E. SCH	WARZ ST. INT. IMPROVEMENTS	CONTRACT NO. 97333		
SCALE: SHEET NO. 1 OF 1 SHEETS	CITY OF	F EDWARDSVILLE ILLINOIS FED.	. AID PROJECT C	MM-5011 (2	228)

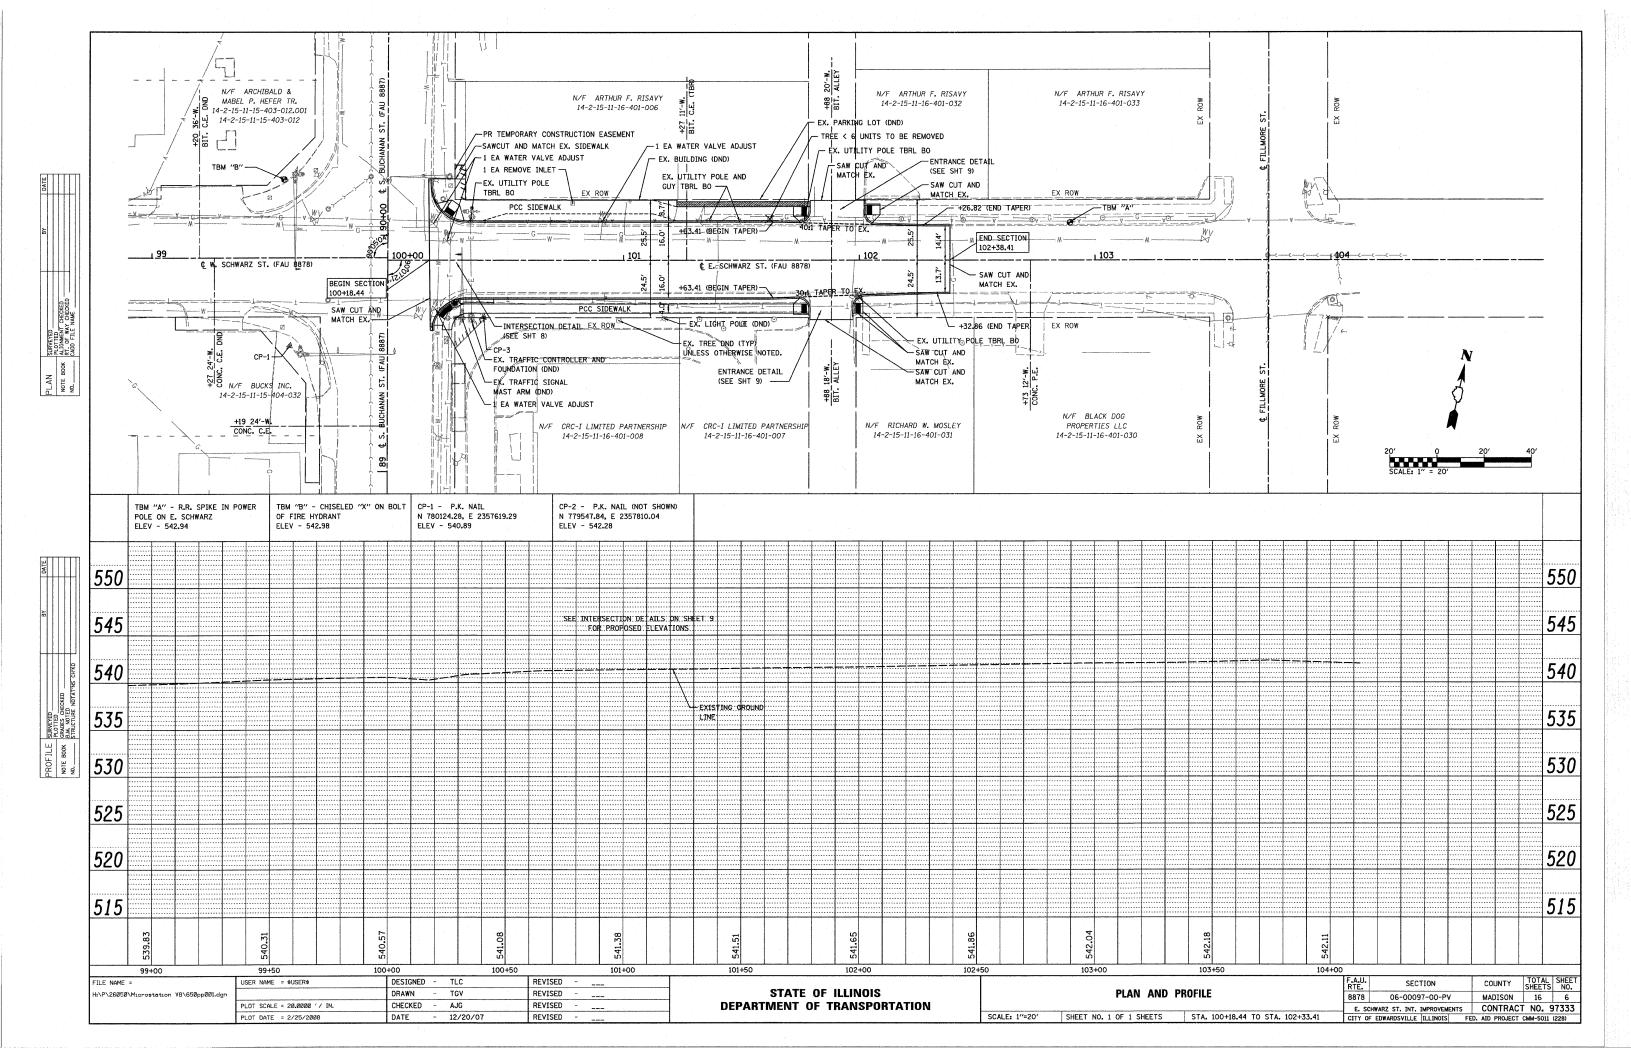

NOTES

- TYPE III BARRICADES AND ROAD CLOSURE SIGNS SHALL BE POSITIONED AS SHOWN IN ACCORDANCE WITH HIGHWAY STANDARDS.
- 2. TYPE A LOW INTENSITY FLASHING AND WARNING LIGHTS SHALL BE USED ON EACH SIGN IN ADVANCE OF THE WORK DURING HOURS OF DARKNESS.
- 3. ALL WARNING SIGNS SHALL BE A MINIMUM OF 48" X 48' AND HAVE A BLACK LEGEND AND BORDER ON A FLOURESCENT ORANGE REFLECTORIZED BACKGROUD.
- 4. LONGITUDINAL DISTANCES MAY BE ADJUSTED TO FIT FIELD CONDITIONS.
- 5. ALL TYPE III BARRICADES UTILIZED FOR ROAD CLOSURES SHALL HAVE A LOW INTENSITY FLASHING LIGHT MOUNTED ON TOP OF EACH BARRICADE.
- 6. ALL RESIDENTS/BUSINESSES FRONTING THE PROJECT SHALL BE NOTIFIED AT LEAST 48 HOURS PRIOR TO ROAD CLOSURES AFFECTING THEIR ACCESS.
- 7. SEE HIGHWAY STANDARD 701701 FOR LEFT TURN LANE CLOSURE ON S. BUCHANAN STREET.
- 8. SEE HIGHWAY STANDARD 701801 FOR CROSSWALK OR SIDEWALK CLOSURES.

SEQUENCE OF CONSTRUCTION


- 1. ERECT TRAFFIC CONTROL MEASURES
- 2. CLOSE E. SCHWARZ STREET FROM S. BUCHANAN STREET TO THE ALLEY EAST OF SWING CITY MUSIC / JACK-IN-THE-BOX, LEAVING THE ALLEY OPEN TO LOCAL TRAFFIC
- PERFORM REMOVAL OPERATIONS, ROADSIDE RECONSTRUCTION, AND TRAFFIC SIGNAL WORK.
- 4. CLOSE THE ALLEY, MOVE BARRIER TO EASTERN PROJECT LIMITS FOR ONE CALENDAR DAY AND PERFORM PAVING OPERATIONS. NOTIFY ADJACENT BUSINESSES AT LEAST 48 HOURS PRIOR TO THIS WORK.
- 5. E. SCHWARZ STREET MAY BE OPENED TO THRU TRAFFIC UPON COMPLETION OF PAVING OPERATIONS.
- PAVEMENT MARKINGS AND CLEAN-UP WORK MAY BE DONE UNDER TRAFFIC, USING PROPER TRAFFIC CONTROL MEASURES.


LEGEND

	WORK AREA
þ	SIGN ON PORTABLE OR PERMANENT SUPPORT
-P	TYPE III BARRICADES WITH FLASHING LIGHTS
1>	ROAD CONSTRUCTION AHEAD W20-1(0)
⟨2⟩	ROAD CLOSED AHEAD W20-3(0)
3	LEFT TURN LANE CLOSED AHEAD W20-1103(0)
4	WORKERS W21-1a(0), AS NEEDED PER STANDARDS
5	24" X 24"
6	24" X 24"
[7]	TYPE III BARRICADES W/ $R-11-4-6030$ (ROAD CLOSED TO THRU TRAFFIC SIGNS AND TYPE A LOW INTENSITY FLASHING LIGHTS)



FILE NAME =	USER NAME = \$USER\$	DESIGNED - TLC	REVISED	ATATE OF ULUMA		F.A.U. SECTION	COUNTY TOTAL SHEET SHEETS NO.
H:\P\26050\Microstation V8\650trafficco	trolplan.dgn	DRAWN - TGV	REVISED	STATE OF ILLINOIS	TRAFFIC CONTROL AND PROTECTION	8878 06-00097-00-PV	MADISON 16 7
	PLOT SCALE = 20.00000 '/ IN.	CHECKED - AJG	REVISED	DEPARTMENT OF TRANSPORTATION		E. SCHWARZ ST. INT. IMPROVEMENTS	CONTRACT NO. 97333
	PLOT DATE = 2/25/2008	DATE - 12/20/07	REVISED		SCALE: N.T.S. SHEET NO. 1 OF 1 SHEETS	CITY OF EDWARDSVILLE ILLINOIS F	ED. AID PROJECT CMM-5011 (228)

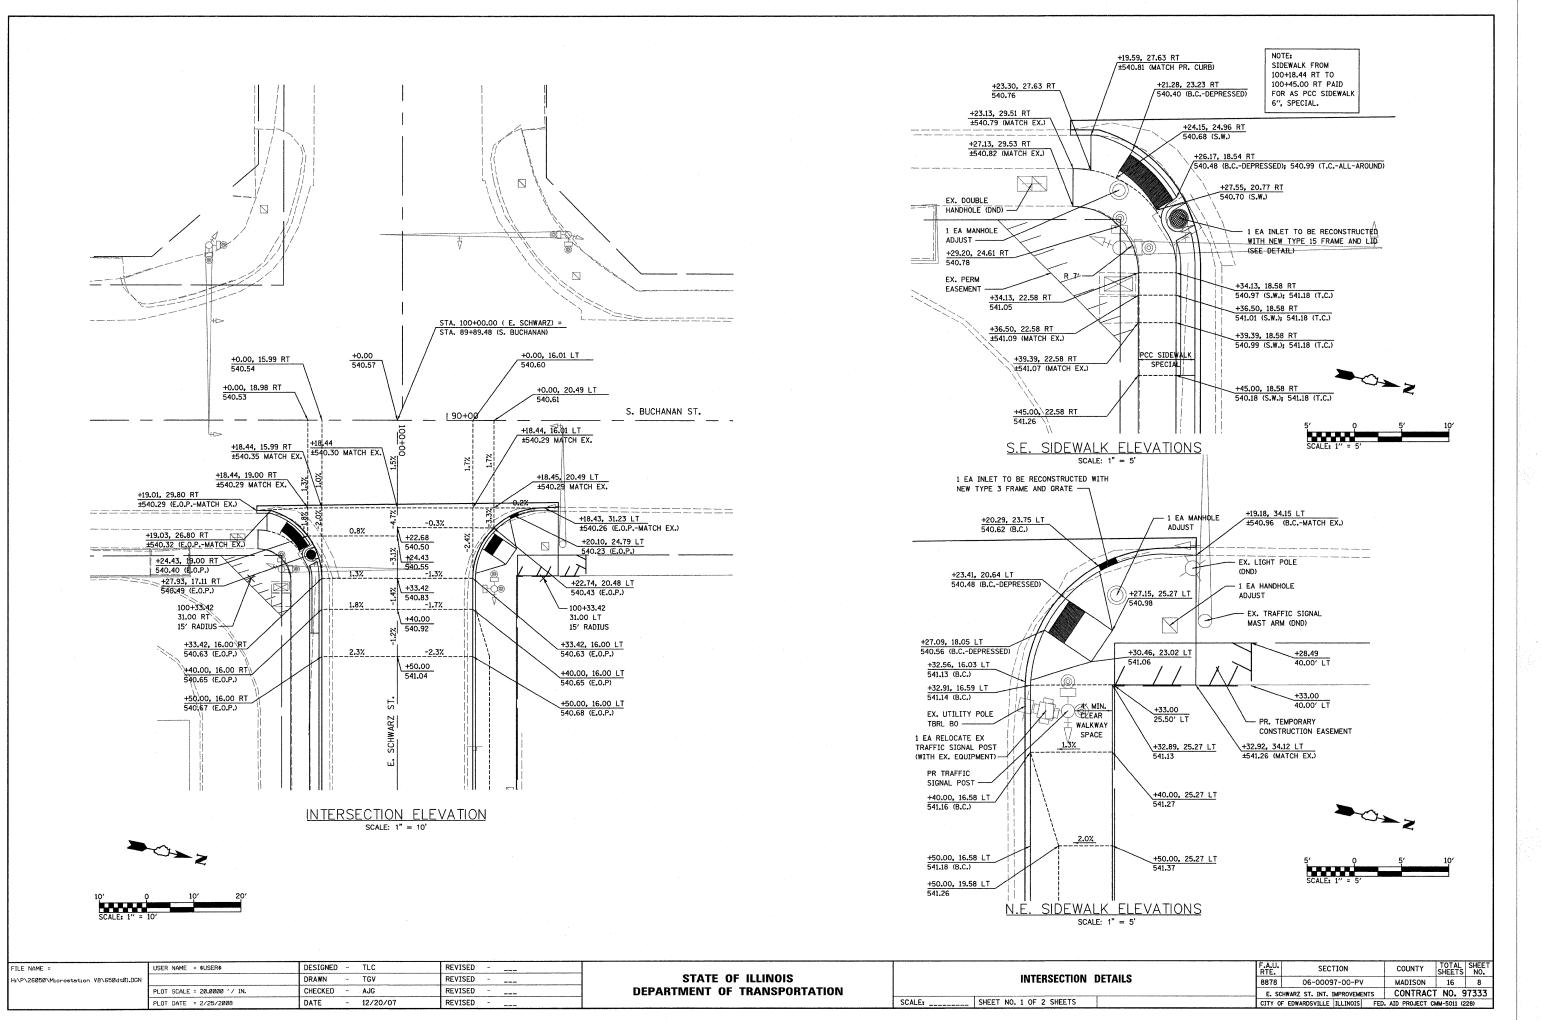

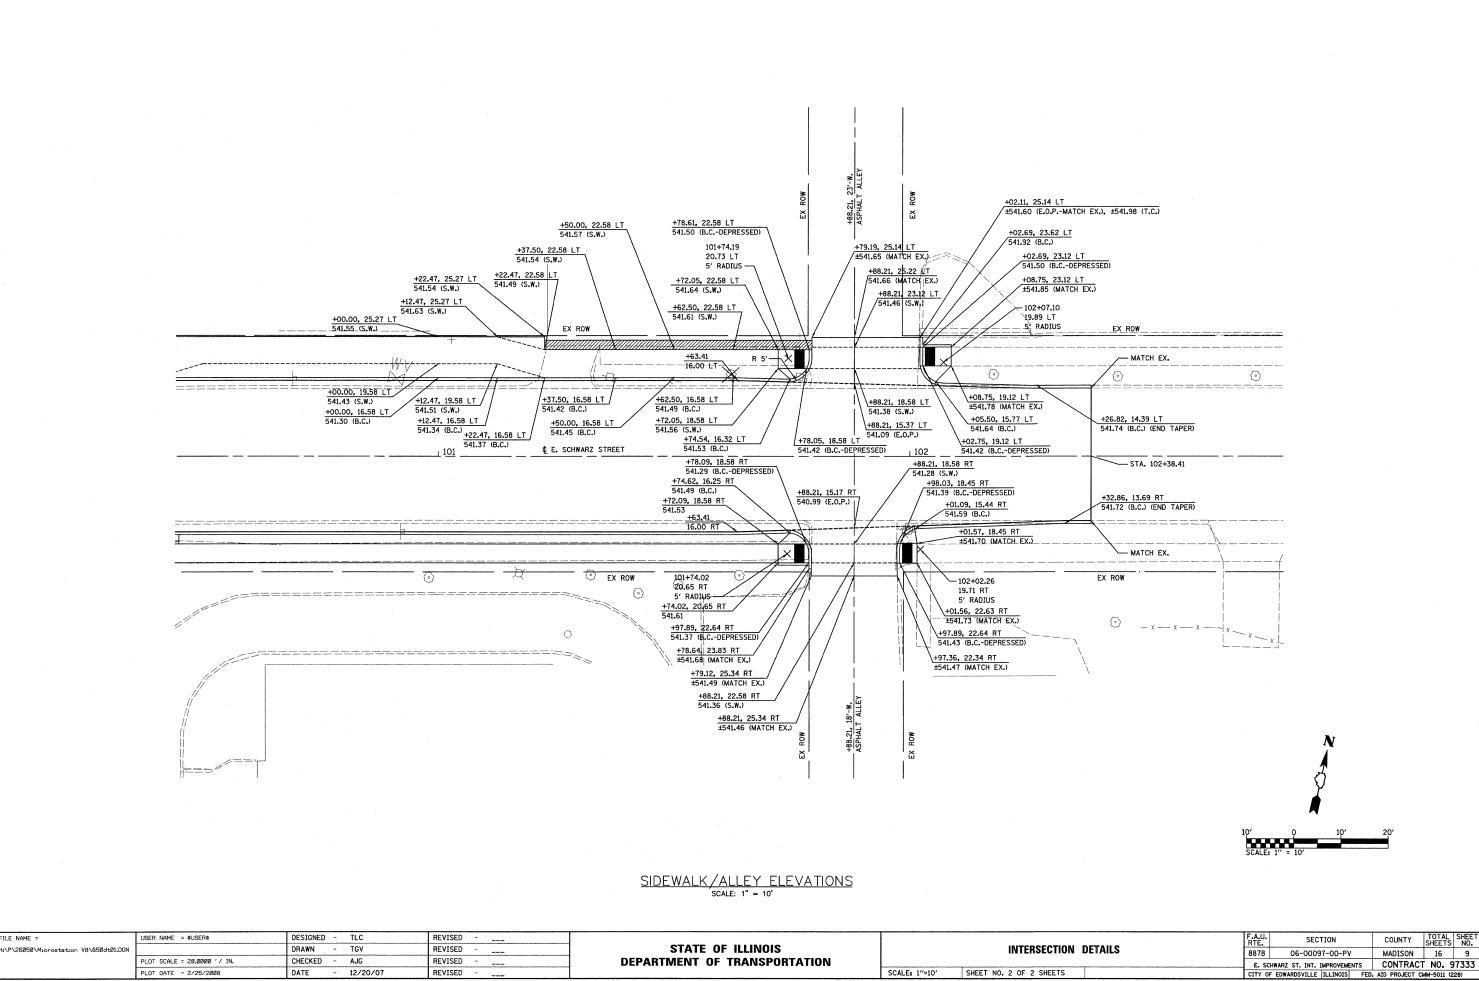

SCALE: 1"=10"


SHEET NO. 2 OF 2 SHEETS


PLOT DATE = 2/25/2008


- 12/20/07

REVISED



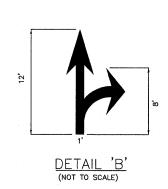


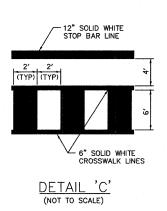


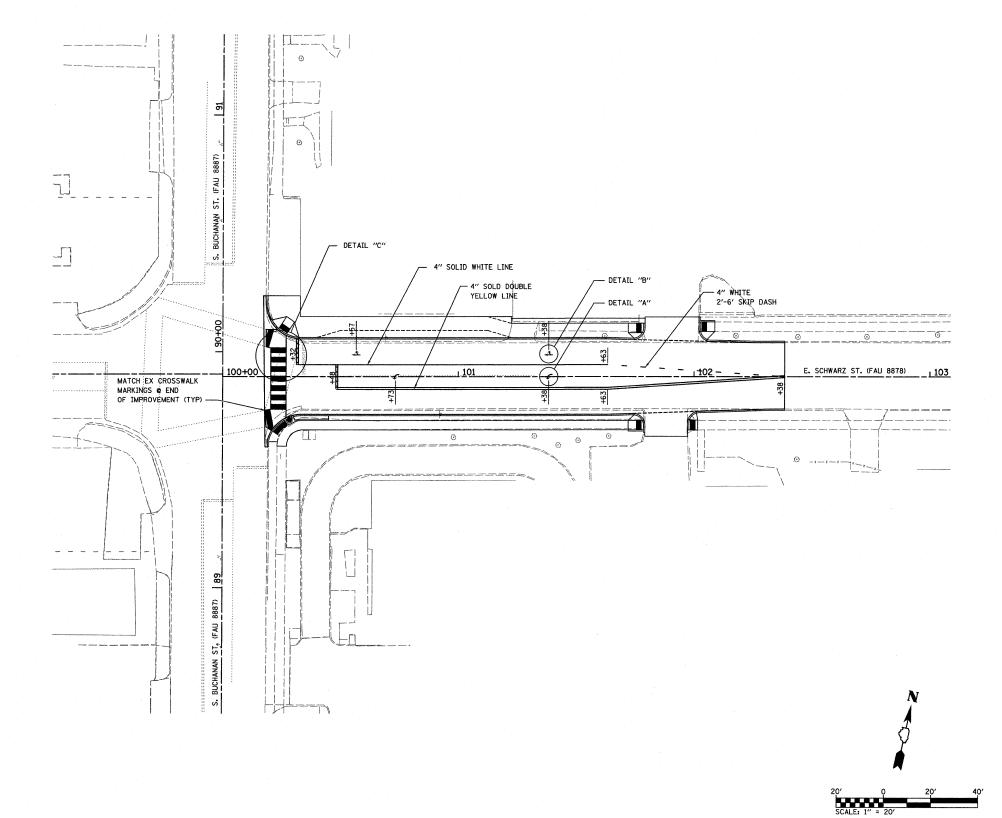

NOTE: ALL EXISTING PAVEMENT MARKINGS THAT CONFLICT WITH PROPOSED PAVEMENT MARKINGS SHALL BE REMOVED

FILE NAME =	USER NAME = \$USER\$	DESIGNED - TLC	REVISED			F.A.U. SECTION	COUNTY TOTAL SHEET
H:\P\26050\Microstation V8\650pm01.DGN		DRAWN - TGV	REVISED	STATE OF ILLINOIS	PAVEMENT MARKINGS	8878 06-00097-00-PV	MADISON 16 10
	PLOT SCALE = 20.0000 '/ IN.	CHECKED - AJG	REVISED	DEPARTMENT OF TRANSPORTATION		E. SCHWARZ ST. INT. IMPROVEMENTS	CONTRACT NO. 97333
	PLOT DATE = 2/25/2008	DATE - 12/20/07	REVISED		SCALE: 1"=20' SHEET NO. 1 OF 1 SHEETS STA. 100+18.44 TO STA. 102+38.41		D. AID PROJECT CMM-5011 (228)

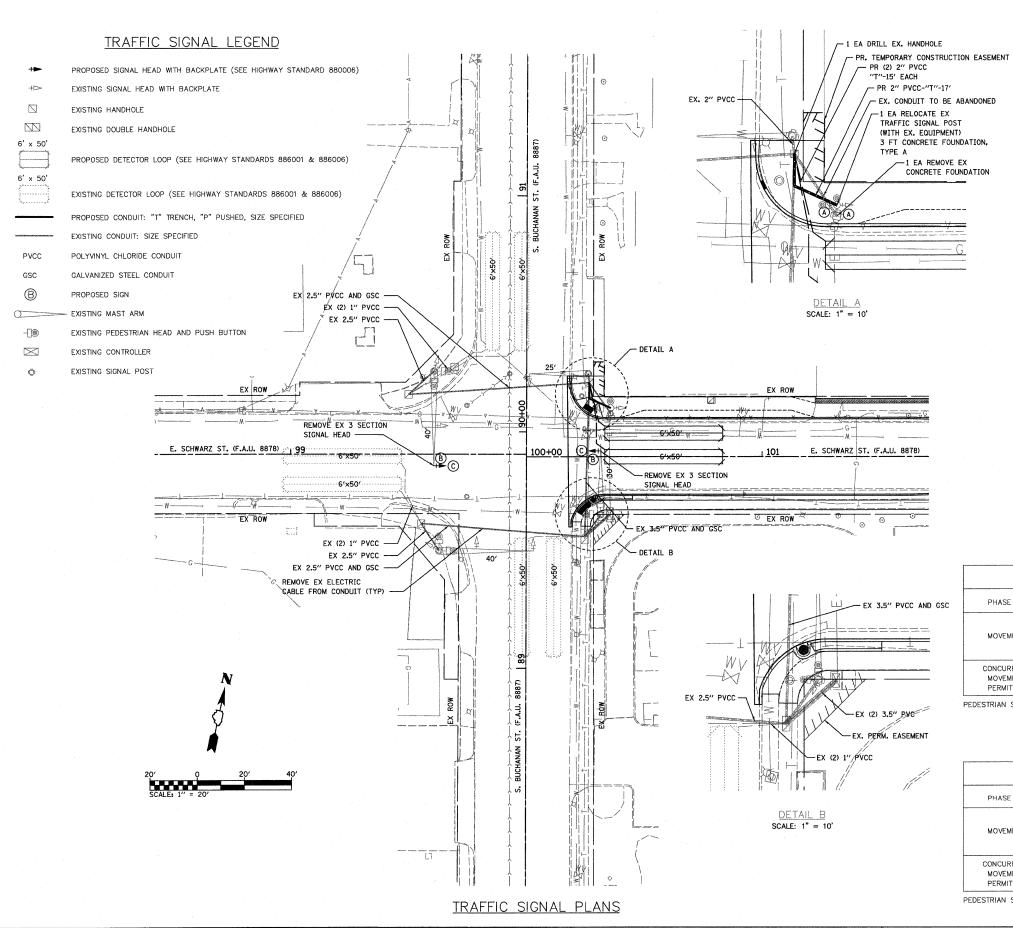

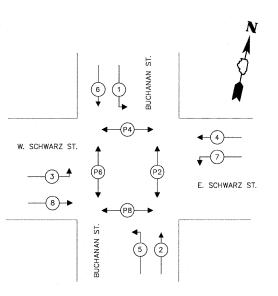

PHASE DESIGNATION DIAGRAM

EXISTING SEQUENCE OF OPERATIONS

	EXISTING	FULL-ACT	UATED CON	ITROLLER A	ND TYPE I	V CABINET		
PHASE Ø	1	2	3	4	5	6	7	8
MOVEMENT	SB LT	↑ ↓ ↓ NB	NOT USED	₩ B	NB LT	\$B	NOT USED	←→ EB
CONCURRENT MOVEMENT PERMITTED	5 OR 6	5 OR 6		8	1 OR .2	1 OR 2		4


PEDESTRIAN SIGNALS BY PUSH BUTTON OPERATION ONLY

PROPOSED SEQUENCE OF OPERATIONS

M	IODIFY EXIS	TING FULL-	ACTUATED	CONTROLLE	ER AND TYP	PE IV CABIN	NET	
PHASE Ø	1	2	3	4	5	6	7	8
MOVEMENT	SB LT	↑ ↓ NB	EB LT	★> WB	NB LT	SB	₩B LT	—— → EB
CONCURRENT MOVEMENT PERMITTED	5 OR 6	5 OR 6	7 OR 8	7 OR 8	1 OR 2	1 OR 2	3 OR 4	3 OR 4


PEDESTRIAN SIGNALS BY PUSH BUTTON OPERATION ONLY

FILE NAME =	USER NAME = \$USER\$	DESIGNED - TLC	REVISED			TRAFFIC SIGNAL PLANS			SECTION	COUNTY	TOTAL SHEET SHEETS NO.
H:\P\26050\Microstation V8\650sg001.dgn	· ·	DRAWN - TGV	REVISED	STATE OF ILLINOIS					06-00097-00-PV	MADISON	16 11
	PLOT SCALE = 20.0000 '/ IN.	CHECKED - AJG	REVISED	DEPARTMENT OF TRANSPORTATION						CT NO. 97333	
PLO.	PLOT DATE = 2/25/2008	DATE - 12/20/07	REVISED	S	SCALE: 1"=20'	SHEET NO. 1 OF 3 SHEETS		CITY OF	EDWARDSVILLE ILLINOIS FE	D. AID PROJECT	

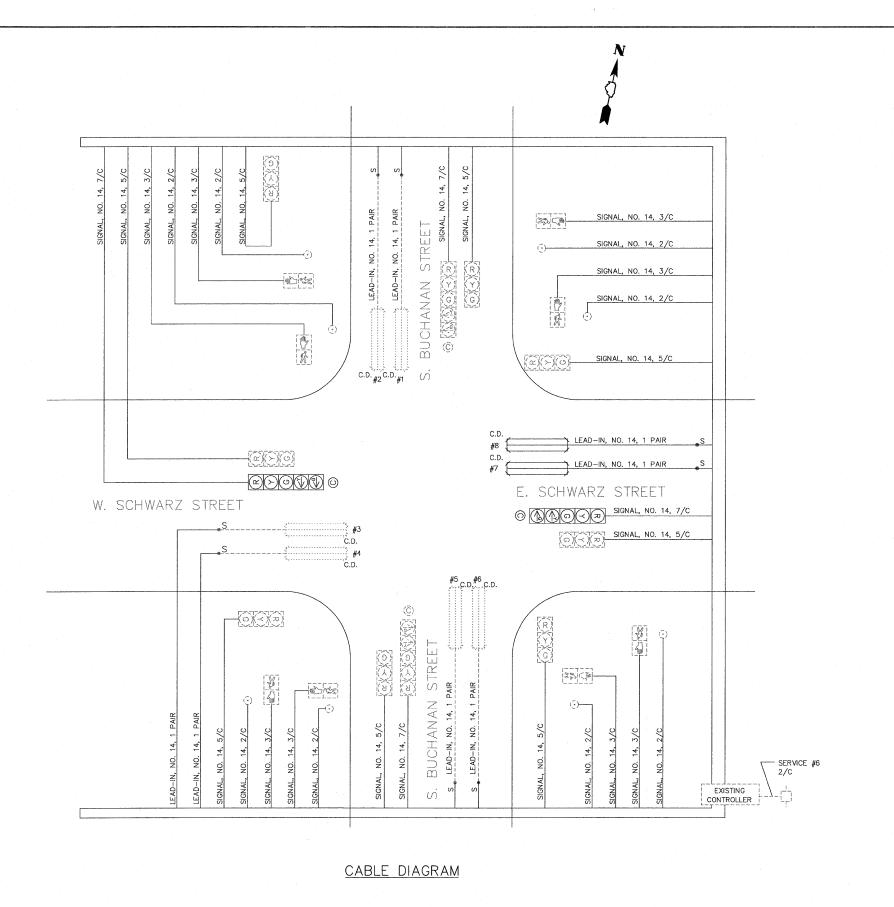

12"
R
R
R
PEDESTRIAN
SIGNAL
FACES
ALL
OTHERS

EXISTING TRAFFIC SIGNAL FACES

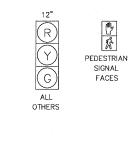

PROPOSED TRAFFIC SIGNAL FACES

CABLE DIAGRAM LEGEND

PROPOSED ELECTRIC CABLE IN CONDUIT

PROPOSED CABLE SPLICE (SEE ELECTRICAL GENERAL NOTES)

2/C INDICATES NUMBER OF CONDUCTORS IN CABLE

C.D. CALL DELAY (SEE ELECTRICAL GENERAL NOTES)

NO. 6 INDICATES AMERICAN WIRE (AWG) SIZE 6

#6 LOOP DETECTOR NUMBER

PROPOSED PEDESTRIAN PUSH BUTTON

- EXISTING ELECTRIC CABLE IN CONDUIT

____S EXISTING CABLE SPLICE (SEE ELECTRICAL GENERAL NOTES)

EXISTING PEDESTRIAN PUSH BUTTON

- EXISTING SERVICE INSTALLATION

BUCHANAN STREET @ SCHWARZ STREET DIRECTION LOOP SIZE REQUIRED CALCULATED CALCULATED NUMBER LENGTH INDUCTANCE RESISTANCE (ohms) 6' X 50' 6' X 50' EB LT EB RT / THRU 6' X 50' 6' X 50' 6' X 50' NB LT NB RT / THRU 6' X 50' 6' X 50' WB LT WB RT / THRU 6' X 50' 132 2.25

THE ABOVE VALUES ARE CALCULATIONS OF COMBINED LOOP AND LEAD-IN INDUCTANCE AND RESISTANCE. ACTUAL MEASURED VALUES SHOULD BE WITHIN 20% OF THESE VALUES.

				·			
FILE NAME =	USER NAME = \$USER\$	DESIGNED - TLC	REVISED			F.A.U. SECTION	COUNTY TOTAL SHEET
H:\P\26050\Microstation V8\650sg001.dgr		DRAWN - TGV	REVISED	STATE OF ILLINOIS	TRAFFIC SIGNAL PLANS	8878 06-00097-00-PV	MADISON 16 12
	PLOT SCALE = 20.0000 '/ IN.	CHECKED - AJG	REVISED	DEPARTMENT OF TRANSPORTATION		E. SCHWARZ ST. INT. IMPROVEMENTS	
	PLOT DATE = 2/26/2008	DATE - 12/20/07	REVISED		SCALE: N.T.S. SHEET NO. 2 OF 3 SHEETS	CITY OF EDWARDSVILLE ILLINOIS	FED. AID PROJECT CMM-5011 (228)

ELECTRICAL GENERAL NOTES

- ALL SIGNAL HEADS SHALL BE POLYCARBONATE AND SHALL HAVE 12" LENSES. MOUNTING HARDWARE SHALL BE PAINTED BLACK ALLWINUM. ALL BOLTS, SCREWS, NUTS AND WASHERS SHALL BE STAINLESS STEEL. ANTI-SIEZE PASTE COMPOUND SHALL BE USED ON ALL MOUNTING HARDWARE FIELD CONNECTIONS.
- 2. BACKPLATES SHALL BE ABS PLASTIC.
- 3. THE LOCATION OF THE SIGNAL POSTS SHALL BE APPROVED BY THE ENGINEER BEFORE FOUNDATIONS ARE CONSTRUCTED. IN CURBED SECTIONS, THE SIGNAL POSTS SHALL BE LOCATED A MINIMUM OF FIVE (5) FEET FROM THE FACE OF THE CURB. THESE DISTANCES ARE TO THE NEAR FACE OF THE SIGNAL POST.
- 4. ALL TRAFFIC SIGNAL CABLE SHALL BE #14 AWG STRANDED COPPER UNLESS OTHERWISE SPECIFIED.
- 5. ALL PROPOSED CONDUIT SHALL BE PVC UNLESS NOTED OTHERWISE. ALL CONDUIT SHALL BE PLACED AND BACKFILLED PRIOR TO CONSTRUCTION OF NEW PAVEMENT, SHOULDER AND CURB. NO ADDITIONAL COMPENSATION WILL BE ALLOWED FOR PUSHING CONDUIT AFTER SUCH WORK HAS BEEN COMPLETED.
- THE LOCATION OF ALL DETECTOR LOOPS SHALL BE APPROVED BY THE ENGINEER BEFORE ANY SLOTS ARE SAWED IN THE PAVEMENT. THE SLOTS SHALL BE CUIT IN THE MILLED SURFACE. NO SLOTS IN THE ASPHALT SURFACE WILL BE ALLOWED.
- 7. DETECTOR LOOP LEAD—IN SPLICES SHALL BE MADE IN A HANDHOLE PER SECTION 873 OF THE "STANDARD SPECIFICATIONS FOR ROAD AND BRIDGE CONSTRUCTION". CONDUCTORS SHALL BE SPLICED IN A RIGID MOLD FILLED WITH NON—HARDENING EPOXY FILLER. RESIN CORE SOLDER SHALL BE USED.
- 8. CALL DELAY SHALL NOT FUNCTION WHEN THE RELATED PHASES ARE IN THE GREEN MODE.
- 9. ALL INDUCTION LOOP DETECTOR AMPLIFIERS SUPPLIED FOR THIS INTERSECTION SHALL BE RACK MOUNTED AND SHALL HAVE THE CAPACITY OF OPERATING WITH BOTH DELAY AND EXTENSION MODES ACTIVE, IF A TIME SETTING IS PROGRAMMED.
- 10. ALL UTILITIES SHALL BE LOCATED IN THE FIELD PRIOR TO ANY ATTEMPT TO CONSTRUCT ANY COMPONENT OF THE VARIOUS TRAFFIC SIGNAL INSTALLATIONS. AGENCIES KNOWN TO HAVE FACILITIES WITHIN THE LIMITS OF THIS IMPROVEMENT ARE THE FOLLOWING:


AMEREN IP (GAS & ELECTRIC) AT&T (TELEPHONE) CHARTER COMMUNICATIONS (CABLE TV) CITY OF EDWARDSVILLE (WATER, SEWER & TRAFFIC SIGNALS)

THE LOCATION OF EXISTING UTILITIES AS SHOWN ON THE PLANS HAVE BEEN LOCATED AT THE TIME OF SURVEY, OR BASED ON AVAILABLE EXISTING INFORMATION. NO GUARANTEE IS IMPLIED THAT ALL UTILITIES HAVE BEEN LOCATED OR DEPICTED ON THE PLANS. THE CONTRACTOR SHALL BE RESPONSIBLE FOR VERIFYING THE EXACT LOCATION OF ALL UTILITIES. IT MAY BE NECESSARY TO HAND DIG TEST HOLES TO EXPOSE EXISTING UTILITIES AT SOME LOCATIONS.

- 11. SEE "JOINT UTILITY LOCATION INFORMATION FOR EXCAVATORS" (JULIE) IN THE SPECIAL PROVISIONS. CALL (800) 892-0123 48 HOURS BEFORE PLANNING TO DIG.
- 12. CONDUIT SPLICES WILL NOT BE PAID FOR SEPARATELY, BUT SHALL BE CONSIDERED PART OF THE NEW CONDUIT INSTALLATION.
- SEE SPECIAL PROVISIONS FOR TRAFFIC CONTROL AND CONSTRUCTION STAGING REQUIREMENTS.
- 14. THE LOCATION OF SIGNAL HEADS ON MAST ARMS SHALL BE APPROVED BY THE ENGINEER BEFORE THEY ARE INSTALLED.
- SLOPE HANDHOLE COVERS TO MATCH PROPOSED GRADE ELEVATIONS.
 WHEN CUTTING PROPOSED DETECTOR LOOPS, THE CONTRACTOR SHALL CONTROL DUST SO THAT DUST DOES NOT BECOME AIRBORNE AND BLOW ONTO PRIVATE PROPERTY.
- 17. THE CONTRACTOR SHALL TOUCH—UP EXISTING BLACK PAINTED SIGNAL POSTS, MAST ARMS, AND MOUNTABLE HARDWARE DAMAGED BY CONSTRUCTION OPERATIONS.


TRAFFIC SIGNAL QUANTITIES

CODE NO.	ODE NO. ITEM		TOTAL QUANTITIES	
72000100	SIGN PANEL - TYPE 1	SQFT	10	
72000105	SIGN PANEL - TYPE 1 (SPECIAL)	SQFT	2	
81012600	CONDUIT IN TRENCH, 2" DIA., PVC	FOOT	47	
81400115	HANDHOLE TO BE ADJUSTED	EACH	1	
81900200	TRENCH AND BACKFILL FOR ELECTRICAL WORK	FOOT	47	
87301215	ELECTRIC CABLE IN CONDUIT, SIGNAL NO. 14 2C	FOOT	1,030	
87301225	ELECTRIC CABLE IN CONDUIT, SIGNAL NO. 14 3C	FOOT	1,086	
87301245	ELECTRIC CABLE IN CONDUIT, SIGNAL NO. 14 5C	FOOT	1,157	
87301255	ELECTRIC CABLE IN CONDUIT, SIGNAL NO. 14 7C	FOOT	690	
87301305	ELECTRIC CABLE IN CONDUIT, LEAD-IN, NO. 14 1 PAIR	FOOT	846	
87800100	CONCRETE FOUNDATION, TYPE A	FOOT	3	
87900200	DRILL EXISTING HANDHOLE	EACH	1	
88040160	SIGNAL HEAD, POLYCARBONATE, LED, 1-FACE, 5- SECTION, MAST ARM MOUNTED	EACH	2	
88200100	TRAFFIC SIGNAL BACKPLATE	EACH	2	
88500100	INDUCTIVE LOOP DETECTOR	EACH	2	
88600100	DETECTOR LOOP, TYPE I	FOOT	374	
89501150	RELOCATE EXISTING TRAFFIC SIGNAL POST	EACH	1	
89502200	MODIFY EXISTING CONTROLLER	EACH	1	
89502300	REMOVE ELECTRIC CABLE FROM CONDUIT	FOOT	4,809	
89502375	REMOVE EXISTING TRAFFIC SIGNAL EQUIPMENT	EACH	1	
89502385	REMOVE EXISTING CONCRETE FOUNDATION	EACH	1	
XX005431	LOCATING UNDERGROUND UTILITY	EACH	100	

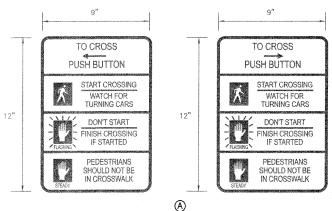

FURNISH & INSTALL TWO (2) EACH SIGNS

DETAIL OF
SIGN PANEL — TYPE 1 (SPECIAL)
(NOT TO SCALE)

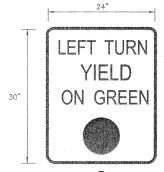


B
FURNISH & INSTALL TWO (2) EACH SIGNS
R10-12
MOUNT SIGNS ON THE MAST ARMS, 2'-8" FROM THE CENTER
OF THE SIGN TO THE CENTER OF THE 5-SECTION SIGNAL
HEAD. (8" SPACING BETWEEN THE EDGE OF THE SIGN AND
THE EDGE OF THE SIGNAL HEAD BACK PLATE)

DETAIL OF SIGN PANEL — TYPE 1 (NOT TO SCALE)

FILE NAME =	USER NAME = \$USER\$	DESIGNED	-	TLC	REVISED	-	
H:\P\26050\Microstation V8\650sg001.dgn		DRAWN	-	TGV	REVISED	-	
	PLOT SCALE = 20.00000 '/ IN.	CHECKED	-	AJG	REVISED	-	
	PLOT DATE = 2/25/2008	DATE	-	12/20/07	REVISED	-	


STATE	0F	ILLINOIS
DEPARTMENT (OF 1	TRANSPORTATION

		F.A.U. SECTION		COUNTY	TOTAL SHEETS	TOTAL SHEE SHEETS NO.	
TRAFFIC SIGNAL PLANS			8878	06-00097-00-PV	MADISON	16	13
			E. SCI	HWARZ ST. INT. IMPROVEMENTS	CONTRAC	T NO. 9	7333
SCALE:	SHEET NO. 3 OF 3 SHEETS		CITY O	F EDWARDSVILLE ILLINOIS FE	D. AID PROJECT	CMM-5011 ((228)

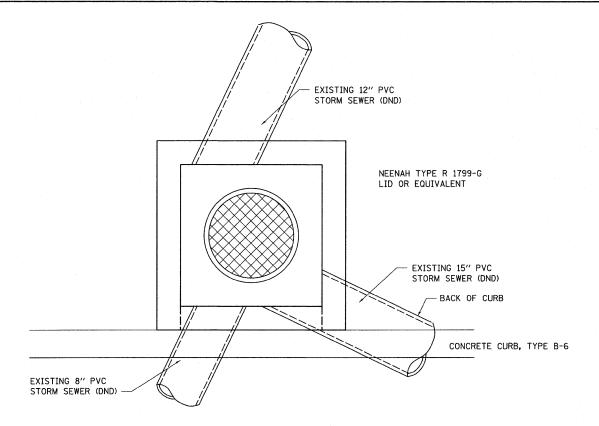


EXISTING PLAN VIEW

NOT TO SCALE

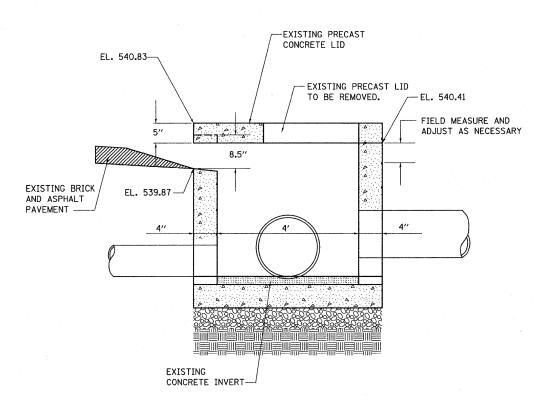


EXISTING SIDE VIEW

NOT TO SCALE

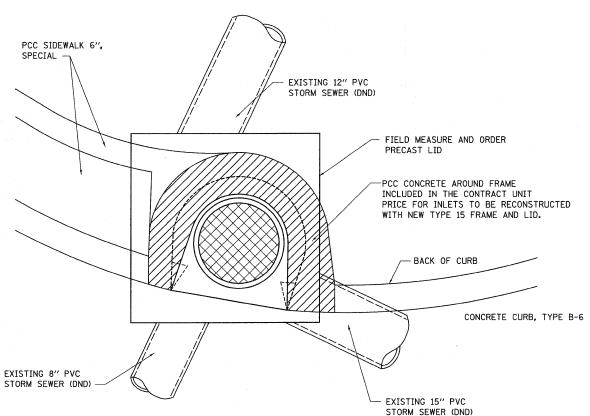

PROPOSED PLAN VIEW

NOT TO SCALE

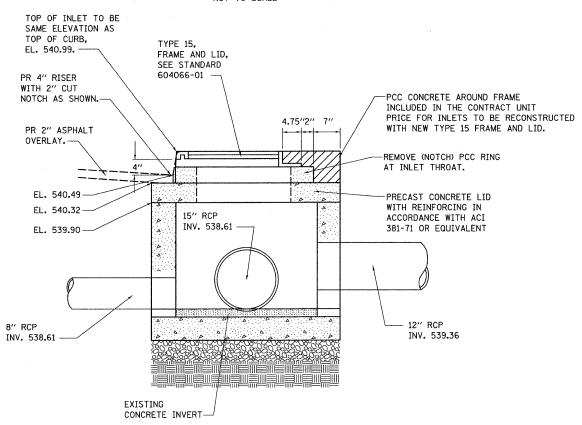

PROPOSED SIDE VIEW

NOT TO SCALE

FILE NAME =	USER NAME = \$USER\$	DESIGNED - TLC	REVISED			F.A.U. SECTION	COUNTY TOTAL SHEET NO.
H:\P\26050\Microstation V8\650dt002.dgn		DRAWN - TGV	REVISED	STATE OF ILLINOIS	DETAILS	8878 06-00097-00-PV	MADISON 16 14
	PLOT SCALE = 20.0000 '/ IN.	CHECKED - AJG	REVISED	DEPARTMENT OF TRANSPORTATION		E. SCHWARZ ST. INT. IMPROVEMENTS	CONTRACT NO. 97333
	PLOT DATE = 2/25/2008	DATE - 12/20/07	REVISED		SCALE: N.T.S. SHEET NO. 1 OF 1 SHEETS	CITY OF EDWARDSVILLE ILLINOIS	FED. AID PROJECT CMM-5011 (228)

