
CODE NO.	DESCRIPTION	UNIT	QUANTITY
80400100	ELECTRIC SERVICE INSTALLATION	LUMP SUM	1 .
81012200	CONDUIT IN TRENCH, 3/4" DIA. PVC	FOOT	317
81012600	CONDUIT IN TRENCH, 2" DIA. PVC	FOOT	205
81021330	CONDUIT PUSHED, 2" DIA. PVC	F00T	160
81300800	JUNCTION BOX, SS, ATTACH TO STRUCT., 18" X 12" X 6"	EACH	1
81400730	HANDHOLE, COMPOSITE CONCRETE	EACH	1
81603035	UNIT DUCT, 600V, 2-1C NO. 6, 1/C NO. 6 GROUND (XLP-TYPE USE), 1" DIA. POLYETHYLENE	FOOT	700
81702450	ELEC. CABLE IN CONDUIT, 600V (XLP-TYPE USE) 3 1/C #10	FOOT	1252
81900200	TRENCH AND BACKFILL FOR ELECTRICAL WORK	FOOT	1171
82500510	LIGHTING CONTROLLER TYPE CB-RCS 60 AMP 240 VOLT	EACH	1
*X0325403	CONDUIT, FLEXIBLE NON-METALLIC, WEATHERPROOF, 2"	EACH	4
*5000841	LIGHTING UNIT A, COMPLETE	EACH	6

	F.A. RTE.	SECTION		COUNTY		TOTAL	SHEE'
	I-57 00-00374-03-LS			HAMPA	AIGN	21	16
	STA. TO STA.						
Y	FED. R	OAD DIST. NO.	ILLINOIS	FED.	AID	PROJECT	

CONTRACT NO. 91382

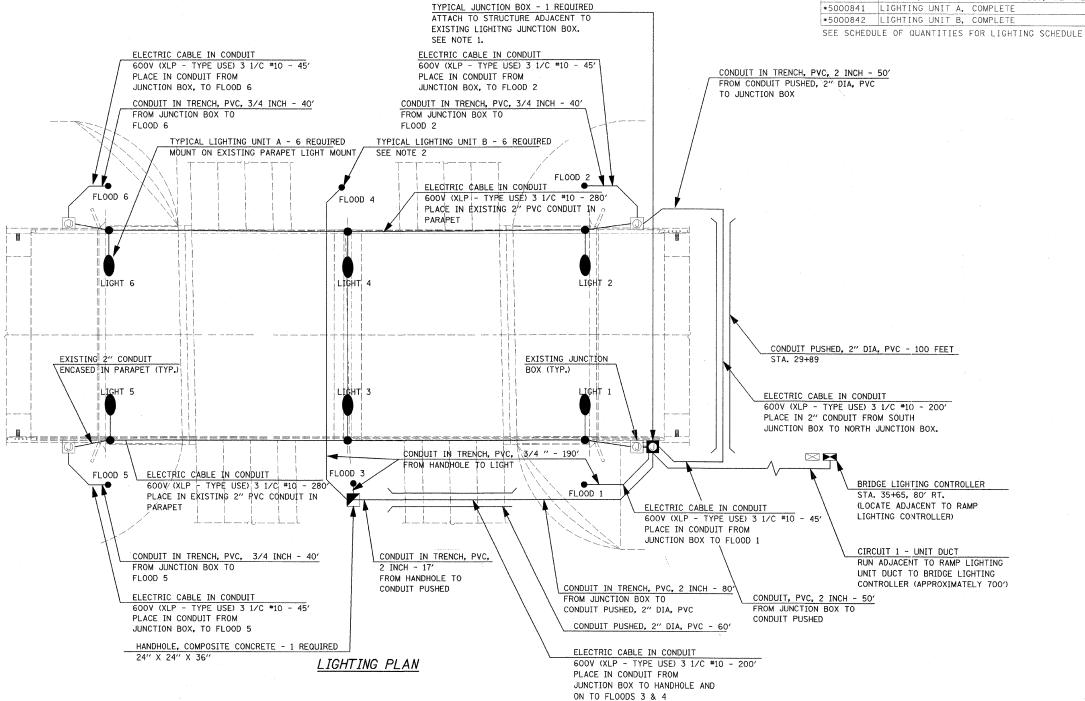

- 1. BRING CIRCUITS UP INTO JUNCTION BOX THROUGH RIGID CONDUIT IN TRENCH. CONNECT CONDUITS TO JUNCTION BOX WITH LIQUID TIGHT FLEXIBLE CONDUIT (6' MAX LENGTH) TO ACCOMODATE MOVEMENT OF PARAPET WALL WITH RESPECT TO THE CONDUIT PENETRATING THE GROUND. CONNECT JUNCTION BOXES TOGETHER WITH 2-2" NIPPLES.
- 2. COORDINATE FINAL FIXTURE LOCATION AND AIMING WITH ENGINEER IN THE FIELD. FLOODS 3 & 4 AND ASSOCIATED HANDHOLES SHALL BE OFFSET 3' FROM COLUMN CENTERLINE TO BE OUT OF DITCH FLOWLINE. LAMPS FOR FLOODS 1,2,5, & 6 SHALL BE 70W M.H. LAMPS FOR FLOODS 3 & 4 SHALL BE 100W M.H.

DESIGN FIRM REGISTRATION No. 184-000450	
118 SOUTH CLINTON STREET SUITE 600 CHICAGO, IL 60661 PHONE: 312.648.9900 FAX: 312.648.0204	

ILLINOIS DEPARTMENT OF TRANSPORTATION

LIGHTING PLAN

SCALE: As Noted DATE: 01/04/08

DRAWN BY RS CHECKED BY MTP