STATE OF ILLINOIS **DEPARTMENT OF TRANSPORTATION DIVISION OF HIGHWAYS**

PLANS FOR PROPOSED **ENHANCEMENTS**

CITY OF CHAMPAIGN **CHAMPAIGN COUNTY, ILLINOIS SECTION NO. 00-00374-03-LS** PROJECT NO. TE-00D5(85) JOB NO. C-95-327-07 CITY PROJECT NO. 22-0000-07900-0377

CURTIS ROAD BRIDGE ENHANCEMENT

ILLINOIS HIGHWAY STANDARD DRAWINGS (SEE SHEET NO. 2)

INDEX OF SHEETS

DESCRIPTION COVER SHEET

SUMMARY OF QUANTITIES

PLANTING DETAILS MATERIALS PLAN

LIGHTING PLAN

LIGHTING SCHEDULE

13 TO 15 COLUMN DETAILS

17 TO 18 LIGHTING DETAILS

20 TO 21 SOIL BORINGS

LARGE COLUMN DETAILS SMALL COLUMN DETAILS

GENERAL PLAN AND ELEVATION STRUCTURE DETAILS RAILING DETAILS MASONRY DETAILS PLANTING PLAN

HIGHWAY STANDARDS, AND GENERAL NOTES

CONTROL INSTALLATION (BASE MOUNT CASINET)


SHEET NO.

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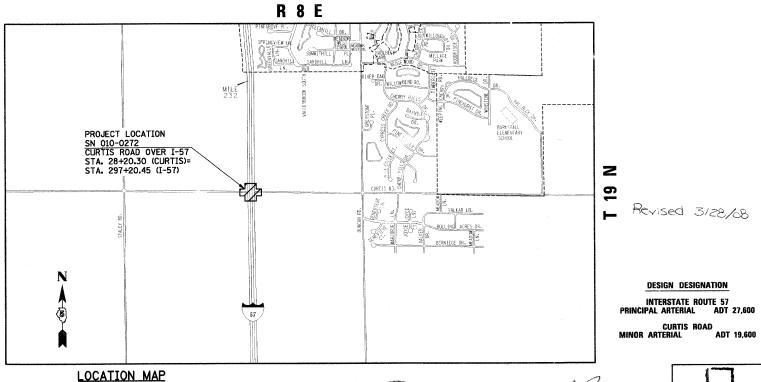
19



FNGINFFRING SCALES, REDUCED SIZED PLANS WILL NOT CONFORM TO STANDARD SCALES. IN MAKING MEASUREMENTS ON REDUCED PLANS, THE ABOVE SCALES MAY BE USED.


JOINT UTILITY LOCATION INFORMATION FOR EXCAVATION 1-800-892-0123

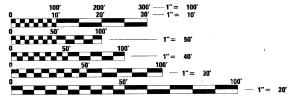CONTRACT NO. 91382



Bid Based on

LOCATION OF SECTION INDICATED THUS: --

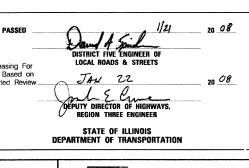

APPROVED W. Poland With Jan 11, 2008

CHAMPAIGN CITY ENGINEER



Creating Better Places



1817 SOUTH NEIL STREET SUITE 100 CHAMPAIGN, IL 61820

374-03-LS CHAMPAIGN 21 ILLINOIS F.A. PROJ. NO. + 1 = EZ

SECTION NO. 00-00374-03-LS

CHAMPAIGN COUNTY

SHEET 1 OF 21 SHEETS C01350

10 -JAN 08

LICENSE EXPIRES 11-30-09

HIGHWAY STANDARDS

SHEET NO.	NAME OF STANDARD
000001-04	STANDARD SYMBOLS, ABBREVIATIONS AND PATTERNS
001001-01	AREAS OF REINFORCEMENT BARS
01006	DECIMAL OF AN INCH AND OF A FOOT
280001-04	TEMPORARY EROSION CONTROL SYSTEMS
701101-01	OFF-ROAD OPERATIONS, MULTILANE, 15' TO 24" FROM PAVEMENT EDGE
701106-01	OFF-ROAD OPERATIONS, MULTILANE, MORE THAN 15' AWAY
701400-02	APPROACH TO LANE CLOSURE, FREEWAY/EXPRESSWAY
701401-04	LANE CLOSURE, FREEWAY/EXPRESSWAY
701406-04	LANE CLOSURE, FREEWAY/EXPRESSWAY, DAY OPERATIONS ONLY
701411-04	LANE CLOSURE, MULTILANE, AT ENTRANCE OR EXIT RAMP, FOR SPEEDS \geq 45 MPH
701601-05	URBAN LANE CLOSURE, MULTILANE, 1W OR 2W WITH NONTRAVERSABLE MEDIAN
701901	TRAFFIC CONTROL DEVICES
805001	ELECTRICAL SERVICE INSTALLATION DETAILS _ A
814001-01-	HANDHOLES- A

GENERAL NOTES

 F.A. RTE.	SECTION		COUNT	ſΥ	TOTAL	SHEE NO.
I-57	00-00374-0	3-LS (CHAMPA	IGN	21	2
STA.	, , , , , , , , , , , , , , , , , , , ,	STA.				
FED. R	OAD DIST. NO.	ILLINOIS	FED.	AID	PROJECT	

CONTRACT NO. 91382

- 1. ALL ELEVATIONS SHOWN ARE REFERRED TO THE N.A.V.D. 88 DATUM
- 2. WHEREVER IN THE PLANS OR SPECIFICATIONS THE TERM "STANDARD SPECIFICATIONS" IS USED IT SHALL BE UNDERSTOOD BY THE CONTRACTOR TO MEAN THE "STANDARD SPECIFICATIONS FOR ROAD AND BRIDGE CONSTRUCTION" AS PREPARED BY THE DEPARTMENT OF TRANSPORTATION OF THE STATE OF ILLINOIS AND ADOPTED ON JANUARY 1, 2007.
- 3. ANY REFERENCE TO STANDARDS THROUGHOUT THE PLANS SHALL BE INTERPRETED TO BE THE LATEST STANDARDS OF THE DEPARTMENT AS SHOWN ON THE HIGHWAY STANDARDS AND LEGEND SHEET.
- 4. IT IS THE CONTRACTOR'S RESPONSIBILITY TO ASCERTAIN EXISTING FIELD CONDITIONS BEFORE BIDDING ON THE PROJECT.
- 5. THE CONTRACTOR WILL BE REQUIRED TO COMPLY WITH STATE REGULATIONS REGARDING AIR, WATER, AND NOISE POLLUTION.
- 6. THE CONTRACTOR SHALL TAKE CARE NOT TO STORE OR DISPOSE OF DEBRIS OR UNSUITABLE MATERIALS WITHIN LIMITS OF THE IMPROVEMENT AND TAKE CARE TO LIMIT CONSTRUCTION TO WITHIN THE RIGHT-OF-WAY AND EASEMENT AREAS. UNNECESSARY ENCROACHMENTS ONTO PRIVATE OR PUBLIC AREAS WILL NOT BE ALLOWED.
- 7. WHERE SECTION OR SUBSECTION MONUMENTS, BENCHMARKS, OR IRON PIPE MONUMENTS ARE ENCOUNTERED, THE ENGINEER SHALL BE NOTIFIED BEFORE SUCH MONUMENTS ARE REMOVED. THE CONTRACTOR SHALL PROTECT AND CAREFULLY PRESERVE ALL MONUMENTS UNTIL AN ILLINOIS REGISTERED LAND SURVEYOR OR AGENT HAS WITNESSED OR OTHERWISE REFERENCED THEIR LOCATION. THE CONTRACTOR WILL BE RESPONSIBLE FOR HAVING AN ILLINOIS REGISTERED LAND SURVEYOR RE-ESTABLISH ANY MONUMENTS UNNECESSARILY DESTROYED BY HIS OPERATIONS.
- B. THE FINISHED EARTHWORK SHALL HAVE VEGETATIVE SUSTAINING SOIL COVERING THE TOP 4 INCHES IN AREAS TO BE SEEDED. THE TOPSOIL REQUIRED WILL BE PAID FOR PER SQUARE YARD FOR TOPSOIL FURNISH AND PLACE, 4".
- 9. ALL DISTURBED AREAS SHALL BE SEEDED AS SHOWN ON THE PLANS. SEEDING AND MULCHING SHALL BE DONE AS SOON AS EACH STAGE IS COMPLETED AS DIRECTED BY THE ENGINEER. EXISTING TURF WHICH IS DAMAGED OUTSIDE THE LIMITS OF CONSTRUCTION SHALL BE REESTABLISHED WITH SEED AS DIRECTED BY THE ENGINEER
- 10. UTILITY LOCATIONS WERE PLOTTED FROM INFORMATION FURNISHED BY THE VARIOUS UTILITY COMPANIES AND THEIR ACCURACY SHOULD BE CONSIDERED APPROXIMATE. NO RESPONSIBILITY IS ACCEPTED FOR THE LOCATIONS AS SHOWN OR THAT ALL UTILITY FACILITIES ARE SHOWN. UTILITY LOCATIONS SHOWN IN THE PLANS ARE APPROXIMATE AND REPRESENT LOCATIONS PRIOR TO ANY UTILITY RELOCATIONS REQUIRED TO ACCOMMODATE THE PROPOSED CONSTRUCTION. THE CONTRACTOR IS ADVISED THAT SOME UTILITY COMPANIES MAY HAVE RELOCATED THEIR FACILITIES PRIOR TO THE START OF CONSTRUCTION UNDER THIS CONTRACT. BEFORE COMMENCING CONSTRUCTION OPERATIONS THE CONTRACTOR SHALL OBTAIN FROM THE ENGINEER ANY AVAILABLE INFORMATION REGARDING THE RELOCATED POSITIONS OF UTILITIES WITHIN THE PROJECT LIMITS. WHETHER VARIOUS UTILITIES HAVE BEEN RELOCATED OR REMAIN IN THEIR ORIGINAL LOCATION, IT SHALL BE THE RESPONSIBILITY OF THE CONTRACTOR TO DETERMINE THEIR EXACT LOCATION AT THE TIME OF CONSTRUCTION AND TO PROTECT SAME. THE CONTRACTOR'S ATTENTION IS DIRECTED TO THE SPECIAL PROVISION ENTITLED "COOPERATION WITH UTILITIES" AND ARTICLE 107.31 OF THE STANDARD SPECIFICATIONS.
- 11. THE CONTRACTOR SHALL COORDINATE CONSTRUCTION ACTIVITIES WITH UTILITY COMPANIES.
- 12. THE CONTRACTOR SHALL BE RESPONSIBLE FOR PROTECTING UTILITY PROPERTY FROM CONSTRUCTION OPERATIONS AS OUTLINED IN ARTICLE 107.31 OF THE STANDARD SPECIFICATIONS. THE JULIE NUMBER IS 800-892-0123. A MINIMUM OF 48 HOURS ADVANCE NOTICE IS REQUIRED.
- 13. UTILITY OWNERS:
 *INDICATES J.U.L.I.E. MEMBER

* LIRBANA-CHAMPAIGN SANITARY DISTRICT P.O. BOX 669 URBANA, ILLINOIS 61803 (217) 367-3409

*ILLINOIS-AMERICAN WATER COMPANY 201 DEVONSHIRE DR. CHAMPAIGN, ILLINOIS 61820 (217) 373-3258

(ELECTRICAL DIST./GAS) 1112 ANTHONY DRIVE URBANA, ILLINOIS 61801 (217) 383-7280

* INSIGHT 303 FAIRLAWN DRIVE URBANA, ILLINOIS 61801 (217) 384-2510

201 S. NEIL STREET

CHAMPAIGN, ILLINOIS 61820 (217) 398-7990 OPERATIONS AND MAINTENANCE

PHYSICAL PLANT SERVICE BUILDING 1501 S. OAK STREET CHAMPAIGN, ILLINOIS 61821 217-333-3463

- 14. AT THIS TIME THERE ARE NO KNOWN UTILITY CONFLICT WITH THE UI LATERAL NATURAL GAS LINE AS RELOCATED IN CONTRACT *9075B. THE CONTRACTOR MAY OBTAIN AS BUILT PLANS FROM THE UNIVERSITY OF ILLINOIS OPERATIONS AND MAINTENANCE DEPARTMENT.
- 15. THE CONTRACTOR SHALL PROVIDE AND INSTALL TWO WEIGHTED SAND BAGS ON EACH TYPE II BARRICADE USED. (ONE WEIGHTED SAND BAG ACROSS EACH BOTTOM RAIL.)
- 16. FOR STABILIZATION, ALL TYPE III BARRICADES SHALL REQUIRE A MINIMUM OF FOUR SAND BAGS PER BARRICADE.

Revised 3/28/08

- 17. THE CITY OF CHAMPAIGN SHALL BE RESPONSIBLE FOR NOTIFYING THE PUBLIC, THE UNITED STATES POSTAL SERVICE, AND THE EMERGENCY SERVICE AGENCIES OF ALL CHANGES IN THE TRAFFIC MAINTENANCE PLANS. THE CONTRACTOR SHALL NOTIFY THE CITY OF CHAMPAIGN OF ALL CHANGES IN THE TRAFFIC MAINTENANCE PLANS A MINIMUM OF 48 HOURS IN ADVANCE.
- 18. THE CONTRACTOR SHALL BE RESPONSIBLE FOR CLEANUP OF THE SITE PRIOR TO FINAL ACCEPTANCE IN ACCORDANCE WITH ARTICLE 104.06 OF THE STANDARD SPECIFICATIONS. THIS WORK SHALL ALSO INCLUDE CLEANING ALL DRAINAGE FACILITIES OF FOREIGN MATERIALS.

REVISIONS ILLINOIS DEPARTMENT OF TRANSPORTATION NAME Λ HIGHWAY STANDARDS AND GENERAL NOTES SCALE: As Noted DRAWN BY SLD DATE: 01/04/08 CHECKED BY JTP

SUMMARY OF QUANTITIES

UNIT

SQ YD

ACRE

POUND

POUND

SQ YD

UNIT

CU. YD.

CU YD

POUND

FOOT

FOOT

FOOT

FACH

EACH

FACH

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EACH -L SUM EACH

FOOT

FOOT

FOOT

EACH

FOOT

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FOOT

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CU YD

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HOUR

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FACH

CONSTRUCTION CODE Y003 TOTAL

QUANTITY

970

0.2

0.2

217

10

121

155.6

10820

539

833

833

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ITEM NUMBER	PAY ITEM	CONSTRUCTION	TOTAL QUANTITY
X8250500 * -5000841-	LIGHTING UNIT X COMPLETE. SPECIAL	EACH	6 1
X0324390 + -5000842- FL000	LIGHTING UNIT-B, COMPLETE	EACH	6 1
* 5000843	MASONRY COLUMN, LARGE	EACH	. 2
• 5000844	MASONRY COLUMN, SMALL	EACH	4
70100420	TRAFFIC CONTROL AND PROTECTION, STANDARD 701411	EACH	2
70100700	TRAFFIC CONTROL AND PROTECTION, STANDARD 701406	L SUM	1.
70100800	TRAFFIC CONTROL AND PROTECTION, STANDARD 701401	L SUM	1
70102630	TRAFFIC CONTROL AND PROTECTION, STANDARD 701601	L SUM	1
81018100	CONDUIT PUSHED, 3/4" DIA., GALVANIZED STEEL	FOOT	120 🛕

 F.A. RTE.	SECTION		С	DUN1	TOTAL	SHEET NO.		
1-57	00-00374-0	3-LS	CH.	AMPA	IGN	21	3	
STA.		Ŧ	0 5	TA.				
FED. R	DAD DIST. NO.	ILLINOIS FED. AID			AID	PROJECT		
CON	TRACT NO.	. 913	82					

Revised 3/28/68

REVISIONS NAME RLH * SEE SPECIAL PROVISIONS DESIGN FIRM REGISTRATION No. 184-000450

ILLINOIS DEPARTMENT OF TRANSPORTATION

SUMMARY OF QUANTITIES

SCALE: As Noted DATE: 01/04/08

DRAWN BY SLD CHECKED BY JTP

ITEM NUMBER

21101615

25000210

25000400

25000500 25000600

25100105

• 25100635

25200200

50200100

50300225

• 50800205

• 50901755

51201400

51202305

51203400

63100167

• 63304385

67100100

* 78201000

• 8040010)X(⁵

81012200

81012600

81021330

81300800

- 81400730 81603035

81702450

81900200

82500510

* A2002420

D2015401

 X0325403 • XX005856

• XX006302

▼ Z0013798

· Z0076600

* 5000839

5000840

TOPSOIL FURNISH AND PLACE, 4"

NITROGEN FERTILIZER NUTRIENT PHOSPHORUS FERTILIZER NUTRIENT

POTASSIUM FERTILIZER NUTRIENT

HEAVY DUTY EROSION CONTROL BLANKET

REINFORCEMENT BARS, EPOXY COATED

FURNISHING STEEL PILES HP10X42

TRAFFIC BARRIER TERMINAL TYPE 1, SPECIAL (TANGENT)

TRAFFIC BARRIER TERMINAL REMOVAL, TYPE 1

TERMINAL MARKER - DIRECT APPLIED

CONDUIT IN TRENCH, 3/4" DIA. PVC

CONDUIT IN TRENCH, 2" DIA., PVC

CONDUIT PUSHED, 2" DIA., PVC

STRUCTURE, 18" x 12" x 6"

USE), 1" DIA, POLYETHYLENE

ELECTRIC SERVICE INSTALLATION, SPECIAL

JUNCTION BOX, STAINLESS STEEL, ATTACHED TO

TRENCH AND BACKFILL FOR ELECTRICAL WORK

2 1/2" CALIPER, BALLED AND BURLAPPED SHRUB, JUNIPERUS CHINENSIS 'KALLAY'S COMPACTA'

(KALLAY COMPACT JUNIPER), 5 GALLON

CONSTRUCTION LAYOUT

FLEECE FLOWER), 1 GALLON

SILVER GRASS), 2 GALLON

TRAINEES

LIGHTING CONTROLLER TYPE CB-RCS 60 AMP-240 VOLT

CONDUIT, FLEXIBLE NON-METALLIC, WEATHERPROOF, 2"

PERENNIAL, FALLOPIA JAPONICA 'COMPACTA' (COMPACT

PERENNIAL, MISCANTHUS SINENSIS 'PURPURASCENS' (PURPLE

NEPETA X FAASSENII WALKERS LOW (WALKERS LOW CATMINT)

MULCH - SHREDDED HARDWOOD BARK, 3" DEPTH

TREE, BETULA NIGRA HERITAGE (HERITAGE RIVER BIRCH).

UNIT DUCT, 600V, 2-1C NO. 6, 1/C NO. 6 GROUND (XLP-TYPE

ELECTRICAL CABLE IN CONDUIT, 600V (XLP-TYPE USE) 3 1/C X10

SEEDING, CLASS 2A

MULCH METHOD 1

SUPPLEMENTAL WATERING

STRUCTURE EXCAVATION


CONCRETE STRUCTURES

PARAPET RAILING, SPECIAL


TEST PILE STEEL HP10X42

DRIVING PILES


MOBILIZATION

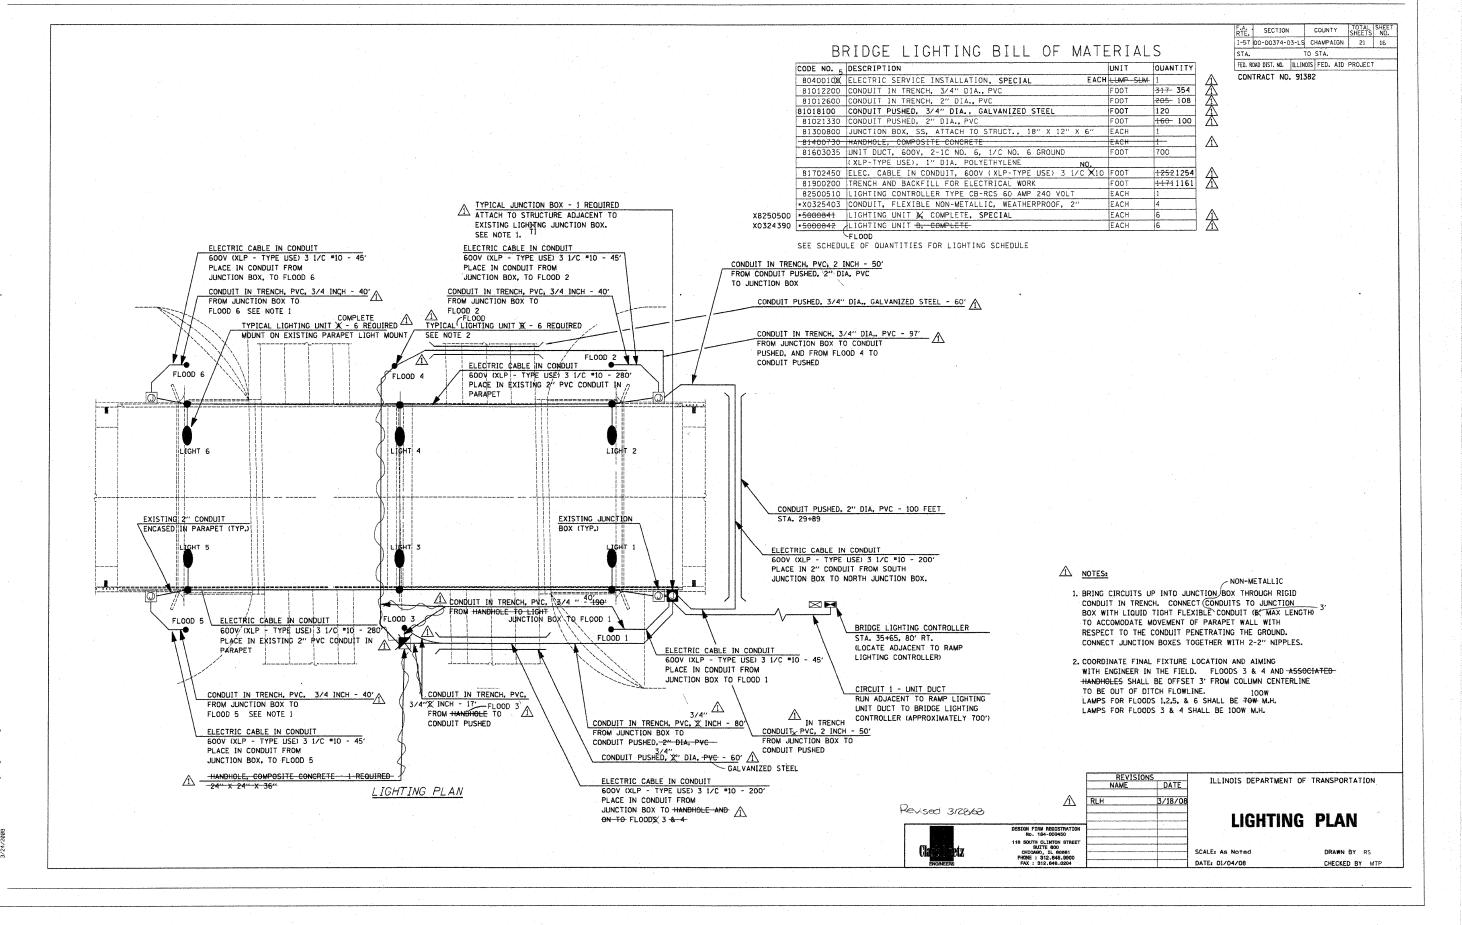

1\081358\plans\sheets\Lighting_Sheets

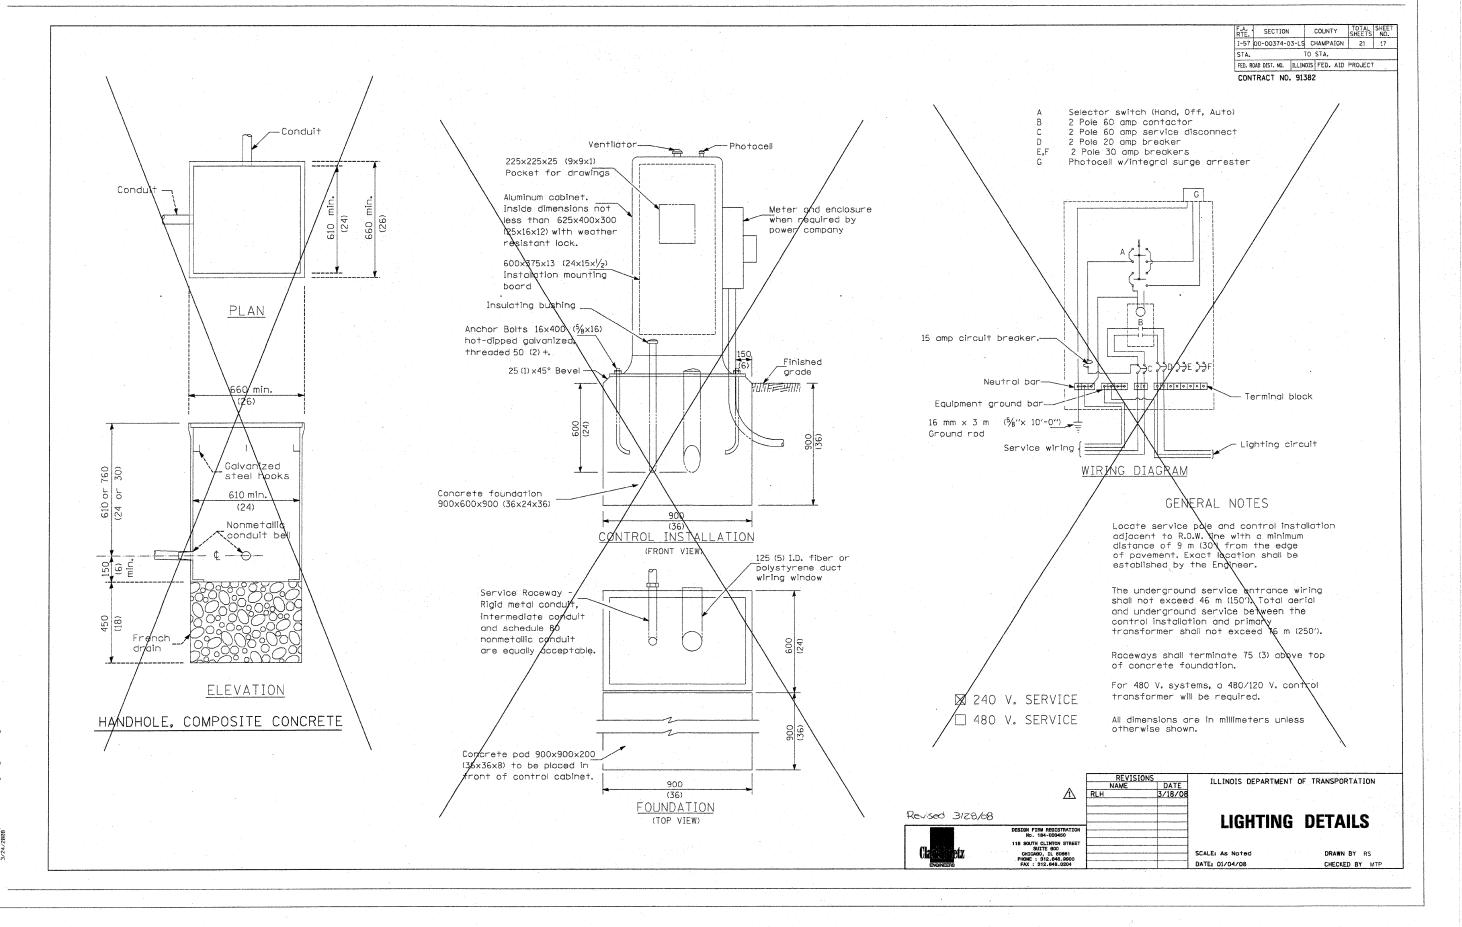

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4\c81358\plens\sheets\Lighting_Sheets.

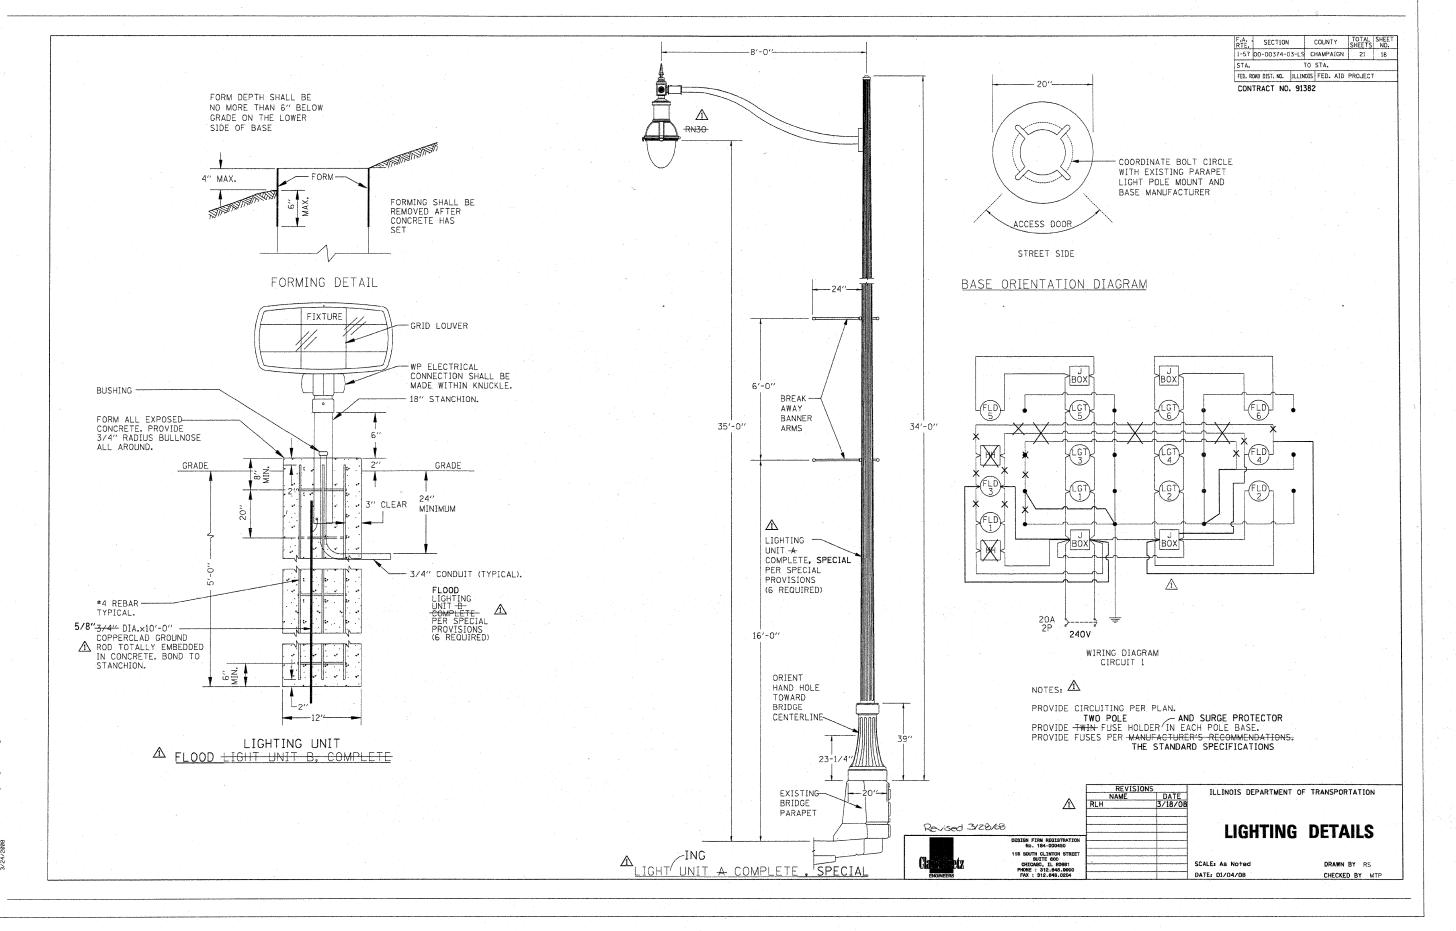SCHEDULES OF QUANTITIES

LIGHTING SCHEDULE	\triangle	\triangle			\triangle	\triangle		\triangle	Λ	\triangle		\triangle	\triangle	\triangle
LOCATION	LIGHTING UNIT — COMPLETE, SPECIAL X8250500	FLOOD LIGHTING UNIT B COMPLETE X0324390	CONDUIT, FLEX. NON-METALLIC, WEATHERPRF, 2"	CONDUIT IN TRENCH, 3/4" DIA. PVC	CONDUIT IN TRENCH, 2" DIA. PVC	CONDUIT PUSHED, 2" DIA. PVC	CONDUIT PUSHED, 3/4" DIA. GALVANIZED STEEL	JUETION BOX, 18" X 12" X 6"	HANDHOLE, COMPOSITE CONCRETE	TRENCH AND BACKFILL FOR ELECTRICAL WORK		ELEC. CABLE IN CONDUIT, 600V (XLP-TYPE USE) 3 1/C ×10 NO.	ELEC. SERVICE INSTALLATION, SPECIAL	LIGHTING CONTROLLER TYPE CB-RCS 60 AMP - 240 VOLT
	*5000841	+5000842 (EACH)	*X0325403	81012200	81012600	81021330	81018100	81300800	81400730	81900200	81603035	81702450	80400105	82500510
	(EACH)	(EACH)	(EACH)	(FOOT)	(FOOT)	(F00T)	(FOOT)	(EACH)	(EACH)	(F00T)	(F00T)	(F00T)	(EACH)	(EACH)
CURTIS 29+25RT		ļ			-				1 1					
CURTIS 29+25LT	1	1							 					
CURTIS 28+20RT	1	1		2.0					1 1					
CURTIS 28+20LT	1	1							+					
CURTIS 27+15RT	· 1	1.			<u> </u>	<u> </u>								
CURTIS 27+15LT	1	11							 					
CURTIS 29+53LT			1		8.0					8.0				
CURTIS 29+53RT			1					1	1 1					
CURTIS 26+87LT			1 .						1					
CURTIS 26+87RT			1						1-1-					
CURTIS 29+89LT TO 29+89						100.0			1 1			100.0		
CURTIS 29+53RT TO 29+89					50.0				1 \ \ \ \ \ \ \ \ \ \ \ \ \ \ \ \ \ \ \	50.0		50.0		
CURTIS 29+53LT TO 29+89					50.0	-			V	50.0		50.0		
CURTIS 29+53RT TO 35+60	RT	L .							.l∧	700.0	700.0			
CURTIS 29+53RT TO 26+87	RT								$\perp \perp \perp \perp \perp \perp$			280.0		
CURTIS 29+53LT TO 26+87	LT				1.5				1 / 1			280.0		
CURTIS 29+53RT TO 29+25	RT			40.0						40.0		45.0		
CURTIS 29+53LT TO 29+25	LT			-50. 0 40. 0						-50. 0- 40. 0		45.0 - 55.0		
CURTIS 26+87RT TO 27+15	RT			40.0						40.0		45.0		
OURTIS 26+87LT TO 27+15	LT			40.0						40.0		45.0		
OURTIS 29+53RT TO 28+96	RT			80.0	-80.0					80.0	4	72.0		
CURTIS 28+96RT TO 28+36	RT					-60.0	60, 0					60.0		
CURTIS 28+36RT TO 28+20	RT			17.0	17.0					16.0 17.0		20.0		
OURTIS 28+20RT TO 28+20	LT			145.0						145.0		-150.0		
CURTIS 35+65RT									1 /				1	1
CURTIS 28+20LT TO 29+25	LT			97.0	1				1/	97.0		102.0		
CURTIS 28+96LT TO 28+36					1		60.0	1	1/			60.0		
		<u> </u>			 				17.					
				354.0	108.0	100.0				1161.0	-	1254.0	<u> </u>	
TOTALS	6	6	4	317.0	205.0	160.0	120.0	1	T/ 1	1171.0	700.0	1252.0	1	1
UNIT	(EACH)	(EACH)	(EACH)	(F00T)	(F00T)	(F00T)	(F00T)	(EACH)	(EACH)	(F00T)	(FOOT)	(F00T)	(EACH)	(EACH)
PAY ITE		₹5000842	•X0325403	81012200	81012600	81021330	81018100	81300800	81400730	81900200	81603035		80400105	82500510
	X8250500	X0324390	<u> </u>								L		<u> </u>	

REVISIONS
NAME
RLH
3/18/08

LIGHTING SCHEDULE
OF QUANTITIES

118 SOUTH CLITTON STREET
SOUTH CLITTON STREET
SOUTH CLITTON STREET
SOUTH CLITTON STREET
CHARGE STATE GROSS
CHECKED BY MTE
ENGINEERS
FRAN 1312-648-0204

REVISIONS
LILLINOIS DEPARTMENT OF TRANSPORTATION
OF QUANTITIES

SCALE: AS NOTED
DATE: 01/04/0B
CHECKED BY MTE

