
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INDEX OF SHEETS

| HEET NO. | DESCRIPTION |
|----------|-----------------------------------------------------------------------------|
| .1 | TITLE SHEET |
| 2 | GENERAL NOTES AND IDOT STANDARDS |
| 3 | SUMMARY OF QUANTITIES |
| 4 | TYPICAL SECTIONS |
| 5 - 9 | PROPOSED PLAN - LEMOYNE STREET |
| 10 | PROPOSED PLAN - DODD AVENUE |
| 11 | PROPOSED PLAN - HAROLD AVENUE |
| 12 | DETOUR PLAN |
| 13 | CONSTRUCTION DETAILS |
| 14 | CURB OR CURB AND GUTTER REMOVAL AND REPLACEMENT |
| 15 | BUTT JOINT AND HMA TAPER DETAILS |
| 16 | DISTRICT ONE TYPICAL PAVEMENT MARKINGS |
| 17 | TRAFFIC CONTROL AND PROTECTION FOR SIDE ROADS, INTERSECTIONS, AND DRIVEWAYS |

THE CONTRACTOR SHALL BE SOLELY RESPONSIBLE FOR JOB SITE SAFETY AS WELL AS SUPERVISION/DIRECTION AND MEANS/METHODS OF CONSTRUCTION.

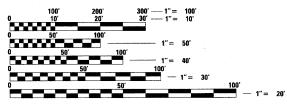

ENGINEERING SCALES. REDUCED SIZED PLANS WILL NOT CONFORM TO STANDARD SCALES. IN MAKING MEASUREMENTS ON REDUCED PLANS, THE ABOVE SCALES MAY BE USED.

JOINT UTILITY LOCATION INFORMATION FOR EXCAVATION 1-800-892-0123

CONTRACT NO. 63009

STATE OF ILLINOIS DEPARTMENT OF TRANSPORTATION **DIVISION OF HIGHWAYS**


PLANS FOR PROPOSED FEDERAL AID HIGHWAY

LEMOYNE STREET FROM WOLF ROAD TO 43rd AVENUE Section No.: 07-00064-00-RS

LEMOYNE STREET RESURFACING

Project No.: M-8003 (914) CITY OF NORTHLAKE **COOK COUNTY**

JOB NO.: C-91-130-08

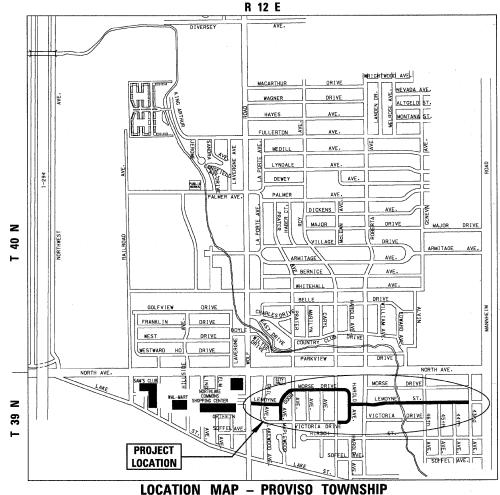

GROSS LENGTH OF PROJECT = 6,422 LINEAL FEET (1.22 MI.)

NET LENGTH OF PROJECT = 6,422 LINEAL FEET (1.22 MI.)


TRAFFIC DATA ADT (YEAR) = 600 (2006)SPEED LIMIT = 25 MPH


DESIGN DESIGNATION RESIDENTIAL COLLECTOR STREET

SECTION 1678 07-00064-00-RS COOK 17 FED. ROAD DIST. NO. 1 ILLINOIS FED. AID PROJECT

CONTRACT NO. 63009



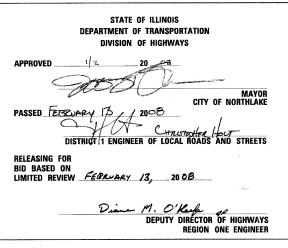

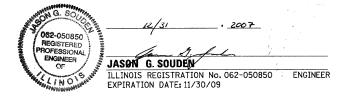

SPECIFICATIONS, STANDARDS AND SPECIAL PROVISIONS

ALL CONSTRUCTION SHALL BE DONE IN ACCORDANCE WITH THE "STANDARD SPECIFICATIONS FOR ROAD AND BRIDGE CONSTRUCTION", ADOPTED JANUARY 1, 2007; THE "SUPPLEMENTAL SPECIFICATIONS AND RECURRING SPECIAL PROVISIONS". ADOPTED JANUARY 1. 2008: THE LATEST EDITION OF THE "ILLINOIS MANUAL ON UNIFORM TRAFFIC CONTROL DEVICES FOR STREETS AND HIGHWAYS". IMITCO. THE STANDARD SPECIFICATIONS FOR WATER AND SEWER MAIN CONSTRUCTION IN ILLINOIS" MAY 1996 FIFTH EDITION, THE "DETAILS" IN THE PLANS AND THE "SPECIAL PROVISIONS" INCLUDED IN THE CONTRACT DOCUMENTS.

THE CONTRACTOR SHALL COOPERATE WITH THE CITY IN ANY UNDERGROUND UTILITY CONSTRUCTION WHICH THE CITY MAY WANT TO PLACE DURING THE CONTRACTOR'S

THE CONTRACTOR SHALL BE RESPONSIBLE FOR CONTACTING THE OWNERS OF ALL EXISTING FACILITIES SO THAT THE UTILITIES AND THEIR APPURTENANCES MAY BE LOCATED AND ADJUSTED OR MOVED, IF NECESSARY, PRIOR TO THE START OF CONSTRUCTION OPERATIONS. THE CONTRACTOR SHALL COOPERATE WITH ALL UTILITY OWNERS AS PROVIDED FOR IN THE STANDARD SPECIFICATIONS

THE LOCATIONS OF EXISTING DRAINAGE STRUCTURES, STORM AND SANITARY SEWERS. WATER SERVICE LINES AND OTHER UTILITY LINES ARE APPROXIMATE, AND THE CITY DOES NOT GUARANTEE THEIR ACCURACY. THEIR EXACT HORIZONTAL AND VERTICAL LOCATIONS ARE TO BE DETERMINED IN THE FIELD BY THE CONTRACTOR AT HIS OWN

THE CONTRACTOR SHALL BE RESPONSIBLE FOR THE PROTECTION OF ALL UNDERGROUND OR SURFACE UTILITIES EVEN THOUGH THEY MAY NOT BE SHOWN ON THE PLANS. ANY UTILITY THAT IS DAMAGED DURING CONSTRUCTION SHALL BE REPAIRED OR REPLACED TO THE SATISFACTION OF THE ENGINEER OR THE CITY. THIS WORK SHALL BE AT THE CONTRACTOR'S EXPENSE.

COORDINATION OF ALL UTILITY WORK INVOLVED IN THE CONSTRUCTION AREA WILL BE DISCUSSED AT THE PRECONSTRUCTION CONFERENCE.

BEFORE STARTING ANY EXCAVATION, THE CONTRACTOR SHALL CALL "JULIE" AT 800-892-0123 FOR FIELD LOCATIONS OF BURIED ELECTRIC, TELEPHONE, GAS AND CABLE TELEVISION FACILITIES. (48 HOURS NOTIFICATION IS REQUIRED.)

THE CONTRACTOR SHALL PROTECT AND CAREFULLY PRESERVE ALL SECTION OR SUBSECTION MONUMENTS OR PROPERTY OR REFERENCE MARKERS UNTIL THE CITY. HIS AGENT OR AN AUTHORIZED SURVEYOR HAS WITNESSED OR OTHERWISE REFERENCED

ALL RADII FOR PROPOSED CURB AND GUTTER ARE TO THE EDGE OF PAVEMENT UNLESS OTHERWISE NOTED, AND SHALL BE AS INDICATED ON THE PLANS, FLEVATIONS SHOWN AT POINT OF CURVE, ETC. IS EDGE OF PAVEMENT UNLESS OTHERWISE NOTED.

WATER, STORM SEWER AND SANITARY SEWER

WHENEVER DURING CONSTRUCTION OPERATIONS ANY LOOSE MATERIAL IS DEPOSITED IN THE FLOW LINE OF DRAINAGE STRUCTURES SUCH THAT THE NATURAL FLOW OF WATER IS OBSTRUCTED. IT SHALL BE REMOVED AT THE CLOSE OF EACH WORKING DAY. AT THE CONCLUSION OF CONSTRUCTION OPERATIONS, ALL UTILITY STRUCTURES SHALL BE FREE FROM DIRT AND DEBRIS. THE WORK SPECIFIED ABOVE WILL NOT BE PAID FOR SEPARATELY BUT SHALL BE INCIDENTAL TO THE CONTRACT.

ANY EXISTING OR PROPOSED STORM SEWER DAMAGED BY THE CONTRACTOR DURING CONSTRUCTION SHALL BE REPLACED BY THE CONTRACTOR AT NO COST TO THE OWNER.

THE CONTRACTOR SHALL NOT OPEN OR SHUT ANY WATER VALVES OR FIRE HYDRANTS WITHOUT PRIOR AUTHORIZATION FROM THE CITY WATER DEPARTMENT UNAUTHORIZED USE SHALL SUBJECT THE OFFENDER TO ARREST AND PROSECUTION.

ACCESS: THE CONTRACTOR SHALL PROVIDE ACCESS TO ABUTTING PROPERTY AT ALL TIMES DURING THE CONSTRUCTION OF THIS PROJECT, EXCEPT FOR PERIODS OF SHORT DURATION. THE COST TO PROVIDE ACCESS SHALL BE PAID FOR AND INCLUDED IN THE ITEM AGGREGATE FOR TEMPORARY ACCESS.

DIMENSIONS: IT SHALL BE THE CONTRACTOR'S RESPONSIBILITY TO VERIEY ALL DIMENSIONS AND CONDITIONS EXISTING IN THE FIELD PRIOR TO ORDERING MATERIALS AND BEGINNING CONSTRUCTION.

ALL SAWCUTTING SHALL BE INCIDENTAL TO REMOVAL ITEMS AND SHALL BE PERFORMED PRIOR TO BEGINNING REMOVAL. ANY ITEMS OF WORK REMOVED PRIOR TO SAWCUTTING WILL NOT BE MEASURED FOR PAYMENT.

COMBINATION CONCRETE CURB AND GUTTER REMOVAL AND REPLACEMENT, DRIVEWAY PAYEMENT REMOVAL, PORTLAND CEMENT CONCRETE DRIVEWAY PAYEMENT, 7 INCH, PORTLAND CEMENT CONCRETE SIDEWALK, 5 INCH AND 7 INCH, AND CLASS C AND D PATCHES 6" (SPECIAL)
ARE NOT SHOWN ON THE PLANS BUT WILL BE DETERMINED BY THE ENGINEER IN THE FIELD AND WILL NOT EXCEED THE PLAN QUANTITY.

THE THICKNESSES OF HOT-MIX ASPHALT MIXTURES SHOWN IN THE PLANS ARE NOMINAL. DEVIATIONS MAY OCCUR DUE TO IRREGULARITIES IN THE SURFACES OR BASIS ON WHICH THEY ARE TO BE PLACED. PLAN THICKNESSES SHOULD BE CONSIDERED THE MINIMUM THICKNESS PERMITTED.

DETECTABLE WARNINGS MEETING ADA REQUIREMENTS SHALL BE INSTALLED AT ALL INTERSECTING STREETS, COMMERCIAL DRIVEWAYS, AND ALLEYS AS DIRECTED BY THE ENGINEER (SEE IDOT STD. 424001-05 INCLUDED IN THE SPECIFICATIONS). CONTRACTOR SHALL VERIFY THAT ALL SLOPES MEET ADA REQUIREMENTS PRIOR TO INSTALLING DETECTABLE WARNINGS.

PAVEMENT GRADES: THE ELEVATIONS INDICATED ON THE PLANS ARE FINISHED GRADES OF PROPOSED PAVEMENT OR SURFACE COURSE. UNLESS OTHERWISE INDICATED.

RELOCATING EXISTING SIGNS: EXISTING SIGNS WHICH ARE IN CONFLICT WITH PROPOSED IMPROVEMENTS SHALL BE REMOVED AND REINSTALLED UPON COMPLETION OF CONFLICTING IMPROVEMENTS IN ACCORDANCE WITH THE ILLINOIS DEPARTMENT OF TRANSPORTATION "MANUAL OF UNIFORM TRAFFIC CONTROL DEVICES" AND THE "STANDARD SPECIFICATIONS FOR ROAD AND BRIDGE CONSTRUCTION". STOP SIGNS, SPEED LIMIT SIGNS, AND STREET NAME SIGNS SHALL BE UP AND VISIBLE AT ALL TIMES. THIS WORK SHALL BE INCLUDED TO THE PAY ITEM TRAFFIC CONTROL AND PROTECTION.

MAILBOXES WHICH ARE IN CONFLICT WITH PROPOSED IMPROVEMENTS SHALL BE REMOVED, TEMPORARILY RELOCATED, AND REPLACED UPON COMPLETION OF THE PROPOSED IMPROVEMENTS AS DIRECTED BY THE ENGINEER. THIS WORK SHALL BE CONSIDERED INCLUDED TO THE PAY ITEM TRAFFIC CONTROL AND PROTECTION.

PROPOSED CONCRETE CURB AND GUTTER SHALL BE TRANSITIONED TO EXISTING CURB AND GUTTER OVER A LENGTH OF 5 FEET. THIS WORK SHALL BE PAID FOR AT THE CONTRACT UNIT PRICE PER FOOT FOR COMBINATION CONCRETE CURB AND GUTTER REMOVAL AND REPLACEMENT.

ALL UNDERGROUND, DRIVEWAY, CONCRETE, AND LANDSCAPE RESTORATION WORK IS TO BE COMPLETED BEFORE THE SURFACE COURSE IS INSTALLED.

HIGHWAY STANDARDS

| | |
|-----------|------------------------------------------------------------------|
| 000001-05 | STANDARD SYMBOLS, ABBREVIATIONS, AND PATTERNS |
| 424001-05 | CURB RAMPS FOR SIDEWALKS |
| 442201-03 | CLASS C AND D PATCHES |
| 602011 | CATCH BASIN TYPE C |
| 604001-02 | FRAME AND LIDS TYPE 1 |
| 606001-03 | CONCRETE CURB TYPE B AND COMBINATION CONCRETE CURB AND GUTTER |
| 701301-02 | LANE CLOSURE, 2L, 2W, SHORT TIME OPERATIONS |
| 701501-04 | URBAN LANE CLOSURE, 2L, 2W UNDIVIDED |
| 701801-03 | LANE CLOSURE MULTILANE 1W OR 2W CROSSWALK OR SIDEWALK CLOSURE |
| 701901 | TRAFFIC CONTROL DEVICES |
| 780001-01 | TYPICAL PAVEMENT MARKINGS |
| 886001 | DETECTOR LOOP INSTALLATIONS |
| BLR 17-3 | TRAFFIC CONTROL DEVICES - DAY LABOR CONSTRUCTION |
| BLR 18-4 | TRAFFIC CONTROL DEVICES - DAY LABOR MAINTENANCE |
| | |

SECTION COUNTY 1678 07-00064-00-RS COOK 17 2 TO STA. STA. FED. ROAD DIST, NO. ILLINOIS FED. AID PROJECT

CONTRACT NO. 63009

| REVISION | 18 | THE THREE DESIGNATION | THE OF TRANSPORTATION | | | | | | |
|----------|------|-------------------------------------|-----------------------|--|--|--|--|--|--|
| NAME | DATE | ILLINOIS DEPARTMENT OF TRANSPORTATI | | | | | | | |
| | | GENERAL NOTES | AND IDOT STANDARDS | | | | | | |
| | | CITY OF NORTHLAKE LEMOYNE SREET | | | | | | | |
| | | SCALE N.T.S. | DRAWN BY EDT | | | | | | |
| | | DATE 12/27/2007 | CHECKED BY MW | | | | | | |

SUMMARY OF QUANTITIES

| | | | | | STP - LAPP | |
|--------------|--------------------------------------------------------------------------------------------------|--------------------------------------|-------------------------|---------------------------|----------------|---------|
| | LOCATION OF WORK | LEMOYNE ST. 80% FED. 20% LOCAL | DODD AVE. 100% LOCAL | HAROLD AVE. 100% LOCAL | | |
| | FUNDING SOURCE | STP | LOCAL | LOCAL | | |
| | SUMMARY OF QUANTITIES | | | | STRUCTION TYPE | |
| ITEM# | ITEM | UNIT | TOTAL QUANTITIES | 1000-2A | 1000-2A | 1000-2A |
| 28000510 INL | | EACH | 71 | 66 | 0 | 5 |
| | B-BASE GRANULAR MATERIAL, TYPE B | CU YD | 50 | 30 | 10 | 10 |
| | GREGATE BASE COURSE, TYPE B 6" | SQ YD | 350 | 250 | 50 | 50 |
| | GREGATE BASE REPAIR | TON | 50 | 50 | 0 | 0 |
| | GREGATE FOR TEMPORARY ACCESS | TON | 300 | 200 | 50 | 50 |
| | UMINOUS MATERIALS (PRIME COAT) | GAL | 2255 | 1945 | 110 | 200 |
| | GREGATE (PRIME COAT) | TON | 48 | 40 | 3 | 5 |
| | /ELING BINDER (MACHINE METHOD), N50 | TON | 2265 | 1955 | 110 | 200 |
| | T-MIX ASPHALT SURFACE REMOVAL - BUTT JOINT | SQ YD | 305 | 240 | 30 | 35 |
| | T-MIX ASPHALT SURFACE COURSE, MIX "C", N50 | TON | 1945 | 1675 | 100 | 170 |
| | RTLAND CEMENT CONCRETE DRIVEWAY PAVEMENT, 7 INCH | SQ YD | 100 | 50 | 25 | 25 |
| | RTLAND CEMENT CONCRETE SIDEWALK, 5 INCH | SQ FT | 3500 | 2500 | 500 | 500 |
| | RTLAND CEMENT CONCRETE SIDEWALK, 7 INCH | SQ FT | 1000 | 600 | 200 | 200 |
| | ECTABLE WARNINGS | SQ FT | 104 | 64 | 20 | 20 |
| | T-MIX ASPHALT SURFACE REMOVAL, 3 1/4" | SQ YD | 21460 | 18540 | 1045 | 1875 |
| | VEWAY PAVEMENT REMOVAL | SQ YD | 450 | 300 | 75 | 75 |
| | EWALK REMOVAL | SQ FT | 4500 | 3100 | 700 | 700 |
| 44001700 COI | MBINATION CONCRETE CURB AND GUTTER REMOVAL AND REPLACEMENT A REFLECTIVE CRACK CONTROL TREATMENT | FOOT | 3800 | 3350 | 200 | 250 |
| | TERPROOFING MEMBRANE SYSTEM | SQ YD | 21460 | 18540 | 1045 | 1875 |
| | TERPROOFING MEMBRANE SYSTEM TCH BASINS, TYPE C, TYPE 1 FRAME, OPEN LID | SQ YD | 210 | 210 | 0 | 0 |
| | TCH BASINS, TIPE C, TIPE T FRAME, OPEN LID | EACH EACH | 6 19 | 6 17 | 0 | 2 |
| | TCH BASINS TO BE ADJUSTED WITH NEW TYPE 1 FRAME, CLOSED LID | EACH | 3 | | 0 | 0 |
| | TCH BASINS TO BE RECONSTRUCTED | | 1 | <u>3</u> 1 | 0 | 0 |
| | VE BOXES TO BE REPLACED | EACH EACH | 1 | 1 | 0 | 0 |
| 67100100 MOI | | L. SUM | 1 | 1 | 0 | 0 |
| | AFFIC CONTROL AND PROTECTION FOR TEMPORARY DETOUR | EACH | 1 | 1 | 0 | 0 |
| | AFFIC CONTROL AND PROTECTION, STANDARD 701501 | L. SUM | 1 | 1 | 0 | 0 |
| | AFFIC CONTROL AND PROTECTION, STANDARD 701701 | L. SUM | 1 | 1 | 0 | l ŏ |
| | AFFIC CONTROL AND PROTECTION, STANDARD 701801 | L. SUM | 1 | 1 | 0 | 0 |
| | ERMOPLASTIC PAVEMENT MARKING - LINE 6" | FOOT | 2255 | 2125 | 65 | 65 |
| | ERMOPLASTIC PAVEMENT MARKING - LINE 12" | FOOT | 575 | 575 | 0 | 0 |
| | ERMOPLASTIC PAVEMENT MARKING - LINE 24" | FOOT | 465 | 435 | 15 | 15 |
| | ECTOR LOOP REPLACEMENT | FOOT | 212 | 212 | 0 | 0 |
| | DIMENT CONTROL, DRAINAGE STRUCTURE INLET FILTER CLEANING | EACH | 71 | 66 | Ö | 5 |
| | SS D PATCHES, 6" (SPECIAL) | SQ YD | 585 | 445 | 50 | 90 |
| | NSTRUCTION LAYOUT | L. SUM | 1 | 1 | Ö | 0 |
| | AINAGE STRUCTURE ADJUSTMENT (SPECIAL) | EACH | 14 | 13 | Ö | 1 |
| | AINAGE STRUCTURES TO BE ADJUSTED | EACH | 29 | 27 | 0 | 2 |
| | AINAGE STRUCTURES TO BE REMOVED | EACH | 8 | 8 | 0 | 0 |
| | SS C PATCHES, 6" (SPECIAL) | SQ YD | 585 | 445 | 50 | 90 |


^{*} INDICATES SPECIALTY ITEM


| REVISION: | S | | | | | |
|-----------|------|------------------------------------|------------------------|--|--|--|
| NAME | DATE | ILLINOIS DEPART | MENT OF TRANSPORTATION | | | |
| | | SUMMARY | Y OF QUANTITIES | | | |
| | | CITY OF NORTHLAKE LEMOYNE SREET | | | | |
| | | SCALE N.T.S. | DRAWN BY EDT | | | |
| | | DATE 1/2/2008 | CHECKED BY MW | | | |

| LAN | SIRREFED | BY | OTTED | NOTED | ALTONNETT CHECKED | CAUD FILE HAME | NEWORTHLINE SPRINGS CHECKED | CAUD FILE HAME | NEW CHECKED | CAUD FILE HAME | NEW CHECKED | CAUD FILE HAME | NEW CHECKED | CAUD FILE HAME | CAUD FILE HAM

THRISTOCTION B. BORNE EN 375 West Higgins Road, Suite 600 Spennort, Illinois 60018

957 W

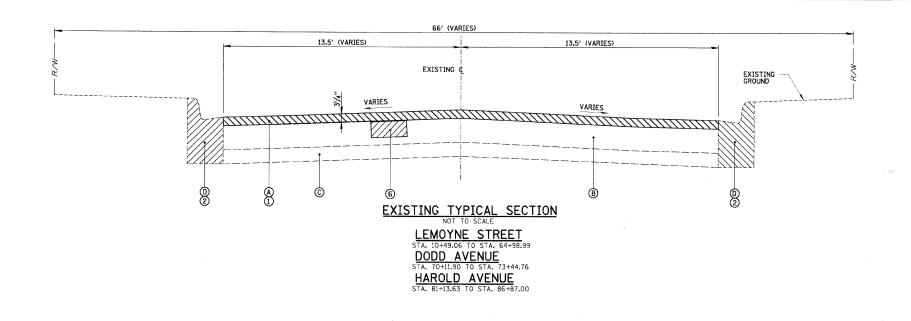

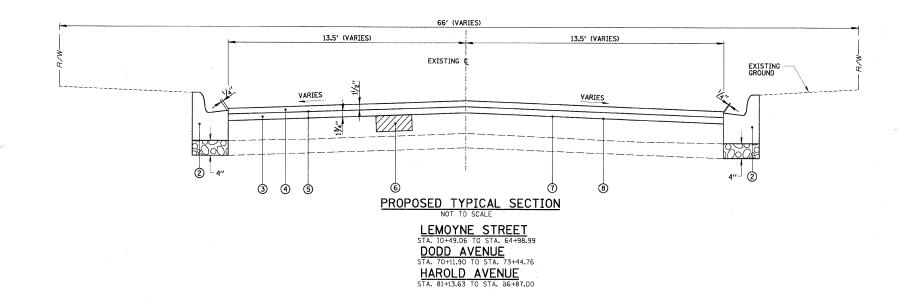

SECTION 1678 07-00064-00-RS COOK STA. TO STA. FED. ROAD DIST. NO. ILLINOIS FED. AID PROJECT

CONTRACT NO. 63009

- A EXISTING ASPHALT PAVEMENT (+/- 2.4" TO 7.9")
- B EXISTING P. C. C. BASE (+/- 4" TO 7")
- © EXISTING AGGREGATE BASE (+/- 0" TO 7")
- D EXISTING COMBINATION CURB AND GUTTER; TYPE M-3.12
- 1 HOT-MIX ASPHALT SURFACE REMOVAL, 3 1/4"
- COMBINATION CONCRETE CURB AND GUTTER REMOVAL AND REPLACEMENT (AS DIRECTED BY ENGINEER) (SEE DETAIL SHEET 14)
- 3 LEVELING BINDER (MACHINE METHOD), N50 1-3/4" MIN.
- (4) HOT-MIX ASPHALT SURFACE COURSE, MIX "C", N50 1 1/2"
- 5 BITUMINOUS MATERIALS (PRIME COAT)
- 6 CLASS C OR D PATCHES, 6" (SPECIAL)
- 7 AGGREGATE (PRIME COAT)
- 8 AREA REFLECTIVE CRACK CONTROL TREATMENT


HOT-MIX ASPHALT MIXTURE REQUIREMENTS


| ITEM | AC-TYPE | VOIDS |
|-------------------------------------------------------------|-----------|--------------------|
| ROADWAYS | | |
| HOT-MIX ASPHALT SURFACE COURSE, MIX "C", N50 (IL-9.5 MM) | PG 64-22 | 4% e 50 GYR |
| LEVELING BINDER (MACHINE METHOD), N50 (IL-9,5 MM) | PG 64-22• | 4% @ 50 GYR |
| CLASS D PATCHES, (HMA BINDER IL-19 MM) 6" (SPECIAL) | PG 64-22* | 4% @ 70 GYR |
| DRIVEWAYS | | |
| HOT-MIX ASPHALT SURFACE COURSE, MIX "C", N50 (IL-9.5 MM) | PG 64-22 | 4% c 50 GYR |


- 1. THE UNIT WEIGHT USED TO CALCULATE ALL HOT-MIX ASPHALT SURFACE MIXTURE QUANTITIES IS 112 LBS/SY/IN.
- 2. *WHEN RAP EXCEEDS 20%, THE NEW ASPHALT BINDER IN THE MIX SHALL BE PG 58-22.


| RE | REVISIONS | | | 05011 | DT14517 | ٥- | TOMES | 00747701 | |
|-----------------------------------------|-----------|----------|------------------------------------|--------|---------|----|---------------|----------|--|
| NAM | E D/ | ATE ILL. | ILLINOIS DEPARTMENT OF | | | | RANSPURTATION | | |
| | | | TYPICAL SECTIONS | | | | | | |
| *************************************** | | | CITY OF NORTHLAKE LEMOYNE SREET | | | | | | |
| | | SCAL | E N.T.S | S. | | [| RAWN BY | EDT | |
| | | DATE | 12/2 | 7/2007 | | (| CHECKED BY | MW | |


CHRISTOPHER B. BURKE 18 9575 West Higgins Road, Suite 600 B Rosemont, Illinois 60018 (847) 823-0500

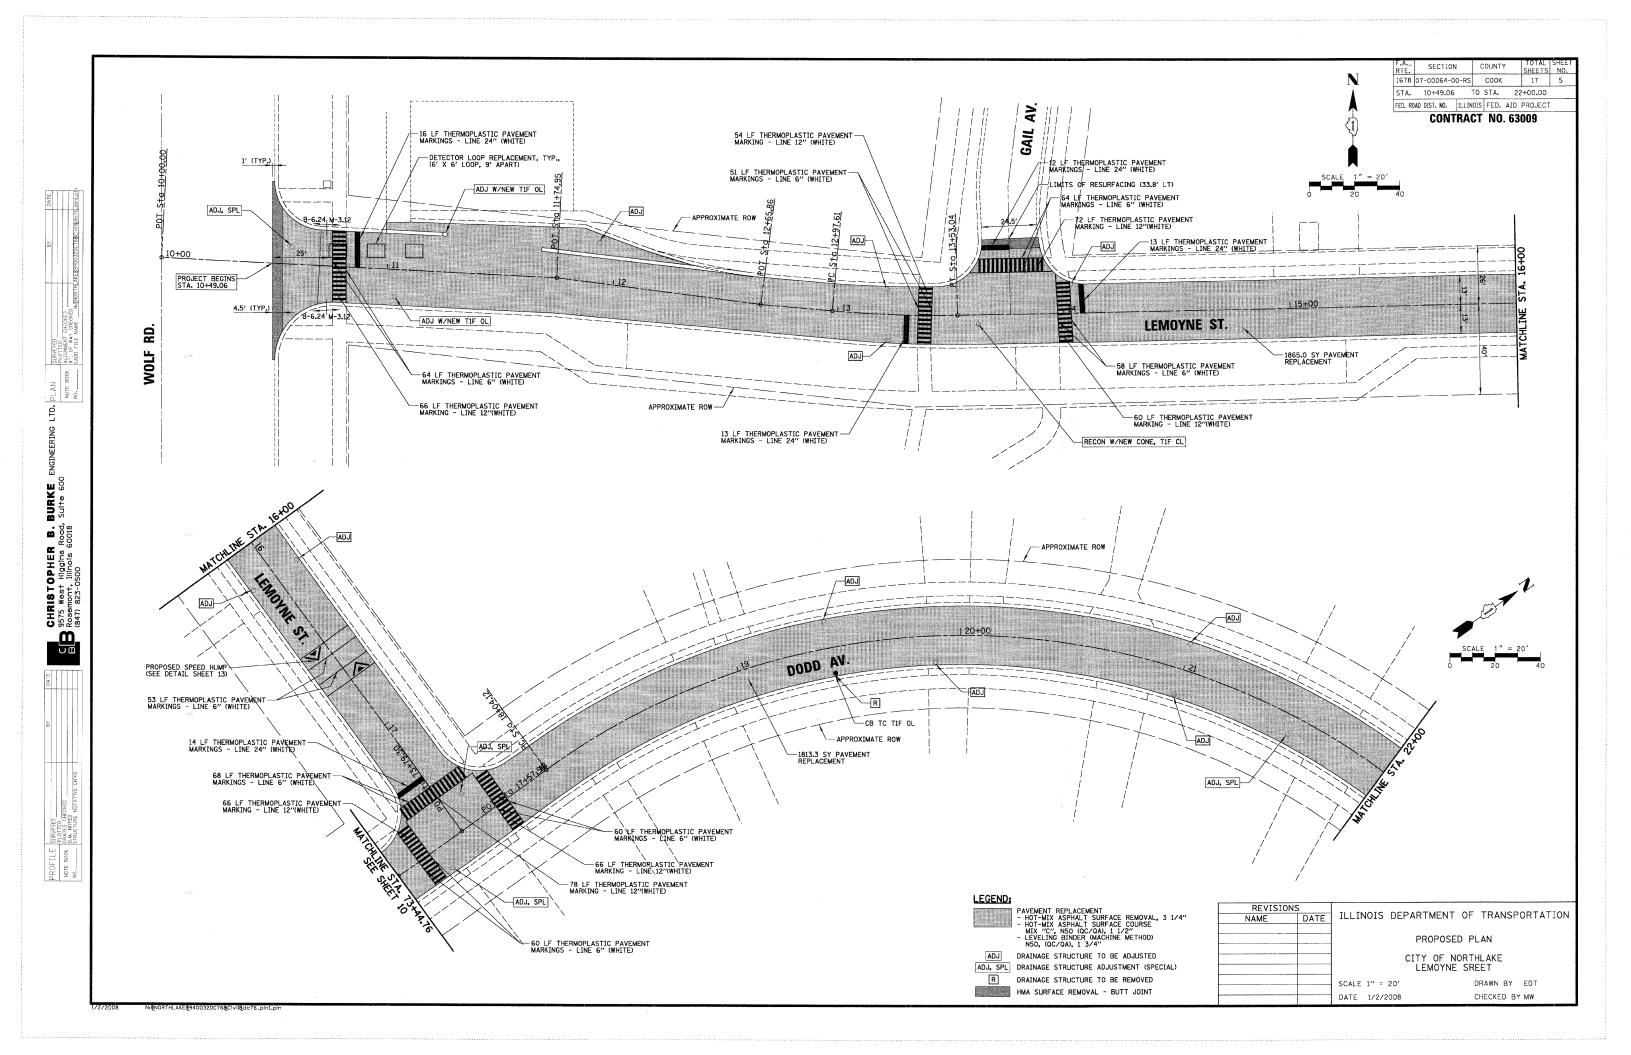

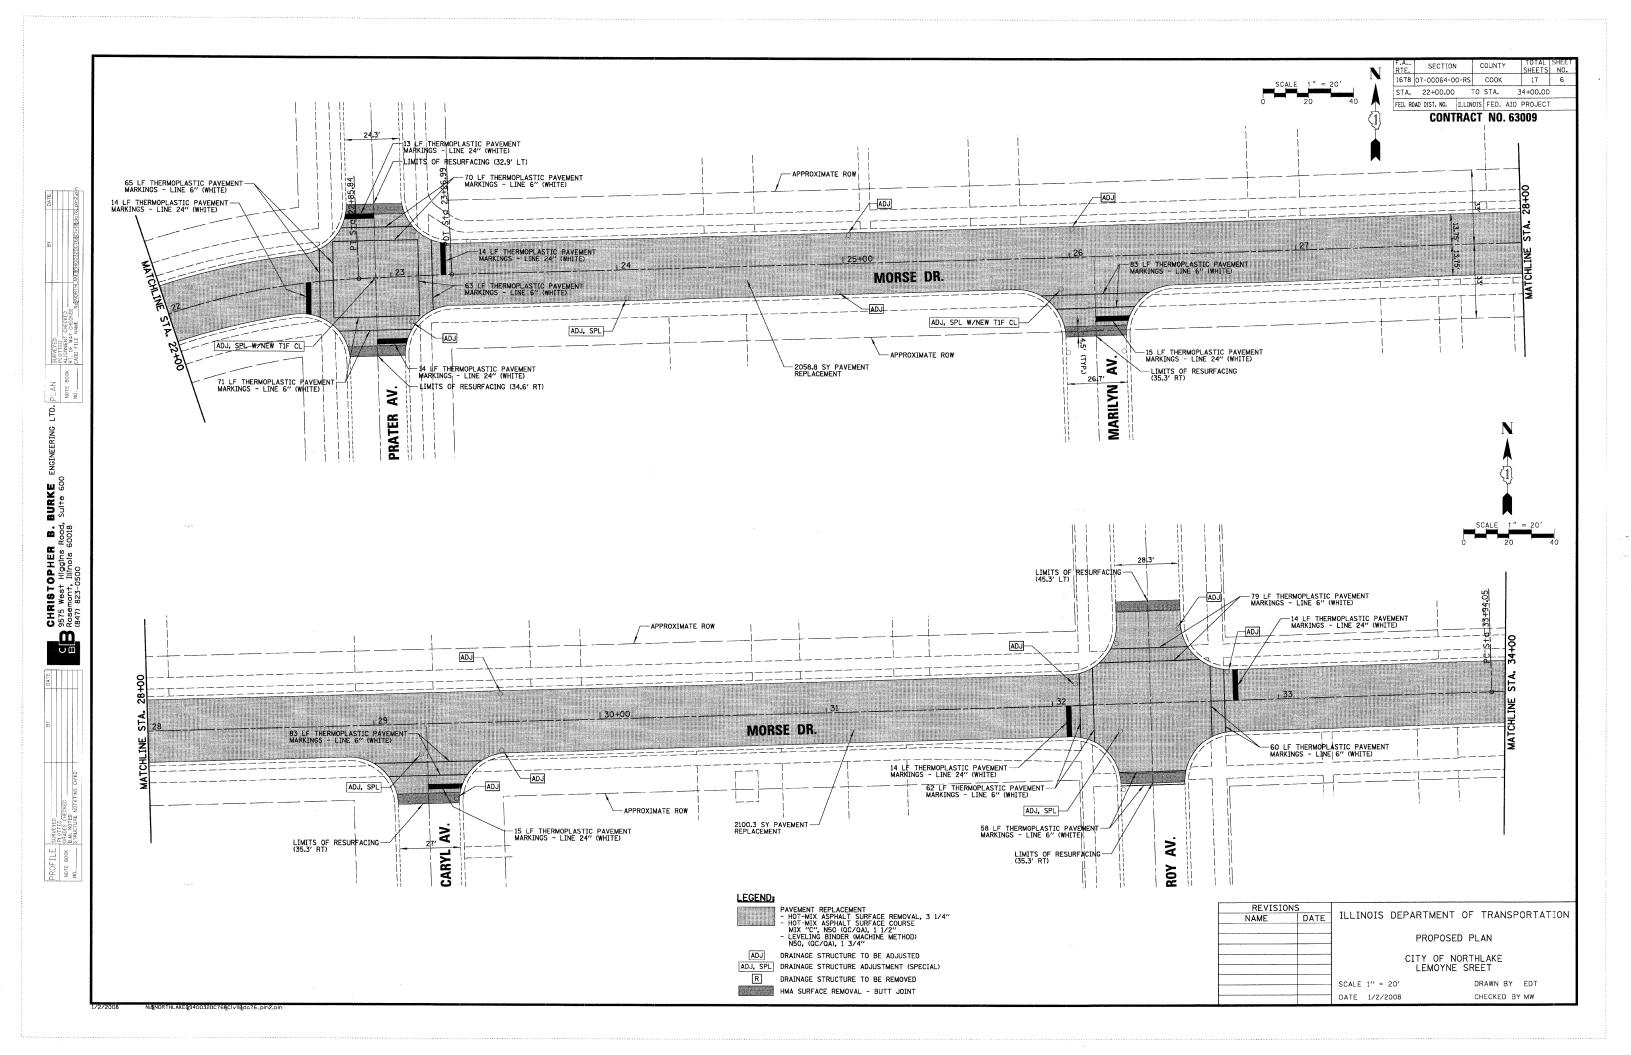


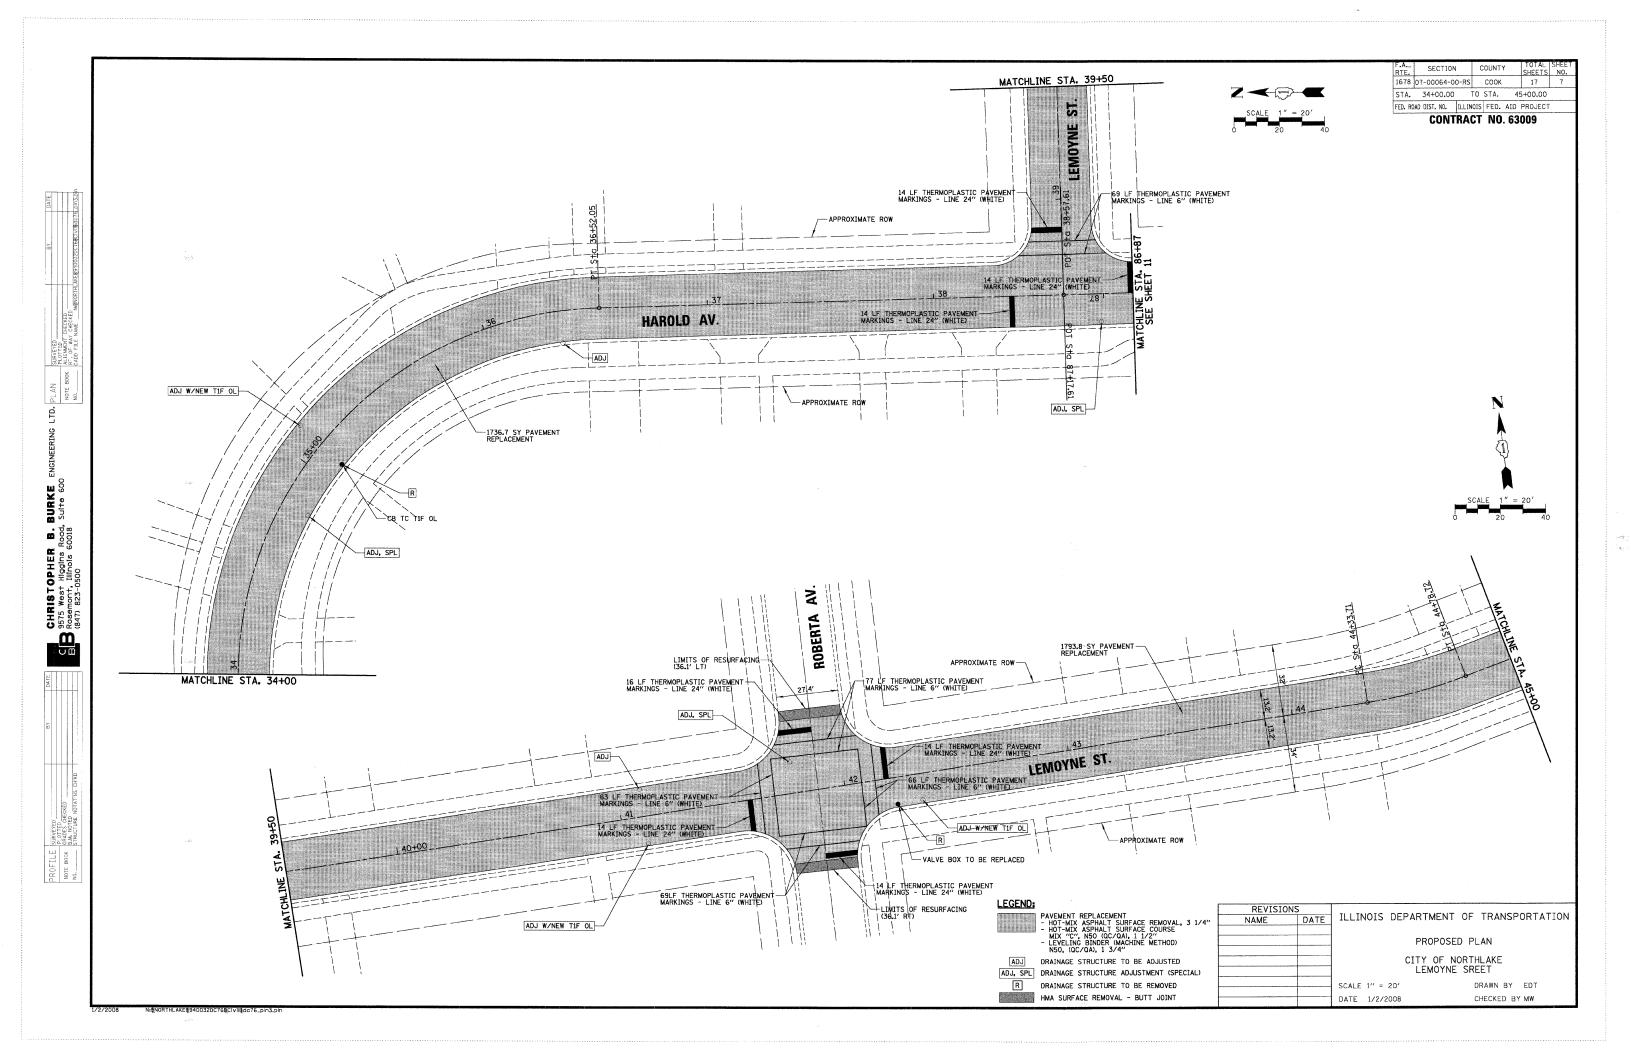


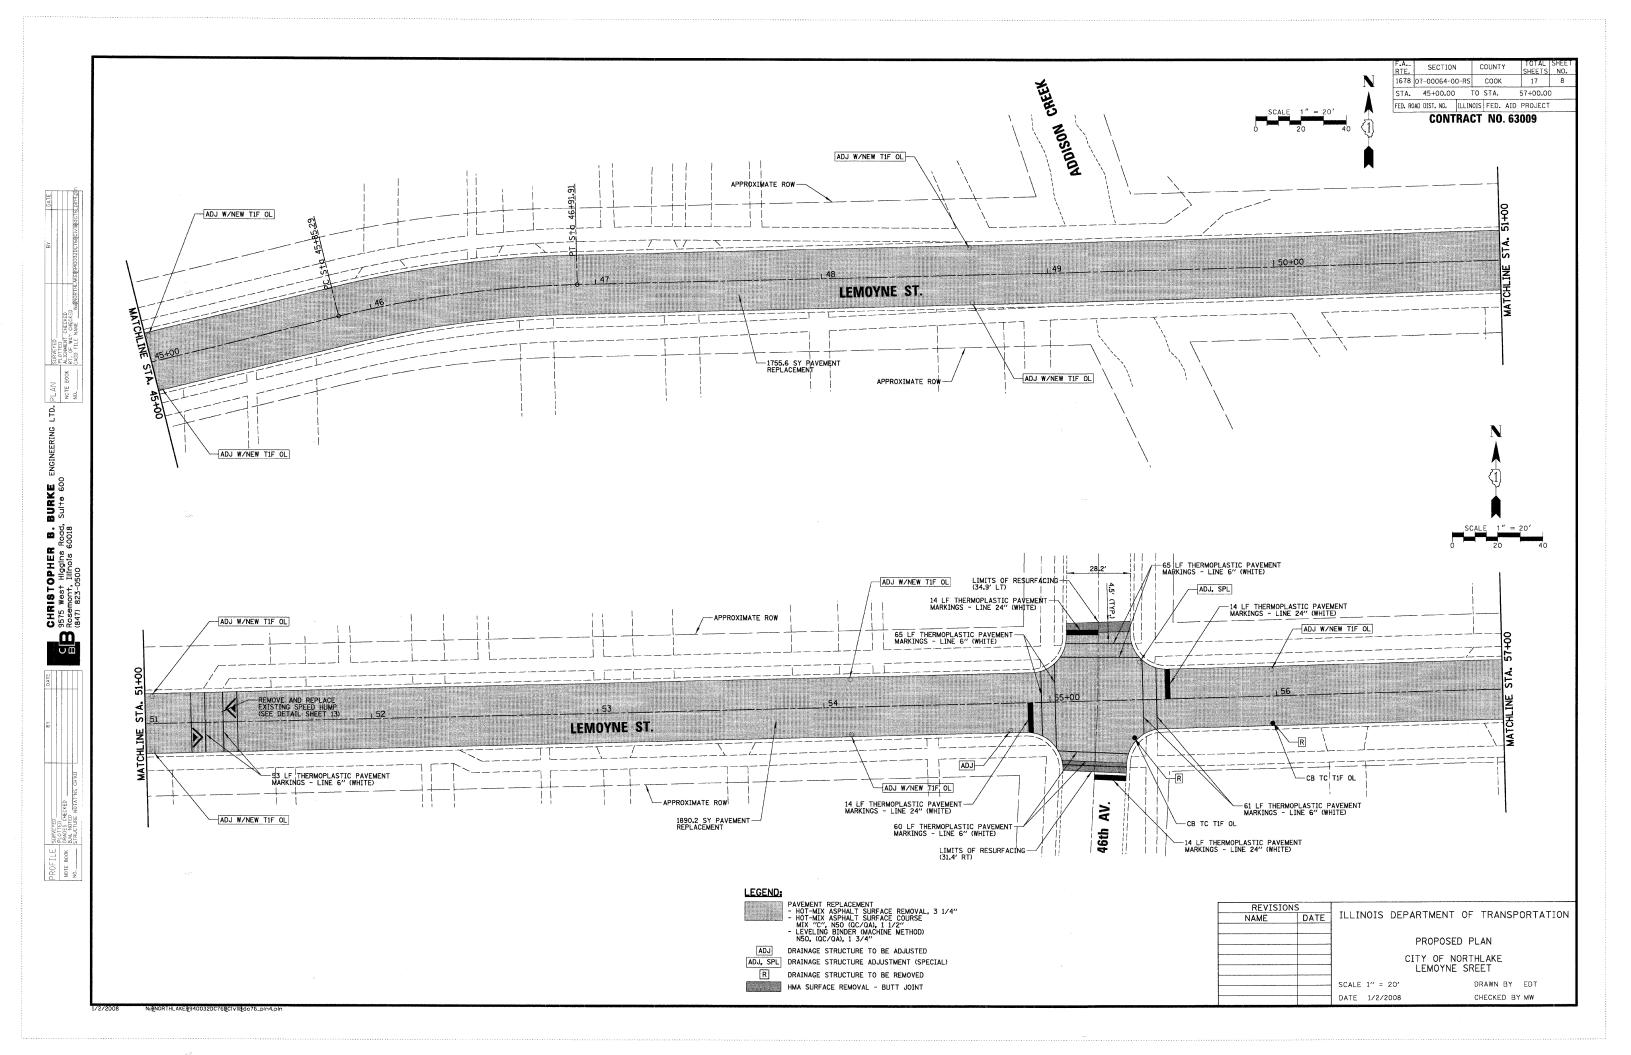

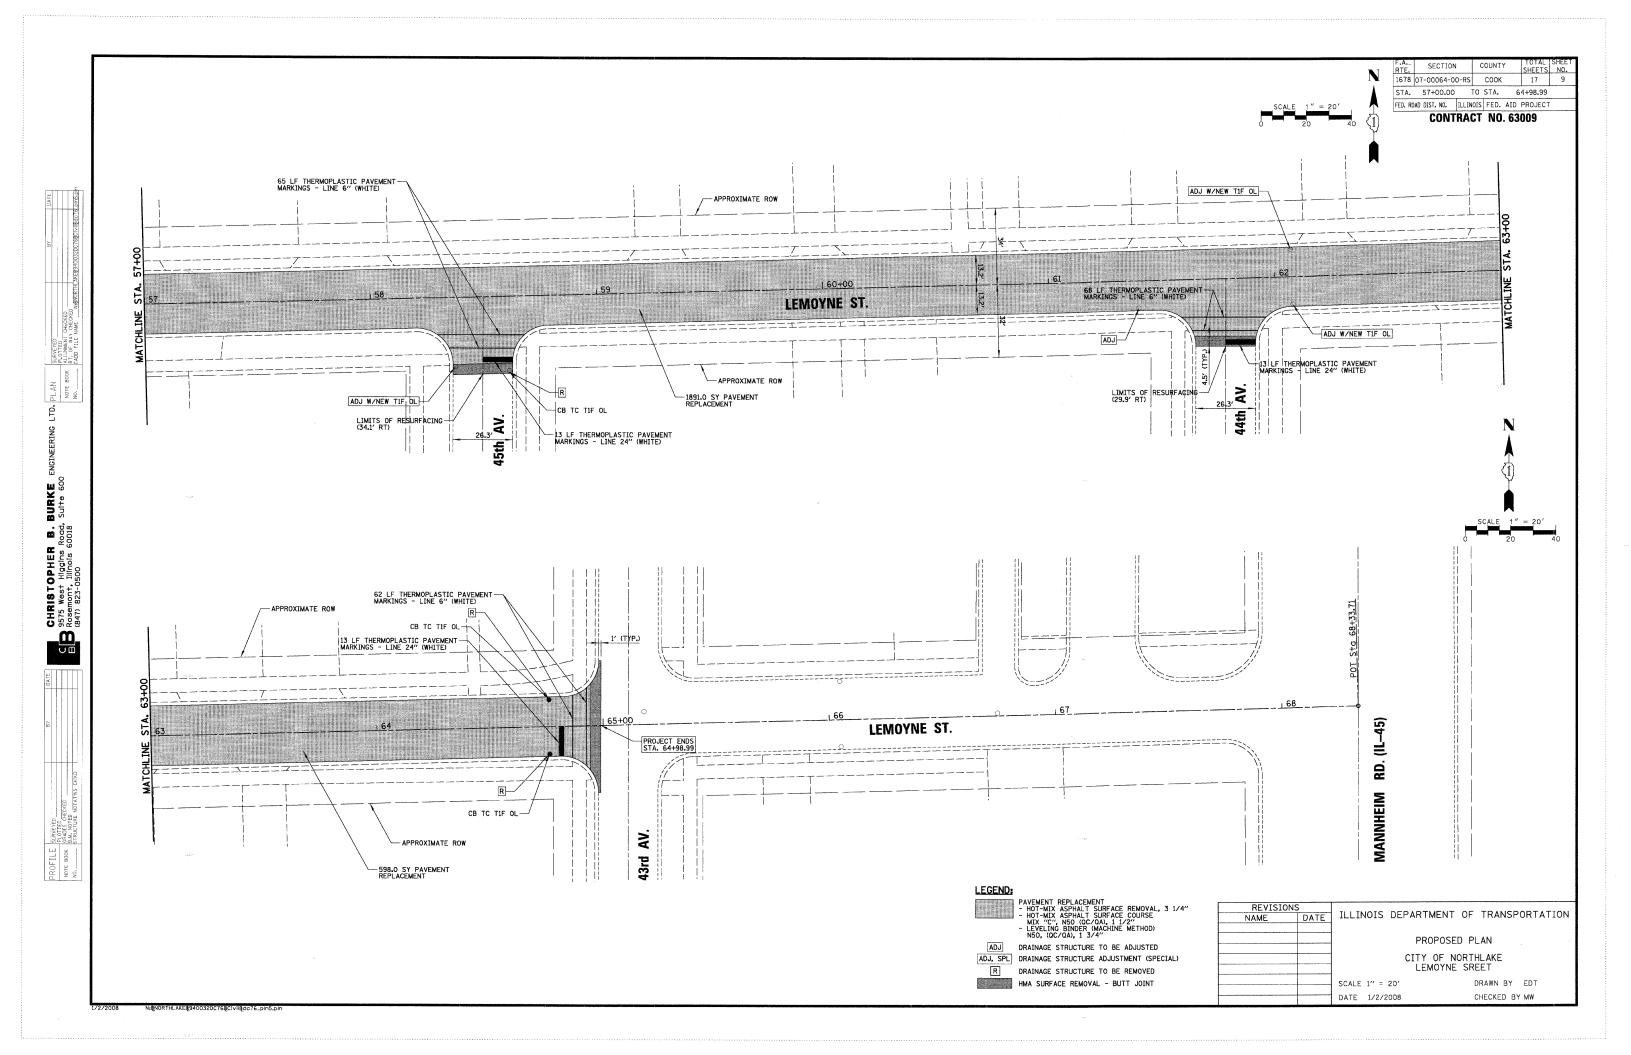


| F.A. | SECTION | COUN1 | SHEL1 | STA. | TO-11.90 | TO STA. | T3+44.76 | STA. | TO-11.90 | TO STA. | T3+44.76 | STA. | TO-11.90 | TO STA. | T3+44.76 | STA. | TO-11.90 | TO STA. | T3+44.76 | STA. | TO-11.90 | TO STA. | T3+44.76 | STA. | TO-11.90 | TO STA. | T3+44.76 | STA. | TO-11.90 | TO STA. | T3+44.76 | STA. | T3+

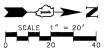

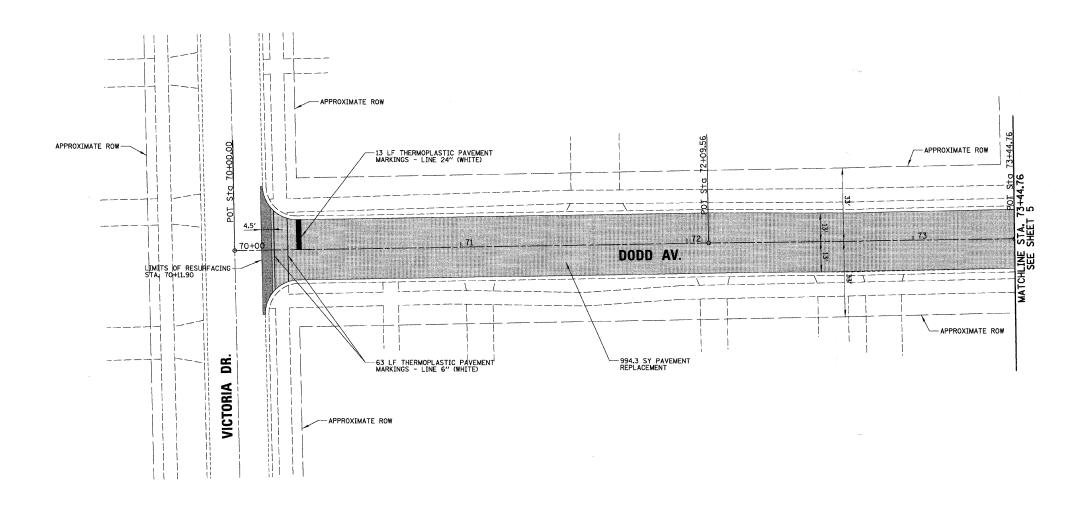

LEGEND:

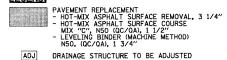


ADJ DRAINAGE STRUCTURE TO BE ADJUSTED

ADJ, SPL
DRAINAGE STRUCTURE ADJUSTMENT (SPECIAL)

| J, SPL | DRAINAGE STRUCTURE ADJUSTMENT (SPECIA |
|--------|---------------------------------------|
| R | DRAINAGE STRUCTURE TO BE REMOVED |
| | HMA SURFACE REMOVAL - BUTT JOINT |
| | |

| REVISIONS | *** ****** |
|-----------|---------------------------------------|
| NAME DATE | ILLINOIS DEPARTMENT OF TRANSPORTATION |
| | PROPOSED BLAN |
| | PROPOSED PLAN |
| | OTTY OF MODILII AVE |
| | CITY OF NORTHLAKE DODD AVENUE |
| | DODD AVENUE |
| | SCALE 1" = 20' DRAWN BY EDT |
| | DATE 1/2/2008 CHECKED BY MW |
| 1 | 1 |

CHRISTOPHER B. BURKE ENGINEERING LTD. PLAN GET 9575 West Higgins Road, Suite 600 NOTE 9 (847) 923-0500

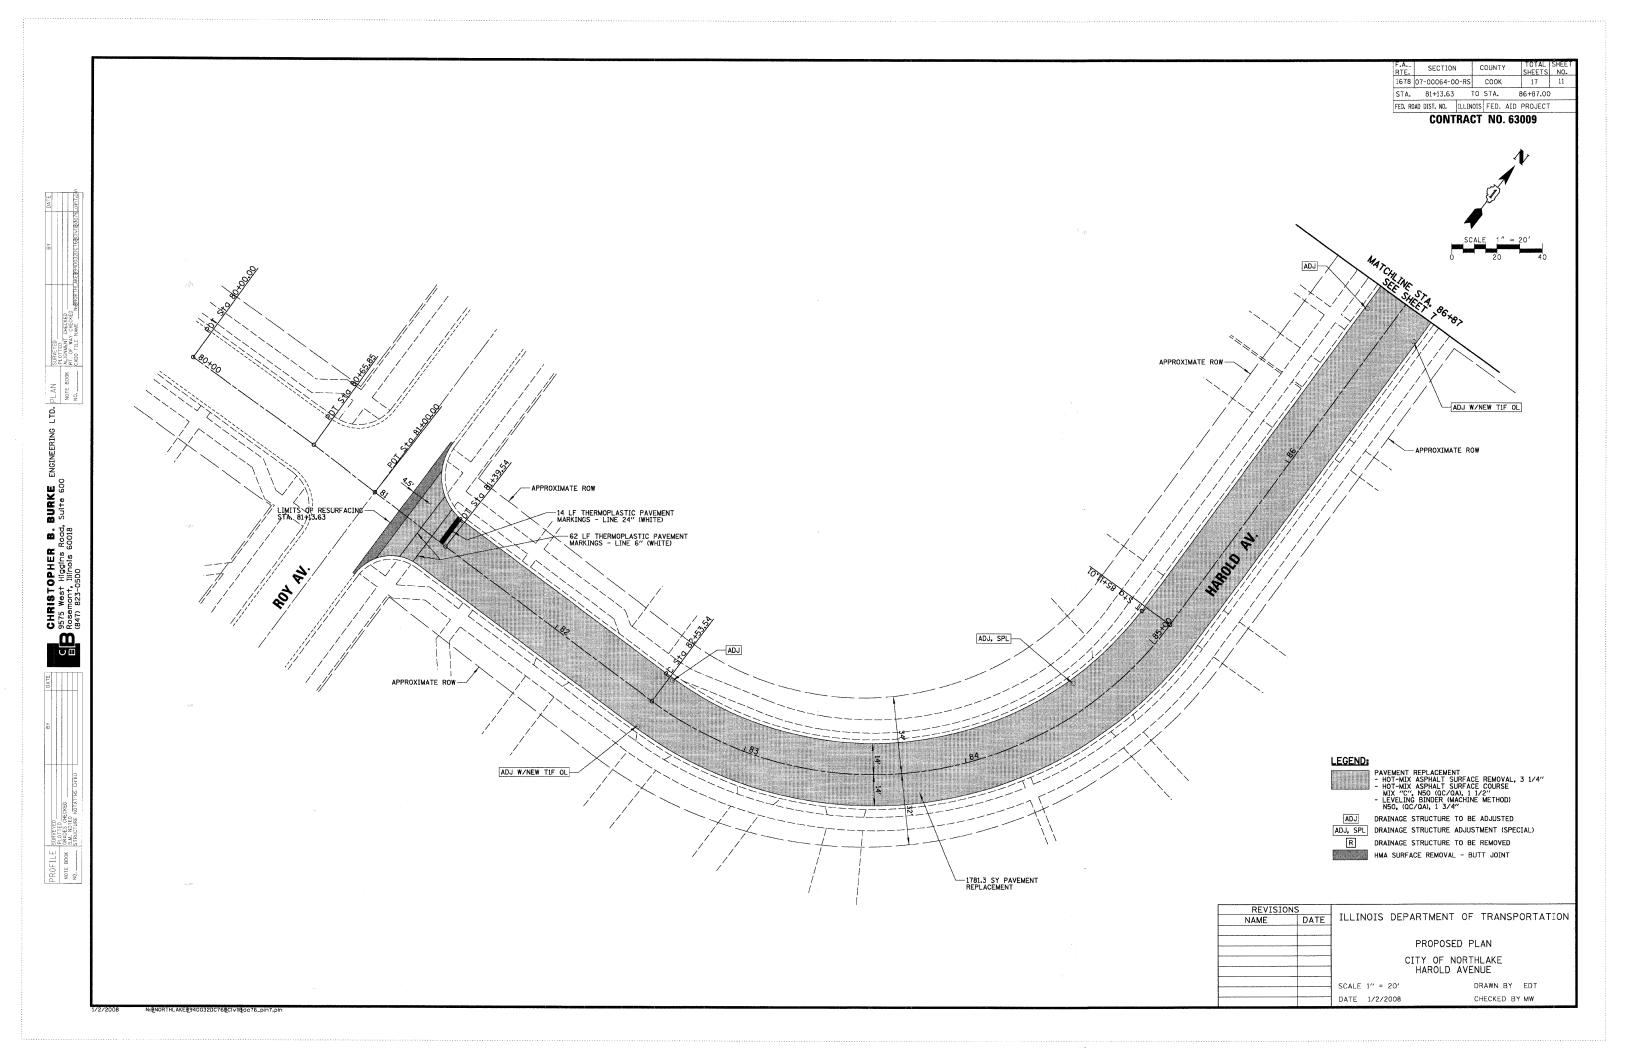

NORTH AVE. DRIVE MORSE LEMOYNE ST. 56 43 1 VICTORIA DRIVEVE 44+h 34 HIRSCH ST. **6**5 AROL AVE. SOFFEL AVE. SOFFEL AVE. ST. DIVISION NOTE:

LEMOYNE STREET SHALL BE CLOSED FOR THE APPLICATION OF THE WATERPROOFING MEMBRANE SYSTEM ONLY AND SHALL BE CLOSED FOR A MAXIMUM OF 3 DAYS.

| F.A. | SECTION | COUNTY | SHEETS | NO. | 1678 | 07-00064-00-RS | COOK | 17 | 12 | | STA. | TO STA. | FED. ROAD DIST. NO. | || ILLINOIS | FED. AID | PROJECT |

CONTRACT NO. 63009

SCHEDULE OF SIGNS

| SIGN NO. | SIGN TYPE | QUANTITY |
|----------|-------------------------------|----------|
| 1 | DETOUR W20-2 (0) 48 | 2 |
| 2 | DETDUR M4-9 (0) 30 21 | 4 |
| 3 | DETOUR M4-9 R (0) 30 21 | 3 |
| 4 | DETOUR M4-9 R (0) 30 21 | 3 |
| 5 | DETOUR M4-9 L (0) 30 21 | 3 |
| 6 | DETOUR M4-9 L (0) 30 21 | 3 |
| 7 | END DETOUR M4-8g (0) 24 18 | 2 |

LEGEND

96

SIGNALIZED INTERSECTION

\$ 46 S1

SIGN WITH AMBER FLASHING LIGHT NUMBER DENOTES TYPE.

M4-9 SERIES DETOUR SIGN WITH
ROAD NAME AND CARDINAL DIRECTION
PLATE, NUMBER DENOTES TYPE.

O OTHER DETOUR SIGNS. NUMBER DENOTES TYPE.

TYPE III BARRICADE WITH AMBER FLASHING LIGHTS.

DETOUR ROUTE

REVISIONS
NAME DATE

ILLINOIS DEPARTMENT OF TRANSPORTATION

DETOUR PLAN

CITY OF NORTHLAKE
LEMOYNE SREET

SCALE N.T.S. DRAWN BY EDT

CHECKED BY MW


DATE 1/2/2008

2008 N:BNC

ENGINEERING LTD. PLAN SINFETED A OTTER BOOK RT. OF WAY OFFEED NO. CAGO SIE NANC

CHRISTOPHER B. BURKE IS 9575 West Higgins Road, Sulte 600 B Rosemont, Illinois 60018 (847) 823-0500

NORTHLAKE#940032DC76#CIVIIBDC76_dtr1.p

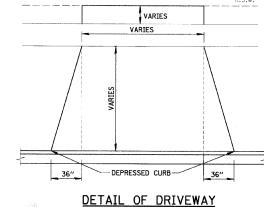


THIS TYPICAL DRIVE LAYOUT IS FOR BOTH CONCRETE AND ASPHALT DRIVES

- 7" P.C.C. DRIVEWAY PAVEMENT 2" SUB-BASE GRANULAR MATERIAL, TYPE B P.C.C. DRIVE

ASPHALT DRIVE - 2" HOT-MIX ASPHALT SURFACE COURSE, MIX "C", N50 (QC/QA)


NOTE: PROPOSED SIDEWALK THROUGH DRIVEWAY SHALL BE 7 INCHES OF PORTLAND CEMENT CONCRETE ON 2 INCH SUB-BASE GRANULAR MATERIAL, TYPE B.

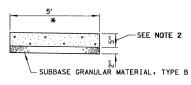

* CROSS SLOPE 2%

- 1. ALL REQUIRED EARTH EXCAVATION TO CONSTRUCT P.C.C. SIDEWALK SHALL BE INCLUDED IN THE COST FOR P.C.C. SIDEWALK.
- 2. WHEN FORMS ARE REMOVED FROM THE SIDEWALK EITHER THE SIDEWALK SHALL BE BARRICADED OR BACKFILLED WITHIN 24 HOURS.
- 3. ALL LANDSCAPE RESTORATION (TOPSOIL. SEEDING CLASS 1 AND SUPPLEMENTAL WATERING) SHALL BE INCLUDED IN THE COST FOR P.C.C. SIDEWALK.

P.C.C. SIDEWALK DETAIL

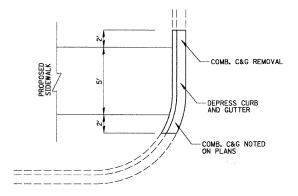


PROPOSED DEPRESSED CURB & GUTTER EXISTING CURB & GUTTER NOT DEPRESSED

EXISTING CURB AND GUTTER-

THERMOPLASTIC PAVEMENT MARKING - LINE 12" (WHITE, TYP.)

SECTION SHEETS NO. 1678 07-00064-00-RS COOK STA. FED. ROAD DIST. NO. | ILLINOIS | FED. AID PROJECT

CONTRACT NO. 63009

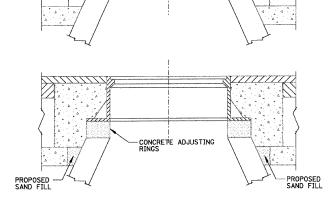

CONSTRUCTION PROCEDURES

STAGE I (BEFORE PAVEMENT MILLING)

- A) REMOVE A MINIMUM OF 12" OF THE PAVEMENT FROM AROUND THE STRUCTURE.

 B) REMOVE THE EXISTING FRAME AND LID FROM THE STRUCTURE.

 C) COVER THE STRUCTURE OPENING WITH A 36" DIAMETER METAL PLATE.

 D) BACKFILL WITH CRUSHED STONE AND A MINIMUM 11/2" THICK BITUMINOUS MATERIAL APPROVED BY THE ENGINEER.

STAGE II (AFTER PAVEMENT MILLING)

- A) REMOVE THE BITUMINOUS MATERIAL AND CRUSHED STONE.
 B) INSTALL THE FRAME AND LID: ADJUST THE FRAME TO ITS
 FINAL SURFACE ELEVATION.
 C) THE SURROUNDING SPACE SHALL BE FILLED WITH CLASS SI
 CONCRETE TO THE ELEVATION OF THE SURFACE OF THE
 EXISTING BASE COURSE.

THE PROCEDURE EXPLAINED ABOVE SHALL CONFORM TO THE APPLICABLE PORTIONS OF SECTIONS 353, 406, 602 AND 603 OF THE STANDARD SPECIFICATIONS.

LOCATION OF STRUCTURES

THE CONTRACTOR WILL BE REQUIRED TO KEEP A RECORD OF THE LOCATIONS OF THE BURIED STRUCTURES ACCORDING TO THE STATION AND DISTANCE LEFT OR RIGHT OF THE CENTERLINE OF PAVEMENT. UPON COMPLETION OF THE WORK. THE CONTRACTOR WILL DELIVER THE RECORD TO THE ENGINEER.

BASIS OF PAYMENT

DRAINAGE STRUCTURE ADJUSTMENT (SPECIAL).


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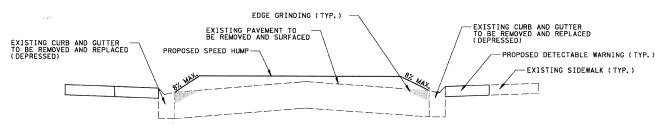
THERMOPLASTIC PAVEMENT MARKING - LINE 6" (WHITE, TYP.)

- AND DISPOSED OF BY THE CONTRACTOR AND SHALL BE REMOVED AND DISPOSED OF BY THE CONTRACTOR AND SHALL BE REPLACEMENT FRAMES AND LIDS WILL BE PAID FOR IN ACCORDANCE WITH ARTICLE 109.04 OF THE STANDARD SPECIFICATIONS UNLESS A SEPARATE PAY ITEM HAS BEEN PROVIDED.
- IF THE EXISTING LIDS ARE OPEN. THE FRAME WILL BE ADJUSTED TO THE ELEVATION OF THE MILLED PAVEMENT SURFACE PRIOR TO THE MILLING OPERATION. THE FRAME WILL NOT BE REMOVED AND COVERED BY THE METAL PLATE.
- 3. THE METAL PLATE USED TO COVER THE STRUCTURE SHALL REMAIN THE PROPERTY OF THE CONTRACTOR.

DRAINAGE STRUCTURE ADJUSTMENT (SPECIAL)

| REVISION | REVISIONS | | | | | | | | |
|----------|-----------|------------------------------------|------------------------------------|------|--|---|----------|--------|--|
| NAME | DATE | ILLIN | ILLINOIS DEPARTMENT OF TRANSPORTAT | | | | | | |
| | | CONSTRUCTION DETAILS | | | | | | | |
| | | CITY OF NORTHLAKE LEMOYNE SREET | | | | | | | |
| | | SCALE | N.T.S. | | | D | RAWN BY | EDT | |
| | - | DATE | 12/27/ | 2007 | | С | HECKED B | Y MW · | |



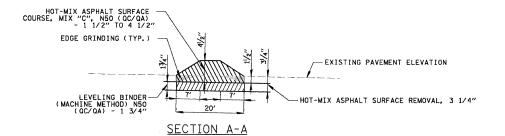

SECTION B-B

SPEED HUMP - PROFILES NOT TO SCALE

SPEED HUMP - PLAN NOT TO SCALE

EXISTING SIDEWALK

-DETECTABLE WARNING

-PROPOSED CURB AND GUTTER (DEPRESSED) (TYP,)

PROPOSED CURB AND GUTTER (DEPRESSED) (TYP.)

DETECTABLE WARNING EXISTING SIDEWALK

<u>a</u>

Road, 60018

FED. ROAD DIST. NO. ILLINOIS FED. AID PROJECT CONTRACT NO. 63009 VARIABLE - TO MEET EXISTING DIMENSIONS AND FIELD CONDITIONS (SEE NOTE 2) PROP. CONC. CURB OR CURB AND GUTTER REPLACEMENT IN ACCORDANCE WITH STATE STANDARD 606001. (SEE NOTE 2) SAW CUT FULL DEPTH - INCLUDED IN THE COST OF SIDEWALK, DRIVEWAY OR MEDIAN SURFACE REMOVAL SEE STATE STANDARD 606001 18 (450) MAX. EXISTING OR PROPOSED HMA SURFACE (IF APPLICABLE) 1/4 (5) *** EXISTING SIDEWALK, DRIVEWAY, MEDIAN SURFACE OR GROUND. PROPOSED SIDEWALK, DRIVEWAY PAVEMENT, MEDIAN SURFACE OR SEEDING, CLASS 1, EROSION CONTROL BLANKET AND TOP SOIL, 4 (100) RESTORATION (SEE NOTE (1)). ING CONCRETE PAVEMENT, CONCRETE BASE COURSE OR FLEXIBLE PAVEMENT SUITABLE BACKFILL MATERIAL -3 (75) MIN。 (INCLUDED IN THE COST OF CURB OR CURB AND GUTTER REMOVAL AND REPLACEMENT) * 3 (75) MINIMUM FROM TOP AND BOTTOM OF THE CONCRETE PAVEMENT OR BASE COURSE. PROPOSED 3/4" (20) PREFORMED EXPANSION JOINT AT CONCRETE SIDEWALKS, DRIVEWAYS, AND MEDIANS, (INCLUDED IN THE COST * * IF THE FINAL SURFACE OF THE PAVEMENT IS CONCRETE, THE GUTTER IS TO BE FLUSH OF CURB OR CURB AND GUTTER REMOVAL AND REPLACEMENT.) WITH THE PAVEMENT. NOTE: 1 SIDEWALK, DRIVEWAY PAVEMENT OR MEDIAN SURFACE SHALL BE SIMILAR TO THE MATERIAL BEING REMOVED AND WILL BE PAID FOR SEPARATELY. UNSUITABLE SUB-BASE MATERIAL TO BE REMOVED, IF DIRECTED BY THE ENGINEER, SHALL BE REPLACED WITH EITHER SUB-BASE GRANULAR SEEDING, CLASS 1, EROSION CONTROL BLANKET AND TOP SOIL, 4 (100) RESTORATION WILL MATERIAL, TYPE B OR ADDITIONAL THICKNESS OF CONCRETE. NOT BE PAID FOR SEPARATELY, BUT SHALL BE INCLUDED IN THE COST OF CURB OR CURB AND GUTTER REMOVAL AND REPLACEMENT. REMOVAL AND REPLACEMENT 4 (100) OR LESS IS INCLUDED IN THE 2 CURB OR CURB AND GUTTER REPLACEMENT SHALL MATCH THE SHAPE OF THE EXISTING COST OF CURB OR CURB AND GUTTER REMOVAL AND REPLACEMENT. CURB OR CURB AND GUTTER UNLESS OTHERWISE SPECIFIED. REMOVAL AND REPLACEMENT IN EXCESS OF 4 (100) WILL BE PAID FOR IN 3 FOR CURB OR CURB AND GUTTER REMOVAL AND REPLACEMENT ADJACENT TO FLEXIBLE ACCORDANCE WITH ARTICLE 109.04 OF THE STANDARD SPECIFICATIONS. PAVEMENT DELETE EPOXY COATED TIE BARS. (4) LONGITUDINAL BARS, IF ENCOUNTERED IN THE EXISTING CURB OR CURB AND GUTTER, ARE PROPOSED #6 (20) EPOXY COATED TIE BARS 24 (600) LONG AT 24 (600) CENTERS WILL NOT BE PAID FOR SEPARATELY. DELETE EPOXY NOT TO BE REPLACED. CUTTING AND REMOVING LONGITUDINAL BARS SHALL BE INCLUDED COATED TIE BARS IF EXISTING TIE BARS ARE USUABLE AS DETERMINED IN THE COST OF CURB OR CURB AND GUTTER REMOVAL AND REPLACEMENT. BY THE ENGINEER. (SEE NOTE (3)). (5) THE COST OF HMA SURFACE REMOVAL IN THE EXISTING GUTTER FLAG SHALL BE INCLUDED IN THE COST OF THE CURB AND GUTTER REMOVAL AND REPLACEMENT. BASIS OF PAYMENT: (6) THE REMOVAL AND REPLACEMENT OF THE EXISTING CURB OR CURB AND GUTTER SHALL BE DONE IN ACCORDANCE WITH THE APPLICABLE PORTIONS OF SECTION 440 AND 606 THIS WORK WILL BE PAID FOR AT THE CONTRACT UNIT PRICE PER FOOT (METER) FOR "CURB REMOVAL AND REPLACEMENT" OR OF THE STANDARD SPECIFICATIONS. "COMBINATION CONCRETE CURB AND GUTTER REMOVAL AND REPLACEMENT". 7 THE LOCATIONS OF REMOVAL AND REPLACEMENT OF EXISTING CURB OR CURB AND GUTTER SHALL BE DETERMINED BY THE RESIDENT ENGINEER AT THE TIME OF CONSTRUCTION. ALL DIMENSIONS ARE IN INCHES (MILLIMETERS) UNLESS OTHERWISE SHOWN. ILLINOIS DEPARTMENT OF TRANSPORTATION

CURB OR CURB AND GUTTER REMOVAL AND REPLACEMENT

G

SHEETS NO.

1678 07-00064-00-RS COOK


CURB AND GUTTER
REMOVAL AND REPLACEMENT

DRAWN BY


SCALE: VERT. NONE


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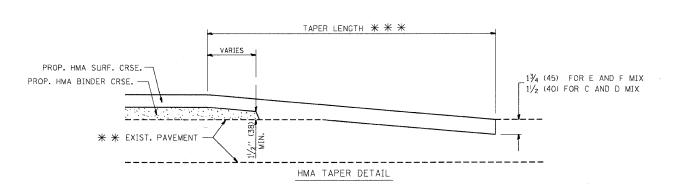
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TYPICAL BUTT JOINT AND HMA TAPER FOR RESURFACING ONLY

* * PC CONCRETE, HMA OR HMA RESURFACED PAVEMENT.

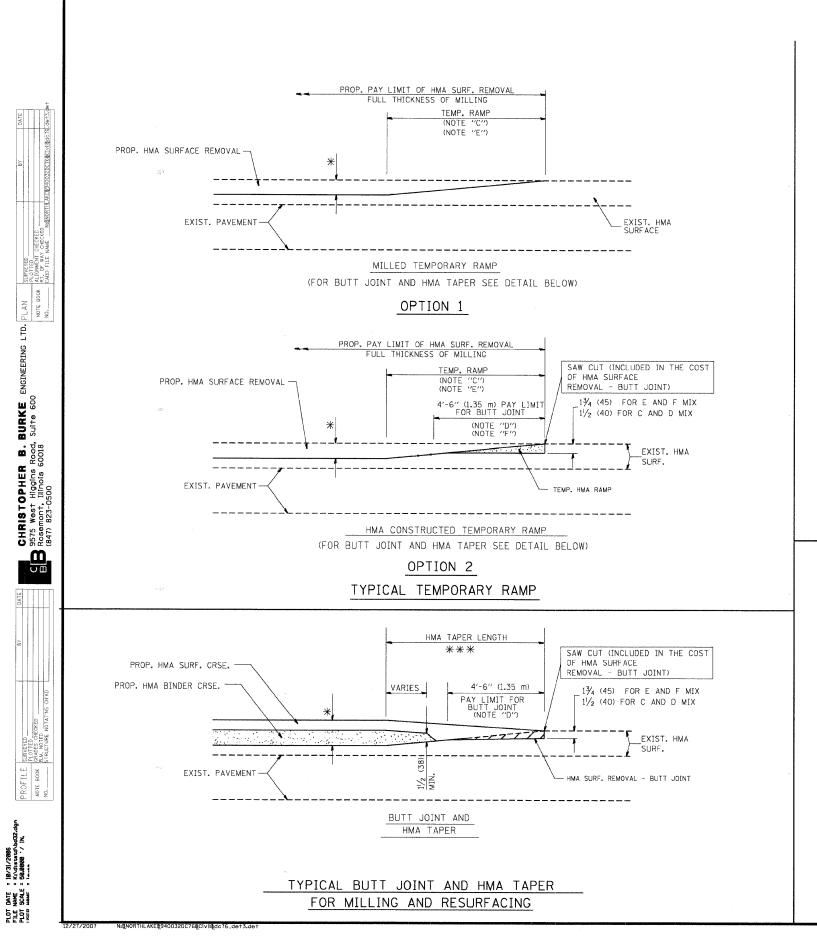- A: MAINLINE ROADWAYS AND MAJOR SIDE ROADS.
- B: MINOR SIDE ROADS.
- C: THE TEMP. RAMP SHALL BE CONSTRUCTED IMMEDIATELY UPON REMOVAL OF THE EXISTING HMA SURFACE.
- D: THE BUTT JOINT SHALL BE CONSTRUCTED IMMEDIATELY PRIOR TO PLACING THE PROPOSED HMA COURSES.
- E: TAPER THE TEMP. RAMP AT A RATE OF 3'-0" (900 mm) PER 1 INCH (25 mm) OF MILLING THICKNESS.
- F: INSTALLATION AND REMOVAL OF THE 4'-6" (1.35 m) TEMP. RAMP IS INCLUDED IN COST OF HMA SURFACE REMOVAL - BUTT JOINT
- G: SEE ARTICLE 406.08 AND 406.14 OF THE STANDARD SPECIFICATIONS FOR "HMA AND/OR PCC SURFACE REMOVAL, BUTT JOINT".
- * SEE TYPICAL SECTIONS FOR MILLING THICKNESS.
- \bigstar \bigstar 20'-0" (6.1 m) PER 1 (25) RESURFACING (NOTE "A") $_{10^{\prime}-0^{\prime\prime}}$ (3.0 m) PER 1 (25) RESURFACING (NOTE "B")

ALL DIMENSIONS ARE IN INCHES (MILLIMETERS) UNLESS OTHERWISE SHOWN.

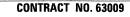BASIS OF PAYMENT:

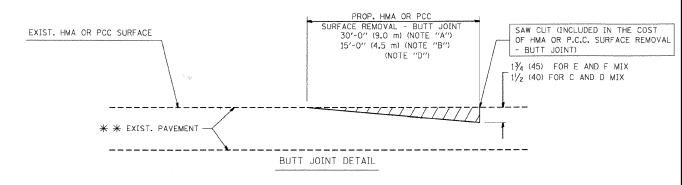THE BUTT JOINT WILL BE PAID FOR AT THE CONTRACT UNIT PRICE PER SQUARE YARD (SQUARE METER) FOR "HOIT-MIX ASPHALT SURFACE REMOVAL - BUTT JOINT" OR FOR "PORTLAND CEMENT CONCRETE SURFACE REMOVAL- BUTT JOINT".


| REVISIONS | | |
|------------|----------|-------|
| NAME | DATE | |
| M. DE YONG | 6-13-90 | |
| M. DE YONG | 7-3-90 | |
| M. DE YONG | 3-27-92 | |
| R. SHAH | 09/09/94 | |
| R. SHAH | 10/25/94 | |
| A. ABBAS | 03/21/97 | |
| M. GOMEZ | 04/06/01 | |
| R. BORO | 01/01/07 | sc |
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| | | - 101 |

ILLINOIS DEPARTMENT OF TRANSPORTATION

BUTT JOINT AND HMA TAPER DETAILS

CALE: VERT. NONE

BD400-05 (VI=BD32)

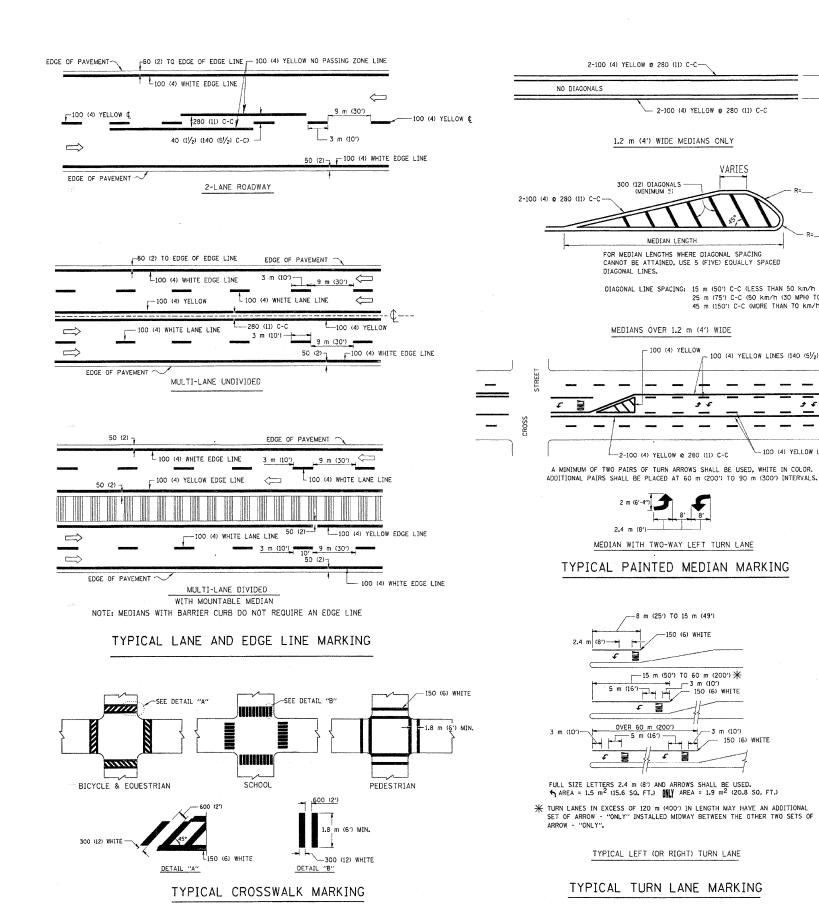

SECTION 1678 07-00064-00-RS COOK TO STA. FED. ROAD DIST. NO. | ILLINOIS | FED. AID PROJECT

CONTRACT NO. 63009

200 (8) WHITE ---300 (12) WHITE DIAGONALS @ 3 m (10') OR LESS SPACING ISLAND OFFSET FROM PAVEMENT EDGE 200 (8) WHITE --- 50 (2)

ISLAND

TYPICAL ISLAND MARKING

ISLAND AT PAVEMENT EDGE

| | TYPE OF MARKING | WIDTH OF LINE | PATTERN | COLOR | SPACING / REMARKS |
|-----------------------------------------|---------------------------------------------------------------------------------------------------|-----------------------------------------------------------------------------------------------------|-------------------------|---------------------------------------------------------|--------------------------------------------------------------------------------------------------------------------------------------------------------------------|
| LOW LINES (140 (5½) C-C) | CENTERLINE ON 2 LANE PAVEMENT | 100 (4) | SKIP-DASH | YELLOW | 3 m (10") LINE WITH 9 m (30") SPACE |
| | CENTERLINE ON MULTI-LANE UNDIVEDED PAVEMENT | 2 e 100 (4) | SOLID | YELLOW | 280 (11) C-C |
| | NO PASSING ZONE LINES: FOR ONE DIRECTION FOR BOTH DIRECTIONS | 100 (4) 2 0 100 (4) | SOLID SOLID | YELLOW YELLOW | 140 (5½) C-C FROM SKIP-DASH CENTERLINE 280 (11) C-C OMIT SKIP-DASH CENTERLINE BETWEEN |
| PAPERSON STORYS STORYS MARKET | LANE LINES | 100 (4) 125 (5) ON FREEWAYS | SKIP-DASH SKIP-DASH | WHITE WHITE | 3 m (10') LINE WITH 9 m (30') SPACE |
| 100 (4) YELLOW LINES (140 (51/2) C-C) | DOTTED LINES (EXTENSIONS OF CENTER, LANE OR TURN LANE MARKINGS) | SAME AS LINE BEING EXTENDED | SKIP-DASH | SAME AS LINE BEING EXTENDED | 600 (2') LINE WITH 1.8 m (6') SPACE |
| D, WHITE IN COLOR. m (300') INTERVALS. | EDGE LINES | 100 (4) | SOLID | YELLOW-LEFT WHITE-RIGHT | OUTLINE MOUNTABLE MEDIANS IN YELLOW; EDGE LINES ARE NOT USED NEXT TO BARRIER CURB |
| | TURN LANE MARKINGS | 150 (6) LINE; FULL SIZE LETTERS & SYMBOLS (2.4 m (8')) | SOLID | WHITE | SEE TYPICAL TURN LANE MARKING DETAIL |
| | TWO WAY LEFT TURN MARKING | 2 0 100 (4) EACH DIRECTION | SKIP-DASH AND SOLID | YELLOW | 3 m (10') LINE WITH 9 m (30') SPACE FOR SKIP-DASH: 140 (5½) C-C BETWEEN SOLID LINE AND SKIP-DASH LINE |
| MRKING WHITE | | 2.4 m (8') LEFT ARROW | IN PAIRS | WHITE | SEE TYPICAL TWO-WAY LEFT TURN MARKING DETAIL |
| | CROSSWALK LINES (PEDESTRIAN) A. DIACONALS (BIKE & EQUESTRIAN) B. LONGITUDINAL BARS (SCHOOL) | 2 @ 150 (6) 300 (12) @ 45° 300 (12) @ 90° | SOLID SOLID SOLID | WHITE WHITE WHITE | NOT LESS THAN 1.8 m (6') APART 600 (2') APART 600 (2') APART SEE TYPICAL CROSSWALK MARKING DETAILS. |
| | STOP LINES | 600 (24) | SOLID | WHITE | PLACE 1.2 m (4') IN ADVANCE OF AND PARALLEL TO CROSSWALK, IF PRESENT. OTHERWISE, PLACE AT DESIRED STOPPING POINT. PARALLEL TO CROSSROAD CENTERLINE, WHERE POSSIBLE |
| | PAINTED MEDIANS | 2 m 100 (4) WITH 300 (12) DIAGONALS @ 45° NO DIAGONALS USED FOR 1.2 m (4') WIDE MEDIANS | SOLID | YELLOW: TWO WAY TRAFFIC WHITE: ONE WAY TRAFFIC | 280 (11) C-C FOR THE DOUBLE LINE SEE TYPICAL PAINTED MEDIAN MARKING. |
| | GORE MARKING AND CHANNELIZING LINES | 200 (8) WITH 300 (12) DIAGONALS & 45° | SOLID | WHITE | DIAGONALS: 4.5 m (15') C-C (LESS THAN 50 km/h (30 MPH)) 6 m (20') C-C (50 km/h (30 MPH) TO 70 km/h (45 MPH) 9 m (30') C-C (OVER 70 km/h (45 MPH)) |
| | RAILROAD CROSSING | 600 (24) TRANSVERSE LINES; "RR" IS 1.8 m (6') LETTERS; 400 (16) LINE FOR "X" | SOLID | WHITE | SEE STATE STANDARD 780001 AREA OF: "M"=0.33m2 (3.6 SO. FT.) EACH "X"=5.0 m2 (54.0 SO. FT.) |
| | SHOULDER DIAGONALS | 300 (12) @ 45° | SOLID | WHITE - RIGHT YELLOW - LEFT | 15 m (50') C-C (LESS THAN 50 km/h (30 MPH)) 25 m (75') C-C (50 km/h (30 MPH) TO 70 km/h (45 MPH) 45 m (150') C-C (OVER 70 km/h (45 MPH)) |

FOR FURTHER DETAILS ON PAVEMENT MARKING REFER TO STANDARD SPECIFICATIONS FOR ROAD AND BRIDGE CONSTRUCTION AND STATE STANDARD 780001.

All dimensions are in millimeters (inches) unless otherwise shown.

ILLINOIS DEPARTMENT OF TRANSPORTATION

DISTRICT ONE TYPICAL PAVEMENT MARKINGS

SCALE: NONE

DRAWN BY CADD

TYPICAL TURN LANE MARKING

TYPICAL LEFT (OR RIGHT) TURN LANE

2-100 (4) YELLOW @ 280 (11) C-C-

300 (12) DIAGONALS (MINIMUM 5)

DIAGONAL LINES.

- 2-100 (4) YELLOW @ 280 (11) C-C

1.2 m (4') WIDE MEDIANS ONLY

MEDIAN LENGTH FOR MEDIAN LENGTHS WHERE DIAGONAL SPACING

MEDIANS OVER 1.2 m (4') WIDE

-2-100 (4) YELLOW & 280 (11) C-C

MEDIAN WITH TWO-WAY LEFT TURN LANE

TYPICAL PAINTED MEDIAN MARKING

-8 m (25') TO 15 m (49')

OVER 60 m (200') 5 m (167)

----15 m (50°) T0 60 m (200°) ★

150 (6) WHITE

CANNOT BE ATTAINED, USE 5 (FIVE) EQUALLY SPACED

DIAGONAL LINE SPACING: 15 m (50') C-C (LESS THAN 50 km/h (30 MPH))

25 m (75") C-C (50 km/h (30 MPH) T0 70 km/h (45 MPH)) 45 m (150") C-C (MORE THAN 70 km/h (45 MPH))

- 100 (4) YELLOW LINES (140 (51/2) C-C)


1.2 m (4') OUTSIDE TO

OUTSIDE OF LINES

<u>G</u>

SECTION 1678 07-00064-00-RS COOK TO STA. STA. FED. ROAD DIST. NO. | ILLINOIS | FED. AID PROJECT

CONTRACT NO. 63009

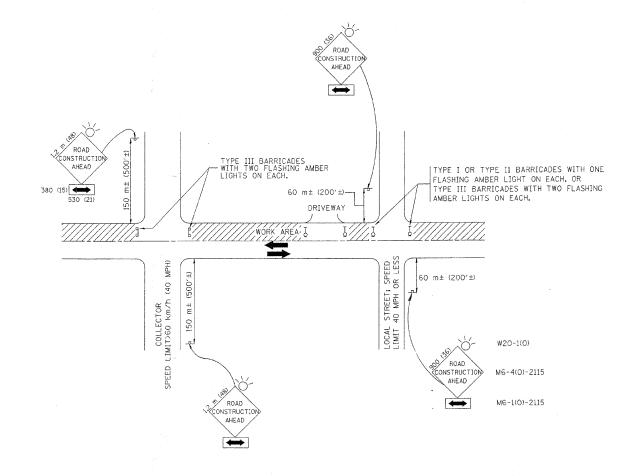

TRAFFIC CONTROL AND PROTECTION FOR SIDE ROADS, INTERSECTIONS, AND DRIVEWAYS

NOTES:

- A. FOR NO LANE RESTRICTION ON THE SIDE ROAD OR DRIVEWAYS
- 1. SIDE ROAD WITH A SPEED LIMIT OF 60 km/h (40 MPH) OR LESS AS SHOWN ON THE DRAWING AND AS DIRECTED BY THE ENGINEER:
- d) ONE ROAD CONSTRUCTION AHEAD SIGN 900×900 (36x36) WITH A FLASHER AND FLAG MOUNTED ON IT APPROXIMATELY 60 m (200') IN ADVANCE OF THE MAIN ROUTE.
- b) THE CLOSED PORTION OF THE MAIN ROUTE SHALL BE PROTECTED BY BLOCKING WITH TYPE I. TYPE II OR TYPE III BARRICADES, 1/3 OF THE CROSS SECTION OF THE CLOSED PORTION.
- 2. SIDE ROAD WITH A SPEED LIMIT GREATER THAN 60 km/h (40 MPH) AS SHOWN ON THE DRAWING AND AS DIRECTED BY THE ENGINEER:
- a) ONE ROAD CONSTRUCTION AHEAD SIGN 1.2 m x 1.2 m (48×48) WITH A FLASHER MOUNTED ON IT APPROXIMATELY 150 m (500°) IN ADVANCE OF THE MAIN ROUTE.
- b) THE CLOSED PORTION OF THE MAIN ROUTE SHALL BE PROTECTED BY BLOCKING WITH TYPE III BARRICADES, 1/2 OF THE CROSS SECTION OF THE CLOSED PORTION.
- 3. WHEN THE SIDE ROAD LIES BETWEEN THE BEGINNING OF THE MAINLINE SIGNING AND THE WORK ZONE, A SINGLE HEADED ARROW (M6-1) SHALL BE USED IN LIEU OF THE DOUBLE HEADED ARROW (M6-4).

- B. FOR A LANE CLOSURE ON A SIDE ROAD OR DRIVEWAY:
- USE APPLICABLE PORTIONS OF THE TYPICAL APPLICATION OF TRAFFIC CONTROL DEVICES (STD. 701501, STD. 701606 OR THE APPROPRIATE STANDARD). THE SPACING OF SIGNS AND BARRICADES SHALL BE ADJUSTED FOR FIELD CONDITIONS AS DIRECTED BY THE ENGINEER. THE DIRECTIONAL ARROW SHALL BE COVERED OR REMOVED WHEN NO LONGER CONSISTENT WITH THE SIDE ROAD LANE CLOSURE.
- C. ADVANCE WARNING SIGNS ARE TO BE OMITTED ON DRIVEWAY UNLESS
- D. THE TRAFFIC CONTROL AND PROTECTION FOR SIDE ROADS, INTERSECTIONS, AND DRIVEWAYS SHALL BE INCIDENTAL TO THE COST OF SPECIFIED TRAFFIC CONTROL STANDARDS OR ITEMS.

All dimensions are in millimeters (inches) unless otherwise shown.

| | IL | ILLINOIS DEPARTMENT OF TRANSPORTATION | | | | | | | |
|-------------------|--------------|---------------------------------------|---------|---------|----------|---------|--|--|--|
| REVISIONS | TRAI | FFIC CO | NTROL | AND | PROTEC | TION | | | |
| NAME D | ATE | | FOR | | | | | | |
| | 789 CTC | | CINTE | Dere | TIONS | A N : D | | | |
| T. RAMMACHER 09/0 | 08/94 SIL | E ROAD | S, INTE | K2FC | 110N5, | AND | | | |
| | 18/95 | DRIVEWAYS | | | | | | | |
| A. HOUSEH 03/C | 06/96 | | DIVIAC | 11/1/1/ | | | | | |
| | 15/96 SCALE: | NONE | | r | DRAWN BY | | | | |
| T. RAMMACHER 01/0 | 06/00 | | | | | | | | |

R B. BURKE E 8 Rodd, Suite 600 60018