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- PROPOSED PLAN
- 6. PAVEMENT MARKING AND SIGNAGE PLAN
- 7. LIGHTING PLAN
- 8. LIGHTING DETAILS
- 9.-10. CROSS SECTIONS
- 11.-12. DISTRICT STANDARDS

STATE STANDARDS

000001-05 STANDARD SYMBOLS, ABBREVIATIONS AND PATTERNS

280001-04 TEMPORARY EROSION CONTROL SYSTEMS

424001-05 CURB RAMPS FOR SIDEWALKS

606001-03 CONCRETE CURB TYPE B & COMBINATION CONCRETE CURB & GUTTER

701006-02 OFF-ROAD OPERATIONS, 2L, 2W

701301-02 LANE CLOSURE, 2L, 2W, SHORT TIME OPERATIONS

701311-02 LANE CLOSURE, 2L, 2W, MOVING OPERATIONS-DAY ONLY 701501-04 URBAN LANE CLOSURE, 2L, 2W, UNDIVIDED

701801-03 URBAN LANE CLOSURE, ML, 2W, CROSSWALK AND SIDEWALK CLOSURE

701901 TRAFFIC CONTROL DEVICES

720001 SIGN PANEL MOUNTING DETAILS

720006-01 SIGN PANEL ERECTION DETAILS

720011 METAL POSTS FOR SIGNS, MARKERS, AND DELINEATORS
729001 APPLICATIONS OF TYPE A AND B METAL POSTS (FOR SIGNS & MARKERS)

780001-01 TYPICAL PAVEMENT MARKINGS

805001 ELECTRIC SERVICE INSTALLATION DETAILS


DESIGN DESIGNATION - TRACY AVENUE ADT 5,600 (2030) - LOCAL ROAD PV=4,928 SU=392 MU=280

TRACY AVENUE

2006 ADT - 5,500 2030 ADT - 5,600

POSTED SPEED LIMIT - 25 MPH

DESIGN PERIOD — 20 YEARS DESIGN SPEED LIMIT — 30 MPH STREET CLASSIFICATION — CLASS III

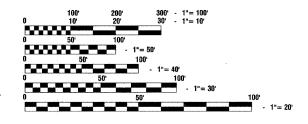

FULL SIZE PLANS HAVE BEEN PREPARED USING STANDARD ENGINEERING SCALES, REDUCED SIZED PLANS WILL NOT CONFORM TO STANDARD SCALES, IN MAKING MEASUREMENTS ON REDUCED PLANS, THE ABOVE SCALES MAY BE USED.


J. U. L. I. E.
JOINT UTILITY LOCATION INFORMATION FOR EXCAVATION
1 - 800 - 892 - 0123

CONTRACT NO. 63006

STATE OF ILLINOIS
DEPARTMENT OF TRANSPORTATION
DIVISION OF HIGHWAYS

PLANS FOR PROPOSED FEDERAL AID HIGHWAY

IVANHOE METRA COMMUTER KISS 'N RIDE
TRACY AVENUE BETWEEN 143RD ST. AND 144TH ST.
CMAQ PROJECT NO.: CMM-8003(584)
L.A. SECTION NO:05-00113-00-PK
VILLAGE of RIVERDALE
COOK COUNTY
C-91-133-06

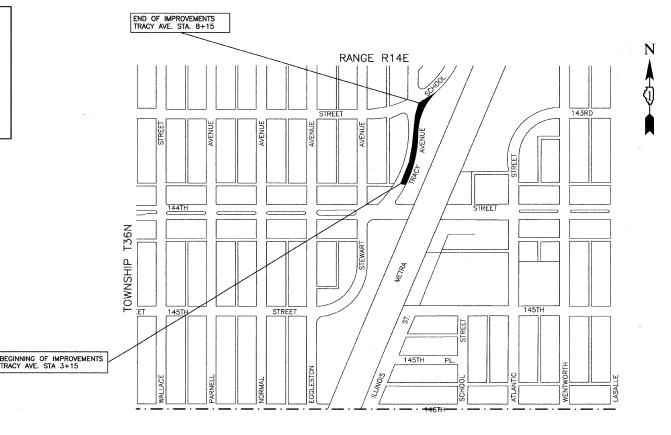



LOCATION MAP

GROSS LENGTH=528 FEET=0.10 MILES
NET LENGTH=528 FEET=0.10 MILES




CONTRACT NO. 63006

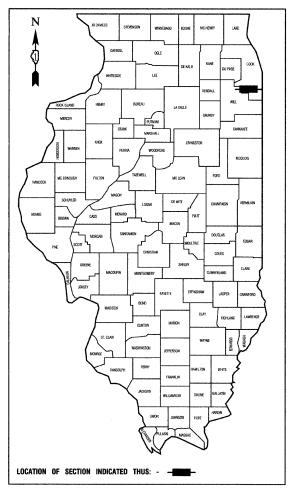

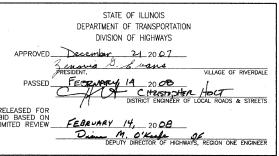

PRINTED BY THE AUTHORITY OF THE STATE OF ILLINOIS

PREPARED BY OR UNDER THE DIRECT SUPERVISION OF:

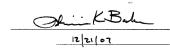

C2-51255

REGISTERD
PROTESSIONAL
PROMEER

UCENSE EXPRES: 11/30/09

| | | SUMMARY OF QUANTITIES | | | PAVEMENT | MARKINGS | | LANDSCAPE | | | <u></u> | |
|---------|----------------|---|-------|----------|----------|---|-----------------------|-----------------------|----------------------|------|----------|---|
| P. S.I. | CODE NO. | PAY ITEM | UNIT | QUAN | 1000 | SFTY-1D | Y002-1C | | TYPE CODE Y030-1E | | T | T |
| | 20100110 | TREE REMOVAL (6 TO 15 UNITS DIAMETER) | UNIT | 14 | | | | 14 | 1020 12 | 1 | | |
| | 20100210 | TREE REMOVAL (OVER 15 UNITS DIAMETER) | UNIT | 21 | | | | 21 | | | | |
| | 20101000 | TEMPORARY FENCE | FOOT | 50 | | | | 50 | | | | |
| | 20101200 | TREE ROOT PRUNING | EACH | 7 | | | | 7 | | | | |
| | 20200500 | EARTH EXCAVATION (WIDENING) | CU YD | 205 | 205 | | | | | + | | |
| | 20201200 | REMOVAL AND DISPOSAL OF UNSUITABLE MATERIAL | CU YD | 23.5 | 23.5 | | and the second by the | eren 6 17 1 a = 18 11 | | | | |
| | 20700420 | POROUS GRANULAR EMBANKMENT, SUBGRADE | CU YD | 23.5 | 23.5 | | | | | | | |
| | 21001000 | GEOTECHNICAL FABRIC FOR GROUND STABILIZATION | SQ YD | 71 | 71 | | | | | | | |
| | 21101615 | TOPSOIL FURNISH AND PLACE, 4" | SQ YD | 167 | | | | 167 | | | | |
| - | 25000400 | NITROGEN FERTILIZER NUTRIENT | POUND | 3 | | er a company of the | | 3 | | | | |
| | 25000500 | PHOSPHORUS FERTILIZER NUTRIENT | POUND | 3 | | - | | 3 | | | | |
| - | + | | | 3 | | | | 3 | | | | |
| | 25000600 | POTASSIUM FERTILIZER NUTRIENT | POUND | 167 | | | ,, | 167 | | | | |
| . | 25200100 | SODDING | SQ YD | | | | | | | | | |
| | 25200200 | SUPPLEMENTAL WATERING | UNIT | 5 | | | | 5 | | | | |
| | 28000400 | PERIMETER EROSION BARRIER | FOOT | 500 | | | | 500 | | | ļ | |
| - | 28000510 | INLET FILTERS | EACH | 3 | | | | 3 | | | | |
| | 35101600 | AGGREGATE BASE COURSE, TYPE B 4" | SQ YD | 415 | 415 | | | | | | | |
| | 40600100 | BITUMINOUS MATERIAL (PRIME COAT) | GAL | 118 | 118 | | | | | | | |
| | 40600300 | AGGREGATE (PRIME COAT) | TON | 2 | 2 | | | | | | | |
| | 40701801 | HOT-MIX ASPHALT PAVEMENT (FULL-DEPTH), 6" | SQ YD | 394 | 394 | | | | | | | |
| | 42001300 | PROTECTIVE COAT | SQ YD | 452 | 452 | | | | | | | |
| | 42400200 | PORTLAND CEMENT CONCRETE SIDEWALK 5 INCH | SQ FT | 3170 | | | | | | | * | |
| . | 42400800 | DETECTABLE WARNINGS | SQ FT | 12 | 12 | | | | | | | |
| | 44000100 | PAVEMENT REMOVAL | SQ YD | 96 | 96 | | | | | | _ | |
| | 44000500 | COMBINATION CURB AND GUTTER REMOVAL | FOOT | 445 | 445 | | | | | | | |
| | 44000600 | SIDEWALK REMOVAL | SQ FT | 50 | 50 | | | | | | | |
| . | 60603800 | COMBINATION CONCRETE CURB AND GUTTER, TYPE B-6.12 | FOOT | 445 | 445 | | | | | | | |
| | 67100100 | MOBILIZATION | L SUM | 1 | 1 | | | | | | | |
| | 70102620 | TRAFFIC CONTROL AND PROTECTION, STANDARD 701501 | L SUM | 1 | 1 | | | | | , , | 1 | |
| | 70102640 | TRAFFIC CONTROL AND PROTECTION, STANDARD 701801 | L SUM | 1 | 1 | | | | | | | |
| | 72000100 | SIGN PANEL - TYPE 1 | SQ FT | 4.88 | | | 4.88 | | | | | |
| | 72900200 | METAL POST TYPE B | FOOT | 14 | | | 14 | | | | | |
| * | 78000200 | THERMOPLASTIC PAVEMENT MARKING - LINE 4" | FOOT | 1013 | | 1013 | | | | | | |
| * | 78000650 | THERMOPLASTIC PAVEMENT MARKING - LINE 24" | FOOT | 35 | | . 35 | | | | : | | |
| * | 81603040 | UNIT DUCT, 600V, 2-1C NO.6, 1/C NO.8 GROUND, (XLP-TYPE USE), 1" DIA. POLYETHYLENE | FOOT | 500 | | *************************************** | | | 500 | | | |
| * | 83600200 | LIGHT POLE FOUNDATION, 24" DIAMETER | FOOT | 14 | | | | | 14 | | 1 | |
| * | XX001399 | UNIT DUCT, BORED AND PULLED | FOOT | 460 | | | | | 460 | | | |
| * | XX005669 | RELOCATE EXISTING LIGHTING UNIT | EACH | 2 | | | | | 2 | | | |
| * | XX006937 | GROUND ROD, 5/8" DIA. X 10 FT. | EACH | 2 | | | | | 2 | | 1 | |
| * | X0321478 | MAINTENANCE OF EXISTING LIGHTING SYSTEM COMPLETE | L SUM | 1 | | | | | 1 | 1 | | |
| * | - | REMOVE EXISTING LIGHT POLE FOUNDATION | EACH | 2 | - 4 | | | | 2 | | | |
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| 1 | 1 | | | . | | | | | | | | |

* - INDICATES SPECIALTY ITEMS

Δ - INDICATES SPECIAL PROVISION

| F. A. U. RTE. | SECTION | | SECTION COUNTY | | | SHEET NO | | |
|------------------|----------------|----------|----------------|-----------------|-------|-------------|--|--|
| | 05-00113-00-PK | | COOK | 01 | 2 002 | ! | | |
| STA. TO STA. | | | | | | | | |
| FED. R | CAD DIST, NO. | ILLINOIS | S SED. A | FED. AD PROJECT | | | | |

CONTRACT NO. 63006

ILLINOIS DEPARTMENT OF TRANSPORTATION

IVANHOE METRA COMMUTER KISS 'N RIDE SUMMARY OF QUANTITIES & GENERAL NOTES

SCALE: VERT.
HORIZ. NONE
DATE 11-1-07

FOBINSON ENGINEER/
708 31-978 (2004) PIRM REGISTRATO/
REMOTE DESCRIPTION REGISTRATO/

DRAWN BY PS/EDG

| F. A. U. RTE. | SECTION COUNTY | | TOTAL SHEETS | SHEET NO | | | |
|------------------|----------------|----|-----------------|-------------|-----|------|--|
| 050011300 | | PK | COOK | | 012 | 002A | |
| STA. | | | TO STA. | | | | |
| PED. R | LUNO | 5 | FED. AID PR | DJECT | | | |

CONTRACT NO. 63006

GENERAL NOTES

- ANY REFERENCE TO STANDARDS THROUGHOUT THE PLANS OR SPECIAL PROVISIONS SHALL BE INTERPRETED TO BE THE LATEST STANDARDS OF THE ILLINOIS DEPARTMENT OF TRANSPORTATION.
- 2. ITEMS OF WORK LISTED IN THE SUMMARY OF QUANTITIES WHICH ARE NOT SPECIFICALLY INDICATED IN THE PLANS SHALL BE PERFORMED AT LOCATIONS AS DIRECTED BY THE ENGINEER.
- 3. WHEN, IN THE CONSTRUCTION OPERATION, ANY LOOSE MATERIAL IS DEPOSITED IN THE FLOW LINE OF DITCHES, GUTTERS OR OTHER DRAINAGE STRUCTURES SO THAT THE NATURAL FLOW OF WATER IS OBSTRUCTED, IT SHALL BE REMOVED AT THE CLOSE OF EACH DAY BY THE CONTRACTOR AT HIS EXPENSE. AT THE CONCLUSION OF THE CONSTRUCTION OPERATIONS, ALL DRAINAGE STRUCTURES SHALL BE FREE FROM ALL DIRT AND DEBRIS. THIS WORK SHALL NOT BE PAID FOR SEPARATELY BUT SHALL BE CONSIDERED INCIDENTAL TO THE CONTRACT.
- 4. WHEN EXISTING DRAINAGE FACILITIES ARE DISTURBED, THE CONTRACTOR SHALL PROVIDE AND MAINTAIN TEMPORARY OUTLETS AND CONNECTIONS FOR ALL PRIVATE OR PUBLIC DRAINS, SEWERS OR CATCH BASINS. HE SHALL PROVIDE FACILITIES TO TAKE IN ALL STORM WATER WHICH WILL BE RECEIVED BY THESE DRAINS & SEWERS AND DISCHARGE SAME. HE SHALL PROVIDE AND MAINTAIN AN EFFICIENT PUMPING PLANT, IF NECESSARY, AND A TEMPORARY OUTLET, AND BE PREPARED AT ALL TIMES TO DISPOSE OF THE WATER RECEIVED FROM THESE TEMPORARY SEWER CONNECTIONS UNTIL SUCH TIME AS THE PERMANENT CONNECTIONS WITH SEWERS ARE BUILT AND IN SERVICE. THIS WORK SHALL NOT BE PAID FOR DIRECTLY, BUT WILL BE CONSIDERED INCIDENTAL TO THE CONTRACT.
- 5. THE APPROXIMATE LOCATION OF KNOWN PUBLIC UTILITIES ARE SHOWN ON THE PLANS. HOWEVER, THE DEPARTMENT DOES NOT GUARANTEE ITS ACCURACY. PRIOR TO COMMENCING OPERATIONS ON THE PROJECT WHICH MAY IN ANY WAY CREATE THE POSSIBILITY OF INVOLVEMENT WITH EXISTING UTILITIES, THE CONTRACTOR SHALL CONTACT THE FIRM (OR COMMUNITY) INVOLVED. ADJUSTMENT OF ALL PUBLIC UTILITIES WITHIN THE LIMITS OF THIS IMPROVEMENT WILL BE DONE BY THE RESPECTIVE OWNERS. NO ADDITIONAL COMPENSATION WILL BE ALLOWED DUE TO DELAYS OR INCONVENIENCE CAUSED BY THESE ADJUSTMENTS. IT SHALL BE THE CONTRACTOR'S RESPONSIBILITY TO VERIFY LOCATIONS OF UNDERGROUND INSTALLATION BEFORE STARTING CONSTRUCTION OPERATIONS.
- ALL TRENCHES WITHIN 2 FEET OF PROPOSED PAVEMENT, DRIVEWAYS, AND SIDEWALKS SHALL BE BACKFILLED WITH TRENCH BACKFILL ONLY.
- 7. THE CONTRACTOR SHALL PROTECT ALL TREES WITHIN AND ADJACENT TO THE CONSTRUCTION SITE DURING THE CLEARING AND SUBSEQUENT CONSTRUCTION OPERATIONS IN ACCORDANCE WITH SECTION 201 OF THE STANDARD SPECIFICATIONS. THOSE TREES TO BE REMOVED AS SHOWN IN THE PLANS SHALL BE DONE IN ACCORDANCE WITH SECTION 201 AND 202 OF THE STANDARD SPECIFICATIONS.
- 8. BEFORE STARTING ANY EXCAVATION, THE CONTRACTOR SHALL CALL "JULIE" AT 800-892-0123 FOR FIELD LOCATIONS OF BURIED ELECTRIC, TELEPHONE AND GAS FACILITIES. (48 HOURS NOTIFICATION IS REQUIRED).
- 9. THE CONTRACTOR SHALL COORDINATE CONSTRUCTION ACTIVITIES WITH UTILITY COMPANIES.
- THE CONTRACTOR WILL NOT BE ALLOWED TO SET UP A YARD OR FIELD OFFICE ON VILLAGE PROPERTY WITHOUT WRITTEN PERMISSION FROM THE VILLAGE.
- 11. BARRICADES: THE CONTRACTOR SHALL PROVIDE AND INSTALL TWO
 (2) WEIGHTED SAND BAGS ON EACH TYPE I OR TYPE II BARRICADE
 USED. (ONE (1) WEIGHTED SAND BAG ACROSS EACH BOTTOM
 RAIL).
- 12. THE CONTRACTOR SHALL CONTACT THE DISTRICT ONE TRAFFIC CONTROL SUPERVISOR AT (847) 705-4150 A MINIMUM OF 72 HOURS IN ADVANCE OF BEGINNING WORK. THE CONTRACTOR SHALL ALSO CONTACT ROBINSON ENGINEERING (708) 331-6700 AND THE VILLAGE OF RIVERDALE (708) 841-2200, A MINIMUM OF 72 HOURS IN ADVANCE OF BEGINNING WORK.

- 13. ALL HMA PAVING SHALL FOLLOW DESIGNATED DRIVING LANES AS SHOWN IN STRIPING DETAILS. NO LONGITUDINAL PAVING JOINT OR SEAMS ARE ALLOWED WITHIN THE DRIVING LANES. ALL LONGITUDINAL PAVING JOINTS OR SEAMS WILL BE BETWEEN THE DRIVING LANES.
- 14. POROUS GRANULAR EMBANKMENT (PGE) SUBGRADE HAS BEEN PROVIDED FOR LOCATIONS WHERE SOILS TEND TO BE UNSTABLE WHEN WET. THE ACTUAL NEED FOR REMOVAL AND REPLACEMENT WITH PGE WILL BE DETERMINED IN THE FIELD AT THE TIME OF CONSTRUCTION BY THE ENGINEER (BY USE OF A CONE PENETROMETER IN CONJUNCTION WITH THE IDOT SUBGRADE STABILITY MANUAL). IF UNSTABLE AND/OR UNSUITABLE MATERIALS ARE NOT ENCOUNTERED, THEN THE QUANTITY SHALL BE DEDUCTED AND NO ADDITIONAL COMPENSATION WILL BE DUE TO THE CONTRACTOR.
- 15. ALL PAVEMENT, CURB AND SIDEWALK REMOVALS SHALL BE MADE BY MEANS OF STRAIGHT SAW CUT JOINT. THE COST FOR SAW CUTTING SHALL BE INCIDENTAL TO THE CONTRACT.
- 16. CONTRACTOR SHALL BE RESPONSIBLE AT ALL TIMES FOR TRAFFIC CONTROL AND PROTECTION IN ACCORDANCE WITH THE IDOT STANDARD SPECIFICATIONS ADOPTED JANUARY 1, 2007, THE LATEST EDITION OF THE ILLINOIS MANUAL ON UNIFORM TRAFFIC AND CONTROL DEVICES FOR STREETS AND HIGHWAYS.
- 17. THE CONTRACTOR SHALL MAKE EVERY ATTEMPT NOT TO DAMAGE EXISTING TREES.
- 18. 10' TRANSITIONS SHALL BE USED TO MATCH PROPOSED CURB AND GUTTER TO EXISTING CURB AND GUTTER OR TO TAPER FROM 6" TO 0", UNLESS OTHERWISE SHOWN. THE TRANSITIONS SHALL BE PAID FOR AT THE CONTRACT UNIT PRICE FOR THE PROPOSED ITEM OF WORK SPECIFIED.
- 19. TEMPORARY FENCE SHOULD BE ERECTED ALONG THE DRIPLINE OF EXISTING TREES TO REMAIN WITHIN THE LIMITS OF CONSTRUCTION. AFTER TREES ARE SAFELY FENCED NOTHING IS TO BE STORED, DRIVEN, OR DISTURBED INSIDE THE FENCE. REMOVE PROTECTIVE TEMPORARY FENCE ONLY AFTER ALL CONSTRUCTION WORK HAS BEEN COMPLETED.
- 20. THE CONTRACTOR SHALL TAKE ALL NECESSARY PRECAUTIONS FOR THE PROTECTION OF EXISTING PLANT MATERIAL FOR WHICH THE CONTRACT DOES NOT PROVIDE REMOVAL. THE PROTECTION OF EXISTING PLANT MATERIAL AND THE REPAIR OR REPLACEMENT OF EXISTING PLANT MATERIAL DAMAGED BY THE CONTRACTOR SHALL BE DONE IN ACCORDANCE WITH THE REQUIREMENTS OF SECTION 201 OF THE STANDARD SPECIFICATIONS.
- 21. TREE ROOT PRUNING IS TO BE USED ON EXISTING TREES TO PREVENT THE RIPPING UP OF ROOTS WHEN TRENCHING OR EXCAVATION IS WITHIN THE ROOT ZONE OF ADJACENT TREES TO REMAIN. SUPPLEMENTAL WATERING OF TREES SHOULD BEGIN IMMEDIATELY AFTER ROOT PRUNING OF THE TREES HAS OCCURRED.
- 22. EROSION CONTROL WORK ITEMS ARE CONSIDERED TO BE HIGH PRIORITY ITEMS ON THIS CONTRACT. THE ENGINEER WILL IMPLEMENT ALL PROVISIONS OF THE SPECIFICATION NECESSARY TO ASSURE THAT EROSION CONTROL ITEMS ARE CONSTRUCTED AND MAINTAINED IN A TIMELY WAY. ALL EROSION CONTROL MEASURES SHALL BE INSTALLED PRIOR TO BEGINNING ANY CONSTRUCTION ACTIVITIES WHICH WILL POTENTIALLY CREATE ERODABLE CONDITIONS.
- 23. PAYMENT FOR CONNECTION TO EXISTING STREET LIGHT SYSTEM SHALL BE CONSIDERED INCIDENTAL TO THE UNIT PRICE FOR UNIT DUCT.
- 24. PAY LIMIT FOR AGGREGATE BASE COURSE, TYPE B, 4" SHALL BE 1 FT OFFSET FROM BACK OF CURB.

ILLINOIS DEPARTMENT OF TRANSPORTATION

IVANHOE METRA COMMUTER KISS 'N RIDE SUMMARY OF QUANTITIES & GENERAL NOTES

SCALE: VERT. HORIZ. NONE

DATE

REVISIONS


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DATE 11-1-07 CHECKED BY PKB


**ROBINSON ENGINEERING. LTD.
1700 S0UTH PARK AVENUE. SOUTH HOLLAND LLLANDS 804700 S13-0200
1LLANDS DESIGN FRAM PERISTRATION NO. 184001182.

| F. A. U. RTE. | SECTION | | SECTION COUNTY | | SHEET NO | | | |
|------------------|----------------|--------|----------------|------------------|-------------|--|--|--|
| | 05-00113-00-PK | | соок | 012 | 003 | | | |
| STA. TO STA. | | | | | | | | |
| FED. R | KOAD DIST. NO. | ILLINO | S FED. AL | FED. AID PROJECT | | | | |

CONTRACT NO. 63006

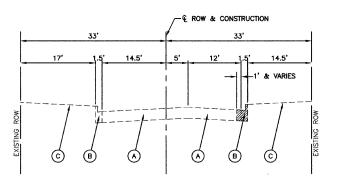

EXISTING TYPICAL CROSS SECTION TRACY AVENUE FROM STA. 3+54 TO STA. 7+89

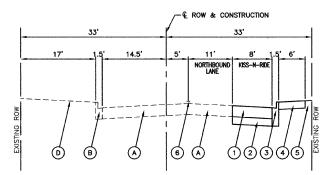

PROPOSED TYPICAL CROSS SECTION TRACY AVENUE FROM STA. 3+54 TO STA. 7+89

HOT-MIX ASPHALT MIXTURE REQUIREMENTS

| MIXTURE TYPE | AC TYPE | AIR VOIDS | |
|---|------------------|---------------------|--|
| FULL DEPTH PAVEMENT | | | |
| HOT-MIX ASPHALT SURFACE COURSE, MIX "C", N50 (IL 9.5mm); 2" | PG 64-22 | 4% © 50 Gyr. | |
| HOT-MIX ASPHALT BINDER COURSE, IL-19.0, N50; 4" | PG 64-22/58-22 * | 4% 🛭 50 Gyr. | |

THE UNIT WEIGHT USED TO CALCULATE ALL HOT-MIX ASPHALT SURFACE MIXTURE QUANTITIES IS 112 lbs/sq yd/in. \pm when RAP exceeds 20%, the New Asphalt binder in the MIX shall be PG 58-22

PROPOSED LEGEND

EXISTING LEGEND

- 1 HOT-MIX ASPHALT PAVEMENT (FULL DEPTH) 6"
- 2 AGGREGATE BASE COURSE, TYPE B, 4"
- 3 COMBINATION CONCRETE CURB & GUTTER TYPE B-6.12

REVISIONS

- 4 P.C.C. SIDEWALK, 5"
- 5 SODDING
- 6 PAVEMENT MARKING

ILLINOIS DEPARTMENT OF TRANSPORTATION

IVANHOE METRA COMMUTER KISS 'N RIDE TYPICAL CROSS SECTIONS

SCALE: VERT.
HORIZ. NONE
DATE 11-1-07

DRAWN BY AG/EDG

DBINSON ENGINEERING, LTD.

10 SOLITH PARK AVENUE SOUTH HOLLAND, ILLINOIS 60473

10 SOLITH PARK AVENUE SOLITH HOLLAND, ILLINOIS 60473

10 SOL

A U. SECTION COUNTY TOTAL SHEETS NO 05-00113-00-PK COOK 012 004 SECTION 4, TOWNSHIP 36, RANGE 14 STA. 3+54 TO STA. 7+89 FED. ROAD DIST. NO. ILLINOIS FED. AID PROJECT CONTRACT NO. 63006 AVE STEWART EX CB RIM EL=599.77 12" INV=597.11 MONITORING WELL HH STEEL LP EX MH RIM EL=599.48 SW 10" INV=595,18 E 10" INV=594.53 W 12" INV=591.04 SW 12" INV=591.04 143AD E 12 "NV=595.16"

RIM EL=600.83

W 6" INV=595.76

NW 6 INV=595.74

NW 6 INV=595.74


NW 6 INV=595.76


E 12" INV=594.63

E 12" INV=597.95

NE 21" INV=587.95 CL FENCE-3 EX CB RIM EL=599.54-N 10" INV=596.03 END PAVEMENT AND C&G REMOVAL STA 7+89 € TRACY AVENUE SCHOOL ST AVE EX ROW 8+00 7+00 SA SHOWER OF EX ROW BEGIN PAVEMENT AND C&G REMOVAL STA 3+54 (O) 2 t NOTE: SEE SHEET 7 FOR LIGHT POLE RELOCATION **LEGEND** BENCH MARK: RR SPIKE SET IN WEST FACE OF WOOD LIGHT POLE AT NORTH WEST CORNER OF 143RD STREET AND TRACY AVENUE. ELEVATION=600.984 X TREE REMOVAL CURB & GUTTER REMOVAL ILLINOIS DEPARTMENT OF TRANSPORTATION IVANHOE METRA COMMUTER KISS 'N RIDE REMOVAL PLAN PAVEMENT REMOVAL SCALE: VERT.
HORIZ. 1"=50'
DATE 11-1-07

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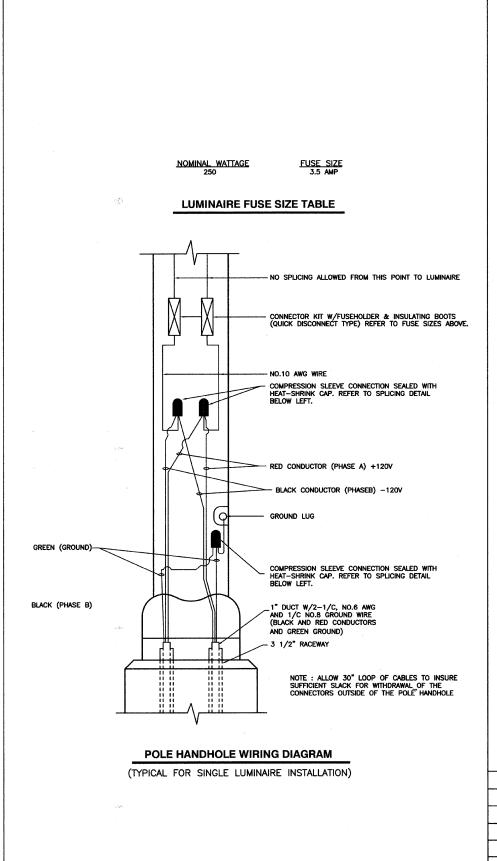


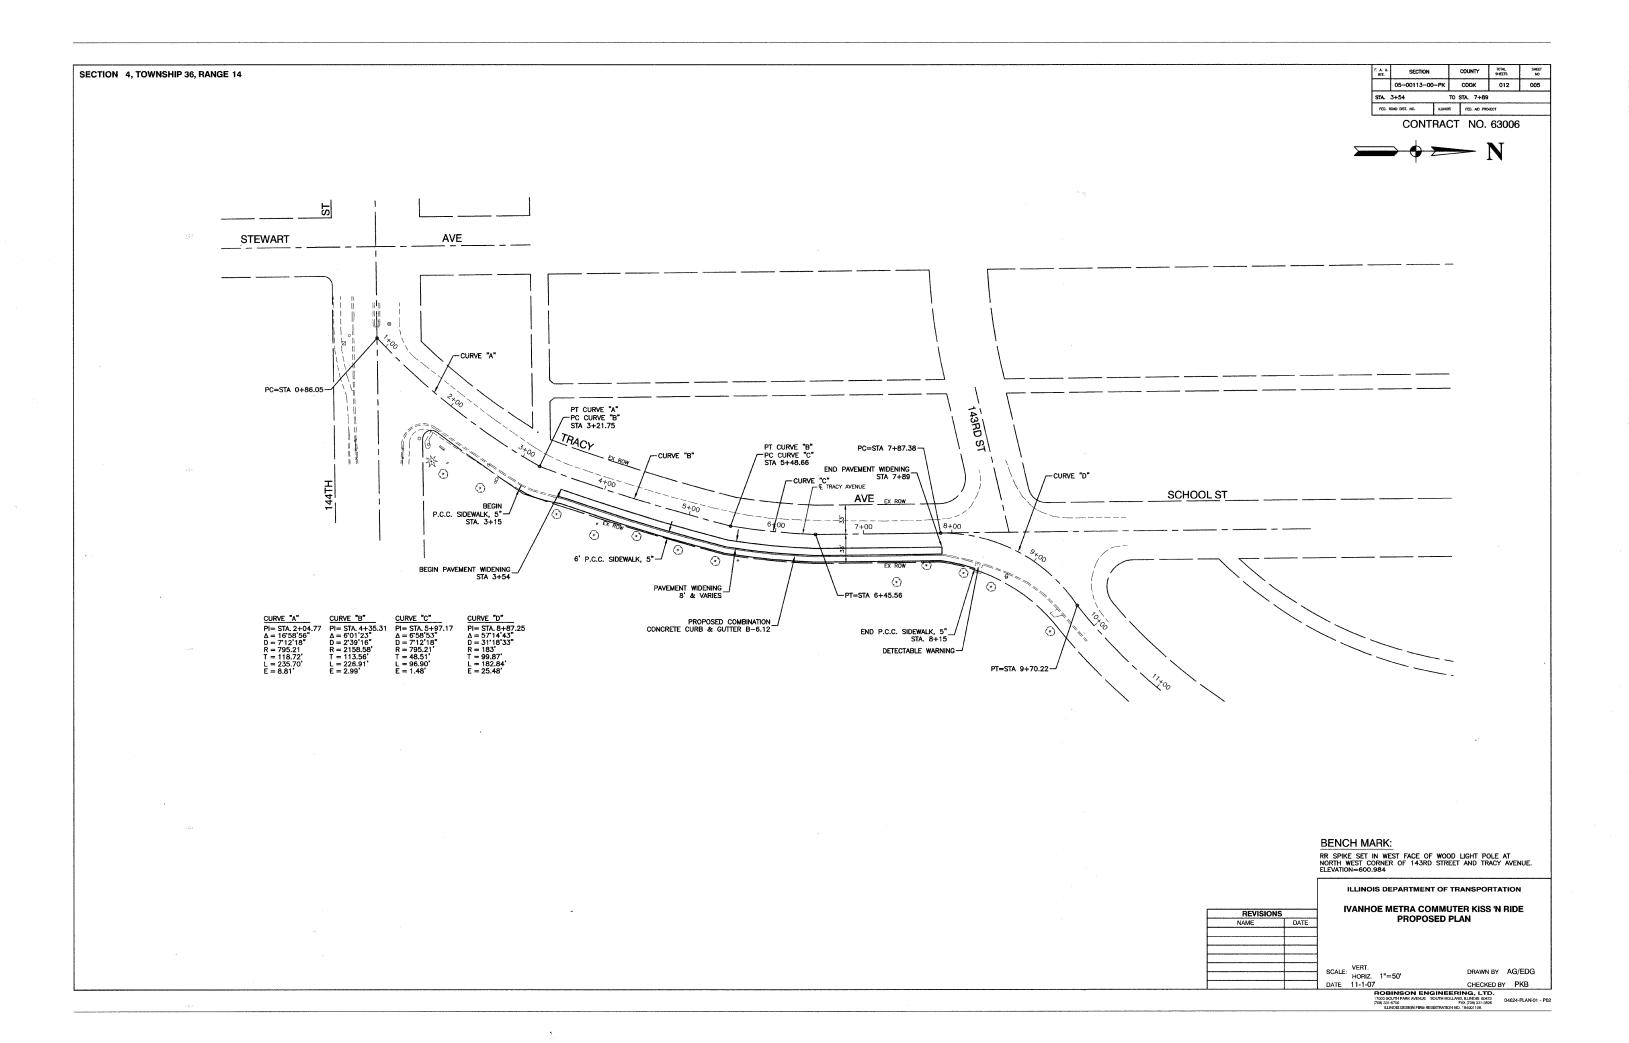


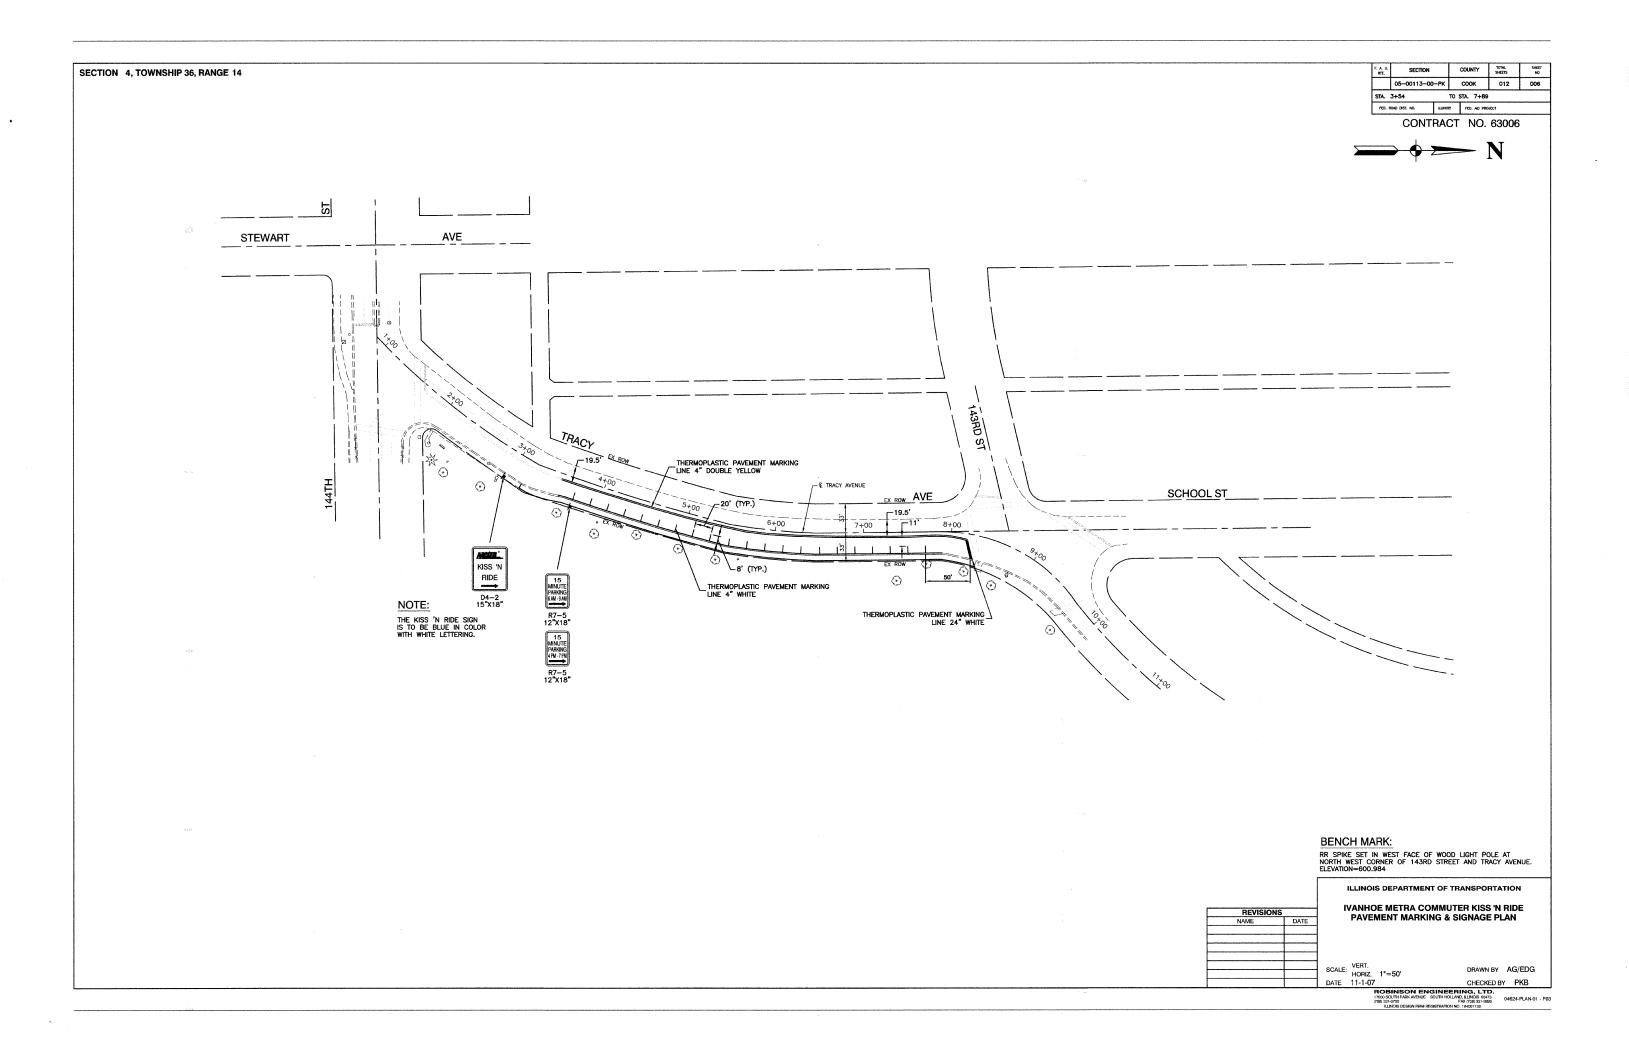COUNTY TOTAL SHEET NO SECTION SECTION 4, TOWNSHIP 36, RANGE 14 05-00113-00-PK COOK 012 007 TO STA. 7+89 FED. ROAD DIST. NO. ILLINOIS FED. AND PROJECT CONTRACT NO. 63006 -STEWART --AVE-STEEL LP CL FENCE SCHOOL ST 7+00 LEGEND: • EXISTING STREET LIGHT • RELOCATED STREET LIGHT ■ EXISTING CONTROLLER <u>ق</u> P CONDUIT, PUSHED, GALVANIZED STEEL T CONDUIT, TRENCHED, GALVANIZED STEEL UNIT DUCT, 2-1/C, NO.6 AWG AND NO.8 GROUND, 600V IN 1" DUCT SERVICE WIRE, 3-1/C, NO. 1/O AWG. (SEE LIGHTING CONTROLLER PLAN) RELOCATED LIGHT S 6+16.0, 32.0' LT., (K GR GROUND ROD, 5/8" DIA. x 10' RELOCATE EXISTING STREET LIGHT (R&R) LT LEFT MOUNTING HEIGHT **GENERAL NOTES:** MAST ARM 1. ALL WORK TO CONFORM TO THE NATIONAL ELECTRICAL CODE AND ANY APPLICABLE LOCAL CODES. B/C BACK OF CURB 2. CONTRACTOR TO VERIFY LOCATION OF ALL UNDERGROUND UTILITIES BEFORE TRENCHING OR AUGERING. BDTB BREAKAWAY DEVICE, TRANSFORMER BASE, 15" BOLT CIRCLE 3. BEFORE INSTALLING STANDARDS NEAR OVERHEAD FACILITIES CALL CE Co. FOR APPROVAL OF LOCATION. R&R REMOVE AND REPLACE EXISTING STREET LIGHT 4. FOR LOCATION OF EXISTING UNDERGROUND ELECTRICAL CABLE CALL CE Co. 5. ALL PUSHED CONDUIT TO BE 2" DIAMETER UNLESS OTHERWISE SPECIFIED. 6. ANY TREE TRIMMING REQUIRED AS DIRECTED BY THE ENGINEER SHALL BE PERFORMED BY THE CONTRACTOR, AND THE COST OF THIS WORK SHALL BE CONSIDERED INCIDENTAL TO THE CONTRACT. CONTRACTOR SHALL TAKE ALL NECESSARY MEASURES TO RESTORE ANY SPECIALIZED LANDSCAPING, (i.e.
DECORATIVE ROCKS, SHRUBS, PLANTS, ECT.) OR SHALL REPLACE IT, THE COST OF WHICH SHALL BE
CONSIDERED INCIDENTAL TO THE CONTRACT. ILLINOIS DEPARTMENT OF TRANSPORTATION IVANHOE METRA COMMUTER KISS 'N RIDE STREET LIGHTING 8. CONNECTION TO EXISTING STREET LIGHT SYSTEM SHALL BE CONSIDERED INCIDENTAL TO THE UNIT PRICE FOR UNIT DUCT. 9. STATION AND OFFSET CALLOUTS FOR PROPOSED FOUNDATIONS ARE TO THE CENTER OF FOUNDATION. SCALE: VERT. HORIZ. 1"=50' DATE 11-1-07 DRAWN BY PS/EDG

ROBINSON ENGINEERING, LTD.
17003 SOUTH PARK AVENUE SOUTH HOLLAND, ILLINOIS 60473
(708) 331-6700 FAX (708) 331-9828


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SECTION COUNTY TOTAL SHEETS 05-00113-00-PK COOK 012 008 TO STA. ILLINOIS FED. AID PROJECT CONTRACT NO. 63006

SPLICING ELECTRIC CABLES BASIC MATERIALS AND METHODS

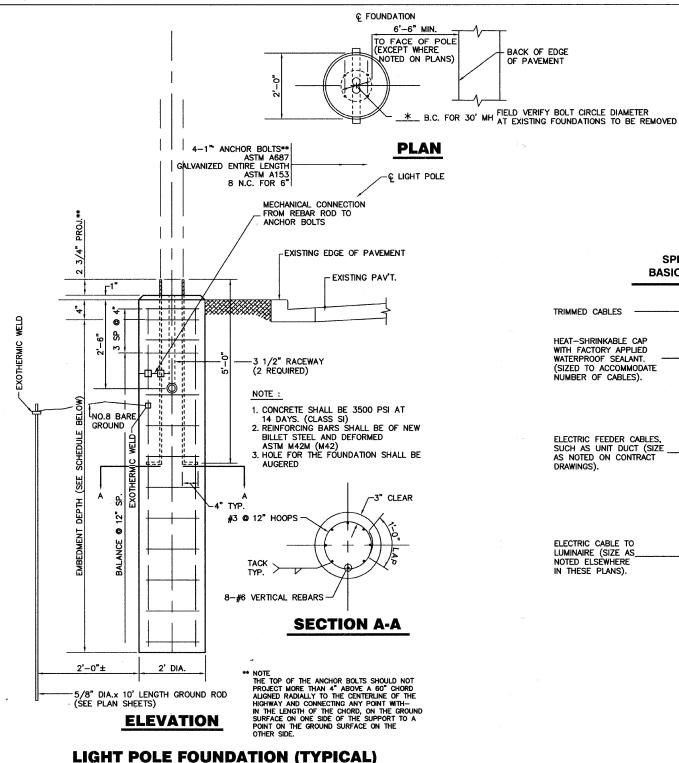

| FOUNDATION SCHEDULE* | | | | | | | |
|----------------------|--------------------------------|-----------|---------|----------|--------|--|--|
| TYP | E OF SOILS | EMBEDMENT | | | | | |
| | 1 | 1 | MOUNTIN | g height | | | |
| DESCRIPTION | STANDARDS | 30 FT. | 35 FT. | 40 FT. | 50 FT. | | |
| SOFT CLAY | Qu= .2550 T/FT.2 | 9'-0" | 9'-8" | 10'-6" | 14'-0" | | |
| MEDIUM CLAY | Qu= .50-1.0 T/FT. ² | 6'-6" | 7'0" | 7'-6" * | 10'-0" | | |
| DENSE CLAY | Qu= 1.0-2.0 T/FT. ² | 5'-6" | 6'-0" | 6'-6" | 8'-6" | | |
| LOOSE SAND | N= 4-10 | 7'-0" | 7'-8" | 8'-4" | 11'-0" | | |
| MEDIUM SAND | N= 10-30 | 6'-0" | 6'-6" | 7'-3" | 9'-6" | | |
| DENSE SAND | N= 30-50 | 5'-6" | 6'-0" | 6'-6" | 8'-6" | | |

* NOTE: ACTUAL FOUNDATION DEPTH IS 6'-6" EMBEDMENT DEPTH (FROM SCHEDULE) PLUS 6" EQUALS TOTAL DEPTH OF 7'-0" FOR 35' MOUNTING HEIGHT POLES

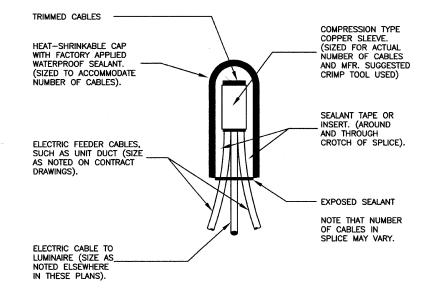
BACK OF EDGE

OF PAVEMENT

| | | ILLINOIS DEPARTMENT OF TRANSPORTATION IVANHOE METRA COMMUTER KISS 'N RIDE | | | | |
|---------|------|--|----------------|--|--|--|
| REVISIO | vs | | | | | |
| NAME | DATE | LIGHTIF | NG DETAILS | | | |
| | | | | | | |
| | | | | | | |
| | | | | | | |
| | | | | | | |
| | | SCALE: VERT. | DRAWN BY PS | | | |
| | | HORIZ. NONE | | | | |
| | | DATE 11-1-07 | CHECKED BY PAP | | | |

SECTION COUNTY TOTAL SHEET NO 05-00113-00-PK COOK 012 009 STA. 3+53.3 TO STA. 5+50 FED. ROAD DIST. NO. ILLINOIS FED. AID PROJECT CONTRACT NO. 63006 595 | ELEV.=600.57 ELEV.=600.31 C ELEY =600.00 OZ-2669=791 우 유 0 5+50 20.108 69.009 14.008 90.009 90.009 27.993 **o** C=11 SF C=9 SF C=0 SF C=17 ILLINOIS DEPARTMENT OF TRANSPORTATION IVANHOE METRA COMMUTER KISS 'N RIDE CROSS SECTIONS STA. 3+53.3 TO STA. 5+50 REVISIONS SCALE: VERT. 1"=5" HORIZ. 1"=10" DATE 11-1-07 DRAWN BY PS/EDG

F. A. U. SECTION COUNTY TOTAL SHEETS 05-00113-00-PK COOK 012 010 STA. 6+00 TO STA. 8+00 FED. ROAD DIST. NO. | ELLINOIS | FED. AID PROJECT CONTRACT NO. 63006 90 605 EFEX =288.88 ELEV.=600.19 ELEV.=600.44 F=0 SF =0 SF 2 8+00 7+00 6+50 00+9 82.003 82.003 24,000 c 19.009 €6.009 51,108 C=18 SF C=16 SF C=16 SF C=0 SF 2 ILLINOIS DEPARTMENT OF TRANSPORTATION IVANHOE METRA COMMUTER KISS 'N RIDE CROSS SECTIONS STA. 6+00 TO STA. 8+00 SCALE: VERT. 1"=5' HORIZ. 1"=10' DATE 11-1-07 DRAWN BY PS/EDG

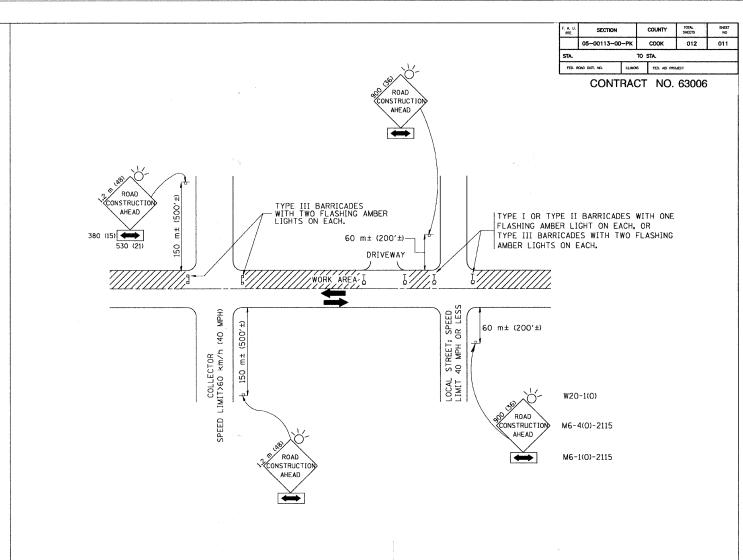

TRAFFIC CONTROL AND PROTECTION FOR SIDE ROADS, INTERSECTIONS, AND DRIVEWAYS

NOTES:

- A. FOR NO LANE RESTRICTION ON THE SIDE ROAD OR DRIVEWAYS
- 1. SIDE ROAD WITH A SPEED LIMIT OF 60 km/h (40 MPH) OR LESS AS SHOWN ON THE DRAWING AND AS DIRECTED BY THE ENGINEER:
- O) ONE **ROAD CONSTRUCTION AHEAD** SIGN 900x900 (36x36) WITH A FLASHER AND FLAG MOUNTED ON IT APPROXIMATELY 60 m (200') IN ADVANCE OF THE MAIN ROUTE.
- b) THE CLOSED PORTION OF THE MAIN ROUTE SHALL BE PROTECTED BY BLOCKING WITH TYPE I, TYPE II OR TYPE III BARRICADES, 1/3 OF THE CROSS SECTION OF THE CLOSED PORTION.
- 2. SIDE ROAD WITH A SPEED LIMIT GREATER THAN 60 km/h (40 MPH) AS SHOWN ON THE DRAWING AND AS DIRECTED BY THE ENGINEER:
- g) ONE ROAD CONSTRUCTION AHEAD SIGN 1.2 m \times 1.2 m (48 \times 48) WITH A FLASHER MOUNTED ON IT APPROXIMATELY 150 m (500°) IN ADVANCE OF THE MAIN ROUTE.
- b) THE CLOSED PORTION OF THE MAIN ROUTE SHALL BE PROTECTED BY BLOCKING WITH TYPE III BARRICADES, 1/2 OF THE CROSS SECTION OF THE CLOSED PORTION.
- 3. WHEN THE SIDE ROAD LIES BETWEEN THE BEGINNING OF THE MAINLINE SIGNING AND THE WORK ZONE, A SINGLE HEADED ARROW (MG-1) SHALL BE USED IN LIEU OF THE DOUBLE HEADED ARROW (MG-4).

- B. FOR A LANE CLOSURE ON A SIDE ROAD OR DRIVEWAY:
- USE APPLICABLE PORTIONS OF THE TYPICAL APPLICATION OF TRAFFIC CONTROL DEVICES (STD. 701501, STD. 701606 OR THE APPROPRIATE STANDARD). THE SPACING OF SIGNS AND BARRICADES SHALL BE ADJUSTED FOR FIELD CONDITIONS AS DIRECTED BY THE ENGINEER. THE DIRECTIONAL ARROW SHALL BE COVERED OR REMOVED WHEN NO LONGER CONSISTENT WITH THE SIDE ROAD LANE CLOSURE.
- C. ADVANCE WARNING SIGNS ARE TO BE OMITTED ON DRIVEWAY UNLESS OTHERWISE NOTED.
- D. THE TRAFFIC CONTROL AND PROTECTION FOR SIDE ROADS, INTERSECTIONS, AND DRIVEWAYS SHALL BE INCIDENTAL TO THE COST OF SPECIFIED TRAFFIC CONTROL STANDARDS OR ITEMS.

| REVISIO | ILLINOIS DE | |
|--------------|-------------|-----------------|
| NAME | DATE | ILLINOIS DE |
| LHA | 6/89 | TRAFFIC C |
| T. RAMMACHER | 09/08/94 | INALLIC C |
| J. OBERLE | 10/18/95 | |
| A. HOUSEH | 03/06/96 | CIDE DO |
| A. HOUSEH | 10/15/96 | SIDE ROA |
| T. RAMMACHER | 01/06/00 | |
| | | |
| | | SCALE: VERT. |
| | | HORIZ. |
| | | DATE 10/18/2002 |

ILLINOIS DEPARTMENT OF TRANSPORTATION
TRAFFIC CONTROL AND PROTECTION


FOR SIDE ROADS, INTERSECTIONS, AND


DRIVEWAYS
SCALE: VERT. DI

DRAWN BY CHECKED BY


REVISION DATE: 01/06/00
04624-DTLS-02 (P01)

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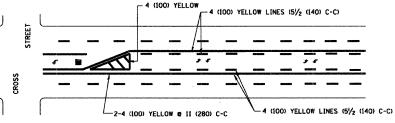


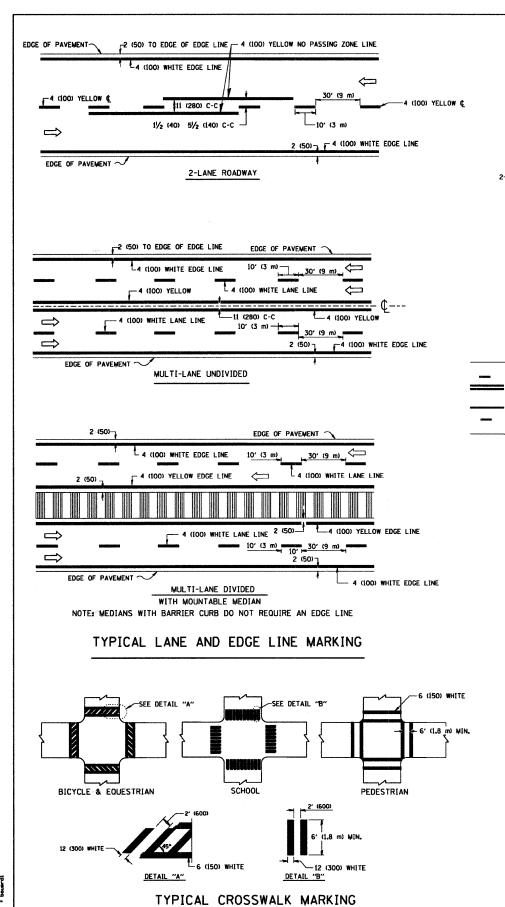4' (1.2 m) WIDE MEDIANS ONLY

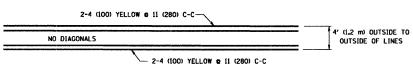


DIAGONAL LINE SPACING: 50' (15 m) C-C (LESS THAN 30MPH (50 km/h))
75' (25 m) C-C 30MPH (50 km/h) TO 45MPH (70 km/h))
150' (45 m) C-C (MORE THAN 45MPH (70 km/h))

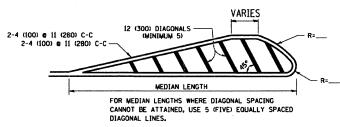MEDIANS OVER 4' (1.2 m) WIDE




A MINIMUM OF TWO PAIRS OF TURN ARROWS SHALL BE USED, WHITE IN COLOR. ADDITIONAL PAIRS SHALL BE PLACED AT 200' (60 m) TO 300' (90 m) INTERVALS.

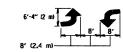

MEDIAN WITH TWO-WAY LEFT TURN LANE

TYPICAL PAINTED MEDIAN MARKING

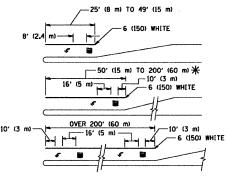


FULL SIZE LETTERS 8' (2.4 m) AND ARROWS SHALL BE USED.

AREA = 15.6 SO. FT. (1.5 m²)

* TURN LANES IN EXCESS OF 400' (120 m) IN LENGTH MAY HAVE AN ADDITIONAL SET OF ARROW - "ONLY" INSTALLED MIDWAY BETWEEN THE OTHER TWO SETS OF ARROW - "ONLY".


TYPICAL LEFT (OR RIGHT) TURN LANE

TYPICAL TURN LANE MARKING

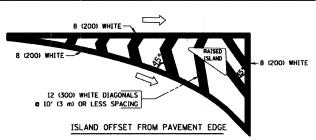

| F. A. U. SECTION | | | COUNTY | TOTAL SHEETS | SHEET NO | | | |
|------------------|----------------|----------|-------------|------------------|-------------|--|--|--|
| | 05-00113-00- | | COOK | 012 | 012 | | | |
| STA. | | T | TO STA. | | | | | |
| FED. F | KOAD DIST. NO. | ILLINOIS | PED. AID PR | FED. AID PROJECT | | | | |

CONTRACT NO. 63006

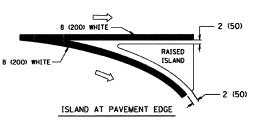

TYPICAL ISLAND MARKING

| TYPE OF MARKING | WIDTH OF LINE | PATTERN | COLOR | SPACING / REMARKS |
|---|---|-------------------------|--------------------------------------|--|
| CENTERLINE ON 2 LANE PAVEMENT | 4 (100) | SKIP-DASH | YELLOW | 10' (3 m) LINE WITH 30' (9 m) SPACE |
| CENTERLINE ON MULTI-LANE UNDIVEDED PAVEMENT | 2 6 4 (100) | SOLID | YELLOW | 11 (280) C-C |
| NO PASSING ZONE LINES: FOR ONE DIRECTION FOR BOTH DIRECTIONS | 4 (100) 2 6 4 (100) | SOLID SOLID | YELLOW YELLOW | 5½ (140) C-C FROM SKIP-DASH CENTERLINE 11 (280) C-C OMIT SKIP-DASH CENTERLINE BETWEEN |
| LANE LINES | 4 (100) 5 (125) ON FREEWAYS | SKIP-DASH SKIP-DASH | WHITE WHITE | 10' (3 m) LINE WITH 30' (9 m) SPACE |
| DOTTED LINES (EXTENSIONS OF CENTER, LANE OR TURN LANE MARKINGS) | SAME AS LINE BEING EXTENDED | SKIP-DASH | SAME AS LINE BEING EXTENDED | 2' (600) LINE WITH 6' (1.8 m) SPACE |
| EDGE LINES | 4 (100) | SOLID | YELLOW-LEFT WHITE-RIGHT | OUTLINE MOUNTABLE MEDIANS IN YELLOW; EDGE LINES ARE NOT USED NEXT TO BARRIER CURB |
| TURN LANE MARKINGS | 6 (150) LINE; FULL SIZE LETTERS & SYMBOLS (8' (2.4m)) | SOLID | WHITE | SEE TYPICAL TURN LANE MARKING DETAIL |
| TWO WAY LEFT TURN MARKING | 2 c 4 (100) EACH DIRECTION | SKIP-DASH AND SOLID | YELLOW | 10' (3 m) LINE WITH 30' (9 m) SPACE FOR SKIP-DASH; 5½ (140) C-C BETWEEN SOLID LINE AND SKIP-DASH LINE |
| | 8' (2.4m) LEFT ARROW | IN PAIRS | WHITE | SEE TYPICAL TWO-WAY LEFT TURN MARKING DETAIL |
| CROSSWALK LINES (PEDESTRIAN) A. DIAGONALS (BIKE & EQUESTRIAN) B. LONGITUDINAL BARS (SCHOOL) | 2 @ 6 (150) 12 (300) @ 45° 12 (300) @ 90° | SOLID SOLID SOLID | WHITE WHITE WHITE | NOT LESS THAN 6' (I.8 m) APART 2' (GOD) APART 2' (GOD) APART SEE TYPICAL CROSSWALK MARKING DETAILS. |
| STOP LINES | 24 (600) | SOLID | WHITE | PLACE 4" (1.2 m) IN ADVANCE OF AND PARALLEL TO CROSSWALX, IF PRESENT. OTHERWISE, PLACE AT DESIRED STOPPING POINT. PARALLEL TO CROSSROAD CENTERLINE, WHERE POSSIBLE |
| PAINTED MEDIANS | 2 e 4 (100) WITH 12 (300) DIAGONALS e 45° | SOLID | YELLOW: TWO WAY TRAFFIC WHITE: | 11 (280) C-C FOR THE DOUBLE LINE SEE TYPICAL PAINTED MEDIAN MARKING. |
| | NO DIAGONALS USED FOR 4' (1.2 m) WIDE MEDIANS | | ONE WAY TRAFFIC | |
| GORE MARKING AND CHANNELIZING LINES | 8 (200) WITH 12 (300) DIAGONALS & 45° | SOLID | WHITE | DIACONALS: 15' (4.5 m) C-C (LESS THAN 30MPH (50 km/h)) 20' (6 m) C-C 30MPH (50 km/h) TO 45MPH (70 km/h)) 30' (9 m) C-C (OVER 45MPH (70 km/h)) |
| RAILROAD CROSSING | 24 (600) TRANSVERSE LINES: "RR" IS 6' (1.8 m) LETTERS: 16 (400) LINE FOR "X" | SOLID | WHITE | SEE STATE STANDARD 780001 AREA OF: "R"-3.6 SO. FT. (0.33 m²) EACH "X"-54.0 SO. FT. (5.0 m²) |
| SHOULDER DIAGONALS | 12 (300) @ 45° | SOLID | WHITE - RIGHT YELLOW - LEFT | 50' (15 m) C-C (LESS THAN 30MPH (50 km/h)) 75' (25 m) C-C (30 MPH (50 km/h) TO 45MPH (70 km/h) 150' (45 m) C-C (0VER 45MPH (70 km/h)) |

FOR FURTHER DETAILS ON PAVEMENT MARKING REFER TO STANDARD SPECIFICATIONS FOR ROAD AND BRIDGE CONSTRUCTION AND STATE STANDARD 780001.

All dimensions are in inches (millimeters) unless otherwise shown.

| REVISIONS | | ILLINOIS DEPARTMENT OF TRANSPORTAT | | | |
|--------------|----------|------------------------------------|------------------------|--|--|
| NAME | DATE | ILLINOIS DEFARTI | WENT OF TRANSFORTATION | | |
| EVERS | 03-19-90 | | | | |
| T. RAMMACHER | 10-27-94 | DIST | RICT ONE | | |
| ALEX HOUSEH | 10-09-96 | | | | |
| ALEX HOUSEH | 10-17-96 | TYPICA | L PAVEMENT | | |
| T. RAMMACHER | 01-06-00 | | RKINGS | | |
| | | | | | |
| | | SCALE: NONE | DRAWN BY CADD | | |
| | | | CHECKED BY | | |

TC-13