STATE OF ILLINOIS

DEPARTMENT OF TRANSPORTATION

DIVISION OF HIGHWAYS

FOR INDEX OF SHEETS, SEE SHEET NO. 2

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PROPOSED HIGHWAY PLANS

F.A.U. 1472: FOREST AVENUE
OVER THE DES PLAINES RIVER
SECTION: 2007–045 I
SCOUR COUNTERMEASURES
COOK COUNTY
C-91-007-08

R 12 E

IMPROVEMENT LOCATED IN THE VILLAGE OF RIVERSIDE.

LOCATION OF PROJECT
FOREST AVENUE OVER
THE DES PLAINES RIVER
SN 016-0874

SPEED LIMIT = 25 MPH
2006 ADT = 3,200

RIVERSIDE TOWNSHIP

FOR EST PARK

PAR

100' 200' 300'—1"= 100'
0 10' 20' 30'—1"= 10'
0 50' 100' 1"= 50'
0 50' 100' 1"= 40'
0 50' 100' 1"= 30'
0 100' 1"= 20'

FULL SIZE PLANS HAVE BEEN PREPARED USING STANDARD ENGINEERING SCALES. REDUCED SIZED PLANS WILL NOT CONFORM TO STANDARD SCALES. IN MAKING MEASUREMENTS ON REDUCED PLANS, THE ABOVE SCALES MAY BE USED.

J.U.L.I.E.
JOINT UTILITY LOCATION INFORMATION FOR EXCAVATION
1–800–892–0123
OR 811

PROJECT ENGINEER: J.P. CHANG (847) 705 4432
PLAN PREPARATION ENGINEER: KEN ENG (847) 705 4247

CONTRACT NO. 60D35



STATE OF ILLINOIS
DEPARTMENT OF TRANSPORTATION
DIVISION OF HIGHWAYS

SUBMITTED FEBRUARY 7, 20 08

Diene M. O'Kashe JE DEPUTY DIRECTOR OF HIGHWAYS, REGION ENGINEER

March 21, 20 08

TIME ENGINEER OF DESIGN AND ENVIRONMENT

March 21, 20 08 Christine M. Reed

PRINTED BY THE AUTHORITY OF THE STATE OF ILLINOIS

INDEX OF SHEETS

- 1 TITLE SHEET
- 2 INDEX OF SHEETS STATE STANDARDS GENERAL NOTES
- 3 SUMMARY OF QUANTITIES
- ROADWAY PLAN
- 5 COUNTERMEASURE DETAILS
- 6 PLAT OF HIGHWAYS
- 7 CROSS SECTIONS
- 8 TEMPORARY INFORMATION SIGNING
- 9 TRAFFIC CONTROL AND PROTECTION FOR SIDE ROADS, INTERSECTIONS AND DRIVEWAYS

10-12 DEWATERING

STATE STANDARDS

STANDARD DESCRIPTION

701201-02 LANE CLOSURE, 2L, 2W, DAY ONLY ON-ROAD TO 24" OFF-ROAD FOR SPEEDS > 45 MPH

701501-04 URBAN LANE CLOSURE 2L, 2W UNDIVIDED

701901 TRAFFIC CONTROL DEVICES

GENERAL NOTES

BEFORE STARTING ANY EXCAVATION, THE CONTRACTOR SHALL CALL "J.U.L.I.E."
(JOINT UTILITY LOCATION INFORMATION FOR EXCAVATION) AT 800-892-0123 FOR FIELD LOCATIONS OF BURIED ELECTRIC, TELEPHONE & GAS FACILITIES. (48 HOURS NOTIFICATION IS REQUIRED.)

THE CONTRACTOR WILL NOT BE ALLOWED TO SET UP A YARD OR FIELD OFFICE ON STATE PROPERTY WITHOUT WRITTEN PERMISSION FROM THE DEPARTMENT.

EXCAVATION INTO THE STREAM BED FOR SLOPE MATTRESS INSTALLATION SHALL NOT BE DEEPER THAN THE BOTTOM OF THE FOOTING OF THE PIER OR ABUTMENT TO BE PROTECTED.

TO AVOID EXCAVATING BELOW THE TOP OF THE PIER OR ABUTMENT FOOTING, SLOPE MATTRESSES CAN BE PLACED AT AN HIGHER ELEVATION AS DIRECTED BY THE ENGINEER, AND AS LONG AS THE TOP OF THE MATTRESSES ARE BELOW THE ORIGINAL STREAMBED LINE AS SHOWN IN THE PLANS.

DEBRIS REMOVAL, IF ENCOUNTERED, SHALL BE DONE IN ACCORDANCE WITH ARTICLE 109.04 OF THE STANDARD SPECIFICATIONS FOR ROAD AND BRIDGE CONSTRUCTION.

IT SHALL BE THE CONTRACTOR'S RESPONSIBILITY TO VERIFY ALL DIMENSIONS & CONDITIONS EXISTING IN THE FIELD PRIOR TO CONSTRUCTION & ORDERING OF MATERIALS.

THE CONTRACTOR SHALL CONTACT THE DISTRICT ONE TRAFFIC CONTROL SUPERVISOR AT (847) 705-4470 A MINIMUM OF 72 HOURS IN ADVANCE OF BEGINNING WORK.

ALL AREAS (INCLUDING WETLAND AREAS) OUTSIDE THE LIMITS OF SCOUR COUNTERMEASURE PLACEMENT AND/OR CHANNEL EXCAVATION WHICH ARE DISTURBED (WHERE EXISTING SOIL CONTOURS HAVE BEEN ALTERED AND/OR EXISTING VEGETATION HAS BEEN DESTROYED BY THE CONTRACTOR'S OPERATIONS) SHALL BE RESTORED BY REGRADING TO THE ORIGINAL CONTOURS AND/OR SEEDING WITH SEEDING, CLASSES 4 AND 5, AND MULCHING WITH EROSION CONTROL BLANKET. PLACE TEMPORARY SEEDING AND TEMPORARY EROSION CONTROL BLANKET AS NEEDED. THIS WORK WILL NOT BE PAID FOR SEPARATELY, BUT THE COSTS SHALL BE CONSIDERED INCLUDED IN THE CONTRACT UNIT PRICES FOR THE CONSTRUCTION ITEMS INVOLVED, AND NO ADDITIONAL COMPENSATION WILL BE ALLOWED.

THE CONTRACTOR IS ADVISED TO AVOID OR MINIMIZE ANY DISTURBANCE TO EXISTING VEGETATION OUTSIDE THE LIMITS OF SCOUR COUNTERMEASURE PLACEMENT AND CHANNEL EXCAVATION WORK DUE TO THE SUBSTANTIAL DIFFICULTY AND COST OF RESTORING THE DISTURBED AREAS.

THE CONTRACTOR IS ADVISED TO AVOID OR MINIMIZE ANY DISTURBANCE TO EXISTING STORM. SEWER DUTLETS, AND UTILITIES WITHIN THE LIMITS OF SCOUR COUNTERMEASURE PLACEMENT AND CHANNEL EXCAVATION.

THE CONTRACTOR MUST PROTECT PAVEMENT WHEN DUMPING STONE AND/OR RIPRAP ONTO PAVEMENT AND WILL BE RESPONSIBLE FOR RESTORING PAVEMENT MARKINGS.

ANY GUARDRAIL OR SIGNS DAMAGED BY THE CONTRACTOR'S OPERATIONS SHALL BE REPLACED IN KIND AT THE CONTRACTOR'S EXPENSE.

THE CONTRACTOR SHALL BE REQUIRED TO PROVIDE ACCESS TO ABUTTING PROPERTY AT ALL TIMES DURING THE CONSTRUCTION OF THIS PROJECT.

DO NOT SCALE PLANS FOR CONSTRUCTION DIMENSIONS.

THE CONTRACTOR SHALL SUBMIT DEWATERING AND SEDIMENT CONTROL PLANS FOR EACH SITE.

PLEASE CONTACT STEVE LIPKIE AT (847) 705-4173 IN THE ROADSIDE DEVELOPMENT UNIT 48 HOURS PRIOR TO PLANTING TREES FOR LAYOUT.

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	PLOT SCALE = 50.0000 '/ IN.	CHECKED -	REVISED -
	PLOT DATE = 2/20/2008	DATE -	REVISED ~

STATE OF ILLINOIS
DEPARTMENT OF TRANSPORTATION

SCALE:

COOK


CONTRACT NO. 60D35

F.A.U. RTE.	SECTION		COUNT	Υ	TOTAL SHEETS	SHEET NO.
1472	2007-045 I		соок		12	3
FED.	ROAD DIST. NO. 1	ILL	INOIS	HIG	HWAY PRO	JECT .
60D	35					


	SUMMARY OF QUANTITIES				CONSTRUC	TION TYPE	CODE			SUMMA	ARY OF QUA	NTITIES					CONSTRUCT	ION TYPE	CODE
CODE NO	ITEM	UNIT	TOTAL QUANTITIES	SFTY-2A				-	CODE NO		ITEM		UNIT	TOTAL QUANTITIES				·	
100110	TREE REMOVAL (6 TO 15 UNITS DIAMETER)	UNIT	85	85						· · · · · · · · · · · · · · · · · · ·									
100210	TREE REMOVAL (OVER 15 UNITS DIAMETER)	UNIT	145	145						•									
201200	REMOVAL AND DISPOSAL OF UNSUITABLE	CU YD	325	325				:											
300100	CHANNEL EXCAVATION	CU YD	325	325															
301084	EXPLORATION TRENCH 84" DEPTH	FOOT	450	450															÷
100105	STONE RIPRAP. CLASS A3	SO YD	700	700															
200200	FILTER FABRIC	SQ YD	1530	1530												-		-	
400100	GABIONS	CU YD	100	100															
401000	SLOPE MATTRESS 12"	SO YD	1520	1520										Military and the second				**	
000400	ENGINEER'S FIELD OFFICE, TYPE A	CAL MO	3	3															
100100	MOBILIZATION	L SUM	1	1															
100450	TRAFFIC CONTROL AND PROTECTION, STANDARD 701201	L SUM	1	. 1															٠.
02620	TRAFFIC CONTROL AND PROTECTION, STANDARD 701501	L SUM	1	1			-	*											
002366	TREE, BETULA NIGRA (RIVER BIRCH), 6' HEIGHT, CLUMP FORM, BALLED AND BURLAPPED	EACH	25	25															
005016	TREE, GYMNOCLADUS DIOICUS (KENTUCKY COFFEETREE), 2" CALIPER, BALLED AND BURLAPPED	EACH	25	25				· ·											
006514	TREE, QUERCUS BICOLOR (SWAMP WHITE OAK), 1-3/4" CALIPER, BALLED AND BURLAPPED	EACH	25	25															
301852	DEWATERING STRUCTURE NO. 1	EACH	1	, 1								•							
322467	TEMPORARY INFORMATION SIGNING FOR LANE CLOSURE	SO FT	51.4	51.4														-	
322859	WEED CONTROL, PRE-EMERGENT GRANULAR HERBICIDE	POUND	7	7										7					
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* SPECIALTY ITEMS


REVISIONS ILLINOIS DEPARTMENT OF TRANSPORTATION SUMMARY OF QUANTITIES

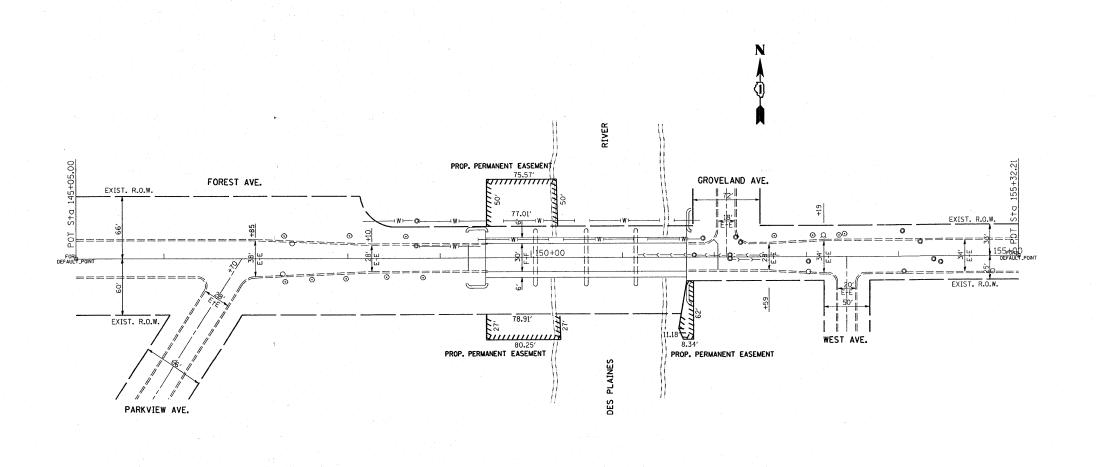

						Ir a col	TOTAL SHEET
FILE NAME =	USER NAME = smithkl	DESIGNED	REVISED -		EXISTING ROADWAY PLAN	RTE. SECTION	COUNTY SHEETS NO.
c:\projects\d117103\design_ea.dgn		DRAWN -	REVISED -	STATE OF ILLINOIS	FOREST AVE. OVER THE DES PLAINES RIVER	1472 2007-045 I	COOK 12 4
	PLOT SCALE = 50.0000 '/ IN.	CHECKED -	REVISED -	DEPARTMENT OF TRANSPORTATION			CONTRACT NO. 60D35
	PLOT DATE = 2/11/2008	DATE -	REVISED -		SCALE: ["=50' SHEET NO. OF SHEETS STA. TO STA.	FED. ROAD DIST. NO. 1 ILLINOIS FED. A	ID PROJECT

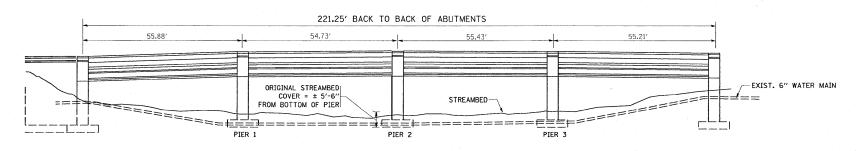

ELEVATION

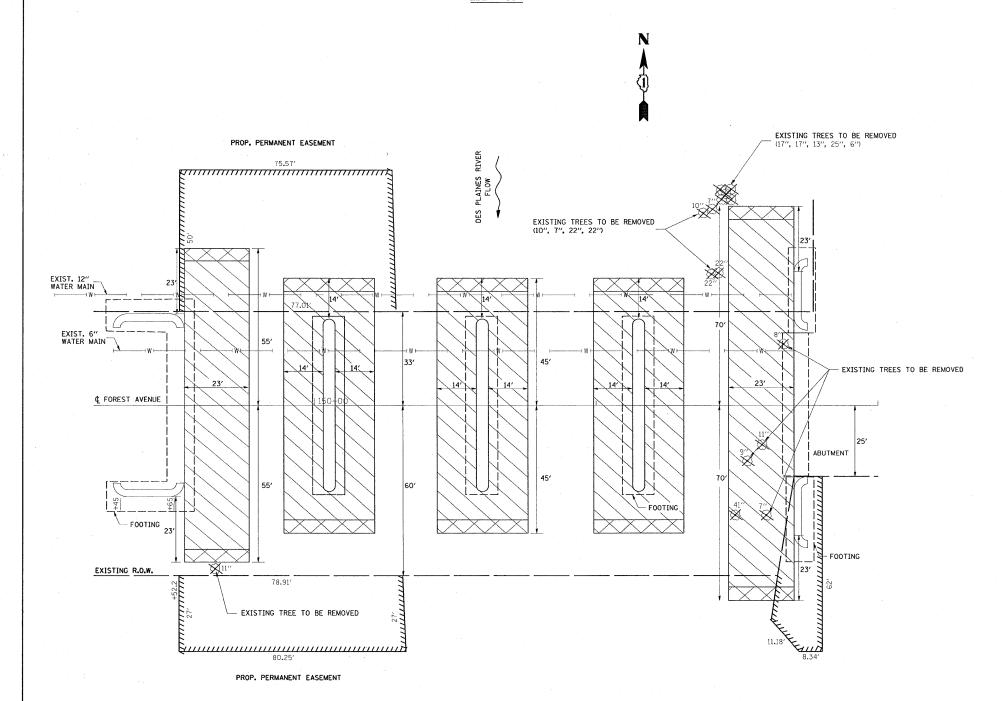

ACCESS TO THIS SITE IS LIMITED. THE CONTRACTOR SHALL ONLY ACCESS THIS SITE BY RAISING AND/OR LOWERING ALL EQUIPMENT AND MATERIAL OVER THE SIDES OF THE BRIDGE. THE CONTRACTOR WILL NOT BE ALLOWED OTHER ACCESS WITHOUT WRITTEN PERMISSION FROM THE ENGINEER. THIS WORK WILL NOT BE PAID FOR SEPARATELY, BUT SHALL BE CONSIDERED AS INCLUDED IN THE CONTRACT UNIT PRICES FOR THE CONSTRUCTION ITEMS INVOLVED AND NO ADDITIONAL COMPENSATION WILL BE ALLOWED

TBM: CUT ON WINGWALL (NE CORNER OF WINGWALL) EL. = 617.89


M: CONCRETE POST WITH REBAR, LOCATED 332' W. OF BRIDGE AND 37' S OF ¢ OF FOREST AVE. (C.C. #406)
EL. = 614.60

BM: NORTHWEST HANDRAIL POST - CHISLED SQUARE EL. = 618.42

NOTES:

GABIONS SHALL BE PLACED AT THE UPSTREAM AND DOWNSTREAM ENDS OF THE PROPOSED SLOPE MATTRESS ACROSS THE CHANNEL

SLOPE MATTRESS SHALL BE SECURELY WIRED DOWN TO THE GABIONS IN ACCORDANCE WITH THE REQUIREMENTS OF ARTICLE 284 OF THE STANDARD SPECIFICATIONS

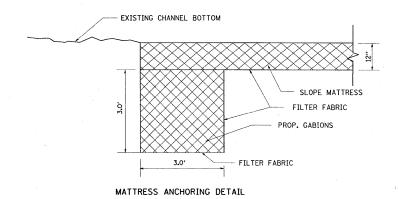


<u>PLAN</u>

										R1
FILE	NAME =	USER NAME = SMITHKL	DESIGNED -	REVISED -			COUNTERMEASURE PLACEMENT DETAIL	F.A.U.	SECTION	COUNTY TOTAL SHEET
c:/p	rojects\d117103\des_bridges.dgn		DRAWN -	REVISED -	STATE OF ILLINOIS	1	+ + +	1472	2007-045 I	COOK 12 5
		PLOT SCALE = 50.0000 '/ IN.	CHECKED -	REVISED -	DEPARTMENT OF TRANSPORTATION		FOREST AVE. OVER THE DES PLAINES RIVER		/	CONTRACT NO. 60D35
		PLOT DATE = 2/20/2008	DATE -	REVISED -		SCALE:	SHEET NO. OF SHEETS STA. TO STA.	FED. ROA	AD DIST. NO. 1 ILLINOIS FED.	

PART OF THE SEC. 35, T39N, R12E OF THE 3RD P.M., COOK COUNTY, ILLINOIS

PARCEL No.	OWNER	TOTAL HOLDING	PART TAKEN	REMAINDER	PREVIOUSLY DED. OR USED	EASEMENT	PURPOSE	PERMANENT INDEX	ACQUIRED BY
		ACRES ACRES		ACRES	ACRES	ACRES	EASEMENT	NUMBER	ACQUALLY BI
1FQ0008PE	Forest Preserve District of Cook County	5.920	N/A	5.920	N/A	0.049 (2,148.76 sq. ft.)	Construction	15-35-403-003	
1FQ0009PE	Forest Preserve District of Cook County	7.250	N/A	7.250	N/A	0.088 (3,814.46 sq. ft.)	Construction	15-35-201-001	
1FQ0010PE	Riverside Condominiums	0.337	N/A	0.337	N/A	0.013 (563.01 sq. ft.)	Construction	15-35-404-020 15-35-404-021 & 022	

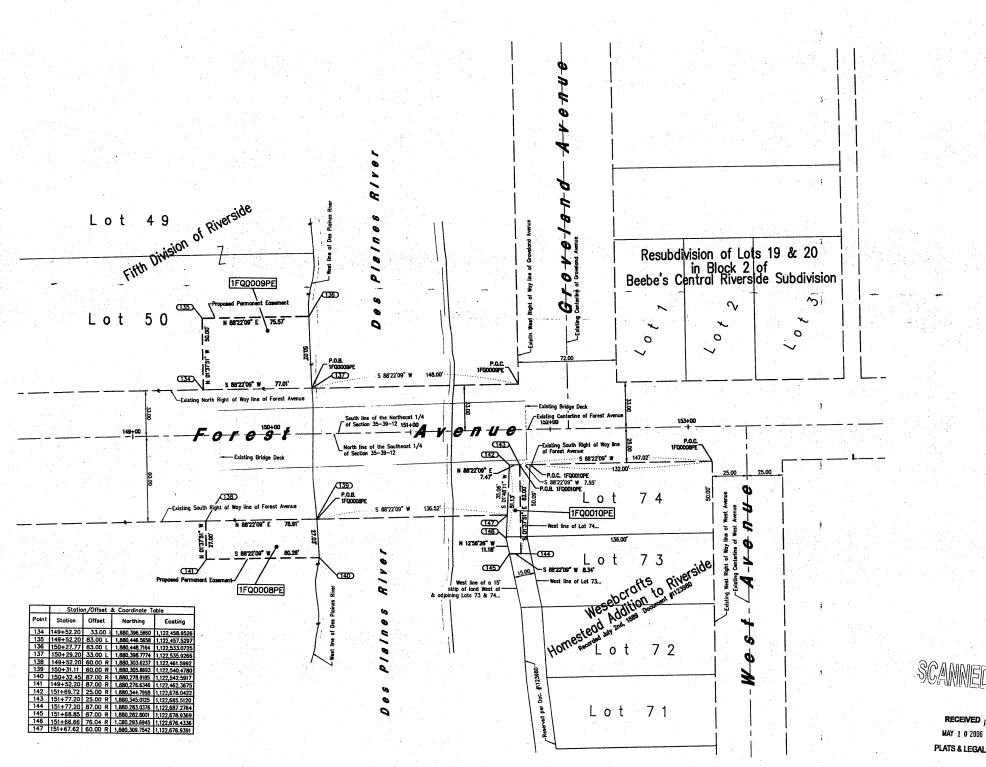

F.A.P RTE.	SECTION	COUNTY	TOTAL	SHEET NO.
1472	2007-045I	Cook	12	6
STA.		TD STA.		

LEGEND





SECTION LINE QUARTER SECTION LINE QUARTER, QUARTER SECTION LINE PLATTED LOT LINE PROPERTY (DEED) LINE

PROPOSED EASEMENT 129.32 129.32 (COMP.) COMPUTED DIMENSION

CENTERLINE EXISTING RIGHT OF WAY LINE PROPOSED RIGHT OF WAY LINE

IRON PIPE OR ROD FOUND CUT CROSS FOUND OR SET

REPLACED AFTER CONSTRUCTION

THESE STAKES REFERENCE FOUND OR SET MONUMENTATION. SET 5/8 INCH IRON ROD FLUSHED WITH GROUND TO TIE FOUND IRON STAKE. IDENTIFIED BY COLORED PLASTIC CAP BEARING SURVEYORS REGISTRATION NUMBER.

THESE STAKES, IN CULTIVATED AREAS, REFERENCE FOUND OR SET MONUMENTATION. BURIED 5/8 INCH IRON ROD 20 INCHES BELOW GROUND TO TIE FOUND IRON STAKE. INCHIENDED BY COLORED PLASTIC CAP BEARING SURVEYORS REGISTRATION NUMBER.

STAKING OR PROROSED RIGHT OF WAY IN CULTIVATED AREAS, BURIED 5, INCH METAL ROD 20 INCHES BELOW GROUND TO MARK FUTURE SURVEY MARKER POSITION. IDENTIFIED BY COLOR PLASTIC CAP BEARING SURVEYOR REGISTRATION NUMBER.

PERMANENT SURVEY MARKER, I D O T STD. 2135 (TO BE SET BY OTHERS) RIGHT OF WAY STAKING PROPOSED TO BE SET-

GRAPHIC SCALE

(IN FEET)

COUNTY OF COOK

THIS IS TO DECLARE THAT WE, W-T LAND SURVEYING, INC., HAVE SURVEYED THE PLAT OF HIGHWAYS SHOWN HEREON IN THAT PART OF SECTION 35, TOWNSHIP 39 NORTH, RANGE 12 EAST OF THE THIRD PRINCIPAL MERIDIAN; THAT THE SURVEYET IS TRUE AND COMPLETE AS SHOWN TO THE BEST OF MY KNOWLEDGE. AND BELLEF; THAT THE PLAT CORRECTLY REPRESENTS SAD SURVEY, THAT TALL MONUMENTS FOUND AND ESTABLISHED ARE OF PERMANENT GUALITY AND OCCUPY THE POSITIONS SHOWN THEREON AND THAT THE MONUMENTS ARE SUFFICIENT TO RANGE THE SURVEY TO BE RETRACED. MADE FOR THE DEPARTMENT OF TRANSPORTATION, STATE OF ILLINOIS.

W-T LAND SURVEYING, INC.

ILLINOIS PROFESSIONAL LAND SURVEY CORPORATION
IL. LICENSE NO. 184-001108



RECEIVED PL

W-T LAND SURVEYING, INC.

39 EAST SCULLY DRIVE SCHAUMBURG, ILLINOIS 60193 ph. (847)895-3640 fax. (847)895-9985

PLAT OF HIGHWAYS

STATE OF ILLINOIS DEPARTMENT OF TRANSPORTATION Forest Avenue (Over Des Plaines River)

SECTION 2003-067 I PROJECT STATION 149+52.20

COOK COUNTY JOB NO. R-91-007-05 TO STATION 150+32.45 SHEET 4 OF 9


BUREAU OF LAND ACQUISITION 201 WEST CENTER COURT SCHAUMBURG, ILLINOIS 60196-1096


FOR INFORMATION ONLY

COUNTY COOK

RECORDING: RECORDED ON

AS DOCUMENT NO.

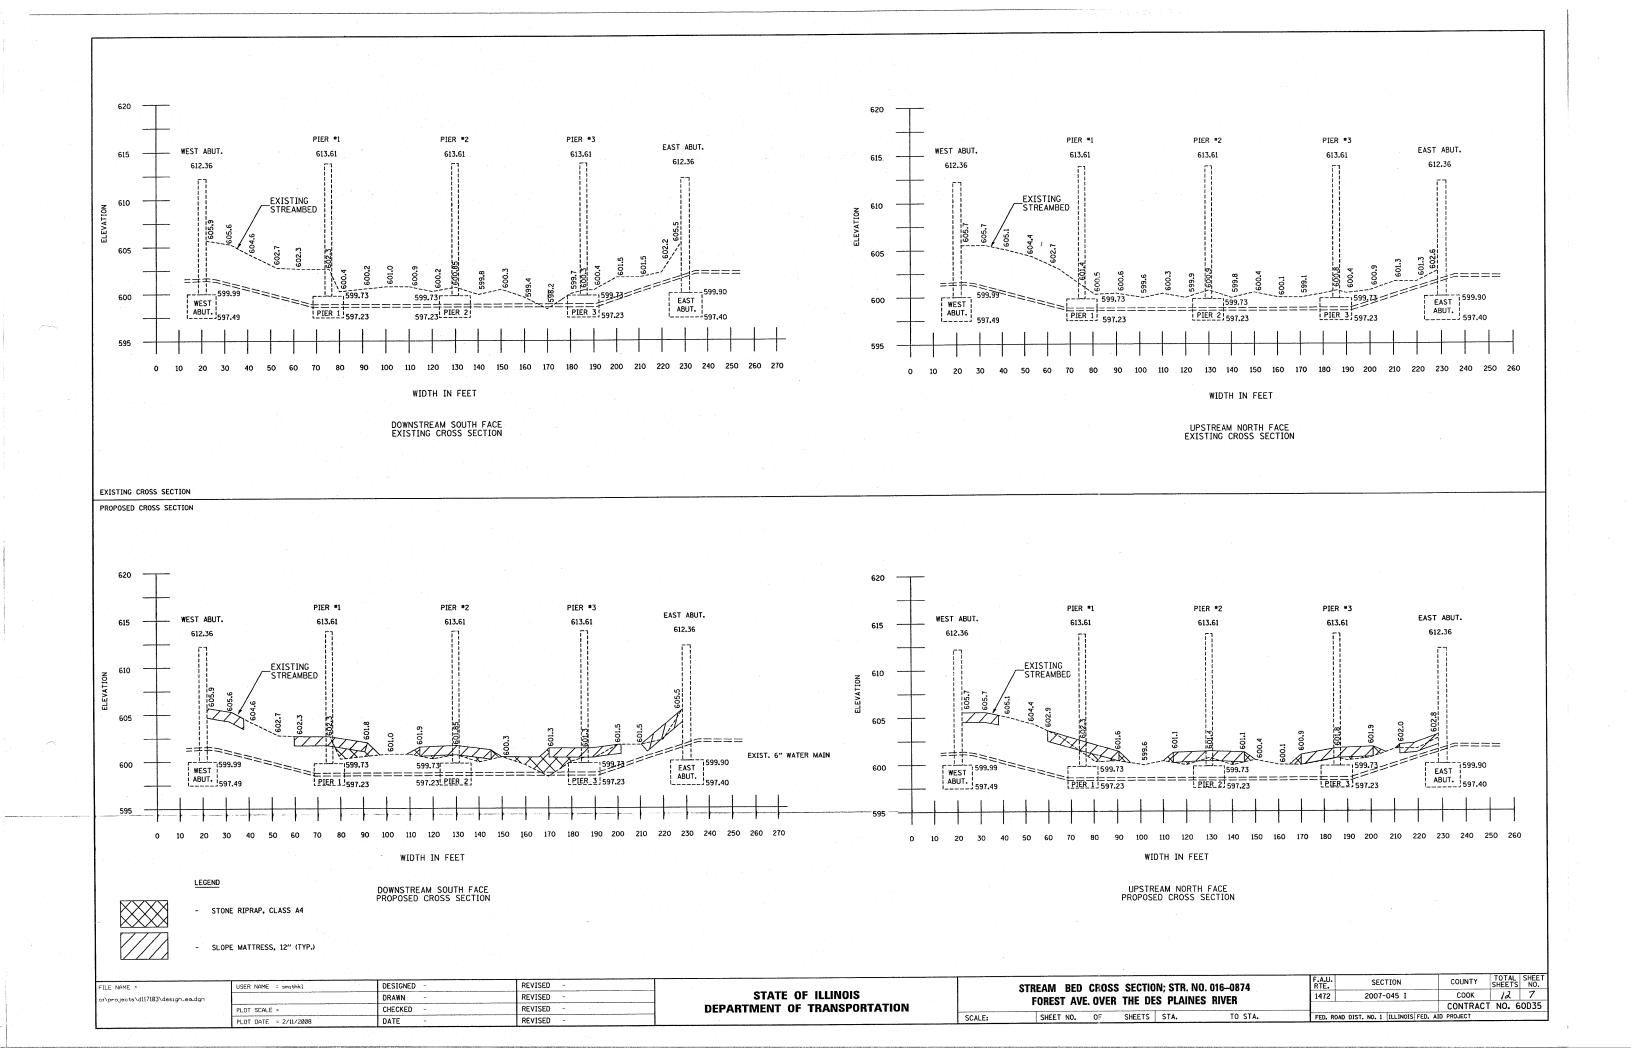

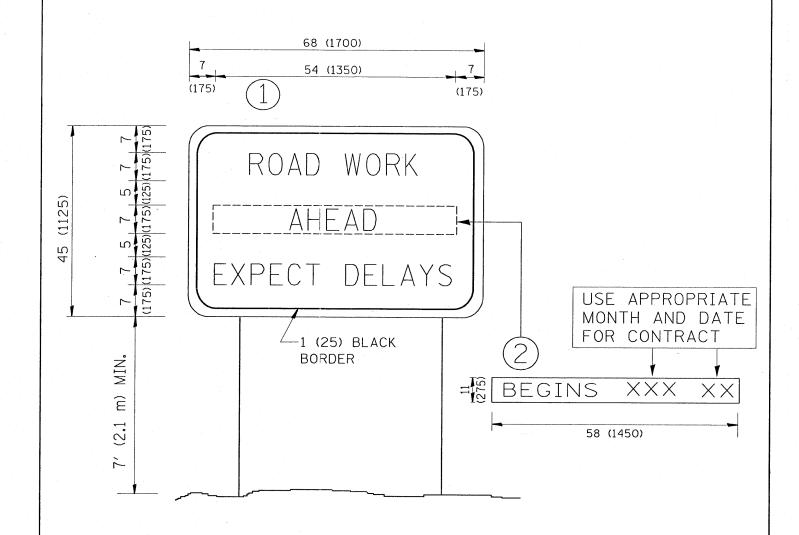


NOTES:

- 1. USE BLACK LETTERING ON ORANGE BACKGROUND.
- 2. ERECT SIGNS IN ADVANCE OF THE LOCATION FOR THE "ROAD CONSTRUCTION AHEAD" SIGN AT LOCATIONS AS DIRECTED BY THE ENGINEER.
- 3. ERECT SIGN (1) WITH INSTALLED PANEL (2) ONE WEEK PRIOR TO THE START OF CONSTRUCTION.
- 4. REMOVE PANEL 2 SOON AFTER THE START OF CONSTRUCTION.
- 5. SEE SPECIAL PROVISION FOR "TEMPORARY INFORMATION SIGNING" FOR ADDITIONAL INFORMATION.
- 6. ONE SIGN ASSEMBLY EQUALS 25.70 SQ. FT. (2.3 SQ. M.)
- 7. SHALL BE PAID FOR AS TEMPORARY INFORMATION SIGNING.

ALL DIMENSIONS ARE IN INCHES (MILLIMETERS) UNLESS OTHERWISE SHOWN.

FILE NAME =	USER NAME = smithkl	DESIGNED -	REVISED - R. MIRS 09-15-97			F.A.V. SECTION COUNTY TOTAL SHEE
W:\diststd\22x34\tc22.dgn		DRAWN -	REVISED - R. MIRS 12-11-97	STATE OF ILLINOIS	ARTERIAL ROAD	NIE. SHEETS NO.
	PLOT SCALE = 50.000 '/ IN.	CHECKED ~	REVISED -T. RAMMACHER 02-02-99	DEPARTMENT OF TRANSPORTATION	INFORMATION SIGN	11/2 2001-013 E COOK 12 8
	PLOT DATE = 2/11/2008	DATE -	REVISED - C. JUCIUS 01-31-07	DEFAITMENT OF THANGS OF A TON	SCALE: NONE SHEET NO. 1 OF 1 SHEETS STA. TO STA.	TC-22 CONTRACT NO.

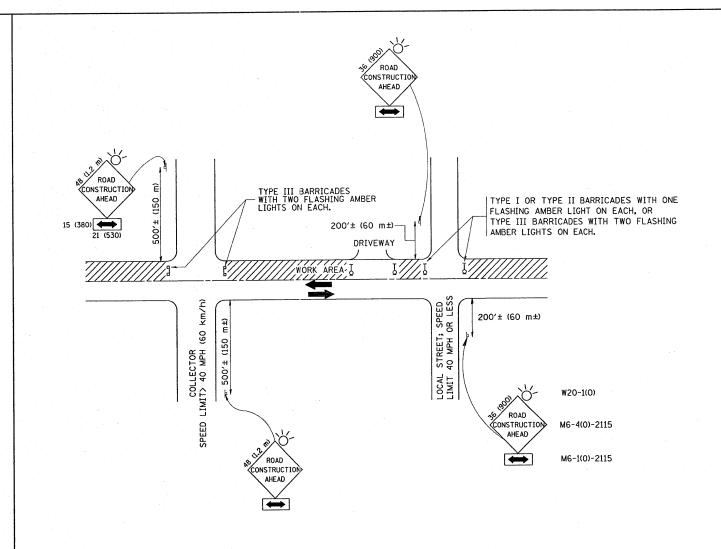

TRAFFIC CONTROL AND PROTECTION FOR SIDE ROADS, INTERSECTIONS, AND DRIVEWAYS

NOTES:

- A. FOR NO LANE RESTRICTION ON THE SIDE ROAD OR DRIVEWAYS
- 1. SIDE ROAD WITH A SPEED LIMIT OF 40 MPH (60 km/h) OR LESS AS SHOWN ON THE DRAWING AND AS DIRECTED BY THE ENGINEER:
- d) ONE ROAD CONSTRUCTION AHEAD SIGN 36 x 36 (900x900) WITH A FLASHER AND FLAG MOUNTED ON IT APPROXIMATELY 200' (60 m) IN ADVANCE OF THE MAIN ROUTE.
- b) THE CLOSED PORTION OF THE MAIN ROUTE SHALL BE PROTECTED BY BLOCKING WITH TYPE I, TYPE II OR TYPE III BARRICADES, 1/3 OF THE CROSS SECTION OF THE CLOSED PORTION.
- 2. SIDE ROAD WITH A SPEED LIMIT GREATER THAN 40 MPH (60 km/h) AS SHOWN ON THE DRAWING AND AS DIRECTED BY THE ENGINEER:
- O) ONE ROAD CONSTRUCTION AHEAD SIGN 48 x 48 (1.2 m x 1.2 m) WITH A FLASHER MOUNTED ON IT APPROXIMATELY 500' (150 m) IN ADVANCE OF THE MAIN ROUTE.
- b) THE CLOSED PORTION OF THE MAIN ROUTE SHALL BE PROTECTED BY BLOCKING WITH TYPE III BARRICADES, 1/2 OF THE CROSS SECTION OF THE CLOSED PORTION.
- 3. WHEN THE SIDE ROAD LIES BETWEEN THE BEGINNING OF THE MAINLINE SIGNING AND THE WORK ZONE, A SINGLE HEADED ARROW (M6-1) SHALL BE USED IN LIEU OF THE DOUBLE HEADED ARROW (M6-4).

- B. FOR A LANE CLOSURE ON A SIDE ROAD OR DRIVEWAY:
- USE APPLICABLE PORTIONS OF THE TYPICAL APPLICATION OF TRAFFIC CONTROL DEVICES (STD. 701501, STD. 701606 OR THE APPROPRIATE STANDARD). THE SPACING OF SIGNS AND BARRICADES SHALL BE ADJUSTED FOR FIELD CONDITIONS AS DIRECTED BY THE ENGINEER. THE DIRECTIONAL ARROW SHALL BE COVERED OR REMOVED WHEN NO LONGER CONSISTENT WITH THE SIDE ROAD LANE CLOSURE.
- C. ADVANCE WARNING SIGNS ARE TO BE OMITTED ON DRIVEWAY UNLESS OTHERWISE NOTED.
- D. THE TRAFFIC CONTROL AND PROTECTION FOR SIDE ROADS, INTERSECTIONS, AND DRIVEWAYS SHALL BE INCIDENTAL TO THE COST OF SPECIFIED TRAFFIC CONTROL STANDARDS OR ITEMS.

All dimensions are in millimeters (inches) unless otherwise shown.

FILE NAME = USER NAME = smithk1 DESIGNED - LHA REVISED - J. 0BERLE 10-18-95

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PLOT SCALE = 50.000 '/ IN. CHECKED - REVISED - A. HOUSEH 03-06-96

PLOT DATE = 2/11/2008 DATE - 06-89 REVISED - T. RAMMACHER 01-06-00

STATE OF ILLINOIS
DEPARTMENT OF TRANSPORTATION

-		TRAFFIC	CONTR	N AND P	N FOR	F.A.U. RTE.	SECTION	COUNTY	SHEE	
				-		1472	2007-045 I	COOK	12	
1		SIDE ROADS	i, inter	SECTIONS	, AND DK	INEMAIS		TC-10	CONTRACT	NO.
	SCALE: NONE	SHEET NO. 1	OF 1	FED. RO	AD DIST. NO. 1 ILLINOIS FED. A	ID PROJECT				


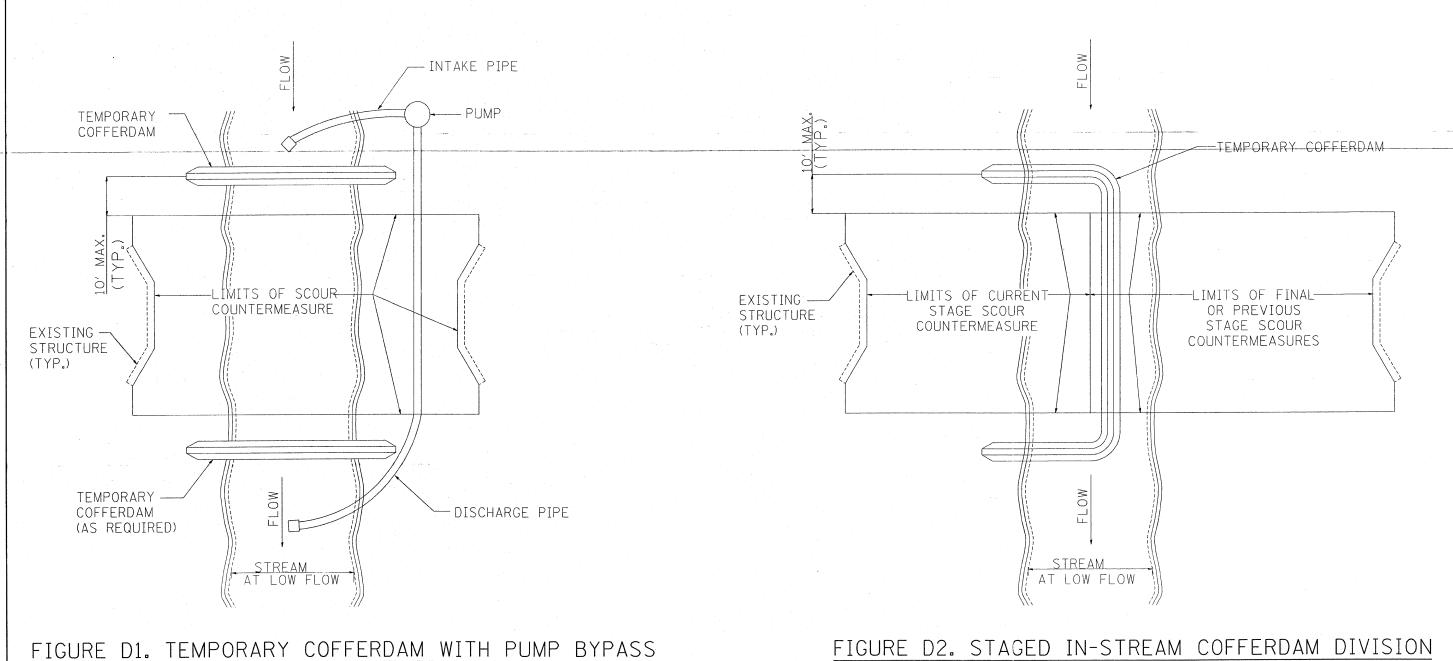


FIGURE D2. STAGED IN-STREAM COFFERDAM DIVISION

NOTE: DEWATERING SYSTEM DETAILS SHALL BE USED IN CONJUNCTION WITH THE PROJECT SPECIAL PROVISIONS.

FILE NAME =	USER NAME = smithkl	DESIGNED -	REVISED -	STATE OF ILLINOIS					EM DE		F.A.U. RTE.	SECTION 2007-045 I	COUNTY	TOTAL SHEE SHEETS NO.	7
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4 (1 × 1)	PLDT DATE = 2/11/2008	DATE -	REVISED -		SCALE:	SHEET NO.	OF:	SHEETS	S STA.	TO STA.	FED. ROA	AD DIST. NO. 1 ILLINOIS FEE	. AID PROJECT		

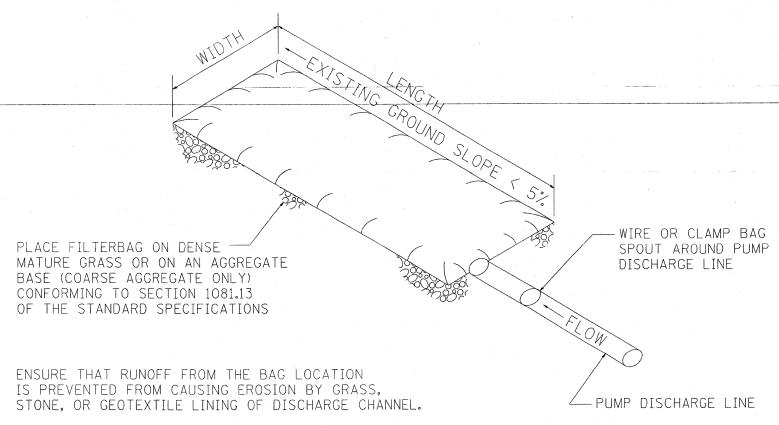

REMOVE SILT WHEN BAG IS HALF FULL OR MORE OFTEN IF RECOMMENDED BY THE MANUFACTURER. DISPOSE OF SILT BY TRANSPORTING THE FILLED BAG TO DISPOSAL AREA. SLIT THE BAG, BLEND SILT INTO EXISTING TOPOGRAGHY, SEED AND MULCH


MAINTAIN EXTRA FILTER BAGS ON SITE. REPLACE DAMAGED BAGS PROMPTLY

TYPICAL FLOW RATE: 10 GPM x W x L


FIGURE S1. SEDIMENT FILTER BAG

NOTE: DEWATERING SYSTEM DETAILS SHALL BE USED IN CONJUNCTION WITH THE PROJECT SPECIAL PROVISIONS.

FILE NAME =	USER NAME = smithkl	DESIGNED -	REVISED -			DEWATERING SYSTEM DETAIL		F.A.U. RTE.	SECTION	COUNTY	TOTAL SHEET SHEETS NO.
c:\projects\d117103\design_shtaa.dgn		DRAWN -	REVISED -	STATE OF ILLINOIS		SEDIMENT FILTER-BAG DETAIL		1472	2007-045 I	COOK	12 11
	PLOT SCALE = 50.0000 ' / IN.	CHECKED -	REVISED ~	DEPARTMENT OF TRANSPORTATION						CONTRAC	T NO. 60D35
	PLOT DATE = 2/11/2008	DATE -	REVISED -		SCALE: SHE	EET NO. OF SHEETS STA.	TO STA.	FED. ROAD (DIST. NO. 1 ILLINOIS FED. A	D PROJECT	

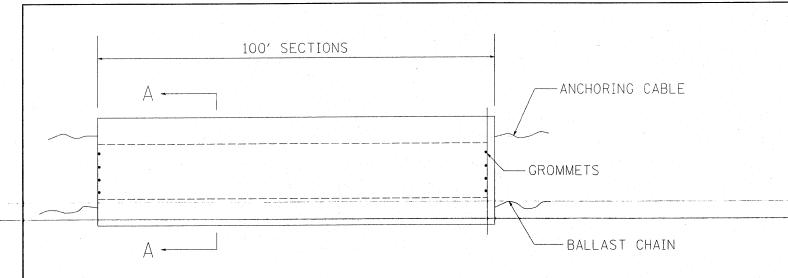

ELEVATION

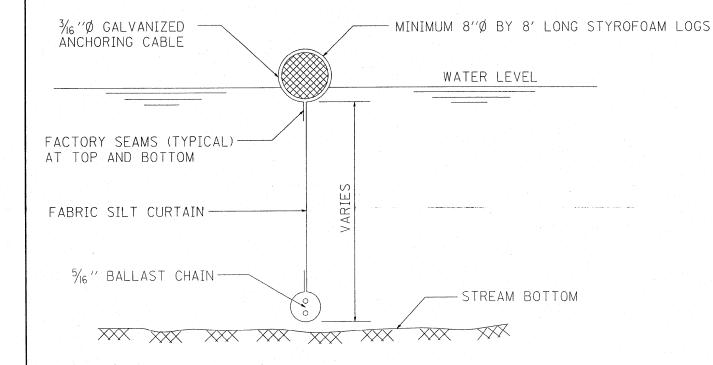

SECTION A-A

FLOTATION BOOM

- 1. FLOTATION BOOM SHALL BE ANCHORED TO PREVENT DRIFT SHOREWARD OR DOWNSTREAM. ANCHORAGES SHALL BE INSTALLED ON BOTH SHORE AND STREAM SIDE.
- 2. SHORE ANCHORS SHALL CONSIST OF A POST WITH DEADMAN OR APPROVED EQUAL. STREAM ANCHORS SHALL BE OF SUFFICIENT SIZE TO STABILIZE THE BARRIER WITH NUMBER AND SPACING DEPENDENT ON WATERWAY VELOCITIES.
- 3. FABRIC SECTIONS SHALL BE CONNECTED END TO END WITH MINIMUM \%" DIAMETER POLYPROPYLENE ROPE.
- 4. DESIGN OF BOOM AND ANCHORAGE SHALL BE IN ACCORDANCE WITH MANUFACTURER'S RECOMENDATIONS. BOTTOM OF BOOM SHALL REACH BOTTOM OF WATERWAY USING ONE OR TWO VERTICAL SECTIONS AS REQUIRED.
- 5. MAINTENANCE SHALL BE PERFORMED AS NEEDED. CONTRACTOR SHALL REMOVE THE BOOM AT COMPLETION OF WORK IN A MANNER THAT WILL PREVENT SILTATION OF THE WATERWAY.

APPLICATION: FLOTATION BOOMS TO BE USED TO CONTROL EROSION, TURBIDITY AND DEBRIS WHEN WORKING IN WATERWAYS.

NOTES:

FILE NAME =	USER NAME = smithkl	DESIGNED -	REVISED -			DEWATERING SYSTEM DETAIL	F.A.U. SECTI	ON COUNTY	TOTAL SHEET SHEETS NO.
c:\projects\d117103\design_shtee.dgn		DRAWN -	REVISED -	STATE OF ILLINOIS		FLOTATION BOOM DETAIL	1472 2007-0	19 1	12 12
	PLOT SCALE = 50.0000 '/ IN.	CHECKED -	REVISED -	DEPARTMENT OF TRANSPORTATION					CT NO. 60D35
	PLOT DATE = 2/11/2008	DATE -	REVISED -		SCALE:	SHEET NO. OF SHEETS STA. TO STA.	FED. ROAD DIST. NO. 1	LLINOIS FED. AID PROJECT	