CONSTRUCTION PLANS FOR INGERSOLL AIRPORT


CANTON, FULTON COUNTY, ILLINOIS

NEW MIRLS ON RUNWAYS 9-27 & 18-36;
NEW MITLS ON TAXIWAYS B & G


SUMMARY OF QUANTITIES						
ITEM NO.	DESCRIPTION	UNIT	AS BID QUANTITY	AS BUILT QUANTITY		
AR108000	CABLE TRENCH	LIN. FT.	45			
AR108108	1/C #8 5KV UG CABLE	LIN. FT.	3,240			
AR108158	1/C #8 5KV UG CABLE IN UD	LIN. FT.	20,450			
AR109301	4 KW REGULATOR, STYLE 1	EACH	2			
AR109311	7.5 KW REGULATOR, STYLE 1	EACH	1			
AR109903	REMOVE REGULATOR	EACH	3			
AR110316	6" STEEL DUCT - JACKED	LIN. FT.	10			
AR110710	ELECTRICAL MANHOLE	EACH	1			
AR125410	MITL - STAKE MOUNTED	EACH	39			
AR125415	MITL - BASE MOUNTED	EACH	6			
AR125442	TAXI GUIDANCE SIGN, 2 CHARACTER	EACH	4			
AR125444	TAXI GUIDANCE SIGN, 4 CHARACTER	EACH	2			
AR125445	TAXI GUIDANCE SIGN, 5 CHARACTER	EACH	3			
AR125446	TAXI GUIDANCE SIGN, 6 CHARACTER	EACH	1			
AR125505	MIRL, STAKE MOUNTED	EACH	55			
AR125510	MIRL, BASE MOUNTED	EACH	18			
AR125540	MI THRESHOLD LIGHT STAKE MTD	EACH	28			
AR125610	REILS	PAIR	1			
AR125901	REMOVE STAKE MOUNTED LIGHT	EACH	117			
AR125902	REMOVE BASE MOUNTED LIGHT	EACH	24			
AR125904	REMOVE TAXI GUIDANCE SIGN	EACH	6			
AR125907	REMOVE REILS	PAIR	1			
AR150530	TRAFFIC MAINTENANCE	L. SUM	1			
AR800250	2-1/C #8 5KV UG CABLE IN UD	LIN. FT.	2,630			

ILLINOIS PROJECT NO. CTK-4350 SBG PROJECT NO. 3-17-SBGP-76

MARCH 20, 2015

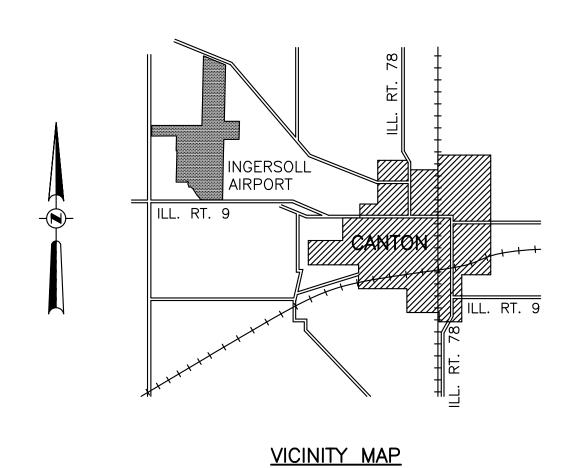

	INDEX TO SHEETS		
NO.	DESCRIPTION		
1	COVER SHEET		
2	IMPROVEMENT AND SAFETY PLAN		
3-4	EDGE LIGHTING UNIT REMOVAL PLAN		
5	RUNWAY 9-27 LIGHTING PLAN		
6	RUNWAY 18-36 LIGHTING PLAN		
7	TAXIWAY B & G LIGHTING LAYOUT		
8	REIL SYSTEM DETAILS		
9-11	TYPICAL LIGHTING DETAILS		
12	GENERAL NOTES AND LEGEND		

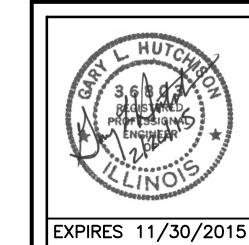

PLANS PREPARED BY :


HUTCHISON ENGINEERING, INC. JACKSONVILLE, ILLINOIS

CANTON PARK DISTRICT

APPROVED Will R Bruk ____ PRESIDENT DATE ___ March 9, 2015

APPROVED_Breat C. Wheels____ SECRETARY

DATE ___ March 9, 2015 _____

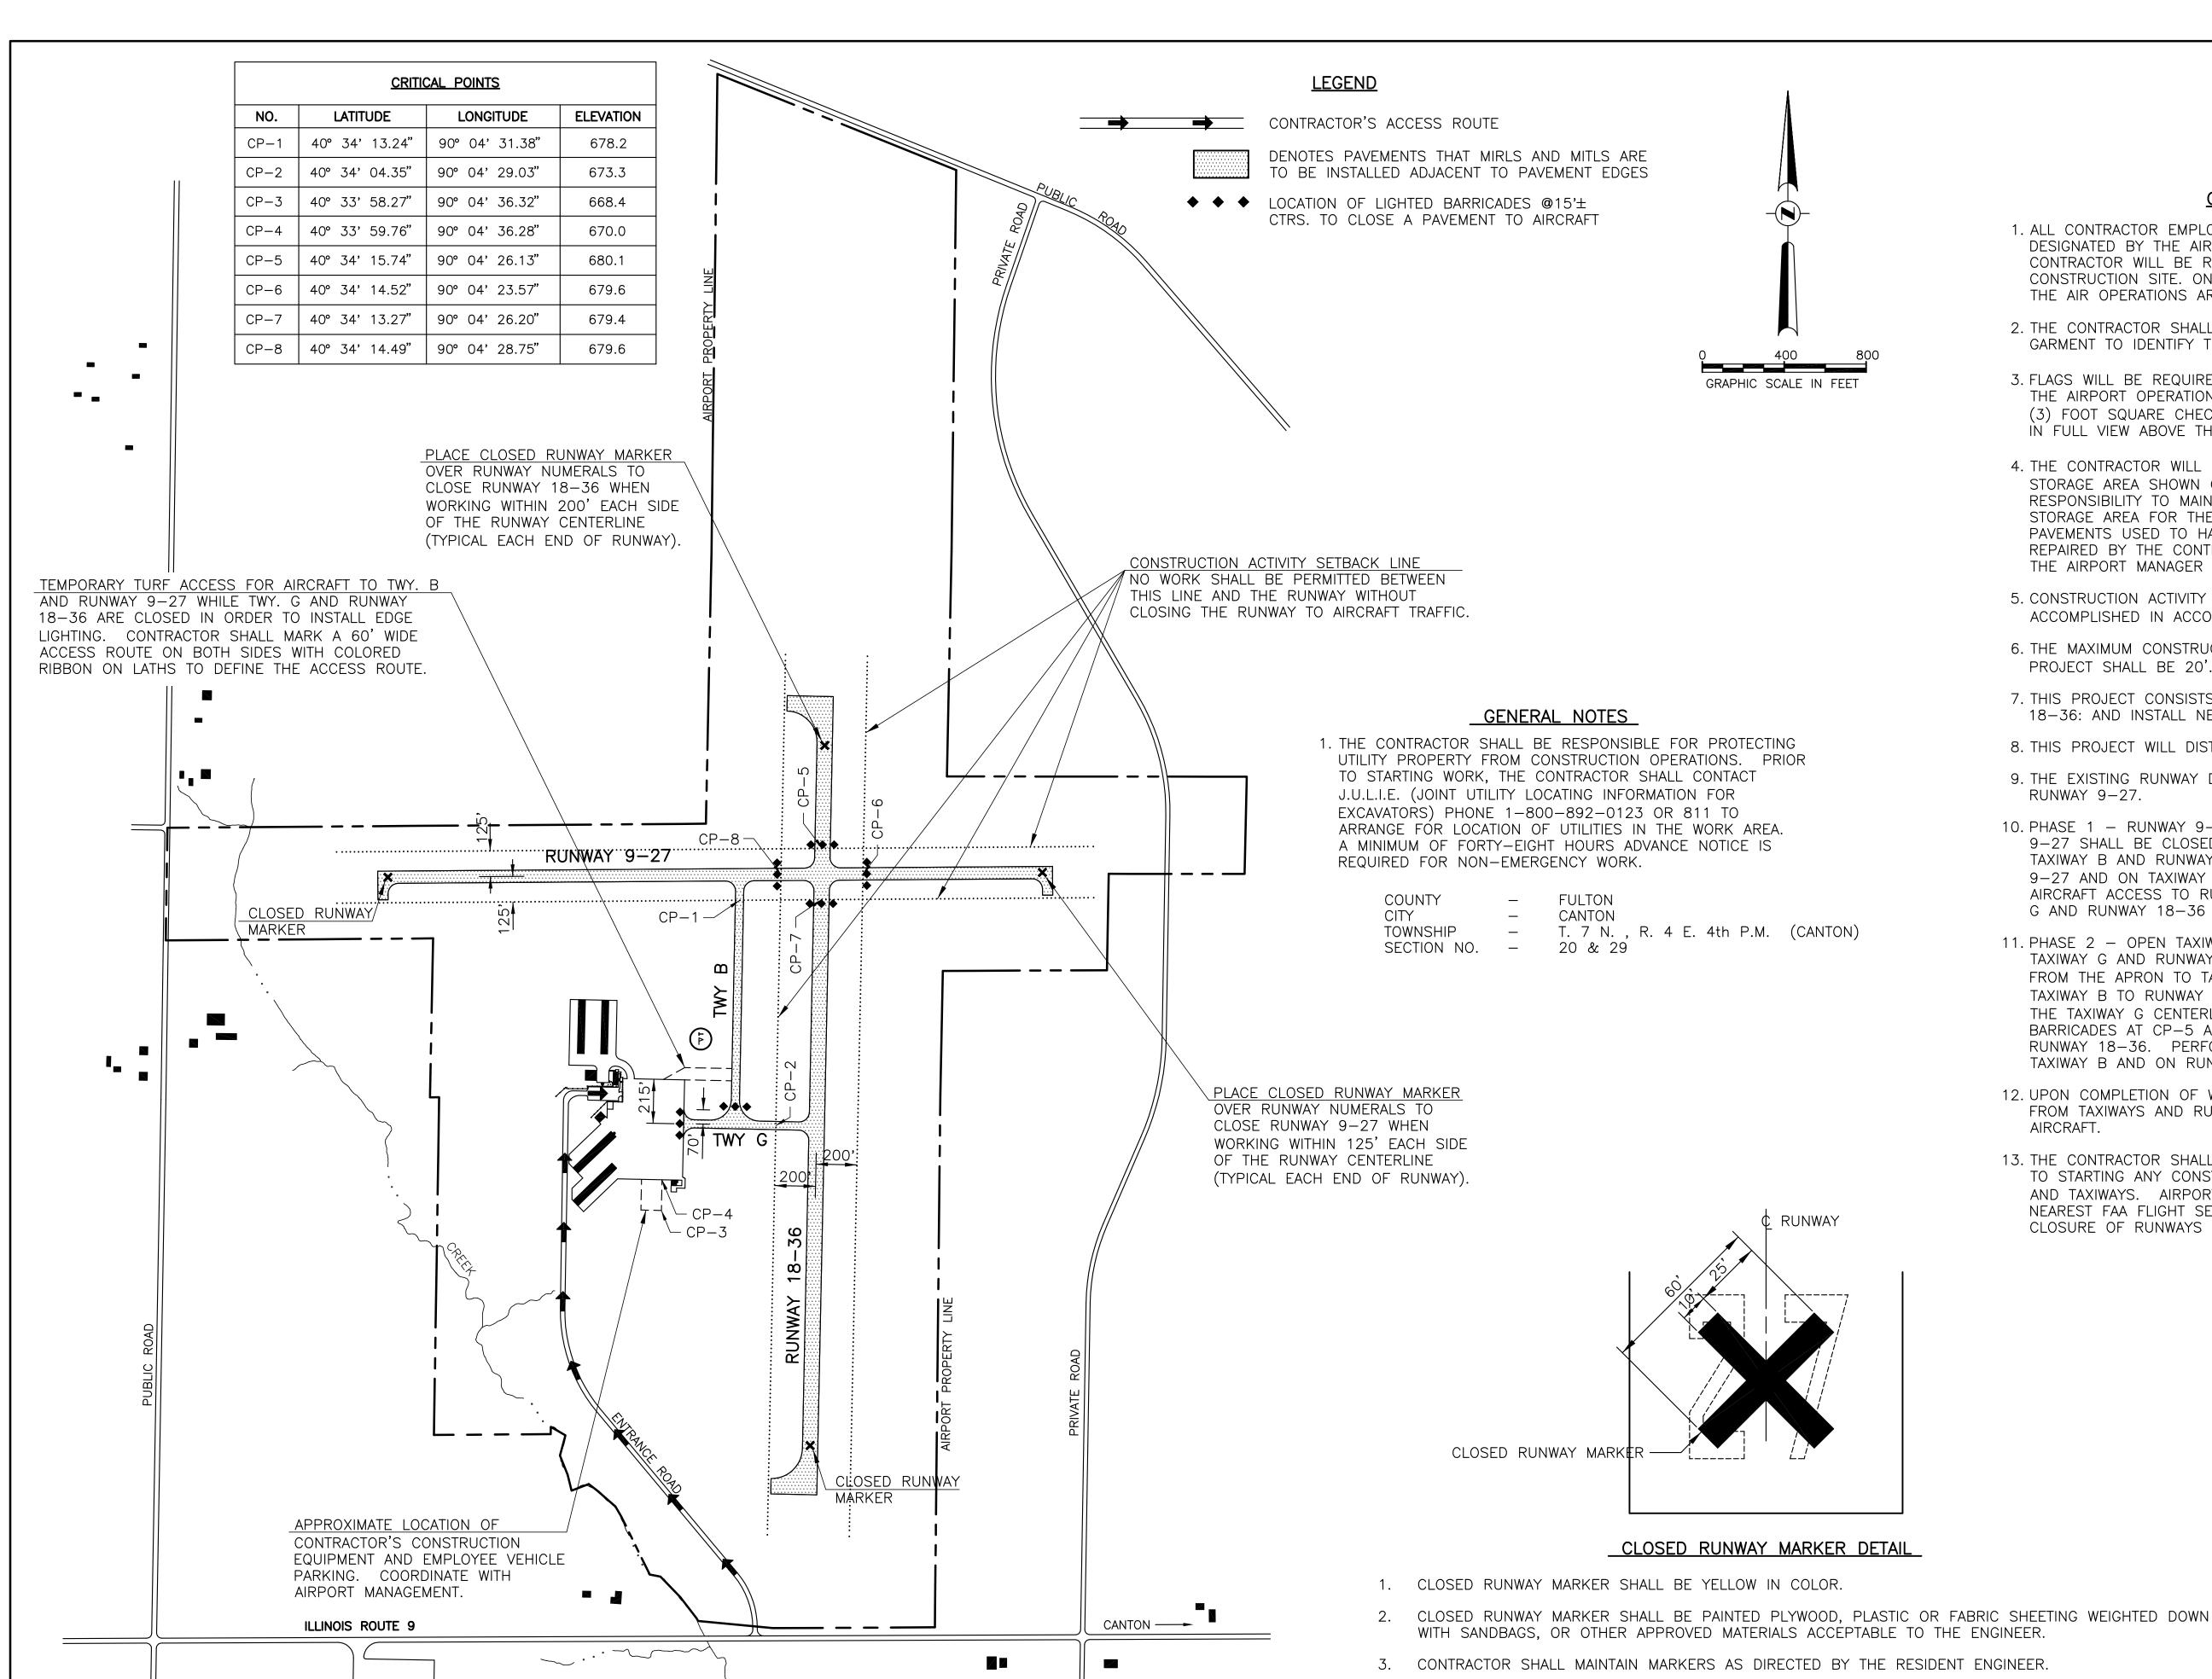

CONSTRUCTION PROCEDURE NOTES

- 1. ALL CONTRACTOR EMPLOYEES WILL PARK THEIR PERSONAL VEHICLES IN THE AREA DESIGNATED BY THE AIRPORT MANAGER FOR USE AS A VEHICLE PARKING AREA. THE CONTRACTOR WILL BE RESPONSIBLE FOR TRANSPORTING EMPLOYEES TO THE PROPOSED CONSTRUCTION SITE. ONLY AUTHORIZED CONTRACTOR VEHICLES WILL BE ALLOWED ON THE AIR OPERATIONS AREA OF THE AIRPORT AND ON THE CONSTRUCTION SITE.
- 2. THE CONTRACTOR SHALL FURNISH ALL EMPLOYEES WITH SOME TYPE OF TAG OR GARMENT TO IDENTIFY THEM AS BEING PART OF THE CONSTRUCTION CREW.
- 3. FLAGS WILL BE REQUIRED ON ALL CONTRACTOR'S VEHICLES AND EQUIPMENT USED ON THE AIRPORT OPERATIONS AREA AND CONSTRUCTION SITE. THE FLAGS SHALL BE THREE (3) FOOT SQUARE CHECKERED FLAGS (INTERNATIONAL ORANGE AND WHITE) DISPLAYED IN FULL VIEW ABOVE THE VEHICLE.
- 4. THE CONTRACTOR WILL USE THE DESIGNATED HAUL ROUTE AND EQUIPMENT STORAGE AREA SHOWN ON THIS SHEET. IT WILL BE THE CONTRACTOR'S RESPONSIBILITY TO MAINTAIN THE DESIGNATED HAUL ROUTE AND EQUIPMENT STORAGE AREA FOR THE DURATION OF THE PROJECT. ANY DAMAGE TO EXISTING PAVEMENTS USED TO HAUL MATERIAL TO THE CONSTRUCTION SITE WILL BE REPAIRED BY THE CONTRACTOR AT HIS OWN EXPENSE TO THE SATISFACTION OF THE AIRPORT MANAGER AND THE RESIDENT ENGINEER.
- 5. CONSTRUCTION ACTIVITY CONTROL AND OPERATION AREA PROTECTION SHALL BE ACCOMPLISHED IN ACCORDANCE WITH FAA ADVISORY CIRCULAR NO. 150/5370-2F.
- 6. THE MAXIMUM CONSTRUCTION EQUIPMENT HEIGHT UTILIZED ON THE AIRPORT FOR THIS PROJECT SHALL BE 20'.
- 7. THIS PROJECT CONSISTS OF WORK TO INSTALL NEW MIRLS ON RUNWAY 9-27 & 18-36: AND INSTALL NEW MITLS ON TAXIWAYS B & G.
- 8. THIS PROJECT WILL DISTURB LESS THAN 1 ACRE OF LAND.
- 9. THE EXISTING RUNWAY DESIGN CODE IS B-II FOR RUNWAY 18-36 AND IS B-1 FOR RUNWAY 9-27.
- 10. PHASE 1 RUNWAY 9-27 AND TAXIWAY B FROM NORTH OF TAXIWAY G TO RUNWAY 9-27 SHALL BE CLOSED TO AIRCRAFT TRAFFIC WHILE WORK IS ACCOMPLISHED ON TAXIWAY B AND RUNWAY 9-27. PLACE BARRICADES AT CP-6 AND CP-8 ON RUNWAY 9-27 AND ON TAXIWAY B AT 70' NORTH OF THE TAXIWAY G CENTERLINE TO DENY AIRCRAFT ACCESS TO RUNWAY 9-27 AND TO TAXIWAY B. AIRCRAFT SHALL USE TAXIWAY G AND RUNWAY 18-36 DURING THIS PERIOD.
- 11. PHASE 2 OPEN TAXIWAY B AND RUNWAY 9-27 TO AIRCRAFT TRAFFIC AND CLOSE TAXIWAY G AND RUNWAY 18-36. AIRCRAFT SHALL USE THE TEMPORARY TURF ACCESS FROM THE APRON TO TAXIWAY B AT 215' NORTH OF TAXIWAY G, THENCE NORTH ON TAXIWAY B TO RUNWAY 9-27. PLACE BARRICADES ON TAXIWAY B AT 70' NORTH OF THE TAXIWAY G CENTERLINE AND AT THE APRON/TAXIWAY G INTERSECTION. PLACE BARRICADES AT CP-5 AND CP-7 ON RUNWAY 18-36 TO DENY AIRCRAFT ACCESS TO RUNWAY 18-36. PERFORM THE WORK ON TAXIWAY G AND ITS INTERSECTION WITH TAXIWAY B AND ON RUNWAY 18-36.
- 12. UPON COMPLETION OF WORK ON TAXIWAY G AND RUNWAY 18-36, REMOVE BARRICADES FROM TAXIWAYS AND RUNWAY 18-36 AND OPEN THE TAXIWAYS AND RUNWAY 18-36 TO
- 13. THE CONTRACTOR SHALL GIVE THE AIRPORT MANAGEMENT THREE DAYS NOTICE PRIOR TO STARTING ANY CONSTRUCTION WHICH WOULD NECESSITATE CLOSURE OF RUNWAYS AND TAXIWAYS. AIRPORT MANAGEMENT SHALL GIVE PROPER NOTICE (NOTAMS) TO THE NEAREST FAA FLIGHT SERVICE STATION PRIOR TO THE START OF CONSTRUCTION AND CLOSURE OF RUNWAYS AND TAXIWAYS.

INGERSOLL AIRPORT CANTON, ILLINOIS

IMPROVEMENT AND SAFETY PLAN

HUTCHISON ENGINEERING, INC. JACKSONVILLE, ILLINOIS


DRAWN BY: R.L.R.


4. THE COST OF FURNISHING, PLACING, MAINTAINING, AND REMOVING CLOSED RUNWAY MARKERS

SHALL BE PAID FOR UNDER ITEM AR150530 TRAFFIC MAINTENANCE.

ILL. PROJ. NO. CTK-4350 DATE: FEBRUARY, 2015 SBG PROJ. NO. 3-17-SBGP-76


EXISTING EDGE LIGHTING UNIT REMOVAL SCHEDULE					
DESCRIPTION	REMOVE BASE MOUNTED LIGHT EACH	REMOVE STAKE MOUNTED LIGHT EACH			
EXISTING RUNWAY 9-27 CIRCUIT NO. 2	8	39			
TOTALS THIS SHEET	8	39			

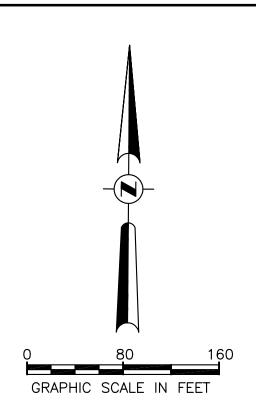

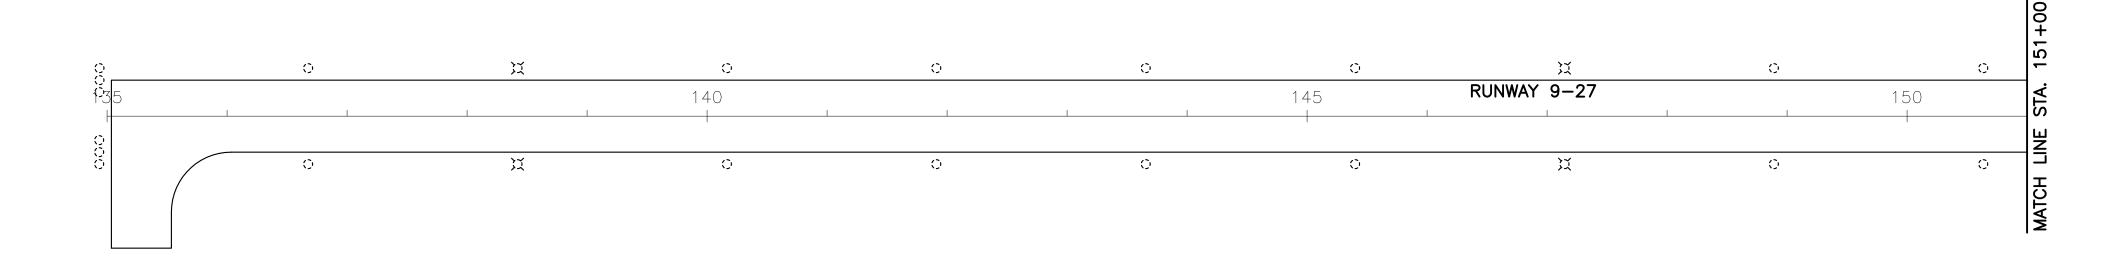

NOTES:

- 1. ALL EXISTING GUIDANCE SIGNS INCLUDING TRANSFORMERS AND STEEL BASES WITH CONCRETE BACKFILL THAT ARE REMOVED SHALL BE DISPOSED OF BY THE CONTRACTOR OFF THE AIRPORT PROPERTY. THE CONTRACTOR SHALL SALVAGE 8 OF THE EXISTING MEDIUM INTENSITY BASE MOUNTED LIGHT FIXTURES AND 24 OF THE EXISTING MEDIUM INTENSITY STAKE MOUNTED FIXTURES INCLUDING TRANSFORMERS FOR USE BY THE AIRPORT AS MAINTENANCE REPAIR PARTS. THE SALVAGED UNITS SHALL BECOME THE PROPERTY OF THE AIRPORT AND SHALL BE TRANSPORTED BY THE CONTRACTOR TO A LOCATION ON THE AIRPORT DESIGNATED BY THE AIRPORT MANAGEMENT AND DEPOSITED AT THE LOCATION FOR STORAGE. THE REMAINDER OF THE MEDIUM INTENSITY FIXTURES THAT ARE REMOVED SHALL BE DISPOSED OF BY THE CONTRACTOR OFF THE AIRPORT PROPERTY. THE DISPOSAL LOCATION SHALL BE ARRANGED AND/OR PROVIDED BY THE CONTRACTOR.
- 2. THE UNDERGROUND CABLE TO THE EXISTING EDGE LIGHTS SHALL BE ABANDONED WITH THE EXCEPTION THAT ALL EXISTING CABLE BEING REPLACED THAT IS IN THE SAME LOCATION IN TRENCH OR DUCT AS THE PROPOSED CABLE SHALL BE REMOVED FROM THE TRENCH OR DUCT INCLUDING THE EXISTING UNIT DUCT THAT CONTAINS THE CABLE. THE CABLE AND UNIT DUCT REMOVED SHALL BE DISPOSED OF OFF THE AIRPORT PROPERTY BY THE CONTRACTOR AND SAID REMOVAL AND DISPOSAL SHALL BE CONSIDERED INCIDENTAL
- 3. AT A MINIMUM, THE EXISTING CABLE AND UNIT DUCT BEING ABANDONED SHALL BE REMOVED TO A DISTANCE OF 3 FEET EACH SIDE OF A NEW LIGHTING FIXTURE LOCATION.
- 4. AT LOCATIONS WHERE A LIGHTING UNIT IS SHOWN TO BE REMOVED AND ALL OR A PORTION OF THE FIXTURE ABOVE GROUND IS MISSING, THE BASE OR STAKE AND TRANSFORMER SHALL BE DUG UP AND REMOVED. THIS REMOVAL SHALL CONSTITUTE AND

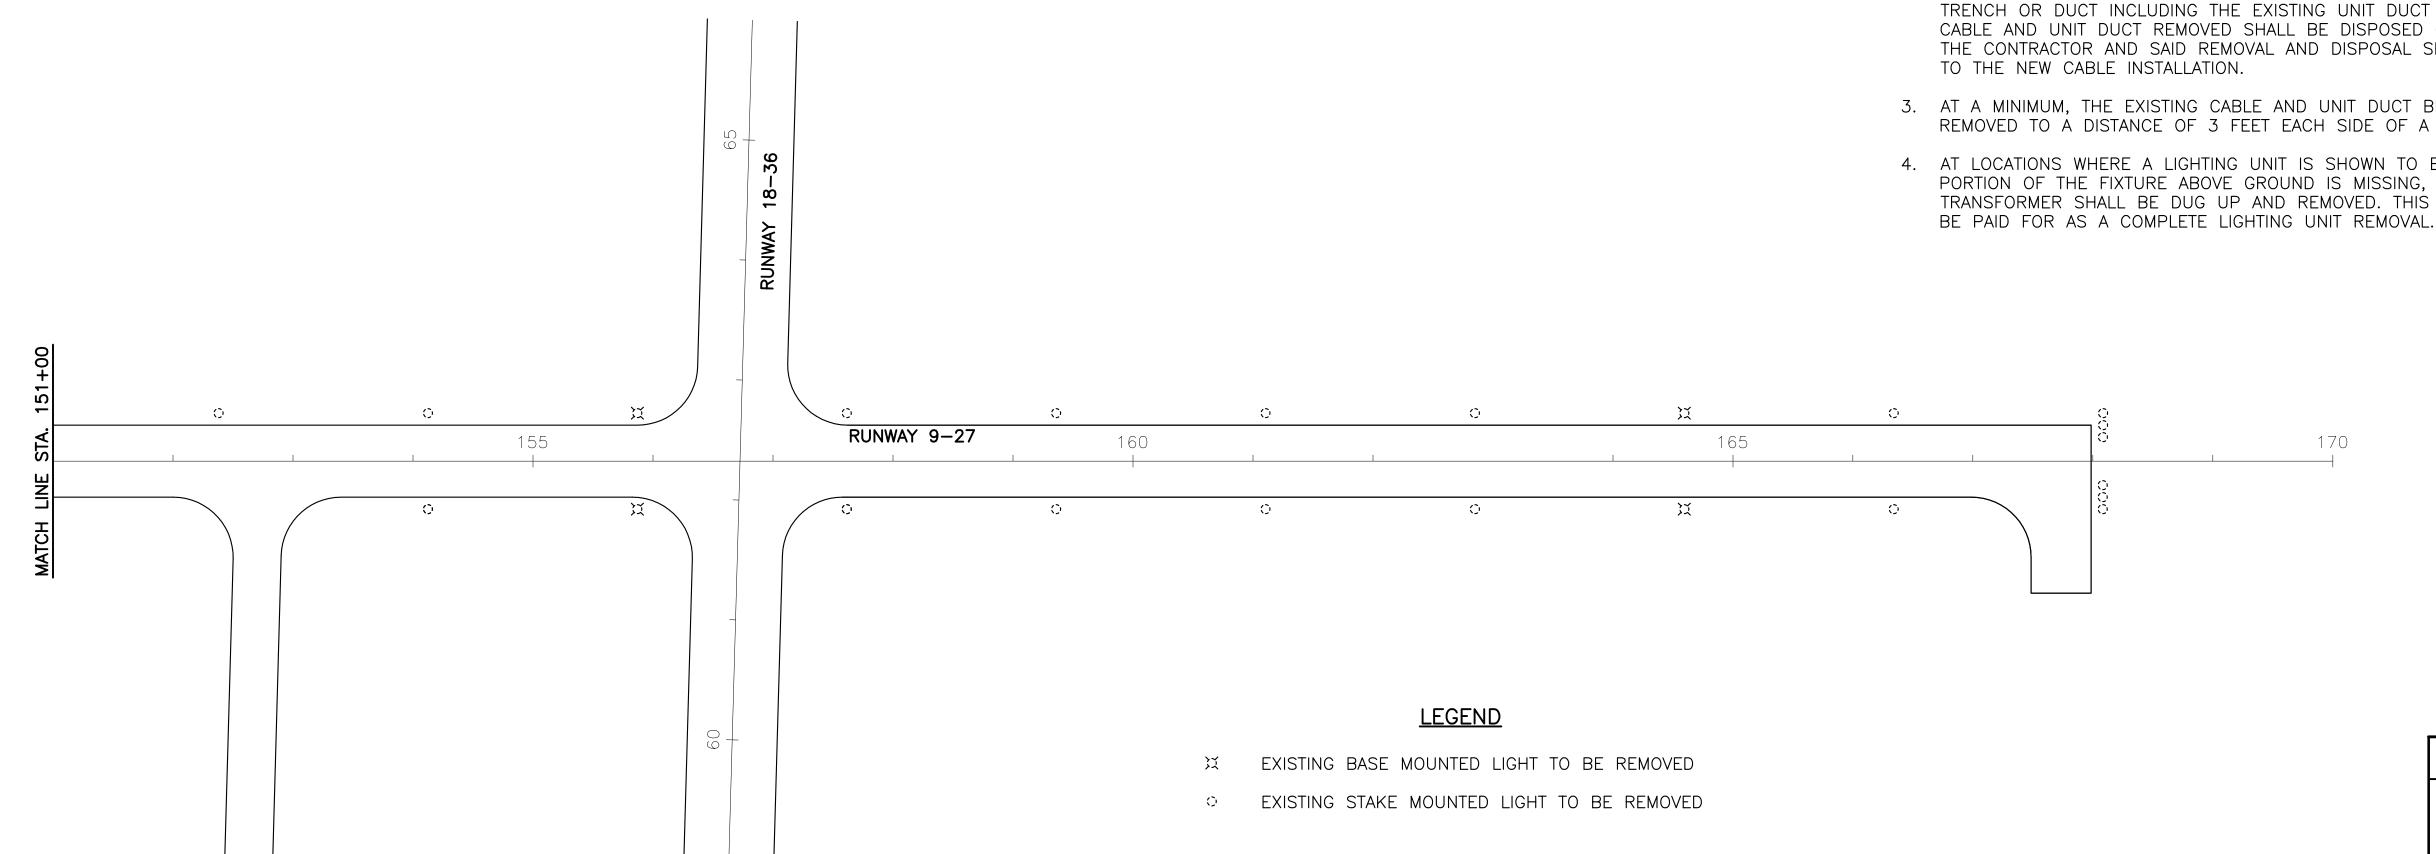


INGERSOLL AIRPORT CANTON, ILLINOIS

EDGE LIGHTING UNIT REMOVAL PLAN

HUTCHISON ENGINEERING, INC. JACKSONVILLE, ILLINOIS

DRAWN BY: R.L.R.

ILL. PROJ. NO. CTK-4350 DATE : FEBRUARY, 2015 SBG PROJ. NO. 3-17-SBGP-76

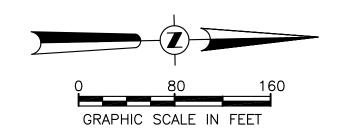


LEGEND


- X EXISTING BASE MOUNTED LIGHT TO BE REMOVED
- EXISTING STAKE MOUNTED LIGHT TO BE REMOVED
- □ EXISTING TAXI GUIDANCE SIGN TO BE REMOVED
- ▷ EXISTING REILS PAIR TO BE REMOVED

\3615Y004 1"=80'

NOTES:

- 1. ALL EXISTING GUIDANCE SIGNS INCLUDING TRANSFORMERS AND STEEL BASES WITH CONCRETE BACKFILL THAT ARE REMOVED SHALL BE DISPOSED OF BY THE CONTRACTOR OFF THE AIRPORT PROPERTY. THE CONTRACTOR SHALL SALVAGE 8 OF THE EXISTING MEDIUM INTENSITY BASE MOUNTED LIGHT FIXTURES AND 24 OF THE EXISTING MEDIUM INTENSITY STAKE MOUNTED FIXTURES INCLUDING TRANSFORMERS FOR USE BY THE AIRPORT AS MAINTENANCE REPAIR PARTS. THE SALVAGED UNITS SHALL BECOME THE PROPERTY OF THE AIRPORT AND SHALL BE TRANSPORTED BY THE CONTRACTOR TO A LOCATION ON THE AIRPORT DESIGNATED BY THE AIRPORT MANAGEMENT AND DEPOSITED AT THE LOCATION FOR STORAGE. THE REMAINDER OF THE MEDIUM INTENSITY FIXTURES THAT ARE REMOVED SHALL BE DISPOSED OF BY THE CONTRACTOR OFF THE AIRPORT PROPERTY. THE DISPOSAL LOCATION SHALL BE ARRANGED AND/OR PROVIDED BY THE CONTRACTOR.
- 2. THE UNDERGROUND CABLE TO THE EXISTING EDGE LIGHTS SHALL BE ABANDONED WITH THE EXCEPTION THAT ALL EXISTING CABLE BEING REPLACED THAT IS IN THE SAME LOCATION IN TRENCH OR DUCT AS THE PROPOSED CABLE SHALL BE REMOVED FROM THE TRENCH OR DUCT INCLUDING THE EXISTING UNIT DUCT THAT CONTAINS THE CABLE. THE CABLE AND UNIT DUCT REMOVED SHALL BE DISPOSED OF OFF THE AIRPORT PROPERTY BY THE CONTRACTOR AND SAID REMOVAL AND DISPOSAL SHALL BE CONSIDERED INCIDENTAL TO THE NEW CABLE INSTALLATION.
- 3. AT A MINIMUM, THE EXISTING CABLE AND UNIT DUCT BEING ABANDONED SHALL BE REMOVED TO A DISTANCE OF 3 FEET EACH SIDE OF A NEW LIGHTING FIXTURE LOCATION.
- 4. AT LOCATIONS WHERE A LIGHTING UNIT IS SHOWN TO BE REMOVED AND ALL OR A PORTION OF THE FIXTURE ABOVE GROUND IS MISSING, THE BASE OR STAKE AND TRANSFORMER SHALL BE DUG UP AND REMOVED. THIS REMOVAL SHALL CONSTITUTE AND BE PAID FOR AS A COMPLETE LIGHTING UNIT REMOVAL.

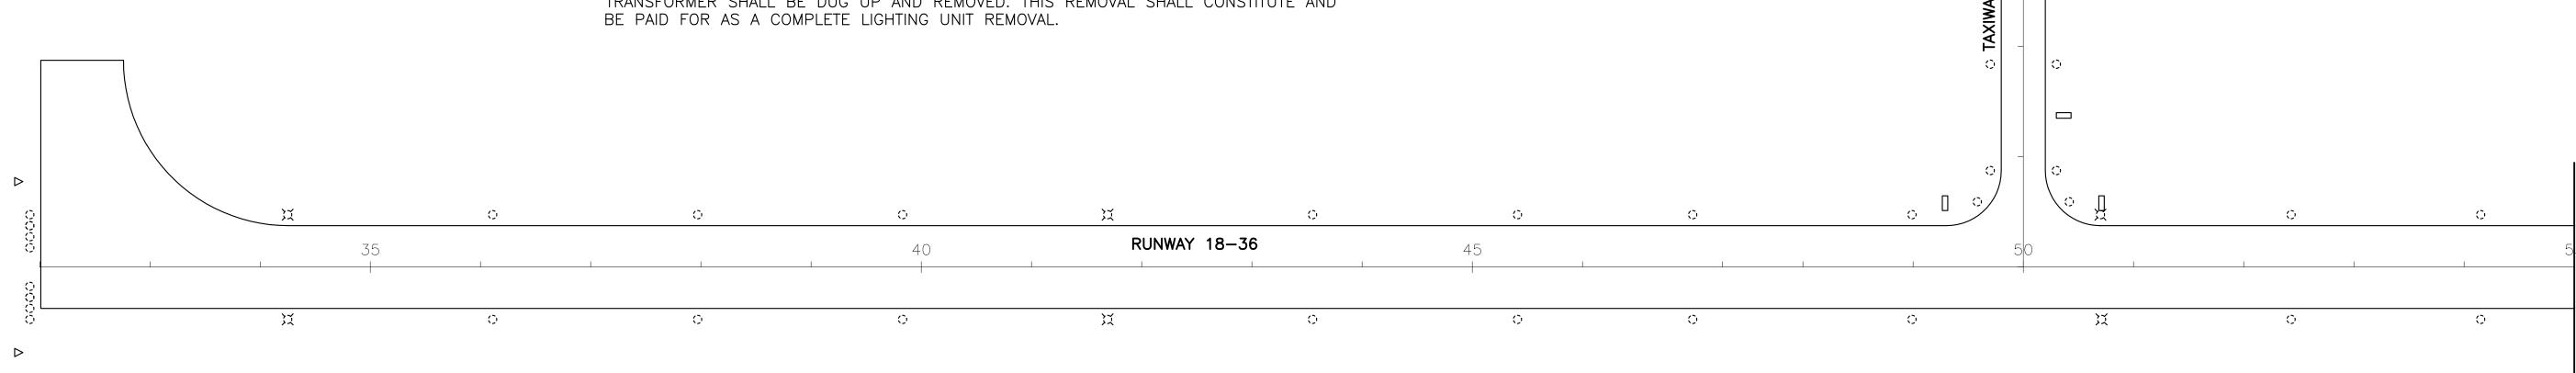

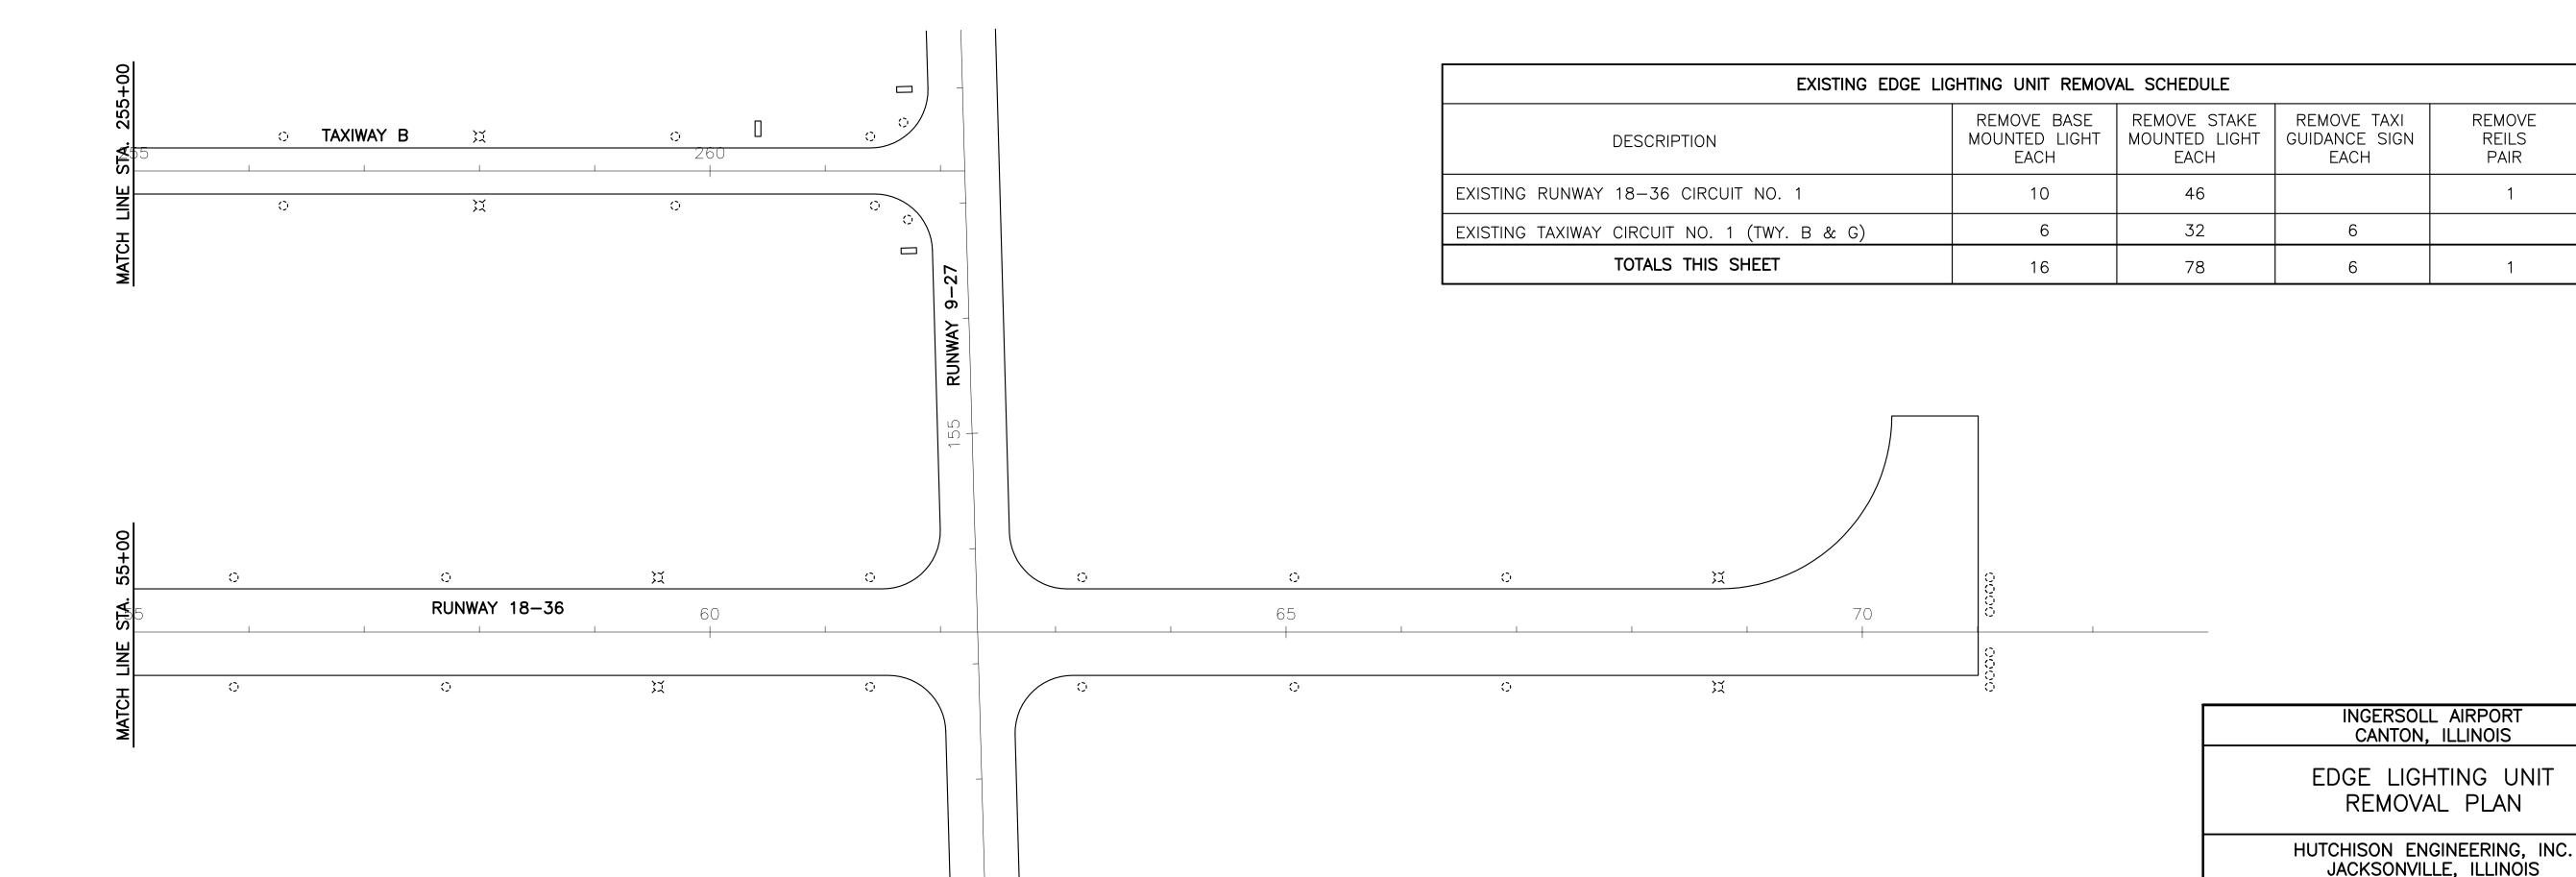

ILL. PROJ. NO. CTK-4350 SBG PROJ. NO. 3-17-SBGP-76


DRAWN BY: R.L.R.


DATE : FEBRUARY, 2015


CN025

 \circ

TAXIWAY B

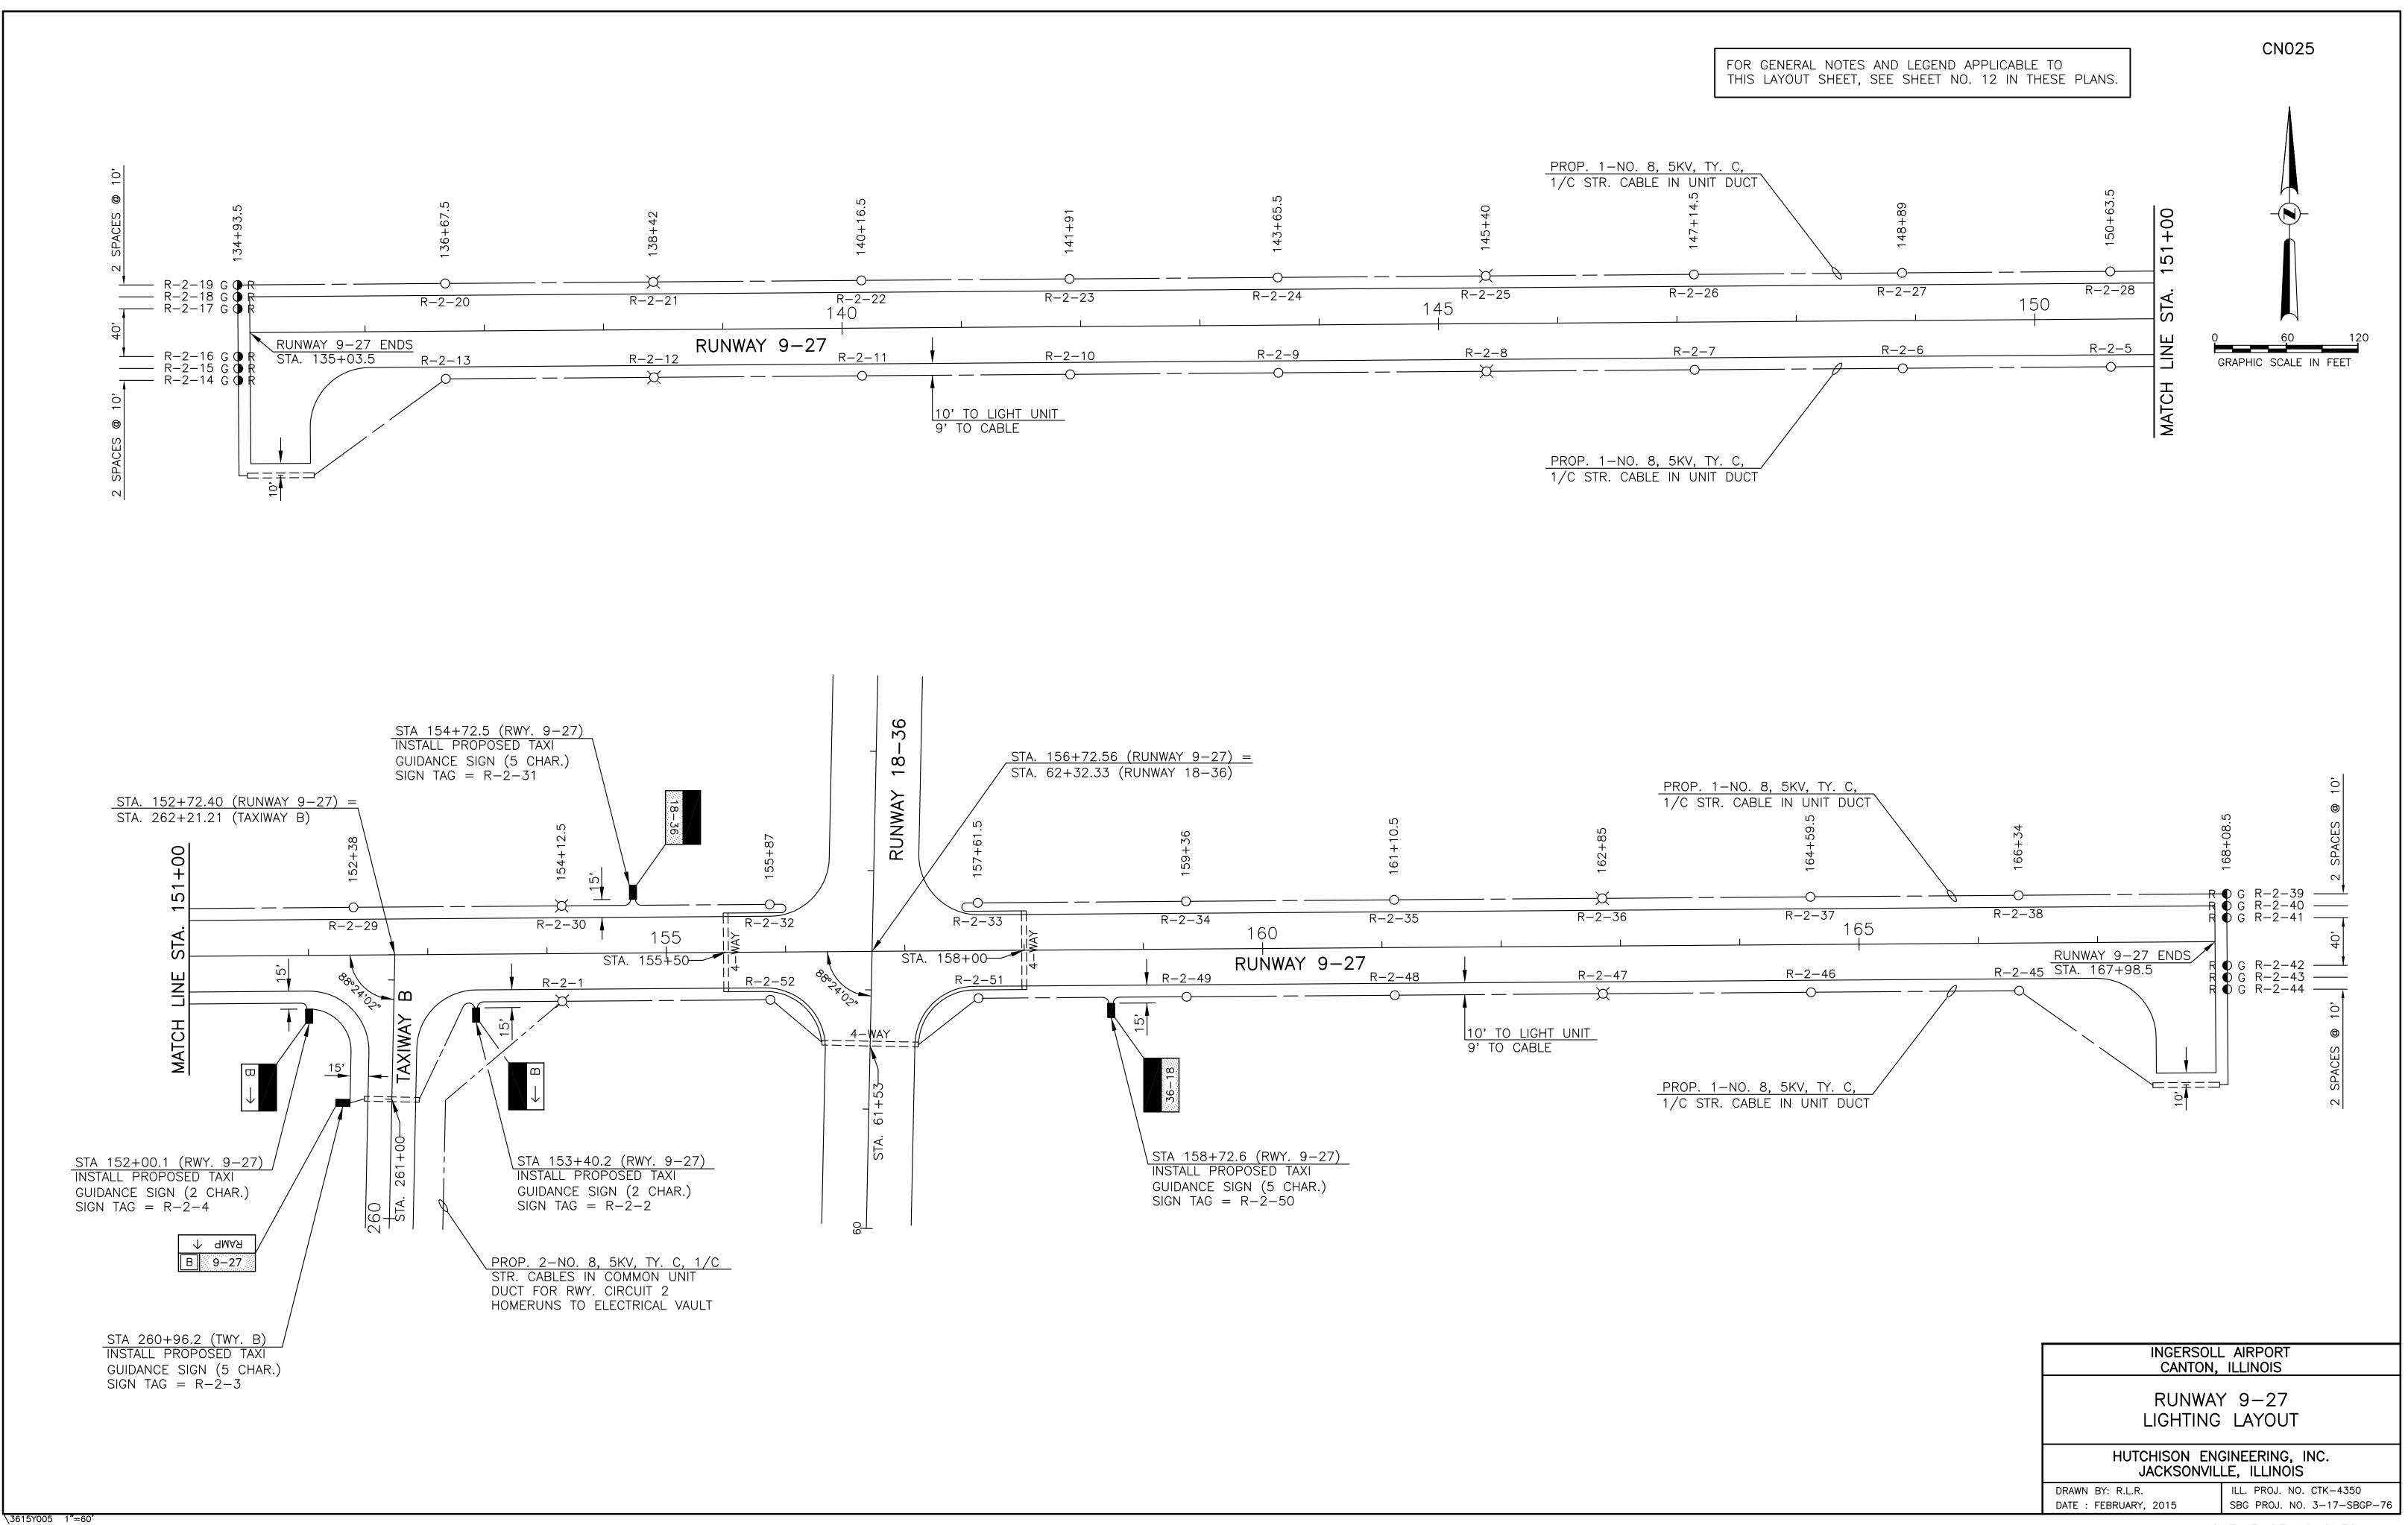

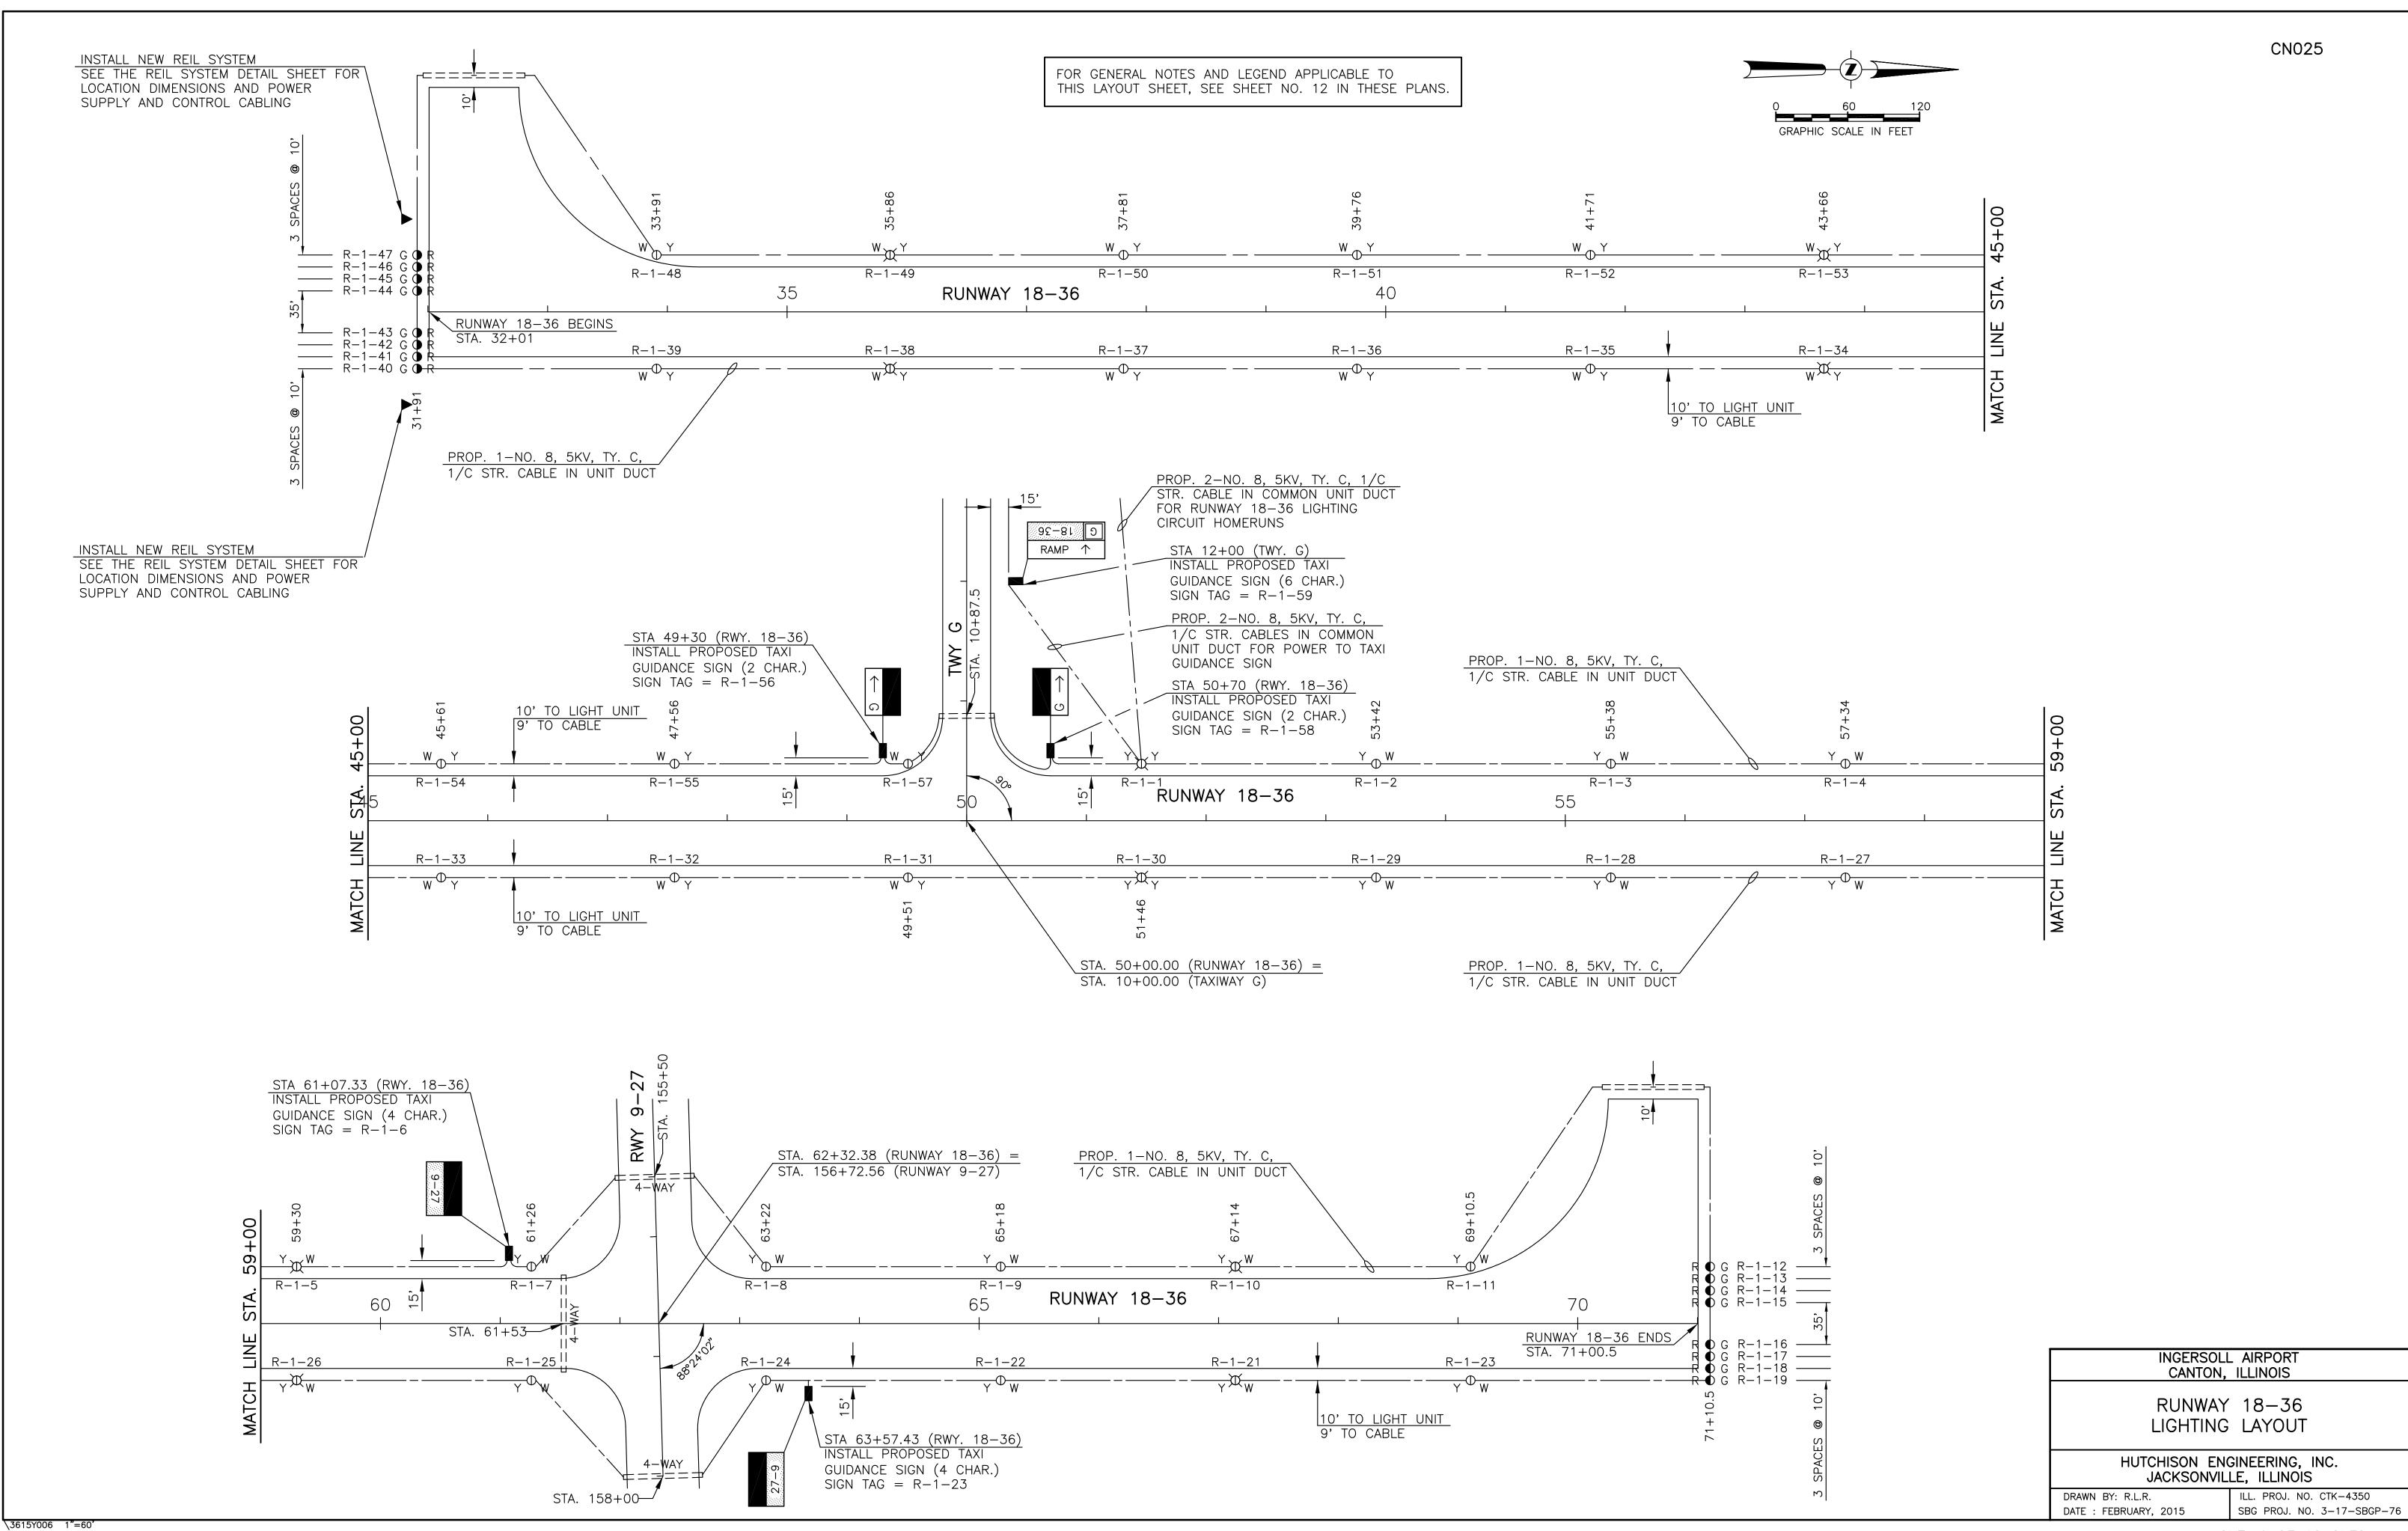

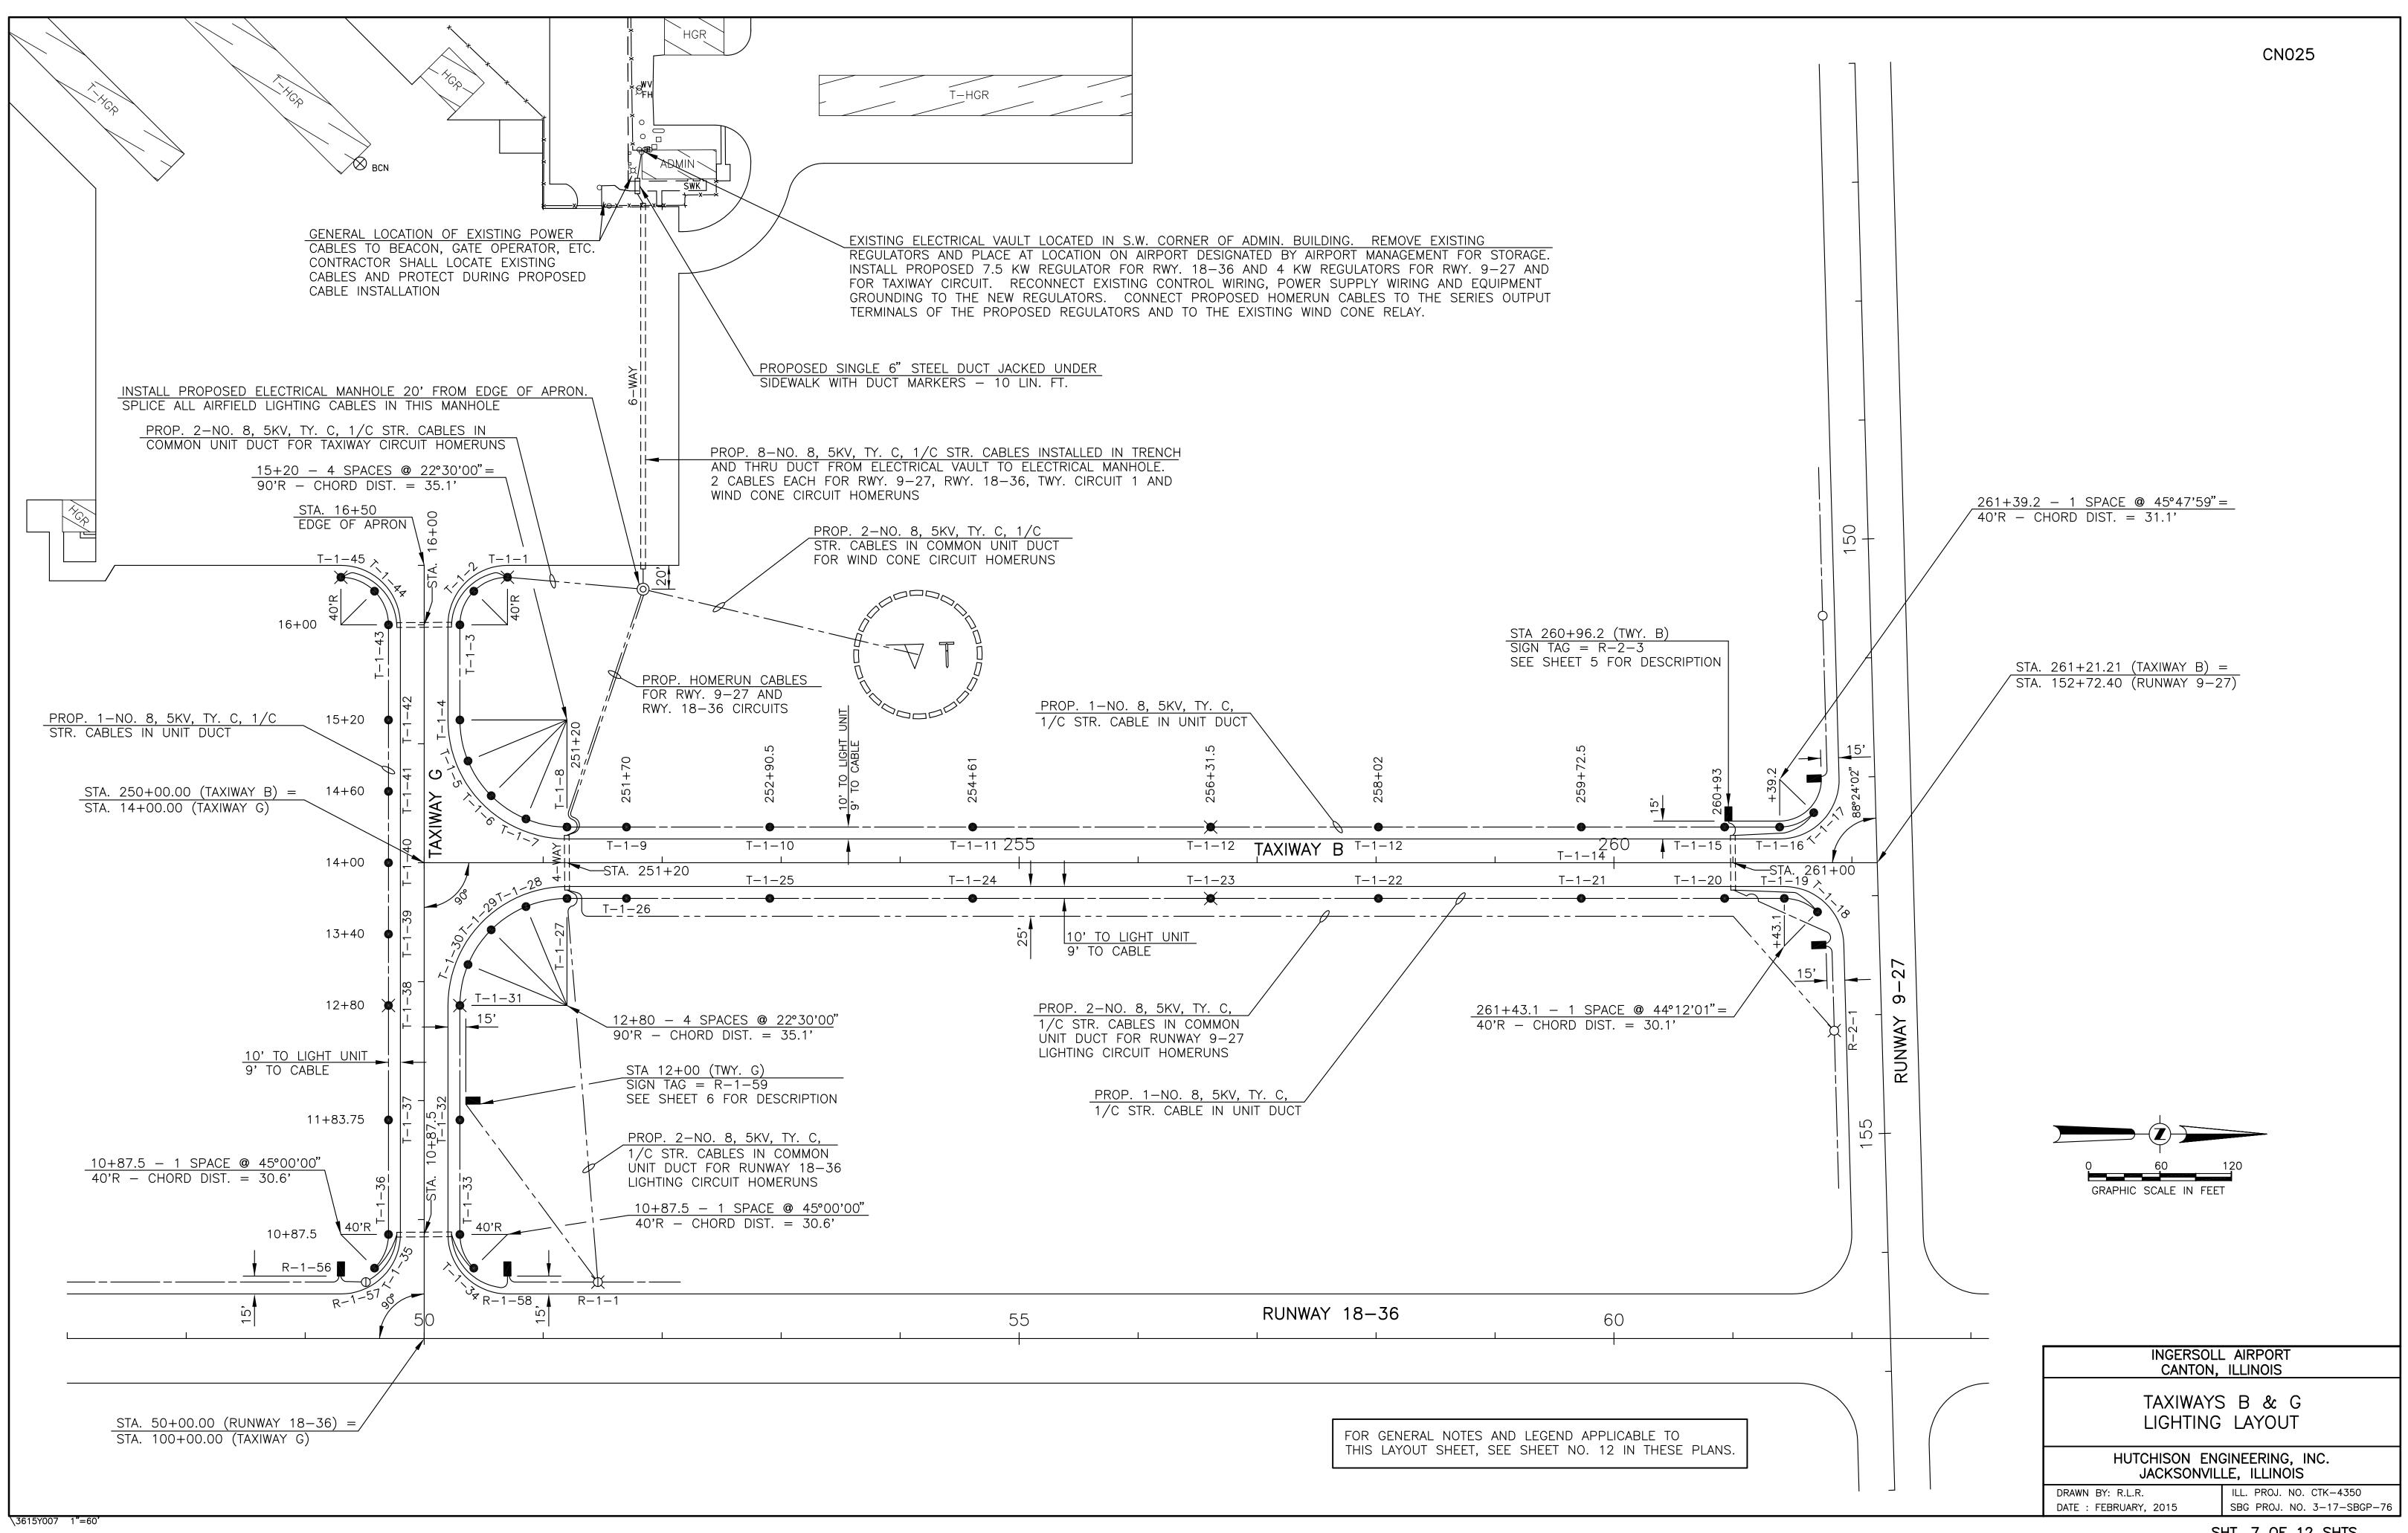

- FINISHED GROUND LINE

— TYPE L-849I, STYLE A REIL UNIT

SEE NOTE 4.

- #6 BARE COPPER GROUND WIRE


CONTROL CABLE INSTALLED

BETWEEN REIL UNITS

- BREAKABLE COUPLING

INTERNAL GROUND LUG

#6 AWG COPPER WIRE WITH GREEN XHHW INSULATION FROM UNIT BASE PLATE TO

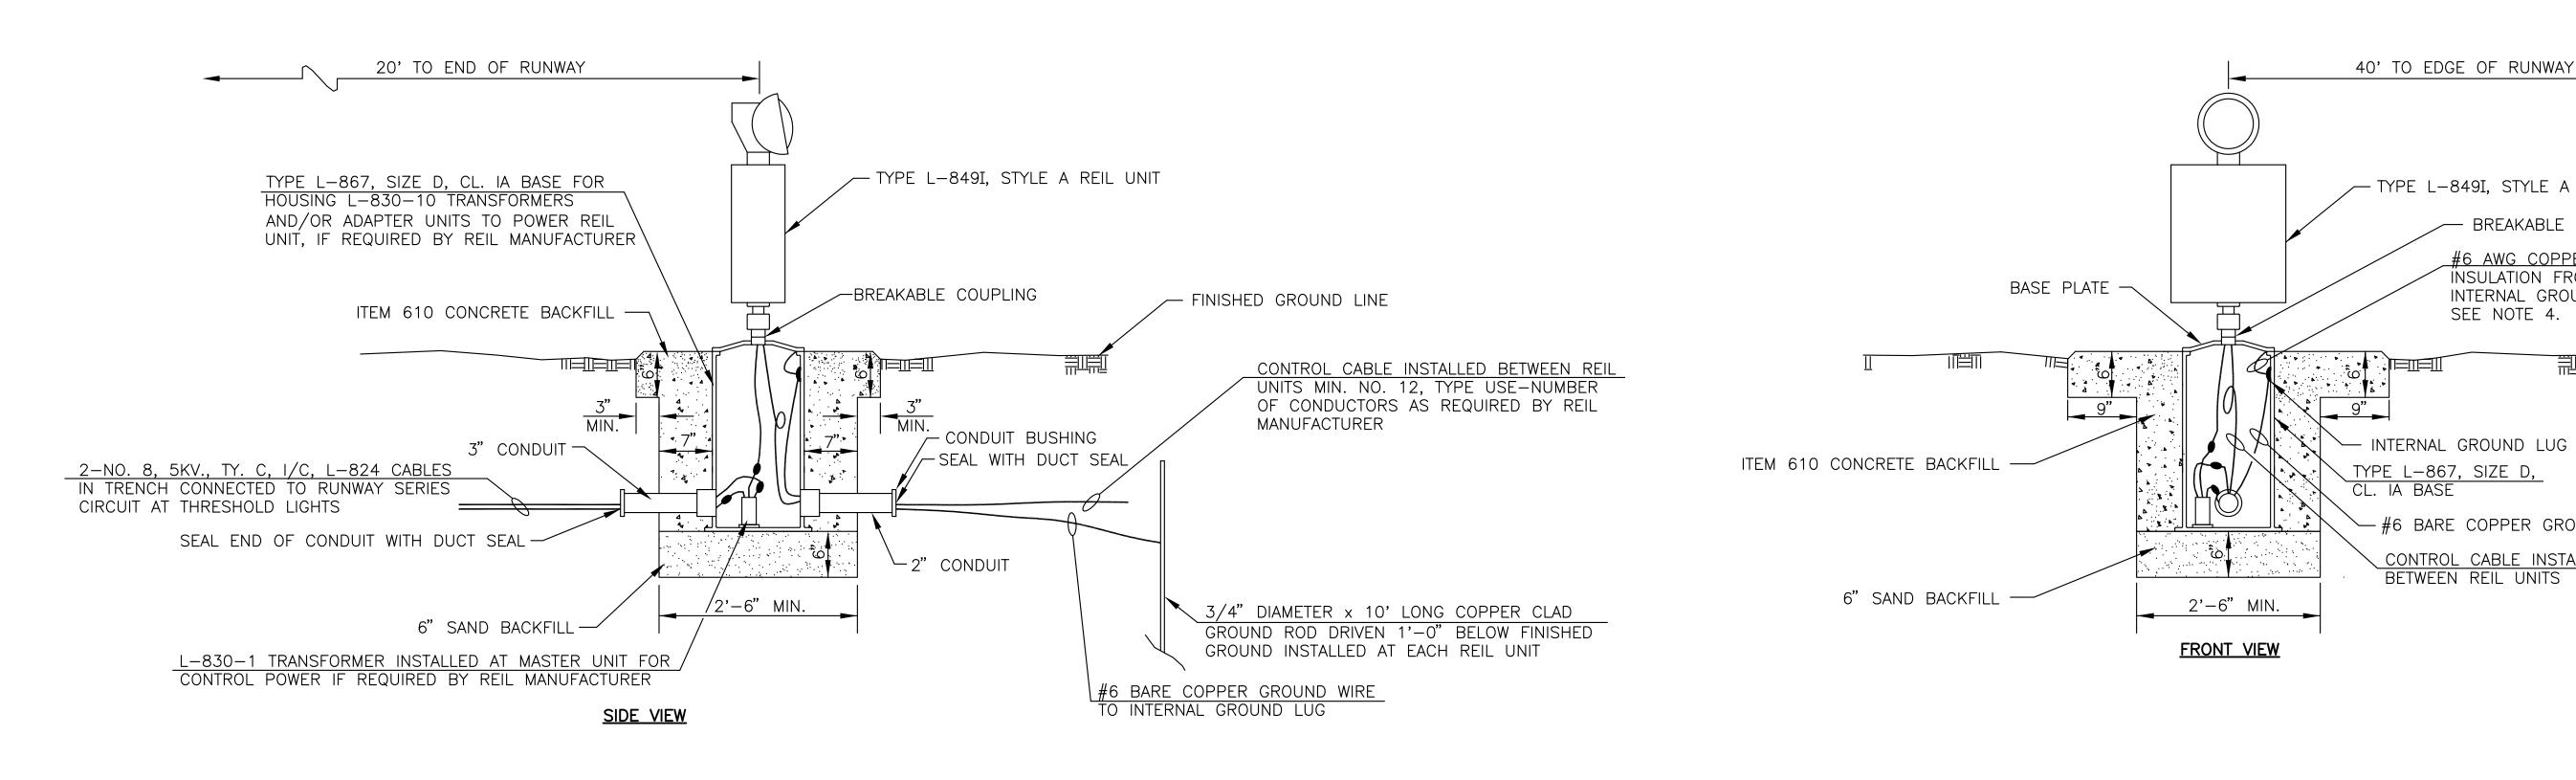


GENERAL NOTE:

MASTER UNIT AND SLAVE UNIT ARE INSTALLED ON IDENTICAL FOUNDATIONS WITH AN L-830-10 TRANSFORMER AND/OR ADAPTER UNIT ALSO INSTALLED IN EACH SIZE D STEEL BASE, IF REQUIRED BY REIL MANUFACTURER.

SYSTEM NOTES:

- 1. THE REIL SYSTEM SHALL BE INSTALLED IN ACCORDANCE WITH THE ABOVE DETAIL AND INSTRUCTIONS PROVIDED BY THE EQUIPMENT MANUFACTURER AND SHALL COMPLY WITH TYPICAL REIL LAYOUT GUIDELINES IN ADVISORY CIRCULAR 150/5340-30H.
- 2. THE BEAM CENTERLINE OF EACH LIGHT UNIT SHALL BE AIMED 15° OUTWARD FROM A LINE PARALLEL TO THE RUNWAY CENTERLINE AND INCLINED AT AN ANGLE 10° ABOVE THE HORIZONTAL.
- 3. A MINIMUM 12" WIDTH OF CONCRETE SHALL EXTEND BEYOND THE OUTER LIMITS OF ALL COMPONENTS OF THE REIL UNIT.
- 4. THE GROUND WIRE LENGTH FROM THE REIL UNIT BASE PLATE TO THE INTERNAL GROUND LUG SHALL BE SUFFICIENT TO ALLOW THE REMOVAL OF THE REIL UNIT FROM THE STEEL BASE FOR ROUTINE MAINTENANCE.

TYPICAL REIL UNIT INSTALLATION

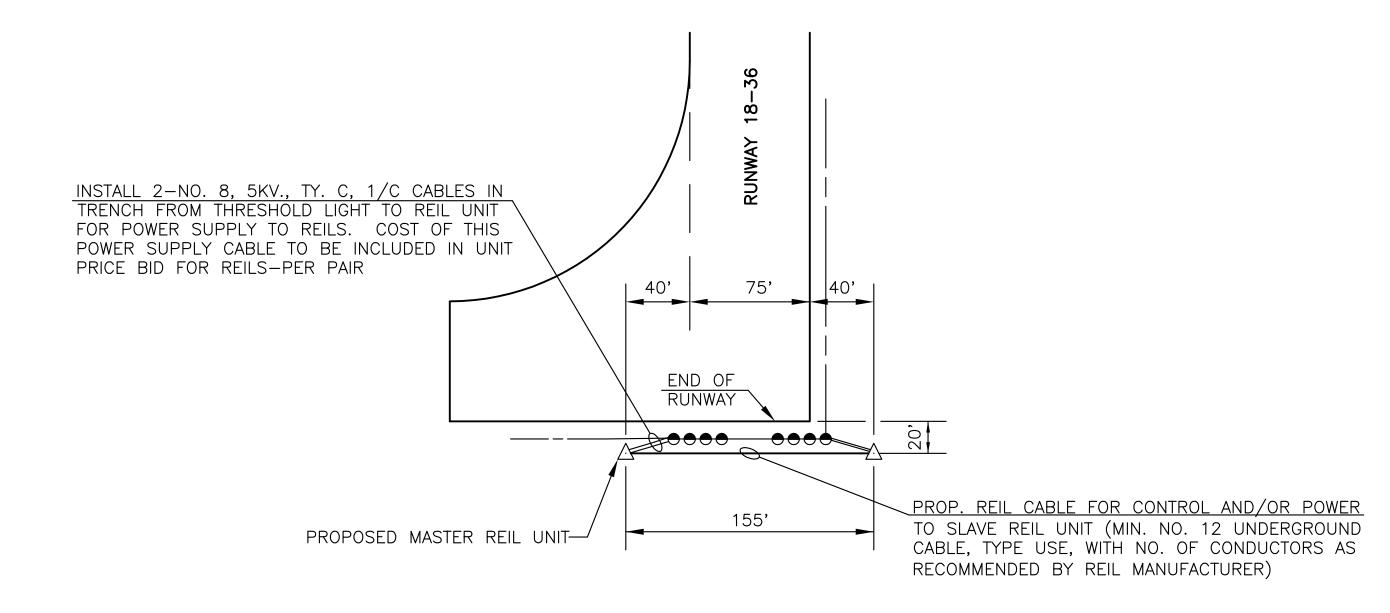

TYPICAL PLAN LAYOUT FOR REIL INSTALLATION

INSTALLATION NOTES:

- 1. RUNWAY CIRCUIT CABLES ARE LOCATED BETWEEN THE EDGE LIGHTS AND THRESHOLD LIGHTS THAT ARE 10' FROM THE EDGE OF THE PAVEMENT END AND EDGE. IT WILL BE THE CONTRACTOR'S RESPONSIBILITY TO LOCATE AND PROTECT THE EDGE LIGHTING CIRCUIT CABLES IN THE WORK AREAS FOR REIL SYSTEM INSTALLATION, CAUTION SHALL BE EXERCISED WHEN TRENCHING, ETC. TO AVOID CUTTING THE LIGHTING CIRCUIT CABLES. ANY CABLE DAMAGED SHALL BE REPAIRED BY THE CONTRACTOR AT HIS OWN EXPENSE.
- 2. IT WILL BE THE CONTRACTOR'S RESPONSIBILITY TO LOCK OUT THE EDGE LIGHTING CIRCUIT WHILE PERFORMING WORK ON OR NEAR SAID CIRCUIT. THE CIRCUIT SHALL BE LOCKED OUT TO INCLUDE AND INSURE THAT THE CIRCUIT CANNOT BE ENERGIZED MANUALLY OR BY THE RADIO CONTROL SYSTEM WHILE WORK IS BEING DONE.
- 3. RUNWAY 18-36 SHALL BE CLOSED TO AIR TRAFFIC WHEN THE TRENCHING, CABLE INSTALLATION AND CONCRETE BACKFILL FOR THE REIL UNITS ARE BEING PERFORMED.
- 4. ALL UNDERGROUND CABLE AND ITS INSTALLATION FOR POWER AND CONTROL TO THE REIL UNITS SHALL BE INCLUDED IN THE UNIT PRICE BID FOR REILS—PER PAIR.

GENERAL NOTE

THE DETAILS SHOWN FOR THE REIL UNIT BASES AND REIL POWER SUPPLY AND CONTROL WIRING ARE INTENDED FOR ILLUSTRATIVE INFORMATION PURPOSES. ACTUAL BASE DETAILS AND WIRING CONNECTIONS SHALL BE IN ACCORDANCE WITH THE REQUIREMENTS OF THE MANUFACTURER OF THE EQUIPMENT BEING FURNISHED. THE CONTRACTOR SHALL SUBMIT DETAILED SHOP DRAWINGS OF THE REIL INSTALLATION TO THE PROJECT ENGINEER FOR ACCEPTANCE PRIOR TO COMMENCEMENT OF CONSTRUCTION.


INGERSOLL AIRPORT CANTON, ILLINOIS

REIL SYSTEM DETAILS

HUTCHISON ENGINEERING, INC. JACKSONVILLE, ILLINOIS


DRAWN BY: R.L.R.

ILL. PROJ. NO. CTK-4350 SBG PROJ. NO. 3-17-SBGP-76 DATE: FEBRUARY, 2015

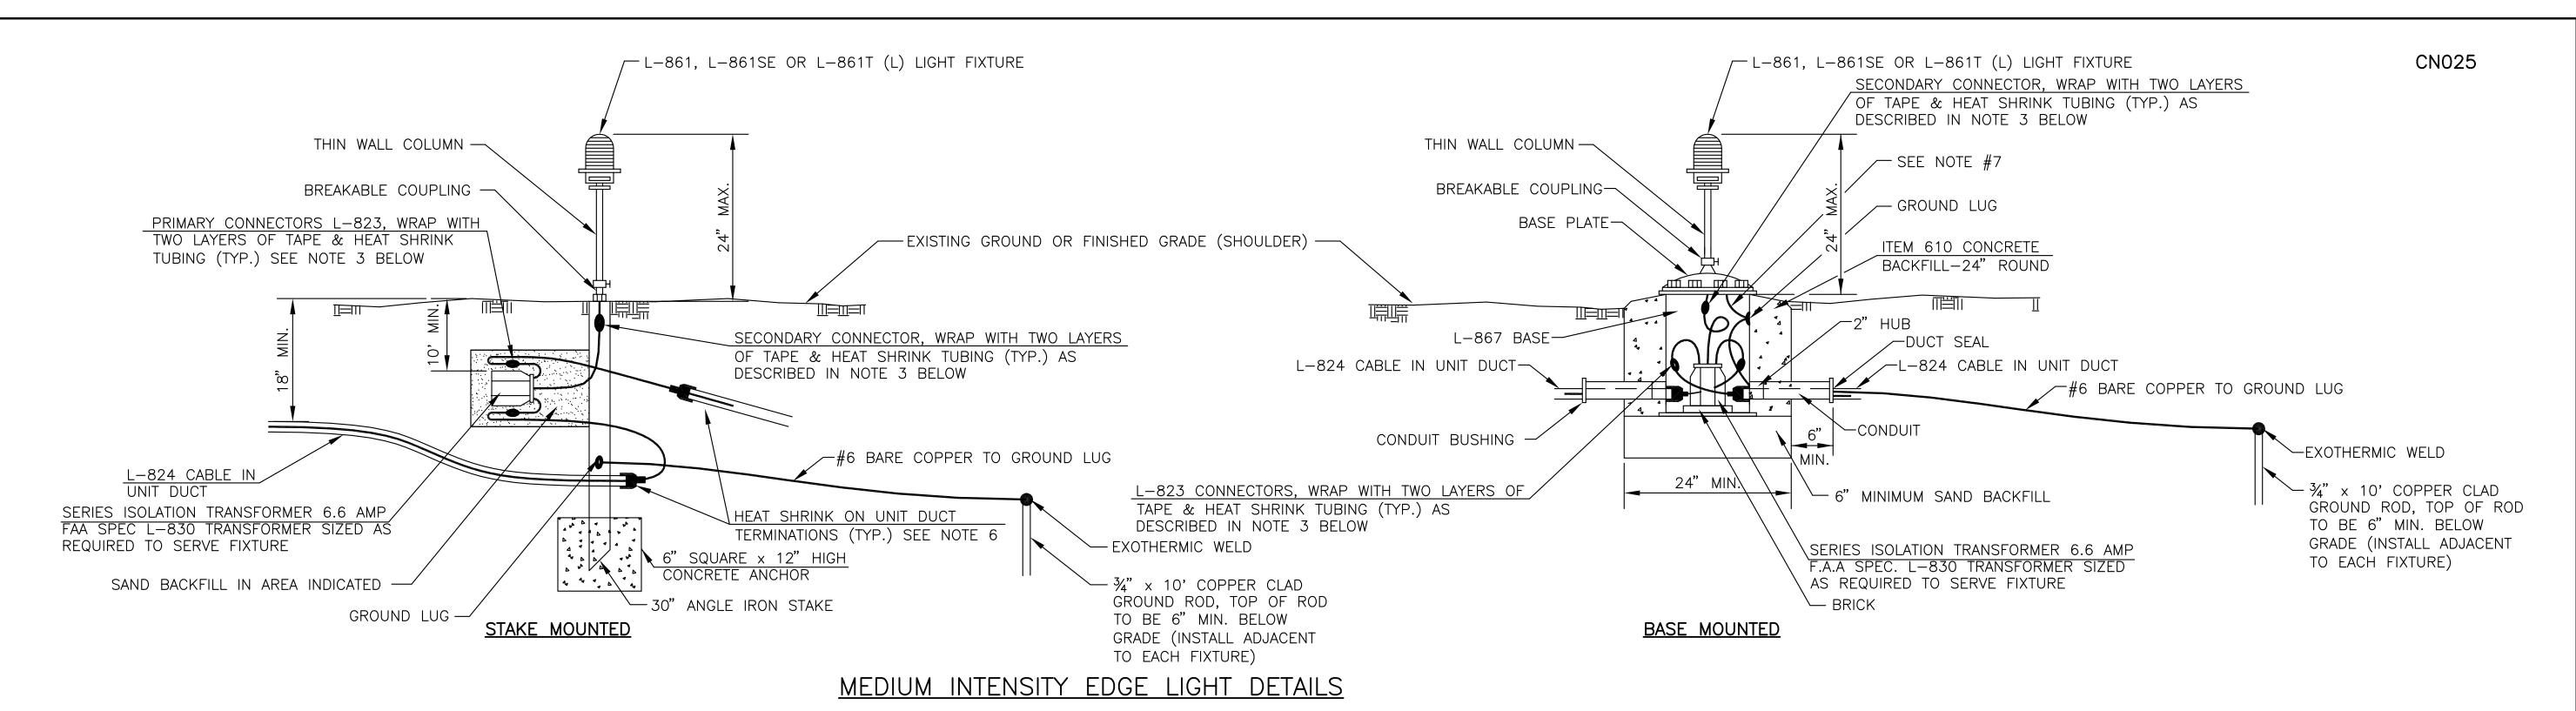

EDGE LIGHT NOTES:

- BREAKING GROOVE OF BREAKABLE COUPLINGS SHALL NOT BE OVER 3 1/2" ABOVE GROUND LINE.
- THE CONCRETE BACKFILL FOR BASE MOUNTED LIGHTS SHALL BE TROWEL FINISHED WITH A 45° BEVELED EDGE WITH THE SURFACE SLOPING TO DRAIN. THE BASE CONCRETE BACKFILL MAY BE PRECAST AT THE CONTRACTOR'S OPTION.
- THE PRIMARY CABLE CONNECTOR JOINTS SHALL BE WRAPPED WITH ONE LAYER OF RUBBER TAPE (SCOTCH NO. 130C) AND ONE LAYER OF PLASTIC TAPE (SCOTCH NO. 88), ONE-HALF LAPPED, EXTENDING 1 1/2" EACH SIDE OF JOINT AND COVERED WITH HEAT SHRINK TUBING.
- 4. A MINIMUM OF THREE FOOT OF CABLE SLACK SHALL BE LEFT AT EACH STAKE MOUNTED LIGHT AND A MINIMUM OF THREE FEET OF CABLE SLACK AT EACH BASE MOUNTED LIGHT, HANDHOLE, OR MANHOLE. THIS REQUIRED SLACK WILL BE LEFT ON THE CABLE SIDE OF ALL PRIMARY CONNECTORS AND SPLICES. THIS REQUIRED SLACK WILL BE CONSIDERED INCIDENTAL TO THE CONTRACT.
- 5. ALL MOUNTING BOLTS SHALL BE COATED WITH AN ANTI-SEIZING LUBRICANT.
- 6. CONTRACTOR SHALL INSTALL HEAT SHRINK TUBING AT ALL TERMINATIONS OF UNIT DUCT (TYPICAL).
- 7. THE LIGHT FIXTURE SHALL BE BONDED TO THE LIGHT BASE INTERNAL GROUND LUG VIA A #6 AWG STRANDED COPPER WIRE RATED FOR 600 VOLTS WITH GREEN XHHW INSULATION. THE GROUND WIRE LENGTH SHALL BE SUFFICIENT TO ALLOW THE REMOVAL OF THE LIGHT FIXTURE FROM THE LIGHT BASE FOR ROUTINE MAINTENANCE. SEE THE LIGHT FIXTURE MANUFACTURER'S INSTRUCTIONS FOR PROPER METHODS OF ATTACHING THIS BONDING WIRE.

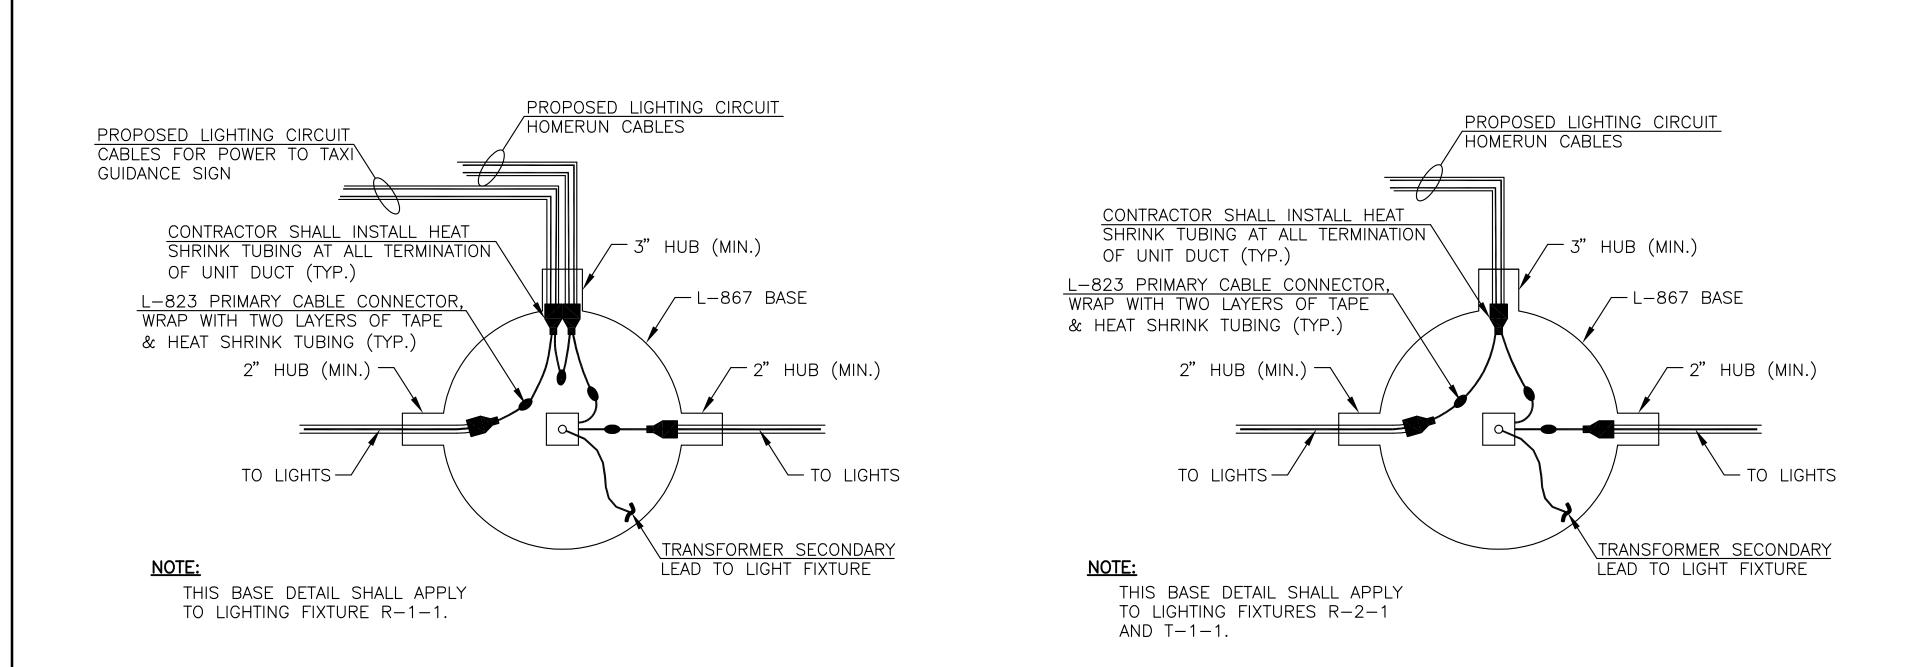

PROPOSED CIRCUIT CONNECTION DETAILS

BASE MOUNTED LIGHT

3/16" DIAMETER — -3/8" LETTERING (MINIMUM) CIRCUIT DESIGNATION —UNIT NUMBER

NOTES

- 1. INSTALL A NONCORROSIVE DISC OF 2 INCH MINIMUM DIAMETER WITH NUMBER PERMANENTLY STAMPED, CUT OUT OR ENGRAVED AT EACH LIGHTING UNIT.
- 2. NONCORROSIVE DISC MAY BE ATTACHED TO LIGHT FLANGE WITH SCREW OR UNDER THE HEAD OF THE BASE PLATE BOLT.
- 3. THE CONTRACTOR SHALL NUMBER THE PROPOSED LIGHTS AND SIGNS IN EACH CIRCUIT STARTING AT THE HOMERUN CONTINUING AROUND THE ENTIRE CIRCUIT BACK TO THE HOMERUN.
- 4. AIRFIELD SIGNS SHALL BE TAGGED AND NUMBERED.

IDENTIFICATION TAG DETAIL

INGERSOLL AIRPORT CANTON, ILLINOIS TYPICAL LIGHTING **DETAILS** HUTCHISON ENGINEERING, INC. JACKSONVILLE, ILLINOIS


DRAWN BY: R.L.R.


DATE: FEBRUARY, 2015

ILL. PROJ. NO. CTK-4350

SBG PROJ. NO. 3-17-SBGP-76

SHT. 9 OF 12 SHTS.

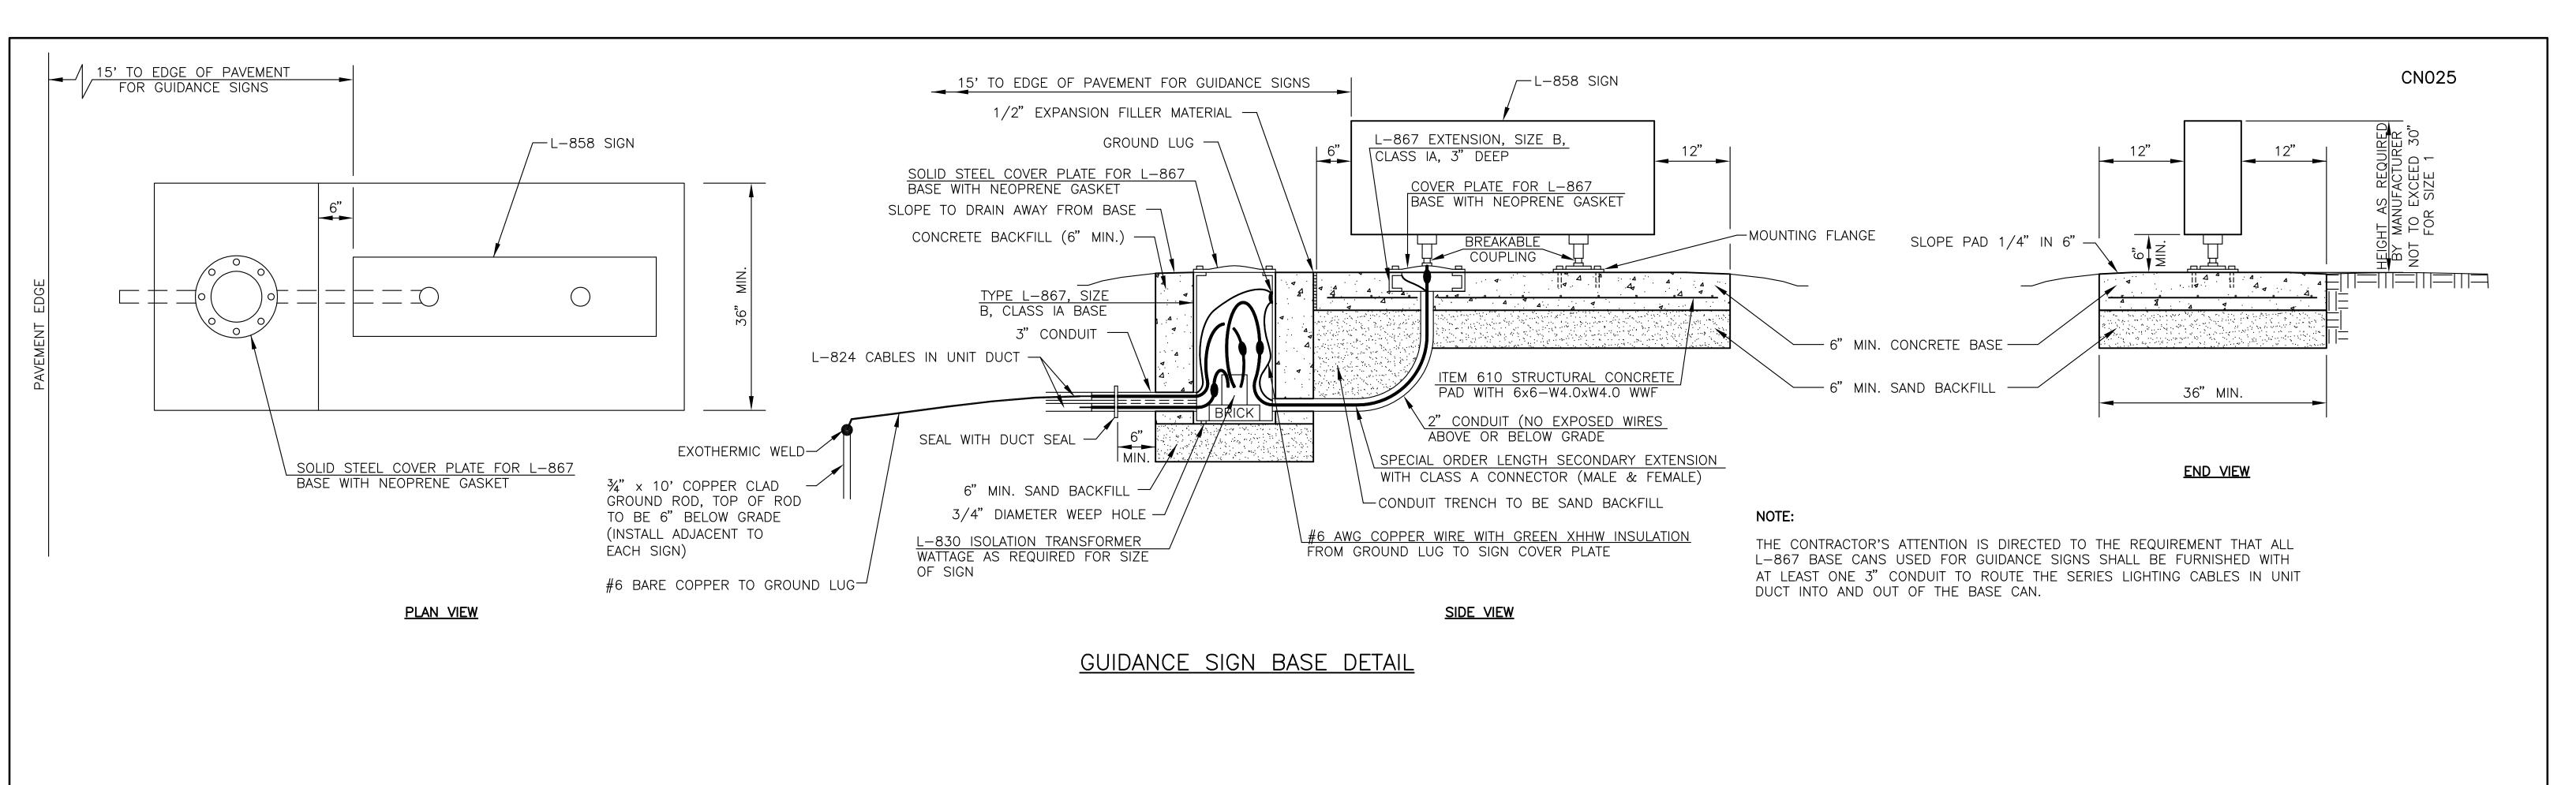

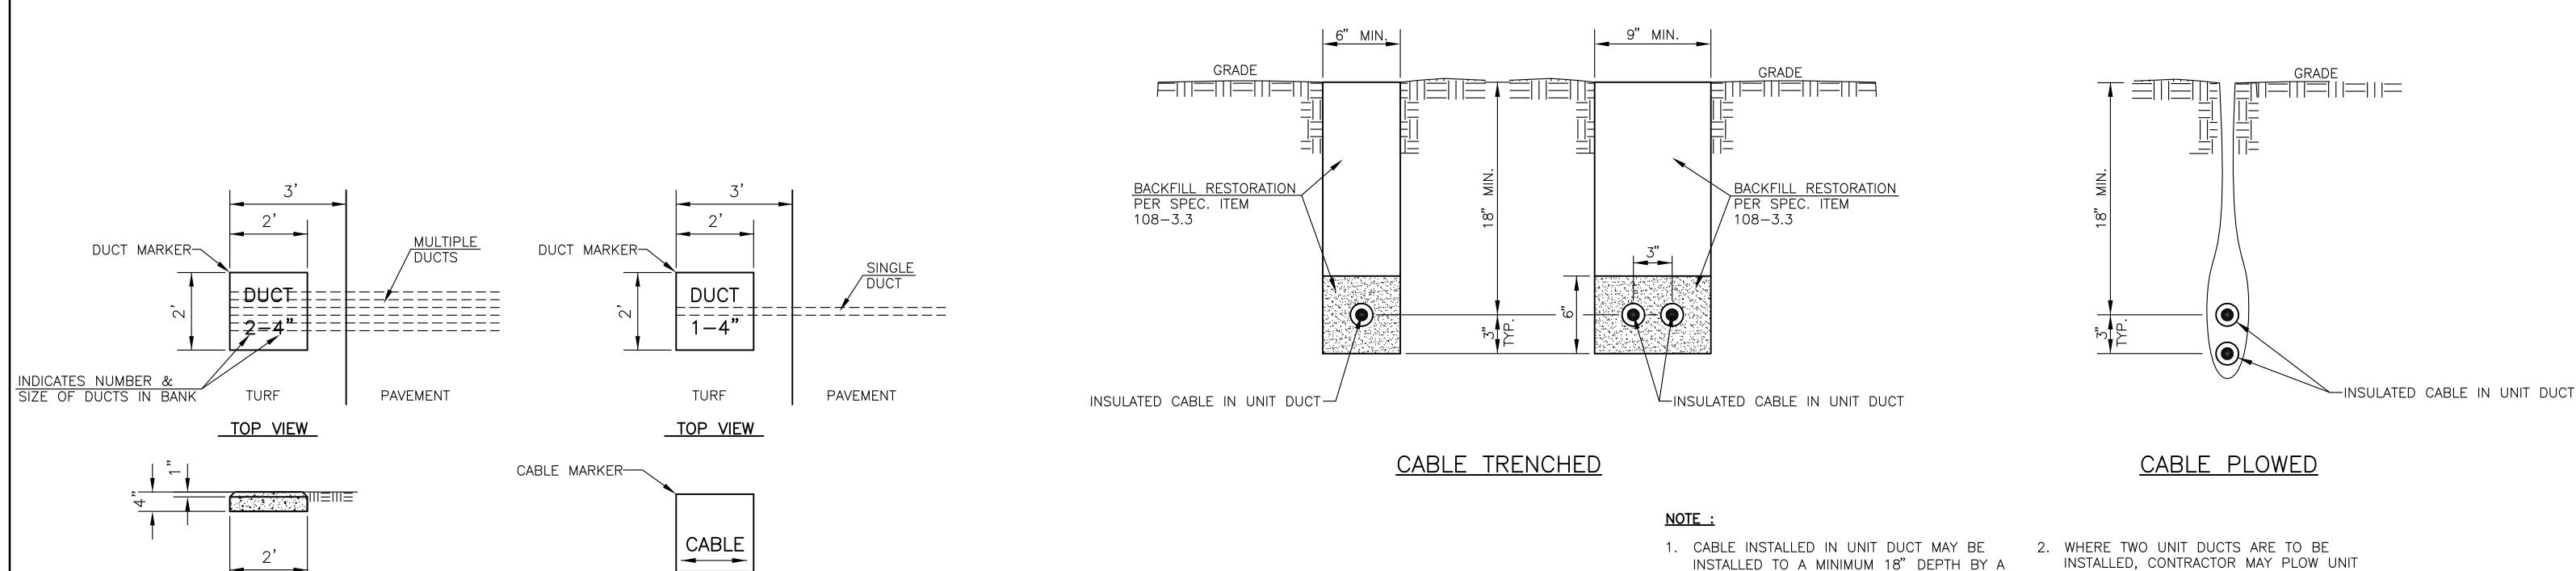

1. LETTERS 4" HIGH, 3" WIDE WITH WIDTH OF STROKE 1/2" AND 1/4" DEEP. ALL LETTERS, NUMBERS AND ARROWS TO BE IMPRESSED. SCRATCHED FIGURES WILL NOT BE ACCEPTABLE.

TOP VIEW

TYPICAL CABLE AND DUCT MARKER

<u>DETAILS</u>

END VIEW

<u>NOTES</u>

TRENCH DETAILS

VIBRATING PLOW IN ACCORDANCE WITH THE

STANDARD SPECIFICATIONS.

INGERSOLL AIRPORT
CANTON, ILLINOIS

TYPICAL LIGHTING
DETAILS

HUTCHISON ENGINEERING, INC.
JACKSONVILLE, ILLINOIS


DRAWN BY: R.L.R. ILL. PROJ. NO. CTK-4350

DATE: FEBRUARY, 2015

DUCTS SEPARATELY (SIDE BY SIDE).

SHT. 10 OF 12 SHTS.

SBG PROJ. NO. 3-17-SBGP-76

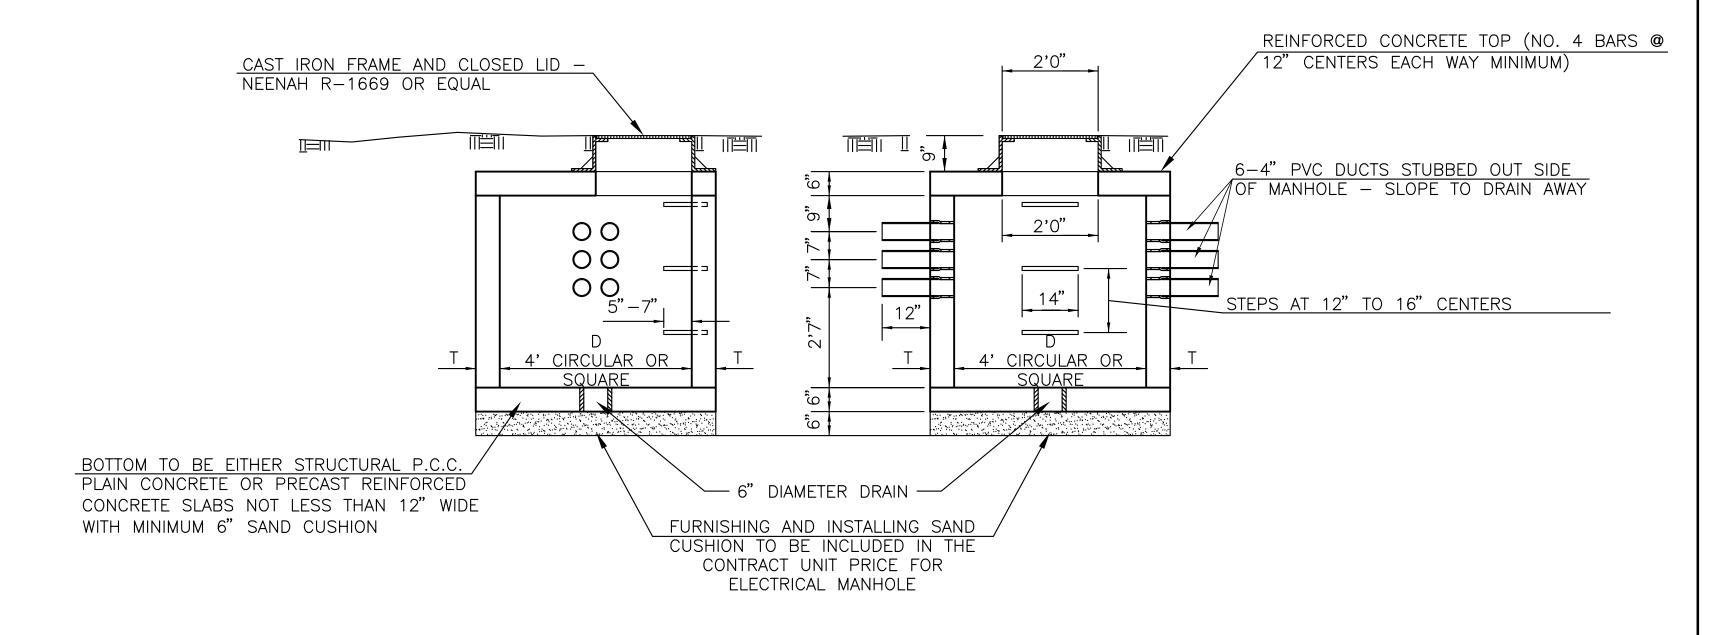


NOTES:

ALTERNATE MATERIAL FOR WALLS	D	Т
CONCRETE BUILDING BRICK GRADE "A"	4'	8"
CONCRETE MASONRY UNITS	4'	5"
BUILDING BRICK GR. S.W. FROM CLAY OR SHALE	4'	8"
PRECAST REINFORCED CONCRETE RINGS		5"
MONOLITHIC CONCRETE	4'	6"

- 1. BRICKS, CONCRETE MASONRY UNITS AND RINGS ARE TO BE LAID IN FULL MORTAR BEDS WITH FLUSH JOINTS.
- 2. ELECTRICAL MANHOLE SHALL BE PROVIDED WITH CAST IRON FRAME AND CLOSED LID AS SPECIFIED.
- 3. THE CONTRACT UNIT PRICE FOR ELECTRICAL MANHOLE SHALL INCLUDE THE FRAME AND CLOSED LID AS SPECIFIED.

ELECTRICAL MANHOLE DETAIL

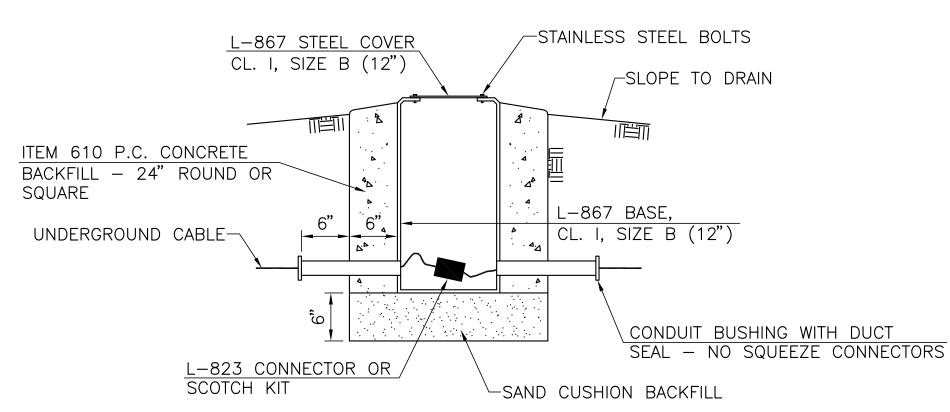

SPLICE CAN DETAIL

CANTON, ILLINOIS TYPICAL LIGHTING **DETAILS** HUTCHISON ENGINEERING, INC. JACKSONVILLE, ILLINOIS

INGERSOLL AIRPORT

DRAWN BY: R.L.R.

ILL. PROJ. NO. CTK-4350 DATE : FEBRUARY, 2015 SBG PROJ. NO. 3-17-SBGP-76

6 . 44 . . . 4 PLASTIC CONDUIT PLUG, TYPICAL FOR UNUSED CONDUIT TWO-WAY DUCT -1/2" DIA. BARS 12" LONG-NO. 10 PULL WIRE OAKUM, TO ALLOW FOR CONDUIT JOINT IF DUCT **NOTES** BANK IS EXTENDED

6"-

- 1. DIMENSIONS SHOWN ARE MINIMUM.
- 2. TOP OF CONCRETE ENCASEMENT TO BE NOT LESS THAN 18" BELOW FINISHED SUBGRADE.
- 3. DUCT CONCRETE SHALL BE STRUCTURAL P.C. CONCRETE (PLAIN OR REINFORCED).
- 4. DUCT SHALL BE PLASTIC CONDUIT CONFORMING TO ASTM D 1784.

— 4" I.D. CONDUIT

- 5. ALL DUCT TO BE 4" UNLESS OTHERWISE SPECIFIED.
- INSTALL CONCRETE DUCT MARKER TWO FEET SQUARE AND 4" THICK, AT ALL ENDS OF DUCTS.
- 1/2" DIAMETER 12" LONG BARS TO BE CAST IN BOTH ENDS OF THE DUCT BANK, AND ALLOWANCES MADE FOR ADDING A JOINT OF PLASTIC CONDUIT FOR FUTURE EXTENSION OF THE DUCT BANK ON BOTH

UNDERGROUND DUCT DETAILS

LEGEND

R (G PROPOSED M.I. THRESHOLD LIGHT - 180° RED/180° GREEN (STK. MTD.), L-861SE

Y \bigcirc W PROPOSED M.I. RUNWAY LIGHT - 180° YELLOW/180° WHITE (STK. MTD.). L-861

Y DW PROPOSED M.I. RUNWAY LIGHT — 180° YELLOW/180° WHITE (BASE MTD.), L—861

PROPOSED M.I. TAXIWAY LIGHT (STK. MTD.), L-861T(L)

PROPOSED M.I. TAXIWAY LIGHT (BASE MTD.), L-861T(L)

PROPOSED M.I. RUNWAY LIGHT - 360° WHITE (STK. MTD.) L-861

PROPOSED M.I. RUNWAY LIGHT - 360° (BASE MTD.) L-861

 \equiv EXISTING UNDERGROUND DUCT (2-WAY UNLESS OTHERWISE NOTED)

PROPOSED UNDERGROUND DUCT

PROPOSED REIL UNIT

TAXI GUIDANCE SIGN YELLOW LEGEND ON BLACK BACKGROUND WITH YELLOW BORDER

TAXI GUIDANCE SIGN WHITE LEGEND ON RED BACKGROUND

TAXI GUIDANCE SIGN BLACK LEGEND ON YELLOW BACKGROUND

PROPOSED TAXI GUIDANCE SIGN

EXISTING GUIDANCE SIGN

PROPOSED CABLE FOR AIRFIELD LIGHTING (1-NO. 8 5KV, TY. C, STR. IN UNIT DUCT)

> — PROPOSED CABLE FOR AIRFIELD LIGHTING HOMERUN (2-NO. 8 5KV, TY. C, STR. IN COMMON UNIT DUCT)

GENERAL NOTES

- 1. ALL RUNWAY AND TAXIWAY EDGE LIGHTS SHALL BE INSTALLED 10' FROM THE EDGE OF PAVEMENT. ALL TAXI GUIDANCE SIGNS SHALL BE INSTALLED 15' FROM THE EDGE OF PAVEMENT.
- 2. TRENCH/CABLE QUANTITIES WERE DETERMINED UTILIZING LINEAR DISTANCES BETWEEN CONSECUTIVE POINTS AND THE NEAREST LIGHT TO THE DUCT OPENING.
- 3. THE APPROXIMATE LOCATION OF UNDERGROUND CABLES AS INDICATED IN THESE PLANS HAS BEEN OBTAINED FROM EXISTING RECORDS. NEITHER THE OWNER NOR THE ENGINEER ASSUMES ANY RESPONSIBILITY IN RESPECT TO THE ACCURACY OR SUFFICIENCY OF THE INFORMATION AND THERE IS NO GUARANTEE, EITHER EXPRESSED OR IMPLIED. THAT THE CONDITIONS INDICATED ARE REPRESENTATIVE OF THOSE TO BE ENCOUNTERED IN THE CONSTRUCTION.
- 4. THE APPROXIMATE LOCATION OF VARIOUS AIRFIELD LIGHTING SYSTEM CABLES IS SHOWN FOR THE CONTRACTOR'S INFORMATION. IT WILL BE THE CONTRACTOR'S RESPONSIBILITY TO LOCATE THE EXISTING CABLES IN THE WORK AREAS AND MAKE HIS OWN DETERMINATION AS TO THE NUMBER OF CABLES EXISTING IN SAID AREAS AND AS TO THE CIRCUIT THAT THE CABLES ARE ASSOCIATED WITH. CAUTION SHALL BE EXERCISED WHEN TRENCHING, EXCAVATING DUCT ENDS, ETC. TO AVOID CUTTING THE EXISTING ACTIVE CIRCUIT CABLES. ANY EXISTING ACTIVE CABLE DAMAGED SHALL BE REPAIRED BY THE CONTRACTOR AT HIS OWN EXPENSE.
- 5. LETTERS AND NUMBERS SHOWN ADJACENT TO AN EDGE LIGHT OR SIGN (R-1-21,T-2-31) INDICATE THE LIGHT NUMBER TO BE ATTACHED TO THE LIGHTING UNIT ON AN IDENTIFICATION TAG. SEE THE IDENTIFICATION TAG DETAIL SHOWN IN THESE PLANS.

- THE CONTRACTOR SHALL APPLY AN ANTI-SEIZING COMPOUND TO THE BOLTS FOR THE BASE PLATES AND TO THE THREADED COUPLINGS OF THE LIGHTING EQUIPMENT WHEN ASSEMBLING THE EQUIPMENT.
- 7. THE PROPOSED UNDERGROUND CABLE BETWEEN CONSECUTIVE LIGHTING UNITS SHALL BE INSTALLED BY PLOWING FACTORY ASSEMBLED CABLE IN UNIT DUCT IN PLACE.
- 8. IN LOCATIONS WHERE TWO OR MORE CABLES ARE INSTALLED IN ONE LOCATION, THE TRENCH OR PLOWING SHALL BE WIDENED OR DEEPENED SUFFICIENTLY TO INSTALL ALL THE CABLES IN ONE LOCATION. COST OF THE LARGER TRENCH OR PLOWING SHALL BE CONSIDERED INCIDENTAL TO THE CABLE INSTALLATION.
- 9. THE UNDERGROUND CABLE BETWEEN LIGHTING UNITS SHALL BE INSTALLED AT 9'± FROM THE EDGE OF PAVEMENT TO AVOID ENCOUNTERING THE EXISTING EDGE LIGHTING CABLES THAT ARE LOCATED AT 10' TO 12' FROM THE EDGE OF PAVEMENT.
- 10. THE EXISTING UNDERGROUND CABLE TO THE EXISTING EDGE LIGHTS SHALL BE ABANDONED WITH THE EXCEPTION THAT ALL EXISTING CABLE BEING REPLACED THAT IS IN THE SAME LOCATION IN TRENCH OR DUCT AS THE PROPOSED CABLE SHALL BE REMOVED FROM THE TRENCH OR DUCT. THE CABLE REMOVED SHALL BE DISPOSED OF OFF THE AIRPORT PROPERTY BY THE CONTRACTOR AND SAID REMOVAL AND DISPOSAL SHALL BE CONSIDERED INCIDENTAL TO THE CONTRACT.
- 11. THE NEW RUNWAY AND TAXIWAY EDGE LIGHTING SHALL NOT BE TURNED ON FOR NIGHTTIME OPERATIONS ON A TEMPORARY OR PARTIAL BASIS. ALL COMPONENTS OF THE EDGE LIGHTING SYSTEMS SHALL BE COMPLETE AND OPERATIONAL BEFORE THE CIRCUITS ARE OPERATED.

INGERSOLL AIRPORT CANTON, ILLINOIS

GENERAL NOTES AND LEGEND

HUTCHISON ENGINEERING, INC. JACKSONVILLE, ILLINOIS

DRAWN BY: R.L.R.

ILL. PROJ. NO. CTK-4350 DATE: FEBRUARY, 2015 SBG PROJ. NO. 3-17-SBGP-76