STATE OF ILLINOIS **DEPARTMENT OF TRANSPORTATION** 

PLANS FOR PROPOSED

CITY OF ALTON, ILLINOIS

# **GREAT RIVERS FLOOD MEMORIAL &**

**BRIDGE WEST BEAUTIFICATION** 



SECTIONS: LICENSED 10-00229-01-LS PROFESSIONAL:

MADISON COUNTY

PROJECT NO. SBIL-TE-00D8(151) JOB NO. C-98-304-11

**PROJECT TEAM** 



(618) 463-3801

CITY OF ALTON, ILLINOIS 101 East Third Stree Alton, Illinois 82002

280001-07 TEMPORARY EROSION CONTROL SYSTEMS 424001-0 REPRENDICULAR CURB RAMPS FOR SIDEWALKS

701701-09 URBAN LANE CLOSURE, MULTILANE INTERSECTION

701801-05 / SIDEWALK CORNER OR CROSSWALK CLOSURE

606001-LO CONCRETE CURB TYPE B AND COMBINATION CONCRETE CURB AND GUTTER

701101-04 OFF-RD OPERATIONS, MULTICANE, 15' (4.5 m) TO 24" (800 mm) FROM PAVEMENT EDGE 701601-09 URBAN LANE CLOSURE, MULTILANE 1W OR 2W WITH NONTRAVERSABLE MEDIAN

424016-07 MID-BLOCK CURB RAMPS FOR SIDEWALKS 442101-07 CLASS B PATCHES

606301-04 PC CONCRETE ISLANDS AND MEDIANS

630001-10 STEEL PLATE BEAM GUARDRAIL

701901-04 TRAFFIC CONTROL DEVICES 780001-05 TYPICAL PAVEMENT MARKINGS 838001-02 LIGHT POLE FOUNDATION


PRIME CONSULTANT / LANDSCAPE ARCHITECT

727 North First Street, Suite 360 Saint Louis, Missouri, 63102

PLANNING DESIGN STUDIO

Phone (314) 241-3600

**LOCATION MAP** 

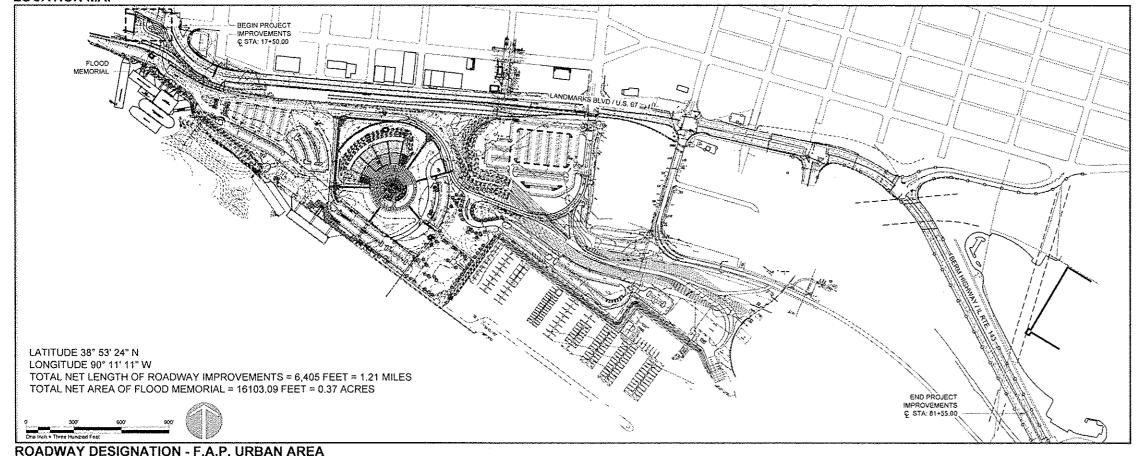


**CIVIL ENGINEER AND SURVEYOR** SHEPPARD MORGAN & SCHWAAB, INC


ENGINEER

Alton, Illinois 82002 Phone (618) 462-9755

STATE MAP

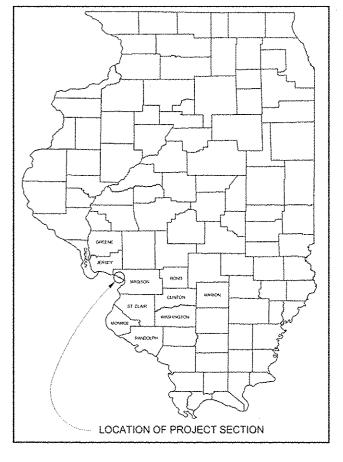

## ILLINOIS DEPT. OF TRANSPORTATION

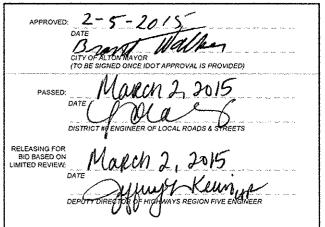

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GREAT RIVERS FLOOD MEMORIAL & BRIDGE WEST BEAUTIFICATION

CITY OF ALTON, ILLINOIS

101 EAST 3RD STREET ALTON, ILLINOIS 62002

**COVER SHEET** 

SECTION COUNTY 10-00229-01-LS MADISON 84 CONTRACT NO. 97539 FEDERAL AID PROJECT ILLINOIS

#### ABBREVIATIONS USED (ALL SHEETS)

&	And	MAX	Maximum
@	At	MH	Manhole
±	Plus or Minus	MIN.	Minimum
A	Amp	MISC.	Miscellaneous
A/C	Access Control	N	Northing Or North
ADD,	Additive	N.E.C.	National Electrical Code
A.F.F.	Above Finish Floor	N/E	Northeast
AGG.	Aggregate	N.I.C.	Not In Contract
Al	Area Inlet	NA, N/A	Not Applicable
ALT.	Alternative	NO.	Number
APPROX,	Approximate	NTS	Not To Scale
ASPH.	Asphalt	MW	Northwest
ATG	Adjust To Grade	O.D.	Outside Diameter
BC	Bottom of Curb	PC	Point Of Curvature
BLDG	Building	P.C.C.	Portland Coment Concrete
BM	Benchmark	PH	Phase
BOTT	Boltom	PI	Point of Intersection
BW	Bottom Of Wall	PL	Property Line
C-C C.F.S.	Center to Center	PN	Product Number/Part Number
C.r.s.	Cubic Feet Per Second Curb Inlet	P.O.B.	Point Of Beginning
C.I.P.	Cast In Place	PROP.	Proposed
C.J.	Contraction Joint	PSI PT	Pounds Per Square Inch
CST.JT.	Construction Joint	PVC	Point of Tangency
Ę	Centerline	PVMT.	Polyvinyl Chloride
C.L.	Centerline		Pavement Outst: Country
CLR.	Clear	Q. CPLR R. RAD.	Quick Coupler
C.P.	Control Point	RCP	Radius Reinforced Concrete Pipe
CONC.	Concrete	REINF.	Reinforcing
CONT.	Continuous or Container	REQD.	Required
CONST.	Construct/Construction	RET.	Retaining
Ç.O.	Cleanout	RR	Railroad
C.Y., CU YD	Cubic Yard	ROW	Right-of-Way
C&G	Curb & Gutter	RDWY	Roadway
DEMO	Demolish	RTE	Route
DIA.	Diameter	SAN.	Sanitary Sewer
D.I.	Drainage Inlet or Drop Inlet	SCH	Schedule
DTL.	Detail	S/E	Southeast
DTLS.	Details	S.F.	Square Feet Or Square Foot
E	Easting Or East	SHT.	Sheet
Ē.J.	Expansion Joint	SHTS.	Sheets
E.W.	Each Way	SS, S.S.	Storm Sewer
EA.	Each	SQ.	Square
ELEC.	Electrical Or Electric	SQ FT	Square Feet
ELEV.	Elevation	SQ YD	Square Yard
EOP	Edge of Pavement	STA.	Station
EW	Each Way	STD	Standard
EXIST.	Existing	s/W	Southwest
EX.	Existing	T.B.	Top Bars
EXP.	Expansion Or Exposed	TBM	Temporary Benchmark
FAP	Federal Aid Primary	TBR	To Be Removed
FAS	Federal Aid Secondary	T.C.	Top Of Curb
FAUS	Federal Aid Urban Secondary	TELE	Telephone
FDN	Foundation	T.F.	Top Of Footing
FES	Flared-End Section	THK	Thick
F.F.	Finished Floor	TSD	Tree Spade Dug
F.F.E.	Finished Floor Elevation	TS	Traffic Signal
F.G.	Finished Grade	TSCB	Traffic Signal Control Box
FH	Fire Hydrant	TW	Top of Wall
FL	Flow Line	TYP.	Typical
FF	Finished Floor	U.J.P.	Use in Place
FTG.	Fitting	U.L. UON	Underwriters Laboratories
F&G	Frame & Grate	U.V.	Unless Otherwise Noted
GFI	Ground Fault Interrupter	Λ.	Ultraviolet Volt
GP	Guy Pole		Valve Box
GW	Guy Wire	VBOX V.C.P.	
GRD.	Ground	V.C.P. Veg.	Vitrified Clay Pipe Vegetation
HDPE	High Density Polyethylene	VERT	Vertical
HMA	Hot-Mix Asphalt	M.	Westing or West
HORZ	Horizontal	W,L.	Water Level
HP	High Point	W.W.F.	Welded Wire Fabric
INV.	invert	W/	With
IP IC	Iron Pipe	W/O	Without
IR	Iron Rod	WP	Water Proof
JCT	Junction	WV	Water Valve
JT.	Joint t anoth		
L_	Length		
LF	Lineal Feet or Linear Feet		

#### **GENERAL NOTES**

#### GENERAL NOTES

- ALL PROJECT WORK IS GOVERNED BY APPLICABLE SECTIONS OF 'IDOT STANDARD SPECIFICATIONS' AND AS MODIFIED BY PROJECT SPECIAL PROVISIONS.
- THE ILLINOIS DEPARTMENT OF TRANSPORTATION SHALL REQUIRE 48 HOURS ADVANCE NOTICE FROM THE CONTRACTOR PRIOR TO IMPLEMENTATION OF LANDSCAPE ACTIVITIES.
- THE CONTRACTOR WILL COORDINATE AN APPROVAL OF IRRIGATION SYSTEM DESIGN AND A FIELD REVIEW OF THE IRRIGATION SYSTEM INSTALLATION WITH THE ILLINOIS DEPARTMENT OF TRANSPORTATION.
- 4. THE ILLINOIS DEPARTMENT OF TRANSPORTATION SHALL CONDUCT A FINAL INSPECTION OF THE IRRIGATION SYSTEM AND THE DECORATIVE LIGHTING UNITS PRIOR TO THE CITY OF ALTON APPROVING THESE ITEMS.
- CONTRACTOR SHOULD BE AWARE THAT CONCURRENT WORK MAY EXIST WITHIN THE PROJECTS LIMITS DURING CONSTRUCTION. CONTRACTOR SHALL COORDINATE THE PROJECT WORK WITH OTHER CONCURRENT WORK TO AVOID CONFLICTS AND DELAYS. REFER TO ARTICLE 105.08 OF THE STANDARD SPECIFICATIONS FOR ADDITIONAL INFORMATION.
- ANY EXCESS SOIL MATERIAL SHALL BE KEPT ON SITE AND SPOILED WITHIN THE SAME VICINITY FROM WHICH IT WAS REMOVED.

#### SITE INFORMATION NOTES

- PROJECT DIMENSIONS AND BENCHMARKS ARE BASED ON CONTROL POINTS USED IN A SITE SURVEY PREVIOUSLY CONDUCTED BY SHEPPARD MORGAN & SCHWAAB, INC. (618) 462-9755.
- UNDERGROUND FACILITIES STRUCTURES AND UTILITIES HAVE BEEN PLOTTED FROM AVAILABLE SURVEYS AND INFORMATION AND, THEREFORE, THEIR LOCATIONS MUST BE CONSIDERED APPROXIMATE ONLY. VERIFICATION OF LOCATION OF ALL UNDERGROUND STRUCTURES AND FACILITIES EITHER SHOWN OR NOT SHOWN ON THESE PLANS SHALL BE THE RESPONSIBILITY OF THE CONTRACTOR.
- CONSTRUCTION ACTIVITIES CANNOT OBSTRUCT OR LIMIT IN ANYWAY ACCESS INTO AND OUT
  OF RIVERFRONT PARK OR IMPACT ACCESS TO LOCAL ROADS AND BUSINESSES / PARKING LOT

#### ENTRANCES AND EXITS.

#### SITE UTILITY NOTES

- FOR UTILITY LOCATION PURPOSES, THIS PROJECT IS LOCATED WITHIN THE NW & N/E QUARTER OF SECTION 14 AND N/W & S/W QUARTER OF SECTION 13, TOWNSHIP 5 NORTH, RANGE 10, WEST OF THE THIRD PRINCIPAL MERIDIAN.
- PROPOSED UTILITIES ON THIS PROJECT ARE LIMITED TO LOW VOLTAGE ELECTRICAL FOR SOLAR POWERED SIGN LIGHTING AND WATER UTILITIES ASSOCIATED WITH THE DRIP IRRIGATION SYSTEM, COORDINATE ALL REQUIREMENTS FOR WORK WITH UTILITY PROVIDERS.
- 3. CONTACT INFORMATION:

#### AMEREN ILLINOIS BRAD LONG

ENERGY SERVICES CONSULTANT DIVISION IV - ALTON, ILLINOIS P.O. BOX 478 ALTON, ILLINOIS 62002 PHONE: (618) 463-4030 (GAS), (618) 463-4051 (ELECTRIC) FAX: (618) 463-4000 BLONG@AMEREN.COM

# CITY OF ALTON PUBLIC WORKS DEPARTMENT - SEWER

#2 EMMA L. KAUS LANE ALTON, ILLINOIS 62002 (618) 463-3530

ILLINOIS AMERICAN WATER CO.

4436 INDUSTRIAL DRIVE

ALTON, ILLINOIS 62002

P.O. BOX 186

(618) 466-2131

#### AT&T DARREN SIMMONS 160 WEST DIVISION ST MARYVILLE, IL 62062 (618) 346-6499

CHARTER COMMUNICATIONS 815 CHARTER COMMONS TOWN & COUNTRY, MO 63017 GARY WARREN (618) 779-4179

### ILLINOIS DEPARTMENT OF TRANSPORTATION

DIVISION OF HIGHWAYS - DISTRICT \$
1102 EASTPORT PLAZA DRIVE
COLLINSVILLE, IL 62234-6198
(618) 346-3110

#### COMMITMENTS

 REVISE PARKING ADJACENT TO CON-AGRA BUILDING TO MITIGATE CONFLICTS WITH TURNING MOVEMENT INTO ENTRANCE DRIVE TO THE EXTENT FEASIBLE.

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CONTACT JULIE AT 811 OR 800-892-0123
With the following:



County MADISON

City/Township ALTON

Sec & 1/4 Sec No. 14 (NW & NE), 13 (NW & SW)

48 HOURS (2 working days) BEFORE YOU DIG

All the improvements, facilities and utilities, above ground and underground shown herein were plotted from available information and do not necessarily reflect the actual existence, nonexistence, elevation, shape, size, type, number or focation of these or other improvements, facilities, or utilities.

The Contractor shall be responsible for verifying the actual location and elevation of all improvements, facilities and utilities, shown and not shown and said improvements, facilities and utilities shall be located in the field prior to any grading, excavation or construction of any improvements.

These provisions above shall in no way relieve any party from complying with Illinois State Law.

CALL ILLINOIS ONE-CALL, 611 OR 800-892-0123, OR VISIT WWW.JLLINOIS1CALL.COM

NO. REVISION DATE 01/28/2015

Pounds Per Foot

Linear Foot Low Point

LBS FT

GREAT RIVERS FLOOD MEMORIAL & BRIDGE WEST BEAUTIFICATION

CITY OF ALTON, ILLINOIS

101 EAST 3RO STREET

**GENERAL NOTES** 

-	CODE NO.	DESCRIPTION					100% LOCAL NON-PARTICIPATING ITEMS
-	20100110	TREE REMOVAL (6 TO 15 UNITS DIAMETER)  EARTH EXCAVATION	CUYD	60 256	60 246	0	0
-	20201200	REMOVAL AND DISPOSAL OF UNSUITABLE MATERIAL	CUYD	891	616	10 275	0
ı	21101610	TOPSOIL FURNISH AND PLACE, 3"	SQ YD	1159	1159	0	0
1	21101625	TOPSOIL FURNISH AND PLACE, 6°	SQ YD	415	0	415	0
	21101635	TOPSOIL FURNISH AND PLACE, 9"	SQ YD	90	90	0	0
	21101645	TOPSOIL FURNISH AND PLACE, 12"	SQ YD	1336	1137	199	Ō
쉬	21101805	COMPOST FURNISH AND PLACE, 2"	SQ YO	939	939	0	0
۱۵	21101810	COMPOST FURNISH AND PLACE, 3" PERIMETER EROSION BARRIER	SQ YD FOOT	1159 7283	1159 6963	0 320	0
ŀ	20000400	FERNICIER CRUSION BARRIER	1001	7203	0503	340	<u> </u>
ŀ	40600275	BITUMNOUS MATERIALS (PRIME COAT)	POUND	255	0	255	0
-	40600315	HOT-MX ASPHALT SURFACE, MX C , N70	TONS	32	0	32	0
Ì	40800050	INCIDENTAL HOT-MIX ASPHALT SURFACING	TON	8	0	â	0
1	42400200	PORTLAND CEMENT CONCRETE SIDEWALK, 5 INCH	SQFT	2348	2348	Ô	0
	42400800	DETECTABLE WARNINGS	SOFT	60	0	60	0
	44000100	PAVEMENT REMOVAL	SQ YD	1313	618	695	0
-	44000157	HOT-MIX ASPHALT SURFACE REMOVAL, 2"	SQ YD	277.5	0	277.5	0
-	44000300 44000600	CURB REMOVAL SIDEWALK REMOVAL	FOOT SQ FT	633 1523	370 1523	263	0
-	44003100	MEDIAN REMOVAL	SQFT	150	150	0	0
1	44200948	CLASS B PATCHES, TYPE I B INCH	SQ YD	26.66	26,66		
1	44200964	CLASS B PATCHES, TYPE N, 9 INCH	SQ YD	51.11	51,11	<del>-</del>	0
	44201299	DOWEL BARS 1-1/2"	EACH	122	122	0	Ö
ì	44213100	PAVEMENT FABRIC	SQ YD	51,11	51,11	0	0
	44213200	SAW CUTS	FOOT	140	140	0	0
-		DOCUMENTS CONTRACTOR OF THE PARTY OF THE PAR					
-	60109520 60600605	PIPE UNDERDRAINS, FABRIC LINED TRENCH 6"	FOOT	180	180	100	
-	60605100	CONCRETE CURB, TYPE B COMBINATION CONCRETE CURB & GUTTER, B-6.24 (ABUTTING	FOOT	190 350	350	190	0
-	(MI CANNO	EXISTING PAVEMENT)	FUUE	350	330	U	
1	60618320	CONCRETE MEDIAN SURFACE, 6 INCH	SQFT	150	150	0	0
	63000001-	STEEL PLATE BEAM GUARDRAIL, TYPE A & FOOT POSTS	-F007-	392-0	0	0	392-0
***************************************	-63100285-	TRAFFIC BARRIER TERMINAL, TYPE 1 (SALVAGED)	-EACH-	-1-0	0	0	-1-0
-	-63100295-	TRAFFIG BARRIER-TERMINAL, TYPE 2 (SALVAGED)	-EACH	-4- 0	0	0	<b>-1</b> − 0
	67100100	MOBILIZATION	LSUM	1	0.5	0.5	O
	70000000	TENDOS LOVIDA ELECTRADO (NO CORROS E	AA 22				
-	70300210 70301000	TEMPORARY PAVEMENT MARKING LETTERS AND SYMBOLS WORK ZONE PAVEMENT MARKING REMOVAL	SQ FT	29.4 29.4	0	29.4	0 0
-	72000100	SKIN PANEL TYPE 1	SQFT	15	0	29.4 15	ļ
-	72400100	REMOVE SIGN PANEL ASSEMBLY-TYPE A	EACH	7	5	2	0
	72400500	RELOCATE SIGN PANEL ASSEMBLY-TYPE A	EACH	3	3	<u>-</u>	
	73000100	WOOD SIGN SUPPORT	FOOT	56	0	58	0
s		THERMOPLASTIC PAVEMENT MARKING - LETTERS AND					
*	78000100	SYMBOLS	SQ FT	26	O .	26	C C
١	78000200	THERMOPLASTIC PAVEMENT MARKING - LINE 4"	FOOT	116	0	116	0
١	78000500	THERMOPLASTIC PAVEMENT MARKING - LINE 8"	FOOT	100	0	100	0
١	78000600 78000650	THERMOPLASTIC PAVEMENT MARKING - LINE 12" THERMOPLASTIC PAVEMENT MARKING - LINE 24"	FOOT	150 25	0	150 25	0
>	78300100	PAVEMENT MARKING REMOVAL	SQFT	28	0	28	0
1					<del></del>		
١	80300100	LOCATING UNDERGROUND CABLES	FOOT	1500	1500	0	Ô
Ì							
	A2004516	TREE, GINKGO BILOBA PRINCETON (PRINCETON SENTRY					
١.		GINKO), 2" CALIPER, BALLED AND BURLAPPED	EACH	7	7	0	0
١	A2006516	TREE, QUERCUS BICOLOR (SWAMP WHITE OAK), 2" CALIPER, BALLED AND BURLAPPED	EADS				1
1	A2008116	TREE, TILIA CORDATA GREENSPIRE (GREENSPIRE	EACH	3	3	0	00
١	FM.VAVE IV	LITTLELEAF LINDEN), 2" CALIPER, BALLED AND BURLAPPED	EACH	10	10	0	0
į							
J	B2000770	TREE, AMELANCHIER X GRADIFLORA AUTUMN BRILLIANCE					
1		(AUTUMN BRILLIANCE SERVICE BERRY), 2" CALIPER, BALLED			-		_
ļ	00004440	AND BURLAPPED	EACH	8	8	0	, C
١	B2001116	TREE, CERCIS CANADENSIS (EASTERN REDBUD), Z' CALIPER, TREE FORM, BALLED AND BURLAPPED	EACH	<del>-18-</del> 12	<del>-14-</del> 8	4	0
١	B2004916	TREE, MALUS SARGENTII TINA (TINA SARGENT CRABAPPLE), 2"		-,0- +2	1 - 1 - 0	<del> </del> -	<u> </u>
۱		CALIPER, TREE FORM, BALLED AND BURLAPPED	EACH	9	9	0	0
	B2004987	TREE, MALUS SENTINEL (SENTINEL CRABAPPLE), 7' HEIGHT,		1			
٦		CLUMP FORM, BALLED AND BURLAPPED	EACH	9	9	0	0
1	(50000.00	CODING ABOAHA AGGITICOUS BOSTISSPECS AS COSTUS	ļ	ļ		ļ	<u> </u>
ᅬ	C2000436	SHRUB, ARONIA ARBUTIFOLIA BRILLWATISSIMA (BRILLIANT RED CHOKEBERRY), 3' HEIGHT, BALLED AND BURLAPPED	EACH	33	33	0	0
ŀ	C2011836	SHRUB, VIBURNUM DENTATUM MORTON (NORTHERN					
١	02011000	BURGANDY ARROWWOOD VIBURNUM), 3' HEIGHT, BALLED					
-		AND BURLAPPED	EACH	39	39	0	0
	C2C01024	SHRUB, BUXUS MICROPHYLLA WINTERGREEN,					
۱-		(WINTERGREEN LITTLELEAF BOXWOOD), 2' HEIGHT,					_
ļ	00004405	CONTAINER	EACH	47	0	47	0
٠	C2C041G5	SHRUB, ITEA VIRGINICA LITTLE HENRY, (LITTLE HENRY VIRGINIA SWEETSPIRE), CONTAINER GROWN, 5-GALLON	EACH	165	154	11	Q
1	C2C058G2	SHRUB, RHUS AROMATICA GRO-LOW, (GRO-LOW FRAGRANT	201	100			
. 1		SUMAC), CONTAINER GROWN, 2-GALLON	EACH	121	121	0	0
١Į	C2C11752	SHRUB, VIBURNUM DENTATUM (CHRISTORS BLUE MUFFIN		T		l	
		VIBURNUM) 2 HEIGHT, CONTAINER	EACH	73	60	13	0
					1	l	
	D2002088	EVERGREEN, PICEA OMORIKA (SERBIAN SPRUCE), 8' HEIGHT,	E	A		_	<b>.</b>
\ \ \	D2092088	EVERGREEN, PICEA OMORIKA (SERBIAN SPRUCE), 8' HEIGHT, BALLED AND BURLAPPED	EACH	-27- 23	-24- 20	3	0
	··	BALLED AND BURLAPPED					
	D2002088 K0012950 K0012990		EACH ACRE UNIT	-27- 23 1,62 1,67 8,25	-24- 20 4-62 1.67 3.81	0 4.44	0 0

	CODE NO.	DESCRIPTION	UNIT			<u> </u>	100% LOCAL NON-PARTICIPATING ITEMS
4		PERENNAL PLANTS, PRAIRIE TYPE, QUART POT	UNIT	4.62	3.21	1.41	0
Δ		PERENNAL PLANTS, PRAIRIE TYPE, GALLON POT	ÜNIT	3:43- 2.76	- <del>3.01</del> - 2.34	0.42	0
۵		IRRIGATION SYSTEM, SPECIAL	LSUM	1	1	0	0
۵	K1005481	SHREDDED BARK MULCH 3"	SQ YD	<del>2074</del> 2064	<del>-1841</del> - 1831	233	0
	LR430050	CONCRETE PAVER SIDEWALK	SQ YD	272	0	272	0
1	X0301430	PRECAST CONCRETE PARKING BLOCK	EACH	2	0	2	0
٥	X0325106	IRRIGATION SYSTEM FALL SHUT-DOWN	EACH	6	6	0	0
١	X0325107	IRRIGATION SYSTEM SPRING START-UP	EACH	В	6	0	O
Ì	X0327018	DECORATIVE SIGN POST	EACH	11	11	0	0
Ì	-X2110100-	TOPSOIL FURNISH AND PLACE, SPECIAL	-CU-YD-	<del>317</del> ~ 0	- <del>317-</del> 0	0	0
7	X2520650	SODDING SALT TOLERANT, (SPECIAL)	SQ YD	-8916- 9035	-8500- B620	415	0
	X2800500	INLET PROTECTION, SPECIAL	EACH	38	37	1	0
1	X7010216	TRAFFIC CONTROL AND PROTECTION, (SPECIAL)	L SUM	1 1	0.5	0.5	0
1	XX000959	TRASHRECEPTACLE	EACH	1 1	0	1	0
J	XX001244	RETAINING WALL	FOOT	65	0	65	0
Ī	XX002202	VEHICULAR CONTROL BOLLARDS	EACH	52	52	0	0
۵	XX007825	ORNAMENTAL FENCE, WROUGHT IRON, SPECIAL	FOOT	20.34	20.34	0	0
	XX008441	BICYCLE RACKS, TYPE 1	EACH	1	0	1	0
	XX008553	RETAINING WALL, SPECIAL	FOOT	85	0	85	0
	-XZ127902-	RETAINING WALL, SPECIAL	-60 FT	-859 0	-850 - 0	0	0
		BENCHES	EACH	6	0	6	0
Ì	20013798	CONSTRUCTION LAYOUT	L SUM	1	0.5	0.5	0
- 1	Z0048665	RAILROAD PROTECTIVE LIABILITY INSURANCE	L SUM	1	0.5	0.5	0
	20062002	SAW CUTTING (FULL DEPTH)	FOOT	1115	780	335	0
۷	XX009016	INTERPRETIVE SIGN SYSTEM COMPLETE	L-SUM	1	0	<del> </del>	0
اد	XX009017	EROSION CONTROL PANEL	SQ FT	-48 16	48 16	0	0
-	XX009018	PORTLAND CEMENT CONCRETE BANDING, 12"	SQFT	62	0	62	0
[	P10900XX	PORTLAND CEMENT CONCRETE BANDING, 24"	SQFT	636	0	636	0
Δ	42401030	TREE, ACER RUBRUM SCARLET SENTINEL (SCARLET SENTINEL MAPLE), 2" CALIPER, BALLED AND BURLAPPED	EACH	2	2	0	0
- 1	B2002582	TREE, MAGNOLIA VIRGINIANA MOONGLOW (MOONGLOW SWEETBAY MAGNOLIA), <b>6' HEIGHT</b> , CLUMP FORM, BALLED IAND BLIER APPED	EACH	9	9	0	0
Δ	02001715	EVERGREEN, JUNIPERUS VIRGINIANA TAYLOR (TAYLOR RED CEDAR), 6' HEIGHT, BALLED AND BURLAPPED	EACH	3	0	3	o

## A SPECIALTY ITEMS

GREAT RIVERS FLOOD MEMORIAL & BRIDGE WEST BEAUTIFICATION

CITY OF ALTON, ILLINOIS

**SUMMARY OF QUANTITIES** 

-,,	F.A.U. ROUTE	SECTION	COUNTY	TOTAL SHEETS	SHEET NO.
		10-00229-01-LS	MADISON	84	3
			CONTRAC	T NO. 9753	9
			PROJ, NO,	SBIL-TE-0	0D8(151
	PEDERA	L AID PROJECT	ILLINOIS		

	UNIT	EARTH EXCAVATION NOTE 01		BALANCE	SHEET REFERENCE	STATION R	EFERENCE	COMMENTS
SCENIC BYWAY	CU,YD.	10	-	-	10, 24 & 25	16+75 RT.	18+50 RT.	NO EMBANKMENT - REFER
TOTAL	CU. YD.	10						TO OTHER SCHEDULES
ENHANCEMENT	CU. YD.	22	-	-	31	18+04 RT.	19+84.79 RT.	TOPSOIL FILL IN AREA
	CU. YD.	15	-		34	45+89.50 LT.	46+43.66 LT.	TOPSOIL FILL IN AREA
	CU, YD.	10	-		34	48+51.85 LT.	49+29.73 LT.	TOPSOIL FILL IN AREA
	CU. YD.	10	4	-	34	50+50.95 LT.	51+13.92 LT.	TOPSOIL FILL IN AREA
	CU. YD.	45	-	-	34	51+89.48 LT.	52+48.14 LT.	TOPSOIL FILL IN AREA
	CU. YD.	8	-	-	34	52+93.89 LT.	53+48.28 LT.	TOPSOIL FILL IN AREA
	CU. YO.	19		-	34	50+37.53 RT.	51+08.87 RT.	TOPSOIL FILL IN AREA
	CU. YD.	11	~	-	34	51+84,59 RT.	52+58.87 RT.	TOPSOL FILL IN AREA
	CU. YD.	36	-		36	70+37.50 C/L	72+00,00 C/L	TOPSOL FILL IN AREA
	CU. YO.	34			36/37	74+25.00 C/L	75+75,00 C/L	TOPSOL FILL IN AREA
	CU. YD.	36	-	-	37	78+00.00 C/L	79+75.00 C/L	TOPSOIL FILL IN AREA
Note: Topsoil fill for t	he above ex	cavaled areas a	re included in	n topsoil sch	edules for the v	arious depths	specified	
TOTAL	CU. YD.	256		256				

NOTE 01 - All excavation to be disposed off site as unsuitable material NOTE 02 - APPROXIMATE QUANTITY SHOWN FOR REFERENCE (Not applicable - area is being built up with other pay item materials) NOTE 03 - APPROXIMATE EARTHWORK BALANCE SHOWN FOR REFERENCE (Not applicable - refer to Note 01 & 02)

	UNIT	COMPOST F & P 3" DEPTH	COMPOST F & P 2" DEPTH	SHEET REFERENCE	STATION F	EFERENCE	COMMENT
SCENIC BYWAY		-	٠	-	-	-	
		-	-	-	-	-	
ENHANCEMENT	SQ. YD.	88	•	13 & 27	45+89.50 LT.	46+43,66 LT,	Planting Bed
	SQ. YD.	60	-	13 & 27	48+51.85 LT.	49+29.73 LT.	Planting Bed
	SQ. YD.	61	-	13 & 27	50+50.95 LT.	51+13.92 LT.	Planting Bed
	SQ. YD.	88	•	13 & 27	51+89.48 LT.	52+48,14 LT.	Planting Bed
	SQ, YD.	47	-	13 & 27	52+93.89 LT,	53+48.28 LT.	Planting Bed
	SQ, YD.	113		13 & 27	50+37.53 RT.	51+08.67 RT.	Planting Bed
	SQ, YD.	66	. •	13 & 27	51+84.59 RT.	52+58.87 RT.	Planting Bed
	SQ. YD.	215	-	15 & 31	70+37.50 C/L	72+00 C/L	Planting Bed
	SQ. YD.	203	-	15/16 & 31/32	74+25 C/L	75+75 C/L	Planting Bed
	SQ, YD.	218	•	16 & 32	78+00 C/L	79+75 C/L	Planting Bed
	SQ. YD.	*	234	15	68+61.78 C/L	70+37.50 C/L	Median Sod Area
	ŞQ, YD.	-	286	15 & 16	72+00 C/L	74+25 C/L	Median Sod Area
	SQ. YD.	-	307	16	75+75 C/L	78+00 C/L	Median Sod Area
	SQ, YD.	•	112	16	79+75 C/L	81+55 C/L	Median Sod Area
TOTALS		1169	939	1		1	

	UNIT	PERIMETER EROSION BARRIER	INLET PROTECTION, SPECIAL	EROSION CONTROL PANEL	SHEET REFERENCE	STATION RE	FERENCE	COMMENT
CENIC BYWAY	EACH	•	1	-	16	17+55 RT.	. ~	TUBULAR FILTER
	FOOT	320		^	16	17+00 RT.	18+50 RT.	SILT FENCE
NHANCEMENT	EACH	-	10	-	36	18+25 C/L	24+00 C/L	TUBULAR FILTER
	FOOT	420	-	-	36	18+04 RT.	22+41 RT.	SILT FENCE
	FOOT	224	-	-	36	18+04 RT.	20+25 RT.	ROLLED EXCELSIOR
	EACH		1	-	36	23+85 RT.	-	TUBULAR FILTER
	FOOT	295			36	22+25 RT.	25+00 RT.	ROLLED EXCELSIOR
	FOOT	292	-	-	36	22+25 RT,	25+00 RT.	SILT FENCE
	EACH	•	1	^	37	34+75 LT.	]-	TUBULAR FILTER
	FOOT	294	-	-	38	34+75 LT.	37+50 LT.	ROLLED EXCELSIOR
	EACH	-	3	-	38	36+00 LT.	37+37 LT.	TUBULAR FILTER
	FOOT	156	-	~	38	39+65 LT.	40+91 LT.	ROLLED EXCELSIOR
	EACH	-	3	-	38	40+35 LT.	40+70 LT.	TUBULAR FILTER
	FOOT	114	-		38	41+20 LT.	42+20 LT.	ROLLED EXCELSIOR
	EACH		4	-	38	41+40 LT.	42+00 LT.	TUBULAR FILTER
	FOOT	96	-		38	44+57 LT.	45+04 LT.	ROLLED EXCELSIOR
	FOOT	316	-	-	39	45+89 LT.	48+75 LT.	ROLLED EXCELSIOR
	FOOT	265	-	-	39	49+15 LT,	51+14 LT.	ROLLED EXCELSIOR
	EACH		2	-	39	48+47 LT.	48+53 LT.	TUBULAR FILTER
	EACH	-	2	-	39	49+40 LT.	49+50 LT.	TUBULAR FILTER
	EACH	-	3	-	39	51+27 LT.	51+30 LT.	TUBULAR FILTER
	FOOT	215	÷	-	39	51+85 LT.	53+48 LT.	ROLLED EXCELSIOR
	EACH	-	5	_	39	51+80	53+12 LT.	TUBULAR FILTER
	FOOT	152	-	-	39	50+25 RT.	51+12 RT.	ROLLED EXCELSIOR
	FOOT	166	-	-	39	51+70 RT.	53+00 RT.	ROLLED EXCELSIOR
	EACH	-	2	-	39	51+15 RT.	51+70 RT.	TUBULAR FILTER
	FOOT	460	-	-	39 & 40	51+90 RT.	56+60 RT.	SILT FENCE
	FOOT	919	-	-	40	55+75 LT.	64+35 LT.	SILT FENCE
	SQ FT	-	-	48	44 & 45	58+75 LT.	60+16 LT.	HDPE PANEL
	EACH	-	1	-	41	70+40 LT.	-	TUBULAR FILTER
	FOOT	1287	-	-	41 & 42	68+61.78 C/L-LT.	81+55 C/L-LT.	ROLLED EXCELSIOR
	FOOT	1292	-		41 & 42	68+61.78 C/L-RT.	81+55 C/L-RT.	ROLLED EXCELSIOR
OTALS		7283	38	48			<del> </del>	<del> </del>

	1	TOPSOIL F & P	TOPSOIL F&P	TOPSOIL F & P	TOPSOIL F & P	TOPSOIL F & P	SHEET			
	UNIT	3	6	9	12	-8PL-	REFERENCE	STATION R	EFERENCE	COMMENT
SCENIC BYWAY	SQ. YD	-	415	-	-	-	10, 19 & 25	17+00 RT.	18+50 RT.	Sod Areas
	SQ,YD.	-	-	-	199	-	10, 19 & 25	17+00 RT.	18+50 RT.	Planting Beds
ENHANCEMENT	SQ. YD	-		90	-	-	31 & 58	18+04 RT.	19+84.79 RT.	Area at Back of Curb
	SQ. YD		-	-	618	-	31 & 58	19+34 RT.	22+41 RT.	Rt. Turn Lane Area
	SQ. YD	-	-	-	208	-	33 & 60	39+64.78 L.T.	40+90.85 LT.	Area at Back of Walk
	SQ. YD	-		-	112	-	33 & 60	41+20.16 LT.	42+20.36 LT.	Area at Back of Walk
	SQ. YD	-	-	-	65	-	33 & 60	44+57.07 LT.	45+04.34 LT.	Planting Bed
	SQ. YD	-	-	-	134	-	34 & 61	51+66.53 RT.	53+06.82 RT.	Behind Curb
	SQ. YD	88		-	•	-	34 & 61	45+89.50 LT.	46+43.66 LT.	Planting Bed
	SQ. YD	60	-	-	-	-	34 & 61	48+51.85 LT.	49+29.73 LT.	Planting Bed
	SQ. YD	61	-		-	-	34 & 61	50+50.95 LT.	51+13.92 LT.	Planting Bed
	SQ. YD	88	-	-	-	-	34 & 61	51+89.48 L.T.	52+48.14 LT.	Planting Bed
	SQ, YD	47	-	-	-		34 & 61	52+93.89 LT.	53+48.28 LT.	Planting Bed
	SQ, YD	113	-	-	-	-	34 & 61	50+37.53 RT.	51+08.67 RT.	Planting Bed
	SQ. YD	66	-	-	-	~	34 & 61	51+84.59 RT.	52+58.87 RT.	Planting Bed
	GU. YD.	-	-	~	-	317	-35-&-62	58+85.48 LT:	60+60:36 LT.	Raised Planter
	SQ. YD	215		-	-	-	36 & 63	70+37.50 C/L	72+00.00 C/L	Planting Bed
	SQ, YD	203	-	-	-		36/37 & 63/64	74+25.00 C/L	75+75.00 C/L	Planting Bed
	SQ.YD.	218	-	-	-	-			79+75.00 C/L	
TOTALS		1159	415	90	1,336	317				

	UNIT	PAVEMENT REMOVAL		SIDEWALK REMOVAL	REMOVE SIGN PANEL ASSEMBLY, TYPE A	SAW CUTTING	REMOVE & DISPOSAL OF UNSUITABLE MATERIAL	TREE REMOVAL (6 TO 15 UNITS DIAMETER)	RELOCATE SIGN PANELASSEMBLY, TYPE A	MEDIAN REMOVAL	HOT-MIX ASPHALT SURFACE REMOVAL 2"	SHEET REFERENCE	STATION	REFERENC
CENIC BYWAY		695	•	-	-	•	-	-	-			10	17+00 RT.	18+50 RT
	FOOT	-	263		•	-	^		-	•	-		17+00 RT.	18+50 RT
	SQ.FT.		-	1316	<u> </u>	-		-	-		-		17+00 RT.	18+50 RT
-	EA		-		2		-	-	-	-	-		17+00 RT.	18+50 R
	FOOT		-		··	335	-	-					17+00 RT.	18+50 R
	CU. YD.		-		-	· · · · · · · · · · · · · · · · · · ·	275		-	l	-		17+00 RT.	18+50 R
	SQ. YD.	-	-			*	-	-	-	-	277.5	10	17+00 RT.	18+50 R
OTALS		695	263	1316	2	336	275				277.5			
NHANCEMENT	FOOT	•	350	-	-	-			-	_		31	19+34 RT.	22+41 R
	FOOT	-	20		-	-	-	-	-	-	-	31	21+50 LT.	21+70 LT
	SQ. YD.	618		-		-	-		*	-	-	31	19+34 RT.	22+41 R
	SQ. YD.	-	-	207	-	-	-			-	-	31, 38 & 39	21+50 LT.	21+70 L
	FOOT	-				20	-	-	-	-	-		21+50 LT.	21+70 L
	SQ. FT.			-			-		-	150	-		21+50 C/L	21+60 C
					_								46+75 LT., 4	
	EA.		-	<u> </u>	5	-							49+65 LT., 5	
	EA			ļ <u>.</u>					3	-			58+10 LT., 7-	
	FOOT	-		-	-	760	-	-		-	-			41+78 C/I 57+05 C/I 9+34 RT, 0+20 LT, to ., & 41+20 .36 LT, C/I cialed with gn posts a
	UNIT	-		-	-	-		50			-		43+00 RT.	44+65 R
	UNIT	-	,	-	-	-	-	10	-	_	-	34	55+00 RT.	-
	ÇU. YD.	-	-	-		_	616	-	_	-	-	31 TO 36	SEE COMME	ENTS
OTALS		618	370	207	5	780	616	60	3	150	·			T

GUARDRAIL SCHE	DULE					
		STEEL PLATE BEAM	TRAFFIC BARRIER	TRAFFIC BARRIER	1	<del></del>
	Į,	GUARDRAIL, TYPE A, 6 FOOT	TERMINAL, TYPE A	TERMINAL, TYPE 2	SHEET	\ /
	TUNK	POSTS	(SALVAGED)	(SALVAGED)	REFERENCE	STATION REFERENCE
ENHANCEMENT	PÓQT	392	· /		44	60*04 LT. 63+78 LT.
/	EACH				44	∕60+01 bt
	EACH	-		1	44	- 63+78 LT.
TOTALS		392	1	1		
			/			

NO.	REVISION	DATE	DATE: 01/28/2015
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,,,			GGV/SBT

F.A.U. ROUTE	SECTION	COUNTY	TOTAL	SHEE
	10-00229-01-LS	MADISON	84	4
- v-creat	To the state of th	CONTRAC	T NO. 9753	18
-		PROJ. NO.	SBIL-TE-0	0D8(15
FEDERA	AL AID PROJECT	ILLINOIS	F	

	UNIT	SODDING SALT TOLERANT, (SPECIAL)	SODDING SALT TOLERANT, (SPECIAL)	HERBICIDE SPRAYING	IRRIGATION SYSTEM, SPECIAL	IRRIGATION SYSTEM SPRING START-UP	IRRIGATION SYSTEM FALL SHUT- DOWN	SHEET REFERENCE	STAT	ION REFERNCE	COMMENT
ENIC BYWAY	SQ. YD.	415	-	-	-	-	-	19	16+75 RT,	18+50 RT.	
HANCEMENT	SQ. YD.	-	77	-	_	<u>-</u>	-	58	17+84 LT.	18+48 LT.	HERBICIDE SPRAYING AREAS - PLACED OVER TOPSOIL & COMPOST FILL
	ACRE	-	-	0.015				58	17+84 LT.		
	SQ. YD.	89	-	-			-	58	1	19+85 RT.	EXCAVATED AREAS - PLACED OVER TOPSOIL FILL
	SQ. YD.	398		-			-	58	19+85 RT.	22+25 RT.	EXCAVATED AREAS - PLACED OVER TOPSOIL FILL
	SQ. YD.	_	200				-	50	00.00 DT	00.00.07	HERBICIDE SPRAYING AREAS - PLACET
	ACRE	<del></del>	399	0.085		<del></del>	ļ <u>-</u>	58 58	22+25 RT.		OVER TOPSOIL & COMPOST FILL
	WORK			0,005		<del></del>		58	22+25 RT.	25+00 K 1.	HERBICIDE SPRAYING AREAS - PLACE
	SQ. YD.	_	339					59 & 60	34+76 LT.	27±64 1 T	OVER TOPSOIL & COMPOST FILL
	ACRE			0.07		<del></del>		59 & 60	34+76 LT.		OVER TOPSOE & CONFOST FEE
	101/10			V.01		<del></del>	<del>-</del>	200.00	134+10£1,	37731 61.	EXCAVATED AREAS - PLACED OVER
	SQ. YD,	214		60 39+63 LT. 40+91 LT		40+91 LT.	TOPSOIL FILL  EXCAVATED AREAS - PLACED OVER				
sissy dispersed	SQ. YD.	112	<del>-</del>	-			-	60 41+19 LT. 42+19 LT.		TOPSOIL FILL HERBICIDE SPRAYING AREAS - PLACED	
	SQ. YD.	- 1	- 684 61 45+79 RT. 51+13 RT.	OVER TOPSOIL & COMPOST FILL							
	ACRE	-		0.14	-		-	61	45+79 RT.		
	SQ. YD.	·	509	_	•		-	61	48+44 LT.		HERBICIDE SPRAYING AREAS - PLACEI OVER TOPSOIL & COMPOST FILL
	ACRE	-		0,11	-	-	-	61	48+44 LT.	48+57 LT.	
	SQ, YD,	-	391	-	-	-		61	49+25 LT.	51+26 LT.	HERBICIDE SPRAYING AREAS - PLACEI OVER TOPSOIL & COMPOST FILL
	ACRE	•	0.08 61 49+25 LT. 51+26 LT.	51+26 LT.							
	SQ, YD.	134		-		-	_	61	51+67 RT.	53+07 RT.	EXCAVATED AREAS - PLACED OVER TOPSOIL FILL
	SQ. YD,		248	-		*	-	61	51+85 LT.		HERBICIDE SPRAYING AREAS - PLACET OVER TOPSOIL & COMPOST FILL
	ACRE		<del> </del>	0.05			-	61	51+85 LT.	53+52 LT.	
	SQ, YD.		1936			<del>-</del>		61	52+11 RT.		HERBICIDE SPRAYING AREAS - PLACEI OVER TOPSOIL & COMPOST FILL
	ACRE	<del>.</del>		0.40		<u> </u>		61	52+11 RT.	56+24 RT.	
	00.00		2174					04.000			HERBICIDE SPRAYING AREAS - PLACEI
	SQ. YD.		<del>-2054</del> -	0.0000			-	61 & 62	55+80 LT.		OVER TOPSOIL & COMPOST FILL
				<del>-0.48</del> 0.53	<del>-</del>	<del></del>		61 & 62	55+80 LT.		HERBICIDE SPRAYING AREAS - PLACEI
	SQ, YO.	<del>.</del>	221	<b> </b>		<del>.</del>	-	63	68+65 C/L		OVER TOPSOIL & COMPOST FILL
	ACRE		-	0.05			<u> </u>	63	68+65 CA.	70+37 C/L	
	SQ, YO.	*	289	-	-			63	72+00 C/L		HERBICIDE SPRAYING AREAS - PLACE OVER TOPSOIL & COMPOST FILL
	ACRE		······································	0.06				63	72+00 C/L	/4+25 C/L	
	SQ. YD.	-	308	-	-		-	63 & 64	75+75 C/L		HERBICIDE SPRAYING AREAS - PLACE OVER TOPSOIL & COMPOST FILL
	ACRE	-		0.06	-	<u>-</u>	-	63 & 64	75+75 C/L	78+00 C/L	
					-						HERBICIDE SPRAYING AREAS - PLACED
	SQ, YD.	-	98		-		-	64	79+75 C/L		OVER TOPSOIL & COMPOST FILL
	ACRE			0.02				64	79+75 C/L		
	LSUM		-	-	1		-	21,22 & 66 to 72			ENTIRE PROJECT
	EACH			-	-	6		66, 68, 69, 70 & 71			SIX POINT OF CONNECTION LOCATION
	EACH	-	~	-	-	<u> </u>	6	66, 68, 69, 70 & 71	17+00 RT.	79+75 LT., RT., & CAL	SIX POINT OF CONNECTION LOCATION
TAL		1362	- <del>75</del> 53- <sub>1</sub>	-4,62	1	6	6				
AL SOD = 8915	SO. YD		1	1							······································

	UNIT	BICYCLE RACKS, TYPE 1	TRASH RECEPTACLE	BENCH	DECORATIVE SIGN POSTS	VEHICULAR CONTROL BOLLARDS	-RETAINING- WALL; SPECIAL- -(SQ. FT.)	PIPE UNDERDRAINS, FABRIC LINED TRENCH 6"	ORNAMENTAL FENCE, WROUGHT IRON, SPECIAL	SHEET REFERENCE	STATION R	EFERENCE
SCENIC BYWAY	L-SUM	1	-	-	-	-	-	_	-	17, 18 & 67	17+00 RT.	18+50 RT.
	EACH		1	•	-	-	-	-		17. 18 & 67	17+00 RT.	18+50 RT.
	EACH	-	-	6	-		-		-	17 & 67	17+00 RT.	18+50 RT.
TOTAL		1	1	6	-	-	•					
ENHANCEMENT	EACH	-	-	-	3	-		-	•	22, 23 & 70	20+94.59 C/L	21+24.59 C/L
	EACH	-	-	-	3	-	-	-		25, 26 & 70	41+38.20 C/L	41+78.20 C/L
	EACH	-	-	•	4	-	-	-	-	28, 30 & 70	56+35.22 C/L	57+05.22 C/L
	EACH	-	-	-	1		-	-	-	31, 32 & 70	66+47.16 C/L	
	EACH		-	-	-	10	-	-		22, 23 & 70	21+19.59 C/L	20+99.59 C/L
	EACH	-	-	-	-	10		-	-	25, 26 & 70	41+33,20 C/L	41+83.20 C/L
	EACH	-		,	•	24	-		-	28, 30 & 70	56+30,22 C/L	57+10.22 CA
	EACH	-	-	-	-	8	-	*	-		66+42.16 C/L	
	SQ.FT.	-	-	-	-		-850-			-28, 29 & 66-	50+05:40 LT:	60+60:36 LT
	FOOT	-		-	-	-		180	-	29 & 66	58+75 LT.	60+60.36 LT.
	FOOT	•		-	-	-		-	20.34	38 & 39	21+48.6 C/L	21+58.6 C/L
TOTAL					11	52	-850-	180	20.34		1	

TRAFFIC & INTERP	RETIVE SI	GN SCHEDU	ĻĘ				
		SIGN PANEL	WOOD SIGN	INTERPRETIVE SIGN SYSTEM	SHEET	STATION	
	UNIT	TYPE 1	SUPPORT	COMPLETE	REFERENCE	REFERENCE	COMMENT
SCENIC BYWAY	SQ. FT.	15	56	-	12, 18 & 27	17+00 RT, 18+50 RT.	FIELD STAKE SIGN LOCATIONS
	L-SUM			1	12, 26 & 27	17+00 RT. 18+50 RT.	FOR APPROVAL
TOTAL		15	56	1			

CONCRETE CUR	B, RETA	INING WALLS	R PRECAST PAR	KING BLOC	KS SCHEDI	JLE				······································
	UNIT	CONCRETE CURB, TYPE B	COMBINATION CONC CURB & GUTTER, B-6, 24		RETAINING WALL		SHEET REFERENCE	STATION R	EFERENCE	COMMENT
SCENIC BYWAY	EACH	-	-	-	-	2		17+00 RT.	18+50 RT.	DISABLED PARKING STALLS
	FOOT	190	• .	85	65		11, 24 & 25	17+00 RT.	18+50 RT.	VARIOUS LOCATIONS
ENHANCEMENT	FOOT	-	20	-	· ·	-	38 & 39	21+50- LT.	21+70 LT.	
	FOOT	```	330		-	-	38 & 39	19+34.43 RT.	22+40.95 RT.	ADJACENT TO EXIST. PAVMT.
TOTAL		190	350	85	65	2				

PAVEMENT MAR	KINGSC	HEDULE											
	UNIT	PAINT PAVEMENT MARKINGS - LINE 4"	PAINT PAVEMENT MARKINGS - LINE 8"	PAINT PAVEMENT MARKINGS - LINE 12"	PAINT PAVEMENT MARKINGS - LINE 24"	PAINT PAVEMENT MARKINGS LETTERS & SYMBOLS	TEMPORARY PAVEMENT MARKING LETTERS & SYMBOLS	PAVEMENT MARKING REMOVAL	MARKING	SHEET REFERENCE	}	TION RENCE	COMMENT
SCENIC BYWAY													ENTRANCE DRIVE
	FOOT	-		150	25	-	-	_	-	11, 15 & 18	17+00 RT.	18+50 RT.	CROSSWALK & STOP BAR
	SQ. FT,			-	-	16		_	_	11 & 18	17+00 RT.	ſ	SHARE THE ROAD SYMBOL
	SQ, FT,		-	٠.	-	-	29.4		29.4	30	17+00 RT.	18+50 RT.	TURN ARROWS
	FOOT	116	100	-		10		28	-	11 & 18	17+00 RT.		DISABLED PARKING STALLS
TOTAL	T	116	100	150	25	26	29.4	28	29.4				

	HEDULE	BITUMINOUS	HOT-MIX	INCEDENTAL	1			<del></del>		CONOGETE	01.400.0	C1 400 D	<del> </del>	·	· · · · · · · · · · · · · · · · · · ·		
					ł					CONCRETE	3	CLASS B					1
	1	MATERIALS	ASPHALT	HOT-MIX	PCC		CONCRETE	PCC	PCC	MEDIAN	PATCHES,	PATCHES,	DOWEL	1			
		(PRIME	SURFACE,		SIDEWALK,	DETECTABLE		CONCRETE	CONCRETE	SURFACE,	TYPE I, 9	TYPE IV, 9	BARS	PAVEMENT	[	SHEET	
	UNIT	COAT)	MIX C, N70	SURFACING	5 INCH	WARNINGS	SIDEWALK	BANDING 12"	BANDING 24"	6 INCH	INCH	INCH	1-1/2"	FABRIC	SAW CUTS	REFERENCE	STATION REFERENCE
SCENIC BYWAY	1	225		-	-	-			-	-		<del></del>	-	-	-	11	17+00 RT, 18+50 RT.
	TON	-	32		-	-	-	-	-	-	-	-		-	-	11	17+00 RT. 18+50 RT.
	TON	-	•	8	-	-	-	-	•	-	-	-	-	-	-	11	17+00 RT. 18+50 RT.
	SQ. FT.	- 1	-	-	2141	-	-	-		7	-	-	-	-		†1	17+00 RT. 18+50 RT.
	SQ. FT.	-			-	60	-	-	-	-	-		-	-	-	11	17+00 RT. 18+50 RT.
	SQ. YD.	-		-	-	-	272	-	-	-	-	-	-	-	-	11	17+00 RT. 18+50 RT.
	SQ. FT.	-	-	-	-		_	62	-	-	_		-	-	-	11	17+00 RT, 18+50 RT.
	SQ. FT.	-	-	-	-	-	-	-	636	-	-	-	•	-	-	11	17+00 RT, 18+50 RT,
TOTALS		225	32	8	2141	60	272	62	636								
NHANCEMENT	SQ. FT.	-	-	-	207	-	-	-	~	-	-	- 1	-	-	-	38 & 39	21+50 LT, 21+70 LT.
	SQ. FT.	-	-	-		-		-	-	150	-		-	-	-	38 & 39	21+50 C/L 21+60 C/L
	SQ. YD.		-	-	-	-	-	-	-	~	26.66		-	-	-	31 & 38	21+58.6 C/L 21+68.6 C/
	SQ. YD.			-	-	-	•	-	-	~	-	51,11	-	-	-	31 & 38	21+58.6 C/L 21+68.6 C/L
	EACH	-	-	-	-	-	-	-	-	-	-	-	122				21+58.6 C/L 21+68.6 C/
	SQ. YD.	-		-	-	-	-	-	-	-	-	-	-	51.11	-	31 & 38	21+58.6 C/L 21+68.6 C/L
	FOOT	-			-	-	-	-	-	~	-	-	•	-	140	31 & 38	21+58.5 C/L 21+68.1 C/
OTALS					207	,,,,,,,,,,,,,,,,,,,,,,,,,,,,,,,,,,,,,,,				150	26,66	51,11	122	51,11	140		

NO.	REVISION	 DATE: 01/28/2015
	ante esta esta esta esta esta esta esta es	DRAWN 8Y: GGV/8BT

GREAT RIVERS FLOOD	MEMORIAL &	& BRIDGE	WEST BEA	UTIFICATION

F.A.U. ROUTE	SECTION	COUNTY	TOTAL SHEETS	SHEET NO.
	10-00229-01-LS	MADISON	84	5
		CONTRAC	T NO. 9753	9
		PROJ. NO,	SBIL-TE-0	OD8(151)
FEDERA	L AID PROJECT	ILLINOIS		

	PLANT-UNIT- MULCH	SHRUB ARONIA ARBUTIFOLIA - 'BRILLIANTISSAMA'	SHRUB VBURNUM DENTATUM MORTON	SHRUB BUXUS MICROPHYLLA WINTERGREEN	SHRUB ITEA VIRGINICA LITTLE HENRY	SHRUB RHUS AROMATICA GRO-LOW	CHRISTORS	TYPE	PERENNIAL PLANTS, ORNAMENTAL TYPE 2-GALLON POT	PERENNIAL PLANTS, PRAIRIE TYPE QUART POT	PERENNIAL PLANTS, PRAIRIE TYPE GALLON POT	SHREDDED BARK MULCH 3"	SHEET REFERENC E	STATION R	EFERENCE
CENIC BYWAY		-		47	11		13	4.44	0,28	1.41	0.42	199	19	17+00 RT.	18+50 RT
NHANCEMENT	EACH-UNIT - SQ.YD.	-	-	-	-	19	-	0.9	-	-	-	63	58	18+00 LT.	18+40 LT.
	EACH-SQ.YD.	2		-		<u> </u>						2	1	20+75 RT.	-
	EACH-SQ.YD.	3	-				·	<del></del>				3		22+10 RT.	
	EACH-SQ.YD.	3	<u> </u>		-							3		34+95 LT.	+
	EACH-SQ.YD.	10				<del></del>	-					10		35+85 LT.	37+35 LT.
	UNIT-SQ.YD.					<del></del>	-		-	-	0.15	33		40+15 LT.	40+71 LT.
	UNIT-SQ.YD.						<u> </u>	<u> </u>	-	_	0.15	34		41+41 LT.	41+97 LT.
	EACH-UNIT - SQ.YD.	•	-		20	-		0.85	-		-	64	60	44+57 LT.	45+04 LT.
	EACH-UNIT - SQ.YD.	-		-	24	15	-	0.43	-	-	-	91		45+89 LT.	46+43 LT.
	EACH-UNIT - SQ.YD.	-	•	-	10	-	-	0.54		-	-	32	61	48+52 LT.	48+75 LT.
	EACH-UNIT - SQ.YD.	*	•	-	10	-	-	0.5	-	-	-	33	61	49+09 LT.	49+29 LT.
	EACH-UNIT - SQ.YD.	-	-	-	24	-	-			0,61	-	72		50+51 LT.	51+13 LT.
	EACH-UNIT - SQ.YD.	-	-	-	29	14	-	-	*	0.47	•	99	61	51+89 LT.	52+48 LT.
	EACH-SQ.YD.		-	-	*	25	-	-	-		-	55	61	52+94 LT.	53+48 LT.
	EACH-UNIT - SQ.YD.	-	-	-	16	5	-	0.59		0.53	-	121	61	50+38 RT.	51+12 RT
	EACH-SQ.YD.	,			21	7	-			-		76		51+85 RT.	52+58 RT
	EACH-UNIT - SQ.YO.	-	39		-	•		-	-	-	1,44 2.11	267 -259-	62	58+86 LT.	60+60 LT.
	EACH-UNIT - SQ.YD,	5	-	-	-	18	20	-	-	0.80	0.20	215	63	70+38 C/L	72+00 C/L
	EACH-UNIT - SQ.YD.	5	*	-	-	10	20	-	-		0.20	204	63	74+25 C/L	75+75 C/L
	EACH-UNIT - SQ,YD.	5	-	-	-	8	20	-	-	0.80	0.20	219		78+00 C/L	79+75 C/L
OTAL.	-	33	39	47	165	121	73	8.25	0,28	4.62	;3:43-	-1887-	<del> </del>		~

	UNIT PLANT-SQ. YD.	TREE ACER RUBRUM SCARLET SENTINEL	TREE  AMELANCHIER X  GRANDIFLORA- AUTUMN  BRILLIANCE	TREE CERCIS CANADENSIS	TREE GINKGO BILOBA PRINCETON	VIRGINIANA	TREE MAGNOLIA VIRGINIANA MOONGLOW	TREE MALUS SARGENTII TINA	MALUS	TREE QUERCUS BICOLOR	EVERGREEN PICEA OMORIKA	TREE TILIA CORDATA GREENSPIRE	SHREDDED BARK MULCH 3"	SHEET REFERENCE	STATION REFERENCE
CENIC BYWAY	EACH-SQ. YD.	- 1	•	4		3	-	-	-	-	3	10	34	19	17+00 RT. 18+50
HANCEMENT	EACH-SQ. YD.	-	•	-	_	-	-	•	~	-	3	-	5.4	58	21+58 LT.   21+89
	EACH-SQ. YD.	1	-	•	-	-	-	-	-		-	-	1.8	58	22+23 LT
	EACH-SQ. YD.		-	3	-	-	-	-	-		-	-	5.4	58	22+35 LT. 22+61
	EACH-SQ. YD.	1	-	•	-	-		-	-	-		-	1.8	58	22+72 LT
	EACH-SQ. YD.	-	-	•	7	-	-	-	-	-	-	-	12.6	58	20+63 RT. 22+28
	EACH-SQ. YD.	-	-	•	-	-	-	-	-	-	6	-	10.8	60	42+77 RT. 44+74
	EACH-SQ. YO.			-	-		-	9	-	-	-	•	16.2	61	46+74 LT. 50+17
	EACH-SQ. YO.		•	-	-	-		-	•	-	8	-	14.4	61	52+42 RT. 53+57
	EACH-SQ. YD.	-	-	•	-	-	-	-	•	3	-	-	5.4	61	53+74 RT. 54+34
	EACH-SQ. YO.	-	5	-	-	<u> </u>	-	-	-	-	-	-	9	61	54+80 RT. 54+85
	EACH-SQ. YO.		-	5	-	<u>-</u>		-	-	-	-	-	9	61	55+13 RT, 55+41
	EACH-SQ. YD.	- 1	3	•	-	-	-	_	-	-	-	-	5.4	62	55+69 RT. 55+85
	EACH-SQ. YD.	-	-	•	•		-	-	-	-	3	•	5.4	62	56+13 LT. 56+40
	EACH-SQ. YD.		-		-			-	3	-	-	٠ .	5.4	62	56+66 LT. 57+25
	EACH-SQ. YD.	-		-	-	-	3	-	-	-	•	-	5.4	62	58+16 LT. 58+75 I
	EACH-SQ, YD.	-	·	-3-	-	-	-	-	-	-	-	-	-5.4	62	59+25 LT. 59+37
	EACH-SQ. YD.			-	-	-	-	-	-	-	-4-	·	-7.2-		59+48 LT. 59+95
	EACH-SQ. YD.	-		3	-	-	-	-	-	-	-	-	-5.4		60+06 LT. 60+18
	EACH-SQ, YD.	-		-	-	•	3	-	-	-	-		5.4	62	60+68 LT. 61+26
	EACH-SQ. YD.	-	-	-		-	-	-	6	-	•	-	10.8		61+55 LT. 63+26
	EACH-SQ, YD.	-	-	-		-	3		-	-	-		5.4		63+54 LT. 64+11
)TAL	1	2	8	18	7	3	9	9	9	3	-27	10	-487		

NO. REVISION DATE 01/28/2015

DRAWN BY:
GGV/SBT

GREAT RIVERS FLOOD MEMORIAL & BRIDGE WEST BEAUTIFICATION

CITY OF ALTON, ILLINOIS

101 EAST 3RD STREET
ALTON, ILLINOIS 62002

SCHEDULE OF QUANTITIES

## **BENCHMARK & CONTROL POINTS**

#### BENCHMARK


 ASSUMED BENCHMARK - ELEVATION 432.42', NORTHING 809625.1573, EASTING 2290861.0316 -LOCATED ON SOUTHWEST CORNER OF TRAFFIC LIGHT CONCRETE BASE AT SOUTHWEST CORNER OF LANDMARKS BOULEVARD AND WEST BROADWAY - 23 INCHES FROM EDGE OF SIDEWALK.


#### CONTROL POIN


- SURVEY CONTROL POINT #112 ELEVATION 432.68', NORTHING 809517.8930, EASTING 2290911.5020 LOCATED 6 FEET AND 1/2 INCH SOUTH FROM BACK OF CURB OF EAST-BOUND LANDMARKS BOULEVARD AND 20 FEET EAST FROM END OF SIDEWALK ALONG EAST-BOUND LANDMARKS BOULE EVAPD.
- 3. CONTROL POINT #117 ELEVATION 431,92', NORTHING 808700,2759, EASTING 2291556,3787 LOCATED 88 FEET AND 6 INCHES SOUTH OF RIVERFRONT PARKING LOT AND 34 FEET AND 9 INCHES NORTH OF RIVERFRONT CONCRETE WAI!


#### GENERAL


- 4. DRAWING BASE INFORMATION IS A COMPILATION OF THE FOLLOWING
- 4.1. PARTIAL AREA BASE SURVEY COMPLETED BY SMS ENGINEERS FOR WESTERN END OF PROJECT
- 4.2. TOPOGRAPHIC AND PLANIMETRIC DATA FROM MADISON COUNTY INFORMATION TECHNOLOGY DEPARTMENT (MARCH 2011)
- i.3. R.O.W./PARCEL DATA DIGITIZED FROM LANDMARKS BOULEVARD RIGHT OF WAY PLAT
- COMPLETED BY HURST-ROSCHE ENGINEERS, INC. AND PROVIDED BY IDOT DISTRICT 8 (JUNE 1988)
- 4.4. ALTON RIVERFRONT STREET LIGHTING PLAN PROVIDED BY IDOT DISTRICT 8 (FEBRUARY 1994)

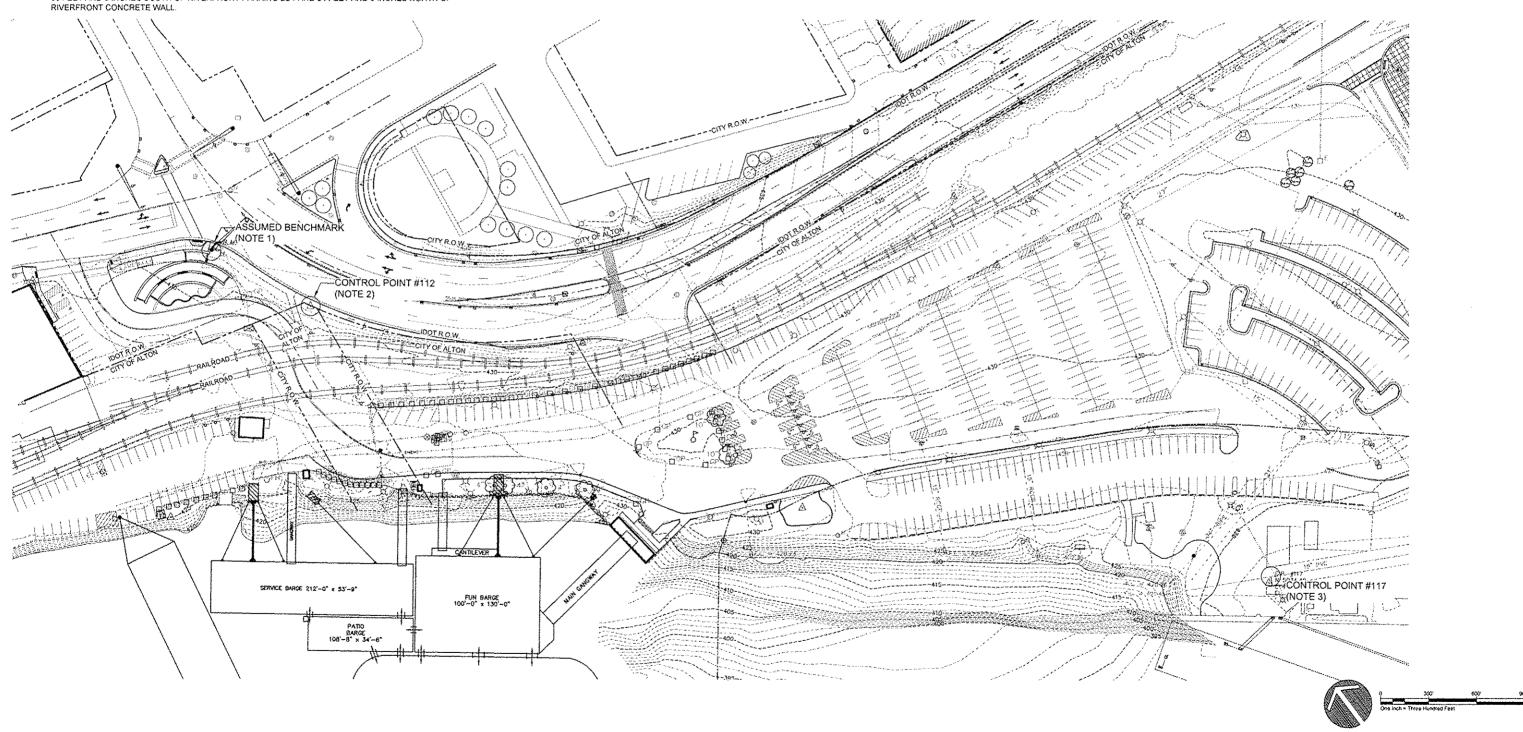


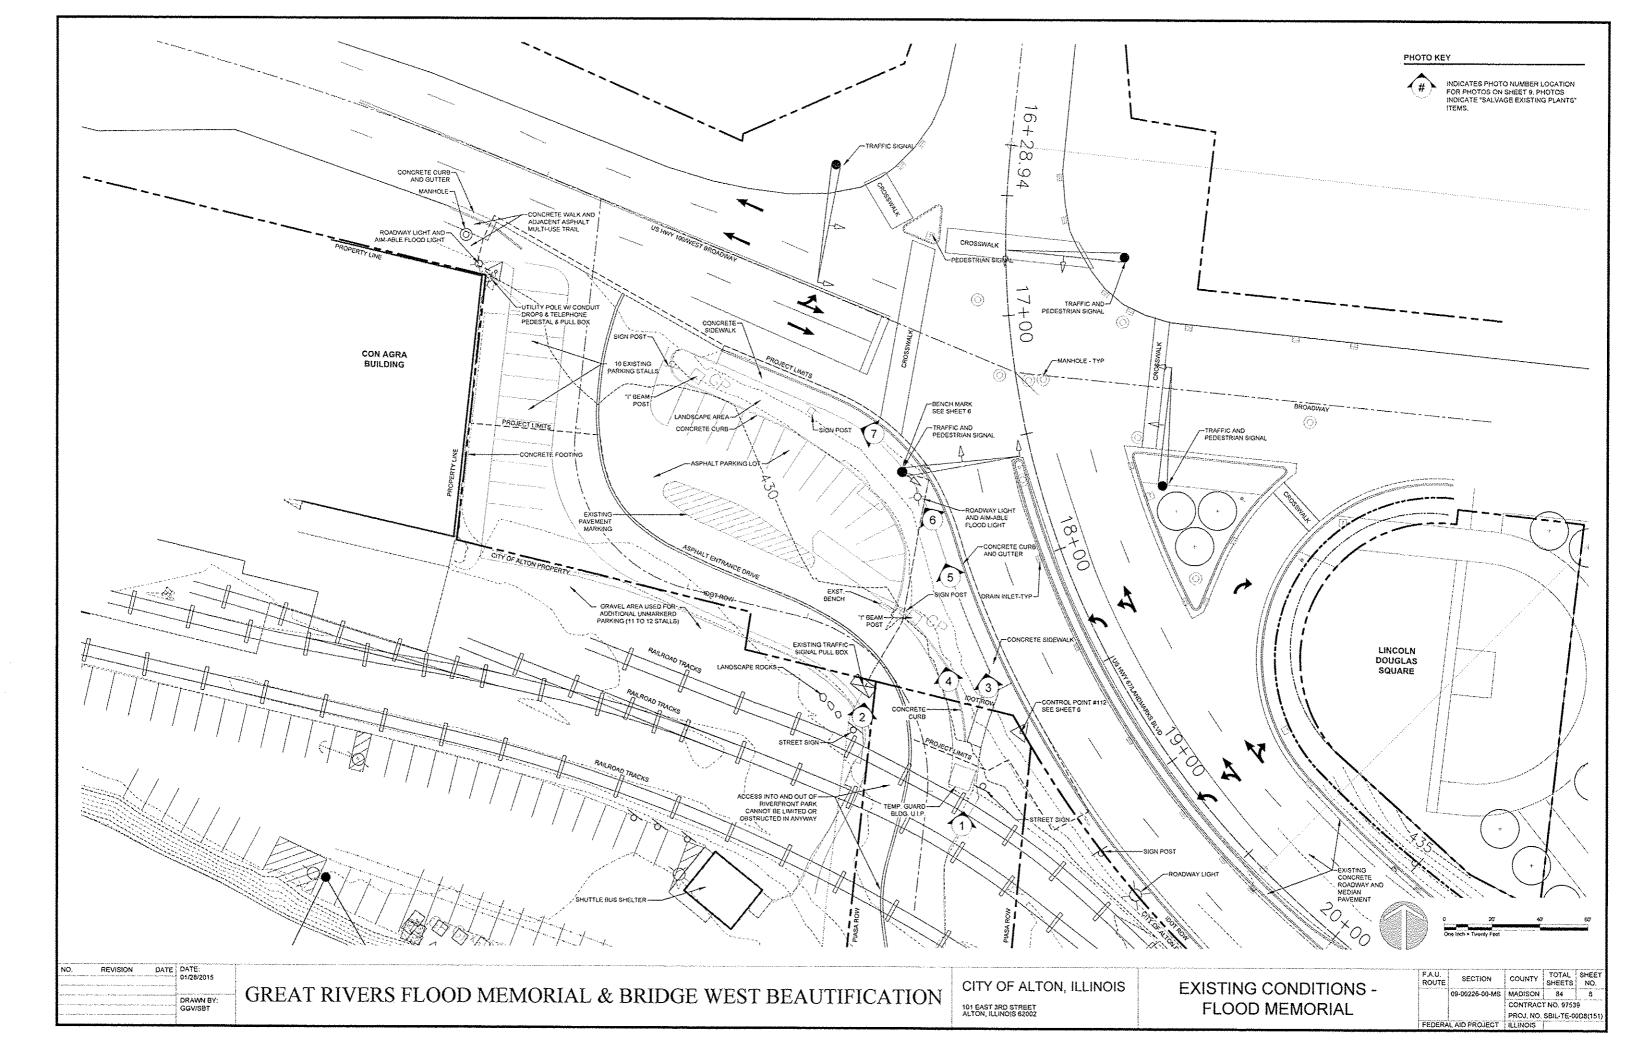

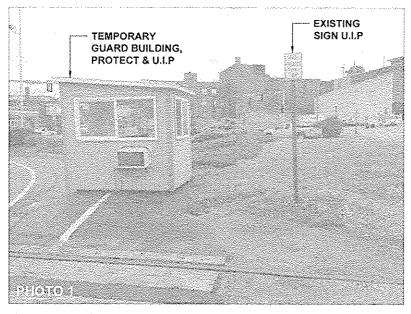


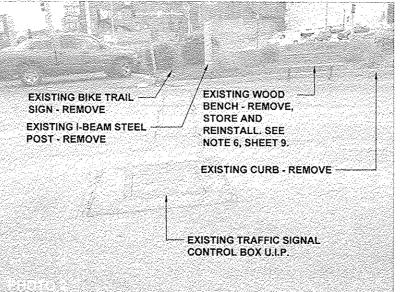

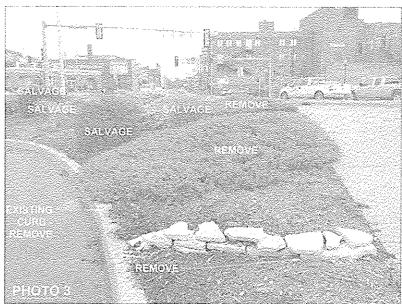


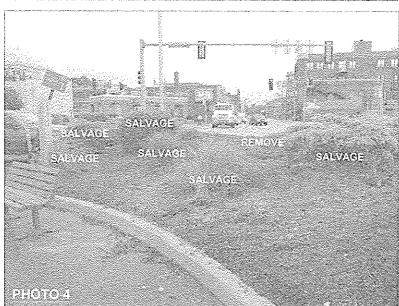





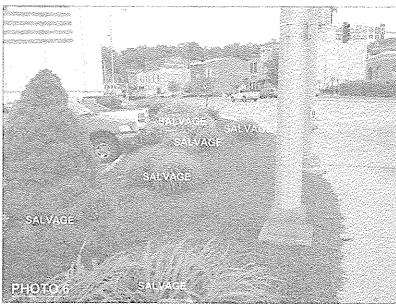



NOTE: EXISTING SHRUBS & ORNAMENTAL GRASSES, REMOVE & SALVAGE AS INDICATED - COORDINATE WITH THE CITY, SEE NOTE 5, SHEET 10,

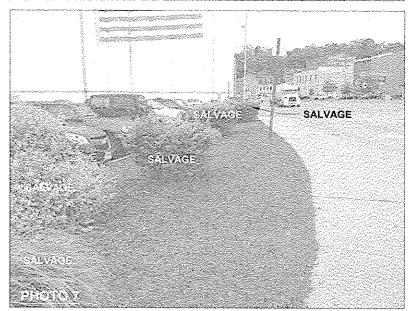


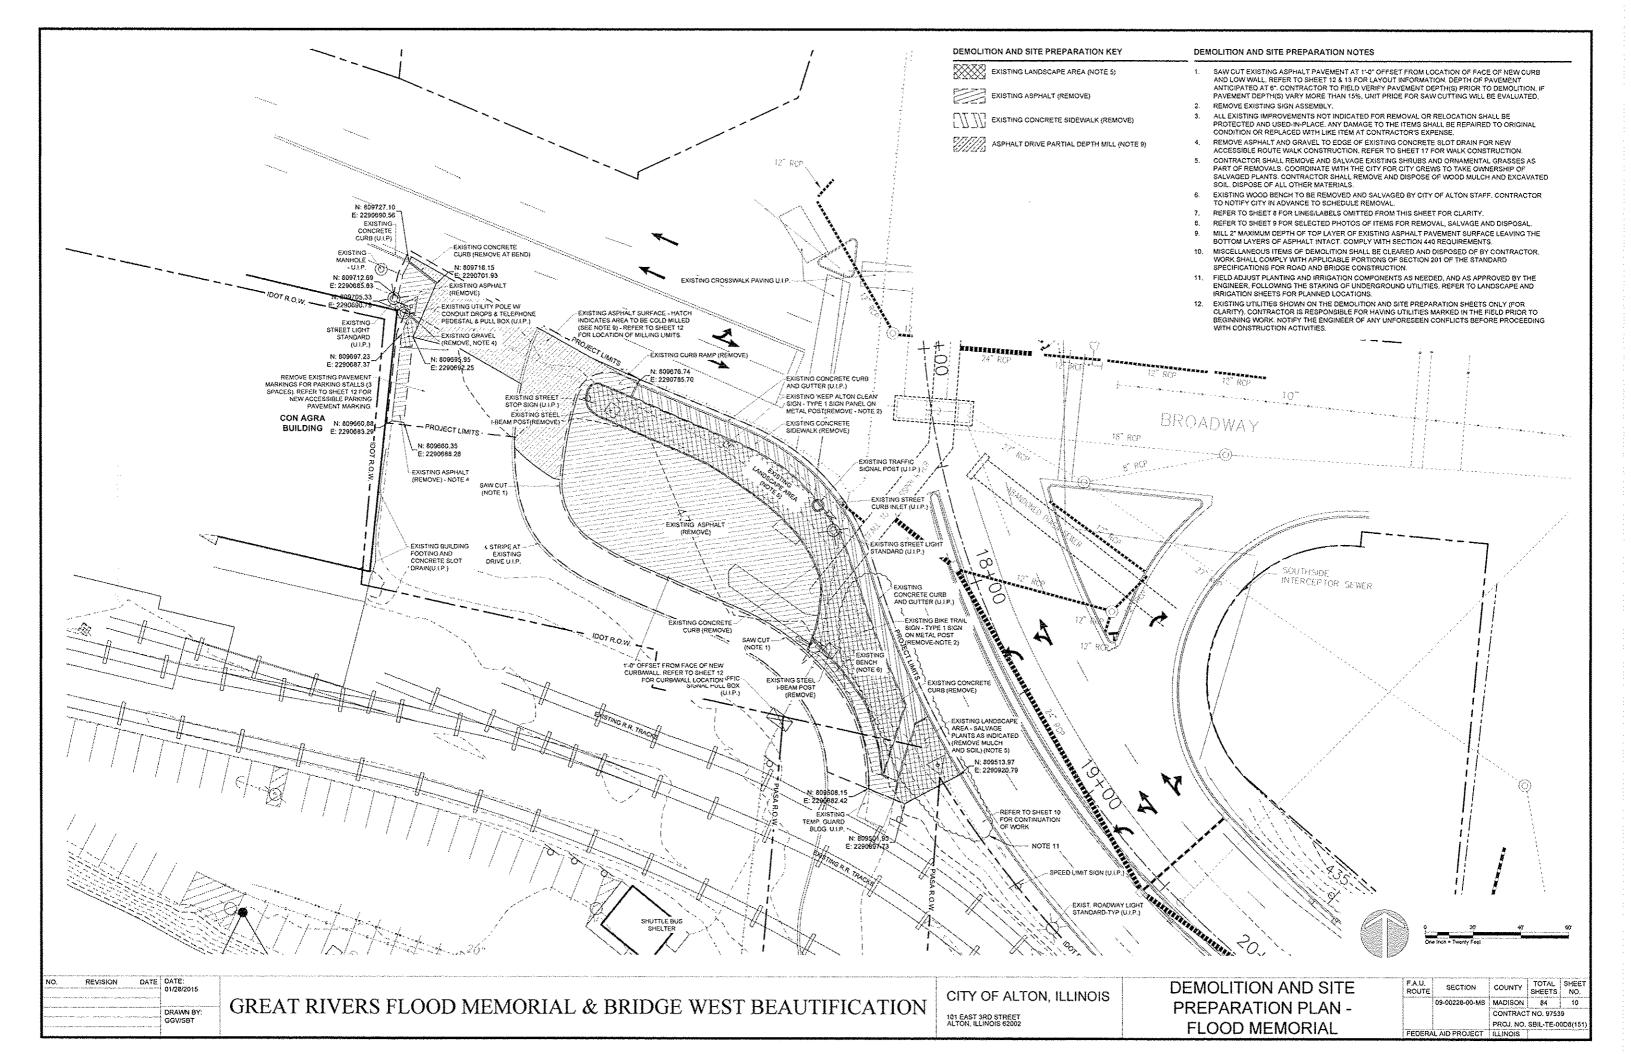

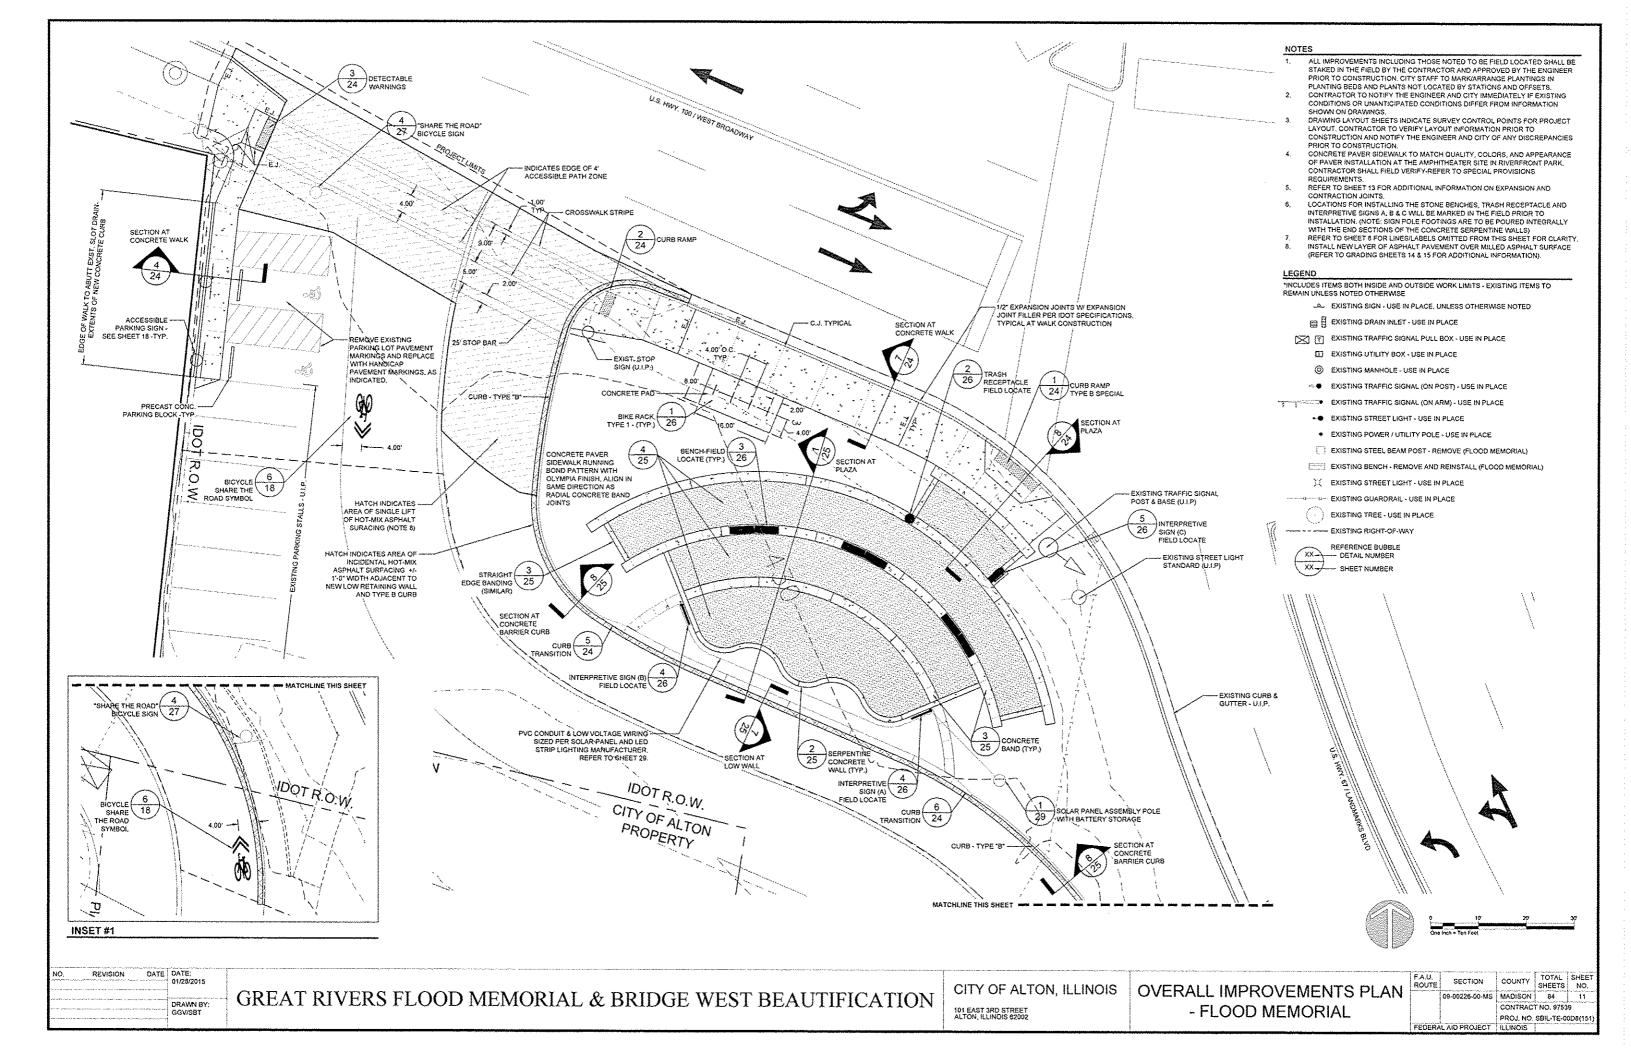


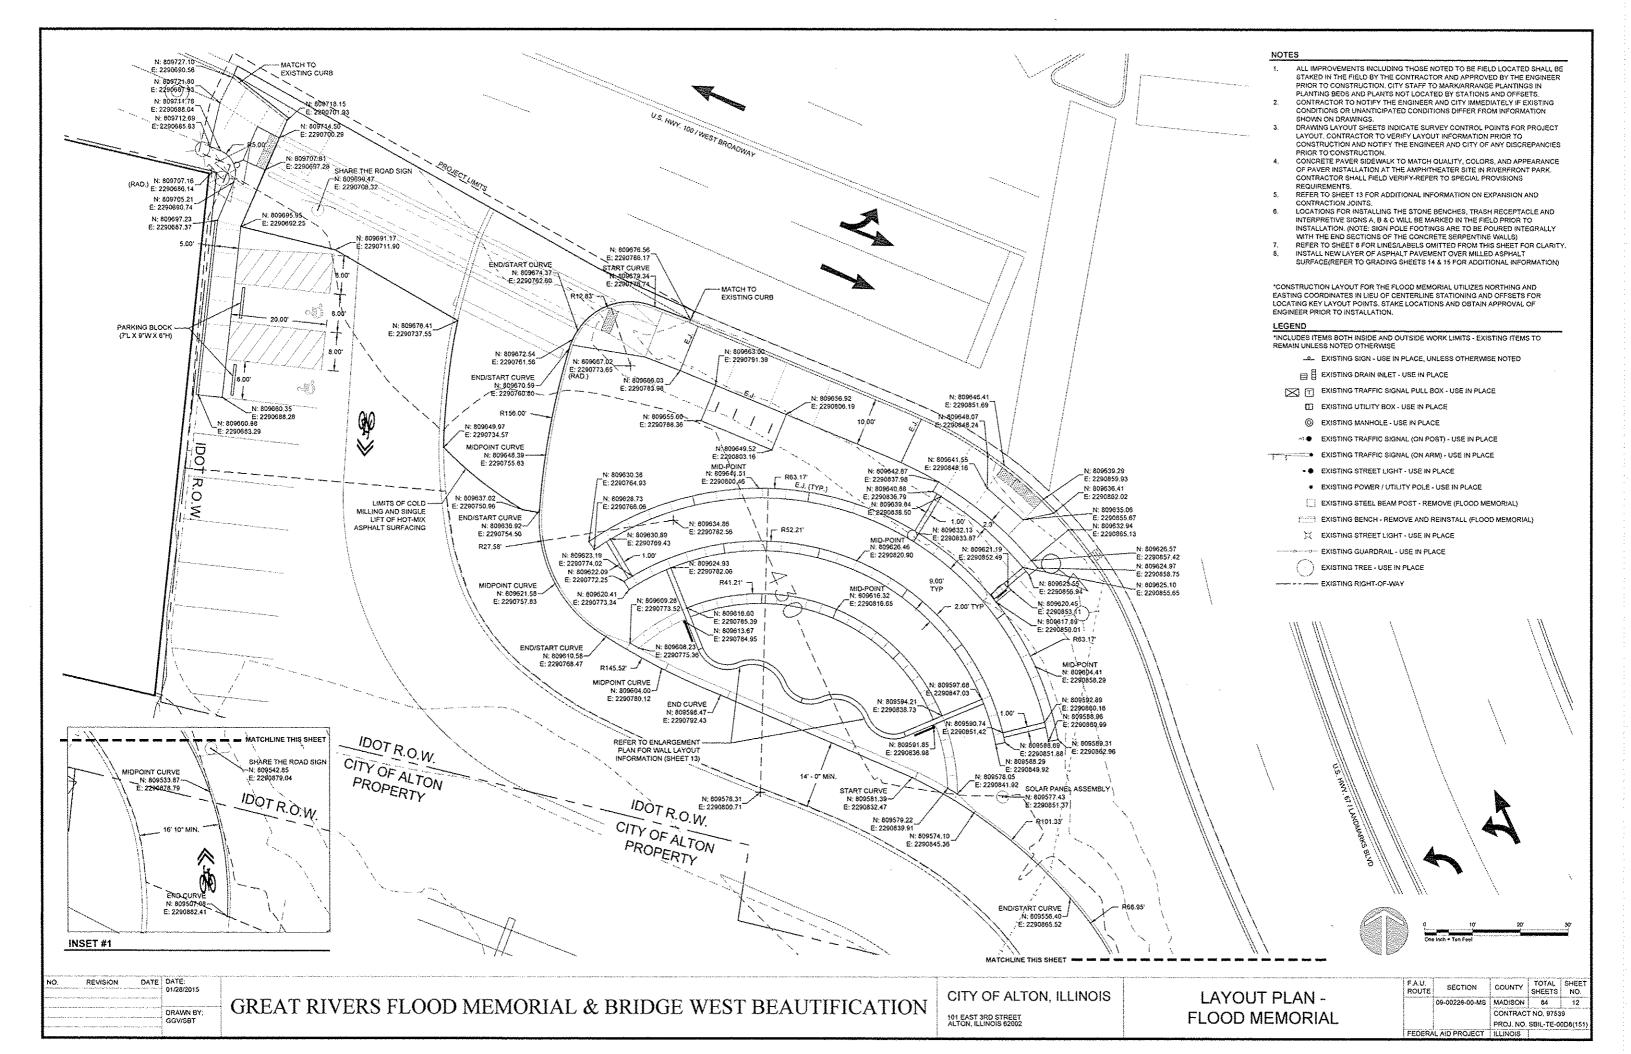

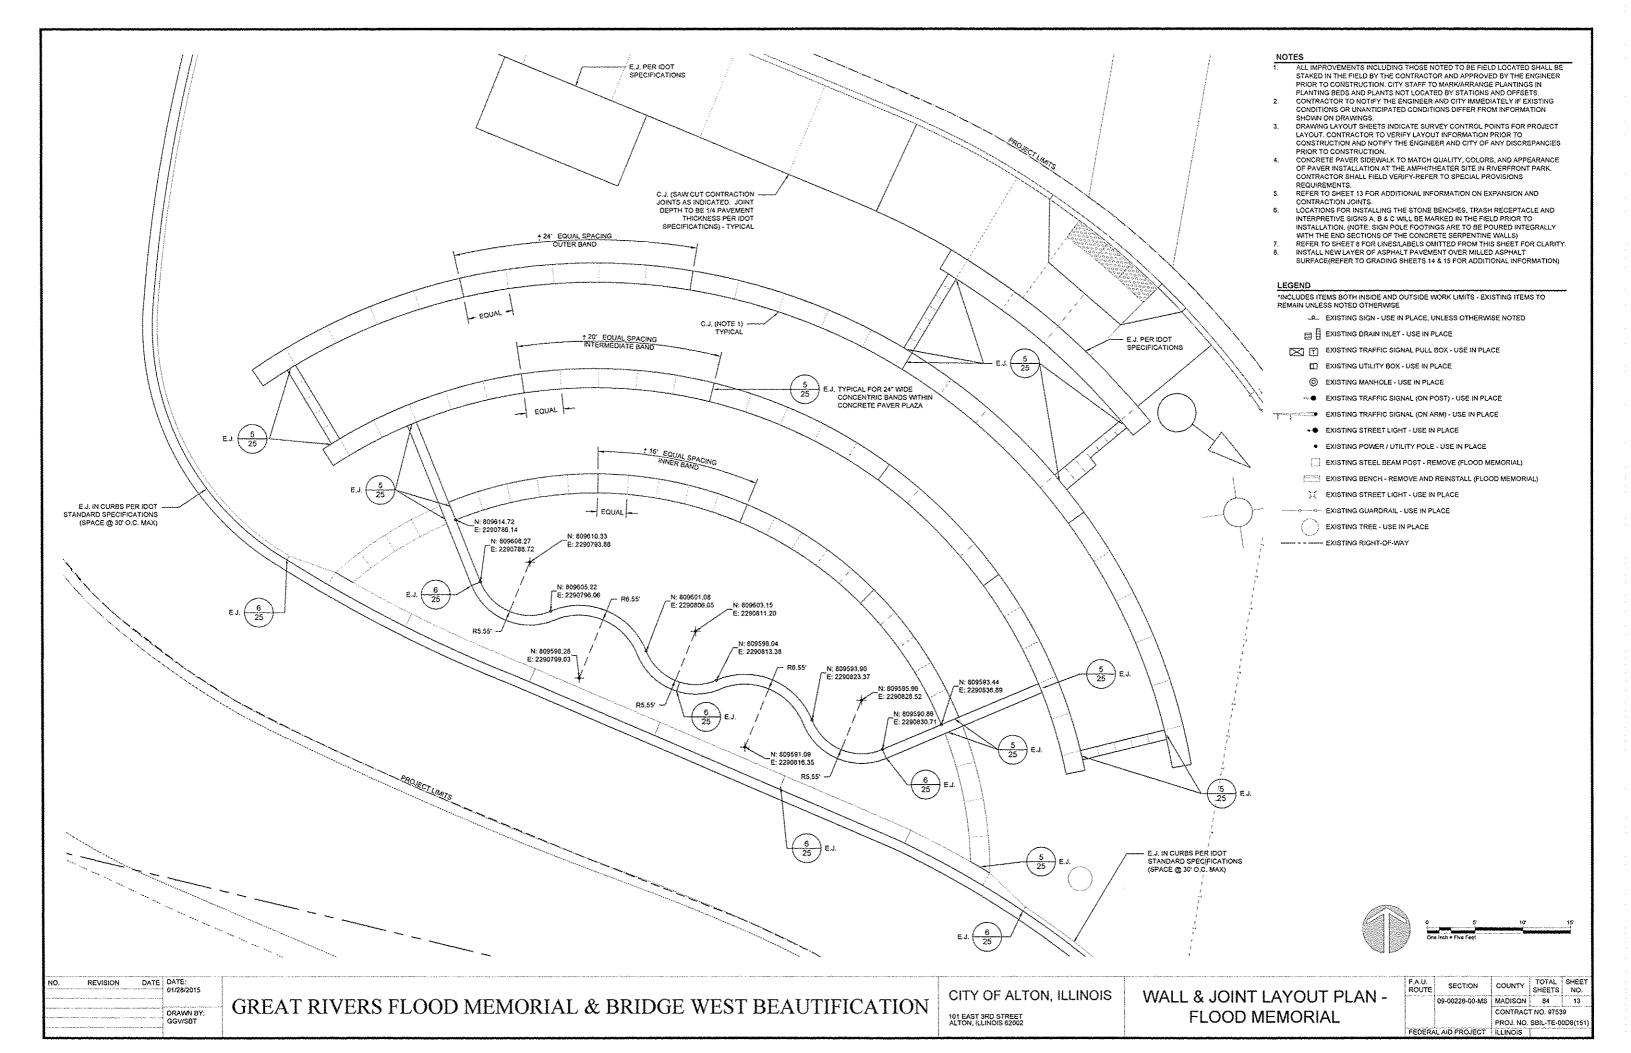

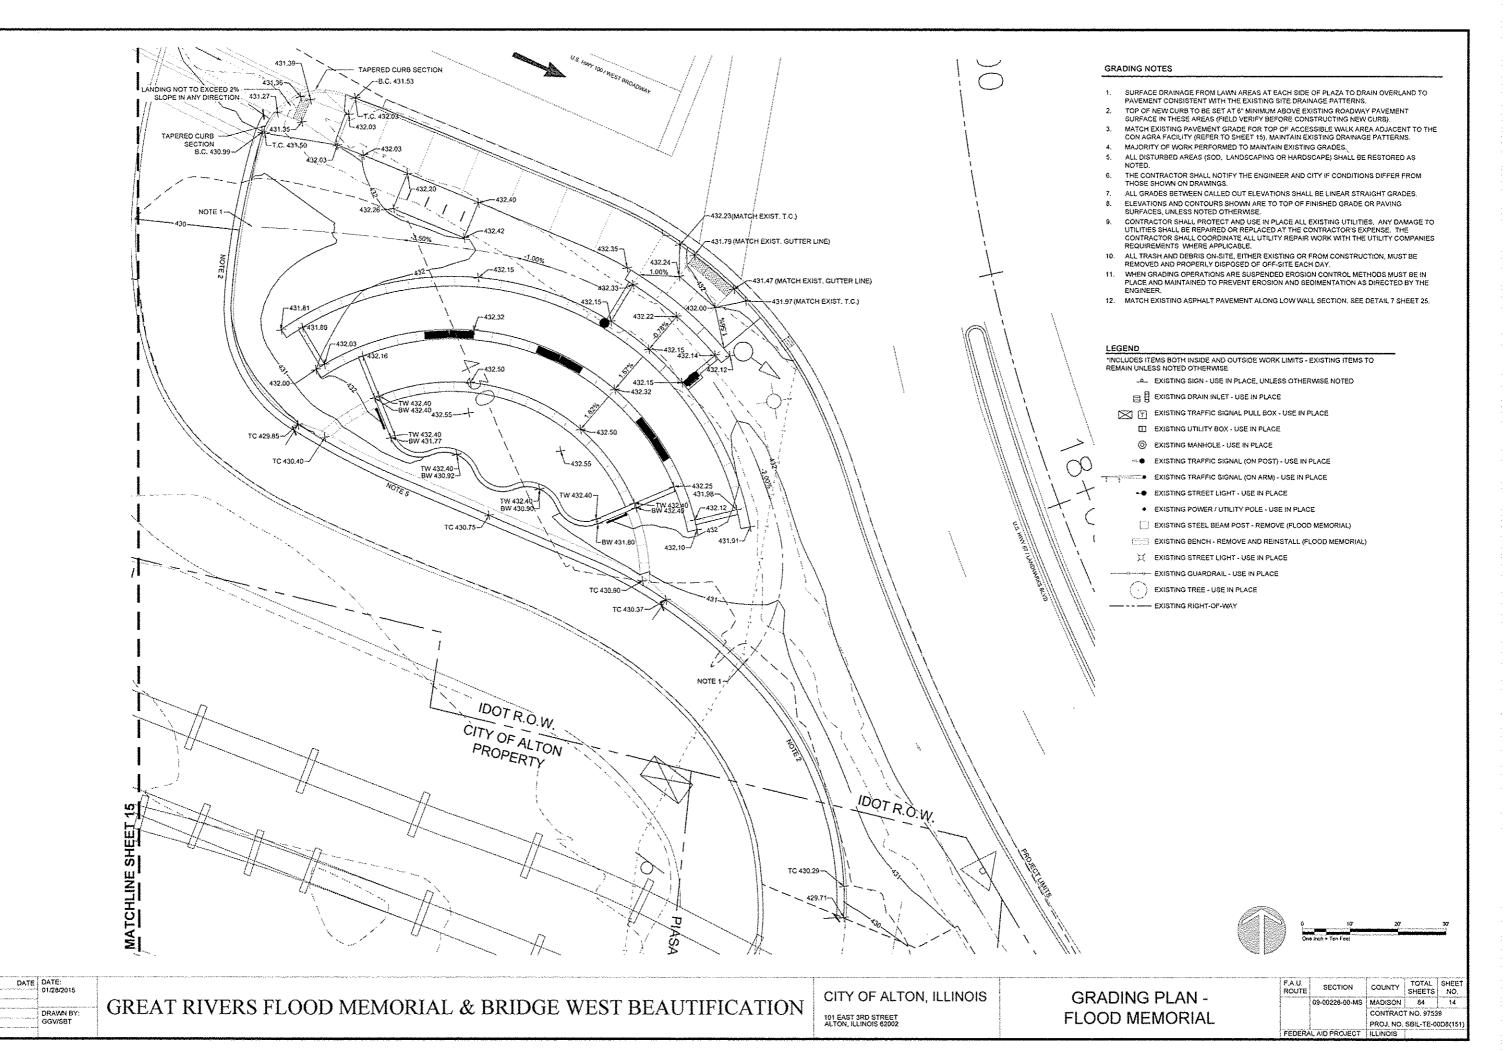

REVISION

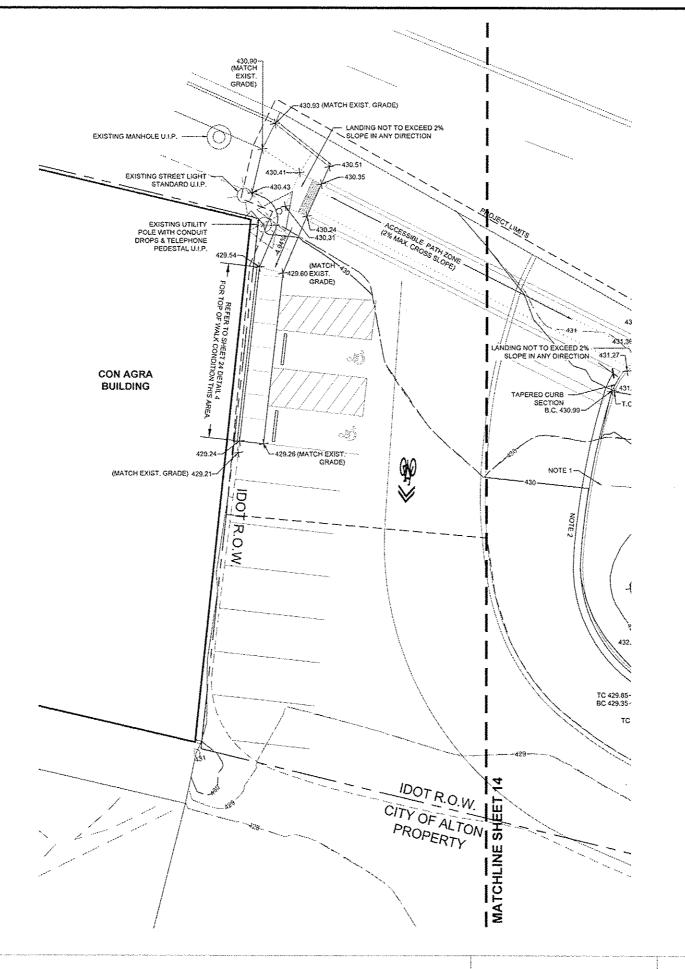

#### **GRADING NOTES**

- SURFACE DRAINAGE FROM LAWN AREAS AT EACH SIDE OF PLAZA TO DRAIN OVERLAND TO PAVEMENT CONSISTENT WITH THE EXISTING SITE DRAINAGE PATTERNS.
- TOP OF NEW CURB TO BE SET AT 6" MINIMUM ABOVE EXISTING ROADWAY PAVEMENT SURFACE IN THESE AREAS (FIELD VERIFY BEFORE CONSTRUCTING NEW CURB).
- MATCH EXISTING PAVEMENT GRADE FOR TOP OF ACCESSIBLE WALK AREA ADJACENT TO THE CON AGRA FACILITY. MAINTAIN EXISTING DRAINAGE PATTERNS.
- MAJORITY OF WORK PERFORMED TO MAINTAIN EXISTING GRADES.
- ALL DISTURBED AREAS (SOD, LANDSCAPING OR HARDSCAPE) SHALL BE RESTORED AS NOTED.
- THE CONTRACTOR SHALL NOTIFY THE ENGINEER AND CITY IF CONDITIONS DIFFER FROM THOSE SHOWN ON DRAWINGS.
- ALL GRADES BETWEEN CALLED OUT ELEVATIONS SHALL BE LINEAR STRAIGHT GRADES.
- ELEVATIONS AND CONTOURS SHOWN ARE TO TOP OF FINISHED GRADE OR PAVING SURFACES, UNLESS NOTED OTHERWISE.
- CONTRACTOR SHALL PROTECT AND USE IN PLACE ALL EXISTING UTILITIES. ANY DAMAGE TO UTILITIES SHALL BE REPAIRED OR REPLACED AT THE CONTRACTOR'S EXPENSE. THE CONTRACTOR SHALL COORDINATE ALL UTILITY REPAIR WORK WITH THE UTILITY COMPANIES
- REQUIREMENTS WHERE APPLICABLE.

  10. ALL TRASH AND DEBRIS ON-SITE, EITHER EXISTING OR FROM CONSTRUCTION, MUST BE REMOVED AND PROPERLY DISPOSED OF OFF-SITE EACH DAY.
- 11. WHEN GRADING OPERATIONS ARE SUSPENDED EROSION CONTROL METHODS MUST BE IN PLACE AND MAINTAINED TO PREVENT EROSION AND SEDIMENTATION AS DIRECTED BY THE ENGINEER.
- 12. MATCH EXISTING ASPHALT PAVEMENT ALONG LOW WALL SECTION, SEE DETAIL 7 SHEET 25,

LEGEND

"INCLUDES ITEMS BOTH INSIDE AND OUTSIDE WORK LIMITS - EXISTING ITEMS TO REMAIN UNLESS NOTED OTHERWISE

- .... EXISTING SIGN USE IN PLACE, UNLESS OTHERWISE NOTED
- E EXISTING DRAIN INLET USE IN PLACE

EXISTING TRAFFIC SIGNAL PULL BOX - USE IN PLACE

- EXISTING UTILITY BOX USE IN PLACE
- @ EXISTING MANHOLE USE IN PLACE
- EXISTING TRAFFIC SIGNAL (ON POST) USE IN PLACE
- EXISTING TRAFFIC SIGNAL (ON ARM) USE IN PLACE
- **◆◆** EXISTING STREET LIGHT USE IN PLACE
- . EXISTING POWER / UTILITY POLE USE IN PLACE
- EXISTING STEEL BEAM POST REMOVE (FLOOD MEMORIAL)
- EXISTING BENCH REMOVE AND REINSTALL (FLOOD MEMORIAL)
- XX EXISTING STREET LIGHT USE IN PLACE
- EXISTING GUARDRAIL USE IN PLACE

---- EXISTING RIGHT-OF-WAY

EXISTING TREE - USE IN PLACE


DATE | DATE: 01/28/2015 DRAWN BY

GREAT RIVERS FLOOD MEMORIAL & BRIDGE WEST BEAUTIFICATION

CITY OF ALTON, ILLINOIS

**GRADING PLAN -**FLOOD MEMORIAL

COUNTY TOTAL SHEET SHEETS NO. SECTION 09-00226-00-MS MADISON 84 15 FEDERAL AID PROJECT ILLINOIS

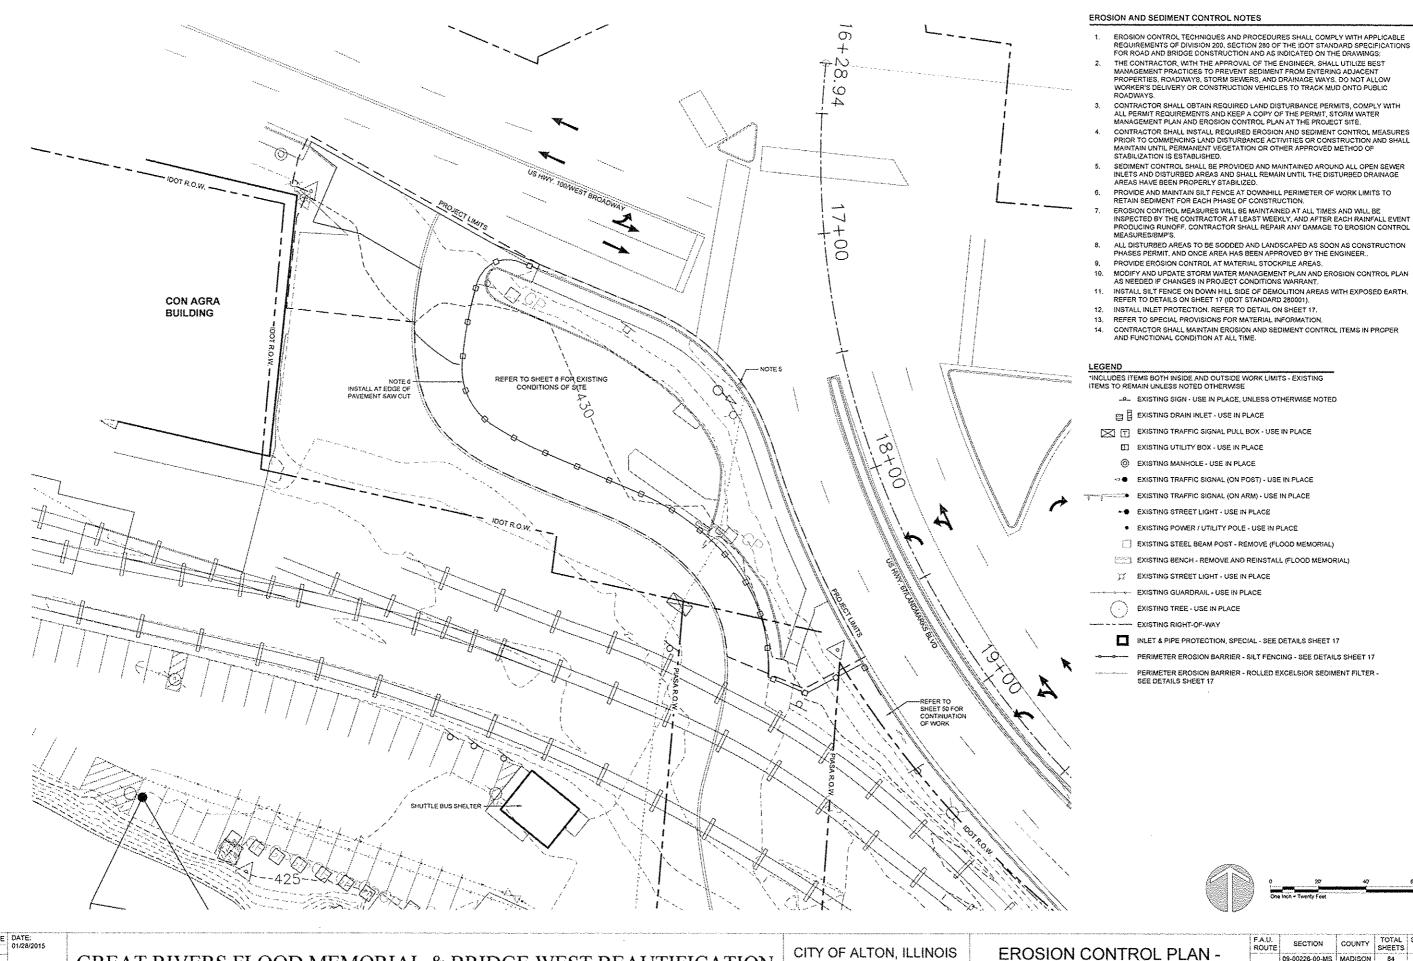

NO. REVISION DATE DATE: 01/28/2015

DRAWN BY: GGV/SBT


GREAT RIVERS FLOOD MEMORIAL & BRIDGE WEST BEAUTIFICATION


CITY OF ALTON, ILLINOIS

101 EAST 3RD STREET
ALTON, ILLINOIS 87002

FLOOD MEMORIAL

 F.A.U. ROUTE	SECTION	COUNTY	TOTAL SHEETS	SHEET NO.
	09-00226-00-MS	MADISON	84	16
		CONTRAC	T NO. 9753	9
		PROJ. NO.	SBIL-TE-0	0D8(151)
FEDERAL AID PROJECT		ILLINOIS	F	

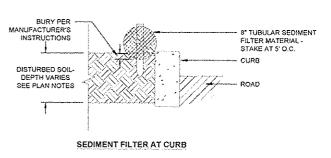


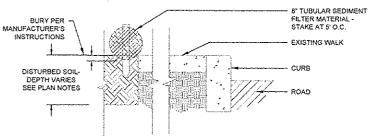

SEDIMENT FILTER AT WALK


PERIMETER EROSION BARRIER -ROLLED EXCELSIOR SEDIMENT FILTER DETAILS  $\binom{2}{17}$ 

NTS

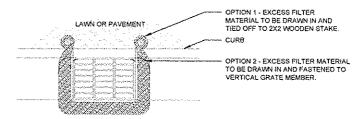

**CURB INLET PROTECTION** 

TYPICAL DRAIN INLET

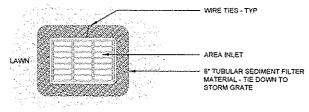

AREA INLET PROTECTION

INLET PROTECTION, SPECIAL - DETAILS - REFER TO PROJECT SPECIAL PROVISIONS  $\left(\begin{array}{c} 3\\17 \end{array}\right)$ 

NTS

REVISION 01/28/2015

**NOT USED** 


GREAT RIVERS FLOOD MEMORIAL & BRIDGE WEST BEAUTIFICATION


CITY OF ALTON, ILLINOIS


101 EAST 3RD STREET ALTON, ILLINOIS 62002

**EROSION CONTROL DETAILS -**FLOOD MEMORIAL

F.A.U. ROUTE COUNTY TOTAL SHEET SHEET NO. SECTION 09-00226-00-MS MADISON 84 17 CONTRACT NO. 97539 PROJ. NO. SBIL-TE-00D8(15 FEDERAL AID PROJECT ILLINOIS

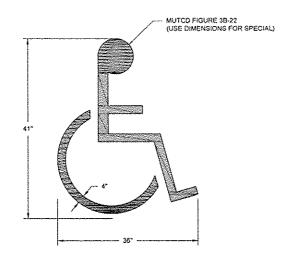

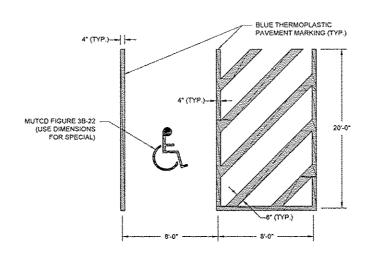

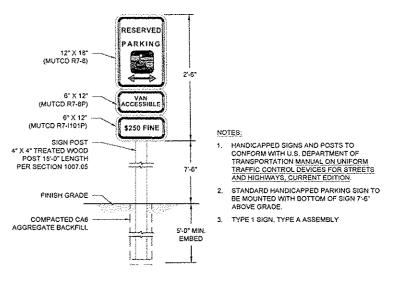

ACCESSIBLE SYMBOL PAVEMENT PARKING
MUTCD FIGURE 38-22

ACCESSIBLE PAVEMENT MARKING PLAN


NTS 3 ACCESSIBLE PARKING SIGN ELEVATION


NTS

25'.0"

24"
1

STOP BAR
THERMOPLASTIC WHITE

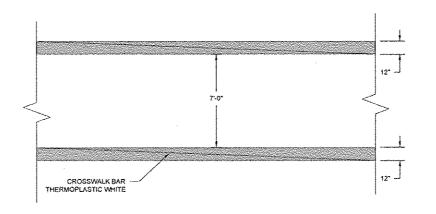

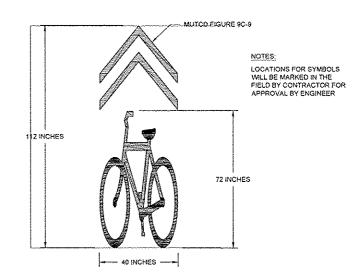


STOP BAR DETAIL

NTS (5) CROSSWALK DETAIL PLAN

6 BICYCLE SHARED LANE SYMBOL

NTS

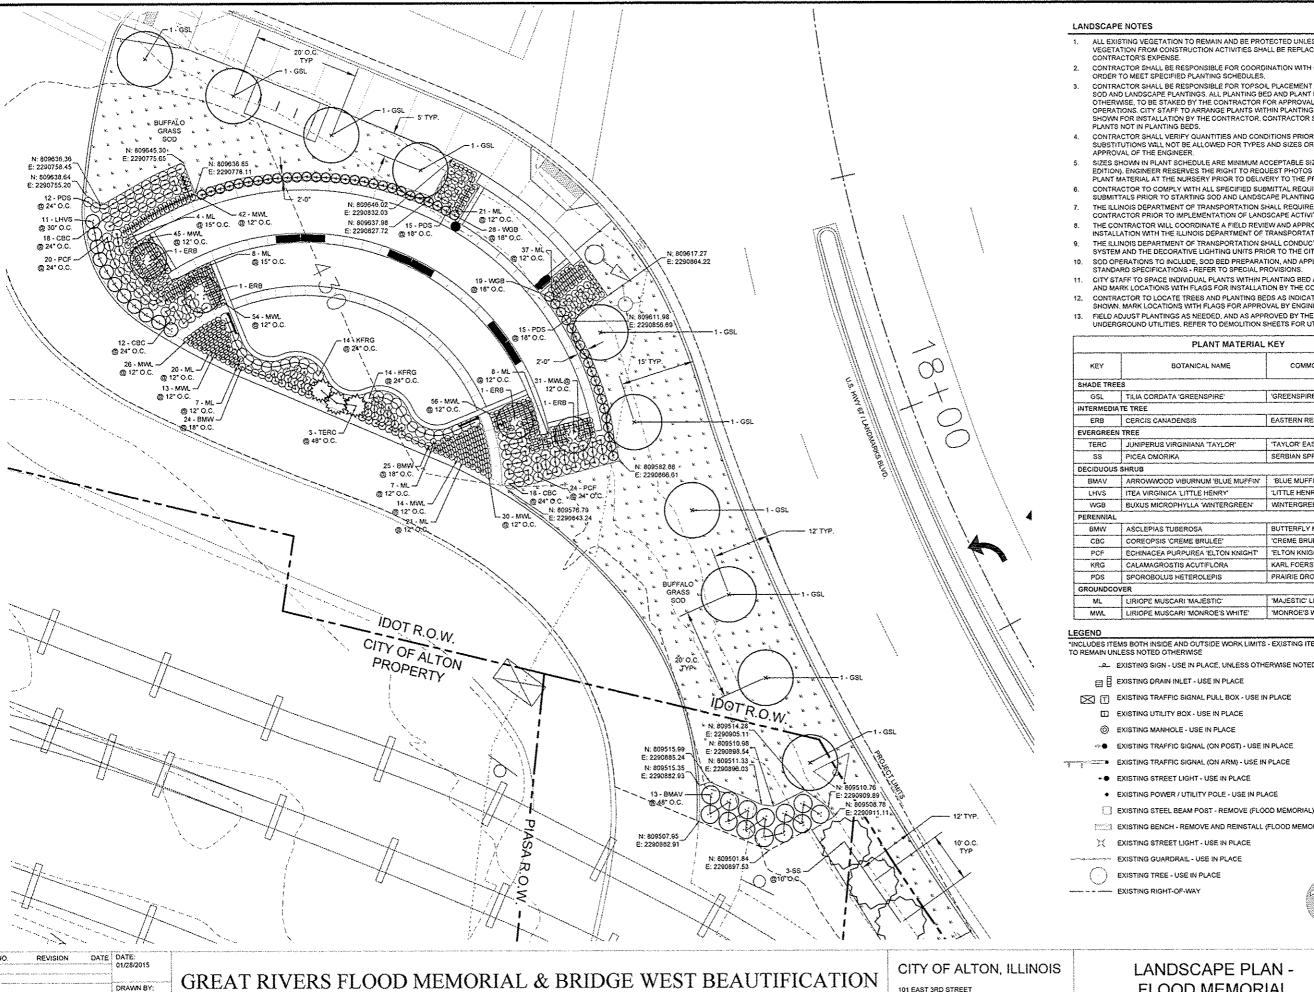

- ALL EXISTING VEGETATION TO REMAIN AND BE PROTECTED UNLESS NOTES OTHERWISE. DAMAGE TO VEGETATION FROM CONSTRUCTION ACTIVITIES SHALL BE REPLACED TO SATISFACTION OF THE OWNER AT
- CONTRACTOR SHALL BE RESPONSIBLE FOR COORDINATION WITH OTHER SITE RELATED CONSTRUCTION IN
- CONTRACTOR SHALL BE RESPONSIBLE FOR TOPSOIL PLACEMENT AND FINAL SHAPING REQUIREMENTS FOR SOD AND LANDSCAPE PLANTINGS. ALL PLANTING BED AND PLANT LOCATIONS, UNLESS INDICATED OTHERWISE, TO BE STAKED BY THE CONTRACTOR FOR APPROVAL BY ENGINEER PRIOR TO LANDSCAPE OPERATIONS. CITY STAFF TO ARRANGE PLANTS WITHIN PLANTING BED AREAS AT THE ON-CENTER SPACING SHOWN FOR INSTALLATION BY THE CONTRACTOR, CONTRACTOR SHALL STAKE LOCATIONS OF INDIVIDUAL PLANTS NOT IN PLANTING BEDS.
- CONTRACTOR SHALL VERIFY QUANTITIES AND CONDITIONS PRIOR TO BIDDING AND IMPLEMENTATION SUBSTITUTIONS WILL NOT BE ALLOWED FOR TYPES AND SIZES OR PLANTS WITHOUT PRIOR WRITTEN
- SIZES SHOWN IN PLANT SCHEDULE ARE MINIMUM ACCEPTABLE SIZES, COMPLY WITH ANSI Z60.1 (CURRENT EDITION), ENGINEER RESERVES THE RIGHT TO REQUEST PHOTOS OF TAGGED PLANTS AND/OR INSPECT PLANT MATERIAL AT THE NURSERY PRIOR TO DELIVERY TO THE PROJECT SITE.
- CONTRACTOR TO COMPLY WITH ALL SPECIFIED SUBMITTAL REQUIREMENTS AND OBTAIN APPROVED SUBMITTALS PRIOR TO STARTING SOD AND LANDSCAPE PLANTING WORK.
- THE ILLINOIS DEPARTMENT OF TRANSPORTATION SHALL REQUIRE 48 HOURS ADVANCE NOTICE FROM CONTRACTOR PRIOR TO IMPLEMENTATION OF LANDSCAPE ACTIVITIES.
- THE CONTRACTOR WILL COORDINATE A FIELD REVIEW AND APPROVAL OF THE IRRIGATION SYSTEM INSTALLATION WITH THE ILLINOIS DEPARTMENT OF TRANSPORTATION.
- THE ILLINOIS DEPARTMENT OF TRANSPORTATION SHALL CONDUCT A FINAL INSPECTION OF THE IRRIGATION SYSTEM AND THE DECORATIVE LIGHTING UNITS PRIOR TO THE CITY OF ALTON APPROVING THESE ITEMS.
- SOD OPERATIONS TO INCLUDE, SOD BED PREPARATION, AND APPLICATION OF FERTILIZER PER IDOT
- CITY STAFF TO SPACE INDIVIDUAL PLANTS WITHIN PLANTING BED AREAS AT ON-CENTER SPACING INDICATED AND MARK LOCATIONS WITH FLAGS FOR INSTALLATION BY THE CONTRACTOR.
- CONTRACTOR TO LOCATE TREES AND PLANTING BEDS AS INDICATED BY COORDINATES AND DIMENSIONS SHOWN, MARK LOCATIONS WITH FLAGS FOR APPROVAL BY ENGINEER.
- FIELD ADJUST PLANTINGS AS NEEDED, AND AS APPROVED BY THE ENGINEER, FOLLOWING THE STAKING OF UNDERGROUND UTILITIES, REFER TO DEMOLITION SHEETS FOR UTILITY LOCATIONS.

	PLANT MATERIAL	KEY
KEY	BOTANICAL NAME	COMMON NAME
SHADE TRE	ES	
GSL	TILIA CORDATA 'GREENSPIRE'	'GREENSPIRE' LINDEN
INTERMEDI	ATE TREE	
ERB	CERCIS CANADENSIS	EASTERN RED BUD
EVERGREE	N TREE	
TERC	JUNIPERUS VIRGINIANA 'TAYLOR'	'TAYLOR' EASTERN RED CEDAR
SS	PICEA OMORIKA	SERBIAN SPRUCE
DECIDUOUS	SHRUB	
BMAV	ARROWWOOD VIBURNUM 'BLUE MUFFIN'	BLUE MUFFIN' ARROWWOOD VIBURNUM
LHVS	ITEA VIRGINICA 'LITTLE HENRY'	"LITTLE HENRY" SWEETSPIRE
WGB	BUXUS MICROPHYLLA 'WINTERGREEN'	WINTERGREEN LITTLELEAF BOXWOOD
PERENNIAL	-	
BMW	ASCLEPIAS TUBEROSA	BUTTERFLY MILKWEED
CBC	COREOPSIS 'CREME BRULEE'	'CREME BRULEE' COREOPSIS
PCF	ECHINACEA PURPUREA 'ELTON KNIGHT'	'ELTON KNIGHT' PURPLE CONEFLOWER
KRG	CALAMAGROSTIS ACUTIFLORA	KARL FOERSTER FEATHER REED GRASS
PDS	SPOROBOLUS HETEROLEPIS	PRAIRIE DROPSEED
GROUNDCO	OVER	
ML	LIRIOPE MUSCARI MAJESTIC	'MAJESTIC' LIRIOPE
MVA	LIRIOPE MUSCARI MONROE'S WHITE'	'MONROE'S WHITE' LIRIOPE

"INCLUDES ITEMS BOTH INSIDE AND OUTSIDE WORK LIMITS - EXISTING ITEMS

... EXISTING SIGN - USE IN PLACE, UNLESS OTHERWISE NOTED

→ ● EXISTING TRAFFIC SIGNAL (ON POST) - USE IN PLACE

=200 EXISTING TRAFFIC SIGNAL (ON ARM) - USE IN PLACE

■ EXISTING STREET LIGHT - USE IN PLACE


EXISTING BENCH - REMOVE AND REINSTALL (FLOOD MEMORIAL






LANDSCAPE PLAN -FLOOD MEMORIAL

 F.A.U. ROUTE	SECTION	COUNTY	TOTAL SHEETS	SHEE NO.
	09-00226-00-MS	MADISON	84	19
		CONTRAC	of the promoted states and a feet	9
}		PROJ. NO.	SBIL-TE-0	QD8(15
FEDERA	L AID PROJECT	ILLINOIS	5	

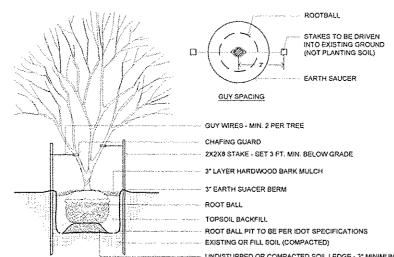

UNDISTURBED OR COMPACTED SOIL LEDGE - 3" MINIMUN INTERMEDIATE TREE PLANTING  $\frac{1}{20}$ SECTION

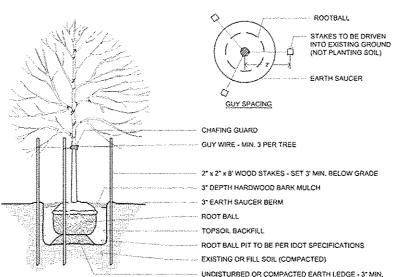


PRUNE TIPS TO ACHIEVE ACCEPTABLE FORM (ONLY AS DIRECTI 3" LAYER HARDWOOD BARK MULCH

SHADE TREE PLANTING PLAN & SECTION

FINISHED GRADE

08a-004

**EVERGREEN TREE PLANTING** 

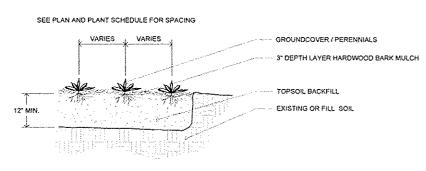

ENTIRE BED AREA SHALL BE PREPARED IN ACCORDANCE WITH SPECIFICATIONS.

**GROUNDCOVER AND PERENNIAL PLANTING**  $\left(\frac{4}{20}\right)$ SECTION



PLANT MATERIAL SCHEDULE

EXISTING OR FILL SOIL (COMPACTED)

ROOT BALL PIT TO BE PER IDOT SPECIFICATIONS

UNDISTURBED OR COMPACTED SOIL LEDGE - 3" MIN

GUY WIRE - MIN. 3 PER TREE.

3 - 2"X2"X24" WOOD STAKES

TOPSOIL BACKFILL.

ROOT BALL.

GUY SPACING

		TEMAT HIM TENIME SCITEDUEL				
KEY	BOTANICAL NAME	COMMON NAME	MATURE HT.	MATURE SPREAD	SIZE & CONDITION	TOTAL
SHADE TRE	E				****	·
GSL	TILIA CORDATA 'GREENSPIRE'	'GREENSPIRE' LINDEN	50'	35'	2" CAL, 8&8	10
INTERMEDIA	ATE TREE					
ERB	CERCIS CANADENSIS	EASTERN RED BUD	20"	25'	2" CAL, B&B	4
EVERGREEN	V TREE		·	······································		
TERC	JUNIPERUS VIRGINIANA 'TAYLOR'	'TAYLOR' EASTERN RED CEDAR	15'	5'	6" HT. B&B	3
\$8	PICEA OMORIKA	SERBIAN SPRUCE	40'	15'	8" HT. 8&B	3
DECIDUOUS	SHRUB		A.,	·	*	·
BMAV	VIBURNUM DENTATUM 'BLUE MUFFIN'	'BLUE MUFFIN' ARROWWOOD VIBURNUM	5'	4'	2' HT. CONT.	13
LHVS	ITEA VIRGINICA 'LITTLE HENRY'S'	"LITTLE HENRY'S" VIRGINIA SWEETSPIRE	2"	2.5	S.OSI DOT	11
WGB	BUXUS MICROPHYLLA "WINTERGREEN"	WINTERGREEN LITTLELEAF BOXWOOD	4'	5'	Z' HT. CONT.	47
PERENNIAL			l	·	L	
BMW	ASCLEPIAS TUBEROSA	BUTTERFLY MILKWEED	2.5'	1.5*	QT. POT	49
CBC	COREOPSIS 'CREME BRULEE'	'CREME BRULEE' COREOPSIS	1.5'	3,	QT. POT	48
KRG	CALAMAGROSTIS ACUTIFLORA	KARL FOERSTER FEATHER REED GRASS	5'	2.5'	2-GAL POT	28
PCF	ECHINACEA PURPUREA 'ELTON KNIGHT'	'ELTON KNIGHT' PURPLE CONEFLOWER	2'	1,5'	QT, POT	44
PDS	SPOROBOLUS HETEROLEPIS	PRAIRIE DROPSEED	3'	3'	1-GAL POT	42
GROUNDCO	VER	<u></u>	<del></del>	L	L	L
ΜŁ	LIRIOPE X MUSCARI MAJESTIC	'MAJESTIC' LIRIOPE	1.5'	1.5	1-GAL POT	133
MWL	LIRIOPE MUSCARI 'MONROE'S WHITE'	'MONROE'S WHITE' LIRIOPE	1.5'	1.5'	1-GAL POT	311
SEED - BUF	FALOGRASS (5,165 SF)	**************************************		•	*	·
	REFER TO SPECIFICATIONS	1			[	574 81


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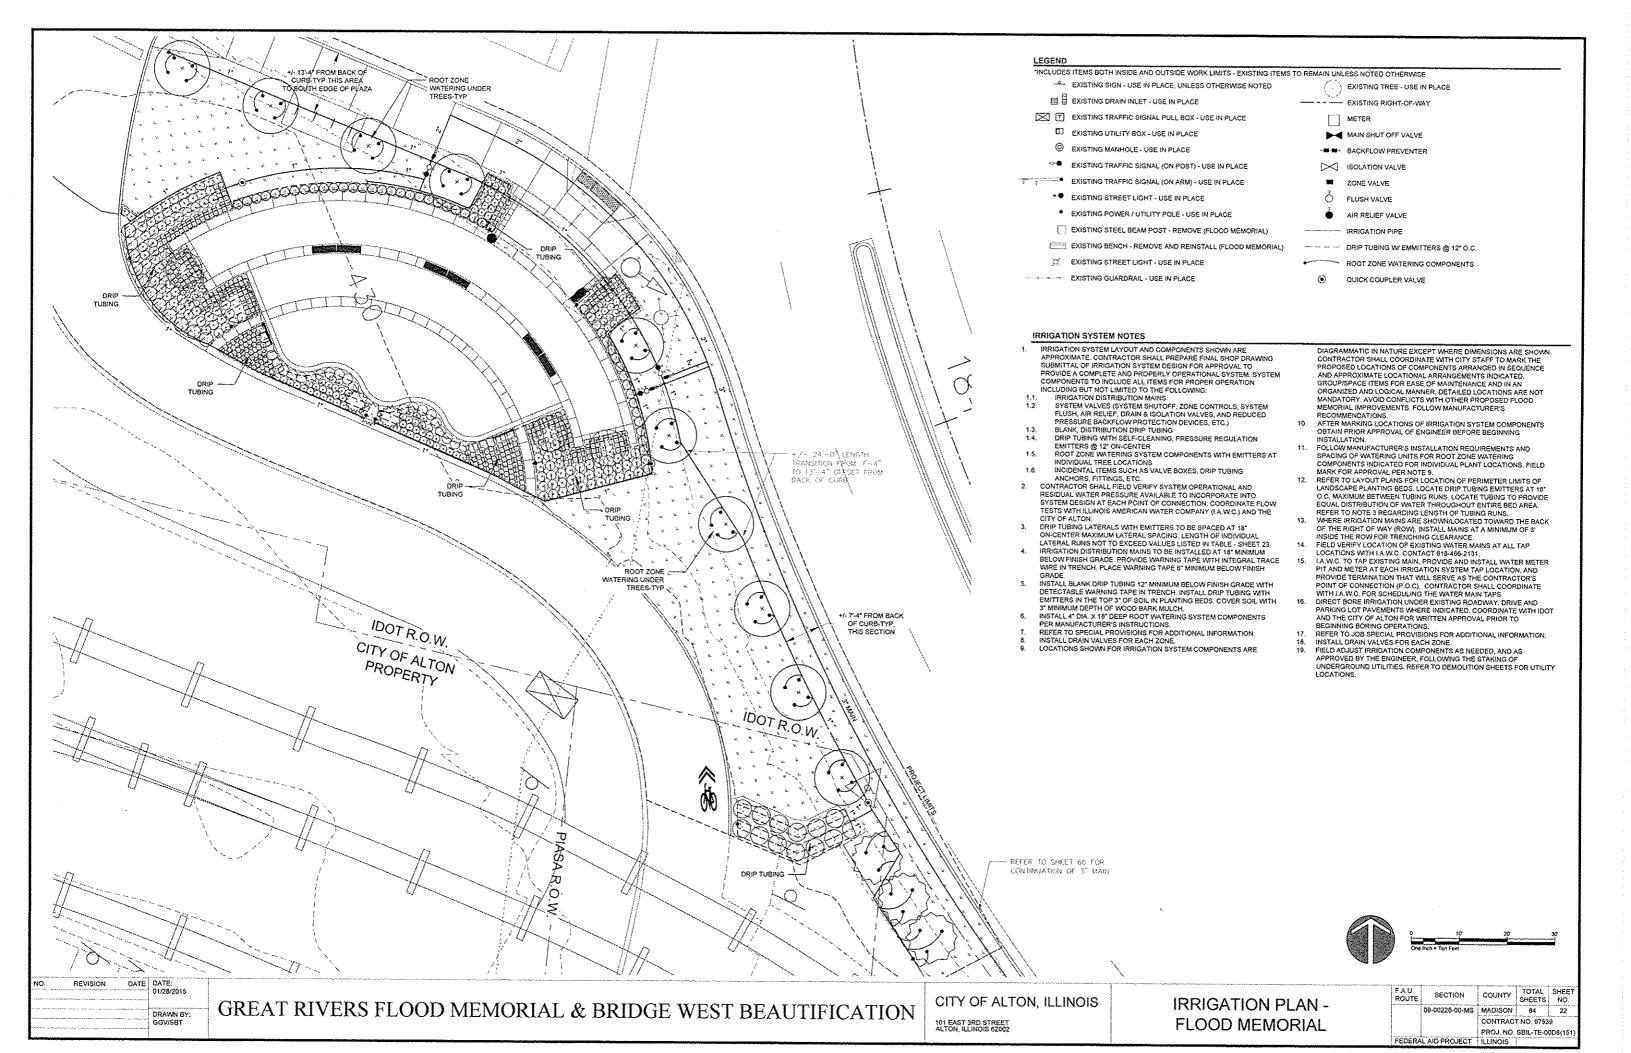
GREAT RIVERS FLOOD MEMORIAL & BRIDGE WEST BEAUTIFICATION


CITY OF ALTON, ILLINOIS


LANDSCAPE DETAILS -FLOOD MEMORIAL


_	F.A.U. ROUTE	SECTION	COUNTY	TOTAL SHEETS	SHEET NO.
		09-00226-00-MS	MADISON	84	20
			CONTRAC	T NO. 9753	9
			PROJ. NO.	SBIL-TE-0	0D8(151)
	FEDERA	AID PROJECT	ILLINOIS		




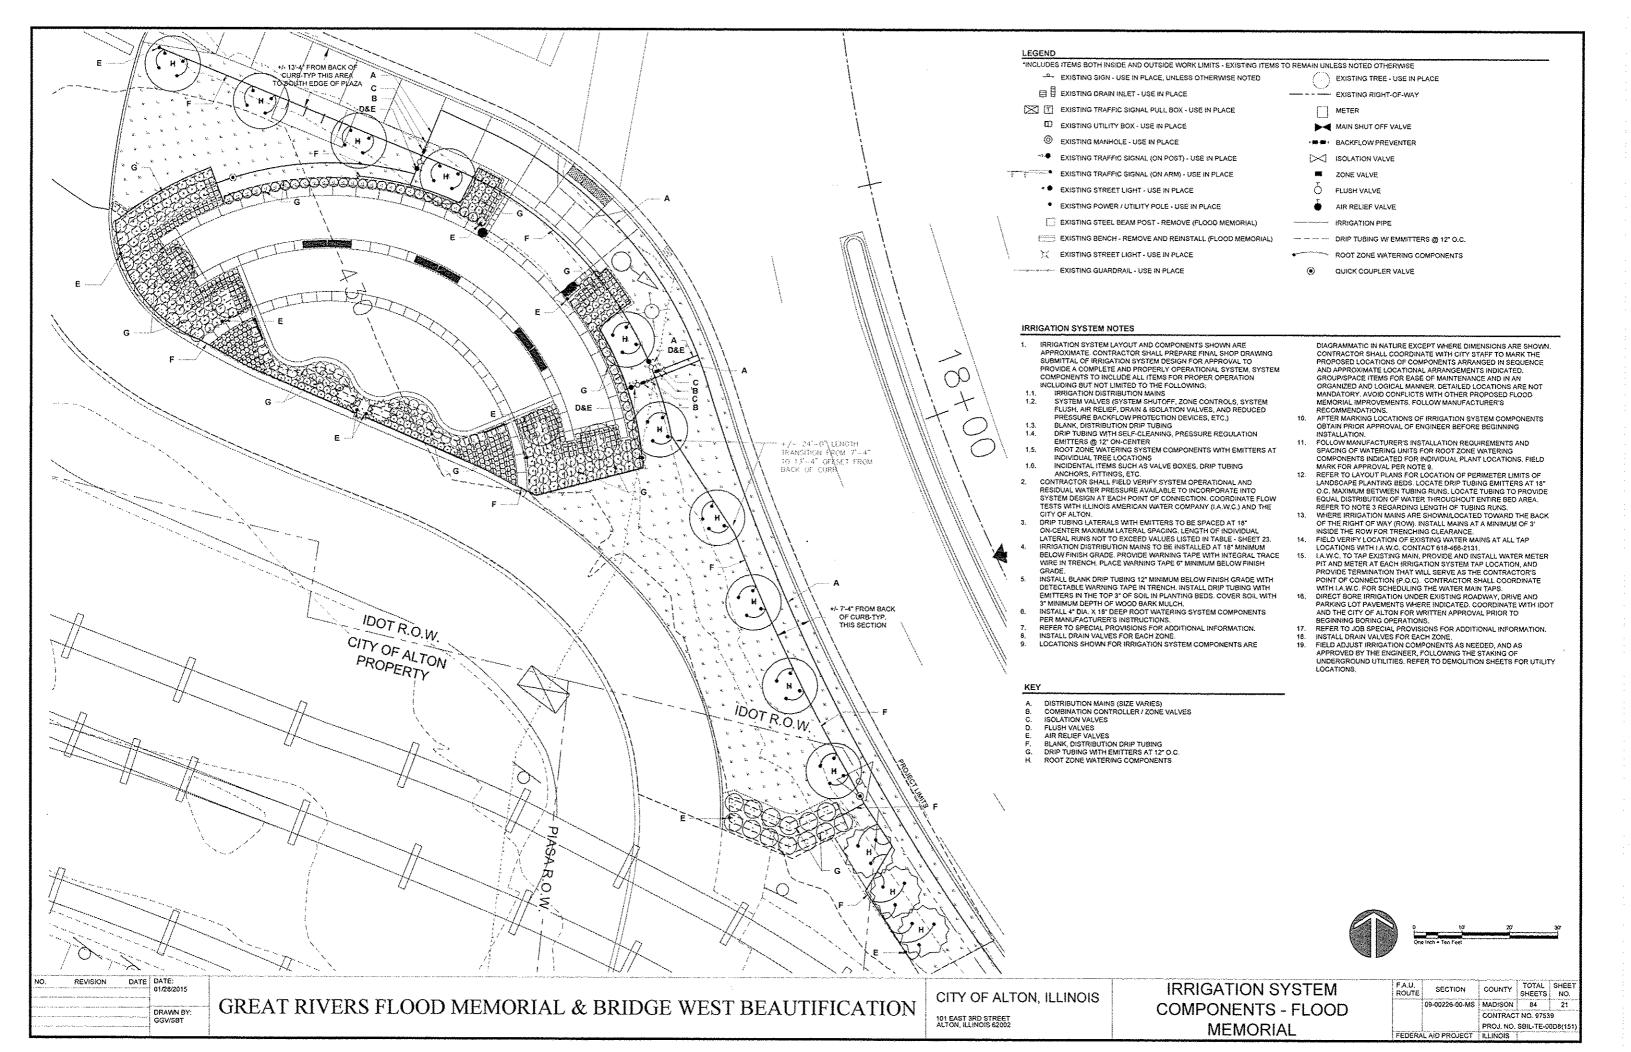

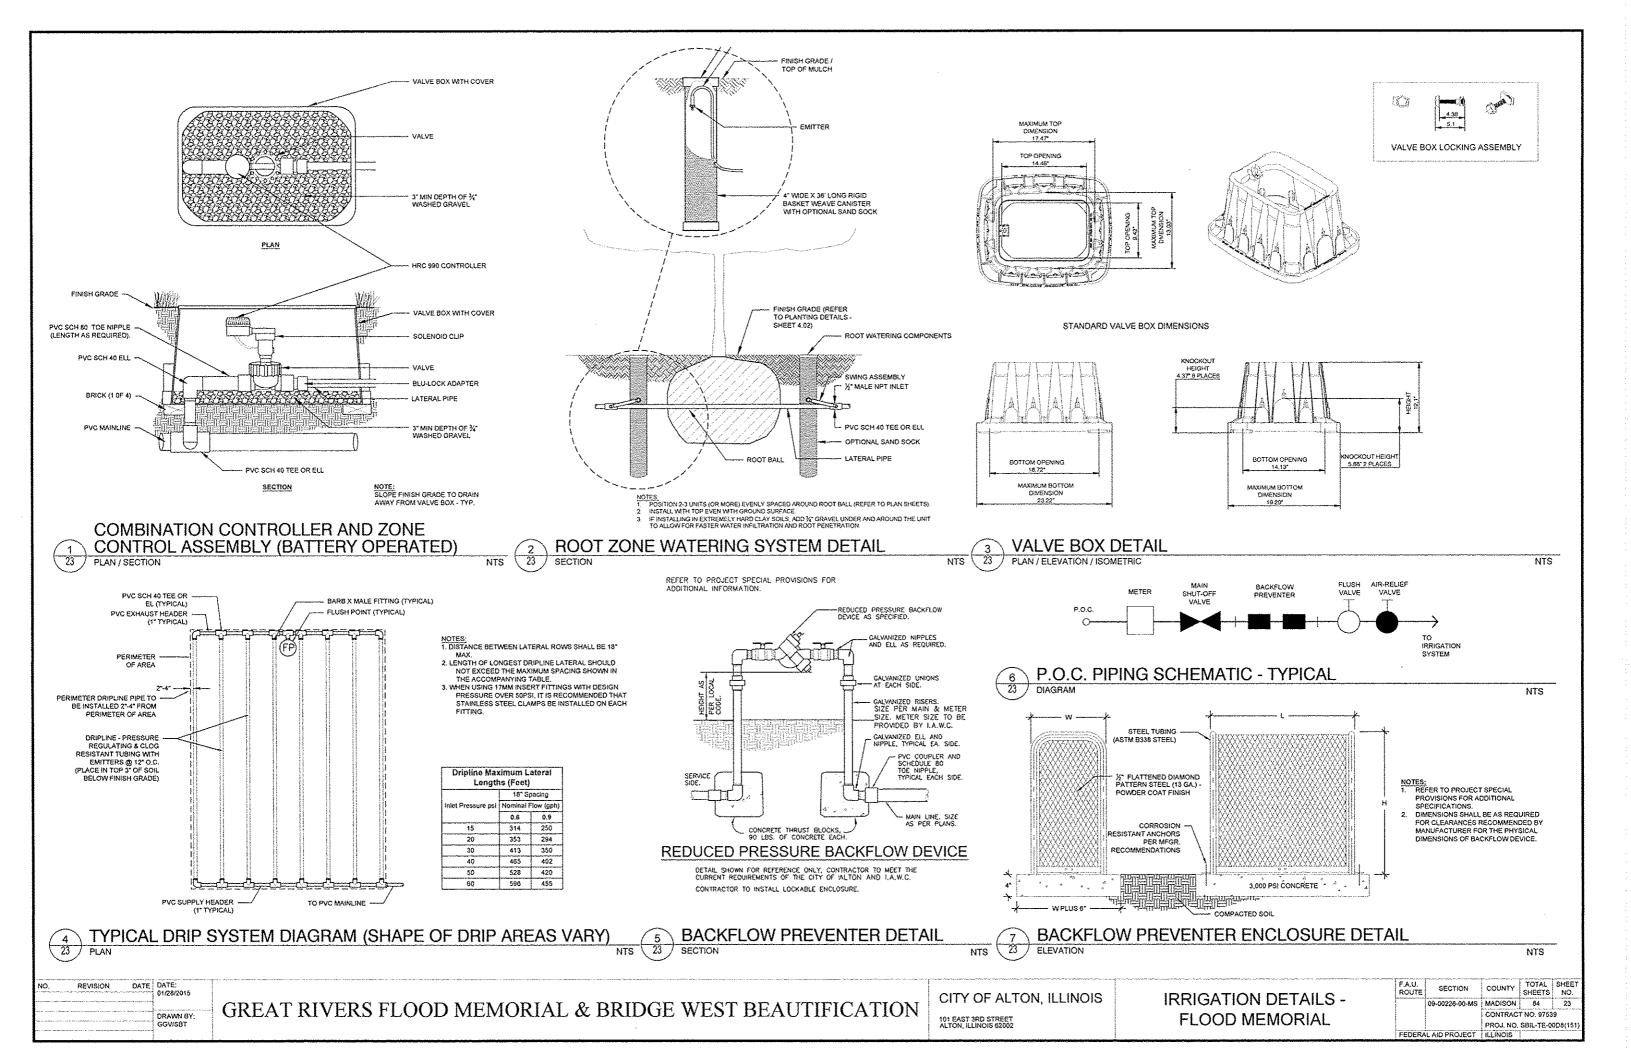

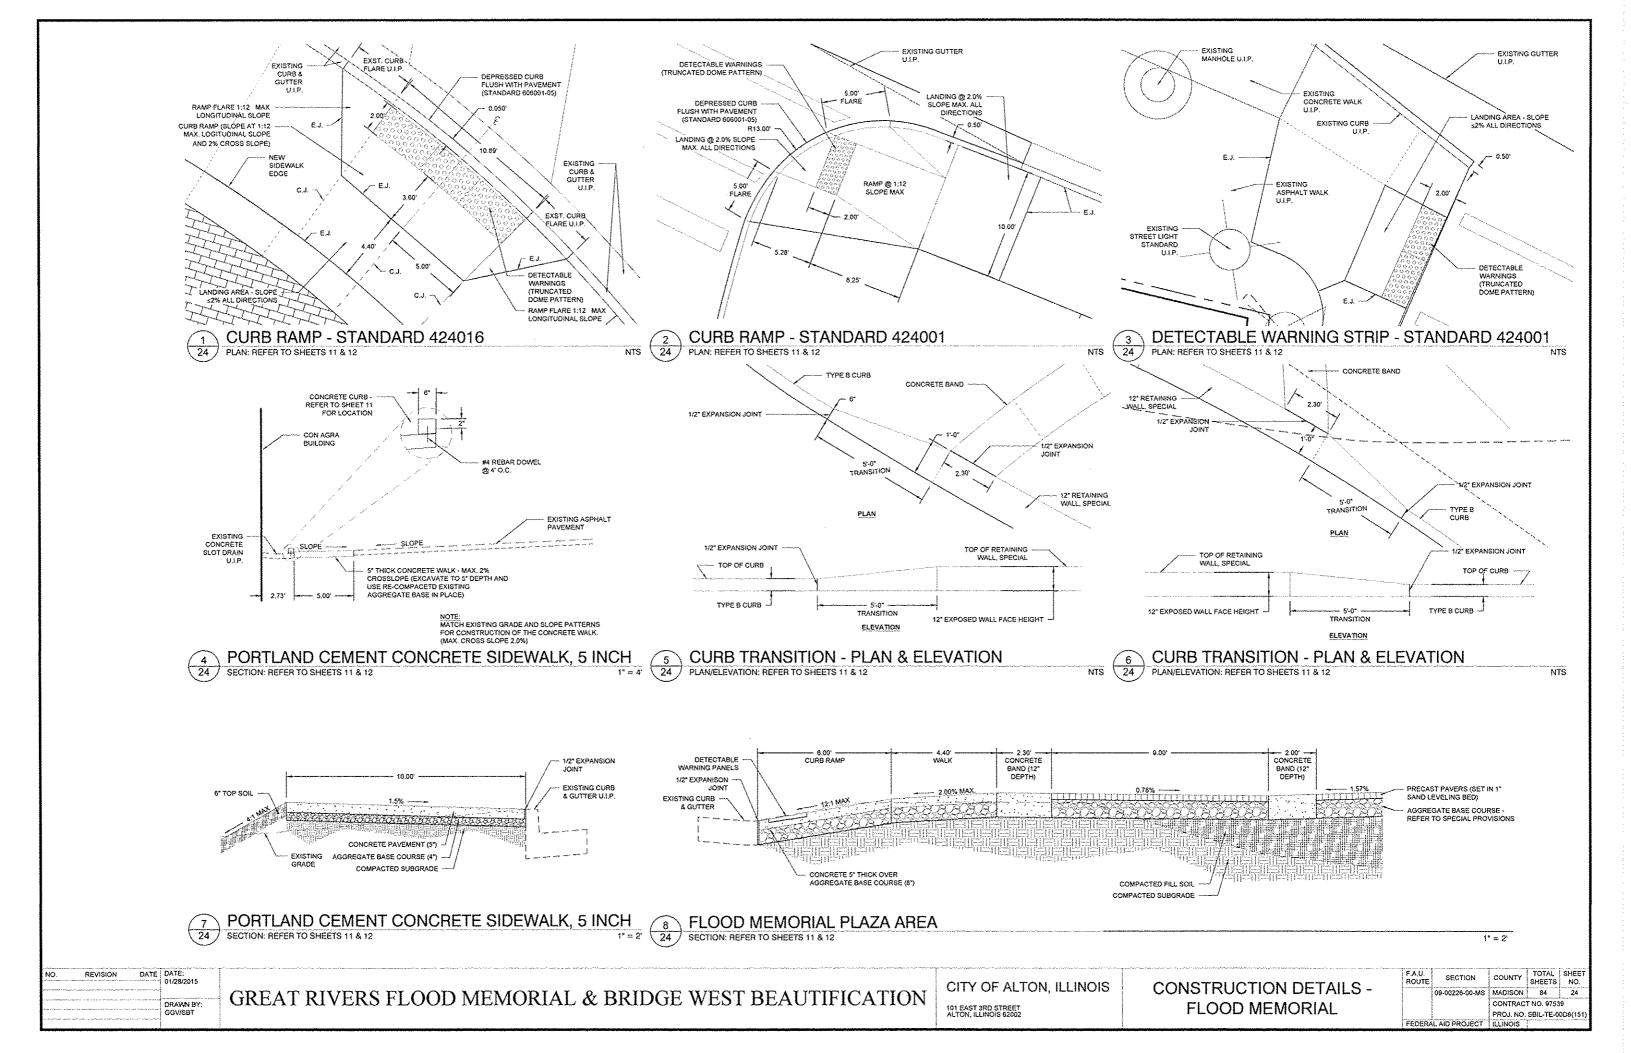

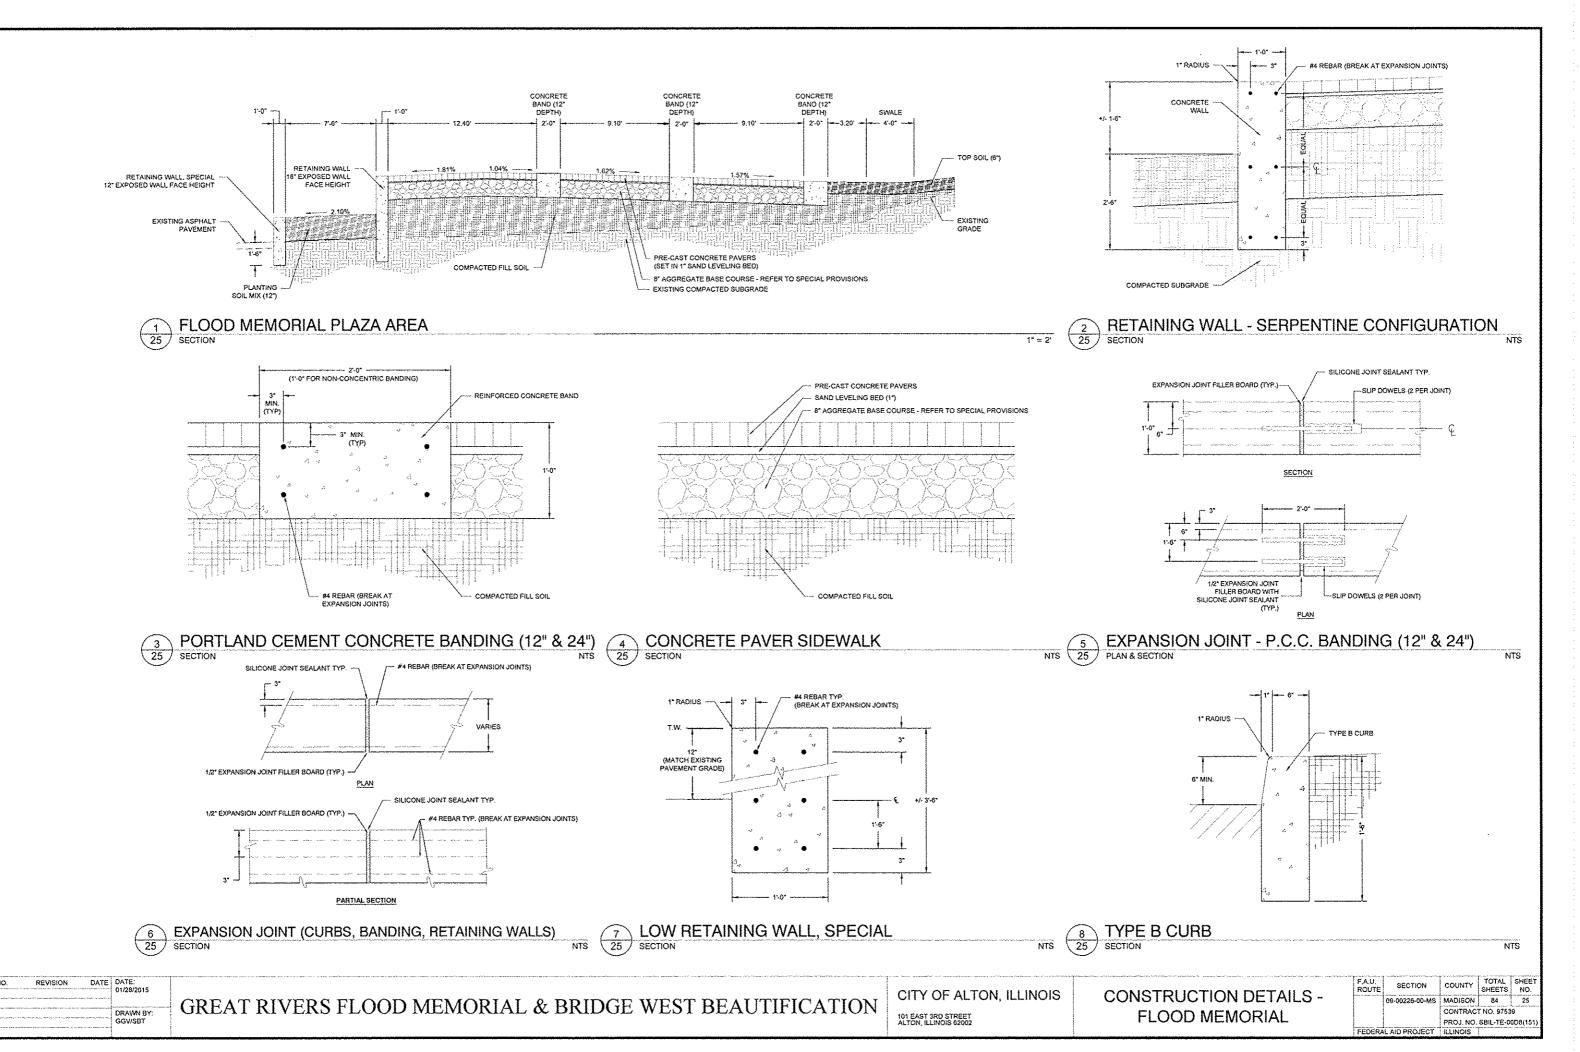

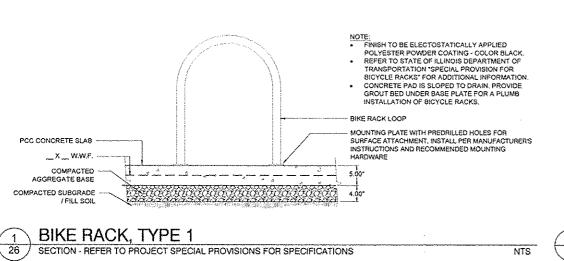

SURFACE MOUNTING
PER MANUFACTURER
RECOMMENDATIONS

TRASH R

STANDAM

TRASH R

STANDAM

TRASH R


STANDAM

TRASH R

TRASH R

TRASH R

TRASH R

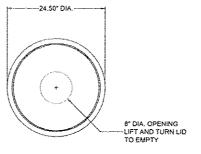

- TRASH RECEPTACLES SHALL BE BY LANDSCAPEFORMS, SCARBOROUGH SERIES, 25° W X 33° H, TOP OPENING LID, VERTICAL STRAP BODY STYLE, WITH 30 GAL, LINER ANCHOR HARDWARE PER MANUFACTURER'S RECUIREMENT OR APPROVED EQUIAL
- FINISH TO BE ELECTROSTATICALLY APPLIED POLYESTER POWDER COATING - COLOR BLACK.

- LOW SERPENTINE WALL

4'-0" X 6'-0" X 3/4" THICK PHENOLIC RESIN PANELS MOUNTED TO POLE STRUCTURE

2 1/2" x 2 1/2" x 4' STEEL TUBING (NOTE 1).

LED STRIP LIGHT

NTS

2 26 TR/ ELEVA

TRASH RECEPTACLE

ELEVATION & PLAN - REFER TO PROJECT SPECIAL PROVISIONS FOR SPECIFICATIONS

NOTE:
BENCHES TO BE LIMESTONE TO MATCH COLOR, SIZE, AND
SHAPE OF THE EXISTING STONE BENCHES LOCATED AT
THE ALTON RIVERFRONT PARK (FIELD VERIFY).

84 REBAR DOWEL, 6\* LONG
W 4\* GROUTED EMBED IN
BENCH & CONCRETE
PLAZA BAND (THREE PER
BENCH)
SMOOTH FINISH

1/4\*

R 2\* (TYP.)

1.50\*

ROUGH FINISH
ON FOUR SIDES
CONCRETE SLAB
PLAN

SECTION

BENCH

26 PLAN / SECTION - REFER TO PROJECT SPECIAL PROVISIONS FOR SPECIFICATIONS
3° DIA. STEEL POLE STRUCTURE (NOTE 1)
CABLE TIE-DOWNS

NON-REINFORCED CONCRETE PAD (NOTE 4)

PHENOLIC RESIN PANEL (NOTE 3)
3° RADIUS

3° DIA. STEEL POLE - POLE SUPPORTS STRUCTURE (NOTE 1)

1" x 9" x 3"-6" x 3/4" THICK PHENOLIC

RESIN INTERPRETIVE PANEL AT A

(NOTE 3)

OF EXISTING SIGNS)

2' x 4' x 6" DEEP NON-REINFORCED CONCRETE PAD CONCRETE PAD (NOTE 4)

NOTE:
CONTRACTOR TO FIELD VERIFY ALL DIMENSIONS
FOR EXISTING SIGN TYPE "C"

3" DIA. STEEL POLE CAP
STRUCTURE W/ DECORATIVE
CABLE ACCENT
1' x 9' x 3'-6' x 1/2' THICK
PHENOLIC RESIN
INTERPRETIVE PANEL AT A
DIA. STEEL POLE CAP

9 3/4

2'-4"

1' x 9' x 3'-6' x 1/2" THICK
PHENCIC RESIN
INTERPETIVE PANEL AT A
30 DEGREE ANGLE
(1 REQUIRED)
3" RADIUS

2'-2 5/8"


4 EXPANSION ANCHORS
(MATCH SIZE OF
EXISTING SIGNS)

9" DIA, X 2 1/4" STEEL COLLAR

(MATCH SIZE OF EXISTING SIGNS)

2" X 4" X 6" DEEP NON-REINFORCED CONCRETE PAD

5 INTERPRETIVE SIGN (C) - REFER TO SHEET 28 (PHOTOS)
ELEVATION & PLAN

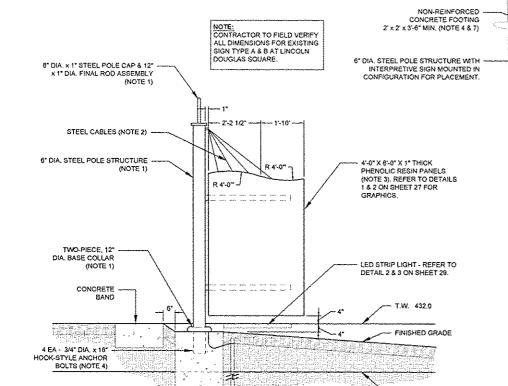

NOTES - INTERPRETIVE SIGN SYSTEM, COMPLETE:

- STEEL POST STRUCTURE AND SUPPORT MEMBERS SHALL COMPLY WITH DOT STANDARD SPECIFICATIONS FOR ROAD AND GRIDGE CONSTRUCTION - DIVISION 1000: SECTION 1006.04. STAINLESS STEEL HARDWARE SHALL COMPLY WITH SECTIONS 1006.29 AND 1006.32.
- 1.1. FINISHES SHALL BE THERMOSET POLYESTER POWDER COATING, COMPLY WITH AMERICAN ARCHITECTURAL MANUFACTURERS ASSOCIATION - AMMA SPECIFICATION 2604 FOR ARCHITECTURAL POWDER COATINGS. COLOR SHALL BE GRAY TO MATCH THE EXISTING INTERPRETIVE SIGNS. CONTRACTOR SHALL FIELD VERIFY AND MATCH THE COLOR.
- 1.2. STRUCTURE SHALL BE FABRICATED IN COMPLIANCE WITH DIVISION 500, SECTION 5.05.04, ALL PARTS EXCEPT BASE COLLAR, SHALL BE SHOP-WELDED INTO THE POLE STRUCTURE ASSEMBLY.
- BASE COLLAR TO BE FABRICATED WITH FLUSH AND TAMPER-PROOF FASTENERS.

VIEWING SIDE

- 1.4. STRUCTURAL STEEL TUBING SIGN PANEL SUPPORTS SHALL BE DRILLED FOR SIGN PANEL AND COLLAR FASTENERS PRIOR TO FINISH APPLICATION.
- 2. STEEL CABLES TO BE 318 STAINLESS STEEL AIRCRAFT CABLES 1:4\* DIA. CABLE WITH 5600 LB MINIMUM BREAKING STREINGTH. ASSEMBLYTERMINATION HARDWARE TO BE 318 STAINLESS STEEL AND INCLUDE BALL-STYLE TURNBUCKLES FOR ANGLED INSTALLATIONS AT ONE ORD AND EYELDET STYLE FITTINGS AT THE OPPOSITE END OF THE CABLE. ALL HARDWARE FITTINGS SHALL BE SWAGED ONTO THE CABLE, FIELD VERIFY AND MATCH CABLE AND HARDWARE FABRICATIONS ON EXISTING RIVERFRONT AND LINCOLN DOUGLAS SQUARE INTERPRETIVE SIGNS. REFER TO PHOTOS OF EXISTING SIGNS FOR REFERENCE (SHEET 28).
- PHENOLIC RESIN SIGN PANELS TO MATCH MATERIAL AND GRAPHIC QUALITY OF EXISTING RIVERFRONT AND LINCOLN DOUGLAS SQUARE INTERPRETIVE SIGNS, IMAGES AND TEXT WILL BE PROVIDED IN POST-SCRIPT FORMAT (FOR INCORPORATION INTO SIGN PANELS) TO THE SIGN PANEL CONTRACTOR PRIOR TO SHOP DRAWING SUBMITTALS. REFER TO SHEET 27.
- 3.1. SIGN PANELS TO BE MOUNTED TO STRUCTURAL STEEL TUBING SUPPORTS WITH STAINLESS STEEL HARDWARE.
- 4. CONCRETE FOOTINGS AND ANCHOR BOLTSIHARDWARE TO COMPLY WITH IDOT STANDARD SPECIFICATIONS FOR ROAD AND BRIDGE CONSTRUCTION - SECTION 1006.09, CONCRETE TO BE CLASS SI, 3500 PSI MINIMUM STRENGTH AT 14 DAYS -COMPLY WITH APPLICABLE PORTIONS OF SECTION 734.
- CONTRACTOR SHALL FIELD VERIFY AND MEASURE EXISTING INTERPRETIVE SIGNS AT RIVERFRONT PARK AND LINCOLN
  DOUGLAS SQUARE AND PREPARE FINAL SHOP DRAWINGS FOR SIGN STRUCTURES AND FOOTINGS. SHOP DRAWINGS
  SHALL BE SEALED BY A PROFESSIONAL ENGINEER LICENSED IN THE STATE OF ILLINOIS.
- GRAPHIC PANELS TO BE ILLUMINATED BY SOLAR POWERED LED STRIP LIGHTING. REFER TO SHEET 29 FOR SOLAR POWER AND LED LIGHTING COMPONENTS INCLUDED IN INTERPRETIVE SIGN SYSTEM, COMPLETE.
- POLE FOUNDATION TO BE CAST INTEGRAL TO LOW SERPENTINE WALL. COORDINATE TOP OF FOOTING ELEVATION WITH STEEL SIGN POLE FABRICATOR PRIOR TO CONSTRUCTION AND SIGN POLE FABRICATION.

4 INTERPRETIVE SIGNS (A & B) - REFER TO SHEET 28 (PHOTOS)
ELEVATION & PLAN (SIGN B IS SHOWN - SIGN A IS MIRROR IMAGE)

BARE COPPER #8.

GROUNDING CONDUCTOR

NO. REVISION DATE DATE: 01/28/2015


CONCRETE FOOTING 2"x


GREAT RIVERS FLOOD MEMORIAL & BRIDGE WEST BEAUTIFICATION


CITY OF ALTON, ILLINOIS

NTS

101 EAST 3RD STREET ALTON, ILLINOIS 62002 SITE FURNISHING & SIGNAGE - FLOOD MEMORIAL

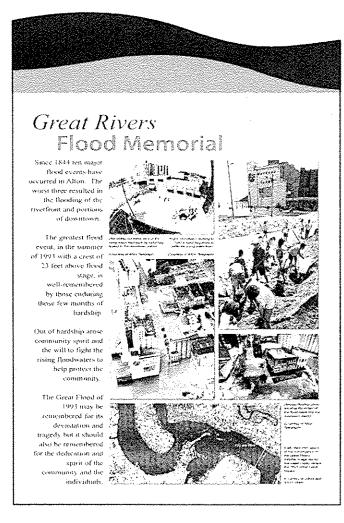

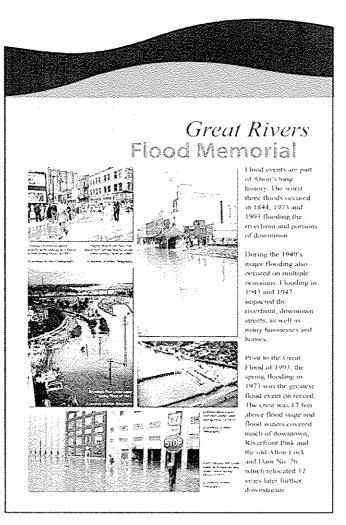

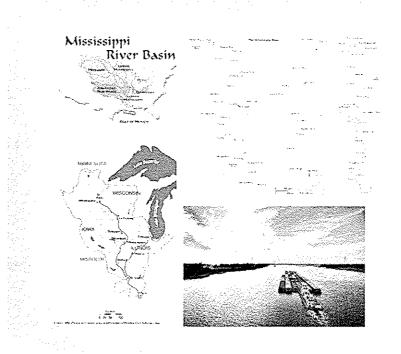

# **Great Rivers Flood Memorial**

You are standing just downstream of the confluence of the litmost and Mississippi Rivers and just upstream from the confluence with time Missioum River During the Great Flood of 1989 water in the urea of this memoral was approximately 9.5 feet deep and the shore to shore distitution of the flood waters measured around 4.3 miles. Some facts about the Mississippi and its

It is a Big River
The Mississippl River is the fourth longest river in the world at 2,350 miles. Only the Nile, Amazon and Yangtze Rivers are longer. At its headwarders the river is 20 to 30 feet wide. At the widest novigatele point it is approximately two miles wide. At its headwarders if flows approximately 2.7 thousand gallons per minute. At the Gulf of Mexico the volume is approximately 2.7 million gallotin per minute. The river and its flabstones drain over 1.2 million square miles of land covering 31 states and two Canadian Provinces. There are aix. states and two Canadian Provinces. There are six sub-basins that make up the overall drainage area

Early in the history of Native American settlements the over was crucial to survival and their way of life. The fixor was crucial to survival and their way of life. The abundance of natural resolutions and widelithe sustained both hunter and gatherer settlements as well as agricultural settlements, such as the Mississippian Indian settlement near Cahckai, IL. During the European settlement eras the river and its tributanas. served Similar needs but also provided crucial transportation and communication links that allowed for

During post-industrial times the river still provided caltural resources, a source for drinking water supplies natural resources, a source for dinasing water supplies and a major commerce centure for the transportation of goods. The river supports ever 260 species of fish. Likewise, 40% of the nation's migratory waterflowd and 60% of North American migratory birds use the river basin as their migratory flyway.

As a commerce corridor today, major volumes of goods are transported from city to city and city to port along its length. Over 60% of all grain exported from the United States is shipped on the Mississippi.

Today's become

Modern development impacts on the river have brought continuing and new challenges for the over 70 million people living in the river basin. New priorities include managing environmental issues, wildlife and natural resources, flood control as well as maintaining the navigability of the river as a commerce route through a series of sophisticated lock and dam structures. Those management efforts and flood control measures have helped but with the unpredictability of weather events and the power of the river, flooding continues.

This memoral provides insight and Information regarding some of the major floods that have occurred in the City of Alton, especially the Great Flood of 1993.

**GRAPHIC PANEL LAYOUT** INTERPRETIVE SIGN A  $\left(\begin{array}{c} 1\\27\end{array}\right)$ ELEVATION

**GRAPHIC PANEL LAYOUT** INTERPRETIVE SIGN B ( <u>2</u> 27 ELEVATION

GRAPHIC PANEL LAYOUT - INTERPRETIVE SIGN C

(3) 27 ELEVATION

> 24" X 24" SHARE THE ROAD SIGN WITH 4" x 4" TREATED WOOD POST - 13:-0" LENGTH PER SECTION 1007-05 FINISHED GRADE OR EDGE OF

> > MIN, 5 0' IMBED DEPTH

COMPACTED CAS

1 SIGNS AND POSTS TO CONFORM WITH U.S. DEPARTMENT OF TRANSPORTATION MANUAL OF UNIFORM TRAFFIC CONTROL DEVICES FOR STREETS AND HIGHWAYS CURRENT EDITION.

2 THERE SHALL BE A 2'-0" CLEARANCE FROM THE FACE OF CURB TO THE EDGE OF SIGN OR A 6-0" CLEARANCE FROM THE EDGE OF DRIVING LANE TO THE

3. TYPE I SIGN TYPE A ASSEMBLY

BICYCLE "SHARE THE ROAD" SIGN ( 4 27 ELEVATION

NTS

REVISION

01/28/2015

GREAT RIVERS FLOOD MEMORIAL & BRIDGE WEST BEAUTIFICATION


CITY OF ALTON, ILLINOIS


SITE FURNISHING & SIGNAGE -FLOOD MEMORIAL


TOTAL SHEE SHEETS NO. 09-00226-00-MS MADISON 84


CONTRACT NO 97539 PROJ NO SBIL-TE-00D8(15)


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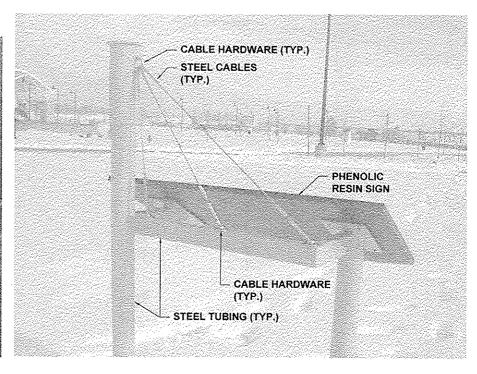


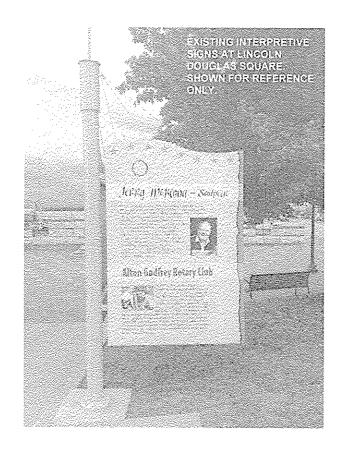

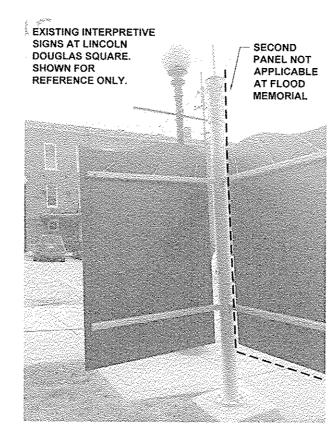

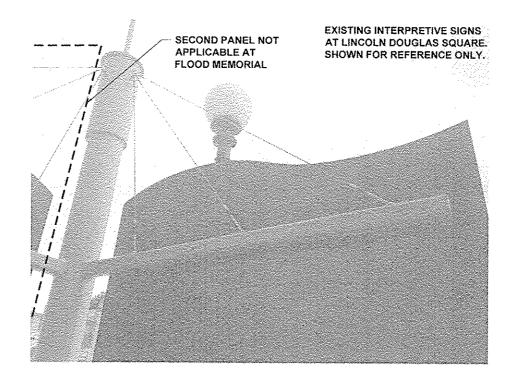

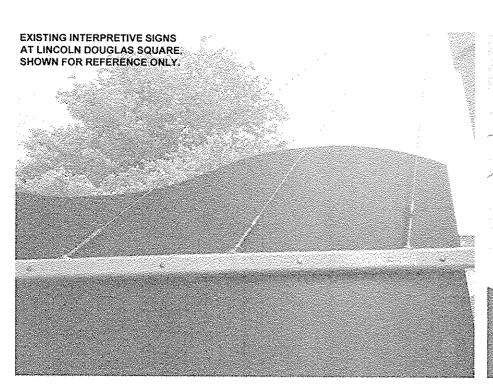

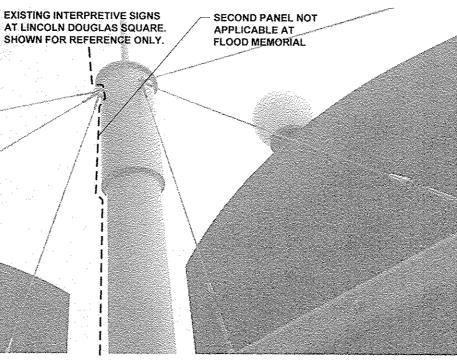

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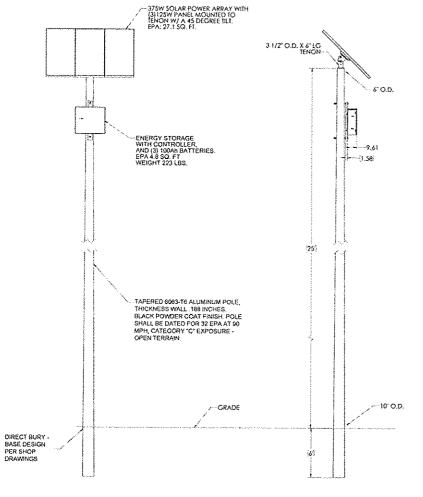
GREAT RIVERS FLOOD MEMORIAL & BRIDGE WEST BEAUTIFICATION


CITY OF ALTON, ILLINOIS


101 EAST 3RD STREET
ALTON, ILLINOIS 62002

EXISTING INTERPRETIVE SIGN EXAMPLE PHOTOS -FLOOD MEMORIAL

_	F.A.U. ROUTE	SECTION	COUNTY	TOTAL SHEETS	SHEET NO.
		09-00226-00-MS	MADISON	84	28
			CONTRAC	T NO. 9753	9
			PROJ. NO.	SBIL-TE-0	0D8(151)
	FEDER!	L AID PROJECT	ILLINOIS		Andrew Charles



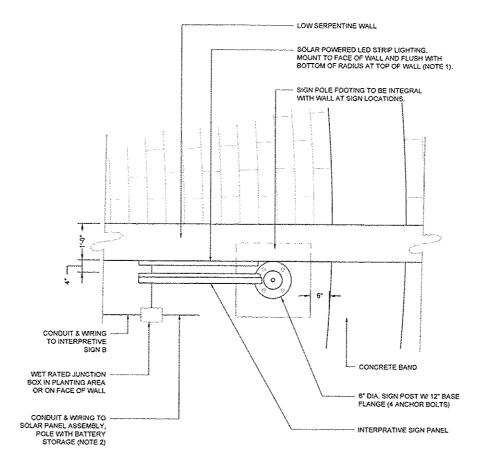

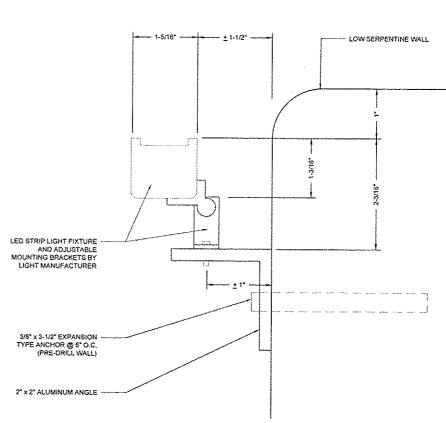

SOLAR PANEL & SUPPORT POLE ASSEMBLY
ELEVATION

2 SOLAR POWERED LED LIGHTING SIGNS A & B 29 PLAN - SIGN A SHOWN (SIGN B SIMILAR) NTS 29 LED FIXTURE - ATTACHMENT DETAIL

NOTES:

- PROVIDE SHOP DRAWING FOR COMPLETE SOLAR POWERED LED SIGN LIGHTING SYSTEM INCLUDING FIXTURES, ATTACHMENT HARDWARE, SOLAR PANEL POLE ASSEMBLY WITH BATTERY STORAGE, POLE FOUNDATION, CONDUIT WIRING AND CONTROLS AS WELL AS COORDINATION WITH INTERPRETIVE SIGN POLE ASSEMBLY AND FOUNDATION FABRICATION AND SERPENTINE WALL SHOP DRAWING. REFER TO SPECIAL PROVISIONS FOR ADDITIONAL INFORMATION.
- REFER TO SPECIAL PROVISIONS AND DETAIL 1, THIS SHEET, FOR DETAILS REGARDING SOLAR PANEL POLE ASSEMBLY W/ BATTERY STORAGE.

NO.	REVISION	DATE	DATE:
			01/28/2015
**************************************	Marine Marine Control of the Control		DRAWN 8Y:
			GGV/SBT

GREAT RIVERS FLOOD MEMORIAL & BRIDGE WEST BEAUTIFICATION

CITY OF ALTON, ILLINOIS

SOLAR POWERED LIGHTING DETAILS -FLOOD MEMORIAL

NTS

Cytand Projects/PDS (467963) PLOCID MEMORIAL/dwa/Flood Memorial Traffic Control Ph 1 dwg 1/

GREAT RIVERS FLOOD MEMORIAL & BRIDGE WEST BEAUTIFICATION

CITY OF ALTON, ILLINOIS

101 EAST 3RD STREET
ALTON, ILLINOIS 62602

TRAFFIC CONTROL PLAN FLOOD MEMORIAL


-	F.A.U. ROUTE	SECTION	COUNTY	TOTAL SHEETS	SHEET NO.
		10-00229-01-LS	MADISON	84	30
			CONTRAC	T NO. 9753	9
			PROJ. NO.	SBIL-TE-0	DD8(151)
	FEDERAL AID PROJECT		ILLINQIS		***************************************


# TRAFFIC CONTROL LEGEND GENERAL NOTES ALL SIGNS SHALL MEET THE REQUIREMENTS OF THE LATEST EDITION OF THE "MANUAL ON UNIFORM TRAFFIC CONTROL DEVICES FOR STREETS AND HIGHWAYS". A SIGN, "ROAD CONSTRUCTION AHEAD", W20-1103(0)-48 O CONE, DRUM OR TYPE II BARRICADE SIGN, "RIGHT LANE CLOSED AHEAD", W20-5(0)-48 INSTALLATION AND REMOVAL OF ALL SIGNS, HARDWARE AND POSTS SHALL BE INCLUDED IN THE CONTRACT UNIT PRICE FOR TRAFFIC CONTROL AND PROTECTION, SPECIAL. SIGN, "LEFT LANE CLOSED AHEAD", W20-1103(0)-48 3. THE ENGINEER SHALL DETERMINE THE FINAL LOCATION OF EACH TRAFFIC CONTROL (TEM. (D) SIGN, "WORKER SYMBOL", W21-I(0)-48 (USE ONLY WHEN WORKERS ARE PRESENT) BARRICADE OR DRUM WITH FLASHING LIGHT SIGN, BLACK ARROW ON ORANGE BACKGROUND, M5-1, 21" x 15" ├─ TYPE III BARRICADE 2 SIGN, BLACK ARROW ON ORANGE BACKGROUND, M5-1, 21" x 15" 3 SIGN, "SIDEWALK CLOSED", R11-I101-2418 4 SIGN, "SIDEWALK CLOSED, ARROW SYMBOL, USE OTHER SIDE", R11-1102-2430 5 SIGN, NO RIGHT TURN SYMBOL, R3-1, 24" x 24" 6 SIGN, "YIELD", R1-2, 36" x 36" x 36" WORK AREA \*SEE NOTE 3. PHASE 2 DATE DATE: 01/28/2014 SECTION GREAT RIVERS FLOOD MEMORIAL & BRIDGE WEST BEAUTIFICATION CITY OF ALTON, ILLINOIS TRAFFIC CONTROL PLAN

101 EAST 3RD STREET ALTON, ILLINOIS 82002 FLOOD MEMORIAL

FEDERAL AID PROJECT ILLINOIS

Silland Projects/PDS (467963) FLOOD MENIORALISMAN Flood Memorial Traffic Control Ph 2 disa 1722/2015 12204 pu

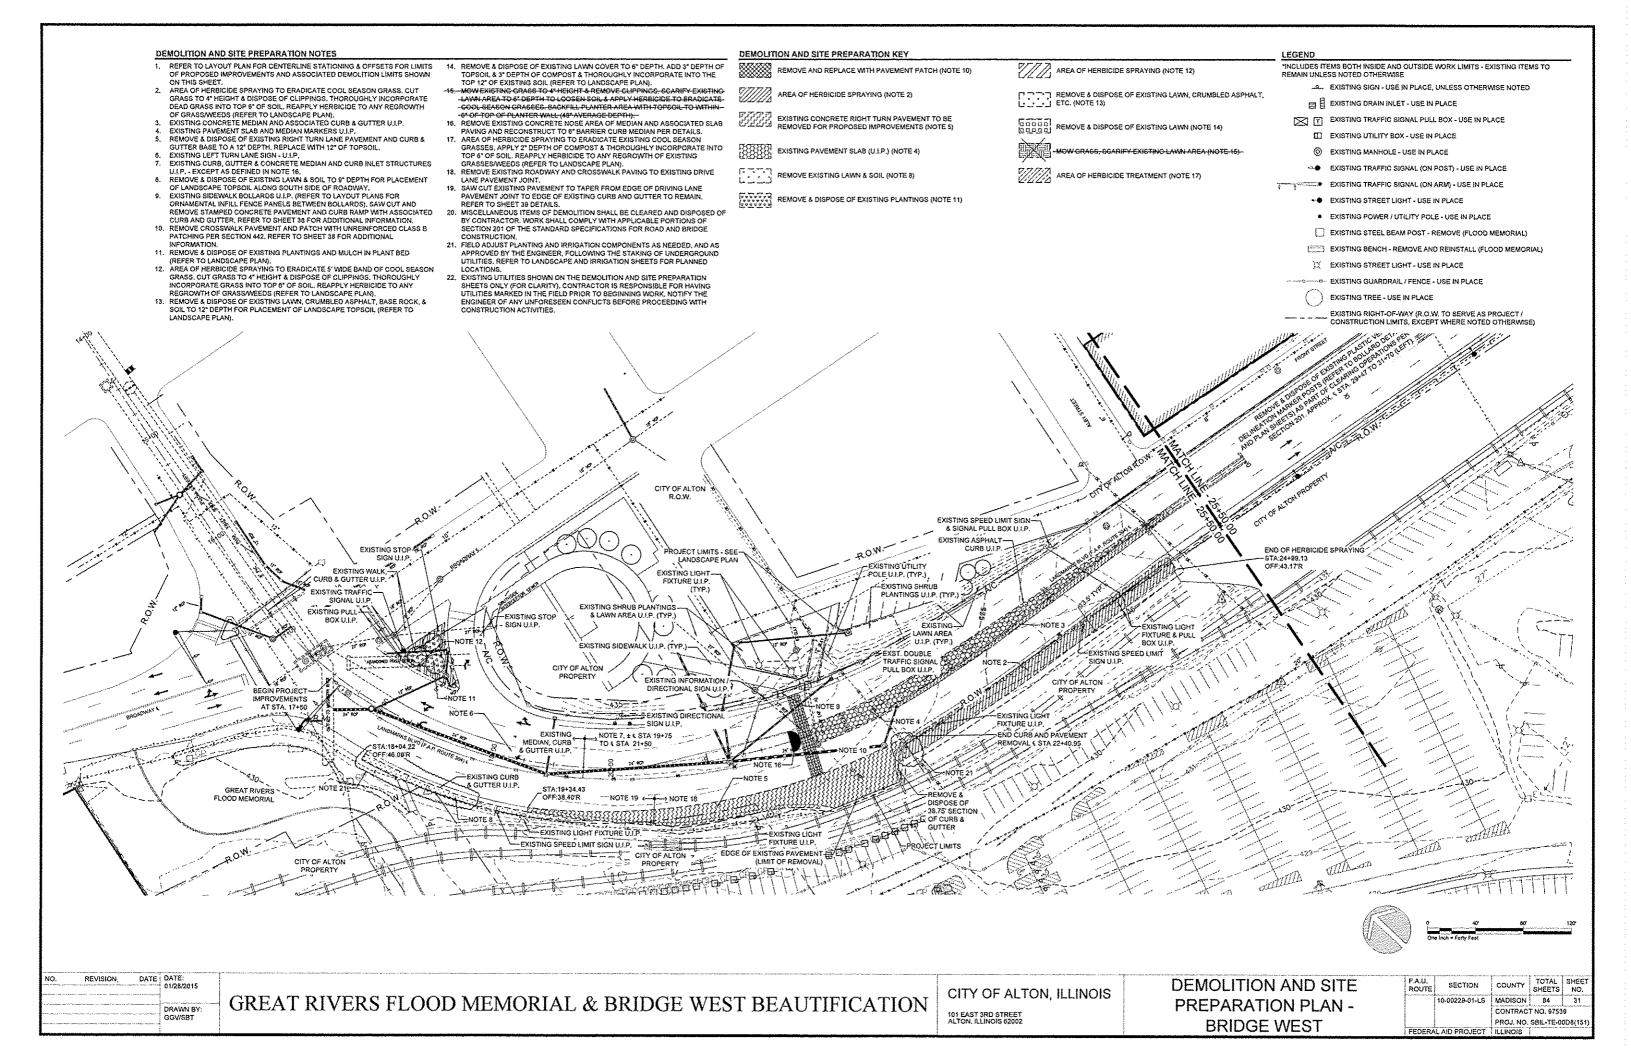

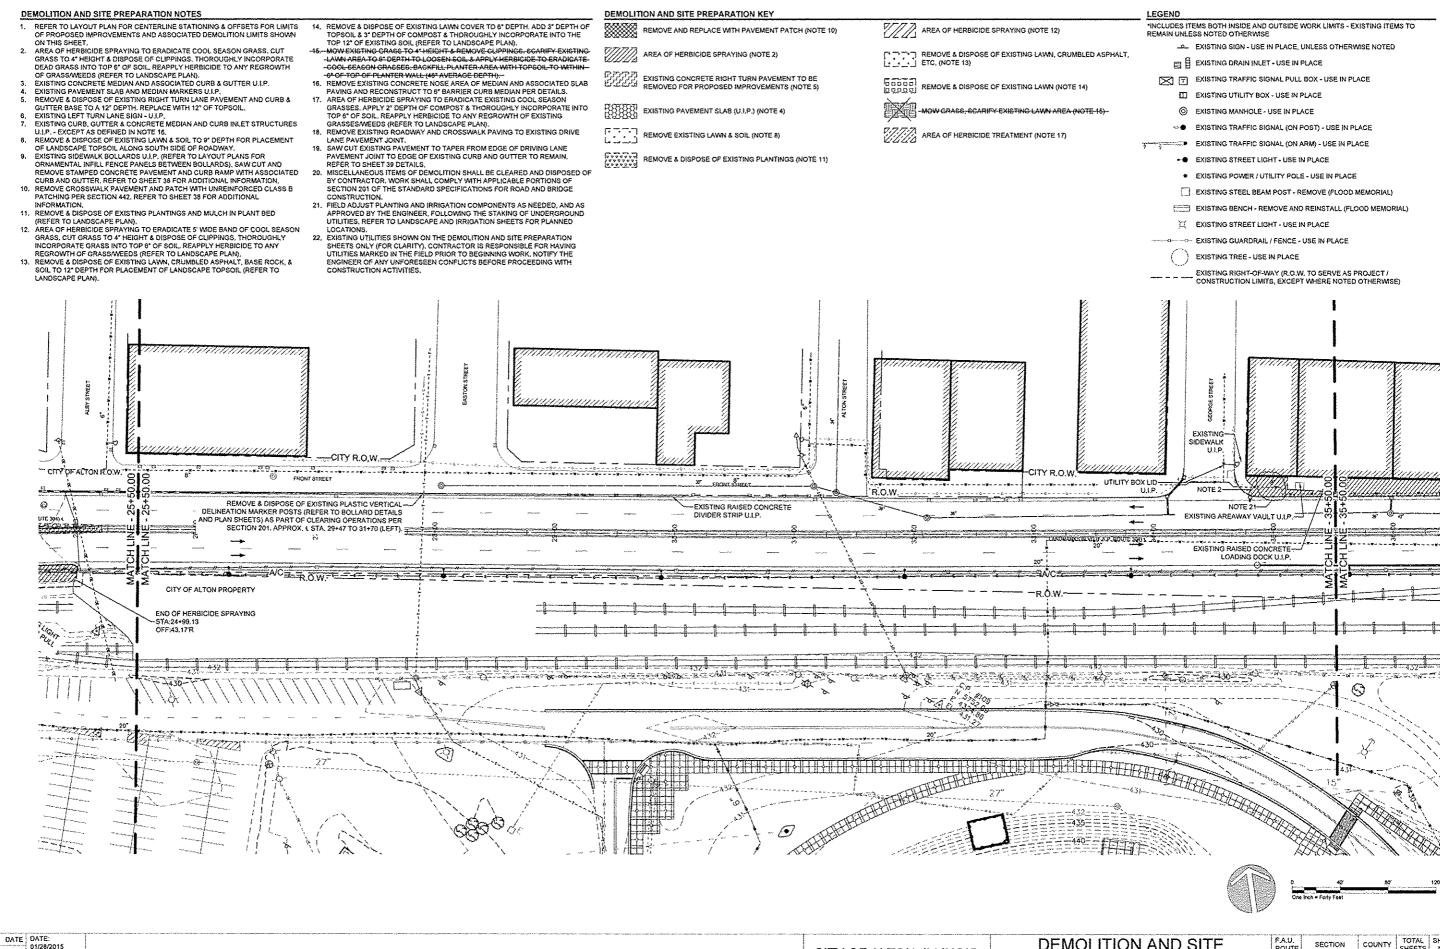

DATE: 01/28/2015


DATE: 01/28/2015


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GREAT RIVERS FLOOD MEMORIAL & BRIDGE WEST BEAUTIFICATION


CITY OF ALTON, ILLINOIS

DEMOLITION AND SITE PREPARATION PLAN -BRIDGE WEST



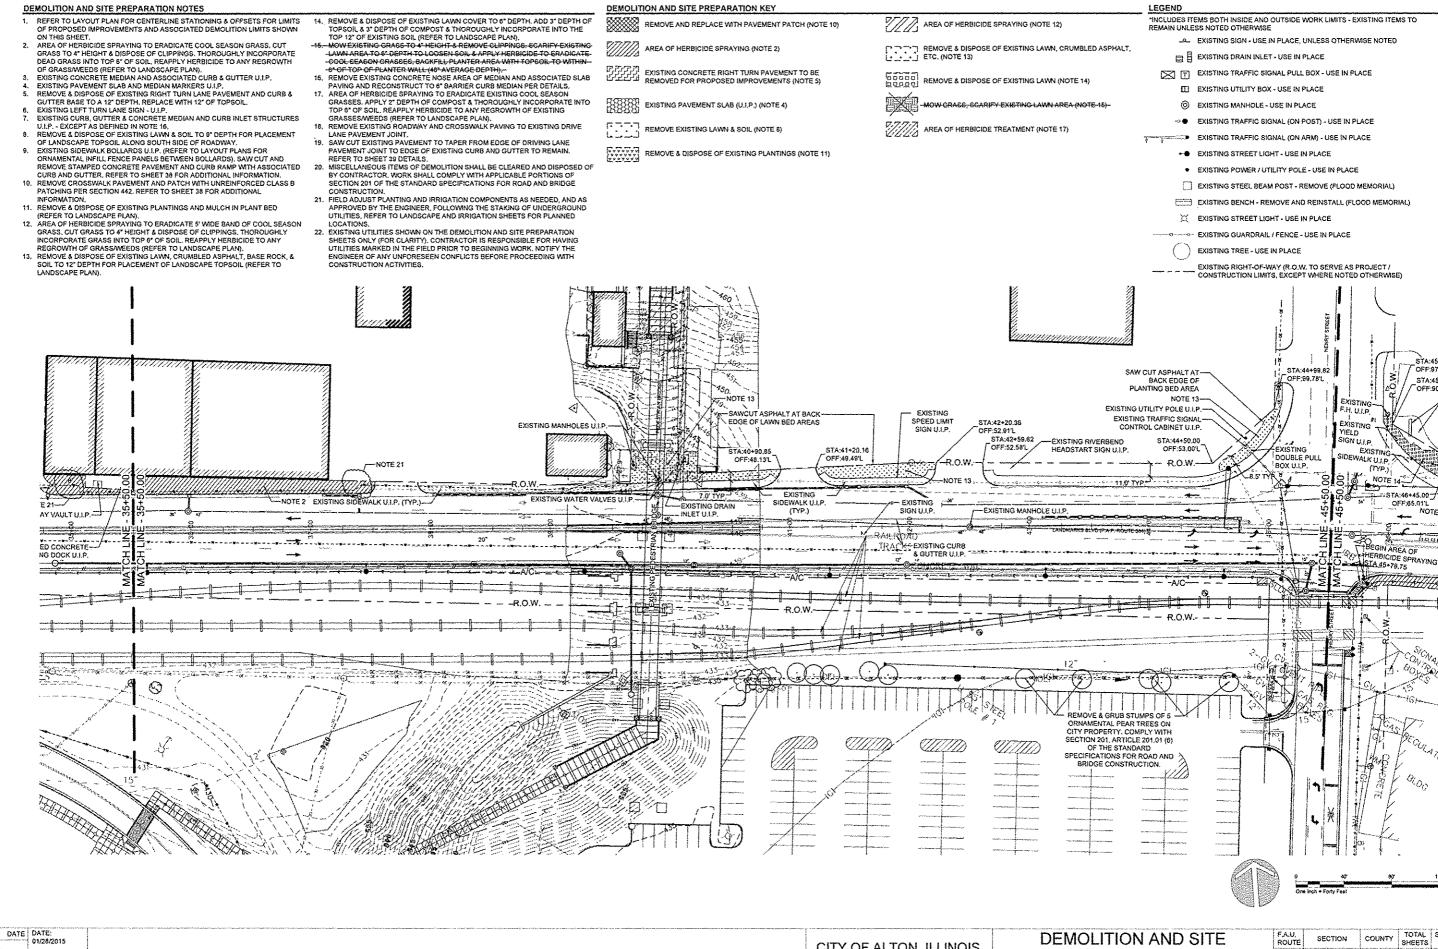
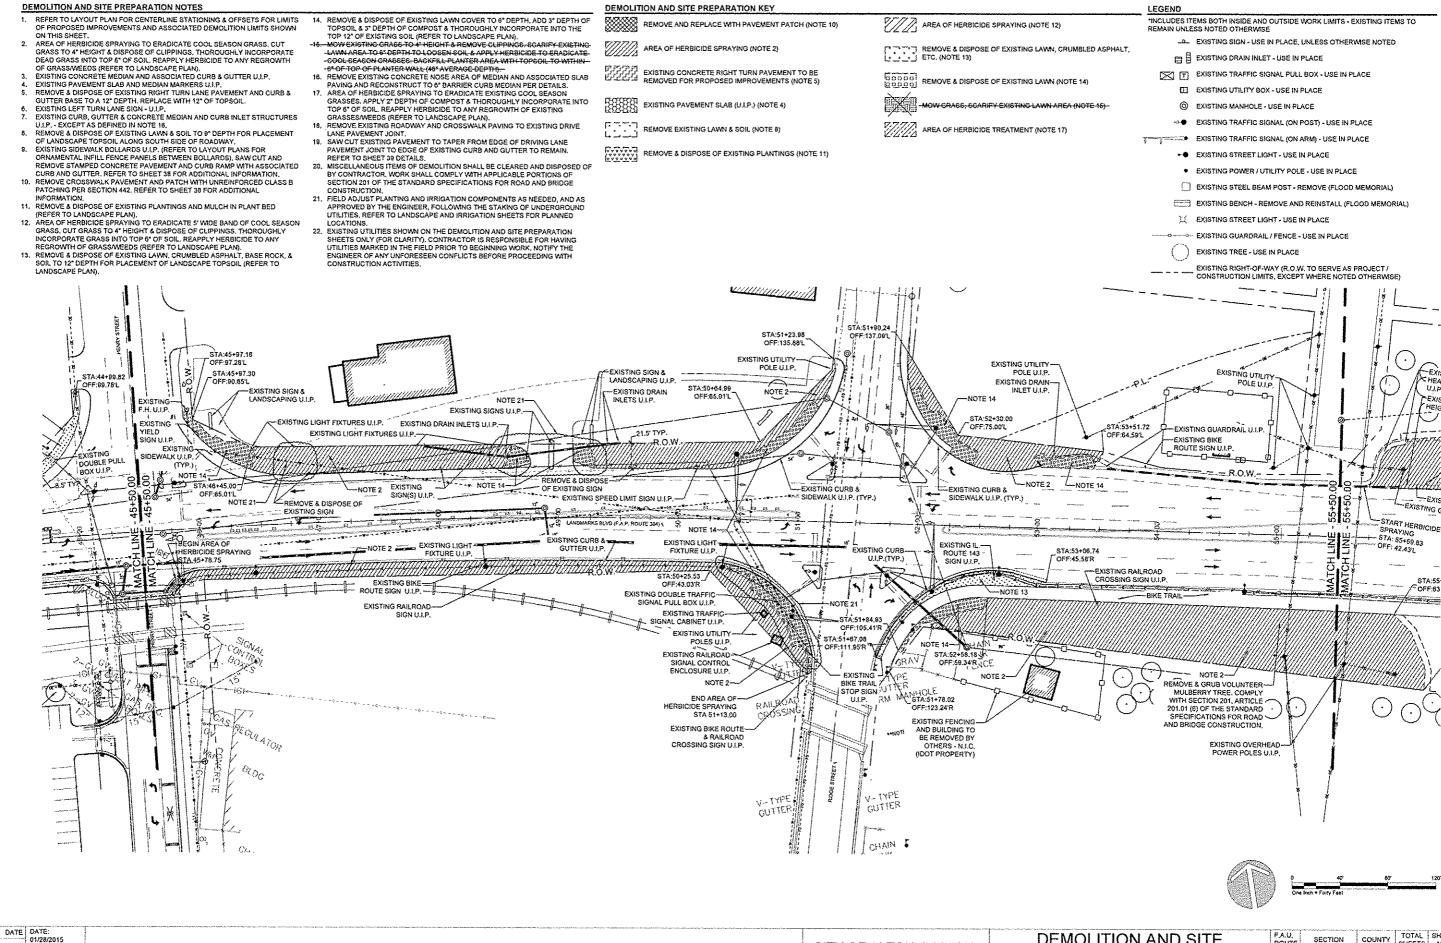
#### DEMOLITION AND SITE PREPARATION KEY **DEMOLITION AND SITE PREPARATION NOTES** INCLUDES ITEMS BOTH INSIDE AND OUTSIDE WORK LIMITS - EXISTING ITEMS TO REMOVE & DISPOSE OF EXISTING LAWN COVER TO 6" DEPTH, ADD 3" DEPTH OF 1. REFER TO LAYOUT PLAN FOR CENTERLINE STATIONING & OFFSETS FOR LIMITS AREA OF HERBICIDE SPRAYING (NOTE 12) REMOVE AND REPLACE WITH PAVEMENT PATCH (NOTE 10) TOPSOIL & 3" DEPTH OF COMPOST & THOROUGHLY INCORPORATE INTO THE OF PROPOSED IMPROVEMENTS AND ASSOCIATED DEMOLITION LIMITS SHOWN TOP 12' OF EXISTING SOIL (REFER TO LANDSCAPE PLAN). MOW EXISTING CRASE TO 4" HEIGHT & REMOVE CLIPPINGS, SCARIFY EXISTING LAWN AREA TO 8" DEPTH TO LOOSEN SOIL & APPLY HERBICIDE TO ERADIGATE. \_\_\_ EXISTING SIGN - USE IN PLACE, UNLESS OTHERWISE NOTED 2. AREA OF HERBICIDE SPRAYING TO ERADICATE COOL SEASON GRASS, CUT AREA OF HERBICIDE SPRAYING (NOTE 2) REMOVE & DISPOSE OF EXISTING LAWN, CRUMBLED ASPHALT. GRASS TO 4" HEIGHT & DISPOSE OF CLIPPINGS, THOROUGHLY INCORPORATE DEAD GRASS INTO TOP 8" OF SOIL, REAPPLY HERBICIDE TO ANY REGROWTH OF GRASS/WEEDS (REFER TO LANDSCAPE PLAN). EXISTING DRAIN INLET - USE IN PLACE \_\_\_\_\_\_ ETC, (NOTE 13) COOL SEASON CRASSES BACKELL DI ANTER AREA WITH TORSOIL TO WITHIN -0" OF TOP OF PLANTER WALL (10" AVERAGE DEPTH). 16. REMOVE EXISTING CONCRETE NOSE AREA OF MEDIAN AND ASSOCIATED SLAB EXISTING TRAFFIC SIGNAL PULL BOX - USE IN PLACE EXISTING CONCRETE RIGHT TURN PAVEMENT TO BE REMOVED FOR PROPOSED IMPROVEMENTS (NOTE 5) REMOVE & DISPOSE OF EXISTING LAWN (NOTE 14) EXISTING CONCRETE MEDIAN AND ASSOCIATED CURB & GUTTER U.LP PAVING AND RECONSTRUCT TO 6' BARRIER CURB MEDIAN PER DETAILS. AREA OF HERBICIDE SPRAYING TO ERADICATE EXISTING COOL SEASON GRASSES. APPLY 2' DEPTH OF COMPOST & THOROUGHLY INCORPORATE INTO EXISTING PAVEMENT SLAB AND MEDIAN MARKERS U.L.P. REMOVE & DISPOSE OF EXISTING RIGHT TURN LANE PAVEMENT AND CURB & (I) EXISTING UTILITY BOX - USE IN PLACE GUTTER BASE TO A 12" DEPTH, REPLACE WITH 12" OF TOPSOIL (C) EXISTING MANHOLE - USE IN PLACE EXISTING PAVEMENT SLAB (U.I.P.) (NOTE 4) MOW GRACE, CCARIFY EXISTING LAWN AREA (NOTE 45) EXISTING LEFT TURN LANE SIGN - U.I.P. EXISTING CURB, GUTTER & CONCRETE MEDIAN AND CURB INLET STRUCTURES TOP 8" OF SOIL REAPPLY HERRICIDE TO ANY REGROWTH OF EXISTING GRASSES/WEEDS (REFER TO LANDSCAPE PLAN). REMOVE EXISTING ROADWAY AND CROSSWALK PAVING TO EXISTING DRIVE EXISTING TRAFFIC SIGNAL (ON POST) - USE IN PLACE AREA OF HERBICIDE TREATMENT (NOTE 17) U.L.P. - EXCEPT AS DEFINED IN NOTE 16. REMOVE EXISTING LAWN & SOIL (NOTE 8) U.I.P., EXCEPT AS DEFINED IN NOTE 16. REMOVE & DISPOSE OF EXISTING LAWA'S SOIL TO 8" DEPTH FOR PLACEMENT OF LANDSCAPE TOPSOIL ALONG SOUTH SIDE OF ROADWAY. EXISTING SIDEWALK BOLLARDS U.I.P. (REFER TO LAYOUT PLANS FOR ORNAMENTAL INFILL FENCE PANELS BETWEEN BOLLARDS). SAW CUT AND REMOVE STAMPED CONCRETE PAYEMENT AND CURB RAMP WITH ASSOCIATED CURB AND GUTTER. REFER TO SHEET 38 FOR ADDITIONAL INFORMATION. LANE PAVEMENT JOINT. EXISTING TRAFFIC SIGNAL (ON ARM) - USE IN PLACE SAW CUT EXISTING PAVEMENT TO TAPER FROM EDGE OF DRIVING LANE PAVEMENT JOINT TO EDGE OF EXISTING CURB AND GUTTER TO REMAIN. REMOVE & DISPOSE OF EXISTING PLANTINGS (NOTE 11) ◆● EXISTING STREET LIGHT • USE IN PLACE REFER TO SHEET 39 DETAILS. MISCELLANEOUS ITEMS OF DEMOLITION SHALL BE CLEARED AND DISPOSED OF BY CONTRACTOR, WORK SHALL COMPLY WITH APPLICABLE PORTIONS OF EXISTING POWER / UTILITY POLE - USE IN PLACE SECTION 201 OF THE STANDARD SPECIFICATIONS FOR ROAD AND BRIDGE FXISTING STEEL BEAM POST - REMOVE (FLOOD MEMORIAL 10. REMOVE CROSSWALK PAVEMENT AND PATCH WITH UNREINFORCED CLASS B PATCHING PER SECTION 442. REFER TO SHEET 38 FOR ADDITIONAL INFORMATION. 21. FIELD ADJUST PLANTING AND IRRIGATION COMPONENTS AS NEEDED, AND AS APPROVED BY THE ENGINEER, FOLLOWING THE STAKING OF UNDERGROUND EXISTING BENCH - REMOVE AND REINSTALL (FLOOD MEMORIAL) 11. REMOVE & DISPOSE OF EXISTING PLANTINGS AND MULCH IN PLANT BED (REFER TO LANDSCAPE PLAN). 12. AREA OF HERBICIDE SPRAYING TO ERADICATE 5' WIDE BAND OF COOL SEASON GRASS, CUT GRASS TO 4" HEIGHT & DISPOSE OF CLIPPINGS. THOROUGHLY UTILITIES, REFER TO LANDSCAPE AND IRRIGATION SHEETS FOR PLANNED EXISTING STREET LIGHT - USE IN PLACE 22. EXISTING UTILITIES SHOWN ON THE DEMOLITION AND SITE PREPARATION SHEETS ONLY (FOR CLARITY), CONTRACTOR IS RESPONSIBLE FOR HAVING UTILITIES MARKED IN THE FIELD PRIOR TO BEGINNING WORK, NOTHY THE ENGINEER OF ANY UNFORESEEN CONFLICTS BEFORE PROCEEDING WITH - EXISTING GUARDRAIL - USE IN PLACE INCORPORATE GRASS INTO TOP 8" OF SOIL. REAPPLY HERBICIDE TO ANY REGROWTH OF GRASS/WEEDS (REFER TO LANDSCAPE PLAN). EXISTING TREE - USE IN PLACE 13. REMOVE & DISPOSE OF EXISTING LAWN, CRUMBLED ASPHALT, BASE ROCK, & EXISTING RIGHT-OF-WAY (R.O.W. TO SERVE AS PROJECT / SOIL TO 12" DEPTH FOR PLACEMENT OF LANDSCAPE TOPSOIL (REFER TO LANDSCAPE PLAN). CONSTRUCTION ACTIVITIES. CONSTRUCTION LIMITS, EXCEPT WHERE NOTED OTHERWISE) REMOVE AND SALVAGE TYPE 1 TRAFFIC BARRIER TERMINAL FROM EAST END OF REMOVE AND SALVAGE TYPES TRAFFIN BARRIER TERMINAL FROM WEST END OF EXISTING STEEL PLATE BEAM GUARDRAID AND EXISTING UTILIT EXISTING STEEL PLATE BEAM GUARDRAK AND BETURN TO IDOT - REFER TO LAYOUT PLAN FOR EXTENSION OF NEW GUARDRAIL. STA:80+38.13 OFF:72.481 RETURN TO DOT - REPER TO LAYOUT PLAN FOR CONNECTION TO NEW GUARDRAIL EXISTING SIGNS U.I.P. STA:59+24.96 -PROJECT LIMITS OFF:73,18 EXISTING CONCRETE EXISTING-EXISTING SIGN U.I.P.-OFF:67.149 HEADWALL & SWALE U.I.P. REMOVE & DISPOSE OF & METERS EXISTING MARIAN HEIGHTS SIGN U.I.P. EXISTING RIGHT TURN LANE SIGN U.I.P. NOTE 2-STA:56+32.66 OFF:84.92'L -REMOVE EXISTING WELCOME TO ALTON SIGN\_\_ EXISTING TRAFFIC SIGNAL PULL BOX SIGNAL CONTROL - RELOCATE 15' WEST. -- REMOVE & DISPOSE PULL BOX U.I.P. MATCH EXISTING OFFSET OFF:81.12'L INFO, SIGN (Ø) EXISTING GUARDRAIL U.I.P. EXISTING TRAFFIC OW. EXISTING GUY POLE U.I.P. SIGNAL CONTROL END HERBICIDE SPRAYING CABINET U.I.P. OFF:42.64'L -START HERBICIDE

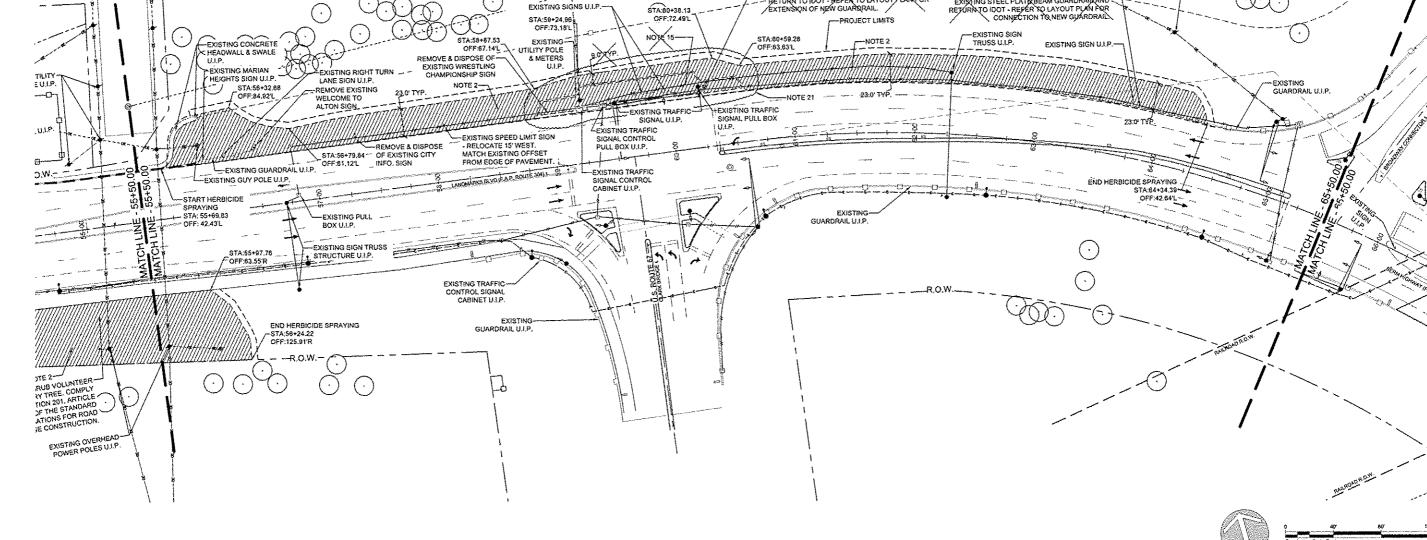

O,	REVISION	DATE	DATE:
			01/28/2015
~~~~			DRAWN BY: GGV/SBT

CITY OF ALTON, ILLINOIS

101 EAST 3RO STREET
ALTON, ILLINOIS 62002

DEMOLITION AND SITE PREPARATION PLAN -BRIDGE WEST

mpm/h/ m h (h )	F.A.U. ROUTE	SECTION	COUNTY	TOTAL SHEETS	SHEET NO.
	1	10-00229-01-LS	MADISON	84	35
			CONTRACT NO. 97539		
			PROJ. NO.	SBIL-TE-0	0D8(151)
	FEDERAL AID PROJECT		ILLINOIS		

#### DEMOLITION AND SITE PREPARATION KEY **DEMOLITION AND SITE PREPARATION NOTES** REMOVE & DISPOSE OF EXISTING LAWN COVER TO 6" DEPTH. ADD 3" DEPTH OF TOPSOIL & 3" DEPTH OF COMPOST & THOROUGHLY INCORPORATE INTO THE \*INCLUDES ITEMS BOTH INSIDE AND OUTSIDE WORK LIMITS - EXISTING ITEMS TO 1. REFER TO LAYOUT PLAN FOR CENTERLINE STATIONING & OFFSETS FOR LIMITS REMOVE AND REPLACE WITH PAVEMENT PATCH (NOTE 10) AREA OF HERBICIDE SPRAYING (NOTE 12) OF PROPOSED IMPROVEMENTS AND ASSOCIATED DEMOLITION LIMITS SHOWN ON THIS SHEET. 2. AREA OF HERBICIDE SPRAYING TO ERADICATE COOL SEASON GRASS. CUT \_P\_ EXISTING SIGN - USE IN PLACE, UNLESS OTHERWISE NOTED AREA OF HERBICIDE SPRAYING (NOTE 2) REMOVE & DISPOSE OF EXISTING LAWN, CRUMBLED ASPHALT, GRASS TO 4" HEIGHT & DISPOSE OF CLIPPINGS. THOROUGHLY INCORPORATE DEAD GRASS INTO TOP 6" OF SOIL. REAPPLY HERRICIDE TO ANY REGROWTH OF GRASSMEEDS (REFER TO LANDSCAPE PLAN). EXISTING CONCRETE MEDIAN AND ASSOCIATED CURB & GUTTER U.I.P. E EXISTING DRAIN INLET - USE IN PLACE -6"-OF-TOP-OF-PLANTER-WALL (16"-AVERAGE-DEPTH). 16. REMOVE EXISTING CONCRETE NOSE AREA OF MEDIAN AND ASSOCIATED SLAB EXISTING CONCRETE RIGHT TURN PAVEMENT TO BE REMOVED FOR PROPOSED IMPROVEMENTS (NOTE 5) EXISTING TRAFFIC SIGNAL PULL BOX - USE IN PLACE 00000 REMOVE & DISPOSE OF EXISTING LAWN (NOTE 14) EXISTING PAVEMENT SLAB AND MEDIAN MARKERS U.I.P. REMOVE & DISPOSE OF EXISTING RIGHT TURN LANE PAVEMENT AND CURB & GUTTER BASE TO A 12" DEPTH. REPLACE WITH 12" OF TOPSOIL. PAVING AND RECONSTRUCT TO 6" BARRIER CURB MEDIAN PER DETAILS. FTI EXISTING LITILITY BOX - LISE IN PLACE AREA OF HERBICIDE SPRAYING TO ERADICATE EXISTING COOL SEASON GRASSES. APPLY 2° DEPTH OF COMPOST & THOROUGHLY INCORPORATE INTO EXISTING PAVEMENT SLAB (U.I.P.) (NOTE 4) WGRASS, SGARIFY EXISTING LAWN AREA (NOTE-15) @ EXISTING MANHOLE - USE IN PLACE EVISTING LEFT THOM LANE SIGH . !! LD TOP 5" OF SOIL, REAPPLY HERBICIDE TO ANY REGROWTH OF EXISTING EXISTING CURB, GUTTER & CONCRETE MEDIAN AND CURB INLET STRUCTURES U.J.P. - EXCEPT AS DEFINED IN NOTE 16. GRASSES/WEEDS (REFER TO LANDSCAPE PLAN). REMOVE EXISTING ROADWAY AND CROSSWALK PAVING TO EXISTING DRIVE EXISTING TRAFFIC SIGNAL (ON POST) - USE IN PLACE REMOVE EXISTING LAWN & SOIL (NOTE 8) AREA OF HERBICIDE TREATMENT (NOTE 17) 8. REMOVE & DISPOSE OF EXISTING LAWN & SOIL TO 9" DEPTH FOR PLACEMENT LANE PAVEMENT JOINT EXISTING TRAFFIC SIGNAL (ON ARM) - USE IN PLACE REMOVE & DISPUSE OF EXISTING CAWNS SOULT OF DEPTH FOR PLACEMED OF LANDSCAPE TOPSOIL ALONG SOUTH SIDE OF ROADWAY. EXISTING SIDEWALK BOLLARDS U.I.P. (REFER TO LAYOUT PLANS FOR ORNAMENTAL INFILL FENCE PANELS BETWEEN BOLLARDS). SAW CUT AND SAW CUT EXISTING PAVEMENT TO TAPER FROM EDGE OF DRIVING LANE PAVEMENT JOINT TO EDGE OF EXISTING CURB AND GUTTER TO REMAIN. REMOVE & DISPOSE OF EXISTING PLANTINGS (NOTE 11) ← EXISTING STREET LIGHT - USE IN PLACE REFER TO SHEET 39 DETAILS. REMOVE STAMPED CONCRETE PAVEMENT AND CURB RAMP WITH ASSOCIATED CURB AND GUTTER, REFER TO SHEET 38 FOR ADDITIONAL INFORMATION. MISCELLANEOUS ITEMS OF DEMOLITION SHALL BE CLEARED AND DISPOSED OF BY CONTRACTOR, WORK SHALL COMPLY WITH APPLICABLE PORTIONS OF EXISTING POWER / UTILITY POLE - USE IN PLACE SECTION 201 OF THE STANDARD SPECIFICATIONS FOR ROAD AND BRIDGE 10. REMOVE CROSSWALK PAVEMENT AND PATCH WITH UNREINFORCED CLASS B EXISTING STEEL BEAM POST - REMOVE (FLOOD MEMORIAL) PATCHING PER SECTION 442. REFER TO SHEET 38 FOR ADDITIONAL 21. FIELD ADJUST PLANTING AND IRRIGATION COMPONENTS AS NEEDED, AND AS APPROVED BY THE ENGINEER, FOLLOWING THE STAKING OF UNDERGROUND EXISTING BENCH - REMOVE AND REINSTALL (FLOOD MEMORIAL) 11. REMOVE & DISPOSE OF EXISTING PLANTINGS AND MULCH IN PLANT BED (REFER TO LANDSCAPE PLAN). 12. AREA OF HERBICIDE SPRAYING TO ERADICATE 5' WIDE BAND OF COOL SEASON GRASS, CUT GRASS TO 4" HEIGHT & DISPOSE OF CLIPPINGS, THOROUGHLY UTILITIES. REFER TO LANDSCAPE AND IRRIGATION SHEETS FOR PLANNED TO EXISTING STREET LIGHT - USE IN PLACE 22, EXISTING UTILITIES SHOWN ON THE DEMOLITION AND SITE PREPARATION EXISTING GUARDRAIL - USE IN PLACE SHEETS ONLY (FOR CLARITY), CONTRACTOR IS RESPONSIBLE FOR HAVING UTILITIES MARKED IN THE FIELD PRIOR TO BEGINNING WORK, NOTIFY THE ENGINEER OF ANY UNFORESEEN CONFLICTS BEFORE PROCEEDING WITH INCORPORATE GRASS INTO TOP 6" OF SOIL. REAPPLY HERBICIDE TO ANY REGROWTH OF GRASSMEEDS (REFER TO LANDSCAPE PLAN). 13. REMOVE & DISPOSE OF EXISTING LAWN, CRUMBLED ASPHALT, BASE ROCK, & EXISTING TREE - USE IN PLACE SOIL TO 12" DEPTH FOR PLACEMENT OF LANDSCAPE TOPSOIL (REFER TO CONSTRUCTION ACTIVITIES. EXISTING RIGHT-OF-WAY (R.O.W. TO SERVE AS PROJECT / CONSTRUCTION LIMITS. EXCEPT WHERE NOTED OTHERWISE) EXISTING GUARDRAIL U.I.P. -EXISTING GUARDRAIL U.I.P. REMOVE & RELOCATE EXISTING DIRECTIONAL SIGNS TO ± STA. 74+00. START HERBICIDE SPRAYING AT EAST END OF EXISTING MATCH EXISTING LEFT & EXISTING CURB &--PAVED SHOULDER-BRIDGE DECK - \$ STA 68+61.78 RIGHT OFFSET DISTANCES SIGN U.LP. GUTTER HIP (TYP)

-END PLAN1 START HEF - ( STATIO! FND HERBICIDE SPRAYING & BEGIN PLANTING BED AREA -SIGN U.I.P. FXST END HERBICIDE SPRAYING 68+61.78 TO STA. & BEGIN PLANTING BED U.I.P. AREA - 1 STA 70+37,50 END PLANTING BED AREA 8 SPRAYING - & STATION 72+00 PAVED SHOULDER-GUTTER U.LP, (TYP.) NOTE 17 - € STA, 72+00 TO STA, 74+25. GUARDRAIL U.I.P. REICIDE SPRAYING



REVISION DATE DATE: 01/28/2015


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GREAT RIVERS FLOOD MEMORIAL & BRIDGE WEST BEAUTIFICATION


CITY OF ALTON, ILLINOIS


DEMOLITION AND SITE PREPARATION PLAN -BRIDGE WEST


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		10-00229-01-LS	MADISON	84	36
			CONTRAC	T NO. 9753	8
			PROJ. NO.	SBIL-TE-0	9D8(151
-	FEDERA	L AID PROJECT	ILLINOIS	<u> </u>	

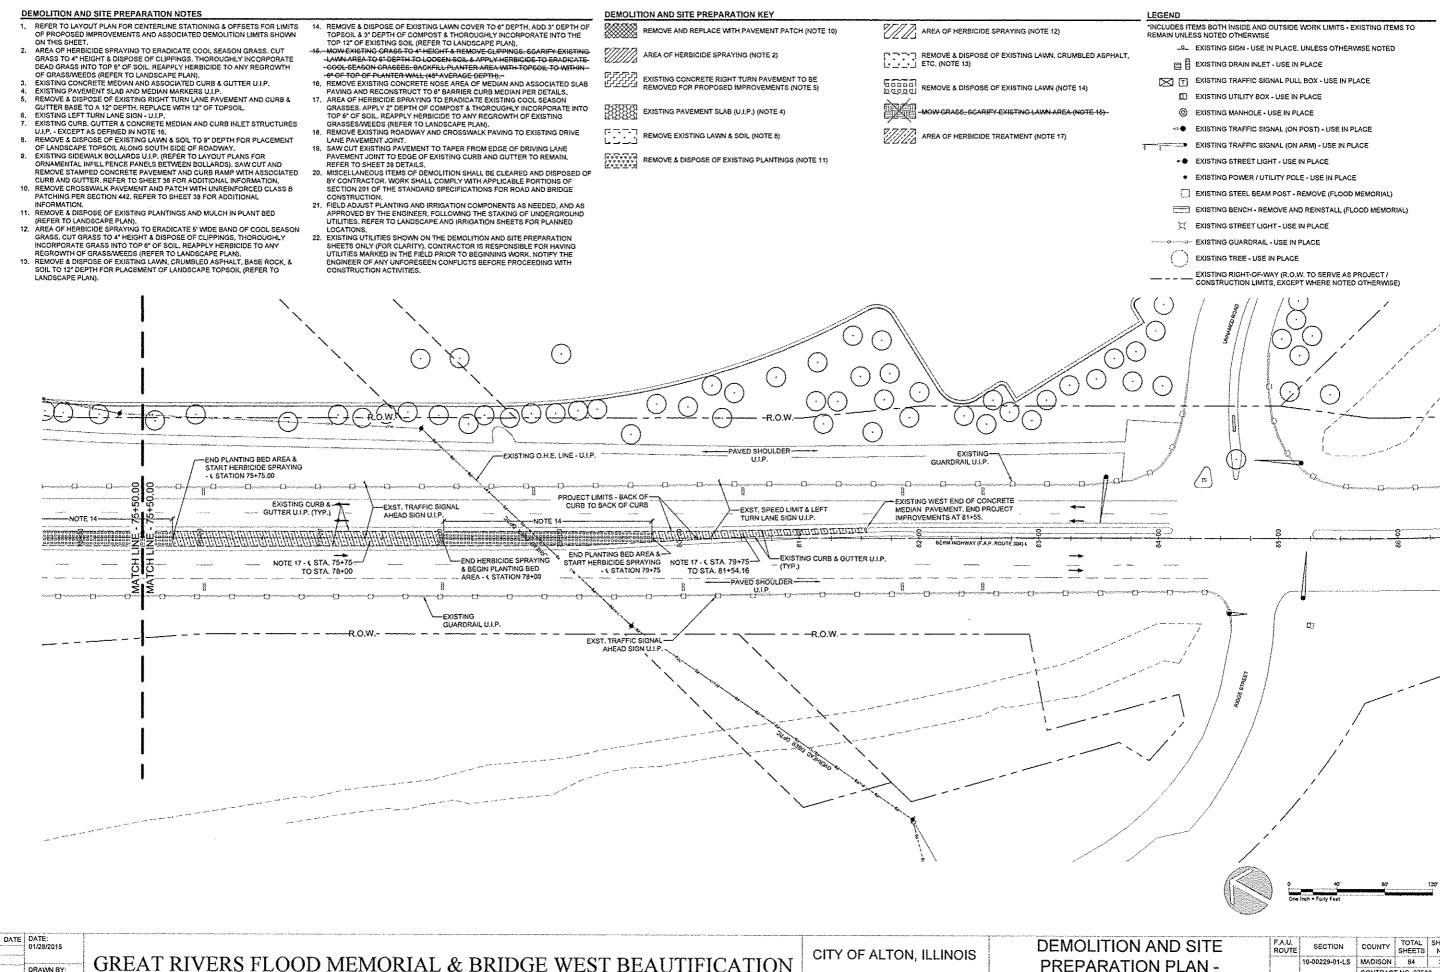


REVISION

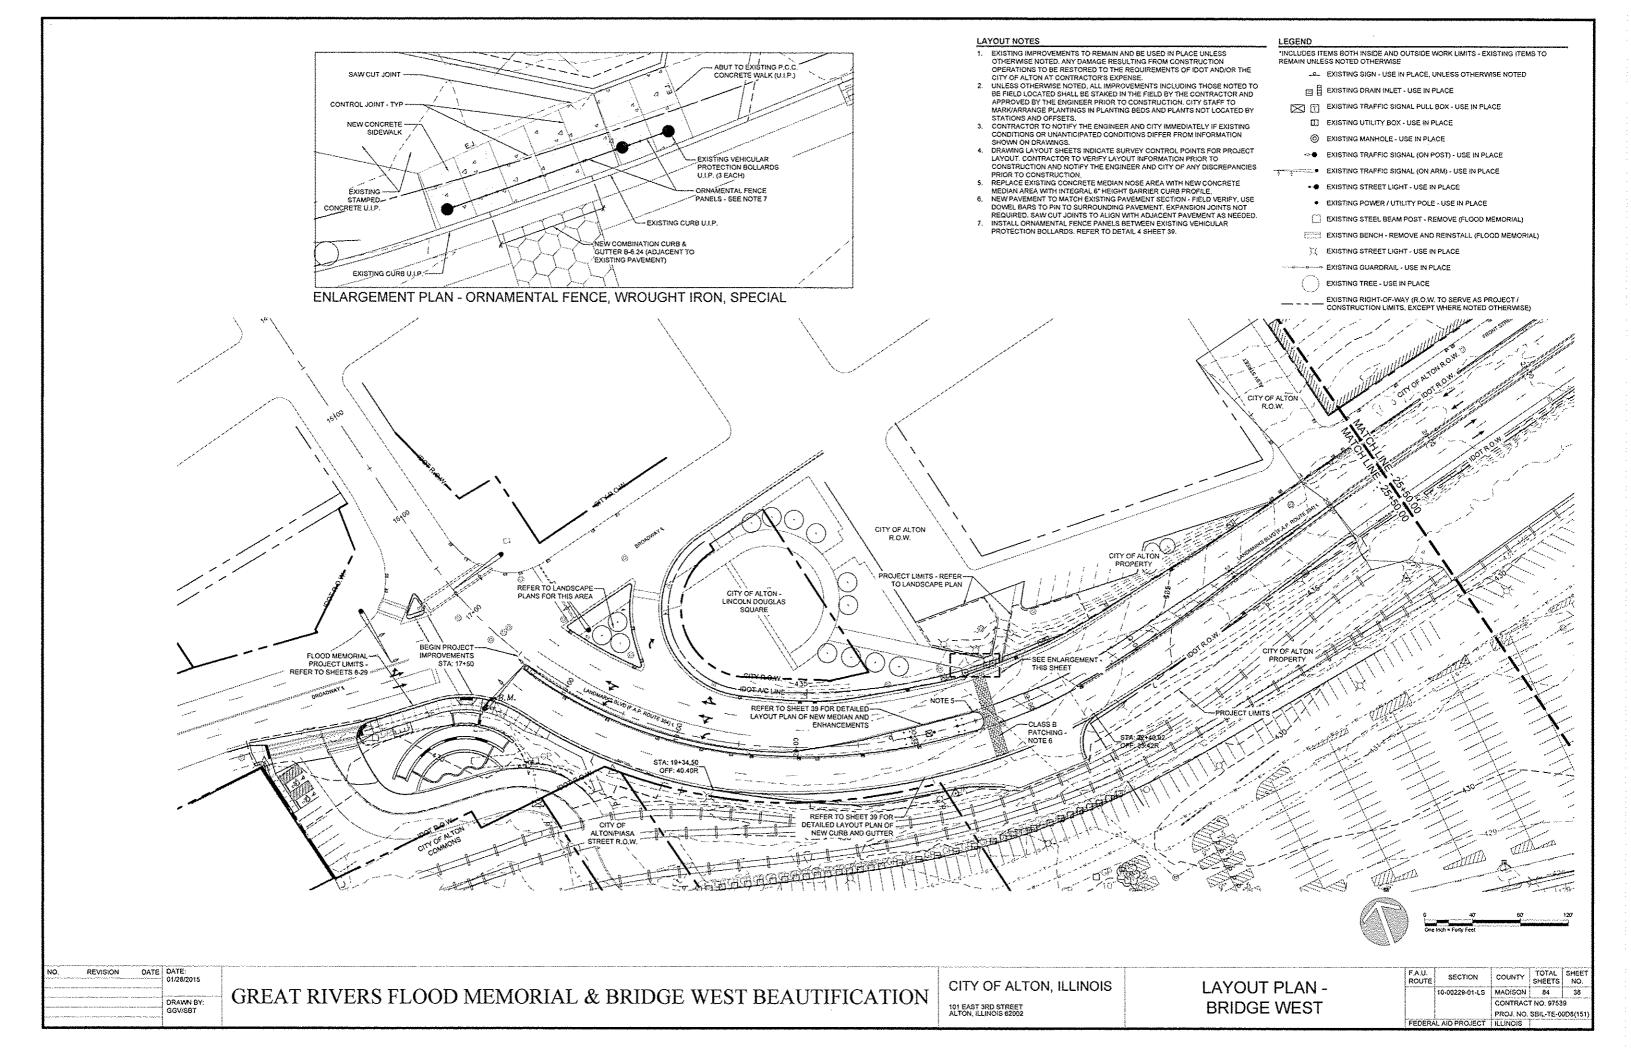

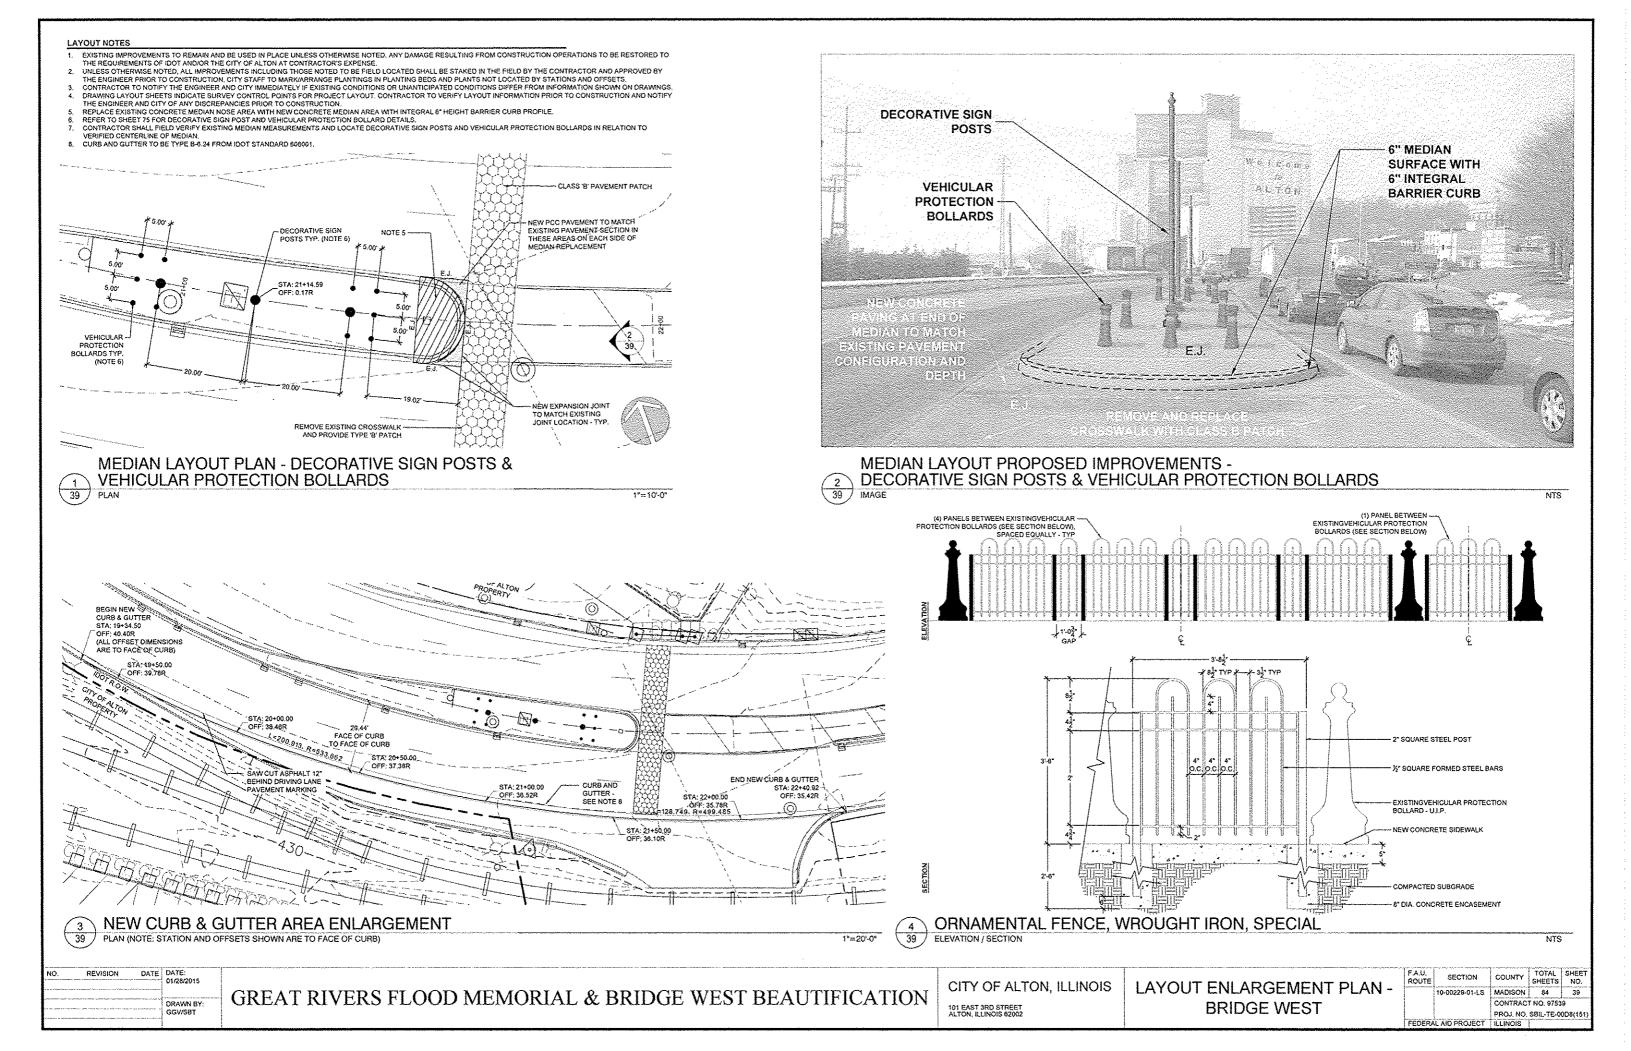

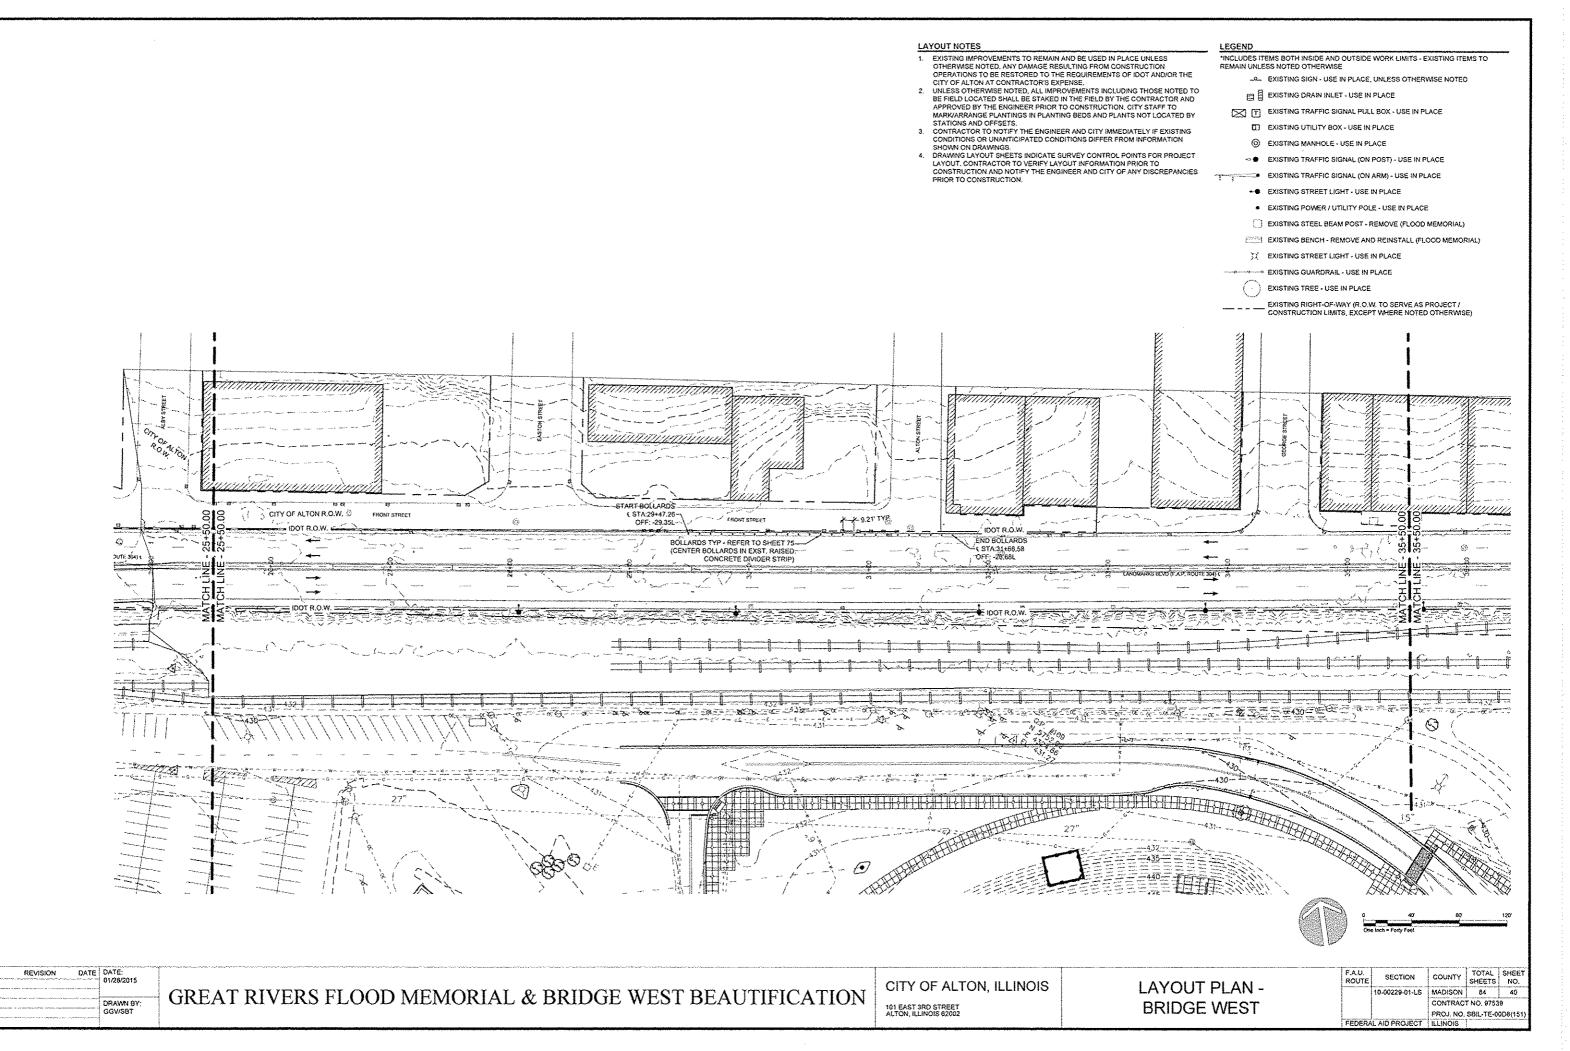

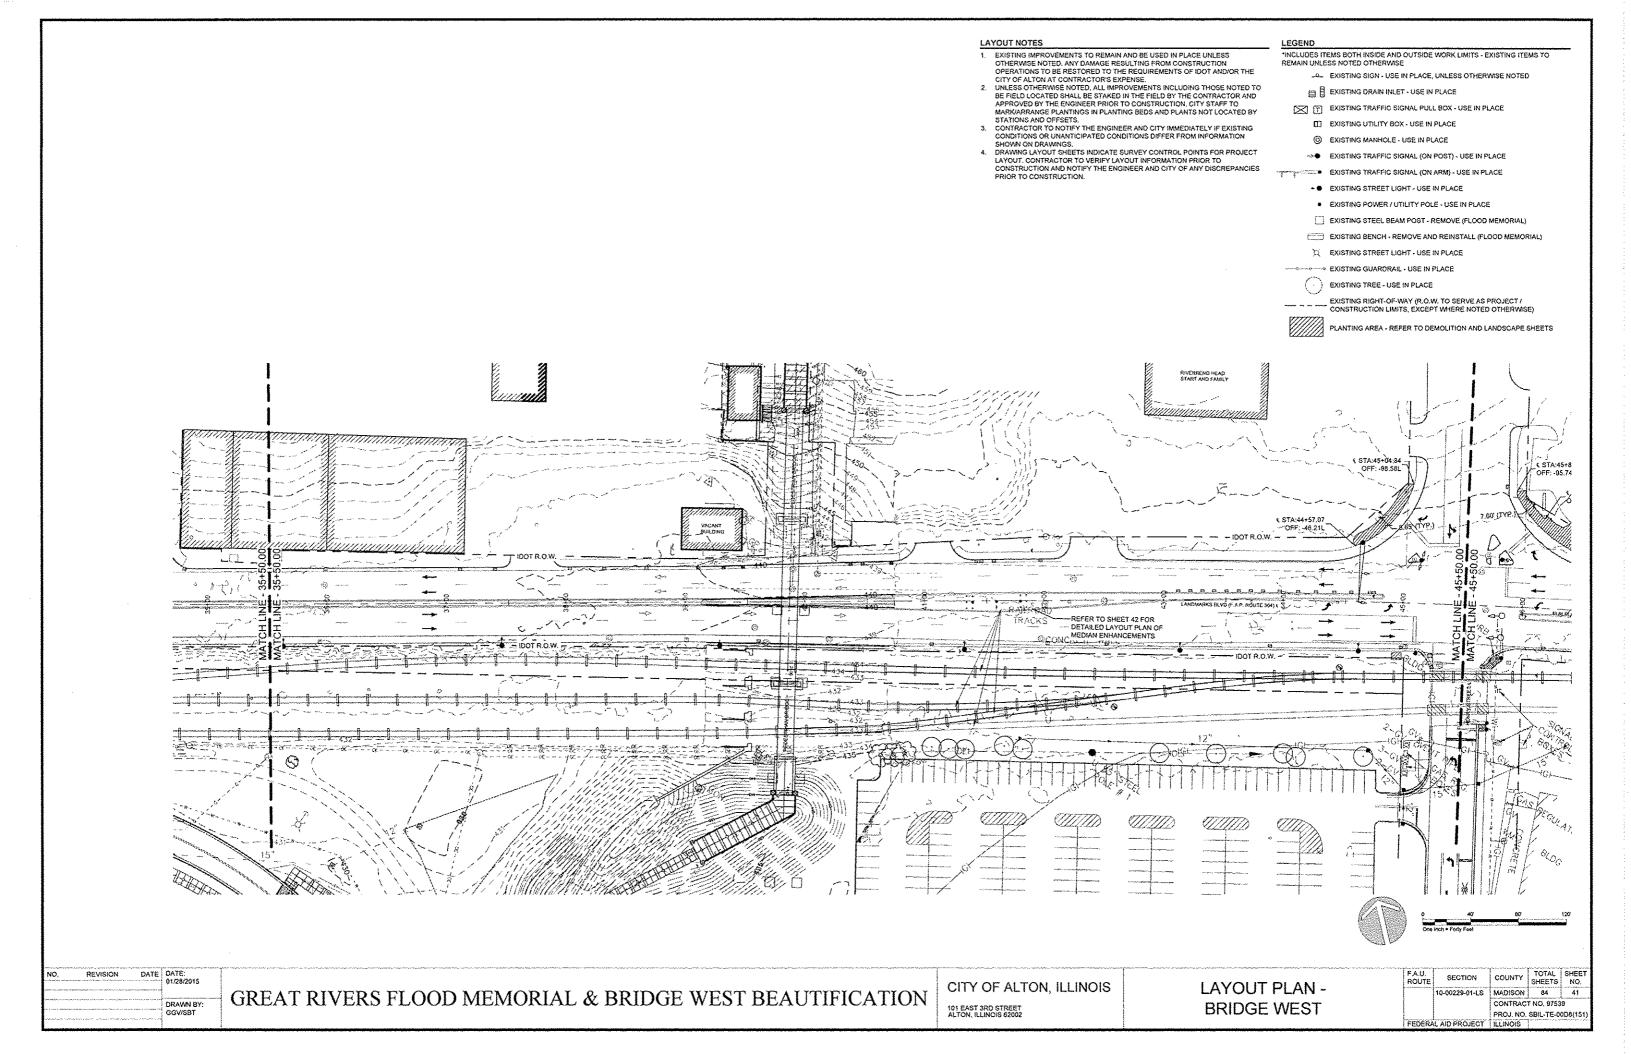

# LAYOUT NOTES


- 1. EXISTING IMPROVEMENTS TO REMAIN AND BE USED IN PLACE UNLESS OTHERWISE NOTED, ANY DAMAGE RESULTING FROM CONSTRUCTION OPERATIONS TO BE RESTORED TO THE REQUIREMENTS OF IDOT AND/OR THE CITY OF ALTON AT CONTRACTOR'S EXPENSE.
- 2. UNLESS OTHERWISE NOTED, ALL IMPROVEMENTS INCLUDING THOSE NOTED TO BE FIELD LOCATED SHALL BE STAKED IN THE FIELD BY THE CONTRACTOR AND APPROVED BY THE ENGINEER PRIOR TO CONSTRUCTION. CITY STAFF TO MARK/ARRANGE PLANTINGS IN PLANTING BEDS AND PLANTS NOT LOCATED BY STATIONS AND OFFSETS.

  3. CONTRACTOR TO NOTIFY THE ENGINEER AND CITY IMMEDIATELY IF EXISTING
- CONDITIONS OR UNANTICIPATED CONDITIONS DIFFER FROM INFORMATION
- SHOWN ON DRAWINGS.

  4. DRAWING LAYOUT SHEETS INDICATE SURVEY CONTROL POINTS FOR PROJECT LAYOUT, CONTRACTOR TO VERIFY LAYOUT INFORMATION PRIOR TO
- LAYOUT. CONTRACTOR TO VERIFY LAYOUT INFORMATION PRIOR TO CONSTRUCTION AND NOTIFY THE ENGINEER AND CITY OF ANY DISCREPANCIES PRIOR TO CONSTRUCTION.

  5. REFER TO SHEET 75 FOR DECORATIVE SIGN POST AND VEHICULAR PROTECTION BOLLARD DETAILS.

  6. CONTRACTOR SHALL FIELD VERIFY EXISTING MEDIAN MEASUREMENTS AND LOCATE DECORATIVE SIGN POSTS AND VEHICULAR PROTECTION BOLLARDS IN RELATION TO VERIFIED CENTERLINE OF MEDIAN.

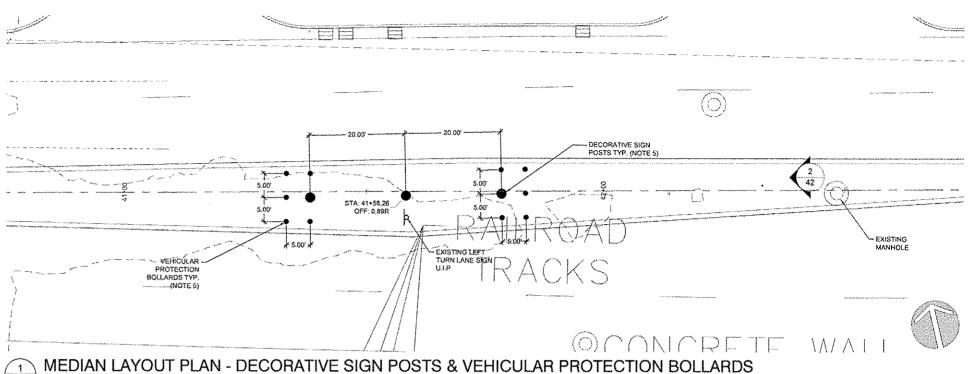



MEDIAN LAYOUT PROPOSED IMPROVEMENTS - DECORATIVE SIGN POSTS & VEHICULAR PROTECTION BOLLARDS  $\binom{2}{42}$ IMAGE


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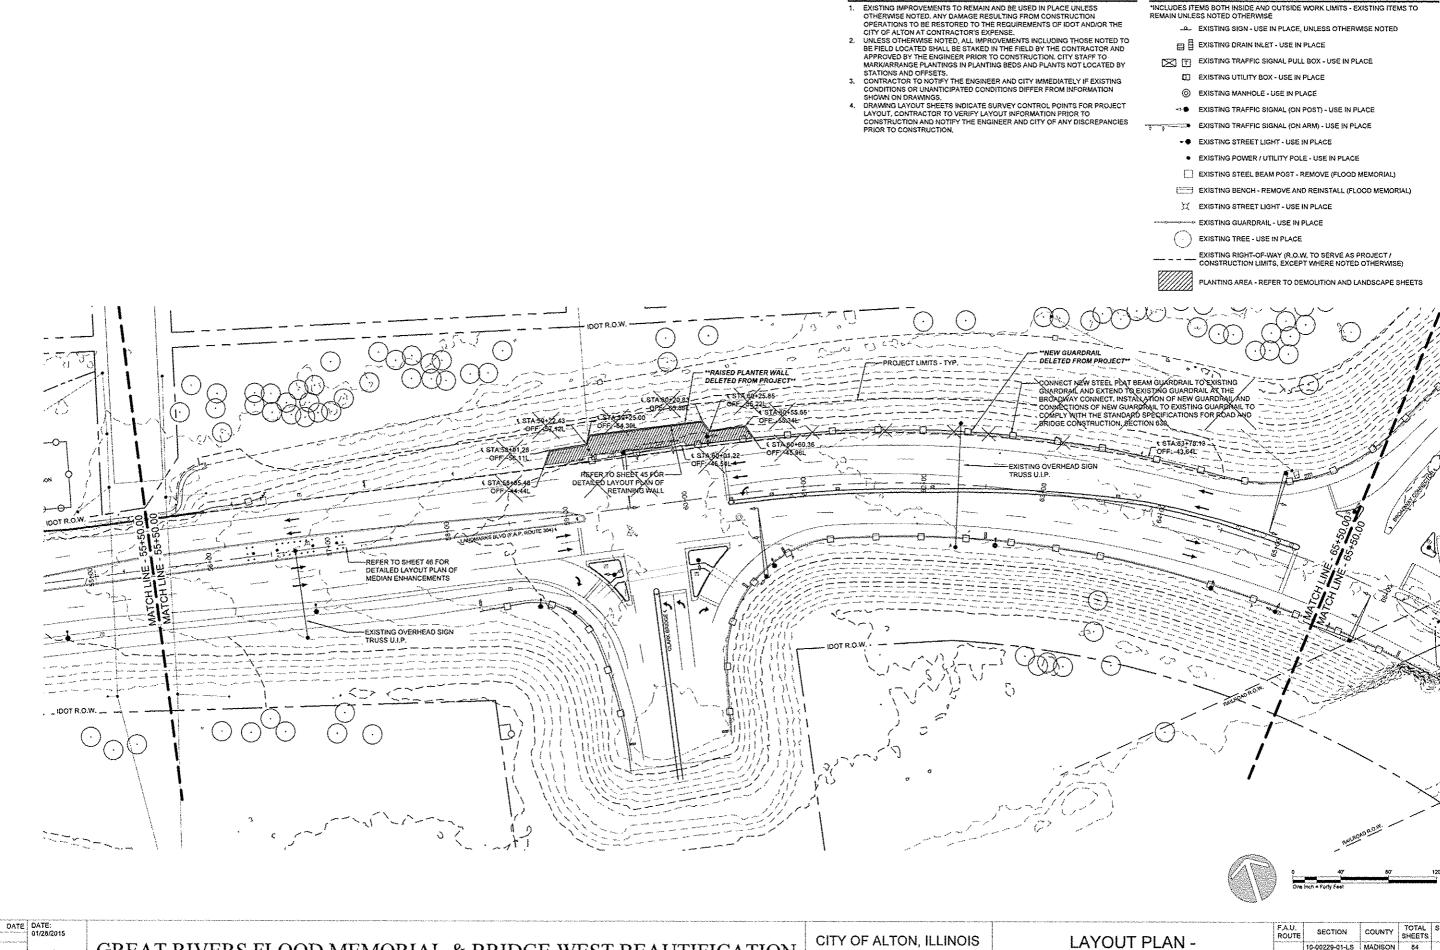
GREAT RIVERS FLOOD MEMORIAL & BRIDGE WEST BEAUTIFICATION

CITY OF ALTON, ILLINOIS

LAYOUT ENLARGEMENT PLAN -**BRIDGE WEST** 

F.A.U. ROUTE	SECTION	COUNTY	TOTAL SHEETS	SHEET NO.
	10-00229-01-LS	MADISON	84	42
		CONTRACT NO. 97539		
		PROJ. NO.	SBIL-TE-0	008(151)
FEDERA	L AID PROJECT	ILLINOIS	g. of continent count	. recover an annual reco



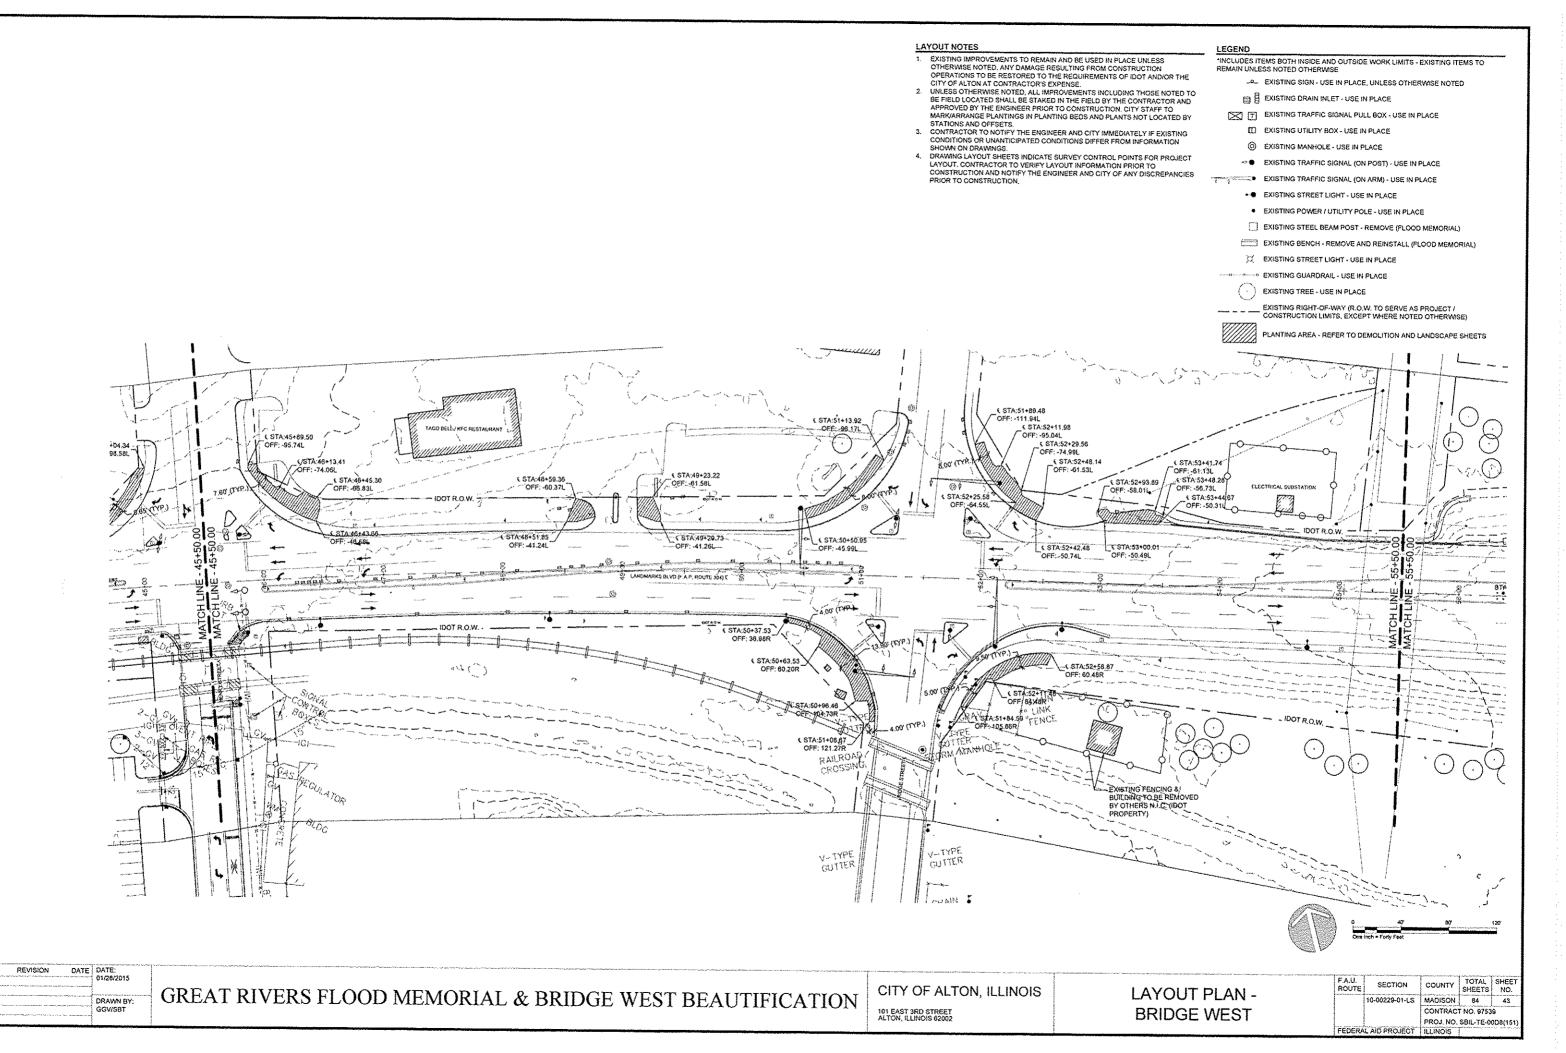

GREAT RIVERS FLOOD MEMORIAL & BRIDGE WEST BEAUTIFICATION

**BRIDGE WEST** 

 F.A.U. ROUTE	SECTION	COUNTY	TOTAL SHEETS	SHEE NO.
	10-00229-01-LS	MADISON	84	44
		CONTRAC	T NO. 9753	18
-		PROJ. NO.	SBIL-TE-0	0D8(15
ECOCO/	LAID DOO COT	I I I GIOIC	·	

## LAYOUT NOTES


- EXISTING IMPROVEMENTS TO REMAIN AND BE USED IN PLACE UNLESS OTHERWISE NOTED. ANY DAMAGE RESULTING FROM CONSTRUCTION OPERATIONS TO BE RESTORED TO THE REQUIREMENTS OF IDOT AND/OR THE CITY OF ALTON AT CONTRACTOR'S EXPENSE.
- 2. UNLESS OTHERWISE NOTED, ALL IMPROVEMENTS INCLUDING THOSE NOTED TO BE FIELD LOCATED SHALL BE STAKED IN THE FIELD BY THE CONTRACTOR AND APPROVED BY THE ENGINEER PRIOR TO CONSTRUCTION, CITY STAFF TO MARK/ARRANGE PLANTINGS IN PLANTING BEDS AND PLANTS NOT LOCATED BY
- STATIONS AND OFFSETS.
  CONTRACTOR TO NOTIFY THE ENGINEER AND CITY IMMEDIATELY IF EXISTING CONDITIONS OR UNANTIGIPATED CONDITIONS DIFFER FROM INFORMATION SHOWN ON DRAWNIGS.
- SHOWN ON DEVANINGS.

  DRAWING LAYOUT SHEETS INDICATE SURVEY CONTROL POINTS FOR PROJECT LAYOUT, CONTRACTOR TO VERIFY LAYOUT INFORMATION PRIOR TO CONSTRUCTION AND NOTIFY THE ENGINEER AND CITY OF ANY DISCREPANCIES PRIOR TO CONSTRUCTION.

INCLUDES ITEMS BOTH INSIDE AND OUTSIDE WORK LIMITS - EXISTING ITEMS TO

- \_Q\_ EXISTING SIGN USE IN PLACE, UNLESS OTHERWISE NOTED
- EXISTING DRAIN INLET USE IN PLACE
- EXISTING TRAFFIC SIGNAL PULL BOX USE IN PLACE
  - EXISTING UTILITY BOX USE IN PLACE

  - EXISTING TRAFFIC SIGNAL (ON POST) USE IN PLACE
- EXISTING TRAFFIC SIGNAL (ON ARM) USE IN PLACE
  - **-●** EXISTING STREET LIGHT USE IN PLACE
  - . EXISTING POWER / UTILITY POLE USE IN PLACE
  - EXISTING STEEL BEAM POST REMOVE (FLOOD MEMORIAL
- EXISTING BENCH REMOVE AND REINSTALL (FLOOD MEMORIAL)
- XX EXISTING STREET LIGHT USE IN PLACE
- EXISTING GUARDRAIL USE IN PLACE
- EXISTING TREE USE IN PLACE
- EXISTING RIGHT-OF-WAY (R.O.W. TO SERVE AS PROJECT / CONSTRUCTION LIMITS, EXCEPT WHERE NOTED OTHERWISE)

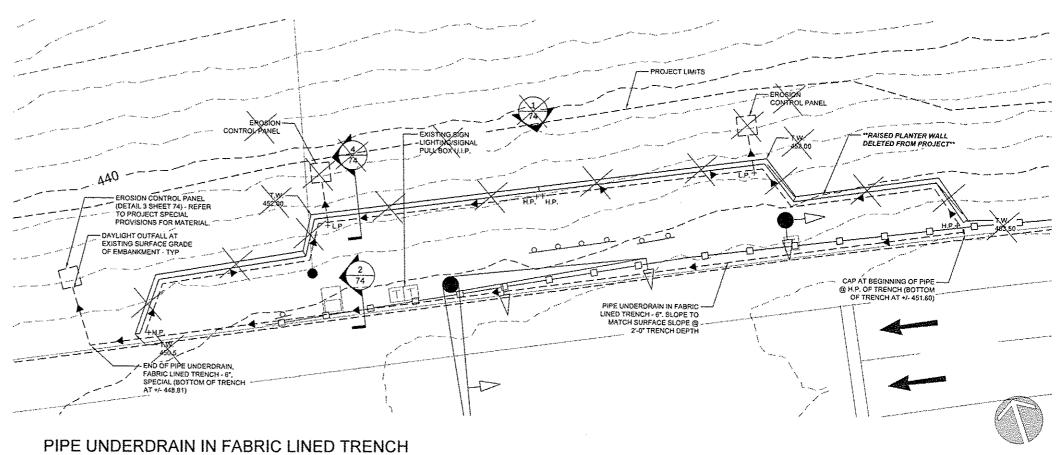

RETAINING WALL AT CLARK BRIDGE INTERSECTION

1" = 10'-0"

DATE DATE: 01/28/2015 REVISION

GREAT RIVERS FLOOD MEMORIAL & BRIDGE WEST BEAUTIFICATION

CITY OF ALTON, ILLINOIS


LAYOUT ENLARGEMENT PLAN -**BRIDGE WEST** 

 
 SECTION
 COUNTY
 TOTAL SHEETS NO.
 SHEET NO.


 10-00229-01-LS
 MADISON
 84
 45
 F.A.U. ROUTE CONTRACT NO. 97539 PROJ. NO. SBIL-TE-00D8(15 FEDERAL AID PROJECT ILLINOIS

# LAYOUT NOTES

- 1. EXISTING IMPROVEMENTS TO REMAIN AND BE USED IN PLACE UNLESS OTHERWISE NOTED. ANY DAMAGE RESULTING FROM CONSTRUCTION OPERATIONS TO BE RESTORED TO THE REQUIREMENTS OF IDOT AND/OR THE CITY OF ALTON AT CONTRACTOR'S EXPENSE.
  2. UNLESS OTHERWISE NOTED. ALL IMPROVEMENTS INCLUDING THOSE NOTED TO BE FIELD LOCATED SHALL BE STAKED IN THE FIELD BY THE CONTRACTOR AND APPROVED BY THE ENGINEER PRIOR TO CONSTRUCTION. CITY STAFF TO MARK/ARRANGE PLANTINGS IN PLANTING BEDS AND PLANTS NOT LOCATED BY STATIONS AND OFFSETS.
  3. CONTRACTOR TO NOTIFY THE ENGINEER AND CITY IMMEDIATELY IF EXISTING CONDITIONS OR UNANTICIPATED CONDITIONS DIFFER FROM INFORMATION SHOWN ON DRAWINGS.
  4. DRAWINGS.
  5. DRAWING LAYOUT SHEETS INDICATE SURVEY CONTROL POINTS FOR PROJECT LAYOUT, CONTRACTOR TO VERIFY LAYOUT INFORMATION PRIOR TO CONSTRUCTION AND NOTIFY THE ENGINEER AND CITY OF ANY DISCREPANCIES PRIOR TO CONSTRUCTION.
  5. REFER TO SHEET 75 FOR DECORATIVE SIGN POST AND VEHICULAR PROTECTION BOLLARD DETAILS.
  6. CONTRACTOR SHALL FIELD VERIFY EXISTING MEDIAN MEASUREMENTS AND LOCATE DECORATIVE SIGN POSTS AND VEHICULAR PROTECTION BOLLARDS IN RELATION TO VERIFIED CENTERLINE OF MEDIAN.

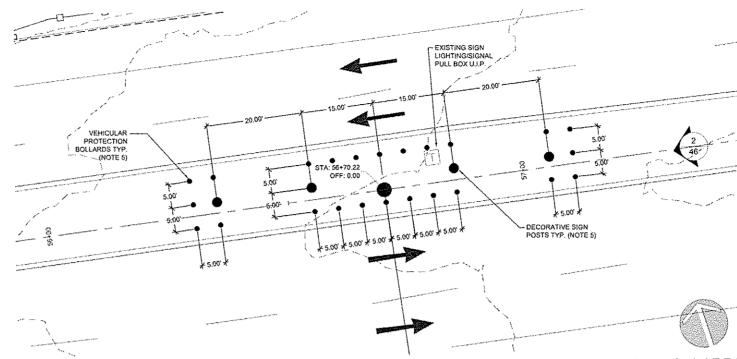

MEDIAN LAYOUT PLAN - DECORATIVE SIGN POSTS & VEHICULAR PROTECTION BOLLARDS

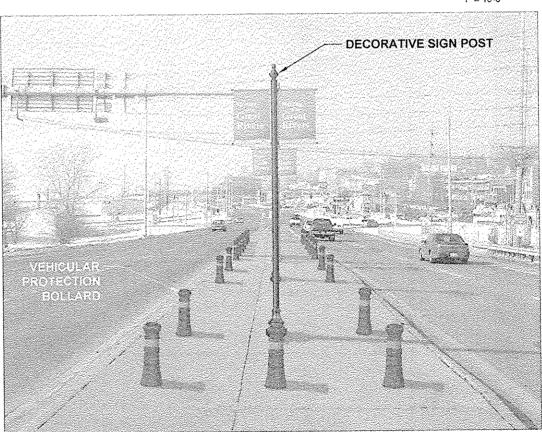

MEDIAN LAYOUT PROPOSED IMPROVEMENTS - DECORATIVE SIGN POSTS & VEHICULAR PROTECTION BOLLARDS

NO.	REVISION	DATE	DATE: 01/28/2015
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AT RIVERS FLOOD MEMORIAL & BRIDGE WEST BEAUTIFICATION	· vyrysy syntasyn tako
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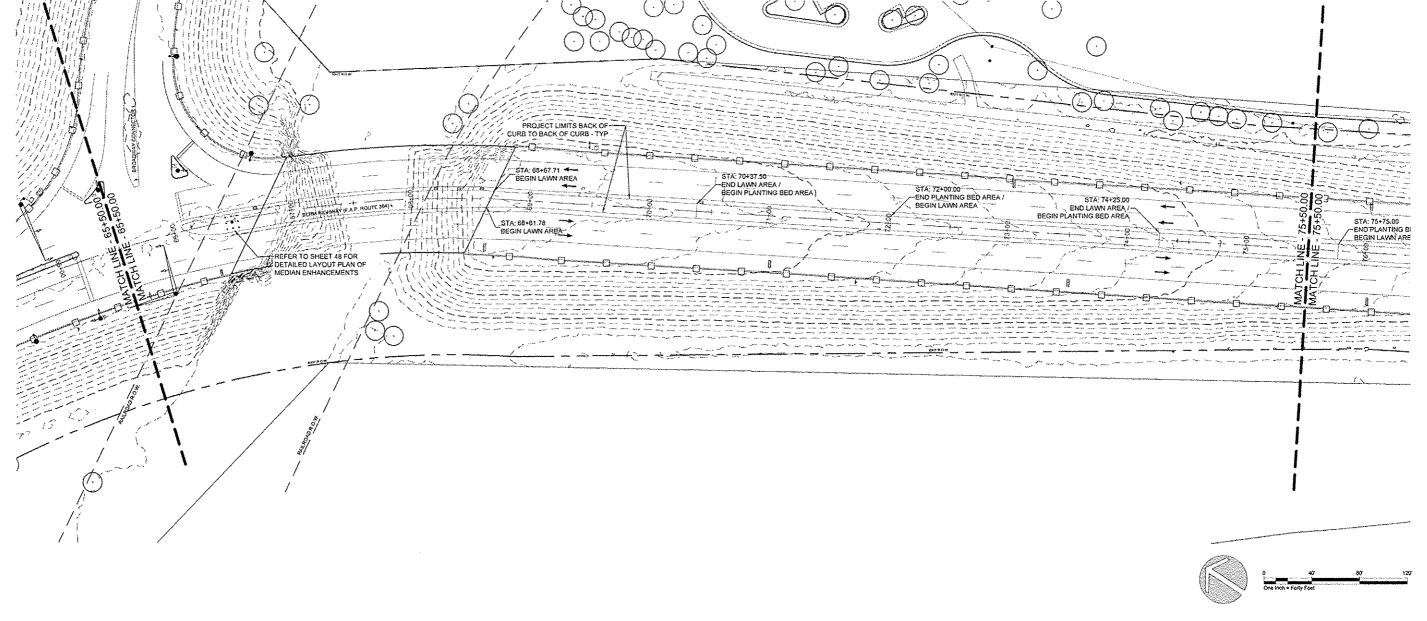
CITY OF ALTON, ILLINOIS

101 EAST 3RD STREET ALTON, ILLINOIS 62002

LAYOUT	PLAN -
<b>BRIDGE</b>	WEST

F.A.U. ROUTE	SECTION	COUNTY	TOTAL SHEETS	SHEET NO.
	10-00229-01-LS	MADISON	84	46
		CONTRACT	T NO. 9753	9
		PROJ. NO.	SBIL-TE-0	0D8(151)
FEDERA	AL AID PROJECT	ILLINOIS		

# LAYOUT NOTES LEGEND LAYOUT NOTES 1. EXISTING IMPROVEMENTS TO REMAIN AND BE USED IN PLACE UNLESS OTHERWISE NOTED. ANY DAMAGE RESULTING FROM CONSTRUCTION OPERATIONS TO BE RESTORED TO THE REQUIREMENTS OF IDOT AND/OR THE CITY OF ALTON AT CONTRACTOR'S EXPENSE. 2. UNLESS OTHERWISE NOTED, ALL IMPROVEMENTS INCLUDING THOSE NOTED TO BE FIELD LOCATED SHALL BE STAKED IN THE FIELD BY THE CONTRACTOR AND APPROVED BY THE ENGINEER PRIOR TO CONSTRUCTION. CITY STAFF TO MARK/ARRANGE PLANTINGS IN PLANTING BEDS AND PLANTS NOT LOCATED BY STATIONS AND OFFSETS. 3. CONTRACTOR TO NOTIFY THE ENGINEER AND CITY IMMEDIATELY IF EXISTING CONDITIONS OR UNANTICIPATED CONDITIONS DIFFER FROM INFORMATION SHOWN ON DRAWNOS. 4. DRAWING LAYOUT SHEETS INDICATE SURVEY CONTROL POINTS FOR PROJECT LAYOUT. CONTRACTOR TO VERIFY LAYOUT INFORMATION PRIOR TO CONSTRUCTION AND NOTIFY THE ENGINEER AND CITY OF ANY DISCREPANCIES PRIOR TO CONSTRUCTION. "INCLUDES ITEMS BOTH INSIDE AND OUTSIDE WORK LIMITS - EXISTING ITEMS TO REMAIN UNLESS NOTED OTHERWISE \_O\_ EXISTING SIGN - USE IN PLACE, UNLESS OTHERWISE NOTED B EXISTING DRAIN INLET - USE IN PLACE EXISTING TRAFFIC SIGNAL PULL BOX - USE IN PLACE EXISTING UTILITY BOX - USE IN PLACE EXISTING MANHOLE - USE IN PLACE → ■ EXISTING TRAFFIC SIGNAL (ON POST) - USE IN PLACE EXISTING TRAFFIC SIGNAL (ON ARM) - USE IN PLACE . EXISTING POWER / UTILITY POLE - USE IN PLACE EXISTING STEEL BEAM POST - REMOVE (FLOOD MEMORIAL) EXISTING BENCH - REMOVE AND REINSTALL (FLOOD MEMORIAL) EXISTING STREET LIGHT - USE IN PLACE -->--> EXISTING GUARDRAIL - USE IN PLACE EXISTING TREE - USE IN PLACE EXISTING RIGHT-OF-WAY (R.O.W. TO SERVE AS PROJECT / CONSTRUCTION LIMITS, EXCEPT WHERE NOTED OTHERWISE)



NO.	REVISION	DATE	DATE: 01/28/2015
			DRAWN BY: GGV/SBT

GREAT RIVERS FLOOD MEMORIAL & BRIDGE WEST BEAUTIFICATION

CITY OF ALTON, ILLINOIS

101 EAST 3RD STREET ALTON, ILLINOIS 62002 LAYOUT PLAN -BRIDGE WEST


 F.A.U. ROUTE	SECTION	COUNTY	TOTAL SHEETS	SHEET NO.
	10-00229-01-LS	MADISON	84	47
Washington And Andrews		CONTRAC	T NO. 9753	9
	All Parts	PROJ. NO.	SBIL-TE-0	0D8(151
FEDERA	L AID PROJECT	ILLINOIS	Ţ/	

### LAYOUT NOTES

- EXISTING IMPROVEMENTS TO REMAIN AND BE USED IN PLACE UNLESS
  OTHERWISE NOTED. ANY DAMAGE RESULTING FROM CONSTRUCTION
  OPERATIONS TO BE RESTORED TO THE REQUIREMENTS OF IDOT AND/OR THE
- OPERATIONS TO BE RESTORED TO THE REQUIREMENTS OF IDDT AND/OR THE CITY OF ALTON AT CONTRACTOR'S EXPENSE.

  2. UNLESS OTHERWISE NOTED, ALL IMPROVEMENTS INCLUDING THOSE NOTED TO BE FIELD LOCATED SHALL BE STAKED IN THE FIELD BY THE CONTRACTOR AND APPROVED BY THE ENGINEER PRIOR TO CONSTRUCTION, CITY STAFF TO MARK/ARRANGE PLANTINGS IN PLANTING BEDS AND PLANTS NOT LOCATED BY STATIONS AND OFFSETS.

  3. CONTRACTOR TO NOTIFY THE ENGINEER AND CITY IMMEDIATELY IF EXISTING CONDITIONS OF THE NAME/CHARTED CONDITIONS CITYED BY MICEOBARTICAL.
- CONTRACTOR TO NOTIFY THE ENGINEER AND CITY IMMEDIATELY IF EXISTING
  CONDITIONS OR UNANTICIPATED CONDITIONS DIFFER FROM INFORMATION
  SHOWN ON DRAWINGS.
   DRAWING LAYOUT SHEETS INDICATE SURVEY CONTROL POINTS FOR PROJECT
  LAYOUT. CONTRACTOR TO VERIEY LAYOUT INFORMATION PRIOR TO
  CONSTRUCTION AND NOTIFY THE ENGINEER AND CITY OF ANY DISCREPANCIES
  PRIOR TO CONSTRUCTION.
   REFER TO SHEET 75 FOR DECORATIVE SIGN POST AND VEHICULAR PROTECTION
  BOLLARD DETAILS.
- REPER 10 SHEEL 15 FOR DECORATIVE SIGN POST AND VEHICULAR PROTECTION BOLLARD DETAILS.
   CONTRACTOR SHALL FIELD VERIFY EXISTING MEDIAN MEASUREMENTS AND LOCATE DECORATIVE SIGN POSTS AND VEHICULAR PROTECTION BOLLARDS IN RELATION TO VERIFIED CENTERLINE OF MEDIAN.

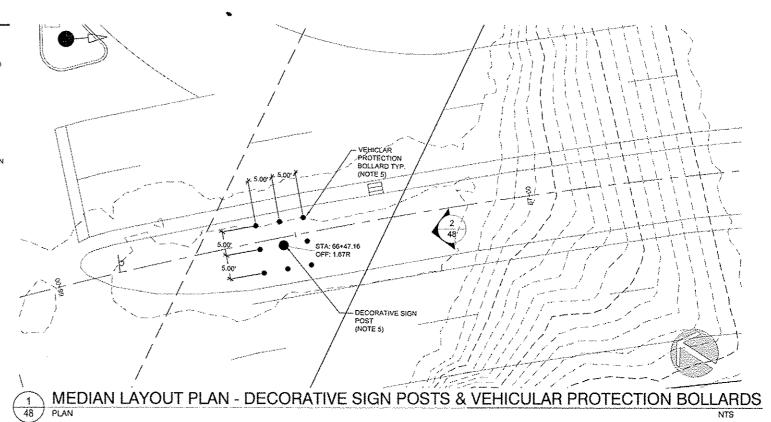

DECORATIVE SIGN POST VEHICULAR **PROTECTION BOLLARDS** 

MEDIAN LAYOUT PROPOSED IMPROVEMENTS - DECORATIVE SIGN POSTS & VEHICULAR PROTECTION BOLLARDS  $\frac{2}{48}$ IMAGE


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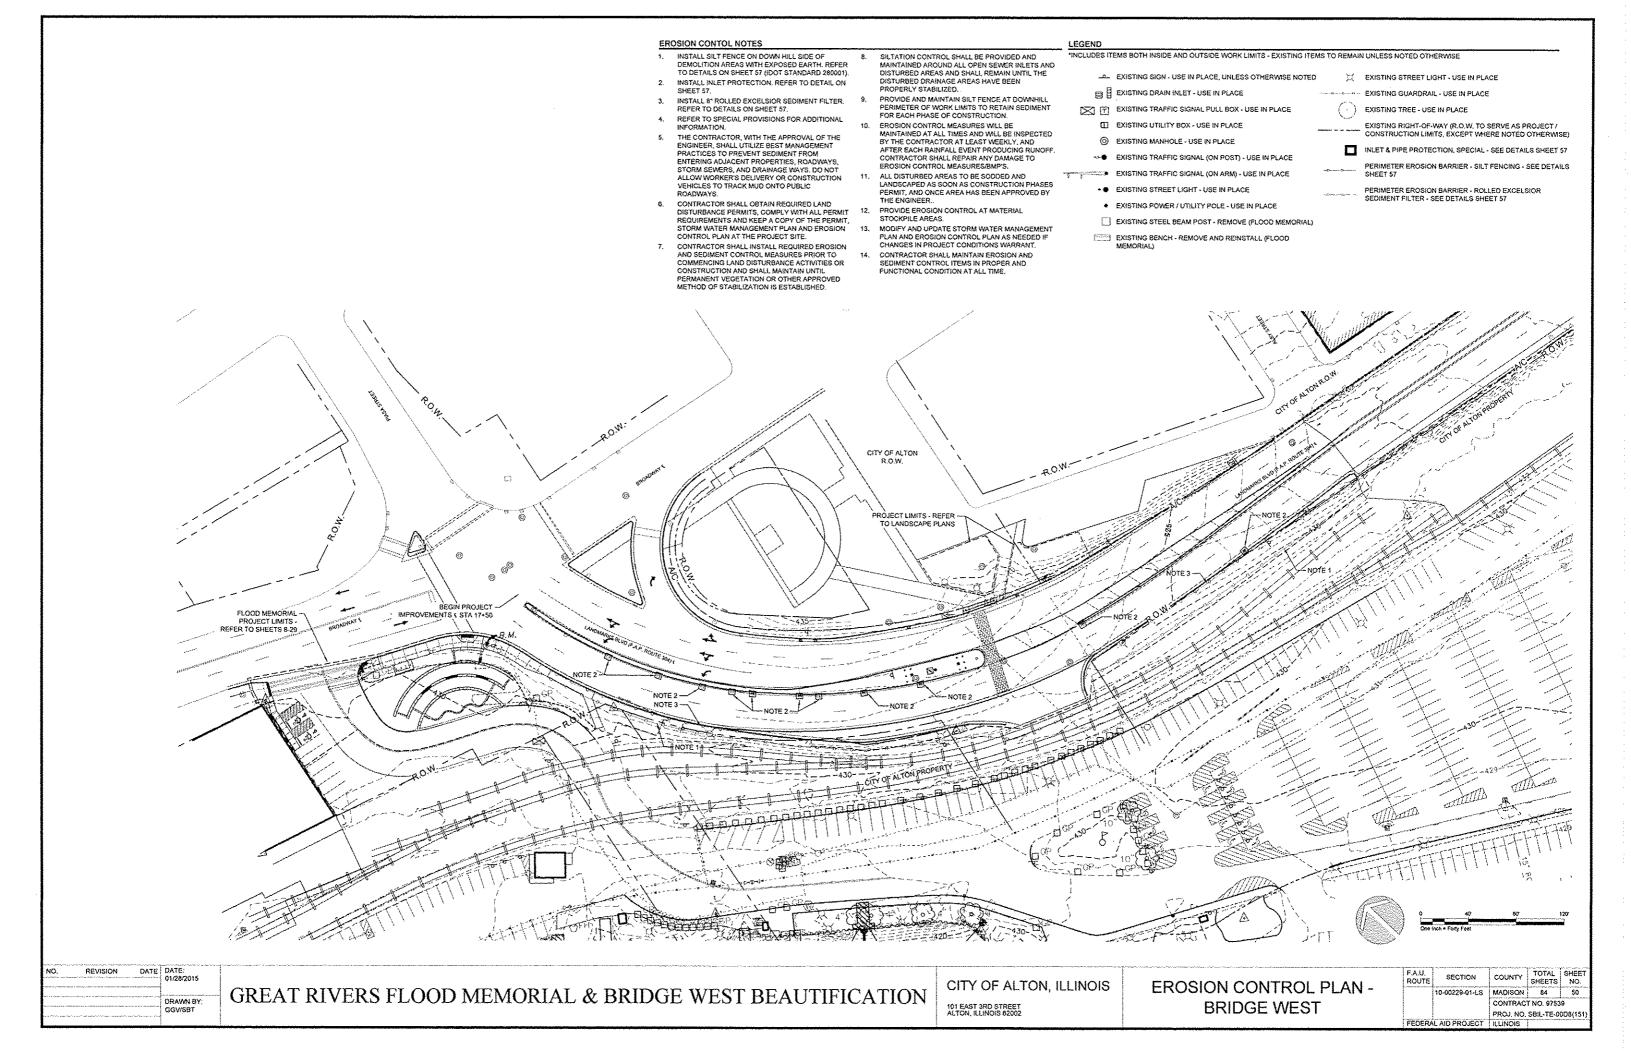
GREAT RIVERS FLOOD MEMORIAL & BRIDGE WEST BEAUTIFICATION


CITY OF ALTON, ILLINOIS


LAYOUT ENLARGEMENT PLAN -**BRIDGE WEST** 


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	F.A.U. ROUTE	SECTION 10-00229-01-LS	MADISON	TOTAL SHEETS	SHEET NO.




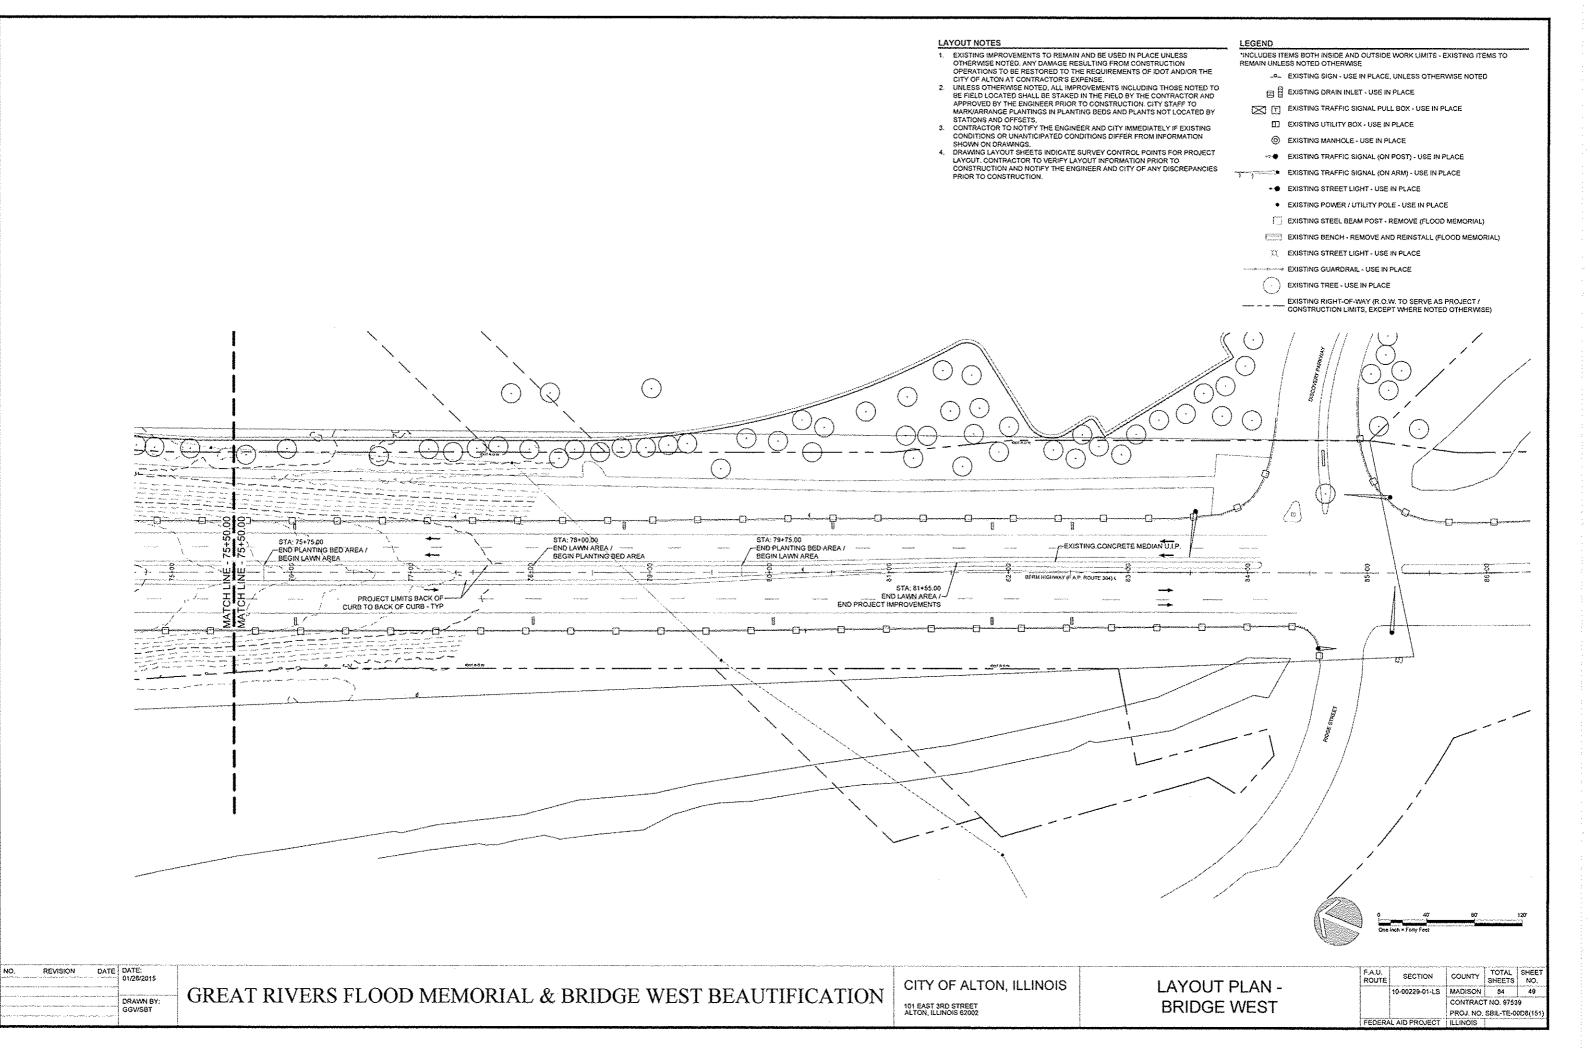

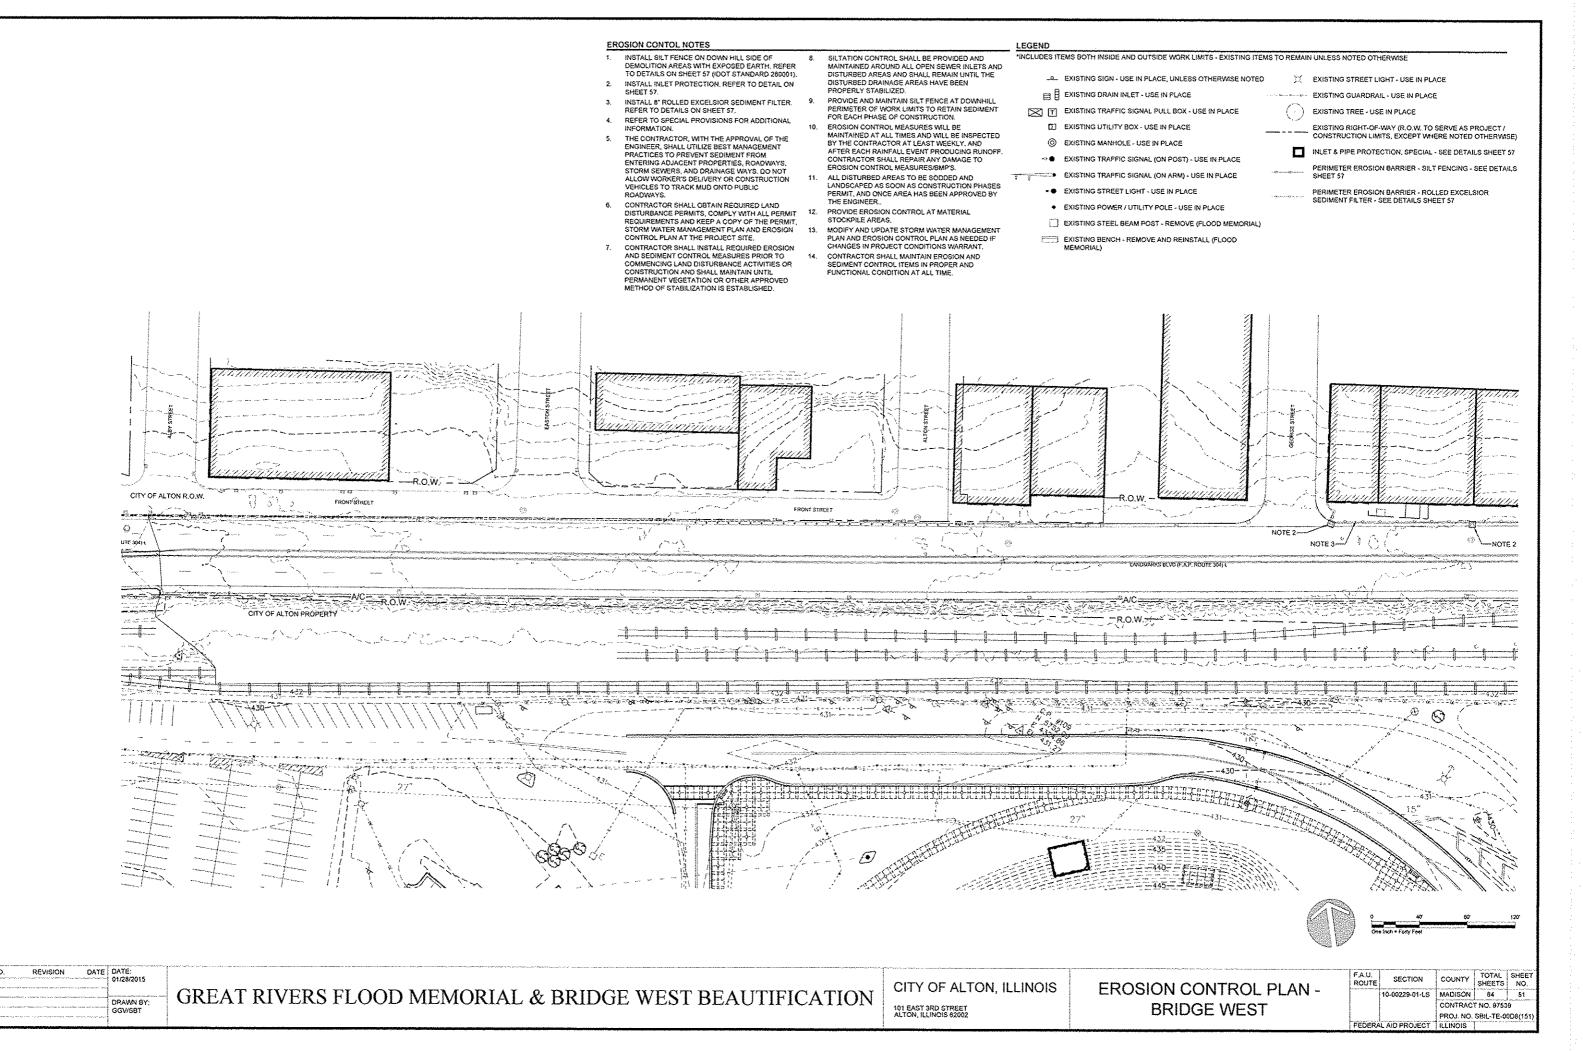

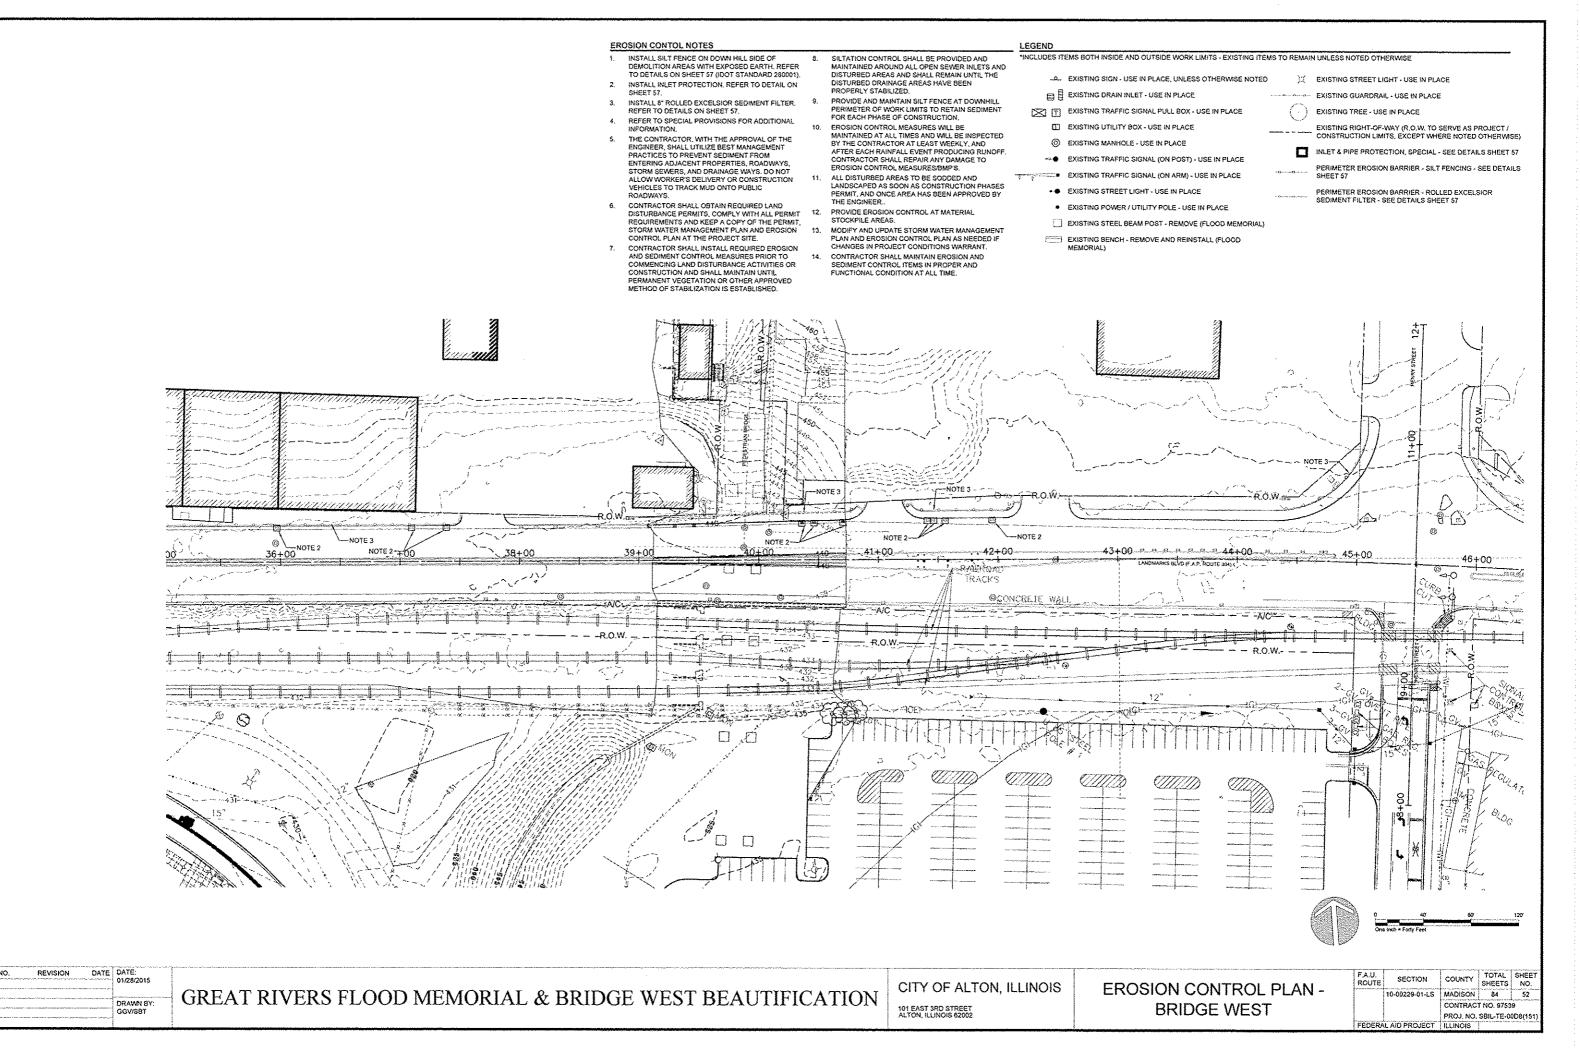

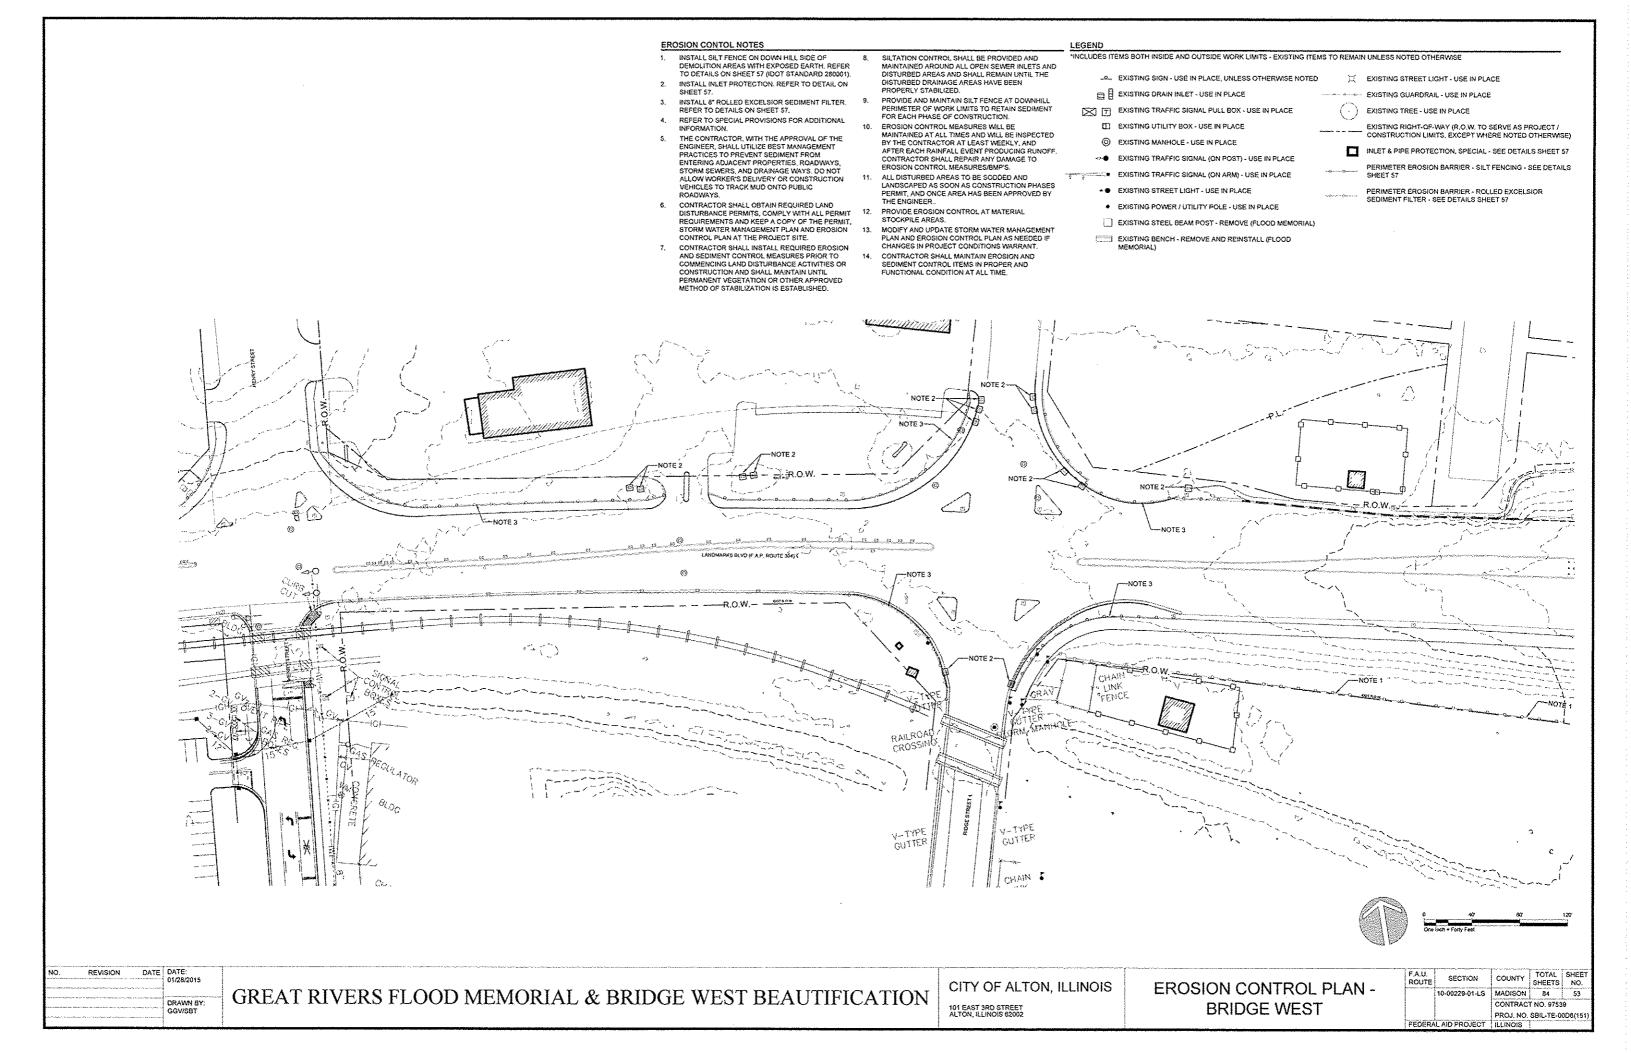


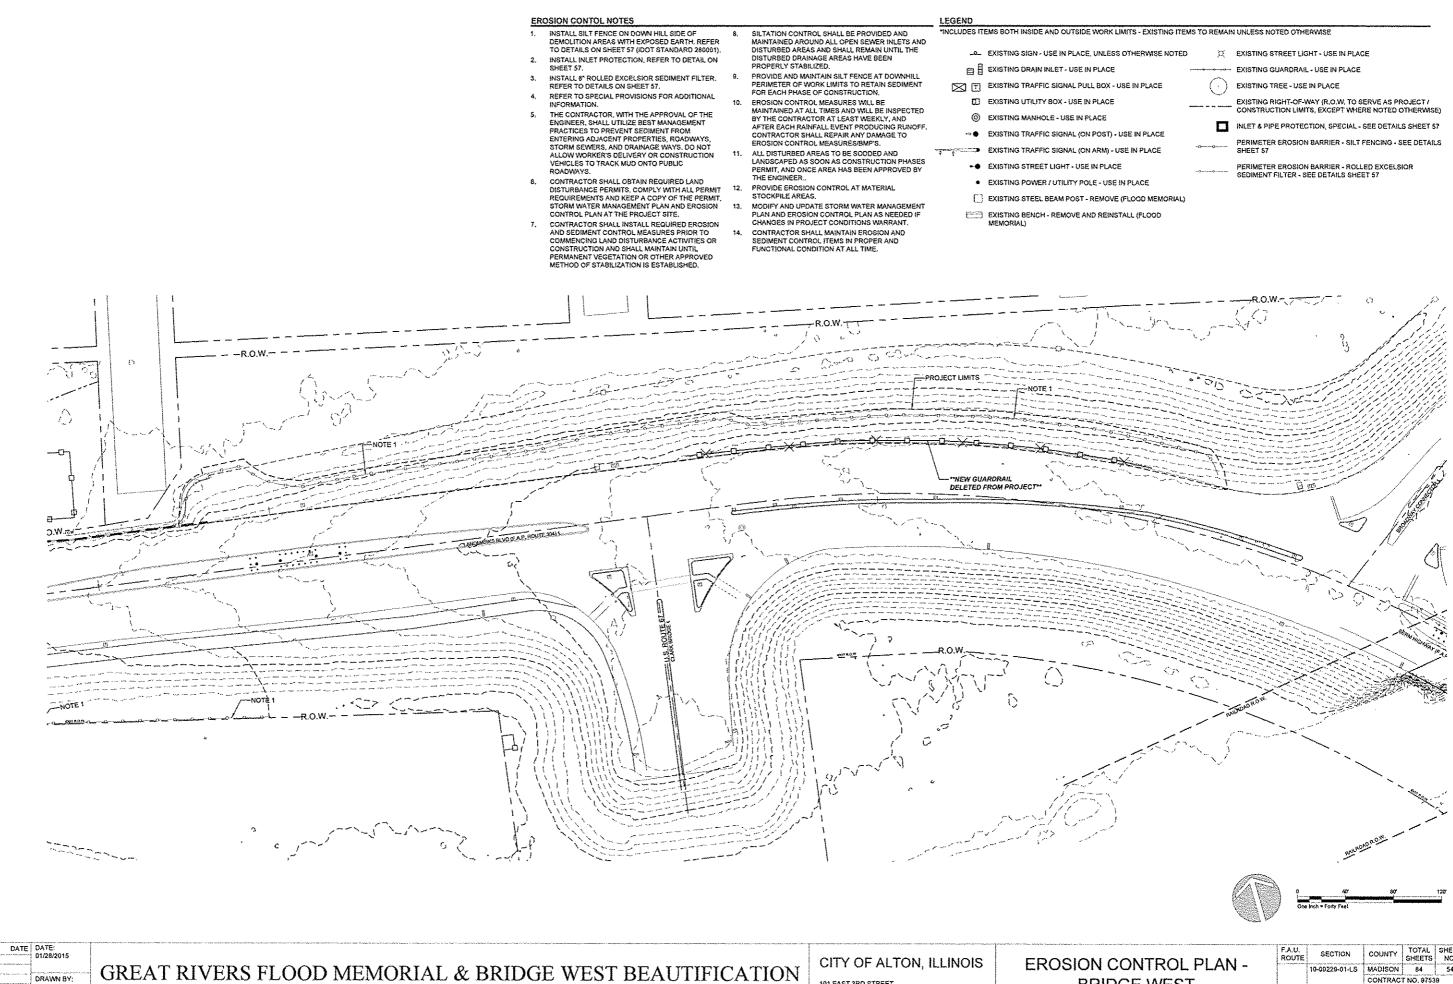


GREAT RIVERS FLOOD MEMORIAL & BRIDGE WEST BEAUTIFICATION

**BRIDGE WEST** 


TOTAL SHEET SHEETS NO. 10-00229-01-LS MADISON 84 CONTRACT NO. 97539 PROJ. NO, SBIL-TE-00D8(1 FEDERAL AID PROJECT ILLINOIS

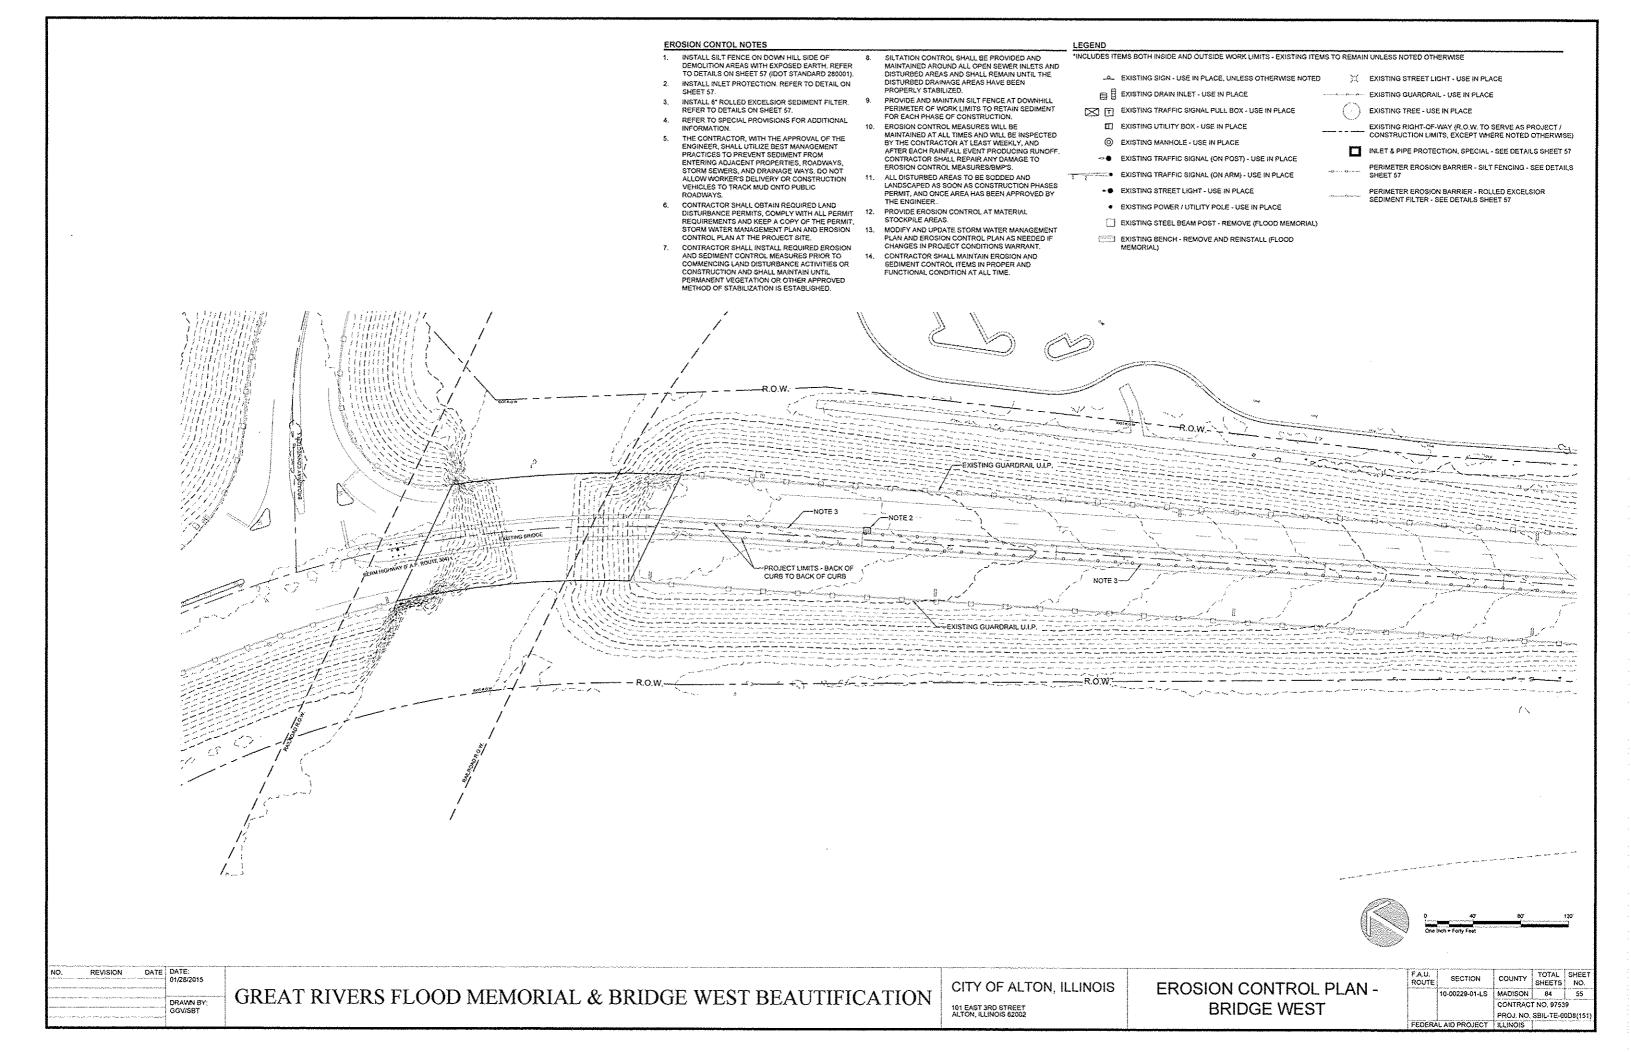

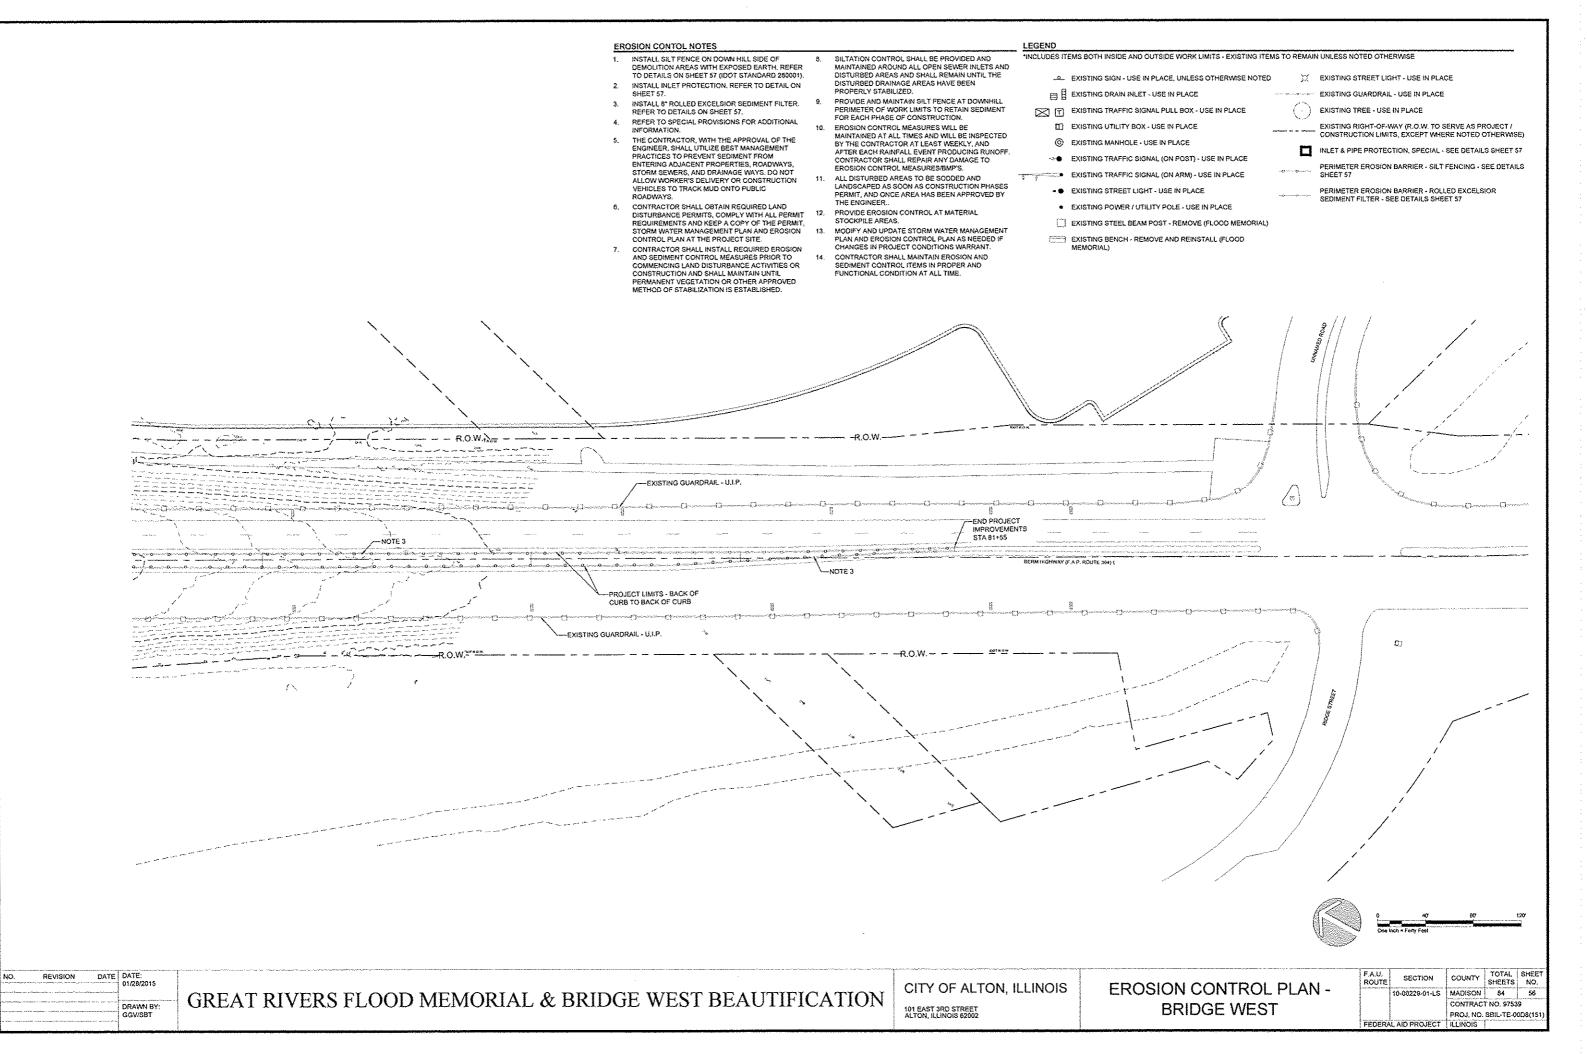


NOT USED

NOTE: REFER TO SHEET 74 FOR EROSION CONTROL PANEL DETAILS AT RETAINING WALL PLANTER AREA.

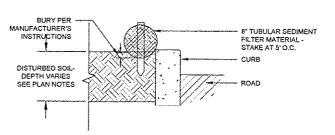


# SEDIMENT FILTER AT CURB

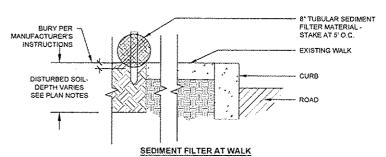

PERIMETER EROSION BARRIER - ROLLED EXCELSIOR SEDIMENT FILTER DETAILS

OPTION 1 - EXCESS FILTER
MATERIAL TO BE DRAWN IN AND
TIED OFF TO 2X2 WOODEN STAKE. LAWN OR PAVEMENT OPTION 2 - EXCESS FILTER MATERIAL TO BE DRAWN IN AND FASTENED TO VERTICAL GRATE MEMBER,

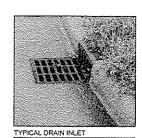

NTS

CURB INLET PROTECTION

WIRE TIES - TYP 8" ROBUEDREXEDUNEDR FILTER SECURIAL FREEZWATERIAL -SECENWARKOESTORM GRATE

AREA INLET PROTECTION

INLET PROTECTION, SPECIAL - DETAILS -REFER TO PROJECT SPECIAL PROVISIONS  $\binom{3}{57}$ 

NTS

DATE DATE: 01/28/2015 REVISION

GREAT RIVERS FLOOD MEMORIAL & BRIDGE WEST BEAUTIFICATION

CITY OF ALTON, ILLINOIS 101 EAST 3RD STREET ALTON, ILLINOIS 62002

**EROSION CONTROL DETAILS -BRIDGE WEST** 

F.A.U. ROUTE	SECTION	COUNTY	TOTAL SHEETS	SHEET NO.
	09-00226-00-MS	MADISON	84	57
		CONTRAC	T NO. 9753	9
		PROJ. NO.	SBIL-TE-0	0D8(151)
FEDERA	L AID PROJECT	ILUNOIS		

	PLANT MATERIAL KEY									
KEY	BOTANICAL NAME	COMMON NAME	KEY	BOTANICAL NAME	COMMON NAME					
SHADE TREE			PERENNIAL							
PSG	GINKGO BILOBA 'PRINCETON SENTRY'	PRINCETON SENTRY GINKGO	BES	RUDBECKIA HIRTA	BLACK-EYED SUSAN					
SWO	QUERCUS BICOLOR	SWAMP WHITE OAK	BMW	ASCLEPIAS TUBEROSA	BUTTERFLY MILKWEED					
SSM	ACER RUBRUM 'SCARLET SENTINEL'	'SCARLET SENTINEL' MAPLE	C8C	COREOPSIS 'CREME BRULEE'	'CREME BRULEE' COREOPSIS					
INTERMEDIATE TREE				PANICUM VIRGATUM 'DALLAS BLUES'	'DALLAS BLUES' SWITCHGRASS					
ASS	AMELANCHIER X GRANDIFLORA ' AUTUMN BRILLANCE	'AUTUMN BRILLIANCE' SERVICEBERRY	PCF	ECHINACEA PURPUREA 'ELTON KNIGHT'	'ELTON KNIGHT' PURPLE CONEFLOWER					
ER8	CERCIS CANADENSIS	EASTERN RED BUD	PDS	SPOROBOLUS HETEROLEPIS	PRAIRIE DROPSEED					
MS	MALUS SPP. 'SENTINEL'	MALUS 'SENTINEL' (CLUMP FORM)	SSG	PANICUM VIRGATUM 'SHENANDOAH'	'SHENANDOAH' SWITCHGRASS					
SSM	MAGNOLIA VIRGINIANA	SWEET BAY MAGNOLIA	GROUNDCO	VER						
TSC	MALUS SARGENTII 'TINA'	'TINA' SARGENT CRABAPPLE	BBL	LIRIOPE X MUSCARI 'BIG BLUE'	'BIG BLUE' LIRIOPE					
EVERGREEN	TREE		MŁ,	LIRIOPE X MUSCARI MAJESTIC	'MAJESTIC' LIRIOPE					
\$8	PICEA OMORIKA	SERBIAN SPRUCE								
DECIDUOUS	SHRUB									
BMAV	VIBURNUM DENTATUM 'BLUE MUFFIN'	'BLUE MUFFIN' ARROWWOOD VIBURNUM								
GLFS	RHUS AROMATICA 'GROW-LO'	'GROW-LO' FRAGRANT SUMAC								
LHVS	ITEA VIRGINICA 'LITTLE HENRY'S'	LITTLE HENRY'S' VIRGINIA SWEETSPIRE								
MAV	VIBURNUM DENTATUM 'MORTON'	'MORYON' ARROWMOOD VIBURNUM								
RCB	ARONIA ARBUTIFOLIA 'BRILLANTISSIMA'	RED CHOKEBERRY								

- ALL EXISTING VEGETATION TO REMAIN AND BE PROTECTED UNLESS NOTES OTHERWISE. DAMAGE TO VEGETATION FROM CONSTRUCTION ACTIVITIES SHALL BE REPLACED TO SATISFACTION OF THE OWNER AT CONTRACTOR'S EXPENSE.
- CONTRACTOR SHALL BE RESPONSIBLE FOR COORDINATION
  WITH OTHER SITE RELATED CONSTRUCTION IN ORDER TO
  MEET SPECIFIED PLANTING SCHEDULES.
- CONTRACTOR SHALL BE RESPONSIBLE FOR TOPSOIL
   PLACEMENT AND FINAL SHAPING REQUIREMENTS FOR SOD
   AND LANDSCAPE PLANTINGS.
- ALL PLANTING BED AREAS TO BE STAKED BY THE CONTRACTOR FOR APPROVAL BY ENGINEER PRIOR TO LANDSCAPE OPERATIONS.
- CITY STAFF TO SPACE INDIVIDUAL PLANTS WITHIN PLANTING BED AREAS AT ON-CENTER SPACING INDICATED AND MARK LOCATIONS WITH FLAGS FOR INSTALLATION BY THE CONTRACTOR.
- CONTRACTOR TO LOCATE TREES AS INDICATED BY CENTERLINE STATION AND OFFSETS, AND/OR DIMENSIONS SHOWN, MARK LOCATIONS WITH FLAGS FOR APPROVAL BY ENGINEER, MAINTAIN 10" MINIMUM SETBACK FROM EDGE OF DRIVING LANE TO FACE OF THE TREE TRUNK UNLESS OTHERWISE NOTED.
- CONTRACTOR SHALL VERIFY QUANTITIES AND CONDITIONS PRIOR TO BIDDING AND IMPLEMENTATION, SUBSTITUTIONS WILL NOT BE ALLOWED FOR TYPES AND SIZES OR PLANTS WITHOUT PRIOR WRITTEN APPROVAL OF THE ENGINEER

- 8. SIZES SHOWN IN PLANT SCHEDULE ARE MINIMUM ACCEPTABLE SIZES, COMPLY WITH ANSI Z60,1 (CURRENT EDITION), ENGINEER RESERVES THE RIGHT TO REQUEST PHOTOS OF TAGGED PLANTS AND/OR INSPECT PLANT MATERIAL AT THE NURSERY PRIOR TO DELIVERY TO THE
- PROJECT SITE.

  9. CONTRACTOR TO COMPLY WITH ALL SPECIFIED SUBMITTAL REQUIREMENTS AND OBTAIN APPROVED SUBMITTALS PRIOR TO STARTING SOD AND LANDSCAPE PLANTING WORK
- THE ILLINOIS DEPARTMENT OF TRANSPORTATION SHALL REQUIRE 48 HOURS ADVANCE NOTICE FROM CONTRACTOR PRIOR TO IMPLEMENTATION OF LANDSCAPE ACTIVITIES.
   THE CONTRACTOR WILL COORDINATE A FIELD REVIEW AND
- APPROVAL OF THE IRRIGATION SYSTEM INSTALLATION WITH THE ILLINOIS DEPARTMENT OF TRANSPORTATION.

  12. THE ILLINOIS DEPARTMENT OF TRANSPORTATION SHALL CONDUCT A FINAL INSPECTION OF THE IRRIGATION SYSTEM AND THE DECORATIVE LIGHTING UNITS PRIOR TO THE CITY OF ALTON APPROVING THESE ITEMS.
- 13. ALL AREAS INDICATED AS LAWN TO BE SODDED BLEND OF BUFFAL OGRASS (BUCHLOE DACTYLOIDES) ACCEPTABLE TO IDOT AS FOLLOWS: 'LEGACY', 'CODY', '315' OR (80-10-10) BLEND OF ALL THREE IN ORDER LISTED.
- REFER TO LAYOUT PLANS FOR LOCATIONS OF PLANTING BED AREAS (SHRUBS AND PERENNIALS), REFER TO IRRIGATION PLANS FOR LAYOUT OF DRIP SYSTEM IN PLANTING BED AREAS.
- IRRIGATION PLANS FOR LATOUT OF UNIT STOLES.
  PLANTING BED AREAS.

  15. FIELD ADJUST PLANTINGS AS NEEDED, AND AS APPROVED BY THE ENGINEER, FOLLOWING THE STAKING OF UNDERGROUND UTILITIES. REFER TO DEMOLITION SHEETS FOR UTILITY LOCATIONS.

#### EGEND

\*INCLUDES ITEMS BOTH INSIDE AND OUTSIDE WORK LIMITS - EXISTING ITEMS TO REMAIN UNLESS NOTED OTHERWISE

EXISTING SIGN - USE IN PLACE, UNLESS OTHERWISE NOTED

E EXISTING DRAIN INLET - USE IN PLACE

EXISTING TRAFFIC SIGNAL PULL BOX - USE IN PLACE

[]] EXISTING UTILITY BOX - USE IN PLACE

EXISTING MANHOLE - USE IN PLACE

◆ EXISTING TRAFFIC SIGNAL (ON POST) - USE IN PLACE

EXISTING TRAFFIC SIGNAL (ON ARM) - USE IN PLACE

.. EXISTING STREET LIGHT - USE IN PLACE

EXISTING POWER / UTILITY POLE - USE IN PLACE

EXISTING STEEL BEAM POST - REMOVE (FLOOD MEMORIAL)


EXISTING BENCH - REMOVE AND REINSTALL (FLOOD MEMORIAL)

X EXISTING STREET LIGHT - USE IN PLACE

---- EXISTING GUARDRAIL - USE IN PLACE

( - ) EXISTING TREE - USE IN PLACE

EXISTING RIGHT-OF-WAY (R.O.W. TO SERVE AS PROJECT / CONSTRUCTION LIMITS, EXCEPT WHERE NOTED OTHERWISE)

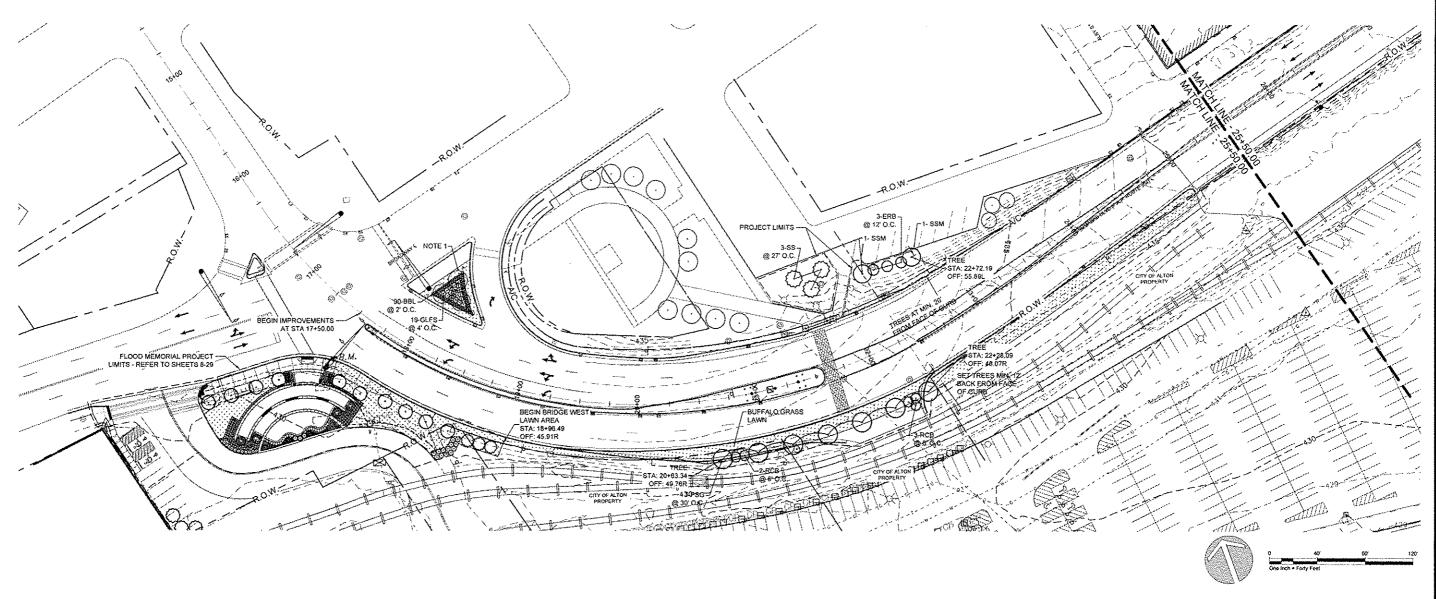

NO. REVISION DATE DATE: 01/28/2015

DRAWN 8Y: GGV/SBT

GREAT RIVERS FLOOD MEMORIAL & BRIDGE WEST BEAUTIFICATION

CITY OF ALTON, ILLINOIS

101 EAST 3RD STREET ALTON, ILLINOIS 62002 LANDSCAPE PLAN -BRIDGE WEST

	PLANT MATERIAL KEY									
KEY	BOTANICAL NAME	COMMON NAME	KEY	BOTANICAL NAME	COMMON NAME					
SHADE TRE	E		PERENNIAL	-	1					
PSG	GINKGO BILOBA 'PRINCETON SENTRY'	PRINCETON SENTRY GINKGO	BES	RUDBECKIA HIRTA	BLACK-EYED SUSAN					
SWO	QUERCUS BICOLOR	SWAMP WHITE OAK	BMW	ASCLEPIAS TUBEROSA	BUTTERFLY MILKWEED					
SSM	ACER RUBRUM 'SCARLET SENTINEL'	'SCARLET SENTINEL' MAPLE	CBC	COREOPSIS 'CREME BRULEE'	'CREME BRULEE' COREOPSIS					
INTERMEDIA	ATE TREE		DBSG	PANICUM VIRGATUM 'DALLAS BLUES'	'DALLAS BLUES' SWITCHGRASS					
ABS	AMELANCHIER X GRANDIFLORA ' AUTUMN BRILLANCE	'AUTUMN BRILLIANCE' SERVICEBERRY	PCF	ECHINACEA PURPUREA 'ELTON KNIGHT'	'ELTON KNIGHT' PURPLE CONEFLOWER					
ER8	CERCIS CANADENSIS	EASTERN RED BUD	POS	SPOROBOLUS HETEROLEPIS	PRAIRIE DROPSEED					
MS	MALUS SPP. 'SENTINEL'	MALUS 'SENTINEL' (CLUMP FORM)	SSG	PANICUM VIRGATUM 'SHENANDOAH' SHENANDOAH' SWITCHO						
SBM	MAGNOLIA VIRGINIANA	SWEET BAY MAGNOLIA	GROUNDCO	VER						
TSC	MALUS SARGENTII 'TINA'	'TINA' SARGENT CRABAPPLE	BBL	LIRIOPE X MUSCARI 'BIG BLUE'	BIG BLUE LIRIOPE					
EVERGREE!	N TREE		ML	LIRIOPE X MUSCARI MAJESTIC	'MAJESTIC' LIRIOPE					
88	PICEA OMORIKA	SERBIAN SPRUCE								
DECIDUOUS	SHRUB									
SMAV	VIBURNUM DENTATUM 'BLUE MUFFIN'	'BLUE MUFFIN' ARROWWOOD VIBURNUM								
GLFS	RHUS AROMATICA 'GROW-LO'	'GROW-LO' FRAGRANT SUMAC								
LHVS	ITEA VIRGINICA 'LITTLE HENRY'S'	'LITTLE HENRY'S' VIRGINIA SWEETSPIRE								
MAV	VIBURNUM DENTATUM 'MORTON'	'MORTON' ARROWMOOD VIBURNUM	1							
RCB	ARONIA ARBUTIFOLIA 'BRILLANTISSIMA'	RED CHOKEBERRY	1	·····						

- ALL EXISTING VEGETATION TO REMAIN AND BE PROTECTED UNLESS NOTES OTHERWISE. DAMAGE TO VEGETATION FROM CONSTRUCTION ACTIVITIES SHALL BE REPLACED TO SATISFACTION OF THE OWNER AT CONTRACTOR'S EXPENSE.
- 2. CONTRACTOR SHALL BE RESPONSIBLE FOR COORDINATION WITH OTHER SITE RELATED CONSTRUCTION IN ORDER TO MEET SPECIFIED PLANTING SCHEDULES. 3. CONTRACTOR SHALL BE RESPONSIBLE FOR TOPSOIL
- PLACEMENT AND FINAL SHAPING REQUIREMENTS FOR SOD AND LANDSCAPE PLANTINGS.
- 4. ALL PLANTING BED AREAS TO BE STAKED BY THE CONTRACTOR FOR APPROVAL BY ENGINEER PRIOR TO LANDSCAPE OPERATIONS.
  5. CITY STAFF TO SPACE INDIVIDUAL PLANTS WITHIN PLANTING BED AREAS AT ON-CENTER SPACING INDICATED AND MARK LOCATIONS WITH FLAGS FOR INSTALLATION BY THE CONTRACTOR.
- 6. CONTRACTOR TO LOCATE TREES AS INDICATED BY CENTERLINE STATION AND OFFSETS, AND/OR DIMENSIONS SHOWN. MARK LOCATIONS WITH FLAGS FOR APPROVAL BY ENGINEER, MAINTAIN 10' MINIMUM SETBACK FROM EDGE OF DRIVING LANE TO FACE OF THE TREE TRUNK UNLESS OTHERWISE NOTED.

  7. CONTRACTOR SHALL VERIFY QUANTITIES AND CONDITIONS
- PRIOR TO BIDDING AND IMPLEMENTATION, SUBSTITUTIONS WILL NOT BE ALLOWED FOR TYPES AND SIZES OR PLANTS WITHOUT PRIOR WRITTEN APPROVAL OF THE ENGINEER

- SIZES SHOWN IN PLANT SCHEDULE ARE MINIMUM ACCEPTABLE SIZES, COMPLY WITH ANSI 260.1 (CURRENT EDITION), ENGINEER RESERVES THE RIGHT TO REQUEST PHOTOS OF TAGGED PLANTS AND/OR INSPECT PLANT MATERIAL AT THE NURSERY PRIOR TO DELIVERY TO THE
- PROJECT SITE.

  CONTRACTOR TO COMPLY WITH ALL SPECIFIED SUBMITTAL
  REQUIREMENTS AND OBTAIN APPROVED SUBMITTALS PRIOR TO STARTING SOD AND LANDSCAPE PLANTING
- THE ILLINOIS DEPARTMENT OF TRANSPORTATION SHALL THE ILLINOIS DEPARTMENT OF TRANSPORTATION SHALL REQUIRE 48 HOURS ADVANCE NOTICE FROM CONTRACTOR PRIOR TO IMPLEMENTATION OF LANDSCAPE ACTIVITIES. THE CONTRACTOR WILL COORDINATE A FIELD REVIEW AND APPROVAL OF THE IRRIGATION SYSTEM INSTALLATION
- WITH THE ILLINOIS DEPARTMENT OF TRANSPORTATION.
  THE ILLINOIS DEPARTMENT OF TRANSPORTATION SHALL CONDUCT A FINAL INSPECTION OF THE IRRIGATION SYSTEM
- AND THE DECORATIVE LIGHTING UNITS PRIOR TO THE CITY OF ALTON APPROVING THESE ITEMS.

  13. ALL AREAS INDICATED AS LAWN TO BE SODDED BLEND OF
- BUFFALOGRASS (BUCHLOE DACTYLOIDES) ACCEPTABLE TO IDOT AS FOLLOWS: "LEGACY," CODY, "315" OR (80-10-10) BLEND OF ALL THREE IN ORDER LISTED. REFER TO LAYOUT PLANS FOR LOCATIONS OF PLANTING BED AREAS (SHRUBS AND PERENNIALS), REFER TO IRRIGATION PLANS FOR LAYOUT OF DRIP SYSTEM IN
- PLANTING BED AREAS 15. FIELD ADJUST PLANTINGS AS NEEDED, AND AS APPROVED BY THE ENGINEER, FOLLOWING THE STAKING OF UNDERGROUND UTILITIES, REFER TO DEMOLITION SHEETS

\*INCLUDES ITEMS BOTH INSIDE AND OUTSIDE WORK LIMITS - EXISTING ITEMS TO REMAIN UNLESS NOTED OTHERWISE

EXISTING SIGN - USE IN PLACE, UNLESS OTHERWISE NOTED

E EXISTING DRAIN INLET - USE IN PLACE

EXISTING TRAFFIC SIGNAL PULL BOX - USE IN PLACE

[] EXISTING UTILITY BOX - USE IN PLACE

(i) EXISTING MANHOLE - USE IN PLACE

EXISTING TRAFFIC SIGNAL (ON POST) - USE IN PLACE

EXISTING TRAFFIC SIGNAL (ON ARM) - USE IN PLACE

**★●** EXISTING STREET LIGHT - USE IN PLACE

. EXISTING POWER / UTILITY POLE - USE IN PLACE

EXISTING STEEL BEAM POST - REMOVE (FLOOD MEMORIAL)


EXISTING BENCH - REMOVE AND REINSTALL (FLOOD MEMORIAL)

EXISTING STREET LIGHT - USE IN PLACE

· EXISTING GUARDRAIL · USE IN PLACE

EXISTING TREE - USE IN PLACE

EXISTING RIGHT-OF-WAY (R.O.W. TO SERVE AS PROJECT / CONSTRUCTION LIMITS, EXCEPT WHERE NOTED OTHERWISE)

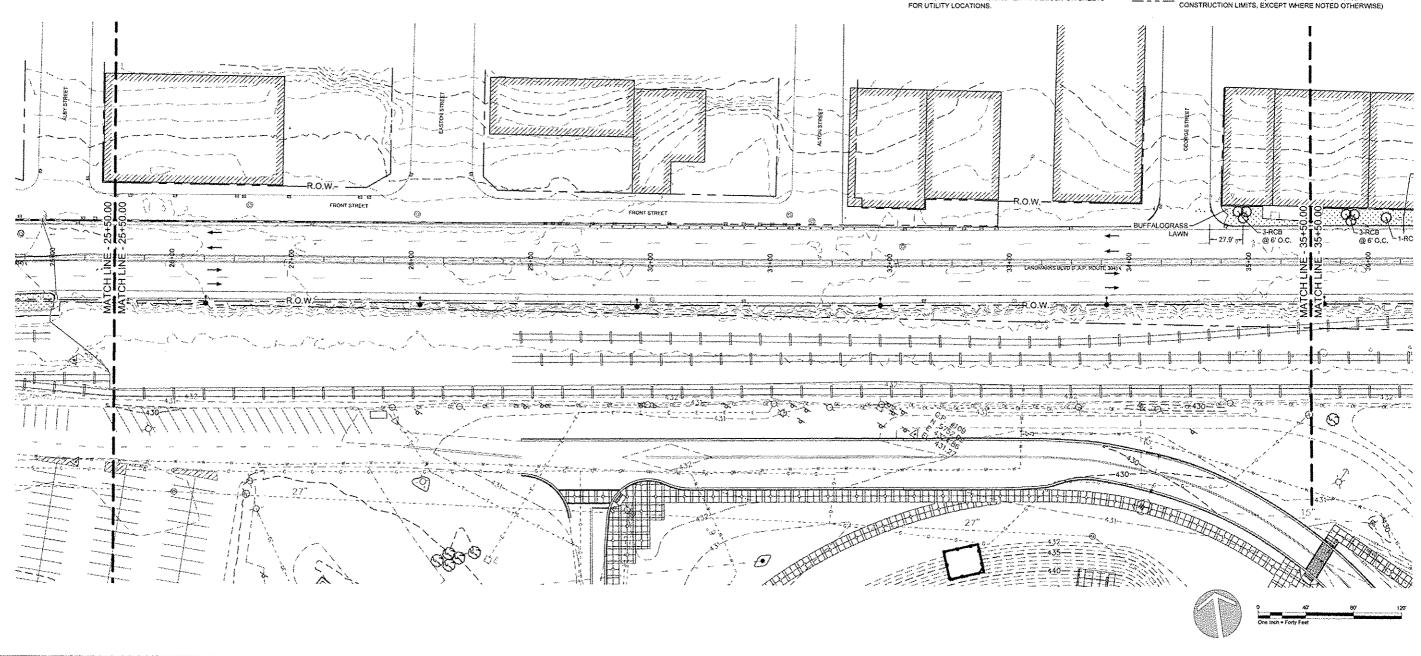

DATE DATE: 01/28/2015 REVISION DRAWN BY

GREAT RIVERS FLOOD MEMORIAL & BRIDGE WEST BEAUTIFICATION

CITY OF ALTON, ILLINOIS

LANDSCAPE PLAN -**BRIDGE WEST** 

F.A.U. ROUTE TOTAL SHEET SHEETS NO. SECTION COUNTY MADISON 84 10-00229-01-LS 59 CONTRACT NO. 97539 PROJ. NO. SBIL-TE-00D8(151 FEDERAL AID PROJECT ILLINOIS

<del> </del>		PLANT MATERIA	AL KEY		
KEY	BOTANICAL NAME	COMMON NAME	KEY	BOTANICAL NAME	COMMON NAME
SHADE TRE	E		PERENNIA	L	
PSG	GINKGO BILOBA 'PRINCETON SENTRY'	'PRINCETON SENTRY' GINKGO	BES	RUDBECKIA HIRTA	BLACK-EYED SUSAN
swo	QUERCUS BICOLOR	SWAMP WHITE OAK	BMW	ASCLEPIAS TUBEROSA	BUTTERFLY MILKWEED
SSM	ACER RUBRUM SCARLET SENTINEL	'SCARLET SENTINEL' MAPLE	CBC	COREOPSIS 'CREME BRULEE'	'CREME BRULEE' COREOPSIS
INTERMEDIATE TREE				PANICUM VIRGATUM 'DALLAS BLUES'	'DALLAS BLUES' SWITCHGRASS
ABS	AMELANCHIER X GRANDIFLORA ' AUTUMN BRILLANCE	'AUTUMN BRILLIANCE' SERVICEBERRY	PCF	ECHINACEA PURPUREA 'ELTON KNIGHT'	'ELTON KNIGHT PURPLE CONEFLOWER
ERB	CERCIS CANADENSIS	EASTERN RED BUD	PDS	SPOROBOLUS HETEROLEPIS	PRAIRIE DROPSEED
MS	MALUS SPP, 'SENTINEL'	MALUS 'SENTINEL' (CLUMP FORM)	SSG	PANICUM VIRGATUM 'SHENANDOAH'	'SHENANDOAH' SWITCHGRASS
SBM	MAGNOLIA VIRGINIANA	SWEET BAY MAGNOLIA	GROUNDC	OVER	
TSC	MALUS SARGENTII TINA'	TINA' SARGENT CRABAPPLE	BBL	LIRIOPE X MUSCARI 'BIG BLUE'	'BIG BLUE' LIRIOPE
EVERGREE	N TREE		ML	LIRIOPE X MUSCARI MAJESTIC	'MAJESTIC' LIRIOPE
98	PICEA OMORIKA	SERBIAN SPRUCE			
DECIDUOUS	SHRUB				
BMAV	VIBURNUM DENTATUM BLUE MUFFIN	'BLUE MUFFIN' ARROWWOOD VIBURNUM			
GLFS	RHUS AROMATICA 'GROW-LO'	'GROW-LO' FRAGRANT SUMAC			
LHVS	ITEA VIRGINICA 'LITTLE HENRY'S'	'LITTLE HENRY'S' VIRGINIA SWEETSPIRE			
MAV	VIBURNUM DENTATUM 'MORTON'	'MORTON' ARROWWOOD VIBURNUM	1		
RCB	ARONIA ARBUTIFOLIA 'BRILLANTISSIMA'	RED CHOKEBERRY	1		<u> </u>

- ALL EXISTING VEGETATION TO REMAIN AND BE PROTECTED UNLESS NOTES OTHERWISE. DAMAGE TO VEGETATION FROM CONSTRUCTION ACTIVITIES SHALL BE REPLACED TO SATISFACTION OF THE OWNER AT CONTRACTOR'S EXPENSE.
- CONTRACTOR SHALL BE RESPONSIBLE FOR COORDINATION WITH OTHER SITE RELATED CONSTRUCTION IN ORDER TO MEET SPECIFIED PLANTING SCHEDULES.
- MEET SPECIFIED PLANTING SCHEDULES.
  CONTRACTOR SHALL BE RESPONSIBLE FOR TOPSOIL
  PLACEMENT AND FINAL SHAPING REQUIREMENTS FOR SOD
  AND LANDSCAPE PLANTINGS.
  ALL PLANTING BED AREAS TO BE STAKED BY THE
  CONTRACTOR FOR APPROVAL BY ENGINEER PRIOR TO
  LANDSCAPE OPERATIONS.
- CITY STAFF TO SPACE INDIVIDUAL PLANTS WITHIN
- PLANTING BED AREAS AT ON-CENTER SPACING INDICATED AND MARK LOCATIONS WITH FLAGS FOR INSTALLATION BY THE CONTRACTOR.
- CONTRACTOR TO LOCATE TREES AS INDICATED BY CENTERLINE STATION AND OFFSETS, AND/OR DIMENSIONS SHOWN, MARK LOCATIONS WITH FLAGS FOR APPROVAL BY ENGINEER, MAINTAIN 10' MINIMUM SETBACK FROM EDGE OF OTHERWISE NOTED.
- CONTRACTOR SHALL VERIFY QUANTITIES AND CONDITIONS PRIOR TO BIDDING AND IMPLEMENTATION, SUBSTITUTIONS WILL NOT BE ALLOWED FOR TYPES AND SIZES OR PLANTS WITHOUT PRIOR WRITTEN APPROVAL OF THE ENGINEER

- SIZES SHOWN IN PLANT SCHEDULE ARE MINIMUM ACCEPTABLE SIZES, COMPLY WITH ANSI ZEO, 1 (CURRENT EDITION), ENGINEER RESERVES THE RIGHT TO REQUEST PHOTOS OF TAGGED PLANTS AND/OR INSPECT PLANT MATERIAL AT THE NURSERY PRIOR TO DELIVERY TO THE
- PROJECT SITE
  CONTRACTOR TO COMPLY WITH ALL SPECIFIED SUBMITTAL
  REQUIREMENTS AND OBTAIN APPROVED SUBMITTALS
- 10. THE ILLINOIS DEPARTMENT OF TRANSPORTATION SHALL REQUIRE 48 HOURS ADVANCE NOTICE FROM CONTRACTOR PRIOR TO IMPLEMENTATION OF LANDSCAPE ACTIVITIES. 11. THE CONTRACTOR WILL COORDINATE A FIELD REVIEW AND
- APPROVAL OF THE IRRIGATION SYSTEM INSTALLATION WITH THE ILLINOIS DEPARTMENT OF TRANSPORTATION. THE ILLINOIS DEPARTMENT OF TRANSPORTATION SHALL
- CONDUCT A FINAL INSPECTION OF THE IRRIGATION SYSTEM AND THE DECORATIVE LIGHTING UNITS PRIOR TO THE CITY OF ALTON APPROVING THESE ITEMS.
- ALL AREAS INDICATED AS LAWN TO BE SODDED BLEND OF BUFFALOGRASS (BUCHLOE DACTYLOIDES) ACCEPTABLE TO IDOT AS FOLLOWS: LEGACY, "CODY," 315' OR (80-10-10) BLEND OF ALL THREE IN ORDER LISTED.
- REFER TO LAYOUT PLANS FOR LOCATIONS OF PLANTING SED AREAS (SHRUBS AND PERENNIALS). REFER TO IRRIGATION PLANS FOR LAYOUT OF DRIP SYSTEM IN PLANTING BED AREAS.
- FIGUA DAJUST PLANTINGS AS NEEDED, AND AS APPROVED BY THE ENGINEER, FOLLOWING THE STAKING OF UNDERGROUND UTILITIES, REFER TO DEMOLITION SHEETS FOR UTILITY LOCATIONS.

\*INCLUDES ITEMS BOTH INSIDE AND OUTSIDE WORK LIMITS - EXISTING ITEMS TO REMAIN UNLESS NOTED OTHERWISE

EXISTING SIGN - USE IN PLACE, UNLESS OTHERWISE NOTED

EXISTING DRAIN INLET - USE IN PLACE

EXISTING TRAFFIC SIGNAL PULL BOX - USE IN PLACE

[] EXISTING UTILITY BOX - USE IN PLACE

EXISTING MANHOLE - USE IN PLACE

◆ EXISTING TRAFFIC SIGNAL (ON POST) - USE IN PLACE

EXISTING TRAFFIC SIGNAL (ON ARM) - USE IN PLACE ■ EXISTING STREET LIGHT - USE IN PLACE

. EXISTING POWER / UTILITY POLE - USE IN PLACE

EXISTING STEEL BEAM POST - REMOVE (FLOOD MEMORIAL)


EXISTING BENCH - REMOVE AND REINSTALL (FLOOD MEMORIAL)

X EXISTING STREET LIGHT - USE IN PLACE

→ EXISTING GUARDRAIL - USE IN PLACE

EXISTING TREE - USE IN PLACE

EXISTING RIGHT-OF-WAY (R.O.W. TO SERVE AS PROJECT / CONSTRUCTION LIMITS, EXCEPT WHERE NOTED OTHERWISE)

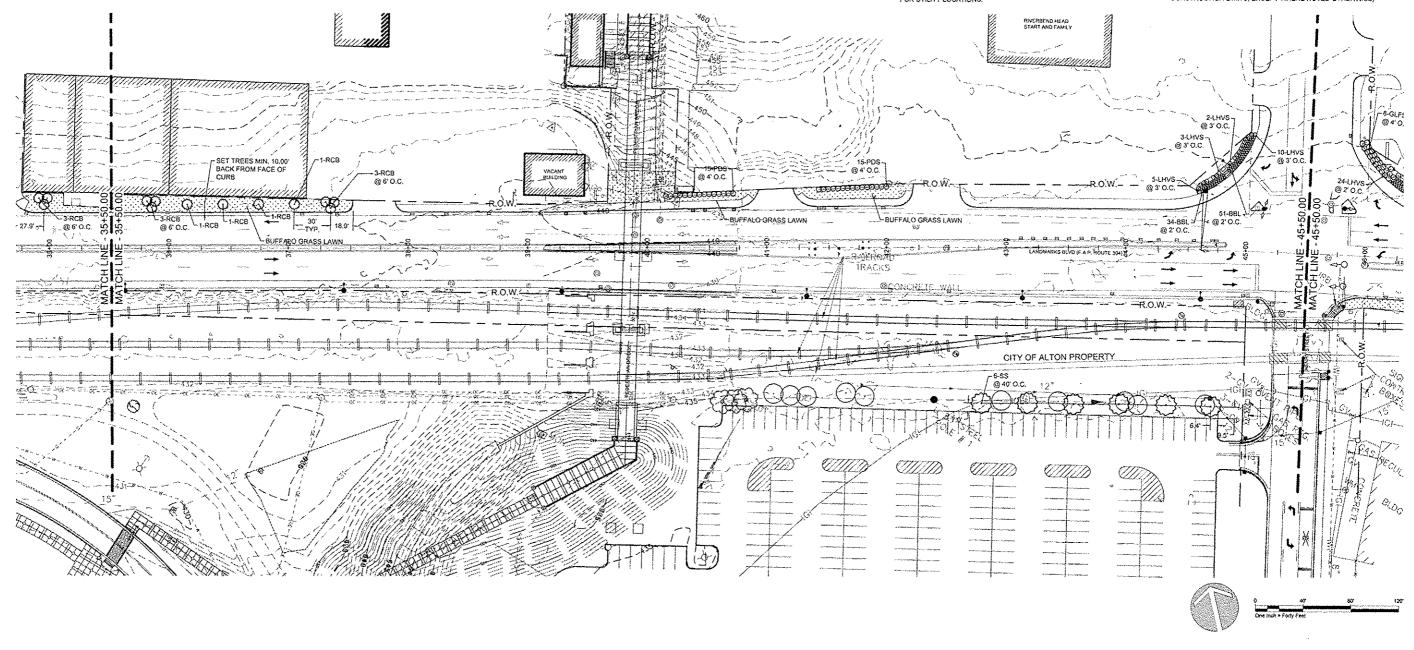

REVISION DATE DATE: 01/28/2015

GREAT RIVERS FLOOD MEMORIAL & BRIDGE WEST BEAUTIFICATION

CITY OF ALTON, ILLINOIS

LANDSCAPE PLAN -**BRIDGE WEST** 

TOTAL SHEE SHEETS NO. SECTION COUNTY ROUTE 84 60 10-00229-01-LS MADISON CONTRACT NO. 97539 PROJ. NO. SBIL-TE-00D8(15

	PLANT MATERIAL KEY							
KEY	BOTANICAL NAME	COMMON NAME	KEY	BOTANICAL NAME	COMMON NAME			
SHADE TRE	E		PERENNIAL	•	_1			
PSG	GINKGO BILOBA 'PRINCETON SENTRY'	PRINCETON SENTRY GINKGO	BES	RUDBECKIA HIRTA	BLACK-EYED SUSAN			
SWO	QUERCUS BICOLOR	SWAMP WHITE OAK	8MW	ASCLEPIAS TUBEROSA	BUTTERFLY MILKWEED			
SS₩	ACER RUBRUM 'SCARLET SENTINEL'	'SCARLET SENTINEL' MAPLE	CBC	COREOPSIS 'CREME BRULEE'	'CREME BRULEE' COREOPSIS			
INTERMEDIATE TREE				PANICUM VIRGATUM 'DALLAS BLUES'	'DALLAS BLUES' SWITCHGRASS			
ABS	AMELANCHIER X GRANDIFLORA ' AUTUMN BRILLANCE	'AUTUMN BRILLIANCE' SERVICEBERRY	PCF	ECHINACEA PURPUREA 'ELTON KNIGHT'	'ELTON KNIGHT' PURPLE CONEFLOWER			
ERB	CERCIS CANADENSIS	EASTERN RED BUD	PDS	SPOROBOLUS HETEROLEPIS	PRAIRIE DROPSEED			
MS	MALUS SPP. 'SENTINEL'	MALUS 'SENTINEL' (CLUMP FORM)	SSG	PANICUM VIRGATUM 'SHENANDOAH'	'SHENANDOAH' SWITCHGRASS			
SBM	MAGNOLIA VIRGINIANA	SWEET BAY MAGNOLIA	GROUNDCO	OVER				
TSC	MALUS SARGENTH 'TINA'	TINA' SARGENT CRABAPPLE	BBL	LIRIOPE X MUSCARI 'BIG BLUE'	'BIG BLUE' LIRIOPE			
EVERGREE	V TREE		ML	LIRIOPE X MUSCARI MAJESTIC	'MAJESTIC' LIRIOPE			
88	PICEA OMORIKA	SERBIAN SPRUCE						
DECIDUOUS	SHRUB							
BMAV	VIBURNUM DENTATUM BLUE MUFFIN	'BLUE MUFFIN' ARROWWOOD VIBURNUM						
GLFS	RHUS AROMATICA 'GROW-LO'	'GROW-LO' FRAGRANT SUMAC						
LHVS	ITEA VIRGINICA 'LITTLE HENRY'S'	'LITTLE HENRY'S' VIRGINIA SWEETSPIRE						
MAV	VIBURNUM DENTATUM 'MORTON'	'MORTON' ARROWMOOD VIBURNUM						
RCB	ARONIA ARBUTIFOLIA 'BRILLANTISSIMA'	RED CHOKEBERRY						

ALL EXISTING VEGETATION TO REMAIN AND BE PROTECTED UNLESS NOTES OTHERWISE. DAMAGE TO VEGETATION FROM CONSTRUCTION ACTIVITIES SHALL BE REPLACED TO SATISFACTION OF THE OWNER AT CONTRACTOR'S

LANDSCAPE NOTES

EXPENSE. CONTRACTOR SHALL BE RESPONSIBLE FOR COORDINATION WITH OTHER SITE RELATED CONSTRUCTION IN ORDER TO MEET SPECIFIED PLANTING SCHEDULES.

CONTRACTOR SHALL BE RESPONSIBLE FOR TOPSOIL PLACEMENT AND FINAL SHAPING REQUIREMENTS FOR SOD AND LANDSCAPE PLANTINGS.

ALL PLANTING BED AREAS TO BE STAKED BY THE CONTRACTOR FOR APPROVAL BY ENGINEER PRIOR TO LANDSCAPE OPERATIONS.

CITY STAFF TO SPACE INDIVIDUAL PLANTS WITHIN PLANTING BED AREAS AT ON-CENTER SPACING INDICATED AND MARK LOCATIONS WITH FLAGS FOR INSTALLATION BY THE CONTRACTOR

CONTRACTOR TO LOCATE TREES AS INDICATED BY CENTERLINE STATION AND OFFSETS, AND/OR DIMENSIONS SHOWN, MARK LOCATIONS WITH FLAGS FOR APPROVAL BY ENGINEER, MAINTAIN 10' MINIMUM SETBACK FROM EDGE OF DRIVING LANE TO FACE OF THE TREE TRUNK UNLESS OTHERWISE NOTED.

CONTRACTOR SHALL VERIFY QUANTITIES AND CONDITIONS PRIOR TO BIDDING AND IMPLEMENTATION. SUBSTITUTIONS WILL NOT BE ALLOWED FOR TYPES AND SIZES OR PLANTS WITHOUT PRIOR WRITTEN APPROVAL OF THE ENGINEER.

SIZES SHOWN IN PLANT SCHEDULE ARE MINIMUM ACCEPTABLE SIZES, COMPLY WITH ANSI Z60.1 (CURRENT EDITION). ENGINEER RESERVES THE RIGHT TO REQUEST PHOTOS OF TAGGED PLANTS AND/OR INSPECT PLANT MATERIAL AT THE NURSERY PRIOR TO DELIVERY TO THE PROJECT SITE

CONTRACTOR TO COMPLY WITH ALL SPECIFIED SUBMITTAL REQUIREMENTS AND OBTAIN APPROVED SUBMITTALS PRIOR TO STARTING SOD AND LANDSCAPE PLANTING

WORK.

10. THE ILLINOIS DEPARTMENT OF TRANSPORTATION SHALL REQUIRE 48 HOURS ADVANCE NOTICE FROM CONTRACTOR PRIOR TO IMPLEMENTATION OF LANDSCAPE ACTIVITIES.
THE CONTRACTOR WILL COORDINATE A FIELD REVIEW AND

APPROVAL OF THE IRRIGATION SYSTEM INSTALLATION WITH THE ILLINOIS DEPARTMENT OF TRANSPORTATION THE ILLINOIS DEPARTMENT OF TRANSPORTATION SHALL CONDUCT A FINAL INSPECTION OF THE IRRIGATION SYSTEM AND THE DECORATIVE LIGHTING UNITS PRIOR TO THE CITY

OF ALTON APPROVING THESE ITEMS.
ALL AREAS INDICATED AS LAWN TO BE SODDED BLEND OF BUFFALOGRASS (BUCHLOE DACTYLOIDES) ACCEPTABLE TO IDOT AS FOLLOWS: 'LEGACY, 'CODY, '315' OR (80-10-10)
BLEND OF ALL THREE IN ORDER LISTED.
REFER TO LAYOUT PLANS FOR LOCATIONS OF PLANTING

BED AREAS (SHRUBS AND PERENNIALS), REFER TO IRRIGATION PLANS FOR LAYOUT OF DRIP SYSTEM IN PLANTING BED AREAS.

15. FIELD ADJUST PLANTINGS AS NEEDED, AND AS APPROVED BY THE ENGINEER, FOLLOWING THE STAKING OF UNDERGROUND UTILITIES, REFER TO DEMOLITION SHEETS FOR UTILITY LOCATIONS.

\*INCLUDES ITEMS BOTH INSIDE AND OUTSIDE WORK LIMITS - EXISTING ITEMS TO REMAIN UNLESS NOTED OTHERWISE

EXISTING SIGN - USE IN PLACE, UNLESS OTHERWISE NOTED

E EXISTING DRAIN INLET - USE IN PLACE

[7] EXISTING TRAFFIC SIGNAL PULL BOX - USE IN PLACE

[1] EXISTING UTILITY BOX - USE IN PLACE

EXISTING MANHOLE - USE IN PLACE

→ EXISTING TRAFFIC SIGNAL (ON POST) - USE IN PLACE

EXISTING TRAFFIC SIGNAL (ON ARM) - USE IN PLACE EXISTING STREET LIGHT - USE IN PLACE

. EXISTING POWER / UTILITY POLE - USE IN PLACE


EXISTING STEEL BEAM POST - REMOVE (FLOOD MEMORIAL) EXISTING BENCH - REMOVE AND REINSTALL (FLOOD MEMORIAL)

TO EXISTING STREET LIGHT - USE IN PLACE

EXISTING GUARDRAIL - USE IN PLACE

EXISTING TREE - USE IN PLACE

EXISTING RIGHT-OF-WAY (R.O.W. TO SERVE AS PROJECT /

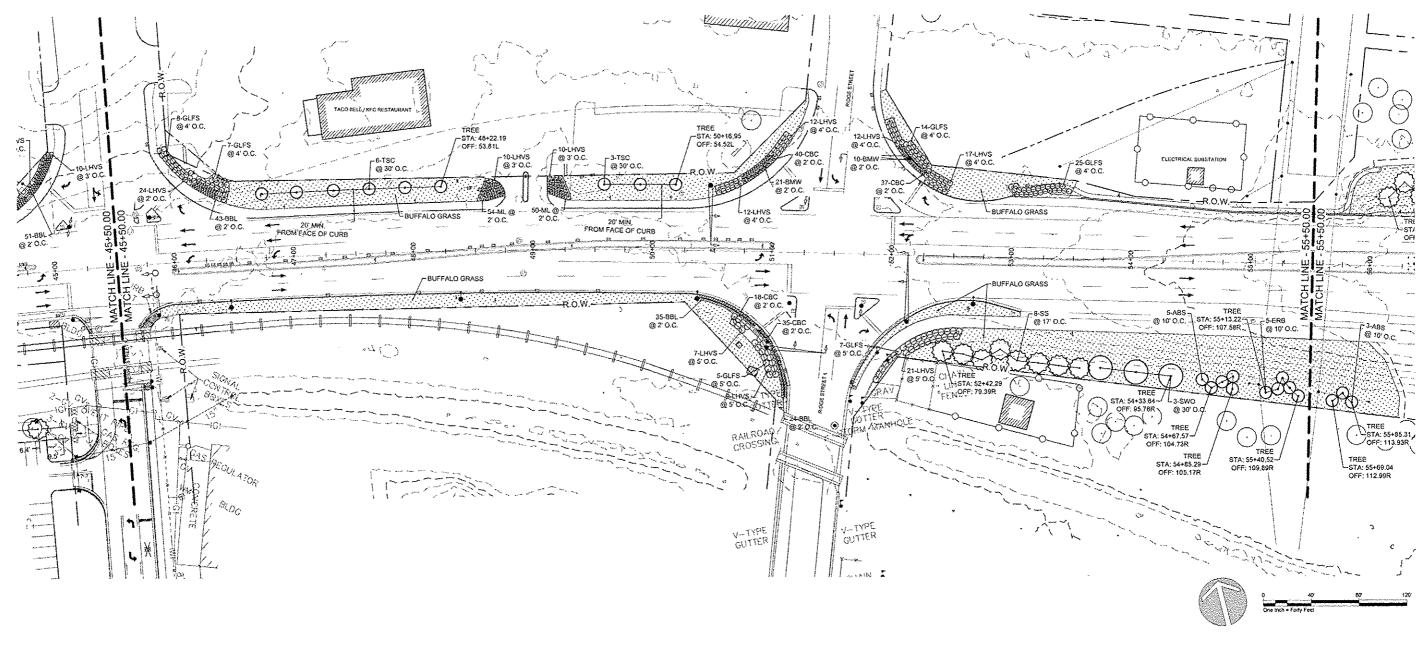

DATE DATE: DRAWN BY

GREAT RIVERS FLOOD MEMORIAL & BRIDGE WEST BEAUTIFICATION

CITY OF ALTON, ILLINOIS

101 EAST 3RD STREET ALTON, ILLINOIS 62002

LANDSCAPE PLAN -**BRIDGE WEST** 

COUNTY TOTAL SHEE SHEETS NO. SECTION 10-00229-01-LS MADISON 84 61 CONTRACT NO. 97539 PROJ. NO. SBIL-TE-00D8(15 FEDERAL AID PROJECT | ILLINOIS

	PLANT MATERIAL KEY									
KEY	BOTANICAL NAME	COMMON NAME	KEY	BOTANICAL NAME	COMMON NAME					
SHADE TREE										
PSG	GINKGO BILOBA 'PRINCETON SENTRY'	PRINCETON SENTRY GINKGO	8ES	RUDBECKIA HIRTA	BLACK-EYED SUSAN					
SWO	QUERCUS BICOLOR	SWAMP WHITE OAK	BMW	ASCLEPIAS TUBEROSA	BUTTERFLY MILKWEED					
SSM	ACER RUBRUM 'SCARLET SENTINEL'	'SCARLET SENTINEL' MAPLE	CBC	COREOPSIS 'CREME BRULEE'	'CREME BRULEE' COREOPSIS					
INTERMEDIATE TREE				PANICUM VIRGATUM 'DALLAS BLUES'	'DALLAS BLUES' SWITCHGRASS					
ABS	AMELANCHIER X GRANDIFLORA ' AUTUMN BRILLANCE	'AUTUMN BRILLIANCE' SERVICEBERRY	PCF	ECHINACEA PURPUREA 'ELTON KNIGHT'	'ELTON KNIGHT' PURPLE CONEFLOWER					
ERB	CERCIS CANADENSIS	EASTERN RED BUD	PDS	SPOROBOLUS HETEROLEPIS	PRAIRIE DROPSEED					
MS	MALUS SPP. 'SENTINEL'	MALUS 'SENTINEL' (CLUMP FORM)	SSG	PANICUM VIRGATUM 'SHENANDOAH'	'SHENANDOAH' SWITCHGRASS					
SBM	MAGNOLIA VIRGINIANA	SWEET BAY MAGNOLIA	GROUNDCO	VER						
TSC	MALUS SARGENTII 'TINA'	TINA' SARGENT CRABAPPLE	BBL	LIRIOPE X MUSCARI 'BIG BLUE'	'BIG BLUE' LIRIOPE					
EVERGREEN	TREE	-	ML	LIRIOPE X MUSCARI MAJESTIC	'MAJESTIC' LIRIOPE					
SS	PICEA OMORIKA	SERBIAN SPRUCE								
DECIDUOUS	SHRUB									
BMAV	VIBURNUM DENTATUM 'BLUE MUFFIN'	'BLUE MUFFIN' ARROWWOOD VIBURNUM								
GLFS	RHUS AROMATICA 'GROW-LO'	'GROW-LO' FRAGRANT SUMAC								
LHVS	ITEA VIRGINICA 'LITTLE HENRY'S'	'LITTLE HENRY'S' VIRGINIA SWEETSPIRE								
MAV	VIBURNUM DENTATUM 'MORTON'	'MORTON' ARROWWOOD VIBURNUM								
RCB	ARONIA ARBUTIFOLIA 'BRILLANTISSIMA'	RED CHOKE8ERRY								

- ALL EXISTING VEGETATION TO REMAIN AND BE PROTECTED UNLESS NOTES OTHERWISE. DAMAGE TO VEGETATION FROM CONSTRUCTION ACTIVITIES SHALL BE REPLACED TO SATISFACTION OF THE OWNER AT CONTRACTOR'S
- 2. CONTRACTOR SHALL BE RESPONSIBLE FOR COORDINATION WITH OTHER SITE RELATED CONSTRUCTION IN ORDER TO MEET SPECIFIED PLANTING SCHEDULES.
- 3. CONTRACTOR SHALL BE RESPONSIBLE FOR TOPSOIL PLACEMENT AND FINAL SHAPING REQUIREMENTS FOR SOD AND LANDSCAPE PLANTINGS.
  4. ALL PLANTING BED AREAS TO BE STAKED BY THE
- CONTRACTOR FOR APPROVAL BY ENGINEER PRIOR TO LANDSCAPE OPERATIONS.
- 5. CITY STAFF TO SPACE INDIVIDUAL PLANTS WITHIN PLANTING BED AREAS AT ON-CENTER SPACING INDICATED AND MARK LOCATIONS WITH FLAGS FOR INSTALLATION BY THE CONTRACTOR.
- CONTRACTOR TO LOCATE TREES AS INDICATED BY CENTERLINE STATION AND OFFSETS, AND/OR DIMENSIONS SHOWN, MARK LOCATIONS WITH FLAGS FOR APPROVAL BY ENGINEER, MAINTAIN 10' MINIMUM SETBACK FROM EDGE OF DRIVING LANE TO FACE OF THE TREE TRUNK UNLESS OTHERWISE NOTED.
- CONTRACTOR SHALL VERIFY QUANTITIES AND CONDITIONS PRIOR TO BIDDING AND IMPLEMENTATION. SUBSTITUTIONS WILL NOT BE ALLOWED FOR TYPES AND SIZES OR PLANTS WITHOUT PRIOR WRITTEN APPROVAL OF THE ENGINEER

- SIZES SHOWN IN PLANT SCHEDULE ARE MINIMUM ACCEPTABLE SIZES, COMPLY WITH ANSI Z60,1 (CURRENT EDITION), ENGINEER RESERVES THE RIGHT TO REQUEST PHOTOS OF TAGGED PLANTS AND/OR INSPECT PLANT MATERIAL AT THE NURSERY PRIOR TO DELIVERY TO THE
- CONTRACTOR TO COMPLY WITH ALL SPECIFIED SUBMITTAL REQUIREMENTS AND OBTAIN APPROVED SUBMITTALS PRIOR TO STARTING SOD AND LANDSCAPE PLANTING
- 10. THE ILLINOIS DEPARTMENT OF TRANSPORTATION SHALL REQUIRE 46 HOURS ADVANCE NOTICE FROM CONTRACTOR PRIOR TO IMPLEMENTATION OF LANDSCAPE ACTIVITIES.
  THE CONTRACTOR WILL COORDINATE A FIELD REVIEW AND
- APPROVAL OF THE IRRIGATION SYSTEM INSTALLATION WITH THE ILLINOIS DEPARTMENT OF TRANSPORTATION.
  THE ILLINOIS DEPARTMENT OF TRANSPORTATION SHALL
- CONDUCT A FINAL INSPECTION OF THE IRRIGATION SYSTEM AND THE DECORATIVE LIGHTING UNITS PRIOR TO THE CITY OF ALTON APPROVING THESE ITEMS. 13. ALL AREAS INDICATED AS LAWN TO BE SODDED BLEND OF
- BUFFALOGRASS (BUCHLOE DACTYLOIDES) ACCEPTABLE TO IDOT AS FOLLOWS: 'LEGACY', 'CODY', '315' OR (80-10-10) BLEND OF ALL THREE IN ORDER LISTED. REFER TO LAYOUT PLANS FOR LOCATIONS OF PLANTING BED AREAS (SHRUBS AND PERENNIALS), REFER TO IRRIGATION PLANS FOR LAYOUT OF DRIP SYSTEM IN
- PLANTING BED AREAS.
  FIELD ADJUST PLANTINGS AS NEEDED, AND AS APPROVED
  BY THE ENGINEER, FOLLOWING THE STAKING OF
- UNDERGROUND UTILITIES. REFER TO DEMOLITION SHEETS FOR UTILITY LOCATIONS.

INCLUDES ITEMS BOTH INSIDE AND OUTSIDE WORK LIMITS - EXISTING ITEMS TO REMAIN UNLESS NOTED OTHERWISE


- 🗻 EXISTING SIGN USE IN PLACE, UNLESS OTHERWISE NOTED
- 🗐 🖟 EXISTING DRAIN INLET USE IN PLACE

EXISTING TRAFFIC SIGNAL PULL BOX - USE IN PLACE

(1) EXISTING UTILITY BOX - USE IN PLACE

- (i) EXISTING MANHOLE USE IN PLACE
- EXISTING TRAFFIC SIGNAL (ON POST) USE IN PLACE
- EXISTING TRAFFIC SIGNAL (ON ARM) USE IN PLACE
- EXISTING STREET LIGHT USE IN PLACE
- . EXISTING POWER / UTILITY POLE USE IN PLACE
- EXISTING STEEL BEAM POST REMOVE (FLOOD MEMORIAL)
- EXISTING BENCH REMOVE AND REINSTALL (FLOOD MEMORIAL)
- M EXISTING STREET LIGHT USE IN PLACE
- EXISTING GUARDRAIL USE IN PLACE EXISTING TREE - USE IN PLACE
- EXISTING RIGHT-OF-WAY (R.O.W. TO SERVE AS PROJECT /

CONSTRUCTION LIMITS, EXCEPT WHERE NOTED OTHERWISE)

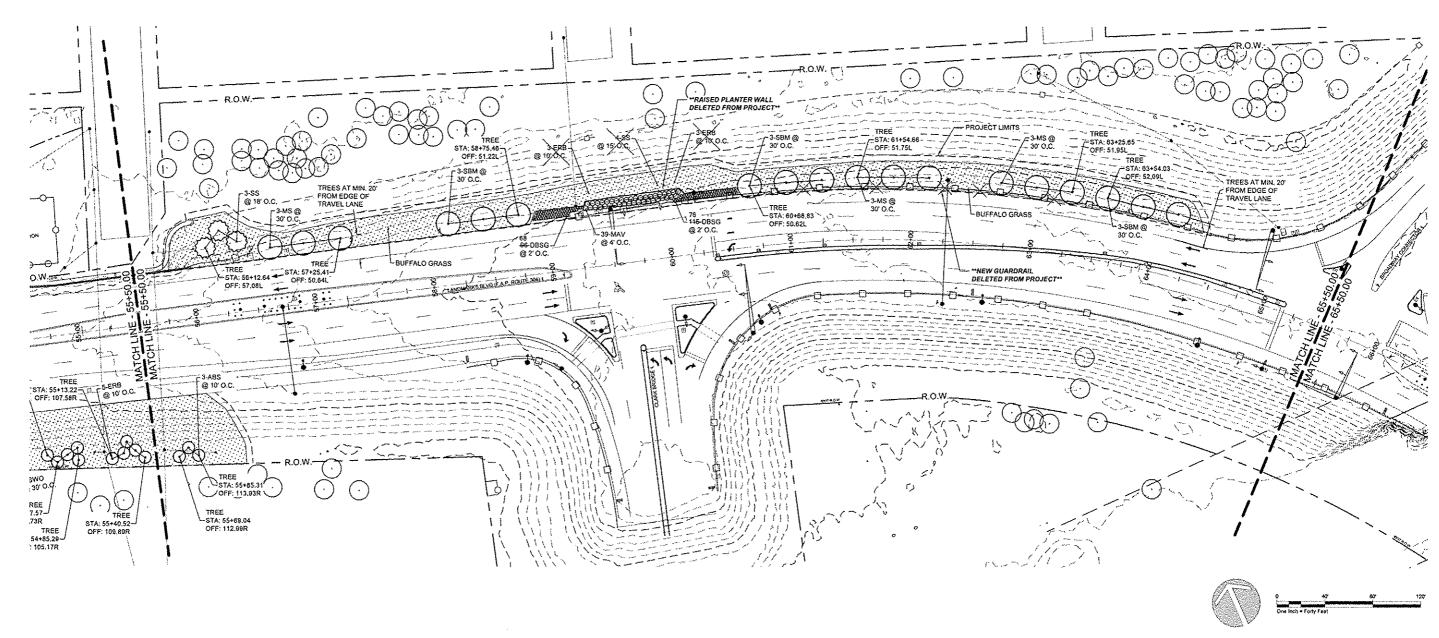

DATE DATE 01/28/2015

GREAT RIVERS FLOOD MEMORIAL & BRIDGE WEST BEAUTIFICATION

CITY OF ALTON, ILLINOIS

LANDSCAPE PLAN -**BRIDGE WEST** 

SECTION COUNTY MADISON 84 0-00228-01-LS CONTRACT NO. 97538 PROJ. NO. SBIL-TE-00D8(15

	PLANT MATERIAL KEY								
KEY	BOTANICAL NAME	COMMON NAME	KEY	BOTANICAL NAME	COMMON NAME				
SHADE TRE	<u>-</u>		PERENNIAL						
PSG	GINKGO BILOBA 'PRINCETON SENTRY'	'PRINCETON SENTRY' GINKGO	8ES	RUDBECKIA HIRTA	BLACK-EYED SUSAN				
SWO	QUERCUS BICOLOR	SWAMP WHITE OAK	BMW	ASCLEPIAS TUBEROSA	BUTTERFLY MILKWEED				
SSM	ACER RUBRUM 'SCARLET SENTINEL'	'SCARLET SENTINEL' MAPLE	CBC	COREOPSIS 'CREME BRULEE'	'CREME BRULEE' COREOPSIS				
INTERMEDIATE TREE				PANICUM VIRGATUM 'DALLAS BLUES'	'DALLAS BLUES' SWITCHGRASS				
ABS	AMELANCHIER X GRANDIFLORA ' AUTUMN BRILLANCE	'AUTUMN BRILLIANCE' SERVICEBERRY	PCF	ECHINACEA PURPUREA 'ELTON KNIGHT'	'ELTON KNIGHT' PURPLE CONEFLOWER				
ERB	CERCIS CANADENSIS	EASTERN RED BUD	PDS	SPOROBOLUS HÉTEROLEPIS	PRAIRIE DROPSEED				
MS	MALUS SPP. 'SENTINEL'	MALUS 'SENTINEL' (CLUMP FORM)	SSG	PANICUM VIRGATUM 'SHENANDOAH'	'SHENANDOAH' SWITCHGRASS				
SBM	MAGNOLIA VIRGINIANA	SWEET BAY MAGNOLIA	GROUNDCO	VER					
TSC	MALUS SARGENTII TINA'	'TINA' SARGENT CRABAPPLE	88L	LIRIOPE X MUSCARI 'BIG BLUE'	'BIG BLUE' LIRIOPE				
EVERGREE	TREE		ML	LIRIOPE X MUSCARI MAJESTIC	'MAJESTIC' LIRIOPE				
SS	PICEA OMORIKA	SERBIAN SPRUCE							
DECIDUOUS	SHRUB								
BMAV	VIBURNUM DENTATUM 'BLUE MUFFIN'	'BLUE MUFFIN' ARROWWOOD VIBURNUM							
GLFS	RHUS AROMATICA 'GROW-LO'	'GROW-LO' FRAGRANT SUMAC							
LHVS	ITEA VIRGINICA 'LITTLE HENRY'S'	'LITTLE HENRY'S' VIRGINIA SWEETSPIRE							
MAV	VIBURNUM DENTATUM 'MORTON'	'MORTON' ARROWWOOD VIBURNUM							
RCS	ARONIA ARBUTIFOLIA BRILLANTISSIMA	RED CHOKEBERRY	T						

- ALL EXISTING VEGETATION TO REMAIN AND BE PROTECTED UNLESS NOTES OTHERWISE. DAMAGE TO VEGETATION FROM CONSTRUCTION ACTIVITIES SHALL BE REPLACED TO SATISFACTION OF THE OWNER AT CONTRACTOR'S
- CONTRACTOR SHALL BE RESPONSIBLE FOR COORDINATION WITH OTHER SITE RELATED CONSTRUCTION IN ORDER TO MEET SPECIFIED PLANTING SCHEDULES.
- CONTRACTOR SHALL BE RESPONSIBLE FOR TOPSOIL PLACEMENT AND FINAL SHAPING REQUIREMENTS FOR SOD AND LANDSCAPE PLANTINGS.
- ALL PLANTING BED AREAS TO BE STAKED BY THE CONTRACTOR FOR APPROVAL BY ENGINEER PRIOR TO LANDSCAPE OPERATIONS.
- 5 CITY STAFF TO SPACE INDIVIDUAL PLANTS WITHIN PLANTING BED AREAS AT ON-CENTER SPACING INDICATED AND MARK LOCATIONS WITH FLAGS FOR INSTALLATION BY THE CONTRACTOR.
- CONTRACTOR TO LOCATE TREES AS INDICATED BY
   CENTERLINE STATION AND OFFSETS, AND/OR DIMENSIONS
   SHOWN, MARK LOCATIONS WITH FLAGS FOR APPROVAL BY ENGINEER, MAINTAIN 10' MINIMUM SETBACK FROM EDGE OF DRIVING LANE TO FACE OF THE TREE TRUNK UNLESS OTHERWISE NOTED.
- 7. CONTRACTOR SHALL VERIFY QUANTITIES AND CONDITIONS PRIOR TO BIDDING AND IMPLEMENTATION, SUBSTITUTIONS WILL NOT BE ALLOWED FOR TYPES AND SIZES OR PLANTS WITHOUT PRIOR WRITTEN APPROVAL OF THE ENGINEER
- SIZES SHOWN IN PLANT SCHEDULE ARE MINIMUM ACCEPTABLE SIZES. COMPLY WITH ANSI Z60.1 (CURRENT EDITION), ENGINEER RESERVES THE RIGHT TO REQUEST PHOTOS OF TAGGED PLANTS AND/OR INSPECT PLANT MATERIAL AT THE NURSERY PRIOR TO DELIVERY TO THE PROJECT SITE.

- CONTRACTOR TO COMPLY WITH ALL SPECIFIED SUBMITTAL REQUIREMENTS AND ORTAIN APPROVED SUBMITTALS PRIOR TO STARTING SOD AND LANDSCAPE PLANTING
- 10. THE ILLINOIS DEPARTMENT OF TRANSPORTATION SHALL REQUIRE 48 HOURS ADVANCE NOTICE FROM CONTRACTOR PRIOR TO IMPLEMENTATION OF LANDSCAPE ACTIVITIES. 11. THE CONTRACTOR WILL COORDINATE A FIELD REVIEW AND
- APPROVAL OF THE IRRIGATION SYSTEM INSTALLATION WITH THE ILLINOIS DEPARTMENT OF TRANSPORTATION 12. THE ILLINOIS DEPARTMENT OF TRANSPORTATION SHALL
- CONDUCT A FINAL INSPECTION OF THE IRRIGATION SYSTEM AND THE DECORATIVE LIGHTING UNITS PRIOR TO THE CITY OF ALTON APPROVING THESE ITEMS.
- 13. ALL AREAS INDICATED AS LAWN TO BE SODDED BLEND OF BUFFALOGRASS (BUCHLOE DACTYLOIDES) ACCEPTABLE TO IDOT AS FOLLOWS: LEGACY, 'CODY, '315' OR (80-10-10) BLEND OF ALL THREE IN ORDER LISTED.
- REFER TO LAYOUT PLANS FOR LOCATIONS OF PLANTING BED AREAS (SHRUBS AND PERENNIALS), REFER TO IRRIGATION PLANS FOR LAYOUT OF DRIP SYSTEM IN
- PLANTING BED AREAS,
  PERENNIAL MIX 'A' TO CONSIST OF EQUAL PORTIONS OF
  PLANTS @ 2' O.C. AS FOLLOWS
- - 20 BUTTERFLY MILKWEED
     20 CREME BRULEE COREOPSIS
     20 'ELTON KNIGHT' PURPLE CONEFLOWER
  - 20 BLACKEYED SUSAN
- FIELD ADJUST PLANTINGS AS NEEDED, AND AS APPROVED BY THE ENGINEER, FOLLOWING THE STAKING OF UNDERGROUND UTILITIES, REFER TO DEMOLITION SHEETS FOR UTILITY LOCATIONS.

"INCLUDES ITEMS BOTH INSIDE AND OUTSIDE WORK LIMITS - EXISTING ITEMS TO REMAIN UNLESS NOTED OTHERWISE

. EXISTING SIGN - USE IN PLACE, UNLESS OTHERWISE NOTED

E EXISTING DRAIN INLET - USE IN PLACE

EXISTING TRAFFIC SIGNAL PULL BOX - USE IN PLACE

(I) EXISTING UTILITY BOX - USE IN PLACE

(i) EXISTING MANHOLE - USE IN PLACE

◆● EXISTING TRAFFIC SIGNAL (ON POST) - USE IN PLACE EXISTING TRAFFIC SIGNAL (ON ARM) - USE IN PLACE

. EXISTING STREET LIGHT - USE IN PLACE

. EXISTING POWER / UTILITY POLE - USE IN PLACE

EXISTING STEEL BEAM POST - REMOVE (FLOOD MEMORIAL)


EXISTING BENCH - REMOVE AND REINSTALL (FLOOD MEMORIAL)

EXISTING STREET LIGHT - USE IN PLACE

→ EXISTING GUARDRAIL - USE IN PLACE

EXISTING TREE - USE IN PLACE

EXISTING RIGHT-OF-WAY (R.O.W, TO SERVE AS PROJECT / CONSTRUCTION LIMITS, EXCEPT WHERE NOTED OTHERWISE)

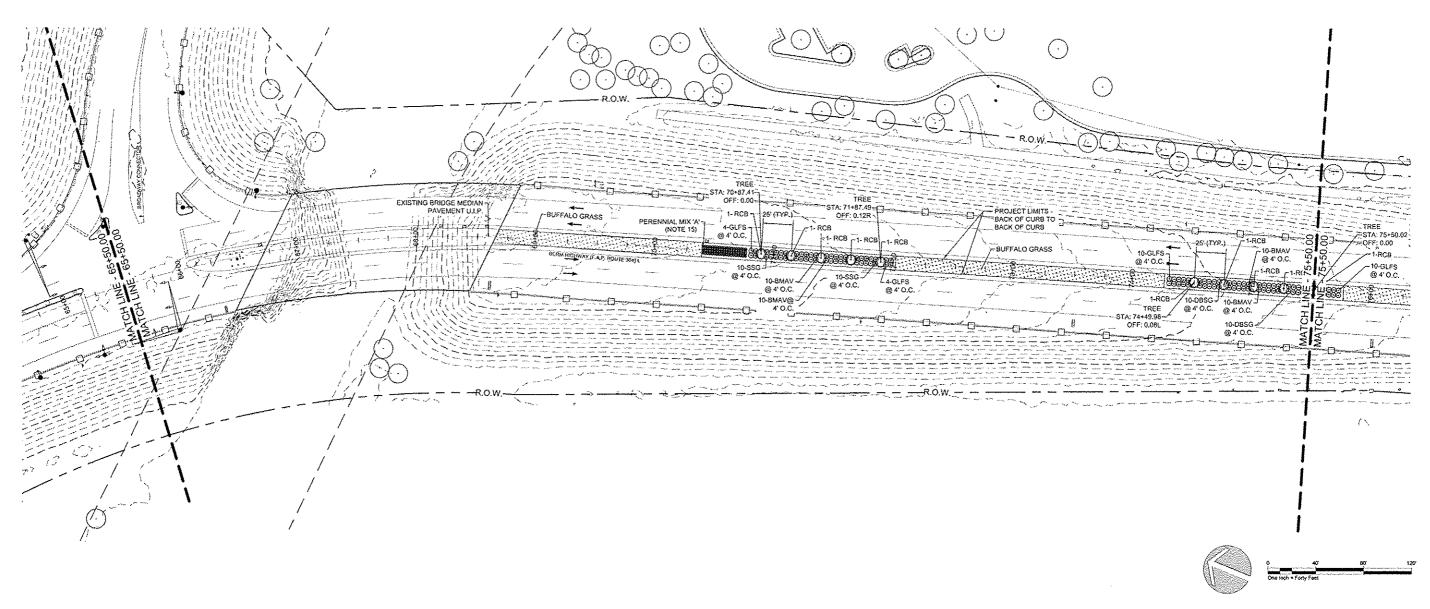

REVISION DATE DATE: 01/28/2015

GREAT RIVERS FLOOD MEMORIAL & BRIDGE WEST BEAUTIFICATION

CITY OF ALTON, ILLINOIS

LANDSCAPE PLAN -**BRIDGE WEST** 

TOTAL SHEET SHEETS NO. COUNTY MADISON 54 CONTRACT NO. 97539 PROJ. NO. SBIL-TE-0008(15

	PLANT MATERIAL KEY									
KEY BOTANICAL NAME		COMMON NAME	KEY	BOTANICAL NAME	COMMON NAME					
SHADE TRE	E		PERENNIAL							
PSG	GINKGO BILOBA 'PRINCETON SENTRY'	'PRINCETON SENTRY' GINKGO	BES	RUDBECKIA HIRTA	BLACK-EYED SUSAN					
SWO	QUERCUS BICOLOR	SWAMP WHITE OAK	BMW	ASCLEPIAS TUBEROSA	BUTTERFLY MILKWEED					
SSM	ACER RUBRUM 'SCARLET SENTINEL'	'SCARLET SENTINEL' MAPLE	CBC	COREOPSIS 'CREME BRULEE'	'CREME BRULEE' COREOPSIS					
INTERMEDIATE TREE				PANICUM VIRGATUM 'DALLAS BLUES'	'DALLAS BLUES' SWITCHGRASS					
A8S	AMELANCHIER X GRANDIFLORA : AUTUMN BRILLANCE	'AUTUMN BRILLIANCE' SERVICEBERRY	PCF	ECHINACEA PURPUREA 'ELTON KNIGHT'	'ELTON KNIGHT' PURPLE CONEFLOWER					
ERB	CERCIS CANADENSIS	EASTERN RED BUD	PDS	SPOROBOLUS HETEROLEPIS	PRAIRIE DROPSEED					
MS	MALUS SPP. 'SENTINEL'	MALUS 'SENTINEL' (CLUMP FORM)	SSG	PANICUM VIRGATUM 'SHENANDOAH'	'SHENANDOAH' SWITCHGRASS					
SBM	MAGNOLIA VIRGINIANA	SWEET BAY MAGNOLIA	GROUNDCO	VER						
TSC	MALUS SARGENTII 'TINA'	'TINA' SARGENT CRABAPPLE	BBL	LIRIOPE X MUSCARI 'BIG BLUE'	'BIG BLUE' LIRIOPE					
EVERGREEN	I TREE		ML	LIRIOPE X MUSCARI MAJESTIC	'MAJESTIC' LIRIOPE					
\$\$	PICEA OMORIKA	SERBIAN SPRUCE								
DECIDUOUS	SHRUB									
BMAV	VIBURNUM DENTATUM 'BLUE MUFFIN'	BLUE MUFFIN' ARROWMOOD VIBURNUM								
GLFS	RHUS AROMATICA 'GROW-LO'	'GROW-LO' FRAGRANT SUMAC			1					
LHVS	ITEA VIRGINICA 'LITTLE HENRY'S'	'LITTLE HENRY'S' VIRGINIA SWEETSPIRE			†					
MAY	VIBURNUM DENTATUM 'MORTON'	'MORTON' ARROWWOOD VIBURNUM								
RCB	ARONIA ARBUTIFOLIA 'BRILLANTISSIMA'	RED CHOKEBERRY	1							

- 1. ALL EXISTING VEGETATION TO REMAIN AND BE PROTECTED UNLESS NOTES OTHERWISE. DAMAGE TO VEGETATION FROM CONSTRUCTION ACTIVITIES SHALL BE REPLACED TO SATISFACTION OF THE OWNER AT CONTRACTOR'S
- CONTRACTOR SHALL BE RESPONSIBLE FOR COORDINATION WITH OTHER SITE RELATED CONSTRUCTION IN ORDER TO MEET SPECIFIED PLANTING SCHEDULES.
- CONTRACTOR SHALL BE RESPONSIBLE FOR TOPSCIL PLACEMENT AND FINAL SHAPING REQUIREMENTS FOR SOD AND LANDSCAPE PLANTINGS.
- ALL PLANTING BED AREAS TO BE STAKED BY THE CONTRACTOR FOR APPROVAL BY ENGINEER PRIOR TO LANDSCAPE OPERATIONS,
- CITY STAFF TO SPACE INDIVIDUAL PLANTS WITHIN PLANTING BED AREAS AT ON-CENTER SPACING INDICATED AND MARK LOCATIONS WITH FLAGS FOR INSTALLATION BY THE CONTRACTOR.
- CONTRACTOR TO LOCATE TREES AS INDICATED BY CENTERLINE STATION AND OFFSETS, AND/OR DIMENSIONS SHOWN, MARK LOCATIONS WITH FLAGS FOR APPROVAL BY ENGINEER, MAINTAIN 10' MINIMUM SETBACK FROM EDGE OF DRIVING LANE TO FACE OF THE TREE TRUNK UNLESS OTHERWISE NOTED.
- 7. CONTRACTOR SHALL VERIFY QUANTITIES AND CONDITIONS
  PRIOR TO BIDDING AND IMPLEMENTATION, SUBSTITUTIONS
  WILL NOT BE ALLOWED FOR TYPES AND SIZES OR PLANTS
- WITHOUT PRIOR WRITTEN APPROVAL OF THE ENGINEER.
  SIZES SHOWN IN PLANT SCHEDULE ARE MINIMUM
  ACCEPTABLE SIZES. COMPLY WITH ANSI ZBO.1 (CURRENT EDITION). ENGINEER RESERVES THE RIGHT TO REQUEST PHOTOS OF TAGGED PLANTS AND/OR INSPECT PLANT MATERIAL AT THE NURSERY PRIOR TO DELIVERY TO THE

- CONTRACTOR TO COMPLY WITH ALL SPECIFIED SUBMITTAL REQUIREMENTS AND OBTAIN APPROVED SUBMITTALS PRIOR TO STARTING SOD AND LANDSCAPE PLANTING
- WORK.

  THE ILLINOIS DEPARTMENT OF TRANSPORTATION SHALL
  REQUIRE 48 HOURS ADVANCE NOTICE FROM CONTRACTOR
  PRIOR TO IMPLEMENTATION OF LANDSCAPE ACTIVITIES.
  THE CONTRACTOR WILL COORDINATE A FIELD REVIEW AND
  APPROVAL OF THE IRRIGATION SYSTEM INSTALLATION
  WITH THE ILLINOIS DEPARTMENT OF TRANSPORTATION.
- THE ILLINOIS DEPARTMENT OF TRANSPORTATION SHALL CONDUCT A FINAL INSPECTION OF THE IRRIGATION SYSTEM
- AND THE DECORATIVE LIGHTING UNITS PRIOR TO THE CITY OF ALTON APPROVING THESE ITEMS
- ALL AREAS INDICATED AS LAWN TO BE SODDED BLEND OF BUFFALOGRASS (BUCHLOE DACTYLOIDES) ACCEPTABLE TO IDOT AS FOLLOWS: LEGACY, 'CODY, '315' OR (80-10-10)
  BLEND OF ALL THREE IN ORDER LISTED.
  REFER TO LAYOUT PLANS FOR LOCATIONS OF PLANTING
- BED AREAS (SHRUBS AND PERENNIALS), REFER TO IRRIGATION PLANS FOR LAYOUT OF DRIP SYSTEM IN PLANTING BED AREAS. PERENNIAL MIX 'A' TO CONSIST OF EQUAL PORTIONS OF
- 15. PERENNIAL MIX 'A' TO CONSIST OF EQUAL PORTIONS OF PLANTS @ 2' O.C. AS FOLLOWS

  +20 BUTTERFLY MILKWEED

  +20 CREME BRULEE COREOPSIS

  +20 'ELTON KNIGHT PURPLE CONEFLOWER


  +20 BLACKEYED SUSAN

  16. FIELD ADJUST PLANTINGS AS NEEDED, AND AS APPROVED

  BY THE BROWNER OF COLONIA TO TO THE TOTAL OF THE PROVINCE OF THE PROPERTY OF T
- BY THE ENGINEER, FOLLOWING THE STAKING OF UNDERGROUND UTILITIES, REFER TO DEMOLITION SHEETS FOR UTILITY LOCATIONS.

\*INCLUDES ITEMS BOTH INSIDE AND OUTSIDE WORK LIMITS - EXISTING ITEMS TO REMAIN UNLESS NOTED OTHERWISH

- \_C EXISTING SIGN USE IN PLACE, UNLESS OTHERWISE NOTED
- EXISTING DRAIN INLET USE IN PLACE
- EXISTING TRAFFIC SIGNAL PULL BOX USE IN PLACE
  - (1) EXISTING UTILITY BOX USE IN PLACE
  - EXISTING MANHOLE USE IN PLACE
- → EXISTING TRAFFIC SIGNAL (ON POST) USE IN PLACE
- EXISTING TRAFFIC SIGNAL (ON ARM) USE IN PLACE
  - ◆● EXISTING STREET LIGHT USE IN PLACE
  - EXISTING POWER / UTILITY POLE USE IN PLACE
- EXISTING STEEL BEAM POST REMOVE (FLOOD MEMORIAL)
- EXISTING BENCH REMOVE AND REINSTALL (FLOOD MEMORIAL)
- X EXISTING STREET LIGHT USE IN PLACE
- EXISTING GUARDRAIL USE IN PLACE
- EXISTING TREE USE IN PLACE
- EXISTING RIGHT-OF-WAY (R.O.W. TO SERVE AS PROJECT / CONSTRUCTION LIMITS, EXCEPT WHERE NOTED OTHERWISE)

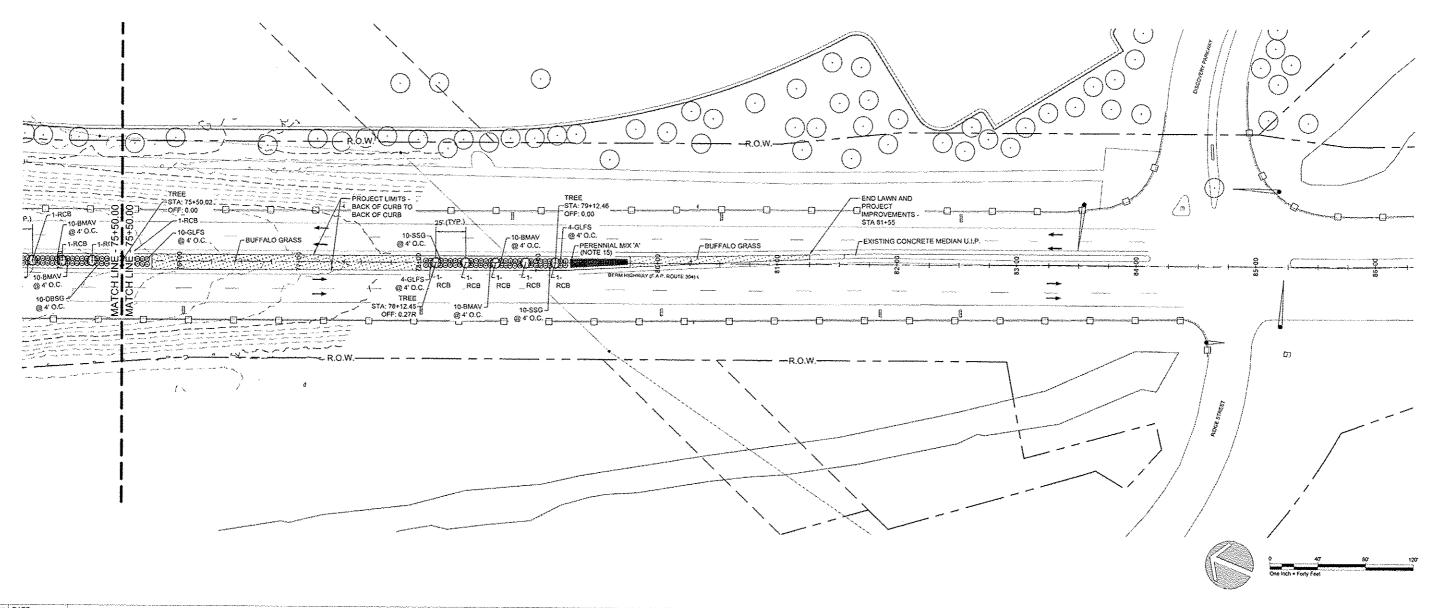

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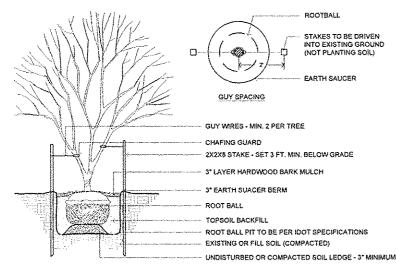
GREAT RIVERS FLOOD MEMORIAL & BRIDGE WEST BEAUTIFICATION

CITY OF ALTON, ILLINOIS


101 EAST 3RD STREET ALTON, ILLINOIS 62002

LANDSCAPE PLAN -**BRIDGE WEST** 

F.A.U. ROUTE COUNTY TOTAL SHEET NO. SECTION MADISON 84 64 CONTRACT NO. 97539 PROJ. NO. SBIL-TE-00D8(15 FEDERAL AID PROJECT



INTERMEDIATE TREE PLANTING

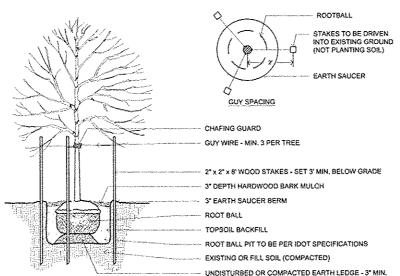

3" LAYER HARDWOOD BARK MULCH TOPSOIL BACKFILL

ROOT BALL PIT TO BE PER IDOT SPECIFICATIONS

EXISTING OR FILL SOIL (COMPACTED).

SHADE TREE PLANTING

PRUNE TIPS TO ACHIEVE ACCEPTABLE FORM (ONLY AS DIRECTED

CHAFING GUARD. GUY WIRE - MIN, 3 PER TREE. 3" LAYER HARDWOOD BARK MULCH. 3" EARTH SAUCER BERM ROOT BALL. ROOT BALL PIT TO BE PER IDOT SPECIFICATIONS UNDISTURBED OR COMPACTED SOIL LEDGE - 3" MIN.

**EVERGREEN TREE PLANTING** 

SEE PLAN AND PLANT SCHEDULE FOR SPACING GROUNDCOVER / PERENNIALS 3° DEPTH LAYER HARDWOOD BARK MULCH

NOTE: ENTIRE BED AREA SHALL BE PREPARED IN ACCORDANCE WITH SPECIFICATIONS,

**GROUNDCOVER AND PERENNIAL PLANTING** 

53 SECTION

UNDISTURBED OR COMPACTED SOIL LEDGE 3" MIN.

**DECIDUOUS SHRUB PLANTING** 

FINISHED GRADE

PLANT MATERIAL SCHEDULE

ROOT BALL

KEY	BOTANICAL NAME	COMMON NAME	MATURE HT,	MATURE SPREAD	SIZE & CONDITION	SHEET 58	SHEET 59	SHEET 60	SHEET 61	SHEET 62	SHEET 63	SHEET 64	TOTAL
SHADE TRE	HADE TREE												
PSG	GINKGO BILOBA 'PRINCETON SENTRY'	'PRINCETON SENTRY' GINKGO	40'	20'	2" CAL 888	7	•	-	-		-		7
SWO	QUERCUS BICOLOR	SWAMP WHITE OAK	50'	50"	2" CAL B&S	-	-	-	3	-	•	-	3
SSM	ACER RUBRUM'SCARLET SENTINEL'	'SCARLET SENTINEL' MAPLE	40'	30'	2" CAL B&B	2	-	-	•	•	-	-	2
INTERMEDIA	NTE TREE												
ABS	AMELANCHIER X GRANDIFLORA' AUTUMN BRILLANCE	'AUTUMN BRILLIANCE' SERVICEBERRY	15'	15'	2" CAL B&B		-	-	5	3	_	-	8
ERB	CERCIS CANADENSIS	EASTERN RED BUD	20'	25'	2" CAL B&B	3		-	5	- <del>0</del> - 0	-		44 8
MS	MALUS SPP, 'SENTINEL'	MALUS 'SENTINEL' (CLUMP FORM)	20'	10'	7' HT. B&B		-	-	-	Ð			9
SBM	MAGNOLIA VIRGINIANA	SWEET BAY MAGNOLIA	20'	15'	2" CAL B&B	-	-	-		Ð		-	9
TSC	MALUS SARGENTII 'TINA'	TINA' SARGENT CRABAPPLE	8'	5'	2" CAL B&B	-	•	-	9	-	-	Ī	9
EVERGREE	VERGREEN TREE												
SS	PICEA OMORIKA	SERBIAN SPRUCE	401	15'	8' HT, B&B	3		8	В	-7-3		Γ.	-24-2

٩L	KEY	BOTANICAL NAME	COMMON NAME	MATURE HT.	MATURE SPREAD	SIZE & CONDITION	SHEET 58	SHEET S9	SHEET 60	SHEET 61	SHEET 62	SHEET 63	SHEET 64	TOTAL
٦	DECIDUOUS SHRUB													
	BMAV	VIBURNUM DENTATUM 'BLUE MUFFIN'	'BLUE MUFFIN' ARROWMOOD VIBURNUM	5'	4'	2" HT. CONT.	-	-	-	-	-	40	20	60
	GLFS	RHUS AROMATICA 'GROVI-LO'	'GROW-LO' FRAGRANT SUMAC	2'	8'	2-GAL POT	19	-		66	-	18	18	121
٦	LHVS	ITEA VIRGINICA 'LITTLE HENRY'S'	'LITTLE HENRY'S' VIRGINIA SWEETSPIRE	2,	2.5'	5-GAL POT		-	20	134	•	-	-	154
٦	MAV	VIBURNUM DENTATUM 'MORTON'	'MORTON' ARROWWOOD VIBURNUM	10'	10'	3' HT, BAB	-	-		•	39	-	-	39
	RCB	ARONIA ARBUTIFOLIA 'BRILLANTISSIMA'	RED CHOKEBERRY	7'	4'	3' HT, 848	5	3	10			10	5	33
8	PERENNIAL													
٦	BES RUDBECKIA HIRTA BLACK-EYED SUS		BLACK-EYED SUSAN	2'	1"	QT. POT	-	<u> </u>		-	-	20	20	40
	BMW	ASCLEPIAS TUBEROSA	BUTTERFLY MILKWEED	2,5'	1.5'	QT, POT			-	31	-	20	20	71
	CBC	COREOPSIS 'CREME BRULEE'	'CREME BRULEE' COREOPSIS	1.5'	31	QT, POT	-	-	-	130	-	20	20	170
7	DBSG	PANICUM VIRGATUM 'DALLAS BLUES'	'DALLAS BLUES' SWITCHGRASS	6'	3,	1-GAL POT	-	-	-		144 -211	20	٠	184 -234
20	PCF	ECHINACEA PURPUREA 'ELTON KNIGHT'	'ELTON KNIGHT' PURPLE CONEFLOWER	2	1.5'	QT. POT	-	-	T		<del>.</del>	20	20	40
	PDS	SPOROBOLUS HETEROLEPIS	PRAIRIE DROPSEED	3'	3,	1-GAL POT	-	-	30	Ī		-	<u> </u>	30
	SSG	PANICUM VIRGATUM 'SHENANDOAH'	'SHENANDOAH' SWITCHGRASS	4'	4'	1-GAL POT		-			l -	20	20	40
	GROUNDCO	VER												
	88L	LIRIOPE X MUSCARI 'BIG BLUE'	'BIG BLUE' LIRIOPE	2'	2'	1-GAL POT	80	-	85	102	. <b>-</b> .		<u> </u>	277
	ML	LIRIOPE X MUSCARI MAJESTIC	'MAJESTIC' LIRIOPE	1.5'	1.5'	1-GAL POT	-	-	-	104		-	-	104
	SEED - BUFFALOGRASS													
		REFER TO SPECIFICATIONS			T		-	-	-	•	-	-	-	8,441 SY
												861	20 SY	

DATE DATE: 01/28/2015 REVISION

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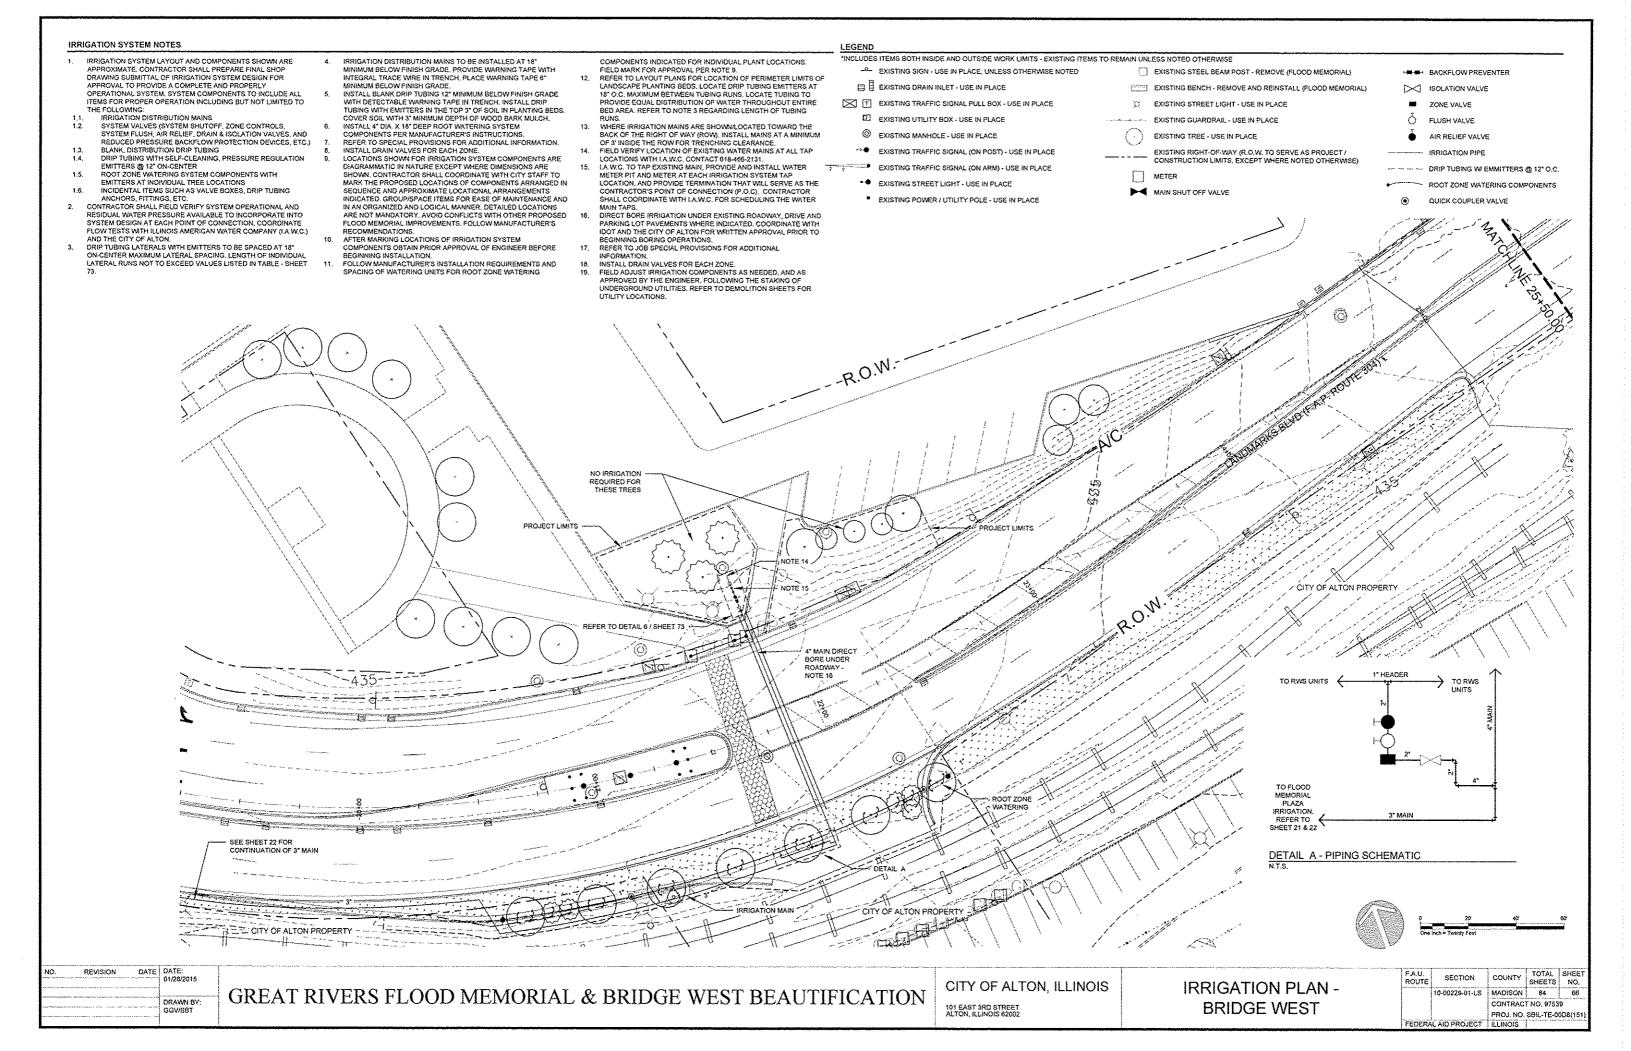
GREAT RIVERS FLOOD MEMORIAL & BRIDGE WEST BEAUTIFICATION

CITY OF ALTON, ILLINOIS

101 EAST 3RD STREET ALTON, ILLINOIS 62002

LANDSCAPE DETAILS

COUNTY TOTAL SHEET NO. SECTION CONTRACT NO. 97539 PROJ. NO. SBIL-TE-00D8(15



### **IRRIGATION SYSTEM NOTES** INCLUDES ITEMS BOTH INSIDE AND OUTSIDE WORK LIMITS - EXISTING ITEMS TO REMAIN UNLESS NOTED OTHERWISE IRRIGATION SYSTEM LAYOUT AND COMPONENTS SHOWN ARE APPROXIMATE, CONTRACTOR SHALL PREPARE FINAL SHOP DRAWING SUBMITTAL OF IRRIGATION SYSTEM DESIGN FOR COMPONENTS INDICATED FOR INDIVIDUAL PLANT LOCATIONS FIELD MARK FOR APPROVAL PER NOTE 9. IRRIGATION DISTRIBUTION MAINS TO BE INSTALLED AT 18 $\stackrel{\mathsf{D}}{\longrightarrow}$ EXISTING SIGN - USE IN PLACE, UNLESS OTHERWISE NOTED EXISTING STEEL BEAM POST - REMOVE (PLOOD MEMORIAL) +₩ ಈ BACKFLOW PREVENTER REFER TO LAYOUT PLANS FOR LOCATION OF PERIMETER LIMITS OF INTEGRAL TRACE WIRE IN TRENCH, PLACE WARNING TAPE 6" LANDSCAPE PLANTING BEDS, LOCATE DRIP TUBING EMITTERS AT 18" O.C. MAXIMUM BETWEEN TUBING RUNS, LOCATE TUBING TO APPROVAL TO PROVIDE A COMPLETE AND PROPERLY MINIMUM BELOW FINISH GRADE. B EXISTING DRAIN INLET - USE IN PLACE EXISTING BENCH - REMOVE AND REINSTALL (FLOOD MEMORIAL) ISOLATION VALVE ITEMS FOR PROPER OPERATION INCLUDING BUT NOT LIMITED TO WITH DETECTABLE WARNING TAPE IN TRENCH, INSTALL DRIP PROVIDE EQUAL DISTRIBUTION OF WATER THROUGHOUT ENTIRE EXISTING TRAFFIC SIGNAL PULL BOX - USE IN PLACE EXISTING STREET LIGHT - USE IN PLACE ZONE VALVE THE FOLLOWING: TUBING WITH EMITTERS IN THE TOP 3" OF SOIL IN PLANTING BEDS. BED AREA. REFER TO NOTE 3 REGARDING LENGTH OF TUBING POLLOWING: RRIGATION DISTRIBUTION MAINS SYSTEM VALVES (SYSTEM CHUTOFF, ZONE CONTROLS, SYSTEM FLUSH, AIR RELIEF, DRAIN & ISOLATION VALVES, AND COVER SOIL WITH 3" MINIMUM DEPTH OF WOOD BARK MULCH, INSTALL 4" DIA. X 18" DEEP ROOT WATERING SYSTEM EXISTING UTILITY BOX - USE IN PLACE EXISTING GUARDRAIL - USE IN PLACE FLUSH VALVE WHERE IRRIGATION MAINS ARE SHOWNLOCATED TOWARD THE BACK OF THE RIGHT OF WAY (ROW), INSTALL MAINS AT A MINIMUM OF 3' INSIDE THE ROW FOR TRENCHING CLEARANCE. FIELD VERIFY LOCATION OF EXISTING WATER MAINS AT ALL TAP COMPONENTS PER MANUFACTURER'S INSTRUCTIONS EXISTING MANHOLE - USE IN PLACE AIR RELIEF VALVE **EXISTING TREE - USE IN PLACE** REDUCED PRESSURE BACKFLOW PROTECTION DEVICES, ETC.) BLANK, DISTRIBUTION DRIP TUBING REFER TO SPECIAL PROVISIONS FOR ADDITIONAL INFORMATION INSTALL DRAIN VALVES FOR EACH ZONE. EXISTING TRAFFIC SIGNAL (ON POST) - USE IN PLACE EXISTING RIGHT-OF-WAY (R.O.W. TO SERVE AS PROJECT / IRRIGATION PIPE DRIP TUBING WITH SELF-CLEANING, PRESSURE REGULATION LOCATIONS SHOWN FOR IRRIGATION SYSTEM COMPONENTS ARE LOCATIONS WITH LA.W.C. CONTACT 618-468-2131. CONSTRUCTION LIMITS, EXCEPT WHERE NOTED OTHERWISE) EMITTERS © 12" ON-CENTER ROOT ZONE WATERING SYSTEM COMPONENTS WITH EMITTERS AT INDIVIDUAL TREE LOCATIONS DIAGRAMMATIC IN NATURE EXCEPT WHERE DIMENSIONS ARE SHOWN, CONTRACTOR SHALL COORDINATE WITH CITY STAFF TO I.A.W.C. TO TAP EXISTING MAIN, PROVIDE AND INSTALL WATER METER PIT AND METER AT EACH IRRIGATION SYSTEM TAP EXISTING TRAFFIC SIGNAL (ON ARM) - USE IN PLACE -- DRIP TUBING W/ EMMITTERS @ 12" O.C. MARK THE PROPOSED LOCATIONS OF COMPONENTS ARRANGED IN LOCATION, AND PROVIDE TERMINATION THAT WILL SERVE AS THE EXISTING STREET LIGHT - USE IN PLACE ROOT ZONE WATERING COMPONENTS INCIDENTAL ITEMS SUCH AS VALVE BOXES, DRIP TUBING ANCHORS, FITTINGS, ETC. SEQUENCE AND APPROXIMATE LOCATIONAL ARRANGEMENTS INDICATED, GROUP/SPACE ITEMS FOR EASE OF MAINTENANCE AND CONTRACTOR'S POINT OF CONNECTION (P.O.C). CONTRACTOR MAIN SHUT OFF VALVE \* EXISTING POWER / UTILITY POLE - USE IN PLACE QUICK COUPLER VALVE CONTRACTOR SHALL FIELD VERIFY SYSTEM OPERATIONAL AND IN AN ORGANIZED AND LOGICAL MANNER. DETAILED LOCATIONS RESIDUAL WATER PRESSURE AVAILABLE TO INCORPORATE INTO SYSTEM DESIGN AT EACH POINT OF CONNECTION, COORDINATE FLOW TESTS WITH ILLINOIS AMERICAN WATER COMPANY (I.A.W.C.) ARE NOT MANDATORY, AVOID CONFLICTS WITH OTHER PROPOSED DIRECT BORE IRRIGATION LINDER EXISTING ROADWAY, DRIVE AND FLOOD MEMORIAL IMPROVEMENTS, FOLLOW MANUFACTURER'S PARKING LOT PAVEMENTS WHERE INDICATED, COORDINATE WITH IDOT AND THE CITY OF ALTON FOR WRITTEN APPROVAL PRIOR TO RECOMMENDATIONS. AFTER MARKING LOCATIONS OF IRRIGATION SYSTEM AND THE CITY OF ALTON BEGINNING BORING OPERATIONS DRIP TUBING LATERALS WITH EMITTERS TO BE SPACED AT 18" ON-CENTER MAXIMUM LATERAL SPACING, LENGTH OF INDIVIDUAL COMPONENTS OBTAIN PRIOR APPROVAL OF ENGINEER BEFORE REFER TO JOB SPECIAL PROVISIONS FOR ADDITIONAL BEGINNING INSTALLATION. INSTALL DRAIN VALVES FOR EACH ZONE. FIELD ADJUST IRRIGATION COMPONENTS AS NEEDED, AND AS APPROVED BY THE ENGINEER, FOLLOWING THE STAKING OF UNDERGROUND UTILITIES, REFER TO DEMOLITION SHEETS FOR FOLLOW MANUFACTURER'S INSTALLATION REQUIREMENTS AND LATERAL RUNS NOT TO EXCEED VALUES LISTED IN TABLE - SHEET SPACING OF WATERING UNITS FOR ROOT ZONE WATERING UTILITY LOCATIONS. CITY OF ALTON ROW. ROOT ZONE WATERING 3 DATE DATE: 01/28/2015 TOTAL SHEETS NO. COUNTY CITY OF ALTON, ILLINOIS **IRRIGATION PLAN -**GREAT RIVERS FLOOD MEMORIAL & BRIDGE WEST BEAUTIFICATION 10-00229-01-LS MADISON 84 67 DRAWN BY CONTRACT NO. 97539 **BRIDGE WEST** 101 EAST 3RD STREET ALTON, ILLINOIS 62002

PROJ. NO. SBIL-TE-0008(15

#### IRRIGATION SYSTEM NOTES LEGEND INCLUDES ITEMS BOTH INSIDE AND OUTSIDE WORK LIMITS - EXISTING ITEMS TO REMAIN UNLESS NOTED OTHERWISE IRRIGATION SYSTEM LAYOUT AND COMPONENTS SHOWN ARE APPROXIMATE. CONTRACTOR SHALL PREPARE FINAL SHOP DRAWING SUBMITTAL OF IRRIGATION SYSTEM DESIGN FOR COMPONENTS INDICATED FOR INDIVIDUAL PLANT LOCATIONS FIELD MARK FOR APPROVAL PER NOTE 9. IRRIGATION DISTRIBUTION MAINS TO BE INSTALLED AT 18" -0- EXISTING SIGN - USE IN PLACE, UNLESS OTHERWISE NOTED EXISTING STEEL BEAM POST - REMOVE (FLOOD MEMORIAL) ·■■ BACKFLOW PREVENTER INTEGRAL TRACE WIRE IN TRENCH, PLACE WARNING TAPE 6" REFER TO LAYOUT PLANS FOR LOCATION OF PERIMETER LIMITS OF APPROVAL TO PROVIDE A COMPLETE AND PROPERLY OPERATIONAL SYSTEM, SYSTEM COMPONENTS TO INCLUDE ALL ITEMS FOR PROPER OPERATION INCLUDING BUT NOT LIMITED TO MINIMUM BELOW FINISH GRADE LANDSCAPE PLANTING BEDS, LOCATE DRIP TUBING EMITTERS AT E EXISTING DRAIN INLET - USE IN PLACE EXISTING BENCH - REMOVE AND REINSTALL (FLOOD MEMORIAL) ISOLATION VALVE INSTALL BLANK DRIP TUBING 12" MINIMUM BELOW FINISH GRADE WITH DETECTABLE WARNING TAPE IN TRENCH, INSTALL DRIP 18" O.C. MAXIMUM BETWEEN TUBING RUNS, LOCATE TUBING TO PROVIDE EQUAL DISTRIBUTION OF WATER THROUGHOUT ENTIRE EXISTING TRAFFIC SIGNAL PULL BOX - USE IN PLACE EXISTING STREET LIGHT - USE IN PLACE ZONE VALVE THE FOLLOWING: TUBING WITH EMITTERS IN THE TOP 3" OF SOIL IN PLANTING BEDS BED AREA. REFER TO NOTE 3 REGARDING LENGTH OF TUBING IRRIGATION DISTRIBUTION MAINS SYSTEM VALVES (SYSTEM SHUTOFF, ZONE CONTROLS, SYSTEM FLUSH, AIR RELIEF, DRAIN & ISOLATION VALVES, AND COVER SOIL WITH 3" MINIMUM DEPTH OF WOOD BARK MULCH. INSTALL 4" DIA. X 18" DEEP ROOT WATERING SYSTEM EXISTING UTILITY BOX - USE IN PLACE EXISTING GUARDRAIL - USE IN PLACE FLUSH VALVE 13. WHERE IRRIGATION MAINS ARE SHOWN/LOCATED TOWARD THE BACK OF THE RIGHT OF WAY (ROW), INSTALL MAINS AT A MINIMUM OF 3' INSIDE THE ROW FOR TRENCHING CLEARANCE. 14. FIELD VERIFY LOCATION OF EXISTING WATER MAINS AT ALL TAP EXISTING MANHOLE - USE IN PLACE COMPONENTS PER MANUFACTURER'S INSTRUCTIONS EXISTING TREE - USE IN PLACE AIR RELIEF VALVE REDUCED PRESSURE BACKFLOW PROTECTION DEVICES, ETC.) BLANK, DISTRIBUTION DRIP TUBING DRIP TUBING WITH SELF-CLEANING, PRESSURE REGULATION REFER TO SPECIAL PROVISIONS FOR ADDITIONAL INFORMATION. INSTALL DRAIN VALVES FOR EACH ZONE. EXISTING TRAFFIC SIGNAL (ON POST) - USE IN PLACE EXISTING RIGHT-OF-WAY (R.O.W. TO SERVE AS PROJECT / IRRIGATION PIPE LOCATIONS SHOWN FOR IRRIGATION SYSTEM COMPONENTS ARE LOCATIONS WITH LA.W.C. CONTACT 618-468-2131. CONSTRUCTION LIMITS, EXCEPT WHERE NOTED OTHERWISE EMITTERS @ 12' ON-CENTER ROOT ZONE WATERING SYSTEM COMPONENTS WITH EMITTERS AT INDIVIDUAL TREE LOCATIONS DIAGRAMMATIC IN NATURE EXCEPT WHERE DIMENSIONS ARE SHOWN, CONTRACTOR SHALL COORDINATE WITH CITY STAFF TO MARK THE PROPOSED LOCATIONS OF COMPONENTS ARRANGED IN I.A.W.C. TO TAP EXISTING MAIN, PROVIDE AND INSTALL WATER METER PIT AND METER AT EACH IRRIGATION SYSTEM TAP LOCATION, AND PROVIDE TERMINATION THAT WILL SERVE AS THE EXISTING TRAFFIC SIGNAL (ON ARM) - USE IN PLACE -- DRIP TUBING WI EMMITTERS @ 12" O.C. EXISTING STREET LIGHT - USE IN PLACE ROOT ZONE WATERING COMPONENTS INCIDENTAL ITEMS SUCH AS VALVE BOXES, DRIP TUBING SECUENCE AND APPROXIMATE LOCATIONAL ARRANGEMENTS. CONTRACTOR'S POINT OF CONNECTION (P.O.C). CONTRACTOR MAIN SHUT OFF VALVE ANCHORS, FITTINGS, ETC. CONTRACTOR SHALL FIELD VERIFY SYSTEM OPERATIONAL AND INDICATED. GROUP/SPACE ITEMS FOR EASE OF MAINTENANCE AND IN AN ORGANIZED AND LOGICAL MANNER, DETAILED LOCATIONS EXISTING POWER / UTILITY POLE - USE IN PLACE QUICK COUPLER VALVE MAIN TAPS, RESIDUAL WATER PRESSURE AVAILABLE TO INCORPORATE INTO SYSTEM DESIGN AT EACH POINT OF CONNECTION. COORDINATE FLOW TESTS WITH ILLINOIS AMERICAN WATER COMPANY (I.A.W.C.) DIRECT BORE IRRIGATION UNDER EXISTING ROADWAY, DRIVE AND ARE NOT MANDATORY, AVOID CONFLICTS WITH OTHER PROPOSED FLOOD MEMORIAL IMPROVEMENTS, FOLLOW MANUFACTURER'S RECOMMENDATIONS. PARKING LOT PAVEMENTS WHERE INDICATED, COORDINATE WITH IDOT AND THE CITY OF ALTON FOR WRITTEN APPROVAL PRIOR TO AND THE CITY OF ALTON. AFTER MARKING LOCATIONS OF IRRIGATION SYSTEM REGINNING BORING OPERATIONS DRIP TUBING LATERALS WITH EMITTERS TO BE SPACED AT 18" ON-CENTER MAXIMUM LATERAL SPACING, LENGTH OF INDIVIDUAL COMPONENTS OBTAIN PRIOR APPROVAL OF ENGINEER BEFORE BEGINNING INSTALLATION. REFER TO JOB SPECIAL PROVISIONS FOR ADDITIONAL INFORMATION. INSTALL DRAIN VALVES FOR EACH ZONE. FIELD ADJUST IRRIGATION COMPONENTS AS NEEDED, AND AS APPROVED BY THE ENGINEER, FOLLOWING THE STAKING OF UNDERGROUND UTILITIES. REFER TO DEMOLITION SHEETS FOR FOLLOW MANUFACTURER'S INSTALLATION REQUIREMENTS AND LATERAL RUNS NOT TO EXCEED VALUES LISTED IN TABLE - SHEET SPACING OF WATERING UNITS FOR ROOT ZONE WATERING UTILITY LOCATIONS. DETAIL C' - DETAIL D ROOT ZONE RRIGATION - DRIP IRRIGATION TUBING amarana. +1.8.89 +1-6.68 IRRIGATION MAIN NOTE 15 CITY OF ALTON PROPERTY NO IRRIGATION FOR THESE 6 TREES $\Theta$ TO DRIP ZONES TO DRIP ZONES 1" HEADER 2" MAIN 2\* HEADER TO DRIP TUBING DETAIL C - PIPING SCHEMATIC N.T.S. DETAIL B - PIPING SCHEMATIC **DETAIL D-PIPING SCHEMATIC**

REVISION DATE DATE 01/28/2015


GREAT RIVERS FLOOD MEMORIAL & BRIDGE WEST BEAUTIFICATION

CITY OF ALTON, ILLINOIS

**IRRIGATION PLAN -BRIDGE WEST** 

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	F.A.U. ROUTE	SECTION	COUNTY	TOTAL SHEETS	SHEET NO.
		10-00229-01-LS	MADISON	84	68
			CONTRAC	T NO. 9753	8
			PROJ. NO.	SBIL TE 0	0D8(151)
	FEDERA	L AID PROJECT	ILLINOIS	[	.,,

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### **IRRIGATION SYSTEM NOTES** INCLUDES ITEMS BOTH INSIDE AND OUTSIDE WORK LIMITS - EXISTING ITEMS TO REMAIN UNLESS NOTED OTHERWISE IRRIGATION DISTRIBUTION MAINS TO BE INSTALLED AT 18" MINIMUM BELOW FINISH GRADE, PROVIDE WARNING TAPE WITH INTEGRAL TRACE WIRE IN TRENCH, PLACE WARNING TAPE 6" COMPONENTS INDICATED FOR INDIVIDUAL PLANT LOCATIONS. FIELD MARK FOR APPROVAL PER NOTE 9. REFER TO LAYOUT PLANS FOR LOCATION OF PERIMETER LIMITS OF IRRIGATION SYSTEM LAYOUT AND COMPONENTS SHOWN ARE APPROXIMATE. CONTRACTOR SHALL PREPARE FINAL SHOP DRAWING SUBMITTAL OF IRRIGATION SYSTEM DESIGN FOR -Q- EXISTING SIGN - USE IN PLACE, UNLESS OTHERWISE NOTED EXISTING STEEL BEAM POST - REMOVE (FLOOD MEMORIAL) +₩# BACKFLOW PREVENTER MINIMUM BELOW FINISH GRADE. INSTALL BLANK DRIP TUBING 12" MINIMUM BELOW FINISH GRADE WITH DETECTABLE WARNING TAPE IN TRENCH, INSTALL DRIP APPROVAL TO PROVIDE A COMPLETE AND PROPERLY LANDSCAPE PLANTING BEDS, LOCATE DRIP TUBING EMITTERS AT 18" O.C. 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TO TAP EXISTING MAIN, PROVIDE AND INSTALL WATER METER PIT AND METER AT EACH IRRIGATION SYSTEM TAP LOCATIONS SHOWN FOR IRRIGATION SYSTEM COMPONENTS ARE EMITTERS © 12" ON-CENTER ROOT ZONE WATERING SYSTEM COMPONENTS WITH EMITTERS AT INDIVIDUAL TREE LOCATIONS DIAGRAMMATIC IN NATURE EXCEPT WHERE DIMENSIONS ARE SHOWN, CONTRACTOR SHALL COORDINATE WITH CITY STAFF TO EXISTING TRAFFIC SIGNAL (ON ARM) - USE IN PLACE DRIP TUBING W/ EMMITTERS @ 12" O.C. MARK THE PROPOSED LOCATIONS OF COMPONENTS ARRANGED IN LOCATION, AND PROVIDE TERMINATION THAT WILL SERVE AS THE ■ EXISTING STREET LIGHT - USE IN PLACE ROOT ZONE WATERING COMPONENTS .6. INCIDENTAL ITEMS SUCH AS VALVE BOXES, DRIP TUBING ANCHORS, FITTINGS, ETC. CONTRACTOR SHALL FIELD VERIFY SYSTEM OPERATIONAL AND SEQUENCE AND APPROXIMATE LOCATIONAL ARRANGEMENTS CONTRACTOR'S POINT OF CONNECTION (P.O.C). CONTRACTOR SHALL COORDINATE WITH I.A.W.C. 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DETAIL M - PIPING SCHEMATIC

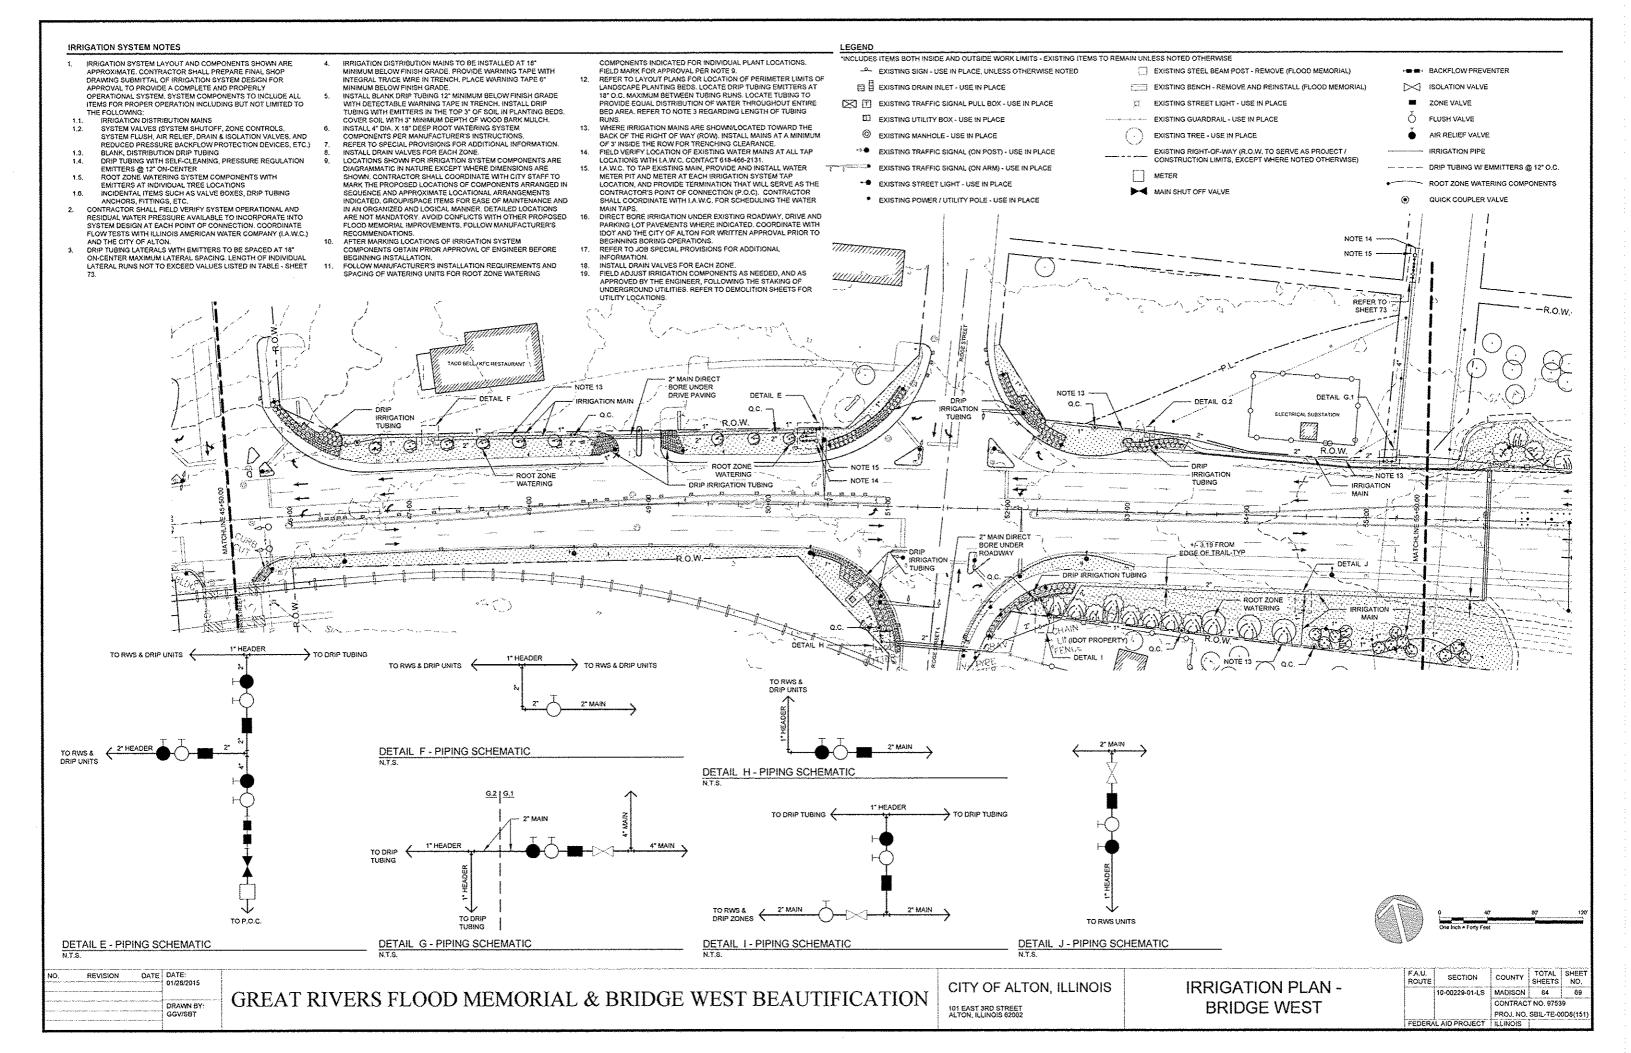NO. REVISION DATE DATE: 01/28/2015

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DETAIL K - PIPING SCHEMATIC


GREAT RIVERS FLOOD MEMORIAL & BRIDGE WEST BEAUTIFICATION

DETAIL L - PIPING SCHEMATIC

CITY OF ALTON, ILLINOIS

DETAIL N - PIPING SCHEMATIC N.T.S.


> IRRIGATION PLAN -BRIDGE WEST

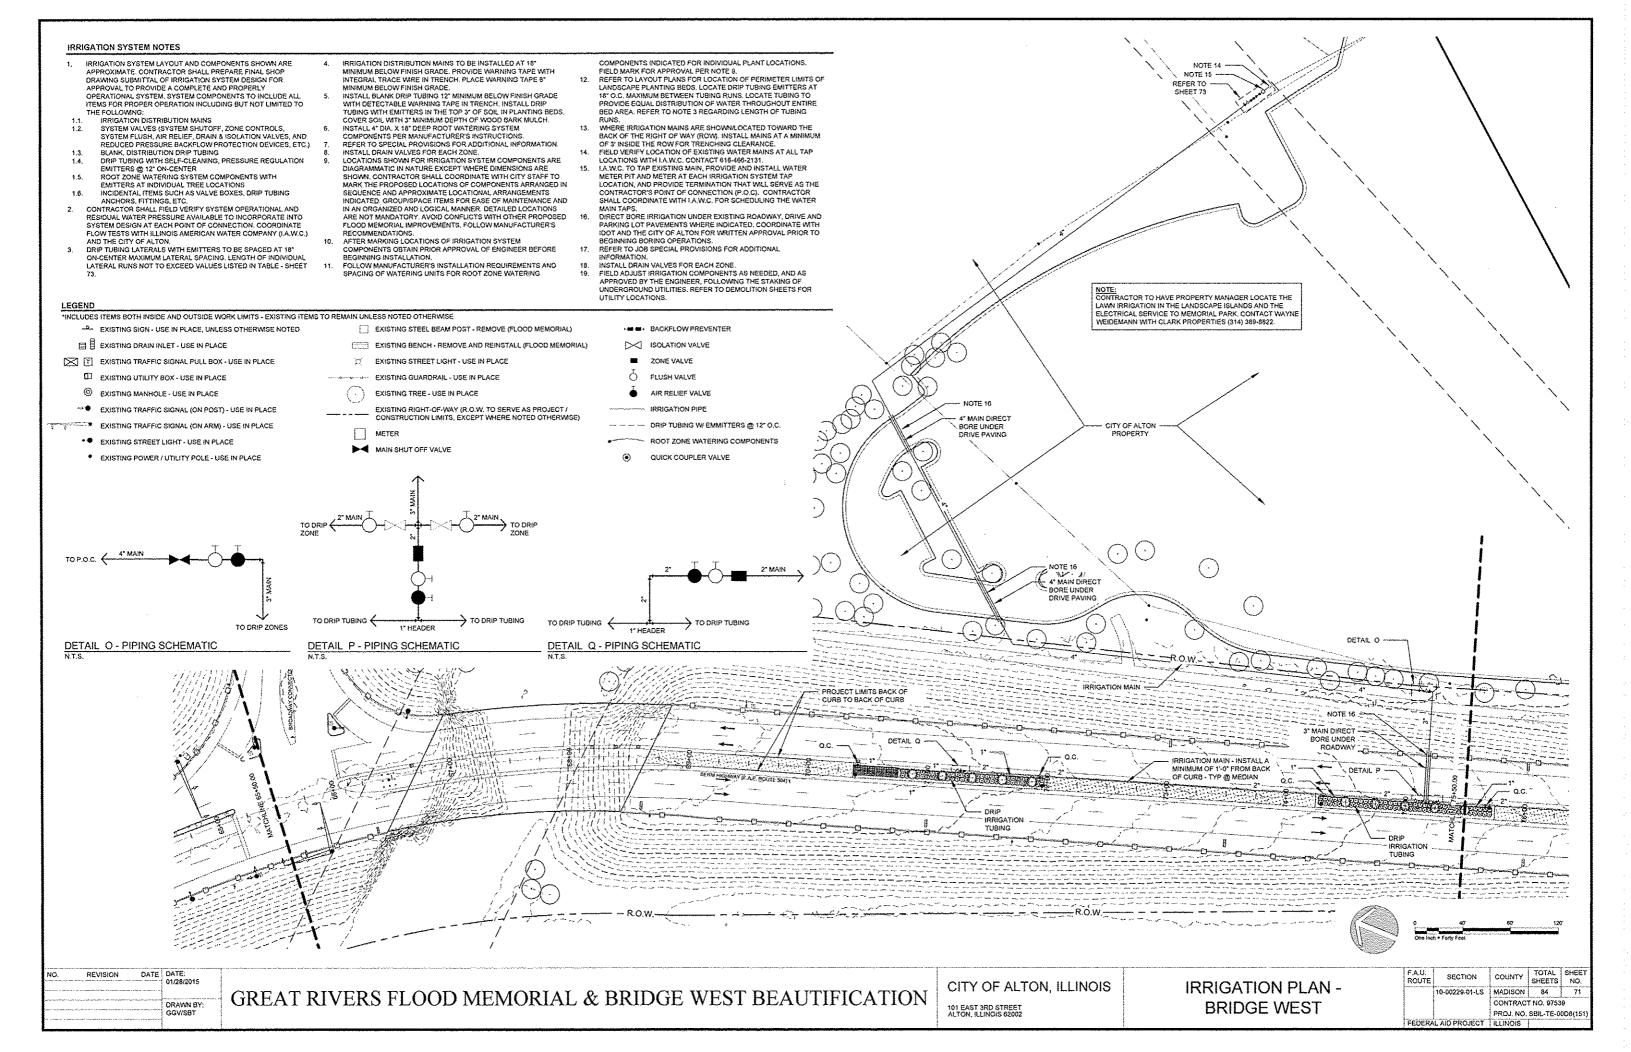


## IRRIGATION SYSTEM NOTES IRRIGATION SYSTEM LAYOUT AND COMPONENTS SHOWN ARE IRRIGATION DISTRIBUTION MAINS TO BE INSTALLED AT 18" APPROXIMATE, CONTRACTOR SHALL PREPARE FINAL SHOP COMPONENTS INDICATED FOR INDIVIDUAL PLANT LOCATIONS. INCLUDES ITEMS BOTH INSIDE AND OUTSIDE WORK LIMITS - EXISTING ITEMS TO REMAIN UNLESS NOTED OTHERWISE MINIMUM BELOW FINISH GRADE, PROVIDE WARNING TAPE WITH INTEGRAL TRACE WIRE IN TRENCH, PLACE WARNING TAPE 6" MINIMUM BELOW FINISH GRADE, DRAWING SUBMITTAL OF IRRIGATION SYSTEM DESIGN FOR APPROVAL TO PROVIDE A COMPLETE AND PROPERLY FIELD MARK FOR APPROVAL PER NOTE 9. REFER TO LAYOUT PLANS FOR LOCATION OF PERIMETER LIMITS OF LANDSCAPE PLANTING BEDS. LOCATE DRIP TUBING EMITTERS AT - EXISTING SIGN - USE IN PLACE, UNLESS OTHERWISE NOTED ☐ EXISTING STEEL BEAM POST - REMOVE (FLOOD MEMORIAL) ■ BACKFLOW PREVENTER OPERATIONAL SYSTEM. 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TO SERVE AS PROJECT / CONSTRUCTION LIMITS, EXCEPT WHERE NOTED OTHERWISE) ROOT ZONE WATERING SYSTEM COMPONENTS WITH DIAGRAMMARIE IN NATURE EACET! WEIGHE DIMENSIONS ARE SHOWN. CONTRACTOR SHALL COORDINATE WITH GITY STAFF TO MARK THE PROPOSED LOCATIONS OF COMPONENTS ARRANGED IN SEQUENCE AND APPROXIMATE LOCATIONAL ARRANGEMENTS INDICATED, GROUP/SPACE ITEMS FOR EASE OF MAINTENANCE AND EXISTING TRAFFIC SIGNAL (ON ARM) - USE IN PLACE EMITTERS AT INDIVIDUAL TREE LOCATIONS INCIDENTAL ITEMS SUCH AS VALVE BOXES, DRIP TUBING ANCHORS, FITTINGS, ETC. METER PIT AND METER AT EACH IRRIGATION SYSTEM TAP LOCATION, AND PROVIDE TERMINATION THAT VALL SERVE AS THE CONTRACTOR'S POINT OF CONNECTION (P.O.C.). CONTRACTOR DRIP TUBING W EMMITTERS @ 12" O.C. EXISTING STREET LIGHT - USE IN PLACE ROOT ZONE WATERING COMPONENTS CONTRACTOR SHALL FIELD VERIFY SYSTEM OPERATIONAL AND RESIDUAL WATER PRESSURE AVAILABLE TO INCORPORATE INTO SYSTEM DESIGN AT EACH POINT OF CONNECTION, COORDINATE SHALL COORDINATE WITH LA.W.C. FOR SCHEDULING THE WATER MAIN SHUT OFF VALVE IN AN ORGANIZED AND LOGICAL MANNER, DETAILED LOCATIONS ARE NOT MANDATORY, AVOID CONFLICTS WITH OTHER PROPOSED FLOOD MEMORIAL IMPROVEMENTS, FOLLOW MANUFACTURER'S RECOMMENDATIONS. EXISTING POWER / UTILITY POLE - USE IN PLACE MAIN TAPS, DIRECT BORE IRRIGATION UNDER EXISTING ROADWAY, DRIVE AND PARKING LOT PAVEMENTS WHERE INDICATED. COORDINATE WITH IDOT AND THE CITY OF ALTON FOR WRITTEN APPROVAL PRIOR TO BEGINNING BORING OPERATIONS. REFER TO JOB SPECIAL PROVISIONS FOR ADDITIONAL INSCRIPMATION. QUICK COUPLER VALVE FLOW TESTS WITH ILLINOIS AMERICAN WATER COMPANY (I.A.W.C.) AND THE CITY OF ALTON. AND THE CITY OF ALTON. DRIP TUBING LATERALS WITH EMITTERS TO BE SPACED AT 18\* ON-CENTER MAXIMUM LATERAL SPACING, LENGTH OF INDIVIDUAL LATERAL RUNS NOT TO EXCEED VALUES LISTED IN TABLE - SHEET RECOMMENDATIONS. AFTER MARKING LOCATIONS OF IRRIGATION SYSTEM COMPONENTS OBTAIN PRIOR APPROVAL OF ENGINEER BEFORE BEGINNING INSTALLATION INFORMATION. FOLLOW MANUFACTURER'S INSTALLATION REQUIREMENTS AND SPACING OF WATERING UNITS FOR ROOT ZONE WATERING INFORMATION, INSTALL DRAIN VALVES FOR EACH ZONE. FIELD ADJUST IRRIGATION COMPONENTS AS NEEDED, AND AS APPROVED BY THE ENGINEER, FOLLOWING THE STAKING OF UNDERGROUND UTILITIES, REPER TO DEMOLITION SHEETS FOR PROJECT LIMITS BACK OF CURB TO BACK OF CURB - DETAIL R RRIGATION MAIN - INSTALL MINIMUM OF 1-0" FROM BACK OF CURB - TYP @ MEDIAN DRIP IRRIGATION TUBING TO DRIP TUBING 4 TO DRIP TUBING 1" HEADER DETAIL R - PIPING SCHEMATIC DATE DATE 01/28/2015 GREAT RIVERS FLOOD MEMORIAL & BRIDGE WEST BEAUTIFICATION TOTAL SHEET SHEETS NO. CITY OF ALTON, ILLINOIS SECTION COUNTY ROUTE **IRRIGATION PLAN -**MADISON 84 101 EAST 3RD STREET ALTON, ILLINOIS 62002 **BRIDGE WEST** CONTRACT NO. 97539


PROJ. NO. SBIL-TE-00D8(151

FEDERAL AID PROJECT ILLINOIS

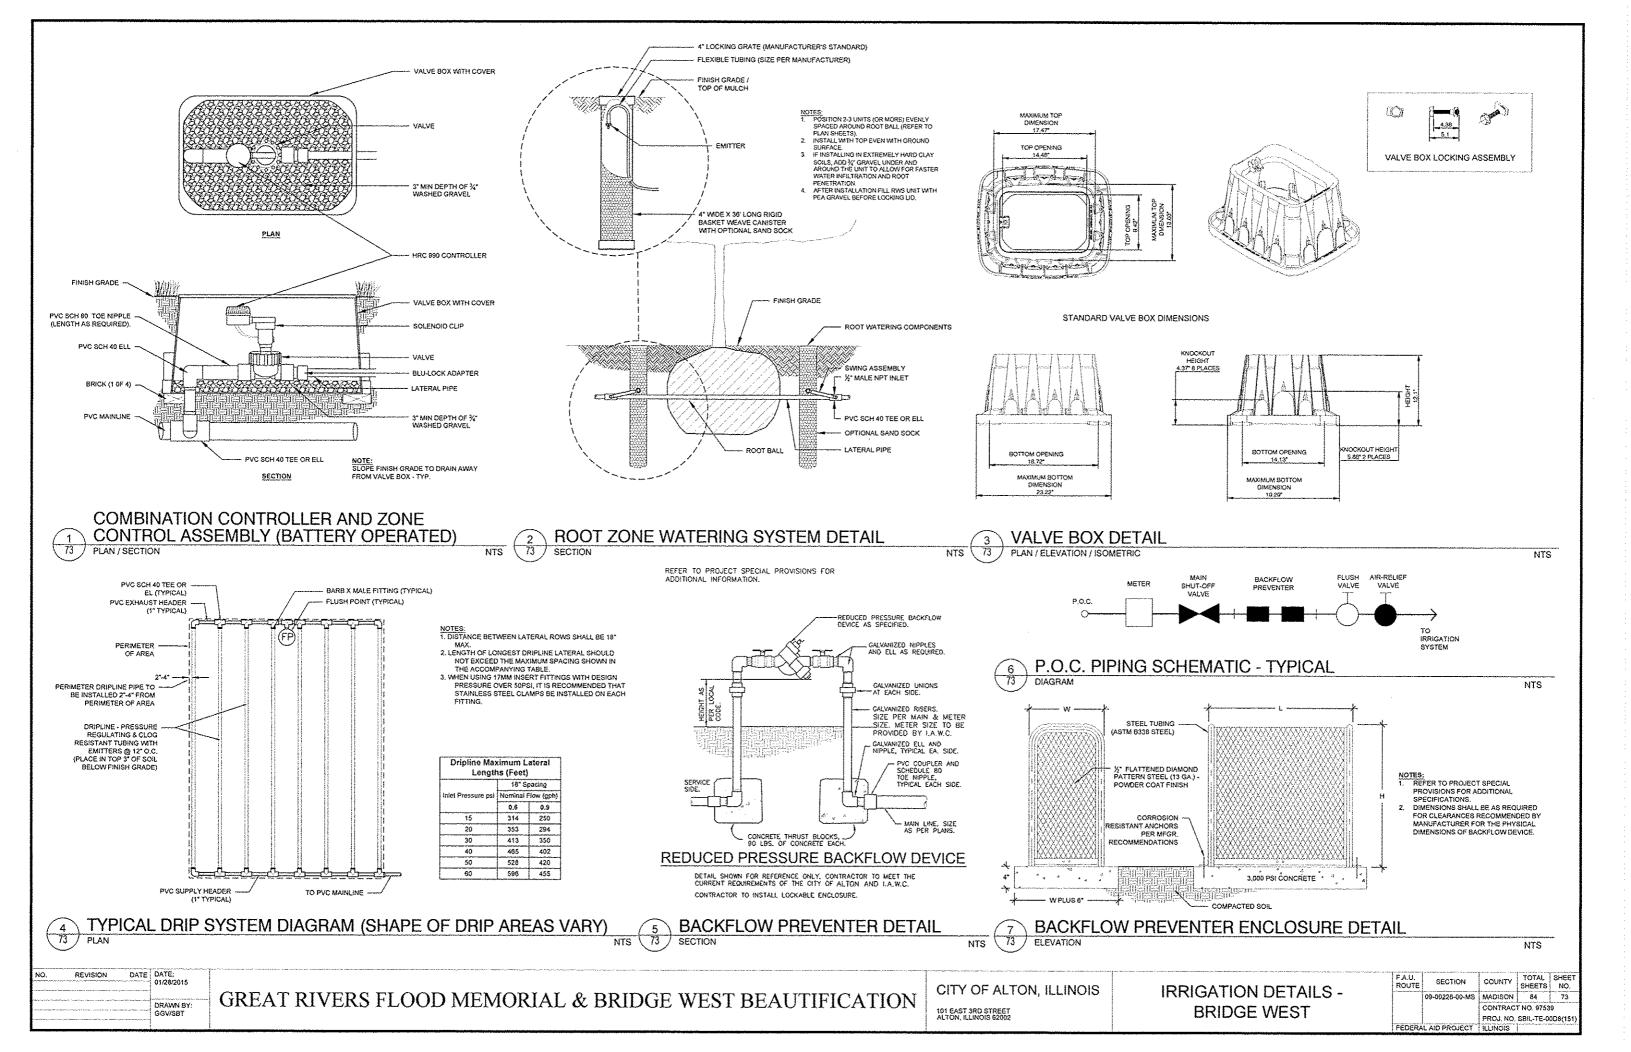

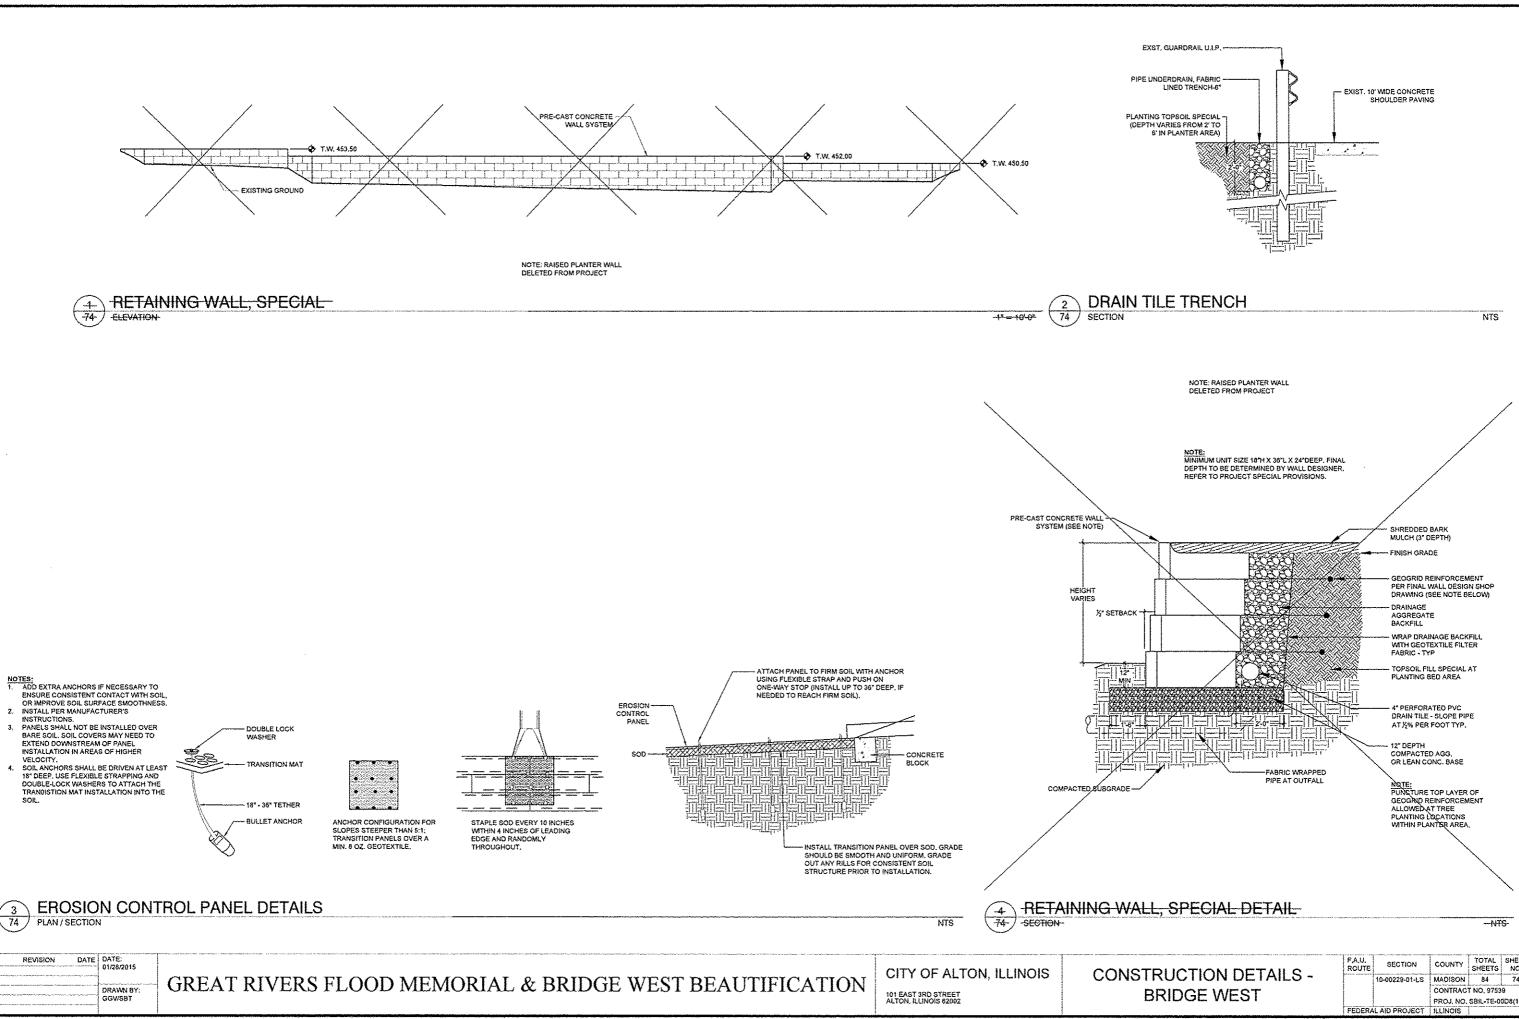

TOTAL SHEET SHEETS NO. 0-00229-01-LS MADISON 84 74 PROJ. NO. SBIL-TE-0008(151

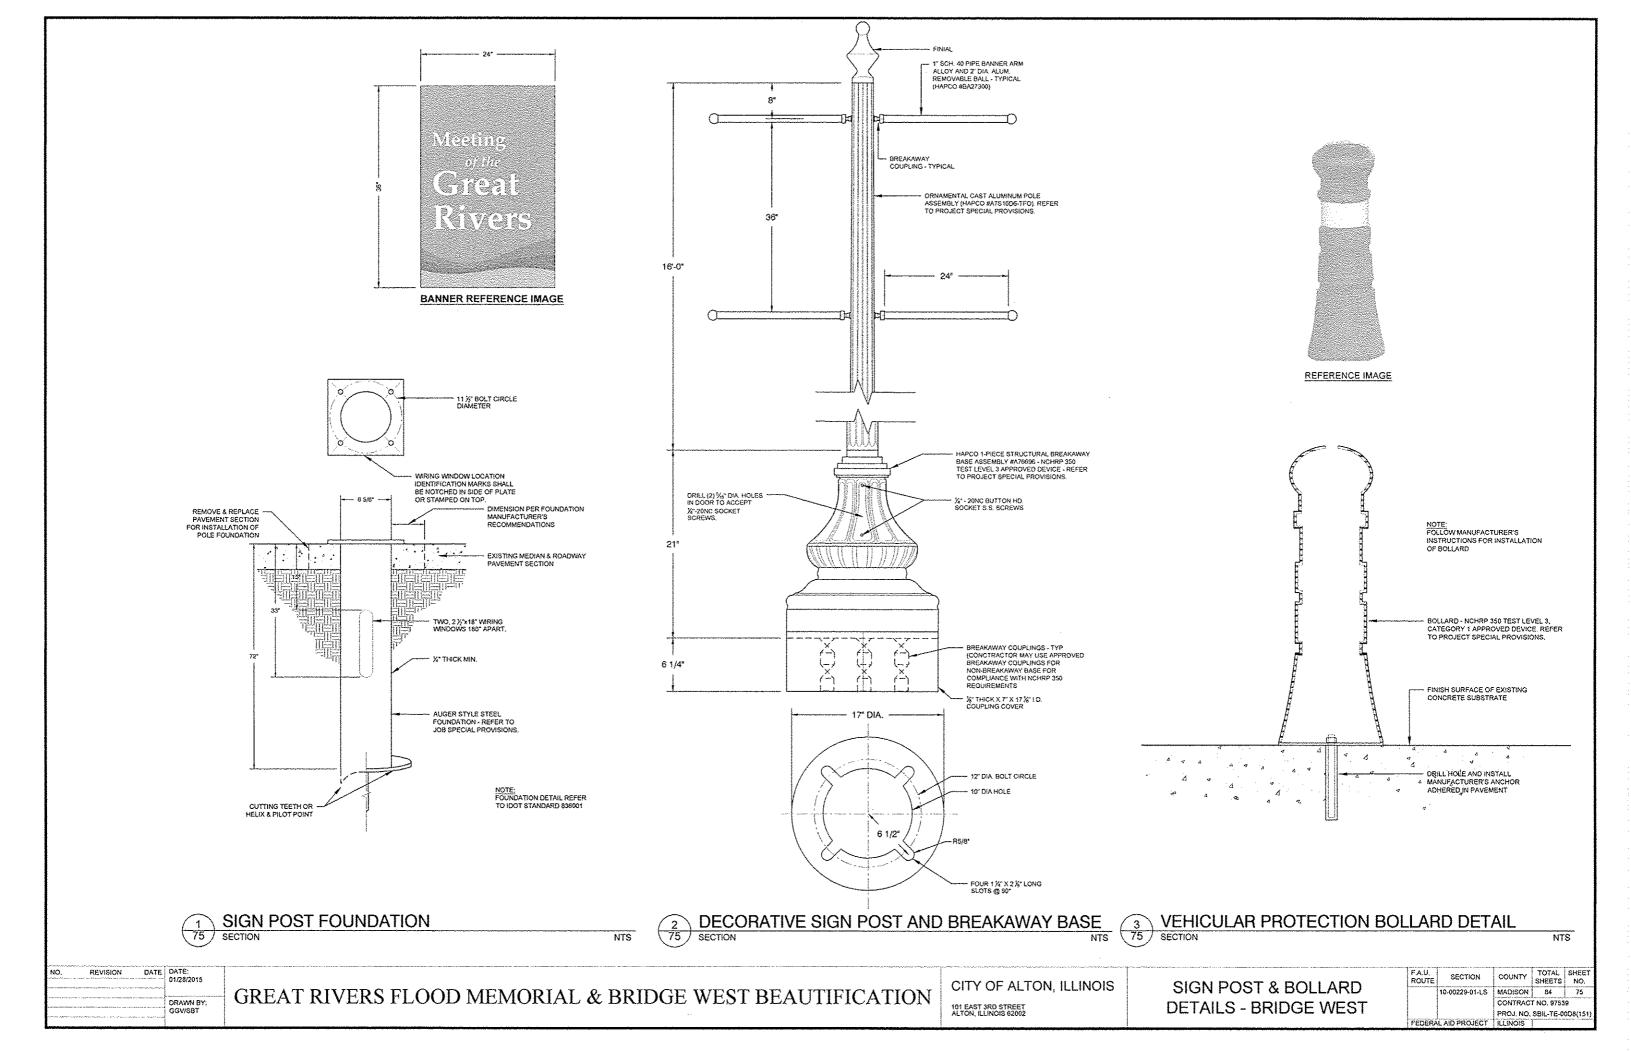

## TRAFFIC CONTROL LEGEND **GENERAL NOTES** ALL SIGNS SHALL MEET THE REQUIREMENTS OF THE LATEST EDITION OF THE "MANUAL ON UNIFORM TRAFFIC CONTROL DEVICES FOR STREETS AND HIGHWAYS". SIGN, "ROAD CONSTRUCTION AHEAD", W20-I103(0)-48 CONE, DRUM OR TYPE II BARRICADE SIGN, "RIGHT LANE CLOSED AHEAD", W20-5(0)-48 INSTALLATION AND REMOVAL OF ALL SIGNS, HARDWARE AND POSTS SHALL BE INCLUDED IN THE CONTRACT UNIT PRICE FOR TRAFFIC CONTROL AND PROTECTION, SPECIAL. SIGN, "LEFT LANE CLOSED AHEAD", W20-I103(0)-48 → ARROW BOARD 3. THE ENGINEER SHALL DETERMINE THE FINAL LOCATION OF EACH TRAFFIC CONTROL ITEM. D SIGN, "WORKER SYMBOL", W21-I(0)-48 (USE ONLY WHEN WORKERS ARE PRESENT) BARRICADE OR DRUM WITH FLASHING LIGHT SIGN, BLACK ARROW ON ORANGE BACKGROUND, M5-1, 21" x 15" TYPE III BARRICADE 2 SIGN, BLACK ARROW ON ORANGE BACKGROUND, M5-1, 21" x 15" 3 SIGN, "SIDEWALK CLOSED", R11-I101-2418 SIGN, "SIDEWALK CLOSED, ARROW SYMBOL, USE OTHER SIDE", R11-I102-2430 SIGN, NO RIGHT TURN SYMBOL, R3-1, 24" x 24" 6 SIGN, "YIELD", R1-2, 36" x 36" x 36" WORK AREA 2 A FOR STAGING AND ACCESS ONLY NO IMPROVEMENTS EAST OF CROSSWALK REMOVAL AND

LEFT LANES CLOSED




GREAT RIVERS FLOOD MEMORIAL & BRIDGE WEST BEAUTIFICATION


TRAFFIC CONTROL PLAN


F.A.U. ROUTE	SECTION	COUNTY	TOTAL SHEETS	SHEET NO.	
	10-00229-01-LS	MADISON	84	78	
		CONTRAC	ONTRACT NO. 97539 ROJ. NO. SBIL-TE-00D8(151)		
		PROJ. NO.			
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CITY OF ALTON, ILLINOIS 101 EAST 3RD STREET ALTON, ILLINOIS 62002


**BRIDGE WEST** 



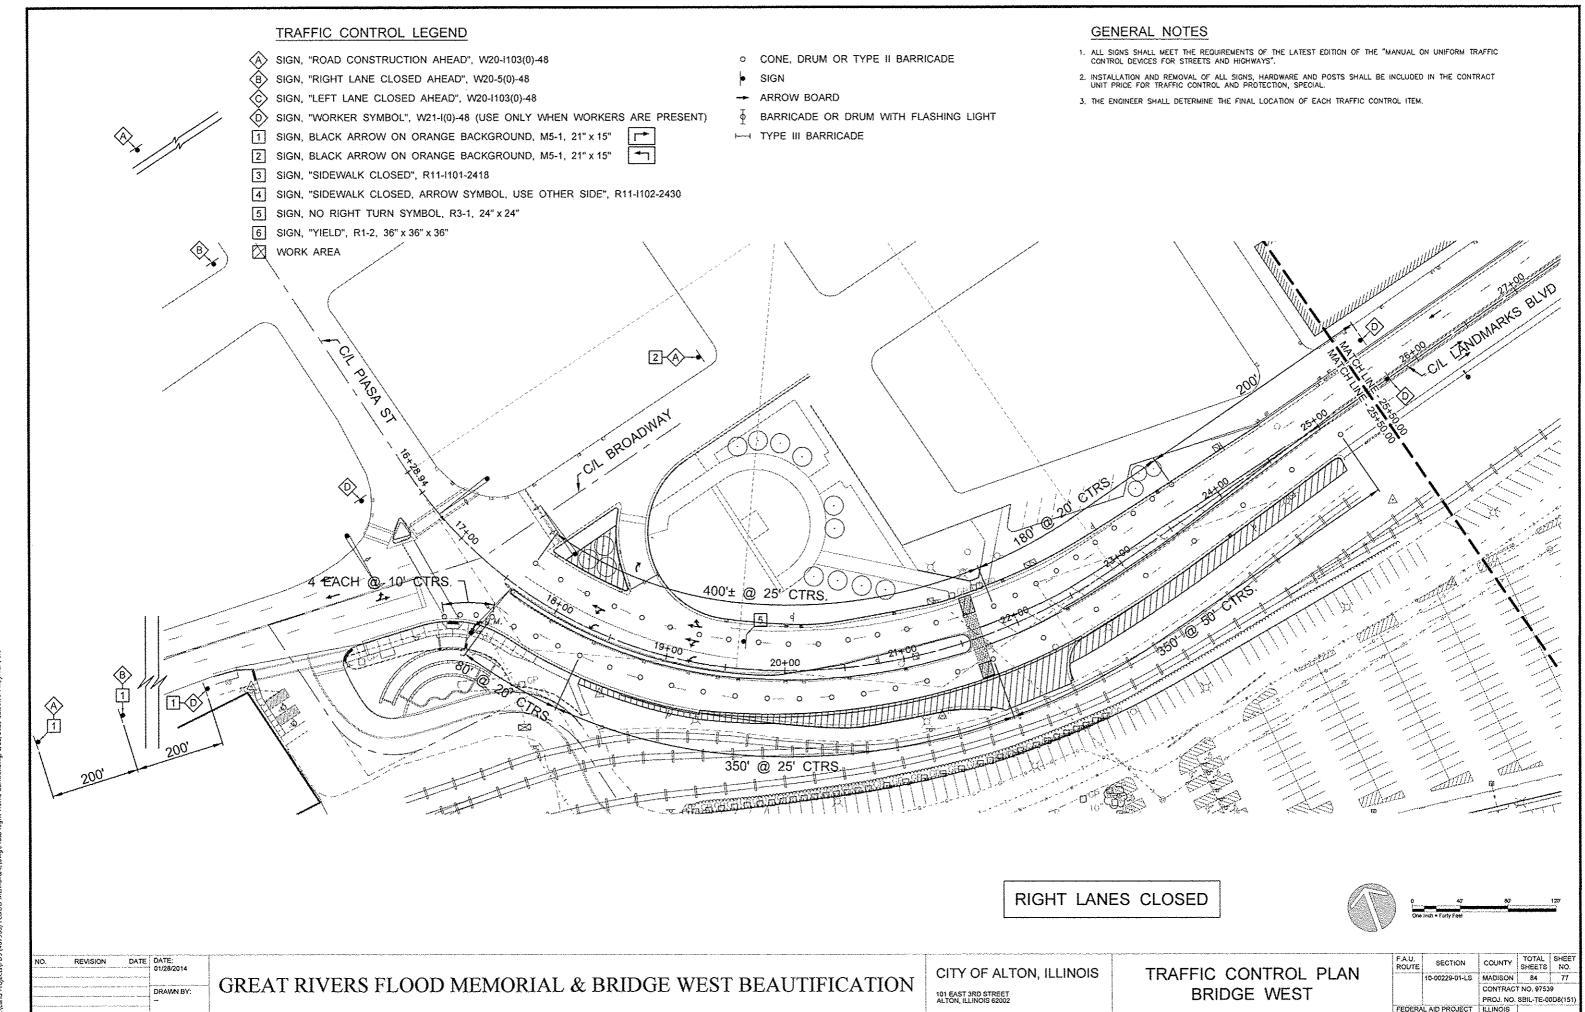

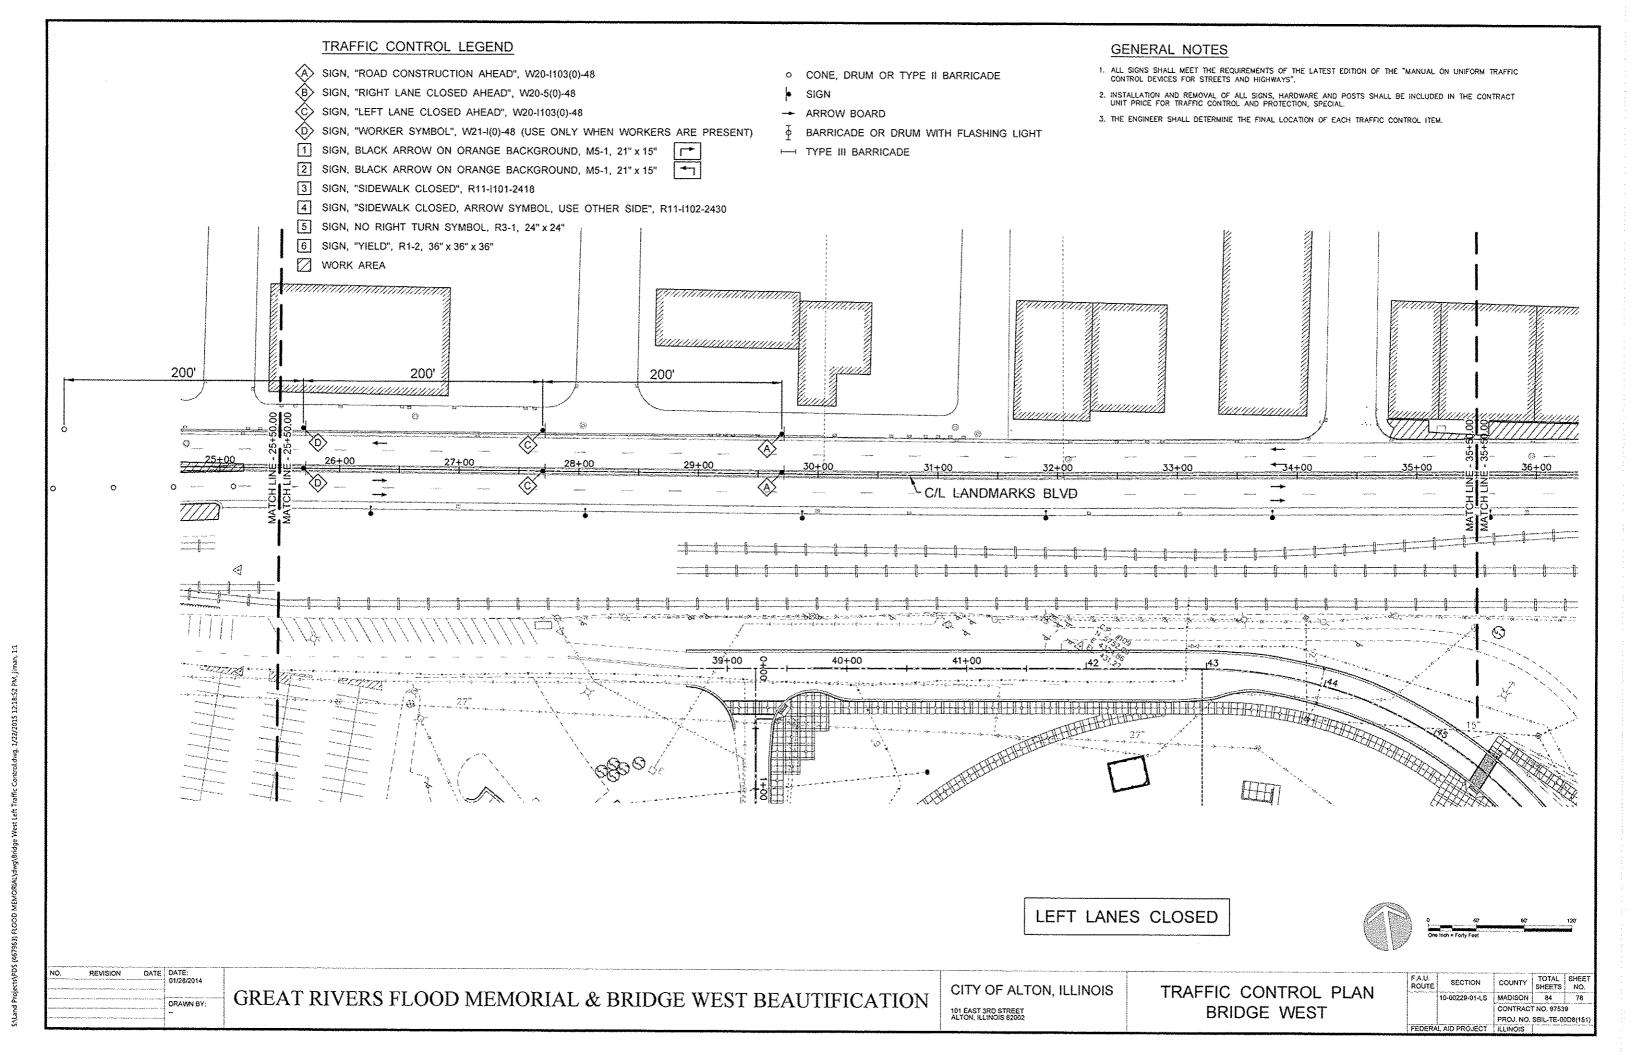
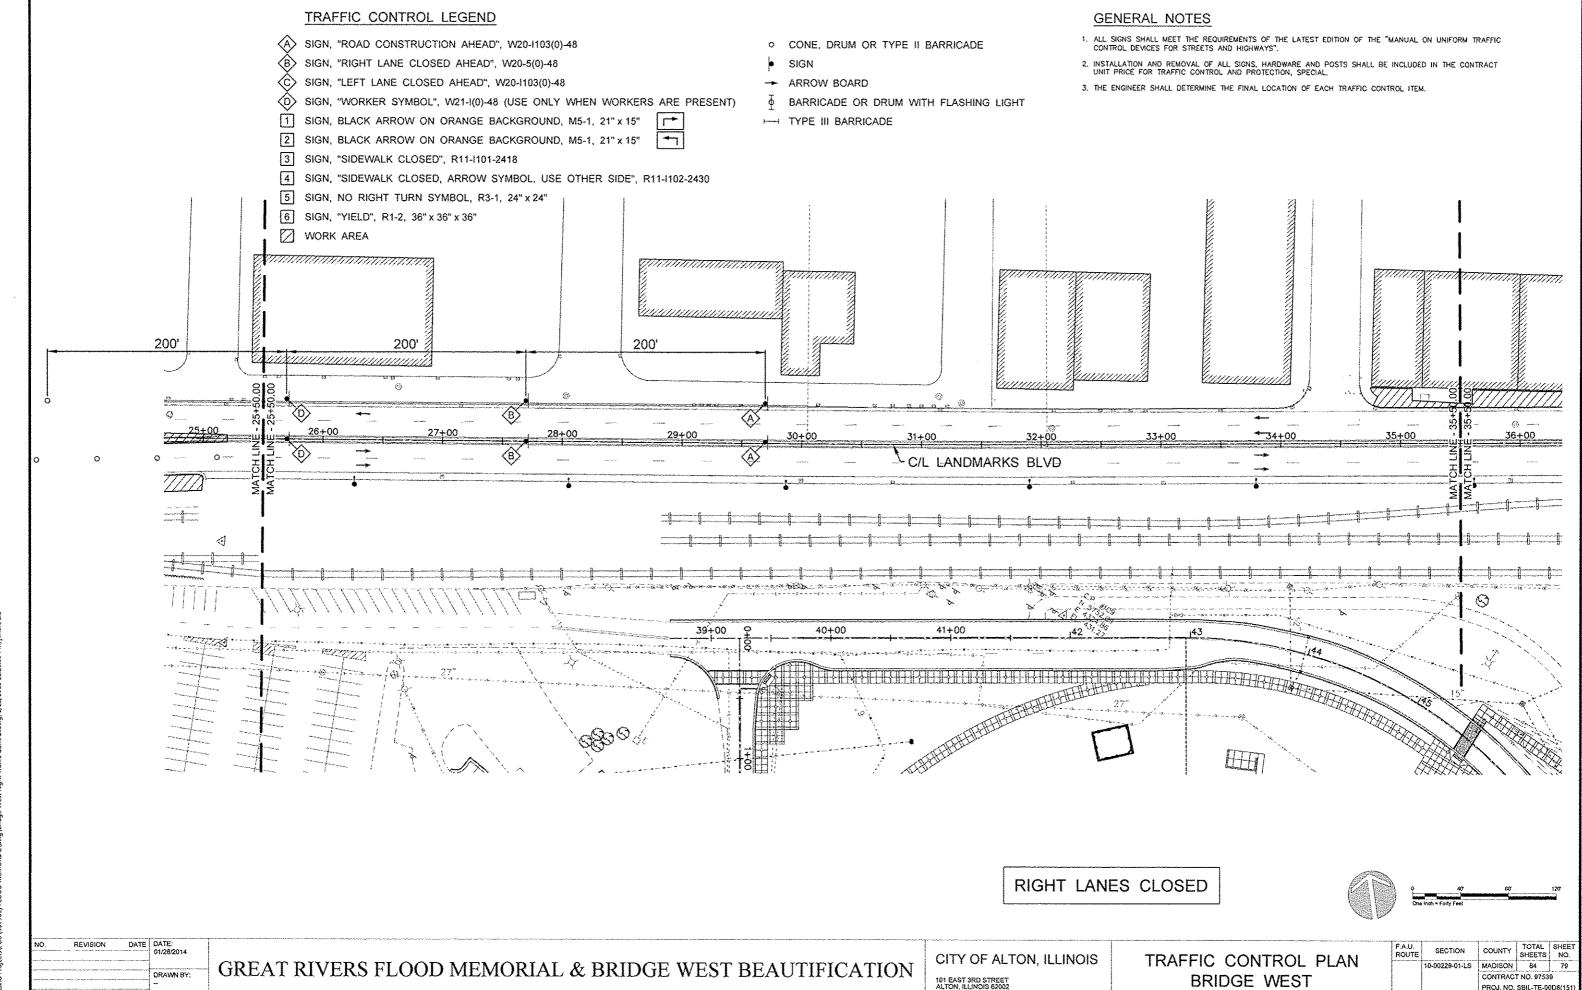
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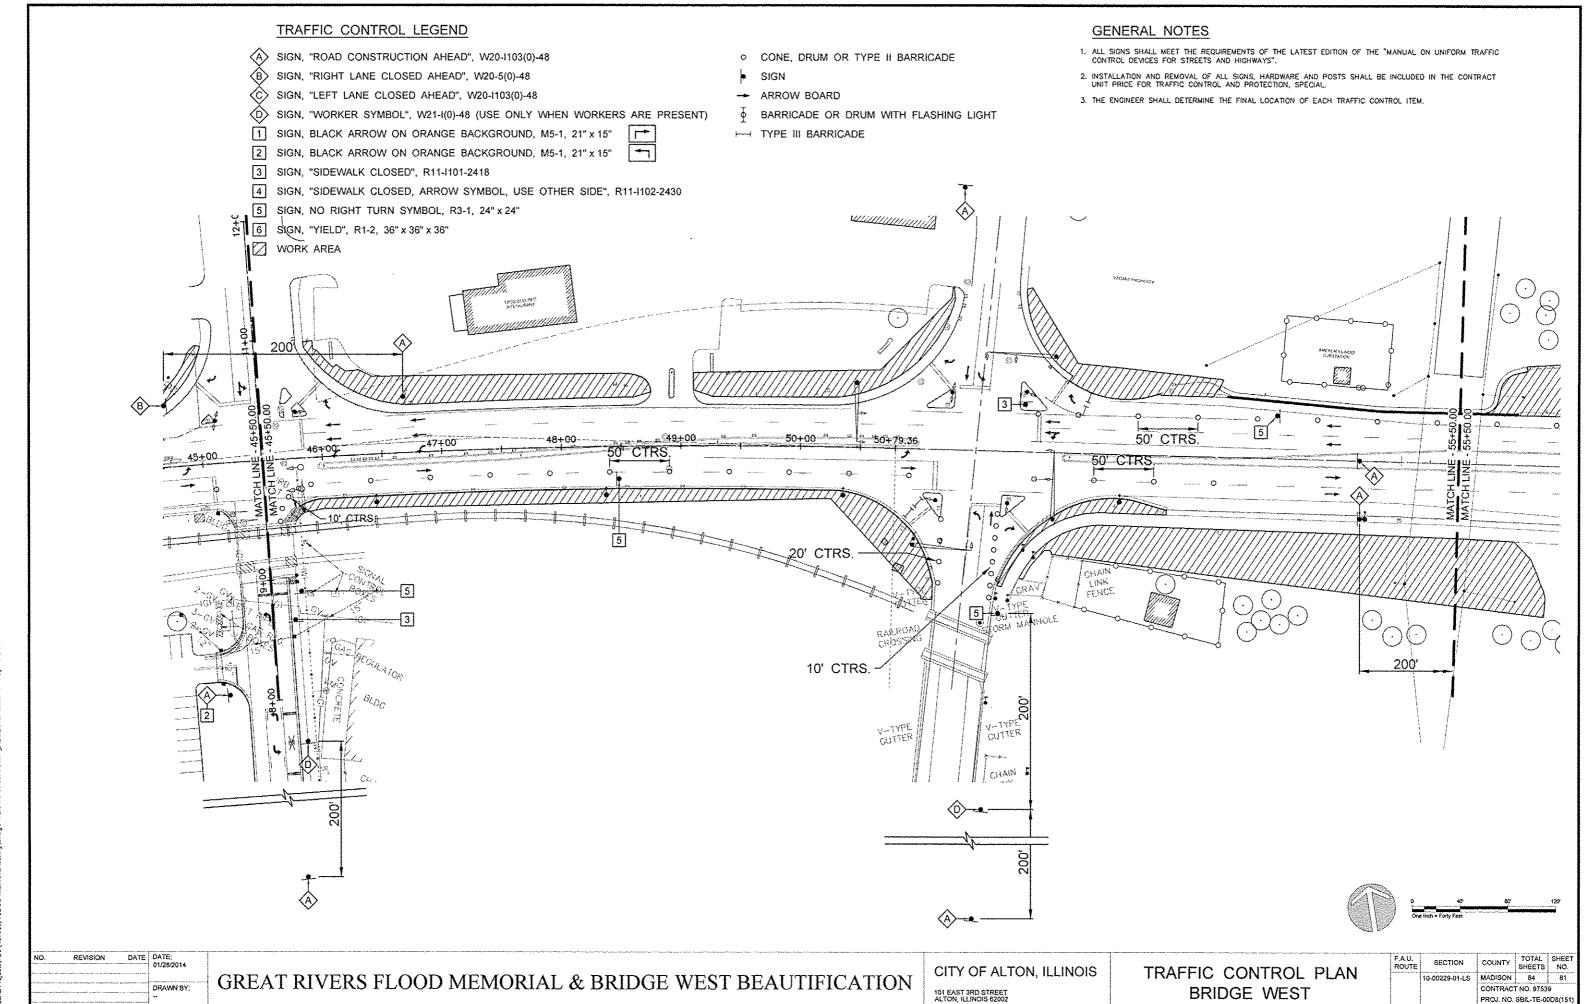
GREAT RIVERS FLOOD MEMORIAL & BRIDGE WEST BEAUTIFICATION

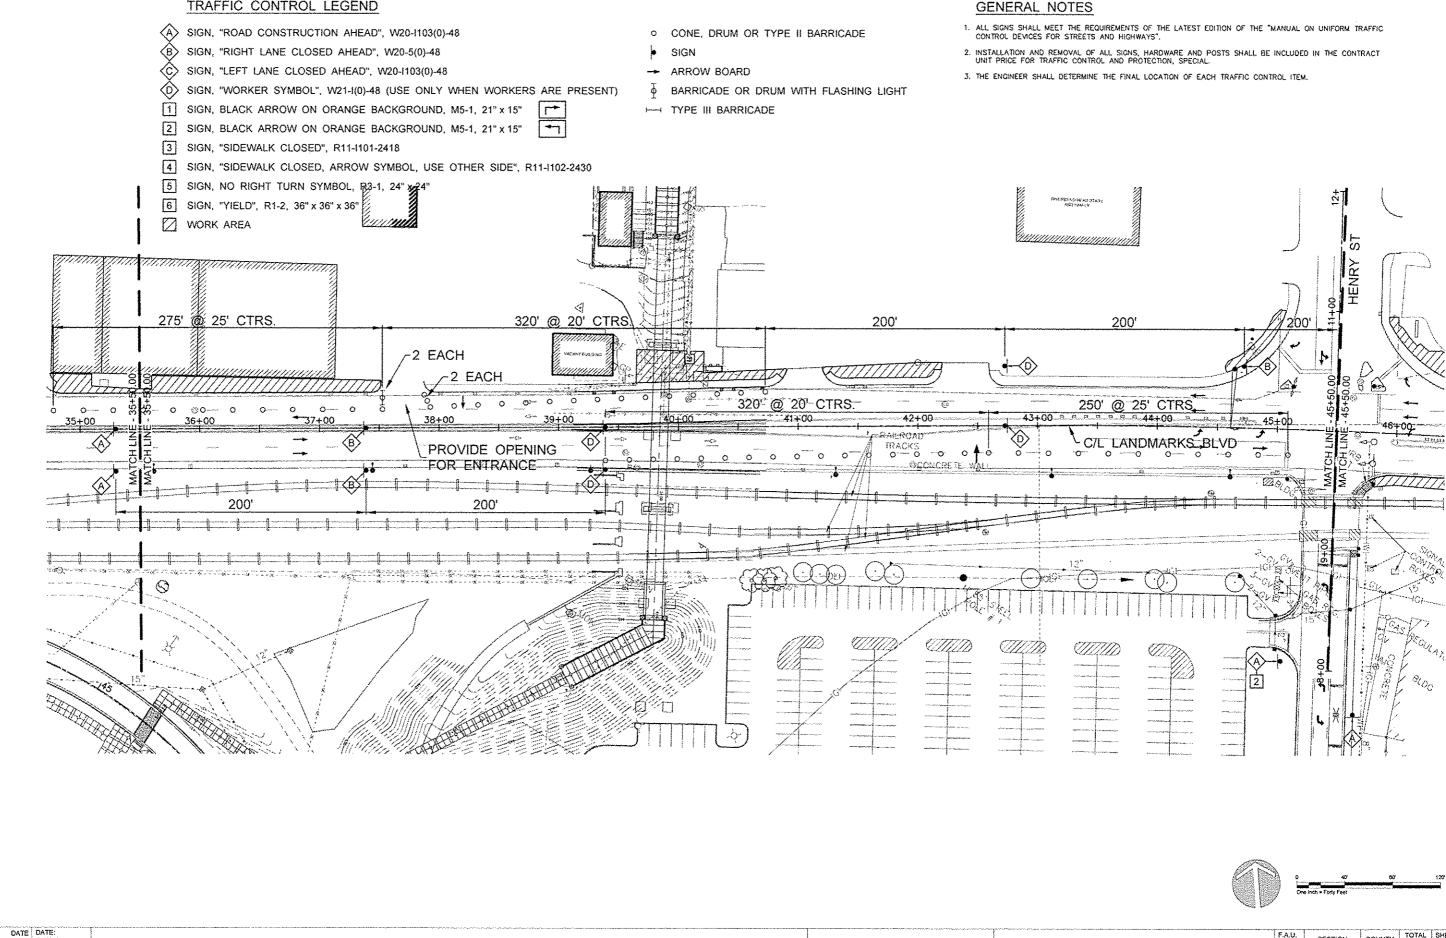TRAFFIC CONTROL LEGEND

CITY OF ALTON, ILLINOIS

TRAFFIC CONTROL PLAN **BRIDGE WEST** 

F.A.U. ROUTE	SECTION	COUNTY	TOTAL SHEETS	SHEET NO.	
	10-00229-01-LS	MADISON	84	80	
		CONTRACT NO. 97539			
		PROJ. NO. SBIL-TE-00D8(151)			
FEDERAL AID PROJECT		ILLINOIS		.,	




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GREAT RIVERS FLOOD MEMORIAL & BRIDGE WEST BEAUTIFICATION


CITY OF ALTON, ILLINOIS

TRAFFIC CONTROL PLAN BRIDGE WEST 

GREAT RIVERS FLOOD MEMORIAL & BRIDGE WEST BEAUTIFICATION

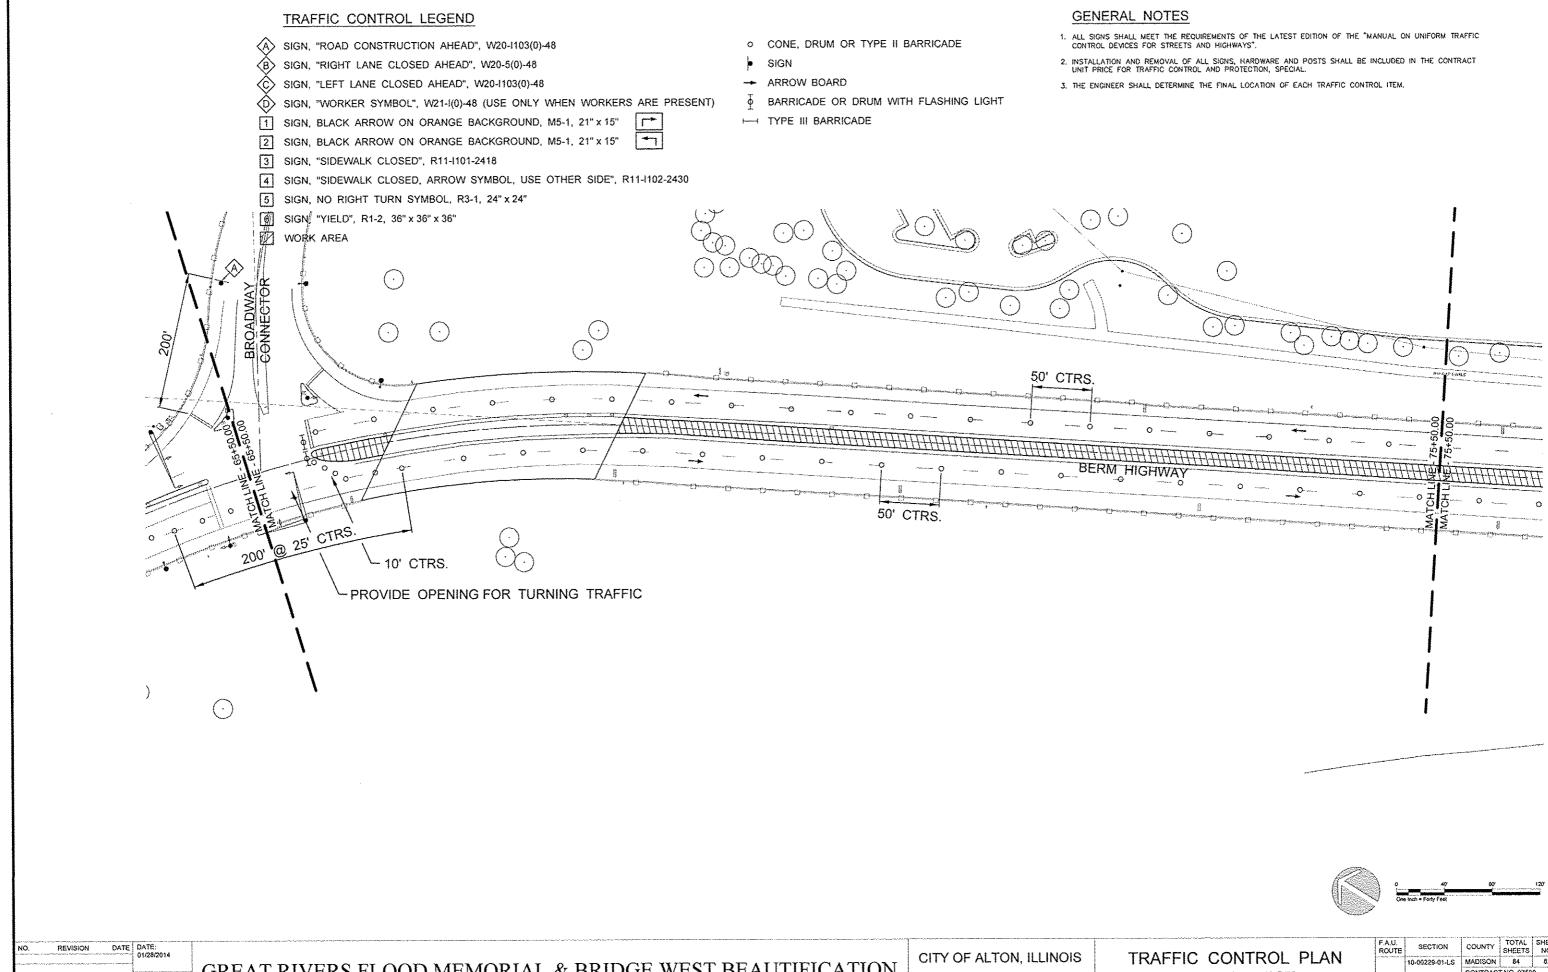**BRIDGE WEST** 

CONTRACT NO. 97539 PROJ. NO. SBIL-TE-00D8(15 FEDERAL AID PROJECT ILLINOIS

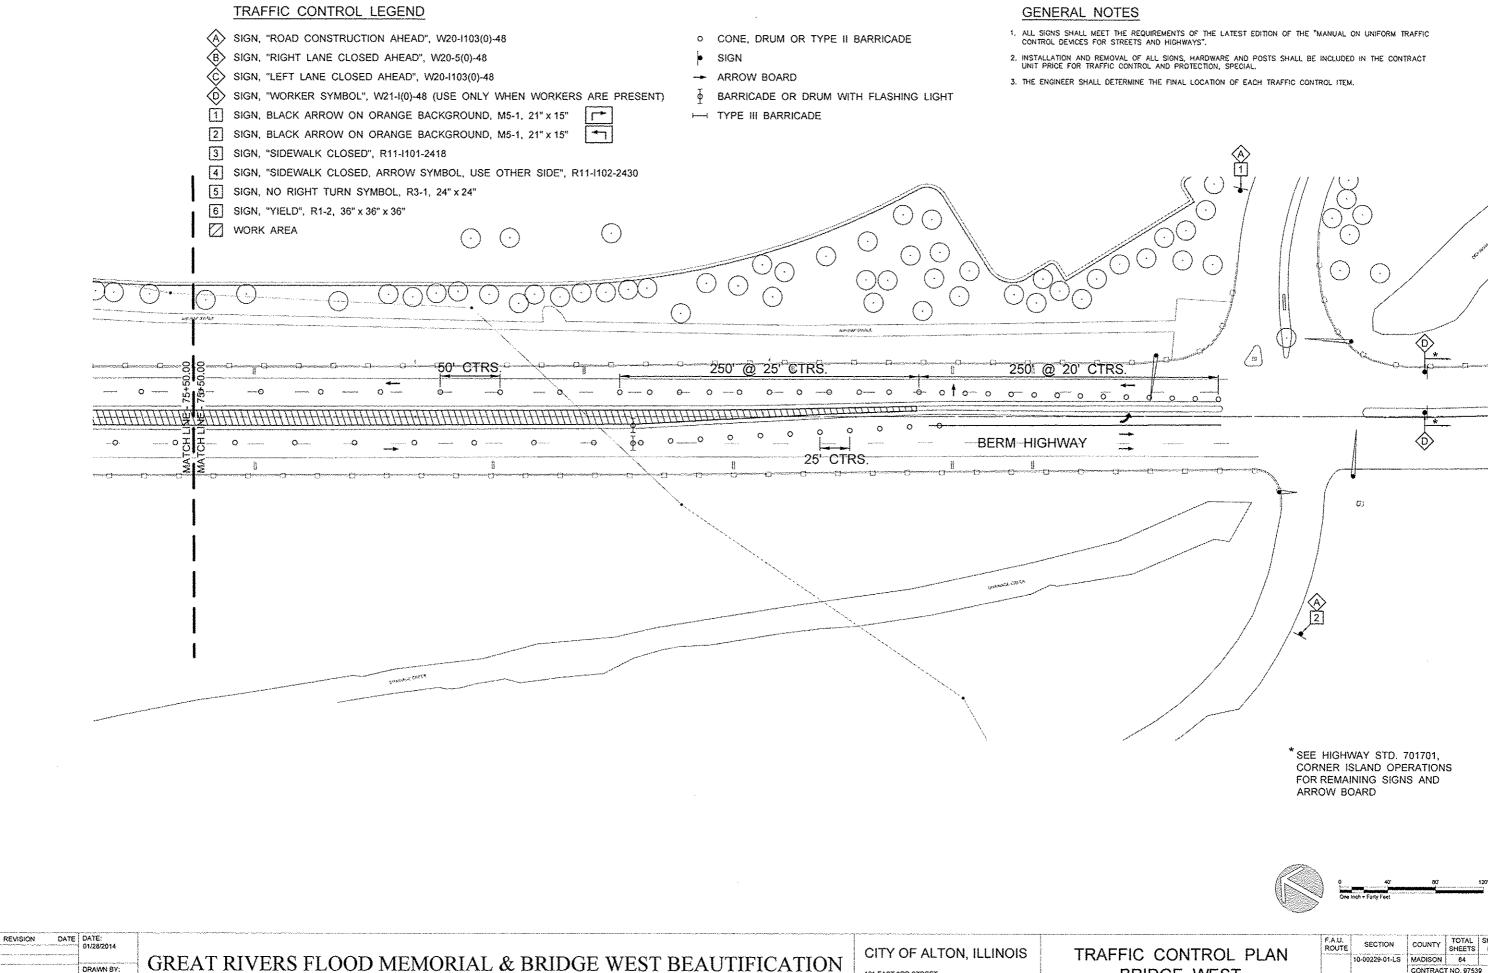

GREAT RIVERS FLOOD MEMORIAL & BRIDGE WEST BEAUTIFICATION

101 EAST 3RD STREET ALTON, ILLINOIS 82902

**BRIDGE WEST** 

COUNTY TOTAL SHEET NO. MADISON 84 84 CONTRACT NO. 97539 PROJ. NO. SBIL-TE-00D8(15