FOR INDEX OF SHEETS, SEE SHEET NO. 2

04-24-2015 LETTING ITEM 176

HIGHWAY CLASSIFICATION
IL RTE 19 - URBAN MINOR ARTERIAL
WOOD DALE ROAD - URBAN MINOR ARTERIAL

DESIGN DESIGNATION 2700(30) ARTERIAL 22.15 (PCC-20)

TRAFFIC DATA
IL RTE 19
2005 ADT =

 $2005 \ ADT = \quad 33,100 \qquad 2030 \ ADT = \quad 34,000$

WOOD DALE ROAD

2005 ADT = 15,200 2030 ADT = 18,000

POSTED SPEED LIMIT IL RTE 19 = 30 MPH

WOOD DALE ROAD = 30 MPH

DESIGN SPEED LIMIT IL RTE 19 = 35 MPH

WOOD DALE ROAD = 35 MPH

STATE OF ILLINOIS

DEPARTMENT OF TRANSPORTATION

DIVISION OF HIGHWAYS

PLANS FOR PROPOSED FEDERAL-AID HIGHWAY

FAU 1321 (ILLINOIS ROUTE 19) (IRVING PARK ROAD)
AT FAU 2652 (C.H. 28, WOOD DALE ROAD)
INTERSECTION RECONSTRUCTION
SECTION 11-00048-00-SP
PROJECT NO. HPP-1149(102)
CITY OF WOOD DALE
DUPAGE COUNTY
C-91-028-14

END IMPROVEMENT
WOOD DALE ROAD
STA 123 + 00.00

BEGIN PROJECT
IL RTE 19
STA 50 + 14.78

END PROJECT
IL RTE 19
STA 70 + 64.18

BEGIN MPROVEMENT
WOOD DALE ROAD
STA 123 + 00.00

ORCHARD DR
FOREST GLEN RULL
FOREST

GROSS LENGTH OF PROJECT (IL RTE 19) = 2,049 FT (0.39 MI)

NET LENGTH OF PROJECT = 2,049 FT (0.39 MI)

SCALE: N.T.S

BRENDA LOWERY, P.E. EXPIRES: 11-30-15

ROBERT G. DAVIES, S.E.


EXPIRES: 11-30-16

Denis Hogan 1/12/15

DENIS T. HOGAN, P.E. EXPIRES: 11-30-15

| F.A.U. | SECTION | COUNTY | TOTAL SHEET | NO. |
| 1321 | 11-00048-00-SP | DUPAGE | 277 | 1 |
| FED. ROAD DIST. NO. | ILLINOIS | CONTRACT NO. | 63872



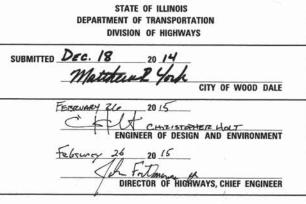



420 NORTH FRONT STREET, SUITE 100 | McHENRY, ILLINOIS 60050
Phone: 815.385.1778 | Toll Free: 800.728.7805 | Fax: 815.385.1781 | HRGreen.c
ILLINOIS PROFESSIONAL DESIGN FIRM #184-001322

PRINTED BY THE AUTHORITY OF THE STATE OF ILLINOIS

CITY OF WOOD DALE

100' 200' 300' — 1" = 100'
0 50' 100'
0 50' 100' — 1" = 50'
0 50' 100' — 1" = 40'
0 50' 100' — 1" = 30'
0 50' 100' — 1" = 20'

PROJECT LOCATED IN THE

FULL SIZE PLANS HAVE BEEN PREPARED USING STANDARD ENGINEERING SCALES. REDUCED SIZED PLANS WILL NOT CONFORM TO STANDARD SCALES. IN MAKING MEASUREMENTS ON REDUCED PLANS, THE ABOVE SCALES MAY BE USED.

J.U.L.I.E

JOINT UTILITY LOCATION INFORMATION FOR EXCAVATION 1-800-892-0123 OR 811

PROJECT ENGINEER: JACK MELHUISH, P.E. PROJECT MANAGER: DENIS HOGAN, P.E.

CONTRACT NO. 63872

12/16/2014/10:13:18 AM 023.cvr.dgn pdf.pit STANDARD-TRANS, TBL

TOWERS NAMES

PROJECT CONTACT:

ATE PLOTTED: 12

FLE NAME: 02

PLOT DRIVER: pc

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DISTRICT ONE DETAILS

STANDARD NO.	LIST OF DESCRIPTION
BD01	DRIVEWAY DETAILS-DISTANCE BETWEEN R.O.W. AND FACE OF CURB & EDGE OF SHOULDER > TO 15 FT
BD02	DRIVEWAY DETAILS-DISTANCE BETWEEN R.O.W. AND FACE OF CURB & EDGE OF SHOULDER < TO 15 FT
BD07	DETAIL OF STORM SEWER CONNECTION TO EXISTING STORM SEWER
BD48	PCC PAVEMENT ROUNDOUTS AT CURB AND GUTTER
BE230	COMBINATION LIGHTING & TRAFFIC POLE MOUNTED ELECTRIC SERVICE BOX DETAIL
BE235	COMBINATION LIGHTING TRAFFIC SIGNAL LIGHTING SCHEMATIC
BE310	LIGHT POLE FOUNDATION OFFSET, 40FT (12.192 m) TO 47 1/2 FT (14.478 m) M.H., 15" (381 mm) BOLT CIRCLE
TC10	TRAFFIC CONTROL AND PROTECTION AT TURN BAYS (TO REMAIN OPEN TO TRAFFIC)
TC11	TYPICAL APPLICATIONS RAISED REFLECTIVE PAVEMENT MARKERS (SNOW PLOW RESISTANT)
TC13	DISTRICT ONE TYPICAL PAVEMENT MARKINGS
TC14	TRAFFIC CONTROL AND PROTECTION AT TURN BAYS (TO REMAIN OPEN TO TRAFFIC)
TC16	PAVEMENT MARKING LETTERS AND SYMBOLS FOR TRAFFIC STAGING
TC21	DETOUR SIGNING FOR CLOSING STATE HIGHWAYS
TC22	ARTERIAL ROAD INFORMATION SIGN
TC23	TYPICAL SUPPLEMENTAL SIGNING AND PAVEMENT MARKING TREATMENT FOR RAILROAD CROSSINGS
TC26	DRIVEWAY ENTRANCE SIGNING
TS02	MAST ARM MOUNTED STREET NAME SIGNS
TS04	POST MOUNTED FLASHING BEACON
TS05	STANDARD TRAFFIC SIGNAL DESIGN DETAILS
T506	RAILROAD CANTILEVER SIGNAL HEAD MOUNTING DETAIL

STATE STANDARDS

STANDARD NO.	LIST OF DESCRIPTION
000001-06	STANDARD SYMBOLS, ABBREVIATIONS AND PATTERNS
280001-07	TEMPORARY EROSION CONTROL SYSTEMS
420001-08	PAVEMENT JOINTS
420106-05	36' JOINTED PCC PAVEMENT
420501-05	PCC PAVEMENT AND PCC BASE COURSE ADJACENT TO RAILROAD GRADE CROSSING
424001-08	PERPENDICULAR CURB RAMPS FOR SIDEWALKS
424006-02	DIAGONAL CURB RAMPS FOR SIDEWALKS
542301-03	PRECAST REINFORCED CONCRETE FLARED END SECTION
542311-05	TRAVERSABLE PIPE GRATE
602001-02 602011-02	CATCH BASIN, TYPE A CATCH BASIN, TYPE C
602016-02	CATCH BASIN, TYPE D
602301-04	INLET, TYPE A
602401-03	MANHOLE, TYPE A
602406-06	MANHOLE, TYPE A 6' DIAMETER
602411-04	MANHOLE, TYPE A 7' DIAMETER
602601-03	PRECAST REINFORCED CONCRETE FLAT SLAB TOP
602701-02	MANHOLE STEPS
604001-04	FRAME AND LIDS, TYPE 1
604036-03	GRATE TYPE 8
604086-03	FRAME AND GRATE TYPE 23
604091-03	FRAME AND GRATE TYPE 24
606001-06	CONCRETE CURB TYPE B AND COMBINATION CONCRETE CURB AND GUTTER
606301-04	PC CONCRETE ISLANDS AND MEDIANS
701006-05	OFF-RD OPERATIONS, 2L, 2W, 15' (4.5M) TO 24" (600 MM) FROM PAVEMENT EDGE
701101-04	OFF-ROAD OPERATIONS, MULTILANE, 15' (4.5 M) TO 24" (600 MM) FROM PAVEMENT EDGE
701301-04 701311-03	LANE CLOSURE, 2L, 2W, SHORT TIME OPERATIONS LANE CLOSURE 2L, 2W MOVING OPERATIONS- DAY ONLY
701311-03	LANE CLOSURE, MULTILANE, INTERMITTENT OR MOVING OPER., FOR SPEEDS & 40 MPH
701606-10	URBAN LANE CLOSURE, MULTILANE, 2W WITH MOUNTABLE MEDIAN
701701-09	URBAN LANE CLOSURE, MULTILANE INTERSECTION
701801-05	SIDEWALK, CORNER OR CROSSWALK CLOSURE
701901-04	TRAFFIC CONTROL DEVICES
704001-07	TEMPORARY CONCRETE BARRIER
720001-01	SIGN PANEL MOUNTING DETAILS
720006-04	SIGN PANEL ERECTION DETAILS
720011-01	METAL POSTS FOR SIGNS, MARKERS, AND DELINEATORS
728001-01	TELESCOPING STEEL SIGN SUPPORT
729001-01	APPLICATION OF TYPE A AND B METAL POSTS (FOR SIGNS AND MARKERS)
731001-01	BASE FOR TELESCOPING STEEL SIGN SUPPORT
814001-03	HANDHOLES
814006-02	DOUBLE HANDHOLES
836001-02 857001-01	LIGHT POLE FOUNDATION STANDARD PHASE DESIGNATION DIAGRAMS AND PHASE SEQUENCES
857006-01	SUPERVISED RAILROAD INTERCONNECT CIRCUIT
862001-01	UNINTERRUPTABLE POWER SUPPLY (UPS)
873001-02	TRAFFIC SIGNAL GROUNDING & BONDING
877001-05	STEEL MAST ARM ASSEMBLY AND POLE 16' THROUGH 55'
877011-05	STEEL COMBINATION MAST ARM ASSEMBLY AND POLE 16' THROUGH 55'
877012-02	STEEL COMBINATION MAST ARM ASSEMBLY AND POLE 56' THROUGH 75'
878001-10	CONCRETE FOUNDATION DETAILS
880001-01	SPAN WIRE MOUNTED SIGNALS AND FLASHING BEACON INSTALLATION
880006-01	TRAFFIC SIGNAL MOUNTING DETAILS
886001-01	DETECTOR LOOP INSTALLATIONS

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FILE NAME = 023_gen01.dgn	DRAWN - JCH	REVISED -
PLOT SCALE = N.T.S.	CHECKED - DTH	REVISED -
PLOT DATE = 2/19/2015	DATE - 2/2/2015	REVISED -

STATE	0	ILLINOIS
DEPARTMENT	0F	TRANSPORTATION

		INDEX OF CUEFTO AND O		IDARRO	F.A.U. RTE.	SECTION NO.	COUNTY	TOTAL	SHEE NO.
		INDEX OF SHEETS AND ST	IAIE SIAN	IDAKUS	1321	11-00048-00-SP	DUPAGE	277	2
2011		The state of the s					CONTRACT	NO.	63872
SCALE:	N.T.S.	SHEET NO. 1 OF 1 SHEETS	STA.	TO STA.	FED. ROAD	DIST. NO. ILLINOIS FED.	AID PROJECT		

GENERAL NOTES

- ALL REFERENCES TO 'STANDARD SPECIFICATIONS' IN THESE GENERAL NOTES SHALL BE INTERPRETED TO MEAN "STANDARD SPECIFICATIONS FOR ROAD AND BRIDGE CONSTRUCTION" ADOPTED BY THE ILLINOIS DEPARTMENT OF TRANSPORTATION, JANUARY 1, 2012. ALL WORK TO BE COMPLETED IN ACCORDANCE WITH THE STANDARD SPECIFICATIONS.
- ALL REFERENCES TO 'ENGINEER" SHALL BE INTERPRETED TO MEAN THE RESIDENT ENGINEER.
- PRIOR TO COMMENCEMENT OF CONSTRUCTION, THE CONTRACTOR SHALL VERIFY ALL DIMENSIONS AND CONDITIONS AFFECTING THEIR WORK WITH THE ACTUAL CONDITIONS AT THE JOB SITE. IF THERE ARE ANY DISCREPANCIES FROM WHAT IS SHOWN ON THE CONSTRUCTION PLANS, HE MUST IMMEDIATELY REPORT THEM TO THE ENGINEER BEFORE DOING ANY WORK, OTHERWISE THE CONTRACTOR ASSUMES FULL RESPONSIBILITY. IN THE EVENT OF DISAGREEMENT BETWEEN THE CONSTRUCTION PLANS, STANDARD SPECIFICATIONS AND/OR SPECIAL DETAILS, THE CONTRACTOR SHALL SECURE WRITTEN INSTRUCTIONS FROM THE ENGINEER PRIOR TO PROCEEDING WITH ANY PART OF THE WORK AFFECTED BY OMISSIONS OR DISCREPANCIES. FAILING TO SECURE SUCH INSTRUCTIONS, THE CONTRACTOR WILL BE CONSIDERED TO HAVE PROCEEDED AT HIS OWN RISK AND EXPENSE. IN THE EVENT OF ANY DOUBT OR OUESTION ARISING WITH RESPECT TO THE TRUE MEANING OF THE CONSTRUCTION PLANS OR SPECIFICATIONS, THE DECISION OF THE FINGINFER SHALL BE FINAL AND CONCLUSIVE. OF THE ENGINEER SHALL BE FINAL AND CONCLUSIVE.
- IT IS THE CONTRACTOR'S RESPONSIBILITY TO ASCERTAIN EXISTING FIELD CONDITIONS PRIOR TO BIDDING ON THE PROJECT.
- BEFORE STARTING ANY EXCAVATION, THE CONTRACTOR SHALL CALL "JULIE" (JOINT UTILITY LOCATION INFORMATION FOR EXCAVATION) AT 8-1-1 IDOT AT (847) 705-4436 AND THE CITY OF WOODDALE AT (630) 787-3765 FOR FIELD LOCATIONS OF BURIED UTILITIES (48 HOURS NOTIFICATION IS REQUIRED).
- ALL ELEVATIONS SHOWN ON THE PLANS ARE ON THE NAVD88 DATUM.
- THE CONTRACTOR SHALL PROTECT AND CAREFULLY PRESERVE ALL SECTION OR SUBSECTION MONUMENTS. PROPERTY CORNERS, AND REFERENCE MARKERS UNTIL THE OWNER, HIS AGENT, OR AN AUTHORIZED SURVEYOR HAS WITNESSED OR OTHERWISE REFERENCED THEIR LOCATIONS.
- ALL RADII FOR PROPOSED CURB AND GUTTER ARE TO THE EDGE OF PAVEMENT, UNLESS OTHERWISE NOTED. CURB AND GUTTER ELEVATIONS SHOWN ALONG RETURNS AND AT POINTS OF CURVATURE, ETC. ARE TO THE EDGE OF PAVEMENT UNLESS OTHERWISE NOTED.
- THE BITUMINOUS MATERIAL PRIME COAT QUANTITIES HAVE BEEN DETERMINED USING A RATE OF 0.25 LBS/SQ FT IF PLACED ON AGGREGATE, 0.025 LBS/SQ FT BETWEEN LIFTS, AND 0.05 LBS/SQ FT ON MILLED
- SAW CUTTING WILL BE REQUIRED FOR ALL REMOVAL ITEMS LISTED IN SECTION 440 OF THE STANDARD SPECIFICATIONS, SHOWN IN THE PLANS, AND AS DIRECTED BY THE ENGINEER. THE COST OF SAW CUTTING WILL BE INCLUDED IN CONTRACT UNIT BID PRICES FOR THE ITEMS BEING REMOVED.
- 11. DRIVEWAYS ARE TO BE CONSTRUCTED TO THE R.O.W. UNLESS OTHERWISE NOTED.
- 12. ABANDONED UNDERGROUND UTILITIES THAT CONFLICT WITH CONSTRUCTION SHALL BE DISPOSED OF OUTSIDE THE LIMITS OF THE RIGHT OF WAY ACCORDING TO ARTICLE 202.03 OF THE STANDARD SPECIFICATIONS AND AS DIRECTED BY THE ENGINEER. THIS WORK WILL NOT BE PAID FOR SEPARATELY. BUT SHALL BE INCLUDED IN THE COST OF EARTH EXCAVATION.
- 13. REMOVAL OF EXISTING COMBINATION CURB AND GUTTER, REGARDLESS OF CURB AND GUTTER TYPE, SHALL BE PAID FOR AS "COMBINATION CURB AND GUTTER REMOVAL".
- 14. THE ELEVATIONS SHOWN ON THE PLANS ARE FINISHED GRADES OF PROPOSED PAVEMENT, UNLESS OTHERWISE NOTED.
- 15. ALL SIGNS TO BE REMOVED ALONG IL ROUTE 19 SHALL REMAIN THE PROPERTY OF IDOT AND SHALL BE RETURNED TO IDOT UPON REMOVAL AT 895 S. STATE STREET, ELGIN, IL. THE PHONE NUMBER IS 847-741-5302. ALL DUPAGE COUNTY D.O.T. SIGNS SHALL REMAIN THE PROPERTY OF DUPAGE COUNTY D.O.T. AND SHALL BE RETURNED TO DUPAGE COUNTY D.O.T. SIGN SHOP UPON REMOVAL AT 140 N. COUNTY FARM ROAD, WHEATON, IL. THE PHONE NUMBER FOR DELIVERY ARRANGEMENT IS 630-407-6928 SIGNS TEMPORARILY RELOCATED OR COVERED SHALL NOT BECOME THE PROPERTY OF IDOT OR DUPAGE COUNTY D.O.T. UNTIL PERMANENTLY REMOVED.
- TYPE "B" CURB RAMPS SHALL BE INSTALLED AT ALL INTERSECTING STREETS AND DRIVEWAYS PER CURRENT IDOT STANDARDS AT LOCATIONS WHERE SIDEWALK IS SHOWN ON THE PLAN.
- THE THICKNESSES OF HOT MIX ASPHALT MIXTURES SHOWN IN THE PLANS ARE NOMINAL. DEVIATIONS MAY OCCUR DUE TO IRREGULARITIES IN THE SURFACES OR BASES ON WHICH THE HOT MIX ASPHALT MIXTURES ARE TO BE PLACED.
- 18. THE CONTRACTOR WILL NOT BE ALLOWED TO SET UP A YARD OR FIELD OFFICE ON CITY PROPERTY WITHOUT WRITTEN CONSENT FROM THE CITY OF WOOD DALE.
- 19. THE CONTRACTOR IS ADVISED THAT METRA WILL BE PERFORMING WORK AT THE TWO CROSSINGS LOCATED WITHIN THE PROJECT LIMITS. THE CONTRACTOR WILL BE REQUIRED TO COORDINATE THEIR WORK AND COOPERATE TO THE FULLEST EXTENT WITH METRA.
- 20. STATE HIGHWAY STANDARD 420501-04, "PCC PAVEMENT AND PCC BASE COURSE ADJACENT TO RAILROAD GRADE CROSSING", SHALL BE MODIFIED TO SHOW A MINIMUM 6 FOOT WIDTH FOR THE HMA PLUG PLACED BETWEEN THE NEW PCC PAVEMENT AND THE RAILROAD CROSSING SURFACE.
- 21. IT IS THE CONTRACTOR'S SOLE RESPONSIBILITY TO COORDINATE WITH THE METRA RAILROAD WHENEVER CONSTRUCTION ACTIVITY IS WITHIN 25 FEET OF THE RAILROAD ROW. THE CONTRACTOR SHALL RETAIN FLAGMEN EMPLOYED AND DESIGNATED BY THE METRA RAILROAD TO MONITOR ON-COMING TRAIN TRAFFIC. AND ADVISE CONTRACTOR PERSONNEL WHEN ACTIVITY ON OR NEAR THE RAILROAD RIGHT-OF-WAY MAY PROCEED. THIS ITEM WILL BE PAID FOR ACCORDING TO ARTICLE 107.12 AND WILL BE REIMBURSED ACCORDING TO ARTICLE 109.05.
- 22. INGRESS AND EGRESS TO AND FROM THE SHELL STATION SHALL BE MAINTAINED AT ALL TIMES TO AND FROM IRVING PARK ROAD AND WOOD DALE ROAD.

STORM SEWERS. WATER MAINS, AND UTILITIES

- THE CONTRACTOR SHALL BE RESPONSIBLE FOR CONTACTING THE OWNERS OF ALL UTILITIES PRIOR TO CONSTRUCTION TO DETERMINE THE LOCATION OF ALL UTILITY EQUIPMENT. THE CONTRACTOR SHALL COOPERATE WITH ALL UTILITY OWNERS IN ACCORDANCE WITH THE STANDARD SPECIFICATIONS IF UTILITY RELOCATION, ADJUSTMENT, OR PROTECTION IS NECESSARY.
- THE LOCATION OF EXISTING DRAINAGE STRUCTURES, STORM SEWERS, WATER MAINS, SANITARY SEWERS, AND ANY OTHER PUBLIC OR PRIVATE UTILITIES AS SHOWN ON THE PLANS IS APPROXIMATE AND THEIR EXACT LOCATION IS TO BE DETERMINED IN THE FIELD BY THE CONTRACTOR. THIS WORK SHALL BE CONSIDERED AS INCLUDED IN THE UNIT BID PRICES OF THE CONTRACT, AND NO ADDITIONAL COMPENSATION WILL BE ALLOWED.

- THE CONTRACTOR SHALL BE RESPONSIBLE FOR THE PROTECTION OF ALL UNDERGROUND AND SURFACE UTILITIES EVEN THOUGH THEY MIGHT NOT BE SHOWN ON THE PLANS. ANY UTILITY PROPERTY DAMAGED DURING CONSTRUCTION SHALL BE REPAIRED OR REPLACED TO THE SATISFACTION OF THE OWNER AT THE CONTRACTOR'S EXPENSE.
- 4. ALL UTILITY COMPANIES SHALL BE NOTIFIED AT LEAST 3 DAYS PRIOR TO THE START OF CONSTRUCTION.
- THE CONTRACTOR SHALL COOPERATE WITH THE CITY OF WOOD DALE IF ANY UTILITY IMPROVEMENTS ARE REQUIRED BY THE CITY WITHIN THE DURATION OF THE CONTRACT.
- THE COST OF MAKING ANY SEWER CONNECTIONS TO AN EXISTING DRAINAGE STRUCTURE OR PIPE SHALL BE INCLUDED IN THE COST OF THE NEW SEWER OR STRUCTURE.
- 7. OFFSET LOCATIONS GIVEN IN THE PLANS FOR STRUCTURES, EDGE OF PAVEMENT, ETC. ARE FROM THE ROADWAY CENTERLINE.
- 8. UNLESS OTHERWISE NOTED, OFFSETS FOR DRAINAGE STRUCTURES LOCATED IN CURB AND GUTTER ARE TO THE EDGE OF PAVEMENT AND OFFSETS FOR DRAINAGE STRUCTURES NOT LOCATED IN THE CURB AND GUTTER ARE TO THE CENTER OF THE STRUCTURE.
- CONTRACTOR SHALL NOTE THAT DUPAGE COUNTY DIVISION OF TRANSPORTATION (COUNTY) GOVERNS WOOD DALE ROAD AND REQUIRES THE USE OF A COMBINATION FRAME AND GRATE INTAKE AT ROADWAY SAG LOCATIONS. CONTRACTOR SHALL REFER TO THE COUNTY DETAILS INCLUDED IN THE PLANS FOR DETERMINING THE OFFSET OF PROPOSED DRAINAGE STRUCTURES LOCATED AT SAGS INCLUDING MODIFICATION OF THE CURB AND GUTTER TRANSITIONS ON EACH SIDE OF THE STRUCTURE.
- 10. FRAME ELEVATIONS GIVEN ON THE PLANS ARE ONLY TO ASSIST THE CONTRACTOR IN DETERMINING THE APPROXIMATE OVERALL HEIGHT OF THE STRUCTURE. FRAMES ON ALL NEW, ADJUSTED OR RECONSTRUCTED STRUCTURES WILL BE ADJUSTED TO THE FINAL ELEVATION OF THE AREA IN WHICH THEY ARE LOCATED AS PART OF THE STRUCTURE, ADJUSTMENT OR RECONSTRUCTION COST.
- WHERE NEW WORK MEETS EXISTING FEATURES TO REMAIN, FIELD CHECK ALL DIMENSIONS AND ELEVATIONS BEFORE PROCEEDING WITH CONSTRUCTION, NOTIFY ENGINEER IMMEDIATELY OF ANY DISCREPANCIES.
- 12. ALL FRAMES, GRATES, LIDS, AND BOXES SCHEDULED TO BE REMOVED FROM EXISTING STRUCTURES SHALL REMAIN THE PROPERTY AND BE DELIVERED TO IDOT, AS APPLICABLE.
- ANY LOOSE MATERIAL DEPOSITED IN THE FLOW LINE OF DRAINAGE STRUCTURES, WHICH OBSTRUCTS THE NATURAL FLOW OF WATER, SHALL BE REMOVED AT THE CLOSE OF EACH WORKING DAY. PRIOR TO ACCEPTANCE OF THE IMPROVEMENT, ALL DRAINAGE STRUCTURES SHALL BE FREE OF DIRT AND DEBRIS. THIS WORK WILL NOT BE PAID FOR SEPARATELY, BUT SHALL BE CONSIDERED AS INCLUDED IN THE UNIT BID PRICES OF THE CONTRACT.
- 14. CONTRACTOR SHALL MAINTAIN THE CONVEYANCE OF ALL FLOWS DURING CONSTRUCTION OF THIS PROJECT. WHEN EXISTING DRAINAGE FACILITIES ARE DISTURBED, THE CONTRACTOR SHALL PROVIDE AND MAINTAIN TEMPORARY OUTLETS AND CONNECTIONS FOR ALL PRIVATE AND PUBLIC DRAINS, SEWERS, CULVERTS, AND OTHER DRAINAGE FACILITIES. THE CONTRACTOR SHALL PROVIDE FACILITIES TO TAKE IN ALL STORM WATER WHICH WILL BE RECEIVED BY THESE DRAINS AND SEWERS AND DISCHARGE THE SAME. THE CONTRACTOR SHALL PROVIDE AND MAINTAIN A PUMPING PLANT, IF NECESSARY, AND A TEMPORARY OUTLET AND BE PREPARED AT ALL TIMES TO DISPOSE OF THE WATER RECEIVED FROM THESE TEMPORARY CONNECTIONS UNTIL SUCH TIME THAT THE PERMANENT CONNECTIONS WITH SEWERS OR CULVERTS ARE BUILT AND IN SERVICE THIS WOOD WILL BE INCLUDED IN THE DRAINAGE FACILITIES BEING UILT AND IN SERVICE. THIS WORK WILL BE INCLUDED IN THE COST OF THE DRAINAGE FACILITIES BEING INSTALLED.
- 15. ALL FRAMES WITH CLOSED LIDS TO BE FURNISHED AS PART OF THE CONTRACT FOR CONSTRUCTION ALL FRAMES WITH CLOSED LIBS TO BE FORNISHED AS PART OF THE CONTRACT FOR CONSTRUCTION, ADJUSTMENT OR RECONSTRUCTION OF ANY MANHOLE, CATCH BASIN, INLET, VALVE VAULT OR METER VAULT SHALL HAVE CAST INTO THE LID ONE OF THE FOLLOWING WORDS: : ALL LIDS TO BE USED ON WATER STRUCTURES SHALL BEAR THE WORD "STORM." ALL LIDS TO BE USED ON STORM SEWER STRUCTURES SHALL BEAR THE WORD "STORM." ALL LIDS TO BE USED ON SANITARY SYSTEM STRUCTURES SHALL BEAR THE WORD "SANITARY." ANY ADDITIONAL COST FOR THIS REQUIREMENT WILL NOT BE PAID FOR SEPARATELY, BUT SHALL BE CONSIDERED AS INCLUDED IN THE UNIT BID PRICES OF THE FRAMES AND CLOSED LIDS PROVIDED.
- 16. ONLY PRECAST CONCRETE ADJUSTMENT RINGS, MAXIMUM OF 12" IN HEIGHT, WILL BE ALLOWED IN THE ADJUSTMENT OR RECONSTRUCTION OF CATCH BASIN, MANHOLE, INLET AND VALVE VAULT STRUCTURES. COMMON BRICK WILL NOT BE ALLOWED. THE RINGS SHALL BE INCLUDED IN THE COST OF WORK BEING
- 17. ALL DRAINAGE STRUCTURES LOCATED IN THE ROADWAY VERTICAL CURVE SAGS (LOW-POINTS) SHALL BE 4" SUB-SURFACE PAVEMENT DRAIN OPENINGS BLOCKED OUT (PRECAST) AS SHOWN IN THE PLAN DETAILS FOR UNDER DRAIN CONNECTIONS. CONTRACTOR SHALL NOTE THAT STRUCTURE.

BACKFILL

- 1. STORM SEWER SHALL BE BACKFILLED IN ACCORDANCE WITH ARTICLE 550.07, METHOD 1 ONLY.
- PROVIDE TRENCH BACKFILL FOR ALL UTILITY LINES WITHIN 2' OF PAVED AREAS. ALL TRENCH BACKFILL QUANTITIES FOR STORM SEWER HAVE ÆEN COMPUTED AND SHALL BE PAID FOR IN ACCORDANCE WITH THE STATE OF ILLINOIS DEPARTMENT OF TRANSPORTATION DIVISION OF HIGHWAYS BUREAU OF CONSTRUCTION TRENCH BACKFILL TABLE, BASED ON PIPE SIZE AND INVERT DEPTH FROM SUBGRADE.

SIGNING AND STRIPING

- TWO WEEKS PRIOR TO PLACEMENT OF PERMANENT PAVEMENT MARKINGS THE ENGINEER SHALL CONTACT DON CHIARUGI, AREA TRAFFIC FIELD ENGINEER, AT (847) 741-9857.
- SEE IDOT STANDARD DETAIL 780001, DISTRICT ONE DETAILS AND PLAN SHEETS FOR PAVEMENT MARKING DETAILS.
- 3. SIGNS SHALL NOT BE MOVED OR COVERED UNTIL PROGRESS OF WORK NECESSITATES IT.
- THE CONTRACTOR WILL BE REQUIRED TO TEMPORARILY RESET ALL SUCH SIGNS THAT INTERFERE WITH HIS CONSTRUCTION OPERATIONS. ALL SUCH SIGNS MUST BE MAINTAINED STRAIGHT AND CLEAN FOR THE DURATION OF THE TEMPORARY SETTING AND MUST BE RE-ERECTED AT A TEMPORARY LOCATION IN A WORKMANLIKE MANNER AND BE VISIBLE TO THE TRAFFIC FOR WHICH IT IS INTENDED. THIS WORK WILL NOT BE PAID FOR SEPARATELY, BUT SHALL BE INCLUDED IN THE COST OF THE SIGNS BEING INSTALLED.
- LONGER POSTS MAY BE REQUIRED AT SOME TEMPORARY OR PERMANENT SIGN LOCATIONS TO MAINTAIN PROPER SIGN ELEVATIONS. THIS WORK SHALL BE COMPLETED IN ACCORDANCE WITH SECTION 729 OF THE STANDARD SPECIFICATIONS.
- ALL SIGNS SHALL BE INSTALLED IN PERMANENT LOCATIONS AS THE ROADWAY IS COMPLETED. THIS WORK SHALL BE PAID FOR USING THE APPROPRIATE PAY ITEMS.

EARTHWORK

- 1. SUBGRADE SHALL BE PREPARED IN ACCORDANCE WITH ARTICLE 301.03 OF THE STANDARD SPECIFICATIONS BEFORE REMOVAL OF ANY UNSTABLE MATERIAL.
- PRIOR TO ANY EMBANKMENT PLACEMENT, ALL VEGETATION AND UNSTABLE MATERIAL SHOULD BE REMOVED TO DEPTH ENCOUNTERED AND REPLACED WITH SUITABLE EMBANKMENT MATERIAL AS APPROVED BY THE
- COST OF ANY TRENCH BACKFILL REQUIRED IN EXCESS OF THE QUANTITY ESTABLISHED, INCLUDING BEDDING MATERIAL, SHALL BE CONSIDERED INCLUDED IN THE UNIT PRICE BID.
- THE CONTRACTOR SHALL BE RESPONSIBLE FOR HIRING AN ENVIRONMENTAL FIRM WITH AT LEAST FIVE (5) DOCUMENTED LEAKING UNDERGROUND STORAGE TANKS (LUST) CLEANUPS OR THAT IS PRE-QUALIFIED IN HAZARDOUS WASTE BY THE DEPARTMENT TO REMEDIATE THE SOIL CONTAMINATION AND MONITOR FOR WORDER PROTECTION

COMMITMENTS

THE ILLINOIS COMMERCE COMMISSION (ICC) REQUIRES SPECIFIC PHASING AND SIGNAL TIMING FOR THE IRVING PARK ROAD AT WOOD DALE ROAD INTERSECTION. THE TRAFFIC SIGNAL TIMING AND SIGNAL INTERCONNECT SHOULD BE COORDINATED WITH THE ICC DURING CONSTRUCTION.

HRGreen

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DESIGNED - JRM REVISED JSER NAME = Jhorwit REVISED DRAWN JICH DTH REVISED CHECKED PLOT SCALE = N.T.S. REVISED DATE 2/2/2015 PLOT DATE = 2/19/2015

STATE OF ILLINOIS DEPARTMENT OF TRANSPORTATION

SECTION NO. SHEETS NO. COUNTY **GENERAL NOTES** DUPAGE 1321 11-00048-00-SP 277 CONTRACT NO. 63872 TO STA. SCALE: N.T.S. SHEET NO. 1 OF 1 SHEETS STA. FED. ROAD DIST. NO. | ILLINOIS FED. AID PROJECT

										CC	ONSTRUCTION CO	DE		
	PAY ITEM	Table of the state				100		80% FEDERAL 20% STATE	RETAINING WALL 80% FEDERAL 20% STATE	SIGNALS	INTERCONNECT 80% FEDERAL 20% STATE	LIGHTING 80% FEDERAL 20% STATE	LANDSCAPING 80% FEDERAL 20% STATE	ROADWAY 80% FEDERAL 20% LOCAL
	NUMBER 20100110	TREE REMOVAL	L (6 TO 15 UNITS DIAMETER)			UNIT	TOTAL 175	0004 175	0040	0021	0021	0021	0031	0004
	20100210	TREE REMOVAL	L (OVER 15 UNITS DIAMETER)			UNIT	96	96						
	20200100	EARTH EXCAVA	ATION			CU YD	20,420	20,420						
	20201200	REMOVAL AND	DISPOSAL OF UNSUITABLE MATER	RIAL		CU YD	1,485	1,485						
	20800150	TRENCH BACKF	FILL			CU YD		5,282						
	* 21101615	TOPSOIL FURN	NISH AND PLACE, 4"			SQ YD							5,980	
,	* 21101625	TOPSOIL FURN	NISH AND PLACE, 6"			SQ YD	4,310				- 4.0.9VV		4,310	
	* 21101685	TOPSOIL FURN	NISH AND PLACE, 24"			SQ YD	310						310	
	* 21101815	COMPOST FURN	NISH AND PLACE, 4"			SO YD	310						310	
,	* 25000110	SEEDING, CLAS	SS 1A	10 20 20 20 20 20 20 20 20 20 20 20 20 20		ACRE	0.75						0.75	
,	* 25000400		RTILIZER NUTRIENT			POUND	49						49	
	* 25000500		FERTILIZER NUTRIENT			POUND	49						49	
	* 25000600		ERTILIZER NUTRIENT			POUND	49						49	
	* 25100630	EROSION CONT				SQ YD								
	* 25200110	SODDING, SALT				SQ YD							2,590	
	* 25200200	SUPPLEMENTAL				UNIT	386						7,705	
			ROSION CONTROL SEEDING			POUND	643	643					386	
	* 28000305					FOOT	105	105						
	* 28000400		ROSION BARRIER			FOOT								
	* 28000510	INLET FILTERS					4,090	4,090						
	* 28001100		ROSION CONTROL BLANKET			EACH	101	101						
	30300001		UBGRADE IMPROVEMENT			SO YD		10,365						
	3030001		JBGRADE IMPROVEMENT 12"			CU YD		1,800						
	31101400		NULAR MATERIAL, TYPE B 6"			SO YD		37,510						
	35501308		ALT BASE COURSE, 6"			SO YD	7,891	7,891						
	35501316		HALT BASE COURSE, 8"			SO YD	420	420						
	40600275		MATERIALS (PRIME COAT)			SQ YD	1,360	1,360						
				NEO.		POUND	53,765	53,765						
	40603335		MALT SURFACE COURSE, MIX "D", I			TON	200	200						
	40701901		MALT PAVEMENT (FULL DEPTH), 9"			SO YD	3,145	3,145						
	42000411		MENT CONCRETE PAVEMENT 9 1/2'			SO YD	15,480	15,480						
	42001020		TRENGTH PORTLAND CEMENT CON			SO YD	14,275	14,275						
				CRETE PAVEMENT 9 172		SQ YD	1,335	1,335						
	42001300 42300400	PROTECTIVE CO	MENT CONCRETE DRIVEWAY PAVEM	ENT 9 INCH		SO YD	23,850	23,850						
						SQ YD	535	535						
	42400200		MENT CONCRETE SIDEWALK 5 INCH	1		SQ FT	50,185	50,185						0.442-1
	42400800	DETECTABLE W				SQ FT	637	637						
	44000100	PAVEMENT REM				SQ YD	31,180	31,180					. 7200=1100	
	44000200		EMENT REMOVAL			SQ YD	2,530	2,530						
* SPECIALTY ITEM	44000500		CURB AND GUTTER REMOVAL			FOOT	10,935	10,935						
X CONSTRUCTION TYPE CODE 0042	44000600	SIDEWALK REMO				SQ FT	41,845	41,845						
^ △ 100% LOCAL	JSER NAME = Jhorwit		AL DESIGNED - JRM	REVISED -		SQ FT	5,160	5,160				Te	AU	
	TI E NAME - 022		DRAWN - ICH	PEVICED	CTATE OF HIMOIC							R	A.U. SECTIO	N NO. CO

△ 100% LOCAL

DRAWN - JCH
CHECKED - DTH
DATE - 2/2/2015 REVISED -FILE NAME = 023_sum01.dgn PLOT SCALE = N.T.S. PLOT DATE = 2/19/2015

		CURANA DV. OF O			F.A.U. RTE.	SECTION NO.	COUNTY	TOTAL	SHEET NO.
		SUMMARY OF Q	JANTITIES		1321	11-00048-00-SP	DUPAGE	277	4
		T	T.				CONTRACT	NO.	63872
SCALE:	N.T.S.	SHEET NO. 1 OF 8 SHEETS	STA.	TO STA.	FED. ROAD	DIST. NO. ILLINOIS FED.	AID PROJECT		

		T								C	ONSTRUCTION CO	DE		
	PAY ITEM	175 055.001						80% FEDERAL 20% STATE	20% STATE	80% FEDERAL 20% STATE	INTERCONNECT 80% FEDERAL 20% STATE	80% FEDERAL 20% STATE	LANDSCAPING 80% FEDERAL 20% STATE	ROADWAY 80% FEDERAL 20% LOCAL
	NUMBER 50300285	FORM LINER T	TEXTURED SURFACE			SQ FT	TOTAL 747	0004	747	0021	0021	0021	0031	0004
	50800105	REINFORCEME	NT BARS			POUND	13,760		13,760					
	50800205	REINFORCEME	NT BARS, EPOXY COATED			POUND	2,270		2,270					
	50901760	PIPE HANDRAI	IL		20000 2000 0000 0000	FOOT	113		113					
	54213669	PRECAST REIN	NFORCED CONCRETE FLARED END SI	ECTIONS 24"		EACH	1	1						
	550A0050	STORM SEWER	RS, CLASS A, TYPE 1 12"			FOOT	644	644						
	550A0070	STORM SEWER	RS, CLASS A, TYPE 1 15"			FOOT	122	122						
	550A0120	STORM SEWER	RS, CLASS A, TYPE 1 24"			FOOT	22	22						
	550A0340	STORM SEWER	RS, CLASS A, TYPE 2 12"			FOOT	777	777						
	550A0360	STORM SEWER	RS, CLASS A, TYPE 2 15"			FOOT	283	283						
	550A0380	STORM SEWER	RS, CLASS A, TYPE 2 18"			FOOT	156	156						
	550A0410	STORM SEWER	RS, CLASS A, TYPE 2 24"			FOOT	264	264						
	550A0450		S, CLASS A, TYPE 2 36"			FOOT	631	631						
	55100100	STORM SEWER	REMOVAL 4"			FOOT	195	195						
	55100300	STORM SEWER	REMOVAL 8"			FOOT	225	225						
	55100400	STORM SEWER	REMOVAL 10"			FOOT		60						
	55100500	STORM SEWER				FOOT		1,770						
	55101200	STORM SEWER				FOOT	85	85						
	55101600	STORM SEWER				FOOT	160	160						
	* 56100015		WATER MAIN TEE, 8" X 6"			EACH	6	- 6						
	* 56100020	1	N WATER MAIN TEE, 8" X 8"			EACH	3	3						
	* 56100050		WATER MAIN TEE, 12" X 6"			EACH	8	8						
	* 56100055		WATER MAIN TEE, 12" X 8"			EACH	6	6						
	* 56100065		WATER MAIN TEE, 12" X 12"			EACH	4	4						
	//		WATER MAIN REDUCERS, 12" X 8"			EACH	2	2						
	* 56101162		WATER MAIN REDUCERS, 12" X 10			EACH	1	1						
	* 56104900	WATER VALVE				EACH	1	1						
	* 56105000	WATER VALVE				EACH	10	10						
	* 56105200	WATER VALVE				EACH	9	9						
	* 56109398		N WATER MAIN FITTINGS 6" 11.25 D	EGREE BEND		EACH	1	1						
	* 56109400		N WATER MAIN FITTINGS 8" 11.25 D			EACH	3	3						
	* 56109404		N WATER MAIN FITTINGS 12" 11.25			EACH	6	6						
	* 56109408		N WATER MAIN FITTINGS 8" 22.50			EACH	4	4						
	* 56109412		N WATER MAIN FITTINGS 12" 22,50			EACH	1	1						
	* 56109420		WATER MAIN FITTINGS 8" 45.00			EACH	10	10						
	* 56109424		WATER MAIN FITTINGS 12" 45.00			EACH	10	10						
	* 56109438		WATER MAIN FITTINGS 12" 90.00		No. 200 - 20	EACH	10	10						
	* 56400820		T WITH AUXILIARY VALVE AND VAL											
008. TO	59100100		E WALL DRAIN	*F 90V		SQ YD	13	13	132					
* SPECIALTY ITEM	60109510		RAINS, FABRIC LINED TRENCH 4"			FOOT	990	990	132					
X CONSTRUCTION TYPE CODE 0042 \[\times \text{100% LOCAL} \]	60200105			DAME OPEN LTD			330							
	USER NAME = jhorwit	•	S, TYPE A, 4'-DIAMETER, TYPE 1 FI DESIGNED - JRM	REVISED -		EACH	1	11	L			I.	A.U. SECTI	ON NO. CO
HRGreen.com	FILE NAME = 023_sum	nØ1.dgn	DRAWN - JCH	REVISED -	STATE OF ILLINOIS				SUMMAR	RY OF QUANTIT	TIES		1721 11 00040	0.00 CD D

△ 100% LOCAL

FILE NAME = 023.sum01.dgn
PLOT SCALE = N.T.S. DRAWN - JCH
CHECKED - DTH
DATE - 2/2/2015 REVISED -REVISED -PLOT DATE = 2/19/2015 REVISED

											F.A.U. RTE.	SEC	TION NO.	COUNTY	TOTAL SHEETS	SHEET NO.
				SI	UIV	IIVIA	HY	or au	ANTITIES		1321	11-00	048-00-SP	DUPAGE	277	5
_														CONTRACT	NO.	63872
SC	CALE:	N.T.S.	SHEET	NO.	2	OF	8	SHEETS	STA.	TO STA.	FED. RO.	AD DIST. NO.	ILLINOIS FED.	AID PROJECT	151194711	

							1			C	INSTRUCTION COL	DE			
	PAY ITEM NUMBER	ITEM DESCRIF	PTION			UNIT	TOTAL	ROADWAY 80% FEDERAL 20% STATE 0004	RETAINING WALL 80% FEDERAL 20% STATE 0040		INTERCONNECT 80% FEDERAL 20% STATE 0021	LIGHTING	LANDSCAPING 80% FEDERAL 20% STATE 0031	ROADWA' 80% FEDER 20% LOCA 0004	AL
	60201105	CATCH BASINS	S, TYPE A, 4'-DIAMETER, TYPE 11	FRAME AND GRATE		EACH	4	4					0001		
	60201340	CATCH BASINS	S, TYPE A, 4'-DIAMETER, TYPE 24	FRAME AND GRATE		EACH	13	13				1 - 10			
	60205040	CATCH BASINS	S, TYPE A, 5'-DIAMETER, TYPE 24	FRAME AND GRATE		EACH	3	3							
	60207905	CATCH BASINS	S, TYPE C, TYPE 11 FRAME AND GR	ATE		EACH	1	1							
	60208240	CATCH BASINS	S, TYPE C, TYPE 24 FRAME AND GR	RATE		EACH	13	13							
	60212814	CATCH BASINS	S, TYPE D, 4'-DIAMETER, TYPE 24	FRAME AND GRATE		EACH	14	14							
	60218400	MANHOLES, TY	YPE A, 4'-DIAMETER, TYPE 1 FRAM	E, CLOSED LID		EACH	1	1							
	60219000	MANHOLES, TY	YPE A, 4'-DIAMETER, TYPE 8 GRAT	E		EACH	2	2							
	60221100	MANHOLES, TY	YPE A, 5'-DIAMETER, TYPE 1 FRAM	E, CLOSED LID		EACH	6	6							
	60223800	MANHOLES, TY	YPE A, 6'-DIAMETER, TYPE 1 FRAM	E, CLOSED LID		EACH	11	11							
	60224039	MANHOLES, TY	YPE A, 6'-DIAMETER, TYPE 24 FRA	ME AND GRATE		EACH	2	2							
	60236200	INLETS, TYPE	E A. TYPE 8 GRATE			EACH	3	3							
	60236800	INLETS, TYPE	A, TYPE 11 FRAME AND GRATE			EACH	4	4							
	60237470	INLETS, TYPE	E A, TYPE 24 FRAME AND GRATE			EACH	17	17							_
	60248700	VALVE VAULT	S, TYPE A, 4'-DIAMETER, TYPE 1 F	FRAME, CLOSED LID		EACH	7	7							
	60248900	VALVE VAULT	S, TYPE A, 5'-DIAMETER, TYPE 1 F	RAME, CLOSED LID		EACH	10	10							
	60250400		S TO BE ADJUSTED WITH NEW TYPE			EACH	1	1							
			S TO BE RECONSTRUCTED WITH NE			EACH	3	3							
	60255500) BE ADJUSTED	THE ETHNAME AND ONATE		EACH	21	21							
	60255700		D BE ADJUSTED WITH NEW TYPE 1 F	PAME OPEN LTD											
						EACH		2							
	60256940		BE ADJUSTED WITH NEW TYPE 24	FRAME AND GRATE		EACH	1	1							
	60257900		BE RECONSTRUCTED			EACH	4	4							
	60260100					EACH	1	1							
	4-27		'S TO BE ADJUSTED			EACH	1	1							=
	60265900	VALVE VAULT	'S TO BE ADJUSTED WITH NEW TYP	E 1 FRAME AND CLOSED LID		EACH	2	2							
	60500040	REMOVING MAI	NHOLES			EACH	9	9							
	60500050	REMOVING CA	TCH BASINS			EACH	32	32							
	60500060	REMOVING INL	LETS			EACH	18	18							
	60600605	CONCRETE CUI	IRB, TYPE B			FOOT	185	185							
	60603800	COMBINATION	CONCRETE CURB AND GUTTER, TY	PE B-6.12		FOOT	4,645	4,645							
	60605000	COMBINATION	CONCRETE CURB AND GUTTER, TY	PE B-6.24		FOOT	7,125	7,125							
	60608300	COMBINATION	CONCRETE CURB AND GUTTER, TY	PE M-2.12		FOOT	590	590							
	60608582	COMBINATION	CONCRETE CURB AND GUTTER, TY	PE M-4.24		FOOT	185	185							
	60608600	COMBINATION	CONCRETE CURB AND GUTTER, TY	PE M-6.06		FOOT	50	50							
	60610400	COMBINATION	CONCRETE CURB AND GUTTER, TY	PE M-6.24		FOOT	95	95							-
	60619600	CONCRETE ME	DIAN, TYPE SB-6.12			SQ FT	1,975	1,975							
ą	* 66900200	NON-SPECIAL	WASTE DISPOSAL			CU YD	4,000	4,000							
,	* 66900450		TE PLANS AND REPORTS			L SUM	1	1							
÷	* 66900530	SOIL DISPOSA				EACH	15	15							
PE CODE 0042	67000400		IELD OFFICE, TYPE A			CAL MO		18							
	67100100	MOBILIZATION				L SUM	10	10							
CONTRACTOR AND	USER NAME = Jhorwit		DESIGNED - JRM	REVISED -		L SUM	1	1				IF.	A.U. SECTIO	N NO	COL
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SPECIALTY II

SPECIALTY II

CONSTRUCTIO

A 100% LOCAL

D 100% LOCAL

DRAWN - JCH
CHECKED - DTH
DATE - 2/2/2015 FILE NAME = 023.sum01.dgn PLOT SCALE = N.T.S. REVISED -REVISED -PLOT DATE = 2/19/2015 REVISED

STATE OF ILLINOIS DEPARTMENT OF TRANSPORTATION

			S	UN			OF QU	ANTITIES	
SCALE:	N.T.S.	SHEET	NO.	3	OF	8	SHEETS	STA.	TO STA.

											ONSTRUCTION CO			
								ROADWAY 80% FEDERAL	RETAINING WALL 80% FEDERAL		INTERCONNECT 80% FEDERAL	LIGHTING 80% FEDERAL	LANDSCAPING 80% FEDERAL	ROADWAY 80% FEDERAL
	PAY ITEM NUMBER	ITEM DESCRIF	PTION			UNIT	TOTAL	20% STATE 0004	20% STATE 0040	20% STATE 0021	20% STATE 0021	20% STATE	20% STATE	20% LOCAL
	70103815		TROL SURVEILLANCE			CAL DA		550	0040	0021	0021	0021	0031	0004
	70106800	CHANGEABLE	MESSAGE SIGN			CAL MO	18	18				7		
3	70300100	SHORT TERM	PAVEMENT MARKING			FOOT	17,320	17,320						
	* 70300510	PAVEMENT MA	ARKING TAPE, TYPE III- LETTERS	AND SYMBOLS		SQ FT	2,840	2,840						
	* 70300520	PAVEMENT MA	ARKING TAPE, TYPE III 4"			FOOT	75,515	75,515						
	* 70300540	PAVEMENT MA	ARKING TAPE, TYPE III 6"			FOOT	9,930	9,930						
	* 70300560	PAVEMENT MA	ARKING TAPE, TYPE III 12"			FOOT	2,815	2,815						
	* 70300570	PAVEMENT MA	ARKING TAPE, TYPE III 24"			FOOT	1,230	1,230						
	* 70301000	WORK ZONE P	AVEMENT MARKING REMOVAL			SQ FT	38,350	38,350						
	70400100	TEMPORARY C	CONCRETE BARRIER WALL		The second secon	FOOT	587.5	587.5						
	70400200	RELOCATE TE	MPORARY CONCRETE BARRIER WAL	L		FOOT	1,325	1,325						
	70600255	IMPACT ATTE	NUATORS, TEMPORARY (FULLY RED	DIRECTIVE, NARROW), TEST LEVEL	2	EACH	3	3						
	70600322		NUATORS, RELOCATE (FULLY REDI			EACH	7	7						
	72000100					SQ FT		781		134				
	72000200					SQ FT		25		55				
	72400100		PANEL ASSEMBLY- TYPE A			EACH	4	4		- 55				
	72400310		PANEL - TYPE 1			SQ FT		75						
	72400500		GN PANEL ASSEMBLY- TYPE A			EACH	4	4						
	72400710		GN PANEL - TYPE 1			SQ FT		75						
	72900200	METAL POST				FOOT		1,750						
	* 78000100		TIC PAVEMENT MARKING - LETTER	S AND SYMBOLS		SQ FT		1,525						
	* 78000200		TIC PAVEMENT MARKING - LINE 4"				26,910	26,910						
	* 78000400		TIC PAVEMENT MARKING - LINE 6"			FOOT								
	* 78000600		TIC PAVEMENT MARKING - LINE 12			FOOT		6,050						
	* 78000650		TIC PAVEMENT MARKING - LINE 24				720	720						
	* 78008200		VEMENT MARKING TYPE I - LETTE			FOOT	710	710						
	* 78008210		VEMENT MARKING TYPE I - LINE 4			SQ FT		595						
	* 78008230					FOOT		5,650						
			VEMENT MARKING TYPE I - LINE 6			FOOT		3,230						
	* 78008240					FOOT	110	110						
	* 78008250		VEMENT MARKING TYPE I - LINE 1			FOOT	580	580						
	* 78008270		VEMENT MARKING TYPE I - LINE 2	4"		FOOT	290	290						
1	* 78100100		ECTIVE PAVEMENT MARKER			EACH	195	195						
	* 78300100		ARKING REMOVAL			S0 FT		16,790						
	* 78300200		ECTIVE PAVEMENT MARKER REMOVA	AL .		EACH	455	455						
	* 80400100		RVICE INSTALLATION			EACH	1					1		
	* 80400200		ILITY SERVICE CONNECTION			L SUM	1					1		
	* 80500010		TALLATION - GROUND MOUNTED			EACH	1			1				
15.75	* 81028200		CONDUIT, GALVANIZED STEEL. 2'			FOOT	846			627	219			
* SPECIALTY ITEM	* 81028210) CONDUIT, GALVANIZED STEEL, 2			FOOT	1,577			678		899		
X CONSTRUCTION TYPE CODE 0042	* 81028220		CONDUIT, GALVANIZED STEEL, 3'			FOOT	105			105				
[™] Δ 100% LOCAL	* 81028230		CONDUIT, GALVANIZED STEEL, 3			FOOT	212			212				
HRGreen.com	USER NAME = jhorwit FILE NAME = 023.sum		DESIGNED - JRM DRAWN - JCH	REVISED -	STATE OF HUMOIS				0111111	V OF OUANITIE	150	F	RTE. SECTION	N NO. COL

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DATE - 2/2/2015 FILE NAME = 023.sum01.dgn PLOT SCALE = N.T.S. REVISED -REVISED PLOT DATE = 2/19/2015

	T T	CUMPANDY OF CUMPITITIES	F.A.U. RTE.	SECTION NO.	COUNTY	TOTAL	SHEET NO.
		SUMMARY OF QUANTITIES	1321	11-00048-00-SP	DUPAGE	277	7
					CONTRACT	NO.	63872
_	SCALE: N.T.S.	SHEET NO. 4 OF 8 SHEETS STA. TO STA.	FED. RO	AD DIST. NO. ILLINOIS FED.	AID PROJECT		

	PAY ITEM NUMBER	ITEM DESCRIPT						UNIT	TOTAL	ROADWAY 80% FEDERAL 20% STATE 0004	RETAINING WALL 80% FEDERAL 20% STATE 0040	SIGNALS 80% FEDERAL 20% STATE 0021	INTERCONNECT 80% FEDERAL 20% STATE 0021	LIGHTING 80% FEDERAL 20% STATE 0021	LANDSCAPING 80% FEDERAL 20% STATE 0031	ROADWAY 80% FEDERAL 20% LOCAL 0004	
3.5	* 81028240		CONDUIT, GALVANIZED ST					FOOT	1,735			888		847			
1.5	* 81028250		CONDUIT, GALVANIZED ST	EEL, 5" DIA.				FOOT	50			50					
5.4	* 81400100	HANDHOLE						EACH	6			6					
	* 81400200	HEAVY-DUTY HA	ANDHOLE					EACH	2			2					
	* 81400300	DOUBLE HANDH	OLE					EACH	4			4					
14	* 81603090	UNIT DUCT, 60	OV. 3-1C NO. 4, 1/C NO.6	GROUND, (XLP-TYPE	USE), 1 1/4" DIA, PO	OLYETHYLENE		FOOT	8,574					8,574			
3.4	* 81603176	UNIT DUCT, 60	OV, 6-1C NO. 4, 1/C NO.6	GROUND, (XLP-TYPE	USE), 1 1/2" DIA. PO	OLYETHYLENE		FOOT	2,614					2,614			
18	* 81702180	ELECTRIC CABL	E IN CONDUIT, 600V (XLP	P-TYPE USE) 1/C NO	. 3/0			FOOT	150					150			
18	* 81800300	AERIAL CABLE,	3-1/C NO. 2 WITH MESSEN	NGER WIRE				FOOT	4,740					4,740			
.4	* 82102250	LUMINAIRE, SO	DIUM VAPOR, HORIZONTAL	MOUNT, 250 WATT				EACH	30					30			
:4	* 82102400	LUMINAIRE, SO	DIUM VAPOR, HORIZONTAL	MOUNT, 400 WATT				EACH	8	1				8			
i i	* 82500370	LIGHTING CONT	ROLLER BASE MOUNTED, 2	240 VOLT, 200 AMP				EACH	1					1			
5.	* 83007400	LIGHT POLE, AL	LUMINUM, 35 FT. M.H., 10 F	FT. MAST ARM				EACH	34					34			
14	* 83057355	LIGHT POLE, W	00D, 60 F00T, CLASS 4, W	VITH 15FT MAST ARM	1			EACH	28					28			
14	* 83600200	LIGHT POLE FO	OUNDATION 24" DIAMETER			ACCOUNT OF THE REAL		FOOT	395					395			
9	* 84100110	REMOVAL OF TE	EMPORARY LIGHTING UNIT					EACH	28					28			
2.8	* 84200500	REMOVAL OF LI	IGHTING UNIT, SALVAGE					EACH	26			***************************************		26			
14	* 84200804		OLE FOUNDATION					EACH	53	1				53			
	* 84500110		IGHTING CONTROLLER					EACH	1	- U-Million Zillian				1			
	* 84500130		IGHTING CONTROLLER FOU	NDATION				EACH	1					1			
	* 85000200		OF EXISTING TRAFFIC SIG					EACH	5			5					
	* 85100500		AFFIC SIGNAL POST	THE INSTRUCTION				EACH	4			4					
	* 85100701		ST ARM AND POLE, 40 FOO	IT AND OVER				EACH	1			1					
5.5					007				1			1					
	* 85100800		MBINATION MAST ARM AND					EACH									
	* 85100901		MBINATION MAST ARM AND	POLE, 40 FOOT AND	OVER			EACH	3			3					
Ų.	* 86400100	TRANSCEIVER -						EACH	6			6					
54	* 87300925		LE IN CONDUIT, TRACER, N					FOOT					3,670				
**	* 87301215	ELECTRIC CABL	LE IN CONDUIT, SIGNAL NO). 14 2C				FOOT	2,176	1		2,176					
	* 87301225	ELECTRIC CABL	LE IN CONDUIT, SIGNAL NO	D. 14 3C				FOOT	5,322			5,322					
v.	* 87301245	ELECTRIC CABL	LE IN CONDUIT, SIGNAL NO	D. 14 5C				FOOT	6,012			6,012					
	* 87301255	ELECTRIC CABL	LE IN CONDUIT, SIGNAL NO	D. 14 7C				FOOT	1,843.0			1,843.0					
4	* 87301305	ELECTRIC CABL	LE IN CONDUIT, LEAD-IN, N	NO. 14 1 PAIR				FOOT	5,064			5,064					
	* 87301750	ELECTRIC CABL	LE IN CONDUIT, RAILROAD,	, NO. 14 3C				FOOT	80			80.0					
	* 87301805	ELECTRIC CABL	LE IN CONDUIT, SERVICE,	NO. 6 2 C				FOOT	74			74					
	* 87301900	ELECTRIC CABL	LE IN CONDUIT, EQUIPMEN	T GROUNDING CONDI	JCTOR, NO. 6 1C			FOOT	2,325			2,325					
	* 87502430	TRAFFIC SIGNA	AL POST, GALVANIZED STE	EL 9 FT.				EACH	1			1					
	* 87502440	TRAFFIC SIGNA	AL POST, GALVANIZED STE	EL 10 FT.				EACH	3	1		3					
	* 87502460	TRAFFIC SIGNA	AL POST, GALVANIZED STE	EL 12 FT.				EACH	1			1					
PECIALTY ITEM	* 87502520	TRAFFIC SIGNA	AL POST, GALVANIZED STE	EL 18 FT.				EACH	1			1					
ONSTRUCTION TYPE CODE 0042	* 87700150	STEEL MAST AF	RM ASSEMBLY AND POLE. 2	22 FT.				EACH	1			1					
	* 87702930	STEEL COMBINA	ATION MAST ARM ASSEMBL	Y AND POLE 40 FT.				EACH	1			1					
HRGreen.com Illinois Professional Design Firm # 184-001322	USER NAME = tyelton FILE NAME = 023.sum PLOT SCALE = N.T.S. PLOT DATE = 2/19/20	nØ1.dgn	DESIGNED - JRM DRAWN - JCH CHECKED - DTH DATE - 2/2/2015	REVISED - REVISED - REVISED - REVISED -			OF ILLINOIS OF TRANSPORTA	TION				RY OF QUANTIT			1321 11-00048	ON NO. COUNTY B-OO-SP DUPAGE CONTRAC	E 277

			c	III.	10/10	DV	UE UII	ANTITIES		F.A.U. RTE.
			3	UIV	11417		or do	ANTITIES		1321
SCALE:	N.T.S.	SHEET	NO.	5	OF	8	SHEETS	STA.	TO STA.	FED. ROAD

	PAY ITEM NUMBER	ITEM DESCRIPTION	UNIT	TOTAL	ROADWAY 80% FEDERAL 20% STATE 0004	RETAINING WALL 80% FEDERAL 20% STATE 0040		INTERCONNECT 80% FEDERAL 20% STATE 0021	LIGHTING 80% FEDERAL 20% STATE 0021	LANDSCAPING 80% FEDERAL 20% STATE 0031	ROADWA 80% FEDER 20% LOCA 0004
	* 87702940	STEEL COMBINATION MAST ARM ASSEMBLY AND POLE 42 FT.	EACH	1	0004	0040	1	0021	0021	0031	0004
	* 87703010	STEEL COMBINATION MAST ARM ASSEMBLY AND POLE 56 FT.	EACH	1			1				
	* 87703040	STEEL COMBINATION MAST ARM ASSEMBLY AND POLE 62 FT.	EACH	1			1				
	* 87800100	CONCRETE FOUNDATION, TYPE A	FOOT	28			28				
	* 87800150	CONCRETE FOUNDATION, TYPE C	FOOT	4			4				
	* 87800415	CONCRETE FOUNDATION, TYPE E 36-INCH DIAMETER	FOOT	37			37				-
	* 87800420	CONCRETE FOUNDATION, TYPE E 42-INCH DIAMETER	FOOT	42			42	-570 >			
	* 87900200	DRILL EXISTING HANDHOLE	EACH	1				1			
	* 88030020	SIGNAL HEAD, LED, 1-FACE, 3-SECTION, MAST-ARM MOUNTED	EACH	11			11				
	* 88030050	SIGNAL HEAD, LED, 1-FACE, 3-SECTION, BRACKET MOUNTED	EACH	7			7				
	* 88030110	SIGNAL HEAD, LED, 1-FACE, 5-SECTION, MAST-ARM MOUNTED	EACH	3			3				
	* 88030210	SIGNAL HEAD, LED, 2-FACE, 3-SECTION, BRACKET MOUNTED	EACH	1			1				
	* 88030220	SIGNAL HEAD, LED, 2-FACE, 5 SECTION, BRACKET MOUNTED	EACH	1			1				
	* 88030240	SIGNAL HEAD, LED, 2-FACE, 1-3 SECTION, 1-5 SECTION, BRACKET MOUNTED	EACH	1			1				-111
	* 88102710	PEDESTRIAN SIGNAL HEAD, LED, 1-FACE BRACKET MOUNTED	EACH	3			3				
	* 88102740	PEDESTRIAN SIGNAL HEAD, LED, 2-FACE BRACKET MOUNTED	EACH	2			2				
	* 88102760	PEDESTRIAN SIGNAL HEAD, LED, 3-FACE BRACKET MOUNTED	EACH	1			1				
	* 88200110	TRAFFIC SIGNAL BACKPLATE, LOUVERED	EACH	18			18				
	* 88500100	INDUCTIVE LOOP DETECTOR	EACH	58			58				
	* 88600100	DETECTOR LOOP, TYPE I	FOOT	525			525				
	* 88600700	PREFORMED DETECTOR LOOP	FOOT	1,377			1,377				
	* 88700200	LIGHT DETECTOR	EACH	5			5				
	* 88700300	LIGHT DETECTOR AMPLIFIER	EACH	1			1				
	* 88800100	PEDESTRIAN PUSH-BUTTON	EACH	9			9				
	* 89000100	TEMPORARY TRAFFIC SIGNAL INSTALLATION	EACH	1			1				
	* 89100400	ILLUMINATED SIGN, LED	EACH	2			2				
	* 89501410	RELOCATE EXISTING EMERGENCY VEHICLE PRIORITY SYSTEM, PHASING UNIT	EACH	5			5				
	* 89502300	REMOVE ELECTRIC CABLE FROM CONDUIT	FOOT	6,118				6,118			
	* 89502375	REMOVE EXISTING TRAFFIC SIGNAL EQUIPMENT	EACH	6			6	0,110			
	* 89502380	REMOVE EXISTING HANDHOLE	EACH	15			15				
	* 89502382	REMOVE EXISTING DOUBLE HANDHOLE	EACH	2			2				
	* 89502385	REMOVE EXISTING CONCRETE FOUNDATION	EACH	14			14				
	* 89502400	REMOVE EXISTING FLASHING BEACON INSTALLATION COMPLETE	EACH	2	2		14				
	* A2000224	TREE, ACER X FREEMANII MARMO (MARMO FREEMAN MAPLE), 3" CALIPER, BALLED AND BURLAPPED			2						
	* A2000224 * A2000324	TREE, ACER MIYABEI MORTON (STATE STREET MIYABE MAPLE), 3" CALIPER, BALLED AND BURLAPPED	EACH	11						11	
	* A2000324 * A2002884		EACH	15						15	
		TREE, CELTIS OCCIDENTALIS CHICAGOLAND, (CHICAGOLAND HACKBERRY), 3" CALIPER, BALLED AND BURLAPPED	EACH	7						7	
	* A2004824	TREE, GLEDITSIA TRIACANTHOS INERMIS SKYLINE (SKYLINE THORNLESS COMMON HONEYLOCUST), 3" CALIPER, BALLED AND BURLAPPED	EACH	12						12	
	* A2005024	TREE, GYMNOCLADUS DIOICUS (KENTUCKY COFFEETREE), 3" CALIPER, BALLED AND BURLAPPED	EACH	7						7	
ECIALTY ITEM	* A2006520	TREE, QUERCUS BICOLOR (SWAMP WHITE OAK), 2.5" CALIPER, BALLED AND BURLAPPED	EACH	11						11	
NSTRUCTION TYPE CODE 0042	* A2007924	TREE, TILIA AMERICANA REDMOND (REDMOND AMERICAN LINDEN), 3" CALIPER, BALLED AND BURLAPPED	EACH	10						10	

* SPECIALTY ITEM

△ 100% LOCAL

DRAWN - JCH
CHECKED - DTH
DATE - 2/2/2015 FILE NAME = 023_sum01.dgn
PLOT SCALE = N.T.S. REVISED -REVISED -PLOT DATE = 2/19/2015 REVISED -

						nv	05 011	ANTITIES		F.A.U. RTE.	SECT	ION NO.	COUNTY	TOTAL	SHEE NO.
			2	UIV	IIVI	KKY	or uo	ANTITIES		1321	11-0004	8-00-SP	DUPAGE	277	9
												21110001	CONTRACT	NO.	63872
SCALE:	N.T.S.	SHEET	NO.	6	OF	8	SHEETS	STA.	TO STA.	FED. ROAD	DIST. NO.	ILLINOIS FED. A	ID PROJECT		

						1				C	ONSTRUCTION CO	DE		
		PAY ITEM	ITEM DESCRIPTION					ROADWAY 80% FEDERAL 20% STATE	RETAINING WALL 80% FEDERAL 20% STATE	SIGNALS 80% FEDERAL 20% STATE	INTERCONNECT 80% FEDERAL 20% STATE	LIGHTING 80% FEDERAL 20% STATE	LANDSCAPING 80% FEDERAL 20% STATE	ROADWAY 80% FEDERAL 20% LOCAL
		* B2001770	TREE, CRATAEGUS CRUSGALLI VAR. INERM	IS (THORNLESS COCKSPUR HAWTHORN)	8' HEIGHT, BALLED AND BURLAPPED, MULTI-HEADS	EACH	TOTAL 5	0004	0040	0021	0021	0021	0031 5	0004
		* C2C024G2	SHRUB, DIERVILLA 'COOL SPLASH' (COOL S	SPLASH DIERVILLA), 2-GALLON		EACH	29	I.					29	
		* C2C05824	SHRUB, RHUS AROMATICA GRO-LOW (GRO-L	OW FRAGRANT SUMACO, 2' WIDTH, COM	TAINER	EACH	34						34	
		* C2C06136	SHRUB, RHUS TYPHINA LACINIATA (CUTLE)	AF STAGHORN SUMAC), 3' HEIGHT, CON	AINER	EACH	39						39	
		* C2C072G3	SHRUB, ROSA FLOWER CARPET RED (FLOWE	R CARPET RED SHRUB ROSE), CONTAIN	ER GROWN, 3-GALLON	EACH	49						49	
		* C2008324	SHRUB, ROSA PURPLE PAVEMENT (PURPLE	PAVEMENT ROSE), 24" HEIGHT, CONTA	NER	EACH	42						42	
		* C2008524	SHRUB, ROSA RUGOSA (RUGOSA ROSE), 24"	HEIGHT, CONTAINER		EACH	44						44	
		* K0012990	PERENNIAL PLANTS, ORNAMENTAL TYPE, G	ALLON POT		UNIT	3.85						3.85	
		* K0029634	WEED CONTROL, PRE-EMERGENT GRANULAR	HERBICIDE		POUND	7			- 12 - 12 - 12 - 12 - 12 - 12 - 12 - 12			7	
		* X0324085	EMERGENCY VEHICLE PRIORITY SYSTEM LI	NE SENSOR CABLE, NO. 20 3/C		FOOT	1,122			1,122				
		* X0324097	COURSE SAND PLACEMENT, 2"			SQ YD	310						310	
		* X0326865	POST MOUNTED FLASHING BEACON INSTAL	LATION		EACH	2			2				
		* X0327078	REMOVE FIRE HYDRANT AND VALVE ASSEM	BLY		EACH	11	11			// // // // // // // // // // // // //			
		X4021000	TEMPORARY ACCESS (PRIVATE ENTRANCE)			EACH	9	9						
		X4022000	TEMPORARY ACCESS (COMMERCIAL ENTRAN	ICE)		EACH	34	34						
		X4024100	TEMPORARY ACCESS (WINTERIZE)			SQ YD	2,315	2,315						
		X4240470	PORTLAND CEMENT CONCRETE SIDEWALK I	0 INCH, SPECIAL		SQ FT	3,577		3,577					
		* X5610646	PLUG WATER MAIN 6"			EACH	1	1						
		* X5610649	PLUG WATER MAIN 12"			EACH	1	1						
		* X5610651	ABANDON EXISTING WATER MAIN, FILL WIT	H CSLM		FOOT	4,427	4,427						
		* X5610706	WATER MAIN REMOVAL, 6"		330000000000000000000000000000000000000	FOOT	126	126						
		* X5610708	WATER MAIN REMOVAL, 8"			FOOT	237	237						
		* X5611106	DUCTILE IRON WATER MAIN, CLASS 52 WIT	H POLYETHYLENE ENCASEMENT, 6"		FOOT	131	131						
		* X5611108	DUCTILE IRON WATER MAIN, CLASS 52 WIT	H POLYETHYLENE ENCASEMENT, 8"		FOOT	1,953	1,953						
		* X5611112	DUCTILE IRON WATER MAIN, CLASS 52 WIT	H POLYETHYLENE ENCASEMENT, 12"		FOOT	2,839	2,839						
		* X5620116	WATER SERVICE CONNECTION (SHORT)			EACH	15	15						
		* X5620118	WATER SERVICE CONNECTION (LONG)			EACH	14	14						
		* X5630006	CUT AND CAP EXISTING 6" WATER MAIN			EACH	2	2						
		* X5630008	CUT AND CAP EXISTING 8" WATER MAIN			EACH	4	4						
		* X5630012	CUT AND CAP EXISTING 12" WATER MAIN			EACH	4	4						
	9	* X5630706	CONNECTION TO EXISTING WATER MAIN 6"			EACH	3	3	<u> </u>					
		* X5630708	CONNECTION TO EXISTING WATER MAIN 8"			EACH	10	10						
		* X5630710	CONNECTION TO EXISTING WATER MAIN 10	,		EACH	1	1						
		* X5630712	CONNECTION TO EXISTING WATER MAIN 12'		TO COMPANY TO THE STATE OF THE	EACH	1	1						
		X6020096	MANHOLES, TYPE A, 6'-DIAMETER, WITH 2	TYPE 1 FRAME, CLOSED LID, RESTRICT	OR PLATE	EACH	1	1						
		X6020102	MANHOLES, TYPE A, 9'-DIAMETER, TYPE 1	FRAME, CLOSED LID, RESTRICTOR PLA	E	EACH	1	1						
		X6023508	INLETS, TYPE A, WITH SPECIAL FRAME AND) GRATE		EACH	3	3						
5		X6025620	CATCH BASINS, TYPE A, 5'-DIAMETER, WIT	H SPECIAL FRAME AND GRATE		EACH	2	2						
*	SPECIALTY ITEM	X6026056	SANITARY MANHOLES TO BE ADJUSTED WIT	H NEW TYPE 1 FRAME, CLOSED LID		EACH	16	16						
X	CONSTRUCTION TYPE CODE 0042	X6026622	VALVE VAULTS TO BE REMOVED			EACH	17	17						
Δ	100% LOCAL		VALVE BOX			EACH	3	3						
n	HRGreen.com	USER NAME = jhorwit	DESIGNED - JRM	REVISED -	STATE OF HUMOIS							F	A.U. SECTIO	ON NO. CO

△ 100% LOCAL

USER NAME = Jhorwit	DESIGNED - JRM	REVISED -	
FILE NAME = 023_sum01.dgn	DRAWN - JCH	REVISED -	Т
PLOT SCALE = N.T.S.	CHECKED - DTH	REVISED -	
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				A DV	. 05 011	ANTITIES		F.A.U. RTE.	SECT	ION NO.	COUNTY	TOTAL	SHEET NO.
		SUMMARY OF QUANTITIES						1321	11-0004	8-00-SP	DUPAGE	277	10
	1012/2	T									CONTRACT	NO.	63872
SCALE:	N.T.S.	SHEET NO.	7 OF	8	SHEETS	STA.	TO STA.	FED. ROAD	DIST. NO.	ILLINOIS FED.	AID PROJECT		

ſ							CC	ONSTRUCTION COL	DE		
	PAY ITEM NUMBER	ITEM DESCRIPTION	UNIT	TOTAL	ROADWAY 80% FEDERAL 20% STATE 0004	RETAINING WALL 80% FEDERAL 20% STATE	SIGNALS 80% FEDERAL 20% STATE	INTERCONNECT 80% FEDERAL 20% STATE	LIGHTING 80% FEDERAL 20% STATE	LANDSCAPING 80% FEDERAL 20% STATE	ROADWAY 80% FEDERAL 20% LOCAL
-	X7010216	TRAFFIC CONTROL AND PROTECTION, (SPECIAL)	L SUM	1	1	0040	0021	0021	0021	0031	0004
ŀ	X7040125	PINNING TEMPORARY CONCRETE BARRIER	EACH	114	114						
*	X7810300	RECESSED REFLECTIVE PAVEMENT MARKER	EACH	260	260						
*	X8210040	TEMPORARY LUMINAIRE, HIGH PRESSURE SODIUM VAPOR, 400 WATT	EACH	28					28		
*	X8250060	TEMPORARY LIGHTING CONTROLLER	EACH	1					1		
*	X8360215	LIGHT POLE FOUNDATION, 24" DIAMETER, OFFSET	EACH	56					56		
*	X8440116	RELOCATE EXISTING LIGHTING UNIT, SPECIAL	EACH	27					27		
*	X8570226	FULL-ACTUATED CONTROLLER AND TYPE IV CABINET, SPECIAL	EACH	4			4				
*	X8571215	RAILROAD, FULL-ACTUATED CONTROLLER AND TYPE IV CABINET, SPECIAL	EACH	1			1				
*	X8571315	RAILROAD, FULL-ACTUATED CONTROLLER AND TYPE V CABINET, SPECIAL	EACH	1			1				
*	X8600105	MASTER CONTROLLER (SPECIAL)	EACH	1			1				
*	X8620200	UNINTERRUPTABLE POWER SUPPLY, SPECIAL									
	X8710024	FIBER OPTIC CABLE IN CONDUIT, NO. 62.5/125, MM12F SM24F	EACH	3			3				
1			FOOT	3,696				3,696			
	XX003219	UNIT PAVERS	SO FT	8,160							8,160
*	XX005972	STAMPED ASPHALT CROSSWALK	SO YD	790							790
T	XX006653	FENCE (SPECIAL)	FOOT	209							209
Δ	Z0010600	CLEANING DRAINAGE SYSTEM	FOOT	3,568							
-	Z0013798	CONSTRUCTION LAYOUT	L SUM	1	1						
Δ	Z0018500	DRAINAGE STRUCTURES TO BE CLEANED	EACH	28							
F	Z0030850	TEMPORARY INFORMATION SIGNING	SQ FT	478	478						
*	Z0033028	MAINTENANCE OF LIGHTING SYSTEM	CAL MO	24					24		
*	Z0033056	OPTIMIZE TRAFFIC SIGNAL SYSTEM	EACH	1				1			
*	Z0033058	POST MOUNTED FLASHING BEACON INSTALLATION (SPECIAL)	EACH	2	2						
*	Z0044800	PRESSURE CONNECTION 8" X 8"	EACH	1	1						
*	Z0045100	PRESSURE CONNECTION 12" X 12"	EACH	1	1						
	Z0048665	RAILROAD PROTECTIVE LIABILITY INSURANCE	L SUM	1	11						
	Z0056608	STORM SEWER (WATER MAIN REQUIREMENTS) 12 INCH	FOOT	419	419						
	Z0056610	STORM SEWER (WATER MAIN REQUIREMENTS) 15 INCH	FOOT	57	57						
-	Z0056612	STORM SEWER (WATER MAIN REQUIREMENTS) 18 INCH	FOOT	137	137						
	Z0056616	STORM SEWER (WATER MAIN REQUIREMENTS) 24 INCH	FOOT	126	126						
-	Z0056622	STORM SEWER (WATER MAIN REQUIREMENTS) 36 INCH	FOOT	96	96						
	Z0062456	TEMPORARY PAVEMENT	SO YD	560	560						
*	Z0068200	STEEL CASINGS, 30"	FOOT	136	136						
*	Z0073510	TEMPORARY TRAFFIC SIGNAL TIMING	EACH	1			1				
×	Z0076600	TRAINEES	HOUR	1,500							
, l	Z0076604	TRAINEES TRAINING PROGRAM GRADUATE									
^ [20010004	THAUMES TRAINING CROUNAN GRAUDATE	HOUR	1,500							

SPECIALTY ITEM

SPECIALTY ITEM


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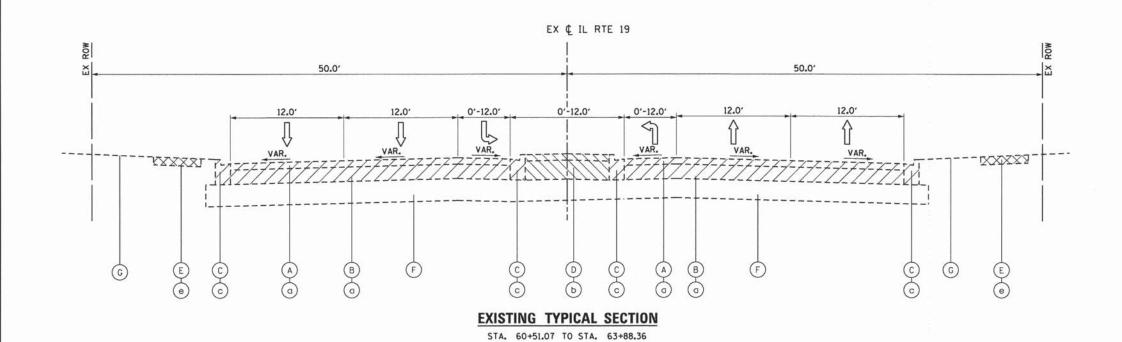
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PLOT DATE = 2/19/2015	DATE - 2/2/2015	REVISED -

		CURREAD				F.A.U. RTE.	SECT	ION NO.	COUNTY	TOTAL	SHEET NO.
		SUMMARY	UF UU	ANTITIES		1321	11-0004	18-00-SP	DUPAGE	277	11
									CONTRACT	NO.	63872
CALE:	N.T.S.	SHEET NO. 8 OF 8	SHEETS	STA.	TO STA,	FED. ROAD	DIST. NO.	ILLINOIS FED.	AID PROJECT		





EXISTING LEGEND

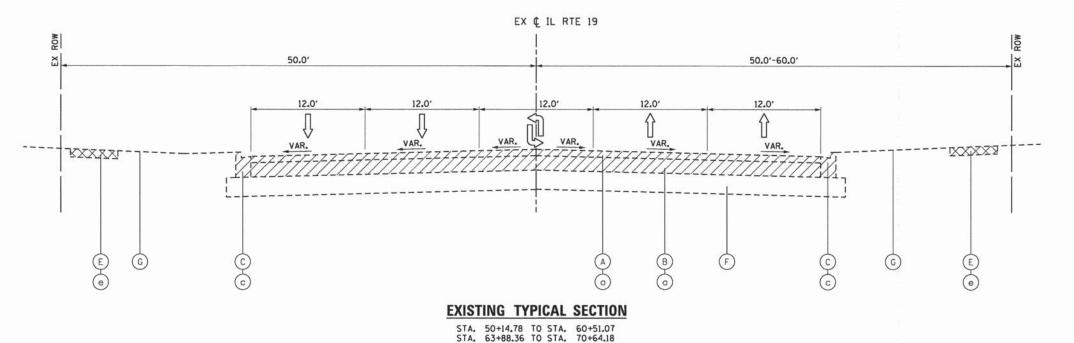- A HOT-MIX ASPHALT OVERLAY, ±4"
- B) P.C.C. PAVEMENT, ±9"
- C COMBINATION CONCRETE CURB & GUTTER, TYPE B-6.12
- D CONCRETE MEDIAN
- E P.C.C. SIDEWALK, 5"
- (F) AGGREGATE SUBGRADE, 12"
- G EXISTING GROUND
- H) RETAINING WALL
- (I) HOT-MIX ASPHALT PAVEMENT, ±9"

REMOVAL LEGEND

- a PAVEMENT REMOVAL
- b MEDIAN REMOVAL
- C COMBINATION CURB AND GUTTER REMOVAL
- (d) RETAINING WALL REMOVAL*
- (e) SIDEWALK REMOVAL
- * PAID FOR AS REMOVAL AND DISPOSAL OF UNSUITABLE MATERIAL


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USER NAME = Jhorwit	DESIGNED - JRM	REVISED -	
FILE NAME = 023_typ01.dgn	DRAWN - JCH	REVISED -	
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PLOT DATE = 2/19/2015	DATE - 2/2/2015	REVISED -	

STATE OF ILLINOIS **DEPARTMENT OF TRANSPORTATION**

TYPICAL SECTIONS							F.A.		
	ILLINOIS ROUTE 19							132	
SCALE:	N.T.S.	SHEET NO.	1	OF	8	SHEETS	STA.	TO STA.	FED.


COUNTY TOTAL SHEET NO. SECTION NO. DUPAGE 277 12 CONTRACT NO. 63872

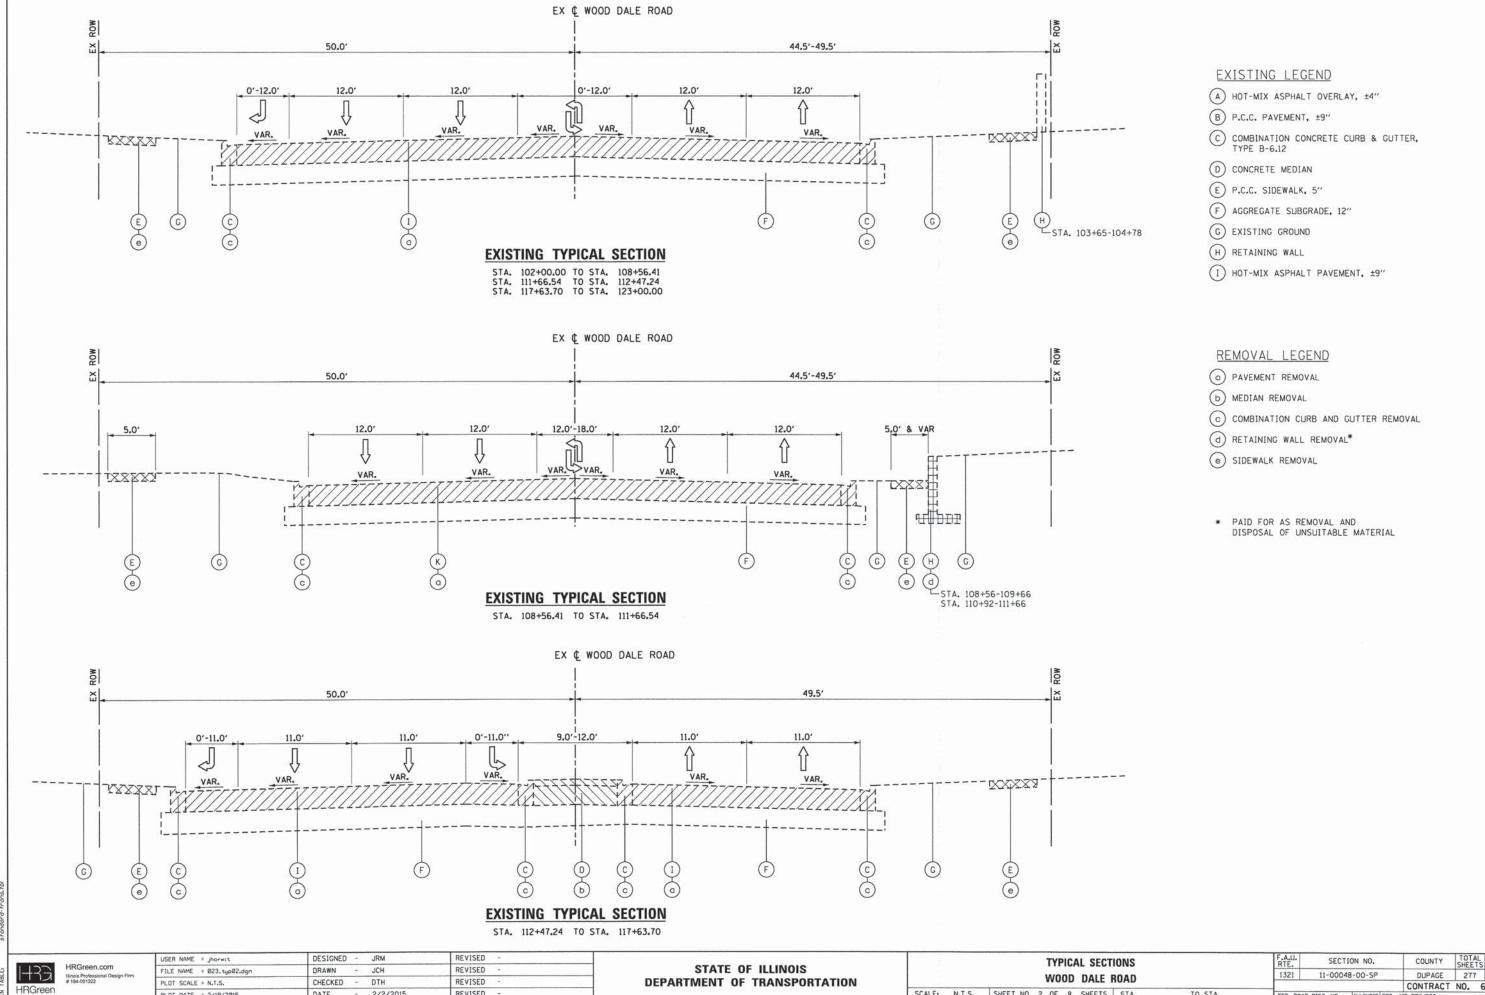


CHECKED - DTH REVISED REVISED PLOT DATE = 2/19/2015 DATE - 2/2/2015

DEPARTMENT OF TRANSPORTATION

COUNTY TOTAL SHEETS NO. DUPAGE 277 13 FED. ROAD DIST. NO. | ILLINOIS | FED. AID PROJECT SCALE: N.T.S. SHEET NO. 2 OF 8 SHEETS STA. TO STA.

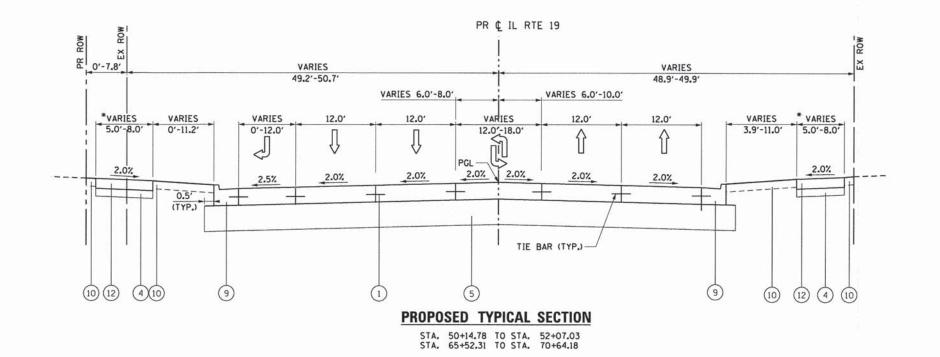

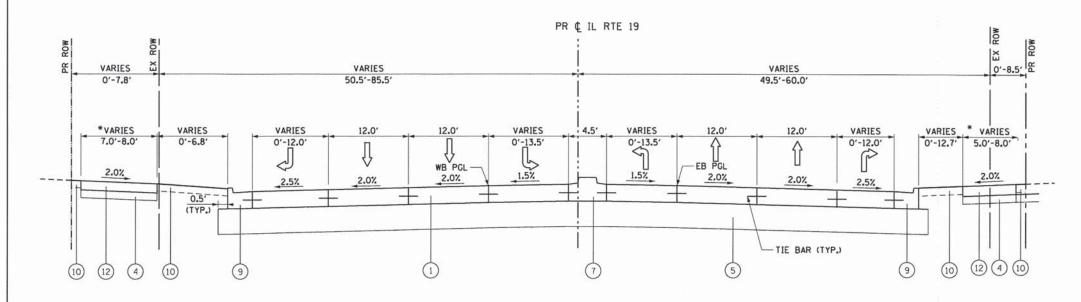

PROPOSED TYPICAL SECTION

STA. 53+69.76 TO STA. 59+35.58

PROPOSED LEGEND

- PORTLAND CEMENT CONCRETE PAVEMENT, 9 1/2" (JOINTED)
- 2 HMA FULL DEPTH PAVEMENT, 9"
- 3 HMA FULL DEPTH PAVEMENT, 11"
- (4) SUBBASE GRANULAR MATERIAL, TYPE B 6"
- (5) AGGREGATE SUBGRADE IMPROVEMENT, 12", (SQ YD)
- (6) AGGREGATE SUBGRADE IMPROVEMENT, (CU YD)
- 7 CONCRETE MEDIAN, TYPE SB-6.12
- 8 COMBINATION CONCRETE CURB & GUTTER, TYPE B-6.12
- 9 COMBINATION CONCRETE CURB & GUTTER, TYPE B-6.24
- (10) TOPSOIL FURNISH AND PLACE, SODDING, SALT TOLERANT OR SEED (SEE LANDSCAPING PLAN)
- 11) UNIT PAVERS
 - (11A) LIMESTONE SCREENING
 - (11B) SUBBASE GRANULAR MATERIAL TYPE B
- (12) PORTLAND CEMENT CONCRETE SIDEWALK, 5"
- (3) PORTLAND CEMENT CONCRETE SIDEWALK, 10" SPECIAL (SEE STRUCTURAL PLANS)
- (14) FENCE (SPECIAL)

STRUCTURAL DESIGN PV =	TRAFFIC:	YEAR:_ SU =_	2030	MU =.	3,024
ROAD/STREET CLAS	SIFICATION:		CLASS_	_ I	
PERCENT OF STRUCT		N TRAF S =_	FIC IN DES	SIGN LAN M =.	E: 9.0%
TRAFFIC FACTOR:	ACTUAL MINIMUM	TF =_ TF =_	22.03 AC 5.02	TYPE =	N/A
PG GRADE BINDER =_	N/A	SL	IRFACE =_	N/A	
SUBGRADE SUPPORT SSR =_ SSR =	POOR POOR	(STA	11+85 100+00	T0 T0	25+52 104+5

TOTAL SHEET SHEETS NO.

DUPAGE 277 14

CONTRACT NO. 63872

COUNTY

* PROPOSED SIDEWALK ARE LOCATED INTERMITTENTLY THROUGHOUT THE PROJECT. SEE PLAN AND PROFILE SHEETS FOR LOCATIONS.

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PROJECT CONTACT:

CLENT;

DATE PLOTED;

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FILE NAME:

PLOT DRIVER;

PLOT DRIVER;


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PLOT DATE = 2/19/2015	DATE	-	2/2/2015	REVISED	-

STATI	E 0	F ILLINOIS
DEPARTMENT	OF	TRANSPORTATION

	TYPICAL SECTIONS			F.A.U. RTE.	SECTION NO.	
	ILLINOIS ROUTE 19				1321	11-00048-00-SP
SCALE:	N.T.S.	SHEET NO. 3 OF	8 SHEETS STA.	TO STA.	FFD. ROAD	DIST NO THE INDIS SED A




•STA. 63+61.36 TO STA. 65+52.31 •STA. 52+07.03 TO STA. 53+69.76 •STA. 59+35.58 TO STA. 63+61.36

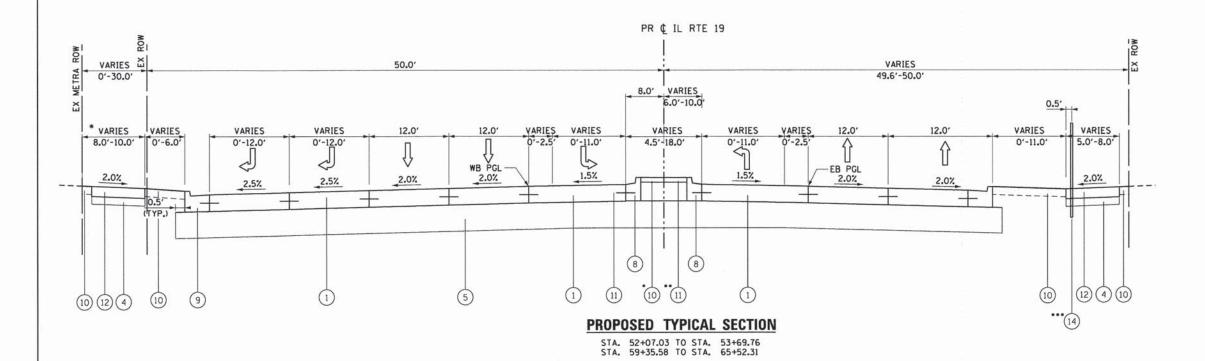***STA. 61+72.00 TO STA. 63+76.92

PROPOSED LEGEND

- 1) PORTLAND CEMENT CONCRETE PAVEMENT, 9 1/2" (JOINTED)
- 2) HMA FULL DEPTH PAVEMENT, 9"
- (3) HMA FULL DEPTH PAVEMENT, 11"
- (4) SUBBASE GRANULAR MATERIAL, TYPE B 6"
- 5) AGGREGATE SUBGRADE IMPROVEMENT, 12", (SQ YD)
- (6) AGGREGATE SUBGRADE IMPROVEMENT, (CU YD)
- (7) CONCRETE MEDIAN, TYPE SB-6.12
- 8 COMBINATION CONCRETE CURB & GUTTER, TYPE B-6.12
- 9 COMBINATION CONCRETE CURB & GUTTER, TYPE B-6.24
- TOPSOIL FURNISH AND PLACE, SODDING, SALT TOLERANT OR SEED (SEE LANDSCAPING PLAN)
- (11) UNIT PAVERS
 - (11A) LIMESTONE SCREENING
 - (11B) SUBBASE GRANULAR MATERIAL TYPE B
- (12) PORTLAND CEMENT CONCRETE SIDEWALK, 5"
- 13 PORTLAND CEMENT CONCRETE SIDEWALK, 10" SPECIAL (SEE STRUCTURAL PLANS)
- (14) FENCE (SPECIAL)

NOTE: PROPOSED SIDEWALKS ARE LOCATED INTERMITTENTLY THROUGHOUT THE PROJECT. SEE PLAN AND PROFILE SHEETS FOR LOCATIONS.

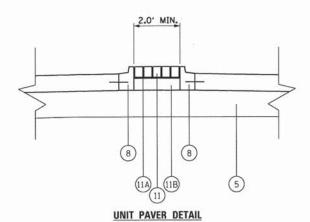

NOTE: 11A AND 11B ARE ALL INCLUDED IN THE COST FOR UNIT PAVERS.

Mar (conservations)	AIR VOIDS
MIXTURE TYPE	@ Ndes
TULL DEPTH PAVEMENT: WOOD DALE RD	
POLYMERIZED HMA SURFACE COURSE, MIX "F", N90 (IL 9.5mm); 2"	4% @ 90 GYR.
POLYMERIZED HMA BINDER COURSE, IL-19.0, N90; 2"	4% № 90 GYR.
HOT-MIX ASPHALT BASE COURSE (HMA BINDER IL-19mm); 7" (IN 2 LIFTS)	4% № 50 GYR.
TULL DEPTH PAVEMENT: COMMERCIAL ST, DIVISON ST, ELMWOOD AVE	
HOT-MIX ASPHALT SURFACE COURSE, MIX "D", N50 (IL 9,5mm); 1-1/2"	4% @ 50 GYR.
HOT-MIX ASPHALT BINDER COURSE, IL-19.0, N50; 2-1/2"	4% @ 50 GYR.
HOT-MIX ASPHALT BASE COURSE (HMA BINDER IL-19mm); 5"	4% @ 50 GYR.
DRIVEWAYS	
HMA SURFACE COURSE, MIX "D", N50; (IL 9.5mm); 2"	4% @ 50 GYR.
HMA BASE COURSE (HMA BINDER IL-19 mm); PE-6", CE-8" (IN 2 LIFTS)	4% @ 50 GYR.
EMPORARY PAVEMENT	
HMA SURFACE COURSE, MIX "D", N50 (IL 9.5 mm); 2"	4% € 50 GYR.
TEMPORARY PAVEMENT (HMA BINDER IL-19mm); 8"	4% @ 50 GYR.

- . THE UNIT WEIGHT TO CALCULATE ALL HMA SURFACE MIXTURE QUANTITIES IS 112 LBS/SQ YD/IN.
- THE "AC TYPE" FOR POLYMERIZED HMA MIXES SHALL BE "SBS/SBR PG 76-22" AND FOR NON-POLYMERIZED HMA THE "AC TYPE" SHALL BE "PG 64-22" UNLESS MODIFIED BY DISTRICT ONE SPECIAL PROVISIONS.
- FOR HMA FULL DEPTH "AC TYPE" SEE SPECIAL PROVISIONS.
- . FOR USE OF RECYCLED MATERIALS SEE SPECIAL PROVISIONS.

SCALE:

 NOTE: IF THE CONTRACTOR CHOOSES TO USE CONCRETE FOR TEMPORARY PAVEMENT, THE THICKNESS SHALL BE 8".


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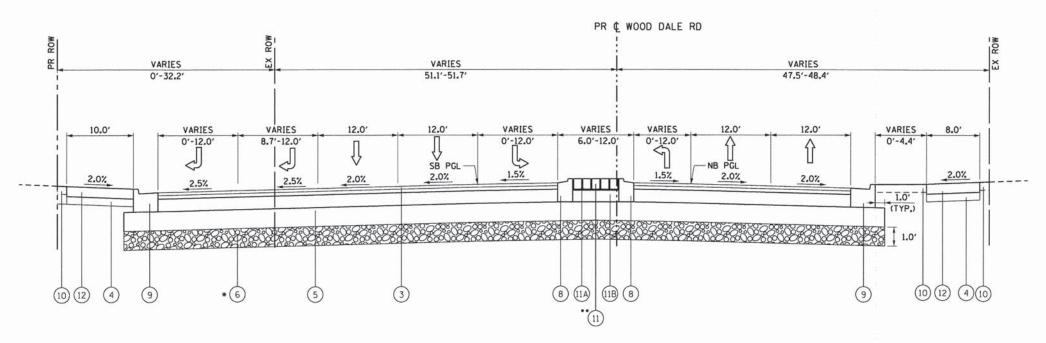
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	PLOT DATE = 2/19/2015	DATE - 2/2/2015	REVISED -	

	TYPICAL SECTIONS			F.A.U. RTE.	SECT	ION NO.	COUNTY	TOTAL	SHEET NO.
	ILLINOIS ROUT	E 10		1321	11-0004	8-00-SP	DUPAGE	277	15
	ILLINOIS HOU	L 13				ACT STATE AND ADDRESS OF THE PARTY OF THE PA	CONTRACT	NO.	63872
N.T.S.	SHEET NO. 4 OF 8 SHEETS	STA.	TO STA.	FED. ROAD	DIST. NO.	ILLINOIS FED.	AID PROJECT		



PROPOSED TYPICAL SECTION

STA. 102+00.00 TO STA. 113+39.53 STA. 119+02.38 TO STA. 123+00.00

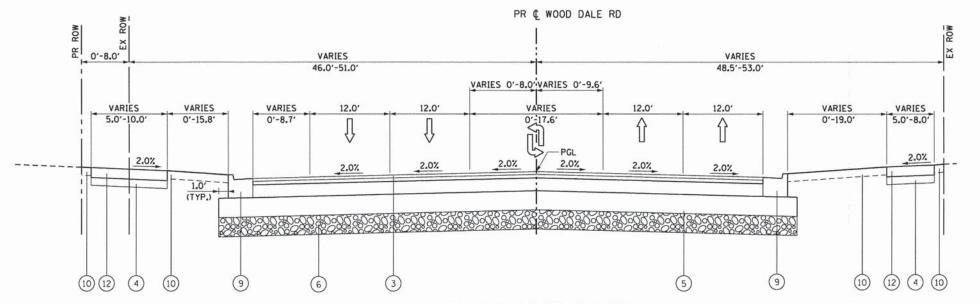

* AGGREGATE SUBGRADE IMPROVEMENT, (CU YD) FROM STA. 115+00.00 TO STA. 120+00.00


PROPOSED TYPICAL SECTION

STA. 114+12.92 TO STA. 119+02.38

..STA. 114+34.89 TO STA. 119+02.38

PROPOSED LEGEND

- 1) PORTLAND CEMENT CONCRETE PAVEMENT, 9 1/2" (JOINTED)
- 2) HMA FULL DEPTH PAVEMENT, 9"
- (3) HMA FULL DEPTH PAVEMENT, 11"
- (4) SUBBASE GRANULAR MATERIAL, TYPE B 6"
- (5) AGGREGATE SUBGRADE IMPROVEMENT, 12", (SQ YD)
- (6) AGGREGATE SUBGRADE IMPROVEMENT, (CU YD)
- (7) CONCRETE MEDIAN, TYPE SB-6.12
- 8 COMBINATION CONCRETE CURB & GUTTER, TYPE B-6.12
- 9 COMBINATION CONCRETE CURB & GUTTER, TYPE B-6.24
- (10) TOPSOIL FURNISH AND PLACE, SODDING, SALT TOLERANT OR SEED (SEE LANDSCAPING PLAN)
- 11 UNIT PAVERS
 - (11A) LIMESTONE SCREENING
 - (11B) SUBBASE GRANULAR MATERIAL TYPE B
- (12) PORTLAND CEMENT CONCRETE SIDEWALK, 5"
- (13) PORTLAND CEMENT CONCRETE SIDEWALK, 10" SPECIAL (SEE STRUCTURAL PLANS)
- (14) FENCE (SPECIAL)

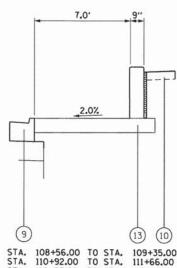


STA. 108+56.00 TO STA. 109+35.00 STA. 110+92.00 TO STA. 111+66.00 STA. 116+37.00 TO STA. 117+43.00

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	TYPICAL SECTIONS				F.A.U. RTE.	SECTION NO.	COUNTY	TOTAL	SHEET NO.
	WOOD DALE ROAD					11-00048-00-SP	DUPAGE	277	16
							CONTRACT	NO.	63872
SCALE:	N.T.S.	SHEET NO. 5 OF 8 SHEETS	STA.	TO STA.	FED. ROAD	DIST. NO. ILLINOIS FED.	AID PROJECT		-/



PR & DIVISION ST VARIES 27.0" 23.0' 0'-10.0' VARIES 12.0' 12.0" 7.0' PGL 2.0% 2.0% 2.0% 13 4 12 (4)(12) \(\Delta \) (13) * PCC SIDEWALK 10", SPECIAL LIMITS

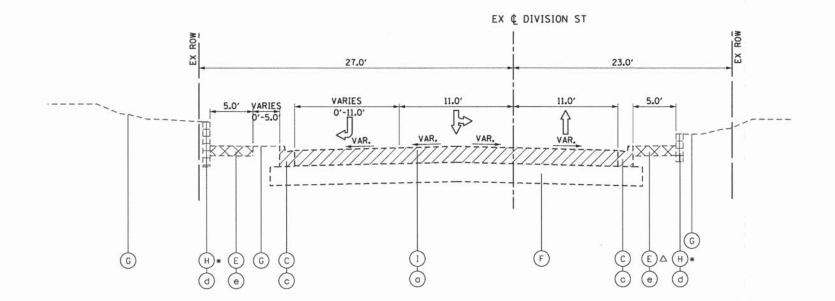EXISTING TYPICAL SECTION

STA. 199+97.28 TO STA. 204+06.98

PROPOSED TYPICAL SECTION

STA. 199+97.28 TO STA. 204+06.98

A HOT-MIX ASPHALT OVERLAY, ±4"

(B) P.C.C. PAVEMENT, ±9"

EXISTING LEGEND

C COMBINATION CONCRETE CURB & GUTTER, TYPE B-6.12

D CONCRETE MEDIAN

E P.C.C. SIDEWALK, 5"

F AGGREGATE SUBGRADE, 12"

G EXISTING GROUND

H RETAINING WALL

(I) HOT-MIX ASPHALT PAVEMENT, ±9"

REMOVAL LEGEND

(a) PAVEMENT REMOVAL

b MEDIAN REMOVAL

(c) COMBINATION CURB AND GUTTER REMOVAL

d RETAINING WALL REMOVAL**

(e) SIDEWALK REMOVAL

** PAID FOR AS REMOVAL AND DISPOSAL OF UNSUITABLE MATERIAL

PROPOSED LEGEND

1) PORTLAND CEMENT CONCRETE PAVEMENT, 9 1/2" (JOINTED)

2) HMA FULL DEPTH PAVEMENT, 9"

(3) HMA FULL DEPTH PAVEMENT, 11"

(4) SUBBASE GRANULAR MATERIAL, TYPE B 6"

5) AGGREGATE SUBGRADE IMPROVEMENT, 12", (SQ YD)

(6) AGGREGATE SUBGRADE IMPROVEMENT, (CU YD)

(7) CONCRETE MEDIAN, TYPE SB-6.12

8 COMBINATION CONCRETE CURB & GUTTER, TYPE B-6.12

9 COMBINATION CONCRETE CURB & GUTTER, TYPE B-6.24

(10) TOPSOIL FURNISH AND PLACE, SODDING, SALT TOLERANT OR SEED (SEE LANDSCAPING PLAN)

11) UNIT PAVERS

(11A) LIMESTONE SCREENING

(11B) SUBBASE GRANULAR MATERIAL TYPE B

(12) PORTLAND CEMENT CONCRETE SIDEWALK, 5"

13 PORTLAND CEMENT CONCRETE SIDEWALK, 10" SPECIAL (SEE STRUCTURAL PLANS)

(14) FENCE (SPECIAL)

TO STA.

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PLOT DATE = 2/19/2015	DATE -	2/2/2015	REVISED -	

STATE OF ILLINOIS **DEPARTMENT OF TRANSPORTATION**

TYPICAL S	ECTIONS
DIVISION	STREET

SECTION NO. COUNTY 1321 11-00048-00-SP DUPAGE 277 17 CONTRACT NO. 63872 FED. ROAD DIST. NO. | ILLINOIS FED. AID PROJECT

SCALE: N.T.S. SHEET NO. 6 OF 8 SHEETS STA.

IL RTE 19 STA. 200+75.93 TO STA. 201+58.23 LT IL RTE 19 STA. 200+42.62 TO STA. 201+08.87 RT


△ SIDEWALK ENDS AT STA. 203+46.15 RT

* SEGMENTAL CONCRETE BLOCK WALL LIMITS

STA. 200+38.17 TO STA. 201+73.43 LT


STA. 200+39.15 TO STA. 201+56.13 RT

 Δ SIDEWALK ENDS AT STA. 203+46.15 RT

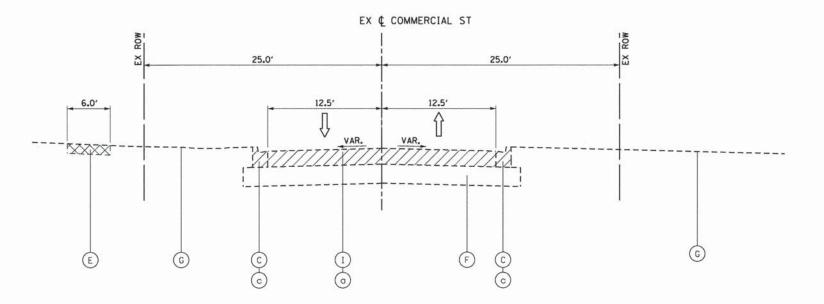

EXISTING TYPICAL SECTION

STA. 700+00.00 TO STA. 706+40.90

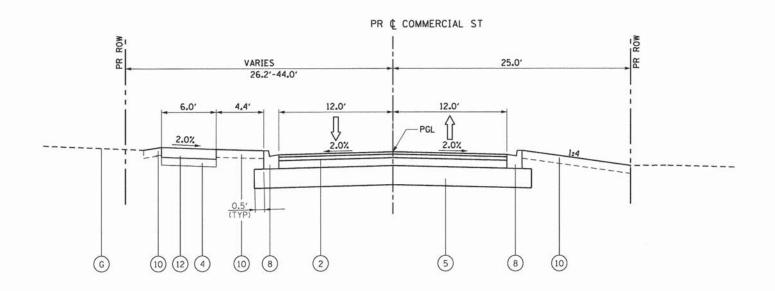

PROPOSED TYPICAL SECTION

STA. 300+00.00 TO STA. 305+05.71

EXISTING LEGEND

- A HOT-MIX ASPHALT OVERLAY, ±4"
- B) P.C.C. PAVEMENT, ±9"
- C COMBINATION CONCRETE CURB & GUTTER, TYPE B-6.12
- D CONCRETE MEDIAN
- (E) P.C.C. SIDEWALK, 5"
- (F) AGGREGATE SUBGRADE, 12"
- G EXISTING GROUND
- (H) RETAINING WALL
- 1 HOT-MIX ASPHALT PAVEMENT, ±9"

REMOVAL LEGEND

- (a) PAVEMENT REMOVAL
- b) MEDIAN REMOVAL
- C COMBINATION CURB AND GUTTER REMOVAL
- d) RETAINING WALL REMOVAL*
- (e) SIDEWALK REMOVAL
- * PAID FOR AS REMOVAL AND DISPOSAL OF UNSUITABLE MATERIAL

PROPOSED LEGEND

- 1) PORTLAND CEMENT CONCRETE PAVEMENT. 9 1/2" (JOINTED)
- (2) HMA FULL DEPTH PAVEMENT, 9"
- 3 HMA FULL DEPTH PAVEMENT, 11"
- 4) SUBBASE GRANULAR MATERIAL, TYPE B 6"
- 5) AGGREGATE SUBGRADE IMPROVEMENT, 12", (SO YD)
- (6) AGGREGATE SUBGRADE IMPROVEMENT, (CU YD)
- 7) CONCRETE MEDIAN, TYPE SB-6.12
- 8 COMBINATION CONCRETE CURB & GUTTER, TYPE B-6.12
- 9 COMBINATION CONCRETE CURB & GUTTER, TYPE B-6.24
- (10) TOPSOIL FURNISH AND PLACE, SODDING, SALT TOLERANT OR SEED (SEE LANDSCAPING PLAN)
- (11) UNIT PAVERS
 - (11A) LIMESTONE SCREENING
 - (11B) SUBBASE GRANULAR MATERIAL TYPE B
- (12) PORTLAND CEMENT CONCRETE SIDEWALK, 5"
- (3) PORTLAND CEMENT CONCRETE SIDEWALK, 10" SPECIAL (SEE STRUCTURAL PLANS)
- (14) FENCE (SPECIAL)

TO STA.

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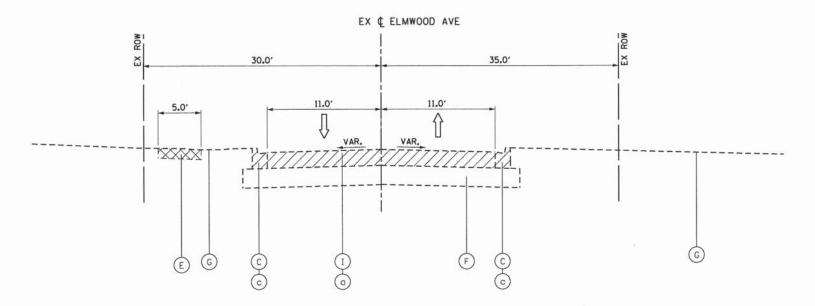
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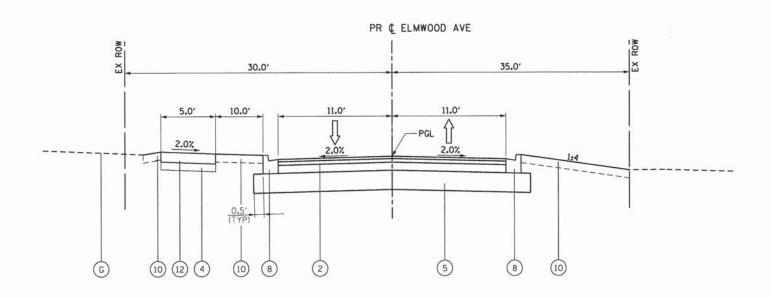
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DEPARTMENT	OF	TRANSPORTATION

				TYPICAL SECTIONS					
				C	OM	ME	RCIAL S	TREET	
SCALE:	N.T.S.	SHEET	NO.	7	OF	8	SHEETS	STA.	

	FED. ROA	DIST. NO.	ILLINOIS	FED. A	ID PROJECT					
_					CONTRACT	NO. 6	33872			
	1321	11-0004	18-00-SP		DUPAGE	277	18			
	RTE. SECTION		SECTION NO.				COUNTY	SHEETS	NO.	



EXISTING TYPICAL SECTION



PROPOSED TYPICAL SECTION

EXISTING LEGEND

- (A) HOT-MIX ASPHALT OVERLAY, ±4"
- B P.C.C. PAVEMENT, ±9"
- C COMBINATION CONCRETE CURB & GUTTER, TYPE B-6.12
- D CONCRETE MEDIAN
- E P.C.C. SIDEWALK, 5"
- (F) AGGREGATE SUBGRADE, 12"
- G EXISTING GROUND
- H) RETAINING WALL
- (I) HOT-MIX ASPHALT PAVEMENT, ±9"

REMOVAL LEGEND

- a PAVEMENT REMOVAL
- (b) MEDIAN REMOVAL
- C COMBINATION CURB AND GUTTER REMOVAL
- d RETAINING WALL REMOVAL*
- (e) SIDEWALK REMOVAL
- * PAID FOR AS REMOVAL AND DISPOSAL OF UNSUITABLE MATERIAL

PROPOSED LEGEND

- 1 PORTLAND CEMENT CONCRETE PAVEMENT, 9 1/2" (JOINTED)
- 2) HMA FULL DEPTH PAVEMENT, 9"
- 3 HMA FULL DEPTH PAVEMENT, 11"
- 4) SUBBASE GRANULAR MATERIAL, TYPE B 6"
- (5) AGGREGATE SUBGRADE IMPROVEMENT, 12", (SO YD)
- (6) AGGREGATE SUBGRADE IMPROVEMENT, (CU YD)
- (7) CONCRETE MEDIAN, TYPE SB-6.12
- 8 COMBINATION CONCRETE CURB & GUTTER, TYPE B-6.12
- 9 COMBINATION CONCRETE CURB & GUTTER, TYPE B-6.24
- (SEE LANDSCAPING PLAN)

 10 TOPSOIL FURNISH AND PLACE, SODDING, SALT TOLERANT OR SEED
 (SEE LANDSCAPING PLAN)
- 11) UNIT PAVERS
 - (11A) LIMESTONE SCREENING
 - (11B) SUBBASE GRANULAR MATERIAL TYPE B
- (12) PORTLAND CEMENT CONCRETE SIDEWALK, 5"
- 13 PORTLAND CEMENT CONCRETE SIDEWALK, 10" SPECIAL (SEE STRUCTURAL PLANS)
- (14) FENCE (SPECIAL)

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STATE OF ILLINOIS
DEPARTMENT OF TRANSPORTATION

					TYP	PIC	AL SECT	IONS
				ĺ	ELIV	IW	DOD AV	ENUE
SCALE:	N.T.S.	SHEET	NO.	8	OF	8	SHEETS	STA.

IL RTE 19

EXIL19		STAGE	(CU YD)			STAGE 2	(CU YD)			STAGE 3	(CU YD)			STAGE 4	(CU YD)		EARTHWORK BALA	ANCE WASTE (+) OF	R SHORTAGE (-) WIT	H 20% SHRINK
STATION	REMOVAL AND DISPOSAL OF UNSUITABLE MATERIAL	EARTH EXCAVATION	EMBANKMENT	AGGREGATE SUBGRADE IMPROVEMENT	REMOVAL AND DISPOSAL OF UNSUITABLE MATERIAL	EARTH EXCAVATION	EMBANKMENT	AGGREGATE SUBGRADE IMPROVEMENT	REMOVAL AND DISPOSAL OF UNSUITABLE MATERIAL	EARTH EXCAVATION	EMBANKMENT	AGGREGATE SUBGRADE IMPROVEMENT	REMOVAL AND DISPOSAL OF UNSUITABLE MATERIAL	EARTH EXCAVATION	EMBANKMENT	AGGREGATE SUBGRADE IMPROVEMENT	STAGE 1	STAGE 2	STAGE 3	STAGE 4
50+50.00	MATERIAL			Land and the same of the same													0.0	0.0	0.0	0.0
51+00.00	3.8	87.2	0.8	0.0	3.6	18.4	0.3	0.0	0.0	29.4	0.0	0.0	0.0	0.0	0.0	0.0	68.9	14.4	23.6	0.0
51+31.95	4.8	36.7	0.5	0.0	2.4	12.1	0.2	0.0	0.0	19.6	0.0	0.0	0.0	0.0	0.0	0.0	28.9	9.5	15.7	0.0
51+50.00	2.3	24.1	0.0	0.0	1.4	7.3	0.1	0.0	0.0	12.1	0.0	0.0	0.0	0.0	0.0	0.0	19.2	5.8	9.7	0.0
51+62.56	1.6	17.2	0.0	0.0	1.0	5.8	0.0	0.0	0.0	8.6	0.0	0.0	0.0	0.0	0.0	0.0	13.7	4.7	6.9	0.0
52+00.00	5.5	52.8	0.0	0.0	2.3	18.3	0.0	0.0	0.0	25.2	0.0	0.0	0,0	0.0	0.0	0.0	42.2	14.6	20.2	0.0
52+09.22	1.1	13.2	0.0	0.0	0.6	4.6	0.0	0.0	0.0	6.4	0.0	0.0	0.0	0.0	0.0	0.0	10.5	3.7	5.1	0.0
52+50.00	5.0	51.2	1.1	0.0	3.2	18.3	1.6	0.0	0.0	22.0	0.0	0.0	0.0	0.0	0.0	0.0	39.8	13.1	17.6	0.0
53+00.00	7.3	59.1	1.2	0.0	3.8	20.9	3.5	0.0	0.0	17.0	0.0	0.0	0.0	0.0	0.0	0.0	46.1	13.2	13.6	0.0
53+33.83	5.1	47.4	0.0	0.0	2.6	15.3	1.6	0.0	0.0	11.5	0.0	0.0	0.0	0.0	0.0	0.0	37.9	10.7	9.2	0.0
53+50.00	2.5	23.4	0.0	0.0	1.1	8.7	0.4	0.0	0.0	5.7	0.0	0.0	0.0	0.0	0.0	0.0	18.7	6.6	4.5 6.4	0.0
53+71.83	1.7	33.5	0.0	0.0	1.6	13.9	0.3	0.0	0.0	8.0	0.0	0.0	0.0	0.0	0.0	0.0	26.8 47.2	10.8	8.8	0.0
54+00.00	4.9	58.9	0.0	0.0	2.2	19.0	0.3	0.0	0.0	11.0	0.0	0.0	0.0	0.0	0.0	0.0	89.1	27.3	16.4	0.0
54+50.00	10.8	111.4	0.0	0.0	3.9	34.4	0.3	0.0	0.0	7.8	0.0	0.0	0.0	0.0	0.0	0.0	39.1	9.8	6.3	0.0
54+68.44	3.2	48.9	0.0	0.0	1.5	12.3	0.0	0.0	0.0	14.0	0.0	0.0	0.0	0.0	0.0	0.0	92.2	16.0	11.2	0.0
55+00.00	6.8	115.3	0.0	0.0	2.5	11.7	0.1	0.0	0.0	8.4	0.0	0.0	0.0	0.0	0.0	0.0	60.5	9.3	6.7	0.0
55+18.33	10.3	75.7 121.5	0.0	0.0	2.4	20.0	0.1	0.0	0.0	15.4	0.0	0.0	0.0	0.0	0.0	0.0	97.2	15.9	12.3	0.0
55+50.00 56+00.00	12.2	178.3	0.0	0.0	5.7	40.6	0.2	0.0	0.0	35.7	0.0	0.0	0.0	0.0	0.0	0.0	142.7	32.3	28.6	0.0
56+50.00	5.2	175.4	0.0	0.0	4.0	68.6	0.2	0.0	0.0	45.3	0.0	0.0	0.0	0.0	0.0	0.0	140.3	54.7	36.2	0.0
58+00.00	20.6	367.5	8.1	0.0	0.6	141.9	0.1	0.0	0.0	133.6	0.0	0.0	0.0	27.5	0.0	0.0	285.9	113.4	106.9	22.0
58+50.00	16.0	82.5	4,2	0.0	0.0	7.1	0.0	0.0	0.0	28.3	0.4	0.0	0.0	15.6	0.0	0.0	61.8	5.7	22.3	12.4
59+00.00	23.6	76.9	5.5	0.0	0.0	7.1	0.0	0.0	0.0	11.6	0.7	0.0	0.0	12.7	0.0	0.0	56.0	5.7	8.5	10.1
59+10.23	5.0	14.8	1.9	0.0	0.0	1.5	0.0	0.0	0.0	2.4	0.2	0.0	0.0	2.6	0.0	0.0	9.9	1.2	1.8	2.1
59+50.00	15.2	57.4	4.6	0.0	0.0	6.4	0.0	0.0	0.0	11.9	0.3	0.0	0.0	11.7	0.0	0.0	41.4	5.2	9.3	9.4
59+75.63	8.3	41.1	0.4	0.0	0.0	4.7	0.0	0.0	0.0	9.1	0.4	0.0	0.0	9.2	0.0	0.0	32.4	3.8	6.8	7.3
60+00.00	7.4	39.8	0.5	0.0	0.0	4.9	0.0	0.0	0.0	9.2	0.9	0.0	0.0	9.8	0.0	0.0	31.3	4.0	6.5	7.8
60+11.28	2.9	20.9	0.2	0.0	0.0	3.4	0.0	0.0	0.0	7.2	0.2	0.0	0.0	6.7	0.0	0.0	16.5	2.7	5.5	5.3
60+50.00	12.4	75.6	3.5	0.0	0.0	12.2	0.0	0.0	0.0	24.3	0.3	0.0	0.0	14.8	0.0	0.0	56.9	9.8	19.2	11.8
61+00.00	20.9	73.2	11.9	0.0	0.0	12.5	0.0	0.0	0.3	20.0	0.6	0.0	0.0	0.0	0.0	0.0	46.6	10.0	15.4	0.0
61+50.00	26.6	79.9	9.5	0.0	2.0	15.6	0.0	0.0	2.5	20.6	6.7	0.0	0.0	0.0	0.0	0.0	54.4	12.5	9.9	0.0
61+80.86	18.1	64.2	1.4	0.0	2.5	10.7	0.1	0.0	5.9	9.7	9.5	0.0	0.0	0.0	0.0	0.0	50.0	8.4	-1.8	0.0
62+00.00	11.1	40.1	0.6	0.0	1.5	4.9	0.4	0.0	5.5	6.9	7.4	0.0	0.0	0.0	0.0	0.0	31.5	3.5	-1.8	0.0
62+50.00	22.5	80.5	2.0	0.0	2.0	4.7	0.9	0.0	14.0	27.3	17.3	0.0	0.0	0.0	0.0	0.0	62.3	2.8	4.5	0.0
63+00.00	20.1	62.4	4.2	0.0	0.0	4.8	0.0	0.0	6.9	30.0	7.0	0.0	0.0	0.0	0.0	0.0	45.8	3.8	17.0	0.0
63+50.00	16.5	59.0	4.4	0.0	0.0	10.0	0.0	0.0	0.0	31.6	0.7	0.0	0.0	0.0	0.0	0.0	42.7	3.0	7.4	0.0
63+65.45	2.5	16.5	0.7	0.0	0.1	3.8	0.0	0.0	0.0	11.2	1.5	0.0	0.0	0.0	0.0	0.0	12.5	6.6	9.0	0.0
64+00.00	4.0	45.3	1.2	0.0	0.2	8.3	0.0	0.0	0.0	14.8	7.1	0.0	0.0	0.0	0.0	0.0	72.1	8.1	4.7	0.0
64+50.00	5.9	91.1	0.7	0.0	0.0	5.3	0.0	0.0	0.0	17.6	3.4	0.0	0.0	0.0	0.0	0.0	101.4	4.2	10.6	0.0
65+00.00	7.5	128.1	1.1	0.0	0.0	0.0	0.0	0.0	0.0	40.3	0.5	0.0	0.0	0.0	0.0	0.0	125.7	0.0	31.8	0.0
65+50.00 66+00.00	10.8	187.0	0.8	0.0	0.0	0.0	0.0	0.0	0.0	68.1	0.0	0.0	0.0	0.0	0.0	0.0	148.8	0.0	54.5	0.0
66+23.74	3.2	116.7	0.1	0.0	0.0	0.0	0.0	0.0	0.0	37.5	0.0	0.0	0.0	0.0	0.0	0.0	93.2	0.0	30.0	0.0
66+50.00	7.0	119.0	0.0	0.0	0.0	5.8	0.0	0.0	0.0	45.3	0.0	0.0	0.0	0.0	0.0	0.0	95.2	4.6	36.2	0.0
67+00.00	11.9	167.2	0.0	0.0	0.0	21.5	0.0	0.0	0.0	88.1	0.0	0.0	0.0	0.0	0.0	0.0	133.8	17.2	70.5	0.0
67+50.00	5.9	153.2	0.0	0.0	0.0	20.3	0.0	0.0	0.0	84.7	0.0	0.0	0.0	0.0	0.0	0.0	122.6	16.2	67.8	0.0
68+00.00	6.3	132.4	0.0	0.0	0.0	17.3	0.0	0.0	0.0	63.9	0.0	0.0	0.0	0.0	0.0	0.0	105.9	13.8	51.1	0.0
68+12.89	2.1	26.5	0.0	0.0	0.5	4.9	0.0	0.0	0.0	12.5	0.0	0.0	0.0	0.0	0.0	0.0	21.2	3.9	10.0	0.0
68+50.00	5.1	66.2	0.1	0.0	2.3	22.2	0.1	0.0	0.0	39.6	0.0	0.0	0.0	0.0	0.0	0.0	52.8	17.7	31.7	0.0
68+65.41	1.0	29.7	0.0	0.0	0.4	7.2	0.1	0.0	0.0	13.8	0.0	0.0	0.0	0.0	0.0	0.0	23.8	5.7	11.0	0.0
69+00.00	2.2	61.6	0.0	0.0	0.8	13.5	0.2	0.0	0.0	27.8	0.0	0.0	0.0	0.0	0.0	0.0	49.2	10.6	22.2	0.0
69+50.00	4.3	73.9	0.0	0.0	2.7	24.2	0.1	0.0	0.0	50.4	0.0	0.0	0.0	0.0	0.0	0.0	59.1	19.2	40.3	0.0
69+62.61	2.4	15.3	0.0	0.0	0.6	4.9	0.1	0.0	0.0	14.4	0.0	0.0	0.0	0.0	0.0	0.0	12.2	3.9	11.5	0.0
70+00.00	7.8	33.2	0.4	0.0	1.8	14.0	0.7	0.0	0.0	47.2	0.0	0.0	0.0	0.0	0.0	0.0	26.1	10.5	37.8	0.0
70+50.00	8.8	38.2	0.4	0.0	1.5	19.9	0.8	0.0	0.0	74.0	0.0	0.0	0.0	0.0	0.0	0.0	30.2	15.1	59.2	0.0
TOTALS:	455.7	4227.0	74.0	0.0	66.4	825.9	12.8	0.0	35.0	1477.0	70.9	0.0	0.0	110.5	0.0	0.0	3307.6	647.9	1110.7	88.4

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PROJECT CONTACT:
CLENT:
CLENT:
CABE PLOTTED: #DATE\$
PLOT DRIVER:
PEN TABLE: stando

HRGreen.com

| Illinois Professional Design |
| 184-001322

USER NAME = Jhorwit	DESIGNED -	JRM	REVISED -	
FILE NAME = 023_sch.dgn	DRAWN -	JCH	REVISED -	
PLOT SCALE = N.T.S.	CHECKED -	DTH	REVISED -	
PLOT DATE = 2/19/2015	DATE -	2/2/2015	REVISED -	

STATE	OF	ILLINOIS	
DEPARTMENT	0F	TRANSPORTATION	

Ī			SI	CHEC	ULE	OF QU	ANTITIES		F.A.U. RTE.	SECTION NO.	COUNTY	TOTAL	SHEET NO.
				111	INO	IS ROUT	TF 19		1321	11-00048-00-SP	DUPAGE	277	20
				11.1	.1140	10 1100	15				CONTRACT	NO.	63872
	SCALE:	N.T.S.	SHEET NO.	1 OF	2	SHEETS	STA.	TO STA.	FED. ROAD	D DIST. NO. ILLINOIS FED.	AID PROJECT		

SOUTH WOOD DALE ROAD

EXWD		STAGE	1 (CU YD)			STAGE 2	2 (CU YD)			STAGE :	(CU YD)			STAGE 4	(CU YD)		EARTHWORK BAL	ANCE WASTE (+) OF	SHORTAGE (-) WIT	H 20% SHRINKAG
STATION	REMOVAL AND DISPOSAL OF UNSUITABLE MATERIAL	EARTH EXCAVATION	EMBANKMENT	AGGREGATE SUBGRADE IMPROVEMENT	REMOVAL AND DISPOSAL OF UNSUITABLE MATERIAL	EARTH EXCAVATION	EMBANKMENT	AGGREGATE SUBGRADE IMPROVEMENT	REMOVAL AND DISPOSAL OF UNSUITABLE MATERIAL	EARTH EXCAVATION	EMBANKMENT	AGGREGATE SUBGRADE IMPROVEMENT	REMOVAL AND DISPOSAL OF UNSUITABLE MATERIAL	EARTH EXCAVATION	EMBANKMENT	AGGREGATE SUBGRADE IMPROVEMENT	STAGE 1	STAGE 2	STAGE 3	STAGE 4
102+00.00																	0.0	0.0	0.0	0.0
102+50.00	11.5	73.7	0.4	0.0	0.0	78.1	0.0	0.0	24.6	234.0	1.3	0.0	0.0	0.0	0.0	0.0	58.6	62.4	185.9	0.0
103+00.00	6.7	64.8	1.7	0.0	0.0	63.2	0.0	0.0	19.4	200.4	2.4	0.0	0.0	0.0	0.0	0.0	50.2	50.6	157.9	0.0
103+31.75	1.3	25.5	2.8	0.0	0.0	27.4	0.0	0.0	5.3	142.3	3.1	0.0	0.0	0.0	0.0	0.0	17.5	21.9	110.8	0.0
103+50.00	2.4	13.5	1.9	0.0	0.0	13.6	0.0	0.0	2.5	79.2	2.2	0.0	0.0	0.0	0.0	0.0	8.9	10.9	61.1	0.0
103+80.97	3.5	30.1	1.4	0.0	0.0	18.5	0.0	0.0	4.4	77.8	3.2	0.0	0.0	0.0	0.0	0.0	22.7	14.8	59.0	0.0
104+00.00	2.1	21.9	0.1	0.0	0.0	10.6	0.0	0.0	2.7	44.7	1.2	0.0	0.0	0.0	0.0	0.0	17.4	8.5	34.6	0.0
104+10.20	1.2	10.5	0.1	0.0	0.0	6.8	0.0	0.0	1.2	24.3	0.3	0.0	0.0	0.0	0.0	0.0	8.3	5.5	19.1	0.0
104+50.00	4.6	42.9	0.3	0.0	0.0	29.4	0.0	0.0	4.6	102.1	1.3	0.0	0.0	0.0	0.0	0.0	34.0	23.5	80.3	0.0
104+91.50	9.5	45.7	0.3	0.0	0.0	30.6	0.0	0.0	10.7	108.5	1.8	0.0	0.0	0.0	0.0	0.0	36.2	24.5	85.0	0.0
105+00.00	2.0	8.5	0.1	0.0	0.0	5.9	0.0	0.0	2.3	20.9	0.4	0.0	0.0	0.0	0.0	0.0	6.7	4.7	16.3	0.0
105+50.00	11.4	42.0	1.9	0.0	0.0	29.8	0.0	0.0	18.2	105.6	5.4	0.0	0.0	0.0	0.0	0.0	31.7	23.9	79.1	0.0
106+00.00	11.3	33.3	1.9	0.0	0.0	22.0	0.0	0.0	24.0	112.1	5.1	0.0	0.0	0.0	0.0	0.0	24.7	17.6	84.6	0.0
106+38.17	4.3	25.7	0.6	0.0	0.0	13.5	0.0	0.0	15.1	82.5	5.2	0.0	0.0	0.0	0.0	0.0	20.0	10.8	60.8	0.0
106+50.00	1.3	7,3	0.5	0.0	0.0	4.1	0.0	0.0	4.7	18.6	2.4	0.0	0.0	0.0	0.0	0.0	5.3	3.3	12.4	0.0
107+00.00	11.1	35.3	2.3	0.0	0.0	22.3	0.0	0.0	22.3	103.7	5.6	0.0	0.0	0.0	0.0	0.0	25.9	17.9	77.4	0.0
107+08.62	1.9	8.0	0.2	0.0	0.0	4.8	0.0	0.0	3.8	23.2	0.4	0.0	0.0	0.0	0.0	0.0	6.2	3.8	18.2	0.0
107+29.72	4.7	21.5	0.4	0.0	0.0	13.5	0.0	0.0	9.9	58.3	1.0	0.0	0.0	0.0	0.0	0.0	16.8	10.8	45.7	0.0
107+50.00	4.5	24.3	0.2	0.0	0.0	14.6	0.0	0.0	9.5	61.1	0.8	0.0	0.0	0.0	0.0	0.0	19.2	11.7	48.1	0.0
108+00.00	11.0	71.6	0.4	0.0	0.0	42.0	0.0	0.0	23.5	193.6	1.4	0.0	0.0	0.0	0.0	0.0	56.9	33.6	153.5	0.0
108+31.55	6.8	50.0	0.2	0.0	0.0	31.5	0.0	0.0	14.5	150.5	0.6	0.0	0.0	0.0	0.0	0.0	39.7	25.2	119.8	0.0
108+50.00	3.8	30.5	0.1	0.0	0.0	19.7	0.0	0.0	7.7	89.2	0.4	0.0	0.0	0.0	0.0	0.0	24.2	15.8	71.0	0.0
109+00.00	9.8	88.5	0.4	0.0	0.0	57.3	0.0	0.0	25.6	241.7	11.7	0.0	0.0	0.0	0.0	0.0	70.4	45.9	181.7	0.0
109+15.99	3.0	29.4	0.1	0.0	0.0	19.2	0.0	0.0	11.6	78.9	7.2	0.0	0.0	0.0	0.0	0.0	23.4	15.4	55.9	0.0
109+50.00	5.9	64.7	0.3	0.0	0.0	40.6	0.0	0.0	27.7	177.9	18.6	0.0	0.0	0.0	0.0	0.0	51.5	32.4	123.8	0.0
110+39.83	7.3	146.4	0.7	0.0	0.0	82.2	0.0	0.0	52.6	406.4	38.4	0.0	0.0	0.0	0.0	0.0	116.4	65.7	286.7	0.0
110+50.00	0.0	12.3	0.1	0.0	0.0	7.8	0.0	0.0	2.9	32.7	1.7	0.0	0.0	0.0	0.0	0.0	9.8	6.3	24.5	0.0
110+94.99	3.4	51.0	0.7	0.0	0.0	34.4	0.0	0.0	15.8	157.3	7.8	0.0	0.0	0.0	0.0	0.0	40.0	27.5	118.0	0.0
111+00.00	0.5	5.5	0.1	0.0	0.0	4.0	0.0	0.0	2.2	20.9	1.2	0.0	0.0	0.0	0.0	0.0	4.3	3.2	15.5	0.0
111+50.00	5.4	63.1	0.9	0.0	0.0	41.9	0.0	0.0	30.7	141.5	24.6	0.0	0.0	13.3	0.0	0.0	49.5	33.6	88.6	10.7
111+78.40	4.4	39.7	0.2	0.0	0.0	28.7	0.0	0.0	11.8	40.0	10.3	0.0	0.0	15.9	0.0	0.0	31.6	23.0	21.7	12.7
112+00.00	3.3	28.6	0.2	0.0	0.0	29.0	0.0	0.0	0.9	26.8	0.1	0.0	0.0	12.8	0.0	0.0	22.7	23.2	21.4	10.2
112+16.53	2.6	22.8	0.1	0.0	0.0	22.7	0.0	0.0	1.8	19.5	0.1	0.0	0.0	9.2	0.0	0.0	18.2	18.2	15.5	7.4
112+36.10	3.1	29.1	0.0	0.0	0.0	27.1	0.0	0.0	2.5	26.1	0.0	0.0	0.0	10.0	0.0	0.0	23.2	21.7	20.9	8.0
112+50.00	1.9	18.8	0.1	0.0	0.0	19.3	0.0	0.0	1.3	14.2	0.1	0.0	0.0	6.9	0.0	0.0	15.0	15.5	11.3	5.5
112+81.49	4.5	37.4	0.2	0.0	0.0	42.6	0.0	0.0	3.2	29.0	0.2	0.0	0.0	14.9	0.0	0.0	29.7	34.1	23.1	11.9
113+00.00	3.1	21.9	0.1	0.0	0.0	23.4	0.0	0.0	1.2	27.4	0.0	0.0	0.0	8.6	0.0	0.0	17.4	18.8	21.9	6.9
TOTALS:	175.1	1345,6	22.1	0.0	0,0	982.4	0.0	0.0	422.7	3473.1	167,5	0.0	0.0	91.6	0.0	0.0	1054.4	785.9	2611.0	73.3

NORTH WOOD DALE ROAD

EXWD		STAGE 1	(CU YD)			STAGE 2	(CU YD)			STAGE :	3 (CU YD)		EARTHWORK BALANCE WASTE (+) OR SHORTAGE (-) WITH 20% SHRINKAGE		
STATION	REMOVAL AND DISPOSAL OF UNSUITABLE MATERIAL	EARTH EXCAVATION	EMBANKMENT	AGGREGATE SUBGRADE IMPROVEMENT	REMOVAL AND DISPOSAL OF UNSUITABLE MATERIAL	EARTH EXCAVATION	EMBANKMENT	AGGREGATE SUBGRADE IMPROVEMENT	REMOVAL AND DISPOSAL OF UNSUITABLE MATERIAL	EARTH EXCAVATION	EMBANKMENT	AGGREGATE SUBGRADE IMPROVEMENT	STAGE 1	STAGE 2	STAGE 3
114+50.00													0.0	0.0	0.0
114+75.95	9.3	116.2	8.7	0.0	0.0	0.0	0.0	0.0	0.0	0.0	0.0	0.0	84.2	0.0	0.0
115+00.00	18.9	213.1	1.6	0.0	0.0	0.0	0.0	0.0	0.0	0.0	0.0	0.0	168.9	0.0	0.0
115+22.53	16.4	220.3	0.8	0.0	0.0	0.0	0.0	0.0	0.0	0.0	0.0	0.0	175.5	0.0	0.0
115+37.07	6.0	126.9	0.9	0.0	0.0	0.0	0.0	0.0	0.0	0.0	0.0	0.0	100.7	0.0	0,0
115+50.00	4.1	126.0	1.1	0.0	0.0	0.0	0.0	0.0	0.0	0.0	0.0	0.0	99.7	0.0	0.0
116+00.00	18.9	439.7	5.8	0.0	0.0	0.0	0.0	0.0	0.0	0.0	0.0	0.0	345.9	0.0	0.0
116+50.00	23.3	407.5	9.4	0.0	0.0	0.0	0.0	0.0	0.0	0.0	0.0	0.0	316.6	0.0	0.0
116+73.97	13.8	215.9	5.5	0.0	0.0	0.0	0.0	0.0	0.0	0.0	0.0	0.0	167.3	0.0	0.0
117+00.00	21.3	233.6	6.2	0.0	0.0	0.0	0.0	0.0	0.0	0.0	0.0	0.0	180.7	0.0	0.0
117+50.00	38.1	377.4	18.2	0.0	0.0	0.0	0.0	0.0	0.0	0.0	0.0	0.0	283.7	0.0	0.0
118+00.00	12.3	264.9	12.8	0.0	0.0	34.4	2.2	0.0	0.0	50.0	0.0	0.0	199.1	25.3	40.0
118+50.00	6.2	213.6	3.0	0.0	0.0	82.5	2.2	0.0	2.4	88.1	0.2	0.0	167.9	63.8	70.3
119+00.00	8.5	246.9	2.1	0.0	0.0	86.9	0.0	0.0	4.7	84.1	0.4	0.0	195.4	69.6	66.9
119+50.00	4.8	250.5	1.0	0.0	0.0	80.0	0.0	0.0	4.8	90.3	0.5	0.0	199.4	64.0	71.8
120+00.00	6.1	232.1	2.8	0.0	0.0	76.2	0.0	0.0	5.2	101.0	0.3	0.0	182.9	61.0	80.5
120+27.27	4.3	118.4	1.1	0.0	0.0	41.3	0.0	0.0	4.2	50.8	0.1	0.0	93.7	33.0	40.5
120+50.00	3.7	83.5	0.0	0.0	0.0	35.3	0.0	0.0	2.4	35.9	0.1	0.0	66.8	28.3	28.6
121+00.00	6,7	116.6	1.8	0.0	0.0	72.6	0.0	0.0	0.4	78.9	0.1	0.0	91.5	58.1	63.0
121+50.00	6.3	76.8	1.9	0.0	0.0	67.0	0.0	0.0	0.2	65.0	0.1	0.0	59.6	53.6	51.9
121+75.54	3.7	40.9	0.0	0.0	0.0	31.5	0.0	0.0	0.0	31.5	0.1	0.0	32.6	25.2	25.1
122+00.00	3.5	34.8	0.4	0.0	0.0	28.9	0.0	0.0	1.8	30.9	0.1	0.0	27.4	23.1	24.7
122+50.00	7.2	72.2	0.8	0.0	0.0	59.3	0.0	0.0	7.1	54.0	0.0	0.0	56.9	47.4	43.2
123+00.00	7.2	76.2	1.4	0.0	0.0	64.2	0.0	0.0	7.0	50.1	0.2	0.0	59.6	51.3	39.9
TOTALS:	250.7	4303.8	87.2	0.0	0.0	759.9	4.4	0.0	40,2	810.5	2.0	0.0	3355.9	603.5	646.4

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					1	wn	nn	DALE I	ROAD		1321	11-0004	18-00-SP	DUPAGE	277	21
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COMMERCIAL STREET

РСОМ		STAGE 1	(CU YD)		EARTHWORK BALANCE WASTE (+) OR SHORTAGE (-) WITH 20% SHRINKAGE
STATION	REMOVAL AND DISPOSAL OF UNSUITABLE MATERIAL	EARTH EXCAVATION	EMBANKMENT	AGGREGATE SUBGRADE IMPROVEMENT	STAGE 1
300+25.00				II	0.0
300+50.00	0.0	57.5	0.0	0.0	46.0
300+75.00	0.0	67.2	0.0	0.0	53.7
301+00.00	0.0	67.6	0.0	0.0	54.1
301+25.00	0.0	89.1	0.0	0.0	71.3
301+50.00	0.0	113.7	0.0	0.0	91.0
301+75.00	0.0	108.7	0.0	0.0	86.9
302+00.00	0.0	99.9	0.0	0.0	79.9
302+25.00	0.0	88.6	0.0	0.0	70.9
302+50.00	0.0	77.2	0.0	0.0	61.7
302+75.00	0.0	68.4	0.0	0.0	54.7
303+00.00	0.0	57.0	0.1	0.0	45.5
303+50.00	0.0	85.5	1.9	0.0	66.4
304+00.00	0.0	75.0	3.6	0.0	56.4
304+50.00	0.0	116.6	1.9	0.0	91.4
TOTALS:	0.0	1172.0	7.6	0.0	930,0

DIVISION STREET

EXDIV	STAGE 1 (CU YD)				STAGE 2 (CU YD)			STAGE 3 (CU YD)				EARTHWORK BALANCE WASTE (+) OR SHORTAGE (-) WITH 20% SHRINKAGE			
	REMOVAL AND DISPOSAL OF UNSUITABLE MATERIAL	EARTH EXCAVATION	EMBANKMENT	AGGREGATE SUBGRADE IMPROVEMENT	REMOVAL AND DISPOSAL OF UNSUITABLE MATERIAL	EARTH EXCAVATION	EMBANKMENT	AGGREGATE SUBGRADE IMPROVEMENT	REMOVAL AND DISPOSAL OF UNSUITABLE MATERIAL	EARTH EXCAVATION	EMBANKMENT	AGGREGATE SUBGRADE IMPROVEMENT	STAGE 1	STAGE 2	STAGE 3
200+50.00													0.0	0.0	0.0
201+00.00	11.3	97.1	10.5	0.0	0.0	21.3	0.0	0.0	8.2	84.5	6.2	0.0	67.2	17.0	61.4
201+24.94	3.8	37.9	2.8	0.0	0.0	7.1	0.0	0.0	1.7	21.8	1.2	0.0	27.5	5.7	16.2
201+50.00	3.9	33.9	2.6	0.0	0.0	7.1	0.0	0.0	0.9	18.4	0.6	0.0	24.5	5.6	14.1
202+00.00	4.6	60.2	3.2	0.0	0.0	17.7	0.0	0.0	1.8	37.5	1.1	0.0	44.9	14.1	28.9
202+50.00	0.0	53.5	0.0	0.0	0.0	20.3	0.0	0.0	0.0	40.8	0.0	0.0	42.8	16.2	32.7
203+00.00	0.0	40.4	0.0	0.0	0.0	17.3	0.0	0.0	0.0	35.2	0.0	0.0	32.3	13.9	28.1
203+24.51	0.0	25.9	0.0	0.0	0.0	8.0	0.0	0.0	0.0	16.5	0.0	0.0	20.7	6.4	13.2
203+50.00	0.0	29.3	0.0	0.0	0.0	10.0	0.0	0.0	0.0	17.4	0.0	0.0	23.4	8.0	13.9
204+00.00	0.0	28.2	0.0	0.0	0.0	21.4	0.0	0.0	0.0	30.4	0.0	0.0	22.6	17.1	24.3
TOTALS:	23.6	406.4	19.2	0.0	0.0	130.1	0.0	0.0	12.6	302.4	9.1	0.0	305.9	104.1	232.8

EARTHWORK SUMMARY

				CROS	S SECTION E	BASED		
ITEM NO.	CODE	DESCRIPTION	COMMERCIAL	DIVISION	IL 19	WOOD DALE NORTH	WOOD DALE SOUTH	TOTAL
1	20200100	EARTH EXCAVATION	1,172.0	839.0	6,640.4	5,874.3	5,892.7	20,418.3
2	20201200	REMOVAL AND DISPOSAL OF UNSUITABLE MATERIAL	0.0	36.2	557.1	290.9	597.8	1,481.9
3	20400800	FURNISHED EXCAVATION	0.0	0.0	0.0	0.0	0.0	0.0
4	30300001	AGGREGATE SUBGRADE IMPROVEMENT	0.0	0.0	0.0	0.0	0.0	0.0


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SCHEDULE OF QUANTITIES						F.A.U. RTE.	SECTION NO.	COUNTY	TOTAL	SHEET NO.
10	COMMERCIAL ST, DIVISION ST AND SUMMARY						1321 11-00048-00-SP		277	22
1								CONTRACT	NO.	63872
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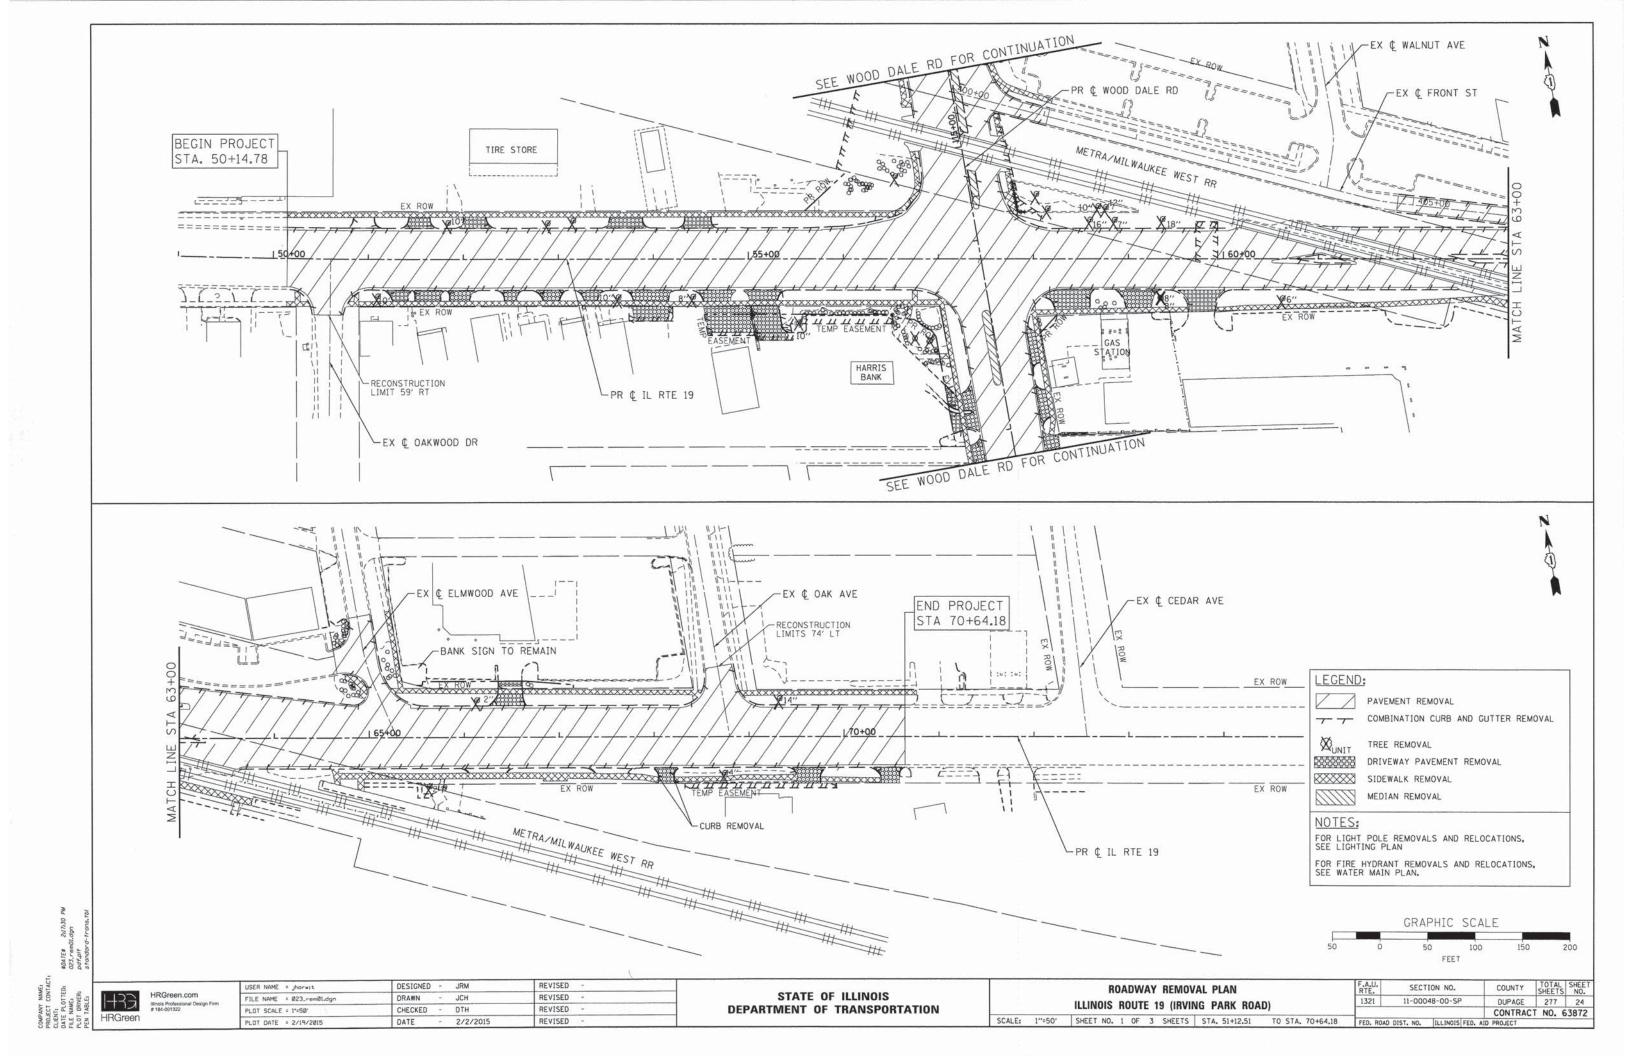
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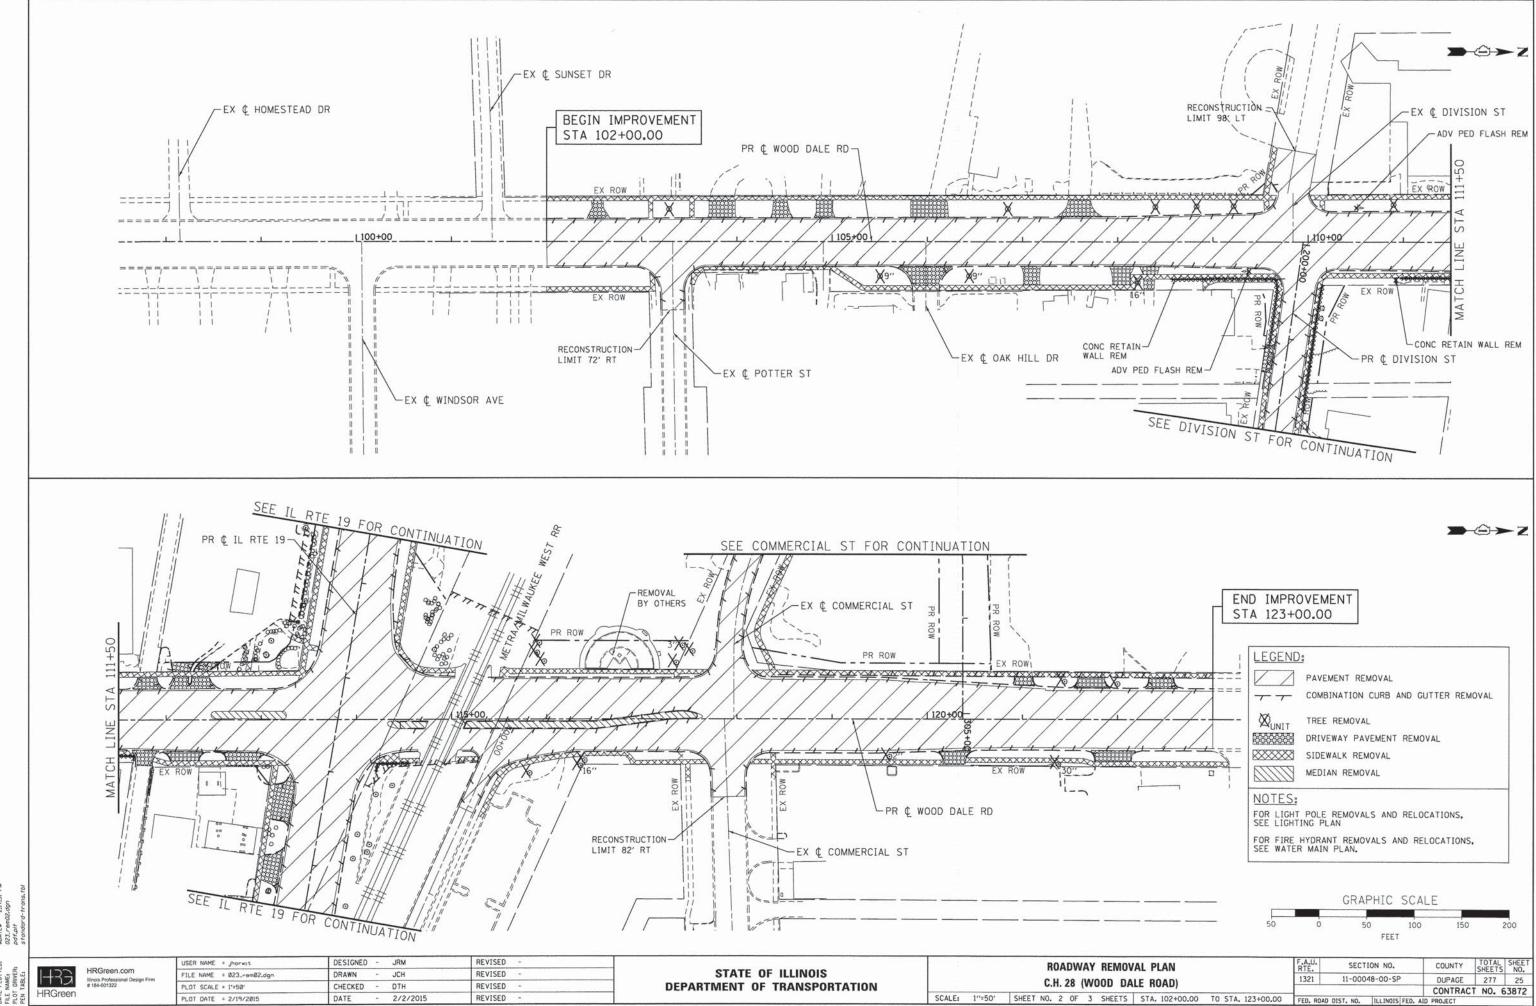
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DEPARTMENT OF TRANSPORTATION


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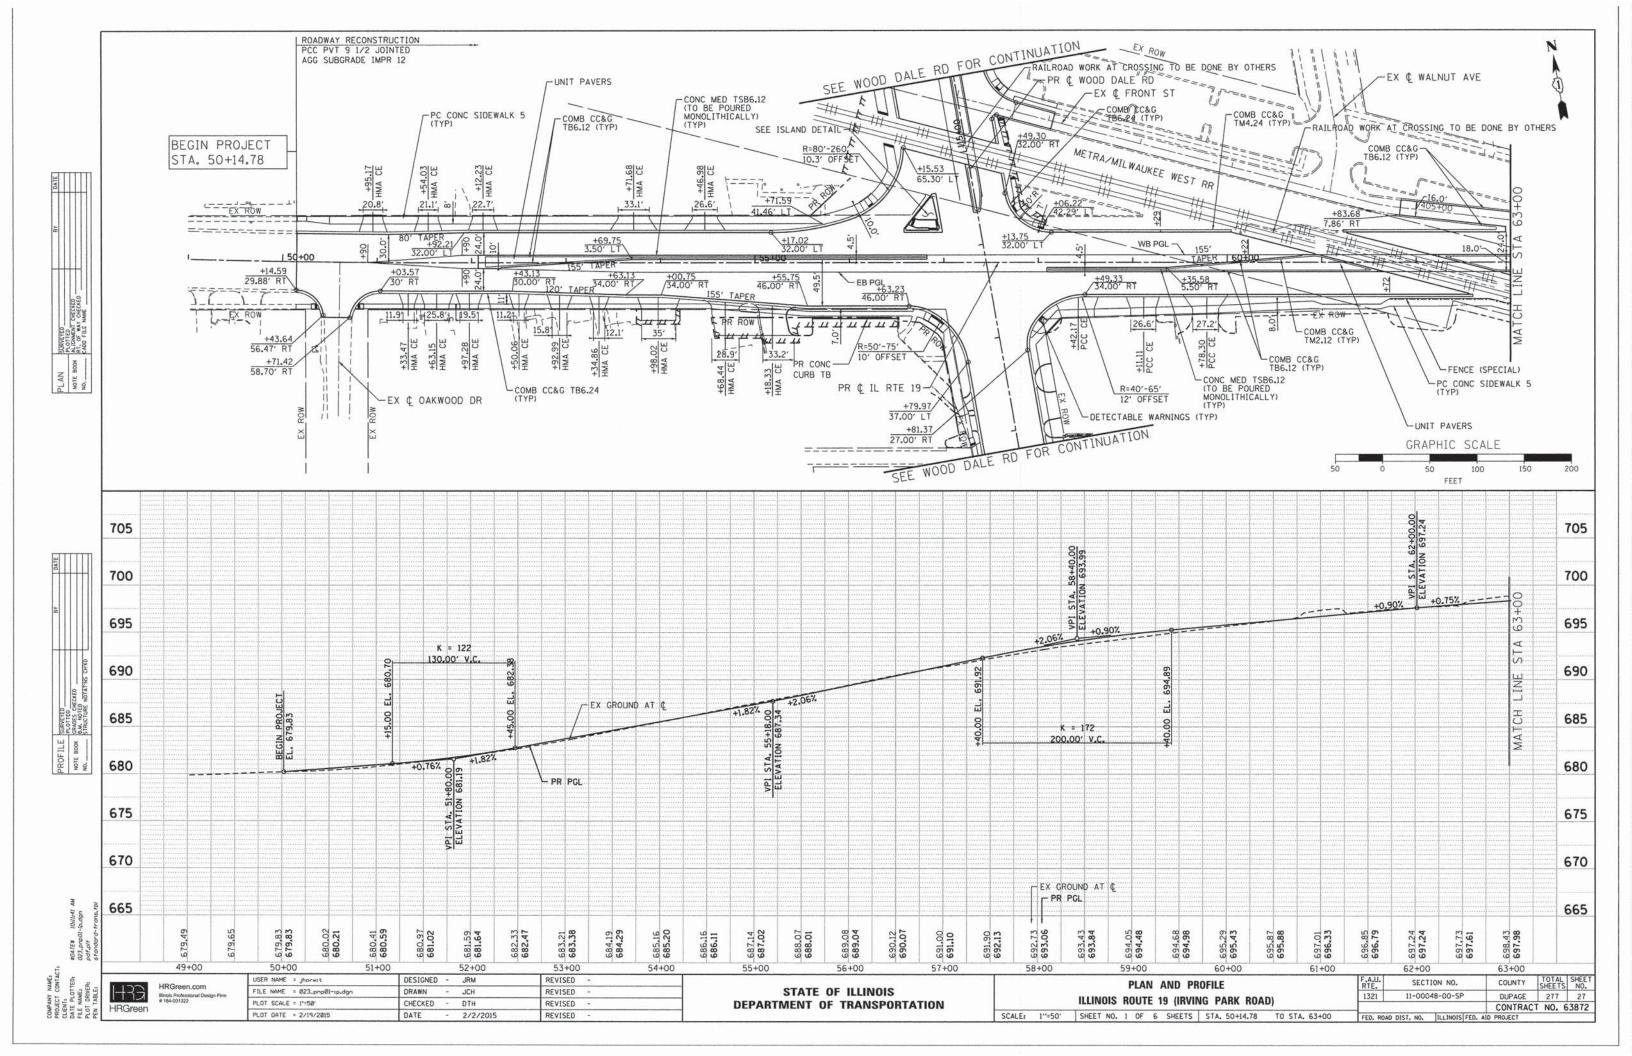
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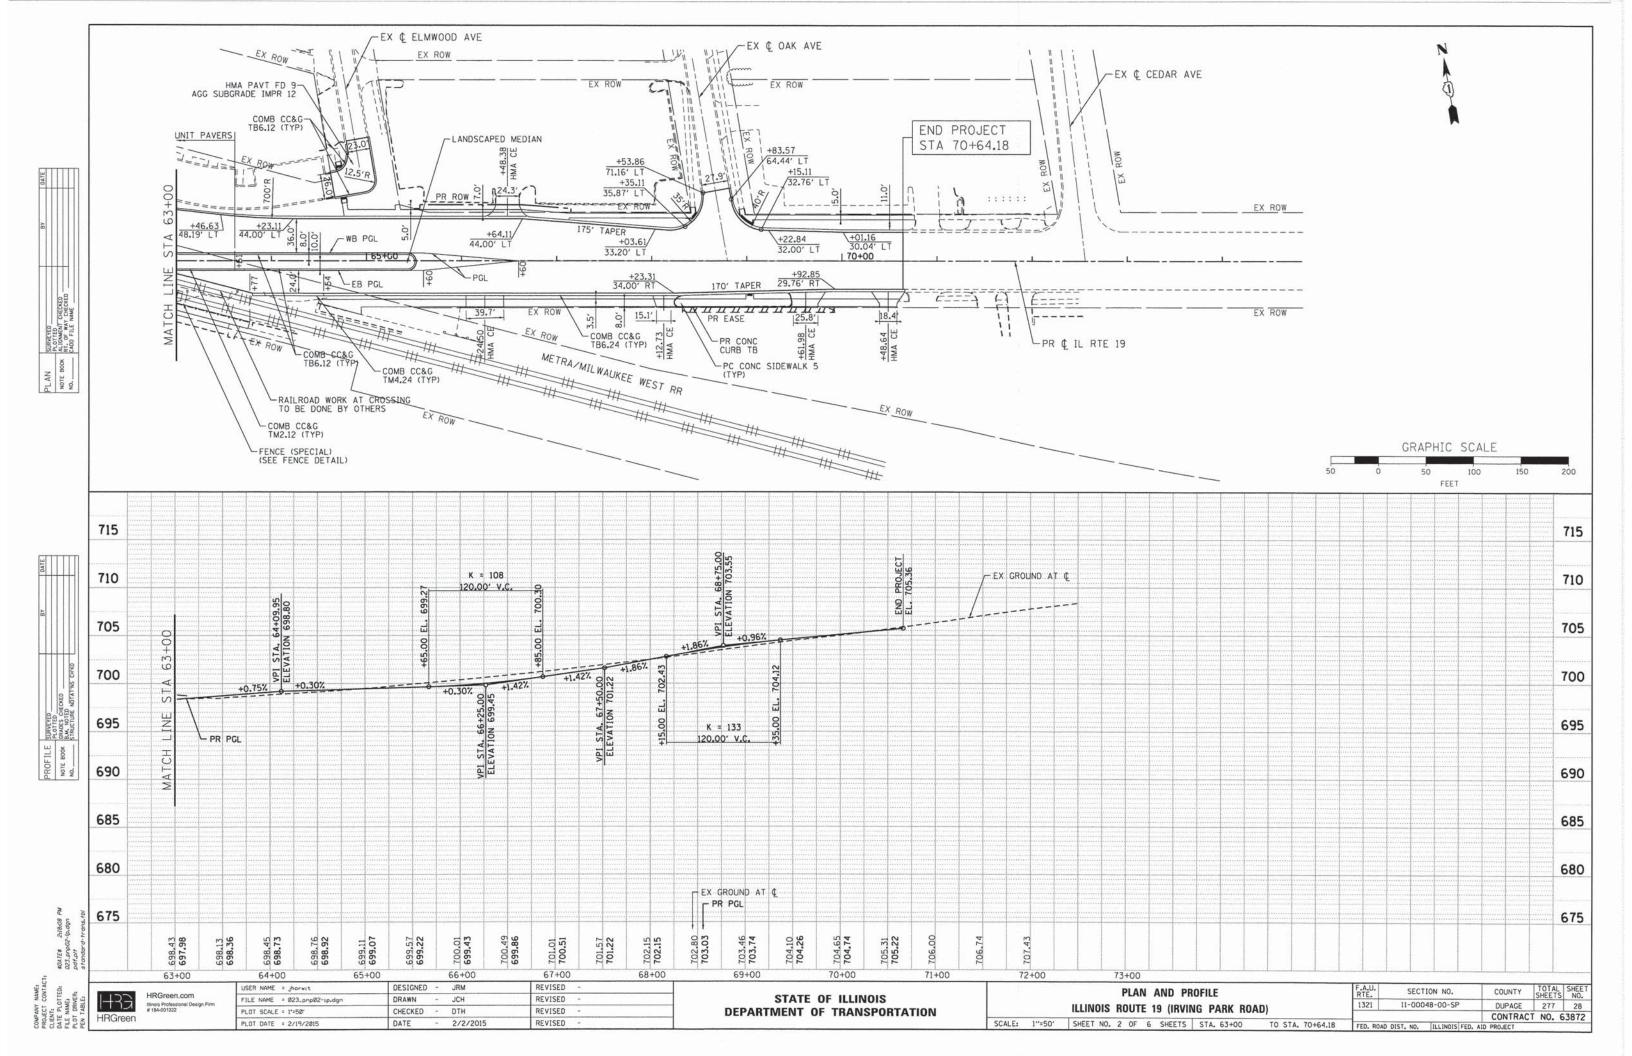






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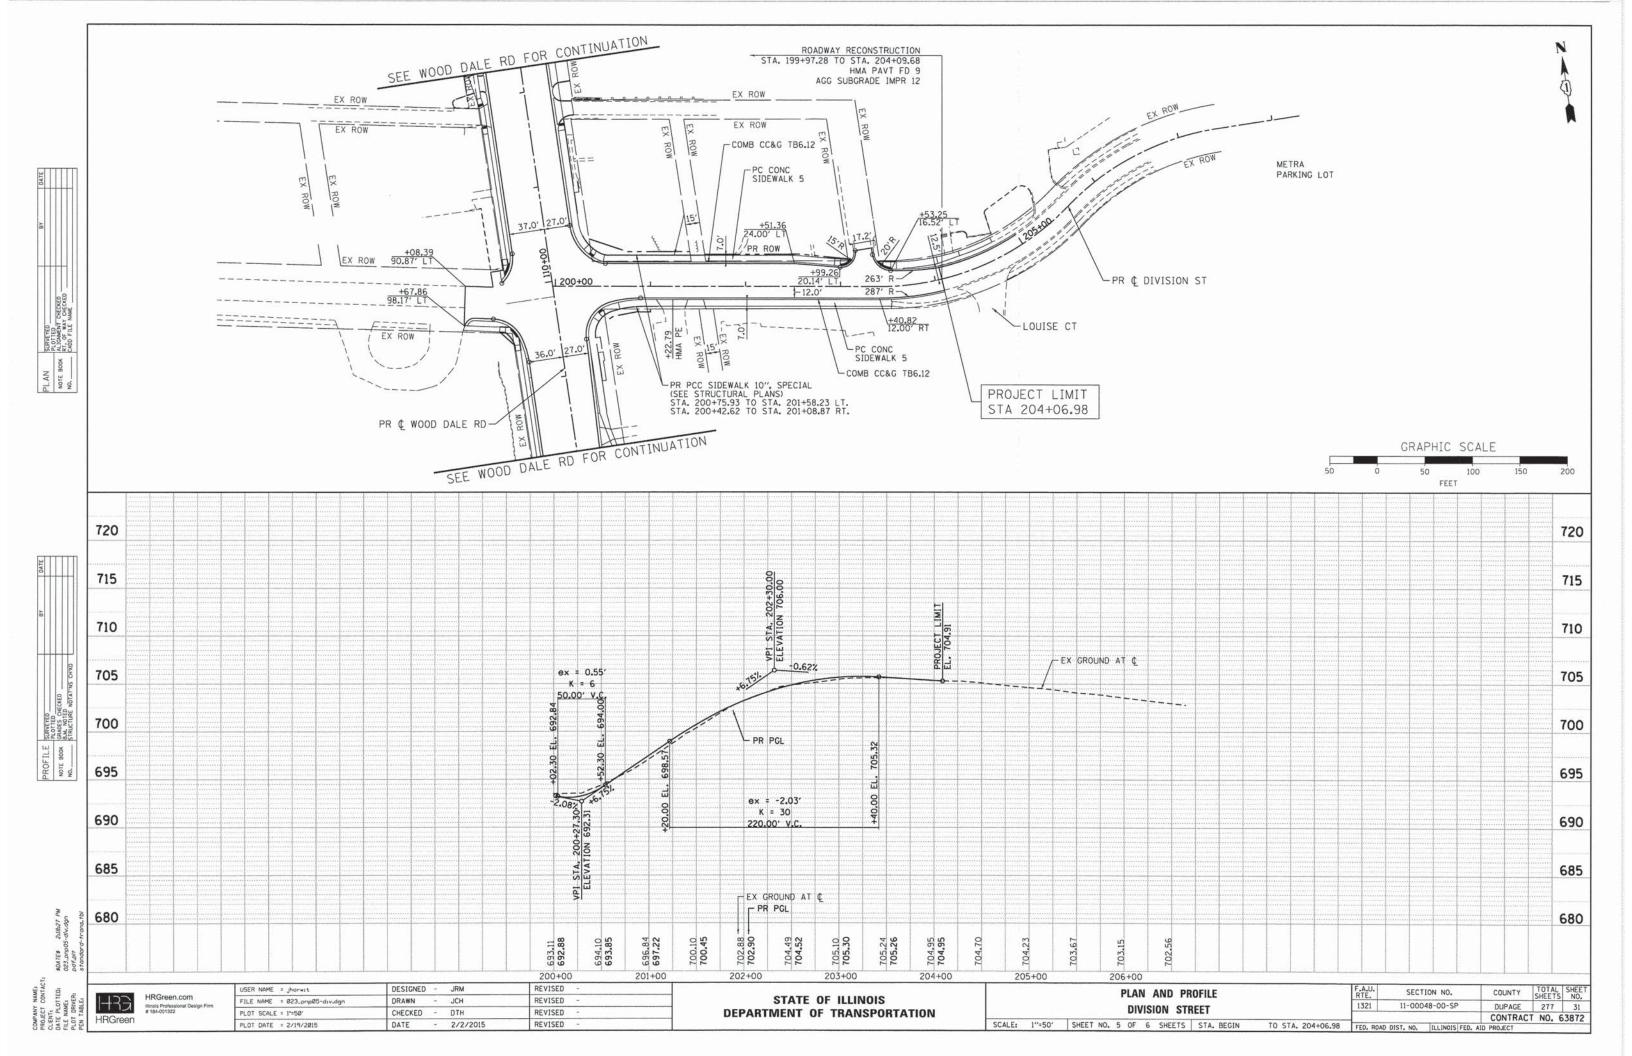





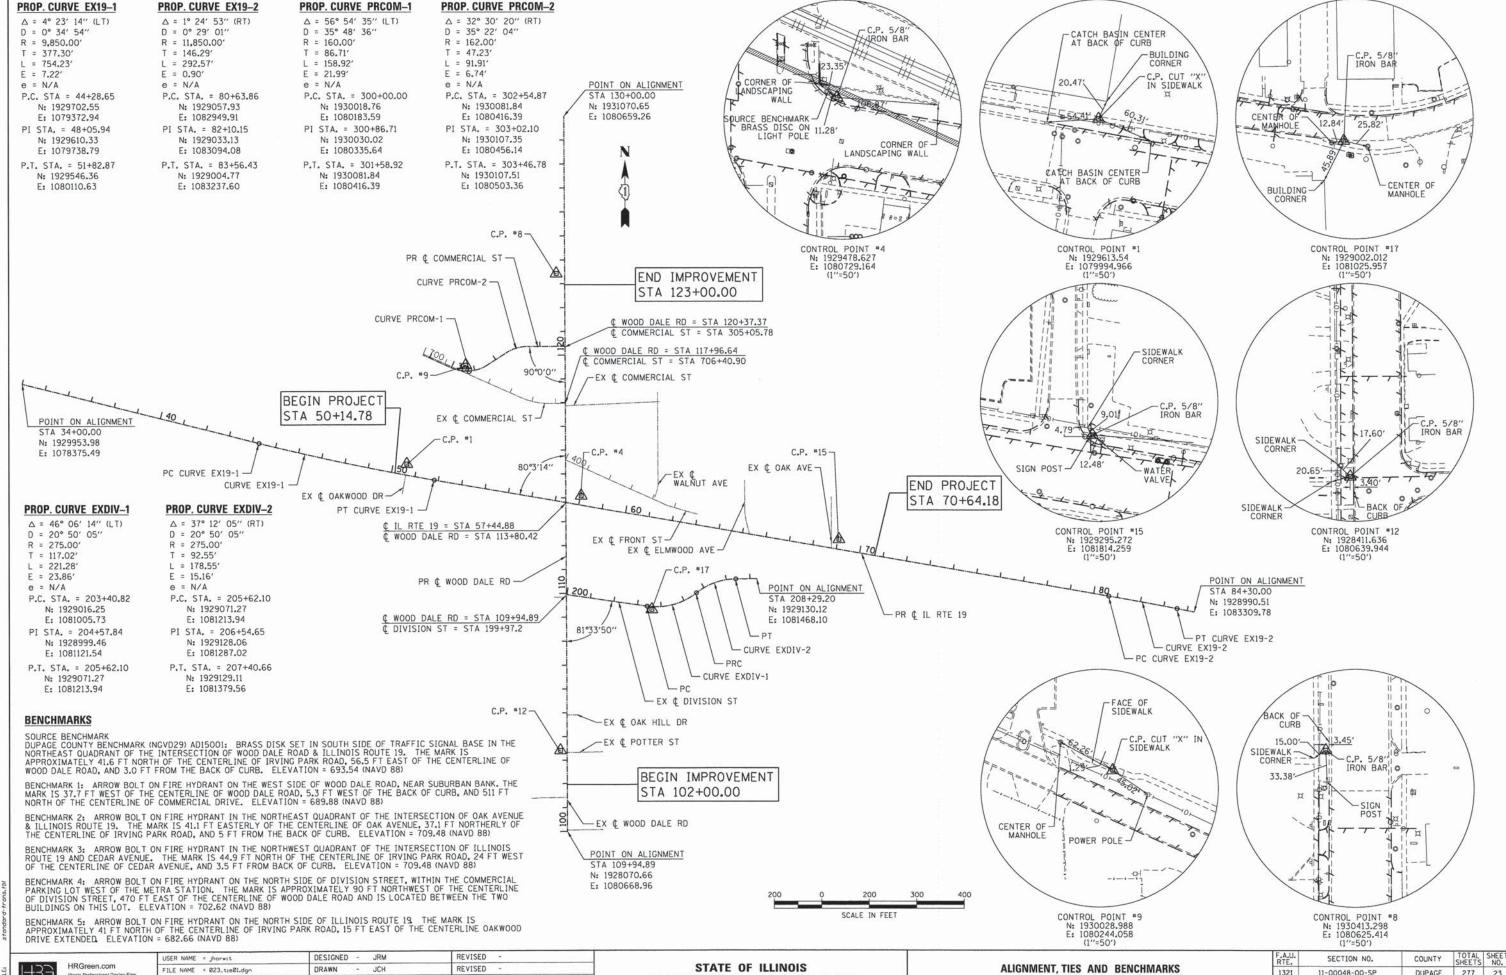

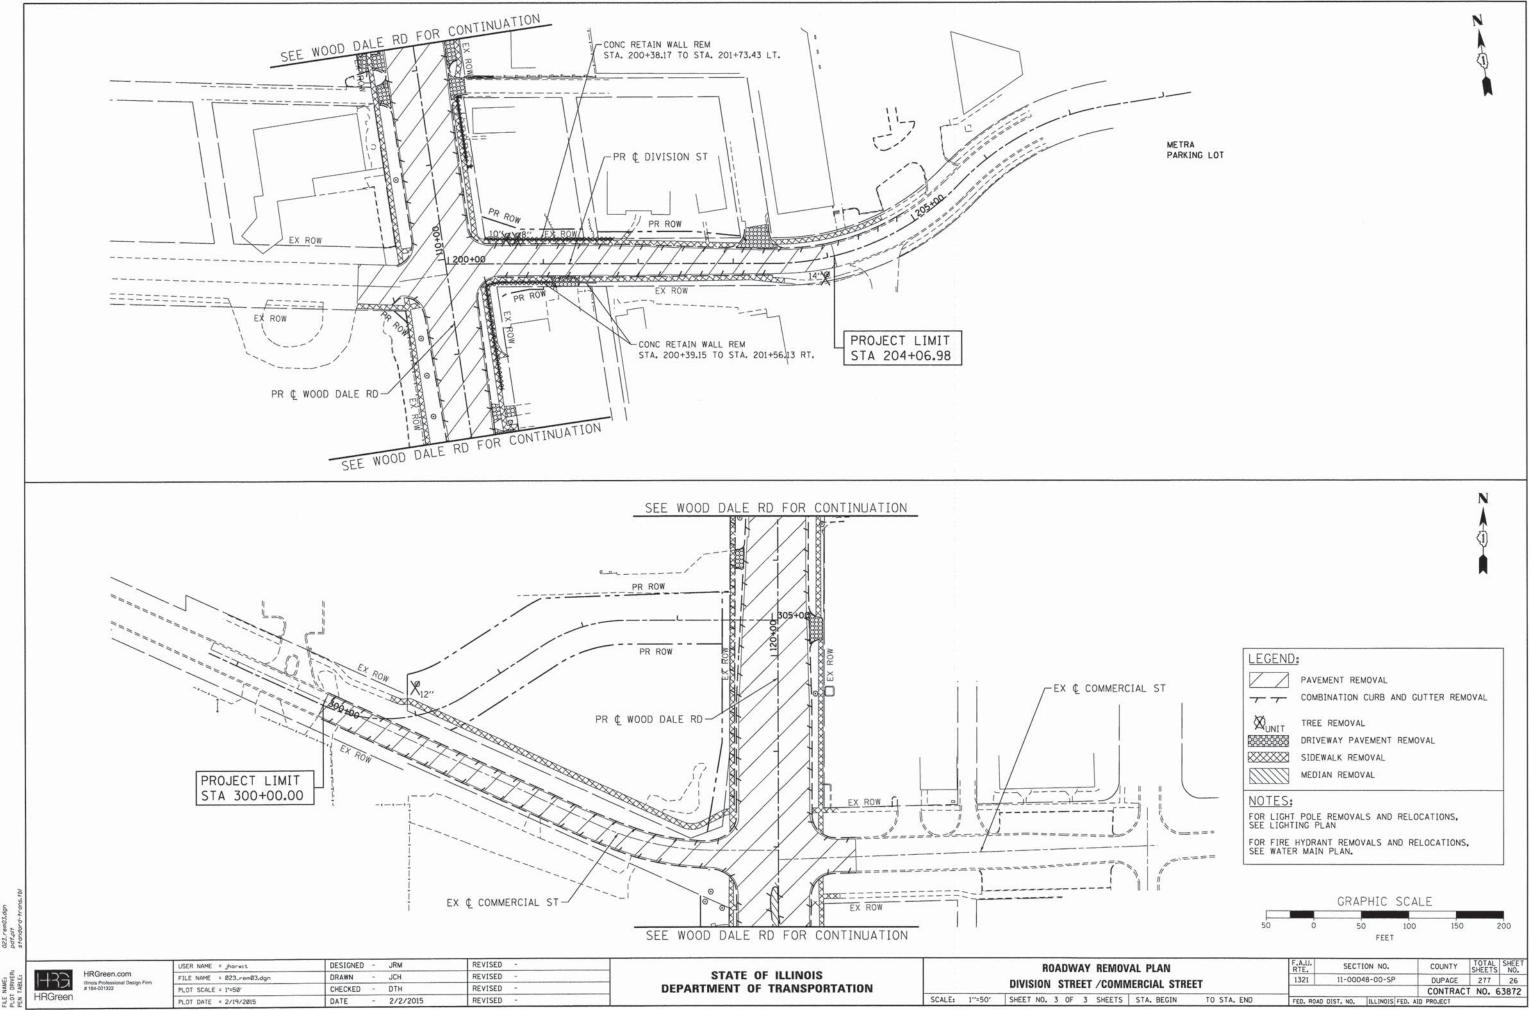

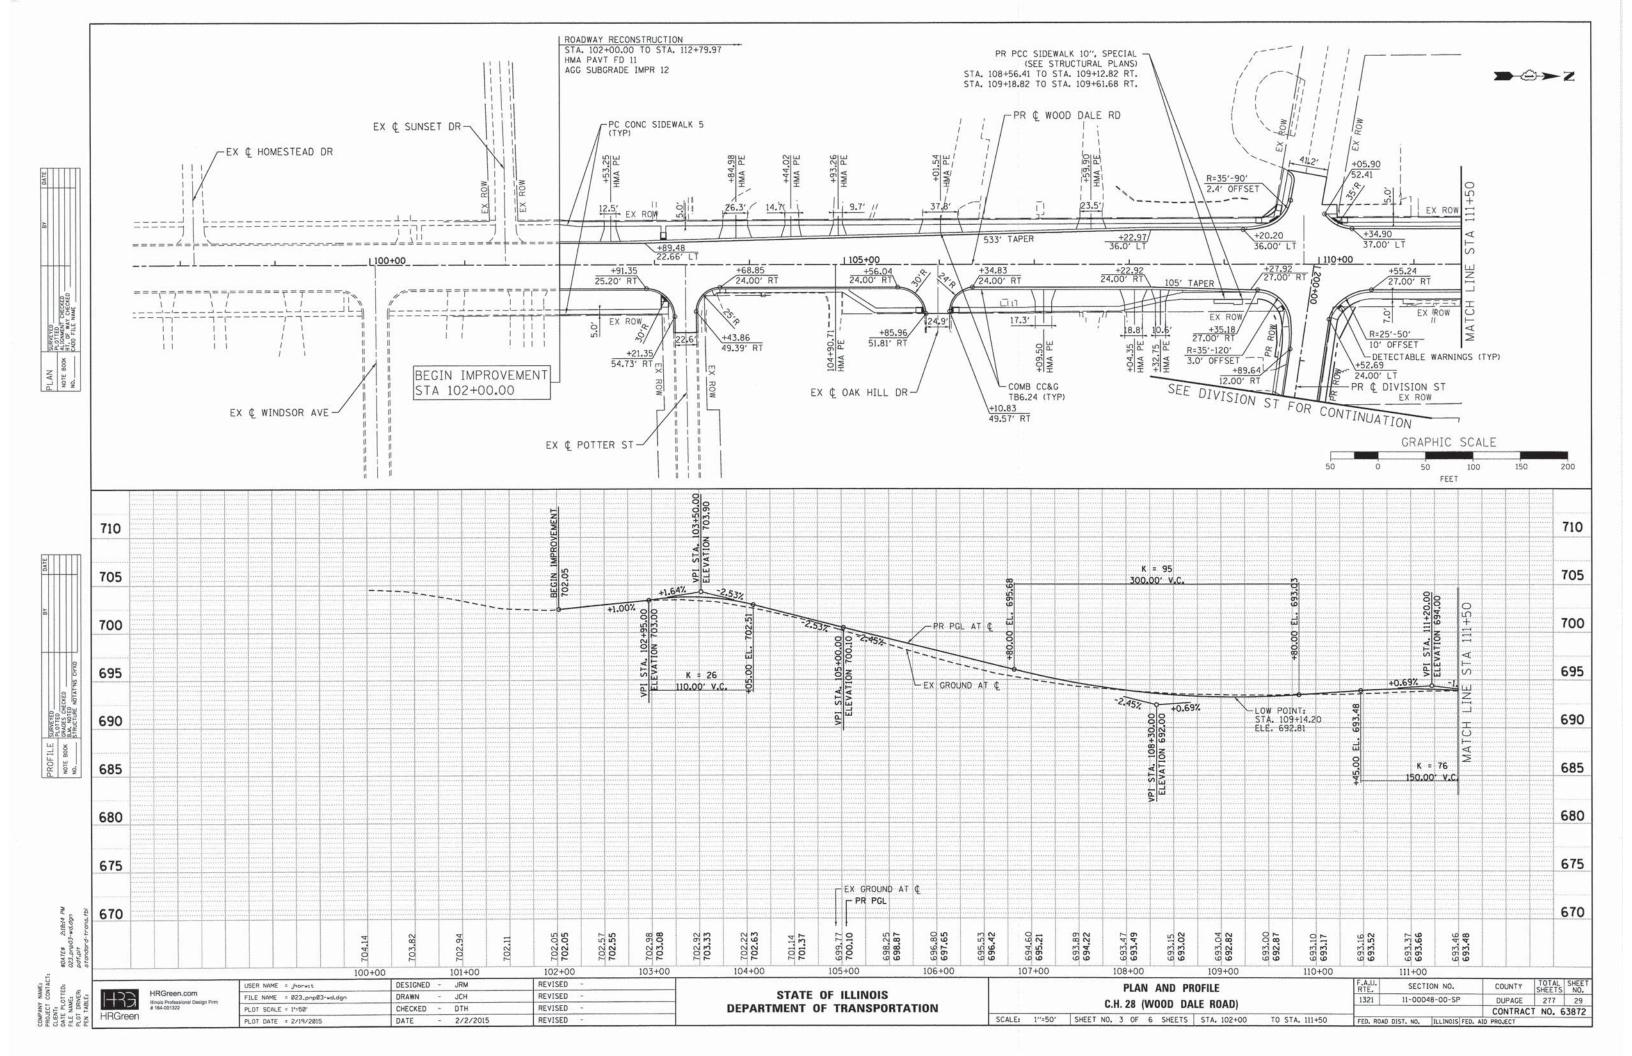

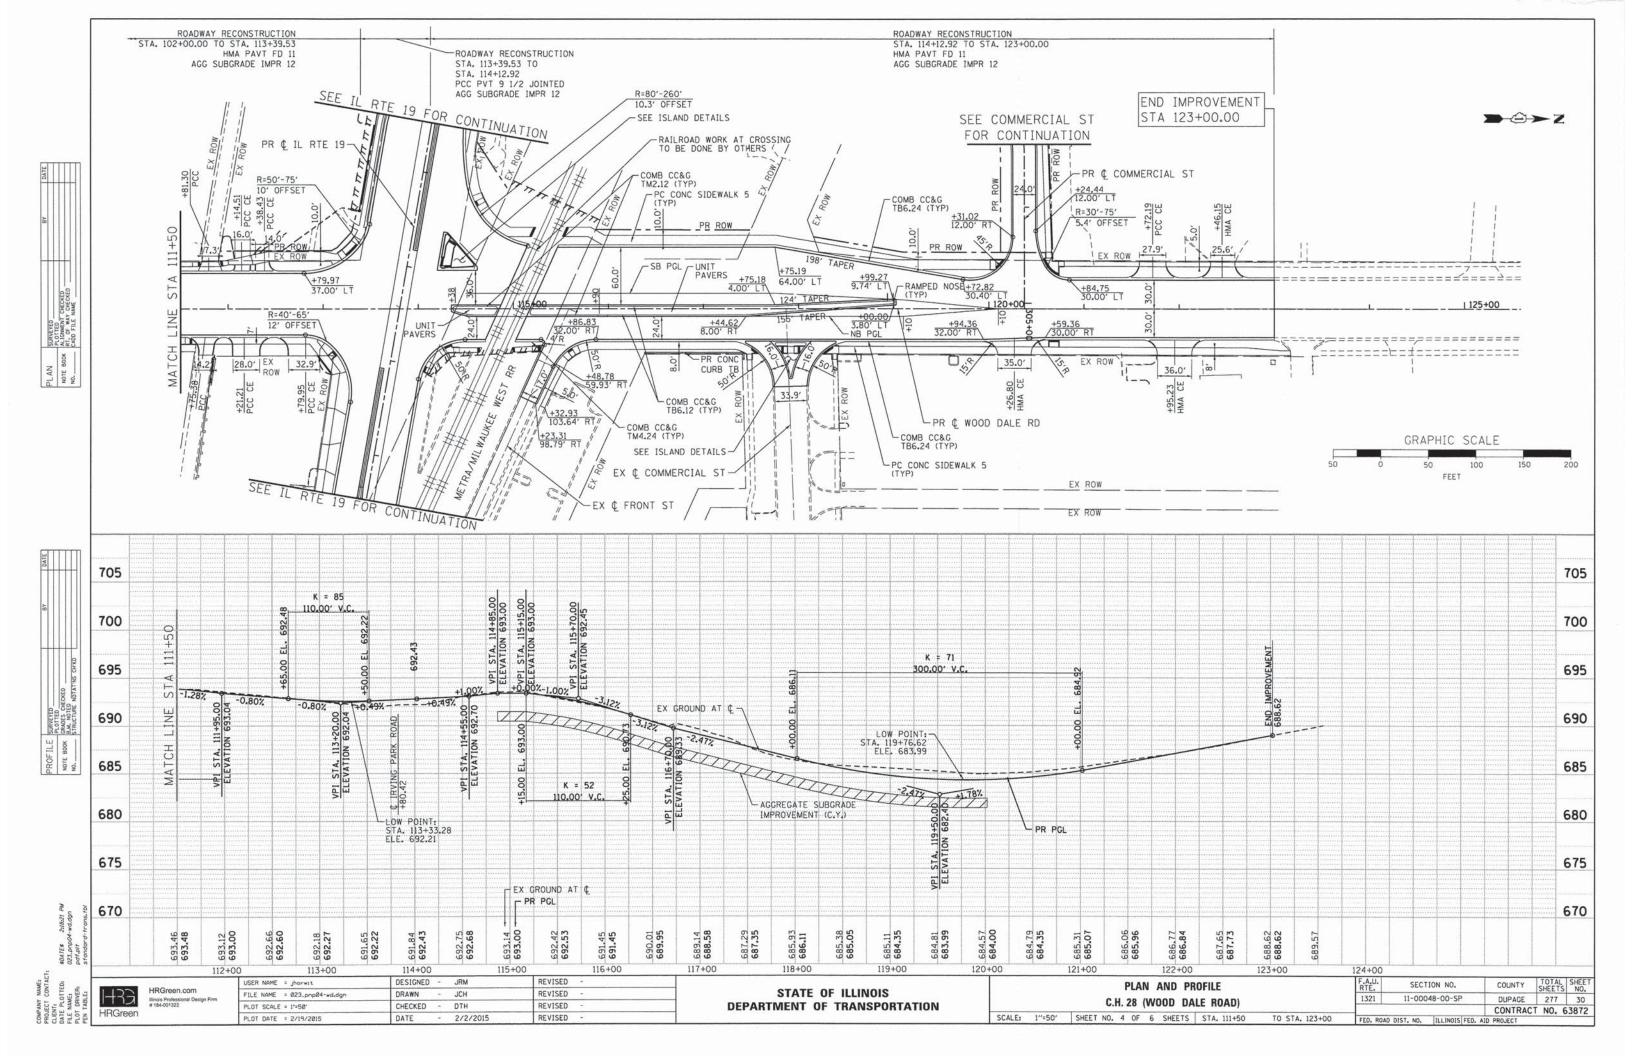

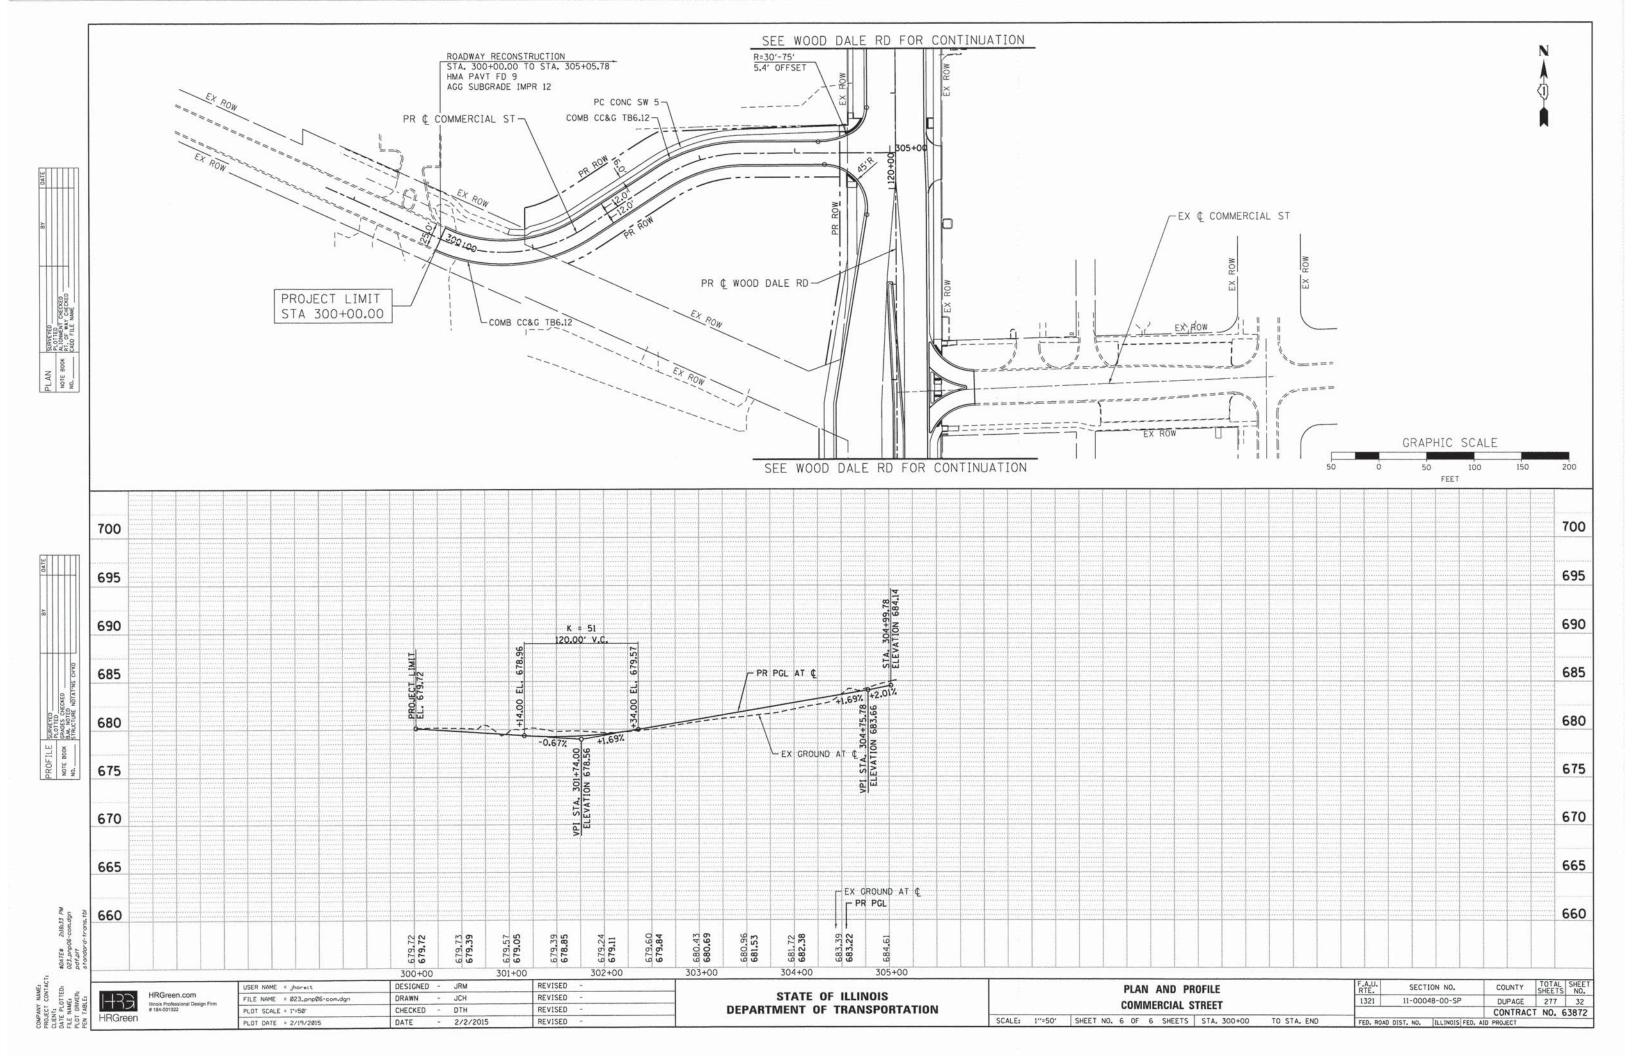

SUGGESTED MAINTENANCE OF TRAFFIC GENERAL NOTES

- 1. THE TRAFFIC CONTROL PLAN SHALL SERVE AS A GUIDE FOR SAFE DIVERSION OF TRAFFIC DURING EXECUTION OF THIS CONTRACT, HOWEVER, THE CONTRACTOR MAY IMPROVE OR MODIFY THE TRAFFIC CONTROL PLANS TO MEET CONSTRUCTION NEEDS BUT NOT AT THE EXPENSE OF PUBLIC SAFETY OR CONVENIENCE. ANY CHANGES TO THE TRAFFIC CONTROL PLAN SHALL BE SUBMITTED TO THE ENGINEER FOR APPROVAL.
- THE CONTRACTOR SHALL CONTACT THE DISTRICT ONE TRAFFIC CONTROL SUPERVISOR AT (847) 705-4470 A MINIMUM OF 72 HOURS IN ADVANCE OF BEGINNING WORK.
- 3. ALL OF THE TRAFFIC CONTROL DEVICES SHALL BE IN PLACE BEFORE CONSTRUCTION IS STARTED. ALL TEMPORARY PAVEMENT MARKINGS & TRAFFIC CONTROL DEVICES SHALL BE IN PLACE AT THE BEGINNING OF EACH STAGE, AND SHALL BE MAINTAINED FOR THE DURATION OF THAT STAGE UNLESS OTHERWISE DIRECTED BY THE ENGINEER.
- 4. A MINIMUM OF ONE (1) ELEVEN FOOT (11') LANE IN EACH DIRECTION SHALL BE KEPT OPEN TO TRAFFIC AT ALL TIMES. A MINIMUM OF ONE (1) FIFTEEN FOOT (15') LANE WILL BE OPEN AT ALL TIMES ON ALL SIDE STREETS.
- ALL PAVEMENT MARKINGS CONFLICTING WITH REVISED TRAFFIC PATTERNS SHALL BE REMOVED. PAVEMENT MARKING TAPE, TYPE III SHALL BE USED ON THE FINAL WEARING SURFACE OR ON THE EXISTING PAVEMENT TO REMAIN WHEN THE TEMPORARY PAVEMENT MARKING CONFLICTS WITH THE PERMANENT PAVEMENT MARKING SUCH AS ON TAPERS OR LANE SHIFTS.
- 6. THE CONTRACTOR SHALL PROVIDE INFORMATION SIGNS ON TEMPORARY SUPPORTS FOR ALL COMMERCIAL DRIVEWAYS. THESE SIGNS SHALL BE WHITE ON GREEN IN ACCORDANCE WITH THE MANUAL OF UNIFORM TRAFFIC CONTROL DEVICES. THIS WORK WILL BE PAID FOR PER DISTRICT ONE DETAIL TC-26. THE CONTRACTOR SHALL BE REQUIRED TO MAINTAIN ACCESS TO ALL ENTRANCES, APPROACHES AND TEMPORARY ROADS WITHIN THE PROJECT LIMITS. THIS WORK WILL BE INCLUDED IN THE COST OF TEMPORARY ACCESS (PRIVATE ENTRANCE) OR TEMPORARY ACCESS (COMMERCIAL ENTRANCE).
- 7. A TEMPORARY HOT-MIX ASPHALT RAMP WEDGE TO TRANSITION THE DIFFERENTIAL ELEVATIONS CAUSED BY STAGED CONSTRUCTION SHALL BE INSTALLED BETWEEN THE NEW CONSTRUCTION AND THE EXISTING PAVEMENT. ANY PAVEMENT DROP-OFFS GREATER THAN 3 INCHES IMMEDIATELY ADJACENT TO TRAFFIC SHALL NOT BE LEFT OVERNIGHT. PROVIDE TEMPORARY BITUMINOUS RAMP WEDGE OR OTHER MITIGATING MEASURES APPROVED BY THE ENGINEER.
- 8. THE CONTRACTOR SHALL MAINTAIN TRAFFIC IN ACCORDANCE WITH THE PLANS, SPECIAL PROVISIONS, STATE STANDARDS AND AS DIRECTED BY THE ENGINEER.
- THE CONTRACTOR SHALL INFORM THE ENGINEER OF ANY CHANGES IN STAGING AT LEAST TWO (2) WORKING DAYS IN ADVANCE.
- 10. TEMPORARY SIGNING, AS SHOWN, SHALL CONFORM TO THE APPLICABLE STANDARDS INCLUDED IN THE SPECIAL PROVISIONS AND CONTRACT PLANS OR AS DIRECTED BY THE ENGINEER.
- 11. ALL "ROAD CONSTRUCTION AHEAD" SIGNS SHALL BE EQUIPPED WITH MONO-DIRECTIONAL AMBER FLASHING LIGHTS.
- 12. ROAD NAME PLATES SHALL BE INSTALLED ON "ROAD CONSTRUCTION AHEAD" SIGNS AT INTERSECTIONS SHOWN ON THE PLANS.
- ALL STATE ROUTE MARKERS SHALL BE MAINTAINED AT ALL TIMES THROUGHOUT ALL STAGES OF CONSTRUCTION.
- 14. EXISTING TRAFFIC CONTROL DEVICES WITHIN THE LIMITS OF CONSTRUCTION ARE TO BE PROTECTED FROM DAMAGE BY THE CONTRACTOR. ANY DAMAGED SIGNS CAUSED BY HIS WORK SHALL BE REPLACED BY THE CONTRACTOR.
- 15. TRAFFIC CONTROL DEPICTED ON THE MAINTENANCE OF TRAFFIC PLANS IS THE MINIMUM REQUIREMENT. OTHER WORK OR SIGNING MAY BE REQUIRED BY THE ENGINEER.
- 16. THE TYPE III BARRICADES ARE TO BE PLACED IN ACCORDANCE WITH STANDARD 701901 UNLESS AUTHORIZED BY THE ENGINEER TO USE AN ALTERNATE ARRANGEMENT.
- 17. TYPE I, TYPE II OR DRUM BARRICADES WITH TWO-WAY FLASHING LIGHTS SHALL BE REQUIRED AT ALL OPEN TRENCHES, EXCAVATIONS, OPEN OR EXPOSED SEWER STRUCTURES, TRANSVERSE PAVEMENT JOINTS, MATERIALS OR EQUIPMENT WITHIN THE RIGHT-OF-WAY (NUMBER AND SPACING DEPENDS ON THE CONDITIONS); AND AT LOCATIONS DESIGNATED BY THE ENGINEER OR LOCAL LAW ENFORCEMENT AGENCIES.
- 18. THE CONTRACTOR SHALL PROVIDE, INSTALL, MAINTAIN AND REMOVE ALL SIGNS AND SIGN SUPPORTS REQUIRED FOR TRAFFIC CONTROL AND PROTECTION. THIS WORK SHALL NOT BE PAID FOR SEPARATELY BUT SHALL BE INCLUDED IN THE CONTRACT UNIT PRICE PER LUMP SUM FOR "TRAFFIC CONTROL AND PROTECTION (SPECIAL)".
- 19. ARROW BOARDS WILL BE REQUIRED WHEN IMPLEMENTING ALL LANE CLOSURES.
- 20. THE CONTRACTOR SHALL REPLACE THE CENTER MEDIAN WITH TEMPORARY PAVEMENT AS SOON AS POSSIBLE TO PREVENT ANY WATER FROM ACCUMULATING IN THE MEDIAN. THE CONTRACTOR SHALL PUMP ANY WATER THAT ACCUMULATES IN THE MEDIAN BEFORE THE TEMPORARY PAVEMENT IS CONSTRUCTED. THIS WORK SHALL NOT BE PAID FOR SEPARATELY BUT SHALL BE INCLUDED IN THE CONTRACT UNIT PRICE PER SQUARE YARD FOR "TEMPORARY PAVEMENT".
- 21. ANY SAW CUTTING OF THE EXISTING PAVEMENT FOR STAGE CONSTRUCTION SHALL BE INCLUDED IN THE CONTRACT UNIT PRICE PER SQUARE YARD FOR "PAVEMENT REMOVAL".
- 22.TRAFFIC CONDITIONS, ACCIDENTS, AND OTHER UNFORESEEN EMERGENCY CONDITIONS MAY REQUIRE THE ENGINEER TO RESTRICT, MODIFY, OR REMOVE LANE CLOSURES OR CHANNELIZATION SHOWN IN THE PLANS. THE CONTRACTOR SHALL MAKE THE NECESSARY ADJUSTMENTS AS DIRECTED BY THE ENGINEER WITHOUT DELAY. THE CONTRACTOR SHALL RESPOND TO ANY REQUEST MADE BY THE ENGINEER FOR CORRECTION WITHIN TWO HOURS FROM THE TIME OF NOTIFICATION.
- 23. WHEN ARTIFICIAL LIGHTING IS USED IN NIGHT OPERATIONS THE CONTRACTOR SHALL EXERCISE THE UTMOST PRECAUTIONS IN PREVENTING ADVERSE VISIBILITY TO THE MOTORING PUBLIC AND ADJOINING RESIDENTIAL AREAS.
- 24.A TYPE II BARRICADE WITH A "SIDEWALK CLOSED" SIGN AFFIXED, SHALL BE PLACED ON ALL SIDEWALKS CLOSED DUE TO CONSTRUCTION ACTIVITIES.

- 25. THE END OF ALL TEMPORARY CONCRETE BARRIER WALLS MUST BE TAPERED 8:1 AWAY FROM TRAFFIC, IMPACT ATTENUATORS (FULLY REDIRECTIVE, NARROW), TEST LEVEL 2 ARE REQUIRED ON APPROACH ENDS OF TEMPORARY CONCRETE BARRIER WALL.
- 26.LANE RESTRICTIONS, FLAGGING, OR OTHER OPERATIONS SHALL NOT CREATE CONDITIONS WHERE VEHICLES CAN BE QUEUED ACROSS THE TRACKS. IF THE QUEUING OF VEHICLES ACROSS THE TRACKS CANNOT BE AVOIDED, A UNIFORMED LAW ENFORCEMENT OFFICER OR FLAGGER SHALL BE PROVIDED AT THE CROSSING TO PREVENT VEHICLES FROM STOPPING ON THE TRACKS, EVEN IF AUTOMATIC WARNING DEVICES ARE IN PLACE.
- 27.ALL EXISTING ADVANCE RAILROAD SIGNING SHALL BE MAINTAINED OR RELOCATED DURING ALL STAGES OF CONSTRUCTION.
- 28.ALL SCHOOL ZONE SIGNING SHALL BE MAINTAINED DURING ALL STAGES OF CONSTRUCTION.
- 29.ALL COMMERCIAL AND RESIDENTIAL DRIVEWAYS SHALL BE MAINTAINED DURING ALL STAGES OF CONSTRUCTION.
- 30.THE TEMPORARY CONCRETE BARRIER WALL SHALL BE PINNED CONTINUOUSLY IN ACCORDANCE WITH THE STANDARD SPECIFICATIONS FOR ROAD & BRIDGE CONSTRUCTION IF A 3.5' CLEAR ZONE FREE FROM DROP-OFFS, OBSTRUCTIONS, AND EQUIPMENT IS NOT AVAILABLE BEHIND THE WALL.

	SUGGESTED MAINTENANCE OF TRAFFIC					F.A.U. RTE.	SECTION NO.	COUNTY	TOTAL	SHEET NO.
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INSTALL TEMPORARY PAVEMENT AS SHOWN IN DETAIL ON C.H. 28 (WOOD DALE ROAD) SOUTH OF IL 19 (IRVING PARK ROAD) AND NORTH AND SOUTH OF THE RAILROAD TRACKS.

INSTALL TEMPORARY TRAFFIC SIGNAL AT IL 19 (IRVING PARK ROAD) AND C.H. 28 (WOOD DALE ROAD).

PRE-STAGE - SUGGESTED MAINTENANCE OF TRAFFIC INSTALL ARTERIAL ROAD INFORMATION SIGNING PER DISTRICT 1 DETAIL TC-22 A MINIMUM OF TWO (2) WEEKS IN ADVANCE OF CONSTRUCTION.

TEMPORARY PAVEMENT INSTALLATION SOUTH OF IL 19 (IRVING PARK ROAD) UTILIZES HIGHWAY STANDARD 701701 FOR "URBAN LANE CLOSURE, MULTILANE

TEMPORARY PAVEMENT INSTALLATION NORTH AND SOUTH OF THE RAILROAD TRACKS UTILIZES HIGHWAY STANDARD 701601 FOR "URBAN LANE CLOSURE, MULTILANE, 1W OR 2W WITH NONTRAVERABLE MEDIAN".

STAGE 1 - CONSTRUCTION IL 19 (IRVING PARK ROAD)

CONSTRUCT SOUTHERN TWO (2) LANES OF PAVEMENT WEST OF C.H. 28 (WOOD DALE

CONSTRUCT SOUTHERN LANE OF PAVEMENT EAST OF C.H. 28 (WOOD DALE ROAD) UNTIL JUST EAST OF ELMWOOD AVENUE.

CONSTRUCT SOUTHERN TWO (2) LANES OF PAVEMENT EAST OF ELMWOOD AVENUE.

CONSTRUCT WESTBOUND FRONT STREET DECELERATION LANE TO BYPASS.

CONSTRUCT PROPOSED PAVEMENT ON ELMWOOD AVENUE

PERFORM STORM SEWER INSTALLATION.

METRA WILL BE PERFORMING WORK AT THE IL 19 CROSSING DURING STAGE 1. COORDINATE WITH METRA.

STAGE 1 - SUGGESTED MAINTENANCE OF TRAFFIC IL 19 (IRVING PARK ROAD) INSTALL LANE CLOSURE ADVANCED SIGNING ACCORDING TO THE PLANS.

COVER OR REMOVE PERMANENT SIGNS AS NEEDED FOR STAGE 1 CONSTRUCTION.

REMOVE ALL CONFLICTING RAISED REFLECTIVE PAVEMENT MARKERS WITHIN THE

REMOVE ALL CONFLICTING PAVEMENT MARKINGS ALONG IL 19 (IRVING PARK ROAD) AND INSTALL TEMPORARY PAVEMENT MARKING AND TRAFFIC CONTROL FOR EASTBOUND AND WESTBOUND LANE DROPS ACCORDING TO HIGHWAY STANDARD 701601.

INSTALL ALL TEMPORARY PAVEMENT MARKING AND TEMPORARY TRAFFIC CONTROL DEVICES FOR STAGE 1 CONSTRUCTION, SHIFT TRAFFIC.

STAGE 1 - CONSTRUCTION C.H. 28 (WOOD DALE ROAD)

CONSTRUCT WESTERN TWO (2) LANES OF PAVEMENT SOUTH OF UNNAMED ACCESS ROAD

CONSTRUCT WESTERN OUTSIDE THROUGH LANE FROM UNNAMED ACCESS ROAD TO IL 19 (IRVING PARK ROAD).

CONSTRUCT SOUTHBOUND DUAL RIGHT TURN LANES AND SOUTHBOUND OUTSIDE THRU LANE OF PAVEMENT NORTH OF IL 19 (IRVING PARK ROAD) UNTIL THE NORTHERN IMPROVEMENT LIMITS.

PERFORM STORM SEWER INSTALLATION.

STAGE 1 - SUGGESTED MAINTENANCE OF TRAFFIC C.H. 28 (WOOD DALE ROAD) INSTALL LANE CLOSURE ADVANCED SIGNING ACCORDING TO THE PLANS.

COVER OR REMOVE PERMANENT SIGNS AS NEEDED FOR STAGE 1 CONSTRUCTION.

REMOVE ALL CONFLICTING PAVEMENT MARKINGS ALONG C.H. 28 (WOOD DALE ROAD) AND INSTALL TEMPORARY PAVEMENT MARKING AND TRAFFIC CONTROL FOR NORTHBOUND AND SOUTHBOUND LANE DROPS ACCORDING TO HIGHWAY STANDARD 701601.

INSTALL ALL TEMPORARY PAVEMENT MARKING AND TEMPORARY TRAFFIC CONTROL DEVICES FOR STAGE 1 CONSTRUCTION, SHIFT TRAFFIC.

STAGE 1A, 1B, 1C, 1D - CONSTRUCTION C.H. 28 (WOOD DALE ROAD) INSTALL WOOD DALE ROAD TEMPORARY DETOUR FOR RAILROAD WORK, COORDINATE WITH

METRA WILL BE PERFORMING THEIR WORK AT THE CROSSING DURING THE FULL CLOSURE OF WOOD DALE ROAD, WHEN THE DETOUR ROUTE IS IMPLEMENTED.

CONSTRUCT SOUTHBOUND INSIDE THRU LANE AND LEFT TURN LANE, NORTHBOUND THRU LANES AND MEDIAN FROM JUST NORTH OF IL 19 TO COMMERCIAL STREET.

PERFORM STORM SEWER INSTALLATION.

CONSTRUCT ENTRANCE AND EXIT TO FRONT STREET BY-PASS.

SUGGESTED MAINTENANCE OF TRAFFIC AND CONSTRUCTION STAGING SEQUENCE OF CONSTRUCTION

STAGE 1A - CONSTRUCTION IL 19 (IRVING PARK ROAD)

CONSTRUCT WESTBOUND OUTSIDE THRU LANE IN INTERSECTION FROM ELMWOOD AVENUE TO WEST OF WOOD DALE ROAD AS SHOWN IN THE PLANS WITH HIGH EARLY STRENGTH CONCRETE DURING THE WOOD DALE ROAD CLOSURE.

STAGE 1A - SUGGESTED MAINTENANCE OF TRAFFIC IL 19 (IRVING PARK ROAD) SHIFT WESTBOUND TRAFFIC SOUTH AND INSTALL TEMPORARY PAVEMENT MARKING AND TEMPORARY TRAFFIC SIGNAL CONTROL DEVICES FOR STAGE 1A CONSTRUCTION.

STAGE 1B - CONSTRUCTION IL 19 (IRVING PARK ROAD) CONSTRUCT NORTHBOUND PAVEMENT IN THE MIDDLE OF THE INTERSECTION AS SHOWN IN THE PLANS WITH HIGH EARLY STRENGTH CONCRETE DURING THE WOOD DALE ROAD

STAGE 1B - SUGGESTED MAINTENANCE OF TRAFFIC IL 19 (IRVING PARK ROAD) SHIFT WESTBOUND TRAFFIC NORTH AND EASTBOUND TRAFFIC SOUTH AND INSTALL TEMPORARY PAVEMENT MARKING AND TEMPORARY TRAFFIC CONTROL DEVICES FOR STAGE

STAGE 1C - CONSTRUCTION IL 19 (IRVING PARK ROAD) CONSTRUCT WESTBOUND INSIDE THRU LANE AND SOUTHEAST QUADRANT OF THE INTERSECTION AS SHOWN IN THE PLANS WITH HIGH EARLY STRENGTH CONCRETE DURING THE WOOD DALE ROAD CLOSURE.

STAGE IC - SUGGESTED MAINTENANCE OF TRAFFIC IL 19 (IRVING PARK ROAD) SHIFT EASTBOUND THRU LANE TO THE NORTH AND WESTBOUND LEFT TURN LANE TO THE SOUTH AND PROHIBIT NORTHBOUND RIGHT TURN MOVEMENTS. NORTHBOUND WOOD DALE ROAD TO EASTBOUND IL 19 SHALL BE TEMPORARILY DETOURED DURING STAGE 1C.

STAGE 1D - CONSTRUCTION IL 19 (IRVING PARK ROAD)

CONSTRUCT SOUTHWEST QUADRANT OF THE INTERSECTION AND THE WESTBOUND INSIDE THROUGH LANE AS SHOWN IN THE PLANS WITH HIGH EARLY STRENGTH CONCRETE DURING THE WOOD DALE ROAD CLOSURE.

INSTALL TEMPORARY PAVEMENT AS SHOWN IN DETAIL IN THE SOUTHEAST QUADRANT OF IL 19 (IRVING PARK ROAD) AND C.H. 28 (WOOD DALE ROAD).

STAGE 1D - SUGGESTED MAINTENANCE OF TRAFFIC IL 19 (IRVING PARK ROAD)
SHIFT EASTBOUND THRU LANE TO THE NORTH AND PROHIBIT WESTBOUND LEFT TURN
LANE MOVEMENTS. WESTBOUND IL 19 TO SOUTHBOUND WOOD DALE ROAD SHALL BE
TEMPORARILY DETOURED DURING STAGE 1D.

STAGE 2 - CONSTRUCTION IL 19 (IRVING PARK ROAD)

CONSTRUCT NORTHERN LANE OF PAVEMENT WEST OF C.H. 28 (WOOD DALE ROAD).

CONSTRUCT EASTBOUND TO NORTHBOUND LEFT TURN LANE.

CONSTRUCT EASTBOUND INSIDE THROUGH LANE EAST OF C.H. 28 (WOOD DALE ROAD) AND WEST OF ELMWOOD AVENUE.

CONSTRUCT WESTBOUND INSIDE THROUGH LANE WEST OF THE RAILROAD TRACKS AS SHOWN ON THE PLANS.

CONSTRUCT THE REMAINDER OF THE FRONT STREET RIGHT TURN LANE.

CONTINUE STORM SEWER INSTALLATION.

STAGE 2 - SUGGESTED MAINTENANCE OF TRAFFIC IL 19 (IRVING PARK ROAD) ADJUST ADVANCED SIGNING ACCORDING TO THE PLANS FOR STAGE 2 CONSTRUCTION.

COVER OR REMOVE PERMANENT SIGNS AS NEEDED FOR STAGE 2 CONSTRUCTION.

REMOVE ALL CONFLICTING RAISED REFLECTIVE PAVEMENT MARKERS WITHIN THE PROJECT LIMITS.

REMOVE ALL CONFLICTING EXISTING AND TEMPORARY PAVEMENT MARKINGS FROM STAGE 1 ALONG IL 19 (IRVING PARK ROAD) AND INSTALL TEMPORARY PAVEMENT MARKING AND TRAFFIC CONTROL FOR EASTBOUND AND WESTBOUND LANE DROPS

INSTALL ALL TEMPORARY PAVEMENT MARKING AND TEMPORARY TRAFFIC CONTROL DEVICES FOR STAGE 2 CONSTRUCTION, SHIFT TRAFFIC.

STAGE 2 - CONSTRUCTION C.H. 28 (WOOD DALE ROAD) CONSTRUCT MIDDLE LANE OF PAVEMENT SOUTH OF IL 19 (IRVING PARK ROAD).

CONSTRUCT TWO (2) LANES OF PAVEMENT IN THE AREA OF DIVISION STREET.

CONSTRUCT PROPOSED RAISED MEDIAN AND ADJACENT NORTHBOUND AND SOUTHBOUND LANES OF PAVEMENT NORTH OF COMMERCIAL STREET TO THE NORTHERN IMPROVEMENT LIMITS.

CONTINUE STORM SEWER INSTALLATION.

STAGE 2 - SUGGESTED MAINTENANCE OF TRAFFIC C.H. 28 (WOOD DALE ROAD) ADJUST ADVANCED SIGNING ACCORDING TO THE PLANS FOR STAGE 2 CONSTRUCTION.

COVER OR REMOVE PERMANENT SIGNS AS NEEDED FOR STAGE 2 CONSTRUCTION.

REMOVE ALL CONFLICTING REFLECTORS WITHIN THE PROJECT LIMITS.

REMOVE ALL CONFLICTING EXISTING AND TEMPORARY PAVEMENT MARKINGS FROM STAGE 1 ALONG C.H. 28 (WOOD DALE ROAD) AND INSTALL TEMPORARY PAVEMENT MARKING AND TRAFFIC CONTROL FOR NORTHBOUND AND SOUTHBOUND LANE DROPS ACCORDING TO HIGHWAY STANDARD 701601.

INSTALL ALL TEMPORARY PAVEMENT MARKING AND TEMPORARY TRAFFIC CONTROL DEVICES FOR STAGE 2 CONSTRUCTION, SHIFT TRAFFIC.

STAGE 3 - CONSTRUCTION IL 19 (IRVING PARK ROAD)

CONSTRUCT REMAINING CENTRAL LANES OF PAVEMENT AND THE RAISED MEDIAN THE ENTIRE LIMIT OF IMPROVEMENT.

COMPLETE STORM SEWER INSTALLATION.

STAGE 3 - SUGGESTED MAINTENANCE OF TRAFFIC IL 19 (IRVING PARK ROAD) ADJUST ADVANCED SIGNING ACCORDING TO THE PLANS FOR STAGE 3 CONSTRUCTION.

COVER OR REMOVE PERMANENT SIGNS AS NEEDED FOR STAGE 3 CONSTRUCTION.

REMOVE ALL REMAINING RAISED REFLECTIVE PAVEMENT MARKERS WITHIN

REMOVE ALL CONFLICTING EXISTING AND TEMPORARY PAVEMENT MARKINGS
FROM STAGE 2 ALONG IL 19 (IRVING PARK ROAD) AND INSTALL TEMPORARY PAVEMENT
MARKING AND TRAFFIC CONTROL FOR EASTBOUND AND WESTBOUND LANE DROPS

INSTALL ALL TEMPORARY PAVEMENT MARKING AND TEMPORARY TRAFFIC CONTROL DEVICES FOR STAGE 3 CONSTRUCTION, SHIFT TRAFFIC.

PLACE TOPSOIL, SEED, SOD AND ALL OTHER RESTORATION ITEMS.

COMPLETE REMAINING CONSTRUCTION, CLEAN-UP AND PUNCH LIST.

STAGE 3 - CONSTRUCTION C.H. 28 (WOOD DALE ROAD) CONSTRUCT REMAINING EASTERN LANE(S) OF PAVEMENT THE ENTIRE LIMIT OF

COMPLETE STORM SEWER INSTALLATION.

STAGE 3 - SUGGESTED MAINTENANCE OF TRAFFIC C.H. 28 (WOOD DALE ROAD) ADJUST ADVANCED SIGNING ACCORDING TO THE PLANS FOR STAGE 3 CONSTRUCTION.

COVER OR REMOVE PERMANENT SIGNS AS NEEDED FOR STAGE 3 CONSTRUCTION.

REMOVE ALL REMAINING REFLECTORS WITHIN THE PROJECT LIMITS.

REMOVE ALL CONFLICTING EXISTING AND TEMPORARY PAVEMENT MARKINGS
FROM STAGE 2 ALONG C.H. 28 (WOOD DALE ROAD) AND INSTALL TEMPORARY PAVEMENT
MARKING AND TRAFFIC CONTROL FOR NORTHBOUND AND SOUTHBOUND LANE DROPS ACCORDING TO HIGHWAY STANDARD 701606.

INSTALL ALL TEMPORARY PAVEMENT MARKING AND TEMPORARY TRAFFIC CONTROL DEVICES FOR STAGE 3 CONSTRUCTION, SHIFT TRAFFIC.

PLACE TOPSOIL, SEED, SOD AND ALL OTHER RESTORATION ITEMS.

COMPLETE REMAINING CONSTRUCTION, CLEAN-UP AND PUNCH LIST.

STAGE 4 - CONSTRUCTION

IL 19-CONSTRUCT REMAINING THRU LANE PAVEMENT ON THE EAST LEG OF IL 19 WEST

WOOD DALE ROAD-CONSTRUCT SOUTHBOUND RIGHT TURN LANE CHANNELIZATION ISLAND AND NORTHBOUND INSIDE THRU LANE SOUTH OF IL 19.

DIVISION STREET-CONSTRUCT REMAINING NORTH PAVEMENT, CURB AND GUTTER AND SIDEWALK ALONG DIVISION STREET.

STAGE 4 - SUGGESTED MAINTENANCE OF TRAFFIC IL 19 (IRVING PARK ROAD) ADJUST ADVANCED SIGNING ACCORDING TO THE PLANS FOR STAGE 4 CONSTRUCTION.

INSTALL ALL TEMPORARY PAVEMENT MARKING AND TEMPORARY TRAFFIC CONTROL DEVICES FOR STAGE 4 CONSTRUCTION, SHIFT TRAFFIC.

PLACE TOPSOIL, SEED, SOD AND ALL OTHER RESTORATION ITEMS.

COMPLETE REMAINING CONSTRUCTION, CLEAN-UP AND PUNCH LIST.

END CONSTRUCTION

RE-ESTABLISH PERMANENT PAVEMENT MARKING, RAISED REFLECTIVE PAVEMENT MARKERS AND RECESSED REFLECTIVE PAVEMENT MARKERS IN ACCORDANCE WITH DISTRICT 1 DETAILS AND DUPAGE COUNTY DETAILS UTILIZING LANE CLOSURES.

REPLACE LENSES ON RAISED REFLECTIVE PAVEMENT MARKERS WHERE TEMPORARILY REMOVED. SHIFT TRAFFIC.

REMOVE ALL CONSTRUCTION SIGNING AND TRAFFIC CONTROL MEASURES.


UNCOVER ALL PERMANENT SIGNS.

REFER TO THE SPECIAL PROVISIONS FOR THE RAILROAD EXHIBITS SEQUENCE OF CONSTRUCTION OF THE RAILROAD IMPROVEMENTS.

SECTION NO.


DUPAGE 277 34

CONTRACT NO. 63872

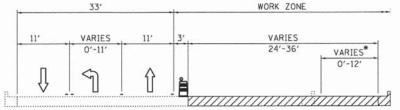


*STA. 54+00.76 TO STA. 57+44.88


TYPICAL SECTION - STAGE 1 IL 19 WEST OF WOOD DALE STA. 50+14.78 TO STA. 57+44.88

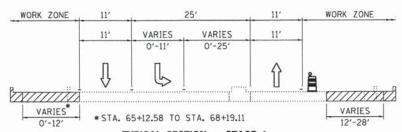


TYPICAL SECTION - STAGE 1 IL 19 EAST OF WOOD DALE STA, 57+44.88 TO STA, 70+64.18

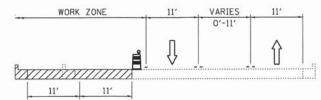


TYPICAL SECTION - STAGE 1 WOOD DALE - SOUTH OF DIVISION STA. 102+00.00 TO STA. 110+00.00

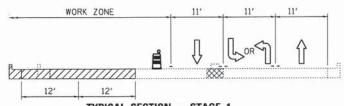

TYPICAL SECTION - STAGE 1 WOOD DALE - DIVISION TO IL 19 STA. 110+00.00 TO STA. 113+80.42

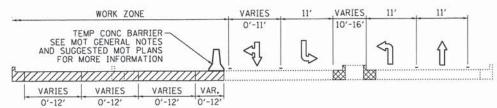


TYPICAL SECTION - STAGE 1 WOOD DALE - NORTH OF IL 19 STA. 113+80.42 TO STA. 117+62.60

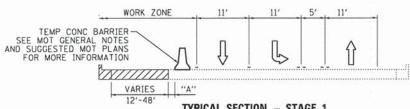


TYPICAL SECTION - STAGE 1 WOOD DALE - NORTH OF IL 19 STA. 117+62.60 TO STA. 123+00.00

WHEN "A" IS 3'-6" OR LESS, THE TEMPORARY CONCRETE BARRIER SHALL BE PINNED TO THE PAVEMENT. PINNING IS NOT REQUIRED WHEN "A" IS GREATER THAN 3'-6".

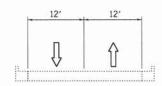


TYPICAL SECTION - STAGE 1 COMMERCIAL STREET

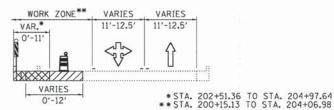


TYPICAL SECTION - STAGE 1 **DIVISION STREET**

TEMPORARY PAVEMENT DETAILS

(CONTRACTOR HAS THE OPTION OF USING HMA OR PCC SECTION FOR TEMPORARY PAVEMENT)

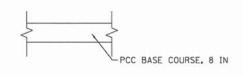

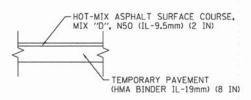

SEE MOT PLANS FOR LOCATIONS OF TEMPORARY PAVEMENT.

LEGEND



TYPE II BARRICADES OR DRUMS WITH BI-DIRECTIONAL STEADY BURNING LIGHT 50' C-C ON TANGENT, 20' C-C ON TAPERS AND 12' ON RADII



DOUBLE VERTICAL PANELS WITH BI-DIRECTIONAL LIGHTING @ 25' C-C



PROPOSED PAVEMENT



TEMPORARY PAVEMENT


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HRGreen.com


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STATE OF ILLINOIS **DEPARTMENT OF TRANSPORTATION** SUGGESTED STAGING OF CONSTRUCTION & TRAFFIC CONTROL TYPICAL SECTIONS - STAGE 1 TO STA.


SECTION NO. COUNTY DUPAGE 277 35 11-00048-00-SP CONTRACT NO. 63872




TYPICAL SECTION - STAGE 2 IL 19 WEST OF WOOD DALE STA. 50+14.78 TO STA. 57+44.88

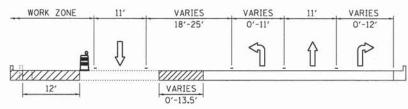

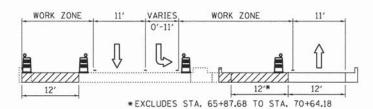
TYPICAL SECTION - STAGE 2 IL 19 EAST OF WOOD DALE STA. 57+44.88 TO STA. 70+64.18

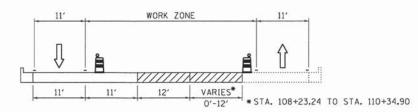

TYPICAL SECTION - STAGE 2 WOOD DALE - SOUTH OF DIVISION STA. 102+00.00 TO STA. 110+34.90

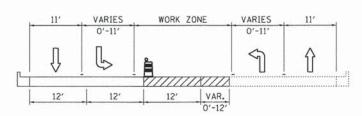

TYPICAL SECTION - STAGE 2 WOOD DALE - DIVISION TO IL 19 STA. 110+34.90 TO STA. 113+80.42

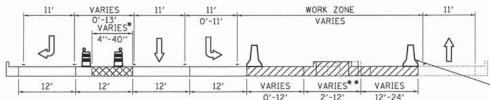

TEMP CONC BARRIER

O'-12'

2'-12'

12'-24'

* STA. 114+19.99 TO STA. 114+62.06


FOR MORE INFORMATION

OD DALE - IL 19 TO COMMERCIAL

STA. 113+69.62 TO STA. 119+02.50

WOOD DALE - IL 19 TO COMMERCIAL

STA. 113+80.42 TO STA. 119+02.50

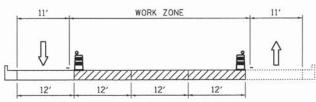

TYPICAL SECTION - STAGE 2 WOOD DALE - NORTH OF COMMERCIAL

STA. 119+02.50 TO STA. 123+00.00

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STATE OF ILLINOIS **DEPARTMENT OF TRANSPORTATION**

VARIES


12'

TYPICAL SECTION - STAGE 2


DIVISION STREET

* * VAR*

12'

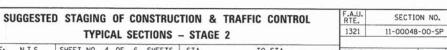

LEGEND

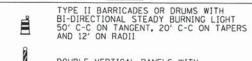

DOUBLE VERTICAL PANELS WITH BI-DIRECTIONAL LIGHTING @ 25' C-C

PROPOSED PAVEMENT

TEMPORARY PAVEMENT

HRGreen


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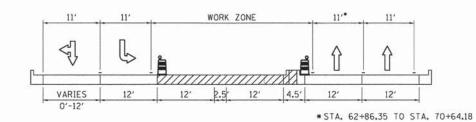
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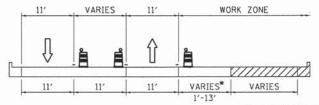
FED. ROAD DIST. NO. ILLINOIS FED. AID PROJECT



TYPICAL SECTION - STAGE 3 IL 19 WEST OF WOOD DALE STA. 50+14.78 TO STA. 57+44.88



TYPICAL SECTION - STAGE 3 IL 19 EAST OF WOOD DALE STA, 57+44,88 TO STA, 70+64,18

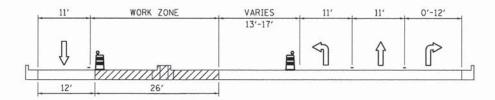

*STA. 108+23.24 TO STA. 110+34.90


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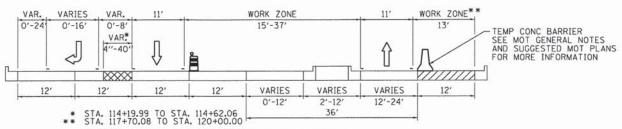
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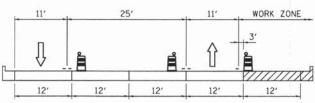
TYPICAL SECTION - STAGE 3 WOOD DALE - SOUTH OF DIVISION STA. 102+00.00 TO STA. 110+34.90




TYPICAL SECTION — STAGE 3 WOOD DALE — DIVISION TO IL 19 STA. 110+34.90 TO STA. 113+80.42



TYPICAL SECTION - STAGE 3 WOOD DALE - IL 19 TO COMMERCIAL STA, 113+80.42 TO STA, 120+00.00

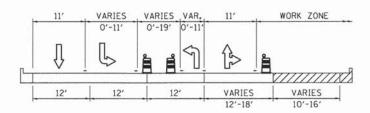

TYPICAL SECTION - STAGE 3 WOOD DALE - NORTH OF COMMERCIAL STA. 120+00.00 TO STA. 123+00.00

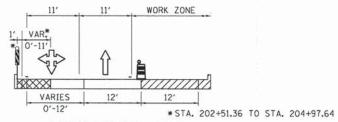

TYPICAL SECTION - STAGE 3
DIVISION STREET





TYPE II BARRICADES OR DRUMS WITH BI-DIRECTIONAL STEADY BURNING LIGHT 50' C-C ON TANGENT, 20' C-C ON TAPERS AND 12' ON RADII



DOUBLE VERTICAL PANELS WITH BI-DIRECTIONAL LIGHTING @ 25' C-C



PROPOSED PAVEMENT


TEMPORARY PAVEMENT

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PLOT DRIVER.


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D. ROAD	DIST. NO.	ILLINOIS FED	. AID PROJECT	1555 No	1000
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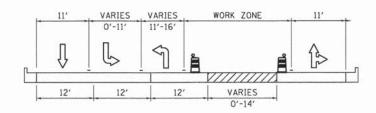


*STA. 57+84.46 TO STA. 60+63.20


TYPICAL SECTION - STAGE 4 IL 19 EAST OF WOOD DALE STA. 57+44.88 TO STA. 70+64.18

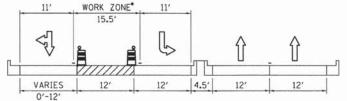


TYPICAL SECTION - STAGE 4
WOOD DALE - SOUTH OF DIVISION
STA. 103+67.06 TO STA. 110+34.90

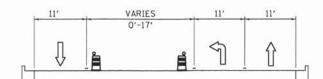


TYPICAL SECTION - STAGE 4 WOOD DALE - DIVISION TO IL 19 STA. 110+34.90 TO STA. 113+80.42

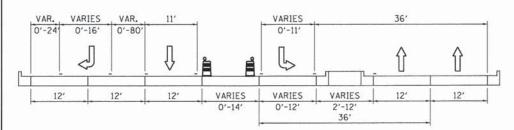

TYPICAL SECTION - STAGE 4
WOOD DALE - IL 19 TO COMMERCIAL
STA. 113+80.42 TO STA. 120+00.00

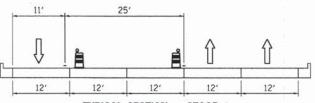

TYPICAL SECTION - STAGE 4
WOOD DALE - NORTH OF COMMERCIAL
STA. 120+00.00 TO STA. 123+00.00

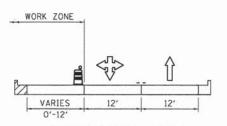

TYPICAL SECTION - STAGE 4
DIVISION STREET

LEGEND



TYPE II BARRICADES OR DRUMS WITH BI-DIRECTIONAL STEADY BURNING LIGHT 50' C-C ON TANGENT, 20' C-C ON TAPERS AND 12' ON RADII



DOUBLE VERTICAL PANELS WITH BI-DIRECTIONAL LIGHTING @ 25' C-C



PROPOSED PAVEMENT




TEMPORARY PAVEMENT

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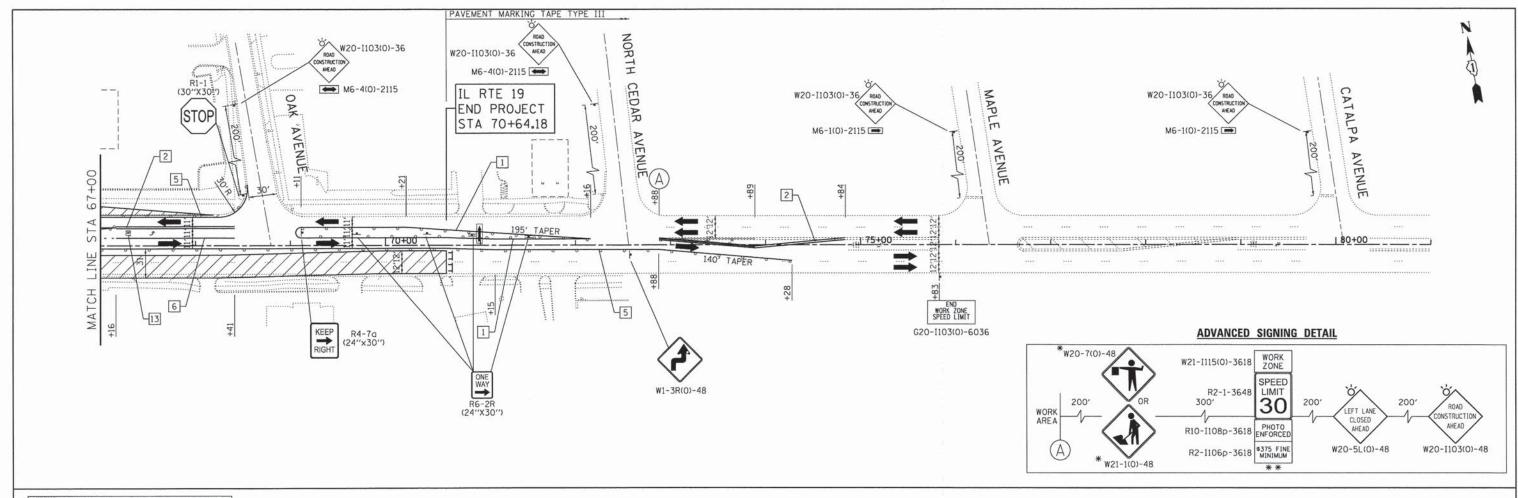
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PROJECT CONTACT:
CLIENT:
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WORK ZONE

TEMPORARY PAVEMENT

DIRECTION OF TRAFFIC TYPE III BARRICADE

WITH FLASHING LIGHTS MAINTENANCE OF TRAFFIC SIGN

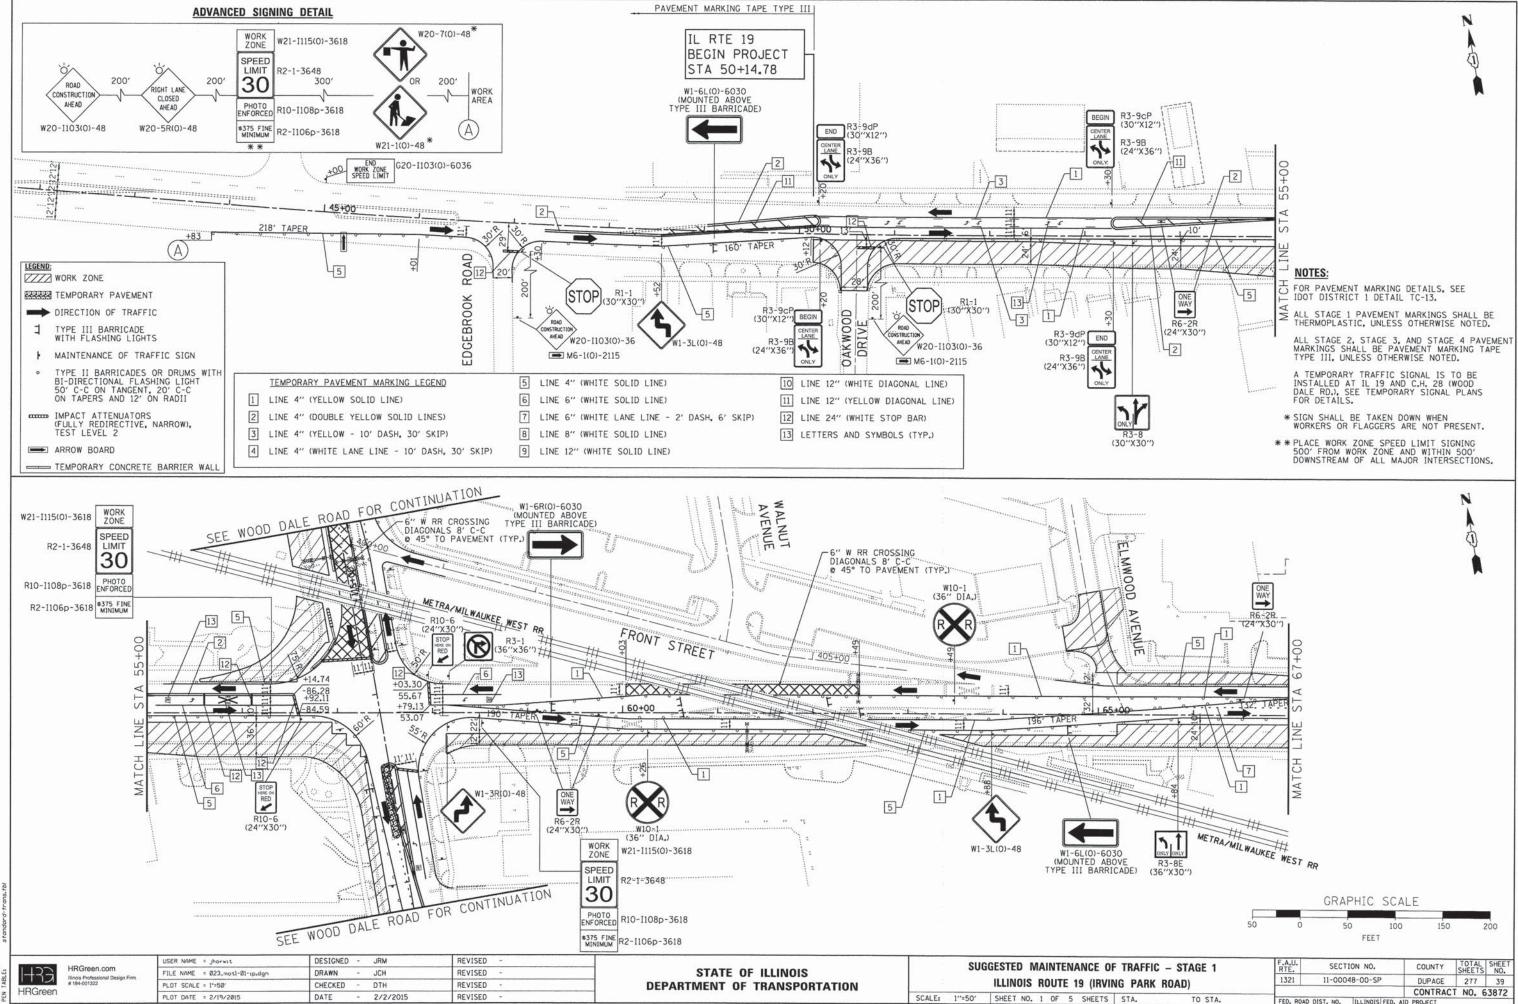TYPE II BARRICADES OR DRUMS WITH BI-DIRECTIONAL FLASHING LIGHT 50' C-C ON TANGENT, 20' C-C ON TAPERS AND 12' ON RADII

IMPACT ATTENUATORS
(FULLY REDIRECTIVE, NARROW),
TEST LEVEL 2

ARROW BOARD

TEMPORARY CONCRETE BARRIER WALL

NOTES:

FOR PAVEMENT MARKING DETAILS, SEE IDOT DISTRICT 1 DETAIL TC-13.

ALL STAGE 1 PAVEMENT MARKINGS SHALL BE THERMOPLASTIC, UNLESS OTHERWISE NOTED.

ALL STAGE 2, STAGE 3, AND STAGE 4 PAVEMENT MARKINGS SHALL BE PAVEMENT MARKING TAPE TYPE III, UNLESS OTHERWISE NOTED.

A TEMPORARY TRAFFIC SIGNAL IS TO BE INSTALLED AT IL 19 AND C.H. 28 (WOOD DALE RD.), SEE TEMPORARY SIGNAL PLANS FOR DETAILS.

* SIGN SHALL BE TAKEN DOWN WHEN WORKERS OR FLAGGERS ARE NOT PRESENT.

*PLACE WORK ZONE SPEED LIMIT SIGNING 500' FROM WORK ZONE AND WITHIN 500' DOWNSTREAM OF ALL MAJOR INTERSECTIONS.

TEMPORARY PAVEMENT MARKING LEGEND

1 LINE 4" (YELLOW SOLID LINE)

- 5 LINE 4" (WHITE SOLID LINE)
- 2 LINE 4" (DOUBLE YELLOW SOLID LINES)
- LINE 4" (YELLOW 10' DASH, 30' SKIP)
- 4 LINE 4" (WHITE LANE LINE 10' DASH, 30' SKIP)
- 6 LINE 6" (WHITE SOLID LINE)
- 7 LINE 6" (WHITE LANE LINE 2' DASH, 6' SKIP)
- 8 LINE 8" (WHITE SOLID LINE)
- 9 LINE 12" (WHITE SOLID LINE)

- 10 LINE 12" (WHITE DIAGONAL LINE)
- 11 LINE 12" (YELLOW DIAGONAL LINE)
- 12 LINE 24" (WHITE STOP BAR)
- 13 LETTERS AND SYMBOLS (TYP.)

GRAPHIC SCALE FEET

H33 HRGreen

HRGreen.com


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PLOT DATE = 2/19/2015	DATE -	2/2/2015	REVISED -	

STATE OF ILLINOIS **DEPARTMENT OF TRANSPORTATION**

	SUG	GESTE	N (ΙΑI	NT	ENA	ANCE O	F TRAFFI	C - STAGE 1
		ILLING	ols	R	TUC	E 1	9 (IRVI	NG PARK	(ROAD)
SCALE:	1"=50"	SHEET	NO.	2	OF	5	SHEETS	STA.	TO STA.


U.	SECT	ION NO.	COUNTY	TOTAL	SHEET NO.
1	11-00048-00-SP		DUPAGE	277	40
			CONTRAC	T NO. 6	3872
ROAD	DIST. NO.	ILLINOIS FED.	AID PROJECT		

1321 TO STA.

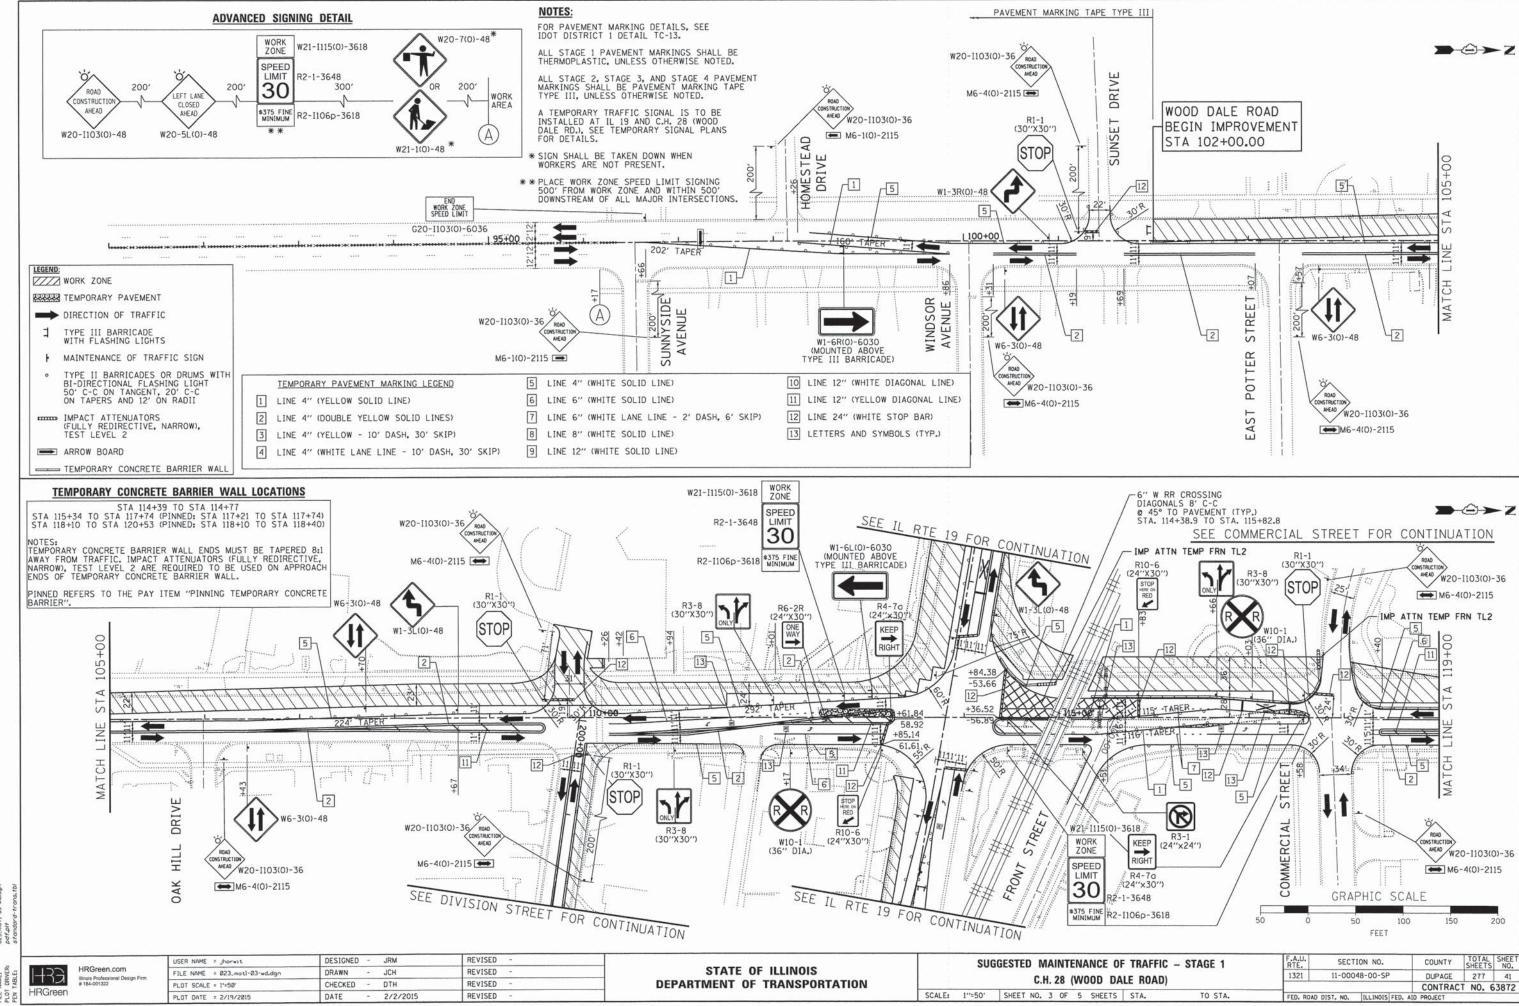

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PROJECT CONTACT:
CLIENT:
DATE PLOTTED:
FILE NAME:
PLOT DRIVER:
PEN TARI E:

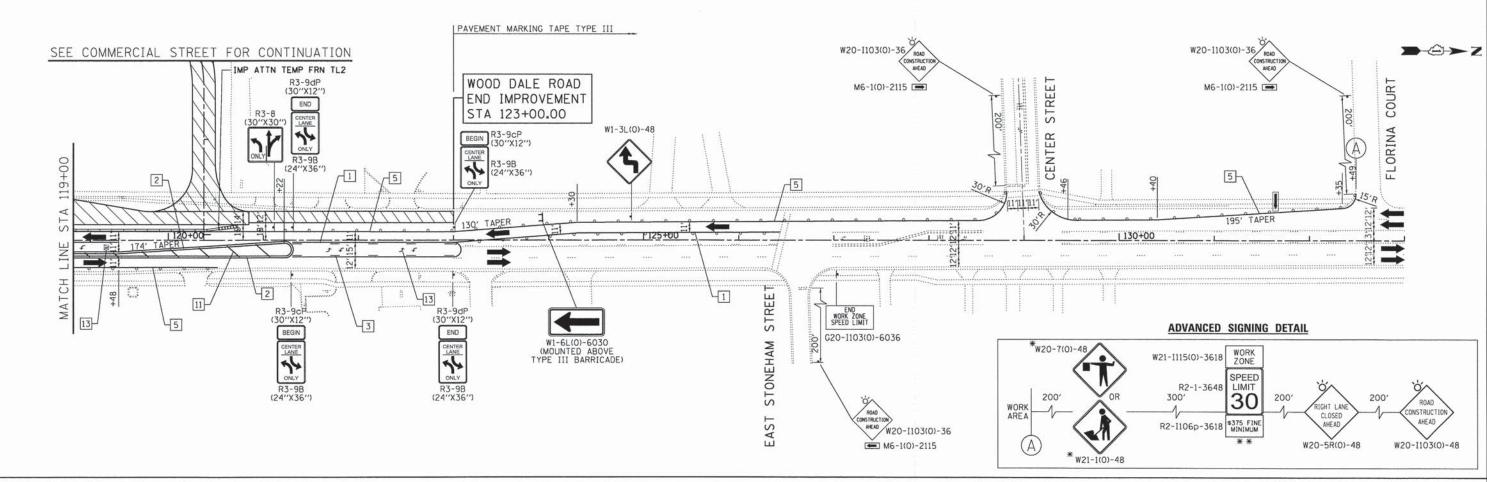

LEGEND:
WORK ZONE

TEMPORARY PAVEMENT

DIRECTION OF TRAFFIC

TYPE III BARRICADE

- WITH FLASHING LIGHTS

 MAINTENANCE OF TRAFFIC SIGN
- TYPE II BARRICADES OR DRUMS WITH BI-DIRECTIONAL FLASHING LIGHT 50' C-C ON TANGENT, 20' C-C ON TAPERS AND 12' ON RADII
- IMPACT ATTENUATORS
 (FULLY REDIRECTIVE, NARROW),
 TEST LEVEL 2
- ARROW BOARD
- TEMPORARY CONCRETE BARRIER WALL

TEMPORARY PAVEMENT MARKING LEGEND

LINE 4" (YELLOW SOLID LINE)

2 LINE 4" (DOUBLE YELLOW SOLID LINES)

3 LINE 4" (YELLOW - 10' DASH, 30' SKIP)

4 LINE 4" (WHITE LANE LINE - 10' DASH, 30' SKIP)

- 5 LINE 4" (WHITE SOLID LINE)
 -
 - LINE 6" (WHITE SOLID LINE)
 - LINE 6" (WHITE LANE LINE 2' DASH, 6' SKIP)
 - 8 LINE 8" (WHITE SOLID LINE)
 - 9 LINE 12" (WHITE SOLID LINE)

- 10 LINE 12" (WHITE DIAGONAL LINE)
- 11 LINE 12" (YELLOW DIAGONAL LINE)
- 12 LINE 24" (WHITE STOP BAR)
- 13 LETTERS AND SYMBOLS (TYP.)

NOTES:

FOR PAVEMENT MARKING DETAILS, SEE IDOT DISTRICT 1 DETAIL TC-13.

ALL STAGE 1 PAVEMENT MARKINGS SHALL BE THERMOPLASTIC, UNLESS OTHERWISE NOTED.

ALL STAGE 2, STAGE 3, AND STAGE 4 PAVEMENT MARKINGS SHALL BE PAVEMENT MARKING TAPE TYPE III, UNLESS OTHERWISE NOTED.

A TEMPORARY TRAFFIC SIGNAL IS TO BE INSTALLED AT IL 19 AND C.H. 28 (WOOD DALE RD.), SEE TEMPORARY SIGNAL PLANS FOR DETAILS.

- * SIGN SHALL BE TAKEN DOWN WHEN WORKERS OR FLAGGERS ARE NOT PRESENT.
- * * PLACE WORK ZONE SPEED LIMIT SIGNING 500' FROM WORK ZONE AND WITHIN 500' DOWNSTREAM OF ALL MAJOR INTERSECTIONS.

TEMPORARY CONCRETE BARRIER WALL LOCATIONS

STA 114+39 TO STA 114+77 STA 115+34 TO STA 117+74 (PINNED: STA 117+21 TO STA 117+74) STA 118+10 TO STA 120+53 (PINNED: STA 118+10 TO STA 118+40)

NOTES: TEMPORARY CONCRETE BARRIER WALL ENDS MUST BE TAPERED 8:1 AWAY FROM TRAFFIC. IMPACT ATTENUATORS (FULLY REDIRECTIVE, NARROW), TEST LEVEL 2 ARE REQUIRED TO BE USED ON APPROACH ENDS OF TEMPORARY CONCRETE BARRIER WALL.

PINNED REFERS TO THE PAY ITEM "PINNING TEMPORARY CONCRETE BARRIER".

		GRAPHI(C SCALE		
50	0	50	100	150	200
		FE	ET		


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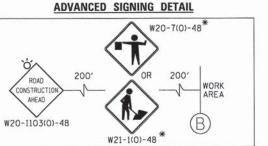
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PLOT DATE = 2/19/2015	DATE - 2/2/2015	REVISED -	

	SUG	GESTE						TRAFFI	C - STAGE 1
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F.A.U. RTE.	SECTION	NO.	COUNTY	TOTAL	SHE
1321 11-00048-00		O-SP	DUPAGE	277	4
		70-11	CONTRAC	T NO. 6	387
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NOTES


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- ** PLACE WORK ZONE SPEED LIMIT SIGNING 500' FROM WORK ZONE AND WITHIN 500' DOWNSTREAM OF ALL MAJOR INTERSECTIONS.




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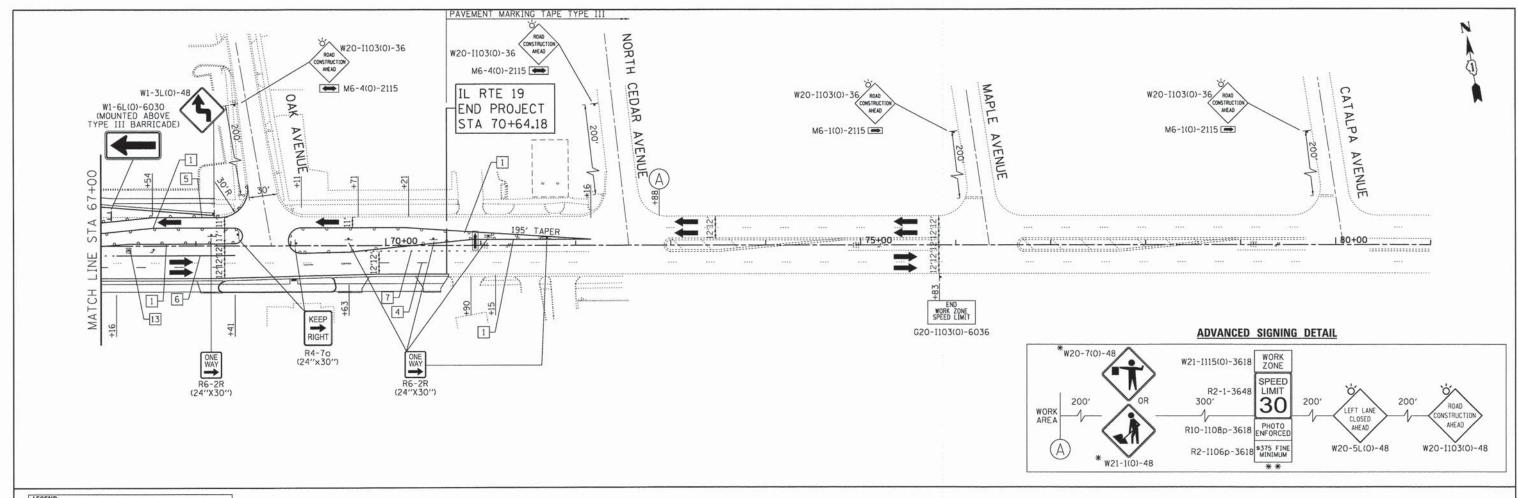
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	PLOT DATE = 2/19/2015	DATE	-	2/2/2015	REVISED -	

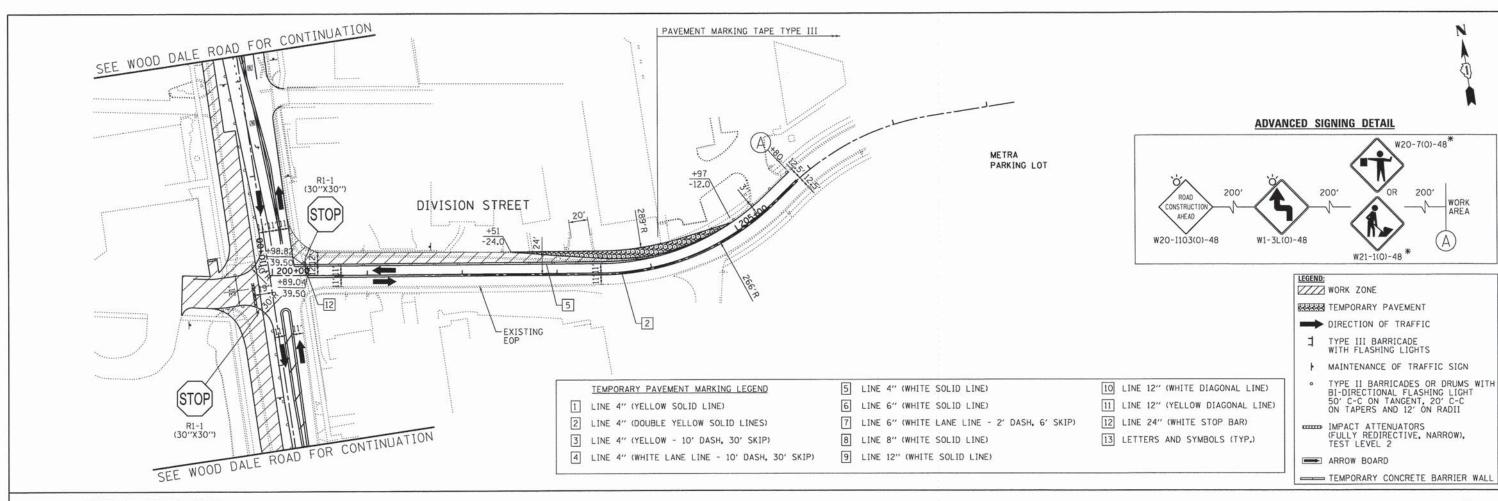	SUC	GESTED I	ΛAI	NTE	NA	NCE OF	TRAFFIC	- STAGE 1
		DIVISION	IS	TRE	ET	/COMN	TERCIAL S	STREET
SCALE:	1"=50"	SHEET NO.	5	OF	5	SHEETS	STA.	TO STA.

F.A.U. RTE.	SECT	ION NO.		COUNTY	TOTAL SHEETS	SHEET NO.
1321	11-000	48-00-SP		DUPAGE	277	43
				CONTRACT	NO. 6	3872
FED. ROA	D DIST. NO.	ILLINOIS	FED. AID	PROJECT		

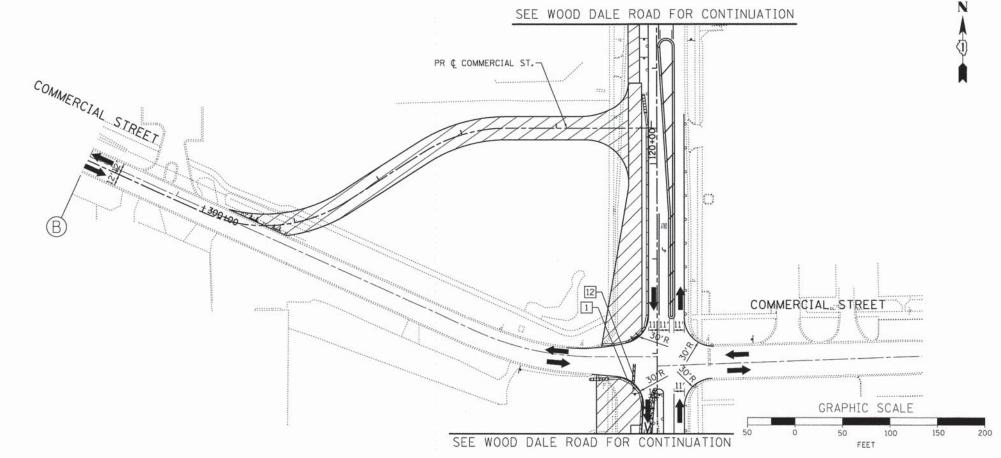

COMPANY NAME:
PROJECT CONTACT:
CLIENT
DATE PLOTIED: \$50ATE\$
FIEL NAME: 025.mort)
PLOT DRIVER: poff.cut
PEN TABLE: stondore

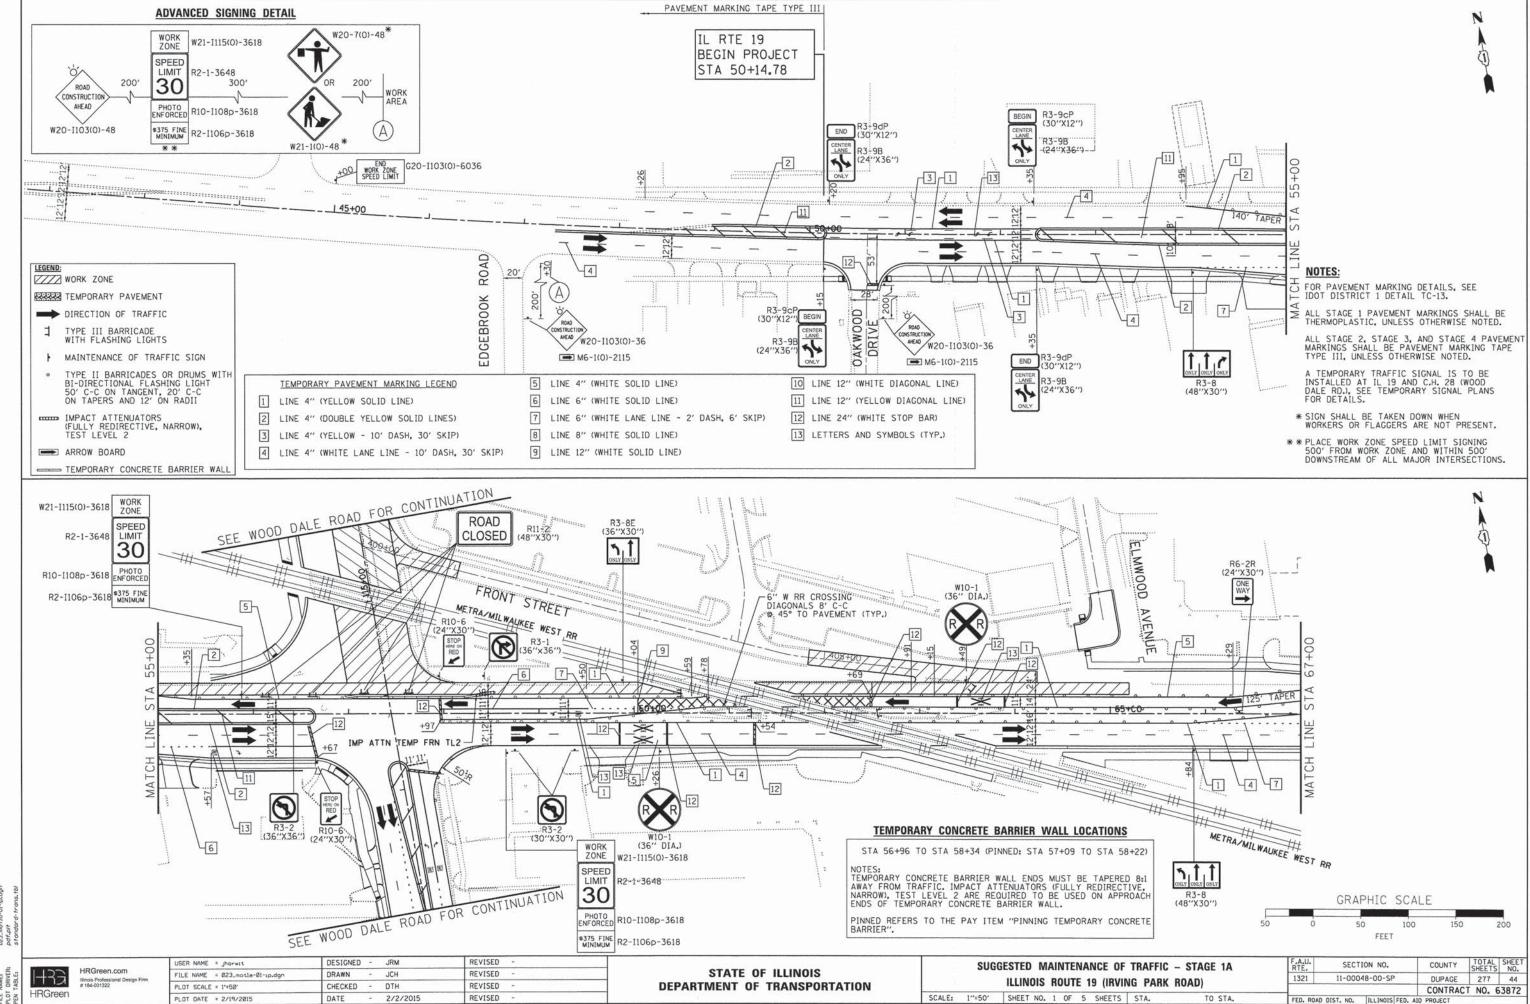

WORK ZONE TEMPORARY PAVEMENT DIRECTION OF TRAFFIC TYPE III BARRICADE WITH FLASHING LIGHTS MAINTENANCE OF TRAFFIC SIGN TYPE II BARRICADES OR DRUMS WITH BI-DIRECTIONAL FLASHING LIGHT 50' C-C ON TANGENT, 20' C-C ON TAPERS AND 12' ON RADII IMPACT ATTENUATORS (FULLY REDIRECTIVE, NARROW), TEST LEVEL 2 ARROW BOARD TEMPORARY CONCRETE BARRIER WALL

TEMPORARY PAVEMENT MARKING LEGEND

LINE 4" (DOUBLE YELLOW SOLID LINES)

LINE 4" (YELLOW - 10' DASH, 30' SKIP)

4 LINE 4" (WHITE LANE LINE - 10' DASH, 30' SKIP)

LINE 4" (YELLOW SOLID LINE)

5 LINE 4" (WHITE SOLID LINE)

10 LINE 12" (WHITE DIAGONAL LINE)

6 LINE 6" (WHITE SOLID LINE)

11 LINE 12" (YELLOW DIAGONAL LINE)

7 LINE 6" (WHITE LANE LINE - 2' DASH, 6' SKIP)

12 LINE 24" (WHITE STOP BAR)

8 LINE 8" (WHITE SOLID LINE)

13 LETTERS AND SYMBOLS (TYP.)

9 LINE 12" (WHITE SOLID LINE)

NOTES:

FOR PAVEMENT MARKING DETAILS, SEE IDOT DISTRICT 1 DETAIL TC-13.

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- * SIGN SHALL BE TAKEN DOWN WHEN WORKERS OR FLAGGERS ARE NOT PRESENT.
- ** PLACE WORK ZONE SPEED LIMIT SIGNING 500' FROM WORK ZONE AND WITHIN 500' DOWNSTREAM OF ALL MAJOR INTERSECTIONS.

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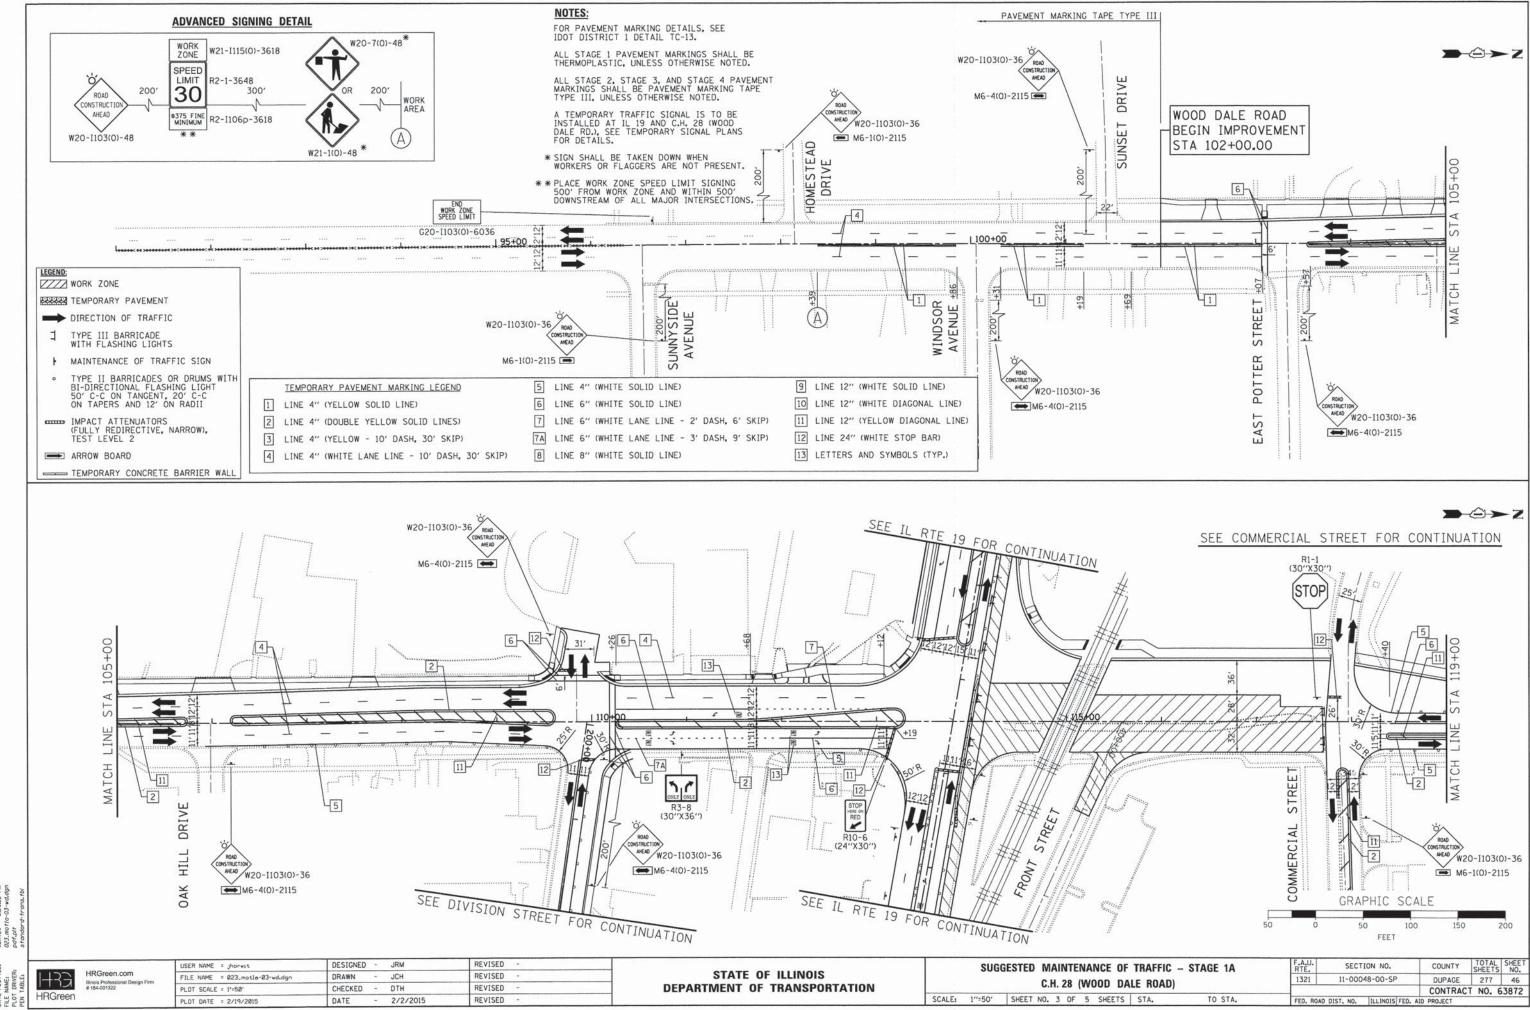
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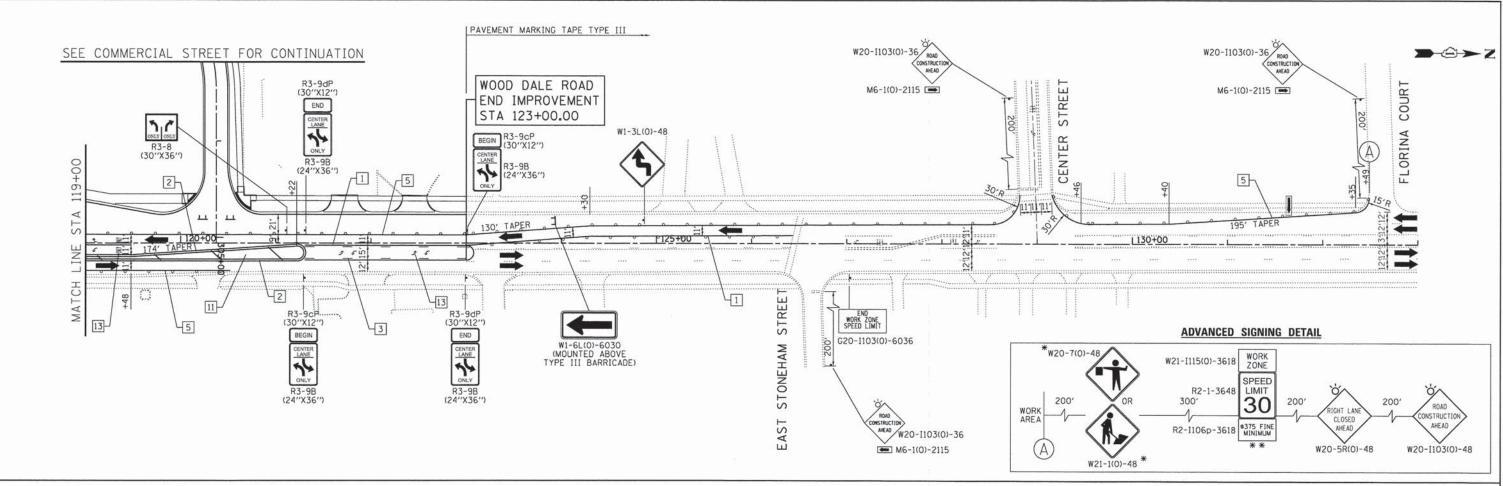
STATE OF ILLINOIS DEPARTMENT OF TRANSPORTATION

SUG	GESTED	M	All	NTE	NA	NCE	0F	TR	AFFIC	- ST/	AGE	1A
	ILLINO	IS	R	TUC	E '	19 (IF	RVIN	G	PARK	ROAD)	
=50'	SHEET	NO.	2	OF	5	SHEE	TS	ST	Α.		TO	STA.

COUNTY TOTAL SHEE NO. SECTION NO. DUPAGE 277 45 11-00048-00-SP 1321 CONTRACT NO. 63872 FED. ROAD DIST. NO. | ILLINOIS FED. AID PROJECT

SCALE: 1"=5





LEGEND: WORK ZONE

TEMPORARY PAVEMENT

DIRECTION OF TRAFFIC

TYPE III BARRICADE

MAINTENANCE OF TRAFFIC SIGN

WITH FLASHING LIGHTS

TYPE II BARRICADES OR DRUMS WITH BI-DIRECTIONAL FLASHING LIGHT 50' C-C ON TANGENT, 20' C-C ON TAPERS AND 12' ON RADII

IMPACT ATTENUATORS (FULLY REDIRECTIVE, NARROW),

ARROW BOARD

---- TEMPORARY CONCRETE BARRIER WALL

TEMPORARY PAVEMENT MARKING LEGEND

2 LINE 4" (DOUBLE YELLOW SOLID LINES)

3 LINE 4" (YELLOW - 10' DASH, 30' SKIP)

1 LINE 4" (YELLOW SOLID LINE)

4 LINE 4" (WHITE LANE LINE - 10' DASH, 30' SKIP)

5 LINE 4" (WHITE SOLID LINE)

6 LINE 6" (WHITE SOLID LINE)

7 LINE 6" (WHITE LANE LINE - 2' DASH, 6' SKIP)

8 LINE 8" (WHITE SOLID LINE) 9 LINE 12" (WHITE SOLID LINE) 10 LINE 12" (WHITE DIAGONAL LINE)

11 LINE 12" (YELLOW DIAGONAL LINE) 12 LINE 24" (WHITE STOP BAR)

13 LETTERS AND SYMBOLS (TYP.)

FOR PAVEMENT MARKING DETAILS, SEE IDOT DISTRICT 1 DETAIL TC-13.

ALL STAGE 1 PAVEMENT MARKINGS SHALL BE THERMOPLASTIC, UNLESS OTHERWISE NOTED.

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A TEMPORARY TRAFFIC SIGNAL IS TO BE INSTALLED AT IL 19 AND C.H. 28 (WOOD DALE RD.), SEE TEMPORARY SIGNAL PLANS FOR DETAILS.

- * SIGN SHALL BE TAKEN DOWN WHEN WORKERS OR FLAGGERS ARE NOT PRESENT.
- ** PLACE WORK ZONE SPEED LIMIT SIGNING 500' FROM WORK ZONE AND WITHIN 500' DOWNSTREAM OF ALL MAJOR INTERSECTIONS.


GRAPHIC SCALE

HRGreen.com 1433 **HRGreen**

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PLOT DATE = 2/19/2015	DATE - 2/2/2015	REVISED -	

	SUG	GESTED	M	All	NTE	NA	NCE	0F	TRAFFIC	- STAGE	1A
			C.I	Н.	28	(W	OOD	DA	LE ROAD)	
SCALE:	1"=50"	SHEET	NO.	4	OF	5	SHEE	TS	STA.	TO	STA.

ED DO	AD DIST. NO.	ILLINOIS FED.	CONTRAC	T NO. 6	3872
1321	11-000	48-00-SP	DUPAGE	277	47
A.U. RTE.	SECT	ION NO.	COUNTY	TOTAL	SHEET NO.

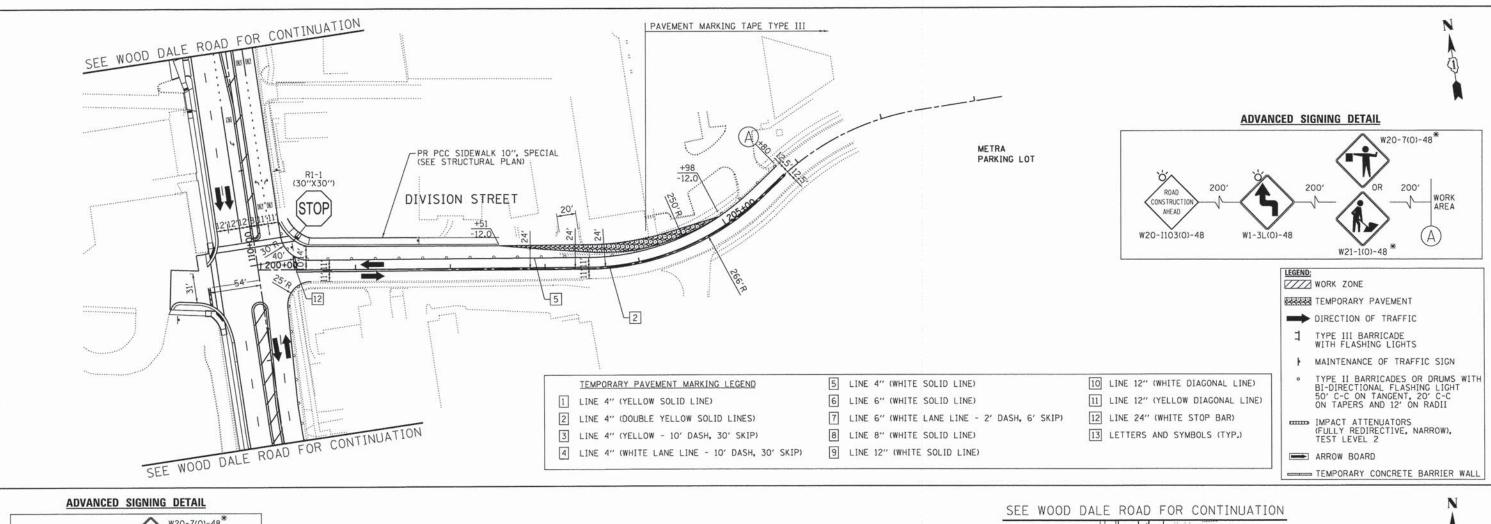



W21-1(0)-48 *

NOTES


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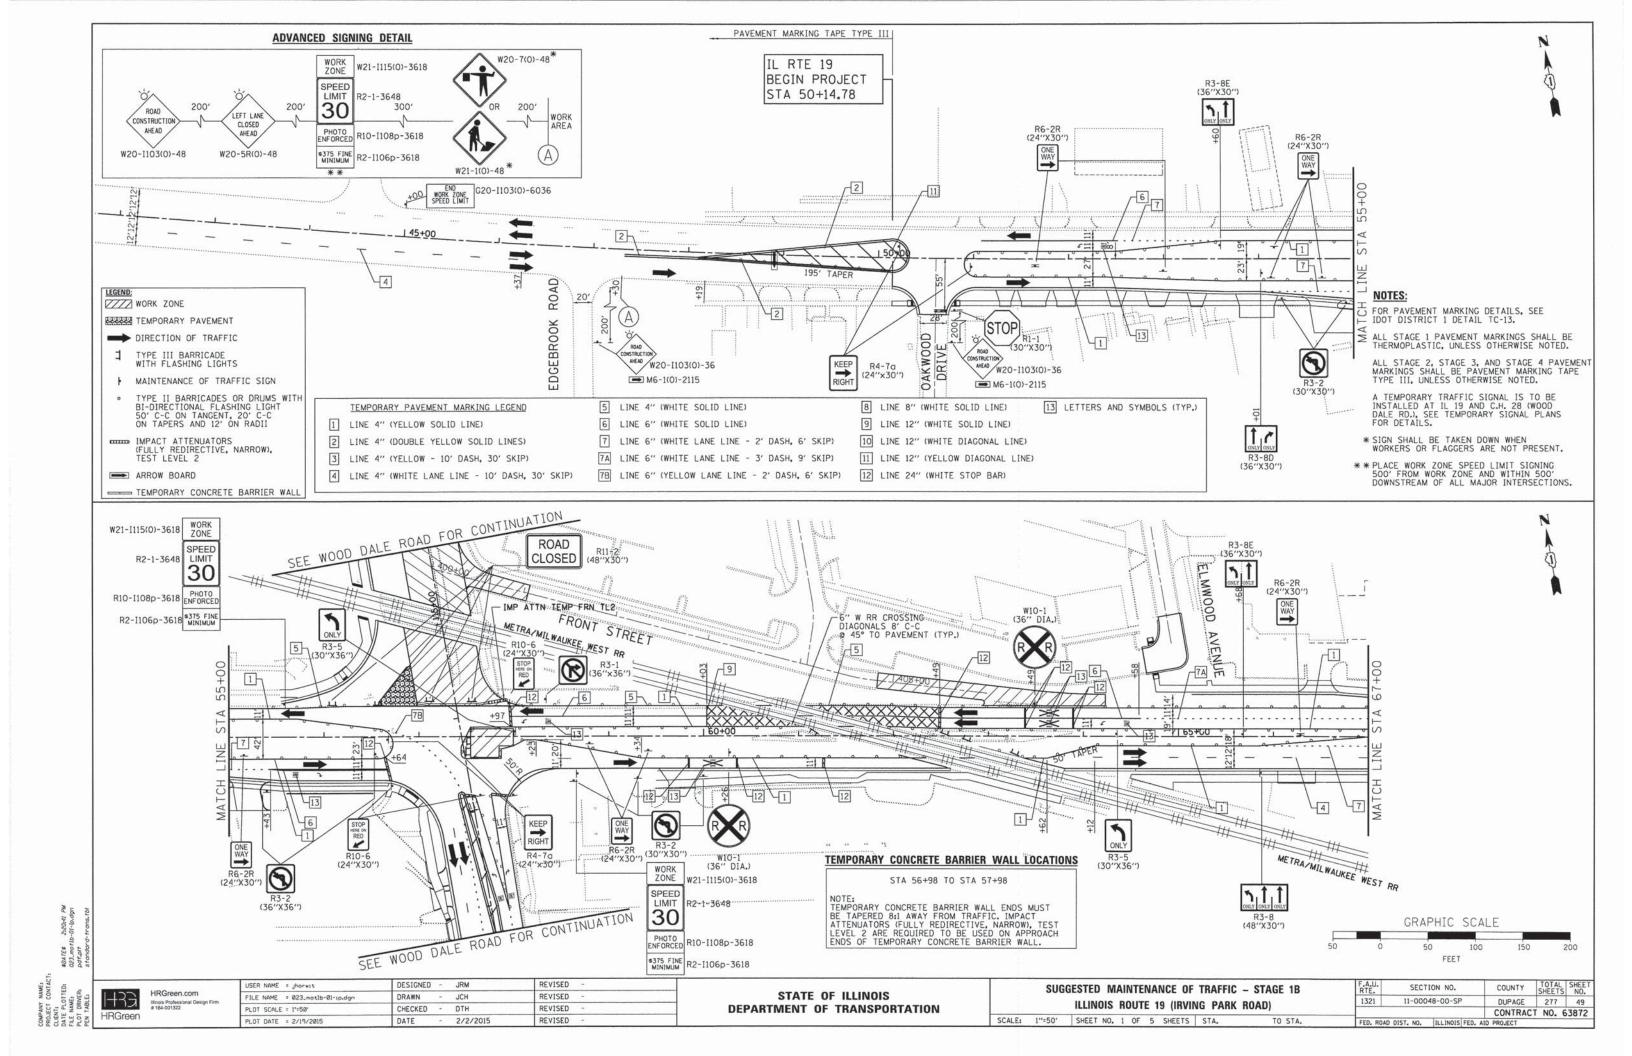
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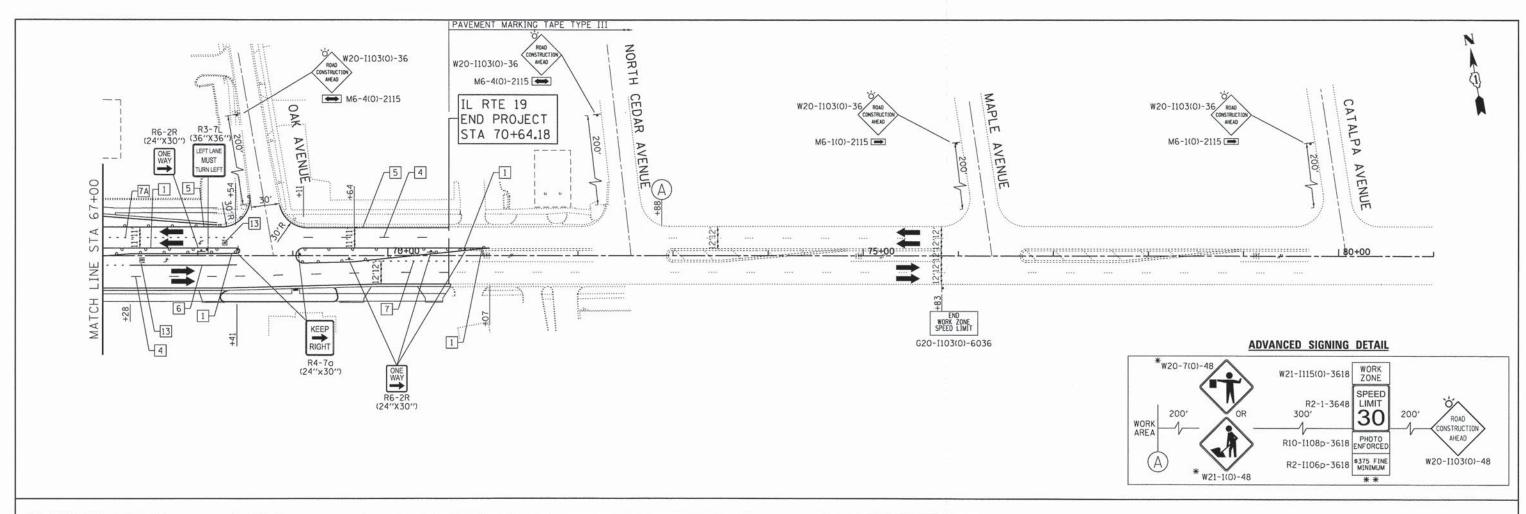
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	SUG	GESTED	M	AINT	ΓENA	NCE OF	TRAFF	IC - STAGE	1A
		DIVIS	ION	ST	REET	COMP	MERCIA	L STREET	
SCALE:	1"=50"	SHEET	NO.	5 0	F 5	SHEETS	STA.	TO	STA.

F.A.U. RTE.	SECT	ION NO.	COUNTY	TOTAL SHEETS	SHEET NO.
1321	11-000	48-00-SP	DUPAGE	277	48
			CONTRACT	NO. E	3872
FED. ROAD	DIST. NO.	ILLINOIS FED.	AID PROJECT		





LEGEND:

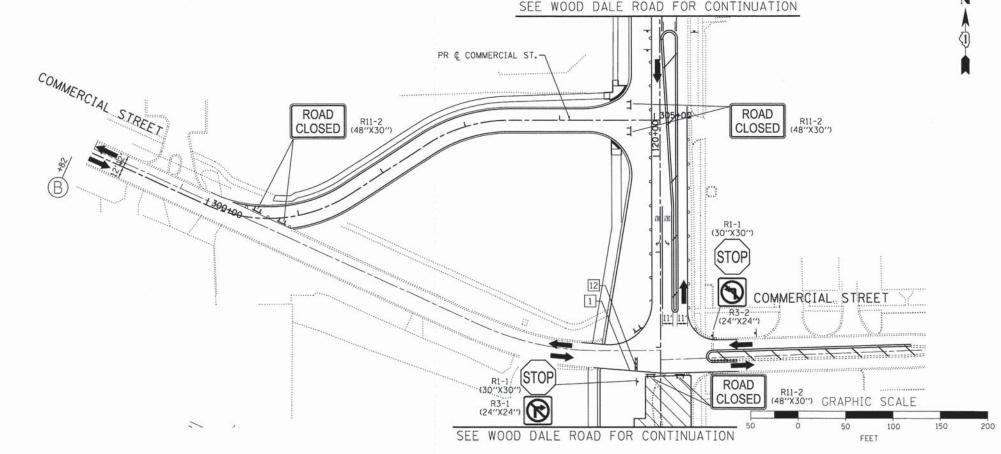WORK ZONE

TEMPORARY PAVEMENT

DIRECTION OF TRAFFIC

WITH FLASHING LIGHTS

MAINTENANCE OF TRAFFIC SIGN

 TYPE II BARRICADES OR DRUMS WITH BI-DIRECTIONAL FLASHING LIGHT 50' C-C ON TANGENT, 20' C-C ON TAPERS AND 12' ON RADII

IMPACT ATTENUATORS
(FULLY REDIRECTIVE, NARROW),
TEST LEVEL 2

ARROW BOARD

TEMPORARY CONCRETE BARRIER WALL

NOTES

FOR PAVEMENT MARKING DETAILS, SEE IDOT DISTRICT 1 DETAIL TC-13.

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- ** PLACE WORK ZONE SPEED LIMIT SIGNING 500' FROM WORK ZONE AND WITHIN 500' DOWNSTREAM OF ALL MAJOR INTERSECTIONS.

- TEMPORARY PAVEMENT MARKING LEGEND
- LINE 4" (YELLOW SOLID LINE)
- 2 LINE 4" (DOUBLE YELLOW SOLID LINES)
- 3 LINE 4" (YELLOW 10' DASH, 30' SKIP)
- 4 LINE 4" (WHITE LANE LINE 10' DASH, 30' SKIP)
- 5 LINE 4" (WHITE SOLID LINE)
- LINE 6" (WHITE SOLID LINE)
- 7] LINE 6" (WHITE LANE LINE 2' DASH, 6' SKIP)
- 7A LINE 6" (WHITE LANE LINE 3' DASH, 9' SKIP)
- 8 LINE 8" (WHITE SOLID LINE)

- 9 LINE 12" (WHITE SOLID LINE)
- 10 LINE 12" (WHITE DIAGONAL LINE)
- 11 LINE 12" (YELLOW DIAGONAL LINE)
- 12 LINE 24" (WHITE STOP BAR)
- 13 LETTERS AND SYMBOLS (TYP.)

		GRAPHI(C SCALE		
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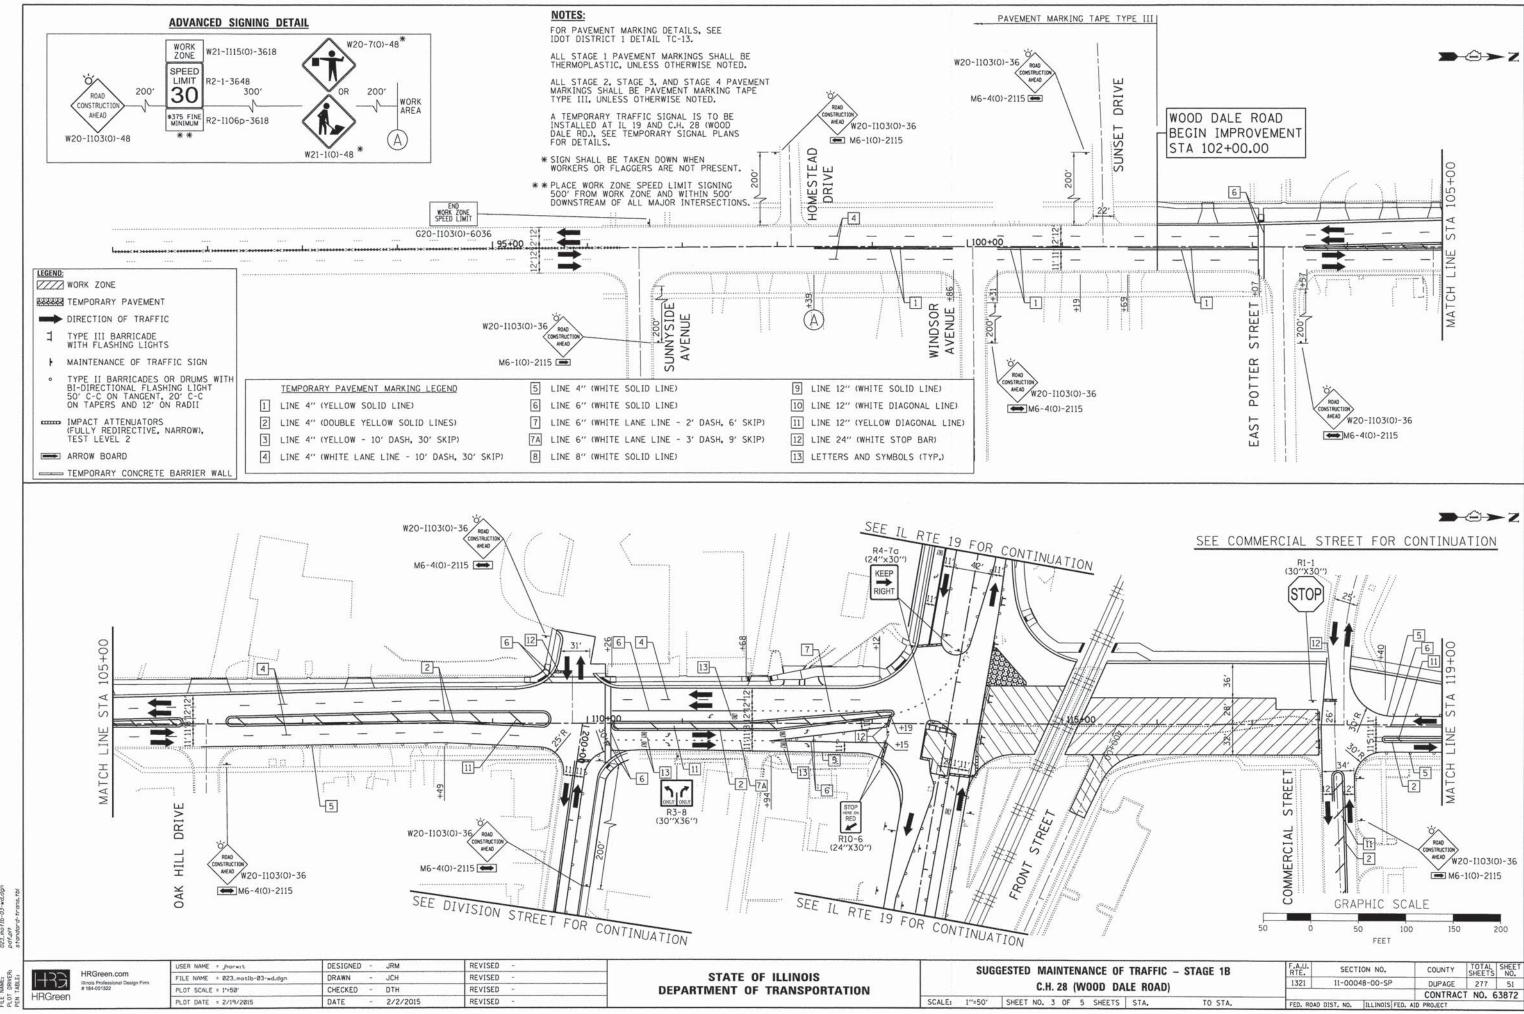
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PLOT DATE = 2/19/2015	DATE -	2/2/2015	REVISED -


STATE OF ILLINOIS
DEPARTMENT OF TRANSPORTATION

SUGGESTED MAINTENANCE OF TRAFFIC - STAGE 1B
ILLINOIS ROUTE 19 (IRVING PARK ROAD)

SCALE: 1"=50' SHEET NO. 2 OF 5 SHEETS STA. TO STA.



COMPANY NAME;
PROJECT CONTACT;
CLIENT;
DATE PLOTTED; \$0ATE\$
FILE NAME; 023.most
PLOT DRIVER;
PEN TABLE; stondore

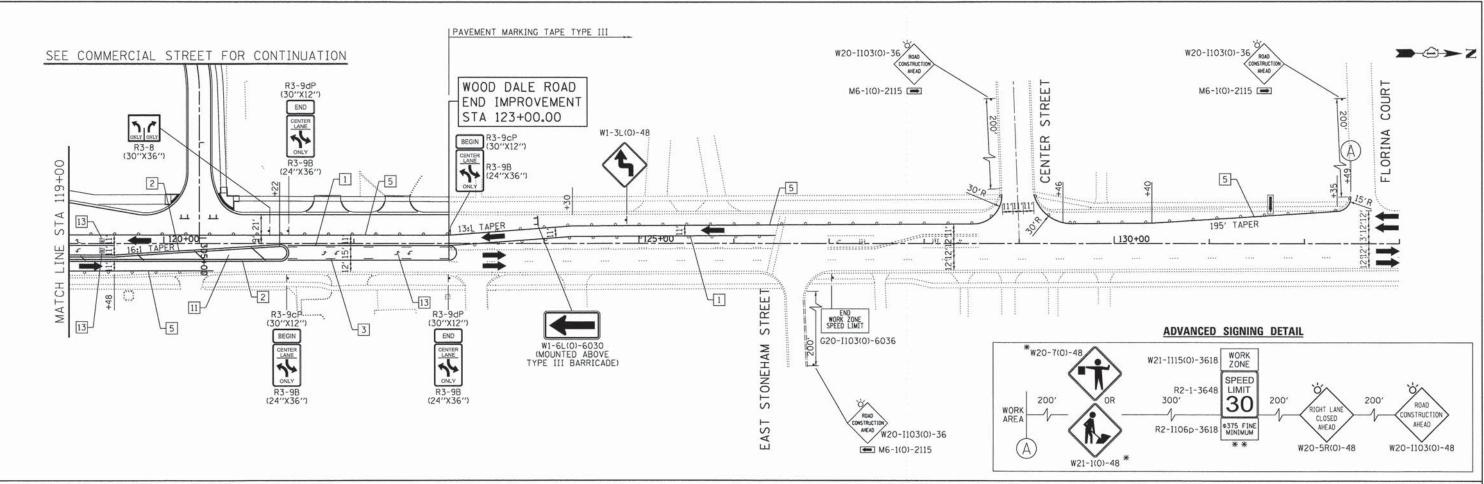

WORK ZONE

TEMPORARY PAVEMENT

DIRECTION OF TRAFFIC

TYPE III BARRICADE WITH FLASHING LIGHTS

MAINTENANCE OF TRAFFIC SIGN

TYPE II BARRICADES OR DRUMS WITH BI-DIRECTIONAL FLASHING LIGHT 50' C-C ON TANGENT, 20' C-C ON TAPERS AND 12' ON RADII

IMPACT ATTENUATORS (FULLY REDIRECTIVE, NARROW), TEST LEVEL 2

ARROW BOARD

TEMPORARY CONCRETE BARRIER WALL

TEMPORARY PAVEMENT MARKING LEGEND

2 LINE 4" (DOUBLE YELLOW SOLID LINES)

3 LINE 4" (YELLOW - 10' DASH, 30' SKIP)

4 LINE 4" (WHITE LANE LINE - 10' DASH, 30' SKIP)

1 LINE 4" (YELLOW SOLID LINE)

5 LINE 4" (WHITE SOLID LINE)

LINE 6" (WHITE SOLID LINE)

LINE 6" (WHITE LANE LINE - 2' DASH, 6' SKIP)

LINE 8" (WHITE SOLID LINE) 9 LINE 12" (WHITE SOLID LINE) 10 LINE 12" (WHITE DIAGONAL LINE)

11 LINE 12" (YELLOW DIAGONAL LINE)

12 LINE 24" (WHITE STOP BAR)

13 LETTERS AND SYMBOLS (TYP.)

NOTES:

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** PLACE WORK ZONE SPEED LIMIT SIGNING 500' FROM WORK ZONE AND WITHIN 500' DOWNSTREAM OF ALL MAJOR INTERSECTIONS.

GRAPHIC SCALE 100 FEET


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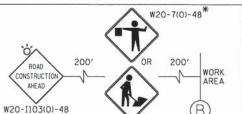
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	PLOT SCALE = 1"=50"	CHECKED	7	DTH	REVISED	•
	PLOT DATE = 2/19/2015	DATE	-	2/2/2015	REVISED	-

STATE OF ILLINOIS **DEPARTMENT OF TRANSPORTATION**

SUGGESTED MAINTENANCE OF TRAFFIC - STAGE 1B C.H. 28 (WOOD DALE ROAD) SCALE: 1"=50" SHEET NO. 4 OF 5 SHEETS STA. TO STA.

.U. E.	SECTION NO.	COUNTY	TOTAL	SHEET NO.
21	11-00048-00-SP	DUPAGE	277	52
		CONTRAC	T NO. 6	3872
ROAD	DIST NO THE INOIS FED	AID PROJECT		_



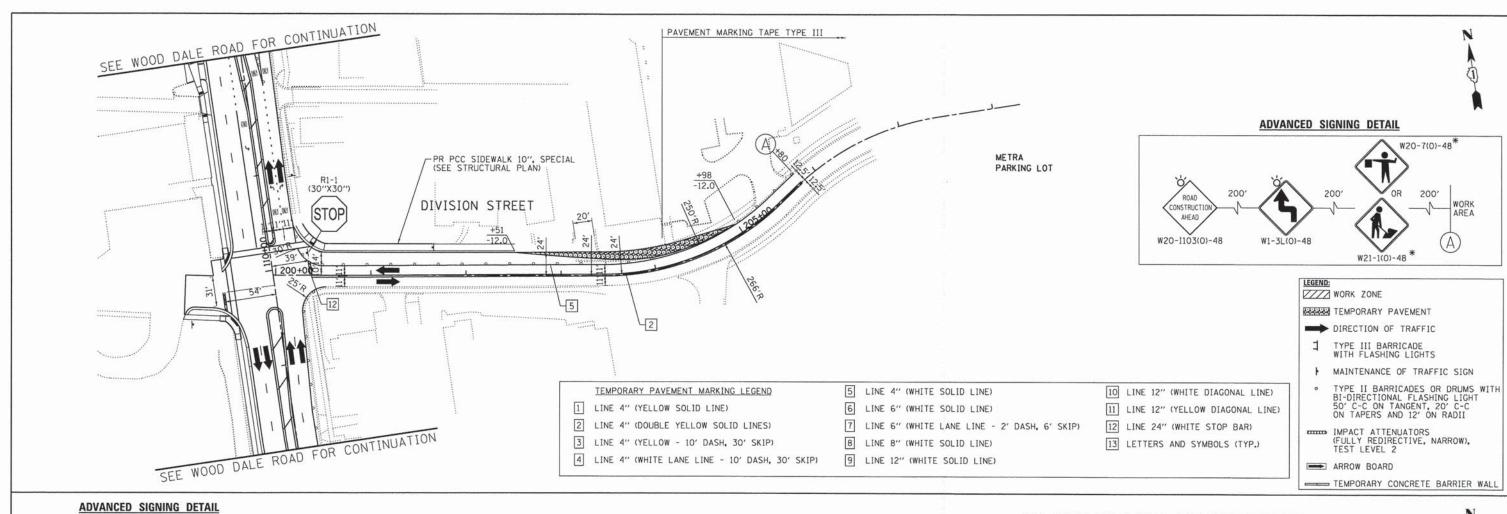

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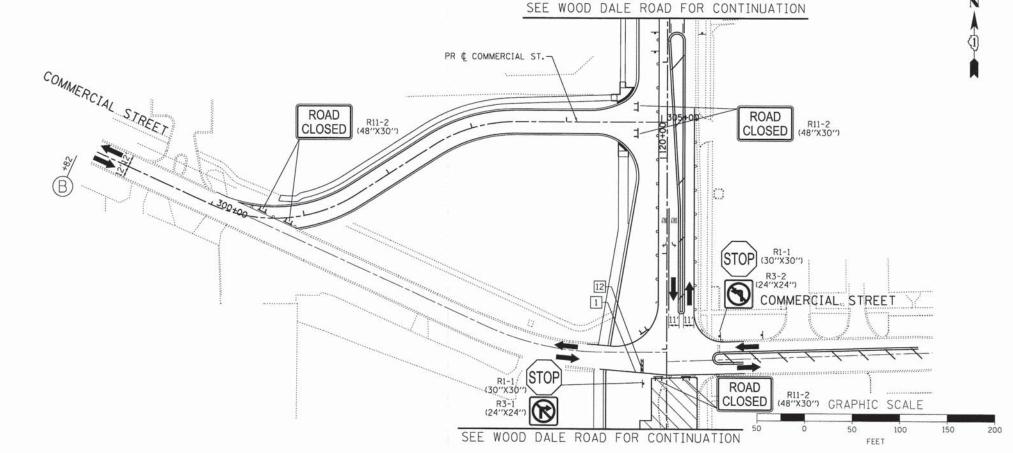
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- * SIGN SHALL BE TAKEN DOWN WHEN WORKERS OR FLAGGERS ARE NOT PRESENT.
- ** PLACE WORK ZONE SPEED LIMIT SIGNING 500' FROM WORK ZONE AND WITHIN 500' DOWNSTREAM OF ALL MAJOR INTERSECTIONS.



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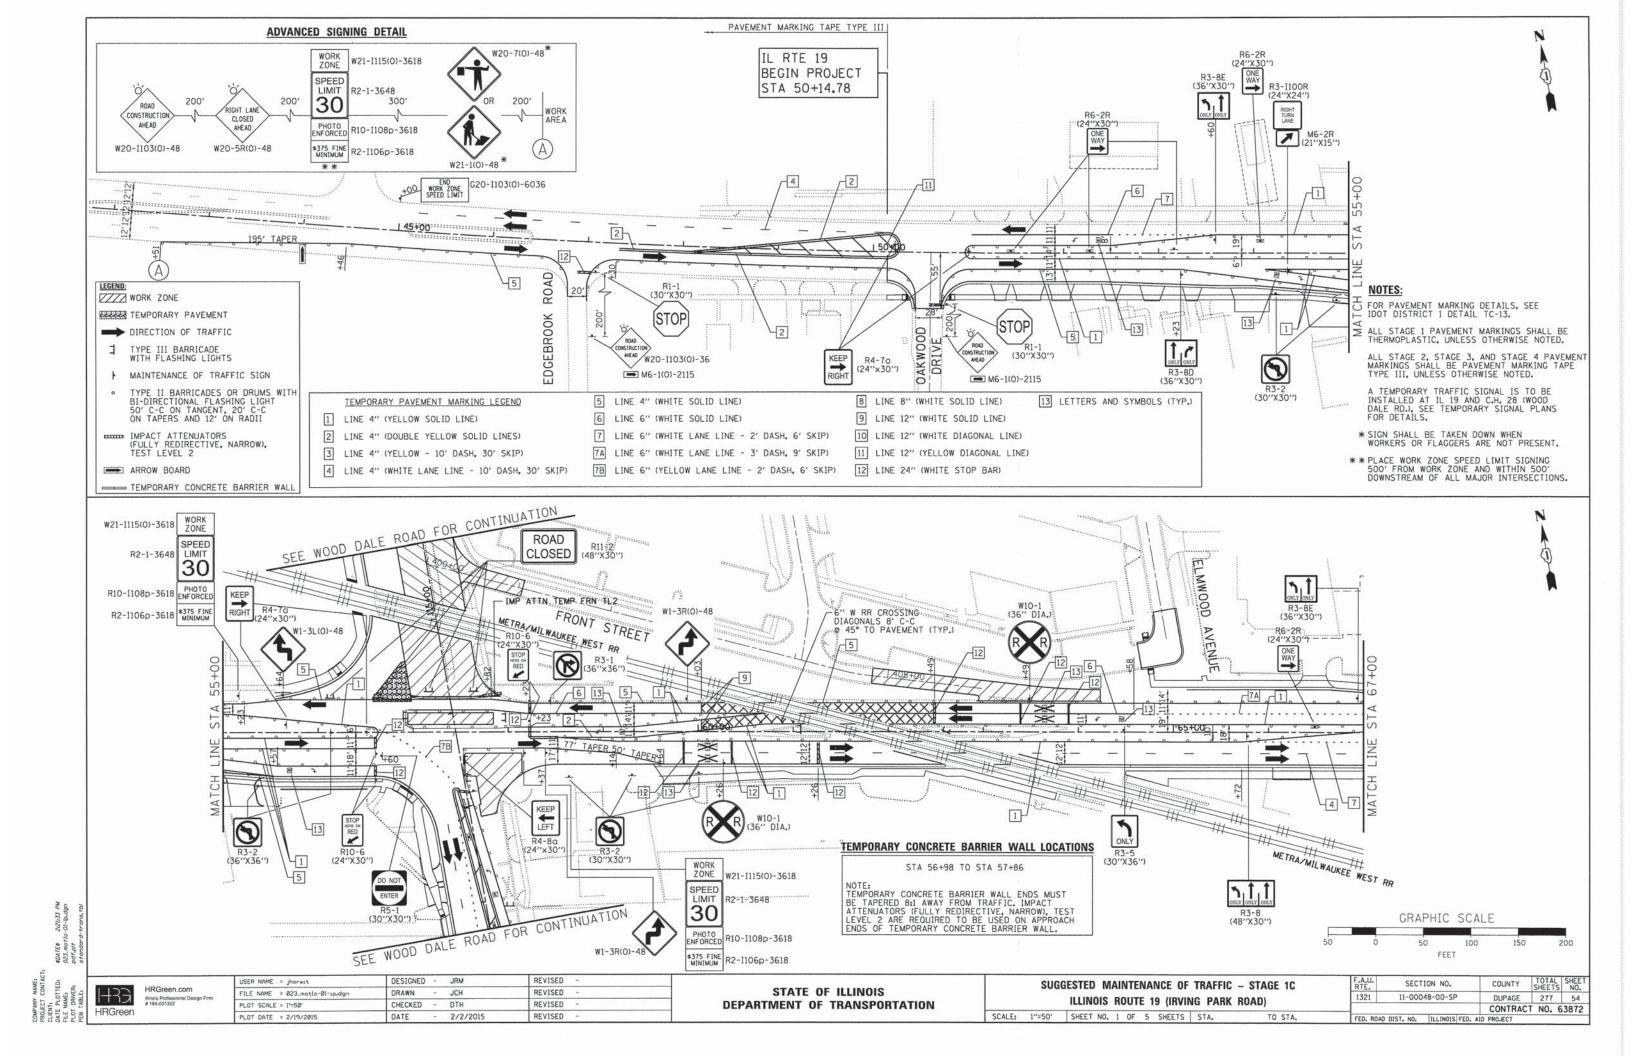
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PLOT DATE = 2/19/2015	DATE	-	2/2/2015	REVISED -	


STATE OF ILLINOIS **DEPARTMENT OF TRANSPORTATION**

	SUG	GESTED N	IAI	NTE	NA	NCE OF	TRAFF	IC - STAGE 1B
		DIVISION	1 8	TRE	EET	/COMN	IERCIAL	STREET
SCALE:	1"=50"	SHEET NO.	5	OF	5	SHEETS	STA.	TO STA.

	SECT	ION NO.		COUNTY	TOTAL	SHEET NO.
	11-000	48-00-SP	98	DUPAGE	277	53
				CONTRAC	T NO. 6	3872
CA	DIST. NO.	ILLINOIS	FED. AIC	PROJECT	Will Silver	

1321



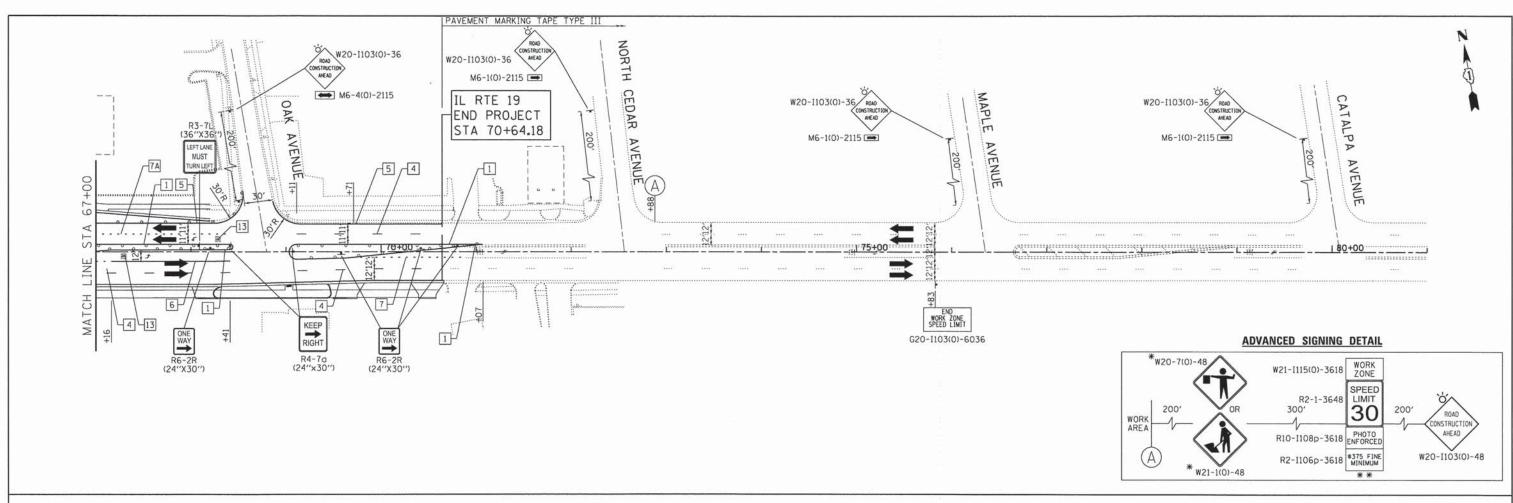

WORK ZONE TEMPORARY PAVEMENT DIRECTION OF TRAFFIC TYPE III BARRICADE WITH FLASHING LIGHTS MAINTENANCE OF TRAFFIC SIGN TYPE II BARRICADES OR DRUMS WITH BI-DIRECTIONAL FLASHING LIGHT 50' C-C ON TANGENT, 20' C-C ON TAPERS AND 12' ON RADII IMPACT ATTENUATORS
(FULLY REDIRECTIVE, NARROW),
TEST LEVEL 2 ARROW BOARD - TEMPORARY CONCRETE BARRIER WALL

FOR PAVEMENT MARKING DETAILS, SEE IDOT DISTRICT 1 DETAIL TC-13.

ALL STAGE 1 PAVEMENT MARKINGS SHALL BE THERMOPLASTIC, UNLESS OTHERWISE NOTED.

ALL STAGE 2, STAGE 3, AND STAGE 4 PAVEMENT MARKINGS SHALL BE PAVEMENT MARKING TAPE TYPE III, UNLESS OTHERWISE NOTED.

A TEMPORARY TRAFFIC SIGNAL IS TO BE INSTALLED AT IL 19 AND C.H. 28 (WOOD DALE RD.), SEE TEMPORARY SIGNAL PLANS

- * SIGN SHALL BE TAKEN DOWN WHEN WORKERS OR FLAGGERS ARE NOT PRESENT.
- ** PLACE WORK ZONE SPEED LIMIT SIGNING 500' FROM WORK ZONE AND WITHIN 500' DOWNSTREAM OF ALL MAJOR INTERSECTIONS.

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TEMPORARY	DAVEMENT	MADKING	LECEND
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2 LINE 4" (DOUBLE YELLOW SOLID LINES)

3 LINE 4" (YELLOW - 10' DASH, 30' SKIP)

4 LINE 4" (WHITE LANE LINE - 10' DASH, 30' SKIP)

1 LINE 4" (YELLOW SOLID LINE)

- 5 LINE 4" (WHITE SOLID LINE)
- LINE 6" (WHITE SOLID LINE)
- 7 LINE 6" (WHITE LANE LINE 2' DASH, 6' SKIP)
- 7A LINE 6" (WHITE LANE LINE 3' DASH, 9' SKIP)
- 8 LINE 8" (WHITE SOLID LINE)
- 9 LINE 12" (WHITE SOLID LINE)
- 10 LINE 12" (WHITE DIAGONAL LINE) 11 LINE 12" (YELLOW DIAGONAL LINE)
- 12 LINE 24" (WHITE STOP BAR)
- 13 LETTERS AND SYMBOLS (TYP.)

		GRAPHIC	SCALE		
50	0	50	100	150	200
		FE	ET		


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SUGGESTED MAINTENANCE OF TRAFFIC - STAGE 1C ILLINOIS ROUTE 19 (IRVING PARK ROAD) SCALE: 1"=50' SHEET NO. 2 OF 5 SHEETS STA.

SECTION NO. COUNTY 1321 11-00048-00-SP DUPAGE 277 55 CONTRACT NO. 63872 FED. ROAD DIST. NO. | ILLINOIS FED. AID PROJECT

HRGreen.com **HRGreen**

REVISED PLOT DATE = 2/19/2015 DATE 2/2/2015

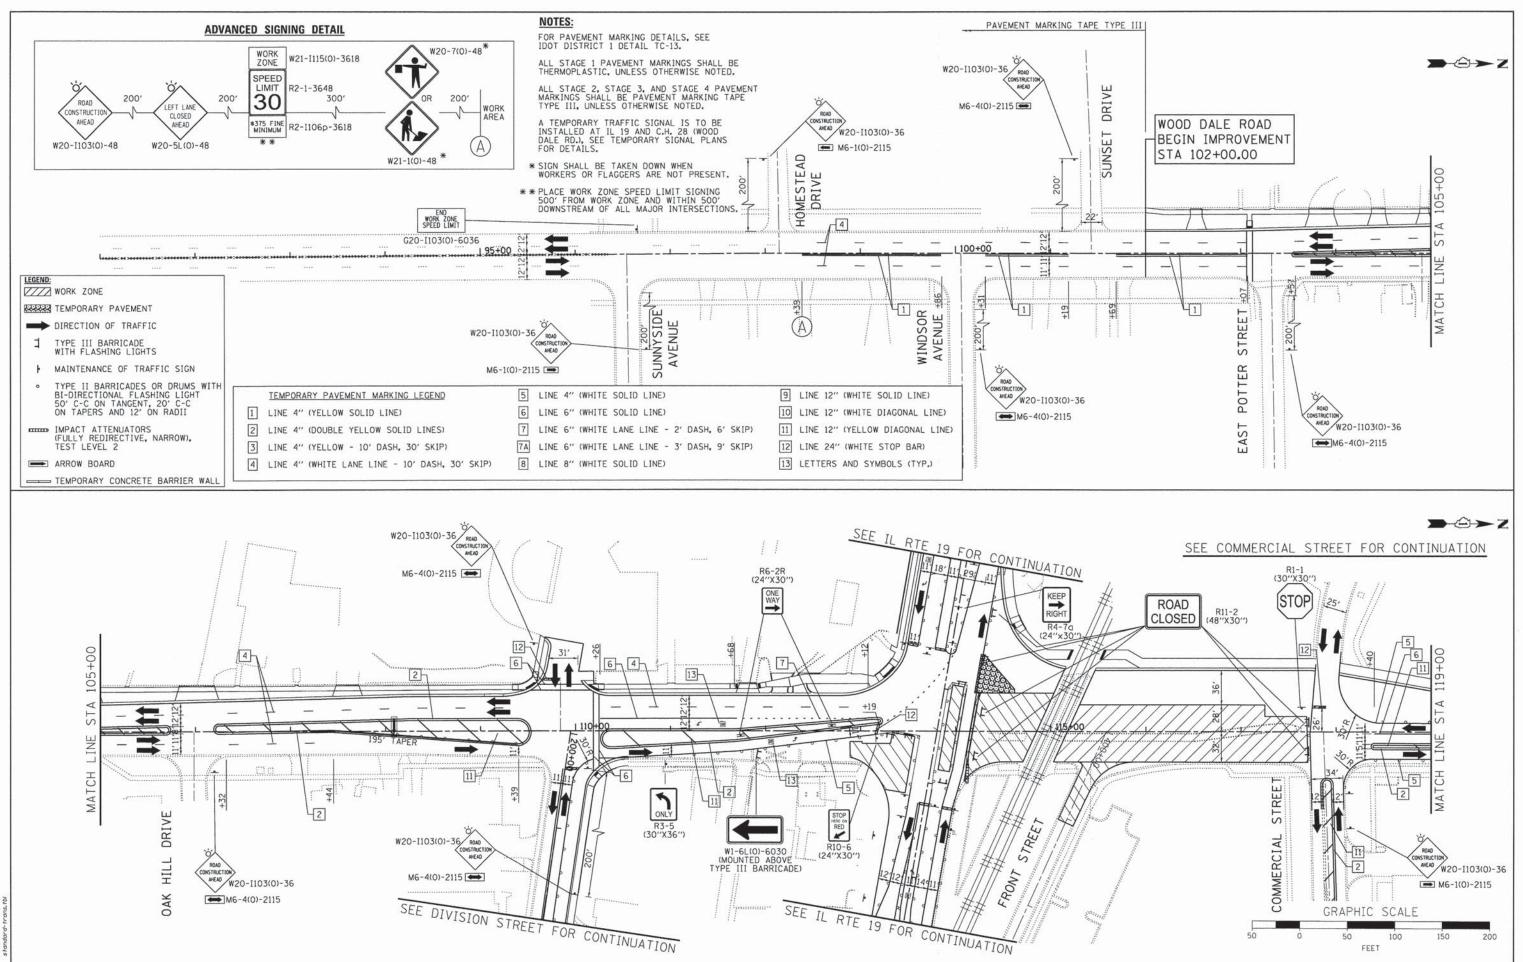

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PROJECT CONTACT:
CLIENT:
DATE PLOTTED: \$
FILE NAME: 0
PLOT DRIVER: P
PEN TABLE: \$

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Illinois Professional Design Fi
184-001322

STATE OF ILLINOIS DEPARTMENT OF TRANSPORTATION

SUGGESTED MAINTENANCE OF TRAFFIC - STAGE 1C


C.H. 28 (WOOD DALE ROAD)

SCALE: 1"=50" SHEET NO. 3 OF 5 SHEETS STA. TO STA.

LU. SECTION NO. COUNTY TOTAL SHEETS NO.
21 11-00048-00-SP DUPAGE 277 56

CONTRACT NO. 63872

ROAD DIST. NO. | ILLINOIS|FED. AID PROJECT

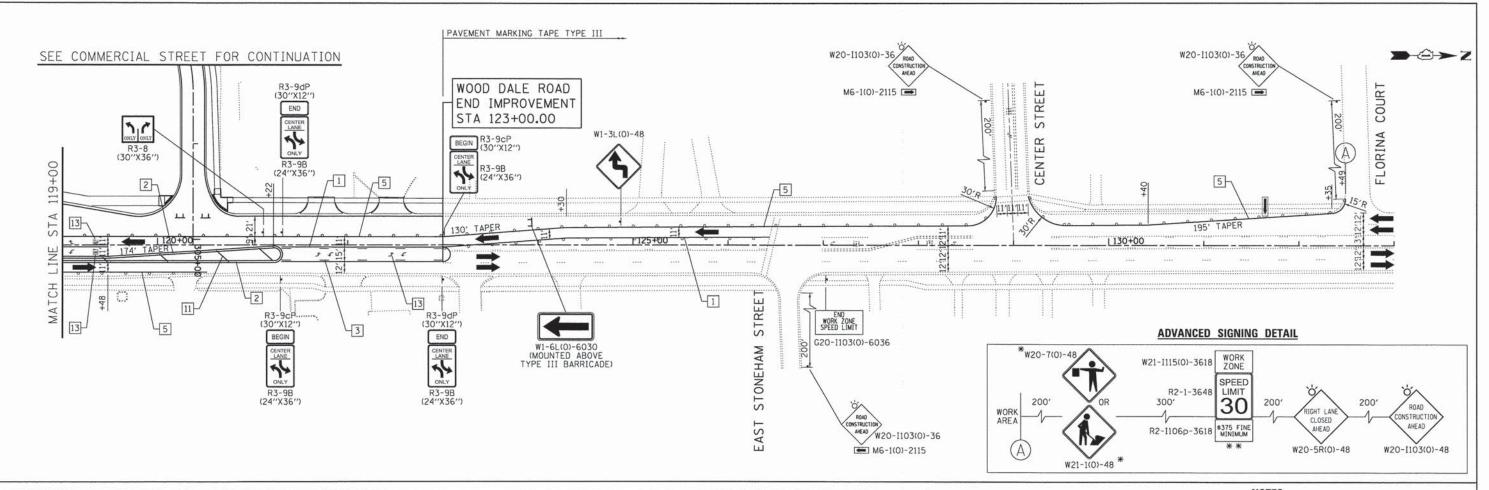

LEGEND WORK ZONE

TEMPORARY PAVEMENT

DIRECTION OF TRAFFIC

- TYPE III BARRICADE WITH FLASHING LIGHTS
- MAINTENANCE OF TRAFFIC SIGN
- TYPE II BARRICADES OR DRUMS WITH BI-DIRECTIONAL FLASHING LIGHT 50' C-C ON TANGENT, 20' C-C ON TAPERS AND 12' ON RADII
- IMPACT ATTENUATORS
 (FULLY REDIRECTIVE, NARROW),
 TEST LEVEL 2
- ARROW BOARD
- TEMPORARY CONCRETE BARRIER WALL

TEMPORARY PAVEMENT MARKING LEGEND

LINE 4" (DOUBLE YELLOW SOLID LINES)

4 LINE 4" (WHITE LANE LINE - 10' DASH, 30' SKIP)

3 LINE 4" (YELLOW - 10' DASH, 30' SKIP)

LINE 4" (YELLOW SOLID LINE)

5 LINE 4" (WHITE SOLID LINE)

LINE 8" (WHITE SOLID LINE)

9 LINE 12" (WHITE SOLID LINE)

LINE 6" (WHITE SOLID LINE)

LINE 6" (WHITE LANE LINE - 2' DASH, 6' SKIP)

- 10 LINE 12" (WHITE DIAGONAL LINE)
- 11 LINE 12" (YELLOW DIAGONAL LINE)
- 12 LINE 24" (WHITE STOP BAR)
- 13 LETTERS AND SYMBOLS (TYP.)

FOR PAVEMENT MARKING DETAILS, SEE IDOT DISTRICT 1 DETAIL TC-13.

ALL STAGE 1 PAVEMENT MARKINGS SHALL BE THERMOPLASTIC, UNLESS OTHERWISE NOTED.

ALL STAGE 2, STAGE 3, AND STAGE 4 PAVEMENT MARKINGS SHALL BE PAVEMENT MARKING TAPE TYPE III, UNLESS OTHERWISE NOTED.

- A TEMPORARY TRAFFIC SIGNAL IS TO BE INSTALLED AT IL 19 AND C.H. 28 (WOOD DALE RD.), SEE TEMPORARY SIGNAL PLANS
- * SIGN SHALL BE TAKEN DOWN WHEN WORKERS OR FLAGGERS ARE NOT PRESENT.
- **PLACE WORK ZONE SPEED LIMIT SIGNING 500' FROM WORK ZONE AND WITHIN 500' DOWNSTREAM OF ALL MAJOR INTERSECTIONS.

		GRAPHIC	C SCALE		
50	0	50	100	150	200
		FE	ET		


HRGreen

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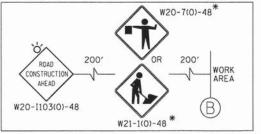
STATE OF ILLINOIS **DEPARTMENT OF TRANSPORTATION**

SUGGESTED MAINTENANCE OF TRAFFIC - STAGE 1C C.H. 28 (WOOD DALE ROAD) SCALE: 1"=50" SHEET NO. 4 OF 5 SHEETS STA. TO STA.

SECTION NO. 1321 11-00048-00-SP DUPAGE 277 57 CONTRACT NO. 63872 FED. ROAD DIST. NO.



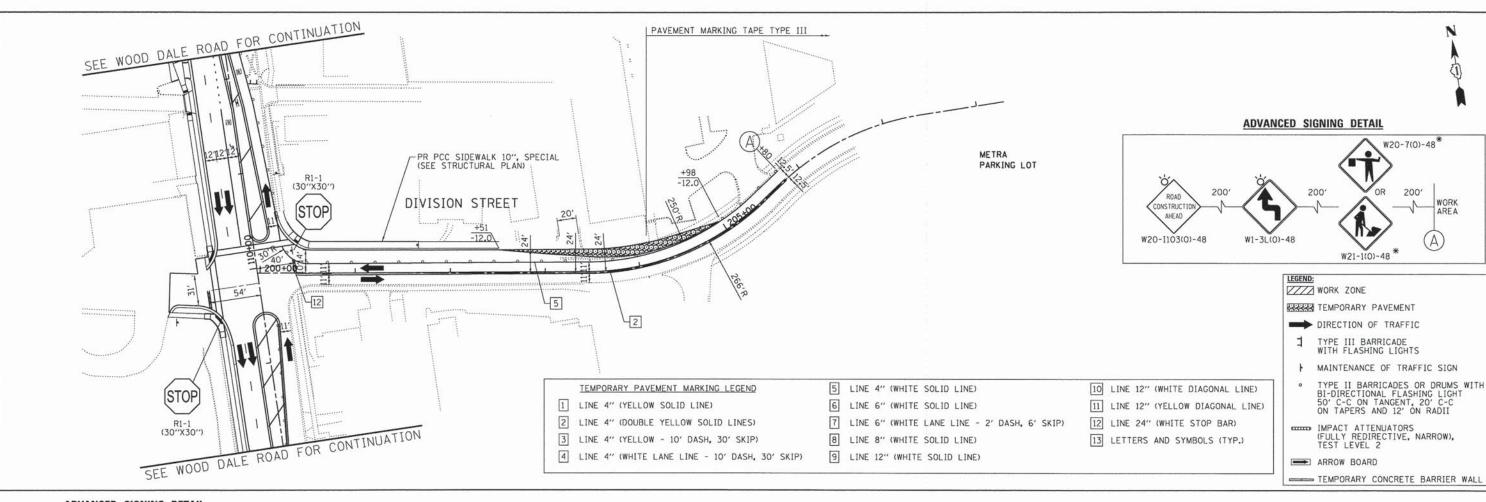




FOR PAVEMENT MARKING DETAILS, SEE IDOT DISTRICT 1 DETAIL TC-13.

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- * SIGN SHALL BE TAKEN DOWN WHEN WORKERS OR FLAGGERS ARE NOT PRESENT.
- **PLACE WORK ZONE SPEED LIMIT SIGNING 500' FROM WORK ZONE AND WITHIN 500' DOWNSTREAM OF ALL MAJOR INTERSECTIONS.



HRGreen.com **HRGreen**


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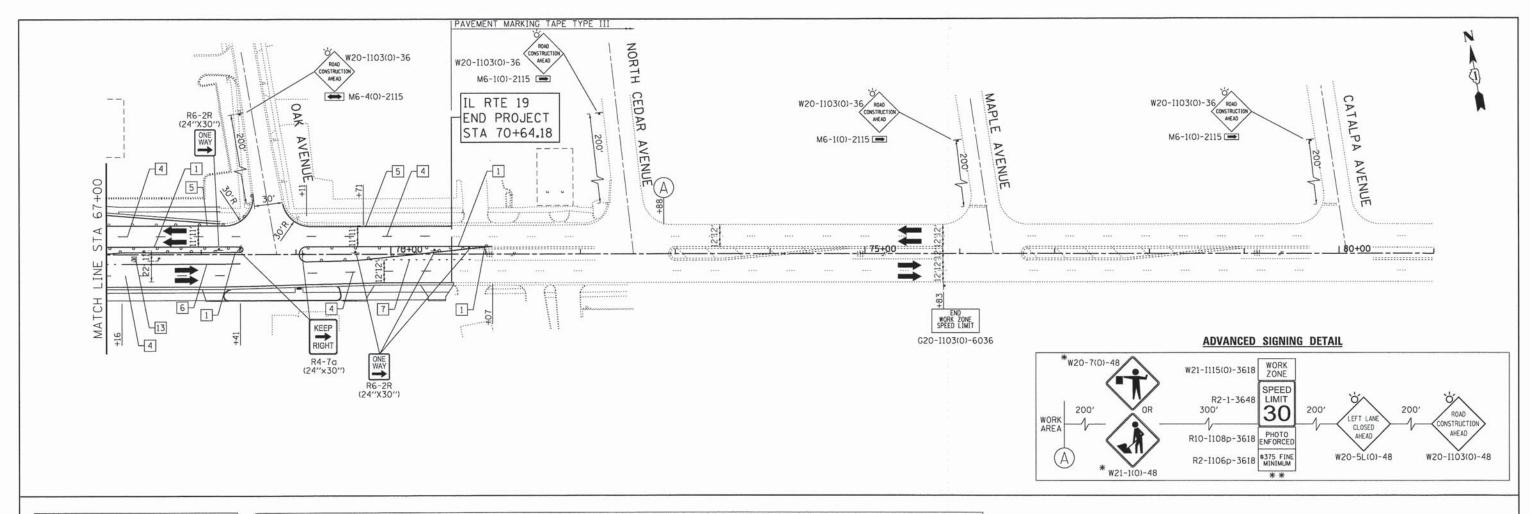
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STATE OF ILLINOIS **DEPARTMENT OF TRANSPORTATION**

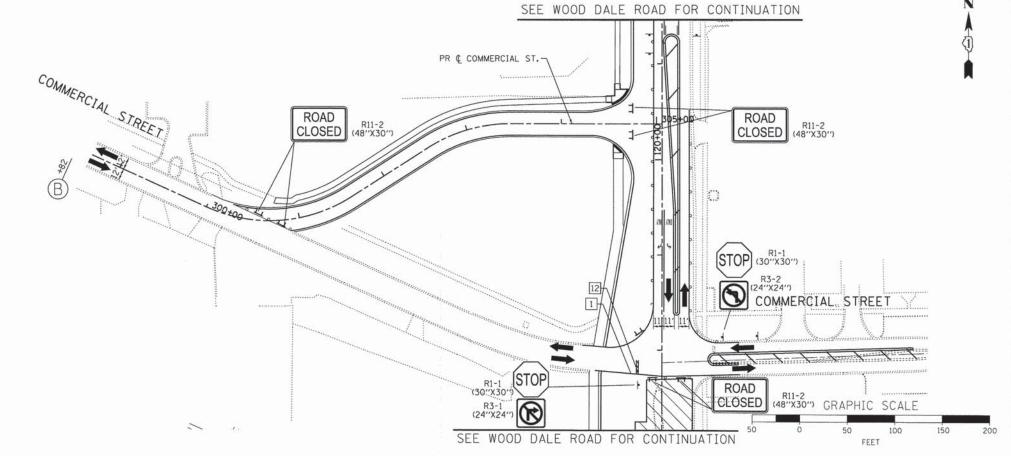SUGGESTED MAINTENANCE OF TRAFFIC - STAGE 1C DIVISION STREET / COMMERCIAL STREET SCALE: 1"=50" SHEET NO. 5 OF 5 SHEETS STA. TO STA.

SECTION NO. TOTAL SHEET NO. COUNTY DUPAGE 277 58 1321 11-00048-00-SP CONTRACT NO. 63872 FED. ROAD DIST. NO. | ILLINOIS FED. AID PROJECT



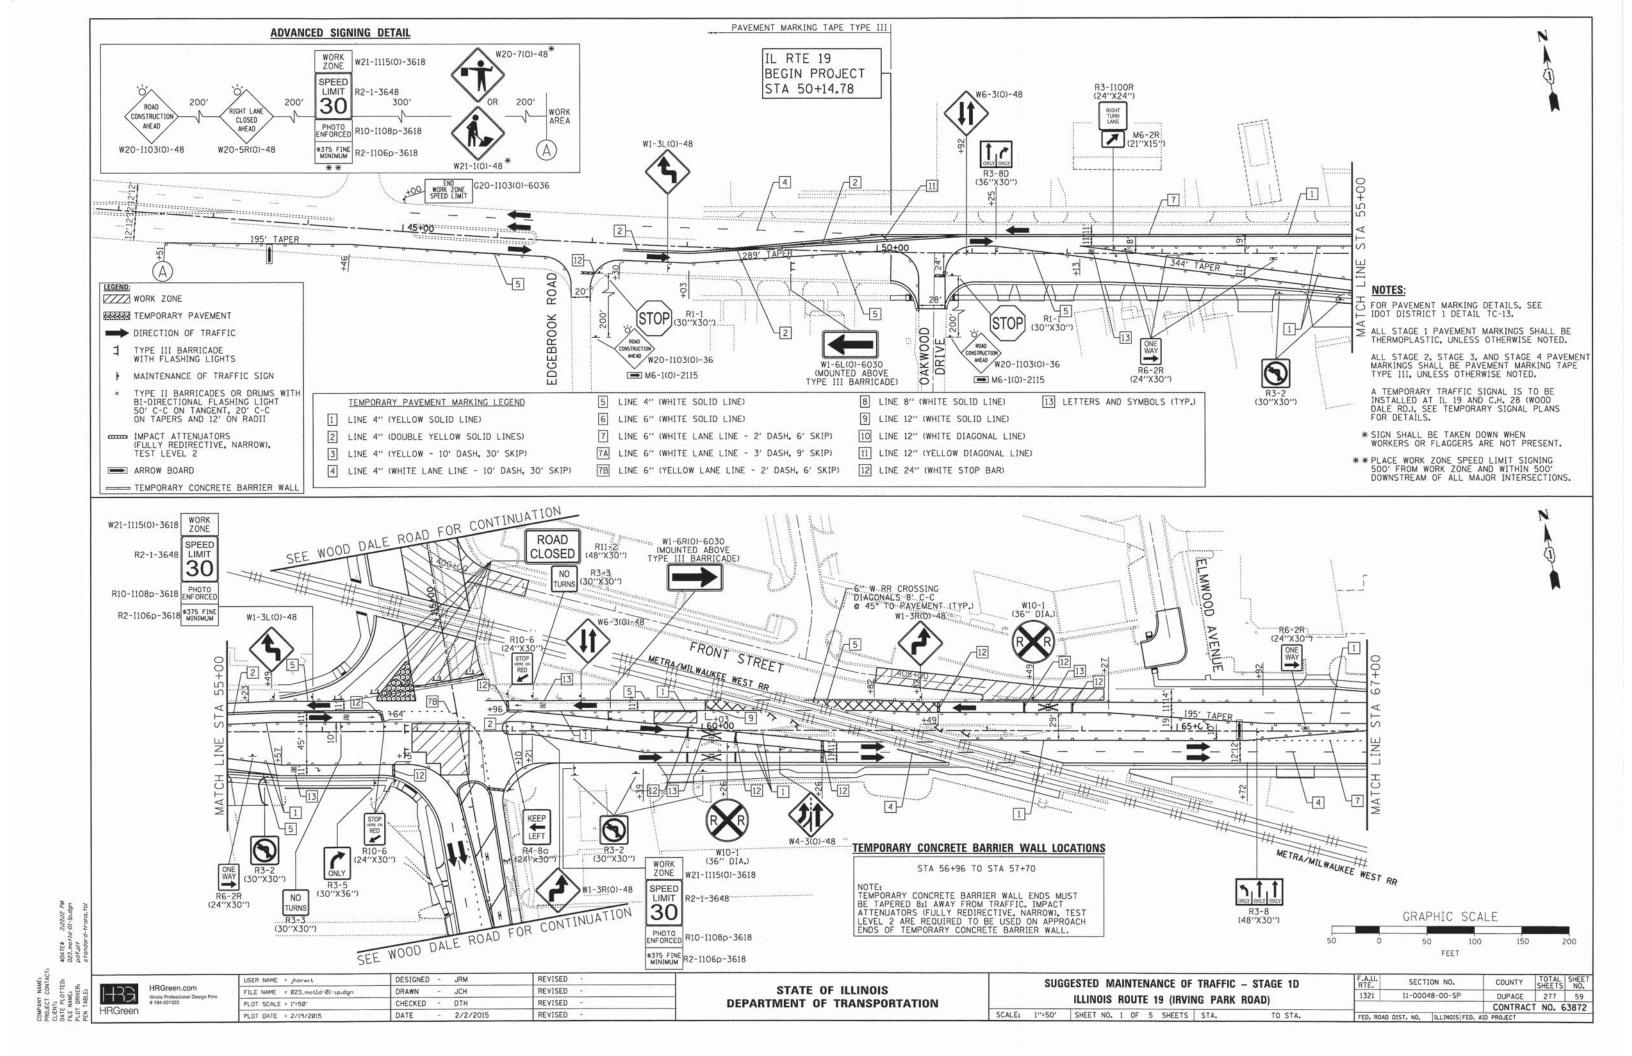

WORK ZONE

TEMPORARY PAVEMENT DIRECTION OF TRAFFIC

TYPE III BARRICADE WITH FLASHING LIGHTS

MAINTENANCE OF TRAFFIC SIGN

TYPE II BARRICADES OR DRUMS WITH BI-DIRECTIONAL FLASHING LIGHT 50' C-C ON TANGENT, 20' C-C ON TAPERS AND 12' ON RADII

IMPACT ATTENUATORS (FULLY REDIRECTIVE, NARROW), TEST LEVEL 2

ARROW BOARD

TEMPORARY CONCRETE BARRIER WALL

FOR PAVEMENT MARKING DETAILS, SEE IDOT DISTRICT 1 DETAIL TC-13.

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A TEMPORARY TRAFFIC SIGNAL IS TO BE INSTALLED AT IL 19 AND C.H. 28 (WOOD DALE RD.), SEE TEMPORARY SIGNAL PLANS

- * SIGN SHALL BE TAKEN DOWN WHEN WORKERS OR FLAGGERS ARE NOT PRESENT.
- ** PLACE WORK ZONE SPEED LIMIT SIGNING 500' FROM WORK ZONE AND WITHIN 500' DOWNSTREAM OF ALL MAJOR INTERSECTIONS.

TEMPORARY	PAVEMENT	MARKING	LEGEND
-----------	----------	---------	--------

LINE 4" (DOUBLE YELLOW SOLID LINES)

4 LINE 4" (WHITE LANE LINE - 10' DASH, 30' SKIP)

3 LINE 4" (YELLOW - 10' DASH, 30' SKIP)

1 LINE 4" (YELLOW SOLID LINE)

- 5 LINE 4" (WHITE SOLID LINE)
- LINE 6" (WHITE SOLID LINE)
- 7 LINE 6" (WHITE LANE LINE 2' DASH, 6' SKIP)
- B LINE 8" (WHITE SOLID LINE)
- 9 LINE 12" (WHITE SOLID LINE)

- 10 LINE 12" (WHITE DIAGONAL LINE)
- 11 LINE 12" (YELLOW DIAGONAL LINE)

SCALE:

- 12 LINE 24" (WHITE STOP BAR)
- 13 LETTERS AND SYMBOLS (TYP.)

GRAPHIC SCALE 100


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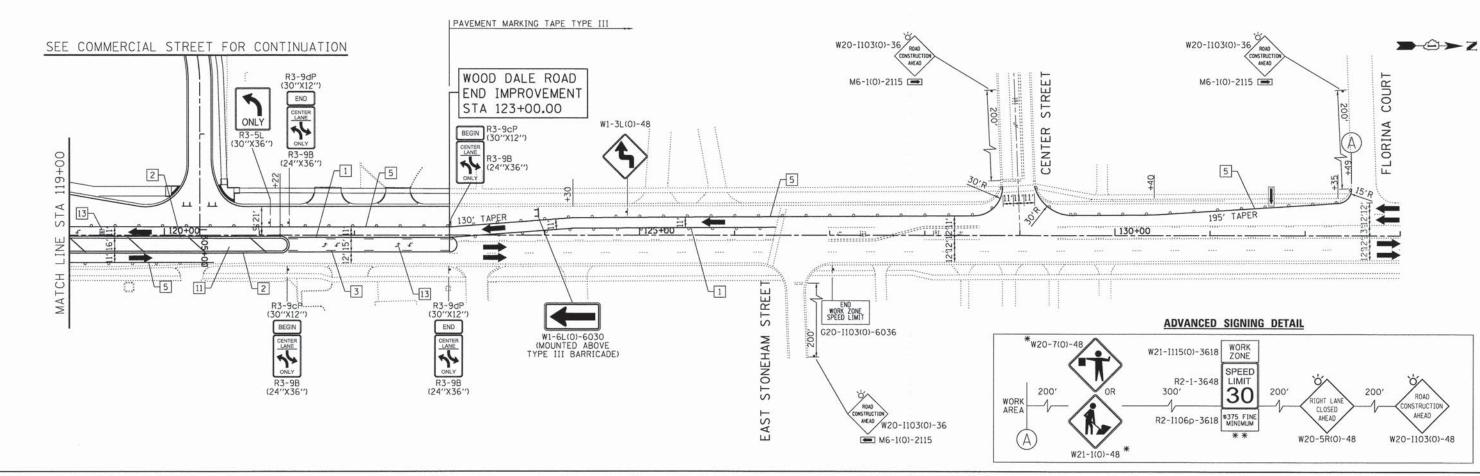
SUG	GESTED M	AINTENA	NCE OF	TRAFFIC	- STAGE	1D
	ILLINOIS	ROUTE 1	9 (IRVIN	IG PARK	ROAD)	
1"=50"	SHEET NO	2 OF 5	SHEETS	STA	TO	STA

ED. ROA	D DIST. NO.	ILLINOIS FED.	AID PROJECT		-
			CONTRAC	T NO. 6	3872
1321 11-00048-00-SP			DUPAGE	277	60
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PROJECT CONTACT:
CLIENT:
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PLOT DRIVER:
PEN TABLE:



WORK ZONE

TEMPORARY PAVEMENT

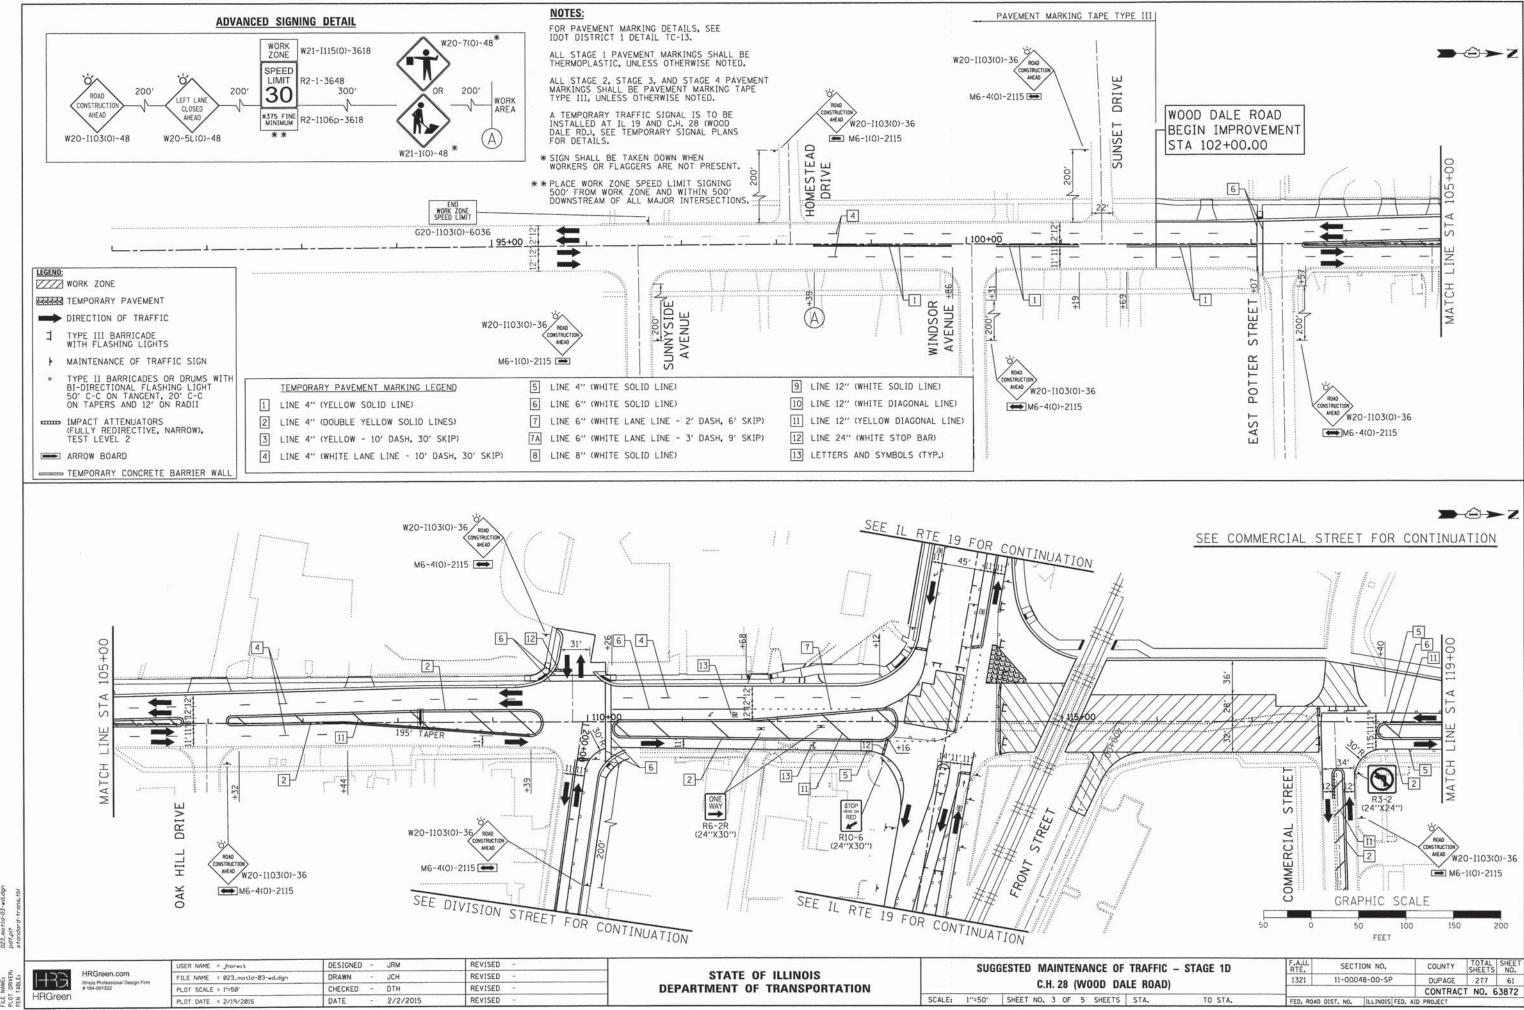DIRECTION OF TRAFFIC

- TYPE III BARRICADE WITH FLASHING LIGHTS
- MAINTENANCE OF TRAFFIC SIGN
- TYPE II BARRICADES OR DRUMS WITH BI-DIRECTIONAL FLASHING LIGHT 50' C-C ON TANGENT, 20' C-C ON TAPERS AND 12' ON RADII
- IMPACT ATTENUATORS
 (FULLY REDIRECTIVE, NARROW),
 TEST LEVEL 2
- ARROW BOARD
- TEMPORARY CONCRETE BARRIER WALL

TEMPORARY PAVEMENT MARKING LEGEND

4 LINE 4" (WHITE LANE LINE - 10' DASH, 30' SKIP)

2 LINE 4" (DOUBLE YELLOW SOLID LINES)

3 LINE 4" (YELLOW - 10' DASH, 30' SKIP)

1 LINE 4" (YELLOW SOLID LINE)

- EGEND 5 LINE 4" (WHITE SOLID LINE)
 - 6 LINE 6" (WHITE SOLID LINE)
 - LINE 6" (WHITE LANE LINE 2' DASH, 6' SKIP)
 - 8 LINE 8" (WHITE SOLID LINE)
 - 9 LINE 12" (WHITE SOLID LINE)

10 LINE 12" (WHITE DIAGONAL LINE)

- 11 LINE 12" (YELLOW DIAGONAL LINE)
- 12 LINE 24" (WHITE STOP BAR)
- 13 LETTERS AND SYMBOLS (TYP.)

NOTES:

FOR PAVEMENT MARKING DETAILS, SEE IDOT DISTRICT 1 DETAIL TC-13.

ALL STAGE 1 PAVEMENT MARKINGS SHALL BE THERMOPLASTIC, UNLESS OTHERWISE NOTED.

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- A TEMPORARY TRAFFIC SIGNAL IS TO BE INSTALLED AT IL 19 AND C.H. 28 (WOOD DALE RD.), SEE TEMPORARY SIGNAL PLANS FOR DETAILS.
- * SIGN SHALL BE TAKEN DOWN WHEN WORKERS OR FLAGGERS ARE NOT PRESENT.
- **PLACE WORK ZONE SPEED LIMIT SIGNING 500' FROM WORK ZONE AND WITHIN 500' DOWNSTREAM OF ALL MAJOR INTERSECTIONS.

GRAPHIC SCALE
50 0 50 100 150 200
FEET

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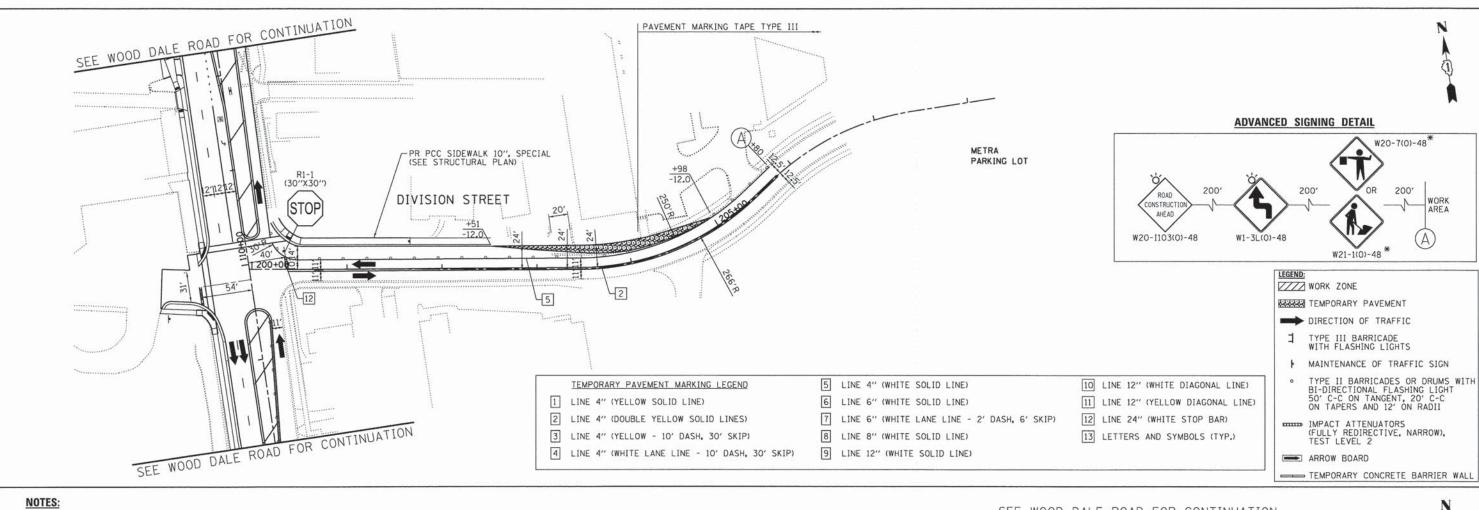
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HRGreen.com Illinois Professional Design Firm # 184-001322

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PLOT SCALE = 1*=50°	CHECKED	-	DTH	REVISED		
PLOT DATE = 2/19/2015	DATE	-	2/2/2015	REVISED	-	

	SUG	GESTED	M	All	NTE	NA	NCE OF	TRAFFIC	- STAGE 1D
			C.I	H. :	28	(W	DOD DA	LE ROAD)	
SCALE:	1"=50"	SHEET	NO.	4	OF	5	SHEETS	STA.	TO STA.

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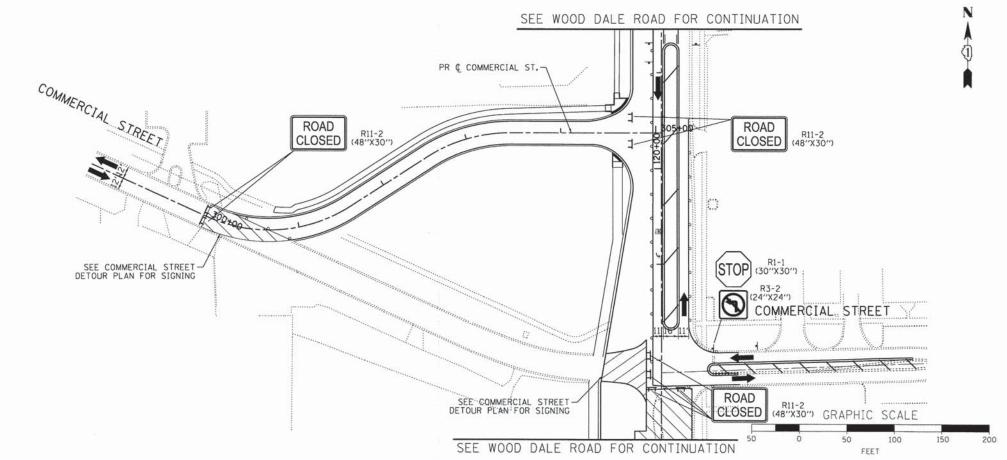
FOR PAVEMENT MARKING DETAILS, SEE IDOT DISTRICT 1 DETAIL TC-13.

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- ** PLACE WORK ZONE SPEED LIMIT SIGNING 500' FROM WORK ZONE AND WITHIN 500' DOWNSTREAM OF ALL MAJOR INTERSECTIONS.



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USER NAME = Jhorwit	DESIGNED	-	JRM	REVISED		
FILE NAME = 023_motld-05-div+com.dgn	DRAWN	-	JCH	REVISED	121	
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PLOT DATE = 2/19/2015	DATE	2	2/2/2015	REVISED		


STATE OF ILLINOIS
DEPARTMENT OF TRANSPORTATION

SUGGESTED MAINTENANCE OF TRAFFIC - STAGE 1D

DIVISION STREET / COMMERCIAL STREET


SCALE: 1"=50" SHEET NO. 5 OF 5 SHEETS STA. TO STA.

F.A.U. RTE. 1321					TOTAL SHEETS 277	NO.
				CONTRAC	T NO. E	3872
FED. ROAD	DIST. NO.	ILLINOIS	FED. AID	PROJECT		

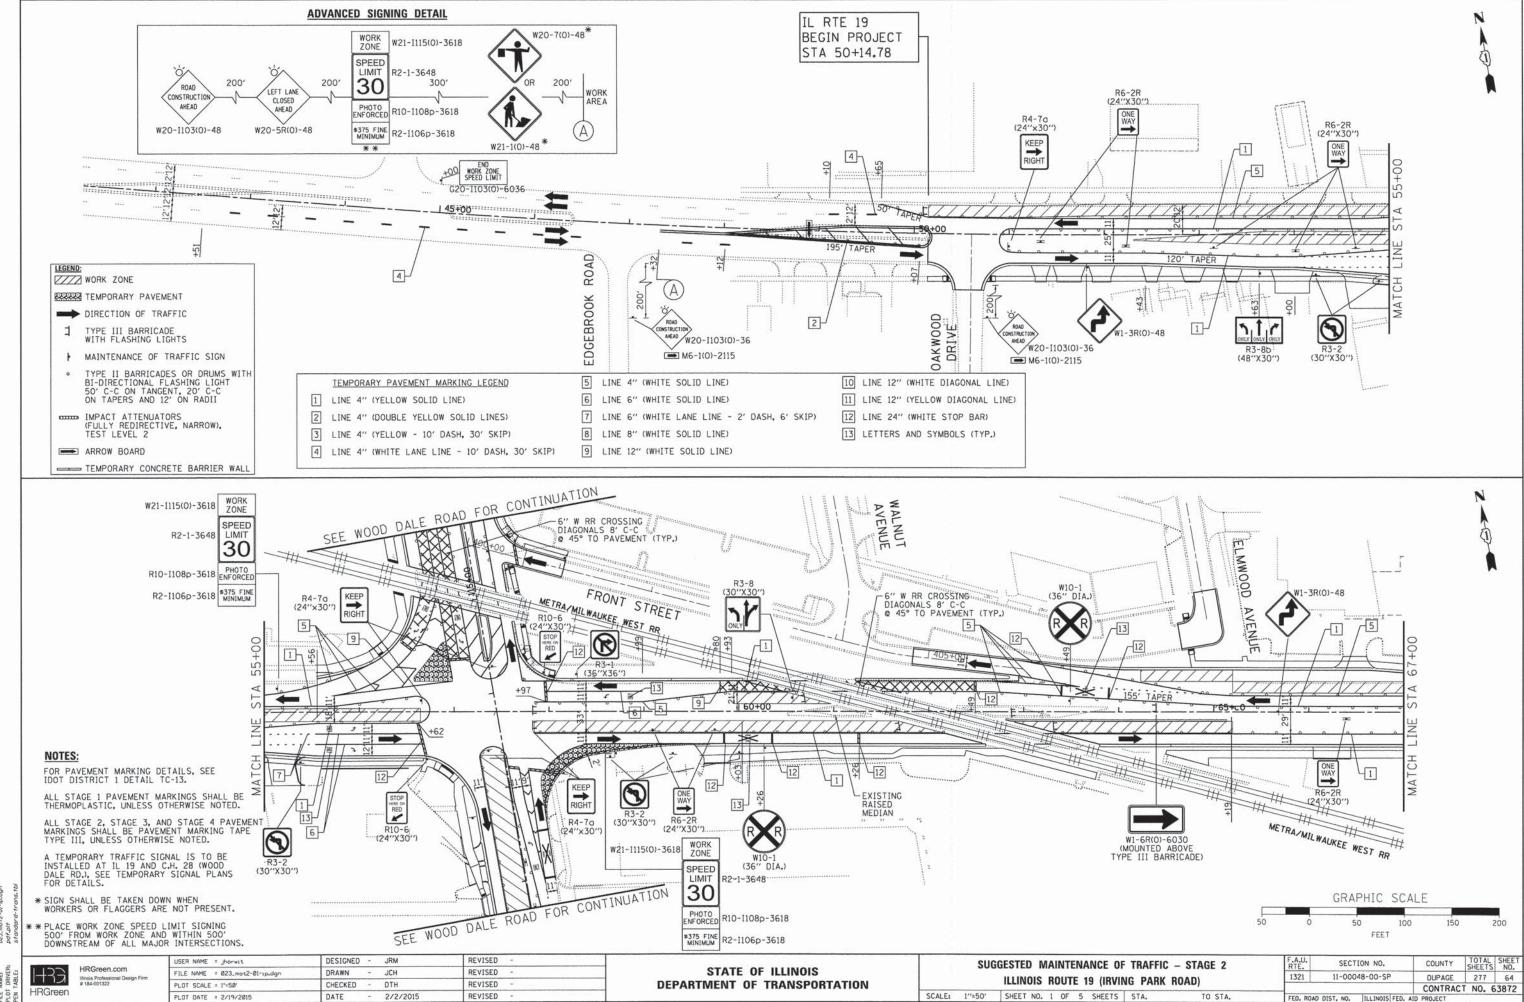

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PROJECT CONTACT:
CLIENT;
CLIENT;
DATE PLOTTED;
FILE NAME;
PLOT DRIVER;
PEN TARI F.

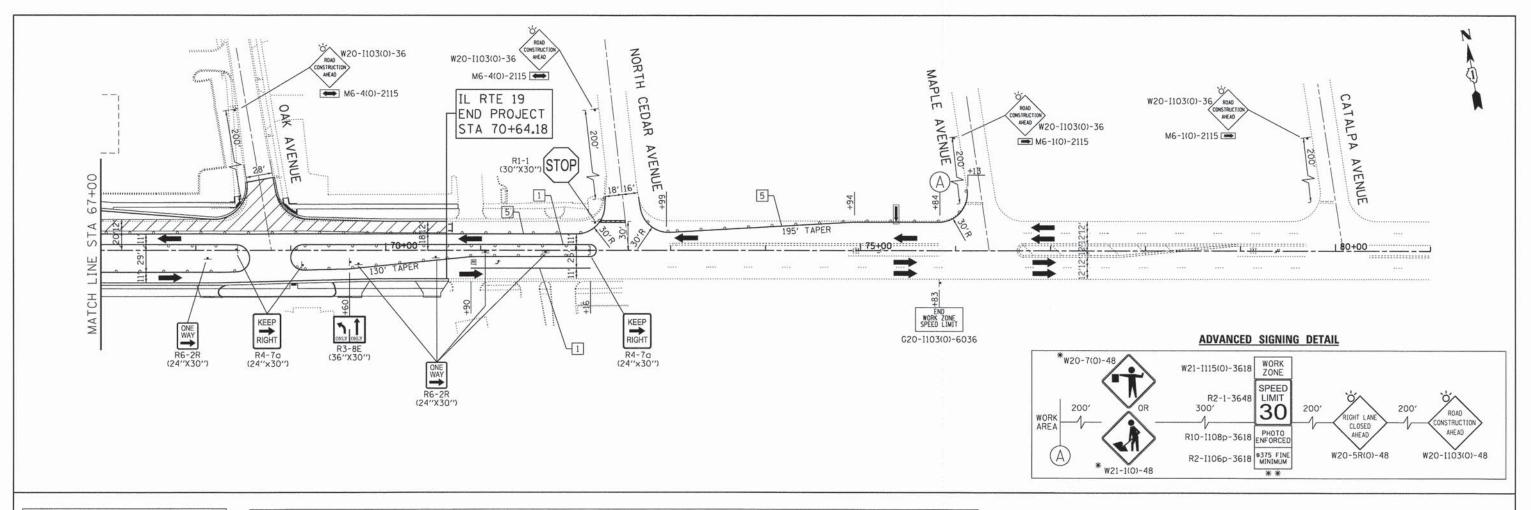

LEGEND: WORK ZONE

TEMPORARY PAVEMENT

DIRECTION OF TRAFFIC

TYPE III BARRICADE WITH FLASHING LIGHTS

MAINTENANCE OF TRAFFIC SIGN

TYPE II BARRICADES OR DRUMS WITH BI-DIRECTIONAL FLASHING LIGHT 50' C-C ON TANGENT, 20' C-C ON TAPERS AND 12' ON RADII

IMPACT ATTENUATORS
(FULLY REDIRECTIVE, NARROW), (FULLY REDIRECTEST LEVEL 2

ARROW BOARD

TEMPORARY CONCRETE BARRIER WALL

FOR PAVEMENT MARKING DETAILS, SEE IDOT DISTRICT 1 DETAIL TC-13.

ALL STAGE 1 PAVEMENT MARKINGS SHALL BE THERMOPLASTIC, UNLESS OTHERWISE NOTED.

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A TEMPORARY TRAFFIC SIGNAL IS TO BE INSTALLED AT IL 19 AND C.H. 28 (WOOD DALE RD.), SEE TEMPORARY SIGNAL PLANS FOR DETAILS.

- * SIGN SHALL BE TAKEN DOWN WHEN WORKERS OR FLAGGERS ARE NOT PRESENT.
- * PLACE WORK ZONE SPEED LIMIT SIGNING 500' FROM WORK ZONE AND WITHIN 500' DOWNSTREAM OF ALL MAJOR INTERSECTIONS.

TEMPORARY PAVEMENT MARKING LEGEND

LINE 4" (DOUBLE YELLOW SOLID LINES)

LINE 4" (YELLOW SOLID LINE)

- 5 LINE 4" (WHITE SOLID LINE)
- 6 LINE 6" (WHITE SOLID LINE)
- 7 LINE 6" (WHITE LANE LINE 2' DASH, 6' SKIP)
- 8 LINE 8" (WHITE SOLID LINE)
- LINE 4" (YELLOW 10' DASH, 30' SKIP) 9 LINE 12" (WHITE SOLID LINE) 4 LINE 4" (WHITE LANE LINE - 10' DASH, 30' SKIP)

- 10 LINE 12" (WHITE DIAGONAL LINE)
- 11 LINE 12" (YELLOW DIAGONAL LINE)
- 12 LINE 24" (WHITE STOP BAR)
- 13 LETTERS AND SYMBOLS (TYP.)

SCALE:


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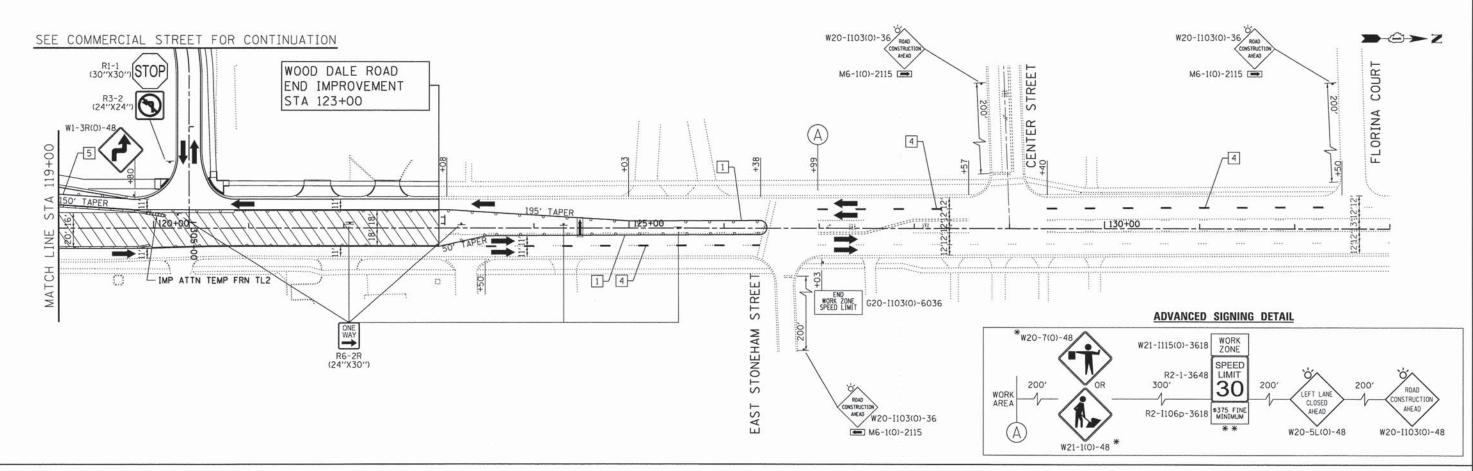
SUG	GESTED N	AINTENAN	CE OF T	RAFFIC -	- STAGE	2
	ILLINOIS	ROUTE 19	(IRVING	PARK R	OAD)	
1"=50"	SHEET NO	2 OF 5 S	игете Се	TA	TO S	. A

F.A.U. RTE.	SECT	ION NO.		COUNTY	TOTAL	SHEE
1321	1321 11-00048-00-SP				277	65
				CONTRAC	T NO. 6	387
FED. ROAD	DIST. NO.	ILLINOIS	FED. AID	PROJECT	-	



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PROJECT CONTACT:
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FILE NAME:
PLOT DRIVER:
POT TABLE:
STORY

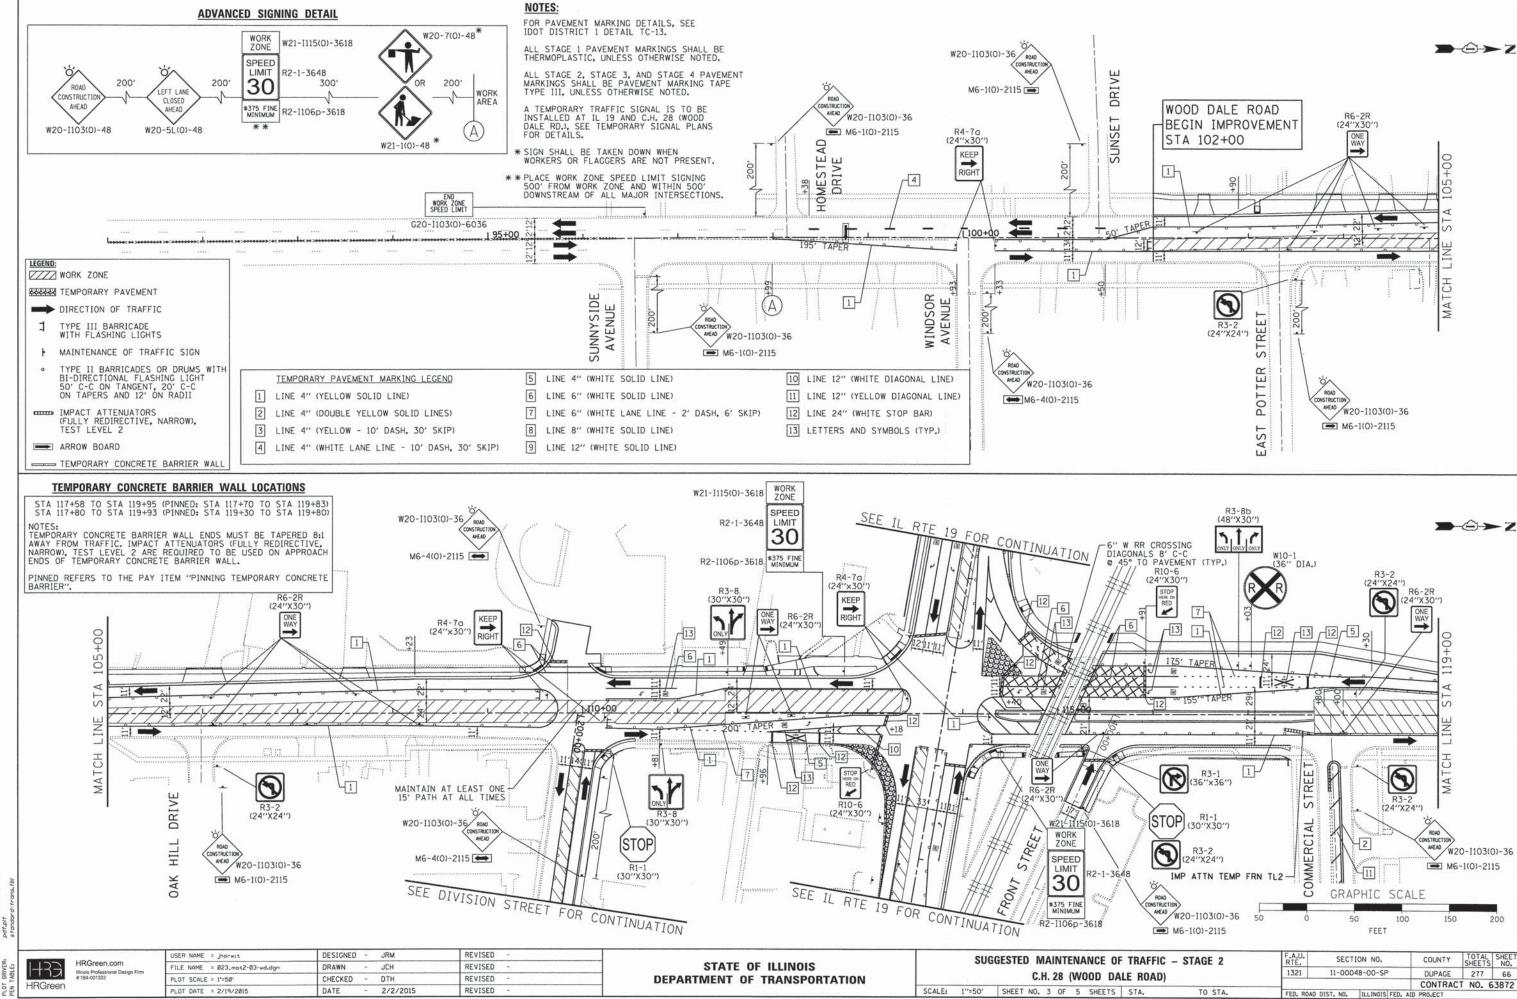

LEGEND: WORK ZONE

TEMPORARY PAVEMENT

DIRECTION OF TRAFFIC

- TYPE III BARRICADE WITH FLASHING LIGHTS
- MAINTENANCE OF TRAFFIC SIGN
- TYPE II BARRICADES OR DRUMS WITH BI-DIRECTIONAL FLASHING LIGHT 50' C-C ON TANGENT, 20' C-C ON TAPERS AND 12' ON RADII
- IMPACT ATTENUATORS (FULLY REDIRECTIVE, NARROW), TEST LEVEL 2
- ARROW BOARD
- TEMPORARY CONCRETE BARRIER WALL

TEMPORARY PAVEMENT MARKING LEGEND

2 LINE 4" (DOUBLE YELLOW SOLID LINES)

3 LINE 4" (YELLOW - 10' DASH, 30' SKIP)

4 LINE 4" (WHITE LANE LINE - 10' DASH, 30' SKIP)

1 LINE 4" (YELLOW SOLID LINE)

5 LINE 4" (WHITE SOLID LINE)

6 LINE 6" (WHITE SOLID LINE)

7 LINE 6" (WHITE LANE LINE - 2' DASH, 6' SKIP)

8 LINE 8" (WHITE SOLID LINE)

9 LINE 12" (WHITE SOLID LINE)

10 LINE 12" (WHITE DIAGONAL LINE)

11 LINE 12" (YELLOW DIAGONAL LINE)

12 LINE 24" (WHITE STOP BAR)

13 LETTERS AND SYMBOLS (TYP.)

NOTES:

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- ** PLACE WORK ZONE SPEED LIMIT SIGNING 500' FROM WORK ZONE AND WITHIN 500' DOWNSTREAM OF ALL MAJOR INTERSECTIONS.

TEMPORARY CONCRETE BARRIER WALL LOCATIONS

STA 117+58 TO STA 119+95 (PINNED: STA 117+70 TO STA 119+83) STA 117+80 TO STA 119+93 (PINNED: STA 119+30 TO STA 119+80)

NOTES: TEMPORARY CONCRETE BARRIER WALL ENDS MUST BE TAPERED 8:1 AWAY FROM TRAFFIC. IMPACT ATTENUATORS (FULLY REDIRECTIVE, NARROW), TEST LEVEL 2 ARE REQUIRED TO BE USED ON APPROACH ENDS OF TEMPORARY CONCRETE BARRIER WALL.

PINNED REFERS TO THE PAY ITEM "PINNING TEMPORARY CONCRETE

GRAPHIC SCALE 100 FEET


H33 **HRGreen**

HRGreen.com

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PLOT SCALE = 1°=50°	CHECKED - DTH	REVISED -	
PLOT DATE = 2/19/2015	DATE - 2/2/2015	REVISED -	

	SUG	GESTE) N	IAI	NTI	EN/	NCE OF	TRAFFIC	- STAGE 2
			C.	Н. 2	28	(W	OOD DA	LE ROAD)
SCALE:	1"=50"	SHEET	NO.	4	OF	5	SHEETS	STA.	TO STA.

F.A.U. RTE.	SECT	ION NO.		COUNTY	TOTAL	SHEE NO.
1321	11-000		DUPAGE	277	67	
				CONTRAC	T NO. 6	387
FED. ROAD	DIST. NO.	ILL INDIS F	FD. AID	PROJECT		

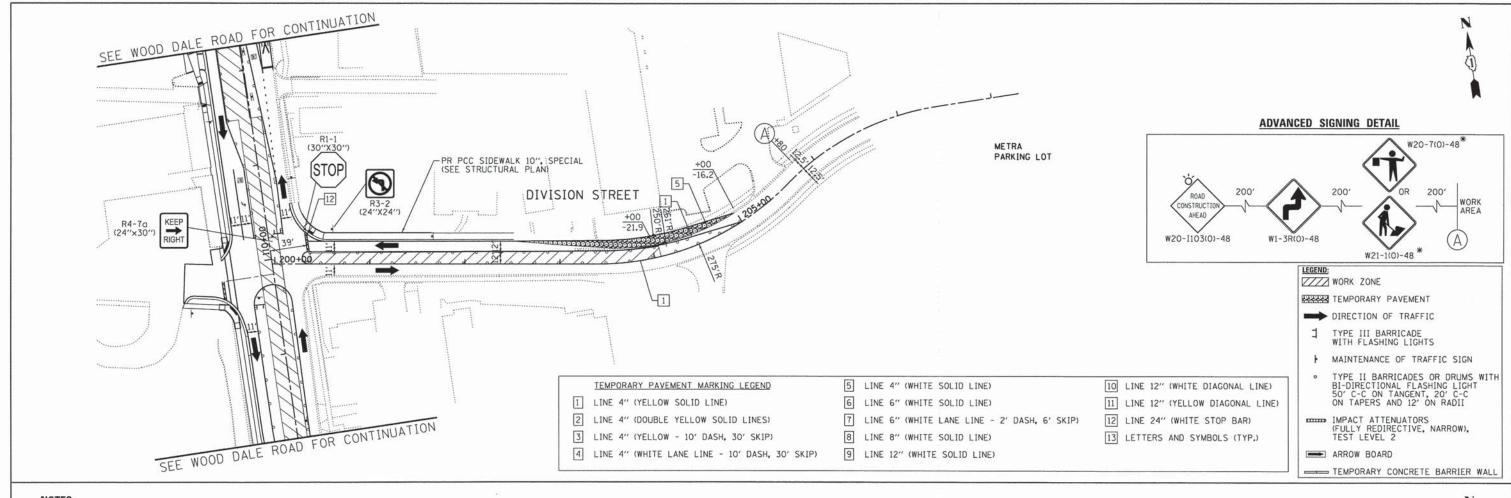

NOTES:


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ALL STAGE 2, STAGE 3, AND STAGE 4 PAVEMENT MARKINGS SHALL BE PAVEMENT MARKING TAPE TYPE III, UNLESS OTHERWISE NOTED.

A TEMPORARY TRAFFIC SIGNAL IS TO BE INSTALLED AT IL 19 AND C.H. 28 (WOOD DALE RD.), SEE TEMPORARY SIGNAL PLANS FOR DETAILS.

- * SIGN SHALL BE TAKEN DOWN WHEN WORKERS OR FLAGGERS ARE NOT PRESENT.
- ** PLACE WORK ZONE SPEED LIMIT SIGNING 500' FROM WORK ZONE AND WITHIN 500' DOWNSTREAM OF ALL MAJOR INTERSECTIONS.



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STATE OF ILLINOIS
DEPARTMENT OF TRANSPORTATION

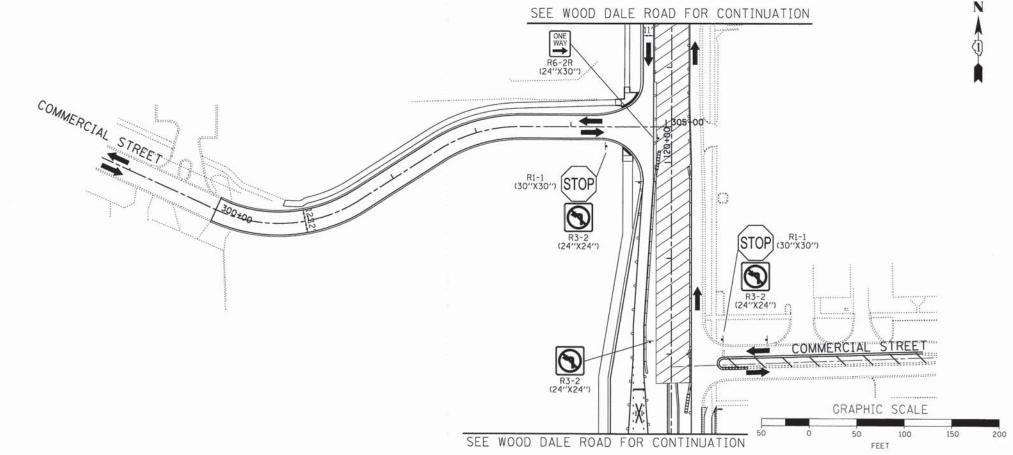
SUGGESTED MAINTENANCE OF TRAFFIC - STAGE 2

DIVISION STREET /COMMERCIAL STREET


SCALE: 1"=50" SHEET NO. 5 OF 5 SHEETS STA. TO STA.

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WORK ZONE

TEMPORARY PAVEMENT

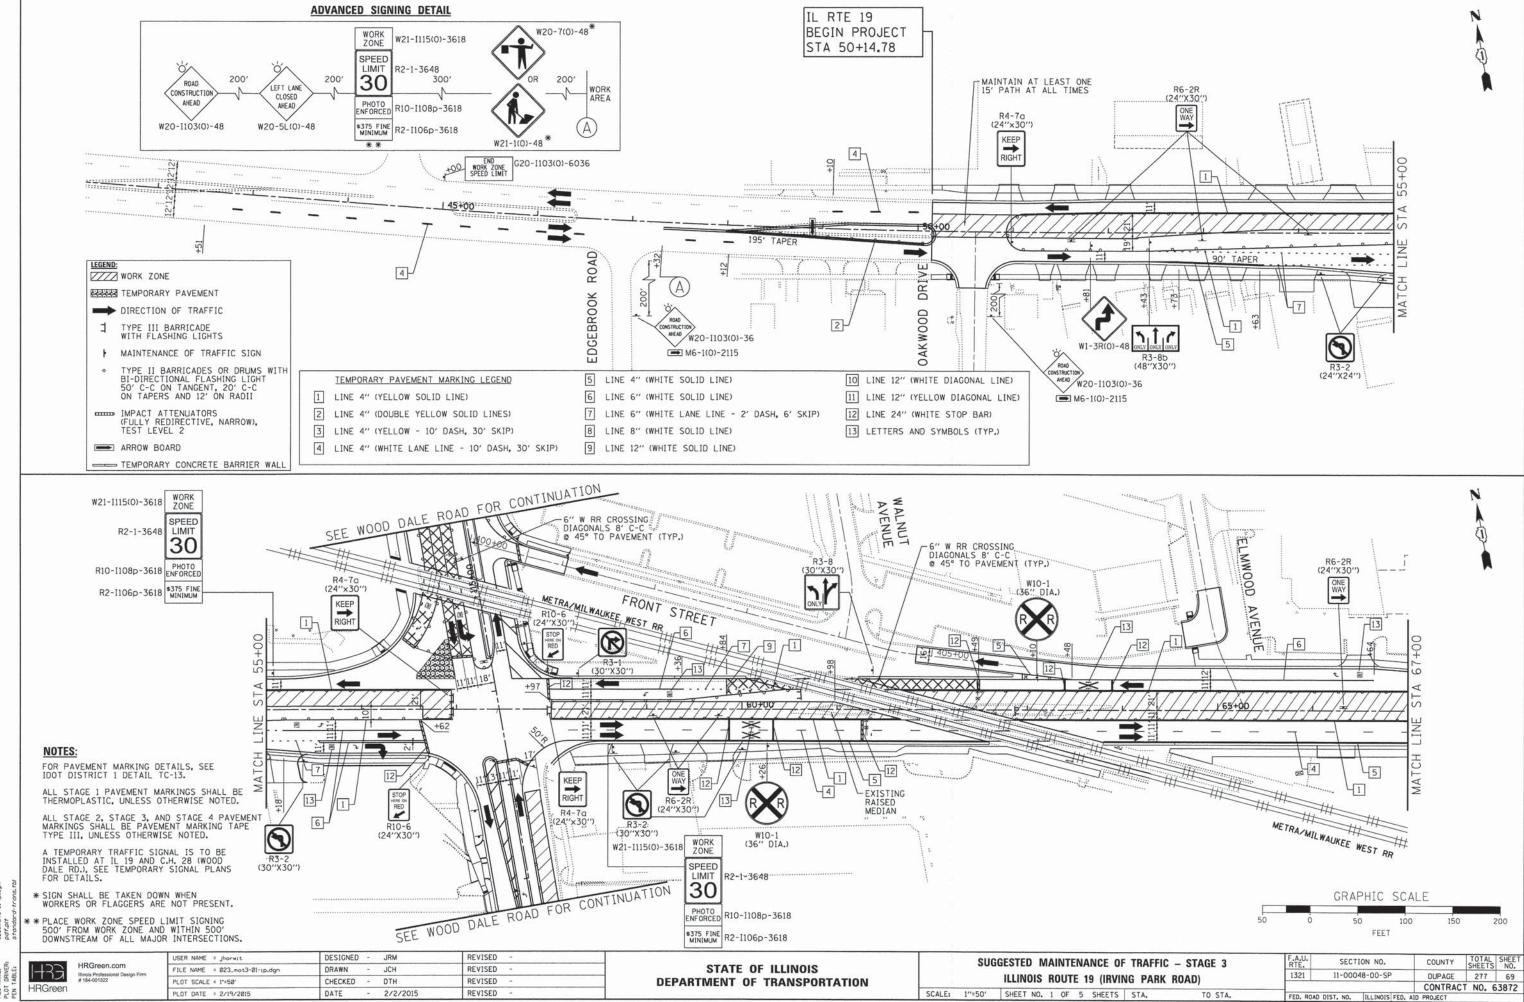DIRECTION OF TRAFFIC

TYPE III BARRICADE WITH FLASHING LIGHTS

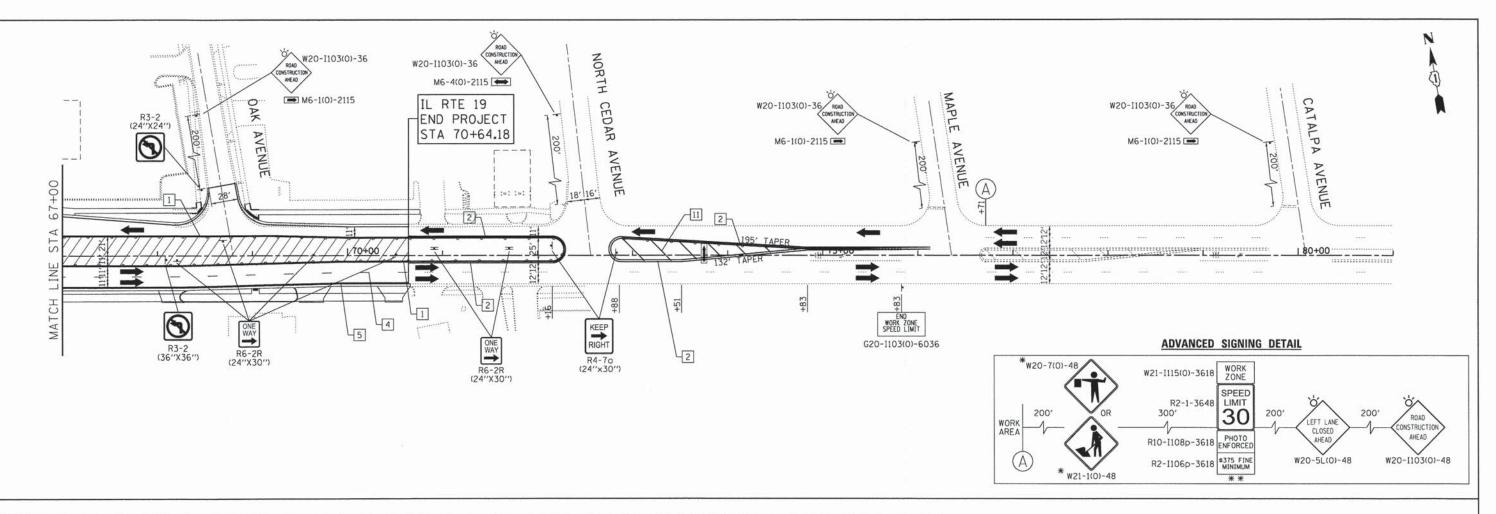MAINTENANCE OF TRAFFIC SIGN

TYPE II BARRICADES OR DRUMS WITH BI-DIRECTIONAL FLASHING LIGHT 50' C-C ON TANGENT, 20' C-C ON TAPERS AND 12' ON RADII

IMPACT ATTENUATORS (FULLY REDIRECTIVE, NARROW), TEST LEVEL 2

ARROW BOARD

TEMPORARY CONCRETE BARRIER WALL

NOTES:

FOR PAVEMENT MARKING DETAILS, SEE IDOT DISTRICT 1 DETAIL TC-13.

ALL STAGE 1 PAVEMENT MARKINGS SHALL BE THERMOPLASTIC, UNLESS OTHERWISE NOTED.

DALE RD.), SEE TEMPORARY SIGNAL PLANS FOR DETAILS.

- **PLACE WORK ZONE SPEED LIMIT SIGNING 500' FROM WORK ZONE AND WITHIN 500' DOWNSTREAM OF ALL MAJOR INTERSECTIONS.

TEMPORARY PAVEMENT MARKING LEGEND

LINE 4" (DOUBLE YELLOW SOLID LINES)

LINE 4" (YELLOW - 10' DASH, 30' SKIP)

4 LINE 4" (WHITE LANE LINE - 10' DASH, 30' SKIP)

LINE 4" (YELLOW SOLID LINE)

- 5 LINE 4" (WHITE SOLID LINE)
- 6 LINE 6" (WHITE SOLID LINE)
- 7 LINE 6" (WHITE LANE LINE 2' DASH, 6' SKIP)
- 8 LINE 8" (WHITE SOLID LINE)
- 9 LINE 12" (WHITE SOLID LINE)

- 10 LINE 12" (WHITE DIAGONAL LINE)
- 11 LINE 12" (YELLOW DIAGONAL LINE)
- 12 LINE 24" (WHITE STOP BAR)
- 13 LETTERS AND SYMBOLS (TYP.)

	L BE PAVEME	STAGE 4 PAVE NT MARKING TA E NOTED.
A TEMPORARY INSTALLED AT		

* SIGN SHALL BE TAKEN DOWN WHEN WORKERS OR FLAGGERS ARE NOT PRESENT.

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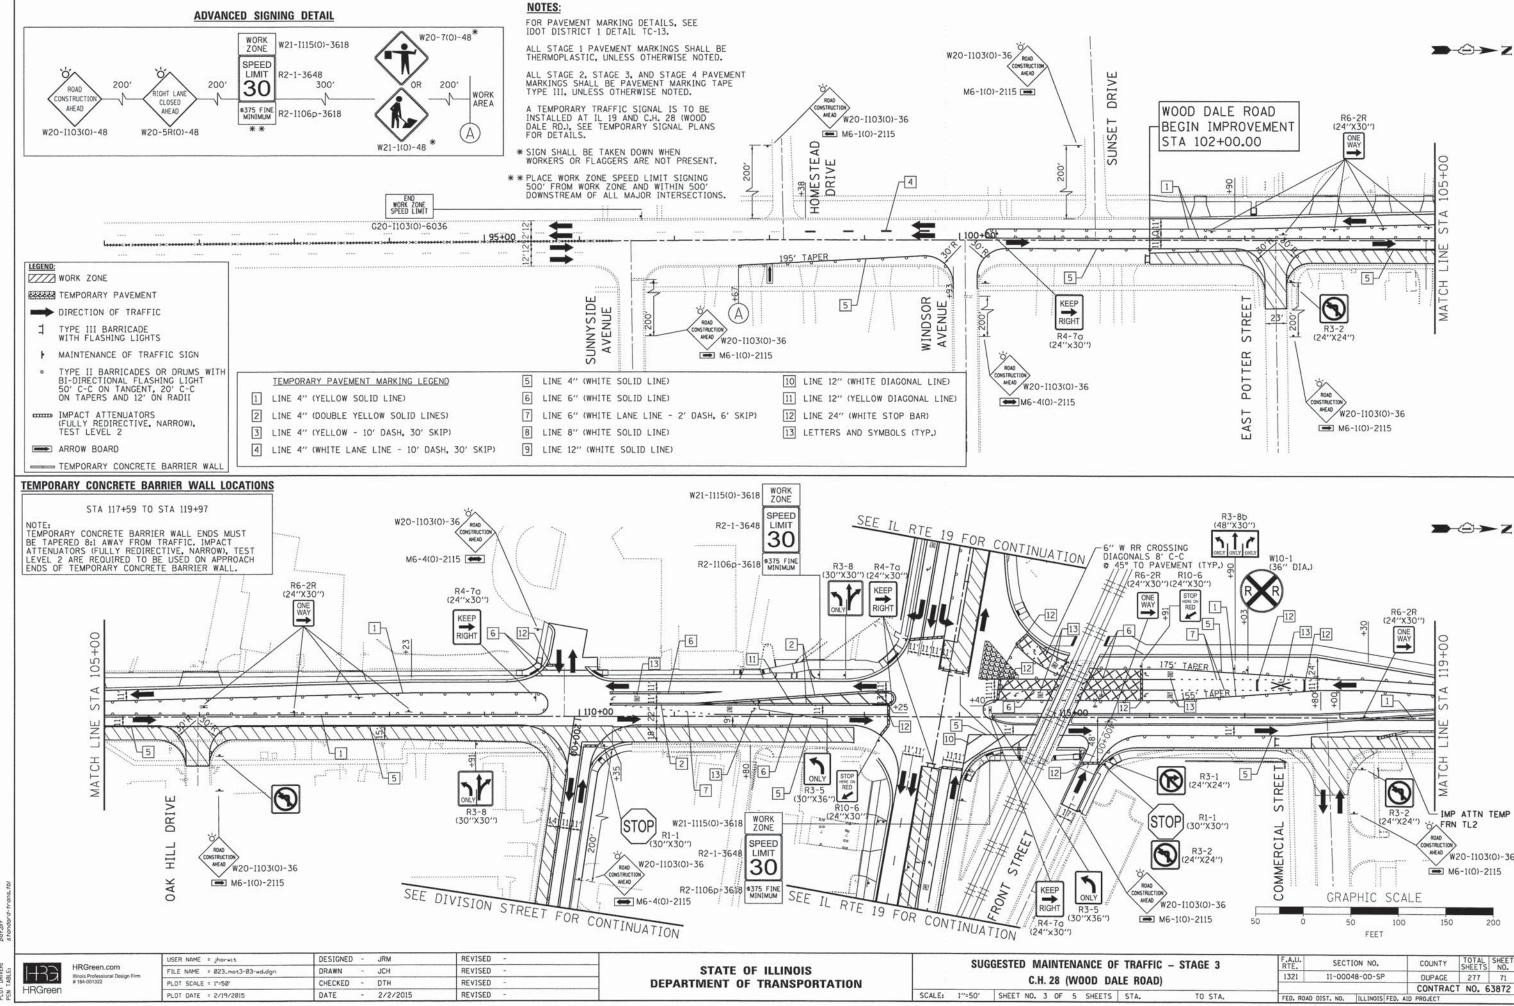
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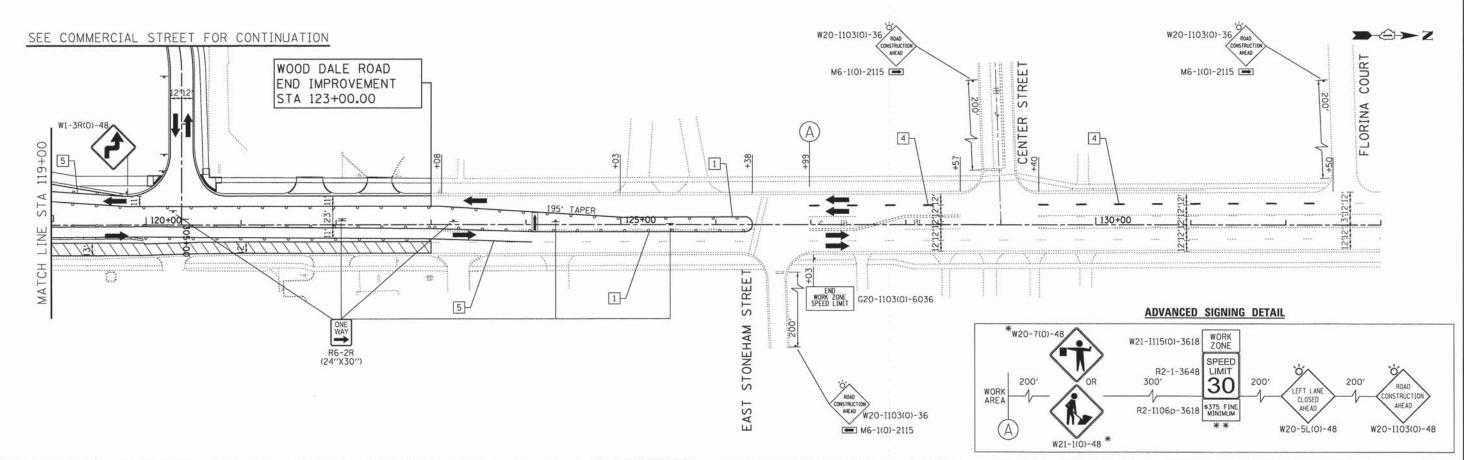
STATE OF ILLINOIS **DEPARTMENT OF TRANSPORTATION**

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SECTION NO. COUNTY DUPAGE 277 70 1321 11-00048-00-SP CONTRACT NO. 63872 FED. ROAD DIST. NO. | ILLINOIS FED. AID PROJECT



CONTRACT NO. 63872



WORK ZONE TEMPORARY PAVEMENT DIRECTION OF TRAFFIC TYPE III BARRICADE WITH FLASHING LIGHTS MAINTENANCE OF TRAFFIC SIGN TYPE II BARRICADES OR DRUMS WITH BI-DIRECTIONAL FLASHING LIGHT 50' C-C ON TANGENT, 20' C-C ON TAPERS AND 12' ON RADII IMPACT ATTENUATORS (FULLY REDIRECTIVE, NARROW), TEST LEVEL 2 ARROW BOARD TEMPORARY CONCRETE BARRIER WALL

TEMPORARY PAVEMENT MARKING LEGEND

2 LINE 4" (DOUBLE YELLOW SOLID LINES)

3 LINE 4" (YELLOW - 10' DASH, 30' SKIP)

4 LINE 4" (WHITE LANE LINE - 10' DASH, 30' SKIP)

1 LINE 4" (YELLOW SOLID LINE)

5 LINE 4" (WHITE SOLID LINE) LINE 6" (WHITE SOLID LINE)

LINE 8" (WHITE SOLID LINE)

9 LINE 12" (WHITE SOLID LINE)

10 LINE 12" (WHITE DIAGONAL LINE) 11 LINE 12" (YELLOW DIAGONAL LINE)

LINE 6" (WHITE LANE LINE - 2' DASH, 6' SKIP)

12 LINE 24" (WHITE STOP BAR)

13 LETTERS AND SYMBOLS (TYP.)

NOTES:

FOR PAVEMENT MARKING DETAILS, SEE IDOT DISTRICT 1 DETAIL TC-13.

ALL STAGE 1 PAVEMENT MARKINGS SHALL BE THERMOPLASTIC, UNLESS OTHERWISE NOTED.

ALL STAGE 2, STAGE 3, AND STAGE 4 PAVEMENT MARKINGS SHALL BE PAVEMENT MARKING TAPE TYPE III, UNLESS OTHERWISE NOTED.

A TEMPORARY TRAFFIC SIGNAL IS TO BE INSTALLED AT IL 19 AND C.H. 28 (WOOD DALE RD.), SEE TEMPORARY SIGNAL PLANS FOR DETAILS.

* SIGN SHALL BE TAKEN DOWN WHEN WORKERS OR FLAGGERS ARE NOT PRESENT.

** PLACE WORK ZONE SPEED LIMIT SIGNING 500' FROM WORK ZONE AND WITHIN 500' DOWNSTREAM OF ALL MAJOR INTERSECTIONS.

TEMPORARY CONCRETE BARRIER WALL LOCATIONS

STA 117+59 TO STA 119+97

NUIL: TEMPORARY CONCRETE BARRIER WALL ENDS MUST BE TAPERED 8:1 AWAY FROM TRAFFIC. IMPACT ATTENUATORS (FULLY REDIRECTIVE, NARROW), TEST LEVEL 2 ARE REQUIRED TO BE USED ON APPROACH ENDS OF TEMPORARY CONCRETE BARRIER WALL.

BE USED ON APPROACH BETE BARRIER WALL.		
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STATE OF ILLINOIS DEPARTMENT OF TRANSPORTATION

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COUNTY TOTAL SHEET NO. SECTION NO. 1321 11-00048-00-SP DUPAGE 277 72 CONTRACT NO. 63872 FED. ROAD DIST. NO. | ILLINOIS FED. AID PROJECT


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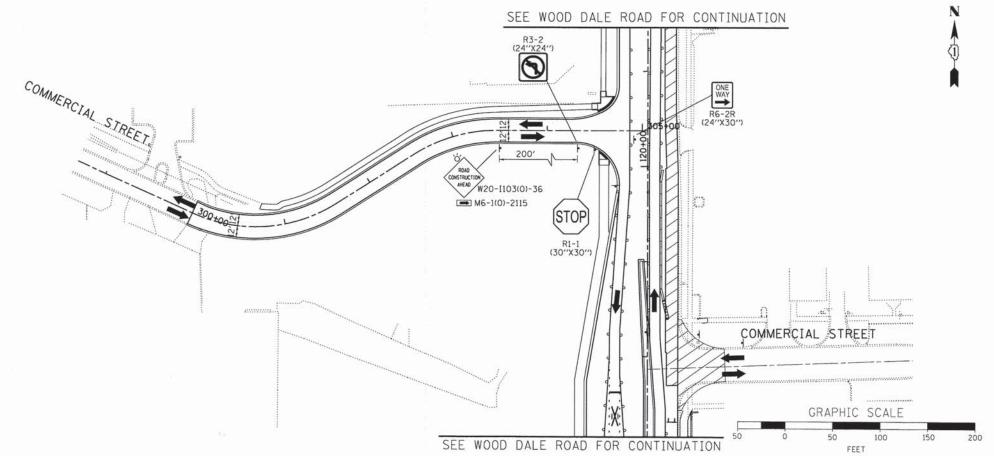
FOR PAVEMENT MARKING DETAILS, SEE IDOT DISTRICT 1 DETAIL TC-13.

ALL STAGE 1 PAVEMENT MARKINGS SHALL BE THERMOPLASTIC, UNLESS OTHERWISE NOTED.

ALL STAGE 2, STAGE 3, AND STAGE 4 PAVEMENT MARKINGS SHALL BE PAVEMENT MARKING TAPE TYPE III, UNLESS OTHERWISE NOTED.

A TEMPORARY TRAFFIC SIGNAL IS TO BE INSTALLED AT IL 19 AND C.H. 28 (WOOD DALE RD.), SEE TEMPORARY SIGNAL PLANS FOR DETAILS.

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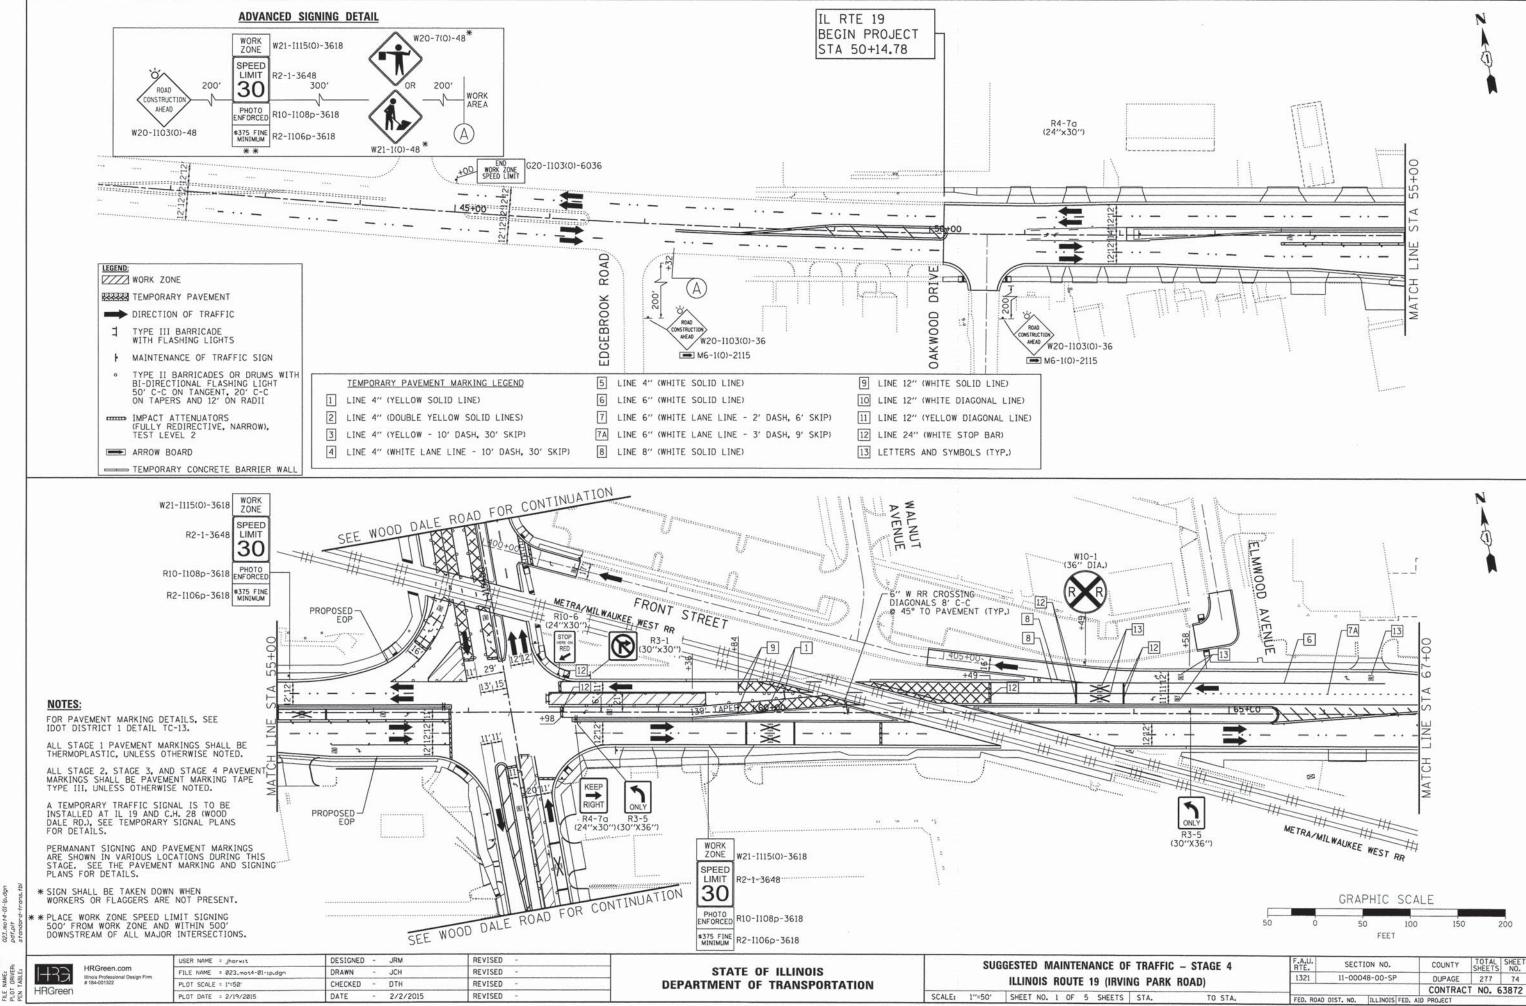
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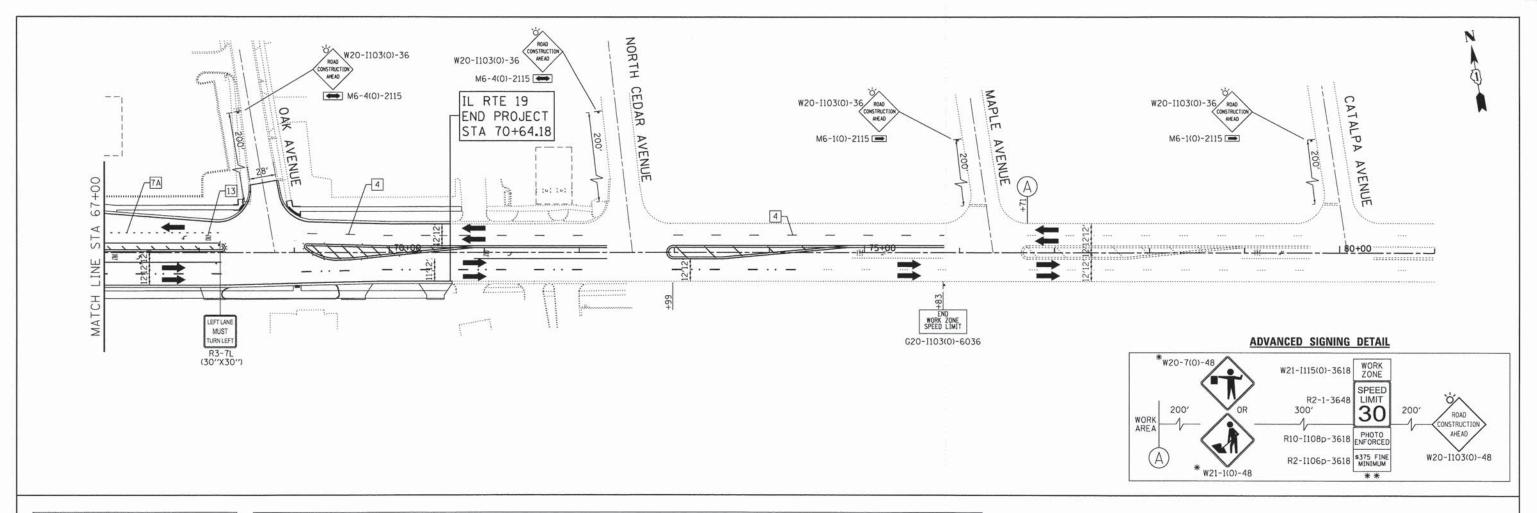
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				CONTRAC	T NO. 6	3872
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TEMPORARY PAVEMENT

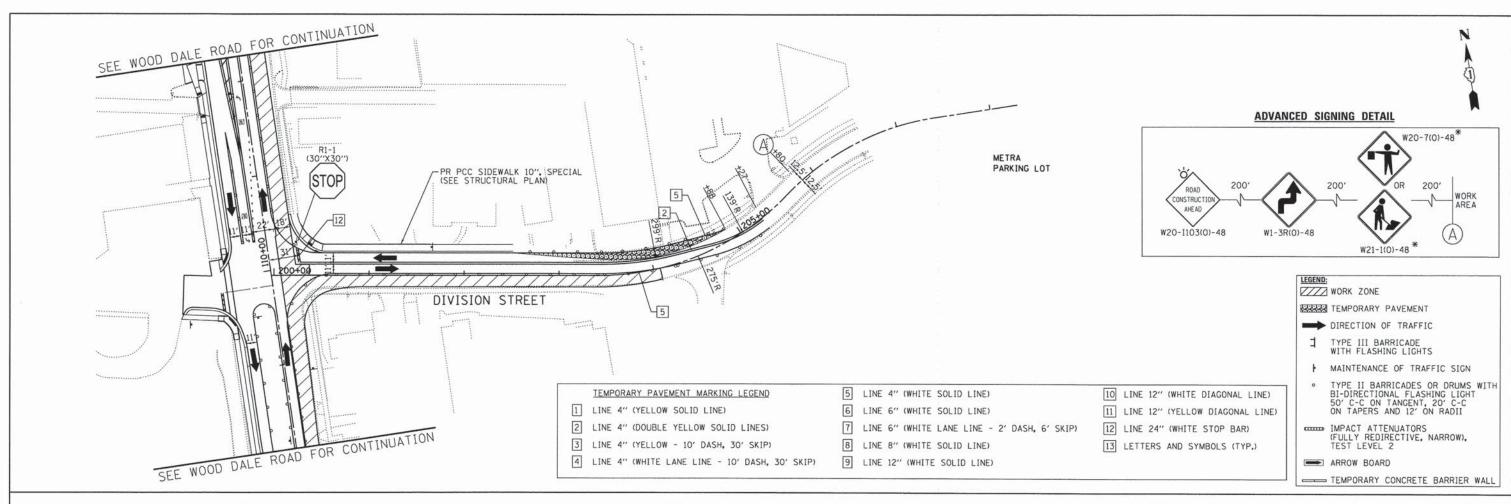DIRECTION OF TRAFFIC

TYPE III BARRICADE WITH FLASHING LIGHTS

MAINTENANCE OF TRAFFIC SIGN

TYPE II BARRICADES OR DRUMS WITH BI-DIRECTIONAL FLASHING LIGHT 50' C-C ON TANGENT, 20' C-C ON TAPERS AND 12' ON RADII

IMPACT ATTENUATORS
(FULLY REDIRECTIVE, NARROW),
TEST LEVEL 2

ARROW BOARD

TEMPORARY CONCRETE BARRIER WALL

NOTES:

FOR PAVEMENT MARKING DETAILS, SEE IDOT DISTRICT 1 DETAIL TC-13.

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A TEMPORARY TRAFFIC SIGNAL IS TO BE INSTALLED AT IL 19 AND C.H. 28 (WOOD DALE RD.), SEE TEMPORARY SIGNAL PLANS FOR DETAILS.

PERMANANT SIGNING AND PAVEMENT MARKINGS ARE SHOWN IN VARIOUS LOCATIONS DURING THIS STAGE. SEE THE PAVEMENT MARKING AND SIGNING PLANS FOR DETAILS.

- * SIGN SHALL BE TAKEN DOWN WHEN WORKERS OR FLAGGERS ARE NOT PRESENT.
- *PLACE WORK ZONE SPEED LIMIT SIGNING 500' FROM WORK ZONE AND WITHIN 500' DOWNSTREAM OF ALL MAJOR INTERSECTIONS.

- TEMPORARY PAVEMENT MARKING LEGEND
- LINE 4" (YELLOW SOLID LINE)
- LINE 4" (DOUBLE YELLOW SOLID LINES)
- LINE 4" (YELLOW 10' DASH, 30' SKIP)
- 4 LINE 4" (WHITE LANE LINE 10' DASH, 30' SKIP)
- 5 LINE 4" (WHITE SOLID LINE)
- 6 LINE 6" (WHITE SOLID LINE)
- 7 LINE 6" (WHITE LANE LINE 2' DASH, 6' SKIP)
- 7A LINE 6" (WHITE LANE LINE 3' DASH, 9' SKIP)
- 8 LINE 8" (WHITE SOLID LINE)

- 9 LINE 12" (WHITE SOLID LINE)
- 10 LINE 12" (WHITE DIAGONAL LINE)
- 11 LINE 12" (YELLOW DIAGONAL LINE)
- 12 LINE 24" (WHITE STOP BAR)
- 13 LETTERS AND SYMBOLS (TYP.)

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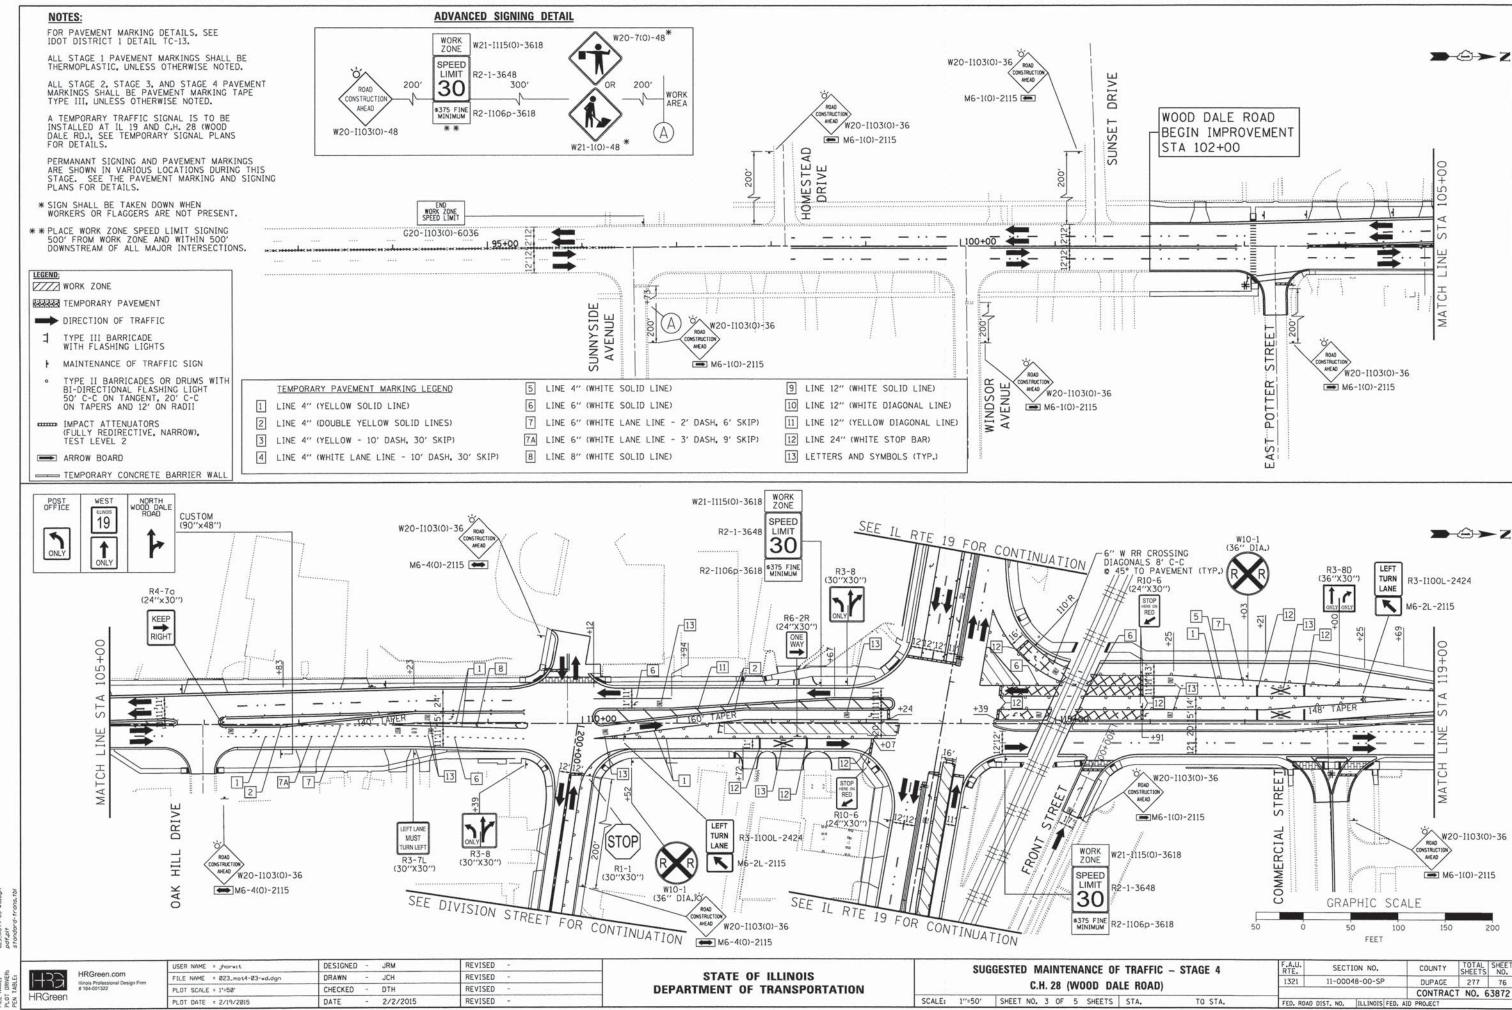
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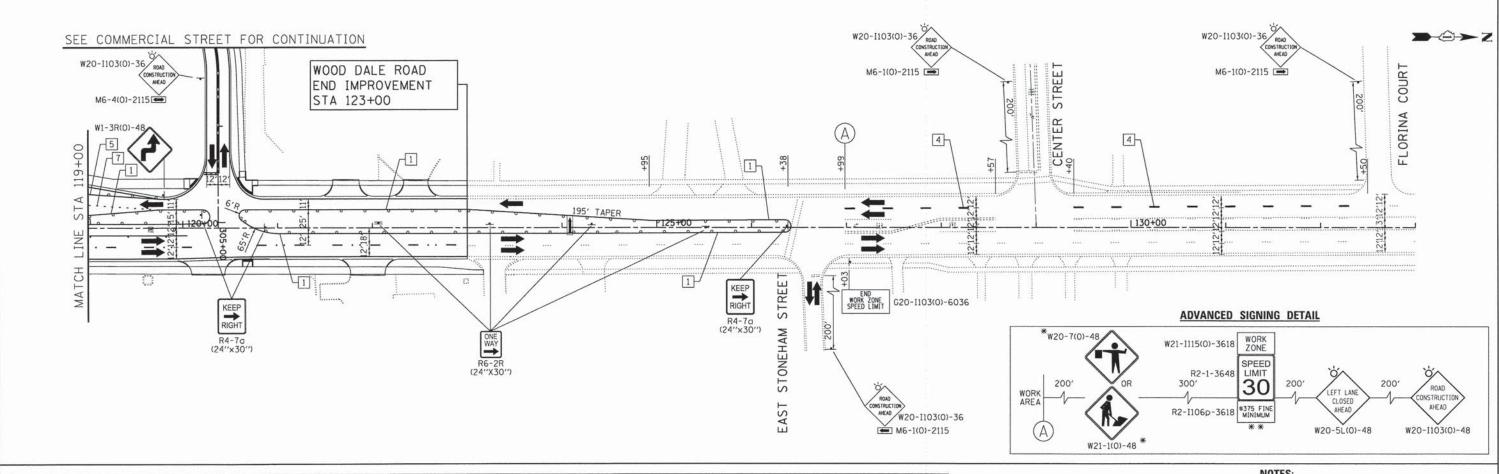
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WORK ZONE

TEMPORARY PAVEMENT

DIRECTION OF TRAFFIC

- TYPE III BARRICADE WITH FLASHING LIGHTS
- MAINTENANCE OF TRAFFIC SIGN
- TYPE II BARRICADES OR DRUMS WITH BI-DIRECTIONAL FLASHING LIGHT 50' C-C ON TANGENT, 20' C-C ON TAPERS AND 12' ON RADII
- IMPACT ATTENUATORS (FULLY REDIRECTIVE, NARROW), TEST LEVEL 2
- ARROW BOARD
- TEMPORARY CONCRETE BARRIER WALL

TEMPORARY PAVEMENT MARKING LEGEND

- 1 LINE 4" (YELLOW SOLID LINE)
- 2 LINE 4" (DOUBLE YELLOW SOLID LINES)
- 3 LINE 4" (YELLOW 10' DASH, 30' SKIP)
- 4 LINE 4" (WHITE LANE LINE 10' DASH, 30' SKIP)

LINE 4" (WHITE SOLID LINE)

- 6 LINE 6" (WHITE SOLID LINE)
- 7 LINE 6" (WHITE LANE LINE - 2' DASH, 6' SKIP)
- 8 LINE 8" (WHITE SOLID LINE)
- 9 LINE 12" (WHITE SOLID LINE)

10 LINE 12" (WHITE DIAGONAL LINE)

- 11 LINE 12" (YELLOW DIAGONAL LINE)
- 12 LINE 24" (WHITE STOP BAR)
- 13 LETTERS AND SYMBOLS (TYP.)

FOR PAVEMENT MARKING DETAILS, SEE IDOT DISTRICT 1 DETAIL TC-13.

ALL STAGE 1 PAVEMENT MARKINGS SHALL BE THERMOPLASTIC, UNLESS OTHERWISE NOTED.

ALL STAGE 2, STAGE 3, AND STAGE 4 PAVEMENT MARKINGS SHALL BE PAVEMENT MARKING TAPE TYPE III, UNLESS OTHERWISE NOTED.

A TEMPORARY TRAFFIC SIGNAL IS TO BE INSTALLED AT IL 19 AND C.H. 28 (WOOD DALE RD.), SEE TEMPORARY SIGNAL PLANS FOR DETAILS.

PERMANANT SIGNING AND PAVEMENT MARKINGS ARE SHOWN IN VARIOUS LOCATIONS DURING THIS STAGE. SEE THE PAVEMENT MARKING AND SIGNING PLANS FOR DETAILS.

- * SIGN SHALL BE TAKEN DOWN WHEN WORKERS OR FLAGGERS ARE NOT PRESENT.
- ** PLACE WORK ZONE SPEED LIMIT SIGNING 500' FROM WORK ZONE AND WITHIN 500' DOWNSTREAM OF ALL MAJOR INTERSECTIONS.

GRAPHIC SCALE 100 FEET

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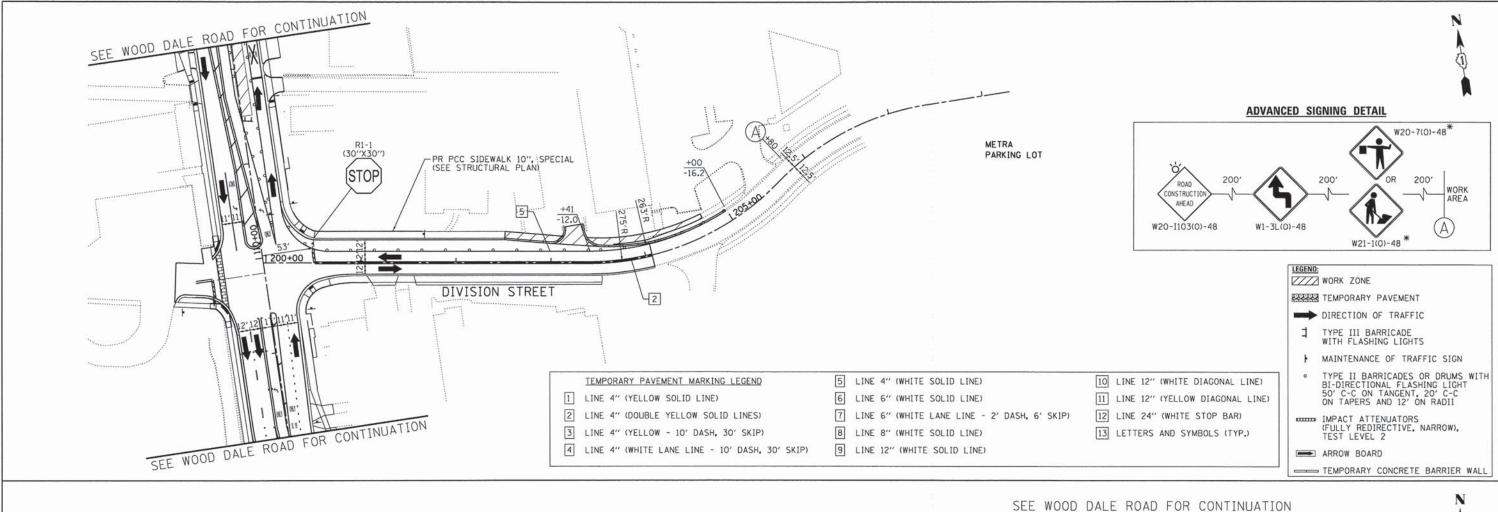
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DEPARTMENT OF TRANSPORTATION



NOTES:

FOR PAVEMENT MARKING DETAILS, SEE IDOT DISTRICT 1 DETAIL TC-13.


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STATE OF ILLINOIS
DEPARTMENT OF TRANSPORTATION


SUGGESTED MAINTENANCE OF TRAFFIC - STAGE 4

DIVISION STREET / COMMERCIAL STREET

SCALE: 1"=50" SHEET NO. 5 OF 5 SHEETS STA. TO STA.

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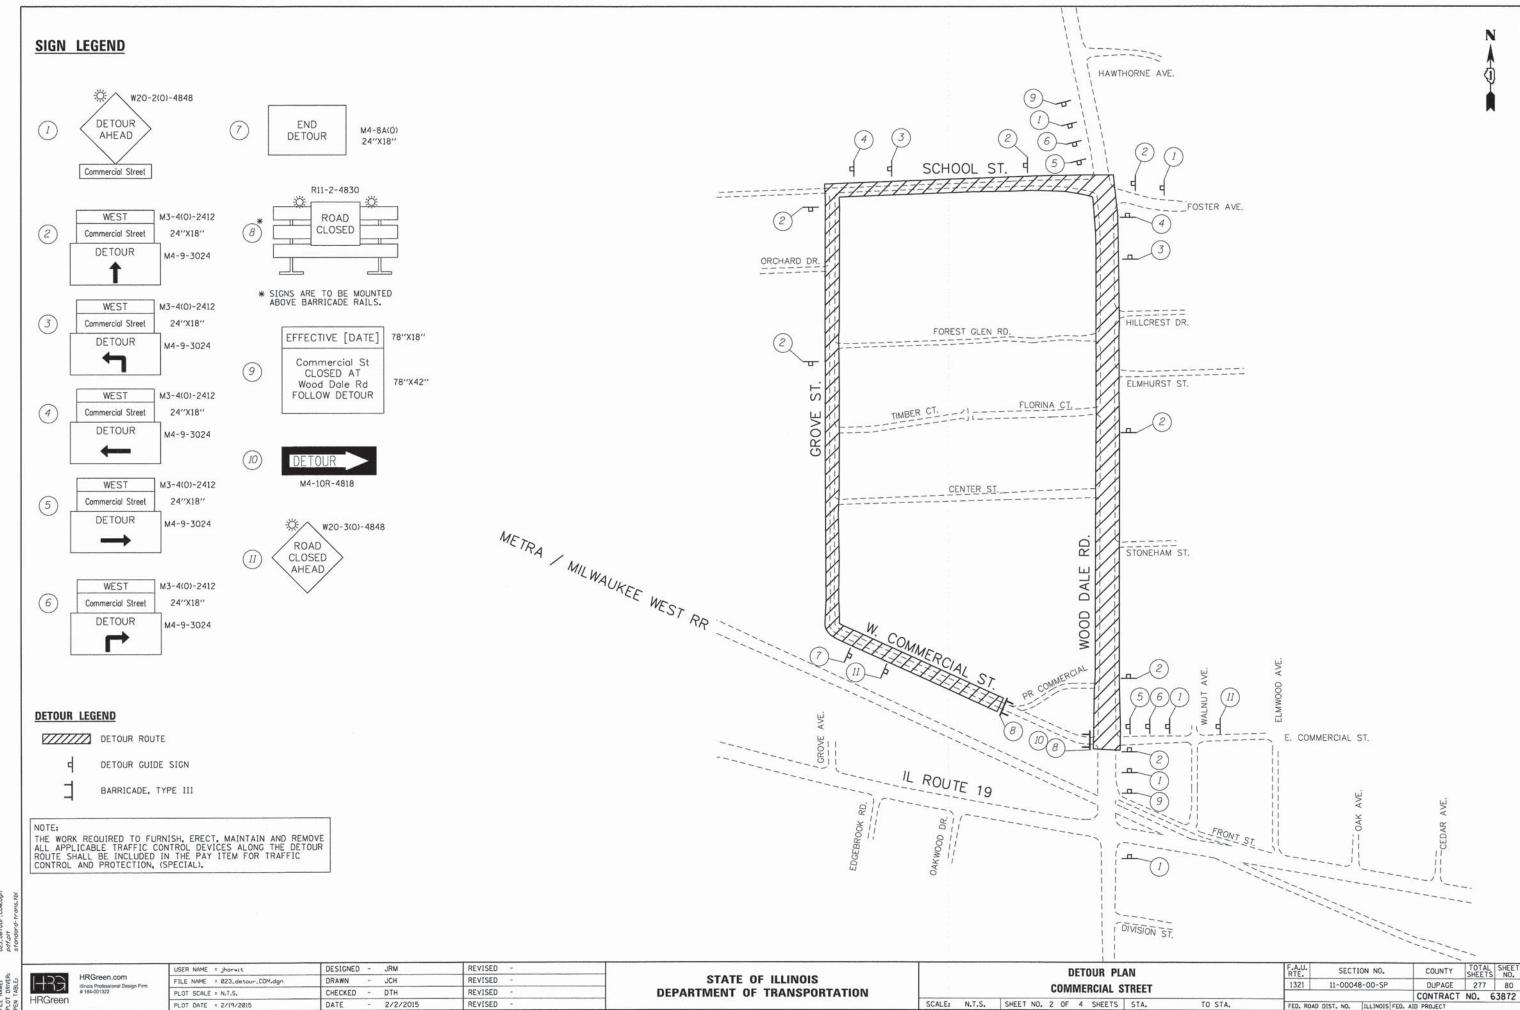
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DEPARTMENT OF TRANSPORTATION

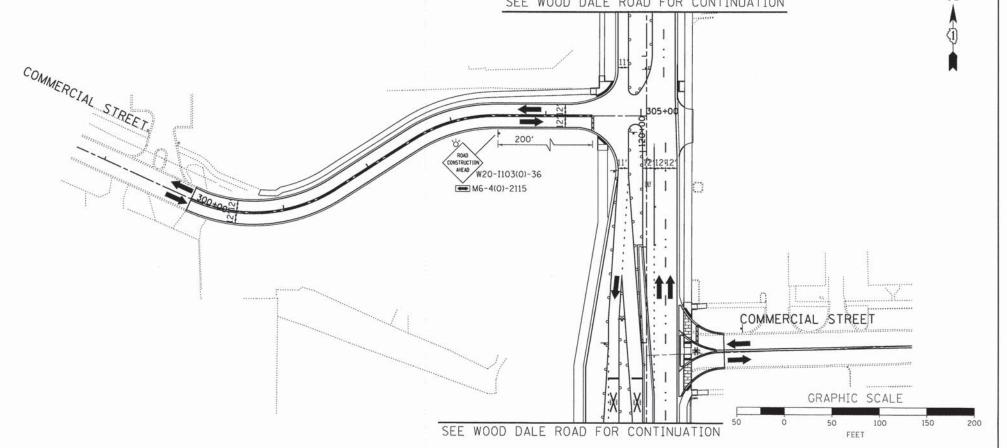WOOD DALE ROAD SCALE: N.T.S. SHEET NO. 1 OF 4 SHEETS STA. TO STA.

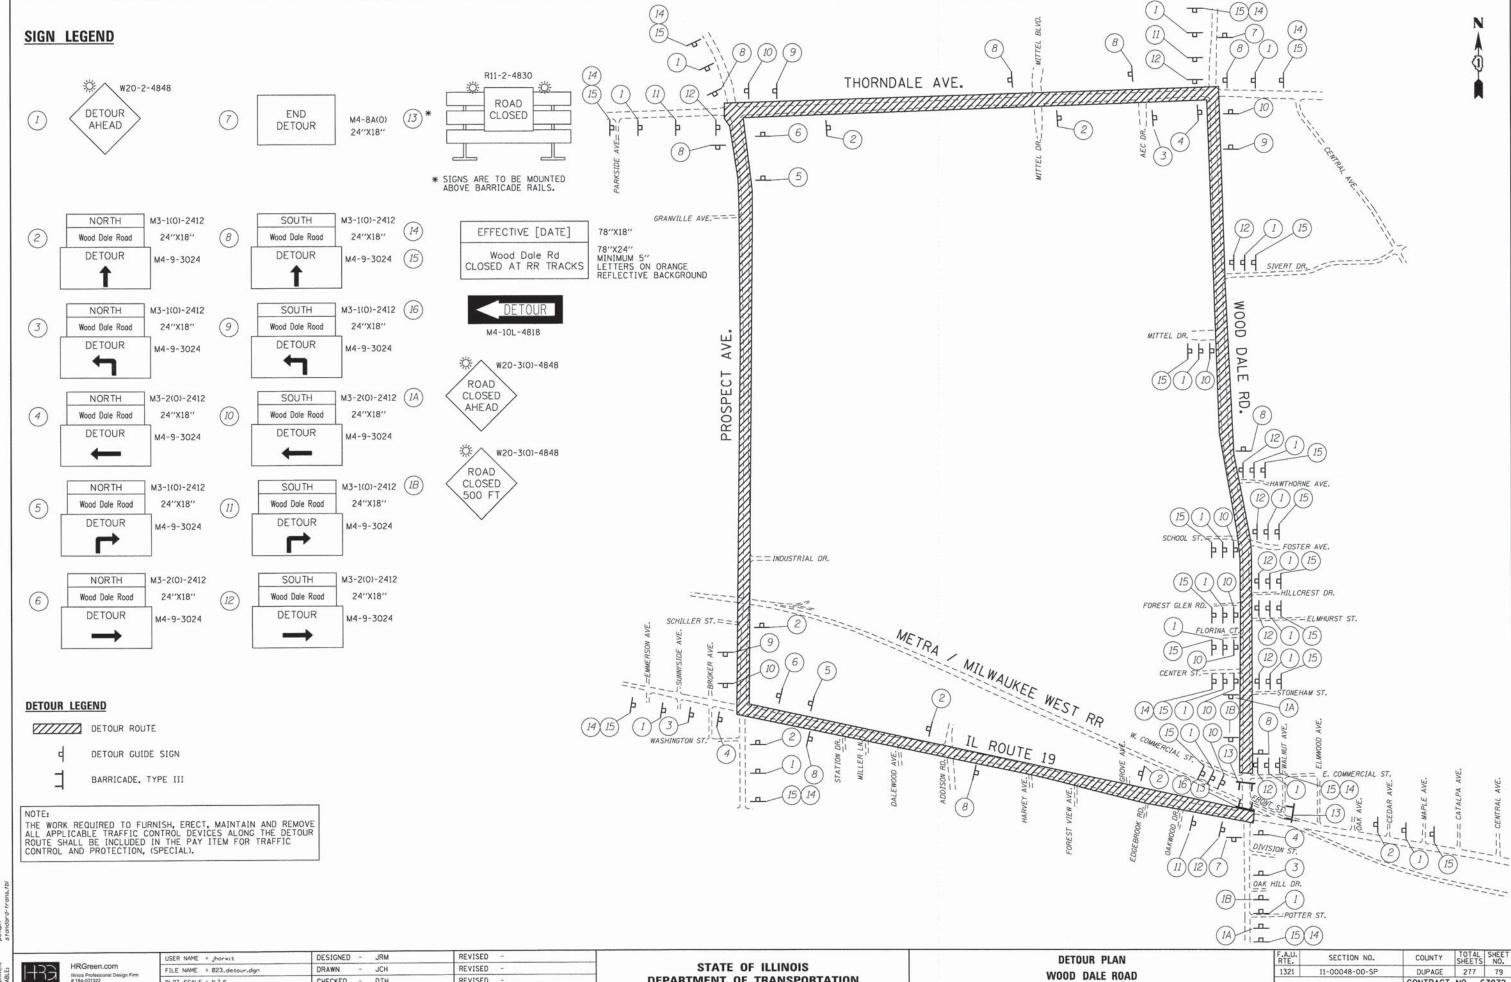CONTRACT NO. 63872 FED. ROAD DIST. NO. ILLINOIS FED. AID PROJECT



SIGN LEGEND



END DETOUR

M4-8A(0) 24"X18"

DETOUR M4-8(0)-2412 EAST M3-1(0)-2412 IL ROUTE 19 24"X18"

DETOUR

R3-1 36"X36"

M6-3(0)-2115

M4-8(0)-2412 M3-1(0)-2412

EFFECTIVE [DATE] NO RIGHT TURN AT IL Route 19

72"X24" MINIMUM 5" BLACK LETTERS ON ORANGE REFLECTIVE BACKGROUND

78"X18"

EAST IL ROUTE 19 24"X18" M5-1L(0)-2115

DETOUR M4-8(0)-2412 EAST M3-2(0)-2412 IL ROUTE 19 24"X18" M6-1(0)-2115

DETOUR M4-8(0)-2412 EAST M3-1(0)-2412 (5) IL ROUTE 19 24"X18" M5-1R(0)-2115

DETOUR M4-8(0)-2412 EAST M3-2(0)-2412 24"X18" IL ROUTE 19 (6) M6-1(0)-2115

DETOUR LEGEND


DETOUR ROUTE

DETOUR GUIDE SIGN

BARRICADE, TYPE III

NOTE:

THE WORK REQUIRED TO FURNISH, ERECT, MAINTAIN AND REMOVE ALL APPLICABLE TRAFFIC CONTROL DEVICES ALONG THE DETOUR ROUTE SHALL BE INCLUDED IN THE PAY ITEM FOR TRAFFIC CONTROL AND PROTECTION, (SPECIAL).

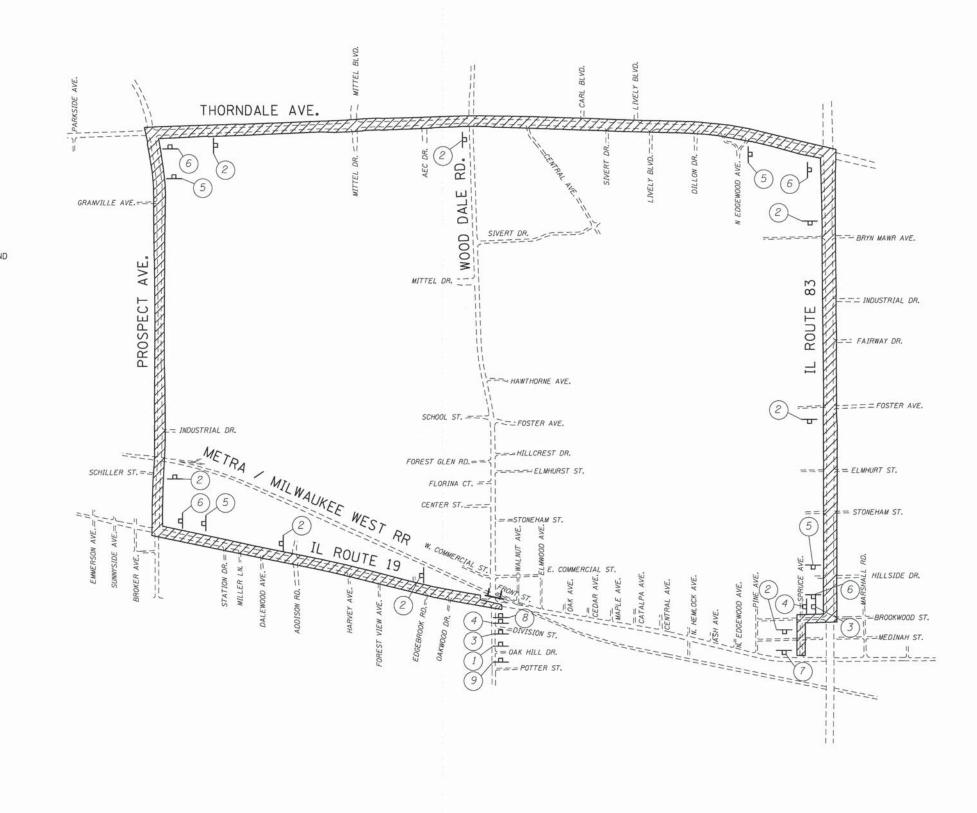

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REVISED DESIGNED - JRM DRAWN REVISED DTH REVISED CHECKED -DATE 2/2/2015 REVISED

STATE OF ILLINOIS **DEPARTMENT OF TRANSPORTATION**

DETOUR PLAN SECTION NO. 11-00048-00-SP DUPAGE 277 81 IL ROUTE 19 STAGE 1C CONTRACT NO. 63872 SCALE: N.T.S. SHEET NO. 3 OF 4 SHEETS STA. TO STA.

SIGN LEGEND



END M4-8A(0) DETOUR 24"X18"

SOUTH M3-1(0)-2412 Wood Dale Road DETOUR M4-9-3024

SOUTH M3-1(0)-2412 (3) Wood Dale Road 24"X18" DETOUR M4-9-3024

SOUTH M3-2(0)-2412 Wood Dale Road 24"X18" DETOUR M4-9-3024

SOUTH M3-1(0)-2412 (5) Wood Dale Road 24"X18" DETOUR M4-9-3024

SOUTH M3-2(0)-2412 Wood Dale Road 24"X18" (6) DETOUR M4-9-3024


DETOUR LEGEND

DETOUR ROUTE

DETOUR GUIDE SIGN

BARRICADE, TYPE III

THE WORK REQUIRED TO FURNISH, ERECT, MAINTAIN AND REMOVE ALL APPLICABLE TRAFFIC CONTROL DEVICES ALONG THE DETOUR ROUTE SHALL BE INCLUDED IN THE PAY ITEM FOR TRAFFIC CONTROL AND PROTECTION, (SPECIAL).

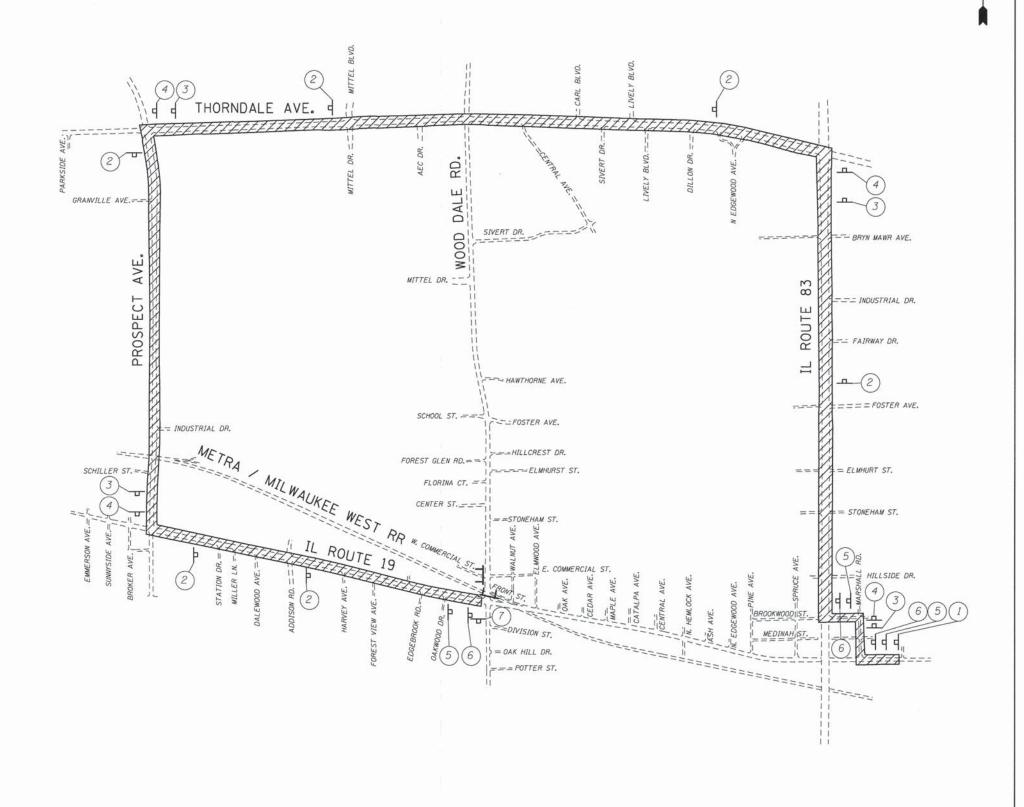

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PLOT SCALE = N.T.S. PLOT DATE = 2/19/2015

DESIGNED - JRM REVISED USER NAME = jhorwit DRAWN REVISED CHECKED - DTH REVISED DATE - 2/2/2015 REVISED

STATE OF ILLINOIS **DEPARTMENT OF TRANSPORTATION**


COUNTY TOTAL SHEET NO. DUPAGE 277 82 SECTION NO. **DETOUR PLAN** 1321 11-00048-00-SP WOOD DALE ROAD STAGE 1D CONTRACT NO. 63872 SCALE: N.T.S. SHEET NO. 4 OF 4 SHEETS STA. TO STA. FED. ROAD DIST. NO. | ILLINOIS FED. AID PROJECT

EROSION CONTROL GENERAL NOTES

- ALL WORK SHALL BE DONE IN ACCORDANCE WITH SECTION 15-116 OF THE DUPAGE COUNTY COUNTYWIDE STORM WATER AND FLOOD PLAIN ORDINANCE, EFFECTIVE SEPTEMBER 24, 1991 AND ALL SUBSEQUENT REVISIONS. ALL SEDIMENT AND EROSION CONTROL MEASURES WILL BE INSTALLED PER IDOT STANDARD 280001 OR AS SPECIFIED HEREIN AND PAID FOR IN ACCORDANCE WITH SECTION 280 OF THE STANDARD SPECIFICATIONS, ALL CONSTRUCTION ACTIVITIES WILL BE IN ACCORDANCE WITH THE NATIONAL POLLUTANT DISCHARGE ELIMINATION SYSTEM STORM WATER PERMIT ILR40.
- EROSION CONTROL SHALL BE PROVIDED IN ACCORDANCE WITH THE SEQUENCE OF STAGE CONSTRUCTION. THE CONTRACTOR SHALL SUBMIT A DETAILED SCHEDULE FOR APPROVAL.
- 3. SEDIMENT AND EROSION CONTROL DEVICES SHALL BE FUNCTIONAL BEFORE THE PROJECT SITE IS OTHERWISE DISTURBED.
- 4. ALL DISTURBED AREAS SHALL BE SEEDED OR SODDED AS SOON AS PRACTICAL AFTER CONSTRUCTION ACTIVITIES IN THAT AREA HAVE CONCLUDED. ALL ERODABLE/BARE AREAS SHALL BE SEEDED EVERY 7 DAYS WITH TEMPORARY EROSION CONTROL SEEDING, IF A TOPSOIL STOCKPILE IS TO REMAIN IN PLACE FOR MORE THAN THREE DAYS, EROSION CONTROL MEASURES WILL BE PROVIDED.
- 5. WHERE WETLANDS ARE TO REMAIN, THE CONTRACTOR SHALL TAKE ALL PRECAUTIONS TO PROTECT WETLANDS FROM DAMAGE BY SEDIMENT, CONSTRUCTION EQUIPMENT OR BY HIS WORK CREWS. THE CONTRACTOR SHALL ASSURE THAT DEBRIS OR ANY CONSTRUCTION MATERIAL IS NOT DISPOSED OF OR STOCKPILED IN WETLANDS.
- 6. STOCKPILES AND MATERIAL STORAGE ARE PROHIBITED IN SPECIAL MANAGEMENT AREAS INCLUDING WETLANDS, WETLAND BUFFERS, AND FLOOD PLAINS. LOCATIONS OF STOCKPILES MUST BE APPROVED BY THE ENGINEER AND HAVE PROPER EROSION CONTROL MEASURES.
- WATER PUMPED OR OTHERWISE DISCHARGED FROM THE SITE DURING CONSTRUCTION DEWATERING SHALL BE FILTERED.
- 8. WHEN TEMPORARY DRAINAGE IS ESTABLISHED, EROSION CONTROL MEASURES MAY BE REQUIRED BY THE ENGINEER.
- 9. GRAVEL ROADS, ACCESS DRIVES, PARKING AREAS OF SUFFICIENT WIDTH AND LENGTH, AND VEHICLE WASH DOWN FACILITIES IF NECESSARY, SHALL BE PROVIDED TO PREVENT SOIL FROM BEING TRACKED ONTO PUBLIC OR PRIVATE ROADWAYS. ANY SOIL REACHING A PUBLIC OR PRIVATE ROADWAY SHALL BE REMOVED BEFORE THE END OF EACH WORKDAY AND AS NEEDED.
- 10. CLEANING OF VEHICLES AND EQUIPMENT, INCLUDING CONCRETE MIXERS, SHALL BE PERFORMED IN A MANNER TO REDUCE THE AMOUNT OF POLLUTANTS TRIBUTARY TO STORM SEWERS AND OPEN WATERS TO THE MAXIMUM EXTENT PRACTICAL.
- 11. ALL NECESSARY MEASURES SHALL BE TAKEN TO CONTAIN ANY FUEL OR POLLUTION RUNOFF. LEAKING EQUIPMENT OR SUPPLIES SHALL BE IMMEDIATELY REPAIRED OR REMOVED FROM THE SITE.
- 12. SEDIMENT COLLECTED DURING CONSTRUCTION BY THE VARIOUS TEMPORARY EROSION CONTROL SYSTEMS SHALL BE DISPOSED OF ON A REGULAR BASIS. SEDIMENT SHALL BE REMOVED FROM EROSION CONTROL SYSTEMS WHEN THE HEIGHT OF THE SEDIMENT EXCEEDS ONE-HALF OF THE HEIGHT OF THE FILTER DEVICE.
- 13. ALL EROSION CONTROL MEASURES SHALL BE KEPT OPERATIONAL AND MAINTAINED CONTINUOUSLY THROUGHOUT THE PERIOD OF LAND DISTURBANCE UNTIL PERMANENT SEDIMENT AND EROSION CONTROL MEASURES ARE OPERATIONAL.
- 14. THE ENGINEER SHALL INSPECT EROSION CONTROL MEASURES PERIODICALLY AND WITHIN 24 HOURS OF ANY STORM EXCEEDING 1/2 INCH PRECIPITATION. DAMAGED AND INFFFECTIVE EROSION CONTROL MEASURES SHALL BE REPAIRED OR REPLACED BY THE CONTRACTOR WITHIN 24 HOURS. EROSION CONTROL SYSTEMS REPLACED DUE TO SEDIMENT LOADING WILL BE PAID FOR AT THE CONTRACT UNIT PRICE FOR THE APPLICABLE EROSION CONTROL ITEM.
- 15. THE COST OF REMOVING SEDIMENT OR REPAIRING EROSION CONTROL SYSTEMS SHALL BE INCLUDED IN THE CONTRACT UNIT PRICE FOR THE APPLICABLE EROSION CONTROL ITEM.
- 16. SOIL DISTURBANCE SHALL BE CONDUCTED IN SUCH A MANNER AS TO MINIMIZE EROSION. AREAS OF THE SITE THAT ARE NOT TO BE GRADED SHALL BE PROTECTED FROM CONSTRUCTION TRAFFIC OR OTHER DISTURBANCE UNTIL FINAL SEEDING IS PERFORMED.
- 17. PROPERTIES AND CHANNELS ADJOINING THE SITE SHALL BE PROTECTED FROM EROSION AND SEDIMENTATION.
- 18. DISTURBED AREAS SHALL BE STABILIZED WITH TEMPORARY OR PERMANENT MEASURES WITHIN SEVEN (7) CALENDAR DAYS FOLLOWING THE END OF ACTIVE HYDROLOGIC DISTURBANCE.
- ALL STORM SEWERS THAT ARE OR WILL BE FUNCTIONING DURING CONSTRUCTION SHALL BE PROTECTED BY AN APPROPRIATE SEDIMENT CONTROL MEASURE.


- 20. IF DEWATERING SERVICES ARE USED ADJOINING PROPERTIES AND DISCHARGE LOCATIONS SHALL BE PROTECTED FROM EROSION. DISCHARGES SHALL BE ROUTED THROUGH AN EFFECTIVE SEDIMENT CONTROL MEASURE (E.G. SEDIMENT TRAP, SEDIMENT BASIN, OR OTHER APPROPRIATE MEASURE).
- 21. THE CONTRACTOR SHALL PROVIDE ADEQUATE RECEPTACLES FOR THE DEPOSITION OF ALL CONSTRUCTION MATERIAL DEBRIS GENERATED DURING THE DEVELOPMENT PROCESS. THE CONTRACTOR SHALL NOT CAUSE OR PERMIT DUMPING, DEPOSITING, DROPPING, THROWING, DISCARDING OR LEAVING OF CONSTRUCTION MATERIAL DEBRIS UPON OR INTO THE CONSTRUCTION SITE, CHANNEL, WATERS OF THE UNITED STATES OR ISOLATED WATERS. THE CONTRUCTION MATERIAL DEBRIS.
- 22. SEDIMENT COLLECTED DURING CONSTRUCTION BY THE VARIOUS TEMPORARY EROSION CONTROL SYSTEMS SHALL BE DISPOSED OF ON A REGULAR BASIS. SEDIMENT SHALL BE REMOVED FROM EROSION CONTROL SYSTEMS WHEN THE HEIGHT OF THE SEDIMENT EXCEEDS ONE-HALF OF THE HEIGHT OF THE FILTER DEVICE.
- 23. ALL TEMPORARY SOIL EROSION AND SEDIMENT CONTROL MEASURES SHALL BE REMOVED WITHIN THIRTY (30) DAYS AFTER FINAL SITE STABILIZATION IS ACHIEVED OR AFTER THE TEMPORARY MEASURES ARE NO LONGER NEEDED. TRAPPED SEDIMENT AND OTHER DISTURBED SOIL AREAS SHALL BE PERMANENTLY STABILIZED.
- 24. ALL WORK SHALL BE PERFORMED IN ACCORDANCE WITH THE STORM WATER POLLUTION PREVENTION PLAN FOR THIS PROJECT.
- 25. PRIOR TO CONSTRUCTION, THE CONTRACTOR SHALL CREATE A PLAN TO STABILIZE FLOW LINES DURING STORM SEWER CONSTRUCTION WHEN RAIN IS FORECASTED. LACK OF AN APPROVED PLAN FROM THE RESIDENT ENGINEER OR FAILURE TO COMPLY WITH THE STABILIZED FLOW LINE PLAN WILL RESULT IN AN A DEFICIENCY DEDUCTION.

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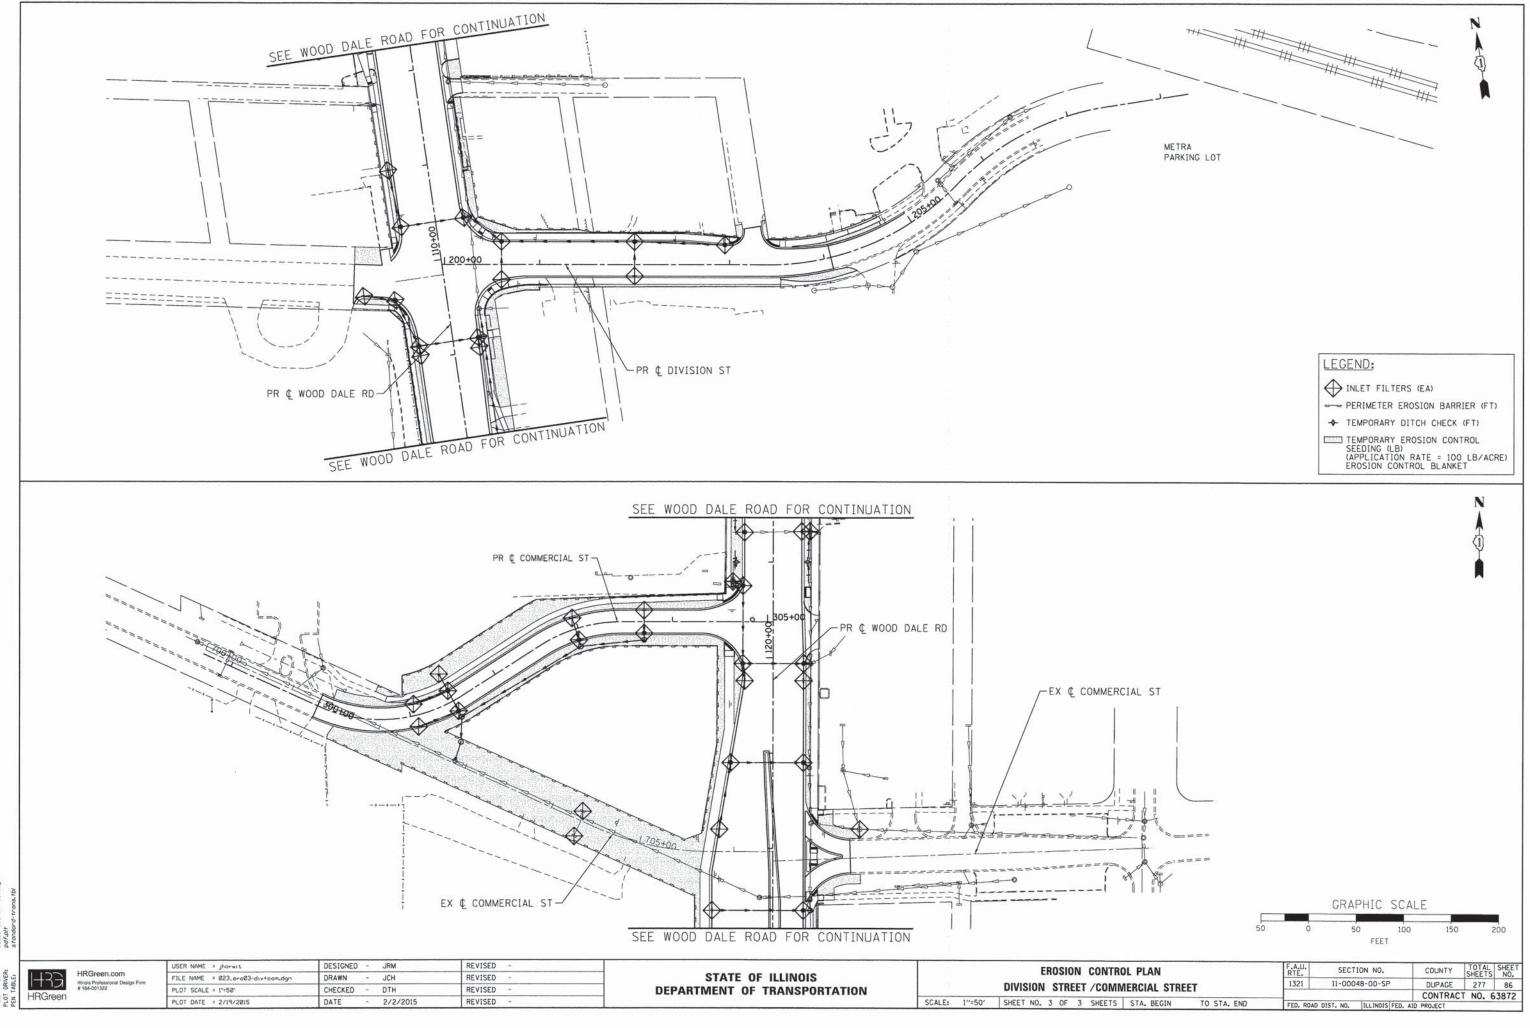
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TO STA. END

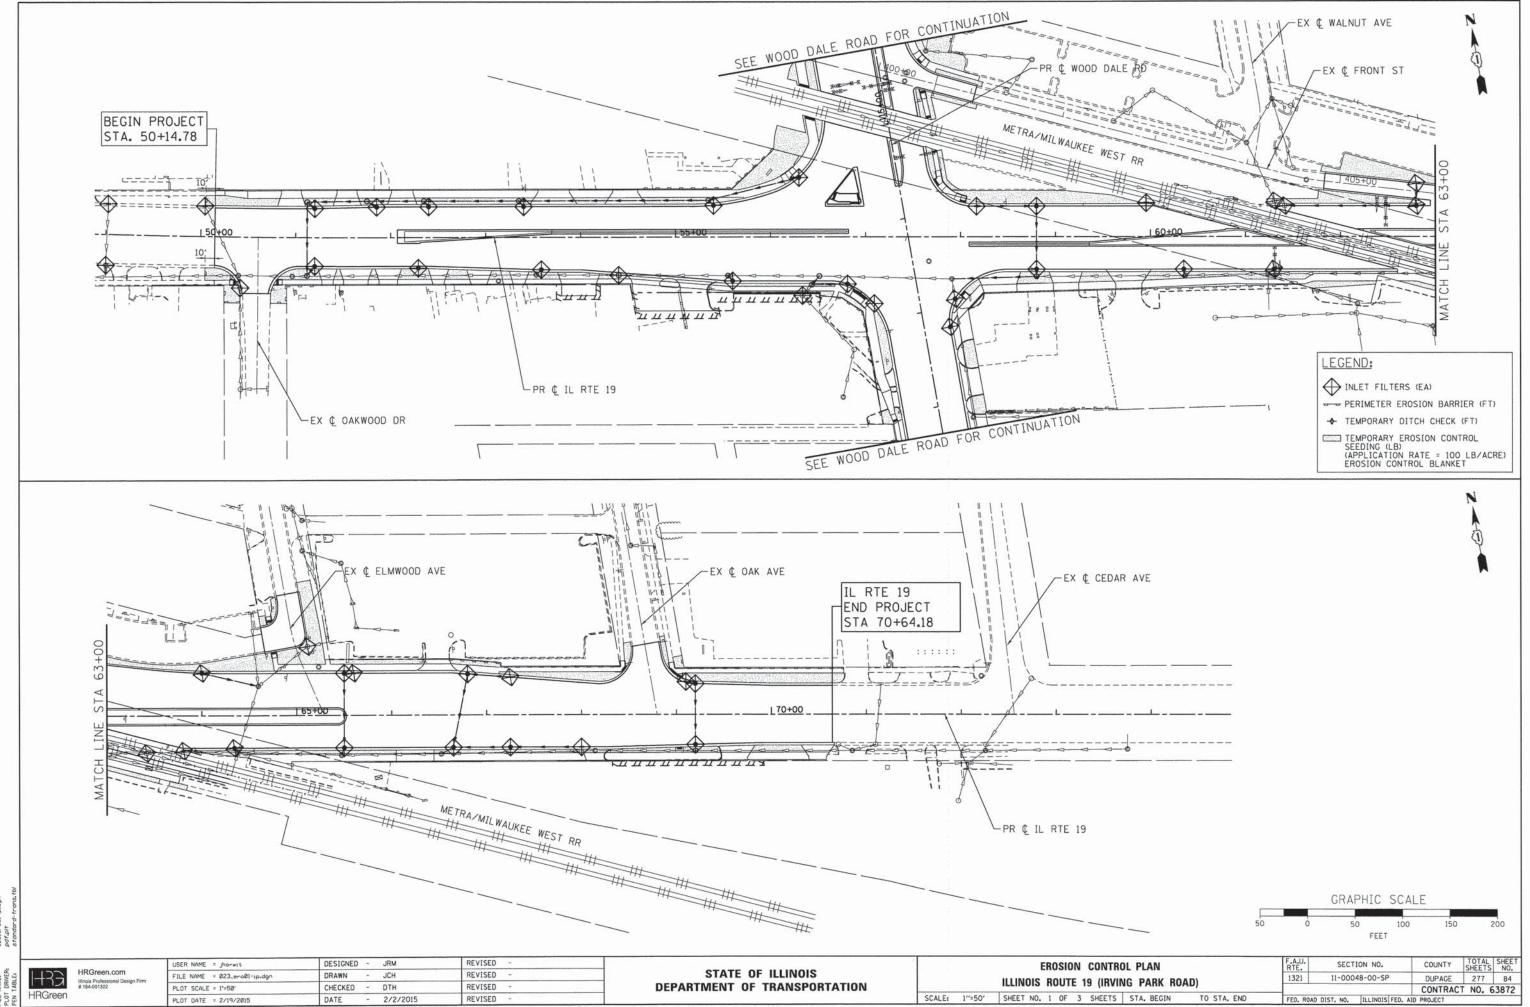PLOT DATE = 2/19/2015

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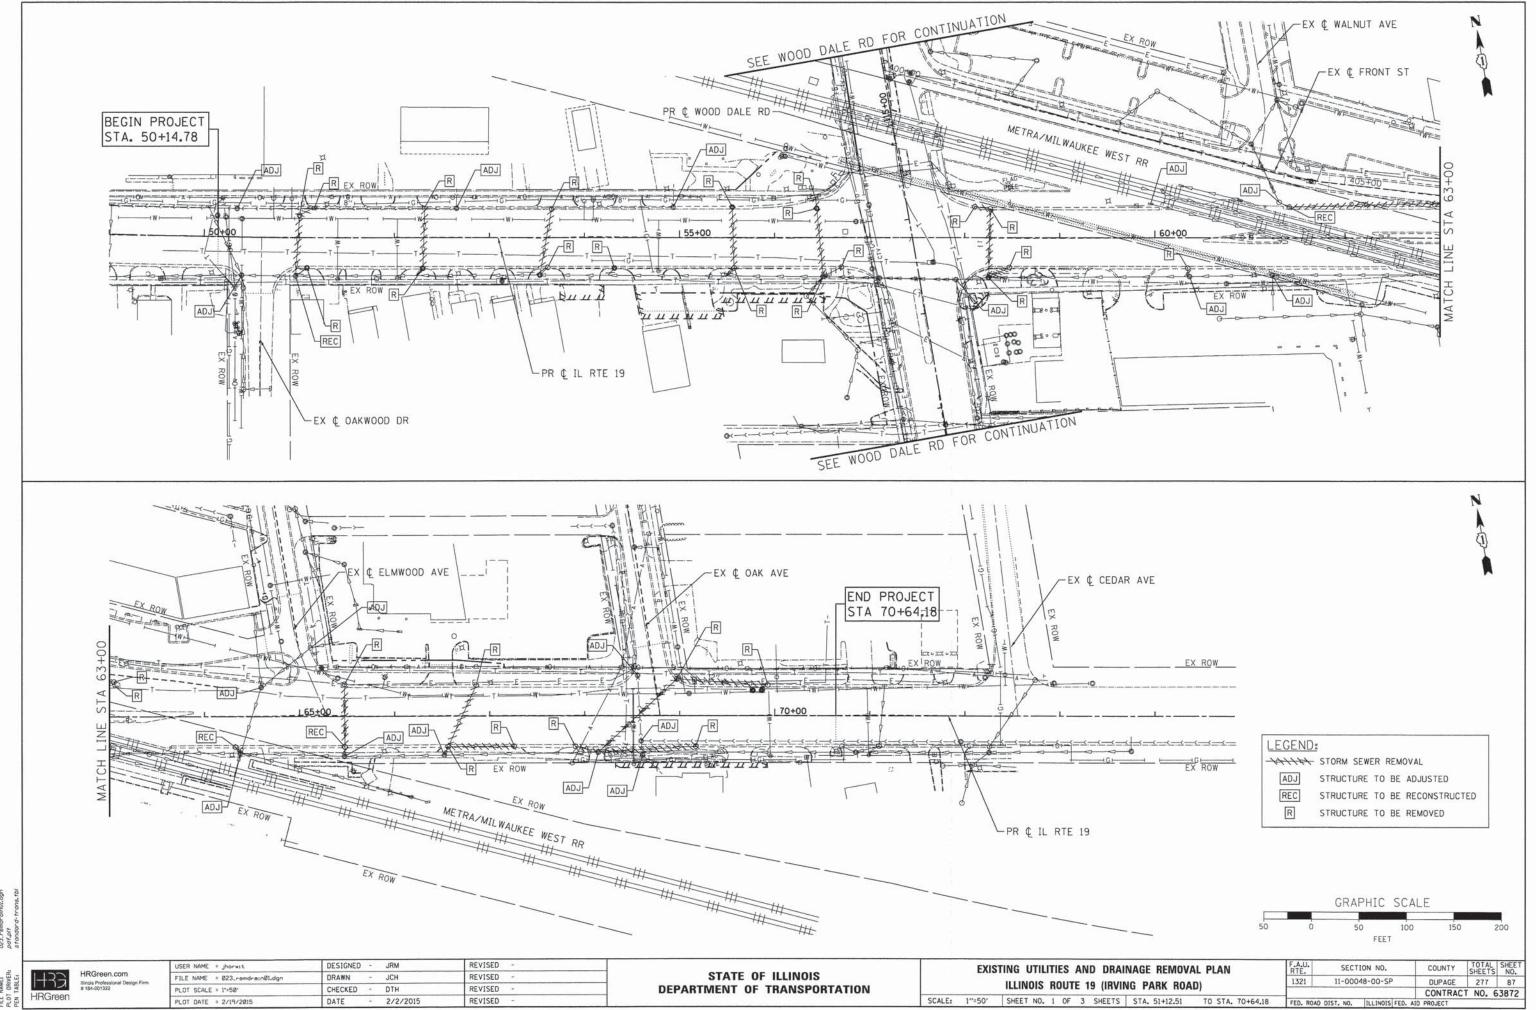
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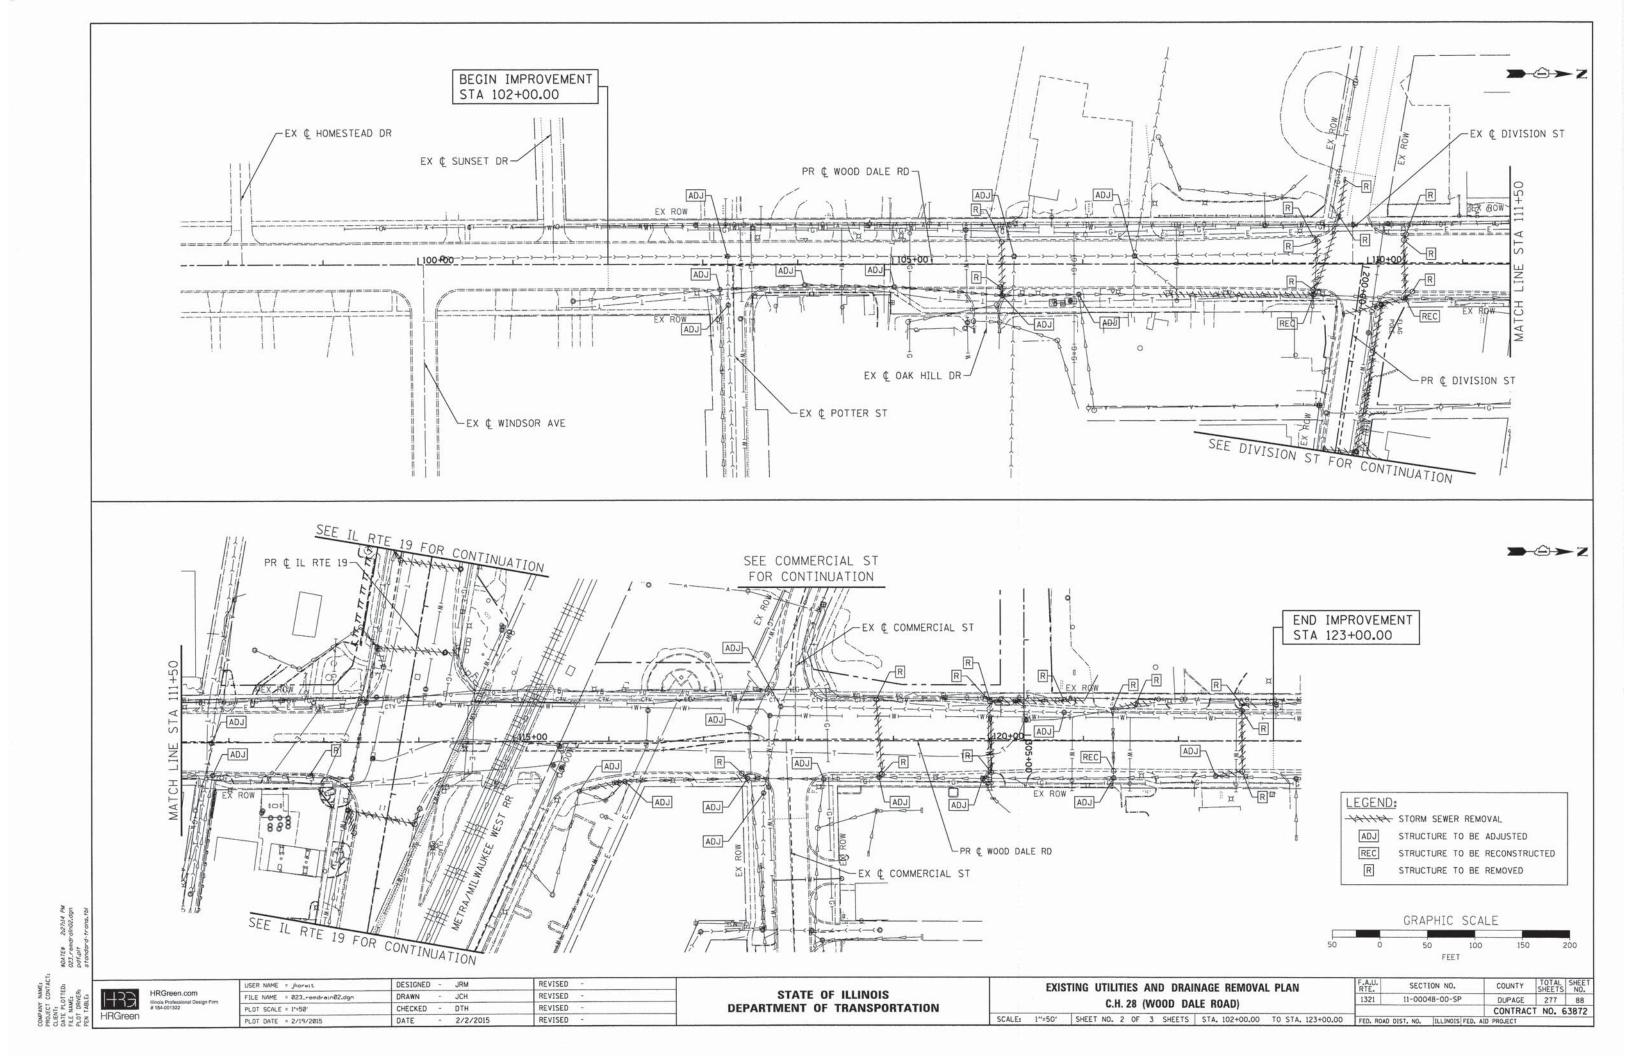



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PLOT DATE = 2/19/2015

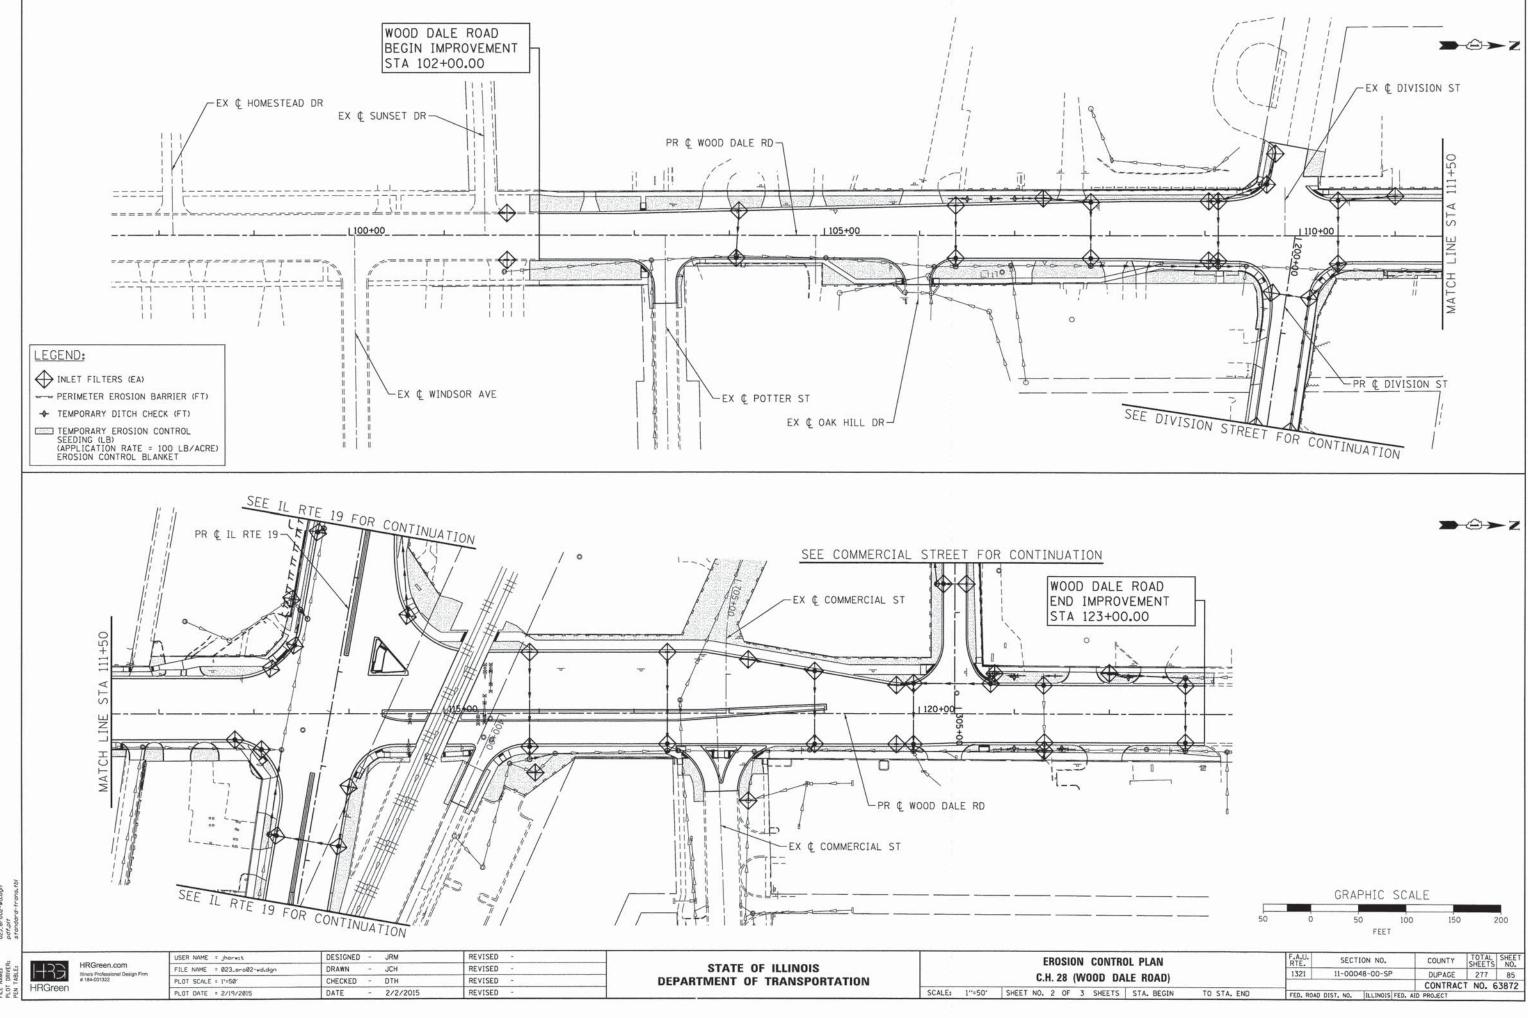- 2/2/2015





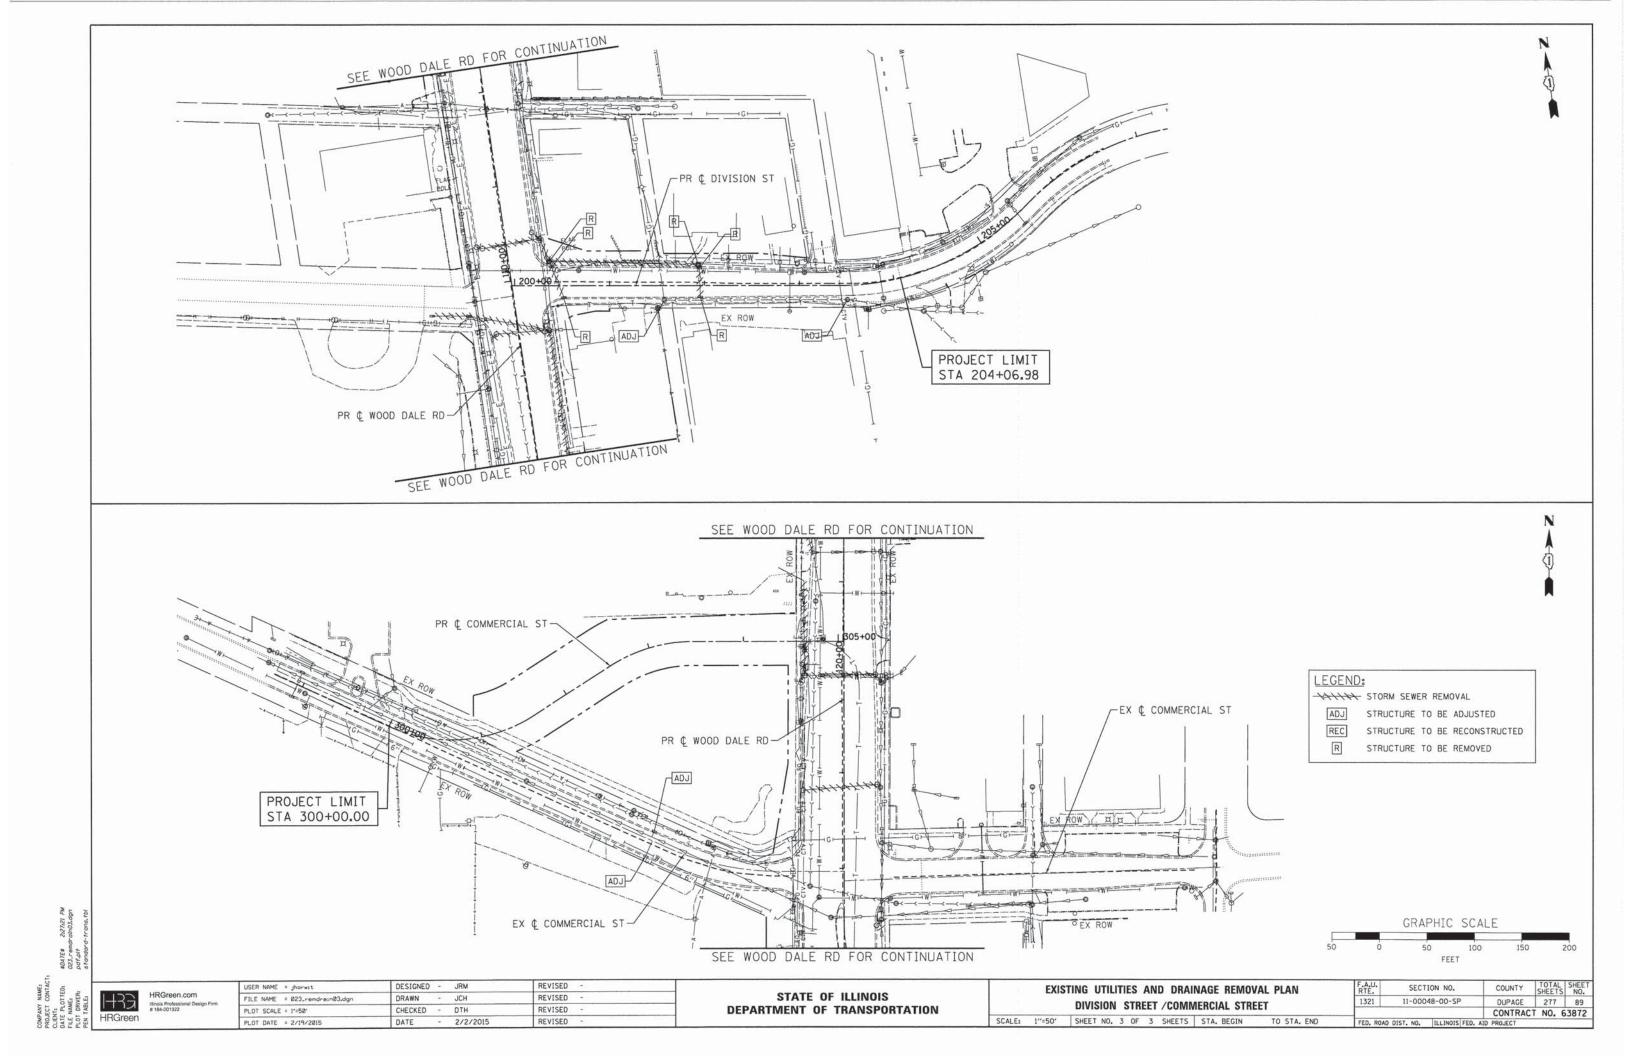

LOCA	TION	EXIST. RIM ELEV.	PROP. RIM ELEV.	ST	ORM SEWER	R REMOVALS	S (* NOTE -	SEE BELO	W)	TRENCH BACKFILL	MANHOLES TO BE ADJUSTED	MANHOLES TO BE ADJUSTED	MANHOLES TO BE ADJUSTED	MANHOLES TO BE RECONSTRUCTED	CATCH BASINS TO BE ADJUSTED	CATCH BASINS TO BE RECONSTRUCTED	INLETS TO BE ADJUSTED	REMOVING MANHOLES	REMOVING CATCH BASINS	REMOVING INLETS
STATION	OFFSET (FOOT)	ELEV.		(F00T) 55100100	8" (F00T) 55100300	10" (F00T) 55100400	12" (F00T) 55100500	24" (F00T) 55101200	36" (F00T) 55101600	(CU YD)	(EACH)	MANHOLES TO BE ADJUSTED WITH NEW TYPE 1 FRAME, OL (EACH) 60255700	MANHOLES TO BE ADJUSTED WITH NEW TYPE 24 F&G (EACH) 60256940	(EACH) 60257900	CATCH BASINS TO BE ADJUSTED WITH NEW TYPE 1 FRAME, OL (EACH) 60250400	CATCH BASINS TO BE RECONSTRUCTED WITH NEW TYPE 24 F&G (EACH) 60254340	(EACH) 60260100	(EACH) 60500040	(EACH) 60500050	(EACH) 60500060
1RVING PA 50+40 4 50+97 4		679.51 680.41									1			1				Marga-		
51+00 2	23.2 LT	000111	000130				58.8			17.16									1	
51+08 3	31.7 RT 31.7 RT						9.8											1		
51+16 3	31.8 LT 31.8 LT						15.1			2.50										1
52+32 3	32.1 RT 31.8 LT						59.9			14.97								1		
53+61 3	31.8 LT 31.1 RT				8.7															1
53+65 2	31.1 RT				65.1					21.22										
54+31 3	29.8 LT 32.0 RT						8.2			2.41								1	-	
55+55 3	32.0 RT 31.9 LT 31.9 LT						59.8			14.97								1		
55+57 3	32.0 RT 32.0 RT						9.8			6.73									. 1	
56+43 4	41.2 LT 50.0 RT						6.6 7.7			0.99										
56+43 4	41.2 LT 30.6 LT				66.8					15.73										1
56+51 4	30.6 LT 40.9 RT																	1		
56+70 3	30.9 RT 30.9 RT				16.6		10.6			3.31									1	
58+11 3	32.3 LT	602.15	602.17				12.6			3.16				1					1	
58+25 4	44.1 RT 41.9 RT 41.9 RT	692.15	692.11					30.3										1		
58+27 3	30.2 LT 30.2 LT						68.2	30.0		25.58									1	
58+47 3	31.2 RT 31.2 RT				20.4					6.33									1	
58+80 4	41.6 RT 35.3 LT	694.49	694.50					53.0									1			
60+35 3	31.8 RT 31.8 RT						4.9												1	
61+24 3	39.0 RT		696.50								1									
61+41 3	37.3 LT 32.2 LT	696.29 696.25										1				1		1,5,2,3,17		
63+05 3	36.6 LT						159.4			23.16									1	
63+07 3	31.4 LT				15		2.6			0.43										1
64+32 3	31.8 RT 31.8 RT 38.2 RT	698.29			4.5						1					1				
64+60 3	38.2 RT 30.7 LT 71.8 LT	698.66 698.20 696.43									î				1					
	33.7 LT		550.00				61.7			9.00									1	
65+47 4 65+48 3	41.8 RT 32.0 RT		699.40								1								1	
65+48 3	32.0 RT 40.8 RT	700.28	700.10				5.8			1.27	1									
66+56 3 66+56 3	31.9 RT 31.9 RT						5.8			1.37									1	
66+86 3 66+86 3	32.3 LT 32.3 LT						66.6			9.66									1	
67+26	31.7 RT 31.7 RT		THE STATE OF THE S				65.5			9.55									1	
67+90 67+90	31.9 RT	700 11	701.00				20.9			3.97	1								11	
68+97 3	38.1 RT 38.5 LT	702.41	701.98				108.6	ternellas		31.60	1								1	
69+17 3	38.5 LT 32.0 RT						98.8			34.98									1	
69+93 3	32.0 RT 32.2 LT						91.8			13.39									1	
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RTE.	1321 11-00048-	ION NO.		COUNTY	TOTAL	NO.
1321	11-0004	8-00-SP		DUPAGE	277	90
				CONTRACT	NO. 6	3872
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	1321	TA IOSTA	1321 11-00048-00-SP	1321 11-00048-00-SP	1321 11-00048-00-SP DUPAGE CONTRACT	1321 11-00048-00-SP DUPAGE 277 CONTRACT NO. 6

CATCH BASINS INLETS REMOVING R TRENCH MANHOLES TO BE ADJUSTED MANHOLES TO BE RECONSTRUCTED CATCH BASINS TO BE D ADJUSTED R WITH NEW TYPE 1 FRAME, OL (EACH) 60250400 MANHOLES TO BE ADJUSTED WITH NEW TYPE 1 FRAME, OL (EACH) (EACH) TO BE
ADJUSTED
WITH NEW
TYPE 24 F&G
(EACH)
60256940 STORM SEWER REMOVALS (* NOTE - SEE BELOW) | WOOD DALE ROAD | 103+18 | 26.5 | RT | 703.41 | 702.75 | 104+07 | 21.8 | RT | 701.98 | 702.02 | 105+02 | 23.9 | RT | 699.53 | 699.52 | 106+13 | 24.0 | RT | 106+15 | 23.1 | LT | 109+42 | 29.0 | LT | 109+42 | 27.1 | RT | 109+42 | 23.7 | LT | 109+47 | 23.7 | LT | 109+47 | 23.7 | LT | 109+70 | 49.4 | LT | 110+47 | 28.9 | RT | 110+40 | 31.0 | LT | 110+47 | 28.9 | RT | 110+40 | 31.0 | LT | 110+47 | 28.9 | RT | 111+83 | 34.6 | RT | 692.97 | 693.29 | 112+86 | 33.9 | RT | 112+86 | 33.9 | RT | 111+80 | 34.0 | RT | 117+40 | 34.0 | RT | 118+82 | 43.4 | LT | 118+85 | 38.3 | RT | 684.60 | 684.49 | 118+88 | 34.9 | RT | 119+94 | 39.6 | RT | 685.10 | 684.86 | 118+85 | 38.3 | RT | 684.60 | 684.49 | 118+88 | 34.9 | RT | 119+94 | 39.6 | RT | 684.60 | 684.49 | 118+88 | 34.9 | RT | 119+94 | 39.6 | RT | 684.60 | 684.49 | 118+88 | 34.9 | RT | 119+94 | 39.6 | RT | 684.60 | 684.49 | 118+88 | 34.9 | RT | 119+94 | 39.6 | RT | 684.60 | 684.49 | 118+88 | 34.9 | RT | 119+94 | 39.6 | RT | 684.60 | 684.49 | 118+88 | 34.9 | RT | 119+94 | 39.6 | RT | 684.60 | 684.49 | 118+88 | 34.9 | RT | 119+94 | 39.6 | RT | 684.60 | 684.49 | 118+88 | 34.9 | RT | 119+94 | 39.6 | RT | 684.60 | 684.49 | 118+88 | 34.9 | RT | 119+94 | 39.6 | RT | 684.60 | 684.4 STATION OFFSET (EACH) 60257900 4.8 1.55 51.6 17.59 157.5 4.4 0.1 0.66 50.9 81.8 14.86 24.67 6.88 36.8 21.44 56.0 2.6 0.43 5.5 1.27 5.0 22.0 74.6 10.86 0.5 0.06 70.4 20+01 41.5 LT
20+01 43.8 LT
20+01 43.8 LT
20+03 33.2 RT
20+03 33.2 RT
20+03 33.2 RT
120+79 42.3 LT
120+79 42.3 LT
121+31 33.4 LT
121+31 33.4 LT
121+32 38.7 RT 684.69 684.98
121+32 38.7 RT 685.46 685.10
121+55 39.2 LT
121+55 39.2 LT
121+57 38.8 LT
122+67 37.7 LT
122+67 31.9 RT
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122+67 37.7 LT 1.49 7.1 74.0 97.7 4.05 0.4 1 23.3 0.89 3.6 10.3 SUBTOTAL WOOD DALE ROAD 56 517 0 158 134 191 41 0 0 13 DIVISION STREET
200+37 25.4 LT
200+39 19.6 LT
200+39 19.6 LT
200+52 12.4 RT
201+93 22.0 LT
201+93 22.0 LT
201+93 22.0 LT
201+95 18.4 LT
201+96 11.9 RT
201+96 11.9 RT 4.58 21.7 0.65 3.8 32.5 4.72 148.08 153.3 0.22 1.3 4.17 28.4 SUBTOTAL DIVISION STREET 162 241 0 195 225 60 1770 85 160 570 20

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LOCATION					SANITARY MANHOLES TO BE ADJUSTED W/ NEV
STATION	OFF (FO				TYPE 1 FRAME, CLOSED LID (EACH) X6026056
IRVING PARK ROA	D				7,002,000
50+34	29.7	LT	679.43	680.09	1
52+65	30.7	LT	682.01	682.75	1
54+93	31.7	LT	686.40	686.90	1
68+56	42.3	LT	702.59	702.44	1
68+59	26.3	RT	702.49	702.83	1
68+61	41.1	RT	704.22	703.20	1
SUBTOTAL IRVING	PARK ROAD)		-200	6
WOOD DALE ROAD)		300 000 000		
103+26	8.4	LT	702.84	703.33	1
103+27	42.8	RT	703.62	703.42	1
106+28	8.2	LT	695.79	696.97	1
107+54	8.6	LT	693.67	694.15	1
111+82	0.6	RT	693.30	693.20	1
117+63	54.7	RT	685.65	685.75	1
117+81	35.9	LT	685.63	686.60	1
120+80	29.7	LT	684.20	684.61	1
SUBTOTAL WOOD D	ALE ROAD				8
DIVISION STREET	ī				
201+58	15.4	RT	700.42	701.27	1
203+50	15	RT	705.31	705.67	1
SUBTOTAL DIVISIO	N STREET				2
TOT	' 11		-		16


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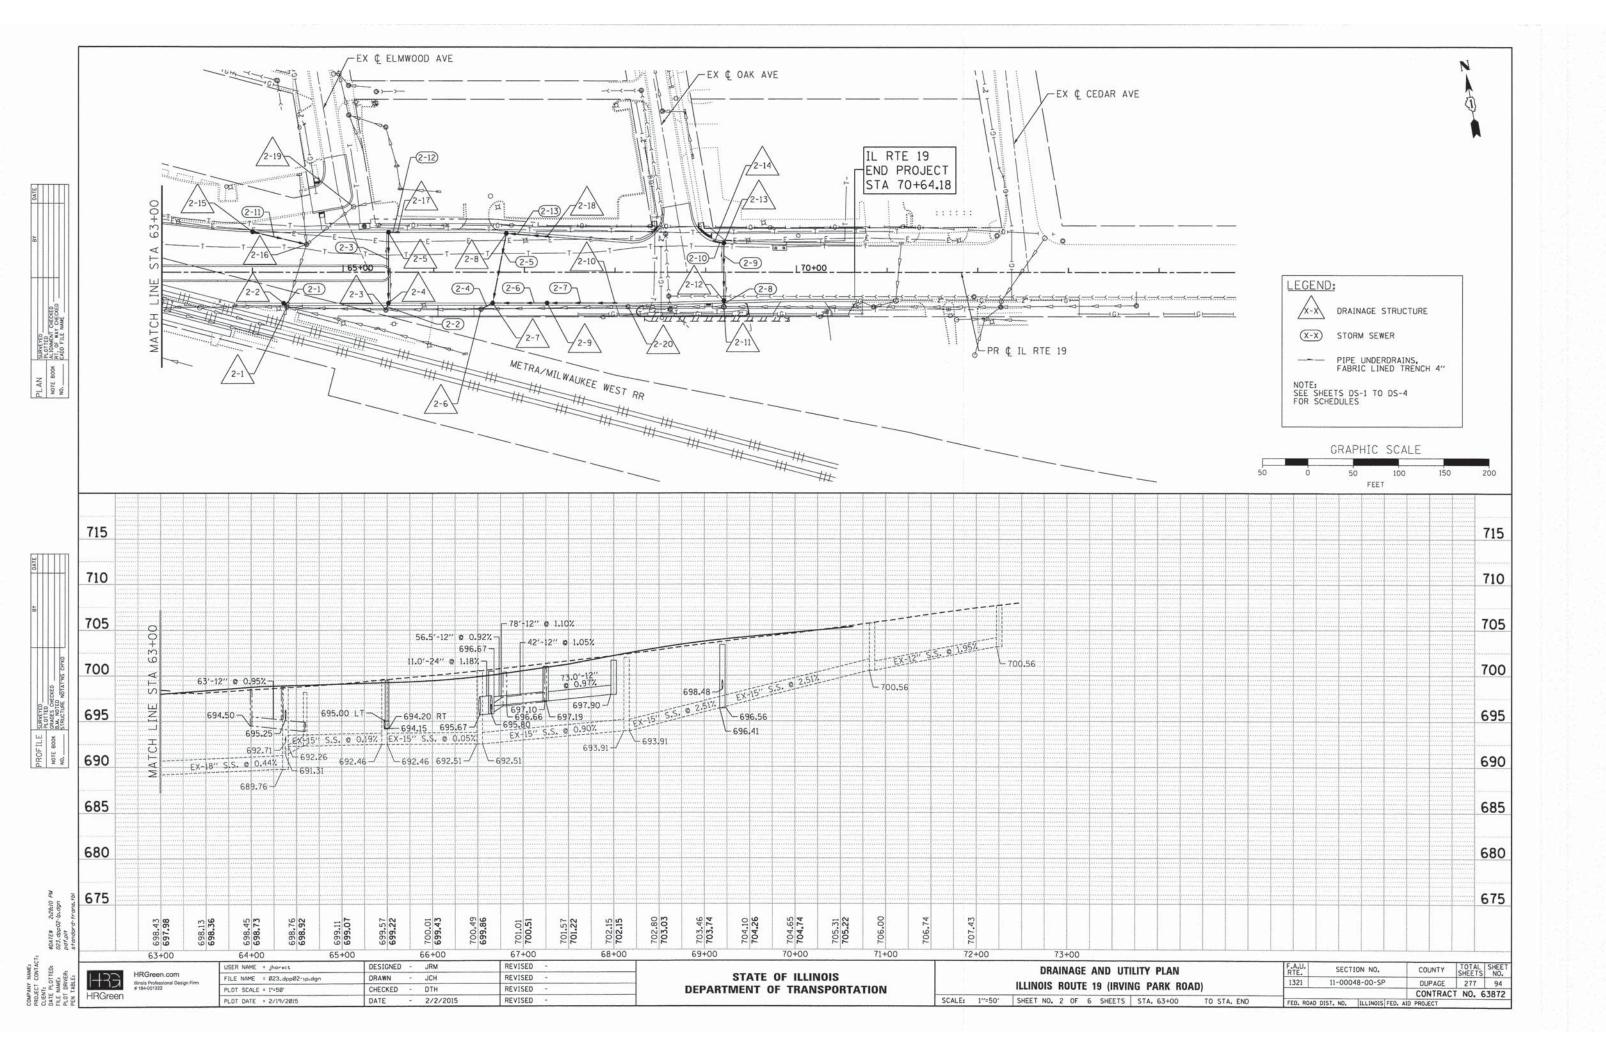
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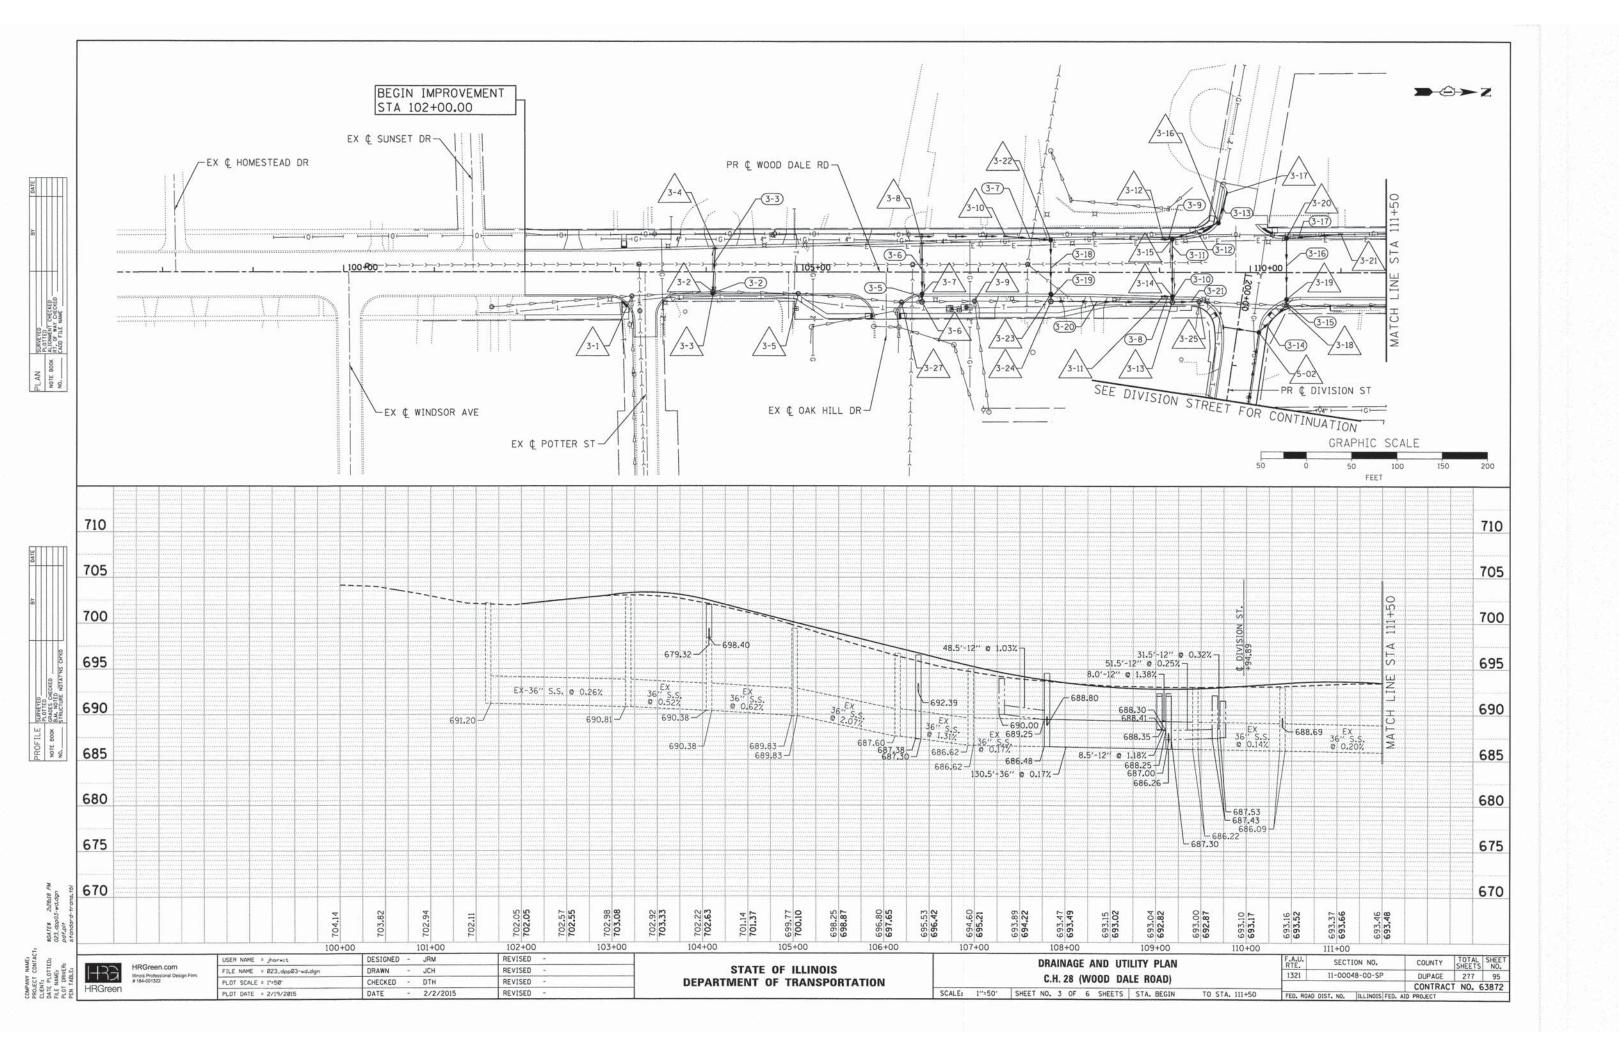
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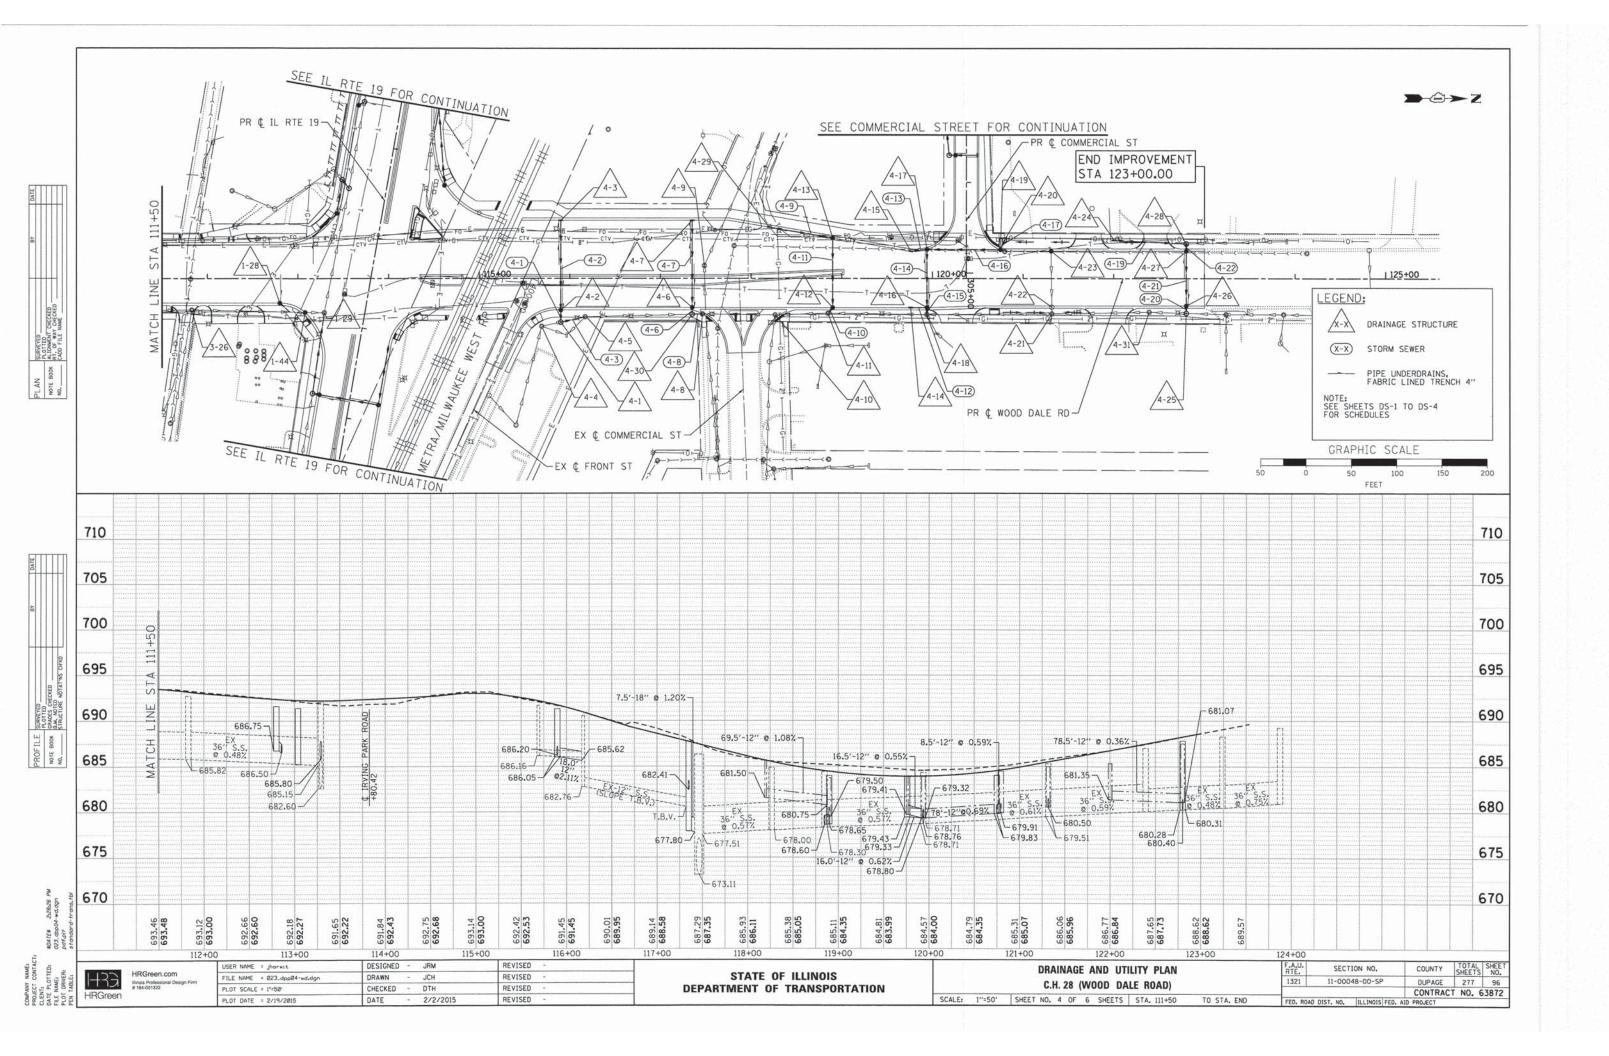
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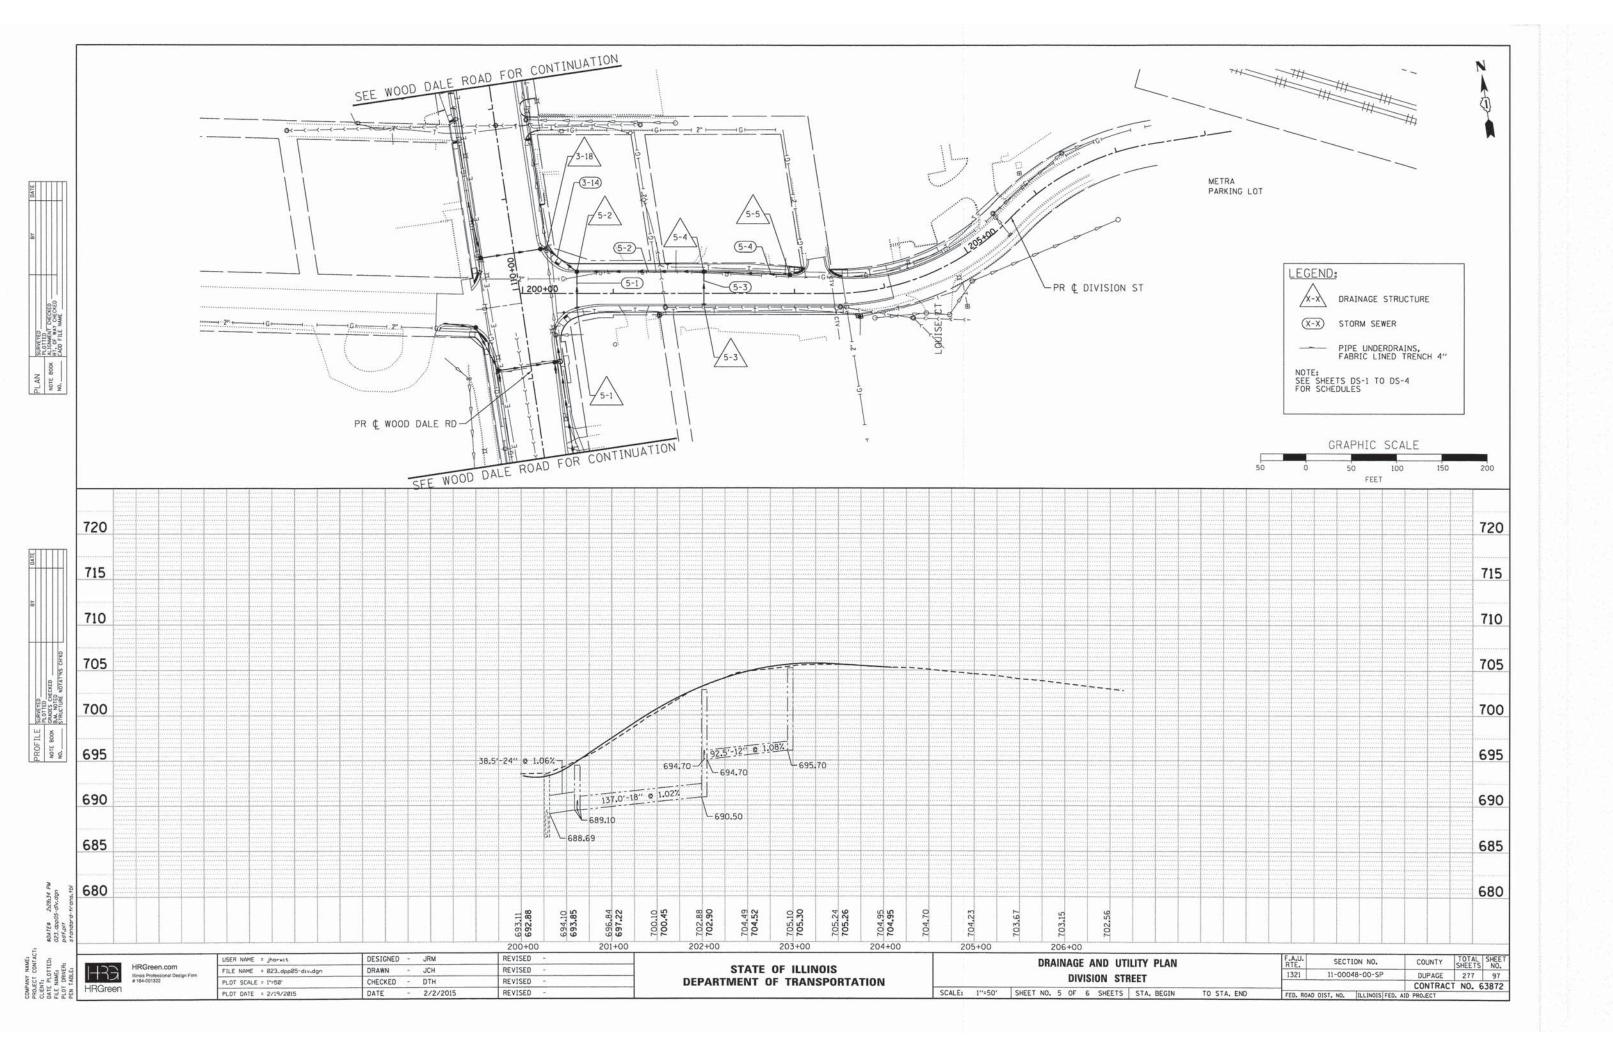
		EXISTI	NG	UTIL	ITIES A	ND DRAIN	AGE	F.A.U. RTE.	SECT	ION NO.	COUNTY	TOTAL	SHEET S NO.
			RF	MOV	AL SCH	FDIIIF		1321	11-000	48-00-SP	DUPAGE	277	92
	REMOVAL SCHEDULE										CONTRACT	NO.	63872
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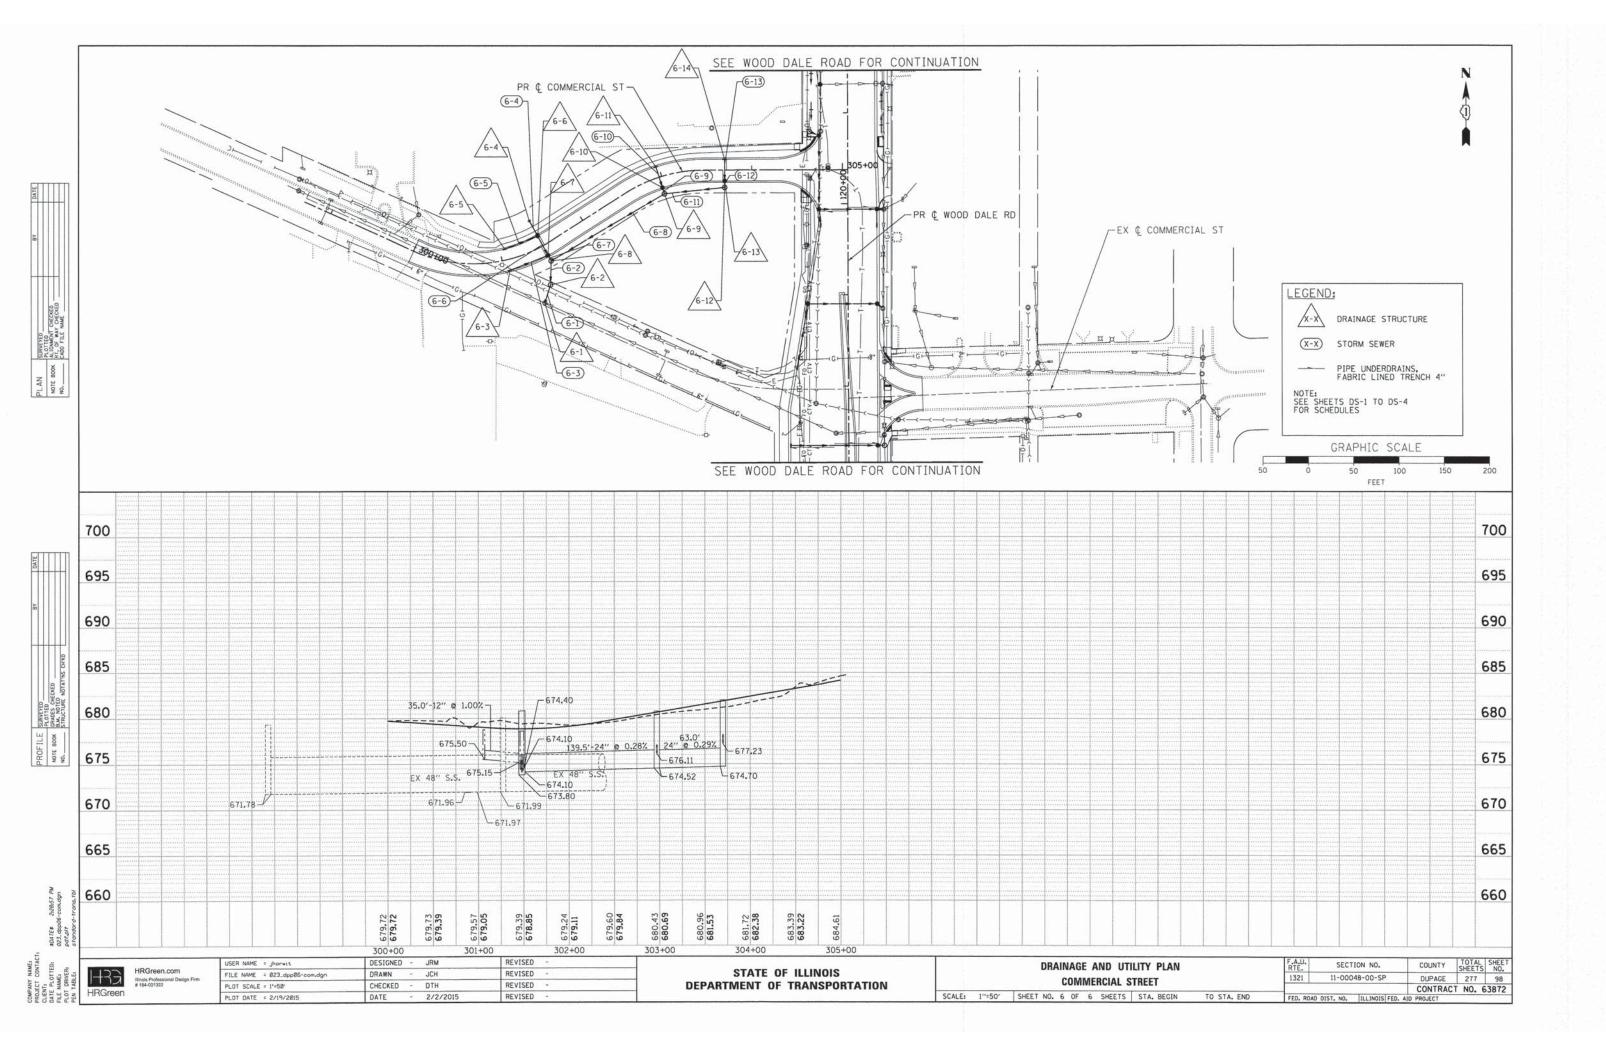










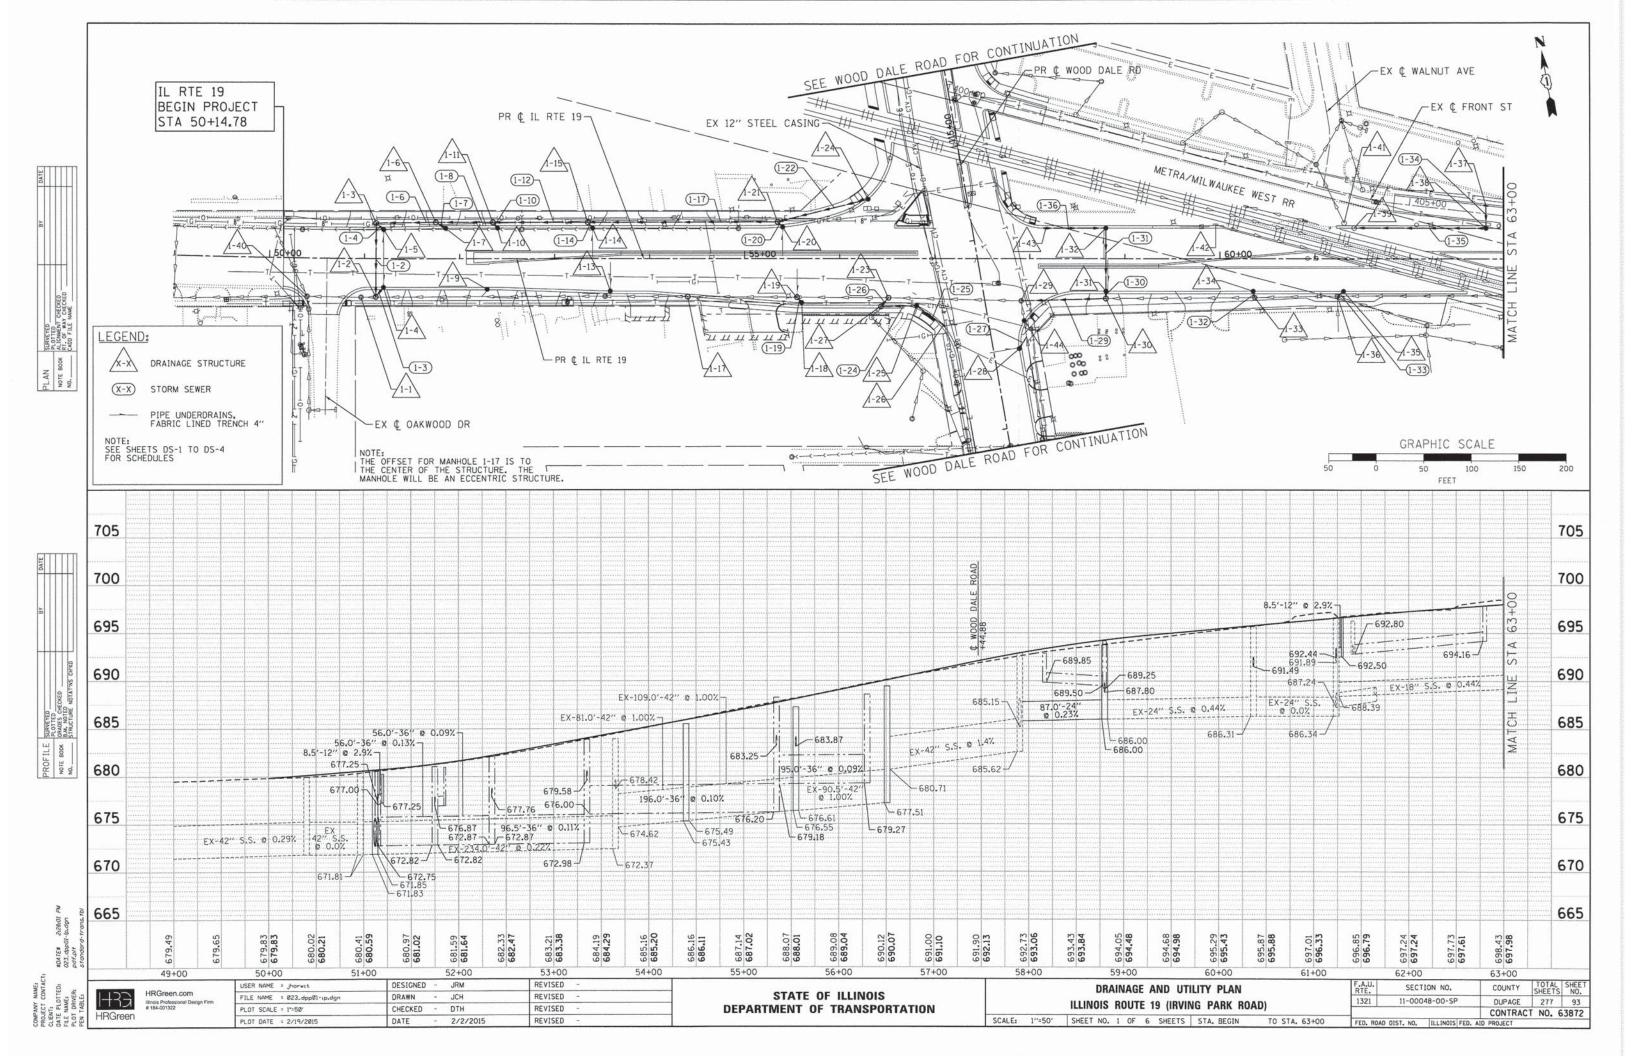

TRUCTURE	CTATION	OFFCET (FT)	STRUCTURE TYPE	FRAME &	RIM				STORM SEW	VER INVERTS					PIPE UNDERDE	RAIN INVERTS	£	RESTRICTOR	TOP PLATE
NUMBER	STATION	OFFSET (FT)	STRUCTURE TIPE	GRATE	ELEVATION	NORTH	NORTHWEST	WEST	SOUTHWEST	SOUTH	SOUTHEAST	EAST	NORTHEAST	NORTH	WEST	SOUTH	EAST	ELEVATION	ELEVATION
1-1	50+96.5	40.5' RT	MANHOLES TO BE RECONSTRUCTED	TYPE 1, CL	680.50			671.81-EX				671.81-EX							
1-2	51+12.0	40.0' RT	*MANHOLES, TYPE A, 9'-DIAMETER, RESTRICTOR PLATE	2 TYPE 1, CL	680.70	672.67		671.83-EX				671.85-EX	677.00					672.67	675.99
1-3	51+15.0	37.0' LT	MANHOLES, TYPE A, 6'-DIAMETER	TYPE 1, CL	680.68					672.75	677.25	672.75							
1-4	51+20.0	30.0' RT	CATCH BASINS, TYPE C	TYPE 24	680.19				677.25						678.14		678.14		
1-5	51+20.0	30.2' LT	CATCH BASINS, TYPE C	TYPE 24	680.21		677.30	161							678.18		678.18		
1-6	51+75.0	38.0' LT	MANHOLES, TYPE A, 6'-DIAMETER	TYPE 1, CL	681.33			672.82		676.87		672.82							
1-7	51+85.3	31.8' LT	CATCH BASINS, TYPE C	TYPE 24	680.96	676.96											ATTUS - IS		
1-9	52+29.0	30.0' RT	CATCH BASINS, TYPE A, 4'-DIAMETER	TYPE 24	681.59					674.74-EX									
1-10	52+40.0	32.0' LT	CATCH BASINS, TYPE C	TYPE 24	681.81	677.81													
1-11	52+35.0	38.0' LT	MANHOLES, TYPE A, 6'-DIAMETER	TYPE 1, CL	682.10			672.97		677.76		672.97							
1-13	53+58.5	33.8' RT	CATCH BASINS, TYPE C	TYPE 24	681.63			1	678.57-EX										
1-14	53+40.0	32.0' LT	CATCH BASINS, TYPE C	TYPE 24	683.63	679.63													
1-15	53+35.0	38.0' LT	MANHOLES, TYPE A, 6'-DIAMETER	TYPE 1, CL	684.00			673.08		679.58		676.00							
1-17	54+40.0	39.7' RT	MANHOLES, TYPE A, 6'-DIAMETER	TYPE 24	685.37			675.43-EX				675.49-EX			683.01		683.01		
1-18	55+60.0	46.0' RT	CATCH BASINS, TYPE C	TYPE 24	687.43		683.89												
1-19	55+55.0	40.4' RT	MANHOLES, TYPE A, 6'-DIAMETER	TYPE 1, CL	687.47			676.55-EX			683.87	676.61-EX							
1-20	55+40.0	33.0' LT	CATCH BASINS, TYPE C	TYPE 24	687.30	683.30									685.18		685.18		
1-21	55+34.6	38.4' LT	MANHOLES, TYPE A, 6'-DIAMETER	TYPE 1, CL	687.80			676.20		683.25		678.18							
1-23	56+51.0	41.0' RT	MANHOLES, TYPE A, 6'-DIAMETER	TYPE 1, CL	689.44			677.51-EX	687.41			680.71-EX						Lata .	
1-24	56+30.0	62.2' LT	CATCH BASINS, TYPE A, 5'-DIAMETER	TYPE 24	689.93			679.27											
1-25	56+80.9	49.2' RT	CATCH BASINS, TYPE A, 4'-DIAMETER	TYPE 24	690.10			687.60			687.60								
1-26	57+09.0	69.7′ RT	INLETS, TYPE A	TYPE 24	690.92		687.75								689.72		689.72		
1-27	56+43.25	50.0' RT	MANHOLES, TYPE A, 4'-DIAMETER	TYPE 1, CL	689.85				687.47-EX			687.45	687.45						
1-28	112+80.0	35.5' RT	CATCH BASINS, TYPE C	TYPE 24	691.83								686.75		689.16		689.16		
1-29	57+90.80	44.1' RT	MANHOLES TO BE RECONSTRUCTED	TYPE 1, CL	692.17			682.60-EX		685.15		685.80							
1-30	58+80.0	41.6' RT	MANHOLES, TYPE A, 5'-DIAMETER	TYPE 1, CL	694.31	688.80		686.00				686.00-EX							
1-31	58+80.0	34.0' RT	CATCH BASINS, TYPE A, 4'-DIAMETER	TYPE 24	693.76	688.84				689.74					691.64		691.64		
1-32	58+80.0	32.0' LT	CATCH BASINS, TYPE A, 4'-DIAMETER	TYPE 24	693.76		689.50			689.25					692.04		692.04		
1-33	60+36.6	40.7' RT	MANHOLES TO BE ADJUSTED	TYPE 1, CL	696.20	691.49		686.31-EX				686.31-EX							
1-34	60+35.0	34.0' RT	CATCH BASINS, TYPE C	TYPE 24	695.27					691.52									
1-35	61+30.0	34.0' RT	CATCH BASINS, TYPE C	TYPE 24	696.13				692.50										
1-36	61+23.6	39.0' RT	MANHOLES TO BE ADJUSTED	TYPE 1, CL	696.68			686.34-EX	691.49-EX	687.24-EX		688.39-EX	692.44						
1-37	62+80.0	55.5' LT	INLETS, TYPE A	TYPE 24	697.34		-			694.37									
1-38	62+80.0	32.0' LT	CATCH BASINS, TYPE A, 4'-DIAMETER	TYPE 24	697.36	694.16		694.16											
1-39	61+41.3	32.2' LT	CATCH BASINS TO BE RECONSTRUCTED w/ NEW TYPE 24 F&G	TYPE 24	696.25		692.80-EX	071 01 511			692.80-EX								
1-40	50+40.0	40.0' RT	MANHOLES TO BE ADJUSTED	TYPE 1, CL	679.45	672.76-EX		671.81-EX		672.61-EX		671.81-EX							-
1-41	61+30.7	37.3' LT	MANHOLES TO BE ADJUSTED	TYPE 1, OL	696.35		690.69-EX	-			692.59-EX								-
1-42	59+95.5	35.3' LT	INLETS TO BE ADJUSTED	TYPE 24	694.49		-			-	693.19-EX	-	-						
1-43	58+16.8	32.0' LT	INLETS, TYPE A	TYPE 24	692.86	COE OF EV	-			505 01 54	689.85		-						
1-44	113+08.0	37.2' RT	MANHOLES, TYPE A, 6'-DIAMETER	TYPE 24	691.07	685.25-EX	COE OF	C00 7C FV		685.21-EX		C00 00 EV	-					_	-
2-1	64+34.4	34.0' RT	MANHOLES TO BE ADJUSTED	TYPE 1, CL	698.80	691.31-EX	695.25	689.76-EX	-	693.81-EX	COE 70	692.26-EX	-		505.50		505.50		-
2-2	64+34.4	34.0' RT	CATCH BASINS TO BE RECONSTRUCTED W/ NEW TYPE 24 F&C	TYPE 24	698.40 699.40	694.15		693.01-EX		-	695.30	693.01-EX			696.50		696.50	-	
2-3	65+47.2	41.8' RT		TYPE 24	698.75	694.20	-	693.01-EX		694.20		693.01-EX			+	 	-		
2-4	65+50.0	34.0' RT	CATCH BASINS, TYPE A, 4'-DIAMETER	TYPE 24	698.45	634,20	_			695.00		695.00			697.08	-	607.00		
2-5	65+50.0	44.0' LT	INLETS, TYPE A	TYPE 1, CL	700.10		 	692.51-EX		693.00		692.51-EX	695.67		691.08		697.08	-	
2-6	66+52.2	40.8' RT	MANHOLES TO BE ADJUSTED	TYPE 24	699.36	695.80		632.31-EA	695.80			696.67	633.61		-			+	
2-7	66+65.0	34.0' RT	CATCH BASINS, TYPE A, 5'-DIAMETER	TYPE 24	699.32	033.00	-		033.00	696.66		696.66						-	
2-8	66+80.0	42.8' LT	CATCH BASINS, TYPE A, 4'-DIAMETER CATCH BASINS, TYPE C	TYPE 24	700.19		1070	697.19		030.00		697.19			-		-	+	+
2-9	67+25.0	34.0' RT	INLETS, TYPE A	TYPE 24	701.47	100 100 100 100 100	-	697.90			-	037.13							1
2-10	68+00.0	34.0' RT 38.1' RT	MANHOLES, TYPE A, 5'-DIAMETER	TYPE 1, CL	704.13	698.48		696.41-EX				696.56-EX						+	+
2-11	69+20.0	31.6' RT	CATCH BASINS, TYPE A, 4'-DIAMETER	TYPE 24	703.10	698.51		030.11 LA		698.51		030.30 EX			700.98		700.98	+	
2-12	69+20.0		CATCH BASINS, TYPE A, 4'-DIAMETER	TYPE 24	703.33	030131	699.11			699.11		+	1		700.99		700.99	+	
2-13	69+20.0	32.1' LT		TYPE 24	703.16	-	033,11			333.11	699.19	-			100.33		100.33		
2-14	69+10.0	34.1' LT	INLETS, TYPE A	TYPE 24	697.94		-			1	694.50	-							
2-15	64+00.0	44.4' LT	CATCH BASINS, TYPE C	TYPE 1, CL	698.48	692.35-EX	693.90			692.35-EX	034.30	-	692.35-EX						1
2-16	64+59.6	30.7' LT	MANHOLES TO BE ADJUSTED	TYPE 24	698.47	032.33-EX	333,30	695.10		032.33-EA			032.33-EX				-		
2-17	65+60.0	44.0′ LT	INLETS, TYPE A	TYPE 24	700.04			696.75							-			+	
0 10	67+25.0	39.3' LT	INLETS, TYPE A					030.13			-	-							
2-18	65+11.5	71.8' LT	CATCH BASINS TO BE ADJUSTED WITH NEW TYPE 1 FRAME, OPEN LID	TYPE 1. OL	696.00														

^{*} ORIFICE SIZE IS 18". THE 42" STORM SEWER IS NOT TO BE DETAINED.

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USER NAME = jhorwit	DESIGNED - JRM	REVISED -
FILE NAME = 023_dSch.dgn	DRAWN -	REVISED -
PLOT SCALE = N.T.S.	CHECKED - DTH	REVISED -
PLOT DATE = 2/19/2015	DATE - 2/2/2015	REVISED -

DRAINAGE AND UTILITY						SECTION NO.	COUNTY	TOTAL	SHEET NO.
		STRUCTURE SCH	1321	11-00048-00-SP	DUPAGE	277	99		
	minaned						CONTRACT	NO. (63872
SCALE:	N.T.S.	SHEET NO.DS-1 OF DS-4 SHEETS	STA.	TO STA.	FED. ROAD	DIST. NO. ILLINOIS FED.	AID PROJECT		

TRUCTURE	STATION	OFFSET (FT)	STRUCTURE TYPE	FRAME &	RIM								PIPE UNDERDE			RESTRICTOR			
NUMBER	3141104	0.1321117	Jillottone Title	GRATE	ELEVATION	NORTH	NORTHWEST	WEST	SOUTHWEST		SOUTHEAST	EAST	NORTHEAST	NORTH	WEST	SOUTH	EAST	ELEVATION	ELEVATI
3-1	103+18.0	26.5′ RT	MANHOLES TO BE ADJUSTED	TYPE 1, CL	702.75	690.81				690.81-EX		696.26-EX							
3-2	104+07.1	21.8' RT	MANHOLES TO BE ADJUSTED	TYPE 1, CL	701.97	690.38-EX		697.58		690.38-EX		698.35		699.76		699.76			
3-3	104+07.1	24.0' RT	CATCH BASINS, TYPE C	TYPE 11	701.96			698.40				697.58							
3-4	104+10.0	25.7′ LT	INLETS, TYPE A	TYPE 24	701.87							698.08		699.77		699.77			
3-5	105+01.6	23.9' RT	MANHOLES TO BE ADJUSTED WITH NEW TYPE 24 FRAME AND GRATE	TYPE 24	699.69	689.83-EX				689.83-EX									
3-6	106+38.0	32.7′ RT	MANHOLES, TYPE A, 6'-DIAMETER	TYPE 1, CL	696.50	687.30-EX		692.39		687.38-EX									
3-7	106+38.0	24.0' RT	CATCH BASINS, TYPE D, 4'-DIAMETER	TYPE 24	696.23			692.44				692.44							
3-8	106+38.0	31.4' LT	INLETS, TYPE A	TYPE 24	696,09							692.94							
3-9	106+95.8	31.8' RT	MANHOLES TO BE ADJUSTED	TYPE 1, CL	696.88	686.62-EX				686.62-EX		690.92-EX							
3-10	107+30.0	39.0' LT	INLETS, TYPE A	TYPE 8 GRATE	693.95	689.95													
3-11	109+04.0	26.3' RT	INLETS, TYPE A	TYPE 24	692.29	688.35										689.93			
3-12	109+04.0	36.0' LT	INLETS, TYPE A	SPECIAL	692.09	688.41										690.21			
3-13	109+14.0	32.6' RT	MANHOLES, TYPE A, 6'-DIAMETER	TYPE 1, CL	692.28	686.26-EX		686.97		686.26									
3-14	109+14.0	26.6' RT	CATCH BASINS, TYPE D, 4'-DIAMETER	TYPE 24	692.04			687.00		688.25		687.00		689.92					
3-15	109+14.0	36.0' LT	CATCH BASINS, TYPE A, 5'-DIAMETER	SPECIAL	692.09		687.30			688.30		687.30		690.21					
3-16	109+65.0	53.8' LT	CATCH BASINS, TYPE D, 4'-DIAMETER	TYPE 24	692.11		687.43				687.43								
3-17	109+74.0	85.9' LT	INLETS, TYPE A	TYPE 24	691.53						687.53								
3-18	110+39.6	36.0' RT	MANHOLES TO BE RECONSTRUCTED	TYPE 1, CL	693.05	686.09-EX		688.69		686.09-EX	689.80								
3-19	110+40.0	29.4' RT	CATCH BASINS, TYPE D, 4'-DIAMETER	TYPE 24	692.86		7	688.74				688.74							
3-20	110+40.0	37.0' LT	CATCH BASINS, TYPE D, 4'-DIAMETER	TYPE 24	692.71		689.44					689.44							-
3-21	111+00.0	41.7' LT	INLETS, TYPE A	TYPE 8 GRATE							689.69								
3-22	107+80.0	34.9' LT	CATCH BASINS, TYPE A, 4'-DIAMETER	TYPE 24	693.05					689.45		689.45						-	
3-23	107+80.0	24.0' RT	CATCH BASINS, TYPE A, 4'-DIAMETER	TYPE 24	693.27			688.80				688,80							
3-24	107+80.0	31.9' RT	MANHOLES, TYPE A, 6'-DIAMETER	TYPE 1, CL	693.95	686.48		688.75		686.48-EX		000100	-						-
3-25	109+43.5	32.1' RT	MANHOLES TO BE RECONSTRUCTED	TYPE 1, CL	693.42	686.22-EX		000175		686.22-EX		689.12-EX						-	
3-26	111+82.8	34.6' RT	MANHOLES TO BE ADJUSTED	TYPE 1, CL	692.88	685.82-EX				685.82-EX		687.97-EX	-						-
3-26	106+15.2	33.0' RT	MANHOLES TO BE ADJUSTED WITH NEW TYPE 1 FRAME, OPEN LID	TYPE 1. OL	696.50	687.60-EX	-	690.85-EX		687.60-EX	688.30-EX	001.31-EA							-
4-1	115+90.0	48.0' RT	MANHOLES, TYPE A, 4'-DIAMETER	TYPE 8 GRATE		686.00		686.20		686.05-EX	000.30 EX								-
				TYPE 24	691.23	000.00		686.35		606,03-EA		686.35		689.50	-				
4-2	115+90.0	32.0' RT	CATCH BASINS, TYPE D, 4'-DIAMETER	TYPE 24	690.63			666.33				687.45		688.96	_	688.96			
4-3	115+90.0	64.0' LT	INLETS, TYPE A	TYPE 1, CL	691.29-EX		686.16-EX					686.16-EX	686.16-EX	600*36	-	600.36			-
4-4	115+69.0	52.4' RT	MANHOLES TO BE ADJUSTED		690.56-EX	692 76-EV	000.10 EX	-	COE OC EV	COE C2		600.16 EA	906.16-EX						-
4-5	116+17.0	42.1' RT	MANHOLES TO BE ADJUSTED	TYPE 1, CL		682.76-EX		C02 C7	685.96-EX	685.62	-	500.67							
4-6	117+35.0	32.0' RT	CATCH BASINS, TYPE D. 4'-DIAMETER	TYPE 24	687.24			682.67				682.67			-				-
4-7	117+35.0	64.0' LT	INLETS, TYPE A	TYPE 24	686.64	677.51		677.11	600.71	677.00	-	683,26							
4-8	117+46.4	39.1' RT	MANHOLES TO BE ADJUSTED (6' X 10' RECTANGULAR STRUCTURE)	TYPE 1, CL	687.10	677.51		673.11	682.31	677.80	-	673.11-EX							-
4-9	117+48.5	14.0′ LT	MANHOLES TO BE ADJUSTED	TYPE 1, CL	687.42	670.00 511				670.00		672.90							
4-10	118+26.5	40.0' RT	MANHOLES TO BE ADJUSTED	TYPE 1, CL	684.86	678.00-EX	670.70	-	-	678.00	-	678.55-EX							_
4-11	118+84.8	38.3′ RT	MANHOLES TO BE ADJUSTED	TYPE 1, CL	684.84	678.30-EX	678.30			678.30-EX									-
4-12	118+90.0	32.0′ RT	CATCH BASINS, TYPE D. 4'-DIAMETER	TYPE 24	683.97			678.65			678.35								
4-13	118+90.0	44.5' LT	CATCH BASINS, TYPE D, 4'-DIAMETER	TYPE 24	683.73	670 17		-	-	680.75		679.50							-
4-14	119+76.0	32.0' RT	INLETS, TYPE A	SPECIAL	683.32	679.43					-					681.31			
4-15	119+76.0	30.0' LT	INLETS, TYPE A	SPECIAL	683.37	679.41			4							681.29			
4-16	119+94.0	32.0′ RT	CATCH BASINS, TYPE D, 4'-DIAMETER	TYPE 24	683.92			678.90		679.33			678.90	681.30					
4-17	119+94.0	31.9′ LT	CATCH BASINS, TYPE A, 5'-DIAMETER	SPECIAL	683.88	679.32				679.32		679.32		681.30					
4-18	119+93.8	39.6' RT		TYPE 1, CL	684.32	678.71-EX			678.76	678.71-EX									
4-19	120+75.0	31.6′ LT	CATCH BASINS, TYPE D, 4'-DIAMETER	TYPE 24	683.91			679.86		679.86									
4-20	120+79.4	42.3' LT	MANHOLES, TYPE A, 4'-DIAMETER	TYPE 8 GRATE	684.48	681.80-EX						679.91							
4-21	121+31.8	38.7' RT	MANHOLES TO BE ADJUSTED	TYPE 1, CL	685.24	679.51-EX		680.50		679.51-EX		679.51-EX							
4-22	121+31.7	30.0' RT	CATCH BASINS TO BE RECONSTRUCTED w/ NEW TYPE 24 F&G	TYPE 24	684.86			680.56-EX				680.56							
4-23	121+30.9	30.0' LT	CATCH BASINS, TYPE D, 4'-DIAMETER	TYPE 24	684.84							681.57							
4-24	122+00.0	41.9' LT	INLETS, TYPE A	TYPE 8 GRATE	685.35	681.50													
4-25	122+80.0	38.1' RT	MANHOLES, TYPE A, 5'-DIAMETER	TYPE 1, CL	686.25	680.31-EX		680.40		680.28-EX									
4-26	122+80.0	30.0' RT	CATCH BASINS, TYPE D, 4'-DIAMETER	TYPE 24	687.35			680.45				680.45		685.35		685.35			
4-27	122+80.0	30.0' LT	CATCH BASINS, TYPE D. 4'-DIAMETER	TYPE 24	687.35			681.02				681.02		685.35		685.35			
4-28	122+80.0	38.0' LT	CATCH BASINS, TYPE A, 4'-DIAMETER	TYPE 1, OL	687.51	683.98-EX				681.07		681.07							
4-29	118+20.0	56.4' LT	INLETS, TYPE A	TYPE 24	684.75	681.50													
4-30	117+35.0	39.4' RT	MANHOLES, TYPE A, 5'-DIAMETER	TYPE 1, CL	687.68	677.89		682.62		677.89									
4-31	122+39.1	36.9' RT	MANHOLES TO BE ADJUSTED	TYPE 1, CL	687.06	680.11-EX	682.41-EX			680.11-EX									
5-1	200+60.0		INLETS, TYPE A	TYPE 24	694.21	691.10											692.09		
	200+60.0			TYPE 24	694.04		690.00			690.90		690.90					691.92		
5-7	20010010		INLETS, TYPE A	TYPE 24	702.66	695.20											001102		
5-2	202+00.0				100000000000000000000000000000000000000			4				L.						1	1
5-2 5-3 5-4	202+00.0		CATCH BASINS, TYPE A, 4'-DIAMETER	TYPE 24	702.42	100		692.30		694.70		694.70							

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ROJECT CONTACT:
LERVI: \$0
ATE PLOTTED: \$0
LLE NAME: 02
LOT DRIVER: po

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Illinois Professional Design File
184-001322

 USER NAME = Jhorwit
 DESIGNED - JRM
 REVISED

 FILE NAME = 823.dSch.dgn
 DRAWN - REVISED

 PLOT SCALE = N.T.S.
 CHECKED - DTH REVISED

 PLOT DATE = 2/19/2015
 DATE - 2/2/2015 REVISED

STATE OF ILLINOIS
DEPARTMENT OF TRANSPORTATION

		DRAINAGE AND UTILITY
		STRUCTURE SCHEDULES
CONF.	NTC	CUEET NO DE OOF DE A CUEETE CATA