PROJECT LOCATED IN UNINCORPORATED LAKE COUNTY

FOR INDEX OF SHEETS, SEE SHEET NO. 2

JUST EAST OF THE VILLAGE OF VOLO

TRAFFIC DATA POSTED SPEED: 55 MPH **DESIGN SPEED: 60 MPH** 

**FUNCTIONAL CLASSIFICATION:** OTHER PRINCIPAL ARTERIAL ADT = 9,100 (2013)

STATE OF ILLINOIS

DEPARTMENT OF TRANSPORTATION


**DIVISION OF HIGHWAYS** 

# **PROPOSED** HIGHWAY PLANS

FAP ROUTE 535 (IL 60) OVER DITCH (0.5 MILES WEST OF WILSON ROAD) **SECTION 2014-084B CULVERT REPAIR** LAKE COUNTY C-91-133-15

T. 44 N.

# PROJECT LOCATION STRUCTURE NO. 049-0569

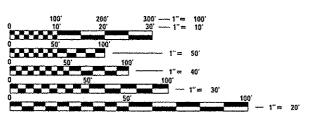

ENGINEERING SCALES. REDUCED SIZED PLANS WILL NOT CONFORM TO STANDARD SCALES, IN MAKING MEASUREMENTS ON REDUCED PLANS, THE ABOVE SCALES MAY BE USED.

**CONTRACT NO. 62A32** 

JOINT UTILITY LOCATION INFORMATION FOR EXCAVATION 1-800-892-0123

PROJECT MANAGER: ISSAM RAYYAN, P.E. (847) 705-4178 PROJECT ENGINEER: ROBERT T. BORO, P.E. (847) 705-4237

GROSS LENGTH = 38 FT. = 0.007 MILE NET LENGTH = 38 FT. = 0.007 MILE

**LOCATION MAP** 



LICENSED PROFESSIONAL ENGINEER
ILLINOIS NO. 062-047537 EXPIRES 11-30-15



## D-91-133-15

2014-0848

LAKE



STATE OF ILLINOIS DEPARTMENT OF TRANSPORTATION

PRINTED BY THE AUTHORITY OF THE STATE OF ILLINOIS

 $\circ$ 

0

#### INDEX OF SHEETS

SHEET NO.	DESCRIPTION
1	COVER SHEET
2	INDEX OF SHEETS, STATE STANDARDS AND GENERAL NOTES
3 - 5	SUMMARY OF QUANTITIES
6	TYPICAL SECTIONS
7	IL 60 PLAN & PAVEMENT MARKINGS
8	TRAFFIC CONTROL DETOUR PLAN
9	GENERAL PLAN AND ELEVATION
10 - 11	BOX CULVERT REPAIR DETAILS
12	EXISTING CULVERT PLANS
13	TRAFFIC CONTROL AND PROTECTION FOR SIDE ROAD, INTERSECTION AND DRIVEWAYS (TC-10)
14	TYPICAL APPLICATIONS: RAISED REFLECTIVE PAVEMENT MARKERS (SNOW-PLOW RESISTANT) (TC-11)
15	DISTRICT ONE TYPICAL PAVEMENT MARKINGS (TC-13)
16	DETOUR SIGNING FOR CLOSING STATE HIGHWAYS (TC-21)

#### STATE STANDARDS

000001-06	STANDARD SYMBOLS, ABBREVIATIONS AND PATTERNS
001001-02	AREAS OF REINFORCEMENT BARS
442201-03	CLASS C AND D PATCHES
701001-02	OFF-RD OPERATIONS, 2L, 2W, MORE THAN 15' AWAY
701006-05	OFF-RO OPERATIONS, 2L, 2W, 15' TO 24" FROM PAVEMENT EDGE
701011-04	OFF-RD MOVING OPERATIONS, ZL, ZW, DAY ONLY
701201-04	LANE CLOSURE, 2L, 2W, DAY ONLY, FOR SPEEDS >= 45 MPH
701301-04	LANE CLOSURE, 2L, 2W, SHORT TIME OPERATIONS
701306-03	LANE CLOSURE, 2L, 2W, SLOW MOVING OPERATIONS DAY ONLY, FOR SPEEDS >= 45 MPH
701311-03	LANE CLOSURE, 2L, 2W, MOVING OPERATIONS - DAY ONLY
701901-04	TRAFFIC CONTROL DEVICES
780001-05	TYPICAL PAVEMENT MARKINGS
781001-03	TYPICAL APPLICATIONS RAISED REFLECTIVE PAVEMENT MARKERS

#### GENERAL NOTES

- BEFORE STARTING ANY EXCAVATION, THE CONTRACTOR SHALL CALL "JULIE" AT (800) 892-0123
  FOR FIELD LOCATIONS OF BURIED ELECTRIC, TELEPHONE AND GAS FACILITIES. 48-HOUR
  NOTIFICATION IS REQUIRED.
- THE CONTRACTOR WILL NOT BE ALLOWED TO SET UP A YARD OR FIELD OFFICE ON STATE PROPERTY WITHOUT WRITTEN PERMISSION FROM THE DEPARTMENT.
- ALL DAMAGE TO EXISTING PAVEMENT MARKINGS OR RAISED REFLECTIVE PAVEMENT MARKERS OUTSIDE THE REMOVAL LINE SHOWN ON THE PLANS SHALL BE REPLACED AT THE CONTRACTOR'S EXPENSE.
- 4. BEFORE STARTING ANY WORK, THE CONTRACTOR SHALL OBTAIN AND RECORD FOR FUTURE REFERENCE, ALL EXISTING PAVEMENT MARKING LINES AND RAISED REFLECTIVE MARKERS IN ORDER THAT THESE LOCATIONS CAN BE RE-ESTABLISHED FOR STRIPING. EXACT LOCATIONS OF ALL PAVEMENT MARKINGS SHALL BE AS DIRECTED BY THE ENGINEER.
- IT SHALL BE THE CONTRACTOR'S RESPONSIBILITY TO VERIFY ALL DIMENSIONS AND CONDITIONS IN THE FIELD PRIOR TO CONSTRUCTION AND ORDERING OF MATERIALS,
- 6. DO NOT SCALE PLANS FOR CONSTRUCTION DIMENSIONS.
- 7. PLAN DIMENSIONS AND DETAILS RELATIVE TO THE EXISTING STRUCTURE HAVE BEEN TAKEN FROM EXISTING PLANS AND ARE SUBJECT TO NOMINAL CONSTRUCTION VARIATIONS. IT SHALL BE THE CONTRACTOR'S RESPONSIBILITY TO VERIFY SUCH DIMENSIONS AND DETAILS IN THE FIELD AND MAKE NECESSARY APPROVED ADJUSTMENTS PRIOR TO CONSTRUCTION AND ORDERING OF MATERIALS. SUCH VARIATIONS SHALL NOT BE CAUSE FOR ADDITIONAL COMPENSATION FOR A CHANGE IN SCOPE OF WORK, HOWEVER, THE CONTRACTOR WILL BE PAID FOR THE QUANTITY ACTUALLY FURNISHED AT THE UNIT PRICE BID FOR THE WORK.
- 8, THE CONTRACTOR SHALL CONTACT THE DISTRICT ONE TRAFFIC CONTROL SUPERVISOR AT (847) TO5-44TO A MINIMUM OF 72 HOURS IN ADVANCE OF BEGINNING OF WORK.
- 9. THE RESIDENT ENGINEER SHALL CONTACT WALTER CZARNY, THE AREA TRAFFIC FIELD ENGINEER, AT (847) 438-2300 A MINIMUM OF TWO (2) WEEKS PRIOR TO PLACEMENT OF PERMANENT PAVEMENT MARKINGS.
- 10. THE CONTRACTOR SHALL DIVERT WATER FROM THE WORK AREAS IF NECESSARY BY A METHOD APPROVED BY THE ENGINEER. THIS WORK IS INCIDENTAL TO THE CONTRACT AND WILL NOT BE PAID FOR SEPARATELY.
- 11. ALL EXCAVATED SOILS FROM THE PROJECT SITE SHALL BE RE-USED AS FILL OR TOPSOIL AT THE PROJECT SITE. NO EXCAVATED SOILS FROM THE PROJECT SITE MAY BE DISPOSED OF AT ANY OFFSITE LOCATION.
- 12. THE DEPARTMENT HAS DETERMINED THAT IN STREAM WORK IS NOT REQUIRED FOR THE WORK SPECIFIED IN THIS CONTRACT.
  THE DEPARTMENT HAS NOT OBTAINED A 404 PERMIT. IF THE CONTRACTOR CHOOSES TO USE ACTIVITIES REQUIRING AN USACE
  404 PERMIT. IT IS THE CONTRACTOR'S RESPONSIBILITY TO SECURE THE PROPER USACE PERMITS.
- 13. GUARDRAIL INSTALLATION SHALL BE COMPLETED PRIOR TO OPENING THE ROAD TO TRAFFIC.

773	TERRA	Ü
	ENGINEERING LTD.	P

user name : Kyloc	DESIGNED	~	KJC	REVISED	*	Г
	ORAWN	~	KJE	REVISED	-	
PLOT SCALE * NTS	CHECKED	-	ĹVÁ	REVISED	-	
PLDT 0ATE > 2/17/2015	DATE	-	02/17/15	HEVISED	~	

STATE OF ILLINOIS
DEPARTMENT OF TRANSPORTATION

IL 60 OVER	DITCH CULVERT	REPAIR (0.5	MI WEST	OF WILSON RD)
INDEX O	F SHEETS, STAT	E STANDARDS	AND GEN	IERAL NOTES

TO STA.

SHEET 1 OF 1 SHEETS STA.

SCALE: NTS

F,A.P. RTE.	SECTION	COUNTY	TOTAL SHEETS	SHE
535	2014-084B	LAKE	16	7
		CONTRACT	NO. 62	A 32
	ILLINDIS FED. AL	D PROJECT		

Sheets \OlliceR-eht-500.dgn
841 Design Civil NCADO
62-154-1
Repair
(EB3

					LIRBAN	100% STATE
						ROADWAY
					TOTAL	0040
P	SI	CODE NO.	!TEM	UNIT	QUANTITY	
	ALE	20101100	TREE TRUNK PROTECTION	EACH	3	3
	-					
		20101400	NITROGEN FERTILIZER NUTRIENT	POUNO	1	1
		20101500	PHOSPHORUS FERTILIZER NUTRIENT	POUND	1	1
_						
_		20101600	POTASSIUM FERTILIZER NUTRIENT	POUND	1	Ĭ.
	-	21101625	TOPSOIL FURNISH AND PLACE, 6"	\$0 YD	15	15
		25000210	SEEDING, CLASS 2A	ACRE	0.01	0.01
		25100115	MULCH, METHOD 2	ACRE	0.01	0.01
		28000400	PERIMETER EROSION BARRIER	· F00T	58	58
		28200200	FILTER FABRIC	SO YD	6	6
•		40600275	BITUMINOUS MATERIALS (PRIME COAT)	POUND	5	5
		44201741	CLASS D PATCHES, TYPE II. 8 INCH	SO YD	6	6
	ļ	48101202	AGGRECATE SHOULDERS, TYPE B	CU YD	0.5	0.5
		50102400	CONCRETE REMOVAL	CU YO	5. 0	5.0
	ļ	50200100	STRUCTURE EXCAVATION	CU YD	51	51
	<u></u>	19				

X SPECIALTY ITEM
• SPECIAL PROVISION ITEM

	USER NAME = KuloC	DESTONED	-	KJC	REVISED -	 
RA	· · · · · · · · · · · · · · · · · · ·	DRAWN	-	KJC	REVISED -	 _
KING LID. I	PLOT SCALE . NTS	CHECKED	-	LVA	REVISED -	 _
	PLOT DATE * 2/17/2015	DATE	-	02/17/15	REVISED -	

Sheats NOTILE 8-sht-500 chon
02-154-684)\Design\Civil\CADB
REPAIR
581

				URBAN	100% STATE
					ROADWAY
-			and a second	TOTAL	0040
SI	CODE NO.	ITEM	UNIT	QUANTITY	
area area area area area area area area	50800205	REINFORCEMENT BARS, EPOXY COATED	POUND	710	710
	54002020	EXPANSION BOLTS 3/4 INCH	EACH	51	51
	54003000	CONCRETE BOX CULVERTS	CU YD	5, 0	5.0
	63301210	REMOVE AND REERECT STEEL PLATE BEAM GUARDRAIL, TYPE A	FOOT	37. 5	37.5
-	67000400	ENGINEER'S FIELD OFFICE, TYPE A	CAL MO	I	1
-	01000100		7.2		*
	67100100	MOBILIZATION	L SUM	1	1
	70.0000		20.53		
	70106800	CHANGEABLE MESSAGE SIGN	CAL MO	5	5
X	78000200	THERMOPLASTIC PAVEMENT MARKING - LINE 4"	FOOT	12	12
					_
X	78100100	RAISED REFLECTIVE PAVEMENT MARKER	EACH	2	2
X	85000200	MAINTENANCE OF EXISTING TRAFFIC SIGNAL INSTALLATION	EACH	2	2
***************************************					
Arrado de la companya	K1004595	PRUNING FOR SAFETY AND EQUIPMENT CLEARANCE	L SUM	1	1
	X4810200	AGGREGATE SHOULDER REMOVAL	си ур	0.5	0.5
			**************************************		
	X7010216	TRAFFIC CONTROL AND PROTECTION, (SPECIAL)	L SUM	1	1
	Z0013798	CONSTRUCTION LAYOUT	t SUM	Ĩ	1
	14		The state of the s		

X SPECIALTY ITEM
\* SPECIAL PROVISION ITEM

		USER HAME 2 KyloC	DESIGNED -	KJC	REVISED -	
	上  く  大八		DRAWN -	KJC	REVISED -	
E	NGINEERING LTD.	PLOT SCALE . NTS	CHECKED -	LVA	REVISED -	
	CIAGUACUMA CID.	PLOT DATE * 2/17/2015	DATE -	02/17/15	REVISED -	

STATE OF ILLINOIS
DEPARTMENT OF TRANSPORTATION

	IL 60 OVER DITCH CULVERT REPAIR (0.5 MI WEST OF WILSON RD) SUMMARY OF QUANTITIES										SECTION	COUNTY	TOTAL	SHEET NO.		
												LAKE	16	4		
		SUMMANT OF GOAMITIES									CONTRACT NO. 62A32					
ı	SCALE: NTS SHEET 2 OF 3 SHEETS STA. TO STA.										ILLINDIS FEE	, AID PROJECT				

				·	UNDAY	<del></del>
						ROADWAY
					TOTAL	0040
SP	SI	CODE NO.	ITEM	UNIT	QUANTITY	
		70050665	ADDITION AND CLARATION CONTROL	50 45	10	
•	,	Z0058668	GRADING AND SHAPING FORESLOPES	SO YD	10	10
						The state of the s
		20073002	TEMPORARY SOIL RETENTION SYSTEM	SO FT	110	110
		20013002	Tells of All Policy System	00 / 1		
						- Andrews
				<b></b>		
*		Z0073510	TEMPORARY TRAFFIC SIGNAL TIMING	EACH	4	4
,						
						-
				<del> </del>		
		3				
				ļ		
				ļ	~~~~~~~~~~~~~~~~~~~~~~~~~~~~~~~~~~~~~~	
				<u> </u>		
						A Property of the Property of
				-		
	-					-
				1		
				<u> </u>		
	-					
	<u> </u>			ļ		
	<u> </u>			1.		
	-					Similar Park
						NAME OF TAXABLE PARTY AND ADDRESS OF TAXABLE
L						
	-					The state of the s
L				1		

X SPECIALTY ITEM
• SPECIAL PROVISION ITEM



-	USER NAME 2 XyloC	DESIGNED	-	KJE	REVISED	*
į		DRAWN	<b>-</b>	KJE	REVISED	-
-	PLOT SCALE . NTS	CHECKED		£VA	REVISED	-
1	PLOT DATE * 2/17/2015	DATE	-	02/17/15	REVISED	*

STATE OF ILLINOIS
DEPARTMENT OF TRANSPORTATION


IL 60 OV	ER DITCH			(0,5 MI WI IUANTITIES	EST OF WILSON	RD)
SCALE: NTS	SHEET	3 OF	3 SHEET	S STA.	TO STA.	

100% STATE

URBAN

| F.A.P. | SECTION | COUNTY | SHEET |

ILLINOIS ROUTE 60 OVER DITCH (O.5 MILES WEST OF WILSON ROAD) EXISTING REINFORCED BOX CULVERT

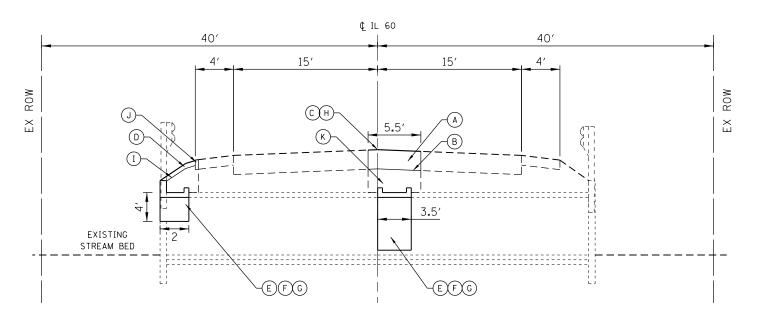

ILLINOIS ROUTE 60 OVER DITCH (O.5 MILES WEST OF WILSON ROAD) PROPOSED REINFORCED BOX CULVERT REPAIRS

#### 1. THE UNIT WEIGHT USED TO CALCULATE ALL HMA MIXTURE QUANTITIES IS 112 LBS/SQYD/IN.

- 2. FOR NON-POLYMERIZED HMA THE "AC TYPE" SHALL BE "PG 64 -22" UNLESS MODIFIED BY DISTRICT ONE SPECIAL PROVISIONS.
- 3. FOR USE OF RECYCLED MATERIALS SEE DISTRICT ONE SPECIAL PROVISIONS.
- 4. QUALITY MANAGEMENT PROGRAM (QMP) IDENTIFIES THE PARTICULAR QUALITY CONTROL SPECIFICATION THAT APPLIES TO THE HMA MIXTURE.

#### HOT-MIX ASPHALT REQUIREMENTS

APPLICATION	MIXTURE TYPE	AC TYPE	AIR VOIDS @ NDES	RAP %
CLASS D PATCHES, TYPE II, 8 INCH	2" HMA SURFACE COURSE, MIX D, N70	PG 64-22	4% <b>@</b> 70 GYR	15
	6" HMA BINDER IL-19 MM	PG 58-22	4% <b>@</b> 70 GYR	25

TERRA ENGINEERING LTD.

	USER NAME = KyleC	DESIGNED	-	KJC	REVISED	-
_		DRAWN	-	KJC	REVISED	=
_	PLOT SCALE = NTS	CHECKED	-	LVA	REVISED	=
٠.	PLOT DATE = 2/17/2015	DATE	-	02/17/15	REVISED	-

#### STATE OF ILLINOIS **DEPARTMENT OF TRANSPORTATION**

IL 60 OVER	DITCH	CUL	VERT	RE	PAIR (	).5 MI \	WEST OF WILSON RD)	F.A.P. RTE.	SECTION		COUNTY	TOTAL SHEETS	SHEET NO.	
	TYPICAL SECTIONS										LAKE	16	6	
				107	AL SECT	IOIVO					CONTRACT	NO. 62	A32	
CALE: NTS	SHEET	1	OF	1	SHEETS	STA.	TO STA.		ILLINOIS	FED. A	D PROJECT			

EXISTING/REMOVAL LEGEND

EXISTING GUARDRAIL TO BE REMOVED AND REERECTED

EXISTING AGGREGATE SHOULDER TO BE REMOVED

4) EXISTING REINFORCED CONCRETE BOX CULVERT

(5) CONCRETE REMOVAL

1 EXISTING PAVEMENT

6 STRUCTURE EXCAVATION (TO BE REPLACED)


CLASS D PATCHES, TYPE II, 8 INCH

(8) EXISTING SUBBASE MATERIAL TO BE REUSED & REPLACED

(9) TEMPORARY SOIL RETENTION SYSTEM

### PROPOSED LEGEND

- (A) CLASS D PATCHES, TYPE II, 8 INCH
- (B) BITUMINOUS MATERIALS (PRIME COAT)
- THERMOPLASTIC PAVEMENT MARKING LINE 4"
- TOPSOIL FURNISH AND PLACE, 6"
- CONCRETE BOX CULVERTS
- REINFORCEMENT BARS, EPOXY COATED
- EXPANSION BOLTS 3/4 INCH
- H RAISED REFLECTIVE PAVEMENT MARKER
- (I) FILTER FABRIC
- AGGREGATE SHOULDERS, TYPE B
- (K) EXISTING SUBBASE MATERIAL TO BE REUSED & REPLACED

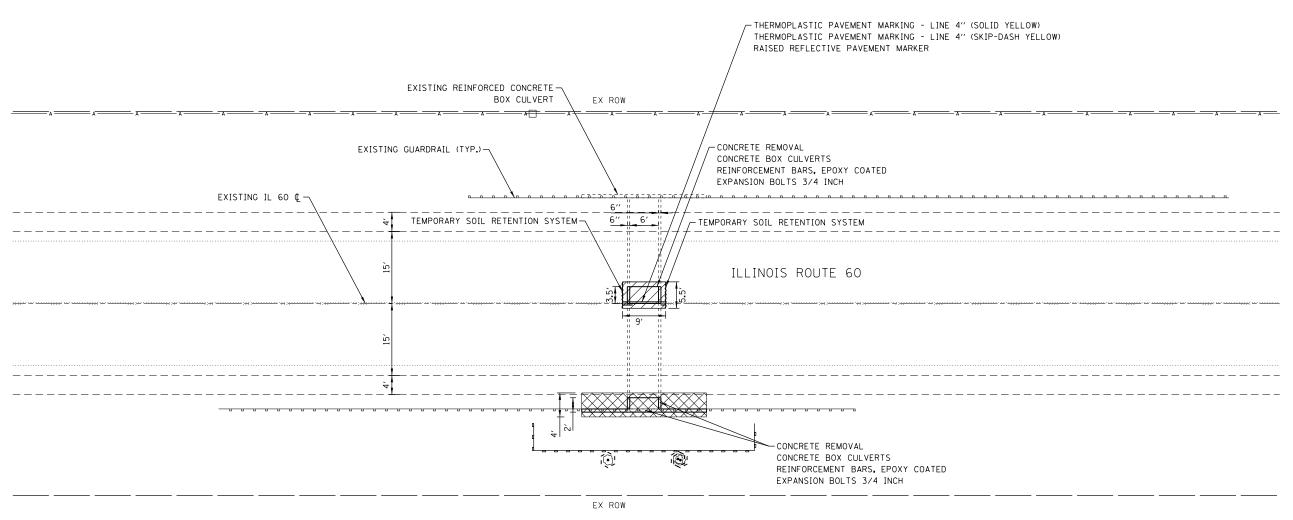

<u>LEGEND</u>



CLASS D PATCHES, TYPE II, 8 INCH
BITUMINOUS MATERIALS (PRIME COAT)
EXISTING SUBBASE MATERIAL ABOVE CULVERT TO BE REUSED & REPLACED



PERIMETER EROSION BARRIER



TREE PROTECTION



STRUCTURE EXCAVATION
FILTER FABRIC
REMOVE AND REERECT STEEL PLATE BEAM GUARDRAIL, TYPE A
AGGREGATE SHOULDERS, TYPE B
TOPSOIL FURNISH AND PLACE, 6"
SEEDING, CLASS 2A
NITROGEN FERTILIZER NUTRIENT
PHOSPHOROUS FERTILIZER NUTRIENT
POTASSIUM FERTILIZER NUTRIENT

#### TEMPORARY EROSION CONTROL NOTES

- 1. THE CONTRACTOR SHALL INSTALL PERIMETER EROSION BARRIER PRIOR TO STRIPPING OF VEGETATION.
- 2. RUNOFF FROM EXCAVATION AREAS SHALL LEAVE THE SITE THROUGH SEDIMENT CONTROL DEVICES. THE CONTRACTOR SHALL ADJUST HIS OPERATION AND IMPLEMENT EROSION CONTROL MEASURES ACCORDINGLY.
- 3. THE CONTRACTOR SHALL SURROUND ANY NECESSARY EARTH STOCKPILES WITH PERIMETER EROSION BARRIER.
- THE CONTRACTOR SHALL MAINTAIN ALL EROSION CONTROL DEVICES AT ALL TIMES. EROSION CONTROL DEVICES SHALL BE INSPECTED EVERY SEVEN CALENDAR DAYS OR WITHIN 24 HOURS AFTER A 1/2 INCH RAINFALL OR SNOWFALL.
- 5. THE CONTRACTOR SHALL SEED ALL DISTURBED AREAS AS SOON AS PRACTICAL AFTER CONSTRUCTION ACTIVITIES IN THAT AREA HAVE BEEN CONCLUDED. AREAS THAT HAVE STEEP SLOPES OR WILL NOT RECEIVE PERMANENT LANDSCAPING SHALL BE TEMPORARILY SEEDED. ALL FLATTER AREAS OR AREAS WHERE NO FURTHER WORK IS TO OCCUR FOR ONE MONTH OR MORE SHALL BE SEEDED AND COVERED WITH AN EROSION CONTROL BLANKET WITHIN SEVEN (7) CALENDAR DAYS.



USER NAME = KyleC	DESIGNED	-	JRM	REVISED -
	DRAWN	-	JRM	REVISED -
PLOT SCALE = 1" = 10"	CHECKED	-	LVA	REVISED -
PLOT DATE = 2/17/2015	DATE	-	02/17/15	REVISED -


STATE OF ILLINOIS
DEPARTMENT OF TRANSPORTATION

MULCH, METHOD 2

IL 60 OVER	DITCH	CUL	VERT	RE	EPAIR (	0.5 MI WEST	OF WILSON RD)
	IL 6	O PL	AN	& I	PAVEMI	ENT MARKING	GS
SCALE: 1" = 10"	SHEET	1	OF	1	SHEETS	STA.	TO STA.

F.A.P. RTE.	SECTION	COUNTY	TOTAL SHEETS	SHEET NO.
535	2014-084B	LAKE	16	7
		CONTRACT	NO. 62	A32
	ILLINOIS FED. A	ID PROJECT		

Minic 60 CULVERT REPAIR (12-154-004)\Design\Civil\CADD Sheets\Dill60-sh Defoult

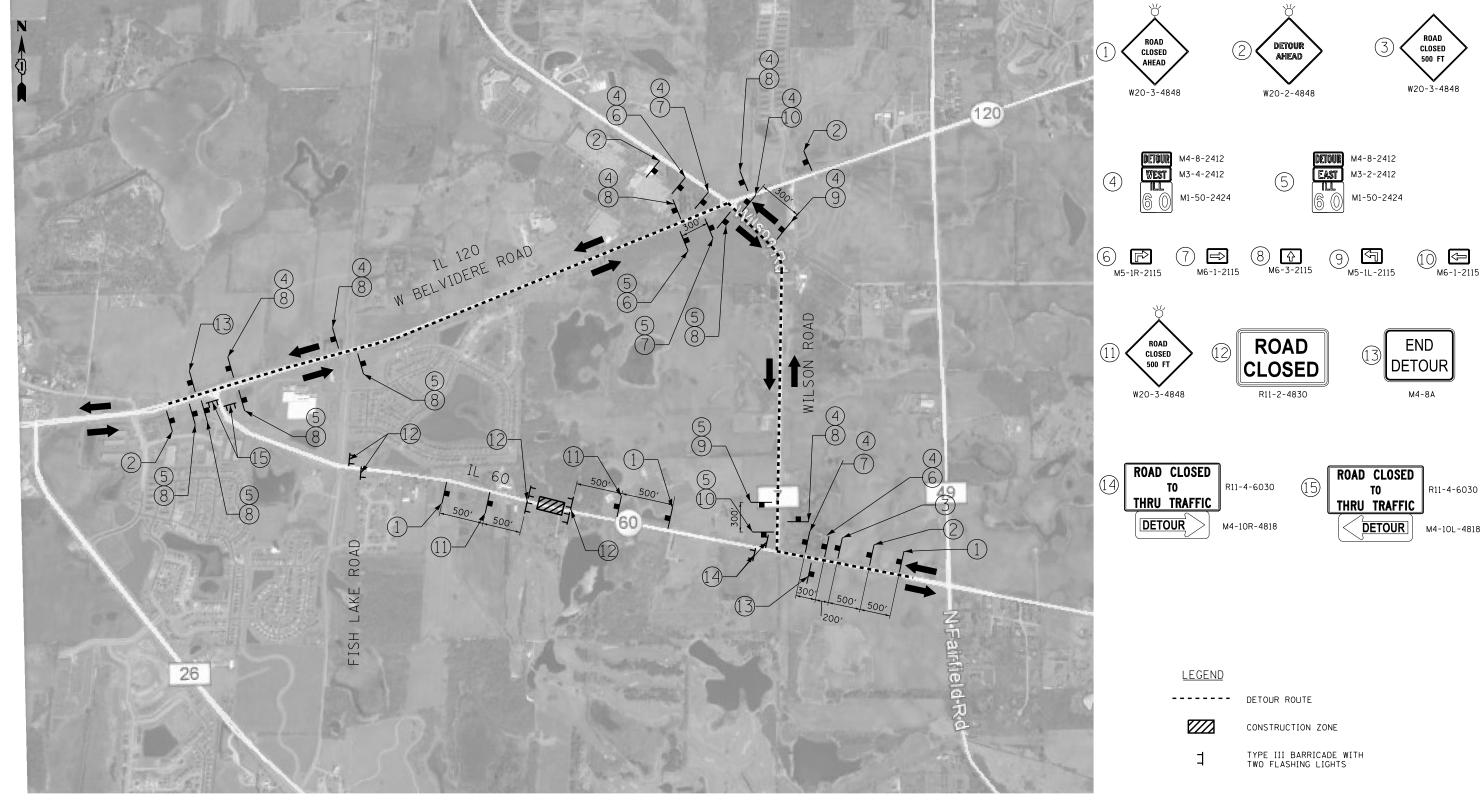

#### <u>NOTES</u>

SCALE: NTS


- PLACEMENT AND SPACING OF SIGNS AND BARRICADES SHALL BE IN ACCORDANCE WITH TC-21 (DETOUR SIGNING FOR CLOSING STATE HIGHWAYS).
- THE COST OF SUPPLYING, ERECTING AND MAINTAINING BARRICADES, WARNING LIGHTS AND ALL SIGNS, INCLUDING SIGN PANEL OVERLAYS, SHALL BE INCLUDED IN THE CONTRACT COST OF TRAFFIC CONTROL AND PROTECTION (SPECIAL).
- 3. ACCESS TO ALL PRIVATE ENTRANCES SHALL BE MAINTAINED.
- 4. ALL SIGNALIZED INTERSECTIONS ALONG THE DETOUR ROUTE SHALL IMPLEMENT TEMPORARY TRAFFIC SIGNAL TIMING.
- THE FOLLOWING INTERSECTIONS WILL REQUIRE MAINTENANCE OF EXISTING TRAFFIC SIGNAL INSTALLATION:
   BELVIDERE RD. AND FISH LAKE RD.
   BELVIDERE RD. AND WILSON RD.



USER NAME = KyleC	DESIGNED - JRM	REVISED -
	DRAWN - JRM	REVISED -
PLOT SCALE = NTS	CHECKED - LVA	REVISED -
PLOT DATE = 2/19/2015	DATE - 02/17/15	REVISED -

STATE OF ILLINOIS **DEPARTMENT OF TRANSPORTATION** 

IL 60 OVER	DITCH	CUL	VERT	RE	PAIR (	F.A.P. RTE.	SECTION	COUNTY	TOTAL SHEETS	SHEET NO.		
	T	RVEE	י חו	UNI	ROL DE	535	2014-084B	LAKE	16	8		
		וואוו	10 0	OIV	HOL DE	10011	ILAN			CONTRACT	NO. 62	A32
CALE: NTS	SHEET	1	OF	1	SHEETS		ILLINOIS FED.	AID PROJECT				

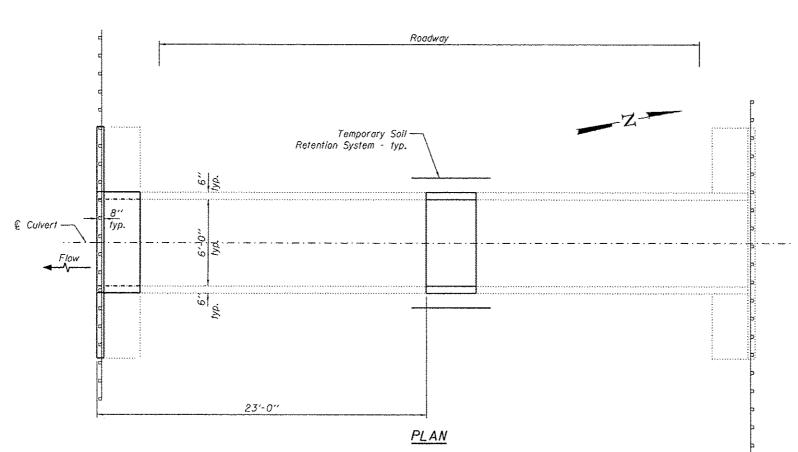

#### LOADING HS 20-44 & ALT.

#### DESIGN STRESSES

FIELD UNITS

f'c = 3,500 psi fy = 60.000 psi (Reinforcement)

#### DESIGN SPECIFICATIONS

AASHTO Standard Bridge Design Specifications

#### GENERAL NOTES

Barrel shall be poured monolithically with wingwalls.

Exposed edges shall be beveled 34".

Reinforcement bars shall conform to the requirements of AASHTO M-31, M-42, or M-53, Grade 60.

Expansion bolts shall be 3/4"  $\phi$  hooked bolts. Hooked bolts shall extend a minimum of 9" into new concrete.

Reinforcement bars designated (E) shall be epoxy coated.

Plan dimensions and details relative to existing plans are subject to nominal construction variations. The Contractor shall field verify existing dimensions and details affecting new construction and make necessary approved adjustments prior to construction or ordering of materials. Such variations shall not be cause for additional compensation for a change in scope of the work, however, the Contractor will be paid for the quantity actually furnished at the unit price bid for the work.

Existing reinforcement shall be cleaned and incorporated into the new construction. Cost included with Concrete Removal.



Exist. Guardrail

typ.

#### TOTAL BILL OF MATERIAL

ITEM	UNJT	TOTAL
Concrete Box Culverts	Cu, Yds.	5.0
Reinforcement Bars, Epoxy Coated	Pound	710
Expansion Bolts 3/4"	Each	51
Structure Excavation	Cu. Yds.	51
Temporary Soil RetentionSystem	Sq. Ft.	110

expires 11.30.2016

Range 9E. 3rd P.M.

S.N. 049-0569

GENER

IL I

F.A.P. RI

GENERAL PLAN & ELEVATION IL RTE. 60 OVER DITCH F.A.P. RTE. 535 - SEC. 2014-084B

LAKE COUNTY STATION 87+00.00 STRUCTURE NO. 049-0569

TERRA ENGINEERING LTD.

USER HAME : Kyloc	DESIGNED	-	88	REVISED	-
	DRAWN	~	BR	REVISED	_
PLOT SCALE = NTS	CHECKED	-	008	REVISED	-
PLOT DATE = 2/11/2015	DATE	-	01/09/15	REVISED	-
					<del></del>


STATE OF ILLINOIS
DEPARTMENT OF TRANSPORTATION

	IL 60 OVER	DITCH	CUL	/ERT	REF	AIR (	0.5 MI WES	T OF WILSON	RD)
_		G	ENER	AL I	PLAN	AND	ELEVATION	ı	
1	SCALE: NTS	SHEET	1	OF	1	SHEETS	STA.	TO STA.	

	F.A.P. RYE.	SECTION	COUNTY	TOTAL	SHE	
535		2014-0848	LAKE	16	9	
_			CONTRACT	NO. 62	A.32	
		to those see at	0.000 607			

Defends

of ault

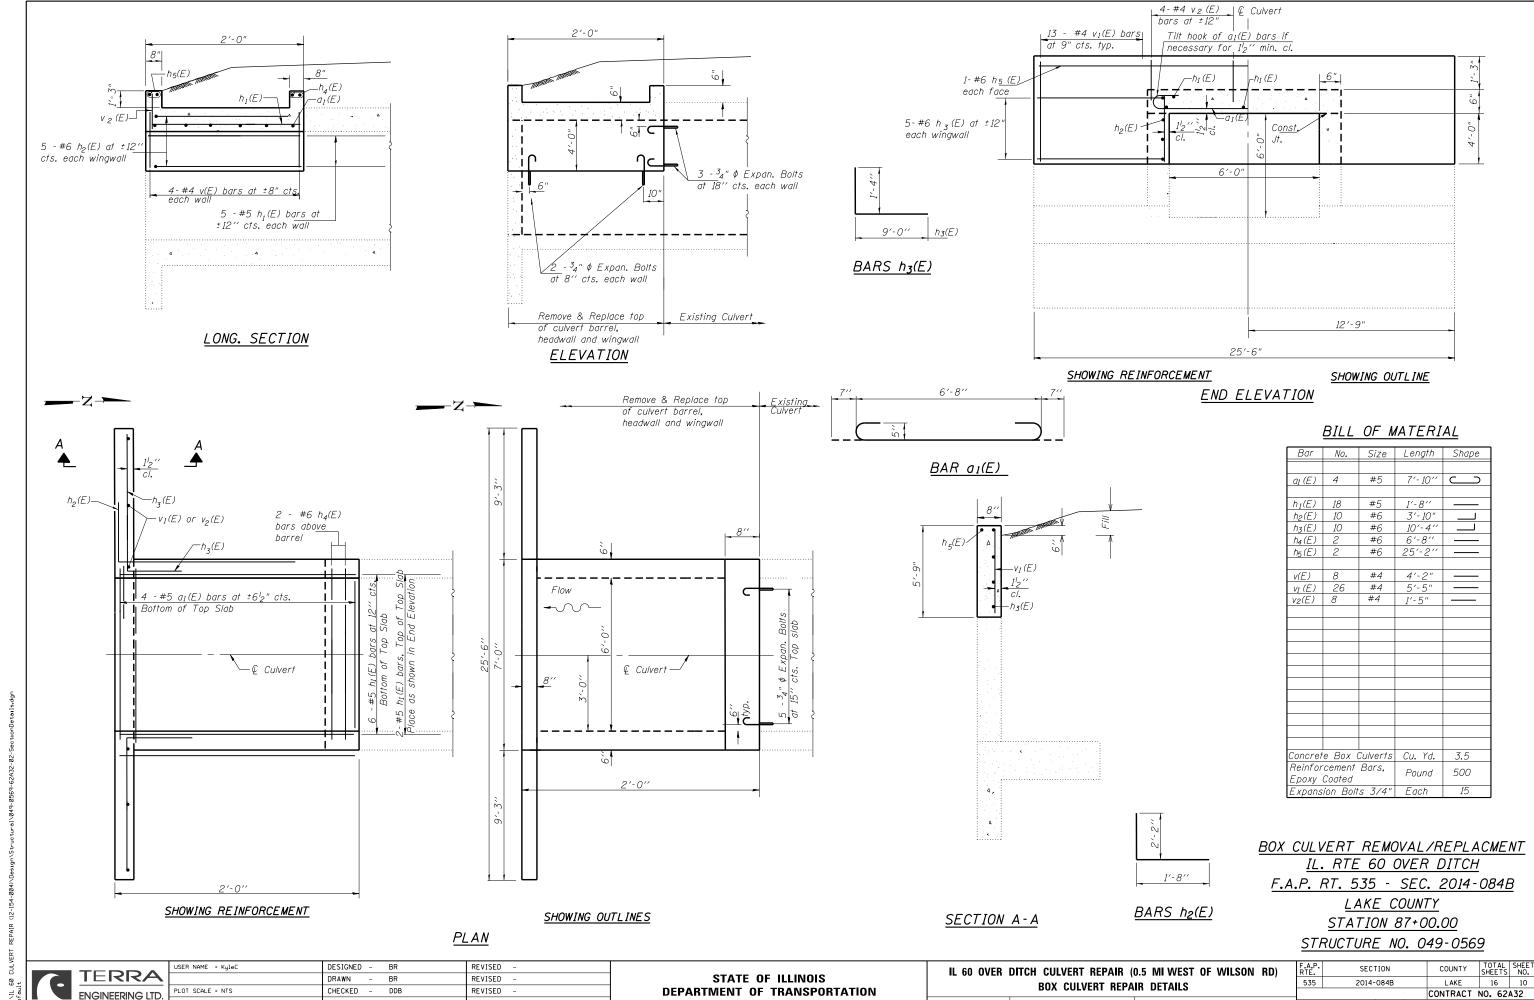

SCALE: NTS

SHEET 1 OF 2 SHEETS STA.


TO STA.

PLOT DATE = 2/17/2015


DATE

- 02/17/15

REVISED

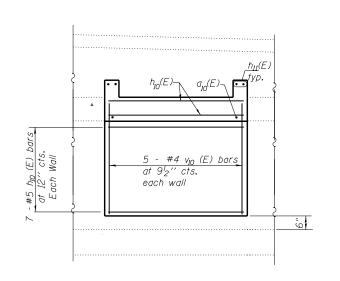


LONG. SECTION

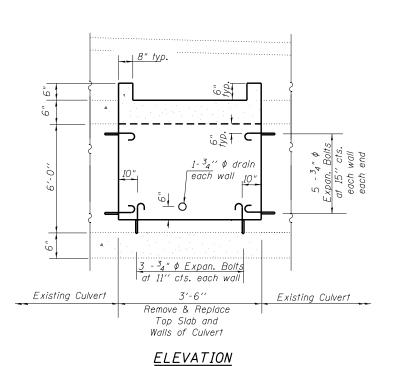

7'-0'' —h<sub>10</sub>(Ε) √h<sub>10</sub>(Ε) Tilt hook of  $a_{l0}(E)$  bars if necessary for  $1^l2^{\prime\prime}$  min. cl. ³₄" ¢ Expan. Bolts € Culvert SHOWING REINFORCEMENT

SHOWING OUTLINES


SECTION THRU BARREL

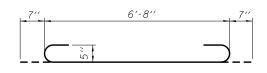

BAR a<sub>10</sub> (E)

#### BILL OF MATERIAL

Bar	No.	Size	Length	Shap	e
					_
a <sub>10</sub> (E)	7	#5	7′-10"	<u> </u>	5
h <sub>10</sub> (E)	22	#5	3'-2''		
h <sub>II</sub> (E)	22 4	#6	6'-8''		=
v <sub>10</sub> (E)	10	#4	5′-8′′	-	_
					_
Concret	е Вох (	L Culverts	Cu. Yd.	1.5	_
	cement		Pound	210	
Expans	ion Bolt	s 3/4"	Each	36	_

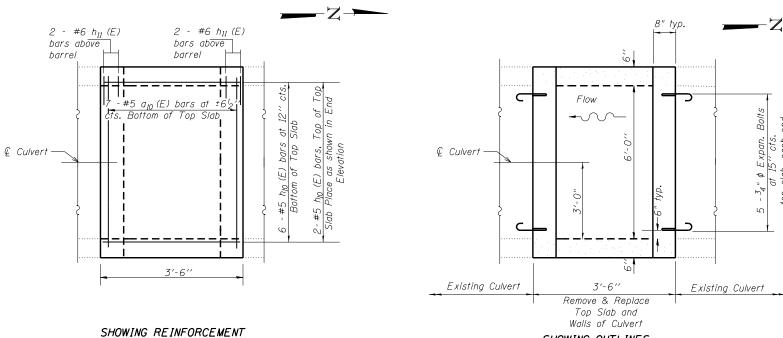


PLAN

SHOWING OUTLINES

BOX CULVERT REMOVAL/REPLACMENT IL. RTE 60 OVER DITCH F.A.P. RT. 535 - SEC. 2014-084B LAKE COUNTY STATION 87+00.00 STRUCTURE NO. 049-0569

	TERRA	
	ENGINEERING LTD.	F
_	LINGINLLINING LID.	ш

DRAWN - BR REVISED -		
DUE CONTROLLED DEPOSITE DE LA CONTROLLED	DRAWN - BR REVISED -	
PLUI SCALE = NIS CHECKED - DDB REVISED -	SCALE = NTS CHECKED - DDB REVISED -	
PLOT DATE = 2/17/2015 DATE - 02/17/15 REVISED -	DATE = 2/17/2015 DATE - 02/17/15 REVISED -	

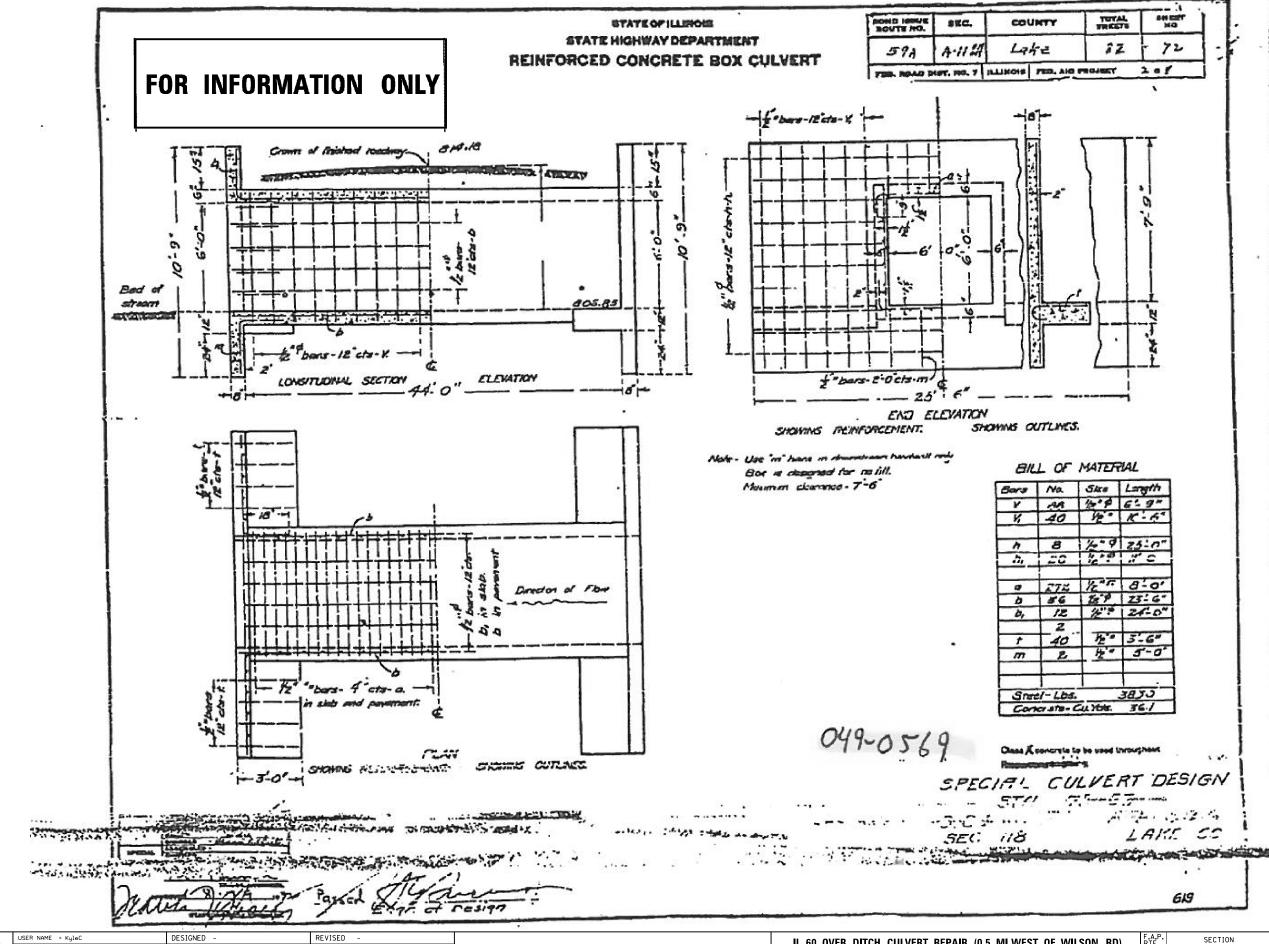

TERRA ENGINEERING LTD.

 USER NAME = KyleC
 DESIGNED = | REVISED | - |

 DRAWN = | REVISED | - |
 REVISED | - |

 PLOT SCALE = NTS | PLOT DATE | = 2/17/2015 | DATE | - | 02/17/15 | REVISED | - |

STATE OF ILLINOIS
DEPARTMENT OF TRANSPORTATION


IL 60 OVER DITCH CULVERT REPAIR (0.5 MI WEST OF WILSON RD)

EXISTING CULVERT PLANS

SCALE: NTS SHEET 1 OF 1 SHEETS STA. TO STA.

F.A.P. SECTION COUNTY TOTAL SHEE NO. 535 2014-084B LAKE 16 12

| CONTRACT NO. 62A32 | ILLINOIS | FED. AID PROJECT

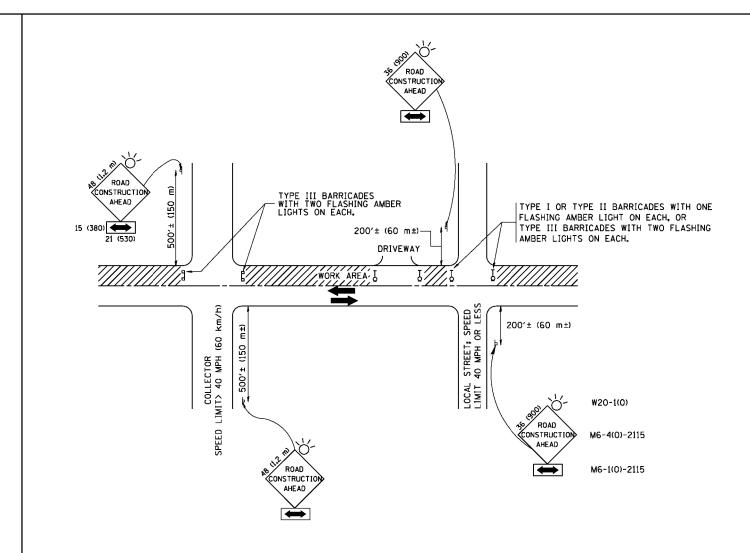

TRAFFIC CONTROL AND PROTECTION FOR SIDE ROADS, INTERSECTIONS, AND DRIVEWAYS

#### NOTES:

- A. FOR NO LANE RESTRICTION ON THE SIDE ROAD OR DRIVEWAYS
- SIDE ROAD WITH A SPEED LIMIT OF 40 MPH (60 km/h) OR LESS AS SHOWN ON THE DRAWING AND AS DIRECTED BY THE ENGINEER:
- Q) ONE ROAD CONSTRUCTION AHEAD SIGN 36 x 36 (900x900) WITH A FLASHER AND FLAG MOUNTED ON IT APPROXIMATELY 200' (60 m) IN ADVANCE OF THE MAIN ROUTE,
- b) THE CLOSED PORTION OF THE MAIN ROUTE SHALL BE PROTECTED BY BLOCKING WITH TYPE I, TYPE II OR TYPE III BARRICADES, 1/3 OF THE CROSS SECTION OF THE CLOSED PORTION.
- 2. SIDE ROAD WITH A SPEED LIMIT GREATER THAN 40 MPH (60 km/h) AS SHOWN ON THE DRAWING AND AS DIRECTED BY THE ENGINEER:
- g) ONE ROAD CONSTRUCTION AHEAD SIGN 48  $\times$  48 (1.2 m  $\times$  1.2 m) WITH A FLASHER MOUNTED ON IT APPROXIMATELY 500° (150 m) IN ADVANCE OF THE MAIN ROUTE.
- b) THE CLOSED PORTION OF THE MAIN ROUTE SHALL BE PROTECTED BY BLOCKING WITH TYPE III BARRICADES, 1/2 OF THE CROSS SECTION OF THE CLOSED PORTION.
- WHEN THE SIDE ROAD LIES BETWEEN THE BEGINNING OF THE MAINLINE SIGNING AND THE WORK ZONE, A SINGLE HEADED ARROW (MG-1) SHALL BE USED IN LIEU OF THE DOUBLE HEADED ARROW (MG-4).

SCALE: NONE

#### B. FOR A LANE CLOSURE ON A SIDE ROAD OR DRIVEWAY:

USE APPLICABLE PORTIONS OF THE TYPICAL APPLICATION OF TRAFFIC CONTROL DEVICES (STD. 701501, STD. 701606 OR THE APPROPRIATE STANDARD). THE SPACING OF SIGNS AND BARRICADES SHALL BE ADJUSTED FOR FIELD CONDITIONS AS DIRECTED BY THE ENGINEER. THE DIRECTIONAL ARROW SHALL BE COVERED OR REMOVED WHEN NO LONGER CONSISTENT WITH THE SIDE ROAD LANE CLOSURE.

- C. ADVANCE WARNING SIGNS ARE TO BE OMITTED ON DRIVEWAY UNLESS OTHERWISE NOTED.
- D. THE TRAFFIC CONTROL AND PROTECTION FOR SIDE ROADS, INTERSECTIONS, AND DRIVEWAYS SHALL BE INCIDENTAL TO THE COST OF SPECIFIED TRAFFIC CONTROL STANDARDS OR ITEMS.


All dimensions are in millimeters (inches) unless otherwise shown.

FILE NAME =	USER NAME = gaglianobt	DESIGNED - LHA	REVISED - J. OBERLE 10-18-95
W:\diststd\22x34\tc10.dgn		DRAWN -	REVISED - A. HOUSEH 03-06-96
	PLOT SCALE = 50.000 '/ IN.	CHECKED -	REVISED - A. HOUSEH 10-15-96
	PLOT DATE = 1/4/2008	DATE - 06-89	REVISED -T. RAMMACHER 01-06-00

STATE	E OF	ILLINOIS
DEPARTMENT	0F	TRANSPORTATION


TRAFFIC CONTROL AND PROTECTION FOR				F.A.P. RTE.	SECTION	
CIDE BOADS INTERSECTIONS AND DRIVEWAYS					535	2014-084B
SIDE ROADS, INTERSECTIONS, AND DRIVEWAYS						TC-10
SHEET NO. 1 (	OF 1	SHEETS	STA.	TO STA.	FED. R	OAD DIST. NO. 1 ILLINOIS F


F.A.P. RTE.	SECTION	COUNTY	TOTAL SHEETS	SHEE.	
535	2014-084B	LAKE	16	13	
	TC-10	CONTRACT	NO. 6	2A32	
FFD. R	DAD DIST. NO. 1 THE INDIS FE	n. A	ID PROJECT		

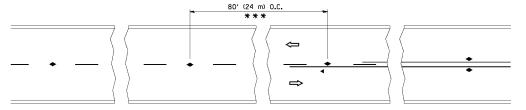


\*\*\* REDUCE TO 40' (12 m) O.C. ON CURVES WITH POSTED OR ADVISORY SPEED 45 M.P.H. (70 km/h) OR LESS.

#### TWO-LANE/TWO-WAY

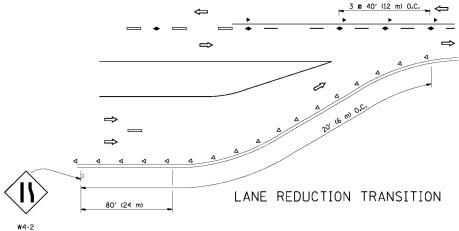


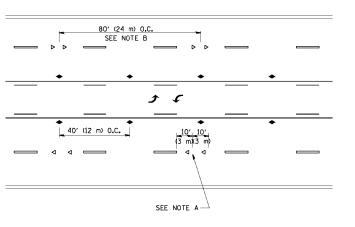

TWO-WAY LEFT TURN

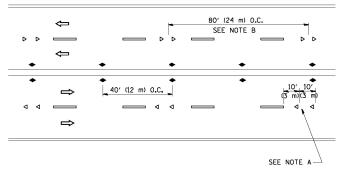

MULTI-LANE/UNDIVIDED

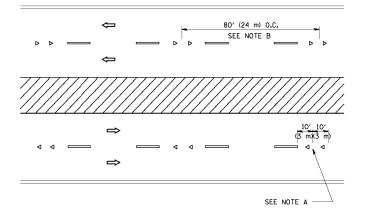

MULTI-LANE/DIVIDED

#### GENERAL NOTES

- 1. MARKERS USED WITH DASHED LINES SHALL BE CENTERED IN THE GAP BETWEEN SEGMENTS.
- 2. MARKERS USED ADJACENT TO SOLID LINES SHALL BE OFFSET 2 TO 3 (50 TO 75) TOWARD TRAFFIC AS SHOWN.
- MARKERS THROUGH TANGENTS LESS THAN 500' (150 m) IN LENGTH BETWEEN CURVES SHALL BE INSTALLED AT THE LESSER OF THE TWO CURVE SPACINGS.

#### LANE MARKER NOTES

A. USE DOUBLE LANE LINE MARKERS SPACED AS SHOWN.

B. REDUCE TO 40' (12 m) O.C. ON CURVES WHERE ADVISORY SPEEDS ARE 10 M.P.H (20 km/h) LOWER THAN POSTED SPEEDS.

#### SYMBOLS

---- YELLOW STRIPE

WHITE STRIF

- ONE-WAY AMBER MARKER
- ONE-WAY CRYSTAL MARKER (₩/O)
- ◆ TWO-WAY AMBER MARKER

#### DESIGN NOTES


- 1. DOUBLE LANE LINE MARKERS SHALL BE USED UNLESS SPECIFIED OTHERWISE.
- 2. EXCEPT AS SHOWN ON THE LANE REDUCTION TRANSITION AND FREEWAY EXIT RAMP DETAIL, MARKERS ARE NOT TO BE SPECIFIED ON RIGHT EDGE LINES.
- 3. THE EXACT MARKER LIMITS, SPACING, AND COLOR SHALL BE INCLUDED IN THE PLANS WHEN STANDARD SPECIFICATIONS ARE NOT BEING USED.
- MARKERS SHOULD NOT BE USED ALONGSIDE CURBS EXCEPT FOR EXTREMELY SHORT SECTIONS OF CURBS WHERE NOT MORE THAN TWO MARKERS WOULD BE INVOLVED.

#### 

LEFT TURN

All dimensions are in inches (millimeters) unless otherwise shown.


FILE NAME =	USER NAME = leyea	DESIGNED -	REVISED - T. RAMMACHER 09-19-94			TYPICAL APPLICATIONS		RTF.	SECTION	COUNTY	SHEETS NO.
c:\pw_work\pwidot\leysa\d0108315\tc11.dgn		DRAWN -	REVISED - T. RAMMACHER 03-12-99	STATE OF ILLINOIS				535	2014-084B	LAKE	16 14
	PLOT SCALE = 50.000 '/ IN.	CHECKED -	REVISED -T. RAMMACHER 01-06-00	DEPARTMENT OF TRANSPORTATION	RAISED REFLECTIVE PAVEMENT MARKERS (SNOW-PLOW RESISTANT)		ESISTANT)		TC-11	CONTRACT N	NO. 62A32
	PLOT DATE = 3/2/2011	DATE -	REVISED - C. JUCIUS 09-09-09		SCALE: NONE	SHEET NO. 1 OF 1 SHEETS STA. TO	O STA.	FED. ROAD D	IST. NO. 1 ILLINOIS FED.	AID PROJECT	

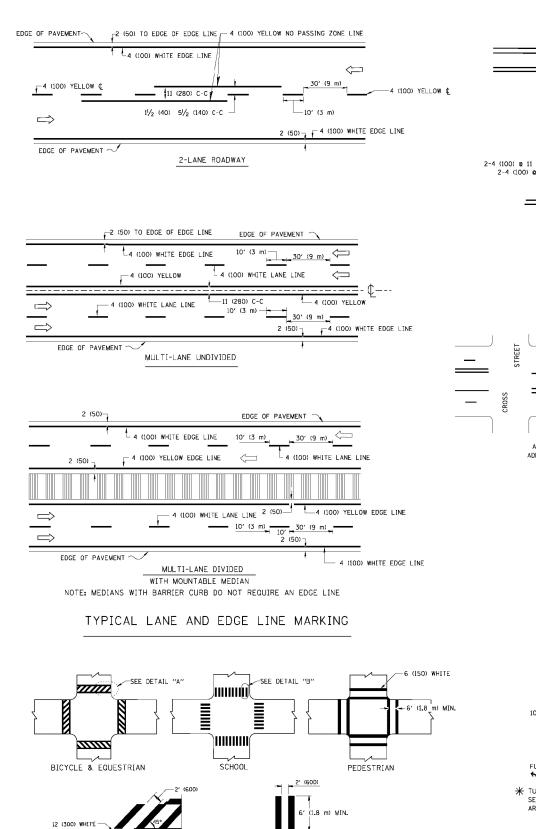


TYPICAL CROSSWALK MARKING

6 (150) WHITE

DETAIL "A"

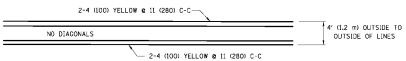


#### 4' (1.2 m) WIDE MEDIANS ONLY

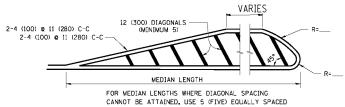


DIAGONAL LINE SPACING: 50' (15 m) C-C (LESS THAN 30MPH (50 km/h))
75' (25 m) C-C 30MPH (50 km/h) T0 45MPH (70 km/h))
150' (45 m) C-C (WORE THAN 45MPH (70 km/h))

#### MEDIANS OVER 4' (1.2 m) WIDE

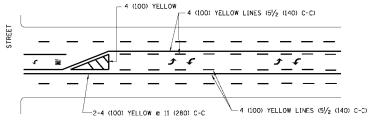


A MINIMUM OF TWO PAIRS OF TURN ARROWS SHALL BE USED, WHITE IN COLOR. ADDITIONAL PAIRS SHALL BE PLACED AT 200' (60 m) TO 300' (90 m) INTERVALS.

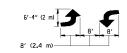

MEDIAN WITH TWO-WAY LEFT TURN LANE

#### TYPICAL PAINTED MEDIAN MARKING

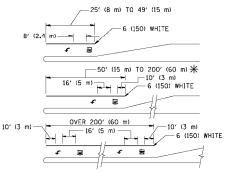


FULL SIZE LETTERS 8' (2.4 m) AND ARROWS SHALL BE USED.  $\P$  AREA = 15.6 SQ. FT. (1.5 m² )  $\P$  AREA = 20.8 SQ. FT. (1.9 m²)

\* TURN LANES IN EXCESS OF 400' (120 m) IN LENGTH MAY HAVE AN ADDITIONAL SET OF ARROW - "ONLY" INSTALLED MIDWAY BETWEEN THE OTHER TWO SETS OF ARROW - "ONLY".

TYPICAL LEFT (OR RIGHT) TURN LANE

#### TYPICAL TURN LANE MARKING

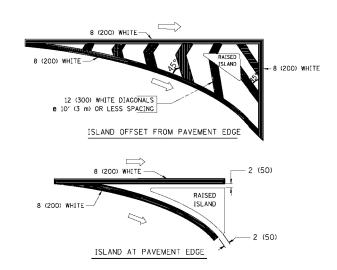

#### TYPICAL ISLAND MARKING

TYPE OF MARKING	WIDTH OF LINE	PATTERN	COLOR	SPACING / REMARKS
CENTERLINE ON 2 LANE PAVEMENT	4 (100)	SKIP-DASH	YELLOW	10' (3 m) LINE WITH 30' (9 m) SPACE
CENTERLINE ON MULTI-LANE UNDIVIDED PAVEMENT	2 @ 4 (100)	SOLID	YELLOW	11 (280) C-C
NO PASSING ZONE LINES: FOR ONE DIRECTION FOR BOTH DIRECTIONS	4 (100) 2 @ 4 (100)	SOLID SOLID	YELLOW YELLOW	5/ <sub>2</sub> (140) C-C FROM SKIP-DASH CENTERLINE 11 (280) C-C OMIT SKIP-DASH CENTERLINE BETWEEN
LANE LINES	4 (100) 5 (125) ON FREEWAYS	SKIP-DASH SKIP-DASH	WHITE WHITE	10' (3 m) LINE WITH 30' (9 m) SPACE
DOTTED LINES (EXTENSIONS OF CENTER, LANE OR TURN LANE MARKINGS)	SAME AS LINE BEING EXTENDED	SKIP-DASH	SAME AS LINE BEING EXTENDED	2' (600) LINE WITH 6' (1.8 m) SPACE
EDGE LINES	4 (100)	SOLID	YELLOW-LEFT WHITE-RIGHT	OUTLINE MOUNTABLE MEDIANS IN YELLOW; EDGE LINES ARE NOT USED NEXT TO BARRIER CURB
TURN LANE MARKINGS	6 (150) LINE; FULL SIZE LETTERS & SYMBOLS (8' (2.4m))	SOLID	WHITE	SEE TYPICAL TURN LANE MARKING DETAIL
TWO WAY LEFT TURN MARKING	2 & 4 (100) EACH DIRECTION	SKIP-DASH AND SOLID	YELLOW	10' (3 m) LINE WITH 30' (9 m) SPACE FOR SKIP-DASH; 51/2 (140) C-C BETWEEN SOLID LINE AND SKIP-DASH LINE
	8' (2.4m) LEFT ARROW	IN PAIRS	WHITE	SEE TYPICAL TWO-WAY LEFT TURN MARKING DETAIL
CROSSWALK LINES (PEDESTRIAN) A. DIAGONALS (BIKE & EQUESTRIAN) B. LONGITUDINAL BARS (SCHOOL)	2 @ 6 (150) 12 (300) @ 45° 12 (300) @ 90°	SOLID SOLID SOLID	WHITE WHITE WHITE	NOT LESS THAN 6' (1.8 m) APART 2' (600) APART 2' (600) APART SEE TYPICAL CROSSWALK MARKING DETAILS.
STOP LINES	24 (600)	SOLID	WHITE	PLACE 4' (1,2 m) IN ADVANCE OF AND PARALLEL TO CROSSMALK, IF PRESENT, OTHERWISE, PLACE AT DESIRED STOPPING POINT. PARALLEL TO CROSSROAD CENTERLINE, WHERE POSSIBLE
PAINTED MEDIANS	2 @ 4 (100) WITH 12 (300) DIAGONALS @ 45° NO DIAGONALS USED FOR 4' (1.2 m) WIDE MEDIANS	SOLID	YELLOW: TWO WAY TRAFFIC WHITE: ONE WAY TRAFFIC	11 (280) C-C FOR THE DOUBLE LINE SEE TYPICAL PAINTED MEDIAN MARKING.
GORE MARKING AND CHANNELIZING LINES	8 (200) WITH 12 (300) DIAGONALS @ 45°	SOLID	WHITE	DIAGONALS: 15' (4.5 m) C-C (LESS THAN 30MPH (50 km/h)) 20' (6 m) C-C 30MPH (50 km/h) TO 45MPH (70 km/h)) 30' (9 m) C-C (OVER 45MPH (70 km/h))
RAILROAD CROSSING	24 (600) TRANSVERSE LINES; "RR" IS 6' (1.8 m) LETTERS; 16 (400) LINE FOR "X"	SOLID	WHITE	SEE STATE STANDARD 780001 AREA OF: "R"=3.6 SO. FT. (0.33 m²) EACH "X"=54.0 SO. FT. (5.0 m²)
SHOULDER DIAGONALS	12 (300) @ 45°	SOLID	WHITE - RIGHT YELLOW - LEFT	50' (15 m) C-C (LESS THAN 30MPH (50 km/h)) 75' (25 m) C-C (30 MPH (50 km/h) TO 45MPH (70 km/h)) 150' (45 m) C-C (0VER 45MPH (70 km/h))

FOR FURTHER DETAILS ON PAVEMENT MARKING REFER TO STANDARD SPECIFICATIONS FOR ROAD AND BRIDGE CONSTRUCTION AND STATE STANDARD 780001.

All dimensions are in inches (millimeters) unless otherwise shown.

FILE NAME =	USER NAME = drivakosgn	DESIGNED	-	EVERS	REVISED	-T.	RAMMACHER	10-27-94
c:\pw_work\pwidot\drivakosgn\d0108315\tc	l3.dgn	DRAWN	-		REVISED	- C.	JUCIUS	09-09-09
	PLOT SCALE = 50.000 '/ IN.	CHECKED	-		REVISED	-		
	PLOT DATE = 9/9/2009	DATE	-	03-19-90	REVISED	-		

12 (300) WHITE

DETAIL "B"

STATE OF	ILLINOIS
<b>DEPARTMENT OF</b>	TRANSPORTATION

DISTRICT ONE					F.A.P. RTE.	SECTION	COUNTY	TOTAL SHEETS			
	TYPICAL PAVEMENT MARKINGS					535	2014-084B	LAKE		15	
							TC-13	CONTRACT	NO.	62A32	
	SCALE: NONE	SHEET NO. 1 OF 1 SHI	EETS	STA.	TO STA.	FED. ROAD DIST. NO. 1 ILLINOIS FED. AID PROJECT					

