STATE OF ILLINOIS

DEPARTMENT OF TRANSPORTATION

DIVISION OF HIGHWAYS

FOR INDEX OF SHEETS, SEE SHEET NO. 2

TRAFFIC DATA
POSTED SPEED: 50 MPH

DESIGN SPEED: 55 MPH FUNCTIONAL CLASSIFICATION:

MINOR ARTERIAL ADT = 13,900 (2013)

0

0

PROJECT LOCATED IN UNINCORPORATED KANE COUNTY
JUST SOUTH OF THE VILLAGE OF ALGONOUIN

PROPOSED HIGHWAY PLANS

FAU ROUTE 3887 IL 31 (MAIN STREET) OVER ANIMAL CROSSING

SECTION 2014-082I CULVERT REMOVAL KANE COUNTY C-91-128-15

PROJECT LOCATION
STRUCTURE NO. 045-0504

LOCATION MAP

LOCATION MAP

GROSS LENGTH = 42 FT. = 0.008 MILE NET LENGTH = 42 FT. = 0.008 MILE JAMIL BOU-STAND 062-047537 REGISTERED PROFESSIONAL ENGINEER
LICENSED PROFESSIONAL ENGINEER ILLINOIS NO. 052-047537 EXPIRES 11-30-15

TERRA

D-91-128-15

SECTION

2014-0821

KANE 18 I



0 100' 200' 300' — 1"= 100'
0 50' 100'
0 50' 100'
0 50' 100'
0 50' 100'
0 50' 100'
0 50' 100' 1"= 30'
0 50' 100' 1"= 30'

FULL SIZE PLANS HAVE BEEN PREPARED USING STANDARD ENGINEERING SCALES. REDUCED SIZED PLANS WILL NOT CONFORM TO STANDARD SCALES, IN MAKING MEASUREMENTS ON REDUCED PLANS, THE ABOVE SCALES MAY BE USED.

J.U.L.I.E.
JOINT UTILITY LOCATION INFORMATION FOR EXCAVATION
1-800-892-0123
OR 811

PROJECT MANAGER: ISSAM RAYYAN, P.E. (847) 705-4178 PROJECT ENGINEER: ROBERT T. BORO, P.E. (847) 705-4237

CONTRACT NO. 62A30

STATE OF ILLINOIS

DEPARTMENT OF TRANSPORTATION

DIVISION OF HIGHWAYS

SUBMITTED

DEPUTY DIRECTOR OF HIGHWAYS, REGION ENGINEER

DEPUTY DIRECTOR OF DESIGN AND ENVIRONMENT

LOCAL DO 20 15

DIRECTOR OF HIGHWAYS, CHIEF ENDINEER

PRINTED BY THE AUTHORITY OF THE STATE OF ILLINOIS

INDEX OF SHEETS

SHEET NO.	DESCRIPTION
1	COVER SHEET
2	INDEX OF SHEETS, STATE STANDARDS AND GENERAL NOTES
3 - 4	SUMMARY OF QUANTITIES
5	TYPICAL SECTIONS
6	SCHEDULE OF QUANTITIES
7	ALIGNMENT, TIES AND BENCHMARKS
8	PLAN AND PROFILE & PAVEMENT MARKINGS
3	TRAFFIC CONTROL DETOUR PLAN
10	EROSION AND SEDIMENT CONTROL PLAN
11	DRAINAGE AND UTILITY PLAN
12	BENCHING DETAIL FOR EMBANKMENT WIDENING (BD-51)
13	TRAFFIC CONTROL AND PROTECTION FOR SIDE ROAD, INTERSECTION AND DRIVEWAYS (TC-10)
14	TYPICAL APPLICATIONS: RAISED REFLECTIVE PAVEMENT MARKERS (SNOW-PLOW RESISTANT) (TC-11)
15	DISTRICT ONE TYPICAL PAVEMENT MARKINGS (TC-13)
16	DETOUR SIGNING FOR CLOSING STATE HIGHWAYS (TC-21)
17 - 18	CROSS SECTIONS

STATE STANDARDS

000001-06 STANDARD SYMBOLS. ABBREVIATIONS AND PATTERNS	
280001-07 TEMPORARY EROSION CONTROL SYSTEMS	
442201-03 CLASS C AND D PATCHES	
630001-10 STEEL PLATE BEAM GUARDRAIL	
701001-02 OFF-RD OPERATIONS, 2L. 2W, MORE THAN 15' AWAY	
701006-05 OFF-RD OPERATIONS, 2L, 2W, 15' TO 24" FROM PAVEMENT EDGE	
701011-04 OFF-RD MOVING OPERATIONS, 2L, 2W, DAY ONLY	
701201-04 LANE CLOSURE, ZL, 2W, DAY ONLY, FOR SPEEDS >= 45 MPH	
701301-04 LANE CLOSURE, 2L. 2W. SHORT TIME OPERATIONS	
701306-03 LANE CLOSURE, 2L, 2W, SLOW MOVING OPERATIONS DAY ONLY, FOR	SPEEDS >= 45 MPH
TOI311-03 LANE CLOSURE, 2L, 2W, MOVING OPERATIONS - DAY ONLY	
701901-04 TRAFFIC CONTROL DEVICES	
780001-05 TYPICAL PAVEMENT MARKINGS	
781001-03 TYPICAL APPLICATIONS RAISED REFLECTIVE PAVEMENT MARKERS	

GENERAL NOTES

- BEFORE STARTING ANY EXCAVATION, THE CONTRACTOR SHALL CALL "JULIE" AT (800) 892-0123
 FOR FIELD LOCATIONS OF BURIED ELECTRIC, TELEPHONE AND GAS FACILITIES. 48-HOUR
 NOTIFICATION IS REQUIRED.
- THE CONTRACTOR WILL NOT BE ALLOWED TO SET UP A YARD OR FIELD OFFICE ON STATE PROPERTY WITHOUT WRITTEN PERMISSION FROM THE DEPARTMENT.
- 3. ALL DAMAGE TO EXISTING PAVEMENT MARKINGS OR RAISED REFLECTIVE PAVEMENT MARKERS OUTSIDE THE REMOVAL LINE SHOWN ON THE PLANS SHALL BE REPLACED AT THE CONTRACTOR'S EXPENSE.
- 4. BEFORE STARTING ANY WORK, THE CONTRACTOR SHALL OBTAIN AND RECORD FOR FUTURE REFERENCE, ALL EXISTING PAVEMENT MARKING LINES AND RAISED REFLECTIVE MARKERS IN ORDER THAT THESE LOCATIONS CAN BE RE-ESTABLISHED FOR STRIPING. EXACT LOCATIONS OF ALL PAVEMENT MARKINGS SHALL BE AS DIRECTED BY THE ENGINEER.
- 5. IT SHALL BE THE CONTRACTOR'S RESPONSIBILITY TO VERIFY ALL DIMENSIONS AND CONDITIONS IN THE FIELD PRIOR TO CONSTRUCTION AND ORDERING OF MATERIALS.
- 6. DO NOT SCALE PLANS FOR CONSTRUCTION DIMENSIONS.
- 7. PLAN DIMENSIONS AND DETAILS RELATIVE TO THE EXISTING STRUCTURE HAVE BEEN TAKEN FROM EXISTING PLANS AND ARE SUBJECT TO NOMINAL CONSTRUCTION VARIATIONS. IT SHALL BE THE CONTRACTOR'S RESPONSIBILITY TO VERIFY SUCH DIMENSIONS AND DETAILS IN THE FIELD AND MAKE NECESSARY APPROVED ADJUSTMENTS PRIOR TO CONSTRUCTION AND ORDERING OF MATERIALS. SUCH VARIATIONS SHALL NOT BE CAUSE FOR ADDITIONAL COMPENSATION FOR A CHANGE IN SCOPE OF WORK, HOWEVER, THE CONTRACTOR WILL BE PAID FOR THE QUANTITY ACTUALLY FURNISHED AT THE UNIT PRICE BID FOR THE WORK.
- 8. THE CONTRACTOR SHALL CONTACT THE DISTRICT ONE TRAFFIC CONTROL SUPERVISOR AT (847) 705-4470 A MINIMUM OF 72 HOURS IN ADVANCE OF BEGINNING OF WORK.
- 9. THE RESIDENT ENGINEER SHALL CONTACT WALTER CZARNY, THE AREA TRAFFIC FIELD ENGINEER, AT (847) 438-2300 A MINIMUM OF TWO (2) WEEKS PRIOR TO PLACEMENT OF PERMANENT PAVEMENT MARKINGS.
- 10. THE CONTRACTOR SHALL DIVERT THE WATER FROM THE WORK AREAS BY A METHOD APPROVED BY THE ENGINEER.
- 11. ALL PAVEMENT PATCHING LOCATIONS WILL BE DETERMINED IN THE FIELD BY THE ENGINEER.
- 12. DURING CONSTRUCTION OPERATIONS, LOOSE MATERIAL DEPOSITS THAT OBSTRUCT THE FLOW OF WATER IN DRAINING THE AREA SHALL BE REMOVED BEFORE THE END OF EACH WORK DAY. AT THE CONCLUSION OF THE CONSTRUCTION OPERATIONS, ALL DRAINAGE STRUCTURES (NEW AND EXISTING) SHALL BE FREE FROM ALL DIRT AND DEBRIS. THIS WORK WILL NOT BE PAID FOR SEPARATELY, BUT SHALL BE CONSIDERED INCIDENTAL TO THE CONTRACT.
- 13. ALL EXCAVATED SOILS FROM THE PROJECT SITE SHALL BE RE-USED AS FILL OR TOPSOIL AT THE PROJECT SITE. NO EXCAVATED SOILS FROM THE PROJECT SITE MAY BE DISPOSED OF AT ANY OFFSITE LOCATION.
- 14. PERIMETER EROSION BARRIER SHALL BE INSTALLED AROUND EXCAVATION STOCKPILES. THIS WORK WILL NOT BE PAID FOR SEPARATELY, BUT SHALL BE CONSIDERED INCIDENTAL TO THE CONTRACT.
- 15. WINCWALL REMOVAL IS INCLUDED IN THE QUANTITY FOR AND PAID FOR AS REMOVAL OF EXISTING STRUCTURES'.
- 16. AGGREGATE SHOULDER REMOVAL IS INCLUDED IN THE QUANTITY FOR AND PAID FOR AS 'EARTH EXCAVATION'.

USER NAME ? KyleC	DESIGNED - KUC	REVISED -
	DRAWN - KJC	REVISED -
PLOT SCALE . NTS	CHECKED - LVA	REVISED -
PLOT DATE + 2/17/2015	DATE - 02/17/1	5 REVISED -

	ILL(NOIS FE	D. AID PROJECT		
		CONTRACT	NO. 62	A30
3887	2014-0821	KANE	18	2
F.A.U. RTE.	SECTION	COUNTY	TOTAL	SHEE NO.

URBAN 100% STATE

					100% STATE
					ROADWAY
SP SI	CODE NO.	ITEM	UNIT	TOTAL QUANTITY	OO4O SN 045-050

	20100110	TREE REMOVAL (6 TO 15 UNITS DIAMETER)	TINU	36	36
	20100210	TREE REMOVAL (OVER 15 UNITS DIAMETER)	TINU	35	35
					44
	20400800	FURNISHED EXCAVATION	CU YD	50	50
	21101505	TOPSOIL EXCAVATION AND PLACEMENT	CU YD	70	70
	20200100	EARTH EXCAVATION	CU YD	528	528
	The state of the s				
	20201200	REMOVAL AND DISPOSAL OF UNSUITABLE MATERIAL	CU YD	53	53
	21101625	TOPSOIL FURNISH AND PLACE. 6"	SO YD	419	419
deterrorbe betrettenstreten	25100635	HEAVY DUTY EROSION CONTROL BLANKET	SO YD	419	419
***************************************	28000250	TEMPORARY EROSION CONTROL SEEDING	POUND	3	3

and the state of t	28000400	PERIMETER EROSION BARRIER	FOOT	316	316
*	40600275	BITUMINOUS MATERIALS (PRIME COAT)	POUND	89	89
	44004250	PAVED SHOULDER REMOVAL	SO YD	24	24
	44201833	CLASS D PATCHES, TYPE IV, 15 INCH	SO YD	100	100
			A COMPANY AND THE PARTY OF THE		
	48101500	AGGREGATE SHOULDERS, TYPE 8 6"	SO YD	16	16
	48101500		SO YD	16	

X SPECIALTY ITEM SPECIAL PROVISION ITEM



 USER NAME = Kyloc
 DESIGNED KJC
 REVISED

 DRAWN KJC
 REVISED

 PLOT SCALE + NTS
 CHECKED LVA
 REVISED

 PLOT OATE 2/17/2815
 DATE 02/17/15
 REVISED

STATE OF ILLINOIS
DEPARTMENT OF TRANSPORTATION

IL 31 OVER ANIMAL CROSSING CULVERT REMOVAL
SUMMARY OF QUANTITIES

SHEET 1 OF 2 SHEETS STA. TO STA.

URBAN

100% STATE

		The second secon		ROADWAY
		To the state of th	TOTAL	0040
CODE NO.	ITEM	UNIT	QUANTITY	SN 045-050
48203033	HOT-MIX ASPHALT SHOULDERS, 9"	SO YD	24	24
		177		-
50100100	REMOVAL OF EXISTING STRUCTURES	EACH	1	1
63000009	STEEL PLATE BEAM GUARDRAIL, TYPE B, 9 FOOT POSTS	FOOT	75	75
63200310	GUARDRAIL REMOVAL	FOOT	75	75
67100100	MOBILIZATION	L SUM	1	T T T T T T T T T T T T T T T T T T T

70106800	CHANGEABLE MESSAGE SIGN	CAL MO	2	2
78000200	THERMOPLASTIC PAVEMENT MARKING - LINE 4"	F00T	120	120
78100100	RAISED REFLECTIVE PAVEMENT MARKER	EACH	2	2
85000200	MAINTENANCE OF EXISTING TRAFFIC SIGNAL INSTALLATION	EACH	1	1
K1004595	PRUNING FOR SAFETY AND EQUIPMENT CLEARANCE	L SUM	1	1
X2501700	SEEDING, CLASS 3 (MODIFIED)	ACRE	0.03	0.03
X7010216	TRAFFIC CONTROL AND PROTECTION (SPECIAL)	I CIM	1	
	TOTAL TO CONTROL PRO FRANCESTALLY	L SUM	1	1
Z0013798	CONSTRUCTION LAYOUT	L SUM	1	1
Z0073510	TEMPORARY TRAFFIC SIGNAL TIMING	EACH	15	15
	50100100 6300009 63200310 67100100 70106800 78000200 78100100 85000200 K1004595 X2501700 X7010216 Z0013798	50100100 REMOVAL OF EXISTING STRUCTURES 63000009 STEEL PLATE BEAM GUARDRAIL, TYPE B, 9 FOOT POSTS 63200310 GUARDRAIL REMOVAL 67100100 MOBILIZATION 70106800 CHANGEABLE MESSAGE SIGN 78000200 THERMOPLASTIC PAVEMENT MARKING - LINE 4" 78100100 RAISED REFLECTIVE PAVEMENT MARKER 85000200 MAINTENANCE OF EXISTING TRAFFIC SIGNAL INSTALLATION K1004595 PRUNING FOR SAFETY AND EDUIPMENT CLEARANCE X2501700 SEEDING, CLASS 3 (MODIFIED) X7010216 TRAFFIC CONTROL AND PROTECTION, (SPECIAL)	50100100 REMOVAL OF EXISTING STRUCTURES 63000009 STEEL PLATE BEAM GUARDRAIL, TYPE B, 9 FOOT POSTS 63200310 GUARDRAIL REMOVAL 67100100 MOBILIZATION CAL MO 70106800 CHANGEABLE MESSAGE SIGN CAL MO 78000200 THERMOPLASTIC PAVEMENT MARKING - LINE 4" FOOT 78100100 RAISED REFLECTIVE PAVEMENT MARKER EACH 85000200 MAINTENANCE OF EXISTING TRAFFIC SIGNAL INSTALLATION EACH K1004599 PRUNING FOR SAFETY AND EQUIPMENT CLEARANCE X2501700 SEEDING, CLASS 3 (MODIFIED) ACRE X7010216 TRAFFIC CONTROL AND PROTECTION, (SPECIAL) L SUM Z0013798 CONSTRUCTION LAYOUT L SUM	50100100 REMOVAL OF EXISTING STRUCTURES EACH 1

X SPECIALTY ITEM . SPECIAL PROVISION ITEM




 USER NAME = KyleC
 DESIGNED KUC
 REVISED

 DRAWN KUC
 REVISED

 PLDT SCALE • NTS
 CHECKED LVA
 REVISED

 PLDT DATE 2/17/2015
 DATE 02/17/15
 REVISED

STATE OF ILLINOIS
DEPARTMENT OF TRANSPORTATION

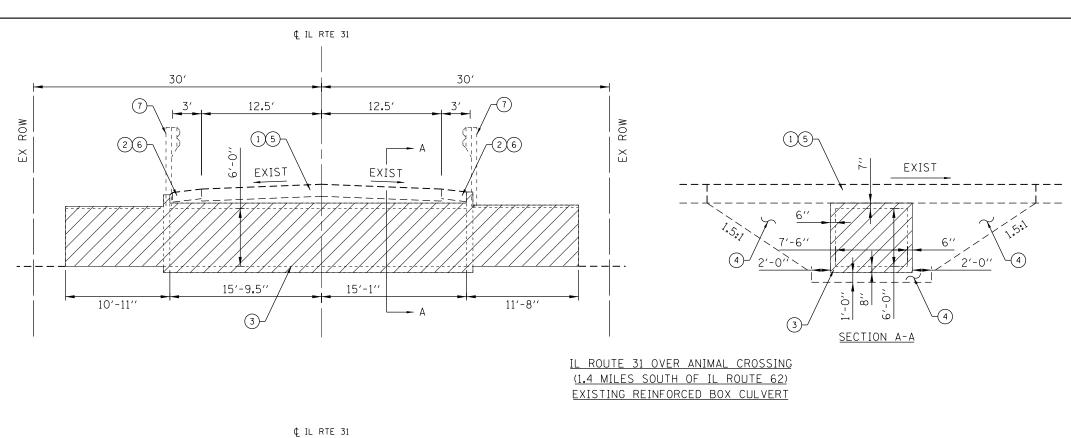

30′ 30′ 35′ 12.5′ 12.5′ ROW MATCH $\stackrel{\times}{\mathsf{E}}$ MATCH EXIST EXIST MATCH EXIST VAR. 70 1:1.8.3.6 1:1.AR. 1:3.0 TO ·5.7 12'-6" (C) SECTION A-A SEE BENCHING DETAIL (D1 STANDARD BD-51) FOR IL ROUTE 31 OVER ANIMAL CROSSING

HOT-MIX ASPHALT REQUIREMENTS

APPLICATION	MIXTURE TYPE	AC TYPE	AIR VOIDS @ NDES	RAP %
CLASS D PATCHES, TYPE IV, 15 INCH	2" HMA SURFACE COURSE, MIX D, N70	PG 64-22	4% @ 70 GYR	15
	13" HMA BINDER IL-19 MM	PG 58-22	4% @ 70 GYR	25
HOT-MIX ASPHALT SHOUDERS, 9 INCH	2" HMA SURFACE COURSE, MIX D, N70	PG 64-22	4% @ 70 GYR	15
	7" HMA BINDER IL-19 MM	PG 58-22	4% @ 70 GYR	25

NOTES:

- 1. THE UNIT WEIGHT USED TO CALCULATE ALL HMA MIXTURE QUANTITIES IS 112 LBS/SQYD/IN.
- 2. FOR NON-POLYMERIZED HMA THE "AC TYPE" SHALL BE "PG 64 -22" UNLESS MODIFIED BY DISTRICT ONE SPECIAL PROVISIONS.
- 3. FOR USE OF RECYCLED MATERIALS SEE DISTRICT ONE SPECIAL PROVISIONS.
- 4. QUALITY MANAGEMENT PROGRAM (QMP) IDENTIFIES THE PARTICULAR QUALITY CONTROL

EXISTING/REMOVAL LEGEND

- 1 EXISTING PAVEMENT
- EXISTING BITUMINOUS SHOULDER
- (3) EXISTING 7.5' X 6' BOX CULVERT
- (4) EARTH EXCAVATION
- CLASS D PATCHES, TYPE IV, 15"
- (6) PAVED SHOULDER REMOVAL
- (7) GUARDRAIL REMOVAL



REMOVAL OF EXISTING STRUCTURES

PROPOSED LEGEND

- (A) CLASS D PATCHES, TYPE IV, 15"
- BITUMINOUS MATERIALS (PRIME COAT)
- HOT-MIX ASPHALT SHOULDERS, 9"
- AGGREGATE SHOULDERS, TYPE B 6"
- EARTH EXCAVATION / FURNISHED EXCAVATION
- (H) STEEL PLATE BEAM GUARDRAIL, TYPE B, 9 FT POSTS
 - TOPSOIL EXCAVATION AND PLACEMENT / TOPSOIL FURNISH AND PLACE, 6'

SPECIFICATION THAT APPLIES TO THE HMA MIXTURE.

	TERRA	
I Y	ENGINEERING LTD.	

	USER NAME = KyleC	DESIGNED	=	KJC	REVISED -
		DRAWN	-	KJC	REVISED -
1	PLOT SCALE = NTS	CHECKED	-	LVA	REVISED -
	PLOT DATE = 2/17/2015	DATE	-	02/17/15	REVISED -
_					

SLOPES STEEPER THAN 4:1 AND GREATER THAN 5' (TYP.)

STATE OF ILLINOIS **DEPARTMENT OF TRANSPORTATION**

(1.4 MILES SOUTH OF IL ROUTE 62)

PROPOSED SECTION

IL 31 OVER ANIMAL CROSSING CULVERT REMOVAL						F.A.U. RTE.	SECTION		
	TYPICAL SECTIONS								2014-0821
				IU	AL SLUI	IUIVO			
SCALE: NTS	SHEET	1	OF	1	SHEETS	STA.	TO STA.		ILLINOIS FED.

А	В	С	D	E	F	G
		EARTH	UNSUITABLE	15% ADJUSTMENT	FILL	EARTHWORK BALANCE
FROM STA	TO STA	EXCAVATION	MATERIAL	FOR SHRINKAGE	EMBANKMENT	WASTE(+) SHORTAGE(-)
		(CU YD)	(CU YD)	(CU YD)	(CU YD)	(CU YD)
2002+00.00	2002+32.19	80.36	8.04	61.47	87.69	-26.22
2002+32.19	2002+43.64	169.33	16.93	129.54	113.14	16.40
2002+43.64	2002+45.67	37.95	3.79	29.03	28.97	0.06
2002+45.67	2002+50.00	27.80	2.78	21.27	60.09	-38.82
2002+50.00	2002+54.33	30.39	3.04	23.25	60.10	-36.85
2002+54.33	2002+56.36	39.31	3.93	30.08	27.95	2.13
2002+56.36	2002+67.81	142.00	14.20	108.63	76.18	32.45
2002+67.81	2003+00.00	1.13	0.11	0.87		0.87
TOTAL		528	53	404	454	-50

<u>LEGEND</u>

COLUMNS A AND B: LOCATION ON PLANS

COLUMN C: CUT QUANTITIES FROM CROSS SECTIONS

COLUMN D: = C X O.1

CUT MATERIAL THAT IS DETERMINED TO BE EITHER UNSTABLE OR UNSUITABLE FOR USE IN EMBANKMENT.

ASSUME 10% OF EARTH EXCAVATION.

COLUMN E: = (C - D) X 0.85

EARTH EXCAVATION THAT IS TO BE USED AS FILL MATERIAL IN THE EMBANKMENT. A SHRINKAGE FACTOR OF 15% IS USED.

COLUMN F: FILL QUANTITIES FROM CROSS SECTIONS

COLUMN G: = E - F

POSITIVE QUANTITY = EXTRA EXCAVATION.

NEGATIVE QUANTITY = FURNISHED EXCAVATION NEEDED.



DRAWN - KJC	USER NAME = KyleC	DESIGNED - KJC	REVISED -
		DRAWN - KJC	REVISED -
PLOT DATE = 2/17/2015 DATE - 02/17/15 REVISED -	PLOT SCALE = NTS	CHECKED - LVA	REVISED -
Ditte Services	PLOT DATE = 2/17/2015	DATE - 02/17/15	REVISED -

USER NAME = KyleC	DESIGNED - KJC	REVISED -
	DRAWN - KJC	REVISED -
PLOT SCALE = 1"=20"	CHECKED - LVA	REVISED -
PLOT DATE = 2/17/2015	DATE - 02/17/15	REVISED -

STATE OF ILLINOIS **DEPARTMENT OF TRANSPORTATION**

IL 31 OVER ANIMAL CROSSING CULVERT REMOVAL ALIGNMENT, TIES AND BENCHMARKS SCALE: 1"=20' SHEET 1 OF 1 SHEETS STA.

SECTION 3887 2014-0821


<u>IL RTE 31 ALIGNMENT DATA</u>						
DESCRIPTION	NORTHING	EASTING	STATION			
POINT OF TANGENT	1996375.0241	994709.2090	2000+00.00			
POINT OF TANGENT	1996874.2911	994682.1460	2005+00.00			


SET RAILROAD SPIKE IN WEST SIDE
OF THE POWER POLE ALONG EAST SIDE OF IL 31
NORTHING: 1996316.8650
EASTING: 994743.0050
ELEVATION: 812.10 FT

EXISTING IL RTE 31 Ç —

EXISTING 7.5' X 6' BOX CULVERT —

EX ROW

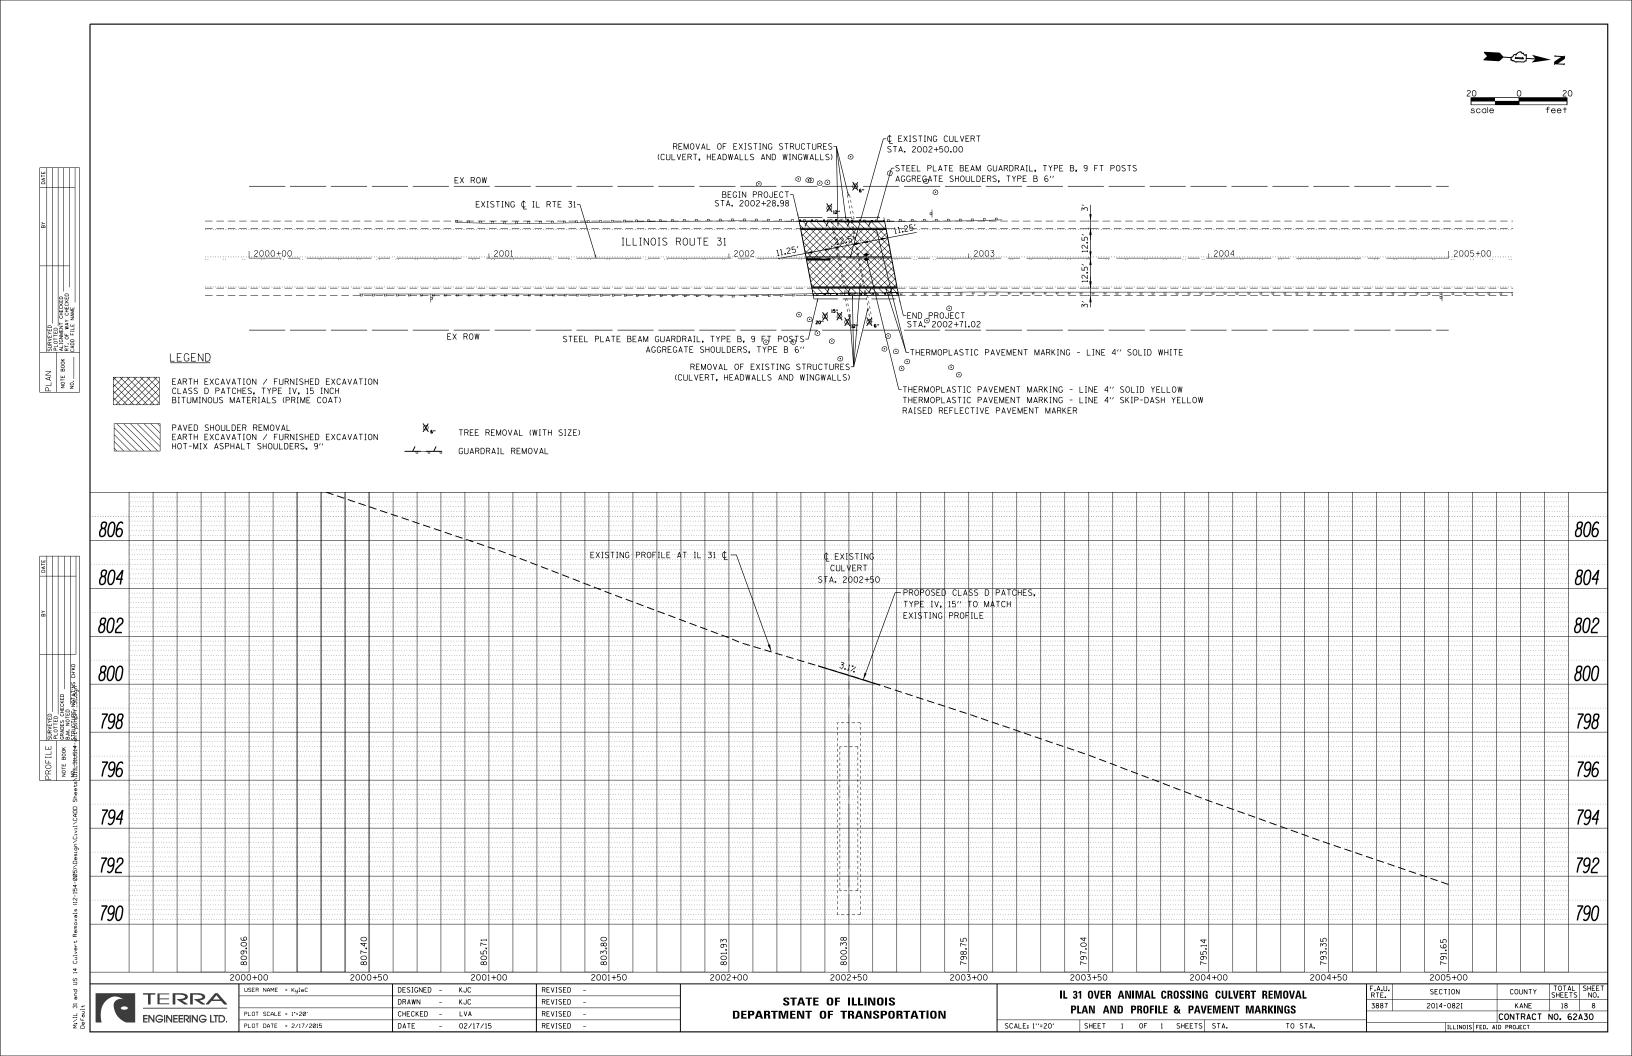

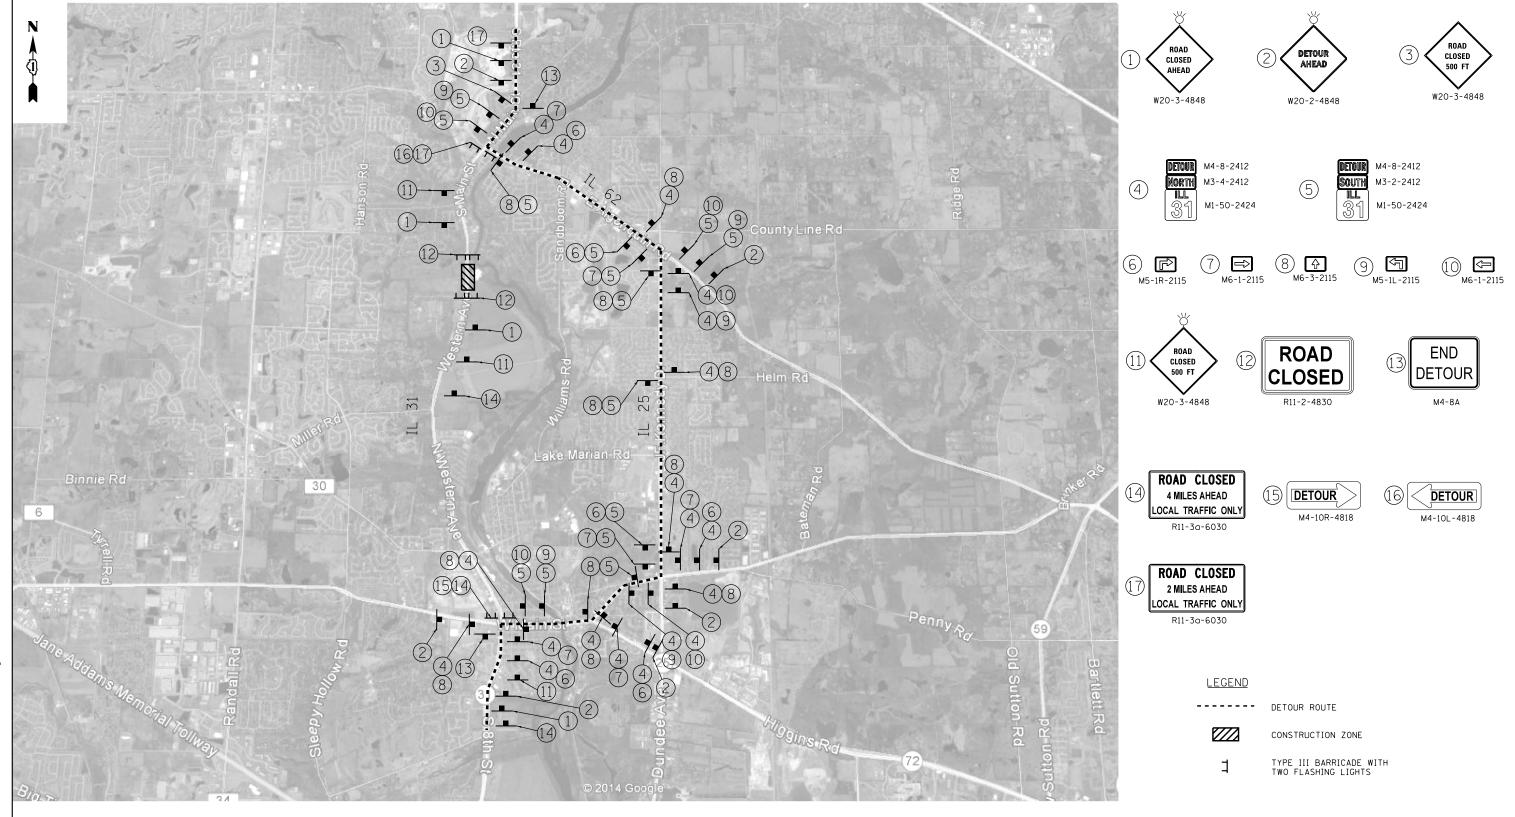

<u>NOTES</u>

SCALE: NTS


- 1. PLACEMENT AND SPACING OF SIGNS AND BARRICADES SHALL BE IN ACCORDANCE WITH TC-21 (DETOUR SIGNING FOR CLOSING STATE HIGHWAYS).
- THE COST OF SUPPLYING, ERECTING AND MAINTAINING BARRICADES, WARNING LIGHTS AND ALL SIGNS, INCLUDING SIGN PANEL OVERLAYS, SHALL BE INCLUDED IN THE CONTRACT COST OF TRAFFIC CONTROL AND PROTECTION (SPECIAL).
- 3. ACCESS TO ALL PRIVATE ENTRANCES SHALL BE MAINTAINED.
- 4. ALL SIGNALIZED INTERSECTIONS ALONG THE DETOUR ROUTE SHALL IMPLEMENT TEMPORARY TRAFFIC SIGNAL TIMING.
- THE FOLLOWING INTERSECTION WILL REQUIRE MAINTENANCE OF EXISTING TRAFFIC SIGNAL INSTALLATION:
 IL RTE 25 AND IL RTE 68



USER NAME = KyleC	DESIGNED -	KJC	REVISED -	
	DRAWN -	KJC	REVISED -	
PLOT SCALE = NTS	CHECKED -	LVA	REVISED -	
PLOT DATE = 2/17/2015	DATE -	02/17/15	REVISED -	

STATE OF ILLINOIS
DEPARTMENT OF TRANSPORTATION

3	31 OVER ANIMAL CROSSING CULVERT REMOVAL					RTE. SECTION COUNTY			TOTAL SHEETS	SHEET NO.		
TRAFFIC CONTROL DETOUR PLAN					3887	2014-0821	KANE	18	9			
						•	CONTRACT	NO. 62	A30			
	SHEET	1	OF	1	SHEETS	STA.	TO STA.		ILLINOIS FED.	AID PROJECT		

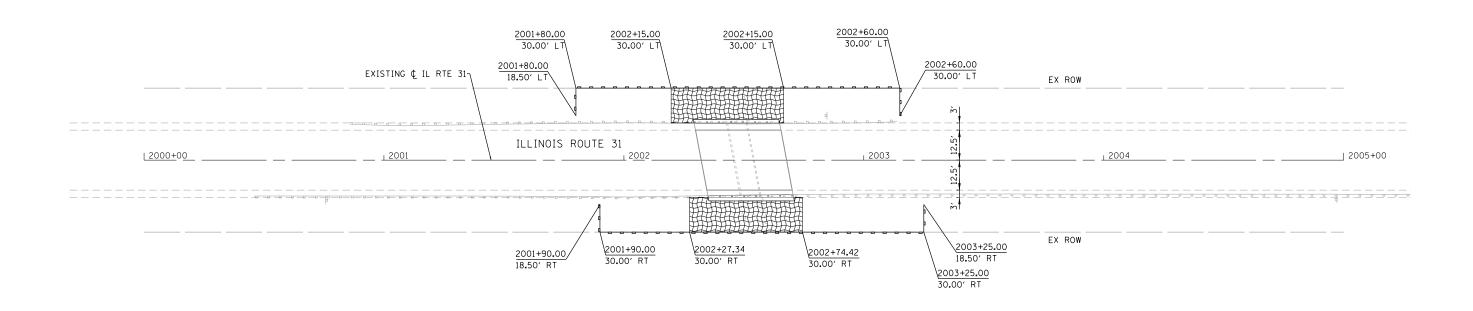

TEMPORARY EROSION CONTROL NOTES

- THE CONTRACTOR SHALL INSTALL PERIMETER EROSION BARRIER PRIOR TO STRIPPING OF VEGETATION.
- 2. RUNOFF FROM EXCAVATION AREAS SHALL LEAVE THE SITE THROUGH SEDIMENT CONTROL DEVICES. THE CONTRACTOR SHALL ADJUST HIS OPERATION AND IMPLEMENT EROSION CONTROL MEASURES ACCORDINGLY.
- 3. THE CONTRACTOR SHALL SURROUND ANY NECESSARY EARTH STOCKPILES WITH PERIMETER EROSION BARRIER. THIS WILL BE INCLUDED IN THE COST OF EARTH EXCAVATION.
- 4. THE CONTRACTOR SHALL MAINTAIN ALL EROSION CONTROL DEVICES AT ALL TIMES. EROSION CONTROL DEVICES SHALL BE INSPECTED EVERY SEVEN CALENDAR DAYS OR WITHIN 24 HOURS AFTER A 1/2 INCH RAINFALL OR SNOWFALL.
- THE CONTRACTOR SHALL SEED ALL DISTURBED AREAS AS SOON AS PRACTICAL AFTER CONSTRUCTION ACTIVITIES IN THAT AREA HAVE BEEN CONCLUDED. AREAS THAT HAVE STEEP SLOPES OR WILL NOT RECEIVE PERMANENT LANDSCAPING SHALL BE TEMPORARILY SEEDED. ALL FLATTER AREAS OR AREAS WHERE NO FURTHER WORK IS TO OCCUR FOR ONE MONTH OR MORE SHALL BE SEEDED AND COVERED WITH AN EROSION CONTROL BLANKET WITHIN SEVEN (7) CALENDAR DAYS.

<u>LEGEND</u>





CLEARING
TEMPORARY EROSION CONTROL SEEDING
TOPSOIL FURNISH AND PLACE, 6"
SEEDING, CLASS 3 (MODIFIED)
HEAVY DUTY EROSION CONTROL BLANKET

PERIMETER EROSION BARRIER



USER NAME = KyleC	DESIGNED	-	KJC	REVISED -
	DRAWN	-	KJC	REVISED -
PLOT SCALE = 1'=20'	CHECKED	-	LVA	REVISED -
PLOT DATE = 2/17/2015	DATE	-	02/17/15	REVISED -

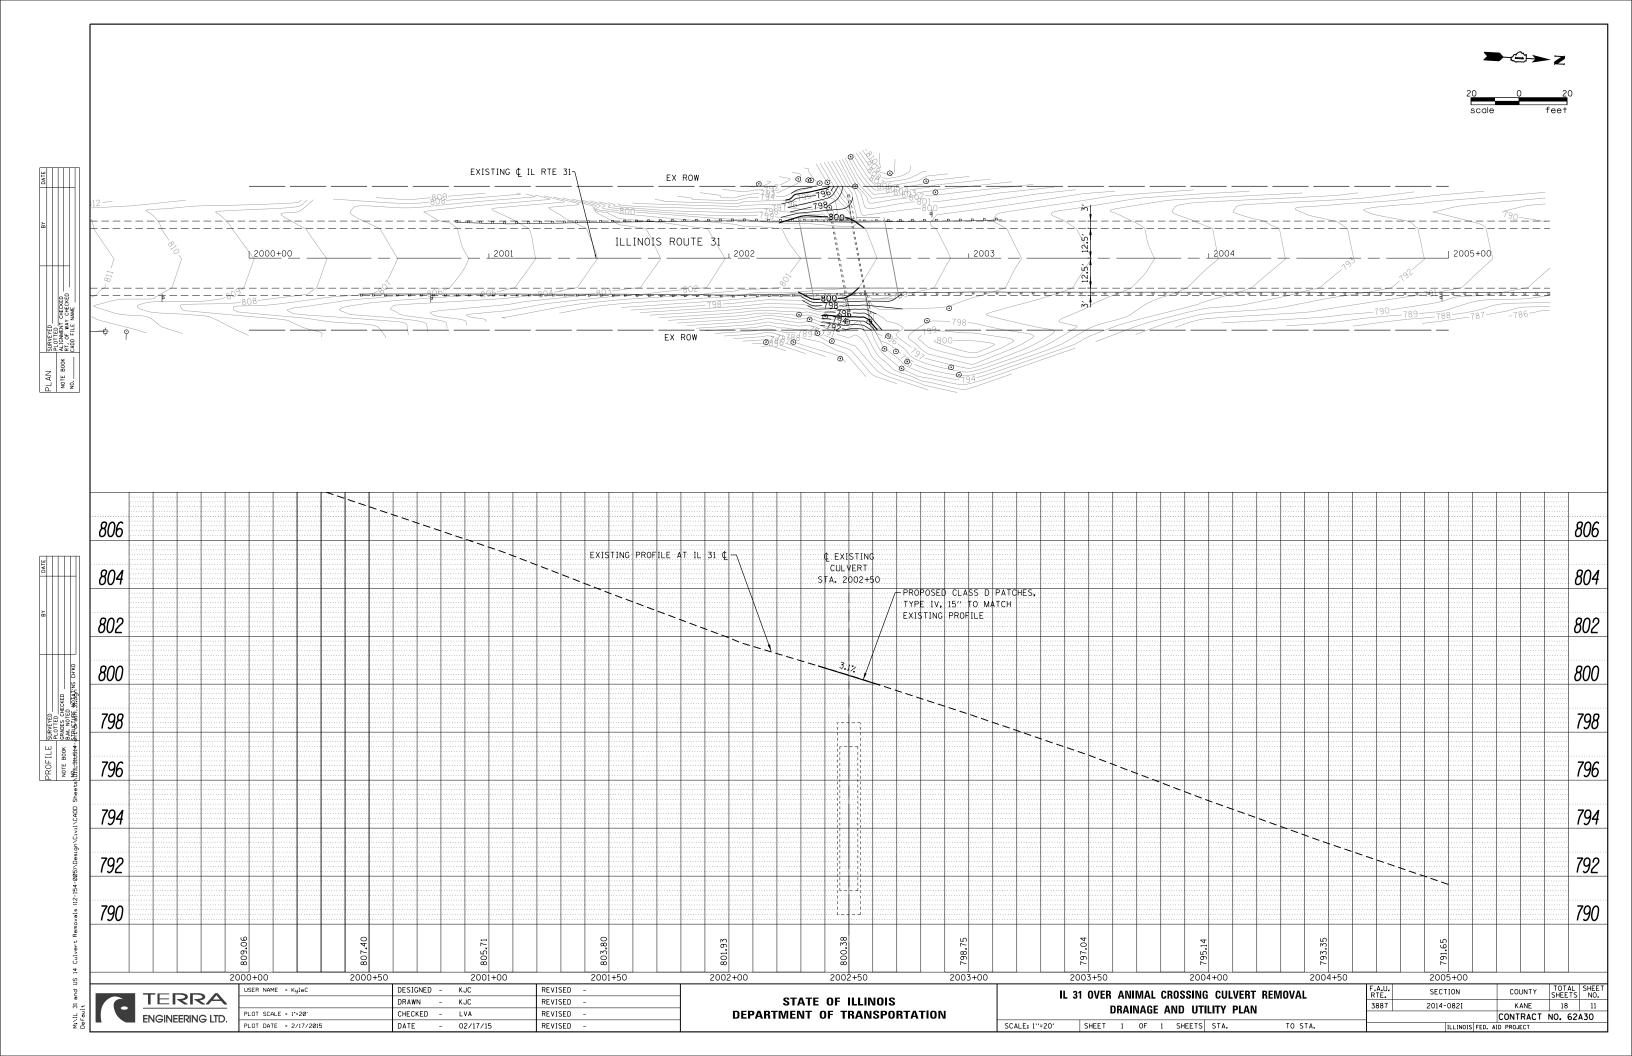

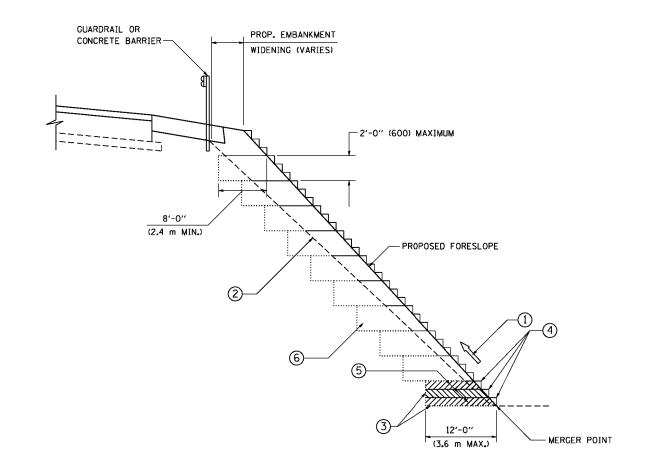

TYPICAL BENCHING DETAIL FOR EMBANKMENT

NOTES:


- CONSTRUCT SUCCEEDING BENCH CUTS AND EMBANKMENT PLACEMENT AND COMPACTION FROM BOTTOM TO TOP IN STAIRSTEP FASHION.
- EXISTING FORESLOPE PREPARED IN ACCORDANCE WITH ARTICLE 205.03
 OF THE STANDARD SPECIFICATIONS.
- 3) BENCH CUT EXISTING SLOPE TYPICAL FOR EACH STEP.
- 4 TRIM TO FINAL SLOPE.
- © EQUAL 8-INCH (200) LIFTS OF EMBANKMENT COMPACTED IN ACCORDANCE WITH ARTICLE 205.05 OF THE STANDARD SPECIFICATIONS.
- 6 EXCAVATION OF BENCH CUTS WITHIN EXISTING EMBANKMENT WILL BE PAID FOR AT THE CONTRACT UNIT PRICE PER CUBIC METER OR CUBIC YARD FOR "EARTH EXCAVATION". THIS PRICE WILL INCLUDE ALL LABOR AND MATERIAL, NO ADDITIONAL COMPENSATION WILL BE ALLOWED.
- 7) SLOPES SHALL BE BENCHED ACCORDING TO THIS DETAIL WHEN THE SLOPE IS STEEPER THAN 4:1 AND THE HEIGHT IS GREATER THAN 5' (1.5 m).

ALL DIMENSIONS ARE IN INCHES (MILLIMETERS) UNLESS OTHERWISE SHOWN.

FILE NAME =	NAME = USER NAME = gaglianobt		·	REVISED -		
W:\d:ststd\22x34\bd51.dgn		DRAWN -	CADD	REVISED	-	
	PLOT SCALE = 50.0000 '/ IN.	CHECKED -	S.E.B.	REVISED	-	
	PLOT DATE = 1/4/2008	DATE -	06-16-04	REVISED	-	

STATE	OF ILLINOIS	
DEPARTMENT (OF TRANSPORTATION	J

BENCHING DETAIL	F.A.U. RTE.	SECTION	COUNTY	TOTAL SHEETS	SHEET NO.
FOR EMBANKMENT WIDENING	3887	2014-082I	KANE	18	12
TON ENDANKMENT WIDENING		BD-51 (MODIFIED)	CONTRACT	NO.	62A30
SCALE: NONE SHEET NO. 1 OF 1 SHEETS STA. TO STA.	FED. R	OAD DIST. NO. 1 ILLINOIS FED. A	D PROJECT		

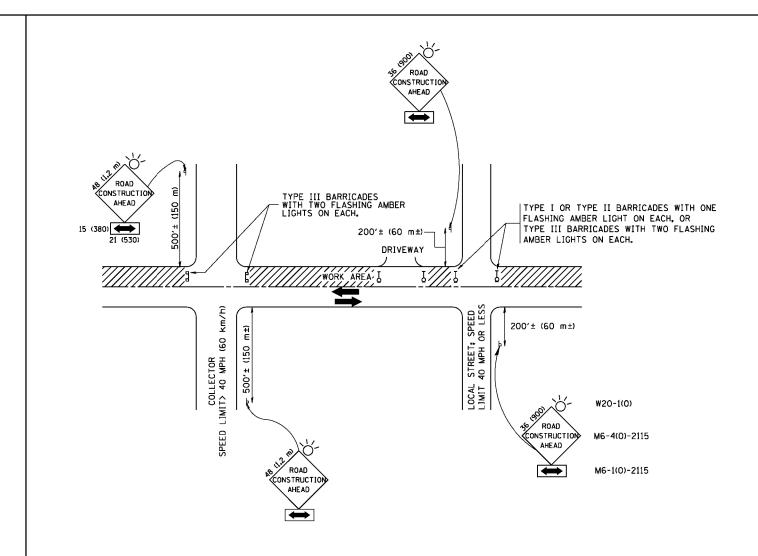

TRAFFIC CONTROL AND PROTECTION FOR SIDE ROADS, INTERSECTIONS, AND DRIVEWAYS

NOTES:

- A. FOR NO LANE RESTRICTION ON THE SIDE ROAD OR DRIVEWAYS
- 1. SIDE ROAD WITH A SPEED LIMIT OF 40 MPH (60 km/h) OR LESS AS SHOWN ON THE DRAWING AND AS DIRECTED BY THE ENGINEER:
- Q) ONE ROAD CONSTRUCTION AHEAD SIGN 36 x 36 (900x900) WITH A FLASHER AND FLAG MOUNTED ON IT APPROXIMATELY 200' (60 m) IN ADVANCE OF THE MAIN ROUTE,
- b) THE CLOSED PORTION OF THE MAIN ROUTE SHALL BE PROTECTED BY BLOCKING WITH TYPE I, TYPE II OR TYPE III BARRICADES, 1/3 OF THE CROSS SECTION OF THE CLOSED PORTION.
- 2. SIDE ROAD WITH A SPEED LIMIT GREATER THAN 40 MPH (60 km/h) AS SHOWN ON THE DRAWING AND AS DIRECTED BY THE ENGINEER:
- d) ONE ROAD CONSTRUCTION AHEAD SIGN 48 x 48 (1.2 m x 1.2 m) WITH A FLASHER MOUNTED ON IT APPROXIMATELY 500' (150 m) IN ADVANCE OF THE MAIN ROLITE.
- b) the closed portion of the main route shall be protected by Blocking with type III Barricades, 1/2 of the cross section of the closed portion.
- 3. WHEN THE SIDE ROAD LIES BETWEEN THE BEGINNING OF THE MAINLINE SIGNING AND THE WORK ZONE, A SINGLE HEADED ARROW (MG-1) SHALL BE USED IN LIEU OF THE DOUBLE HEADED ARROW (MG-4).

SCALE: NONE

B. FOR A LANE CLOSURE ON A SIDE ROAD OR DRIVEWAY:

USE APPLICABLE PORTIONS OF THE TYPICAL APPLICATION OF TRAFFIC CONTROL DEVICES (STD. 701501, STD. 701606 OR THE APPROPRIATE STANDARD). THE SPACING OF SIGNS AND BARRICADES SHALL BE ADJUSTED FOR FIELD CONDITIONS AS DIRECTED BY THE ENGINEER. THE DIRECTIONAL ARROW SHALL BE COVERED OR REMOVED WHEN NO LONGER CONSISTENT WITH THE SIDE ROAD LANE CLOSURE.

- C. ADVANCE WARNING SIGNS ARE TO BE OMITTED ON DRIVEWAY UNLESS OTHERWISE NOTED.
- D. THE TRAFFIC CONTROL AND PROTECTION FOR SIDE ROADS, INTERSECTIONS, AND DRIVEWAYS SHALL BE INCIDENTAL TO THE COST OF SPECIFIED TRAFFIC CONTROL STANDARDS OR ITEMS.


All dimensions are in millimeters (inches) unless otherwise shown.

FILE NAME =	USER NAME = gaglianobt	DESIGNED - LHA	REVISED - J. OBERLE 10-18-95
W:\d:ststd\22x34\tc10.dgn		DRAWN -	REVISED - A. HOUSEH 03-06-96
	PLOT SCALE = 50.000 '/ IN.	CHECKED -	REVISED - A. HOUSEH 10-15-96
	PLOT DATE = 1/4/2008	DATE - 06-89	REVISED -T. RAMMACHER 01-06-00

STATI	E OF	ILLINOIS
DEPARTMENT	0F	TRANSPORTATION


TRAFFIC CONTROL AND PROTECTION I	F.A.U. RTE.	SECTION	
SIDE ROADS, INTERSECTIONS, AND DRIVE	NAVC	3887	2014-0821
SIDE RUADS, INTERSECTIONS, AND DRIVE	WAIO		TC-10
CHEET NO 1 OF 1 CHEETE CTA	TO STA	FF0 D0	


3887 2014-0821 KANE 18 1 TC-10 CONTRACT NO. 62A	RTE. SECTION COUNTY	SHEETS	NO.
TC_10 CONTRACT NO. 62A	3887 2014-082I KANE	18	13
CONTINUE OFF	TC-10 CONTRACT	NO. 6	2A30
FED. ROAD DIST. NO. 1 ILLINOIS FED. AID PROJECT	FED. ROAD DIST. NO. 1 ILLINOIS FED. AID PROJECT		

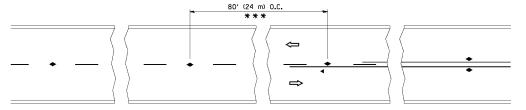


*** REDUCE TO 40' (12 m) O.C. ON CURVES WITH POSTED OR ADVISORY SPEED 45 M.P.H. (70 km/h) OR LESS.

TWO-LANE/TWO-WAY

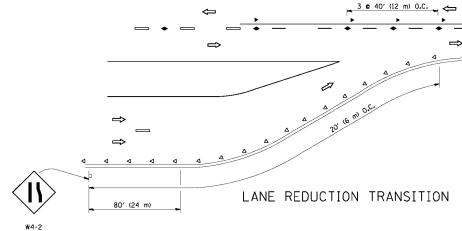


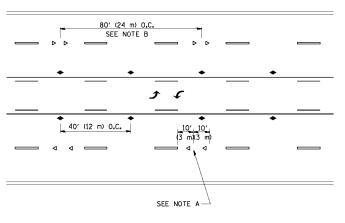

TWO-WAY LEFT TURN

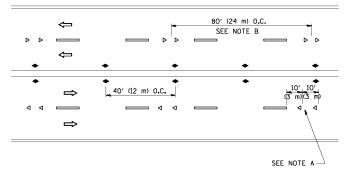

MULTI-LANE/UNDIVIDED

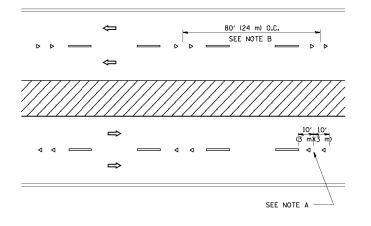

MULTI-LANE/DIVIDED

GENERAL NOTES

- 1. MARKERS USED WITH DASHED LINES SHALL BE CENTERED IN THE GAP BETWEEN SEGMENTS.
- 2. MARKERS USED ADJACENT TO SOLID LINES SHALL BE OFFSET 2 TO 3 (50 TO 75) TOWARD TRAFFIC AS SHOWN.
- MARKERS THROUGH TANGENTS LESS THAN 500' (150 m) IN LENGTH BETWEEN CURVES SHALL BE INSTALLED AT THE LESSER OF THE TWO CURVE SPACINGS.

LANE MARKER NOTES

A. USE DOUBLE LANE LINE MARKERS SPACED AS SHOWN.

B. REDUCE TO 40' (12 m) O.C. ON CURVES WHERE ADVISORY SPEEDS ARE 10 M.P.H (20 km/h) LOWER THAN POSTED SPEEDS.

SYMBOLS

---- YELLOW STRIPE

WHITE STRIP

- ONE-WAY AMBER MARKER
- ONE-WAY CRYSTAL MARKER (₩/O)
- ◆ TWO-WAY AMBER MARKER

DESIGN NOTES


- 1. DOUBLE LANE LINE MARKERS SHALL BE USED UNLESS SPECIFIED OTHERWISE.
- EXCEPT AS SHOWN ON THE LANE REDUCTION TRANSITION AND FREEWAY EXIT RAMP DETAIL, MARKERS ARE NOT TO BE SPECIFIED ON RIGHT EDGE LINES.
- 3. THE EXACT MARKER LIMITS, SPACING, AND COLOR SHALL BE INCLUDED IN THE PLANS WHEN STANDARD SPECIFICATIONS ARE NOT BEING USED.
- 4. MARKERS SHOULD NOT BE USED ALONGSIDE CURBS EXCEPT FOR EXTREMELY SHORT SECTIONS OF CURBS WHERE NOT MORE THAN TWO MARKERS WOULD BE INVOLVED.

All dimensions are in inches (millimeters)

unless otherwise shown.

LEFT TURN

FILE NAME =	USER NAME = leysa	DESIGNED -	REVISED - T. RAMMACHER 09-19-94			TYPICAL APPLICATIONS	F.A.U. RTF	SECTION	COUNTY	TOTAL S	HEET NO.
c:\pw_work\pwidot\leysa\dØ108315\tc11.dgn	1	DRAWN -	REVISED -T. RAMMACHER 03-12-99	STATE OF ILLINOIS			3887	2014-0821	KANE	18	14
	PLOT SCALE = 50.000 '/ IN.	CHECKED -	REVISED -T. RAMMACHER 01-06-00	DEPARTMENT OF TRANSPORTATION				TC-11	CONTRACT	NO. 62	A30
	PLOT DATE = 3/2/2011	DATE -	REVISED - C. JUCIUS 09-09-09		SCALE: NONE	SHEET NO. 1 OF 1 SHEETS STA. TO STA.	FFD. ROAD	DIST. NO. 1 ILLINOIS FED.	AID PROJECT		

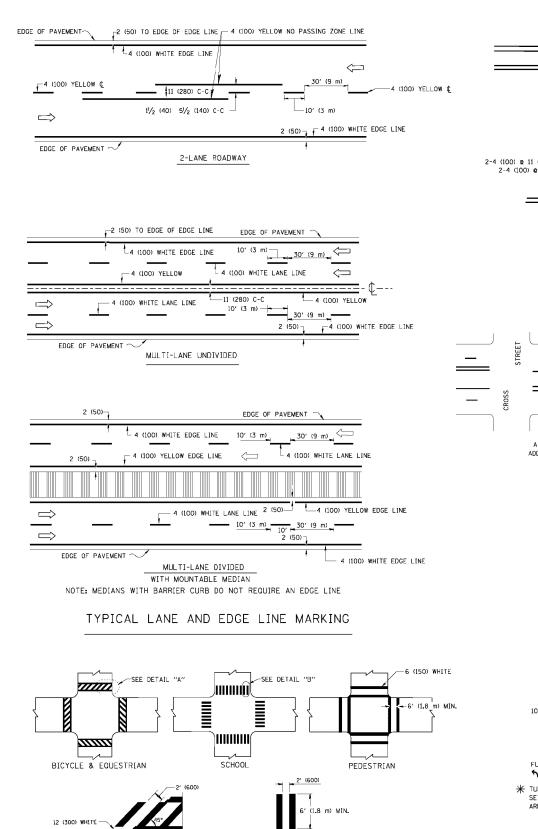


2-4 (100) YELLOW © 11 (280) C-C

NO DIAGONALS

4' (1.2 m) OUTSIDE TO OUTSIDE OF LINES


2-4 (100) YELLOW © 11 (280) C-C

4' (1.2 m) WIDE MEDIANS ONLY

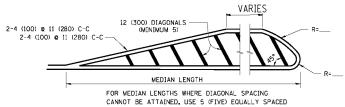


DIAGONAL LINE SPACING: 50' (15 m) C-C (LESS THAN 30MPH (50 km/h))
75' (25 m) C-C 30MPH (50 km/h) T0 45MPH (70 km/h))
150' (45 m) C-C (WORE THAN 45MPH (70 km/h))

MEDIANS OVER 4' (1.2 m) WIDE

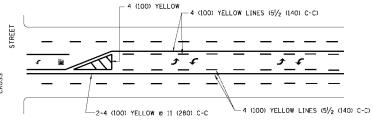


A MINIMUM OF TWO PAIRS OF TURN ARROWS SHALL BE USED, WHITE IN COLOR, ADDITIONAL PAIRS SHALL BE PLACED AT 200' (60 m) TO 300' (90 m) INTERVALS.

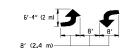

MEDIAN WITH TWO-WAY LEFT TURN LANE

TYPICAL PAINTED MEDIAN MARKING

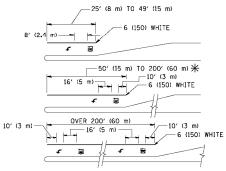


FULL SIZE LETTERS 8' (2.4 m) AND ARROWS SHALL BE USED. \P AREA = 15.6 SQ. FT. (1.5 m²) \P AREA = 20.8 SQ. FT. (1.9 m²)

* TURN LANES IN EXCESS OF 400' (120 m) IN LENGTH MAY HAVE AN ADDITIONAL SET OF ARROW - "ONLY" INSTALLED MIDWAY BETWEEN THE OTHER TWO SETS OF ARROW - "ONLY".

TYPICAL LEFT (OR RIGHT) TURN LANE

TYPICAL TURN LANE MARKING

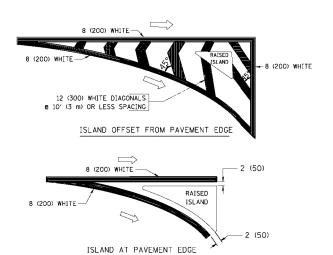

TYPICAL ISLAND MARKING

TYPE OF MARKING	WIDTH OF LINE	PATTERN	COLOR	SPACING / REMARKS
CENTERLINE ON 2 LANE PAVEMENT	4 (100)	SKIP-DASH	YELLOW	10' (3 m) LINE WITH 30' (9 m) SPACE
CENTERLINE ON MULTI-LANE UNDIVIDED PAVEMENT	2 @ 4 (100)	SOLID	YELLOW	11 (280) C-C
NO PASSING ZONE LINES: FOR ONE DIRECTION FOR BOTH DIRECTIONS	4 (100) 2 @ 4 (100)	SOLID SOLID	YELLOW YELLOW	5/ ₂ (140) C-C FROM SKIP-DASH CENTERLINE 11 (280) C-C OMIT SKIP-DASH CENTERLINE BETWEEN
LANE LINES	4 (100) 5 (125) ON FREEWAYS	SKIP-DASH SKIP-DASH	WHITE WHITE	10' (3 m) LINE WITH 30' (9 m) SPACE
DOTTED LINES (EXTENSIONS OF CENTER, LANE OR TURN LANE MARKINGS)	SAME AS LINE BEING EXTENDED	SKIP-DASH	SAME AS LINE BEING EXTENDED	2' (600) LINE WITH 6' (1.8 m) SPACE
EDGE LINES	4 (100)	SOLID	YELLOW-LEFT WHITE-RIGHT	OUTLINE MOUNTABLE MEDIANS IN YELLOW; EDGE LINES ARE NOT USED NEXT TO BARRIER CURB
TURN LANE MARKINGS	6 (150) LINE; FULL SIZE LETTERS & SYMBOLS (8' (2.4m))	SOLID	WHITE	SEE TYPICAL TURN LANE MARKING DETAIL
TWO WAY LEFT TURN MARKING	2 @ 4 (100) EACH DIRECTION	SKIP-DASH AND SOLID	YELLOW	10' (3 m) LINE WITH 30' (9 m) SPACE FOR SKIP-DASH; 51/2 (140) C-C BETWEEN SOLID LINE AND SKIP-DASH LINE
	8' (2.4m) LEFT ARROW	IN PAIRS	WHITE	SEE TYPICAL TWO-WAY LEFT TURN MARKING DETAIL
CROSSWALK LINES (PEDESTRIAN) A. DIAGONALS (BIKE & EQUESTRIAN) B. LONGITUDINAL BARS (SCHOOL)	2 e 6 (150) 12 (300) e 45° 12 (300) e 90°	SOLID SOLID SOLID	WHITE WHITE WHITE	NOT LESS THAN 6' (1.8 m) APART 2' (600) APART 2' (600) APART SEE TYPICAL CROSSWALK MARKING DETAILS.
STOP LINES	24 (600)	SOLID	WHITE	PLACE 4' (1,2 m) IN ADVANCE OF AND PARALLEL TO CROSSWALK, IF PRESENT, OTHERWISE, PLACE AT DESIRED STOPPING POINT, PARALLEL TO CROSSROAD CENTERLINE, WHERE POSSIBLE
PAINTED MEDIANS	2 @ 4 (100) WITH 12 (300) DIAGONALS	SOLID	YELLOW: TWO WAY TRAFFIC	11 (280) C-C FOR THE DOUBLE LINE
	© 45° NO DIAGONALS USED FOR 4' (1.2 m) WIDE MEDIANS		WHITE: ONE WAY TRAFFIC	SEE TYPICAL PAINTED MEDIAN MARKING.
GORE MARKING AND CHANNELIZING LINES	8 (200) WITH 12 (300) DIAGONALS @ 45°	SOLID	WHITE	DIAGONALS: 15' (4.5 m) C-C (LESS THAN 30MPH (50 km/h)) 20' (6 m) C-C 30MPH (50 km/h) TO 45MPH (70 km/h)) 30' (9 m) C-C (OVER 45MPH (70 km/h))
RAILROAD CROSSING	24 (600) TRANSVERSE LINES; "RR" IS 6' (1.8 m) LETTERS; 16 (400) LINE FOR "X"	SOLID	WHITE	SEE STATE STANDARD 780001 AREA OF: "R"=3.6 SO. FT. (0.33 m²) EACH "X"=54.0 SO. FT. (5.0 m²)
SHOULDER DIAGONALS	12 (300) c 45°	SOLID	WHITE - RIGHT YELLOW - LEFT	50' (15 m) C-C (LESS THAN 30MPH (50 km/h)) 75' (25 m) C-C (30 MPH (50 km/h) TO 45MPH (70 km/h)) 150' (45 m) C-C (0VER 45MPH (70 km/h))

FOR FURTHER DETAILS ON PAVEMENT MARKING REFER TO STANDARD SPECIFICATIONS FOR ROAD AND BRIDGE CONSTRUCTION AND STATE STANDARD 780001.

All dimensions are in inches (millimeters) unless otherwise shown.

FILE NAME =	USER NAME = drivakosgn	DESIGNED	-	EVERS	REVISED	-T.	RAMMACHER	10-27-94
c:\pw_work\pwidot\drivakosgn\d0108315\tc	13.dgn	DRAWN	-		REVISED	- C.	JUCIUS	09-09-09
	PLOT SCALE = 50.000 '/ IN.	CHECKED	-		REVISED	-		
	PLOT DATE = 9/9/2009	DATE	-	03-19-90	REVISED	-		

12 (300) WHITE

DETAIL "B"

6 (150) WHITE

TYPICAL CROSSWALK MARKING

DETAIL "A"

STATE OF	ILLINOIS
DEPARTMENT OF	TRANSPORTATION

	DISTRICT ONE TYPICAL PAVEMENT MARKINGS						SECTION	COUNTY	TOTAL SHEETS	
-							2014-0821	KANE	18	15
-	ITFICAL FAVENIENT INARKINGS						TC-13	CONTRACT	NO.	62A30
-	SCALE: NONE	SHEET NO. 1 OF 1	SHEETS	STA.	TO STA.	FED. ROAD DIST. NO. 1 ILLINOIS FED. AID PROJECT				

