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STATE OF ILLINOIS DEPARTMENT OF TRANSPORTATION DIVISION OF HIGHWAYS

PLANS FOR PROPOSED STREET IMPROVEMENTS

CITY OF URBANA CHAMPAIGN COUNTY, ILLINOIS CITY SECTION NO. 07-00456-00-RS PROJECT NO. HSIP-5181(41) JOB NO. C-95-317-08


GOODWIN AVENUE - F.A.U. ROUTE 7175

PEDESTRIAN AND BICYCLE SAFETY IMPROVEMENTS **GREGORY DRIVE TO SPRINGFIELD AVENUE**

R. 9 E.

ILLINOIS HIGHWAY STANDARD DRAWINGS (SEE SHEET NO. 3)

STA. 596+65-00

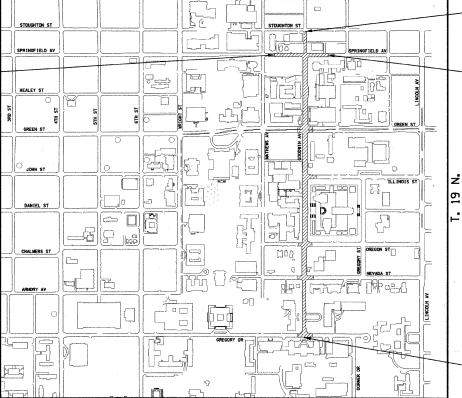

LOCATION MAP

= 3,383.00 FEET = 0.64 MILES

= 3,974.00 FEET = 0.75 MILES

= 0.11 MILES

= 591.00 FEET

TOTAL LENGTH OF GOODWIN AVENUE IMPROVEMENT

TOTAL LENGTH OF SPRINGFIELD AVENUE IMPROVEMENT

STA. 602+56.00 ENGINEER REGISTERED PROFESSIONAL ENGINEER LICENSE EXPIRES 11/30/09

FUNCTIONAL CLASSIFICATION = COLLECTOR ADT = 5400


STA. 10+00.00


END IMPROVEMENTS GOODWIN AVENUE STA. 43+83.00

PROFESSIONAL ENGINEER CLARK DIETZ, INC. FOR SHEETS 1-63 AND 72-75

01/09/2009 LICENSE EXPIRES 11-30-09

CHAMPAIGN 75 1 07-00456-00-RS FED. ROAD DIST. NO. ILLINOIS CONTRACT NO. 91392

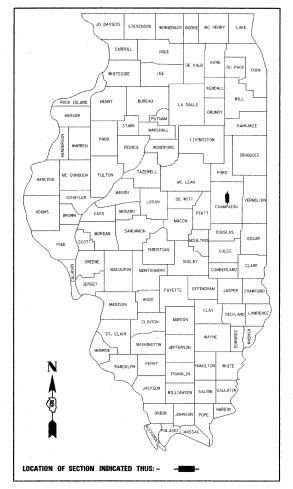

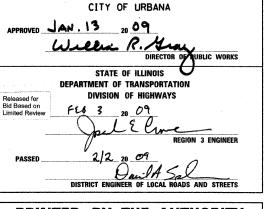

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1817 SOUTH NEIL STREET SUITE 100 CHAMPAIGN, IL 61820 PHONE : 217.373.8900 FAX : 217.373.8923

ENGINEERING SCALES. REDUCED SIZED PLANS WILL NOT CONFORM TO STANDARD SCALES. IN MAKING MEASUREMENTS ON REDUCED PLANS, THE ABOVE SCALES MAY BE USED.

JOINT UTILITY LOCATION INFORMATION FOR EXCAVATION 1-800-892-0123

CONTRACT NO. 91392

P:\U0070052\Plans\sheets\01-Cover.dgn 1/8/2009 3:54:29 PM

GENERAL NOTES

- 1. ALL ELEVATIONS SHOWN ARE REFERRED TO THE N.G.V.D. 1929 DATUM.
- 2. WHEREVER IN THE PLANS OR SPECIFICATIONS THE TERM "STANDARD SPECIFICATIONS" IS USED IT SHALL BE UNDERSTOOD BY THE CONTRACTOR TO MEAN THE "STANDARD SPECIFICATIONS FOR ROAD AND BRIDGE CONSTRUCTION" AS PREPARED BY THE DEPARTMENT OF TRANSPORTATION OF THE STATE OF ILLINOIS AND ADDPTED ON JANUARY 1, 2007.
- 3. WHEREVER IN THE PLANS OR SPECIFICATIONS THE TERMS "STANDARD SPECIFICATIONS FOR WATER MAIN CONSTRUCTION" OR "STANDARD SPECIFICATIONS FOR SEWER CONSTRUCTION" ARE USED IT SHALL BE UNDERSTOOD BY THE CONTRACTOR TO MEAN THE "STANDARD SPECIFICATIONS FOR WATER AND SEWER MAIN CONSTRUCTION IN ILLINOIS" AS PREPARED BY I.S.P.E., A.G.C.I., I.M.L., AND U.C.A., ADDPTED MAY 1996.
- 4. ANY REFERENCE TO STANDARDS THROUGHOUT THE PLANS SHALL BE INTERPRETED TO BE THE LATEST STANDARDS OF THE DEPARTMENT AS SHOWN ON THE HIGHWAY STANDARDS AND LEGEND SHEET NO. 3.
- 5. IT IS THE CONTRACTOR'S RESPONSIBILITY TO ASCERTAIN EXISTING FIELD CONDITIONS BEFORE BIDDING ON THE PROJECT.
- 6. THE CONTRACTOR WILL BE REQUIRED TO COMPLY WITH STATE REGULATIONS REGARDING AIR, WATER, AND NOISE POLLUTION,
- 7. THE CONTRACTOR SHALL TAKE CARE NOT TO STORE OR DISPOSE OF DEBRIS OR UNSUITABLE MATERIALS WITHIN LIMITS OF THE IMPROVEMENT AND TAKE CARE TO LIMIT CONSTRUCTION TO WITHIN THE RIGHT-OF-WAY AND EASEMENT AREAS. UNNECESSARY ENCROACHMENTS ONTO PRIVATE OR PUBLIC AREAS WILL NOT BE ALLOWED.
- 8. WHERE SECTION OR SUBSECTION MONUMENTS, BENCHMARKS, OR IRON PIPE MONUMENTS ARE ENCOUNTERED, THE ENGINEER SHALL BE NOTIFIED BEFORE SUCH MONUMENTS ARE REMOVED, THE CONTRACTOR SHALL PROTECT AND CAREFULLY PRESERVE ALL MONUMENTS UNTIL AN ILLINOIS REGISTERED LAND SURVEYOR OR AGENT HAS WITNESSED OR OTHERWISE REFERENCED THEIR LOCATION. THE CONTRACTOR WILL BE RESPONSIBLE FOR HAVING AN ILLINOIS REGISTERED LAND SURVEYOR RE-ESTABLISH ANY MONUMENTS UNNECESSARILY DESTROYED BY HIS OPERATIONS.
- 9. ALL STREET RETURNS HAVE RADII DESIGNATED TO THE EDGE OF PAVEMENT UNLESS OTHERWISE NOTED ON THE PLANS.
- 10. THE EXCAVATION FOR THIS PROJECT IS CLASSIFIED AS EARTH EXCAVATION IN ACCORDANCE WITH SECTION 202 OF THE STANDARD SPECIFICATIONS AND AS PROVIDED IN THE CONTRACT SPECIFICATIONS. THE EARTH EXCAVATION SHALL INCLUDE THE REMOVAL OF EARTH AND UNCLASSIFIED MATERIALS. THE CONTRACTOR SHALL NOTIFY ALL UTILITY COMPANIES AND AGENCIES PRIOR TO EXCAVATION OPERATIONS. EARTH EXCAVATION WILL NOT BE MEASURED FOR PAYMENT BUT SHALL BE CONSIDERED INCLUDED IN THE COST OF THE SPECIFIC CONSTRUCTION PAY ITEM REQUIRING THE EXCAVATION, AND NO ADDITIONAL COMPENSATION WILL BE ALLOWED. THE REMAINING EXCAVATION IS CLASSIFIED AS PAVEMENT REMOVAL, COMBINATION CURB AND GUTTER REMOVAL, AND SIDEWALK REMOVAL
- 11. TREES TO BE REMOVED: THE INDICATED TREES (INCLUDING STUMPS) TO BE REMOVED SHALL BE SUITABLY MARKED BY THE ENGINEER BEFORE TREE REMOVAL OPERATIONS BEGIN. ALL TREES, STUMPS AND ROOTS SHALL BE COMPLETELY REMOVED AND DISPOSED OF. THIS WORK SHALL BE INCLUDED IN THE COST OF THE REMOVAL AND NO ADDITIONAL COMPENSATION WILL BE ALLOWED.
- 12. TREES TO BE SAVED: PARTICULAR EFFORT SHALL BE MADE TO SAVE ALL DESIRABLE EXISTING TREES OR SHRUBS. ONLY A MINIMUM OF GRADING WILL BE PERMITTED AROUND TREES AS DETERMINED BY THE ENGINEER. THE CONTRACTOR WILL BE HELD RESPONSIBLE FOR UNNECESSARY DAMAGE TO TREES, SHRUBS, OR LANDSCAPING INTENDED TO BE SAVED. SNOW FENCE SHALL BE ERECTED TEN FEET FROM TREES AND SHRUBS TO REMAIN THAT ARE IMMEDIATELY ADJACENT TO THE WORK, AS DIRECTED BY THE ENGINEER. THIS WORK WILL NOT BE PAID FOR SEPARATELY AND NO ADDITIONAL COMPENSATION WILL BE ALLOWED.
- 13. TREES TO BE PRUNED: TREE PRUNING WILL BE PERFORMED BY THE CITY OF URBANA. THE CONTRACTOR SHALL NOTIFY THE CITY OF URBANA OF TREES THAT WILL REQUIRE PRUNING A MINIMUM OF 48 HOURS IN ADVANCE OF THE WORK.
- 14. THE EXISTING TRAFFIC SIGNS AND POSTS WHICH INTERFERE WITH THE CONSTRUCTION SHALL BE REMOVED AND RESET, AS THE CASE MAY BE, AS DIRECTED BY THE ENGINEER. THIS WORK SHALL BE PERFORMED IN ACCORDANCE WITH ARTICLE 107.25 OF THE STANDARD SPECIFICATIONS. EXISTING SIGNS THAT WILL NOT BE RESET SHALL BE RETURNED TO THE CITY OF URBANA'S PUBLIC WORKS GARAGE AT TO SOUTH GLOVER AVENUE. REFER TO THE SPECIAL PROVISIONS FOR "TRAFFIC CONTROL COMPLETE" AND "REMOVING AND RESETTING STREET SIGNS" FOR ADDITIONAL INFORMATION ON REMOVING AND RESETTING THE EXISTING TRAFFIC SIGNS.
- 15. ONLY EXISTING PAVEMENTS AND BASE COURSES COMPOSED OF PORTLAND CEMENT CONCRETE, HOT-MIX ASPHALT, OR BRICK SHALL BE MEASURED AND PAID FOR AS PAVEMENT REMOVAL IN ACCORDANCE WITH SECTION 440 OF THE STANDARD SPECIFICATIONS, NO ADDITIONAL COMPENSATION WILL BE ALLOWED FOR PAVEMENT REMOVAL ITEMS DUE TO VARIATIONS IN THE EXISTING PAVEMENT TYPE, THICKNESS, OR AMOUNT OF REINFORCEMENT. THE ADJUSTMENT OF QUANTITIES AS SPECIFIED IN ARTICLE 440.07 OF THE STANDARD SPECIFICATIONS SHALL NOT APPLY, REMOVAL OF OTHER TYPES OF PAVEMENT COMPOSITION SUCH AS AGGREGATE OR OIL AND CHIP SHALL BE CLASSIFIED AS EARTH EXCAVATION.
- 16. THE FINISHED EARTHWORK SHALL HAVE VEGETATIVE SUSTAINING SOIL COVERING THE TOP 6 INCHES IN AREAS TO BE SODDED OR SEEDED. THE TOPSOIL REQUIRED WILL BE PAID FOR AT THE CONTRACT UNIT PRICE PER SQUARE YARD FOR TOPSOIL FURNISH AND PLACE, 6". 12 INCHES OF TOPSOIL SHALL BE FURNISHED AT THE LOCATIONS SHOWN ON THE PLANS. THE TOPSOIL REQUIRED FOR THIS WORK WILL BE PAID FOR AT THE CONTRACT UNIT PRICE PER SQUARE YARD FOR TOPSOIL FURNISH AND PLACE 12".
- 17. ALL DISTURBED AREAS SHALL BE SODDED OR SEEDED AS SHOWN ON THE PLANS. SEEDING, SODDING, AND MULCHING SHALL BE DONE AS SOON AS EACH STAGE IS COMPLETED AS DIRECTED BY THE ENGINEER. EXISTING TURF WHICH IS DAMAGED OUTSIDE THE LIMITS OF RIGHT-OF-WAY, EASEMENTS OR CONSTRUCTION SHALL BE REESTABLISHED WITH SOD OR SEED AS DIRECTED BY THE ENGINEER AT THE CONTRACTOR'S EXPENSE.
- 18. THE ENGINEER SHALL BE THE SOLE JUDGE CONCERNING CURING TIME FOR THE VARIOUS HOT-MIX ASPHALT LIFTS.
- 19. THE FOLLOWING RATES OF APPLICATION HAVE BEEN ASSUMED IN CALCULATING PLAN QUANTITIES:

BITUMINOUS PRIME COAT - PAVED SURFACE (CSS-1) 0.05 TO 0.10 GAL/SQ YD AGGREGATE BASE (MC-30) 0.25 TO 0.50 GAL/SQ YD

AGGREGATE PRIME COAT - PAVED SURFACE HOT-MIX ASPHALT (ALL TYPES)

AGGREGATE MATERIALS

4 LBS/SQ YD 112 LBS/SQ YD/INCH THICK 2.05 TON/CU YD

- AGGREGATE MATERIALS

 2.05 TOWN OF THE CONTRACTOR TO DETERMINE THE REACT LOCATION AS SHOWN OR THAT ALL UTILITY COMPANIES AND THEIR ACCURACY SHOULD BE CONSIDERED APPROXIMATE. NO RESPONSIBILITY IS ACCEPTED FOR THE LOCATIONS AS SHOWN OR THAT ALL UTILITY FACILITIES ARE SHOWN. UTILITY LOCATIONS SHOWN IN THE PLANS ARE APPROXIMATE AND REPRESENT LOCATIONS PRIDE TO ANY UTILITY RELOCATIONS REQUIRED TO ACCOMPODATE THE PROPOSED CONSTRUCTION. THE CONTRACT OF SHOWN IN THE PLANS ARE APPROXIMATE AND REPRESENT LOCATIONS PRIDE TO ANY UTILITES PRIDE TO THE START OF CONSTRUCTION DIPER THIS CONTRACT. BEFORE COMMENCING CONSTRUCTION OPERATIONS THE CONTRACTOR SHALL OBTAIN FROM THE ENGINEER ANY AVAILABLE INFORMATION RECARDING THE RELOCATED POSITIONS OF UTILITIES WHITHIN THE PROJECT LIMITS. WHETHER VARIOUS UTILITIES HAVE BEEN RELOCATED OR REMAIN IN THEIR ORIGINAL LOCATION, IT SHALL BE THE RESPONSIBILITY OF THE CONTRACTOR TO DETERMINE THEIR EXACT LOCATION AT THE TIME OF CONSTRUCTION AND TO PROTECT SAME. THE CONTRACTOR SHALL ALSO BE RESPONSIBLE FOR AVOIDING CONFLICTS BETWEEN OVERHEAD UTILITY LINES AND THE EQUIPMENT USED DURING CONSTRUCTION. SEE "STATUS OF UTILITIES" SHEET WITHIN THE SPECIAL PROVISIONS FOR ADDITIONAL INFORMATION REGARDING KNOWN UTILITY RELOCATIONS OR ADJUSTMENTS REQUIRED FOR THE PROPOSED CONSTRUCTION. THE CONTRACTOR'S ATTENTION IS DIRECTED TO THE SPECIAL PROVISION ENTITLED "COOPERATION WITH UTILITIES" AND ARTICLE 107.31 OF THE STANDARD SPECIFICATIONS.
- 21. THE CONTRACTOR SHALL COORDINATE CONSTRUCTION ACTIVITIES WITH UTILITY COMPANIES.
- 22. THE CONTRACTOR SHALL BE RESPONSIBLE FOR PROTECTING UTILITY PROPERTY FROM CONSTRUCTION OPERATIONS AS OUTLINED IN ARTICLE 107.31 OF THE STANDARD SPECIFICATIONS. THE JULIE NUMBER IS 800-892-0123. THE UNIVERSITY OF ILLINOIS LOCATE SERVICE NUMBER IS 217-333-3463.

 A MINIMUM OF 48 HOURS ADVANCE NOTICE IS REQUIRED.
- 23. UTILITY OWNERS:
 *INDICATES J.U.L.I.E. MEMBER
 - * AMEREN IP 1112 WEST ANTHONY DRIVE URBANA, ILLINOIS 61803 (217) 383-7280
 - * AT&T 201 SOUTH NEIL STREET CHAMPAIGN, ILLINOIS 61820 (217) 398-7990
- * CITY OF URBANA PUBLIC WORKS 706 SOUTH GLOVER AVENUE URBANA, ILLINOIS 61802 (217) 384-2385
- * COMCAST 303 FAIRLAWN DRIVE URBANA, ILLINOIS 61801 (217) 384-2510
- * ILLINOIS AMERICAN WATER 201 DEVONSHIRE DRIVE CHAMPAIGN, ILLINOIS 61820 (217) 373-3258
- *UNIVERSITY OF ILLINOIS FACILITIES AND SERVICES PHYSICAL PLANT SERVICE BUILDING 1501 SOUTH OAK STREET CHAMPAIGN, ILLINOIS 61820 (217) 333-8484
- UNIVERSITY OF ILLINOIS
 CAMPUS INFORMATION TECHNOLOGIES
 AND EDUCATIONAL SERVICES
 DIGITAL COMPUTER LABORATORY
 1304 WEST SPRINGFIELD AVENUE
 URBANA, ILLINOIS 61801
 (217) 333-1637

- 24. ABANDONED UNDERGROUND UTILITIES THAT CONFLICT WITH CONSTRUCTION SHALL BE REMOVED AND DISPOSED OUTSIDE THE LIMITS OF THE RIGHT OF WAY ACCORDING TO ARTICLE 202.03 OF THE STANDARD SPECIFICATIONS AND AS APPROVED BY THE GRIGHER. THIS WORK WILL NOT BE PAID FOR SEPARATELY BUT SHALL BE CONSIDERED INCLUDED IN THE COST OF THE VARIOUS REMOVAL PAY ITEMS, AND NO ADDITIONAL COMPENSATION WILL BE ALLOWED.
- 25. ALL SALVAGEABLE FRAMES AND GRATES WHICH ARE NOT INCORPORATED IN THE WORK SHALL BECOME THE PROPERTY OF THE CONTRACTOR'S BID PRICE FOR VARIOUS STORM DRAINAGE WORK SHOULD REFLECT THE SALVAGE VALUE OF THE ITEMS.
- 26. ALL TRENCHES AND EXCAVATIONS FOR DRAINAGE PIPES, STRUCTURES, OR STRUCTURE REMOVALS BELOW OR WITHIN TWO FEET LATERALLY OF THE PROPOSED PAVEMENT, SIDEWALK OR CURB AND GUTTER SHALL BE BACKFILLED WITH CONTROLLED LOW-STRENGTH MATERIAL (CLSM) AS SHOWN ON THE PLANS AND IN ACCORDANCE WITH SECTION 593 OF THE STANDARD SPECIFICATIONS AND THE DETAIL IN THE PLANS. THE BACKFILLING WITH CONTROLLED LOW-STRENGTH MATERIAL AROUND DRAINAGE STRUCTURES WILL NOT BE MEASURED FOR PAYMENT AND SHALL BE CONSIDERED INCLUDED IN THE CONTRACT UNIT PRICE FOR THE VARIOUS TYPES OF DRAINAGE STRUCTURES.
- 27. STORM SEWER, WATER MAIN QUALITY IS TO BE USED AT LOCATIONS WHERE LATERAL SEPARATION BETWEEN THE SEWER AND WATER MAIN IS LESS THAN 10 FEET OR WHERE THE WATER MAIN CROSSES BELOW THE SEWER, REGARDLESS OF VERTICAL SEPARATION OR WHERE THE BOTTOM OF THE WATER MAIN IS LESS THAN 18 INCHES ABOVE THE TOP OF THE SEWER, THE MATERIAL SHALL BE CONCRETE PRESSURE PIPE OR DUCTILE IRON PIPE MEETING THE RECQUIREMENTS OF SECTIONS 40-2.01 AND 40-2.02 OF THE STANDARD SPECIFICATIONS FOR WATER AND SEWER MAIN CONSTRUCTION IN ILLINOIS. PVC PIPE WILL NOT BE ALLOWED.
- 28. THE TOP-OF-FRAME ELEVATIONS REFERRED TO IN THE DRAINAGE STRUCTURE CALL-OUTS FOR A TYPE 1 FRAME AND LID OR TYPE 8 GRATE ARE TAKEN ADJACENT TO THE PAVEMENT OR GROUND SURFACE.
- 29. THE TOP-OF-FRAME ELEVATIONS REFERRED TO IN THE DRAINAGE STRUCTURE CALL-OUTS FOR A TYPE 11 FRAME AND GRATE PLACED WITHIN TYPE B-6.12 CURB AND GUTTER ARE TAKEN ALONG THE EDGE OF FRAME WHICH IS COLINEAR WITH THE EDGE OF PAVEMENT. THIS FRAME ELEVATION IS 1/4" LOWER THAN THE ADJACENT EDGE OF PAVEMENT ELEVATION FOR ASPHALT PAVEMENTS. THE TYPE 11 FRAMES AND GRATES SHALL BE PROVIDED WITH OPEN FACE CURB BOXES AS DESCRIBED IN THE SPECIAL PROVISIONS. SEE THE DRAINAGE STRUCTURE FRAME AND GRATE DETAIL SHOWN ON THE MISCELLANEOUS DETAIL SHEETS.
- 30. WHEN CONNECTIONS ARE TO BE MADE TO EXISTING PIPING AND STRUCTURES, THE LOCATION AND ELEVATION OF THE EXISTING PIPING SHALL BE FIELD VERIFIED AND NOTHICATION GIVEN TO THE ENGINEER IT THE EXISTING PIPING IS FOUND TO BE DIFFERENT THAN THAT SHOWN ON THE DRAWINGS. WHERE SUCH DISCREPANCY IS FOUND, WORK SHALL NOT PROCEED UNTIL DIRECTED ACCORDINALY BY THE ENGINEER.
- 31. WHERE PROPOSED SEWERS ARE TO BE CONNECTED INTO EXISTING MANHOLES OR EXISTING SEWERS, THE CONNECTIONS SHALL BE MADE IN A WORKMANLIKE MANNER, AND MASONRY SHALL BE CONSTRUCTED AROUND THEM SO AS TO PREVENT LEARAGE. CONNECTIONS OF PROPOSED SEWERS TO EXISTING STRUCTURES SHALL BE MADE BY CORE DRILLING HOLES IN THE STRUCTURES. THE COST OF MAKING ANY SEWER CONNECTIONS TO AN EXISTING STRUCTURE OR PIPE SHALL BE CONSIDERED INCLUDED WITHIN THE CONTRACT UNIT PRICE FOR THE NEW SEWER.
- 32. THE EXISTING SEWERS TO BE REMOVED FOR THE PROPOSED IMPROVEMENTS SHALL BE REMOVED IN ACCORDANCE WITH SECTION 551 OF THE STANDARD SPECIFICATIONS EXCEPT THAT SALVAGING OF THE PIPE WILL NOT BE REQUIRED. STORM SEWER REMOVAL AND SANITARY SEWER REMOVAL WILL NOT BE PAID FOR SEPARATELY WHEN THE PROPOSED SEWER AND THE EXISTING SEWER ARE AT THE SAME TRENCH LOCATION. EXISTING PIPES SHALL BE PLUGGED AT THE LOCATIONS SHOWN ON THE PLANS IN ACCORDANCE WITH THE SPECIAL PROVISIONS AND AS DIRECTED BY THE ENGINEER.
- 33. EXISTING PAVEMENTS, CURBS AND GUTTERS, AND SIDEWALKS IN WHICH THE TOP SURFACE IS TO BE JOINED TO THE PROPOSED WORK SHALL BE SO JOINED THROUGH SAW CUT JUNCTURES. 34" EXPANSION JOINT MATERIAL SHALL BE PLACED AT THESE JUNCTURES AS DIRECTED BY THE ENGINEER. THIS WORK SHALL BE CONSIDERED INCLUDED IN THE COST OF THE PROPOSED PAVEMENT, CURB AND GUTTER, OR SIDEWALK, AND NO ADDITIONAL COMPENSATION MILL BE ALLOWED.
- 34. WHERE THE PROPOSED COMBINATION CONCRETE CURB AND GUTTER JOINS THE EXISTING CURB AND GUTTER, A TRANSITION BETWEEN THE TWO CONFIGURATIONS MAY BE REQUIRED. THIS WORK WILL BE CONSIDERED INCLUDED IN THE CONTRACT UNIT PRICE FOR CURB AND GUTTER OF THE SIZE AND TYPE SPECIFIED IN THE PLANS.
- 35. THE CONTRACTOR SHALL PROVIDE AND INSTALL TWO WEIGHTED SAND BAGS ON EACH TYPE II BARRICADE USED. (ONE WEIGHTED SAND BAG ACROSS EACH BOTTOM RAIL.)
- 36. FOR STABILIZATION, ALL TYPE III BARRICADES SHALL REQUIRE A MINIMUM OF FOUR SAND BAGS PER BARRICADE.
- 37. THE CITY OF URBANA HAS ACQUIRED AN NPDES PERMIT FOR THIS PROJECT FOR EROSION AND SEDIMENT CONTROL. TO SATISFY THE REQUIREMENTS OF THE NPDES PERMIT, THE CONTRACTOR SHALL FURNISH, INSTALL, AND MAINTAIN THE TEMPORARY EROSION CONTROL SYSTEMS AT THE LOCATIONS SHOWN ON THE STORM WATER POLLUTION PREVENTION PLAN AND AS DIRECTED BY THE ENGINEER. ESTIMATED QUANTITIES FOR THE TEMPORARY EROSION CONTROL SYSTEMS HAVE BEEN INCLUDED IN THE PROJECT AS SHOWN ON THE STORM WATER POLLUTION PREVENTION PLAN AND MAY BE ADJUSTED AS DIRECTED BY THE ENGINEER.
- 38. HORIZONTAL CONTROL TIES ARE SHOWN FOR THE CONTRACTOR TO PHYSICALLY LOCATE MONUMENTATION IN THE FIELD. IT IS THE CONTRACTOR'S RESPONSIBILITY TO MAINTAIN CONTROL POINTS OR TO USE ADDITIONAL TIES AS NECESSARY TO INSURE THAT CONTROL POINTS CAN BE ACCURATELY REPLICATED DURING CONSTRUCTION.
- 39. THE CITY OF URBANA WILL BE RESPONSIBLE FOR NOTIFYING THE PUBLIC, THE UNIVERSITY OF ILLINOIS, THE UNITED STATES POSTAL SERVICE, THE CHAMPAIGN-URBANA MASS TRANSIT DISTRICT, AND THE EMERGENCY SERVICE AGENCIES OF ALL ROAD CLOSURES AND CHANGES IN THE TRAFFIC CONTROL PLANS. THE CONTRACTOR SHALL NOTIFY THE CITY OF URBANA OF ALL ROAD CLOSURES AND CHANGES IN THE TRAFFIC CONTROL PLANS A MINIMUM OF 48 HOURS IN ADVANCE OF THE WORK.
- 40. THE CONTRACTOR SHALL BE RESPONSIBLE FOR CLEANUP OF THE SITE PRIOR TO FINAL ACCEPTANCE IN ACCORDANCE WITH ARTICLE 104.06 OF THE STANDARD SPECIFICATIONS. THIS WORK SHALL ALSO INCLUDE CLEANING ALL DRAINAGE FACILITIES OF FOREIGN MATERIALS IN ACCORDANCE WITH ARTICLE 602.15 OF THE STANDARD SPECIFICATIONS. THIS WORK SHALL BE DONE AS DIRECTED BY THE ENGINEER AND NO ADDITIONAL COMPENSATION WILL BE ALLOWED.
- 41. PARKING METER REMOVAL WILL BE PERFORMED BY THE CITY OF URBANA. THE CONTRACTOR SHALL CONTACT JERRY RABBIT (217-384-2314) FOR REMOVAL OF THE PARKING METERS. THE CONTRACTOR SHALL REMOVE THE PARKING METER POSTS AT THE LOCATIONS SHOWN ON THE PLANS. EXISTING PARKING METER POSTS THAT ARE REMOVED SHALL NOT BE REUSED. THE CONTRACTOR SHALL INSTALL NEW PARKING METER POSTS AT THE LOCATIONS SHOWN ON THE PLANS. THE CITY OF URBANA WILL INSTALL THE NEW PARKING METERS.
- 42. ALL OPEN TRENCHES OR EXCAVATIONS SHALL BE PROTECTED WITH A SIX FOOT HIGH CHAIN LINK FENCE AS DIRECTED BY THE ENGINEER. THIS WORK SHALL BE INCLUDED IN THE COST OF THE VARIOUS REMOVAL PAY ITEMS AND NO ADDITIONAL COMPENSATION WILL BE ALLOWED.
- 43. IN SOME AREAS WORK IS TO BE PERFORMED OUTSIDE OF THE RIGHT-OF-WAY AND TEMPORARY CONSTRUCTION EASEMENTS ARE NOT SHOWN. IN THESE AREAS THE ADJACENT PROPERTY IS OWNED BY THE UNIVERSITY OF ILLINOIS. THE CITY OF URBANA AND THE UNIVERSITY OF ILLINOIS HAVE AN AGREEMENT TO ALLOW WORK TO BE PERFORMED ON UNIVERSITY PROPERTY FOR THIS PROJECT. THE CONTRACTOR SHALL USE REASONABLE CARE TO AVOID DISTURBING PORTIONS OF THE UNIVERSITY'S PROPERTY NOT NECESSARY TO THE CONSTRUCTION OPERATIONS. IF, IN THE JUDGMENT OF THE ENGINEER, AREAS ARE DISTURBED UNNECESSARILY, THE CONTRACTOR SHALL RESTORE THESE AREAS AT HIS/HER OWN EXPENSE.

FILE NAME =	DESIGNED - JAJ	REVISED ~			F	A.U. SECTION	COUNTY TOTAL SHEET
P:\U0070052\Plans\sheets\02-GenNotes.dgn	DRAWN - JRM	REVISED -	STATE OF ILLINOIS	GENERAL NOTES	<u> </u>	7175 07-00456-00-RS	CHAMPAIGN 75 2
PLOT DATE =	CHECKED - RLH	REVISED -	DEPARTMENT OF TRANSPORTATION		-	GOODWIN AVENUE	CONTRACT NO. 91392
1/22/2009 6:41:07 PM	DATE - 01-2009	REVISED -		SCALE : NONE SHEET NO. 2 OF 75 SHEETS STA. TO	STA F		D. ATD. DDO IECT

ILLINOIS HIGHWAY STANDARD DRAWINGS

STANDARD NO.	DESCRIPTION
000001-05	STANDARD SYMBOLS, ABBREVIATIONS, AND PATTERNS
280001-04	TEMPORARY EROSION CONTROL SYSTEMS
420001-07	PAVEMENT JOINTS
424001-05	CURB RAMPS FOR SIDEWALKS
442101-07	CLASS B PATCHES
602301-02	INLET, TYPE A
602306-02	INLET, TYPE B
602401-02	MANHOLE TYPE A
602601-02	PRECAST REINFORCED CONCRETE FLAT SLAB TOP
602701-02	MANHOLE STEPS
604001-03	FRAME AND LIDS, TYPE 1
604036-02	GRATE TYPE 8
604051-03	FRAME AND GRATE, TYPE 11
606001-04	CONCRETE CURB TYPE B AND COMBINATION CONCRETE CURB & GUTTER
668001-01	U.S. GEOLOGICAL SURVEY AND NATIONAL GEODETIC SURVEY BENCHMARKS RESETTING METHOD
701006-03	OFF-ROAD OPERATIONS, 2L, 2W, 4.5 m (15') TO 600 mm (24") FROM PAVEMENT EDGE
701301-03	LANE CLOSURE, 2L, 2W, SHORT TIME OPERATIONS
701311-03	LANE CLOSURE, 2L, 2W, MOVING OPERATIONS - DAY ONLY
701501-05	URBAN LANE CLOSURE, 2L, 2W, UNDIVIDED
701606-06	URBAN LANE CLOSURE, MULTILANE, 2W WITH MOUNTABLE MEDIAN
701701-06	URBAN LANE CLOSURE, MULTILANE, INTERSECTION
701801-04	LANE CLOSURE, MULTILANE 1W OR 2W CROSSWALK OR SIDEWALK CLOSURE
701901-01	TRAFFIC CONTROL DEVICES
720001-01	SIGN PANEL MOUNTING DETAILS
720006-02	SIGN PANEL ERECTION DETAILS
720011-01	METAL POSTS FOR SIGNS, MARKERS & DELINEATORS
729001-01	APPLICATIONS OF TYPES A & B METAL POSTS (FOR SIGNS & MARKERS)
814001-02	HANDHOLES
814006-02	DOUBLE HANDHOLES
857001-01	STANDARD PHASE DESIGNATION DIAGRAMS AND PHASE SEQUENCE
862001-01	UNINTERRUPTABLE POWER SUPPLY (UPS)
873001-02	TRAFFIC SIGNAL GROUNDING AND BONDING
876001-01	PEDESTRIAN PUSH BUTTON POST
877011-04	STEEL COMBINATION MAST ARM ASSEMBLY AND POLE 16' THROUGH 55'
878001-07	CONCRETE FOUNDATION DETAILS
880001-01	SPAN WIRE MOUNTED SIGNALS AND FLASHING BEACON INSTALLATION
880006-01	TRAFFIC SIGNAL MOUNTING DETAILS
886001-01	DETECTOR LOOP INSTALLATIONS
886006-01	TYPICAL LAYOUTS FOR DETECTOR LOOPS

EXISTING		PROPOSED	EXISTING		PROPOSE
w	WATER LINE		<u>A</u>	MONUMENT	
G	GAS LINE		•	IRON PIN/PIPE FOUND	
OHE			×	RIGHT-OF-WAY MARKER	
UGE	UNDERGROUND ELECTRIC		•	SOIL BORING	
UGT	UNDERGROUND TELEPHONE			TRAFFIC SIGNAL CONTROL BOX	X
CATV	CABLE TELEVISION		∆ 0- ⊳	TRAFFIC SIGNAL POST	•
СОМ	UI COMMUNICATION LINE		<u> </u>	TRAFFIC SIGNAL MAST ARM	·
	STEAM TUNNEL			PEDESTRIAL PUSH BUTTON POST	• ₹
CHWS	CHILLED WATER SUPPLY LINE			TRAFFIC SIGNAL HANDHOLE	
CHWR	CHILLED WATER RETURN LINE		-1-	STREET SIGN	
RW	RAW WATER LINE		þ	TRAFFIC SIGN	ŀ
CA	COMPRESSED AIR LINE		B-O-B	PARKING LOT LIGHT	
0	CHILLED WATER DRAIN BOX		×	YARD LIGHT	
0	CHILLED WATER AIR VENT VALVE BOX		9	MAILBOX	
oTC	CHILLED WATER TRACER CABLE BOX		0	PARKING METER	⊕ OR ⇔⊕
— >—	SANITARY SEWER -		- 00	CLEANOUT	
	STORM SEWER -		- oDS	DOWNSPOUT	
	STORM SEWER WATER MAIN QUALITY-		- •	BOLLARD	
	INLET OR CATCH BASIN	•	X	FENCE	
	MANHOLE	$oldsymbol{f O}$			
olw	UTILITY WARNING SIGN		DA.	TREE STUMP	
⊚W ⊚G	SERVICE BOX SHUTOFF				
\bowtie	VALVE			BUSH	
W	WATER MANHOLE		\		
□W.	WATER METER		₹: <i>\$</i>	CONIFEROUS TREE	
A	FIRE HYDRANT	ъ.	711		
ШG	GAS METER		(• }	DECIDUOUS TREE	
GR	GAS REGULATOR		Ç.		
(E)	ELECTRIC MANHOLE				
ДЕ	ELECTRIC METER				
ΠE	ELECTRIC PEDESTAL				
	ELECTRIC JUNCTION BOX				
	POWER POLE				
ф»	POWER POLE W/LIGHT				
-6-	POWER POLE W/TRANSFORMER	_			
~ ○	ROADWAY STREET LIGHT	•			
¤	ORNAMENTAL STREET LIGHT				
<u>o</u> —	GUY WIRE				
(1)	UI COMMUNICATION STRUCTURE				
◐	TELEPHONE MANHOLE				
DΤ	TELEPHONE PEDESTAL				

FILE NAME =	DESIGNED - JAJ	REVISED -			F.A.U. SECTION	COUNTY TOTAL SHEET NO.
p:\u0070052\plans\sheets\03-HwyStandard.dgn	DRAWN - JRM	REVISED -	STATE OF ILLINOIS	HIGHWAY STANDARDS AND LEGEND	7175 07-00456-00-RS	CHAMPAIGN 75 3
PLOT DATE =	CHECKED - RLH	REVISED -	DEPARTMENT OF TRANSPORTATION		GOODWIN AVENUE	CONTRACT NO. 91392
1/12/2009 7:46:04 PM	DATE - 01-2009	REVISED -		SCALE: NONE SHEET NO. 3 OF 75 SHEETS STA. TO STA.	FED. ROAD DIST. NO. ILLINOIS F	FED. AID PROJECT

	SUMMARY OF QUANTITIES	SAFETY C CONSTRUC	ODE TION CODE	2A 1000	1E Y030	1F Y031
CODE NO.	ITEM	UNIT	TOTAL QUANTITY	ROADWAY	ROADWAY LIGHTING	TRAFFI SIGNAL
20100110	TREE REMOVAL (6 TO 15 UNITS DIAMETER)	UNIT	8	8	0	0
20201200	REMOVAL AND DISPOSAL OF UNSUITABLE MATERIAL	CU YD	35	35	0	0
21000300	GRANULAR EMBANKMENT, SPECIAL	TON	75	75	0	0
21001000	GEOTECHNICAL FABRIC FOR GROUND STABILIZATION	SQ YD	100	100	0	0
21101625	TOPSOIL FURNISH AND PLACE, 6"	SQ YD	703	703	0	0
21101645	TOPSOIL FURNISH AND PLACE, 12"	SQ YD	144	144	0	0
25200100	SODDING	SQ YD	36	36	0	0
25200200	SUPPLEMENTAL WATERING	UNIT	16	16	0	0
28000510	INLET FILTERS	EACH	45	45	0	0
31101200	SUB-BASE GRANULAR MATERIAL, TYPE B 4"	SQ YD	2,072	2,072	0	0
35101400	AGGREGATE BASE COURSE, TYPE B	TON	421	421	0	0
35300300	PORTLAND CEMENT CONCRETE BASE COURSE 8"	SQ YD	1,097	1,097	0	0
40201000	AGGREGATE FOR TEMPORARY ACCESS	TON	25	25	0	0
40600100	BITUMINOUS MATERIALS (PRIME COAT)	GALLON	2,920	2,920	0	0
40600300	AGGREGATE (PRIME COAT)	TON	60	60	0	0
40600400	MIXTURE FOR CRACKS, JOINTS, AND FLANGEWAYS	TON	5	5	0	0
40600845	POLYMERIZED LEVELING BINDER (MACHINE METHOD), N90	TON	260	260	0	0
40600990	TEMPORARY RAMP	SQ YD	610	610	0	0
40603240	POLYMERIZED HOT-MIX ASPHALT BINDER COURSE, IL-19.0, N90	TON	560	560	0	0
40603545	POLYMERIZED HOT-MIX ASPHALT SURFACE COURSE, MIX "D", N90	TON	1,660	1,660	0	0
40800050	INCIDENTAL HOT-MIX ASPHALT SURFACING	TON	120	120	0	0
42400300	PORTLAND CEMENT CONCRETE SIDEWALK 6 INCH	SQ FT	25,968	25,968	0	0
42400800	DETECTABLE WARNINGS	SQ FT	870	870	0	0
44000100	PAYEMENT REMOVAL	SQ YD	2,271	2,271	0	0
44000153	HOT-MIX ASPHALT SURFACE REMOVAL, 1"	SQ YD	14,125	14,125	0	0
44000155	HOT-MIX ASPHALT SURFACE REMOVAL, 1 1/2"	SQ YD	822	822	0	0
44000159	HOT-MIX ASPHALT SURFACE REMOVAL, 2 1/2"	SQ YD	2,471	2,471	0	0
44000162	HOT-MIX ASPHALT SURFACE REMOVAL, 3 1/4"	SQ YD	4,211	4,211	0	0
44000300	CURB REMOVAL	FOOT	91	91	0	0
44000500	COMBINATION CURB AND GUTTER REMOVAL	FOOT	2,643	2,643	0	0
44000600	SIDEWALK REMOVAL	SQ FT	18,480	18,480	0	0
44200934	CLASS B PATCHES, TYPE II, 8 INCH	SQ YD	61	61	0	0
44200942	CLASS B PATCHES, TYPE III, 8 INCH	SQ YD	16	16	0	0
44200944	CLASS B PATCHES, TYPE IV, 8 INCH	SQ YD	105	105	0	0
54248515	CONCRETE COLLAR	EACH	29	29	0	0
	STORM SEWERS, CLASS A, TYPE 1 10"	FOOT	7	7	0	0

	SUMMARY OF QUANTITIES	SAFETY CONSTRUC	ODE TION CODE	2A 1000	1E Y030	1F Y031
CODE NO.	ITEM	UNIT	TOTAL QUANTITY	ROADWAY	ROADWAY LIGHTING	TRAFFI SIGNAL
550A0050	STORM SEWERS, CLASS A, TYPE 1 12"	F00T	194	194	0	0
550A0330	STORM SEWERS, CLASS A, TYPE 2 10"	FOOT	20	20	0	0
550A0340	STORM SEWERS, CLASS A, TYPE 2 12"	F00T	70	70	0	0
550A0360	STORM SEWERS, CLASS A, TYPE 2 15"	FOOT	25	25	0	0
550A0380	STORM SEWERS, CLASS A, TYPE 2 18"	FOOT	8	8	0	0
550A0660	STORM SEWERS, CLASS A, TYPE 3 15"	F00T	4	4	0	0
550A0730	STORM SEWERS, CLASS A, TYPE 3 30"	FOOT	8	8	0	0
59300100	CONTROLLED LOW-STRENGTH MATERIAL	CU YD	230	230	0	0
60224600	RESTRICTED DEPTH MANHOLES, 4'-DIAMETER, TYPE 1 FRAME, CLOSED LID	EACH	4	4	0	0
60225110	RESTRICTED DEPTH MANHOLES, 4'-DIAMETER, TYPE 11 FRAME AND GRATE	EACH	2	2	0	0
60225910	RESTRICTED DEPTH MANHOLES, 5'-DIAMETER, TYPE 11 FRAME AND GRATE	EACH	1	1	0	0
60228600	MANHOLES, SPECIAL, WITH TYPE 1 FRAME, CLOSED LID	EACH	1	1	0	0
60236200	INLETS, TYPE A, TYPE 8 GRATE	EACH	1	1	0	0
60236800	INLETS, TYPE A, TYPE 11 FRAME AND GRATE	EACH	15	15	0	0
60238700	INLETS, TYPE A, WITH SPECIAL FRAME AND GRATE	EACH	1	1	0	0
60255500	MANHOLES TO BE ADJUSTED	EACH	10	10	0	0
60255600	MANHOLES TO BE ADJUSTED (SPECIAL)	EACH	35	35	0	0
60255800	MANHOLES TO BE ADJUSTED WITH NEW TYPE 1 FRAME, CLOSED LID	EACH	2	2	0	0
60256700	MANHOLES TO BE ADJUSTED WITH NEW TYPE 11 FRAME AND GRATE	EACH	1	1	0	0
60257900	MANHOLES TO BE RECONSTRUCTED	EACH	1	1	0	0
60258200	MANHOLES TO BE RECONSTRUCTED WITH NEW TYPE 1 FRAME, CLOSED LID	EACH	1	1	0	0
60260050	SANITARY MANHOLES TO BE RECONSTRUCTED	EACH	1	1	0	0
60260100	INLETS TO BE ADJUSTED	EACH	2	2	0	0
60260400	INLETS TO BE ADJUSTED WITH NEW TYPE 1 FRAME, CLOSED LID	EACH	1	1	0	0
60261300	INLETS TO BE ADJUSTED WITH NEW TYPE 11 FRAME AND GRATE	EACH	1	1	0	0
60266600	VALVE BOXES TO BE ADJUSTED	EACH	25	25	0	0
60266610	VALVE BOXES TO BE ADJUSTED (SPECIAL)	EACH	22	22	0	0
60300310	FRAMES AND LIDS TO BE ADJUSTED (SPECIAL)	EACH	4	4	0	0
60500040	REMOVING MANHOLES	EACH	5	5	0	0
60500060	REMOVING INLETS	EACH	12	12	0	0
60600505	CONCRETE CURB (SPECIAL)	FOOT	44	44	0	0
60600605	CONCRETE CURB, TYPE B	FOOT	219	219	0	0
60601005	CONCRETE CURB, TYPE B (SPECIAL)	FOOT	60	60	0	0
60604200	COMBINATION CONCRETE CURB AND GUTTER, TYPE B-6.12 (SPECIAL)	FOOT	2,772	2,772	0	0
67100100	MOBILIZATION	L SUM	1	1	0	0
	TRAFFIC CONTROL COMPLETE	L SUM	1	1	0	0

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P:\U0070052\Plans\sheets\04-SumQuantities.dgn DESIGNED - JAJ REVISED -DRAWN - JAJ REVISED -CHECKED - RLH PLOT DATE = 1/12/2009 10:07:29 PM REVISED -DATE - 01-2009 REVISED -

STATE OF ILLINOIS
DEPARTMENT OF TRANSPORTATION

SECTION SUMMARY OF QUANTITIES 07-00456-00-RS GOODWIN AVENUE CONTRACT NO. 91392

FED. ROAD DIST. NO. | ILLINOIS | FED. AID PROJECT SCALE : NONE | SHEET NO. 4 OF 75 SHEETS | STA.

U0070052

COUNTY TOTAL SHEET NO. CHAMPAIGN 75 4

 CO	NTR	ACT	NO.	913

		SUMMARY OF QUANTITIES	SAFETY CONSTRUC	ODE TION CODE	2A 1000	1E Y030	1F Y031
	CODE NO.	ITEM	UNIT	TOTAL	ROADWAY	ROADWAY LIGHTING	TRAFFIC SIGNALS
	70300100	SHORT-TERM PAVEMENT MARKING	F00T	1,890	1,890	0	0
	70300520	PAVEMENT MARKING TAPE, TYPE III 4"	FOOT	540	540	0	0
	70300560	PAVEMENT MARKING TAPE, TYPE III 12"	F00T	225	225	0	0
	70300570	PAVEMENT MARKING TAPE, TYPE III 24"	F00T	225	225	0	0
*	70301000	WORK ZONE PAVEMENT MARKING REMOVAL	SQ FT	1,485	1,485	0	0
.*	72000100	SIGN PANEL - TYPE 1	SQ FT	119	119	0	0
٠.	72000200	SIGN PANEL - TYPE 2	SQ FT	58	0	0	58
*	72900200	METAL POST - TYPE B	FOOT	84	84	0	0
. *	73000100	WOOD SIGN SUPPORT	F00T	168	168	0	0
Δ	78000100	THERMOPLASTIC PAVEMENT MARKING - LETTERS AND SYMBOLS	SQ FT	356	356	0	0
Δ	78000200	THERMOPLASTIC PAVEMENT MARKING - LINE 4"	FOOT	10,729	10,729	0	0
Δ	78000400	THERMOPLASTIC PAVEMENT MARKING - LINE 6"	F00T	7,799	7,799	0	0
Δ	78000600	THERMOPLASTIC PAVEMENT MARKING - LINE 12"	FOOT	4,858	4,858	0	0
۵	78000650	THERMOPLASTIC PAVEMENT MARKING - LINE 24"	F00T	227	227	0	0
△ *	80400105	ELECTRIC SERVICE INSTALLATION, SPECIAL	EACH	1	0	1	0
۵*	80501000	SERVICE INSTALLATION (SPECIAL)	EACH	1	0	0	1
Δ*	81012300	CONDUIT IN TRENCH, 1" DIA., PVC	FOOT	226	0	0	226
△ *	81012400	CONDUIT IN TRENCH, 1 1/4" DIA., PVC	FOOT	395	0	353	42
Δ*	81012500	CONDUIT IN TRENCH, 1 1/2" DIA., PVC	FOOT	193	0	0	193
Δ*	81012600	CONDUIT IN TRENCH, 2" DIA., PVC	F00T	333	0	110	223
△*	81012700	CONDUIT IN TRENCH, 2 1/2" DIA., PVC	FOOT	107	0	0	107
Δ*	81012800	CONDUIT IN TRENCH, 3" DIA., PVC	FOOT	72	0	72	0
∆.*	81013000	CONDUIT IN TRENCH, 4" DIA., PVC	FOOT	38	0	0	38
Δ*	81021570	CONDUIT, AUGERED 3" DIA., PVC	F00T	80	0	0	80
Δ*	81021590	CONDUIT, AUGERED 4" DIA., PVC	F00T	60	0	0	60
Δ*	81021600	CONDUIT, AUGERED 5" DIA., PVC	FOOT	95	0	0	95
△*	81028050	CONDUIT, BORED AND PULLED, COILABLE NON-METALLIC CONDUIT, 1 1/2"	FOOT	4,270	0	4,000	270
Δ*	81028060	CONDUIT, BORED AND PULLED, COILABLE NON-METALLIC CONDUIT, 2"	FOOT	2,707	0	2,707	0
Δ*	81028080	CONDUIT, BORED AND PULLED, COILABLE NON-METALLIC CONDUIT, 3"	FOOT	60	0	60	0
Δ*	81306100	JUNCTION BOX (SPECIAL)	EACH	70	0	70	0
Δ*	81306500	REMOVE EXISTING JUNCTION BOX	EACH	23	0	23	0
Δ**	81400115	HANDHOLE TO BE ADJUSTED	EACH	2	0	0	2
Δ	81400700	HANDHOLE, PORTLAND CEMENT CONCRETE	EACH	4	0	0	4
- Δ	81400720	DOUBLE HANDHOLE, PORTLAND CEMENT CONCRETE	EACH	1	0	0	1
Δ*	81400730	HANDHOLE, COMPOSITE CONCRETE	EACH	10	0	10	0
Δ*	81500120	GULFBOX JUNCTION, COMPOSITE CONCRETE	EACH	11	0	0	11
	* SEE SPE	CIAL PROVISIONS		l	I	I	L

		SUMMARY OF QUANTITIES	SAFETY CO	DDE TION CODE	2A 1000	1E Y030	1F Y031
	CODE NO.	ITEM	UNIT	TOTAL QUANTITY	ROADWAY	ROADWAY LIGHTING	TRAFFIC SIGNALS
Δ*	81702110	ELECTRIC CABLE IN CONDUIT, 600V (XLP-TYPE USE) 1/C NO. 10	F00T	21,609	0	18,519	3,090
Δ*	81702120	ELECTRIC CABLE IN CONDUIT, 600V (XLP-TYPE USE) 1/C NO. 8	FOOT	10,925	0	10,925	0
Δ*	81702130	ELECTRIC CABLE IN CONDUIT, 600V (XLP-TYPE USE) 1/C NO. 6	FOOT	22,637	0	22,637	0
Δ	81900200	TRENCH AND BACKFILL FOR ELECTRICAL WORK	FOOT	173	0	91	82
Δ	81900302	TRENCH AND BACKFILL WITH SCREENINGS OR SAND	F00T	1,100	0	353	747
Δ*	83600400	POLE FOUNDATION, METAL	EACH	61	0	61	0
Δ*	84200500	REMOVAL OF EXISTING LIGHTING UNIT, SALVAGE	EACH	10	0	10	0
Δ*	84200600	REMOVAL OF EXISTING LIGHTING UNIT, NO SALVAGE	EACH	30	0	30	0
Δ*	84200700	LIGHTING FOUNDATION REMOVAL	EACH	30	0	30	0
Δ*	84400105	RELOCATE EXISTING LIGHTING UNIT	EACH	2	0	2	0
Δ*	85700205	FULL-ACTUATED CONTROLLER AND TYPE IV CABINET, SPECIAL	EACH	1	0	0	1
Δ*	86200200	UNINTERRUPTABLE POWER SUPPLY, STANDARD	EACH	1	0	0	1
*۵	87301215	ELECTRIC CABLE IN CONDUIT, SIGNAL NO. 14 2C	F00T	1,920	0	0	1,920
Δ*	87301225	ELECTRIC CABLE IN CONDUIT, SIGNAL NO. 14 3C	F00T	1,400	0	0	1,400
Δ*	87301245	ELECTRIC CABLE IN CONDUIT, SIGNAL NO. 14 5C	F00T	1,200	0	0	1,200
△*	87301255	ELECTRIC CABLE IN CONDUIT, SIGNAL NO. 14 7C	FOOT	2,640	0	0	2,640
Δ*	87301515	ELECTRIC CABLE IN CONDUIT, LEAD-IN, NO. 18 3 PAIR	FOOT	2,750	0	0	2,750
Δ*	87500600	TRAFFIC SIGNAL POST, 10 FT.	EACH	2	0	0	2
△*	87501000	TRAFFIC SIGNAL POST, 14 FT.	EACH	2	0	0	2
△*	87501200	TRAFFIC SIGNAL POST, 16 FT.	EACH	3	0	0	3
△*	87600100	PEDESTRIAN PUSH-BUTTON POST, TYPE I	EACH	5	0	0	5
△*	87702850	STEEL COMBINATION MAST ARM ASSEMBLY AND POLE 24 FT.	EACH	2	0	0	2
Δ*	87702880	STEEL COMBINATION MAST ARM ASSEMBLY AND POLE 30 FT.	EACH	1	0	0	1
△*	87702910	STEEL COMBINATION MAST ARM ASSEMBLY AND POLE 36 FT.	EACH	1	0	0	1
△*	87800100	CONCRETE FOUNDATION, TYPE A	F00T	21	0	0	21
△*	87800200	CONCRETE FOUNDATION, TYPE D	F00T	4	0	0	4
△*	87800400	CONCRETE FOUNDATION, TYPE E 30-INCH DIAMETER	F00T	47	0	0	47
Δ	87900200	DRILL EXISTING HANDHOLE	EACH	2	0	0	2
∆*	88040090	SIGNAL HEAD, POLYCARBONATE, LED, 1-FACE, 3-SECTION, MAST ARM MOUNTED	EACH	4	0	0	4
△*	88040160	SIGNAL HEAD, POLYCARBONATE, LED, 1-FACE, 5-SECTION, MAST ARM MOUNTED	EACH	4	0	0	4
△*	88040260	SIGNAL HEAD, POLYCARBONATE, LED, 2-FACE, 1-3-SECTION, 1-5-SECTION, BRACKET MOUNTED	EACH	4	0	0	4
Δ*	88102810	PEDESTRIAN SIGNAL HEAD, POLYCARBONATE, LED, 1-FACE, BRACKET MOUNTED	EACH	8	0	0	8
Δ	88200100	TRAFFIC SIGNAL BACKPLATE	EACH	8	0	0	8
Δ*	88600100	DETECTOR LOOP, TYPE I	F00T	1,070	0	0	1,070
۵*	88700200	LIGHT DETECTOR	EACH	2	0	0	2
Δ*	88700300	LIGHT DETECTOR AMPLIFIER	EACH	1	0	0	1
1		CIAL PROVISIONS ACT Y. ITEMS		L			

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STATE OF ILLINOIS
DEPARTMENT OF TRANSPORTATION

	CINALADY OF OL		- ~	F.A.U. RTE.	SECTION	COUNTY	TOTAL	SHEET NO.
	SUMMARY OF QL	IANIIIE	-5	7175	07-00456-00-RS	CHAMPAIGN	75	5
***	,				GOODWIN AVENUE	CONTRACT	NO. 91	392
SCALE : NONE	SHEET NO. 5 OF 75 SHEETS	STA.	TO STA.	FED. ROAL	D DIST. NO. ILLINOIS FED.	AID PROJECT		

		SUMMARY OF QUANTITIES	SAFETY C	ODE TION CODE	2A 1000	1E Y030	1F Y031
	CODE NO.	ITEM	UNIT	TOTAL QUANTITY	ROADWAY	ROADWAY LIGHTING	TRAFFIC SIGNALS
Δ*		PEDESTRIAN PUSH-BUTTON	EACH	2	0	0	2
Δ	89000100	TEMPORARY TRAFFIC SIGNAL INSTALLATION	EACH	1	0	0	1
Δ*	89500100	RELOCATE EXISTING SIGNAL HEAD	EACH	2	0	0	2
Δ*	89500200	RELOCATE EXISTING PEDESTRIAN SIGNAL HEAD	EACH	2	0	0	2
Δ*	89502205	MODIFY EXISTING CONTROLLER (SPECIAL)	EACH	1	0	0	1
Δ*	89502380	REMOVE EXISTING HANDHOLE	EACH	4	0	0	4
Δ*	89502385	REMOVE EXISTING CONCRETE FOUNDATION	EACH	9	0	0	9
*	X0301430	PRECAST CONCRETE PARKING BLOCK	EACH	5	5	0	0
۵*	X0321558	SANITARY MANHOLES TO BE ADJUSTED WITH NEW TYPE 1 FRAME, CLOSED LID	EACH	2	2	0	0
*	X0321566	MULCH, SPECIAL	SQ YD	1,544	1,544	0	0
*	X0321905	STORM SEWERS, TYPE 1, WATER MAIN QUALITY PIPE, 12"	FOOT	307	307	0	0
*	X0321906	STORM SEWERS, TYPE 1, WATER MAIN QUALITY PIPE, 15"	FOOT	12	12	0	0
*	X0321908	STORM SEWERS, TYPE 2, WATER MAIN QUALITY PIPE, 15"	FOOT	4	4	0	0
Δ*	X0321973	MODIFY EXISTING SERVICE INSTALLATION	EACH	1	0	0	1
Δ*	X0322464	ABANDON AND FILL EXISTING SANITARY MANHOLE	EACH	1	1	0	0
*	XX001144	CONCRETE ENCASEMENTS	EACH	1	1	0	0
*	X0322748	BICYCLE LANE MARKING	EACH	44	44	0	0
*	X0322795	REMOVE AND RELOCATE EXISTING MONUMENT	EACH	1	1	0	0
*	X0322923	SEGMENTAL CONCRETE BLOCK WALL	SQ FT	155	155	.0	0
۸*	X0323200	SANITARY SEWER, DUCTILE IRON, 12"	FOOT	30	30	0	0
Δ:*	X0325815	REMOVE EXISTING CABLE	FOOT	1,900	0	1,900	0
Δ*	X0962500	REMOVE EXISTING TRAFFIC SIGNAL EQUIPMENT	L SUM	1	0	0	1
Δ*	XX007866	LIGHTING CONTROLLER, LOCATION NO. 1	L SUM	1	0	1	0
Δ*	X8430100	REMOVE EXISTING CONDUIT ATTACHED TO STRUCTURE	FOOT	40	0	40	0
Δ*	X8730027	ELECTRIC CABLE IN CONDUIT, GROUNDING, NO. 6 1C	FOOT	1,330	0	0	1,330
Δ*	X8730250	ELECTRIC CABLE IN CONDUIT, NO. 20 3C, TWISTED, SHIELDED	FOOT	970	0	0	970
۸*	X8760200	ACCESSIBLE PEDESTRIAN SIGNALS	EACH	8	0	0	8
Δ*	X8760250	VIBROTACTILE FEATURE	EACH	8	0	. 0	8
Δ*	X8850106	INDUCTIVE LOOP DETECTOR, RACK MOUNTED	EACH	16	0	0	16
*	XX000880	SEEDING, CLASS 1, SPECIAL	SQ YD	1,544	1,544	0	0
Δ*	XX002184	PHOTOELECTRIC CONTROL	EACH	1	0	0	1
Δ*.	XX002895	SANITARY MANHOLES TO BE RECONSTRUCTED WITH NEW FRAME AND LID	EACH	1	1	0	0
*	XX003313	REMOVE AND REINSTALL BRICK PAVER	SQ FT	1,060	1,060	0	0
Δ*	XX003581	ELECTRIC CABLE IN CONDUIT, SERVICE NO. 6 1C	FOOT	660	0	0	660
Δ*	81100605	CONDUIT ATTACHED TO STRUCTURE, 2" DIA., PVC COATED GALVANIZED STEEL	FOOT	100	0	100	0
*	XX004688	BRICK PAVER SIDEWALK	SQ FT	220	220	0	0
		CIAL PROVISIONS					

		SUMMARY OF QUANTITIES		SAFETY CODE CONSTRUCTION CODE		2A 1E 1000 Y030	
-	CODE	ITEM	UNIT	TOTAL QUANTITY	ROADWAY	ROADWAY LIGHTING	Y031 TRAFFI SIGNAL
	NO. XX004735	RESTRICTED DEPTH INLET TYPE B, TYPE 1 FRAME, CLOSED LID	EACH	1	1	0	O O
-	XX006163	REMOVE ELECTRIC CABLE FROM CONDUIT (SPECIAL)	L SUM	1	0	0	1
F	Z0013798	CONSTRUCTION LAYOUT	L SUM	1	1	0	0
		FURNISHING AND SETTING STEEL POSTS	EACH	36	36	0	0
L		PARKING METER POSTS TO BE REMOVED	EACH	53	53	0	0
		PERMANENT BENCH MARKS	EACH	1	1	0	0
		PORTLAND CEMENT CONCRETE SIDEWALK CURB	FOOT	60	60	0	0
		REMOVING AND RESETTING STREET SIGNS	EACH	14	14	0	0
X	KX007863	RESTRICTED DEPTH INLET TYPE B, TYPE 11 FRAME AND GRATE	EACH	5	5	0	0
X,	X00786A	SANITARY SEWER, DUCTILE IRON, 8"	F00T	6	6	0	0
X	(X001865	STORM SEWERS, TYPE 3, WATER MAIN QUALITY PIPE, 12"	FOOT	6	6	0	0
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	* SEE SBE	CIAL PROVISIONS	1.	l			

STATE OF ILLINOIS
DEPARTMENT OF TRANSPORTATION

PROPOSED TYPICAL SECTION NOTES

- 1. SEE THE SITE IMPROVEMENTS PLANS, INTERSECTION DETAILS, AND HORIZONTAL ALIGNMENT LAYOUT AND CONTROL SHEETS FOR LOCATIONS OF EDGES OF PAVEMENTS, CURBS AND GUTTERS, SIDEWALKS, RIGHT-OF-WAY LINES, AND TEMPORARY CONSTRUCTION EASEMENTS.
- 2. THE EXISTING PAVEMENT TYPE AND THICKNESS REPRESENTS THE BEST INFORMATION AVAILABLE. NO ADDITIONAL COMPENSATION WILL BE ALLOWED FOR PAVEMENT REMOVAL ITEMS DUE TO VARIATIONS IN THE EXISTING PAVEMENT TYPE, THICKNESS, OR AMOUNT OF REINFORCEMENT. THE ADJUSTMENT OF QUANTITIES AS SPECIFIED IN ARTICLE 440.07 OF THE STANDARD SPECIFICATIONS SHALL NOT APPLY.
- 3. EARTH EXCAVATION WILL NOT BE MEASURED FOR PAYMENT BUT SHALL BE CONSIDERED INCLUDED IN THE COST OF THE SPECIFIC CONSTRUCTION PAY ITEM REQUIRING THE EXCAVATION, AND NO ADDITIONAL COMPENSATION WILL BE ALLOWED.
- 4. THE FINISHED EARTHWORK SHALL HAVE VEGETATIVE SUSTAINING SOIL COVERING THE TOP 6" OF AREAS TO BE SEEDED. THE FURNISHED TOPSOIL SHALL MEET THE REQUIREMENTS OF THE SPECIAL PROVISIONS OR BE APPROVED BY THE ENGINEER. THE VEGETATIVE SUSTAINING SOIL REQUIRED WILL BE PAID FOR AT THE CONTRACT UNIT PRICE PER SQUARE YARD FOR TOPSOIL FURNISH AND PLACE, 6", 12 INCHES OF TOPSOIL SHALL BE FURNISHED AT THE LOCATIONS SHOWN ON THE PLANS. THE TOPSOIL REQUIRED FOR THIS WORK WILL BE PAID FOR AT THE CONTRACT UNIT PRICE PER SQUARE YARD FOR TOPSOIL FURNISH AND PLACE, 12".
- 5. ALL EXPOSED EARTH AREAS SHALL BE SEEDED AND MULCHED IN ACCORDANCE WITH SECTIONS 250 AND 251 OF THE STANDARD SPECIFICATIONS AND THE SPECIAL PROVISIONS, SOD SHALL BE PLACED AT THE LOCATIONS SHOWN ON THE PLANS OR AS DIRECTED BY THE ENGINEER IN ACCORDANCE WITH SECTION 252 OF THE STANDARD SPECIFICATIONS AND THE SPECIAL PROVISIONS.
- 6. THE P.C. CONCRETE BASE COURSE SHALL NOT BE POURED MONOLITHIC WITH THE COMBINATION CONCRETE CURB AND GUTTER EXCEPT AT THE STUB LOCATIONS SHOWN ON THE PLANS. A 1-FOOT STUB SHALL BE CONSTRUCTED PERPENDICULAR TO THE SAWED EDGE OF EXISTING PAVEMENT. THE COST OF ADDITIONAL GUTTER FLAG WIDTH WILL BE PAID FOR AT THE CONTRACT UNIT PRICE PER SQUARE YARD FOR PORTLAND CEMENT CONCRETE BASE COURSE 8". TIE BARS BETWEEN THE BASE COURSE AND THE CURB AND GUTTER SHALL BE REQUIRED IN ACCORDANCE OF WITH STANDARD 606001.
- 7. THE COMBINATION CONCRETE CURB AND GUTTER ADJACENT TO THE NEW P.C. CONCRETE BASE COURSE AND HOT-MIX ASPHALT OVERLAY SHALL BE IN ACCORDANCE WITH STANDARD GOGOOI EXCEPT THAT IT SHALL BE CONSTRUCTED TO THE FULL THICKNESS OF THE PAVEMENT. THE COST OF THE CURB AND GUTTER, INCLUDING THE ADDITIONAL THICKNESS, WILL BE PAID FOR AT THE CONTRACT UNIT PRICE PER FOOT FOR COMBINATION CONCRETE CURB AND GUTTER, TYPE B-6.12 (SPECIAL).
- 8. THE COMBINATION CONCRETE CURB AND GUTTER SHALL BE CONSTRUCTED WITH A CURB HEIGHT OF 4 INCHES AT THE LOCATIONS SHOWN ON THE PLANS. THE COST OF CONSTRUCTING THE COMBINATION CONCRETE CURB AND GUTTER WITH A 4 INCH CURB HEIGHT SHALL BE INCLUDED IN THE COST OF THE COMBINATION CONCRETE
- 9. THE COMBINATION CONCRETE CURB AND GUTTER SHALL BE CONSTRUCTED WITH VARYING GUTTER FLAG SLOPES AT THE LOCATIONS SHOWN ON THE PLANS. THE COST OF CONSTRUCTING THE COMBINATION CONCRETE CURB AND GUTTER WITH VARYING GUTTER FLAG SLOPES SHALL BE INCLUDED IN THE COST OF THE COMBINATION
- 10. SAWED TRANSVERSE CONTRACTION JOINTS SHALL BE PLACED AT 15 FOOT CENTERS IN THE COMBINATION CONCRETE CURB AND GUTTER, TYPE B-6.12 (SPECIAL) AND THE JOINTS SHALL BE SEALED. THIS WORK SHALL BE PERFORMED IN ACCORDANCE WITH ARTICLE 606.07 OF THE STANDARD SPECIFICATIONS.
- 11. ALL SAWED JOINTS IN THE COMBINATION CONCRETE CURB AND GUTTER SHALL BE SEALED WITH A JOINT SEALER MEETING THE REQUIREMENTS OF ARTICLE 606.02 OF THE STANDARD SPECIFICATIONS.
- 12. IN THE AREAS OF CROSS SLOPE MODIFICATION SHOWN ON PLANS, THE PROPOSED HMA SURFACING THICKNESS WILL EXCEED THE TYPICAL OVERLAY THICKNESS FOR THAT LOCATION. THE ADDITIONAL HMA THICKNESS REQUIRED SHALL BE ACHIEVED WITH SURFACE COURSE OR LEVELING BINDER AS DIRECTED BY THE ENGINEER.
- 13. HIGH-EARLY STRENGTH CONCRETE SHALL BE USED AT THE LOCATIONS SHOWN ON THE PLANS OR AS DIRECTED BY THE ENGINEER. SEE THE SITE IMPROVEMENTS PLANS AND SPECIAL PROVISIONS FOR ADDITIONAL INFORMATION.
- 14. THE SUBGRADE SHALL BE PREPARED AND COMPACTED IN ACCORDANCE WITH SECTION 301 OF THE STANDARD SPECIFICATIONS AND THE IDDT SUBGRADE STABILITY MANUAL. IF THE REQUIRED DENSITY AND STABILITY CANNOT BE ATTAINED IT WILL BE NECESSARY TO UNDERCUT AND REMOVE EARTH AND ORGANIC MATERIAL BELOW THE PROPOSED PAVEMENT SYSTEM TO A DEPTH OF 12" AS DIRECTED BY THE ENGINEER. ALL UNSTABLE, UNSUITABLE, OR ORGANIC MATERIAL SHALL BE DISPOSED OF AS DIRECTED BY THE ENGINEER. MATERIALS THAT ARE UNDERCUT AND REMOVED BELOW THE PROPOSED PAVEMENT SYSTEM WHERE THE REQUIRED DENSITY AND STABILITY CANNOT BE ATTAINED SHALL BE MEASURED AND PAID FOR AS REMOVAL AND DISPOSAL OF UNSUITABLE MATERIAL. SET THE "SUBGRADE REMOVAL AND REPLACEMENT DETAIL" ON THE MISCELLANEOUS DETAIL SHEETS FOR ADDITIONAL INFORMATION.
- 15. EPOXY COATING SHALL NOT BE REQUIRED ON DOWEL BARS AND TIE BARS.

PROPOSED TYPICAL SECTION KEY

(A) SUBBASE GRANULAR MATERIAL, TYPE B 4"

D PORTLAND CEMENT CONCRETE SIDEWALK 6"

(C) PORTLAND CEMENT CONCRETE BASE COURSE 8"

© COMBINATION CONCRETE CURB AND GUTTER, TYPE B-6.12 (SPECIAL)

(B) AGGREGATE BASE COURSE, TYPE B

HOT-MIX ASPHALT MIXTURE REQUIREMENTS TABLE

MIXTURE USE:	POLYMERIZED	POLYMERIZED	POLYMERIZED	INCIDENTAL
·	SURFACE	LEVELING BINDER	BINDER	SURFACE
AC/PG	SBS PG 70-22	SBS PG 70-22	SBS PG 70-22	PG 64-22
RAP % (MAX)	10	10	10	10
DESIGN AIR VOIDS	4.0% @ NDES = 90			
MIXTURE COMPOSITION				
(GRADATION)	IL 9.5	IL 9.5	IL 19.0	IL 9.5
FRICTION AGGREGATE	MIXTURE D	MIXTURE C	N/A	MIXTURE C


NOTE 1: IF AN ANTI-STRIPPING ADDITIVE IS REQUIRED FOR ANY HOT-MIX ASPHALT MIXTURE, THE COST OF THE ADDITIVE WILL
NOT BE PAID FOR SEPARATELY AS DESCRIBED IN ARTICLE 406,14 OF THE STANDARD SPECIFICATIONS, IF THE CONTRACTOR ANTICIPATES THAT AN ADDITIVE WILL BE NEEDED, THE COST SHOULD BE INCLUDED IN THE UNIT BID PRICE.

- (J) POLYMERIZED LEVELING BINDER (MACHINE METHOD), N90

❿

- (L) TOPSOIL 6"
- M SEEDING AND MULCH

PROPOSED TYPICAL SECTION KEY

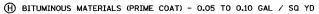


- (I) POLYMERIZED HOT-MIX ASPHALT SURFACE COURSE, MIX "D", N90
- (K) POLYMERIZED HOT-MIX ASPHALT BINDER COURSE, IL-19.0, N90

(F) LONGITUDINAL CONSTRUCTION JOINT WITH NO. 6 X 30" TIE BARS AT 24" CENTERS FORMED IN PLACE (STD. 420001) © LONGITUDINAL CONSTRUCTION JOINT WITH NO. 6 X 24" TIE BARS AT 24" CENTERS DRILLED AND GROUTED IN PLACE (STD. 420001) (PREFORMED HOLES WITH GROUTED TIE BARS WILL NOT BE ALLOWED)


LOCATION MILLING OVERLAY (STA. TO STA.) THICKNESS THICKNESS (N) GOODWIN AVENUE 9+83 T0 33+34 1" 33+34 T0 35+80 3-1/4" 35+80 T0 36+35 1" 36+35 T0 41+11.5 70 41+42 2 70 43+83 1-1/2" 1-1/4" 1-1/4" 1-1/4" 1-1/4" 1-1/4" 1-1/4" 1-1/4" 1-1/4" 1-1/4" 1-1/4" 1-1/4" 1-1/4" 3-1/2" 1-1/4" 3-1/2" 2-3/4" 2" VARIES 34'± TO 54'± VAR. 4.5'± TRAVEL LANES VAR. 10.25' TO 12' PARKING LANE LEFT-TURN LANES = 11' SEE PAVEMENT MARKING PLANS VAR. 0 TO 9.5'± CURB HEIGHT VARIES 4" TO 6". SEE INTERSECTION DETAILS. MATCH EXISTING MATCH EXISTING TO FILL VOIDS UNDER PROPOSEI SIDEWALKS IN AREAS OF PAVEMENT REMOVAL MILLING --THICKNESS O' AND VARIES __ **(D)** (SEE PLANS FOR \mathbb{Q} EXISTING CURB & GUTTER SEE NOTE. ① ① · ® \oplus F) OR G (E) $\mathbb{O}_{\mathbb{W}}$ GOODWIN AVENUE PROPOSED TYPICAL SECTION -EXISTING PAVEMENT SEE THE SITE IMPROVEMENTS PLANS FOR LOCATIONS OF THE PROPOSED COMBINATION CONCRETE CURB AND GUTTER, TYPE B-6.12 (SPECIAL), THE EXISTING CURB AND GUTTER WILL REMAIN AT THE LOCATIONS SHOWN ON THE REMOVAL/RELOCATIONS PLANS. O P (E) (A) (D) OR (D) (M) DETAIL LOCATION (STA. TO STA.) GUTTER FLAG THICKNESS GREGORY TO NEVADA: 34'± F-F OF CURB NEVADA TO OREGON: 54'± F-F OF CURB OREGON TO ILLINOIS, 47'± F-F OF CURB ILLINOIS TO SPRINGFIELD: 54'± F-F OF CURB 9+83 TO 33+34 33+34 TO 35+80 35+80 TO 36+35 36+35 TO 41+11.5 41+11.5 TO 41+42 4 41+42 TO 43+83 11-1/4" --- ¢ GOODWIN AVENUE INCLUDES SPRINGFIELD AVENUE VARIES 34'± TO 54'± VAR. 4.5'± TO 10'± PARKING LANE LANE WIDTHS VARY VAR. 0 TO 8'± VAR. 0 TO 8'± VARIES VARIES SIDEWALK TYPE B-6.12 CURB AND GUTTER (TYP.) HOT-MIX ASPHALT SURFACE GREGORY TO BONEYARD CREEK: 2"± & VARIES BONEYARD CREEK TO SPRINGFIELD: VARIES 4"± TO 8"± SPRINGFIELD TO STOUGHTON: 1-1/2"± P.C. CONCRETE BASE COURSE GREGORY TO BONEYARD CREEK: 8"± & VARIES BONEYARD CREEK TO SPRINGFIELD: VARIES 6-1/2"± TO 8-1/2"± SPRINGFIELD TO STOUGHTON: 7-1/2"±


GOODWIN AVENUE EXISTING TYPICAL SECTION

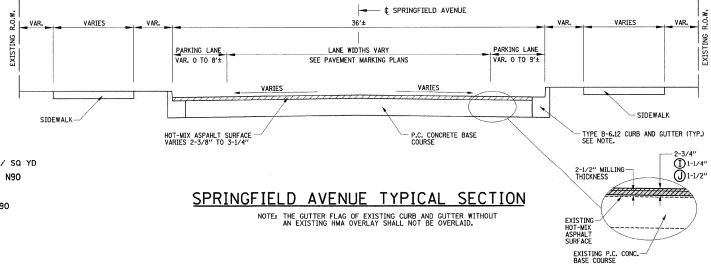


FILE NAME =	DESIGNED - JAJ	REVISED -			F.A.U.	SECTION	COUNTY TOTAL SHEET NO.
p:\u0070052\plans\sheets\07-TypSections.dgn	DRAWN - DLM	REVISED -	STATE OF ILLINOIS	TYPICAL SECTIONS	7175	07-00456-00-RS	CHAMPAIGN 75 7
PLOT DATE =	CHECKED - RLH	REVISED -	DEPARTMENT OF TRANSPORTATION			GOODWIN AVENUE	CONTRACT NO. 91392
1/12/2009 7:46:05 PM	DATE - 01-2009	DEVISED -		SCALE NONE SHEET NO. 7 OF 75 SHEETS STA. TO STA.	ECD BOAD D	TET NO THE THOTE EED	O ATD PROJECT

CONTRACT NO. 91392

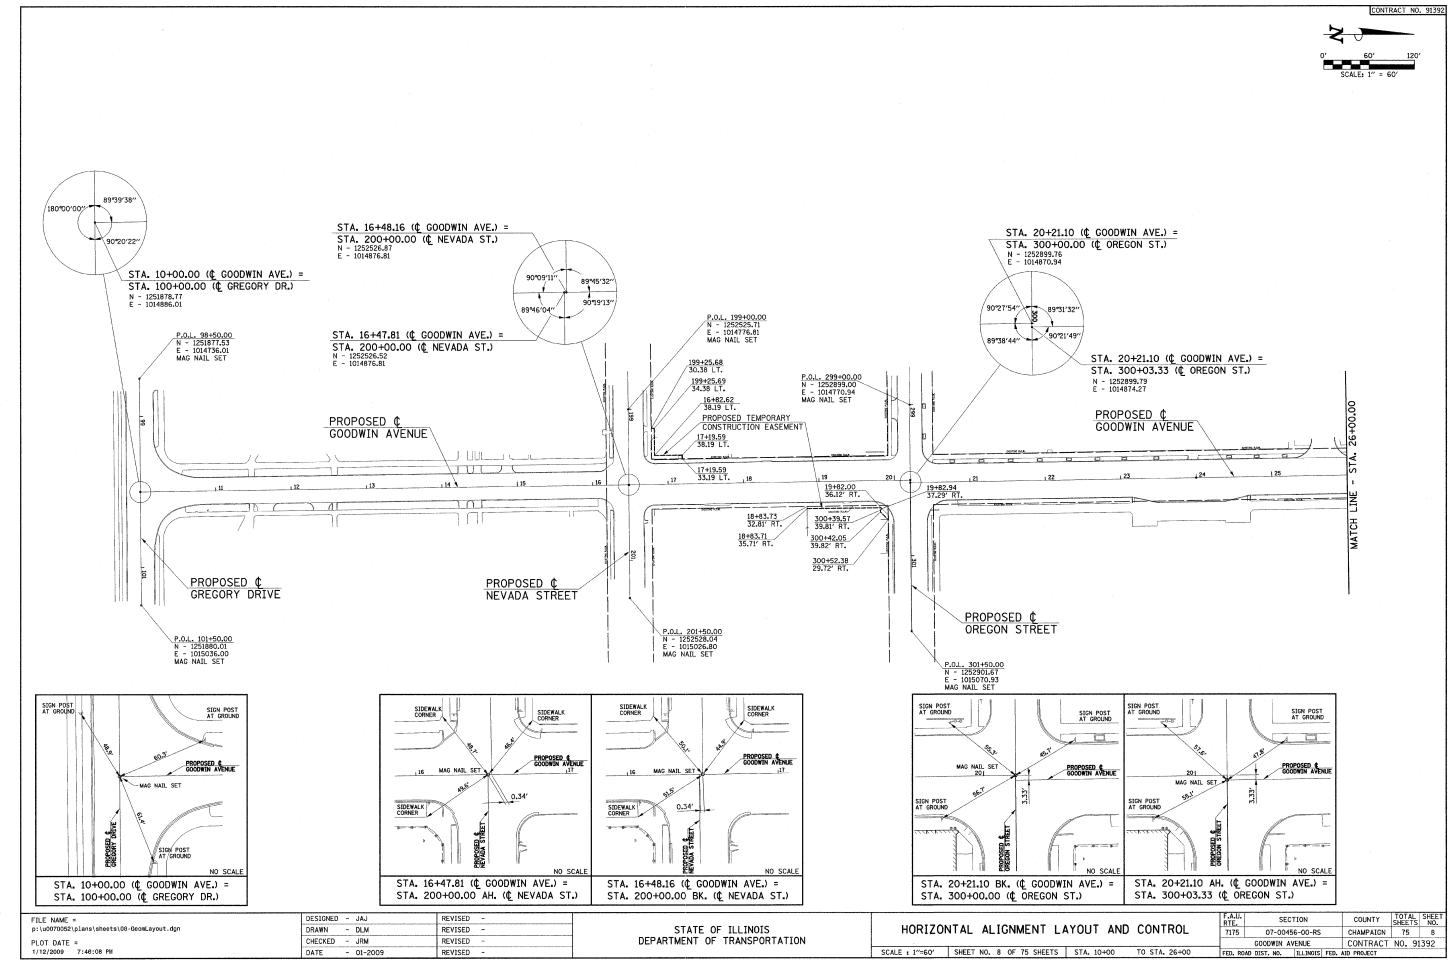

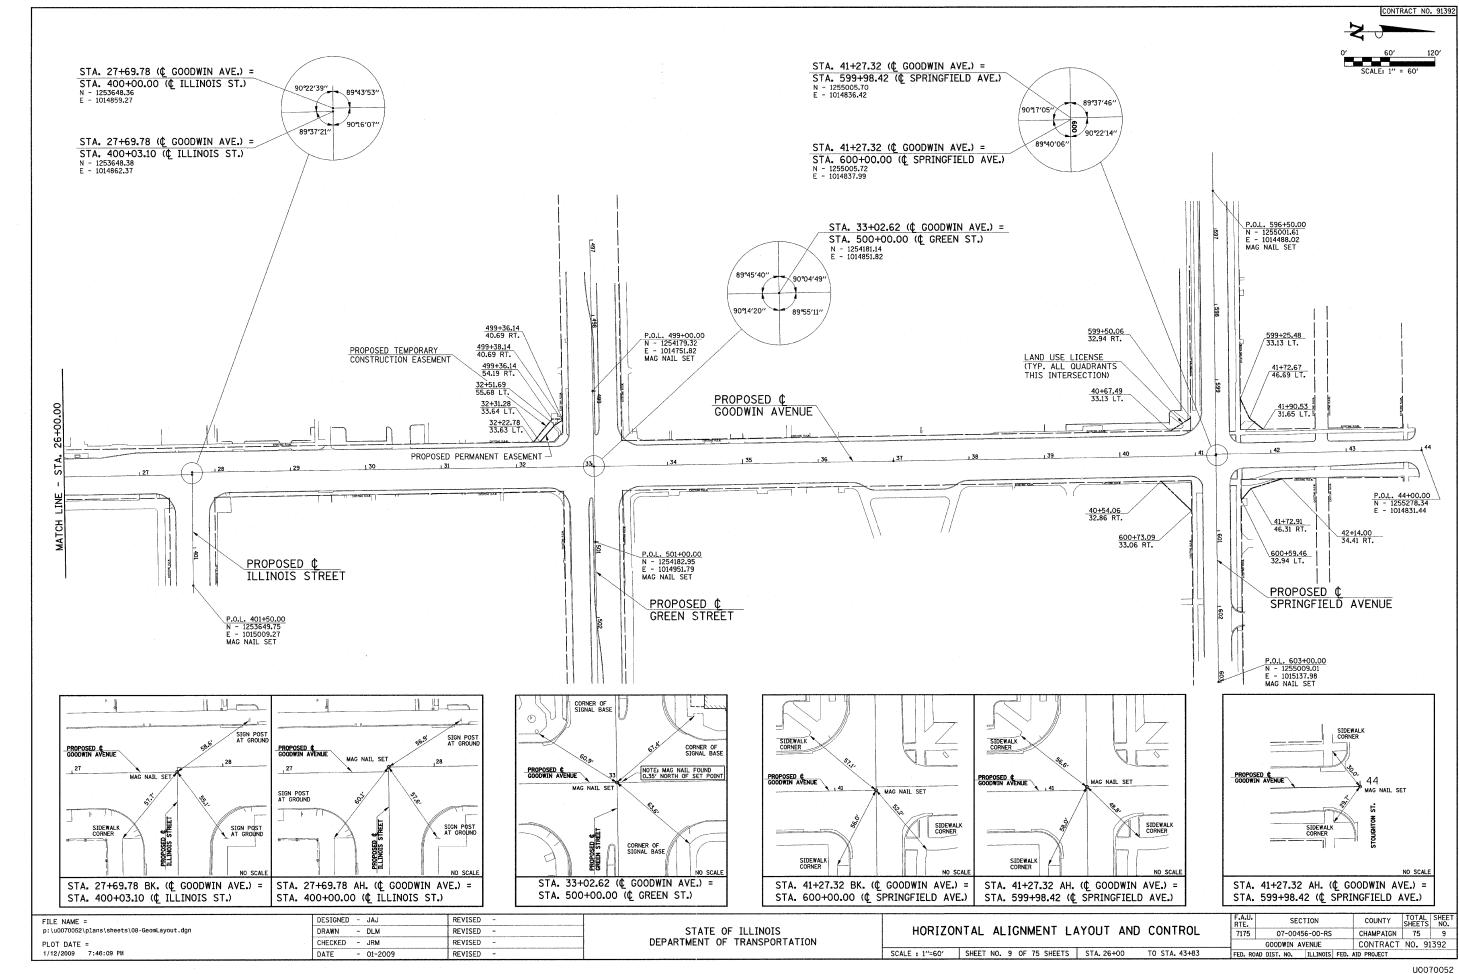

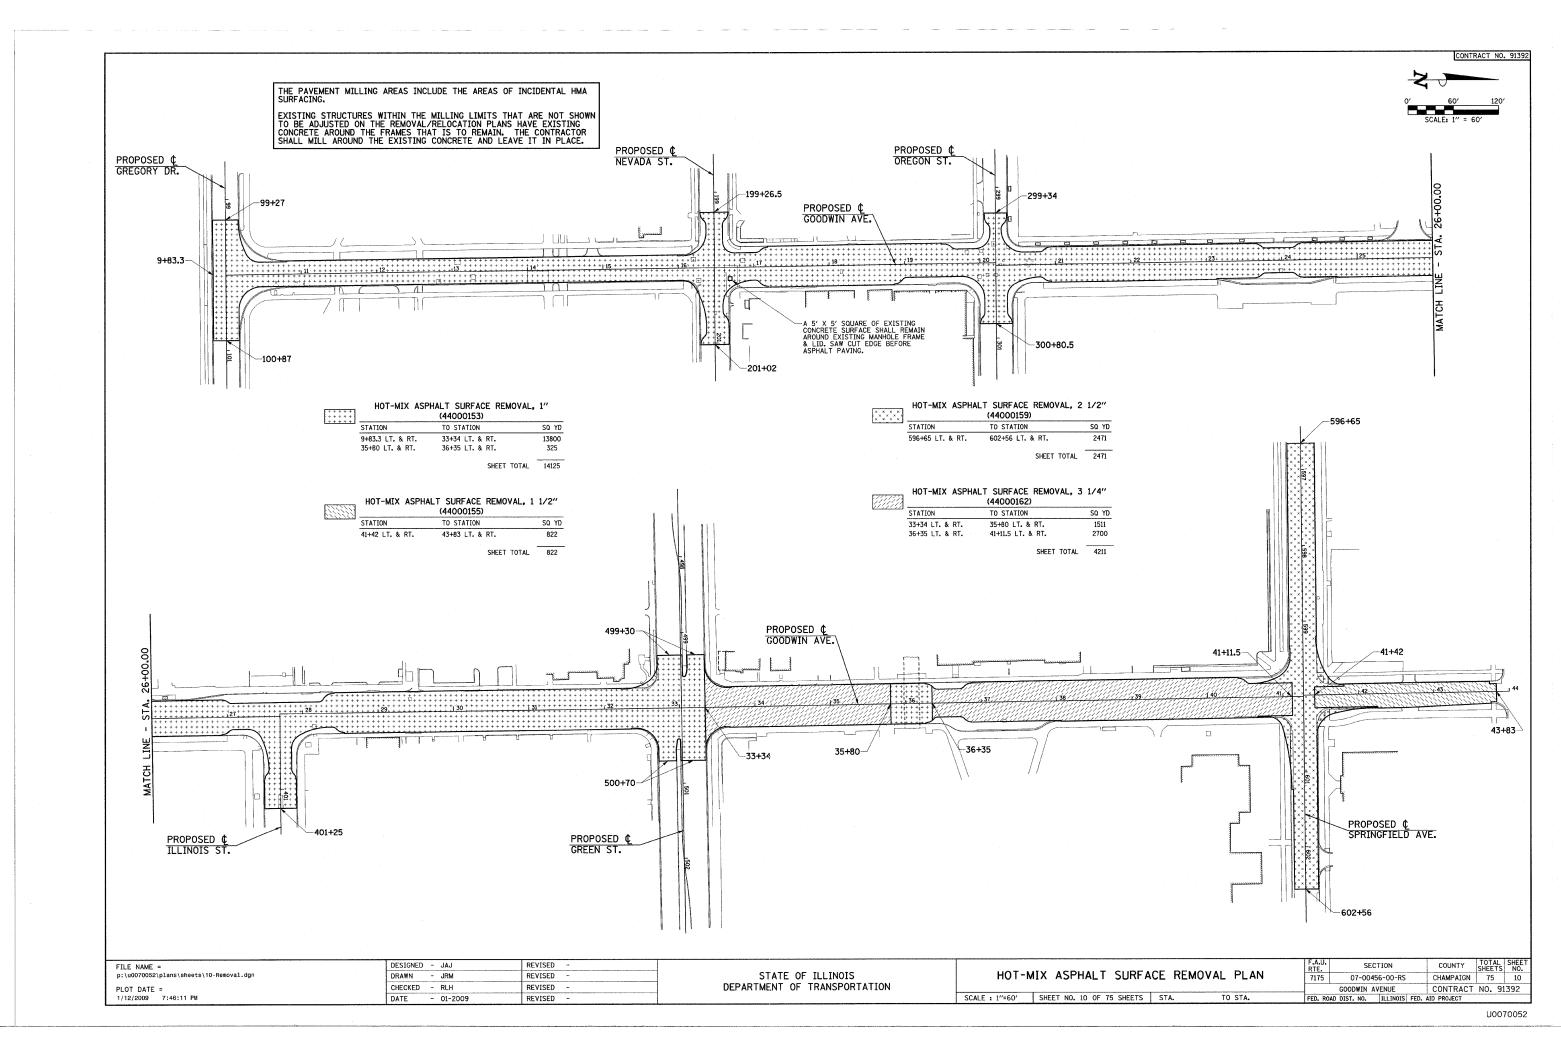

REMOVAL NOTES

- 1. EXISTING MANHOLES AND VALVE BOXES WITHIN THE LIMITS OF MILLING AND RESURFACING THAT ARE NOT SHOWN TO BE ADJUSTED HAVE EXISTING CONCRETE AROUND THE FRAMES THAT IS TO REMAIN. THE CONTRACTOR SHALL MILL AROUND THE EXISTING CONCRETE AND LEAVE IT IN PLACE.
- THE CONCRETE AROUND EXISTING VALVE BOXES TO BE ADJUSTED THAT ARE PART OF THE CHILLED WATER SYSTEM SHALL BE STAMPED WITH THE LEGEND SHOWN ON THE PLANS. THE LETTER SIZE FOR THE PROPOSED LEGEND SHALL MATCH THE EXISTING LETTER SIZE.
- 3. THE CONTRACTOR SHALL SALVAGE THE BRICK PAVERS THAT ARE REMOVED AND USE THEM FOR THE CONSTRUCTION OF THE PROPOSED BRICK PAVER SIDEWALK AT THE LOCATIONS SHOWN ON THE PLANS AND AS APPROVED BY THE ENGINEER. THE PROPOSED LOCATIONS AND THE EXISTING LOCATIONS FOR THE BRICK PAVER SIDEWALK MAY NOT BE THE SAME. SEE THE SITE IMPROVEMENT PLANS FOR ADDITIONAL INFORMATION, THIS WORK SHALL BE INCLUDED IN THE COST OF REMOVE AND REINSTALL BRICK PAVER.
- 5. THE CONTRACTOR SHALL MAKE FULL DEPTH SAW CUTS AT ALL PAVEMENT, SIDEWALK, CURB, AND CURB AND GUTTER REMOVAL LIMITS.
- 6. THE REMOVAL LIMITS MAY BE ADJUSTED AS DIRECTED BY THE ENGINEER.
- 7. THE SIDEWALK REMOVAL LIMITS FOR PARKING METER POST REMOVAL SHALL BE TWO FEET ALONG THE LENGTH OF THE PANEL AS SHOWN ON THE MISCELLANEOUS DETAILS OR AS OTHERWISE DIRECTED BY THE ENGINEER. THE BRICK PAVER REMOVAL LIMITS FOR PARKING METER POST REMOVAL OR INSTALLATION SHALL BE TWO FEET WIDE AND TWO FEET LONG OR AS OTHERWISE DIRECTED BY THE ENGINEER. THE SIDEWALK AND BRICK PAVER REMOVAL LIMITS FOR LIGHT POLE AND JUNCTION BOX REMOVAL SHALL BE FIVE FEET LONG FOR THE WIDTH OF THE SIDEWALK AND BRICK PAVER OTHERWISE DIRECTED BY THE ENGINEER. THE SIDEWALK AND BRICK PAVER OTHERWISE DIRECTED BY THE ENGINEER. THE SIDEWALK AND BRICK PAVER REMOVAL LIMITS FOR LIGHT POLE AND JUNCTION BOX INSTALLATION SHALL BE TEN FEET LONG FOR THE WIDTH OF THE SIDEWALK OR PAVERS OR AS OTHERWISE DIRECTED BY THE ENGINEER. THE REMOVAL LIMITS SHALL BE REDUCED AS DIRECTED BY THE ENGINEER. THE REMOVAL THE THE STALL BE REDUCED AS DIRECTED BY THE ENGINEER. THE MEMOVAL THE THE AND AND SUBSEQUENT REPLACEMENT REQUIRED FOR THIS WORK.


SEE THE TRAFFIC SIGNAL PLANS FOR TRAFFIC SIGNAL REMOVAL ITEMS.

SEE THE ROADWAY LIGHTING PLANS FOR ROADWAY LIGHTING REMOVAL ITEMS.

SEE DRAINAGE PLANS FOR ADDITIONAL INFORMATION.

THE LIMITS OF SIDEWALK REMOVAL AND BRICK PAVER REMOVAL ARE NOT SHOWN FOR THE REMOVAL AND/OR INSTALLATION OF LIGHT POLES, JUNCTION BOXES, OR PARKING METERS, QUANTITIES FOR THIS WORK ARE INCLUDED ON THE PLANS.

THE STRUCTURE INFORMATION SHOWN IN ITALICS IS ALSO SHOWN ON THE DRAINAGE PLANS. THE SCHEDULE OF QUANTITIES FOR THESE ITEMS IS SHOWN ON THE REMOVAL PLANS.

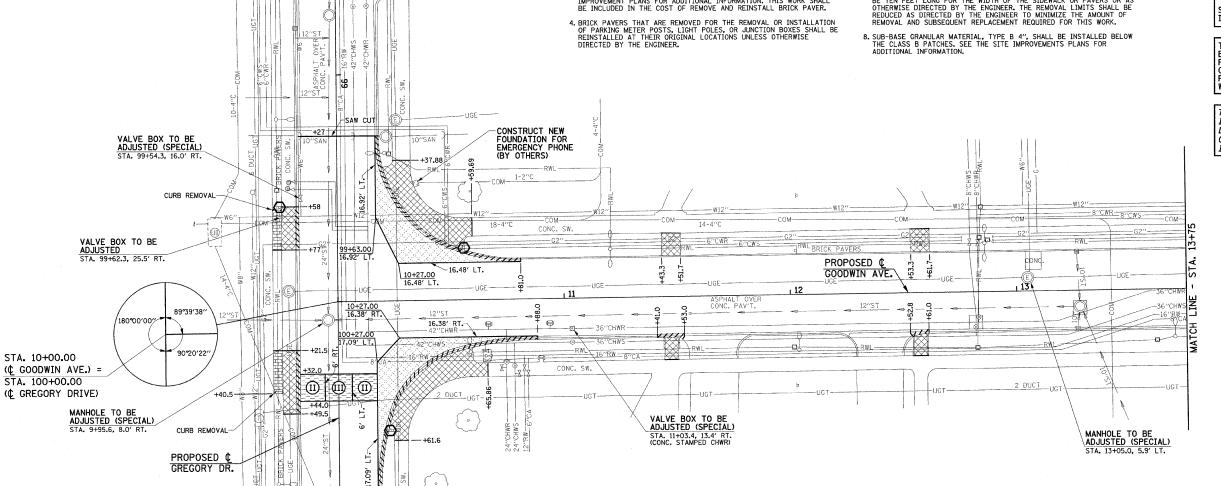

PAVEMENT REMOVAL (44000100) LOCATION SQ YD NW CORNER GOODWIN AND GREGORY 68.6 NE CORNER GOODWIN AND GREGORY 73.9 SHEET TOTAL 142.5

-SAW CU

10

STA. 10+00.00

SIDEWALK REMOVAL (44000600) LOCATION SQ FT SOUTH SIDE OF GREGORY 283.2 NW CORNER GOODWIN AND GREGORY NE CORNER GOODWIN AND GREGORY 675.1 SHEET TOTAL 1651.1

LOCATION

SOUTH SIDE OF GREGORY

ROADWAY LIGHTING

REMOVE AND REINSTALL BRICK PAVER (XX003313) SQ FT 142.8 75.0

SHEET TOTAL 217.8

COMBINATION CURB AND GUTTER REMOVAL (44000500) 11111

> LOCATION FOOT SOUTH SIDE OF GREGORY 47.0 NW CORNER GOODWIN AND GREGORY 94.0 NE CORNER GOODWIN AND GREGORY 134.4 SHEET TOTAL 275.4

CURB REMOVAL (44000300) LOCATION FOOT SOUTH SIDE OF GREGORY 8.0 SHEET TOTAL 8.0

REMOVING AND RESETTING STREET SIGNS ♠

121	1031300/	
LOCATION		EACH
STA. 99+58 RT.		1
STA. 100+57 LT.		1
STA. 10+56 LT.		1
	SHEET TOTAL	3

STF	RUCTURE	ADJU:	STMENT	AND	REMOVAL	PAY	ITEMS	-	10+00	TO	13+7	5
CODE NO.					DESCRIPTION						UNIT	QUAN
60255600	MANHOLES	TO BE	ADJUSTE	(SPE	CIAL)						EACH	2
60266600	VALVE BO	XES TO	BE ADJU	STED							EACH	1
60266610	VALVE BO	XES TO	BE ADJU	STED (SPECIAL)						EACH	2


SHEET TOTAL 29.4


CLASS B PATCHES, TYPE II, 8" (44200934) STATION TO STATION SQ YD 100+32 LT. 14.8 100+32 RT. 100+44 RT. 14.6


CLASS B PATCHES, TYPE III, 8" (44200942) STATION TO STATION SQ YD SHEET TOTAL 16.0

TOTAL SHEE NO. DESIGNED - JAJ REVISED -SECTION COLINTY FILE NAME = REMOVALS/RELOCATIONS PLAN STATE OF ILLINOIS p:\u0070052\plans\sheets\10-Removal.don DRAWN - DLM REVISED 7175 07-00456-00-RS CHAMPAIGN 75 11 CHECKED - RLH REVISED DEPARTMENT OF TRANSPORTATION CONTRACT NO. 91392 PLOT DATE = GOODWIN AVENUE DATE REVISED SCALE : 1"=20" SHEET NO. 11 OF 75 SHEETS STA. 10+00 TO STA. 13+75 - 01-2009 FED. ROAD DIST. NO. ILLINOIS FED. AID PROJECT

SEE THE TRAFFIC SIGNAL PLANS FOR TRAFFIC SIGNAL REMOVAL ITEMS. **LEGEND** SEE THE ROADWAY LIGHTING PLANS FOR ROADWAY LIGHTING REMOVAL ITEMS. R - STRUCTURE TO BE REMOVED SEE DRAINAGE PLANS FOR ADDITIONAL INFORMATION. THE LIMITS OF SIDEWALK REMOVAL AND BRICK PAVER REMOVAL ARE NOT SHOWN FOR THE REMOVAL AND/OR INSTALLATION OF LIGHT POLES, JUNCTION BOXES, OR PARKING METERS, QUANTITIES FOR THIS GAS MAIN TO BE RELOCATED BY OTHERS (AS REQUIRED FOR PROPOSED MANHOLE CONSTRUCTION) STA. 16+58.0, 26.0' LT. WORK ARE INCLUDED ON THE PLANS. STA. 16+48.16 (C GOODWIN AVE.) = THE STRUCTURE INFORMATION SHOWN
IN ITALICS IS ALSO SHOWN ON THE STA. 200+00.00 (C NEVADA ST.) 90°09′11′ OF QUANTITIES FOR THESE ITEMS 89°45'32' IS SHOWN ON THE REMOVAL PLANS. VALVE BOXES TO BE ADJUSTED /STA. 199+54.4, 24.5' LT. STA. 199+55.9, 22.7' LT. SEE SHEET 11 FOR REMOVAL NOTES STA. 16+47.81 (¢ GOODWIN AVE.) = 90°19'13" 89°46'04" VALVE BOXES TO BE ADJUSTED STA. 200+00.00 (¢ NEVADA ST.) CUT STA. 16+74.3, 27.9' LT. STA. 16+76.8, 27.7' LT. (CONC. STAMPED CHWRARV AND CHWSARV) REMOVE EXISTING TIMBER EDGING ALONG THE BACK SIDE OF EXISTING SIDEWALK. THE COST OF THIS WORK SHALL BE CONSIDERED INCLUDED IN SIDEWALK REMOVAL. +49-6-PROPOSED (199+74.00 11.00' RT. GOODWIN AVE. STEAMSESSES 14-4"C 62"- 8"CWR-8"CWS--8"CWR -8"CWS-12.0'LT.-19.0'/LT.-16+48.24 D ASPHALT OVER CONC. PAV'T. 19.00' LT. ASPHALT OVER CONC, PAV'T. 16+24.60 19.50' RT 16.26'RT. _17.5′ RT. ----16"RW-8"CA-CONC. SW. -18" PIPE FOR STEAM SYSTEM---FOR STEAM SYSTEM----2 DUCT INLET TO BE ADJUSTED W/NEW TY. 11 F&G +51.6 STA. 16+06.5, 16.8' RT. RIM=736.62 VALVE BOX TO BE ADJUSTED STA. 16+72.2, 35.9' RT. VALVES AND FRAMES & LIDS TO REMAIN AT EXISTING ELEVATIONS WITH NEW FIRE HYDRANT TO BE RELOCATED BY OTHERS STA. 16+72.0, 38.4' RT. (1) THE CONTRACTOR SHALL REMOVE AND RESET THE EXISTING BOLLARD AND FOUNDATION AS REQUIRED FOR CONSTRUCTION OF THE PROPOSED SIDEWALK WITH MONOLITHIC CURB AND AS DIRECTED BY THE ENGINEER, IF NECESSARY, A PROPOSED CONCRETE FOUNDATION FOR THE EXISTING BOLLARD SHALL BE CONSTRUCTED TO MATCH THE EXISTING FOUNDATION, THE COST OF THIS WORK SHALL BE CONSIDERED INCLUDED IN SIDEWALK REMOVAL. CONCRETE
(CONC. FOR VALVES STAMPED CHWR AND CHWS) REMOVE 4' X 4' OF PAVEMENT ABANDON AND FILL EXISTING SANITARY MANHOLE TO BE ADJUSTED STA. 200+62.7, 17.3' LT. RIM=736.02 STRUCTURE ADJUSTMENT AND REMOVAL PAY ITEMS - 13+75 TO 18+50 MANHOL F MANTULE.
STA. 200+60.0, 0.2' LT.
RIM-735.95
INV.=730.4*
(PLUG PIPE. FILL MANHOLE
WITH CLSM, REMOVE FRAME
AND LID) DESCRIPTION PAVEMENT REMOVAL (44000100) PARKING METER POSTS TO BE REMOVED LOCATION SQ YD 60261300 INLETS TO BE ADJUSTED WITH NEW TYPE 11 FRAME AND GRATI 60266600 VALVE BOXES TO BE ADJUSTED (Z0036700) STATION TO STATION EACH SE CORNER GOODWIN AND NEVADA 65.9 60500060 REMOVING INLETS NW CORNER GOODWIN AND NEVADA 111.8 17+08 LT. 17+76 LT. X0322464 ABANDON AND FILL EXISTING SANITARY MANHOLE NE CORNER GOODWIN AND NEVADA 94.2 17+21 RT. PROPOSED (201+03 RT. NEVADA ST. SHEET TOTAL 337.5 SHEET TOTAL 6 COMBINATION CURB AND GUTTER REMOVAL REMOVING AND RESETTING STREET SIGNS SIDEWALK REMOVAL (44000600) ///// (44000500) (Z0051500) SQ FT LOCATION LOCATION FOOT EACH SW CORNER GOODWIN AND NEVADA 301.9 LOCATION 76.5 SE CORNER GOODWIN AND NEVADA 460.6 SW CORNER GOODWIN AND NEVADA STA. 16+08 RT. NW CORNER GOODWIN AND NEVADA 493.4 SE CORNER GOODWIN AND NEVADA 105.5 STA. 16+83 LT. NE CORNER GOODWIN AND NEVADA 725.8 NW CORNER GOODWIN AND NEVADA 90.8 NE CORNER GOODWIN AND NEVADA ROADWAY LIGHTING 185.0 93.1 STA, 199+60 RT. PARKING METER POSTS 40.0 STA. 200+45 LT. SHEET TOTAL 365.9 SHEET TOTAL 2206.7 SHEET TOTAL 5 COUNTY TOTAL SHEETS NO.
CHAMPAIGN 75 12 FILE NAME = DESIGNED - JAJ REVISED SECTION REMOVALS/RELOCATIONS PLAN STATE OF ILLINOIS p:\u0070052\plans\sheets\10-Removal.dgn DRAWN - DLM REVISED 07-00456-00-RS DEPARTMENT OF TRANSPORTATION CHECKED - RLH REVISED PLOT DATE = CONTRACT NO. 91392 GOODWIN AVENUE - 01-2009 REVISED SCALE : 1"=20" SHEET NO. 12 OF 75 SHEETS STA. 13+75 TO STA. 18+50

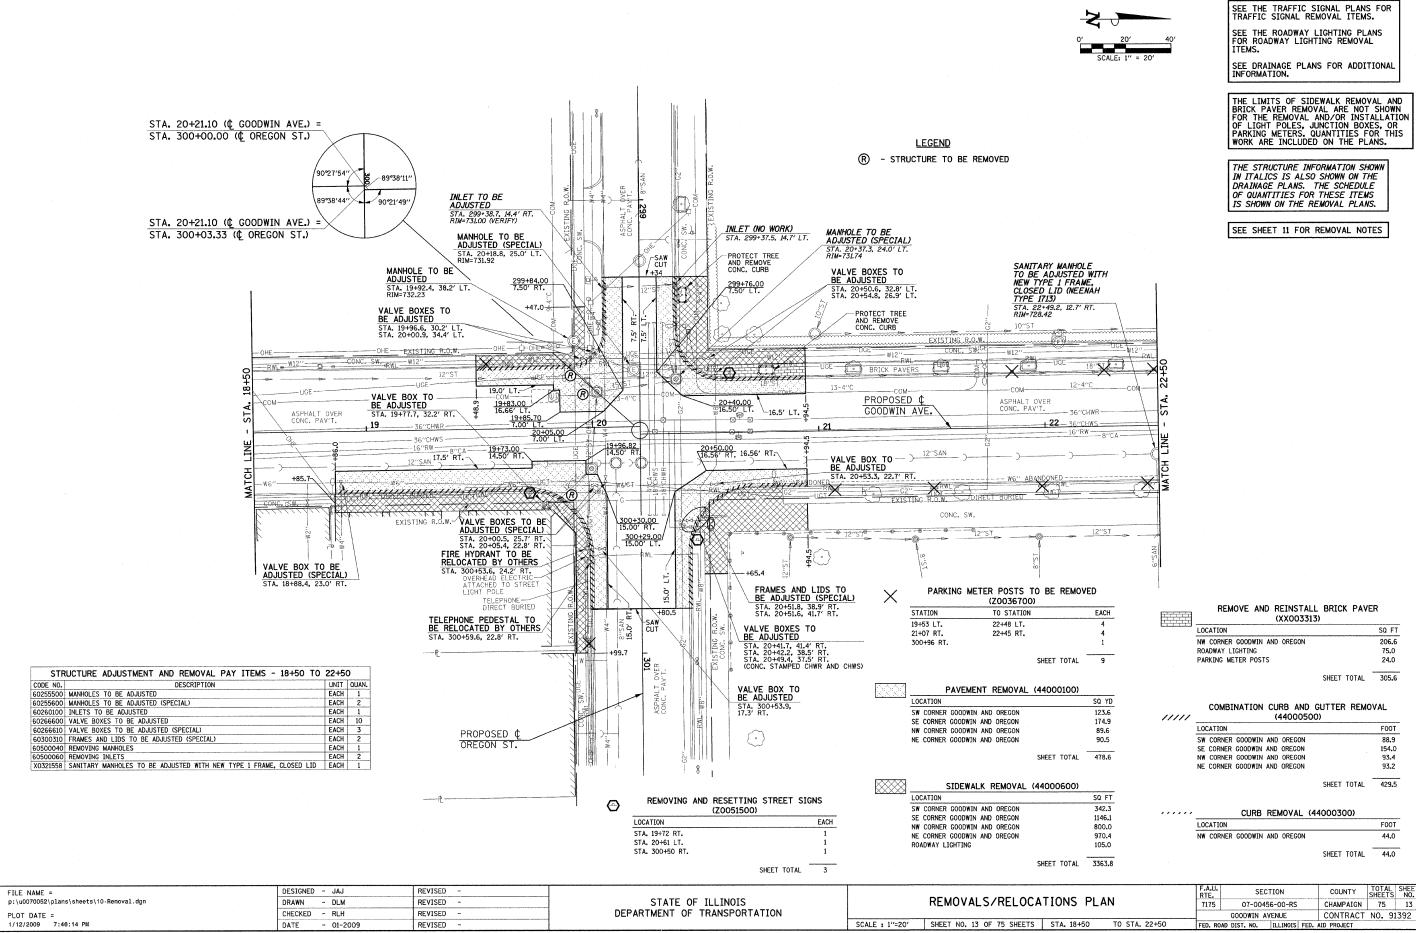

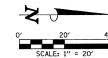

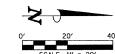

SEE THE TRAFFIC SIGNAL PLANS FOR TRAFFIC SIGNAL REMOVAL ITEMS.


SEE THE ROADWAY LIGHTING PLANS FOR ROADWAY LIGHTING REMOVAL ITEMS.

SEE DRAINAGE PLANS FOR ADDITIONAL INFORMATION.

THE LIMITS OF SIDEWALK REMOVAL AND BRICK PAVER REMOVAL ARE NOT SHOWN FOR THE REMOVAL AND/OR INSTALLATION OF LIGHT POLES, JUNCTION BOXES, OR PARKING METERS. QUANTITIES FOR THIS WORK ARE INCLUDED ON THE PLANS.

THE STRUCTURE INFORMATION SHOWN IN ITALICS IS ALSO SHOWN ON THE DRAINAGE PLANS. THE SCHEDULE OF QUANTITIES FOR THESE ITEMS IS SHOWN ON THE REMOVAL PLANS.

SEE SHEET 11 FOR REMOVAL NOTES

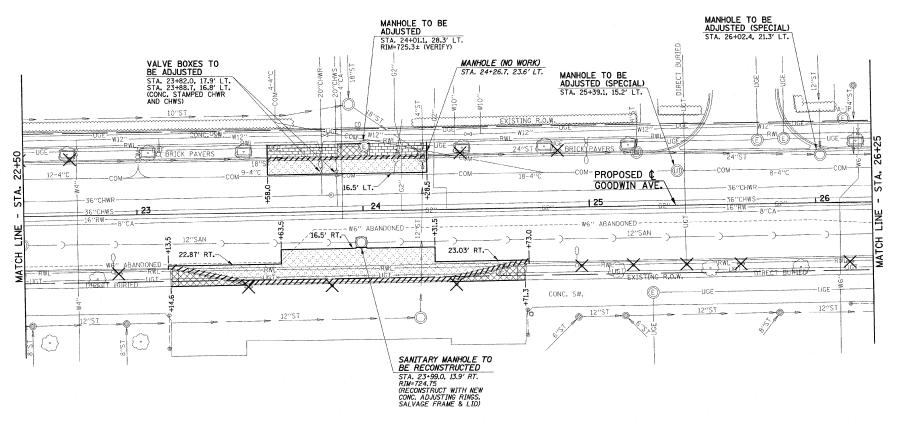

STRUCTURE ADJUSTMENT AND REMOVAL PAY ITEMS - 22+50 TO 26+25

DESCRIPTION

UNIT QUAN. EACH 1

REMOVE AND REINSTALL BRICK PAVER

(XX003313) SQ FT STATION TO STATION 303.4 175.0 23+58 LT. 24+28.5 LT. ROADWAY LIGHTING PARKING METER POSTS 20.0

COMBINATION CURB AND GUTTER REMOVAL (44000500)

> TO STATION 24+28.5 LT. 24+73 RT.

11111

STATION

23+58 LT.

23+13.5 RT.

SHEET TOTAL 498.4

SHEET TOTAL 231.6

FOOT

70.5 161.1

ŞÇÇÇ		PAVEMENT	REMOVAL	(4400	0100)	
	STATION		TO STATION			SQ YD
	23+58 LT.		24+28.5 LT.			49.4
	23+13.5 R	г.	24+73 RT.			144.0
				SHEET	TOTAL	193.4

\bowtie	SIDEWALK	REMOVAL (44000600)	
~~~	STATION	TO STATION	SQ FT
	23+89.1 LT.	24+03.3 LT.	75.6
	23+14.6 RT.	24+71.3 RT.	253.8
	PARKING METER POSTS		30.0
		SHEET TOTAL	359.4

$\times$	PARKING	METER POSTS TO E (Z0036700)	3E REMOVE	ED
	STATION	TO STATION		EACH
	22+71 LT.	24+86 LT.		3
	22+92 RT.	26+15 RT.		9
		SHE	ET TOTAL	12

DESIGNED - JAJ REVISED -FILE NAME = p:\u0070052\plans\sheets\10-Removal.dgn DRAWN - DLM REVISED CHECKED - RLH REVISED PLOT DATE = - 01-2009 REVISED

STATE OF ILLINOIS DEPARTMENT OF TRANSPORTATION


CODE NO.
60255500 MANHOLES TO BE ADJUSTED

60255600 MANHOLES TO BE ADJUSTED (SPECIAL) 60260050 SANITARY MANHOLES TO BE RECONSTRUCTED 60266600 VALVE BOXES TO BE ADJUSTED

> REMOVALS/RELOCATIONS PLAN SCALE : 1"=20' SHEET NO. 14 OF 75 SHEETS STA. 22+50 TO STA. 26+25

COUNTY TOTAL SHEET NO.

CHAMPAIGN 75 14 SECTION 07-00456-00-RS GOODWIN AVENUE CONTRACT NO. 91392

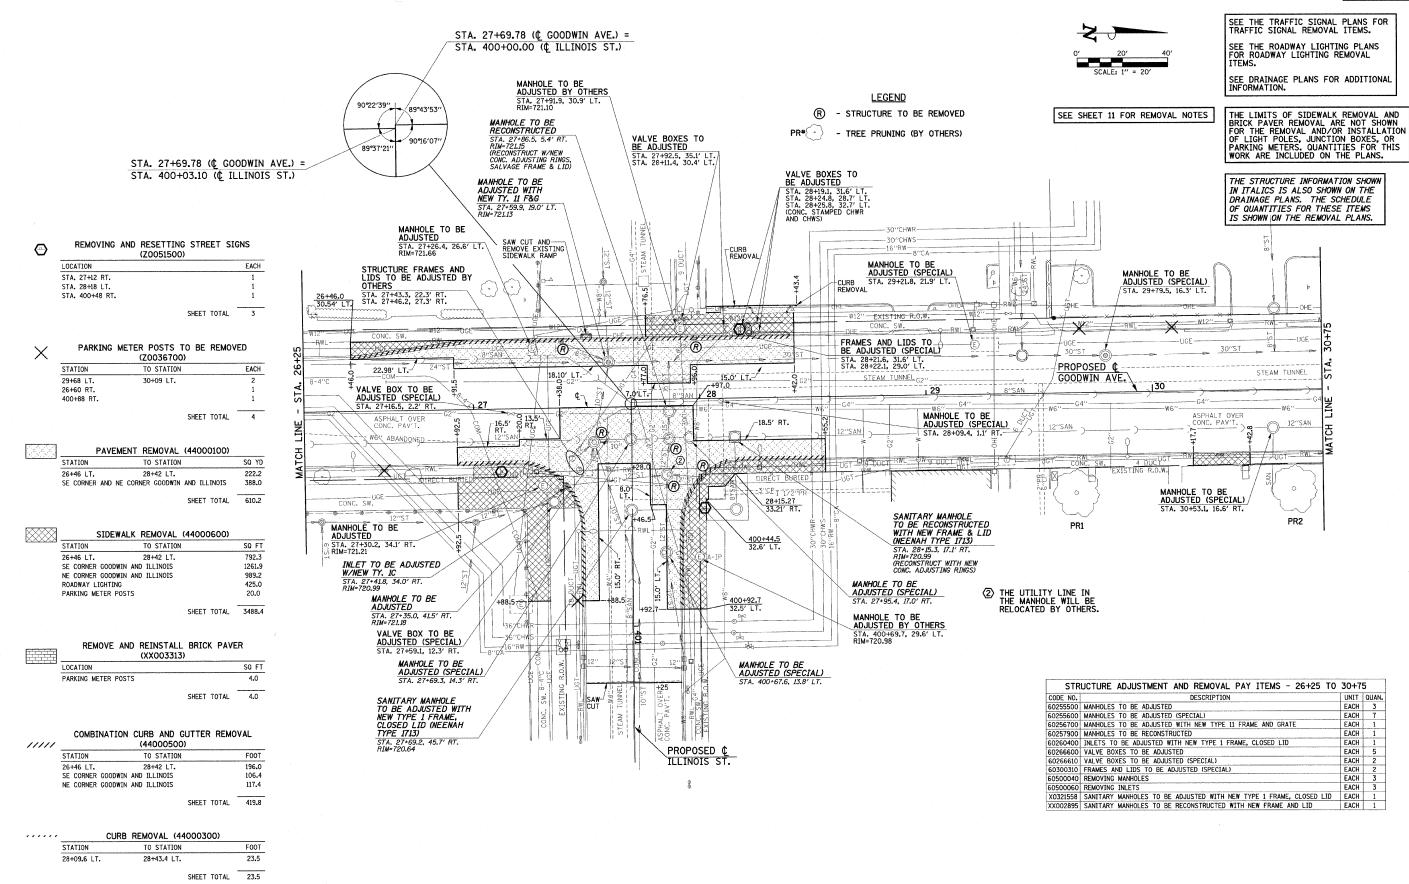

STATE OF ILLINOIS

DEPARTMENT OF TRANSPORTATION

DESIGNED - JAJ

CHECKED - RLH

- DLM

- 01-2009

DRAWN

DATE

FILE NAME =

PLOT DATE =

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COUNTY TOTAL SHEE NO.

CHAMPAIGN 75 15

CONTRACT NO. 91392

SECTION


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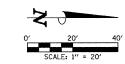
GOODWIN AVENUE

RTE. 7175

REMOVALS/RELOCATIONS PLAN

SCALE : 1"=20' SHEET NO. 15 OF 75 SHEETS STA. 26+25



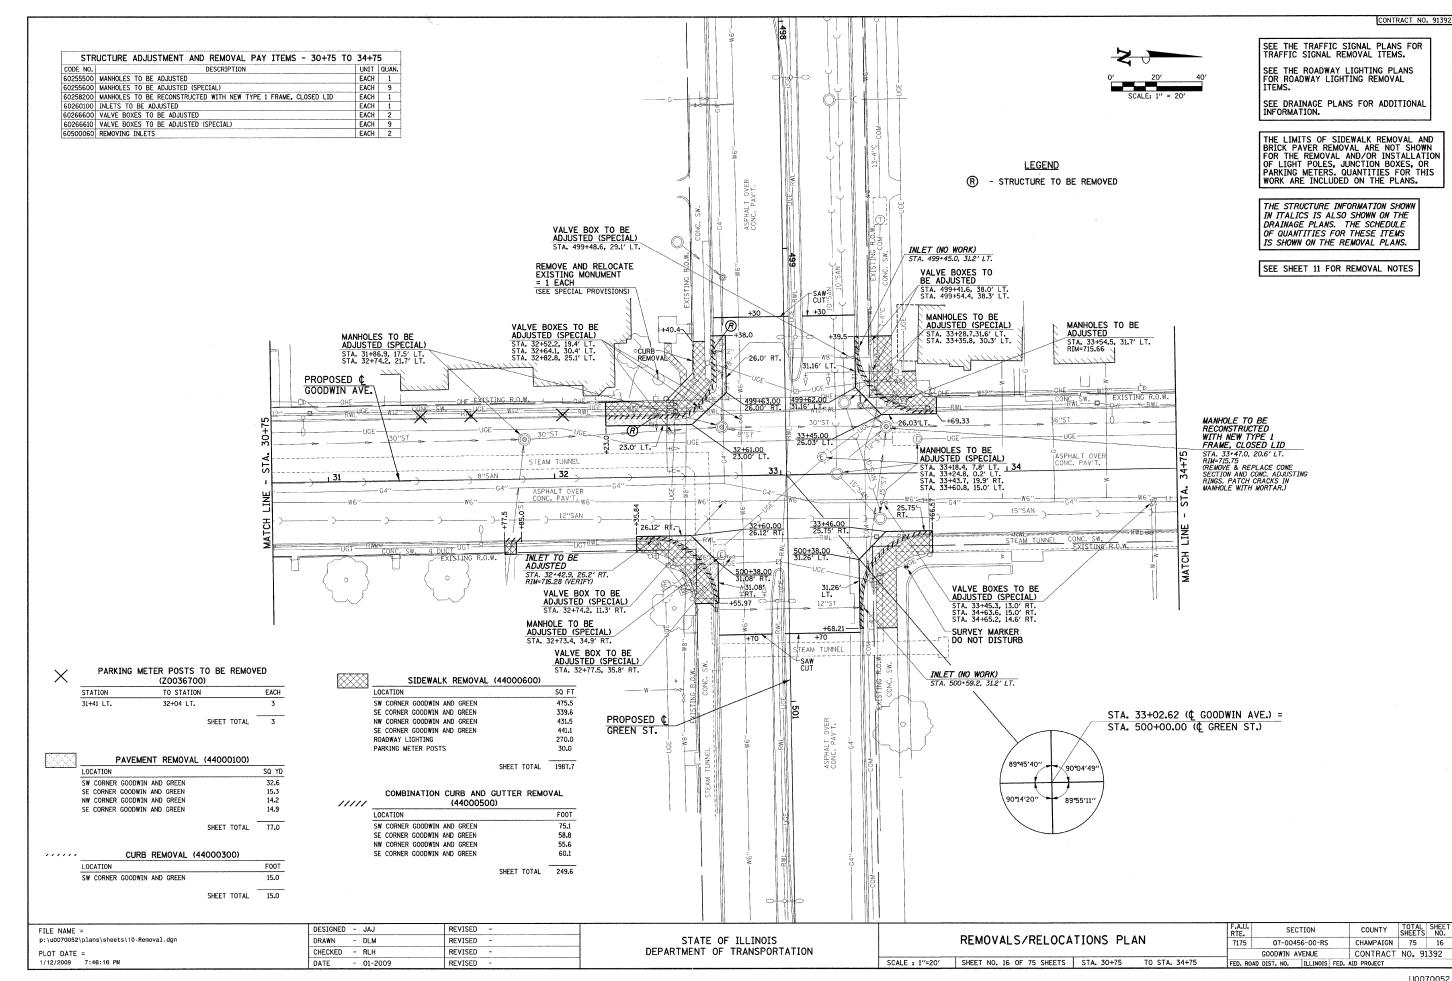

SEE THE TRAFFIC SIGNAL PLANS FOR TRAFFIC SIGNAL REMOVAL ITEMS.


SEE THE ROADWAY LIGHTING PLANS FOR ROADWAY LIGHTING REMOVAL ITEMS.

SEE DRAINAGE PLANS FOR ADDITIONAL INFORMATION.

THE LIMITS OF SIDEWALK REMOVAL AND BRICK PAVER REMOVAL ARE NOT SHOWN FOR THE REMOVAL AND/OR INSTALLATION OF LIGHT POLES, JUNCTION BOXES, OR PARKING METERS. QUANTITIES FOR THIS WORK ARE INCLUDED ON THE PLANS.

THE STRUCTURE INFORMATION SHOWN IN ITALICS IS ALSO SHOWN ON THE DRAINAGE PLANS. THE SCHEDULE OF QUANTITIES FOR THESE ITEMS IS SHOWN ON THE REMOVAL PLANS.

SEE SHEET 11 FOR REMOVAL NOTES

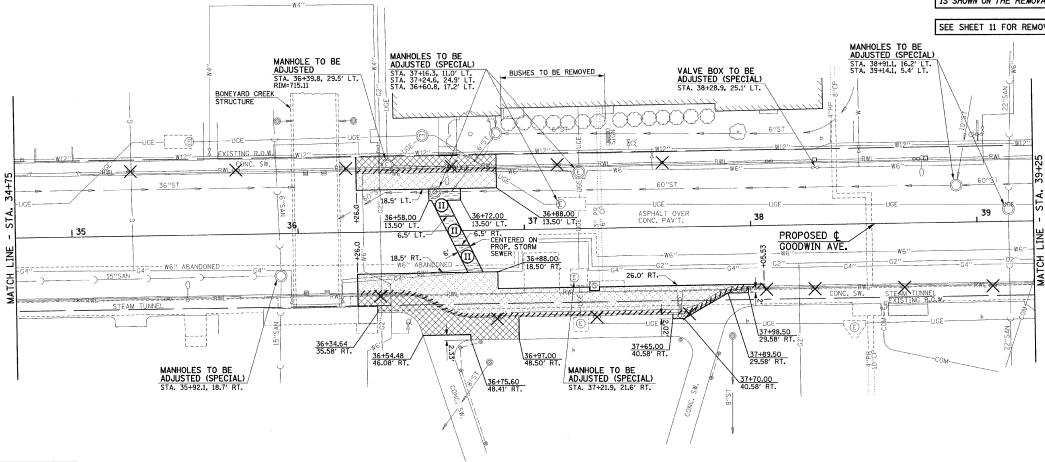

STR	UCTURE ADJUSTMENT AND REMOVAL PAY ITEMS - 34+75 TO	39+2	5
CODE NO.	DESCRIPTION	UNIT	QUAN.
60255500	MANHOLES TO BE ADJUSTED	EACH	1
60255600	MANHOLES TO BE ADJUSTED (SPECIAL)	E.ACH	7
60266610	VALVE BOXES TO BE ADJUSTED (SPECIAL)	EACH	1

$\times$	PARKING	METER POSTS TO BE (Z0036700)	E REMOVI	ED
	STATION	TO STATION		EACH
	35+26 LT.	37+61 LT.		6
	36+36 RT.	39+07 RT.		8
		SHEE	T TOTAL	14

5000	PAVEM	ENT REMOVAL (44000100	)
<u>Lincolnium</u>	STATION	TO STATION	SQ YD
	36+26 LT.	36+88 LT.	52.6
	36+26 RT.	38+05.5 RT.	194.3
		SHEET TOTA	L 246.9


	SIDEWALK	REMOVAL (	44000600)	
KVVVV	STATION	TO STATION		SQ FT
	36+26 LT.	36+88 LT.		340.8
	36+26 RT.	37+98.5 RT.		731.2
	ROADWAY LIGHTING			340.0
	PARKING METER POSTS			100.0
			SHEET TOTAL	1512.0


////	COMBINATION	CURB AND GUTTER (44000500)	REMOVAL
	STATION	TO STATION	F00T
	36+26 LT.	36+88 LT.	62.0
	36+26 RT.	38+05.5 RT.	184.2


-(II)-:	CLASS B	PATCHES,	TYPE	11, 8'	′ (44200	934)
	STATION	TO	STATION	١		SQ Y
	36+58.0 LT.	36-	+72.0 LT	•		13.0
	36+62.7 LT.	36-	+75.7 RT	•		9.7
	36+69.0 RT.	36-	+81.5 RT	•		8.9
				SHEE	T TOTAL	31.6


STATION		1001
88 LT.		62.0
05.5 RT.		184.2
	SHEET TOTAL	246.2

FILE NAME =	DESIGNED - JAJ	REVISED -			F.A.U. SECTION	COUNTY TOTAL SHEET
p:\u0070052\plans\sheets\10-Removal.dgn	DRAWN - DLM	REVISED -	STATE OF ILLINOIS	REMOVALS/RELOCATIONS PLAN	7175 07-00456-00-RS	CHAMPAIGN 75 17
PLOT DATE =	CHECKED - RLH	REVISED ~	DEPARTMENT OF TRANSPORTATION		GOODWIN AVENUE	CONTRACT NO. 91392
1/12/2009 7:46:17 PM	DATE - 01-2009	REVISED ~		SCALE: 1"=20' SHEET NO. 17 OF 75 SHEETS STA. 34+75 TO STA. 39+25	FED. ROAD DIST. NO.   ILLINOIS FED.	AID PROJECT

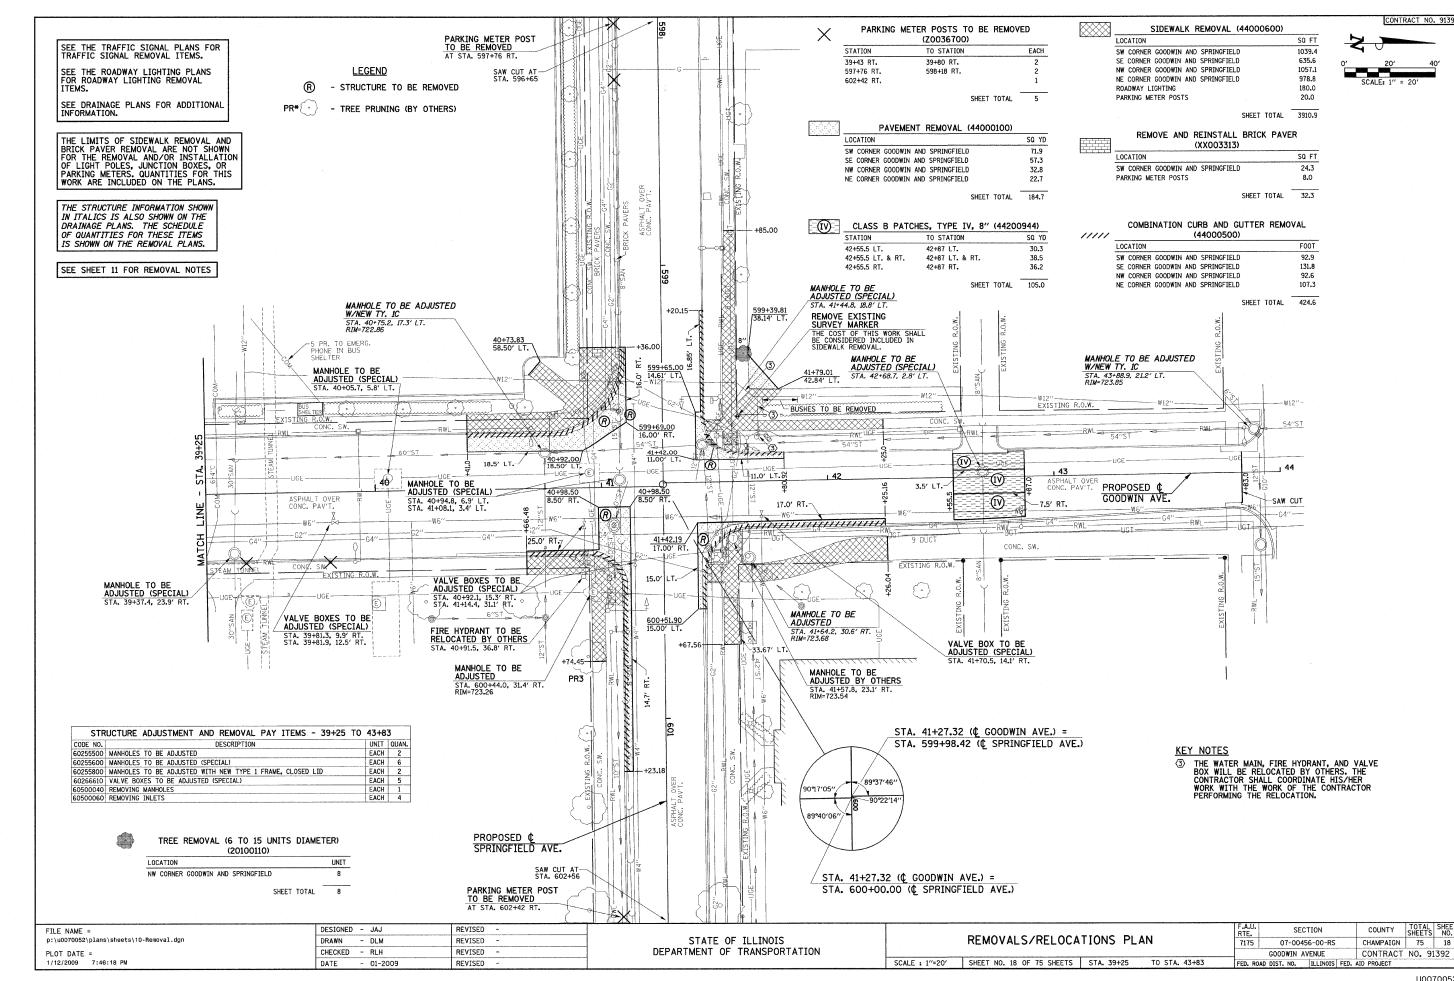

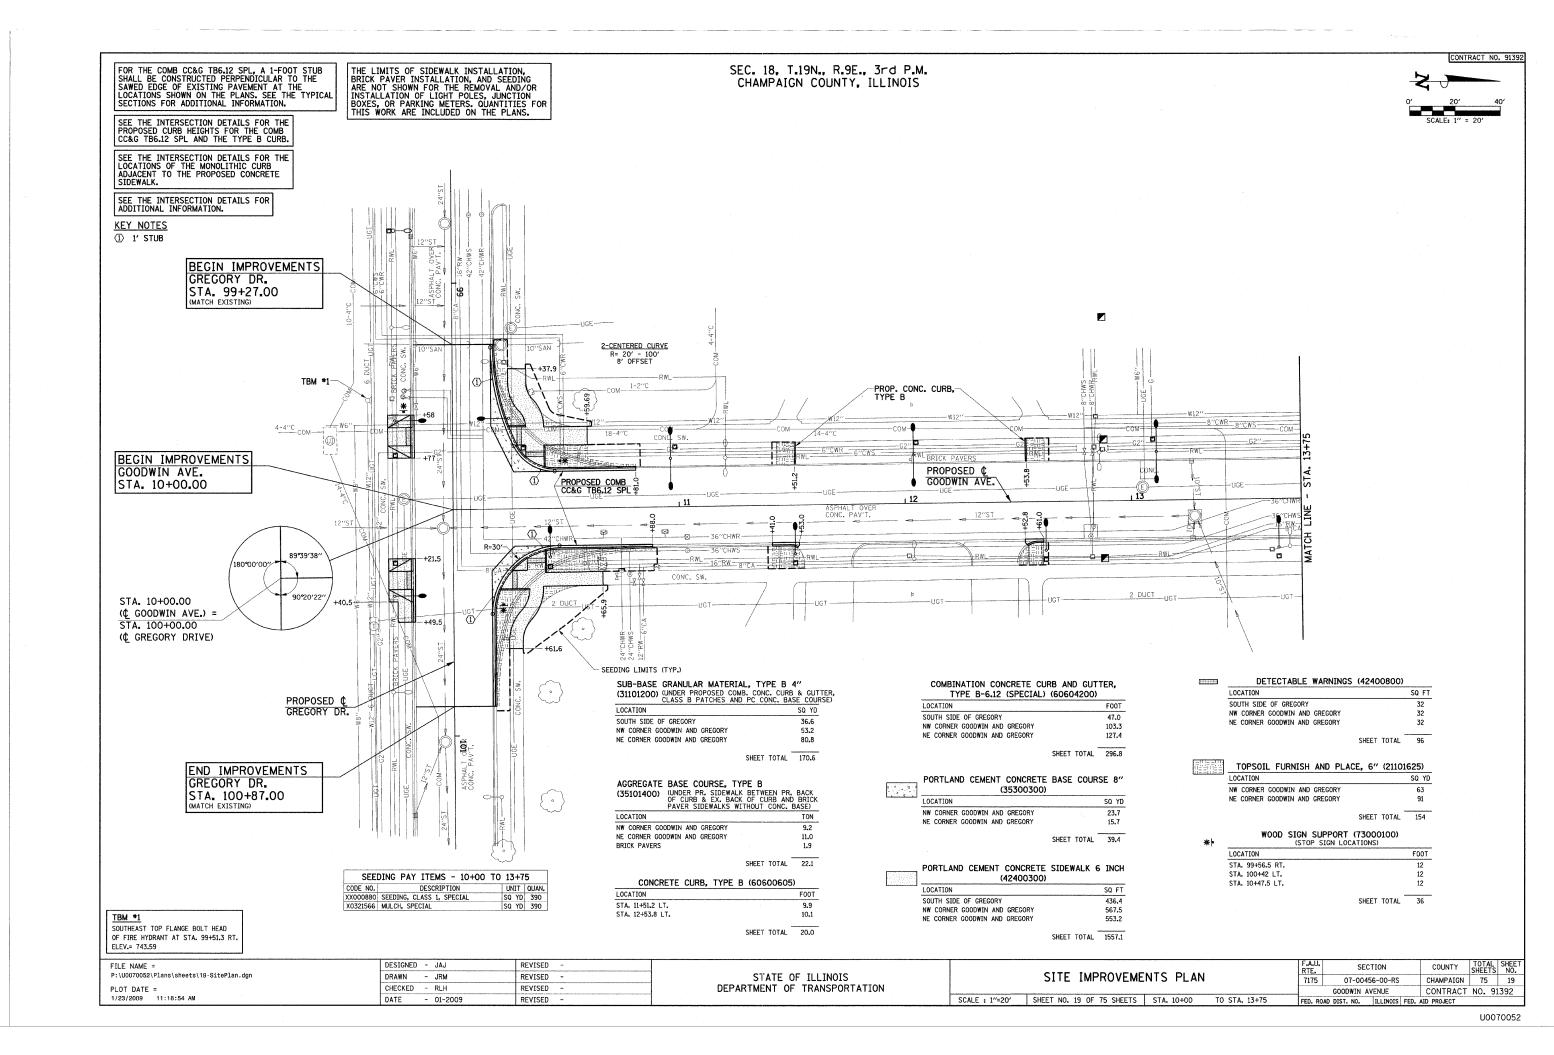

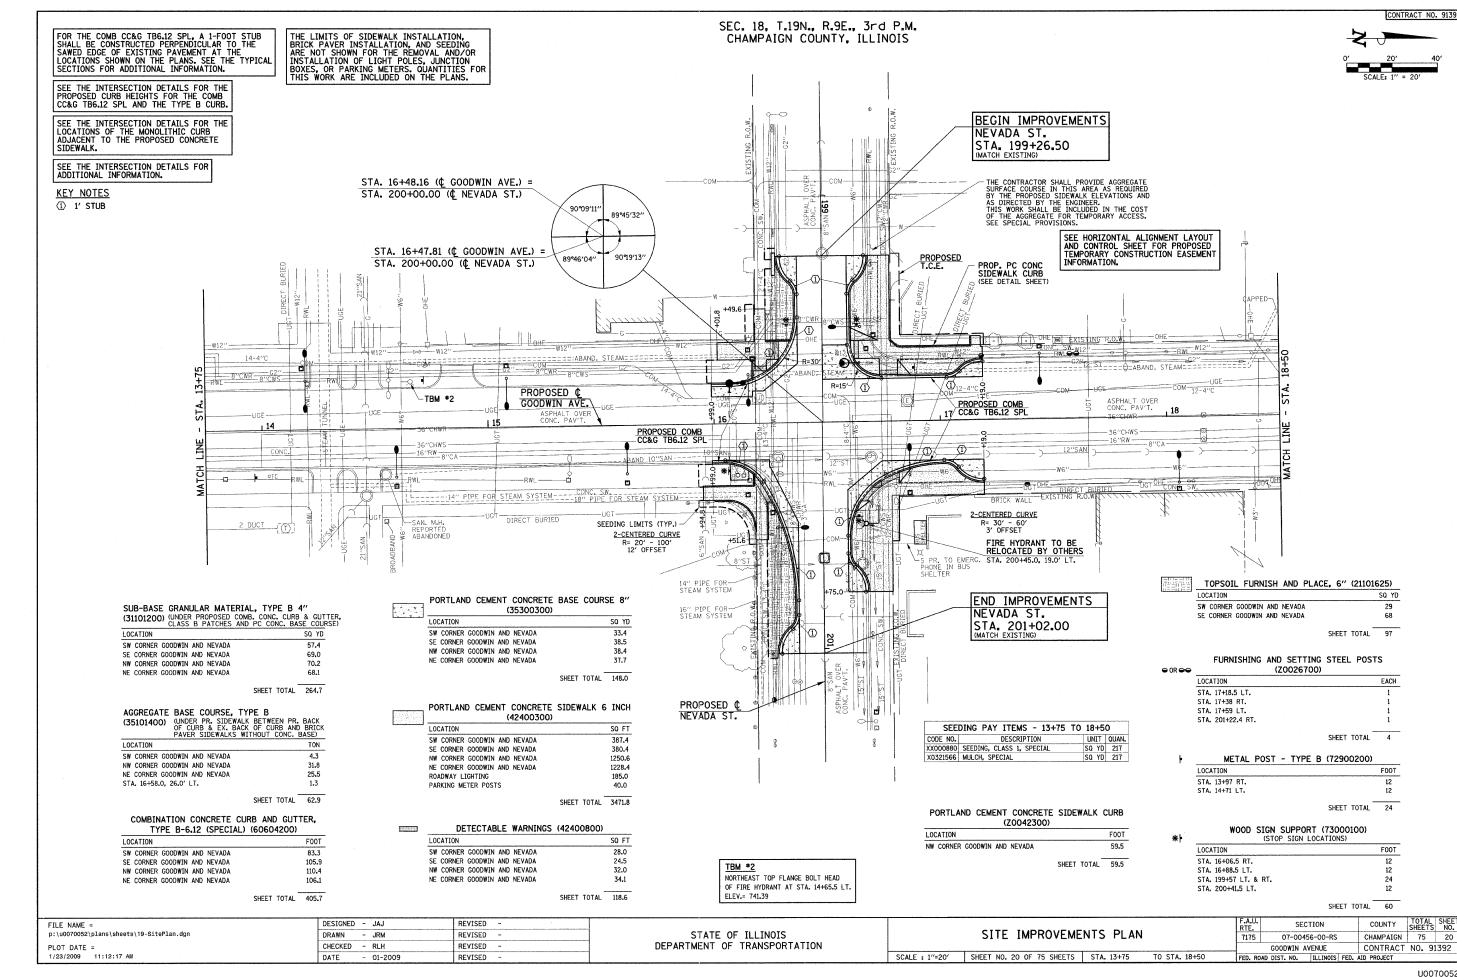

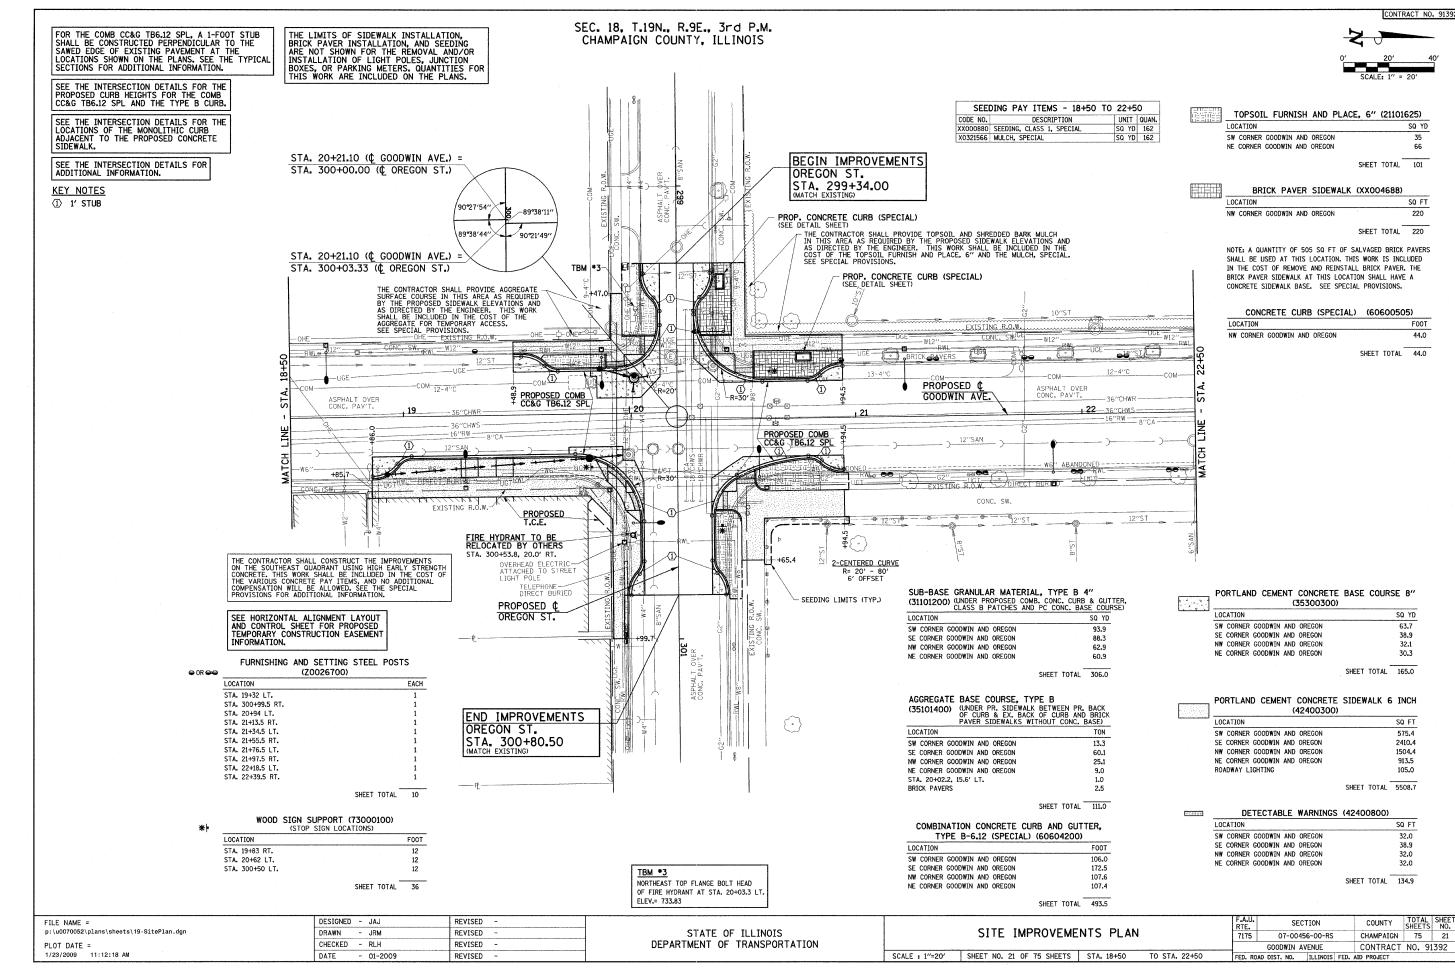

FOR THE COMB CC&G TB6.12 SPL, A 1-FOOT STUB SHALL BE CONSTRUCTED PERPENDICULAR TO THE SAWED EDGE OF EXISTING PAVEMENT AT THE LOCATIONS SHOWN ON THE PLANS. SEE THE TYPICAL SECTIONS FOR ADDITIONAL INFORMATION.

SEE THE INTERSECTION DETAILS FOR THE PROPOSED CURB HEIGHTS FOR THE COMB CC&G TB6.12 SPL AND THE TYPE B CURB.


SEE THE INTERSECTION DETAILS FOR THE LOCATIONS OF THE MONOLITHIC CURB ADJACENT TO THE PROPOSED CONCRETE SIDEWALK.


SEE THE INTERSECTION DETAILS FOR ADDITIONAL INFORMATION.

KEY NOTES 1 1 STUB

THE LIMITS OF SIDEWALK INSTALLATION, BRICK PAVER INSTALLATION, AND SEEDING ARE NOT SHOWN FOR THE REMOVAL AND/OR INSTALLATION OF LIGHT POLES, JUNCTION BOXES, OR PARKING METERS. QUANTITIES FOR THIS WORK ARE INCLUDED ON THE PLANS.

SEC. 18, T.19N., R.9E., 3rd P.M. CHAMPAIGN COUNTY, ILLINOIS

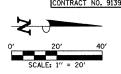

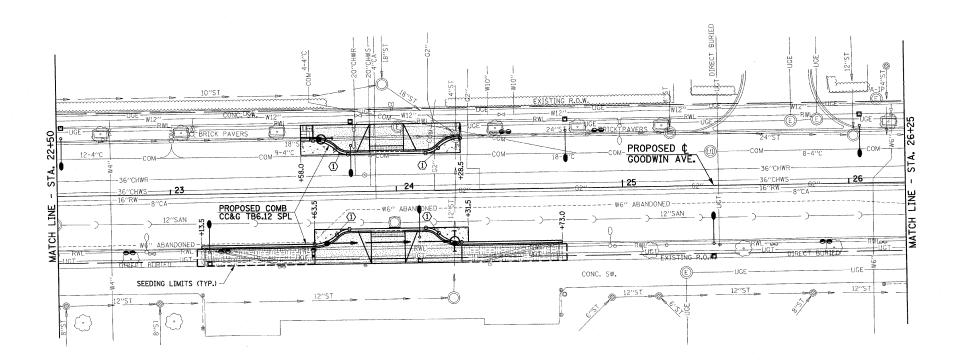

### FURNISHING AND SETTING STEEL POSTS

⊕ OR <del>∞</del>	(Z00	26700)	
	LOCATION	EA	CH
	STA. 22+81.5 RT.		1
	STA. 23+23.5 RT.	:	1
	STA. 23+63 RT.	:	1
	STA. 24+48.5 LT.	:	1
	STA. 24+89.5 LT.		1
	STA. 25+89.5 RT.		1
		SHEET TOTAL (	5

	METAL	POST	- IYPE	. в	(72900200)	
LOCA	ATION					F001
STA.	23+63 LT.				·	12
STA.	24+28.5 RT					12

	GRANULAR MA' (UNDER PROPOSEI CLASS B PATCHE	COMB. CONC.	CURB & GUTTER,
OCATION			SQ YD
EST SIDE GO	DOWIN AVENUE		36.6
AST SIDE GO	OODWIN AVENUE		61.4

AGGREGATE	BASE COUR	SE, TYF	ÈΒ		
(35101400)	(UNDER PR. S OF CURB & E PAVER SIDEW	X. BACK	OF CUF	B AND	BRICK
LOCATION					TON
WEST SIDE GOO	WIN AVENUE				14.8
EAST SIDE GOO	DWIN AVENUE				40.6
BRIACK PAVERS					5.7
			SHEET	TOTAL	61.1

#### COMBINATION CONCRETE CURB AND GUTTER, TYPE B-6.12 (SPECIAL) (60604200) LOCATION FOOT WEST SIDE GOOWIN AVENUE EAST SIDE GOODWIN AVENUE 73.8

SHEET TOTAL 236.8

163.0

SHEET TOTAL 98.0

PORTLAND CEMENT CONCRETE BASE COURSE 8"

LOCATION	SQ YE
WEST SIDE GOOWIN AVENUE	15.5
EAST SIDE GOODWIN AVENUE	14.6

	PORTLAND CEMENT CONCRETE (42400300)	SIDEWALK 6	INCH
لحبجب	LOCATION		SQ FT
	WEST SIDE GOOWIN AVENUE		672.4
	EAST SIDE GOODWIN AVENUE		784.8
	PARKING METER POSTS		30.0
		SHEET TOTAL	1487.2

DETECTABLE WARNINGS (42400800)	
LOCATION	SQ FT
WEST SIDE GOOWIN AVENUE	30.0
EAST SIDE GOODWIN AVENUE	30.0
SHEET TOTAL	60.0

TOPSOIL	FURNISH AND PLACE, 6"	(21101625)
STATION	TO STATION	SQ YD
23+13.5 RT.	23+63.5 RT.	41
24+28.5 RT.	24+73.0 RT.	37
	STATION 23+13.5 RT.	STATION         TO STATION           23+13.5 RT.         23+63.5 RT.


SHEET TOTAL 78


	BRICK	PAVER SIDEWALK	(XX004688)	
11	STATION	TO STATION		SQ FT
	23+58.0 LT.	23+63.5 LT.		0
			SHEET TOTAL	0


NOTE: A QUANTITY OF 30 SQ FT OF SALVAGED BRICK PAVERS SHALL BE USED AT THIS LOCATION. THIS WORK IS INCLUDED
IN THE COST OF REMOVE AND REINSTALL BRICK PAVER. THE
BRICK PAVER SIDEWALK AT THIS LOCATION SHALL HAVE AN
AGGREGATE BASE. SEE SPECIAL PROVISIONS.


SEED	DING PAY ITEMS - 22+50 TO	26+2	5
CODE NO.	DESCRIPTION	UNIT	QUAN.
XX000880	SEEDING, CLASS 1, SPECIAL	SQ YD	101
X0321566	MULCH, SPECIAL	SQ YD	101

FILE NAME =	DESIGNED - JAJ	REVISED -			F.A.U. SECTION	COUNTY TOTAL SHEET NO.
p:\u0070052\plans\sheets\19-SitePlan.dgn	DRAWN - JRM	REVISED -	STATE OF ILLINOIS	SITE IMPROVEMENTS PLAN	7175 07-00456-00-RS	CHAMPAIGN 75 22
PLOT DATE =	CHECKED ~ RLH	REVISED -	DEPARTMENT OF TRANSPORTATION		GOODWIN AVENUE	CONTRACT NO. 91392
1/23/2009 11:12:19 AM	DATE - 01-2009	REVISED -		SCALE : 1"=20'   SHEET NO. 22 OF 75 SHEETS   STA. 22+50 TO STA. 26+25	FED. ROAD DIST. NO. ILLINOIS F	ED. AID PROJECT

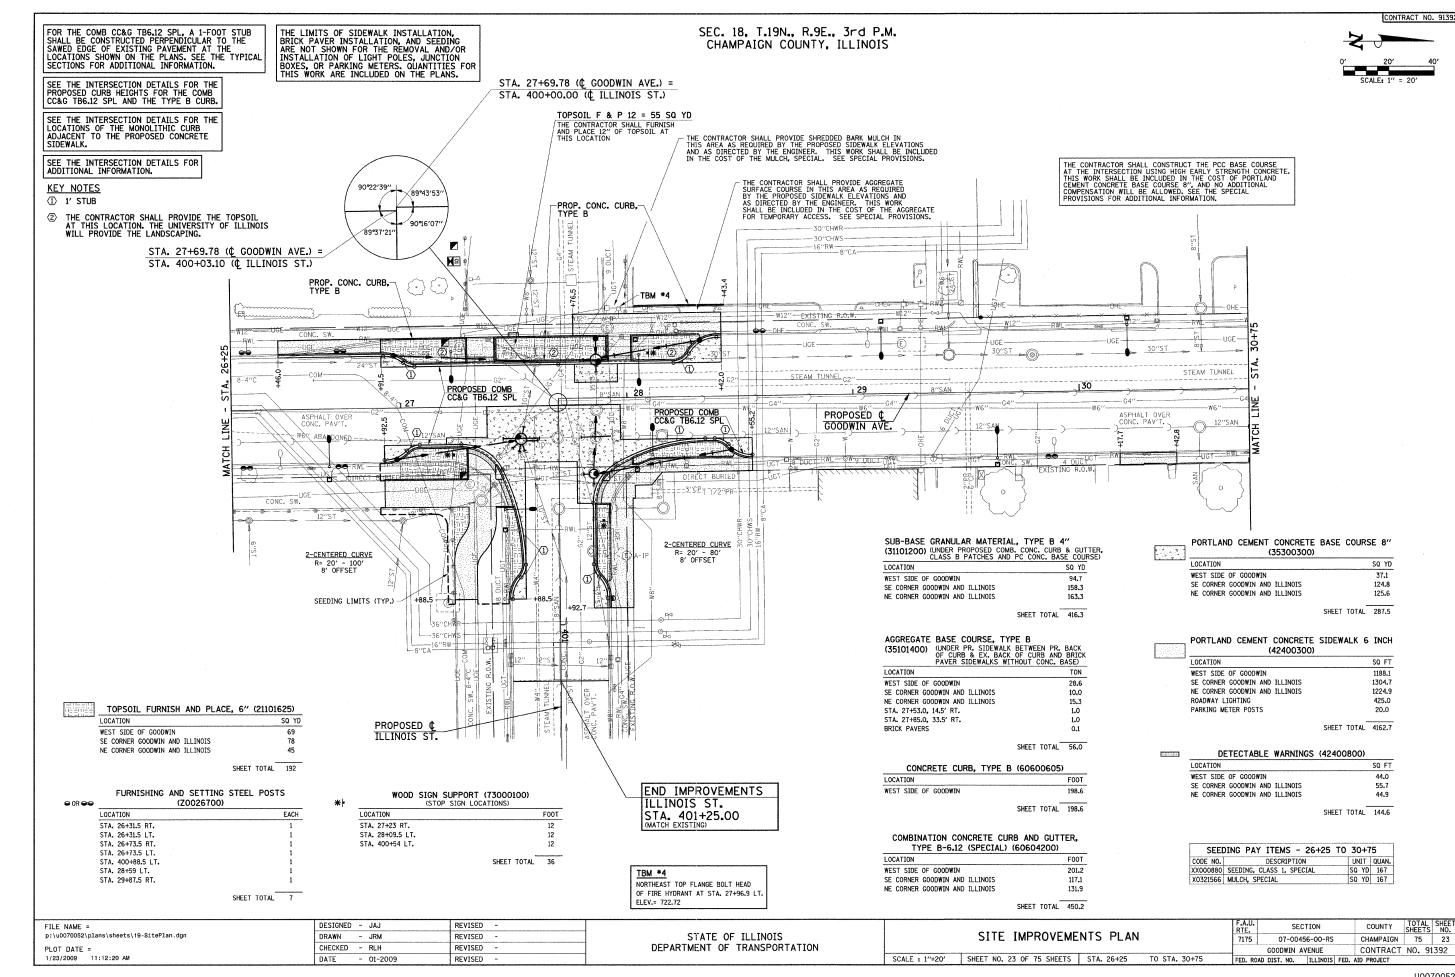

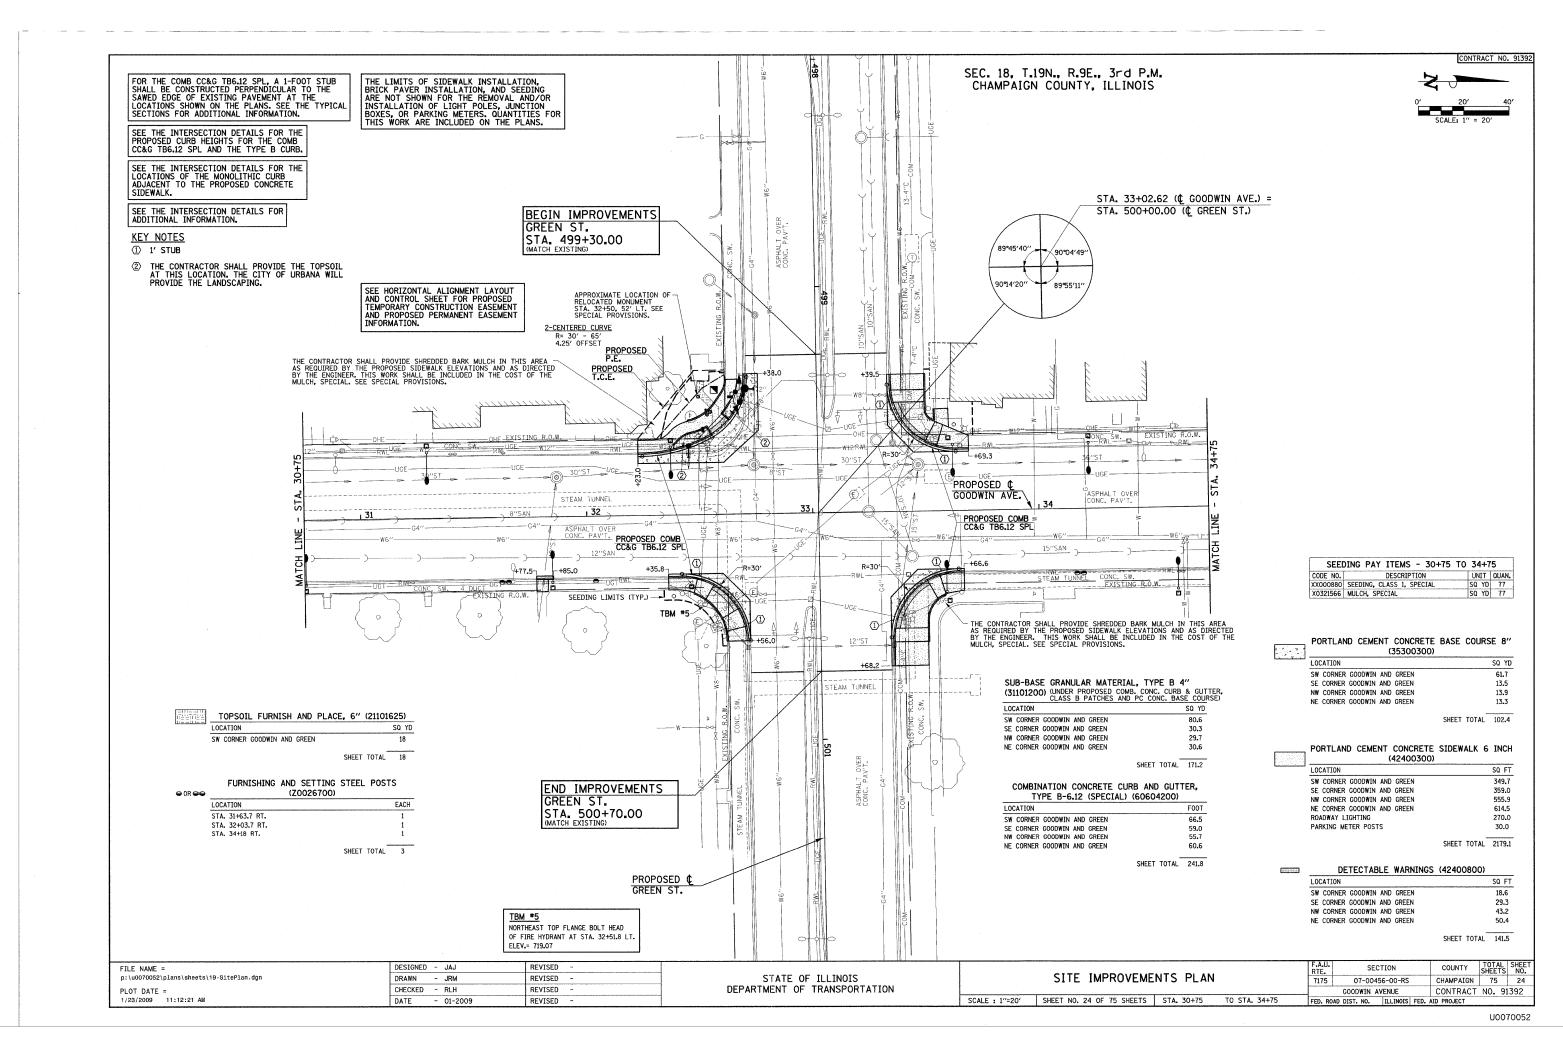

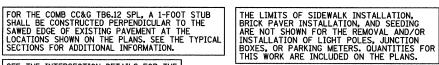

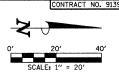


SEE THE INTERSECTION DETAILS FOR THE PROPOSED CURB HEIGHTS FOR THE COMB CC&G TB6.12 SPL AND THE TYPE B CURB.

SEE THE INTERSECTION DETAILS FOR THE LOCATIONS OF THE MONOLITHIC CURB ADJACENT TO THE PROPOSED CONCRETE SIDEWALK.

SEE THE INTERSECTION DETAILS FOR ADDITIONAL INFORMATION.

KEY NOTES ① 1' STUB

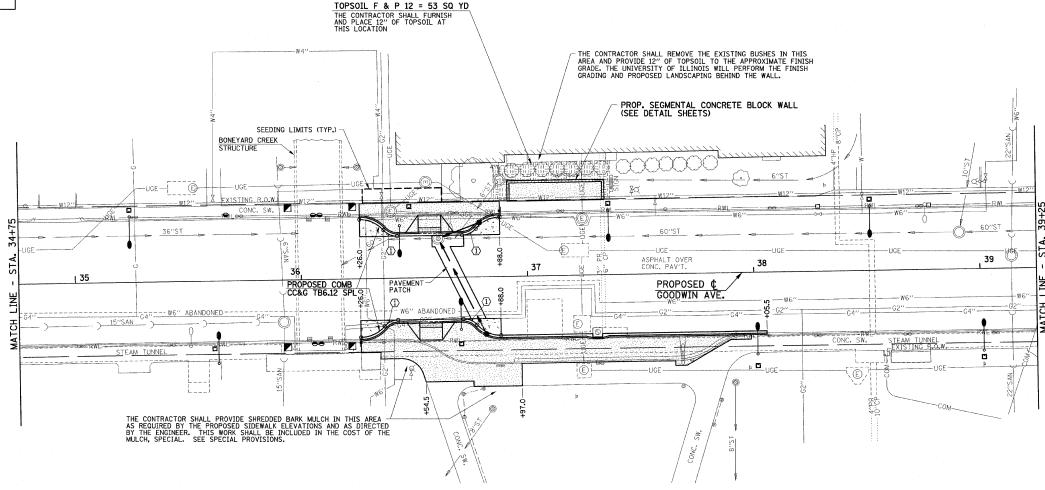

#### FURNISHING AND SETTING STEEL POSTS (70026700)

⊕ OR ⇔⇔

LOCATION		EACH
STA. 35+67 LT.		1
STA. 36+07 LT.		1
STA. 36+07 RT.		1
	SHEET TOTAL	. 3

ŀ	METAL POST - TYPE B (72900200)	
	LOCATION	F001
	STA. 36+26 RT.	12
	STA. 36+88 LT.	12
	_	
	SHEET TOTAL	24

#### SUB-BASE GRANULAR MATERIAL, TYPE B 4" (31101200) (UNDER PROPOSED COMB. CONC. CURB & GUTTER, CLASS B PATCHES AND PC CONC. BASE COURSE) LOCATION WEST SIDE OF GOODWIN 52.3 EAST SIDE OF GOODWIN

SHEET TOTAL 133.8

SHEET TOTAL 100.2

SHEET TOTAL 250.4

AGGREGATE	BASE COURSE, TYPE B	
(35101400)	(UNDER PR. SIDEWALK BETWEEN	PR. BACK
100202 1007	OF CURB & EX. BACK OF CURB	
	PAVER SIDEWALKS WITHOUT CON	C. BASE)
LOCATION		TON
WEST SIDE OF	GOODWIN	16.4
EAST SIDE OF	GOODWIN	83.8

COMBINATION CONCRETE CURB AND TYPE B-6.12 (SPECIAL) (60604	
LOCATION	F00T
WEST SIDE OF GOODWIN	66.4
EAST SIDE OF GOODWIN	184.0

#### PORTLAND CEMENT CONCRETE BASE COURSE 8" LOCATION SQ YD WEST

	GOODWIN			15.1
		SHEET	TOTAL	30.5

SHEET TOTAL 3789.8

(42400300)	VALK 6 INCH
 LOCATION	SQ FT
WEST SIDE OF GOODWIN	991.9
EAST SIDE OF GOODWIN	2357.9
ROADWAY LIGHTING	340.0
PARKING METER POSTS	100.0


LOCA	TION				SQ FT
WEST	SIDE	OF	GOODWIN		20.0
EAST	SIDE	0F	GOODWIN		20.0


SEG	MENT	AL	CONCRE	ΤE	BLOCK	WALL	(X0322923	)
LOCAT	TION						SQ F	T
WEST	SIDE	0F	GOODWIN				155	


SHEET TOTAL 155


SEEDING PAY ITEMS - 34+75 TO 39+25						
CODE NO.	DESCRIPTION	UNIT	QUAN.			
088000XX	SEEDING, CLASS 1, SPECIAL	SQ YD	50			
X0321566	MULCH, SPECIAL	SQ YD	50			


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FILE NAME =	DESIGNED - JAJ	REVISED -			F.A.U.	SECTION	COUNTY TOTAL SHE	,T
p:\u0070052\plans\sheets\19-SitePlan.dgn	DRAWN - JRM	REVISED -	STATE OF ILLINOIS	SITE IMPROVEMENTS PLAN	7175 07-	-00456-00-RS	CHAMPAIGN 75 25	
PLOT DATE =	CHECKED - RLH	REVISED -	DEPARTMENT OF TRANSPORTATION			VIN AVENUE	CONTRACT NO. 91392	1
1/23/2009 11:12:22 AM	DATE - 01-2009	REVISED -		SCALE + 1"=20"   SHEET NO. 25 OF 75 SHEETS   STA 34+75   TO STA 39+25		NO THE THOTE FED		-

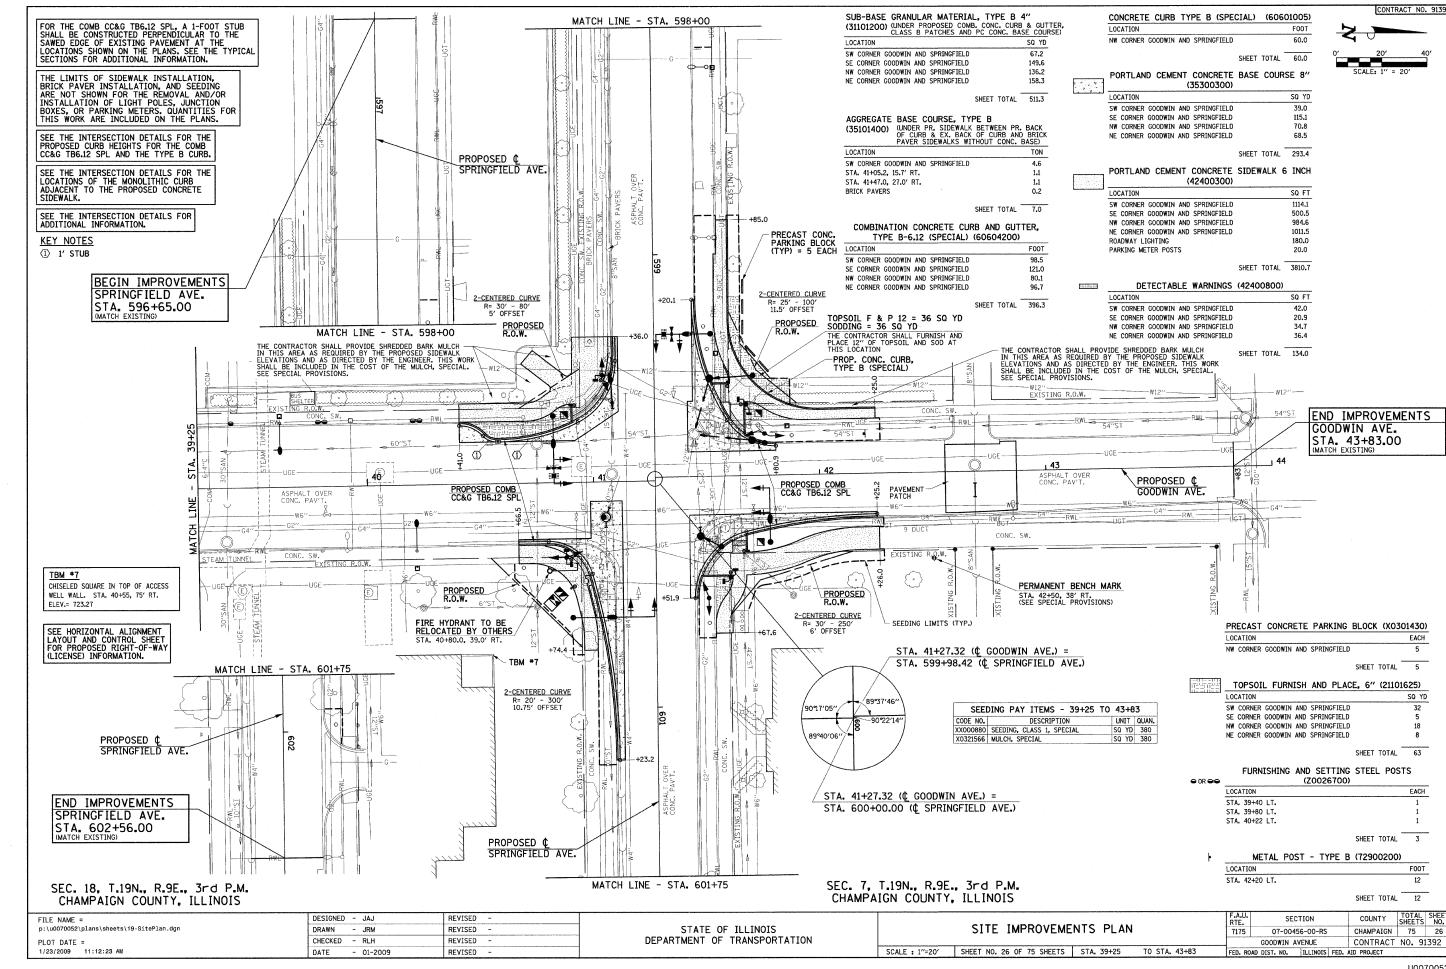


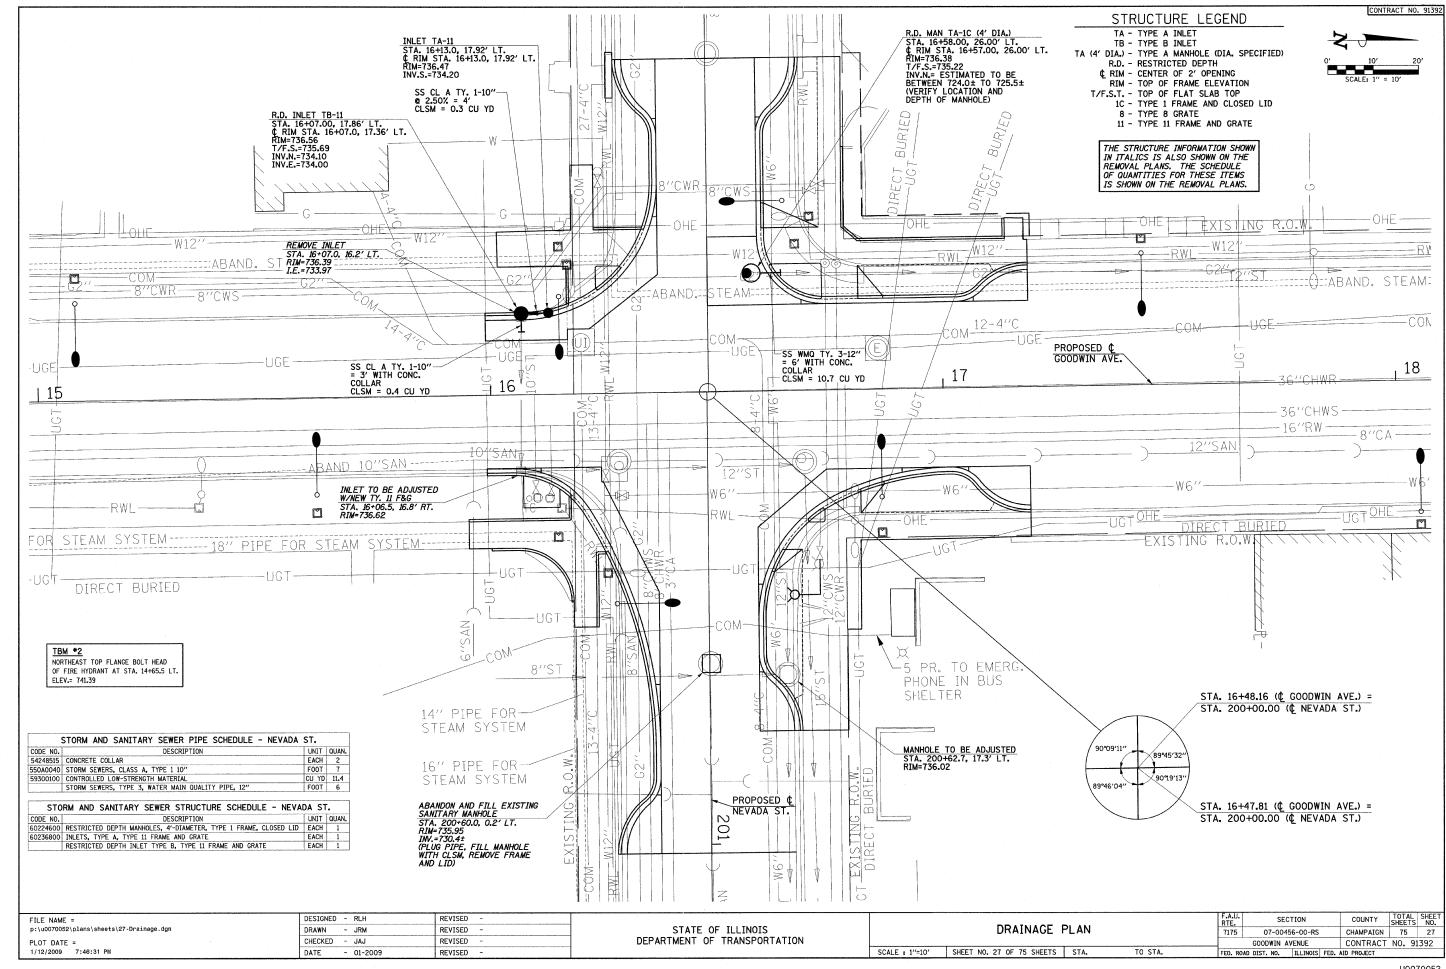


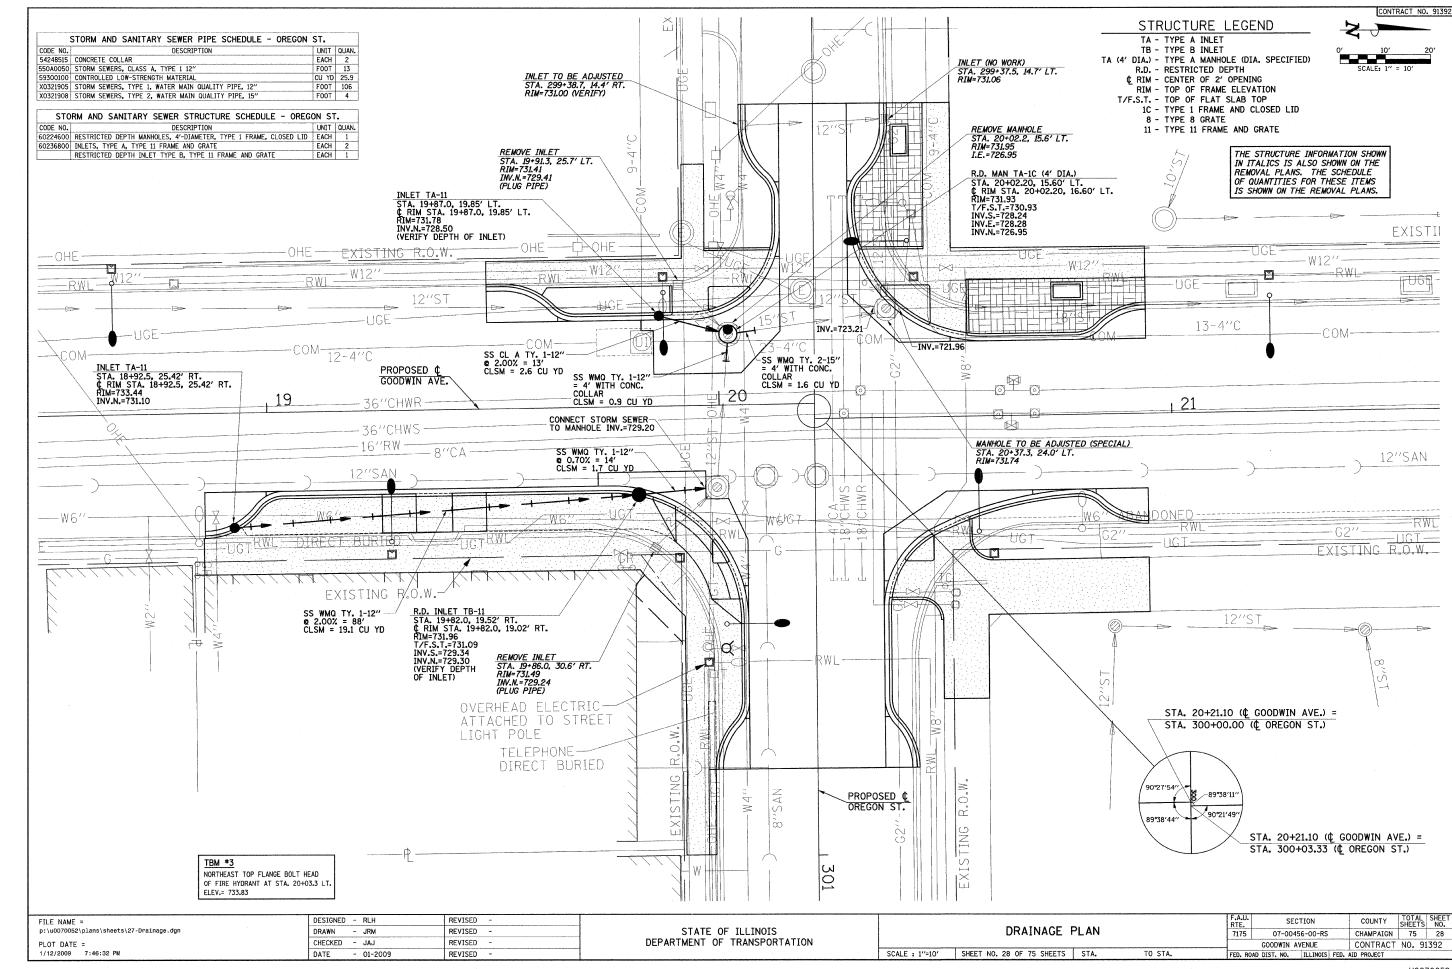


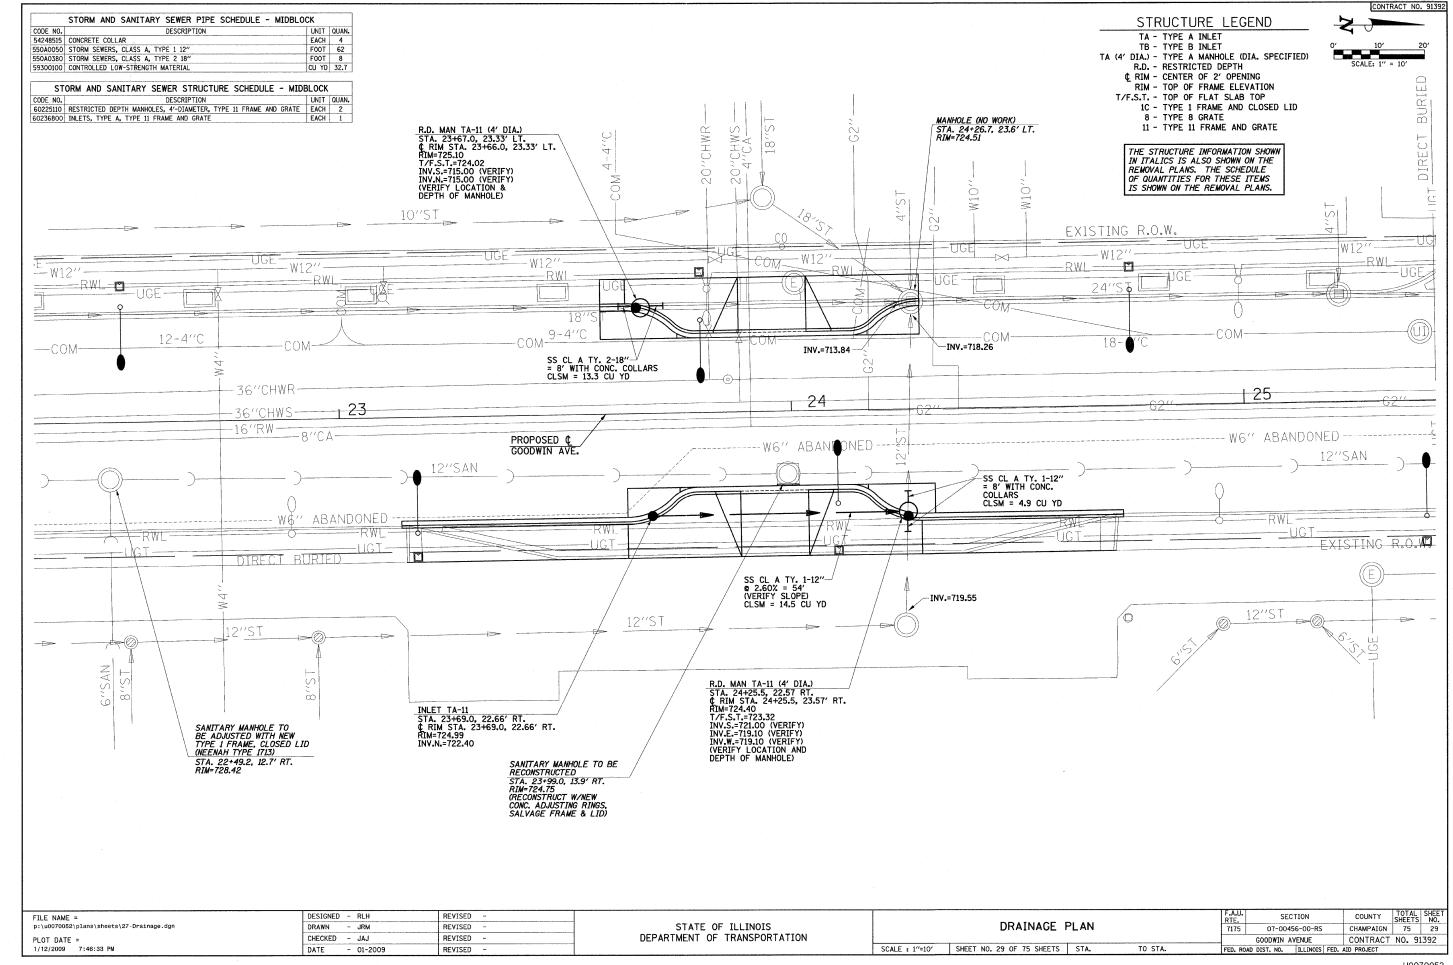


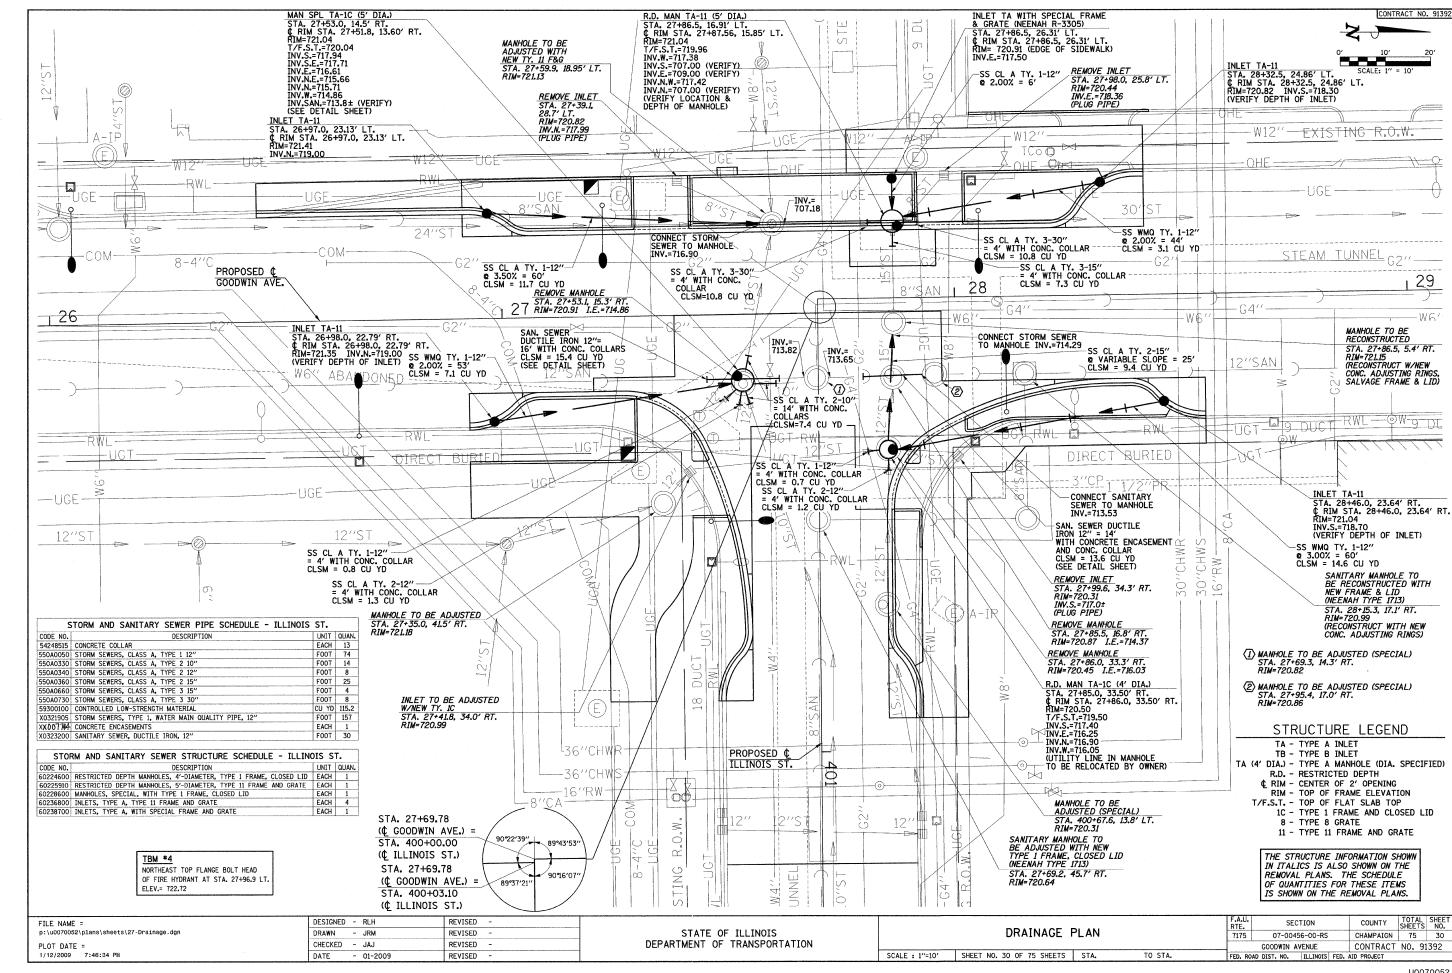

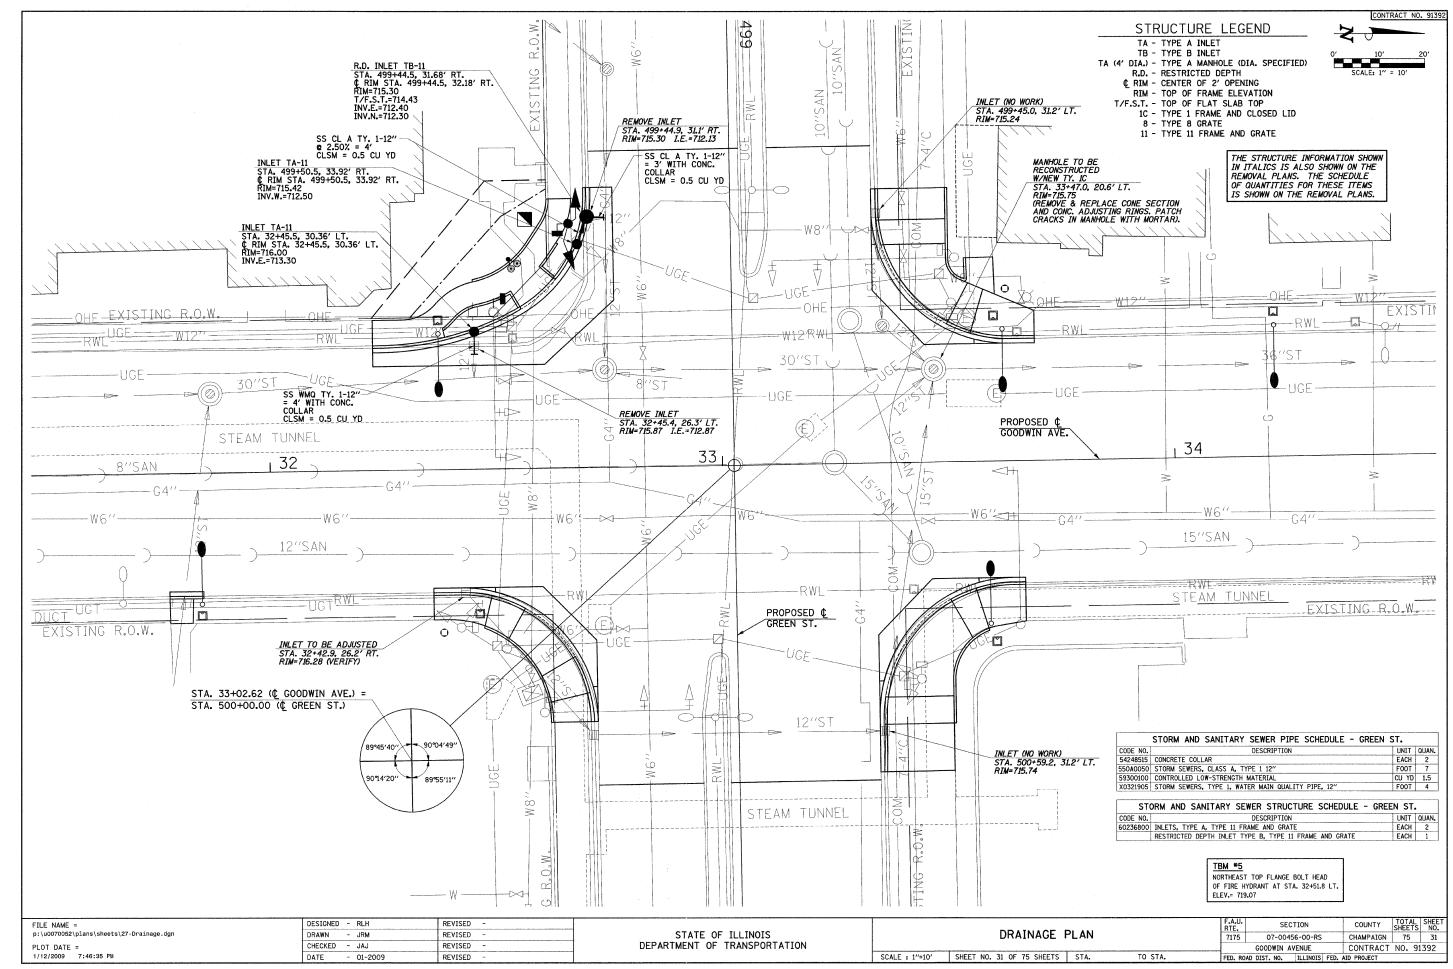

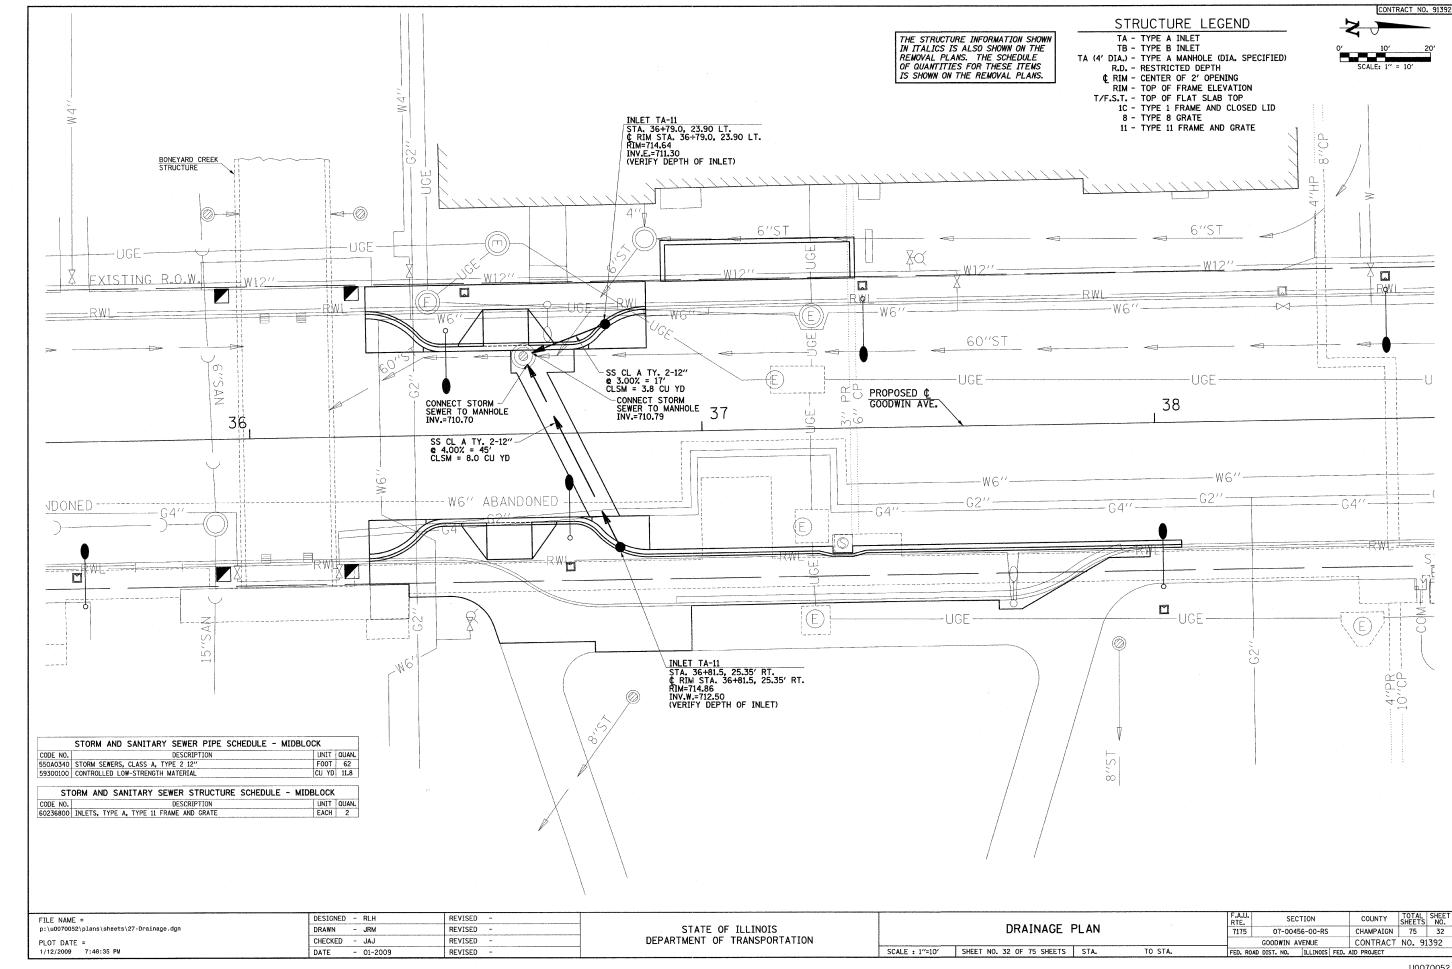

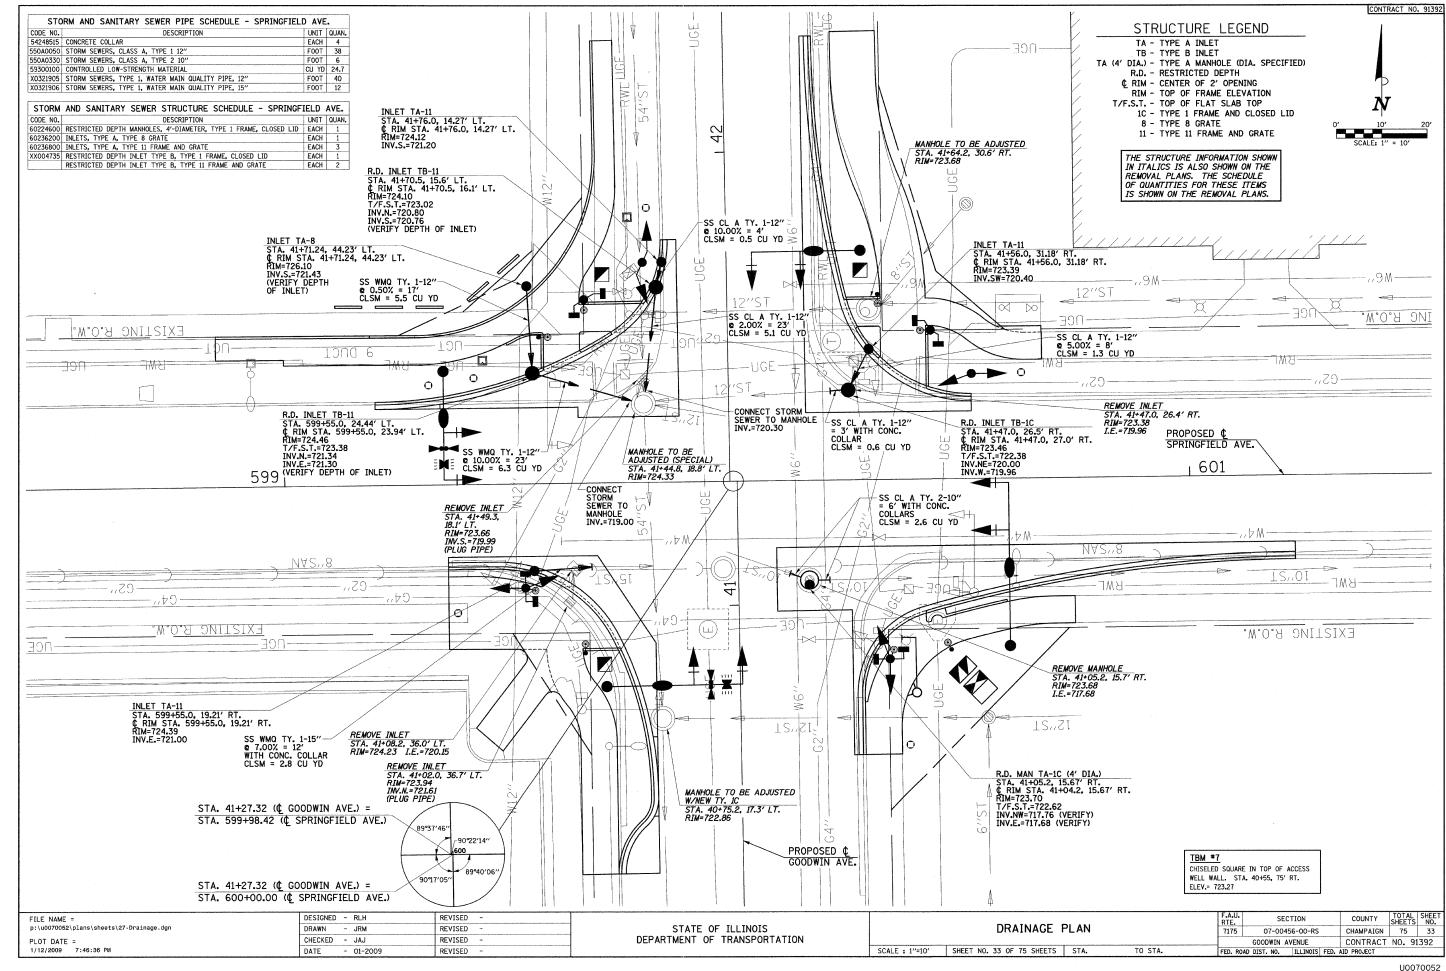


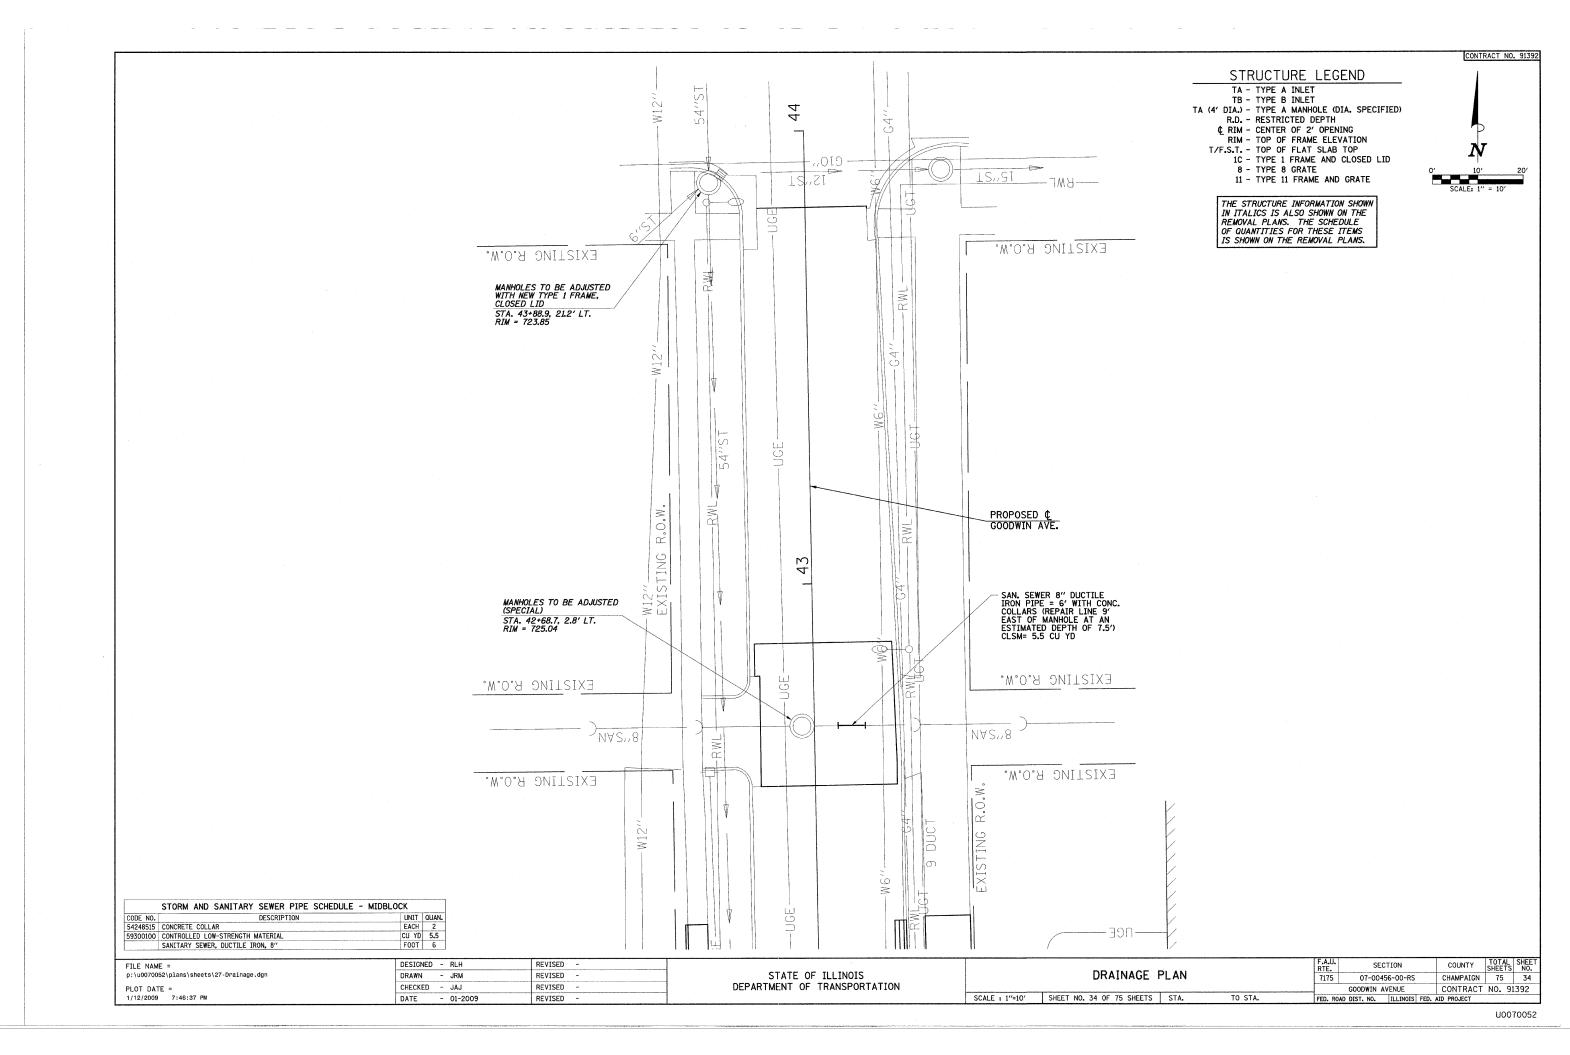

#### TRAFFIC CONTROL GENERAL NOTES

- 1. PRIOR TO THE START OF CONSTRUCTION OPERATIONS, THE CONTRACTOR SHALL SUBMIT A TRAFFIC CONTROL PLAN AND SEQUENCE OF CONSTRUCTION OPERATIONS TO THE ENGINEER FOR APPROVAL. AT EACH INTERSECTION, THE CONTRACTOR SHALL LIMIT CONSTRUCTION OPERATIONS TO TWO ADJACENT OUADRANTS AT A TIME, EITHER BOTH ON THE EAST SIDE OF GOODWIN AVENUE OR BOTH ON THE WEST SIDE OF GOODWIN AVENUE. WORK AT MULTIPLE INTERSECTIONS PERFORMED SIMULTANEOUSLY SHALL BE PERFORMED ON THE SAME SIDE OF GOODWIN AVENUE. THE CONTRACTOR'S AFFIC CONTROL PLAN AND SEQUENCE OF CONSTRUCTION OPERATIONS SHALL INCLUDE THESE REQUIREMENTS.
- 2. NO DEVIATIONS FROM THE APPROVED TRAFFIC CONTROL PLAN WILL BE ALLOWED WITHOUT WRITTEN PERMISSION FROM THE ENGINEER.
- 3. ONE THRU LANE OF TRAFFIC SHALL BE MAINTAINED IN EACH DIRECTION ON GOODWIN AVENUE AND ON ALL CROSS STREETS EXCEPT AS SHOWN ON THE TRAFFIC CONTROL PLAN OR AS OTHERWISE DIRECTED BY THE ENGINEER.
- 4. TRAFFIC CONTROL AND PROTECTION SHALL BE IN ACCORDANCE WITH THE APPLICABLE PORTIONS OF THE STANDARD SPECIFICATIONS FOR ROAD AND BRIDGE CONSTRUCTION; THE APPLICABLE GUIDELINES CONTAINED IN THE MANUAL ON UNIFORM TRAFFIC CONTROL DEVICES FOR STREETS AND HIGHWAYS; STANDARDS 701006, 701301, 701311, 701501, 701606, 701701, 701801, AND 701901; THE TRAFFIC CONTROL PLANS; AND THE SPECIAL PROVISIONS. DELETE ALL REFERENCES TO MEASUREMENT AND PAYMENT.
- 5. TRAFFIC CONTROL AND PROTECTION WILL BE PAID FOR AT THE CONTRACT LUMP SUM PRICE FOR TRAFFIC CONTROL COMPLETE. THE TRAFFIC CONTROL AND PROTECTION INSTALLATION FOR EACH WORK AREA WILL NOT BE PAID FOR SEPARATELY, BUT SHALL BE INCLUDED IN THE LUMP SUM PRICE FOR THIS ITEM. ALL ADDITIONAL TRAFFIC CONTROL DEVICES, TRAFFIC CONTROL SIGNS, AND DETOUR SIGNS REQUIRED FOR THE WORK AS SHOWN ON THE TRAFFIC CONTROL PLANS OR AS DIRECTED BY THE ENGINEER SHALL BE INCLUDED IN THE LUMP SUM PRICE OF TRAFFIC CONTROL COMPLETE.
- 6. TRAFFIC CONTROL SURVEILLANCE WILL NOT BE PAID FOR SEPARATELY FOR THIS PROJECT. THE CONTRACTOR SHALL BE RESPONSIBLE FOR INSPECTING AND MAINTAINING ALL TRAFFIC CONTROL DEVICES AT ALL TIMES INCLUDING NIGHTTIME, WEEKENDS, AND ANY TIME WORKERS AROT PRESENT. THIS WORK SHALL BE PERFORMED IN ACCORDANCE WITH RECURRING SPECIAL PROVISION LRS3. THE COST OF ALL LABOR AND MATERIALS FOR THE MAINTENANCE OF TRAFFIC CONTROL DEVICES SHALL BE INCLUDED IN THE LUMP SUM PRICE OF TRAFFIC CONTROL COMPLETE.
- 7. THE CONTRACTOR SHALL MAINTAIN AT LEAST ONE POINT OF ACCESS TO EACH PROPERTY IN THE WORK AREA AT ALL TIMES.
- 8. FURNISHING, PLACING, AND REMOVING ALL AGGREGATE THAT IS USED TO TEMPORARILY FILL ANY VOIDS OR TO PROVIDE TEMPORARY ACCESS FOR VEHICLES OR PEDESTRIANS WILL BE PAID FOR AT THE CONTRACT UNIT PRICE PER TON FOR AGGREGATE FOR TEMPORARY ACCESS.
- 9. THE CONTRACTOR SHALL COVER ANY EXISTING SIGN THAT CONFLICTS WITH THE TRAFFIC CONTROL PLAN BUT DOES NOT INTERFERE WITH THE PROPOSED WORK. THE CONTRACTOR SHALL PROVIDE ADDITIONAL "STOP" SIGNS (RI-1-3030) AND "ALL WAY" SIGNS (RI-4-1806) AS REQUIRED TO MAINTAIN ALL-WAY STOP CONTROLLE INTERSECTIONS OR AS CHIERCITED BY THE ENGINEER. THE CONTRACTOR SHALL PROVIDE "NO PARKING" SIGNS (R7-1-1218) ALONG THE CORRIDOR AS DIRECTED BY THE ENGINEER. THE PROPOSED TRAFFIC CONTROL SIGNS SHALL BE INSTALLED IN ACCORDANCE WITH STANDARD 701901.
- 10. THE CONTRACTOR SHALL INSTALL THE TEMPORARY TRAFFIC SIGNALS AS SHOWN ON THE TRAFFIC SIGNAL PLANS. THE CONTRACTOR SHALL BAG ANY TRAFFIC SIGNAL HEAD OR PEDESTRIAN SIGNAL HEAD THAT CONFLICTS WITH THE TRAFFIC CONTROL PLAN, THAT IS SHOWN TO BE BAGGED ON THE TRAFFIC SIGNAL PLANS, OR THAT IS INDICATED TO BE BAGGED BY THE ENGINEER. THE METHOD OF BAGGING SHALL BE APPROVED BY THE ENGINEER.
- 11. FLASHING LIGHTS SHALL BE PLACED ON ALL TYPE III BARRICADES IN ACCORDANCE WITH STANDARD 701901 UNLESS OTHERWISE DIRECTED BY THE ENGINEER, STEADY BURN LIGHTS SHALL BE PLACED ON ALL DRUMS AND BARRICADES (EXCEPT FOR TYPE III BARRICADES) IN ACCORDANCE WITH STANDARD 701901 UNLESS OTHERWISE DIRECTED BY THE ENGINEER.
- 12. TRAFFIC CONTROL DEVICES MAY BE ADJUSTED TO FIT FIELD CONDITIONS AS DIRECTED BY THE ENGINEER. ADDITIONAL TRAFFIC CONTROL DEVICES NOT ASSOCIATED WITH ANY TRAFFIC CONTROL STANDARD MAY BE REQUIRED AS DIRECTED BY THE ENGINEER. THE ADDITIONAL TRAFFIC CONTROL DEVICES SHALL BE INCLUDED IN THE LUMP SUM PRICE OF TRAFFIC CONTROL COMPLETE.
- 13. TRAFFIC CONTROL DEVICES SHALL BE REMOVED AS DIRECTED BY THE ENGINEER.
- 14. TEMPORARY HOT-MIX ASPHALT RAMPS SHALL HAVE A MINIMUM TAPER RATE OF 1:40 (V:H) AND WILL BE PAID FOR AT THE CONTRACT UNIT PRICE PER SQUARE YARD FOR TEMPORARY RAMP. THE CONSTRUCTION, MAINTENANCE, AND REMOVAL OF TEMPORARY HOT-MIX ASPHALT RAMPS SHALL BE INCLUDED IN THE PRICE OF THIS ITEM.
- 15. WORK ZONE PAVEMENT MARKING SHALL BE INSTALLED AS REQUIRED BY THE TRAFFIC CONTROL STANDARDS AND THE TRAFFIC CONTROL PLAN, AND AS DIRECTED BY THE ENGINEER, WORK ZONE PAVEMENT MARKING WILL BE PAID FOR AT THE CONTRACT UNIT PRICE PER FOOT FOR SHORT TERM PAVEMENT MARKING, PAVEMENT MARKING TAPE, TYPE III 4", PAVEMENT MARKING TAPE, TYPE III 2", AND PAVEMENT MARKING OF LAW ENGINE SHALL CONSIST OF AN ABBREVIATED PATTERN OF SINGLE STRIPES 4" IN LENGTH AT A MAXIMUM SPACING OF 40' BETWEEN STRIPES AS DESCRIBED IN ARTICLE 703.04 OF THE STANDARD SPECIFICATIONS OR AS OTHERWISE DIRECTED BY THE TRAFFIC CONTROL STANDARDS WILL NOT BE PAID FOR SEPARATELY, AS DESCRIBED IN ARTICLE 703.07 OF THE STANDARD SPECIFICATIONS. ONLY PAVEMENT MARKING THE SHALL BE ALLOWED ON THE FINAL WEARING SURFACE. THE REMOVAL OF WORK ZONE PAVEMENT MARKING REMOVAL.
- 16. THE CONTRACTOR SHALL REMOVE EXISTING PAVEMENT MARKINGS OR PREVIOUSLY INSTALLED WORK ZONE PAVEMENT MARKINGS THAT CONFLICT WITH THE TRAFFIC CONTROL PLAN AS DIRECTED BY THE ENGINEER. REMOVAL OF THE WORK ZONE PAVEMENT MARKINGS WILL BE PAID FOR AT THE CONTRACT UNIT PRICE PER SQUARE FOOT FOR WORK ZONE PAVEMENT MARKING REMOVAL. REMOVAL OF THE EXISTING PAVEMENT MARKINGS SHALL BE DONE IN ACCORDANCE WITH SECTION 783 OF THE STANDARD SPECIFICATIONS. REMOVAL OF EXISTING PAVEMENT MARKINGS WILL NOT BE PAID FOR SEPARATELY, BUT SHALL BE INCLUDED IN THE COST OF THE WORK ZONE PAVEMENT MARKING REMOVAL, AND NO ADDITIONAL COMPENSATION WILL BE ALLOWED.
- 17. THE CONTRACTOR SHALL NOTIFY THE CITY OF URBANA OF ALL ROAD CLOSURES AND DETOURS A MINIMUM OF 48 HOURS IN ADVANCE OF THE ROAD CLOSURES AND DETOURS.
- 18. THE CITY OF URBANA SHALL BE RESPONSIBLE FOR NOTIFYING THE PUBLIC, THE UNIVERSITY OF ILLINOIS, THE UNITED STATES POSTAL SERVICE, THE CHAMPAIGN-URBANA MASS TRANSIT DISTRICT, AND THE EMERGENCY SERVICE AGENCIES OF ALL ROAD CLOSURES AND DETOURS.
- 19. THE WORK ZONES SHOWN ON THE TRAFFIC CONTROL PLANS AND THE PLACEMENT OF SIGNS, BARRICADES, AND OTHER TRAFFIC CONTROL DEVICES DEPICTED HEREON ARE SCHEMATIC IN NATURE. FOR SPECIFIC INSTRUCTIONS ON THE INCLUSION OF SIGNS, BARRICADES, AND OTHER TRAFFIC CONTROL DEVICES FOR INDIVIDUAL WORK ZONES, AND THE PLACEMENT THEREOF, REFER TO THE TRAFFIC CONTROL STANDARDS, THE STANDARD SECIFICATIONS FOR ROAD AND BRIDGE CONSTRUCTION, AND THE SPECIAL PROVISIONS. SIGNS, BARRICADES, AND OTHER TRAFFIC CONTROL DEVICES THAT ARE SHOWN ON THE TRAFFIC CONTROL STANDARDS REQUIRED FOR THIS WORK ARE NOT SHOWN ON THE TRAFFIC CONTROL PLANS UNLESS OTHERWISE NOTED.

#### DETOUR SIGN LEGEND

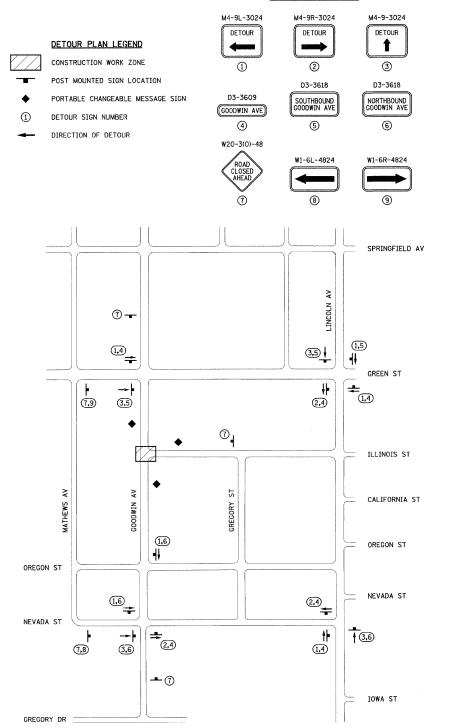

#### DETOUR PLAN

NOTE: THE INTERSECTION OF GOODWIN AVENUE AND GREEN STREET SHALL THE INTERSECTION OF GOODWIN AVENUE AND GREEN STREET SHALL BE ALL-WAY STOP-CONTROLLED DURING THE CONSTRUCTION OF THE PROPOSED TRAFFIC SIGNAL IMPROVEMENTS AT THAT INTERSECTION. THE CONTRACTOR SHALL FURNISH, INSTALL, AND MAINTAIN TEMPORARY STOP SIGNS ON EACH OUADRANT OF THE INTERSECTION AND IN THE MEDIANS AS DIRECTED BY THE ENGINEER, THIS WORK WILL NOT BE PAID FOR SEPARATELY BUT SHALL BE INCLUDED IN THE COST OF TRAFFIC CONTROL COMPLETE, AND NO ADDITIONAL COMPENSATION WILL BE ALLOWED.

#### TRAFFIC CONTROL STANDARDS

THE FOLLOWING TRAFFIC CONTROL STANDARDS ARE THE MINIMUM REQUIREMENTS FOR THE TRAFFIC CONTROL FOR THIS PROJECT WHEN LANES ARE OPEN TO TRAFFIC:


STANDARD	APPLICATION
701006	OFF-ROAD OPERATIONS ON VARIOUS STREETS FOR LANDSCAPING OPERATIONS, SIGN INSTALLATION, ETC.
701301	SHORT TIME LANE CLOSURE ON VARIOUS STREETS FOR CONSTRUCTION LAYOUT, DEBRIS CLEANUP, ETC.
701311	MOVING OPERATIONS LANE CLOSURE ON VARIOUS STREETS FOR LANDSCAPING WORK, PAVEMENT MARKING, DEBRIS CLEANUP, ETC.
701501	LANE CLOSURE ON VARIOUS STREETS FOR CONSTRUCTION ACTIVITIES THAT REQUIRE THE TEMPORARY CLOSURE OF ONE THRU LANE OF TRAFFIC.
701606	LANE CLOSURE ON VARIOUS STREETS FOR PAVEMENT PATCHING UNDER TWO-WAY TRAFFIC.
701701	LANE CLOSURE ON VARIOUS STREETS FOR INTERSECTION SHOULDER OPERATIONS, CORNER ISLAND OPERATIONS, LEFT-LANE OPERATIONS, ETC.
701801	SIDEWALK CLOSURES WITHIN PROJECT LIMITS
701901	TRAFFIC CONTROL DEVICES


WHEN CONSTRUCTION ACTIVITIES ARE PERFORMED UNDER ROAD CLOSURE USE THE ROAD CLOSURE DETAILS AS SHOWN IN THE PLANS.


#### DETOUR PLAN GENERAL NOTES


- THE DETOUR SIGNS SHALL BE IN PLACE PRIOR TO CLOSING THE INTERSECTION OF GOODWIN AVENUE AND ILLINOIS STREET AND SHALL REMAIN IN PLACE UNTIL THE INTERSECTION IS OPEN TO TRAFFIC UNLESS OTHERWISE DIRECTED BY THE ENGINEER.
- 2. PORTABLE CHANGEABLE MESSAGE SIGNS SHALL BE PROVIDED AND MAINTAINED BY THE CONTRACTOR AT THE LOCATIONS SHOWN ON THE DETOUR PLAN FIVE DAYS PRIOR TO CLOSING THE INTERSECTION OF GOODWIN AVENUE AND ILLINOIS STREET. THE MESSAGE FOR THE SIGNS WILL BE PROVIDED BY THE ENGINEER. THE CONTRACTOR SHALL INSPECT THE SIGNS BY 8:00 A.M. EACH DAY TO ENSURE THAT THE SIGNS ARE FULLY OPERATIONAL AND IN PROPER WORKING ORDER, FURNISHING, MAINTAINING, AND REMOVING THE PORTABLE CHANGEABLE MESSAGE SIGNS SHALL BE INCLUDED IN THE LUMP SUM PRICE OF TRAFFIC CONTROL COMPLETE.
- 3, CLOSE GOODWIN AVENUE AT ILLINOIS STREET AND CLOSE ILLINOIS STREET AT GOODWIN AVENUE IN ACCORDANCE WITH THE "ROAD CLOSED TO ALL TRAFFIC" DETAIL SHOWN ON STANDARD TO1901. CLOSE GOODWIN AVENUE AND ILLINOIS STREET TO THRU TRAFFIC AT THE LOCATIONS DETERMINED BY THE ENGINEER IN ACCORDANCE WITH THE "ROAD CLOSED TO THRU TRAFFIC" DETAIL SHOWN ON STANDARD TO1901. ALL CLOSURES SHALL BE INCLUDED IN THE LUMP SUM PRICE OF TRAFFIC CONTROL COMPLETE.
- 4. THE DETOUR SIGNS SHALL HAVE BLACK LETTERS, SYMBOLS, AND BORDERS WITH ORANGE REFLECTORIZED BACKGROUNDS.
- 5. THE DETOUR SIGNS SHALL BE MAINTAINED FOR THE DURATION OF THE DETOUR
- 6. THE DETOUR SIGNS SHALL BE POST MOUNTED IN ACCORDANCE WITH STANDARD
- 7. FURNISHING, ERECTING, MAINTAINING, AND REMOVING THE DETOUR SIGNS SHALL BE INCLUDED IN THE LUMP SUM PRICE OF TRAFFIC CONTROL COMPLETE.


FILE NAME = p:\u0070052\plans\sheets\35-TrafficControl.dgn	DESIGNED - JAJ	REVISED -	STATE OF ILLINOIS	TRAFFIC CONTROL PLAN		SECTION	COUNTY	TOTAL SI SHEETS	NO.
	DRAWN - JAJ	REVISED -				07-00456-00-RS	CHAMPAIGN	75	35
PLOT DATE =	CHECKED - RLH	REVISED -	DEPARTMENT OF TRANSPORTATION			GOODWIN AVENUE	CONTRACT NO. 91392		92
1/12/2009 7:46:39 PM	DATE - 01-2009	REVISED -		SCALE: NONE   SHEET NO. 35 OF 75 SHEETS   STA. TO STA.	FED. F	ROAD DIST. NO. ILLINOIS FED.	. AID PROJECT		

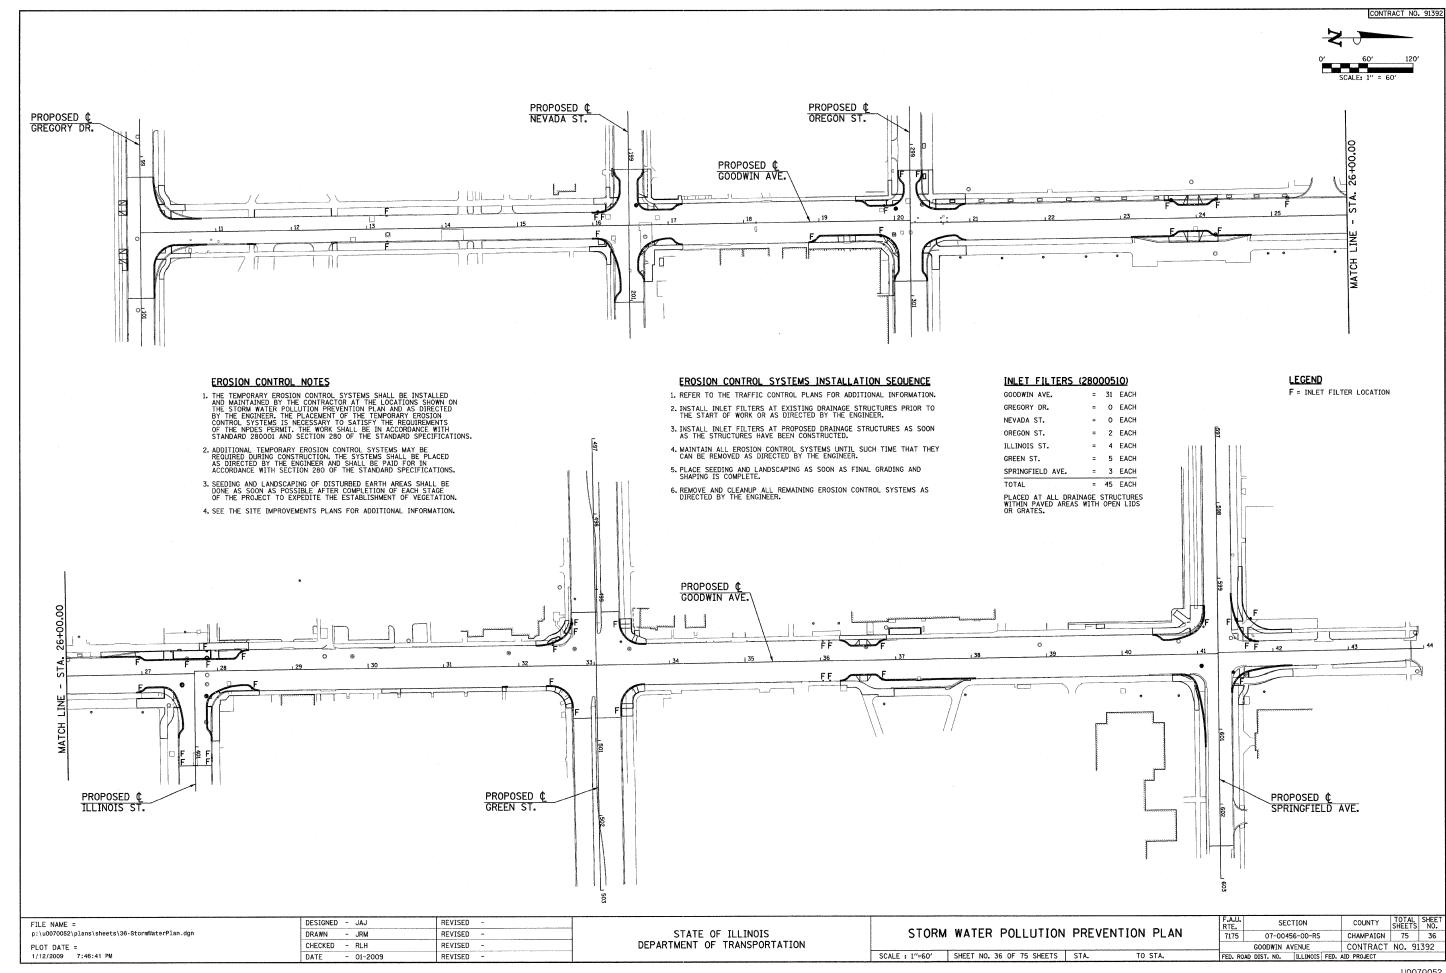


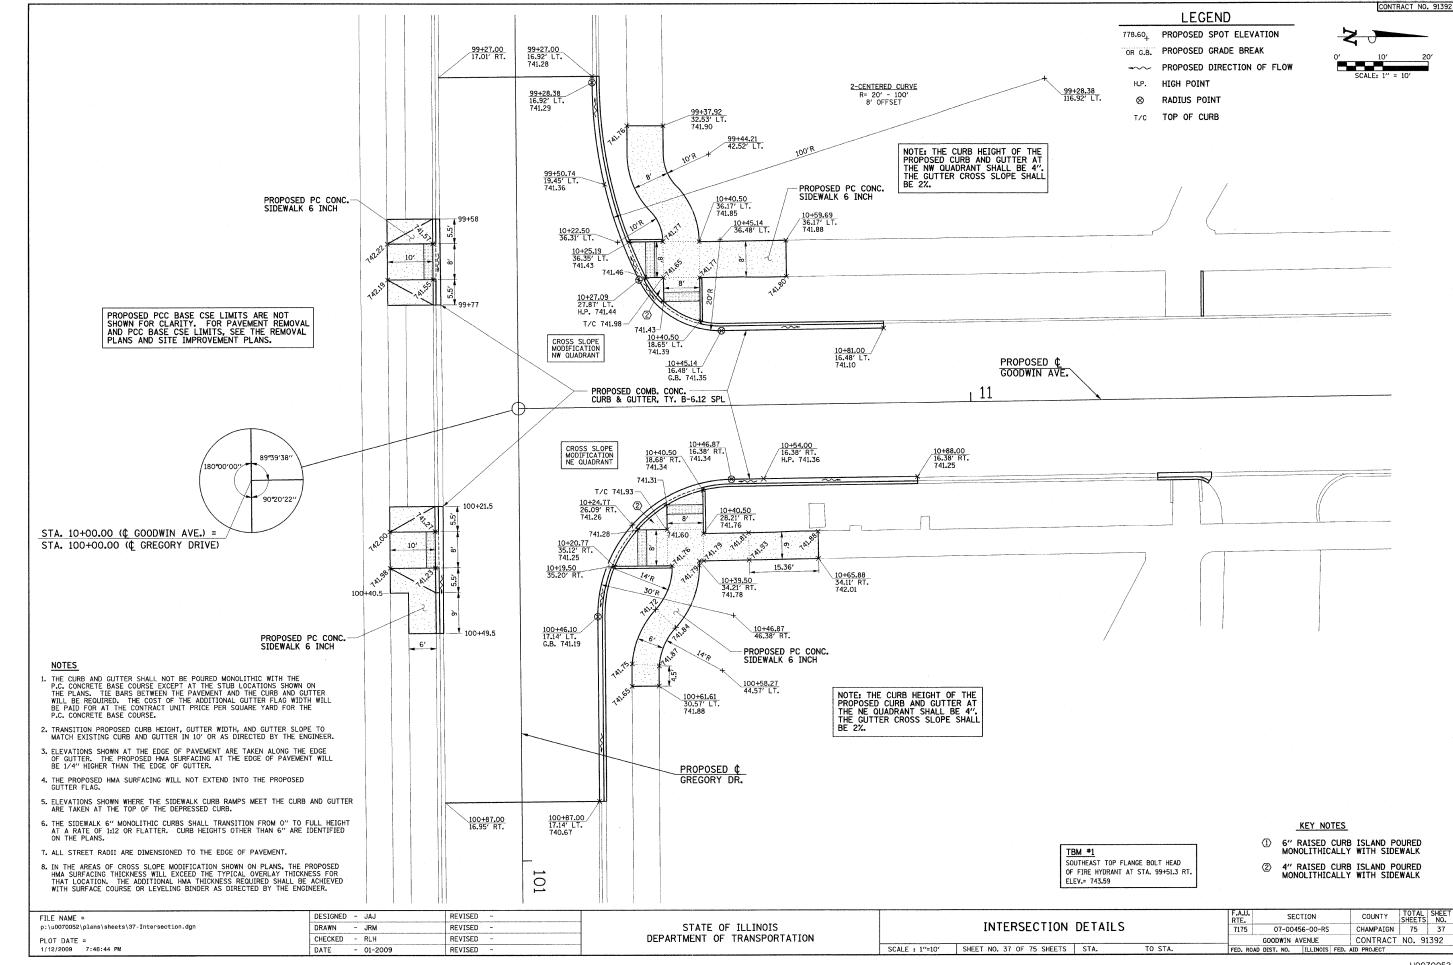


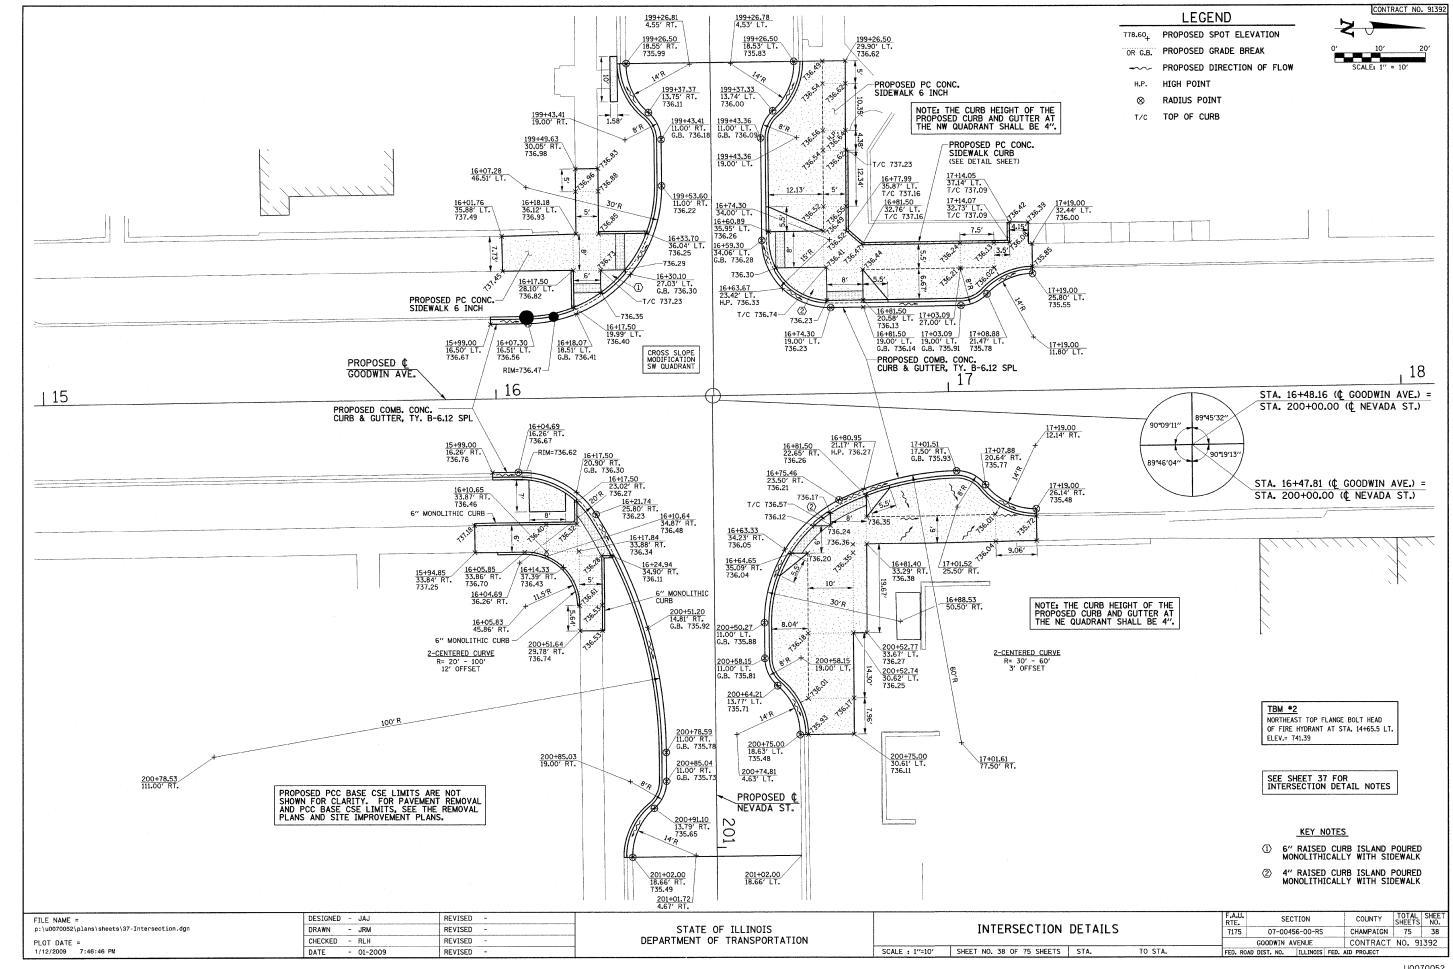


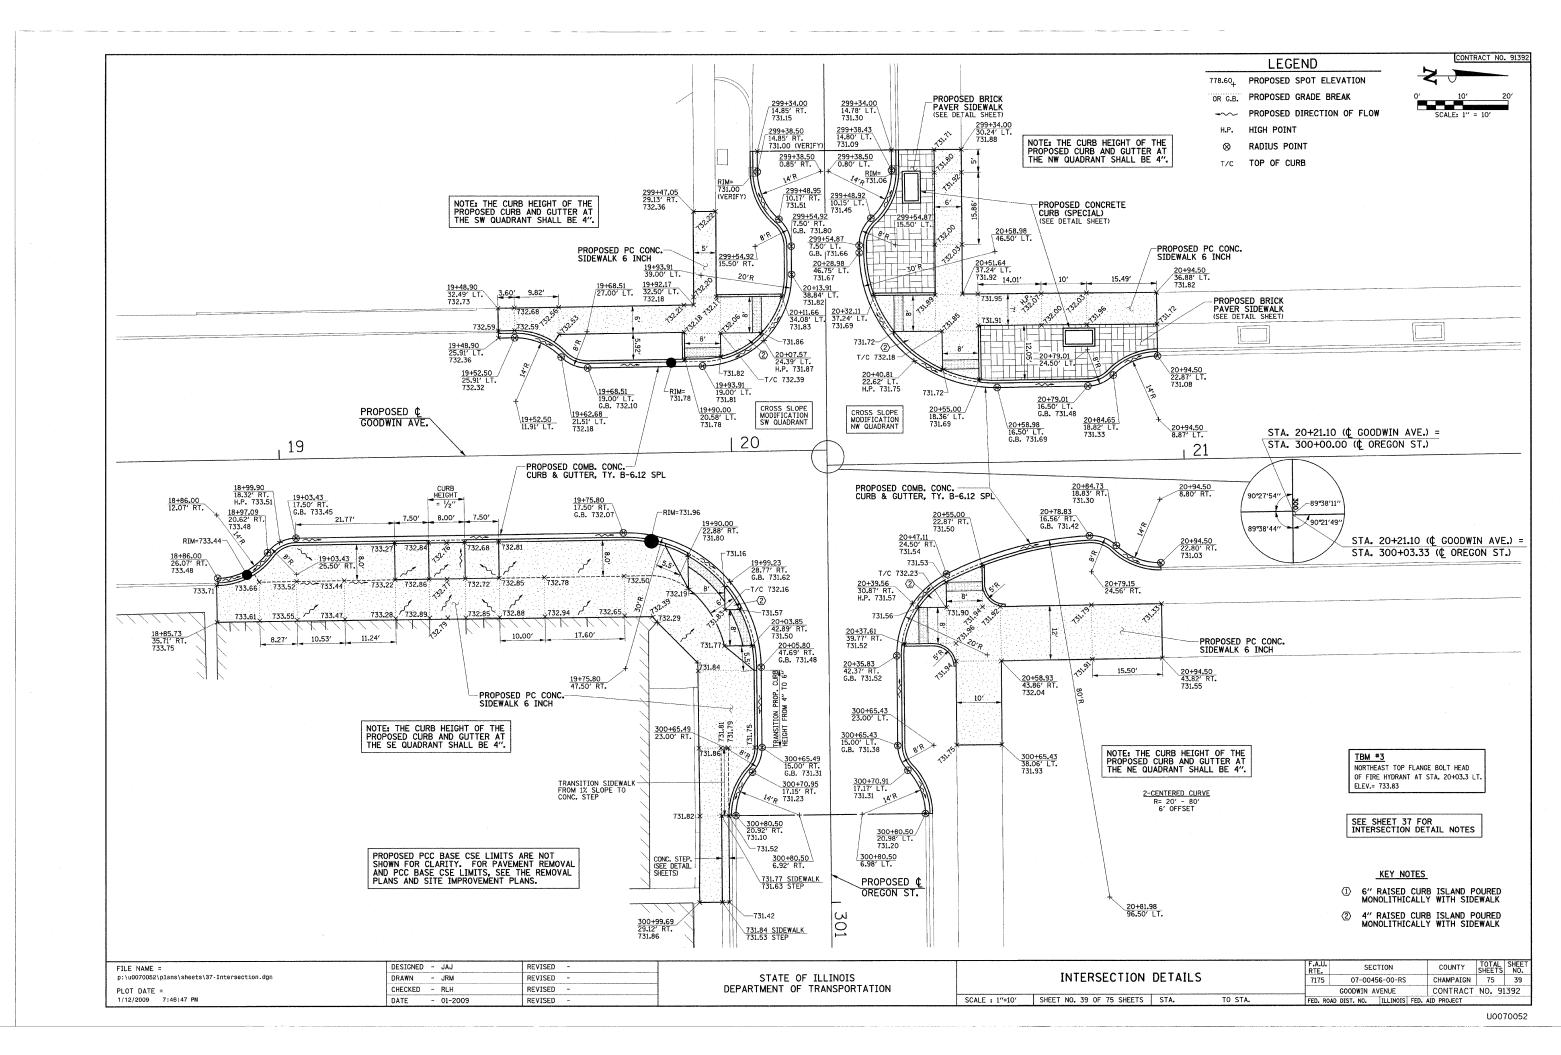


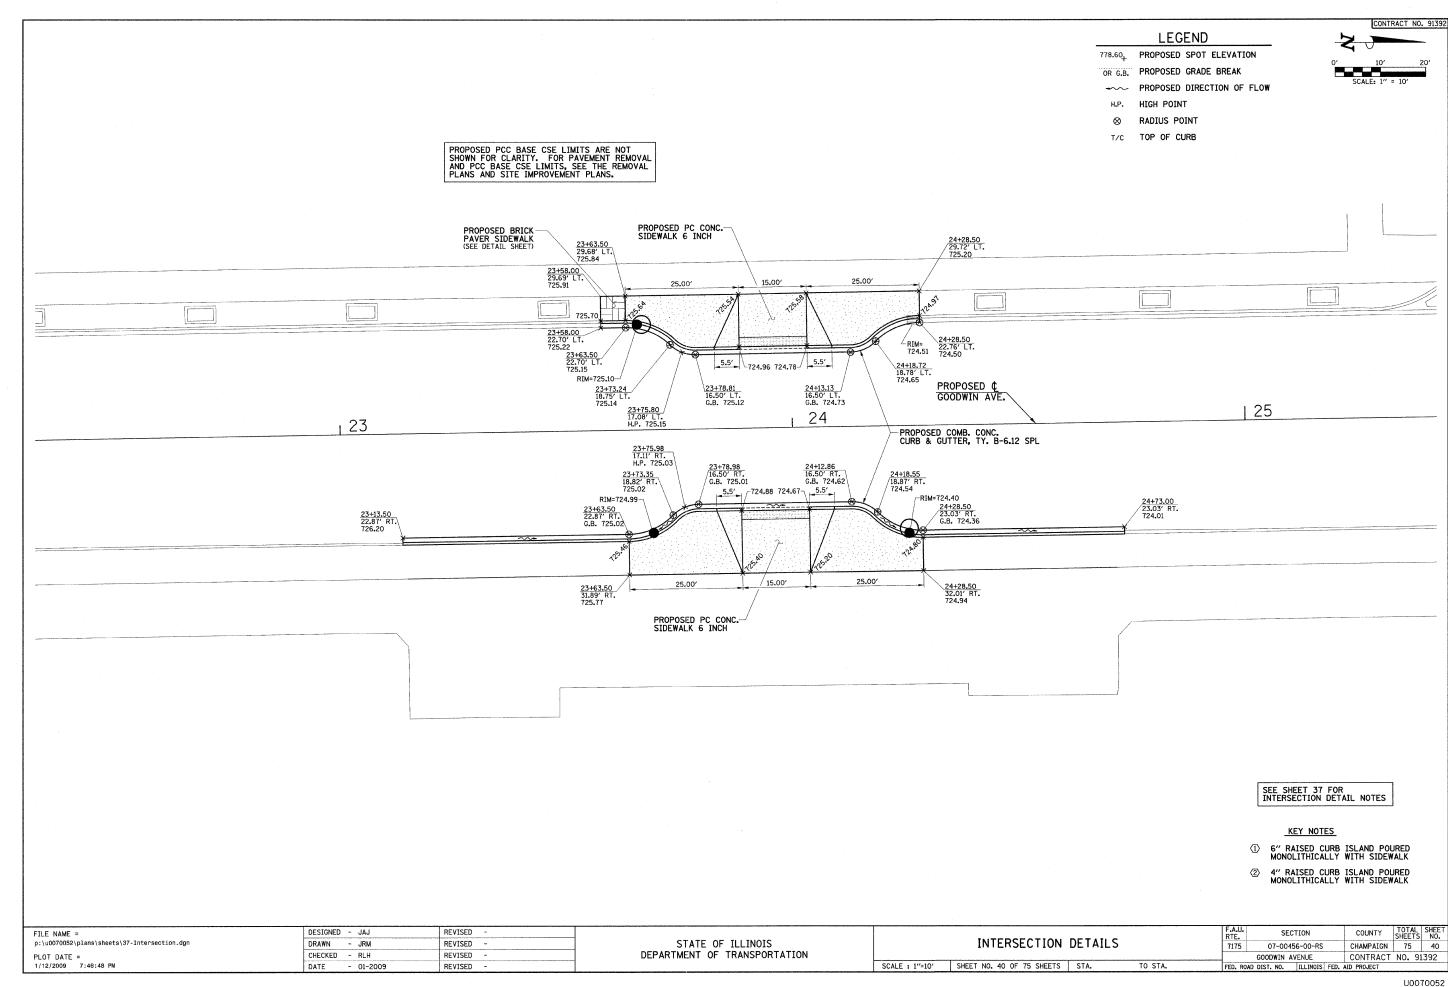


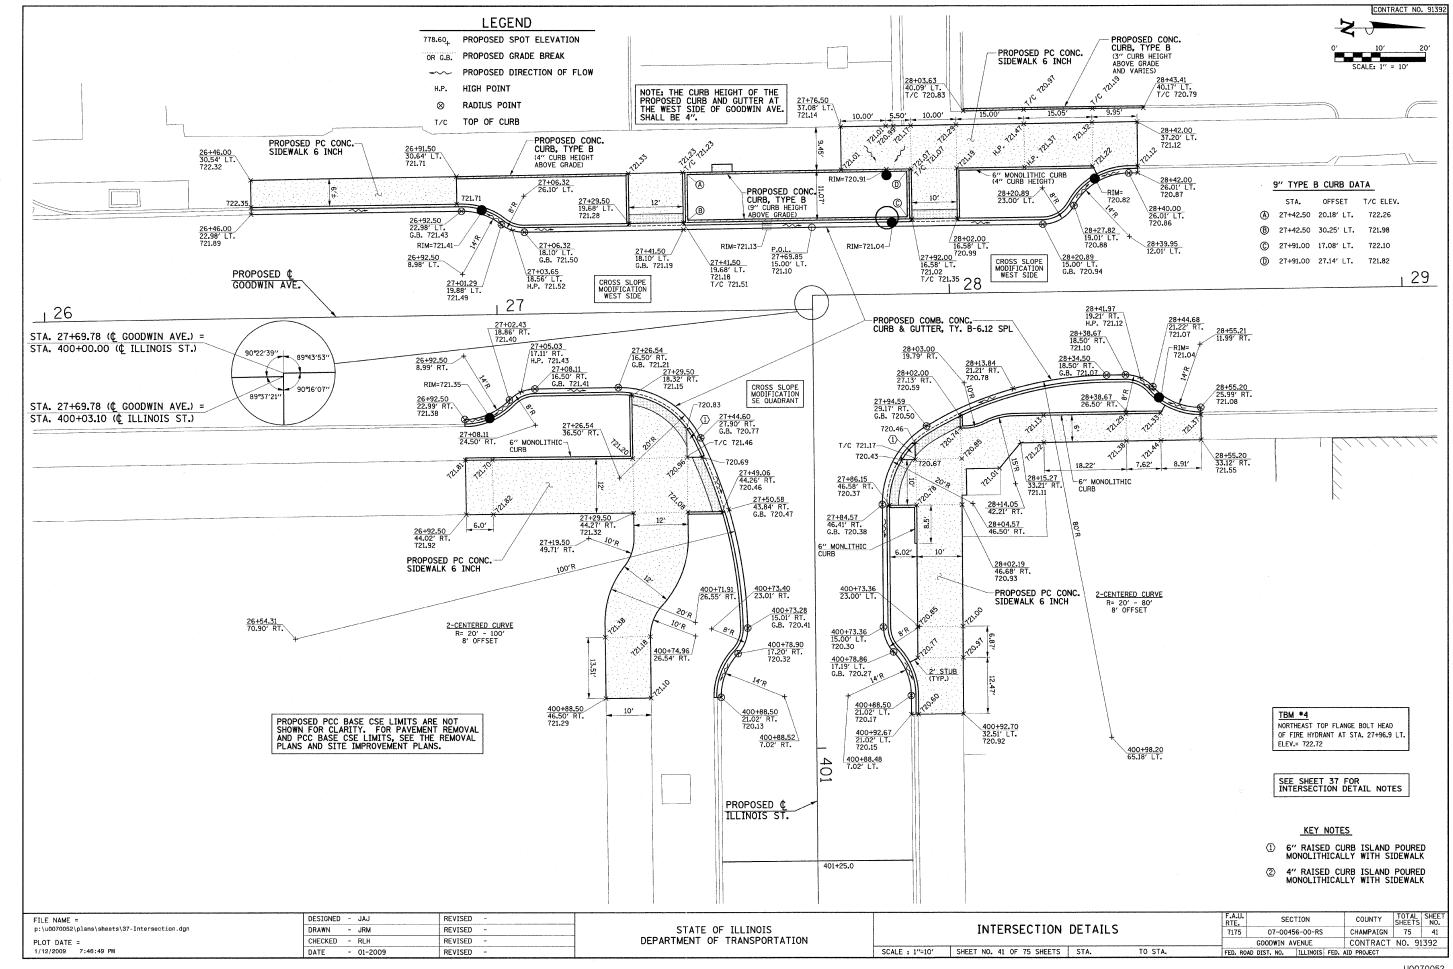

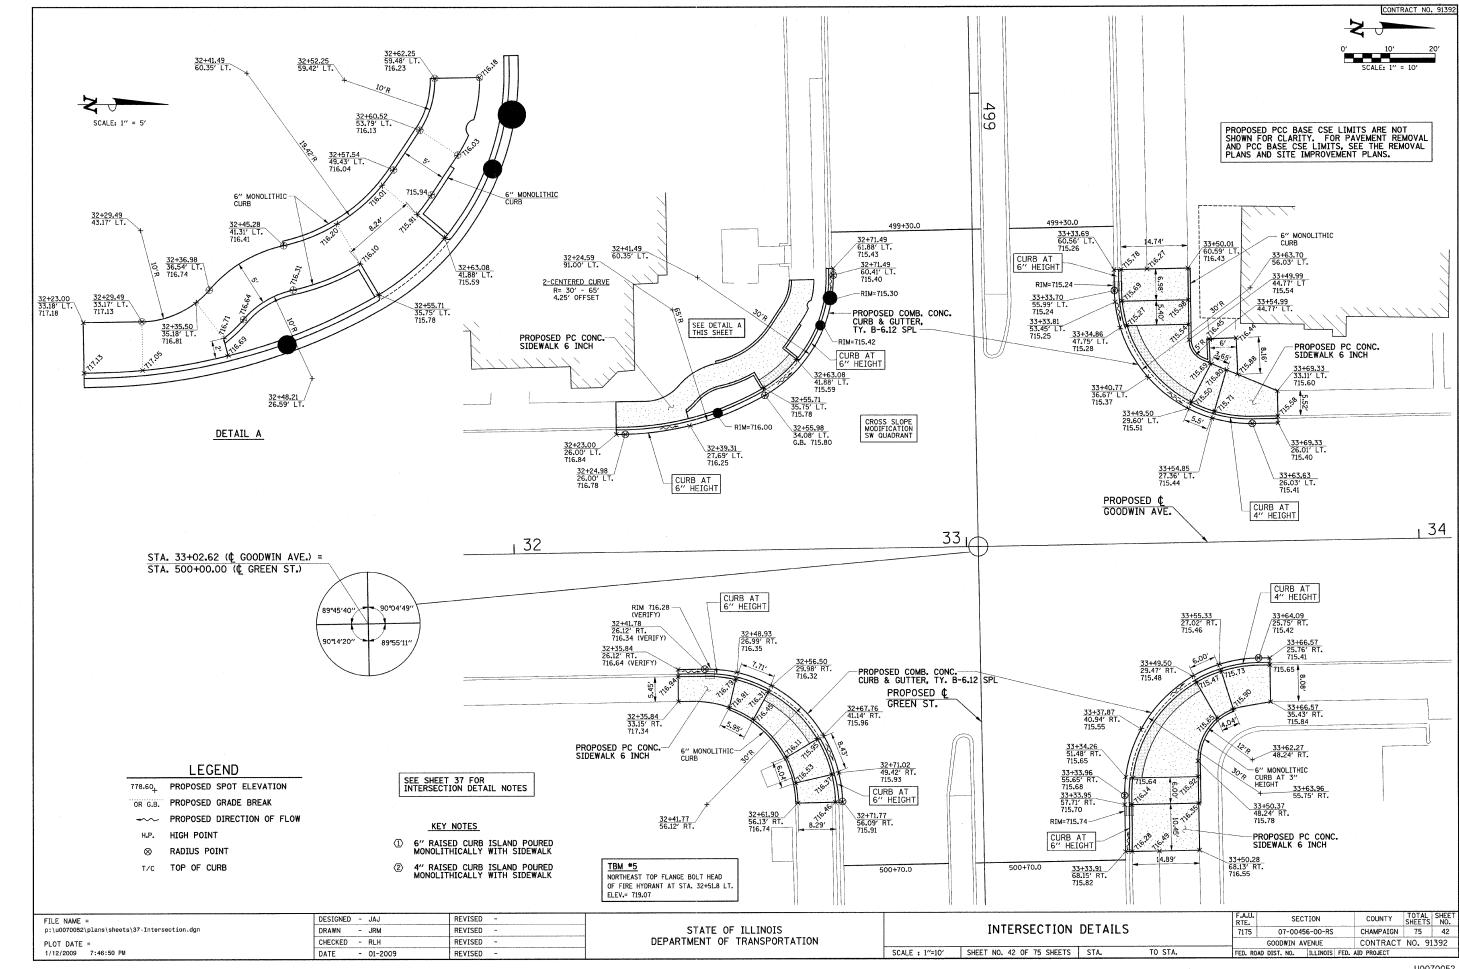

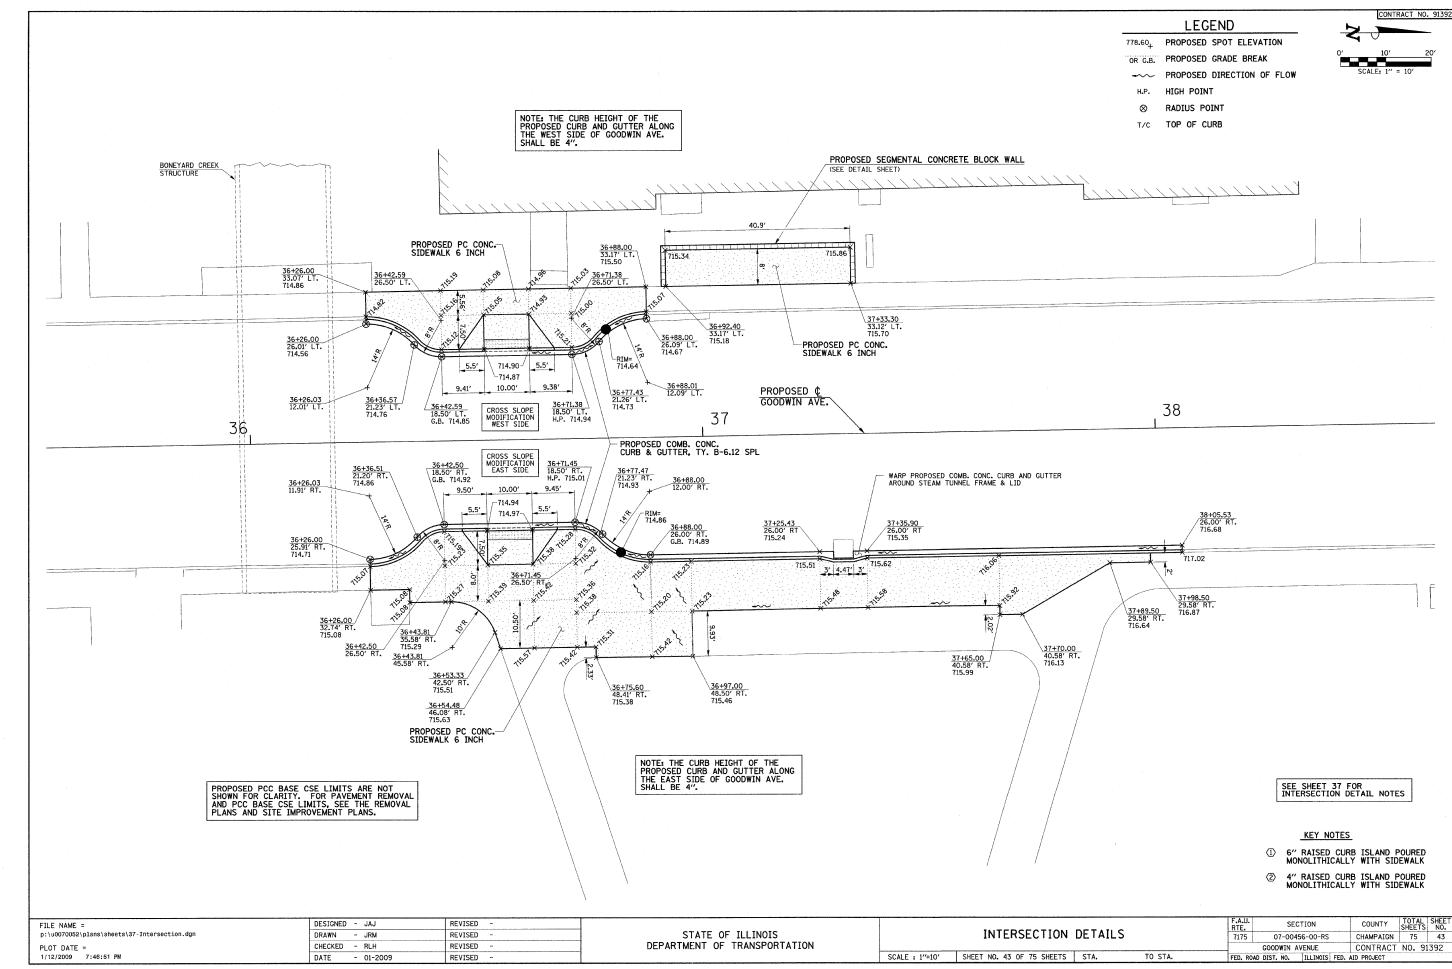

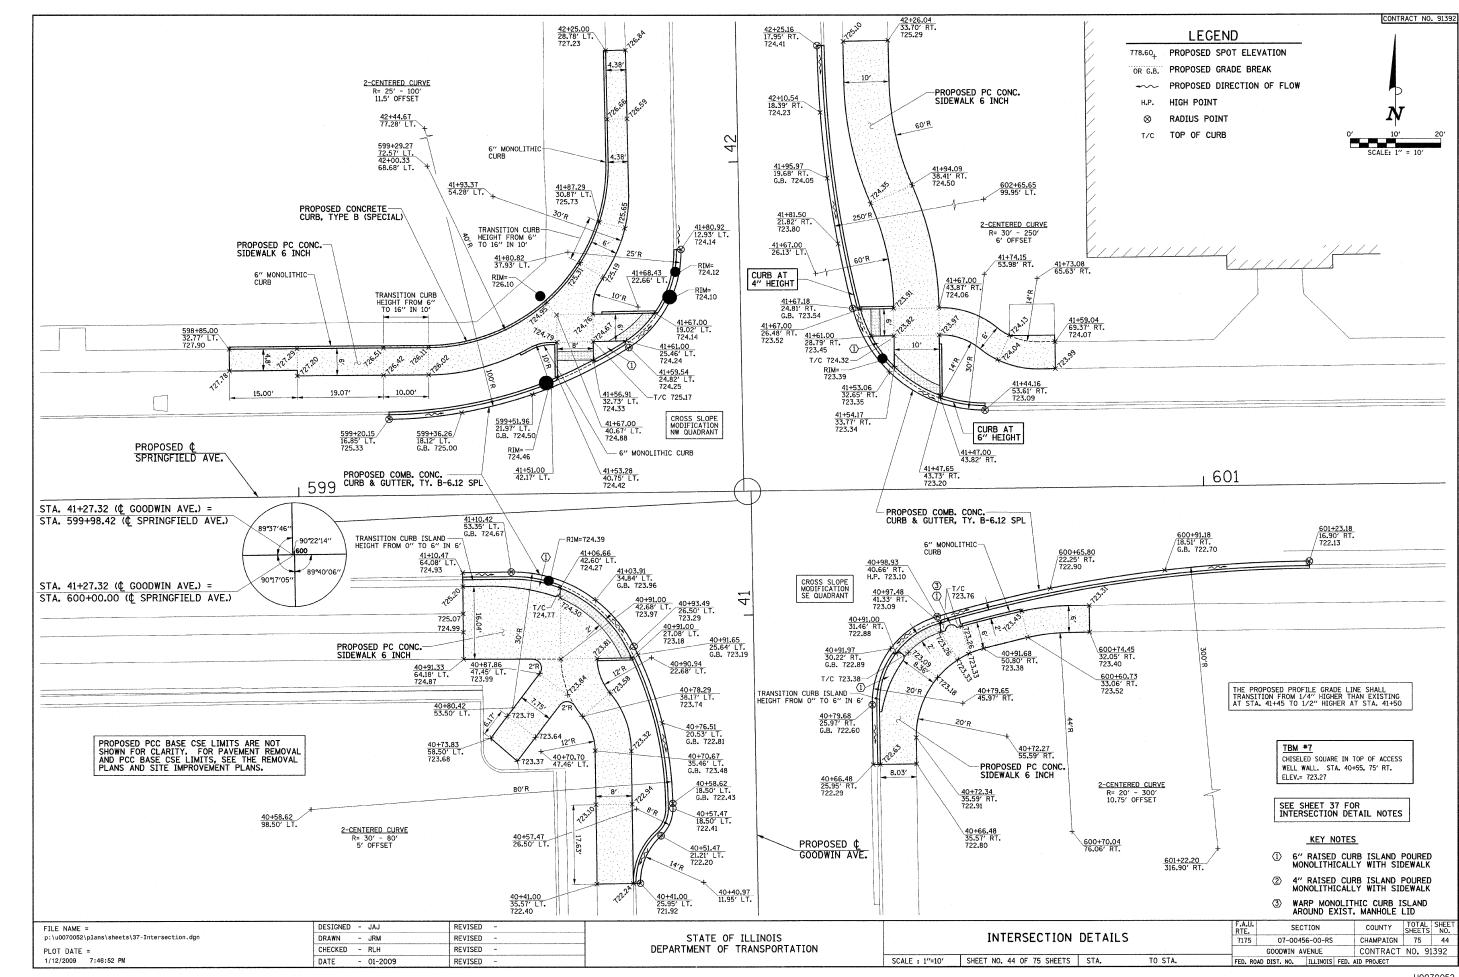

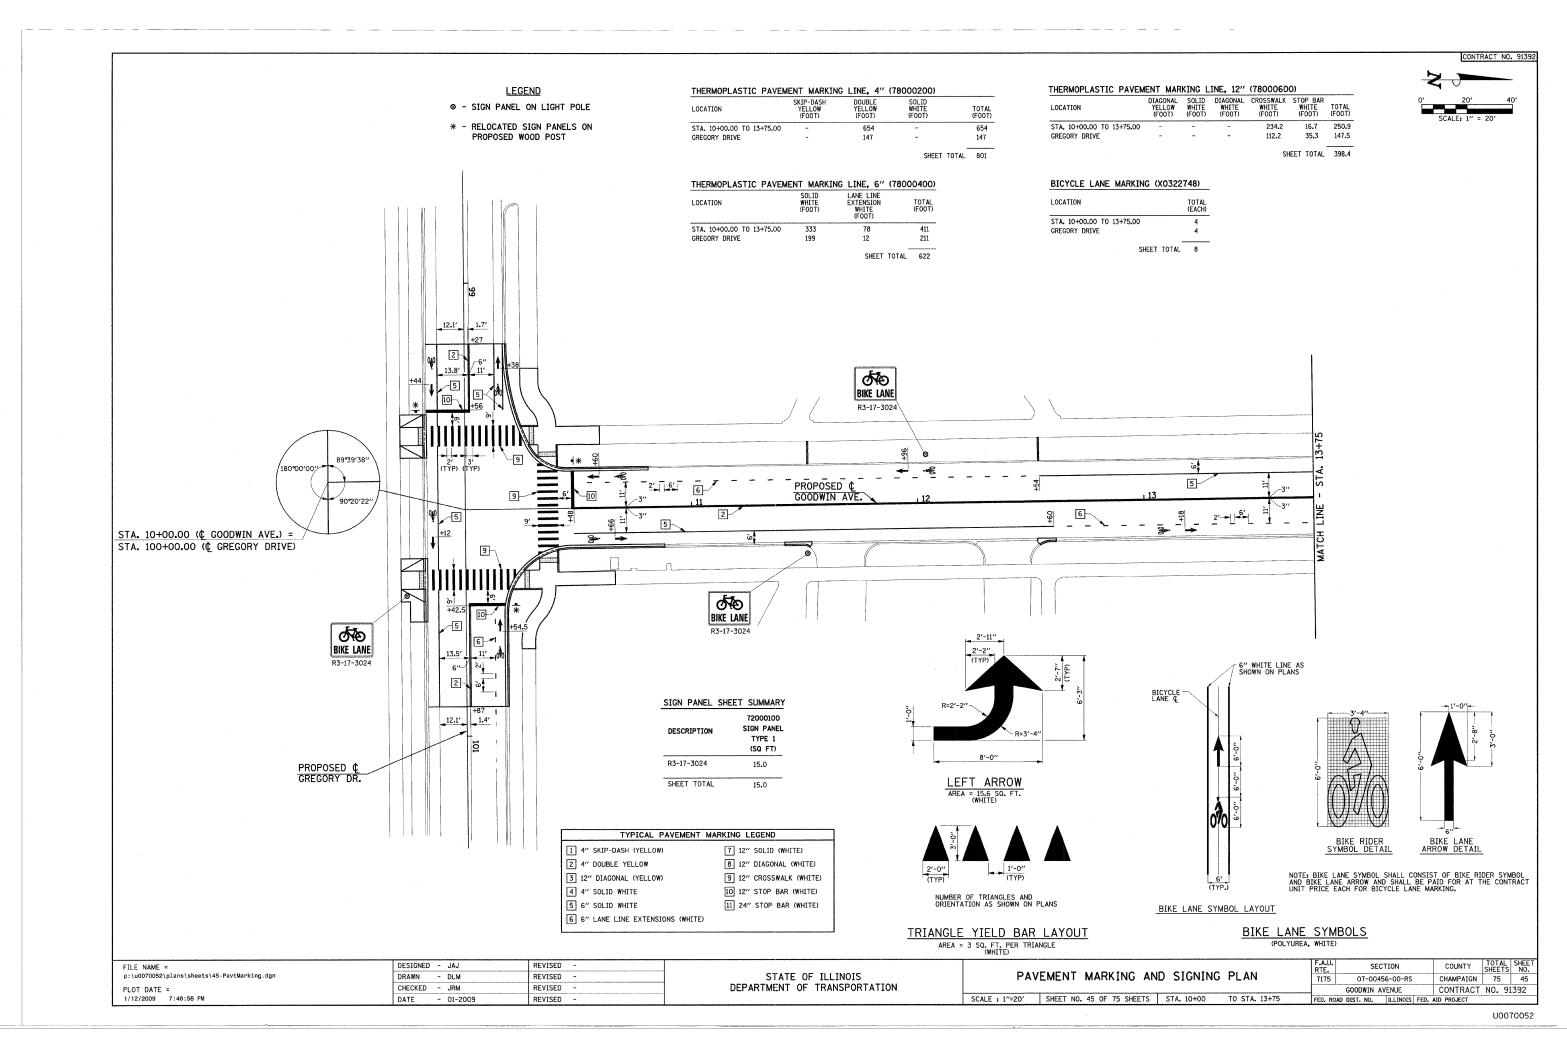

THERMOPLASTIC PAVEMENT MARKING	LETTERS	AND SYMBOLS	(78000100)
LOCATION	TURN ARROW (SQ FT)	YIELD BAR (SQ FT)	TOTAL (SQ FT)
STA. 13+75.00 TO 16+48.00	-	30	30
NEVADA STREET	15 <b>.</b> 6	-	15.6
		SHEET	TOTAL 45.6

THERMOPLASTIC PAVEM	ENT MARKING	LINE, 4"	(78000200)	
LOCATION	SKIP-DASH YELLOW (FOOT)	DOUBLE YELLOW (FOOT)	SOLID WHITE (FOOT)	TOTAL (FOOT)
STA. 13+75.00 TO 16+48.00	-	423	-	423

SHEET TOTAL 872.5

# STA. 16+48.00 TO 18+50.00 NEVADA STREET 440.5

声为

R1-5-1818

# THERMOPLASTIC PAVEMENT MARKING LINE, 6" (78000400)


LOCATION	WHITE (FOOT)	EXTENSION WHITE (FOOT)	(FOOT)
STA. 13+75.00 TO 16+48.00	343.5	16	359.5
STA. 16+48.00 TO 18+50.00	536	20	556
NEVADA STREET	30	=	30
		SHEET TO	TAL 945.5

THERMOPLASTIC PAVEMENT MARKING LINE, 12" (78000600) CROSSWALK STOP BAR WHITE (FOOT) STA. 13+75.00 TO 16+48.00 68 219.5 121.7 STA. 16+48.00 TO 18+50.00 22.7 NEVADA STREET

17.5 18.5 34.5 305.0 162.9 190.1 155.6

**LEGEND** SIGN PANEL ON LIGHT POLE

* - RELOCATED SIGN PANELS ON PROPOSED WOOD POST

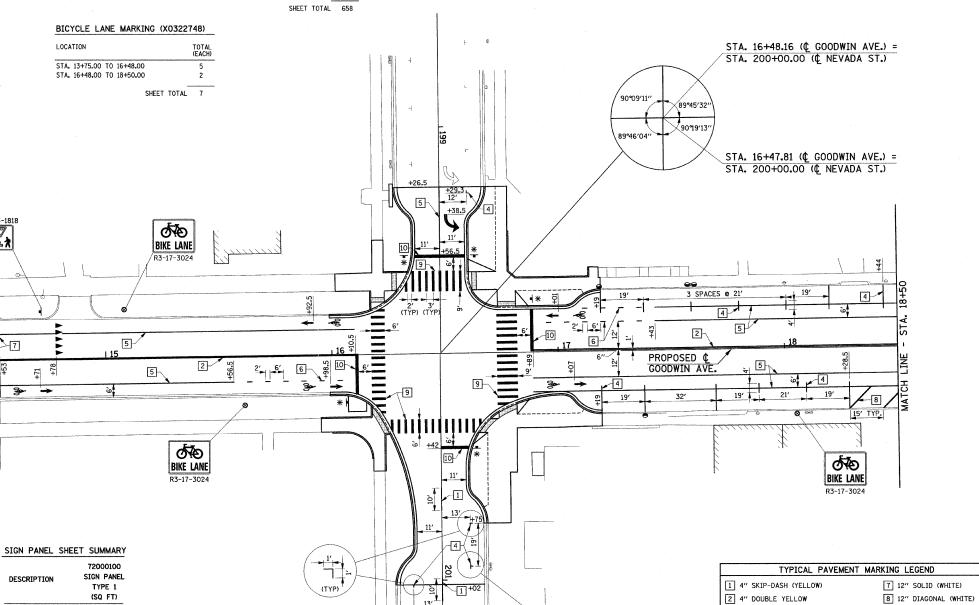

DESCRIPTION	72000100 SIGN PANEI TYPE 1 (SQ FT)
R3-17-3024 R1-5-1818	15.0 4.5
SHEET TOTAL	19.5


PROPOSED ¢ `~[|-

9 12" CROSSWALK (WHITE) 3 12" DIAGONAL (YELLOW)

10 12" STOP BAR (WHITE) 4 4" SOLID WHITE 11 24" STOP BAR (WHITE) 5 6" SOLID WHITE

6 6" LANE LINE EXTENSIONS (WHITE)

			· · · · · · · · · · · · · · · · · · ·			
FILE NAME =	DESIGNED - JAJ	REVISED -			F.A.U. SECTION	COUNTY TOTAL SHEET
p:\u0070052\plans\sheets\45-PavtMarking.dgn	DRAWN - DLM	REVISED -	STATE OF ILLINOIS	PAVEMENT MARKING AND SIGNING PLAN	7175 07-00456-00-RS	CHAMPAIGN 75 46
PLOT DATE =	CHECKED - JRM	REVISED -	DEPARTMENT OF TRANSPORTATION		GOODWIN AVENUE	CONTRACT NO. 91392
1/12/2009 7:46:56 PM	DATE - 01-2009	REVISED -		SCALE: 1"=20'   SHEET NO. 46 OF 75 SHEETS   STA. 13+75 TO STA. 18+50	FED. ROAD DIST. NO. ILLINOIS FED.	AID PROJECT

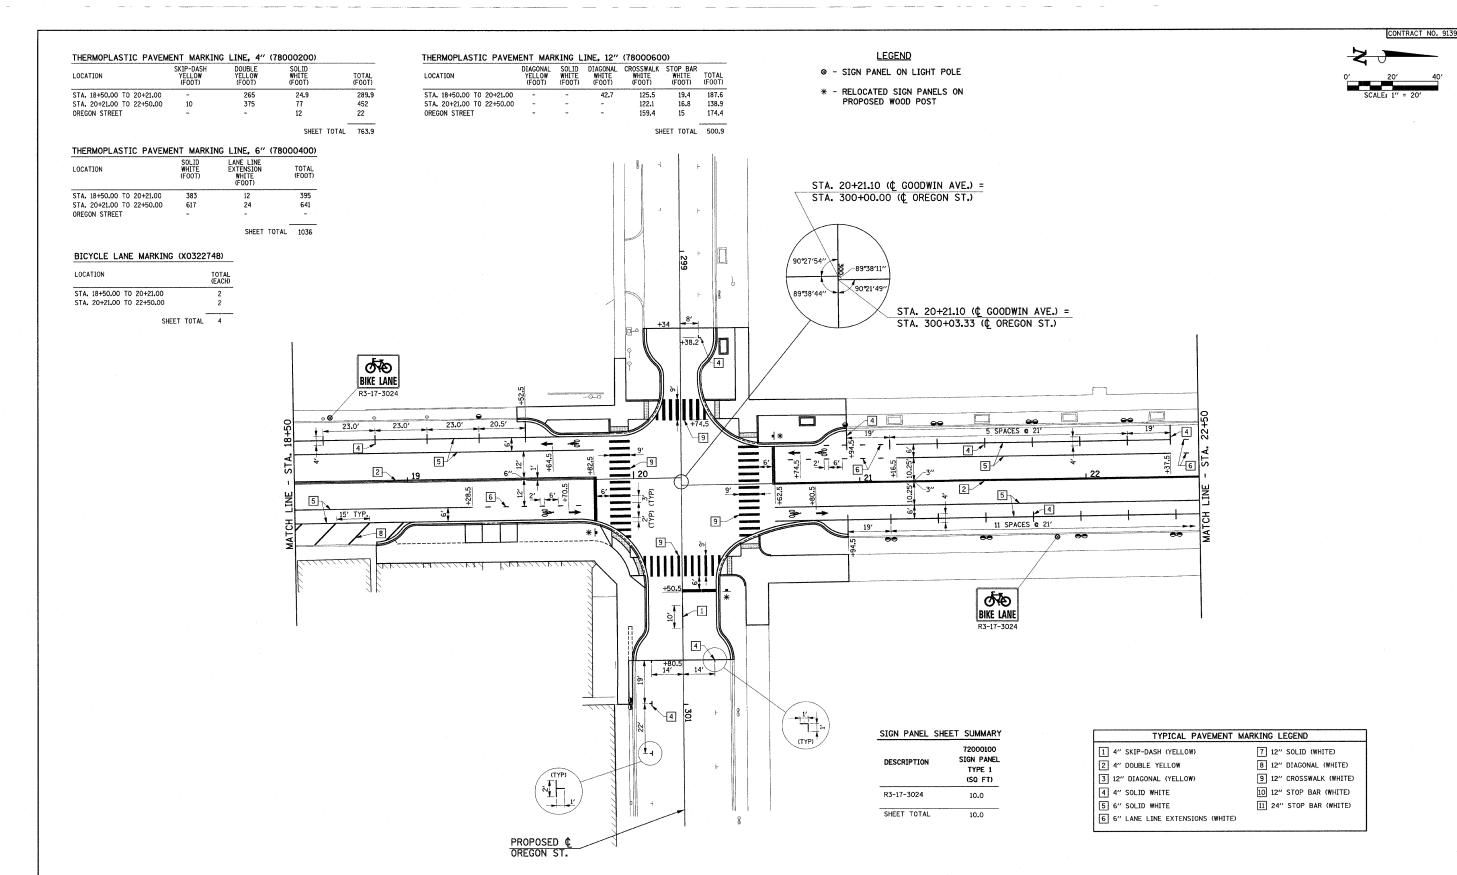

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	FILE NAME =	DESIGNED - JAJ	REVISED -	
	p:\u0070052\plans\sheets\45-PavtMarking.dgn	DRAWN - DLM	REVISED -	STATE OF ILLINOIS
	PLOT DATE =	CHECKED - JRM	REVISED -	DEPARTMENT OF TRANSPORTATION
	1/12/2009 7:46:57 PM	DATE - 01-2009	REVISED -	


 PAVEMENT
 MARKING
 AND
 SIGNING
 PLAN

 SCALE: 1"=20"
 SHEET NO. 47 OF 75 SHEETS
 STA. 18+50
 TO STA. 22+50

F.A.U. SECTION COUNTY TOTAL SHEETS NO. 7175 07-00456-00-RS CHAMPAIGN 75 47

GOODWIN AVENUE CONTRACT NO. 91392

THERMOPI ASTIC PAVEMENT MARKING LINE, 12" (78000600) 0TAL 00T) 165

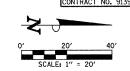

THERMOPLASTIC PAVEMENT MARKIN	LETTERS A	AND SYMBOLS	(78000100)
LOCATION	TURN ARROW (SQ FT)	YIELD BAR (SQ FT)	TOTAL (SQ FT)
STA. 22+50.00 TO 26+25.00	-	30	30
		SHEET T	OTAL 30


))	HERMOPLASTIC PAVEM	ICIY! MAR	VING F	TINE, 12	11000000	01	
<del></del>	LOCATION	DIAGONAL YELLOW (FOOT)	SOLID WHITE (FOOT)	DIAGONAL WHITE (FOOT)	CROSSWALK WHITE (FOOT)	STOP BAR WHITE (FOOT)	TOTA (F001
	STA. 22+50.00 TO 26+25.00	-	-	-	165	-	165
_					SH	EET TOTAL	165

THERMOPLASTIC PAVEM	ENT MARKING	LINE, 4"	(78000200)	
LOCATION	SKIP-DASH YELLOW (FOOT)	DOUBLE YELLOW (FOOT)	SOLID WHITE (FOOT)	TOTAL (FOOT)
STA. 22+50.00 TO 26+25.00	-	720	82.5	802.5
			SHEET TOTA	L 802.5

BICYCLE LANE MA	ARKING (X0322748)
LOCATION	TOTAL (EACH
STA. 22+50.00 TO 26+	F25.00 4
	SHEET TOTAL 4

THERMOPLASTIC	PAVEMENT	MARKING	LINE,	6"	(78000400)
LOCATION	Wi	OLID HITE OOT)	LANE LI EXTENSI WHITE (FOOT	ON	TOTAL (FOOT)
STA. 22+50.00 TO 26	5+25.00	821.2	140	1	961.2

**LEGEND** ⇒ - SIGN PANEL ON LIGHT POLE

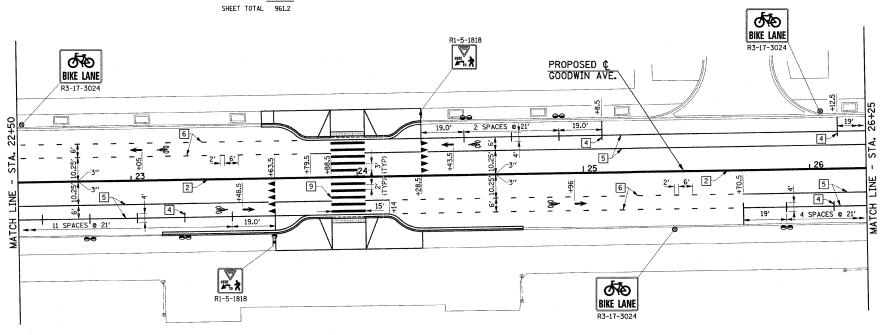


SIGN PANEL	SHEET SUMMARY
DESCRIPTION	72000100 SIGN PANEL TYPE 1 (SQ FT)
R3-17-3024	15.0
R1-5-1818	4.5
SHEET TOTAL	19.5


TYPICAL PAVEMENT N	MARKING LEGEND
1 4" SKIP-DASH (YELLOW)	7 12" SOLID (WHITE)
2 4" DOUBLE YELLOW	8 12" DIAGONAL (WHITE)
3 12" DIAGONAL (YELLOW)	9 12" CROSSWALK (WHITE)
4 4" SOLID WHITE	10 12" STOP BAR (WHITE)
5 6" SOLID WHITE	11 24" STOP BAR (WHITE)
6 6" LANE LINE EXTENSIONS (WHITE)	

FILE NAME =	DESIGNED - JAJ	REVISED -
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1/12/2009 7:46:58 PM	DATE - 01-2009	REVISED -

STATE	: OF	ILLINOIS	
DEPARTMENT	0F	TRANSPORTATION	

	5	F F	D 61011111		F.A.U. RTE.	SECTION	COUNTY	TOTAL SHEETS	SHEET NO.
١	PAV	EMENT MARKING AN	D SIGNING	j PLAN	7175	07-00456-00-RS	CHAMPAIGN	75	48
ı						GOODWIN AVENUE	CONTRACT	NO. 91	1392
ı	SCALE : 1"=20'	SHEET NO. 48 OF 75 SHEETS	STA. 22+50	TO STA. 26+25	FED. RO.	AD DIST. NO. ILLINOIS FED.	AID PROJECT		

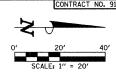

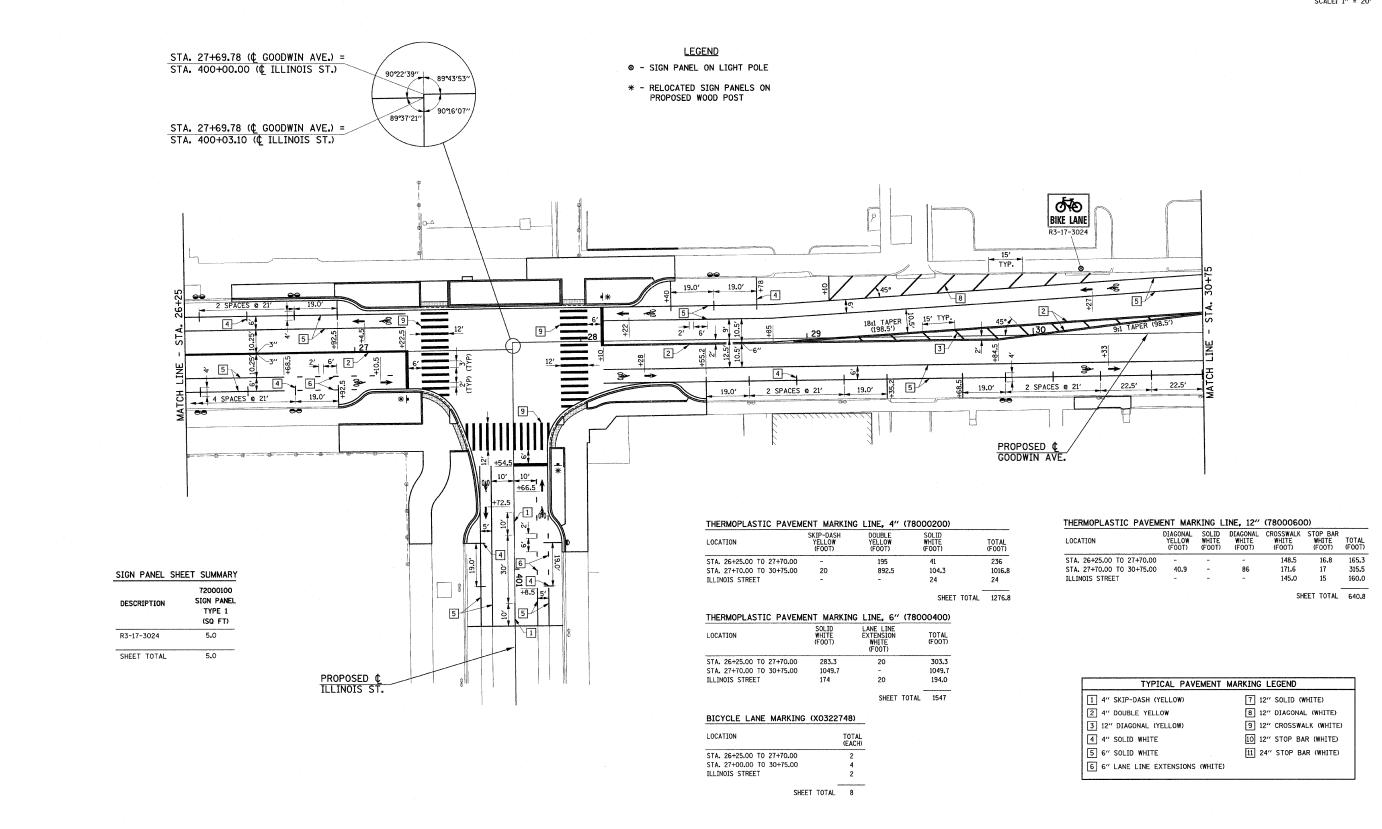

STATE OF ILLINOIS

DEPARTMENT OF TRANSPORTATION

DESIGNED - JAJ

DRAWN - DLM

CHECKED - JRM

- 01-2009

FILE NAME =

PLOT DATE =

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 		GOOD	WIN	A١	ENUE		C	ONTRACT	NO.	9:	1392
FED. RO	DAD	DIST.	NO.		ILLINOIS	FED.	AID	PROJECT			
									1.0	<u></u>	700E2


COUNTY TOTAL SHEET NO. CHAMPAIGN 75 49

SECTION

07-00456-00-RS


PAVEMENT MARKING AND SIGNING PLAN

SCALE: 1"=20' SHEET NO. 49 OF 75 SHEETS STA. 26+25 TO STA. 30+75

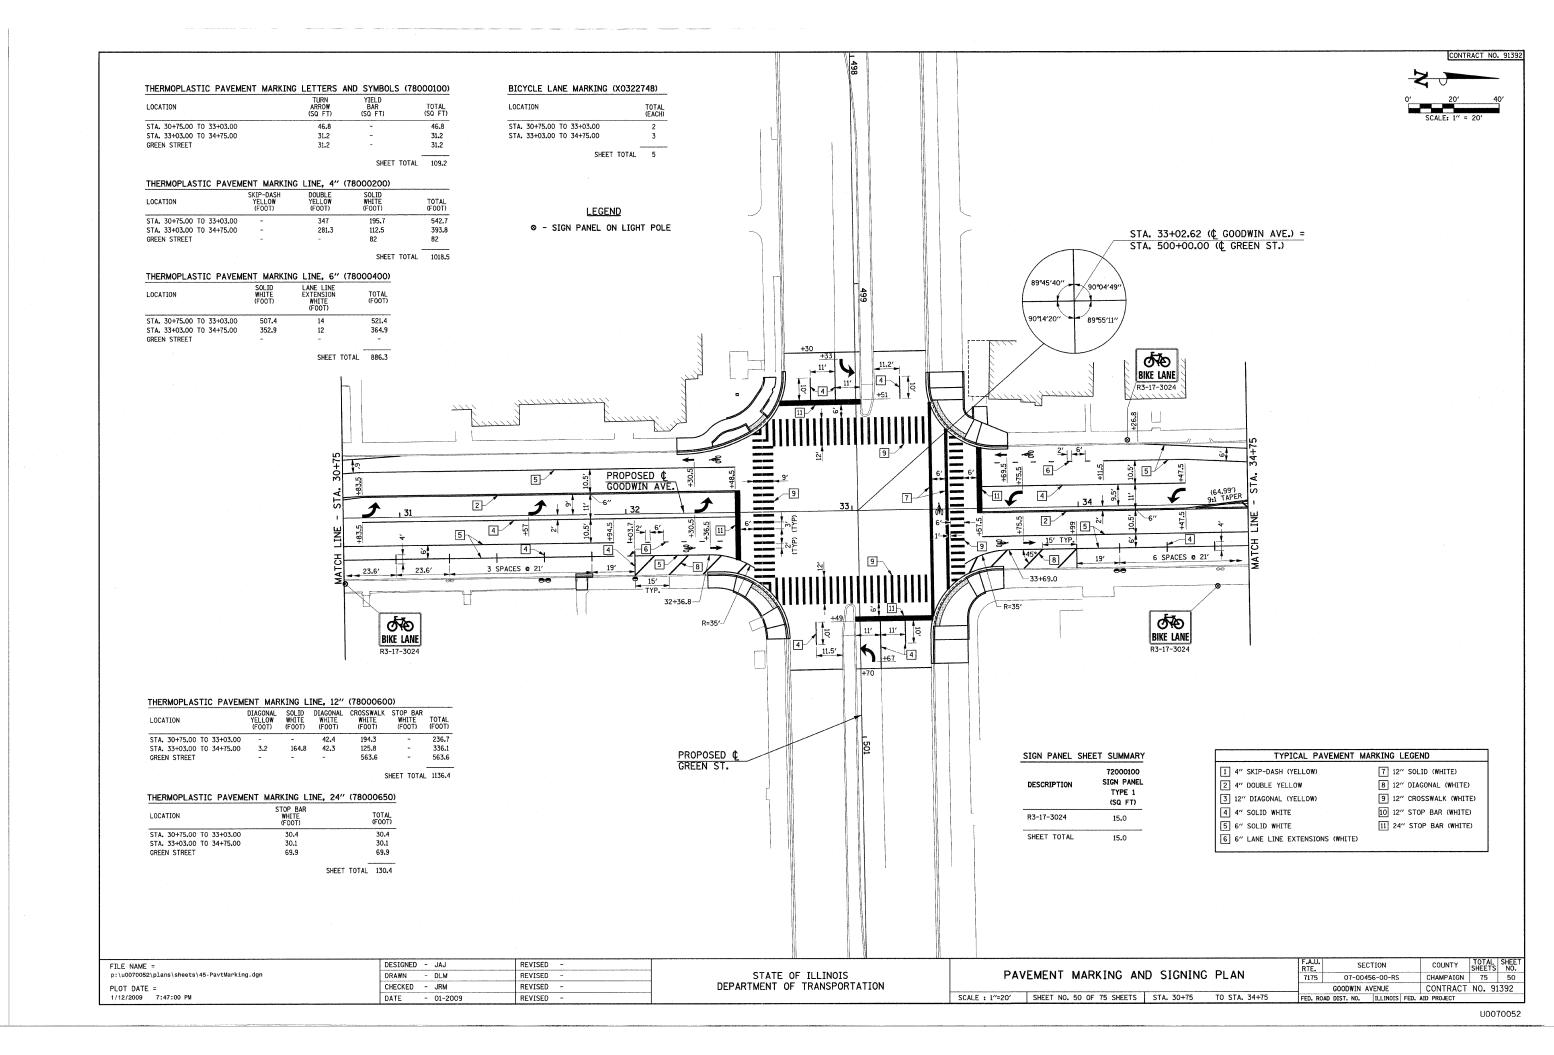

THERMOPLASTIC PAVEMENT N	MARKING	LETTERS	AND SYM	BOLS (78	(000100
LOCATION		TURN ARROW (SQ FT)	YIELI BAR (SQ F		TOTAL (SQ FT)
STA. 34+75.00 TO 39+25.00		-	30		30
			5	SHEET TOTA	L 30

THERMOPLASTIC PAVEM	IENT MAR	KING L	INE, 12"	(7800060	0)	
LOCATION	DIAGONAL YELLOW (FOOT)	SOLID WHITE (FOOT)	DIAGONAL WHITE (FOOT)	CROSSWALK WHITE (FOOT)	STOP BAR WHITE (FOOT)	TOTAL (FOOT
STA. 34+75.00 TO 39+25.00	152.9	-	95.5	144	-	392.4
				cu	EET TOTAL	700

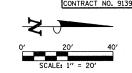


THERMOPLASTIC PAVEM	ENT MARKING	LINE, 4"	(78000200)	
LOCATION	SKIP-DASH YELLOW (FOOT)	DOUBLE YELLOW (FOOT)	SOLID WHITE (FOOT)	TOTAL (FOOT)
STA. 34+75.00 TO 39+25.00	*	1753.6	135.8	1889.4
			SHEET	TOTAL 1889.4

BICYCLE LANE MARKING (XO322	2748)
LOCATION	TOTAL (EACH)
STA. 34+75.00 TO 39+25.00	6
SHEET TOTAL	6

HERMOPLASTIC PAVEME	NT MARKING	LINE, 6"	(78000400)
OCATION	SOLID WHITE (FOOT)	LANE LINE EXTENSION WHITE (FOOT)	TOTAL (FOOT)
TA. 34+75.00 TO 39+25.00	1227.4	116	1343.4
		SHEET TO	OTAL 1343.4

<u>LEGEND</u> ⊗ - SIGN PANEL ON LIGHT POLE

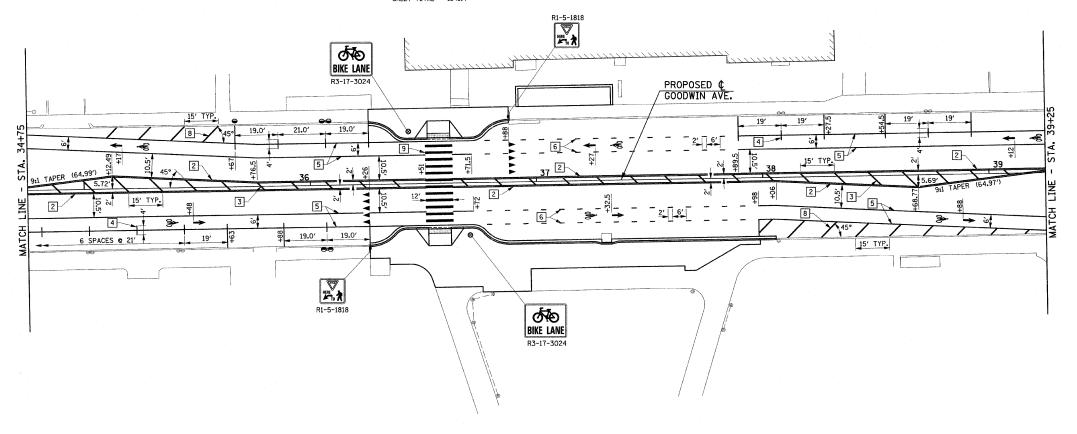

72000100 DESCRIPTION SIGN PANEL TYPE 1
(SQ FT)
-3024 10.0
-5-1818 4.5


TYPICAL PAVEMENT	MARKING LEGEND
1 4" SKIP-DASH (YELLOW)	7 12" SOLID (WHITE)
2 4" DOUBLE YELLOW	8 12" DIAGONAL (WHITE)
3 12" DIAGONAL (YELLOW)	9 12" CROSSWALK (WHITE)
4 4" SOLID WHITE	10 12" STOP BAR (WHITE)
5 6" SOLID WHITE	11 24" STOP BAR (WHITE)
6 6" LANE LINE EXTENSIONS (WHITE)	


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1/12/2009 7:47:01 PM	DATE	-	0


DESIGNED	-	JAJ	REVISED	-
DRAWN	-	DLM	REVISED	-
CHECKED	-	JRM	REVISED	-
DATE	_	01-2009	REVISED	-

STATE	OF	ILLINOIS	
DEPARTMENT	OF	TRANSPORTATION	

	DAVENEST MARKEN AND CONTINO DI MI	F.A.U. RTE.	SECTION	COUNTY	TOTAL SHEETS	SHEET NO.
-	PAVEMENT MARKING AND SIGNING PLAN	7175	07-00456-00-RS	CHAMPAIGN	75	51
-			GOODWIN AVENUE	CONTRACT	NO. 9:	1392
-	SCALE: 1"=20'   SHEET NO. 51 OF 75 SHEETS   STA. 34+75 TO STA. 39+25	FED. RO	AD DIST. NO. ILLINOIS FE	D. AID PROJECT		

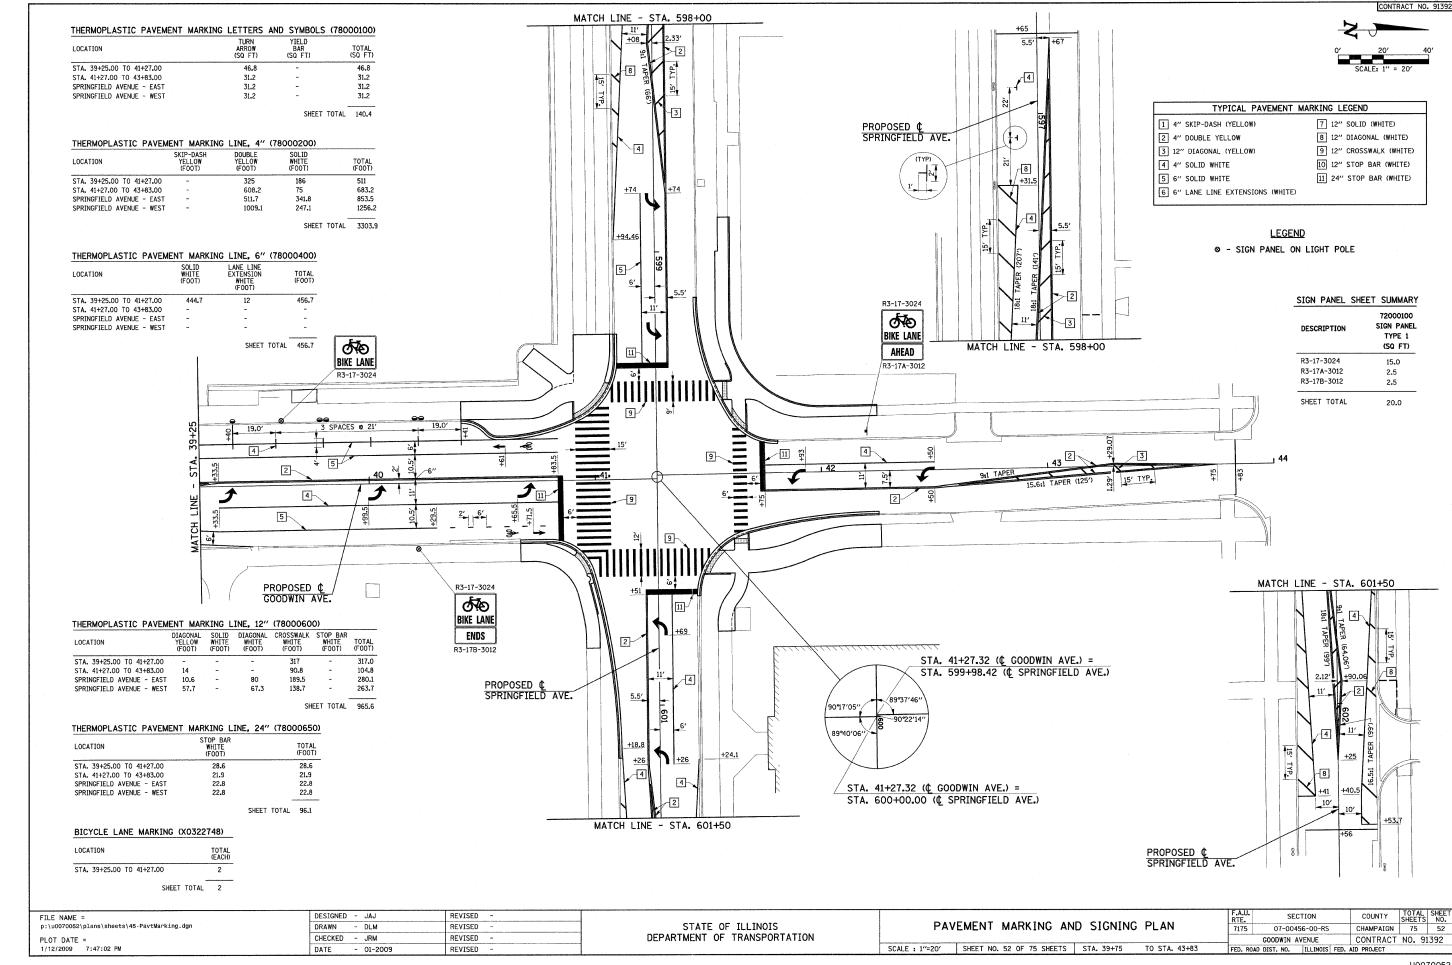

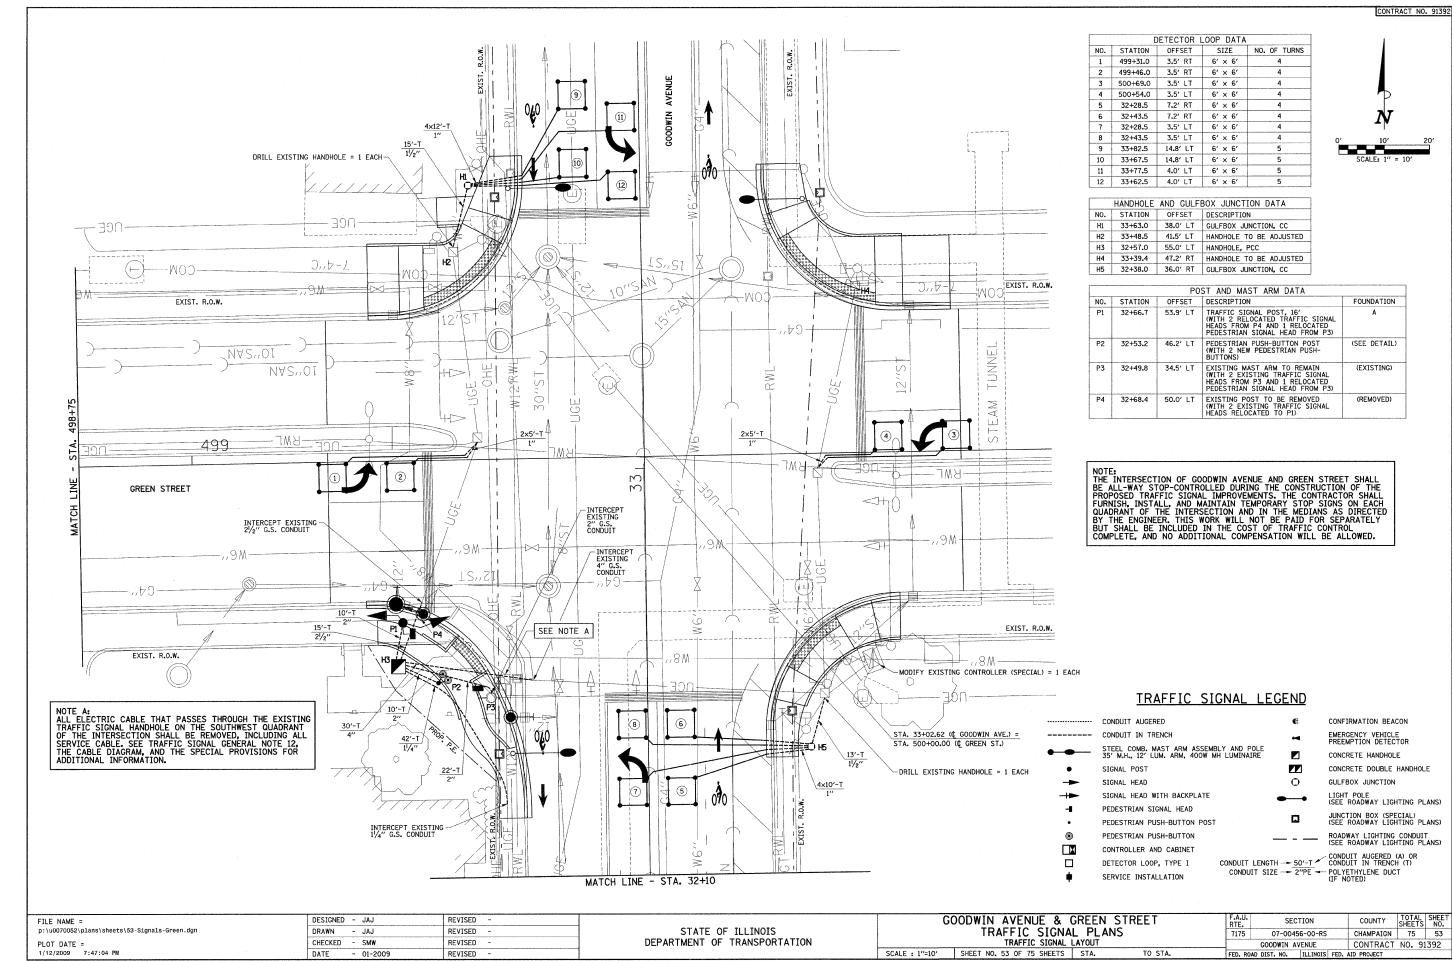

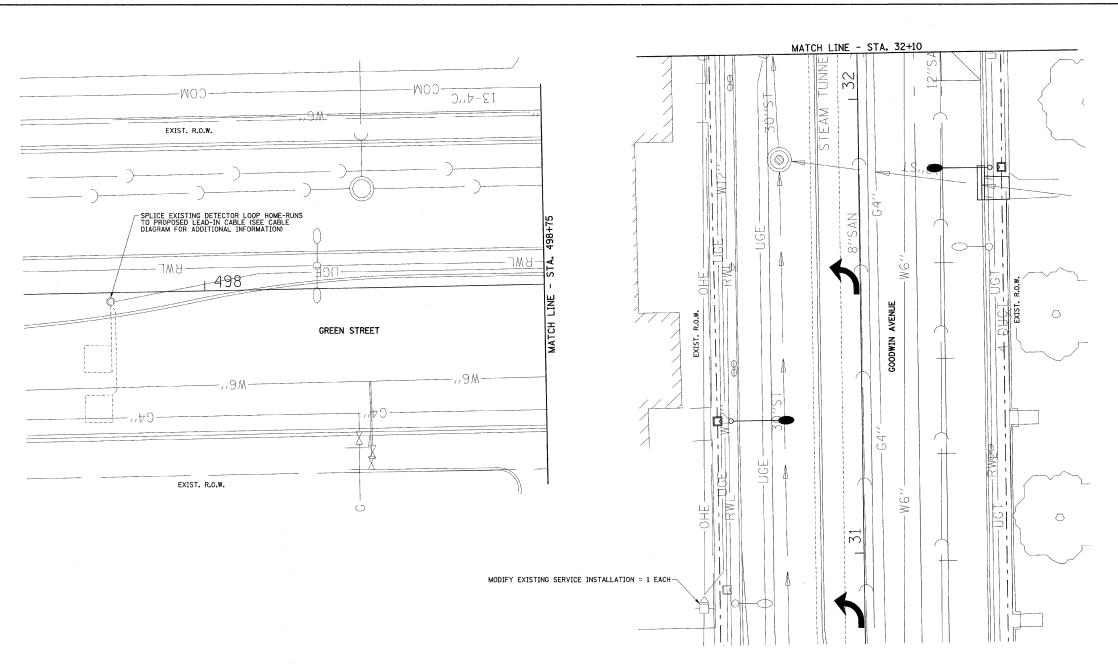

#### EXISTING TRAFFIC SIGNAL EQUIPMENT TO BE REMOVED

A. THE FOLLOWING EXISTING TRAFFIC SIGNAL EQUIPMENT SHALL BE REMOVED BY THE CONTRACTOR, SHALL REMAIN THE PROPERTY OF THE CITY OF URBANA, AND SHALL BE MOVED TO AND STORED AT A LOCATION DESIGNATED BY THE ENGINEER FOR PICK-UP BY THE CITY'S FORCES:

ITEM UNIT QUANTITY

TRAFFIC SIGNAL POST (SOUTHWEST QUADRANT)
PEDESTRIAN PUSH-BUTTON (SOUTHWEST QUADRANT)
EACH 2
MICROWAVE DETECTOR
LOOP DETECTOR AMPLIFIER
EACH 2
LOOP DETECTOR AMPLIFIER

THIS WORK WILL BE PAID FOR AT THE CONTRACT LUMP SUM PRICE FOR REMOVE EXISTING TRAFFIC SIGNAL EQUIPMENT. REMOVAL OF INDIVIDUAL ITEMS WILL NOT BE PAID FOR SEPARATELY.

B. THE CONTRACTOR SHALL REMOVE THE FOLLOWING EXISTING TRAFFIC SIGNAL ITEMS AND DISPOSE OF THEM IN ACCORDANCE WITH THE CONTRACT DOCUMENTS:

TIEM UNIT QUANTITY

HANDHOLE (SOUTHWEST QUADRANT) EACH 1
CONCRETE FOUNDATION (SOUTHWEST QUADRANT) EACH 1

THIS WORK WILL BE PAID FOR AT THE CONTRACT UNIT PRICE EACH FOR REMOVE EXISTING HANDHOLE AND REMOVE EXISTING CONCRETE FOUNDATION.

C. THE CONTRACTOR SHALL REMOVE THE EXISTING ELECTRIC CABLE AS SHOWN ON THE PLANS AND DISPOSE OF IT IN ACCORDANCE WITH THE CONTRACT DOCUMENTS. CABLE THAT IS REMOVED SHALL NOT BE REUSED. THIS WORK WILL BE PAID FOR AT THE CONTRACT LUMP SUM PRICE FOR REMOVE ELECTRIC CABLE FROM CONDUIT (SPECIAL). REMOVAL OF INDIVIDUAL CABLES WILL NOT BE PAID FOR SEPARATELY.

#### TRAFFIC SIGNAL LEGEND

	THAIT TO STOWNE LE	<u>ULIVD</u>	
	CONDUIT AUGERED	Œ	CONFIRMATION BEACON
	CONDUIT IN TRENCH	•	EMERGENCY VEHICLE PREEMPTION DETECTOR
•	STEEL COMB. MAST ARM ASSEMBLY AND POLE 35' M.H., 12' LUM. ARM, 400W MH LUMINAIRE		CONCRETE HANDHOLE
•	SIGNAL POST		CONCRETE DOUBLE HANDHOLE
-	SIGNAL HEAD	0	GULFBOX JUNCTION
-+-	SIGNAL HEAD WITH BACKPLATE	•	LIGHT POLE (SEE ROADWAY LIGHTING PLANS)
-1	PEDESTRIAN SIGNAL HEAD	_	JUNCTION BOX (SPECIAL)
•	PEDESTRIAN PUSH-BUTTON POST		(SEE ROADWAY LIGHTING PLANS)
•	PEDESTRIAN PUSH-BUTTON		ROADWAY LIGHTING CONDUIT
	CONTROLLER AND CABINET		,
	DETECTOR LOOP, TYPE I CONDUIT LENGT	TH 50'-T	CONDUIT AUGERED (A) OR CONDUIT IN TRENCH (T)
•	SERVICE INSTALLATION CONDUIT SIZ	'E → 2"PE →	- POLYETHYLENE DUCT (IF NOTED)

				· · · · · · · · · · · · · · · · · · ·		
FILE NAME =	DESIGNED - JAJ	REVISED -		GOODWIN AVENUE & GREEN STREET	F.A.U. SECTION	COUNTY TOTAL SHEET
P:\U0070052\Plans\sheets\53-Signals-Green.dgn	DRAWN - JAJ	REVISED -	STATE OF ILLINOIS	TRAFFIC SIGNAL PLANS	7175 07-00456-00-RS	CHAMPAIGN 75 54
PLOT DATE =	CHECKED - SMW	REVISED -	DEPARTMENT OF TRANSPORTATION	TRAFFIC SIGNAL LAYOUT	GOODWIN AVENUE	CONTRACT NO. 91392
1/23/2009 3:02:06 PM	DATE - 01-2009	REVISED -		SCALE : 1"=10' SHEET NO. 54 OF 75 SHEETS STA. TO STA.	FED. ROAD DIST. NO. ILLINOIS FED.	AID PROJECT

#### BILL OF MATERIALS

ITEM	UNIT	QUANTITY
CONDUIT IN TRENCH, 1" DIA., PVC	FOOT	108
CONDUIT IN TRENCH, 11/4" DIA., PVC	FOOT	42
CONDUIT IN TRENCH, 11/2" DIA., PVC	FOOT	28
CONDUIT IN TRENCH, 2" DIA., PVC	FOOT	42
CONDUIT IN TRENCH, 21/2" DIA., PVC	FOOT	15
CONDUIT IN TRENCH, 4" DIA., PVC	FOOT	30
HANDHOLE TO BE ADJUSTED	EACH	2
HANDHOLE, PORTLAND CEMENT CONCRETE	EACH	1
GULFBOX JUNCTION, COMPOSITE CONCRETE	EACH	2
TRENCH AND BACKFILL FOR ELECTRICAL WORK	FOOT	13
TRENCH AND BACKFILL WITH SCREENINGS OR SAND	FOOT	252
ELECTRIC CABLE IN CONDUIT, SIGNAL, NO. 14 2C	FOOT	420
ELECTRIC CABLE IN CONDUIT, SIGNAL, NO. 14 3C	FOOT	1220
ELECTRIC CABLE IN CONDUIT, SIGNAL, NO. 14 5C	FOOT	410
ELECTRIC CABLE IN CONDUIT, SIGNAL, NO. 14 7C	FOOT	820
ELECTRIC CABLE IN CONDUIT, LEAD-IN, NO. 18 3 PAIR	FOOT	1260
TRAFFIC SIGNAL POST, 16 FT.	EACH	1
PEDESTRIAN PUSH-BUTTON POST, TYPE I	EACH	1
CONCRETE FOUNDATION, TYPE A	FOOT	3
DRILL EXISTING HANDHOLE	EACH	2
DETECTOR LOOP, TYPE I	FOOT	540
PEDESTRIAN PUSH-BUTTON	EACH	2
RELOCATE EXISTING SIGNAL HEAD	EACH	2
RELOCATE EXISTING PEDESTRIAN SIGNAL HEAD	EACH	2
MODIFY EXISTING CONTROLLER (SPECIAL)	EACH	1
REMOVE EXISTING HANDHOLE	EACH	1
REMOVE EXISTING CONCRETE FOUNDATION	EACH	1
MODIFY EXISTING SERVICE INSTALLATION	EACH	1
REMOVE EXISTING TRAFFIC SIGNAL EQUIPMENT	L SUM	0.1
ELECTRIC CABLE IN CONDUIT, GROUNDING, NO. 6 1C	FOOT	760
ELECTRIC CABLE IN CONDUIT, NO. 20 3C, TWISTED, SHIELDED	FOOT	520
INDUCTIVE LOOP DETECTOR, RACK MOUNTED	EACH	8
ELECTRIC CABLE IN CONDUIT, SERVICE, NO. 6 1C	FOOT	660
REMOVE ELECTRIC CABLE FROM CONDUIT (SPECIAL)	L SUM	1


#### * SEE SPECIAL PROVISIONS FOR SYSTEM GROUNDING INFORMATION

#### TRAFFIC SIGNAL GENERAL NOTES

- 1. THE ACTUAL LOCATIONS OF ALL SIGNAL FOUNDATIONS AND HANDHOLES WILL BE VERIFIED IN THE FIELD BY THE ENGINEER.
- 2. POST MOUNTED SIGNAL HEADS SHALL BE INSTALLED SUCH THAT NO PART OF THE SIGNAL HEAD IS WITHIN TWO (2) FEET OF THE FACE OF CURB.
- 3. 12" LENSES SHALL BE USED ON ALL SIGNAL FACES, LED INDICATIONS SHALL BE USED ON ALL SIGNAL HEADS AND PEDESTRIAN SIGNAL HEADS, PEDESTRIAN SIGNAL HEADS AND FACES SHALL BE SYMBOLS WITH COLUMNITOWN THERS.
- 4. THE CONTRACTOR SHALL VERIFY THE EXACT LOCATION OF ALL UNDERGROUND UTILITIES PRIOR TO BEGINNING CONSTRUCTION.
- 5. THE CONTRACTOR SHALL BE RESPONSIBLE FOR THE COST OF UNCOVERING OR HAND DIGGING AROUND UTILITIES AS NECESSARY, AND NO ADDITIONAL COMPENSATION WILL BE ALLOWED.
- 6. NO ADDITIONAL COMPENSATION WILL BE ALLOWED FOR PLACING CONDUIT AT GREATER THAN 2 FOOT DEPTH TO AVOID OBSTACLES SUCH AS UNDERCROUND UTILITIES OR TO MATCH THE DEPTH OF THE EXISTING CONDUIT TO BE INTERCEPTED.
- 7. A '/" POLYPROPYLENE PULL ROPE SHALL BE INSTALLED IN ALL CONDUIT RUNS EXCEEDING 20 FEET. A MINIMUM OF 2 FEET OF ROPE SHALL BE PROVIDED AT EACH END OF A CONDUIT RUN. THE ROPE SHALL BE INCLUDED IN THE COST OF THE RESPECTIVE CONDUIT PAY ITEM.
- 8. ALL ADAPTERS REQUIRED TO CONNECT THE PROPOSED CONDUIT TO THE EXISTING CONDUIT SHALL BE INCLUDED IN THE COST OF THE RESPECTIVE CONDUIT PAY ITEM, AND NO ADDITIONAL COMPENSATION WILL BE ALLOWED.
- 9. THE CONTRACTOR SHALL BE RESPONSIBLE FOR OBTAINING ELECTRICAL SERVICE FOR THE TRAFFI SIGNALS, THE CONTRACTOR SHALL CONTACT. THE UTILITY COMPANY AND THE CITY OF URBAIN
- 10. CONTROLLER PROGRAMMING OF SIGNAL TIMING WILL BE PROVIDED BY THE CITY OF URBANA.
- THE ELECTRIC CABLE FOR EACH EXISTING LIGHT DETECTOR SHALL BE A CONTINUOUS UNBROKE RUN FROM THE LIGHT DETECTOR TO THE LIGHT DETECTOR AMPLIFIER. SPLICES IN THE CABLE SHALL NOT BE ALLOWED.
- 12. THE EXISTING ELECTRIC CABLES IN THE MAST ARM POLES AND SIGNAL POSTS THAT WILL REMAIN THE POLES AND SIGNAL POSTS THAT WILL REMAIN ON THE MOST AND SOUTHWEST QUADRANTS, EXCEPT FOR THE EXISTING LIGHT OFFICE CORE. AND THE STRUCKER TO THE PROPOSED CABLES IN THE
- 13. THE THREE SECTION AND FIVE SECTION SIGNAL HEADS THAT OPERATE TOGETHER IN THE SAME HEASE AT THE SAME LOCATION WILL BE COMBINED ON A SINGLE SEVEN CONDUCTOR CABLE. TWO PEDESTRIAN PUSH-BUTTONS AT THE SAME LOCATION WILL BE COMBINED ON A SINGLE THREE CONDUCTOR CABLE. SPLICES WILL BE MADE AT THE POLE HANDHOLE PUSH-BUTTON POST CAR WITH INDIVIDUAL CABLES RUNNING FROM THE SPLICE TO EACH SIGNAL HEAD OR PEDESTRIAN
- 14. THE EXISTING "NO TURN ON RED" SIGN ON THE SOUTHWEST QUADRANT SHALL BE RELOCATED FROM THE EXISTING ITRAFFIC SIGNAL POST TO THE PROPOSED TRAFFIC SIGNAL POST, AND NO ADDITIONAL COMPENSATION WILL BE ALLOWED.
- 15. THE EXISTING PEDESTRIAN PUSH-BUTTON SIGNS ON THE SOUTHWEST QUADRANT SHALL BE RELOCATED FROM THE EXISTING MAST ARM POLE TO THE PROPOSED PEDESTRIAN PUSH-BUTTON POST, AND NO ADDITIONAL COMPENSATION WILL BE ALLOWED.
- 16. THE CONCRETE FOUNDATION FOR THE PEDESTRIAN PUSH-BUTTON POST SHALL BE INCLUDED IN THE COST OF THE PEDESTRIAN PUSH-BUTTON POST.

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17. DETECTOR LOOPS SHALL BE INSTALLED PRIOR TO CONSTRUCTION OF THE HMA SURFACE COURSE.

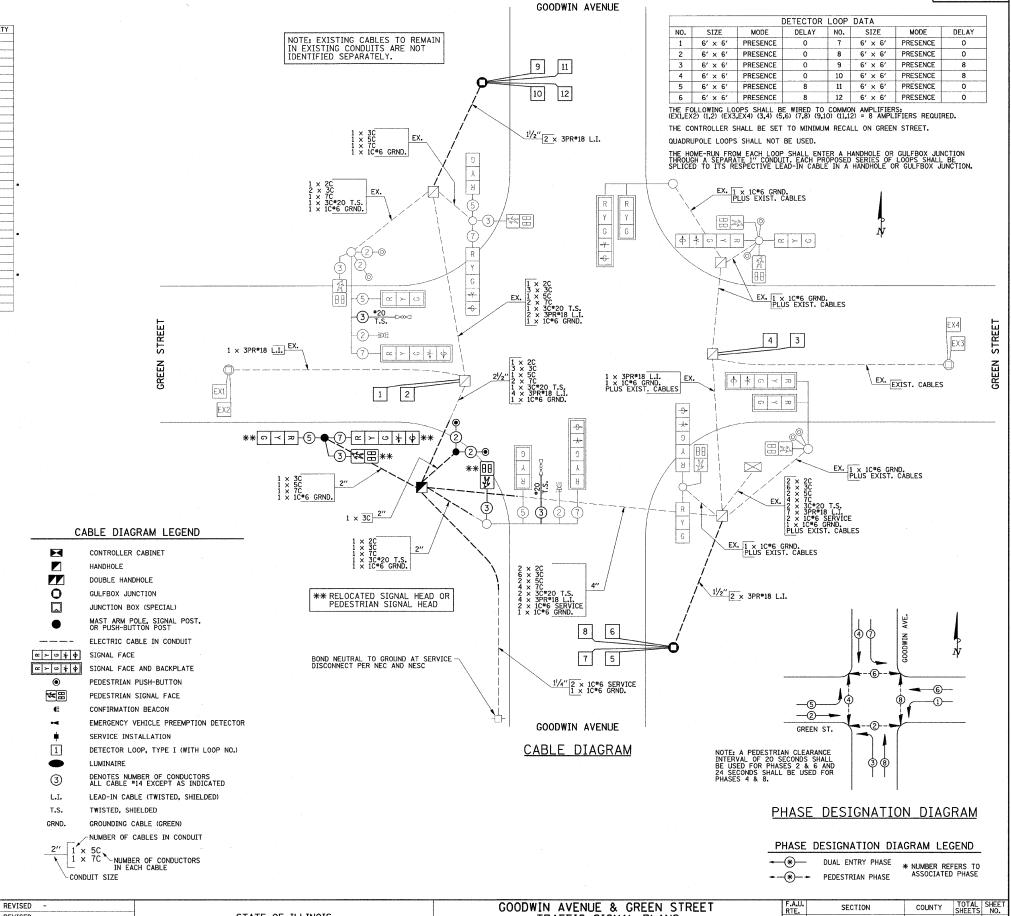

SCALE : NONE


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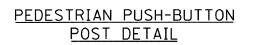
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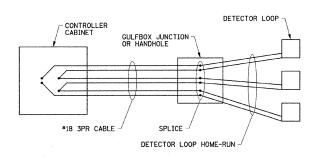
DESIGNED - JAJ

STATE OF ILLINOIS
DEPARTMENT OF TRANSPORTATION



# PUSH-BUTTON SIGN PUSH-BUTTON SIGN PUSH-BUTTON POLARA BULLDOG PUSH-BUTTON PER HIGHWAY STANDARD 876001 EXCEPT SHORTEN POLE FROM 6'-6' OVERALL HEIGHT TO 5'-0' OR AS OTHERWISE REQUIRED TO MOUNT THE RELOCATED PUSH-BUTTON SIGNS. FINISHED GRADE OF MONOLITHIC CURB FINISHED GRADE OF SIDEWALK CONCRETE FOUNDATION 12" DIAMETER x 36" DEPTH



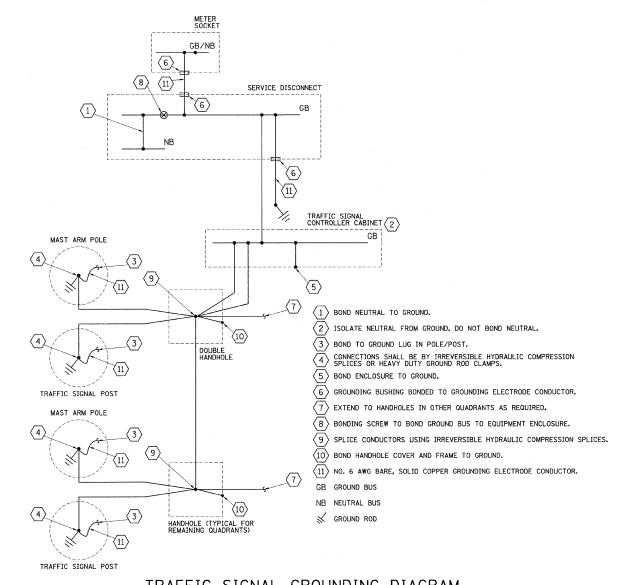

#### DETECTOR LOOP WIRING DETAIL

WIRED IN SERIES WITH MULTI-PAIR CABLE

IRAFFIC	SIGNAL	GROUNDING	DIAGRAM

ALL WIRES SHALL BE NO. 6 AWG STRANDED COPPER CONDUCTORS WITH XLP INSULATION UNLESS OTHERWISE INDICATED. THE INSULATION COLOR SHALL BE GREEN.

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STATE OF ILLINOIS
DEPARTMENT OF TRANSPORTATION

GOODWIN AVENUE & GREEN STREET	F.A.U. SECTION COUNTY TOTAL SHEE SHEETS NO.
TRAFFIC SIGNAL PLANS	7175 07-00456-00-RS CHAMPAIGN 75 56
TRAFFIC SIGNAL DETAILS	GOODWIN AVENUE CONTRACT NO. 91392
SCALE : NONE   SHEET NO. 56 OF 75 SHEETS   STA. TO STA.	FED. ROAD DIST. NO.   ILLINOIS   FED. AID PROJECT

#### TEMPORARY TRAFFIC SIGNAL NOTES

- 1. ALL CONTROL EQUIPMENT FOR THE TEMPORARY TRAFFIC SIGNALS SHALL BE FURNISHED BY THE CONTRACTOR.
- 2. THE TEMPORARY SIGNALS SHALL BE FULLY INSTALLED AND OPERATIONAL PRIOR TO THE EXISTING SIGNALS BEING DISCONNECTED. THE PROPOSED SIGNAL INSTALLATION SHALL BE INSTALLED AND OPERATIONAL BEFORE THE TEMPORARY INSTALLATION IS DISCONNECTED.
- 3. THE PROPOSED TEMPORARY TRAFFIC SIGNALS SHALL BE INSTALLED IN ACCORDANCE WITH STANDARD 880001 AND SECTION 890 OF THE STANDARD SPECIFICATIONS.
- 4. IT SHALL BE THE CONTRACTOR'S RESPONSIBILITY TO PROVIDE WOOD POLES OF SUFFICIENT LENGTH TO MAINTAIN THE CLEARANCE REQUIREMENTS SHOWN IN STANDARD 880001.
- 5. IT SHALL BE THE CONTRACTOR'S RESPONSIBILITY TO PROVIDE WOOD POLES OF THE CLASS REQUIRED TO SUPPORT THE TEMPORARY TRAFFIC SIGNAL INSTALLATION IN ACCORDANCE WITH STANDARD 880001 AND SECTION 890 OF THE STANDARD SPECIFICATIONS.
- 6. ALL HARDWARE NECESSARY TO INSTALL THE SPAN WIRE, SIGNAL HEADS, WOOD POLES, GUY WIRES, AND ANY OTHER ITEMS NECESSARY FOR THE COMPLETE INSTALLATION OF THE TEMPORARY TRAFFIC SIGNALS SHALL BE PROVIDED BY THE CONTRACTOR.
- 7. THE CONTROLLER USED FOR THE TEMPORARY TRAFFIC SIGNAL INSTALLATION SHALL BE A FULLY-ACTUATED NEMA MICROPROCESSOR-BASED CONTROLLER INSTALLED IN A CABINET. THE CONTROLLER SHALL ACCOMMODATE 8 VEHICLE PHASES AND 4 PEDESTRIAN PHASES AND SHALL BE CAPABLE OF SUPPLYING 255 SECONDS OF CYCLE LENGTH WITH INDIVIDUAL PHASE LENGTH SETTINGS UP TO 99 SECONDS.
- 8. ALL TEMPORARY SIGNAL FACES SHALL HAVE 12 INCH LENSES. THE TEMPORARY SIGNAL HEADS SHALL BE PLACED AS INDICATED ON THE TEMPORARY TRAFFIC SIGNAL PLAN OR AS DIRECTED BY THE ENGINEER. THE CONTRACTOR SHALL FURNISH ENOUGH CABLE SLACK TO RELOCATE EACH TEMPORARY SIGNAL HEAD OF ANY POSITION ON ITS SPAN WITE. EACH TEMPORARY SIGNAL HEAD SHALL HAVE ITS OWN CABLE FROM THE CONTROLLER CABINET TO THE SIGNAL HEAD.
- 9. ALL EXISTING STREET NAME AND INTERSECTION REGULATORY SIGNS SHALL BE REMOVED FROM EXISTING LOCATIONS AND RELOCATED AND SECURELY FASTENED TO THE TEMPORARY TRAFFIC SIGNAL INSTALLATION. "NO TURN ON RED" SIGNS (MUTCD RIO-118-2424) SHALL BE ADDED TO THE TEMPORARY TRAFFIC SIGNAL INSTALLATION."
- 10. THE PROPOSED SIGNAL TIMINGS FOR THE TEMPORARY CONTROLLER WILL BE PROVIDED BY THE CITY OF URBANA. THE TEMPORARY TRAFFIC SIGNAL SYSTEM SHALL BE PRE-TIMED.
- 11. ALL LABOR AND MATERIALS REQUIRED TO COMPLY WITH THESE REQUIREMENTS SHALL BE CONSIDERED INCLUDED IN THE CONTRACT UNIT PRICE FOR THEOREMY TRAFFIC SIGNAL INSTALLATION. THE ITEMS AND QUANTITIES SHOWN ARE FOR INFORMATIONAL PURPOSES ONLY.
- 12, NO ADDITIONAL PAYMENT SHALL BE MADE FOR ANY DELAYS OR SIGNAL HEAD RELOCATIONS RESULTING FROM UTILITY RELOCATIONS, CHANGES IN STAGING, REMOVAL OF EXISTING SIGNALS, OR INSTALLATION OF PROPOSED SIGNALS.

#### TEMPORARY CABLE DIAGRAM LEGEND


▼ TEMPORARY CONTROLLER CABINET

∝ > ∪

TEMPORARY TRAFFIC SIGNAL FACE WITH BACKPLATE

-CI- TEMPORARY SERVICE INSTALLATION

5 NUMBER OF CONDUCTORS IN CABLE ALL CABLE *14 EXCEPT AS INDICATED

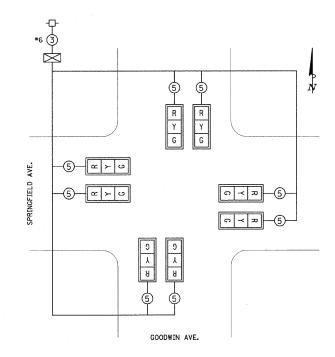

#### TEMPORARY CABLE DIAGRAM

NO SCALE

#### TEMPORARY PHASE DESIGNATION DIAGRAM

STA. 41+27.32 (¢ GOODWIN AVE.) = STA. 600+00.00 (¢ SPRINGFIELD AVE.)

NO SCALE

<del>-</del>6

#### TEMPORARY TRAFFIC SIGNAL LEGEND

TEMPORARY TRAFFIC SIGNAL HEAD, SPAN WIRE MOUNTED

TEMPORARY WOOD POLE


_ TEMPORARY SPAN WIRE, TETHER WIRE,


AND CABLE

TEMPORARY GUY WIRE

▼ TEMPORARY CONTROLLER CABINET

-C- TEMPORARY SERVICE INSTALLATION

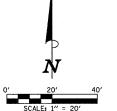

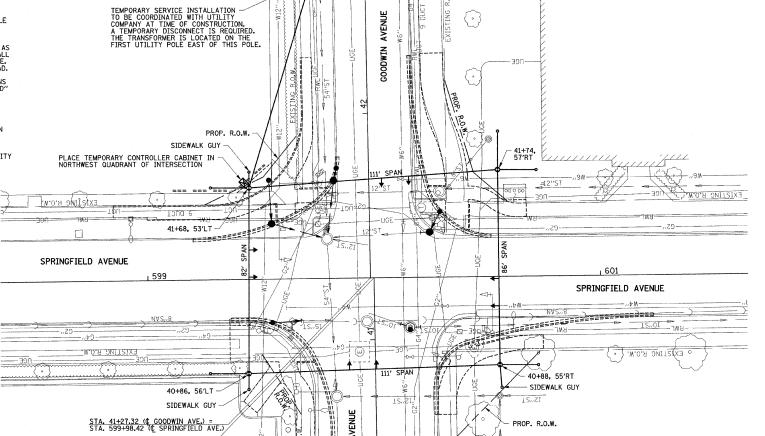

EXISTING R.O.W.

EXIZIINC B'O'M'

EXISTING TRAFFIC SIGNAL EQUIPMENT TO BE REMOVED

A. THE FOLLOWING EXISTING TRAFFIC SIGNAL EQUIPMENT SHALL BE REMOVED BY THE CONTRACTOR, SHALL REMAIN THE PROPERTY OF THE CITY OF URBANA, AND SHALL BE MOVED TO AND STORED AT A LOCATION DESIGNATED BY THE ENGINEER FOR PICK-UP BY THE CITY'S FORCES:

THIS WORK WILL BE PAID FOR AT THE CONTRACT LUMP SUM PRICE FOR REMOVE EXISTING TRAFFIC SIGNAL EQUIPMENT. REMOVAL OF INDIVIDUAL ITEMS WILL NOT BE PAID FOR SEPARATELY.

B. THE CONTRACTOR SHALL REMOVE THE FOLLOWING EXISTING TRAFFIC SIGNAL ITEMS AND DISPOSE OF THEM IN ACCORDANCE WITH THE CONTRACT DOCUMENTS:

 ITEM
 UNIT
 QUANTITY

 HANDHOLE CONCRETE FOUNDATION
 EACH 3

 EACH 8
 8

THIS WORK WILL BE PAID FOR AT THE CONTRACT UNIT PRICE EACH FOR REMOVE EXISTING HANDHOLE AND REMOVE EXISTING CONCRETE FOUNDATION.

C. THE CONTRACTOR SHALL REMOVE THE EXISTING ELECTRIC CABLES THAT RUN FROM THE EXISTING MAST ARM ON THE NORTHWEST QUADRANT OF GOODWIN AND SPRINGFIELD TO THE SCHOOL FLASHER ON THE NORTHEAST QUADRANT OF MATHEWS AND SPRINGFIELD AND THE EXISTING SECTIFIC CABLES FOR THE EXISTING SERVICE INSTALLATION. THE CABLES SHALL BE DISPOSED OF IN ACCORDANCE WITH THE CONTRACT DOCUMENTS. CABLE THAT IS REMOVED SHALL NOT BE REUSED. THE REMAINING CABLES AT THE INTERSECTION SHALL BE ABANDONED IN PLACE UNLESS OTHERWISE DIRECTED BY THE ENGINEER. THIS WORK WILL NOT BE PAID FOR SEPARATELY, BUT SHALL BE INLICUEDE IN THE CONTRACT LUMP SUM PRICE OF REMOVE ELECTRIC CABLE FROM CONDUIT (SPECIAL), AND NO ADDITIONAL COMPENSATION WILL BE ALLOWED.

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SPRINGFIELD AVE.

**_2** 

STATE OF ILLINOIS
DEPARTMENT OF TRANSPORTATION

TEMPORARY PHASE DESIGNATION

DIAGRAM LEGEND

* VEHICULAR PHASE


* NUMBER REFERS TO ASSOCIATED PHASE


EXIZIING B'O'M'


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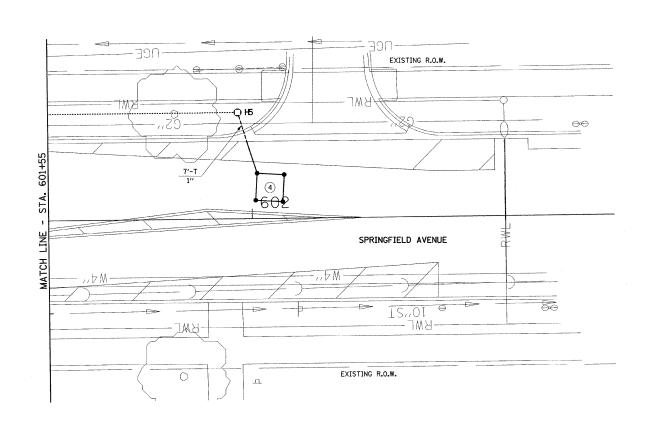
GOODWIN AVENUE & SPRINGFIELD AVENUE
TRAFFIC SIGNAL PLANS
TEMPORARY TRAFFIC SIGNAL PLAN
SCALE: 1"=20" | SHEET NO. 57 OF 75 SHEETS | STA. TO STA.

F.A.U. RTE.	SECT	TION	COUNTY	TOTAL SHEETS	SHEE NO.	
7175	07-0045	6-00-RS	CHAMPAIGN	75	57	
	GOODWIN AV	ENUE	CONTRACT	NO. 91	1392	
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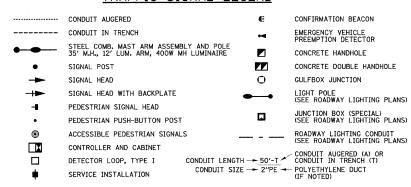




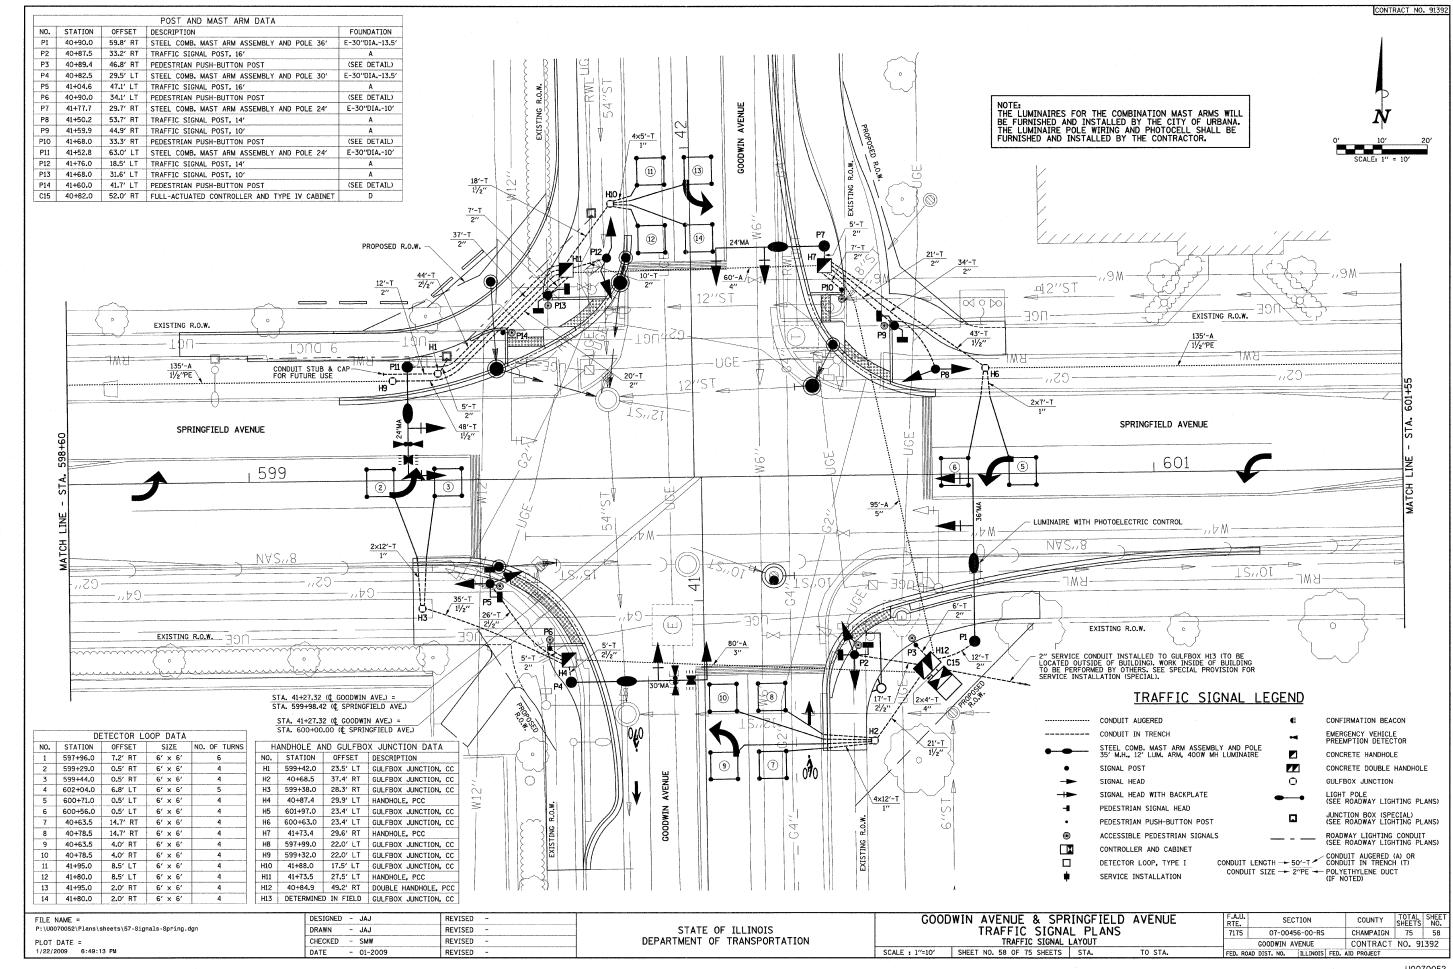

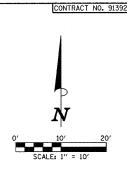
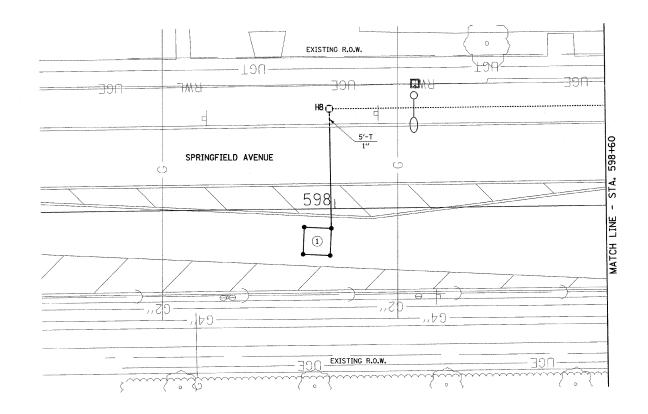
#### TRAFFIC SIGNAL LEGEND




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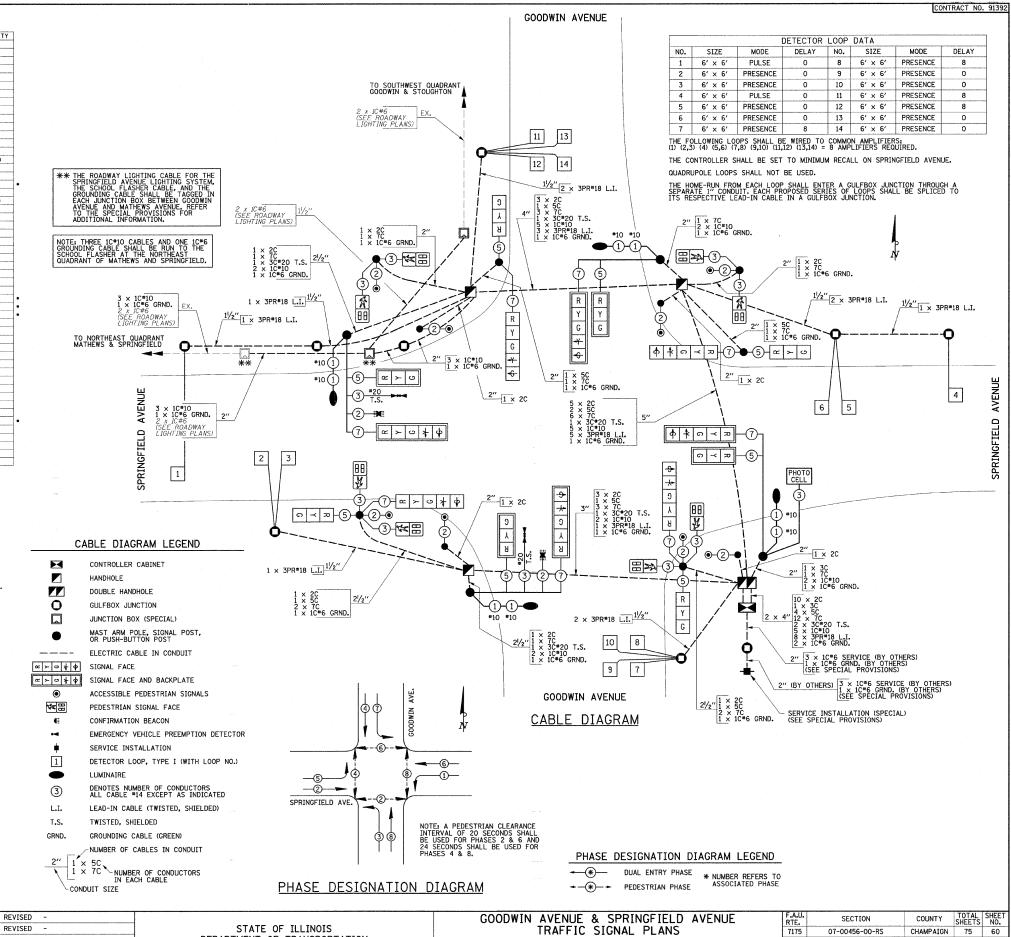
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DATE	-	01-2009	REVISED	-


STATE OF ILLINOIS DEPARTMENT OF TRANSPORTATION


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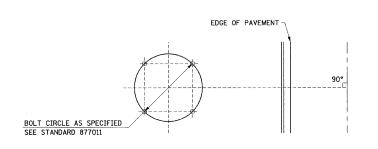


- 1. THE ACTUAL LOCATIONS OF ALL SIGNAL FOUNDATIONS, HANDHOLES, AND THE TRAFFIC SIGNAL CONTROLLER WILL BE VERIFIED IN THE FIELD BY THE ENGINEER.
- POST MOUNTED SIGNAL HEADS SHALL BE INSTALLED SUCH THAT NO PART OF THE SIGNAL HE IS WITHIN TWO (2) FEET OF THE FACE OF CURB. MAST ARM POLES SHALL BE PLACED SUCH THAT A MINIMUM DISTANCE OF SIX (6) FEET IS MAINTAINED BETWEEN THE CENTER OF THE POLE AND THE FACE OF CURB (ON THE MAST ARM SIDE).
- 3. COMBINATION MAST ARM ASSEMBLIES SHALL BE FURNISHED WITH 12-FOOT LUMINAIRE ARMS WITH A MOUNTED LUMINAIRE HEIGHT OF 35 FEET.
- 4. ALL MAST ARM MOUNTED SIGNAL HEADS ON AN INDIVIDUAL MAST ARM SHALL BE MOUNTED SO THAT THE RED INDICATIONS ARE LEVEL WITH EACH OTHER UNLESS OTHERWISE DIRECTED BY THE ENGINEER.
- 5. 12" LENSES SHALL BE USED ON ALL SIGNAL FACES, LED INDICATIONS SHALL BE USED ON ALL SIGNAL HEADS AND PEDESTRIAN SIGNAL HEADS, PEDESTRIAN SIGNAL HEAD FACES SHALL BE SYMBOLS WITH COUNTDOWN TIMERS.
- 6. ACCESSIBLE PEDESTRIAN SIGNALS SHALL BE THE POLARA "NAVIGATOR" SYSTEM OR APPROVED FOLITVALENT.
- 7. THE LUMINAIRE ARM, LUMINAIRE POLE WIRING, LUMINAIRE, AND PHOTOCELL SHALL BE ERECTED WITH THE TRAFFIC SIGNAL MAST ARM POLE. THE LUMINAIRE SHALL BE FURNISHED AND INSTALLED BY THE CITY OF THE HOTOCELL ON THE LUMINAIRE FOR THE SOUTHEAST QUADRANT COMBINATION MAST ARM ASSEMBLY AND POLE.
- 8. THE CONTRACTOR SHALL VERIFY THE EXACT LOCATION OF ALL UNDERGROUND UTILITIES PRIOR TO BEGINNING CONSTRUCTION.
- 9. THE CONTRACTOR SHALL BE RESPONSIBLE FOR THE COST OF UNCOVERING OR HAND DIGGING AROUND UTILITIES AS NECESSARY, AND NO ADDITIONAL COMPENSATION WILL BE ALLOWED.
- 10. NO ADDITIONAL COMPENSATION WILL BE ALLOWED FOR PLACING CONDUIT AT GREATER THAN 2 FOOT DEPTH TO AVOID OBSTACLES SUCH AS UNDERGROUND UTILITIES.
- 11. A 1/4" POLYPROPYLENE PULL ROPE SHALL BE INSTALLED IN ALL CONDUIT RUNS EXCEEDING 20 FEET. A MINIMUM OF 2 FEET OF ROPE SHALL BE PROVIDED AT EACH END OF A CONDUIT RUN THE ROPE SHALL BE INCLUDED IN THE COST OF THE RESPE
- 12. THE CONTRACTOR SHALL COOPERATE WITH THE UNIVERSITY OF ILLINOIS OPERATIONS STAFF IN ARRANGING FOR THE ELECTRICAL SERVICE FOR THE TRAFFIC SIGNALS AND COMBINATION MAST ARM LIGHTING. ALL CITY OF URBANA AND UNIVERSITY OF ILLINOIS REQUIREMENTS AND OTHER CODES FOR CONNECTING POWER TO THE CONTROLLER SHALL BE ADHERED TO COMPLETELY.
- 13. THE TRAFFIC SIGNAL CONTROLLER SHALL BE ORIENTED SUCH THAT INTERSECTION OPERATION AND CONTROLLER COMPONENTS CAN BE VIEWED SIMULTANEOUSLY.
- 14. CONTROLLER PROGRAMMING OF SIGNAL TIMING WILL BE PROVIDED BY THE CITY OF URBANA.
- 15. THE CONFIRMATION BEACON SHALL BE INCLUDED IN THE COST OF THE LIGHT DETECTOR.
- 16. THE ELECTRIC CABLE FOR THE LIGHT DETECTOR SHALL BE A CONTINUOUS UNBROKEN RUN FROM THE LIGHT DETECTOR AMPLIFIER. SPLICES IN THE CABLE SHALL NOT BE ALLOWED.
- 17. THE THREE SECTION AND FIVE SECTION SIGNAL HEADS THAT OPERATE TOGETHER IN THE SAME PHASE AT THE SAME LOCATION WILL BE COMBINED ON A SINGLE SEVEN CONDUCTOR CABLE. TWO PEDESTRIAN SIGNAL HEADS AT THE SAME LOCATION WILL BE COMBINED ON A SINGLE SEVEN CONDUCTOR CABLE. SPLICES WILL BE MADE AT THE POLE HANDHOLE WITH INDIVIDUAL CABLES RUNNING FROM THE SPLICE TO EACH SIGNAL HEAD OR PEDESTRIAN SIGNAL HEAD.
- 18. THE CONCRETE FOUNDATION FOR THE PEDESTRIAN PUSH-BUTTON POST SHALL BE INCLUDED IN THE COST OF THE PEDESTRIAN PUSH-BUTTON POST.
- 19. DETECTOR LOOPS SHALL BE INSTALLED PRIOR TO CONSTRUCTION OF THE HMA SURFACE COURSE.

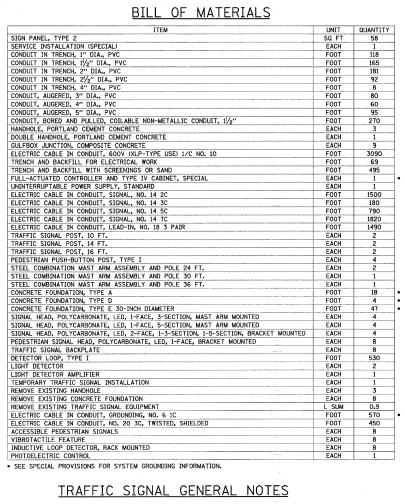




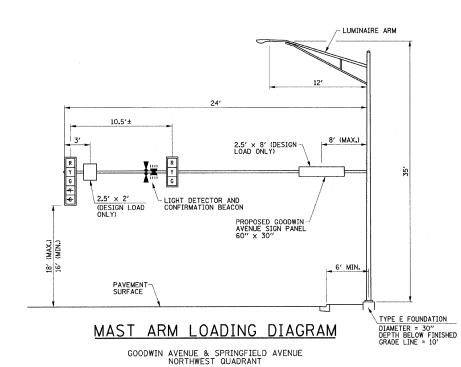


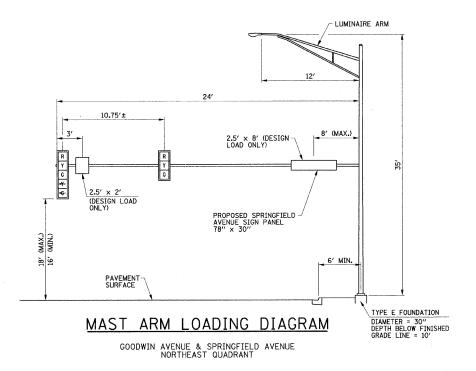


#### MAST ARM FOUNDATION BOLT PATTERN DETAIL

ORIENTATION OF ANCHOR BOLTS TO BE FIELD VERIFIED

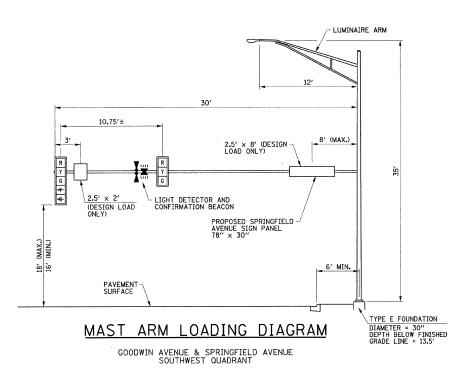

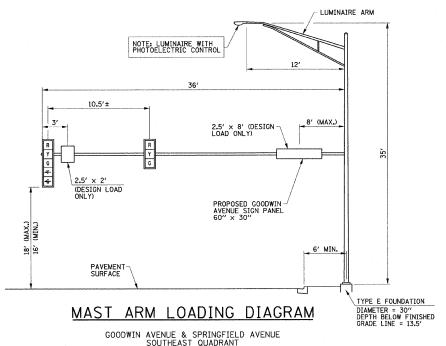

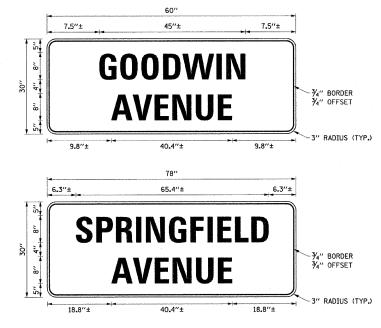


#### MAST ARM MOUNTED STREET NAME SIGN DETAIL

TEXT: 8" HEIGHT, SERIES D
TYPE A SHEETING REQUIRED
BORDER AND LEGEND:
3M DIAMOND GRADE VIP 3990 WHITE
BACKGROUND
EC SERIES 1170 GREEN TRANSLUCENT (REVERSE IMAGE)


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STATE OF ILLINOIS
DEPARTMENT OF TRANSPORTATION

	PRINGFIELD AVENUE	F.A.U. RTE.	SECTION	COUNTY	TOTAL SHEETS	SHEET NO.
TRAFFIC SIG	IAL PLANS	7175	07-00456-00-RS	CHAMPAIGN	75	61
TRAFFIC SIGNA		GOODWIN AVENUE	CONTRACT	NO. 91	1392	
SCALE : NONE   SHEET NO. 61 OF 75 SHEET	STA. TO STA.	FED. RO	AD DIST. NO.   ILLINOIS   FED.	AID PROJECT		

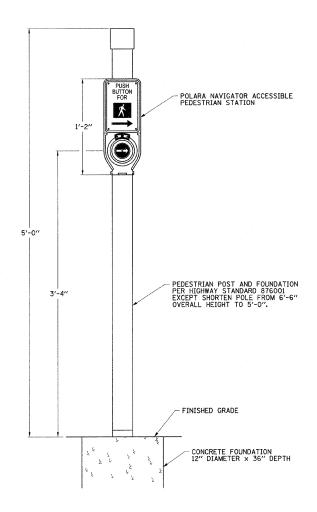

PEDESTRIAN PUSH-BUTTON
POST DETAIL

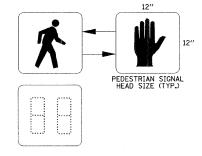

PEDESTRIAN COUNTDOWN SIGNAL DISPLAY DETAIL







MUTCD R10-4B

THE PEDESTRIAN PUSH-BUTTON SIGNS SHALL BE INCLUDED IN THE COST OF THE ACCESSIBLE PEDESTRIAN SIGNALS.

# PEDESTRIAN PUSH-BUTTON SIGN DETAIL

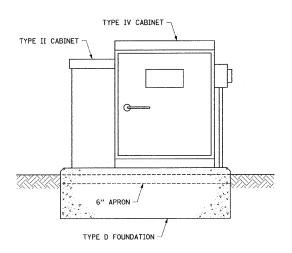

UPS BATTERY CABINET MOUNTING DETAIL

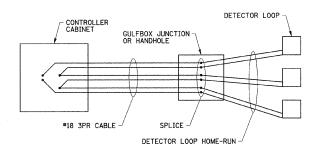

#### DETECTOR LOOP WIRING DETAIL


WIRED IN SERIES WITH MULTI-PAIR CABLE

FILE NAME =	DESIGNED - JAJ	REVISED -
p:\u0070052\plans\sheets\57-Signals-Spring.dgn	DRAWN - JAJ	REVISED -
PLOT DATE =	CHECKED - SMW	REVISED -
1/12/2009 7:47:12 PM	DATE - 01-2009	REVISED -

STATE OF ILLINOIS DEPARTMENT OF TRANSPORTATION

GOOD	WIN AVENUE & SPI		AVENUE	F.A.U. RTE.	SECTION
	TRAFFIC SIGNA	AL PLANS		7175	07-00456-00-RS
	TRAFFIC SIGNAL	DETAILS	-		GOODWIN AVENUE
SCALE : NONE	SHEET NO. 62 OF 75 SHEETS	STA.	TO STA.	FED. ROA	AD DIST. NO.   ILLINOIS FE


COUNTY TOTAL SHEETS NO.
CHAMPAIGN 75 62

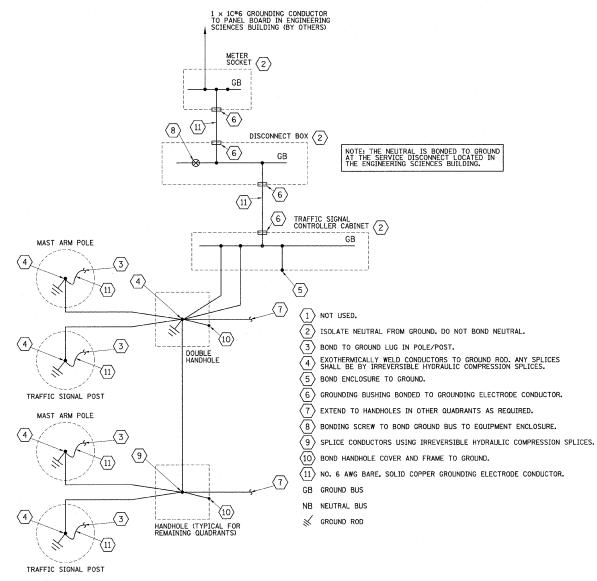

#### TRAFFIC SIGNAL GROUNDING DIAGRAM


ALL WIRES SHALL BE NO. 6 AWG STRANDED COPPER CONDUCTORS WITH XLP INSULATION UNLESS OTHERWISE INDICATED. THE INSULATION COLOR SHALL BE GREEN.

THE PROPOSED SERVICE SHALL BE A 120/240 VOLT, SINGLE PHASE, THREE WIRE SERVICE.

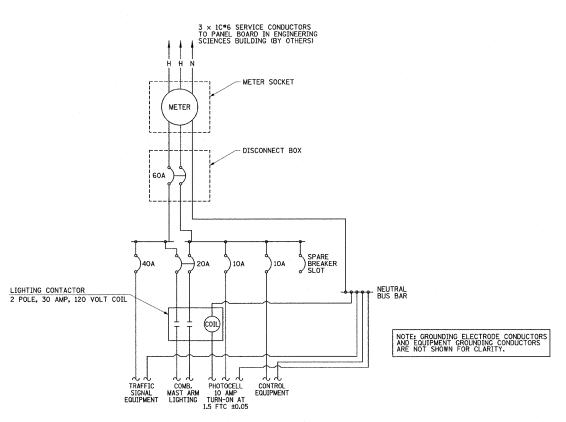

TRAFFIC SIGNAL CONTROLLER
INSTALLATION DIAGRAM

FILE NAME =	DESIGNED - JAJ	REVISED -		GOODWIN AVENUE & SPRINGFIELD AVENUE	F.A.U. SECTION	COUNTY TOTAL SHEET
p:\u0070052\plans\sheets\57-Signals-Spring.dgn	DRAWN - JAJ	REVISED -	STATE OF ILLINOIS	TRAFFIC SIGNAL PLANS	7175 07-00456-00-RS	CHAMPAIGN 75 63
PLOT DATE =	CHECKED - SMW	REVISED -	DEPARTMENT OF TRANSPORTATION	TRAFFIC SIGNAL DETAILS	GOODWIN AVENUE	CONTRACT NO. 91392
1/12/2009 7:47:13 PM	DATE - 01-2009	REVISED -		SCALE: NONE   SHEET NO. 63 OF 75 SHEETS   STA. TO STA.	FED. ROAD DIST, NO. ILLINOIS FED.	AID PROJECT

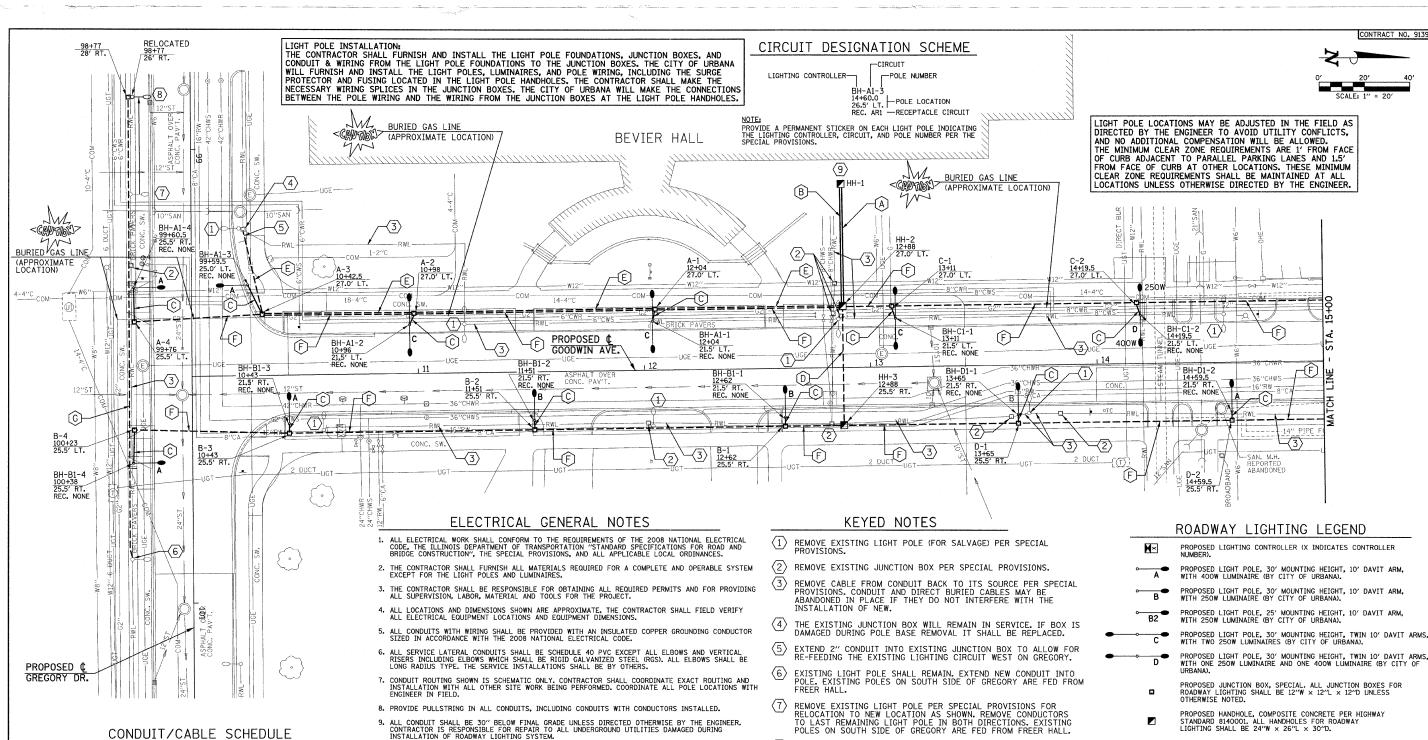

- (1) 2" PVC CONDUIT WITH 8-#10, 4-#10 GND (4 CIRCUITS).
- (1) 2" PVC CONDUIT WITH 2-#6, 1-#6 GND (1 CIRCUIT).
- (1) 1 1/4" PVC CONDUIT WITH 2-#10, 1-#10 GND (1 CIRCUIT),
- (1) 2" CONDUIT WITH 4-#10, 2-#10 GND (2 CIRCUITS).
- (1) 2" CONDUIT WITH 2-#6, 1-#6 GND (1 CIRCUIT).
- (1) 1 1/2" CONDUIT WITH 2-#10, 1-#10 GND (1 CIRCUIT).
- (1) 2" CONDUIT WITH 2-#6, 1-#6 GND (1 CIRCUIT).

- 10. GROUND RODS SHALL BE 3/4" DIA. X 10'-0" LONG COPPER CLAD STEEL. GROUNDING ELECTRODE CONDUCTORS SHALL BE 96 SOLID COPPER AND SHALL BE EXOTHERMICALLY WELDED TO GROUNDING ELECTRODE. GROUND ROD SHALL BE INSTALLED ONLY AT CONCRETE POLE FOUNDATIONS AND LIGHTING
- 11. THE ELECTRIC CABLE FOR THE EXISTING ROADWAY LIGHTING SYSTEM SHALL BE REMOVED AT THE LOCATIONS SHOWN ON THE PLANS OR AS DIRECTED BY THE ENGINEER. THE ELECTRIC CABLE THAT IS REMOVED SHALL NOT BE REUSED. REFER TO THE SPECIAL PROVISION FOR "REMOVE EXISTING CABLE" FOR ADDITIONAL INFORMATION.
- 12. THE CONTRACTOR SHALL USE CARE IN INSTALLING THE STEEL FOUNDATIONS FOR THE STREET LIGHTS THAT ARE NEAR TRENCH EXCAVATIONS FOR STORM SEWERS. THE CONTROLLED LOW-STRENGTH MATERIAL SHALL BE BLOCKED OUT AT THE FOUNDATION LOCATIONS TO ALLOW FOR THEIR LATER CONSTRUCTION.
- 13. THE AUGERED CONDUITS MAY BE CONSTRUCTED IN TRENCHES PRIOR TO CONSTRUCTING PAVEMENTS WITH THE APPROVAL OF THE ENGINEER, THE CONDUITS WILL THEN BE PAID FOR AS CONDUIT IN TRENCH, OF THE SIZE SPECIFIED, ALONG WITH TRENCH AND BACKFILL WITH SCREENINGS OR SAND.
- 14. EXISTING LIGHTING CONTROLLERS, OWNED BY THE CITY AND UNIVERSITY, SHALL BE DE-ENERGIZED BY THE OWNERS UPON PRIOR NOTICE BY THE CONTRACTOR PER THE SPECIAL PROVISIONS. EXISTING CONTROLLER REMOVAL SHALL BE BY THEIR RESPECTIVE OWNERS.
- EXPOSE EXISTING CONDUIT TO THE WEST AND REMOVE ENOUGH TO EXPOSE EXISTING CONDUIT TO THE WEST AND REMOVE ENOUGH TO ALLOW FOR THE REINSTALLATION OF THE POLE. INSTALL NEW JUNCTION BOX AND EXTEND CONDUIT INTO JUNCTION BOX. REINSTALL LIGHT POLE AND INSTALL NEW WIRE (OF SAME TYPE AND SIZE AS WAS REMOVED) FROM LAST REMAINING POLES TO THE EAST AND WEST. RESTORE FINISHED GRADE TO MATCH SURROUNDING AREA. EXISTING POLES ON SOUTH SIDE OF GREGORY ARE FED FROM FREEFE HAI! ARE FED FROM FREER HALL.
- LIGHTING SHALL BE FED FROM CONTROLLER BH (PROVIDED BY THE UNIVERSITY) INSIDE BEVIER HALL. THE CONTRACTOR SHALL STUB CONDUIT INTO HANDHOLE HH-1 10 FEET FROM BUILDING, THE UNIVERSITY SHALL PROVIDE CONDUIT AND THE CONDUCTORS FROM HH-1 INTO THE BUILDING TO THE CONTROLLER. THE UNIVERSITY SHALL PROVIDE (4) 20 AMP, 240V CIRCUITS FOR NEW LIGHTING AND CIRCUIT(S) AS REQUIRED TO REFEED THE EXISTING LIGHTING ON WEST GREGORY, THE UNIVERSITY SHALL PROVIDE ALL NECESSARY CONTROLLER EQUIPMENT TO PROVIDE DUSK TO DAWN OPERATION OF ROADWAY LIGHTING. 9

- PROPOSED LIGHTING CONTROLLER (X INDICATES CONTROLLER

- PROPOSED LIGHT POLE, 25' MOUNTING HEIGHT, 10' DAVIT ARM, WITH 250W LUMINAIRE (BY CITY OF URBANA).
- PROPOSED LIGHT POLE, 30' MOUNTING HEIGHT, TWIN 10' DAVIT ARMS WITH ONE 250W LUMINAIRE AND ONE 400W LUMINAIRE (BY CITY OF


- PROPOSED CONDUIT, BORED AND PULLED, COILABLE NON-METALLIC CONDUIT (SIZE AND QUANTITY AS NOTED).
  - PROPOSED CONDUIT, SCHEDULE 40 PVC (SIZE AND QUANTITY
- EXISTING LIGHT POLE.



PROFESSIONAL ENGINEER CLARK DIETZ, INC. FOR SHEETS 64-71 1/23/2009 DATE : LICENSE EXPIRES 11-30-09


I CERTIFY THAT TO THE BEST OF MY KNOWLEDGE, INFORMATION, AND BELIEF, THIS LIGHTING DESIGN IS VISUALLY ADEQUATE FOR THE ROADWAY CLASSIFICATION AND GEOMETRY SHOWN ON THE PLANS. THE DESIGN IS AN ECONOMICAL ONE AND COMPLES WITH REQUIREMENTS OF CHAPTER SE OF THE BDE MANUAL.

DESIGNED - MTP REVISED TOTAL SHEE NO. FILE NAME = COUNTY SECTION P:\U0070052\Plans\sheets\64-Lighting.dgr DRAWN REVISED STATE OF ILLINOIS ROADWAY LIGHTING PLAN CHAMPAIGN 75 64 CHECKED - JJF DEPARTMENT OF TRANSPORTATION REVISED PLOT DATE = GOODWIN AVENUE CONTRACT NO. 91392 DATE - 01-2009 REVISED SCALE : 1"=20' SHEET NO. 64 OF 75 SHEETS STA. 10+00 TO STA. 15+00

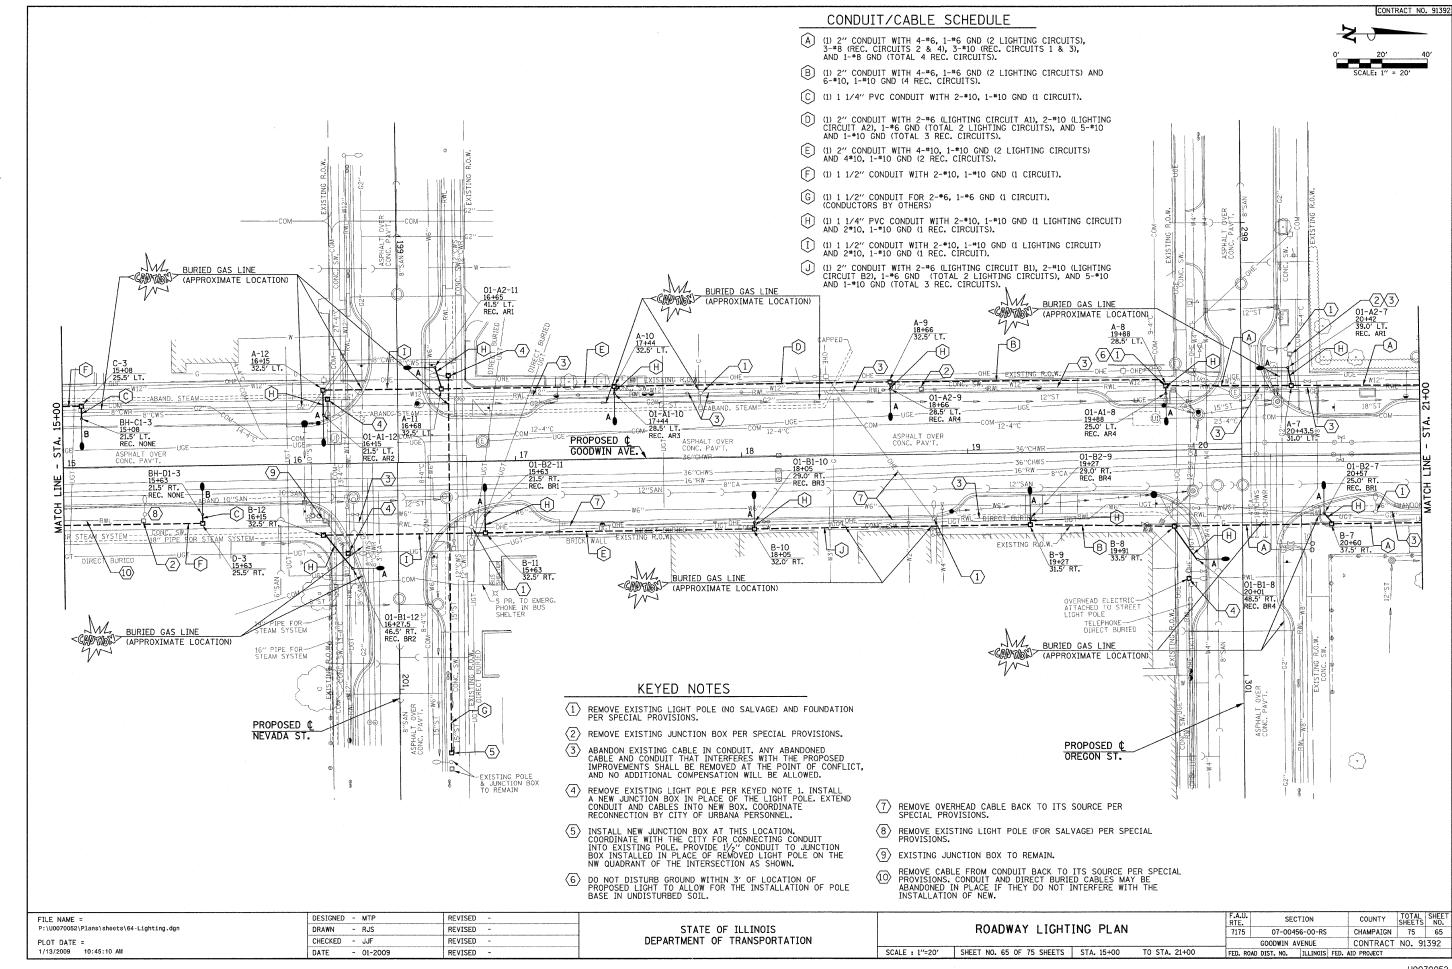

#### CONDUIT/CABLE SCHEDULE


- (1) 2" CONDUIT WITH 4-#6, 1-#6 GND (2 LIGHTING CIRCUITS) AND 6-#8, 1-#8 GND (4 REC. CIRCUITS).
- (1) 1 1/4" PVC CONDUIT WITH 2-#10, 1-#10 GND (1 LIGHTING CIRCUIT) AND 2#10, 1-#10 GND (1 REC. CIRCUITS).
- (1) 2" CONDUIT WITH 4-#6, 1-#6 GND (2 LIGHTING CIRCUITS), 3-#8 (REC. CIRCUITS 2 & 4), 3-#10 (REC. CIRCUITS 1 & 3), AND 1-#8 GND (TOTAL 4 REC. CIRCUITS).

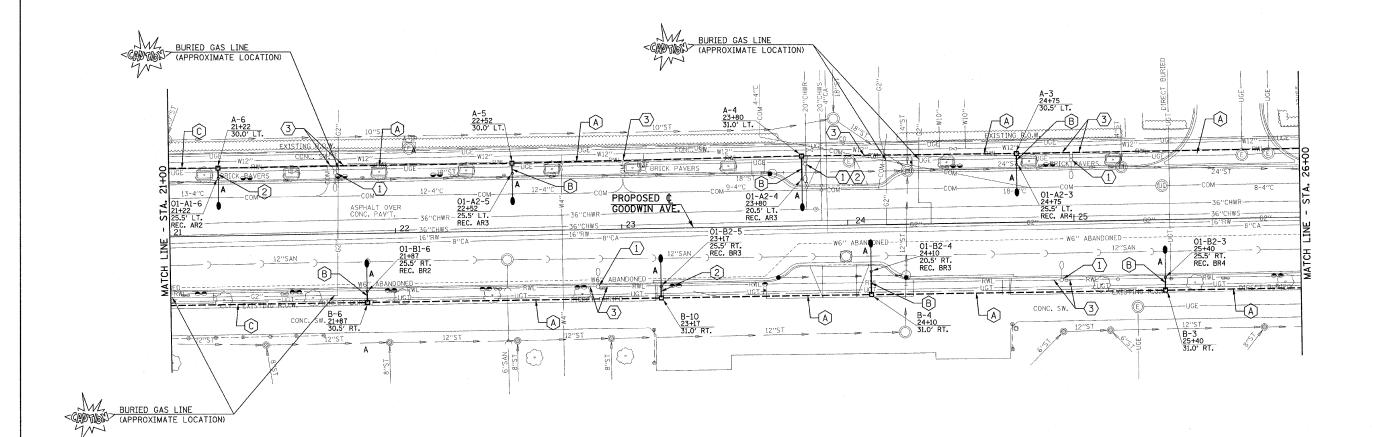



#### KEYED NOTES


- $\fbox{1}$  REMOVE EXISTING LIGHT POLE (NO SALVAGE) AND FOUNDATION PER SPECIAL PROVISIONS.
- ABANDON EXISTING CABLE IN CONDUIT. ANY ABANDONED CABLE AND CONDUIT THAT INTERFERES WITH THE PROPOSED IMPROVEMENTS SHALL BE REMOVED AT THE POINT OF CONFLICT, AND NO ADDITIONAL COMPENSATION WILL BE ALLOWED.

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FILE NAME =	DESIGNED - MTP	REVISED -			F.A.U. SECTION	COUNTY TOTAL SHEET NO.
P:\U0070052\Plans\sheets\64-Lighting.dgn	DRAWN - RJS	REVISED -	STATE OF ILLINOIS	ROADWAY LIGHTING PLAN	7175 07-00456-00-RS	CHAMPAIGN 75 66
PLOT DATE =	CHECKED - JJF	REVISED -	DEPARTMENT OF TRANSPORTATION		GOODWIN AVENUE	CONTRACT NO. 91392
1/13/2009 10:45:11 AM	DATE - 01-2000	DEVICED -		SCALE - 1"=20"   SHEET NO 66 OF 75 SHEETS   STA 21+00	CED DOAD DIST NO TILINOTS SED	ATO DOO SECT

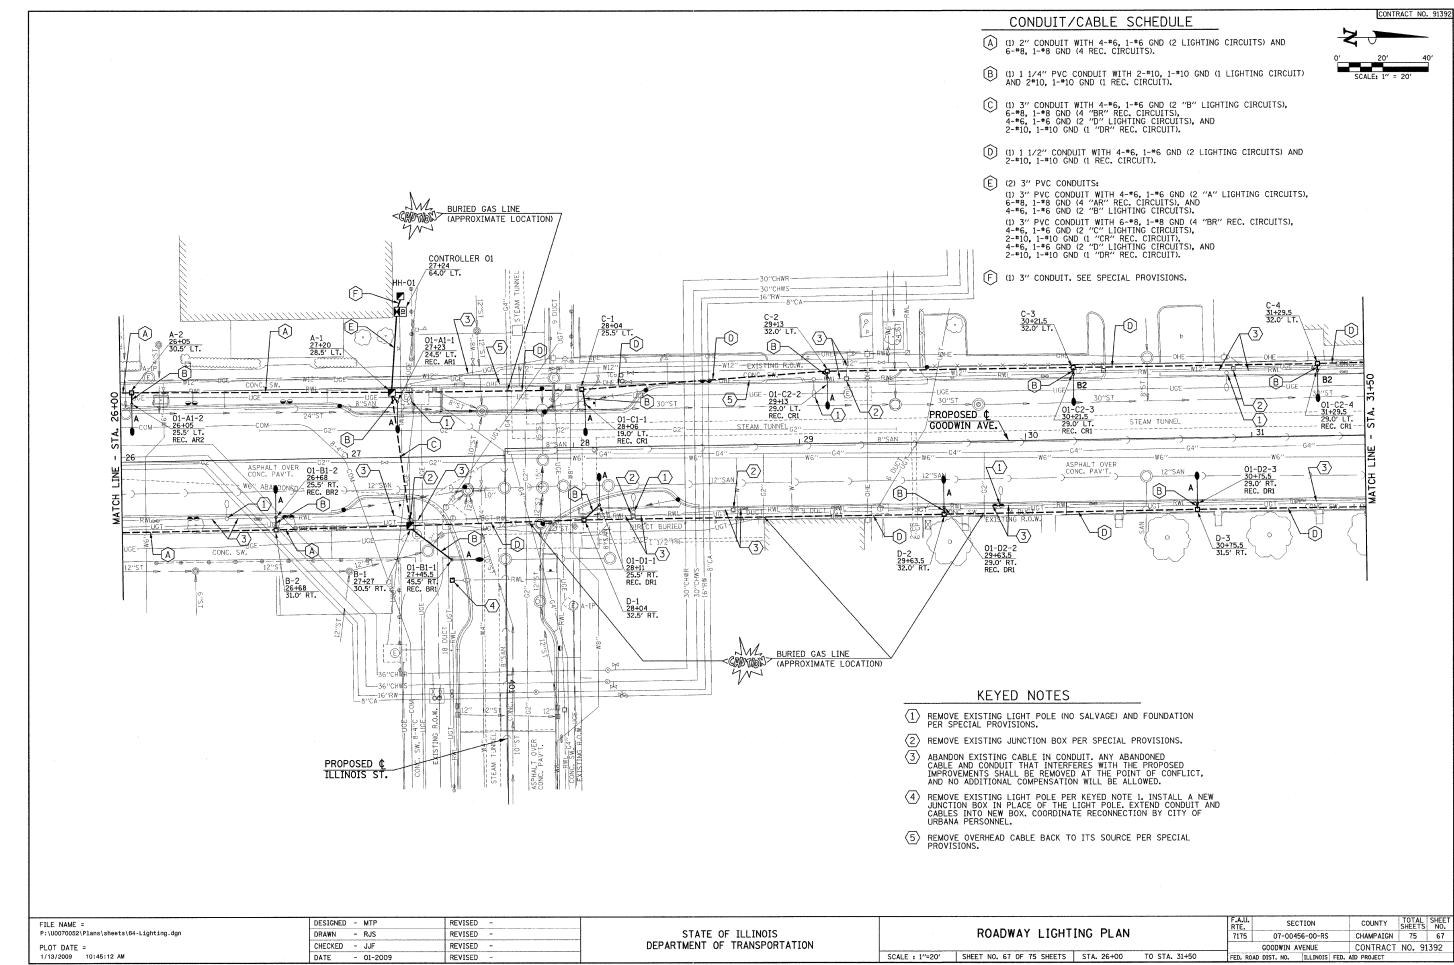


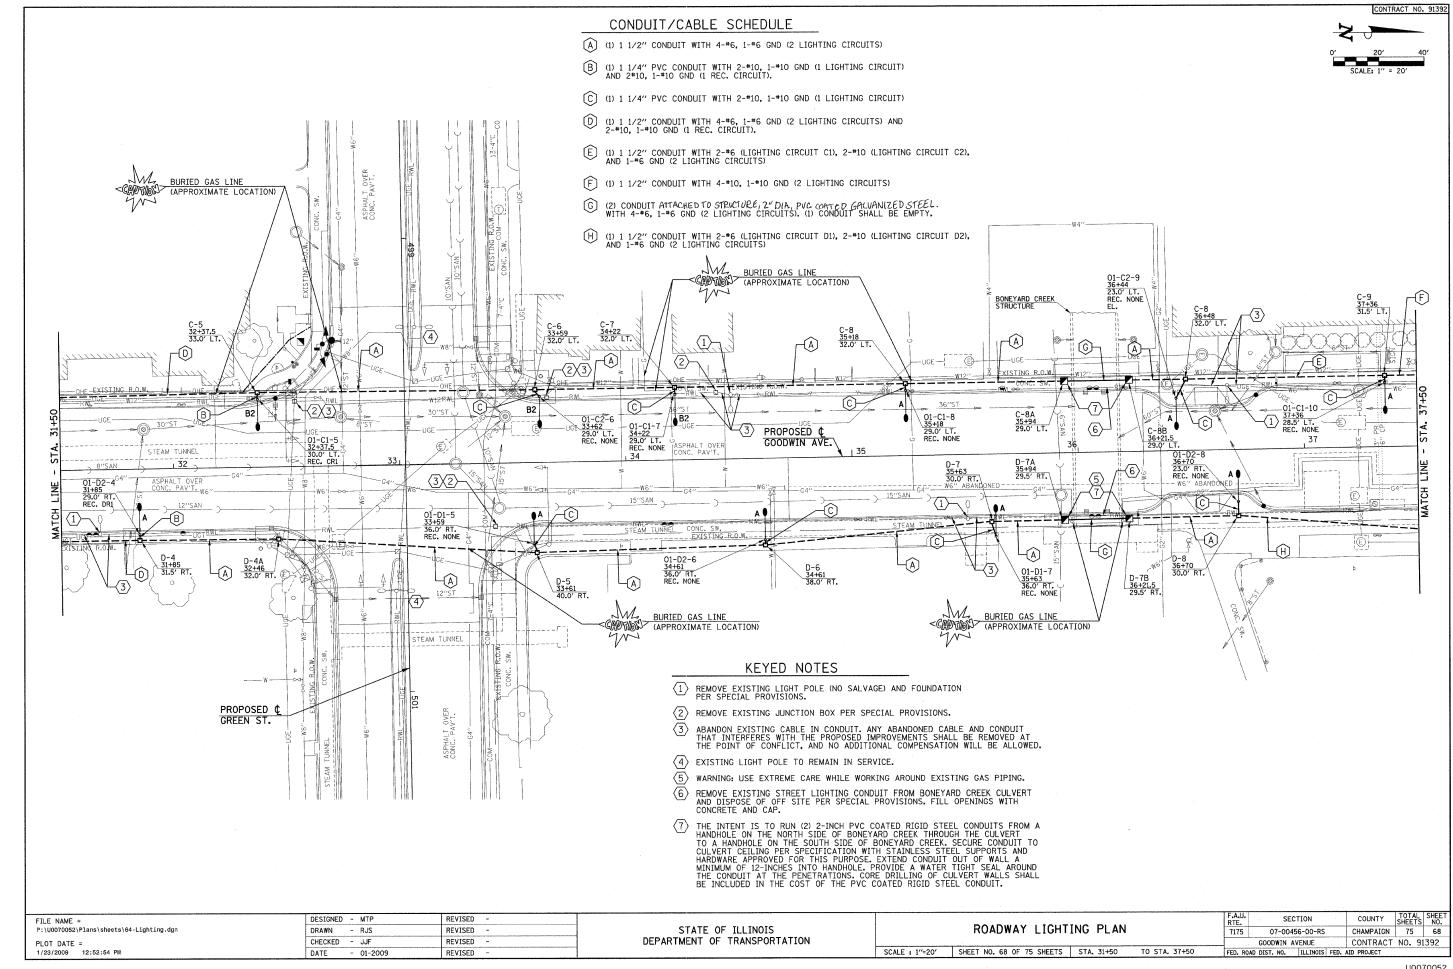

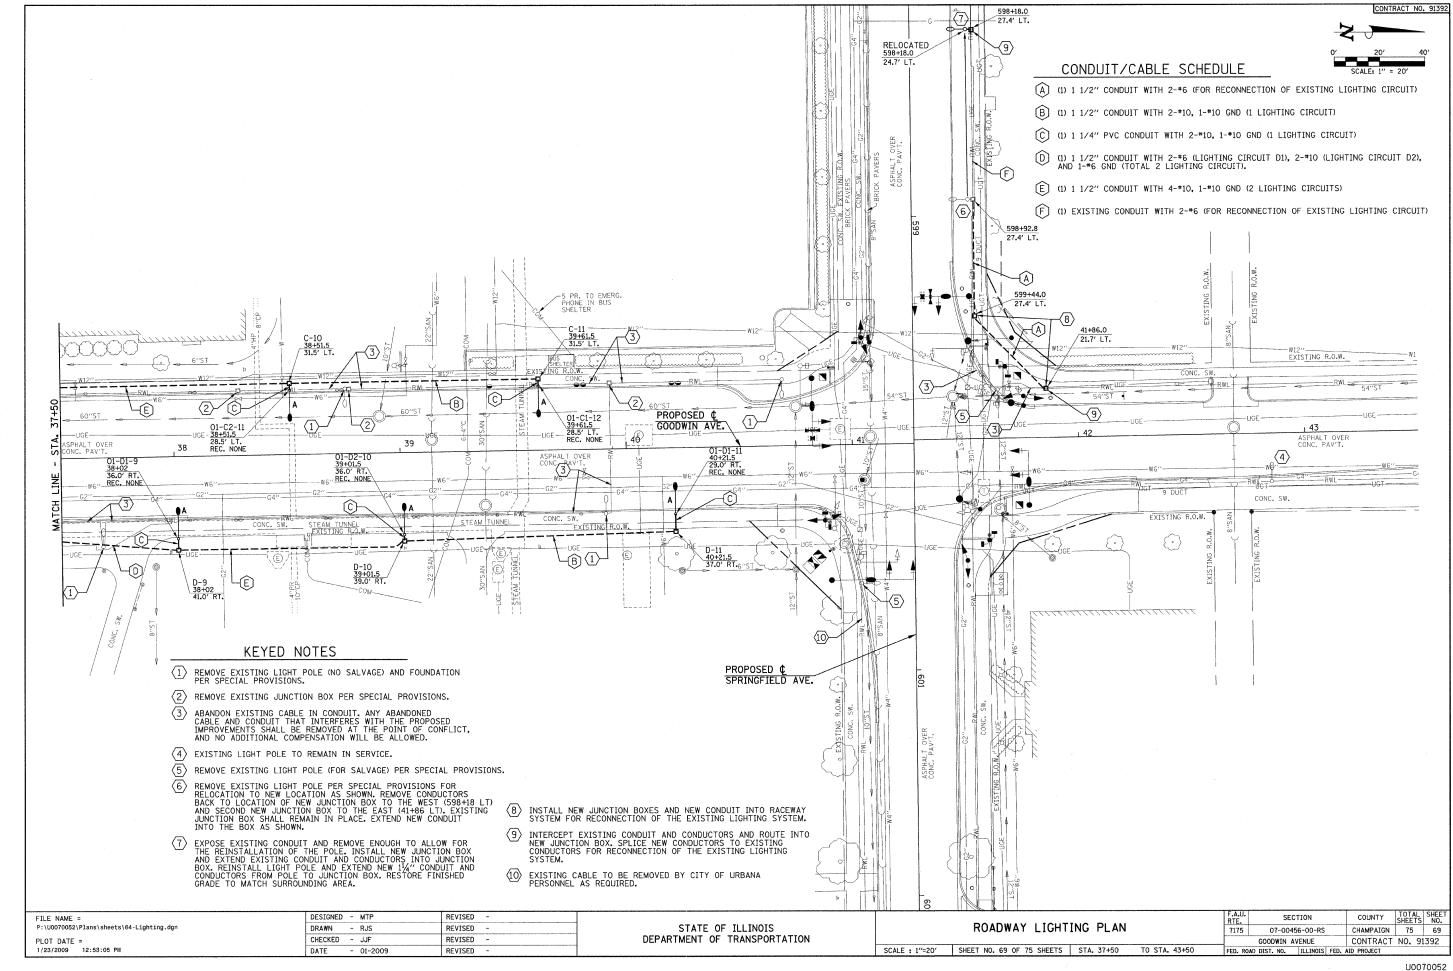

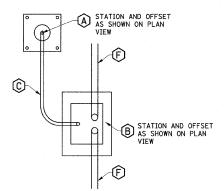

# FOUNDATION/HANDHOLE DETAIL NO SCALE

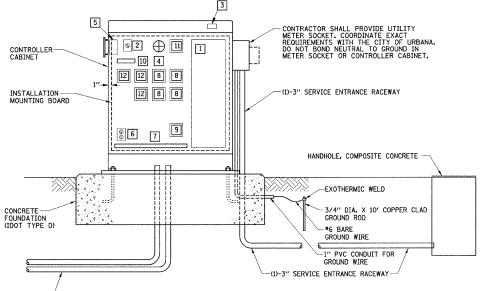


-PROVIDE (2) 3" PVC CONDUITS INTO CABINET FOR ROADWAY LIGHTING CONTROLLER: CONDUITS SHALL BE ROUTED TO HANDHOLE AS SHOWN ON THE PLANS.

# CONTROL CABINET, FOUNDATION AND DIAGRAMMATIC ASSEMBLY DETAIL LIGHTING CONTROLLER *01 NO SCALE

LIGH	ΓING	CONTROLLER #01 BILL OF MATERIALS
QTY	ITEM	DESCRIPTION
1	1	200A, 120/240V, 10, 42 CIRCUIT PANELBOARD (INTERIOR ONLY, NO PANEL TUB), QUANTITY OF BREAKERS AS SHOWN IN PANELBOARD SCHEDULE
1	2	HAND-OFF-AUTO SELECTOR SWITCH WITH LEGEND PLATE.
1	[3]	120 VAC, 20A, 1P PLUNGERTYPE SWITCH FOR CONTROLLER LIGHT, DOOR ACTIVATED
1	4	INCANDESCENT LIGHT FIXTURE WITH CLEAR GLOBE AND PROTECTIVE GUARD. PROVIDE 60WATT, 130VAC LAMP.
1	5	PHOTOCELL SWITCH WITH LOCKING TYPE RECEPTACLE AND INTEGRAL SURGE ARRESTORS. PHOTOCELL SHALL BE CABINET MOUNTED AND SHIELDED FROM SURROUNDING LIGHT SOURCES, WITH TIME DELAY RELAY TO PREVENT NUISANCE SWITCHING. (SEE PHOTOCELL DETAIL).
1	6	DUPLEX RECEPTACLE, 120VAC, 20A, GFCI TYPE.
1	7	TERMINAL STRIPS. QUANTITY AS REQUIRED FOR INCOMING WIRING PLUS 100% SPARE TERMINALS. PROVIDE SEPARATE TERMINAL STRIPS FOR POWER, NEUTRAL AND GROUND WIRING AS REQUIRED.
4	8	LIGHTING CONTACTOR, 30A, 240VAC, 4 POLE, 120VAC ELECTRICALLY HELD COIL. PROVIDE SPACE FOR ADDITIONAL CONTACTORS.
1	9	SURGE ARRESTOR
1	10	CONTROL WIRING TERMINAL BLOCK
1	11	ASTRONOMICAL TIME CLOCK WITH BATTERY MEMORY BACKUP TO CONTROL FESTOON RECEPTACLE "OFF" MODE (ON VIA PHOTOCELL)
3	12	RECEPTACLE CONTACTOR, 30A, 240VAC, 4 POLE, 120VAC ELECTRICALLY HELD COIL.

	SUMMARY OF ROADWAY LIGHTING	QUANT	TIES		
CODE NO.	ITEM	UNIT	QUANTITY	UNIVERSITY	CITY
80400105	ELECTRIC SERVICE INSTALLATION, SPECIAL	EACH	1		1
81012400	CONDUIT IN TRENCH, 11/4" DIA. PVC	FOOT	353	78	275
81012600	CONDUIT IN TRENCH, 2" DIA., PVC	FOOT	110	110	
81012800	CONDUIT IN TRENCH, 3" DIA., PVC	FOOT	72		72
81028050	CONDUIT, BORED AND PULLED, COILABLE NON-METALLIC CONDUIT, 1/2"	FOOT	4000	1125	2875
81028060	CONDUIT, BORED AND PULLED, COILABLE NON-METALLIC CONDUIT, 2"	FOOT	2707	592	2115
81028080	CONDUIT, BORED AND PULLED, COILABLE NON-METALLIC CONDUIT, 3"	FOOT	60		60
81306100	JUNCTION BOX, SPECIAL (12"W x 12"L x 12"D)	EACH	70	15	55
81306500	REMOVE EXISTING JUNCTION BOX	EACH	23	9	14
81400730	HANDHOLE, COMPOSITE CONCRETE	EACH	10	3	7
81702110	ELECTRIC CABLE IN CONDUIT, 600V (XLP-TYPE USE) 1/C NO. 10	FOOT	18519	5007	13512
81702120	ELECTRIC CABLE IN CONDUIT, 600V (XLP-TYPE USE) 1/C NO. 8	FOOT	10925		10925
81702130	ELECTRIC CABLE IN CONDUIT, 600V (XLP-TYPE USE) 1/C NO. 6	FOOT	22637	1737	20900
81900200	TRENCH AND BACKFILL FOR ELECTRICAL WORK	FOOT	91	55	36
81900302	TRENCH AND BACKFILL WITH SCREENINGS OR SAND	FOOT	353	78	275
83600400	POLE FOUNDATION, METAL	EACH	61	14	47
84200500	REMOVAL OF EXISTING LIGHTING UNIT, SALVAGE	EACH	10	8	2
84200600	REMOVAL OF EXISTING LIGHTING UNIT, NO SALVAGE	EACH	30		30
84200700	LIGHTING FOUNDATION REMOVAL	EACH	30		30
84400105	RELOCATE EXISTING LIGHTING UNIT	EACH	2	1	1
X0325815	REMOVE EXISTING CABLE	FOOT	1900	1900	
××001866	LIGHTING CONTROLLER, LOCATION NO. 1	L SUM	1		1
X8430100	REMOVE EXISTING CONDUIT ATTACHED TO STRUCTURE	FOOT	40		40
81100605	CONDUIT ATTACHED TO STRUCTURE 2" DIA., PVC COATED GALVANIZED STEEL	FOOT	100		100

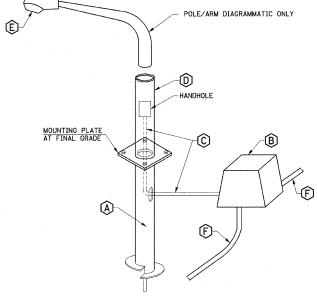

# POLE/LUMINAIRE INSTALLATION DETAIL

#### ELECTRICAL KEYNOTES


- A STEEL FOUNDATION 6' LONG, 6-5/8" DIAMETER WITH THREADED HOLES FOR 1" BOLTS OR STUDS. A.B. CHANCE SA112-0567 OR APPROVED EQUAL. COORDINATE BOLT CIRCLE DIAMETER WITH POLES BEING PROVIDED BY THE CITY OF URBANA.
- B CDR 12"W x 12"L x 12"D (UNLESS OTHERWISE INDICATED IN THE PLANS)
  FLARED WALL BOX WITH HEAVY DUTY COVER CAT. PA22-1212-12-0062 OR APPROVED EQUAL.
- (C) 11/4" SCHEDULE 40 PVC FROM JUNCTION BOX TO 6" ABOVE BASE WITH WIRING AS NOTED ON PLANS. THE CITY OF URBANA WILL FURNISH AND INSTALL A TWO POLE FUSEHOLDER WITH FUSES PER IDOT STANDARD SPECIFICATION 1065.01 AND A SURGE PROTECTOR AT THE LOAD SIDE OF THE FUSE HOLDER PER IDOT STANDARD SPECIFICATION 1065.02.
- D ALUMINUM LIGHT POLE FURNISHED AND INSTALLED BY THE CITY OF URBANA.
- E METAL HALIDE LUMINAIRE FURNISHED AND INSTALLED BY THE CITY OF URBANA.
- RACEWAY PER THE PLANS TO ADJACENT HANDHOLE OR 12" STUB FOR FUTURE EXTENSION OF LIGHTING CIRCUIT.


	CLEAR GLASS LENS, COVER, & NEOPRENE GASKET BETWEEN COVER & CABINET  1/8" X 6" X 8" ALUMINUM SHEET
LIGHT POLE (BY CITY OF URBANA)	PHOTOCELL (LOCATED INSIDE CONTROL CABINET)  3" HOLE IN SIDE OF CAST CABINET
VENTILATING SCREEN, STAINLESS STEEL, SEE SPECIAL PROVISIONS.  STEEL FOUNDATION	1/4" STAINLESS STEEL BOLTS WITH SELF-LOCKING NUTS.  1/4" STAINLESS STEEL BOLT WITH ALLUMINUM SLEEVE AS STANDOFF, USE SELF-LOCKING NUTS.
POLE/FOUNDATION DETAIL NO SCALE	PHOTOCELL DETAIL NO SCALE

FILE NAME =	DESIGNED - MTP	REVISED -
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STATE OF ILLINOIS
DEPARTMENT OF TRANSPORTATION

	DOLDWAY LOUTING DETAILS	F.A.U. RTE.	SEC.	TION	COUNTY	TOTAL	SHEET NO.
ı	ROADWAY LIGHTING DETAILS	7175	07-0045	6-00-RS	. CHAMPAIGN	75	70
			GOODWIN AV	/ENUE	CONTRACT	NO. 91	1392
	SCALE: NONE   SHEET NO. 70 OF 75 SHEETS   STA. 10+00 TO STA. 44+00	FED, RO	DAD DIST. NO.	ILLINOIS FED.	AID PROJECT		




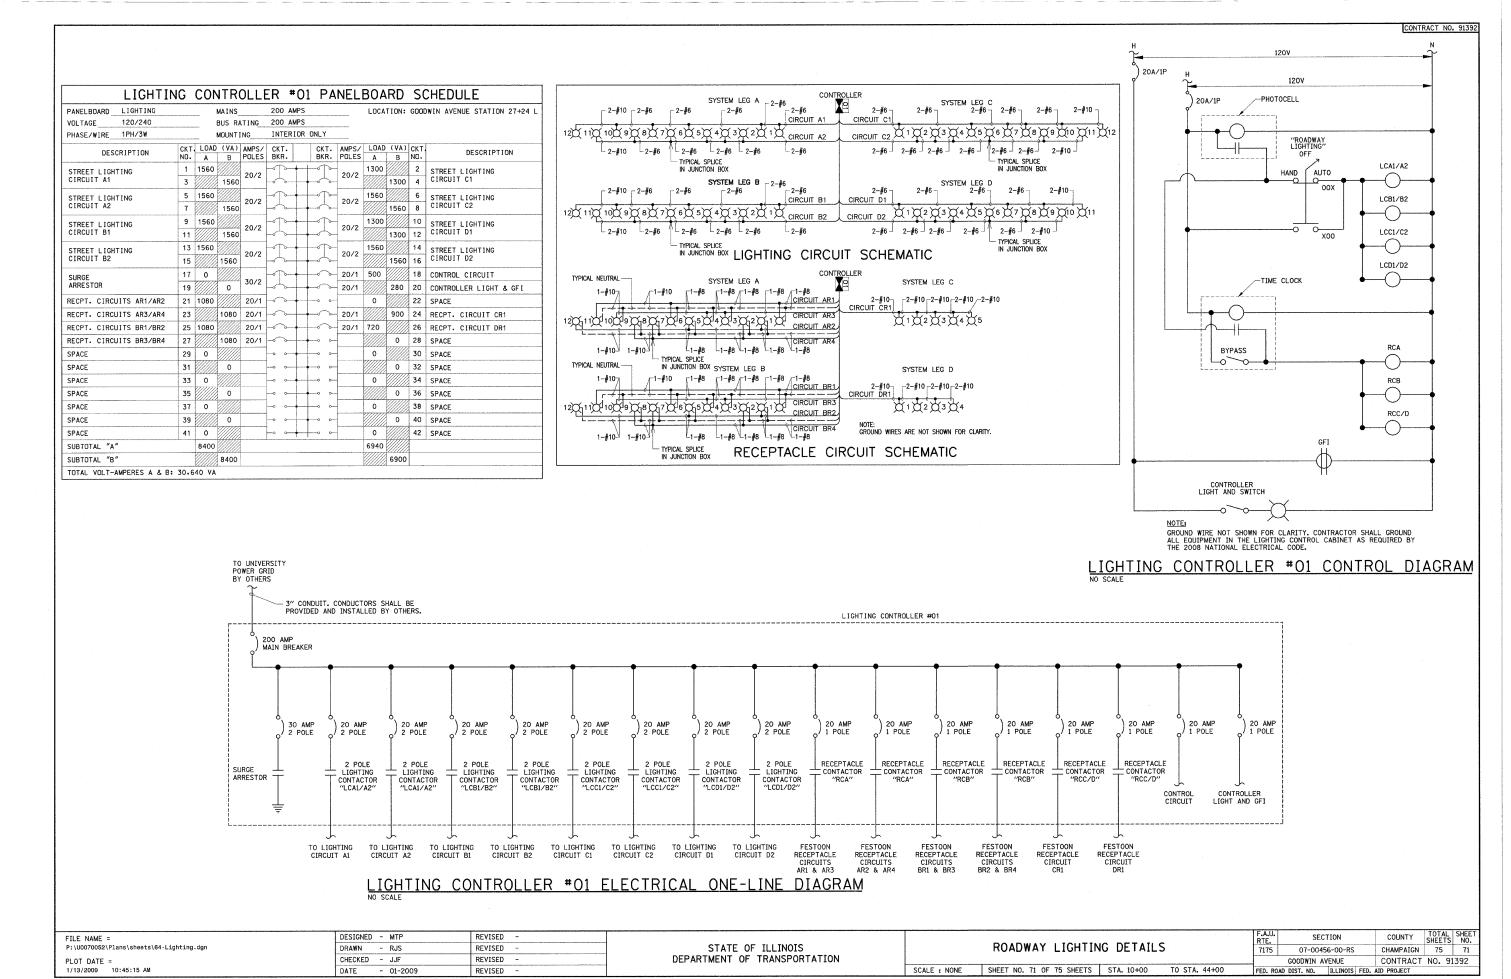
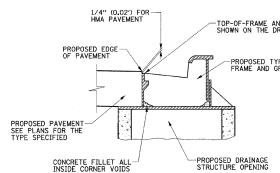
#### 1. SEE THE DRAINAGE PLANS FOR THE LOCATION AND ELEVATION OF THE FRAMES AND GRATES.

- 2. THIS DETAIL SHALL BE APPLICABLE FOR PROP. TYPE 11 FRAMES AND GRATES PLACED WITHIN COMBINATION CONCRETE CURB AND GUTTER, TYPE B-6.12 (SPECIAL).
- 3. THE TOP-OF-FRAME ELEVATIONS SHOWN ON THE DRAINAGE PLANS ARE 0.02' LOWER THAN THE ADJACENT PROPOSED EDGE OF PAVEMENT ELEVATIONS FOR HMA PAVEMENT.
- 4. SEE STANDARD 604051 FOR ADDITIONAL INFORMATION.


#### TYPE 11 FRAME AND GRATE DETAIL

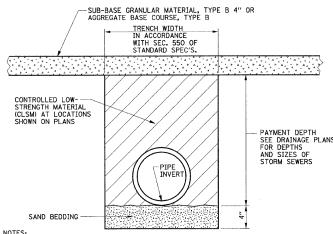

#### NOTES:

- 1. THE CLSM SHALL BE PLACED IN LIFTS AS DESCRIBED IN SECTION 593 OF THE STANDARD SPECIFICATIONS.
- THE APPLICABLE ARTICLES OF SECTION 550 OF THE STANDARD SPECIFICATIONS SHALL APPLY FOR EXCAVATION, BEDDING AND INSTALLATION OF STORM SEWERS.
- 3. THE SAND BEDDING SHALL BE CONSIDERED INCLUDED IN THE COST OF THE CLSM AND NO ADDITIONAL COMPENSATION WILL BE ALLOWED.
- 4. THE CLSM WILL BE PAID FOR IN ACCORDANCE WITH SECTION 593 OF THE STANDARD SPECIFICATIONS AND INCLUDES PAYMENT FOR THE MATERIAL TO THE TOP OF THE SAND BEDDING AS SHOWN ON THE DETAIL. THE QUANTITIES SHOWN ON THE PLANS ARE BASED ON A DEPTH MEASURED FROM THE TOP OF THE SAND BEDDING TO THE BOT LIMITS OF THE SUB-BASE GRANULAR MATERIAL OR THE AGGREGATE BASE COURSE.

#### CONTROLLED LOW-STRENGTH MATERIAL DETAIL

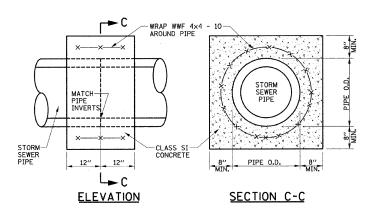


THE CONCRETE COLLARS SHALL BE UTILIZED WHERE CONNECTING STORM SEWERS OF DIFFERENT TYPES OR AS DIRECTED BY THE ENGINEER. THE COST OF CONSTRUCTING THE CONCRETE COLLARS WILL BE PAID FOR AT THE CONTRACT UNIT PRICE PER EACH FOR CONCRETE COLLAR.

#### CONCRETE COLLAR DETAIL


PROPOSED HOT-MIX ASPHALT PROPOSED P.C. CONCRETE BASE COURSE 8" PROPOSED SUBGRADE ELEVATION GRANULAR EMBANKMENT, SPECIAL GEOTECHNICAL FABRIC FOR GROUND-STABILIZATION


- 1. THIS WORK SHALL BE CONSTRUCTED AT LOCATIONS AS DIRECTED BY THE ENGINEER. SEE PROPOSED TYPICAL SECTION NOTE 14 FOR ADDITIONAL INFORMATION.
- 2. THE WORK SHALL BE IN ACCORDANCE WITH SECTION 210 OF THE STANDARD SPECIFICATIONS. THE GRANULAR EMBANKMENT, SPECIAL WILL BE PAID FOR AT THE CONTRACT UNIT PRICE PER TON. THE GEOTECHNICAL FABRIC FOR GROUND STABILIZATION WILL BE PAID FOR AT THE CONTRACT UNIT PRICE PER SQUARE YARD. THE EARTH REMOVAL BELOW THE PROPOSED SUBGRADE ELEVATION LINE WILL BE PAID FOR AS REMOVAL AND DISPOSAL OF UNSUITABLE MATERIAL.

#### SUBGRADE REMOVAL AND REPLACEMENT DETAIL

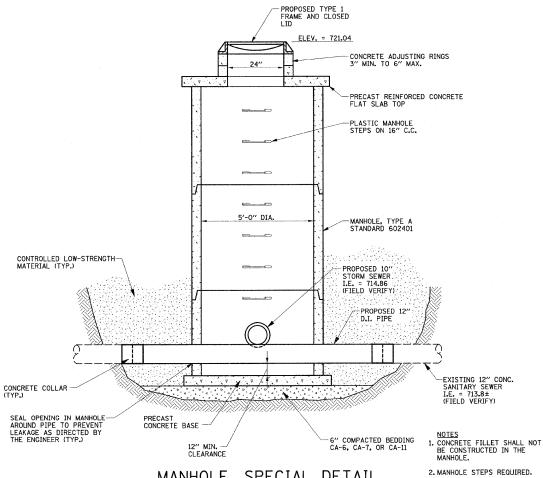

MANHOLE, SPECIAL DETAIL CONFLICT MANHOLE STA. 27+53.0, 14.5' RT.

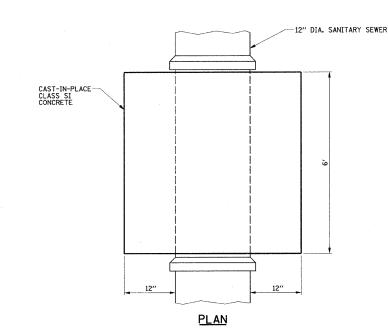


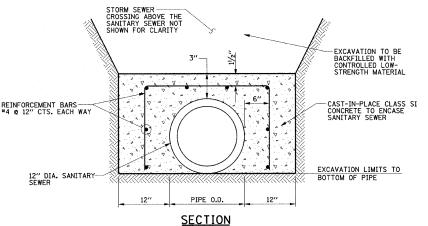

- 1. THE CONCRETE ENCASEMENT SHALL BE CONSTRUCTED PRIOR TO INSTALLING THE STORM SEWER PIPE TO PREVENT DAMAGE TO THE SANITARY SEWER.
- 2. THE COST OF CONSTRUCTING THE CONCRETE ENCASEMENT WILL BE PAID FOR AT THE CONTRACT UNIT PRICE EACH FOR CONCRETE ENCASEMENTS. THE WORK SHALL INCLUDE THE EXCAVATION, CONCRETE, AND REINFORCEMENT BARS. THE CONTROLLED LOW-STRENGTH MATERIAL WILL BE PAID FOR SEPARATELY.

#### CONCRETE ENCASEMENT DETAIL (FOR STORM SEWER AND SANITARY SEWER CROSSING) STA. 27+86, 17' RT.


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p:\u0070052\plans\sheets\72-MiscDetails.dgn	DRAWN - JRM	REVISED -		MISCELLANEOUS DETAILS	7175 07-00456-00-RS CHAMPAIGN 75 72	
PLOT DATE =	CHECKED - RLH	REVISED ~	DEPARTMENT OF TRANSPORTATION		GOODWIN AVENUE CONTRACT NO. 91392	
1/12/2009 7:47:23 PM	DATE - 01-2009	REVISED -		SCALE : NONE SHEET NO. 72 OF 75 SHEETS STA. TO STA.	FED. ROAD DIST. NO.   ILLINOIS   FED. AID PROJECT	

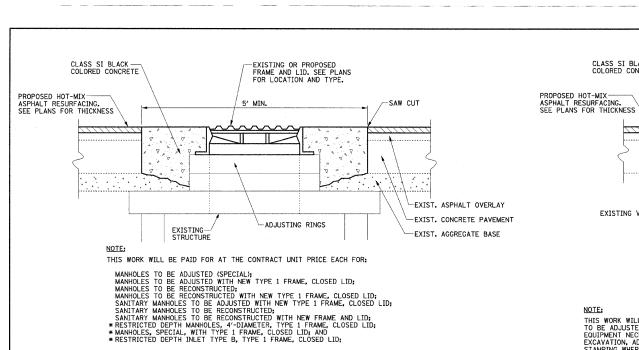


WHICH PRICE SHALL INCLUDE ALL LABOR, MATERIAL, AND EQUIPMENT NECESSARY TO COMPLETE THE WORK, INCLUDING PAVEMENT REMOVAL, EXCAVATION, ADJUSTING RINGS, AND CLASS SI BLACK COLORED CONCRETE.

*SEE DETAIL A


#### FRAME AND LID ADJUSTING DETAIL INSIDE PAVEMENT AREA

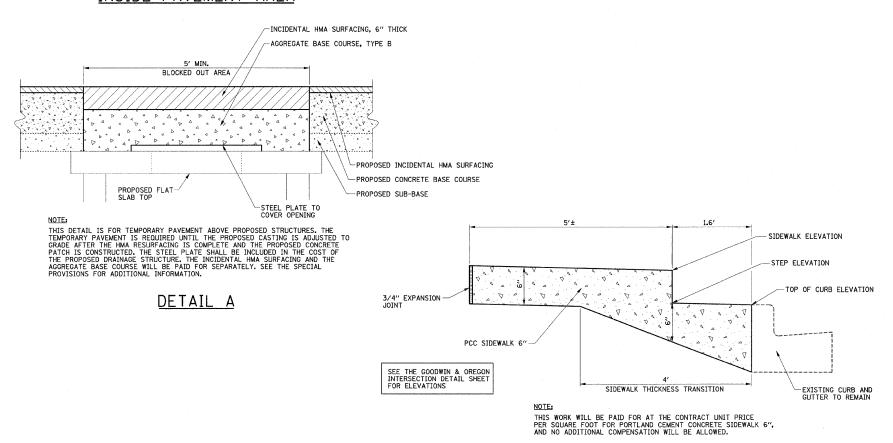

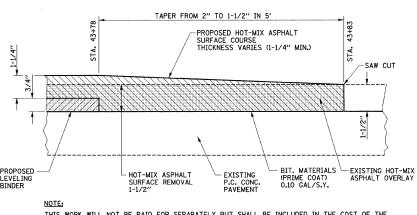

THIS WORK WILL NOT BE PAID FOR SEPARATELY BUT SHALL BE INCLUDED IN THE COST OF THE HOT-MIX ASPHALT SURFACE COURSE AND NO ADDITIONAL COMPENSATION WILL BE ALLOWED. AT OTHER LOCATIONS WHERE THE PROPOSED HMA SURFACE MATCHES THE EXISTING SURFACE, THE CONTRACTOR SHALL TRANSITION THE 1/4" ELEVATION DIFFERENCE OVER 2'.

#### HOT-MIX ASPHALT BUTT-JOINT DETAIL STA. 43+78 TO STA. 43+83

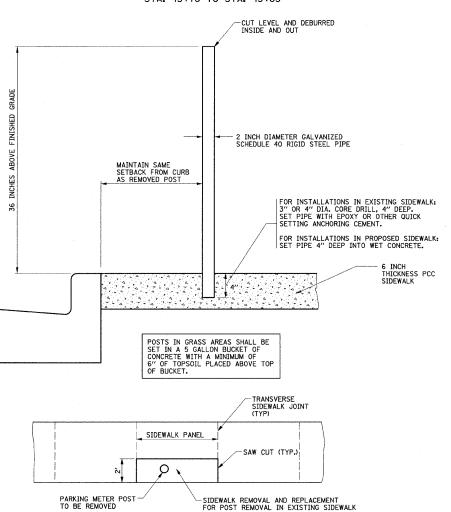

THIS WORK WILL BE PAID FOR AT THE CONTRACT UNIT PRICE EACH FOR FURNISHING AND SETTING STEEL POSTS, WHICH PRICE SHALL INCLUDE ALL LABOR, MATERIAL, AND EQUIPMENT NECESSARY TO COMPLETE THE WORK, INCLUDING CORE DRILLING AND BUCKETS OF CONCRETE. SIDEWALK REMOVAL AND P.C. CONC. SIDEWALK 6" WILL BE PAID FOR SEPARATELY.

#### PARKING METER POST INSTALLATION

FILE NAME =	DESIGNED - JAJ	REVISED ~		WOOD AND DETAILS		COUNTY TOTAL SHEET NO.
p:\u0070052\plans\sheets\72-MiscDetails.dgn	DRAWN - JRM	REVISED -	STATE OF ILLINOIS	MISCELLANEOUS DETAILS	7175 07-00456-00-RS	CHAMPAIGN 75 73
PLOT DATE =	CHECKED - RLH	REVISED -	DEPARTMENT OF TRANSPORTATION			CONTRACT NO. 91392
1/23/2009 11:12:25 AM	DATE - 01-2009	REVISED -		SCALE : NONE   SHEET NO. 73 OF 75 SHEETS   STA. TO STA.	FED. ROAD DIST. NO. ILLINOIS FED.	AID PROJECT

CONCRETE STEP DETAIL

-EXISTING UTILITY CAST IRON LID

THIS WORK WILL BE PAID FOR AT THE CONTRACT UNIT PRICE EACH FOR VALVE BOXES TO BE ADJUSTED (SPECIAL), WHICH PRICE SHALL INCLUDE ALL LABOR, MATERIAL, AND EQUIPMENT NECESSARY TO COMPLETE THE WORK, INCLUDING PAVEMENT REMOVAL, EXCAVATION, ADJUSTING RINGS, CLASS SI BLACK COLORED CONCRETE, AND CONCRETE STAMPING WHERE REQUIRED. THE LETTER SIZE FOR THE PROPOSED LEGEND STAMPED IN THE CONCRETE SHALL MATCH THE EXISTING LETTER SIZE.

VALVE BOXES TO BE ADJUSTED

(SPECIAL) DETAIL


EXISTING VALVE BOX-

NOTE:

-SAW CUT

-EXIST, ASPHALT OVERLAY

-EXIST. CONCRETE PAVEMENT

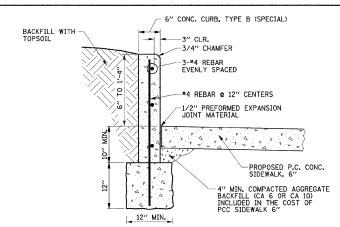


NOTE: THE COST OF CONSTRUCTING THE ADDITIONAL CURB WIDTH BELOW GRADE AND FURNISHING AND INSTALLING THE *4 REBARS AND PREFORMED EXPANSION JOINT MATERIAL SHALL BE INCLUDED IN THE COST OF THE CONCRETE CURB, TYPE B (SPECIAL), AND NO ADDITIONAL COMPENSATION WILL BE ALLOWED. THE P.C. CONC. SIDEWALK WILL BE PAID FOR SEPARATELY.

## CONCRETE CURB. TYPE B

(SPECIAL) DETAIL


NORTHWEST CORNER OF GOODWIN AVE. & SPRINGFIELD AVE.

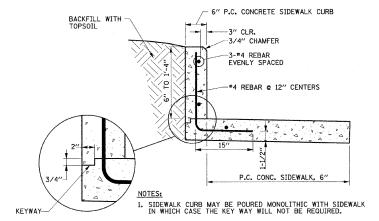

2. THE COST OF CONSTRUCTING THE ADDITIONAL SIDEWALK WIDTH BELOW THE SIDEWALK CURB AND FURRISHING AND INSTALLING *4 REBARS SHALL BE INCLUDED IN THE COST OF THE PORTLAND CEMENT CONCRETE SIDEWALK CURB, AND NO ADDITIONAL COMPENSATION WILL BE ALLOWED. THE P.C. CONC. SIDEWALK ADJACENT TO THE SIDEWALK CURB WILL BE PAID FOR SEPARATELY.


#### PORTLAND CEMENT CONCRETE SIDEWALK CURB DETAIL

NORTHWEST CORNER OF GOODWIN AVE. & NEVADA ST.

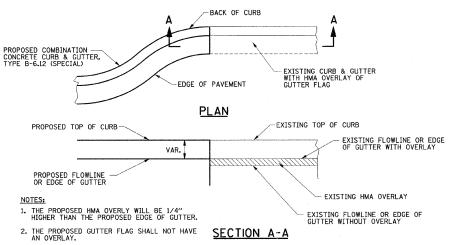

3. WHERE THE PROPOSED CURB AND GUTTER MEETS
THE EXISTING CURB AND GUTTER, THE PROPOSED
OVERLAY OF THE EXISTING GUTTER FLAG SHALL
BE TRANSITIONED TO MATCH THE PROPOSED
GUTTER FLAG WITHOUT OVERLAY AS DIRECTED
BY THE ENGINEER.

#### GUTTER FLAG DETAIL EXISTING GUTTER FLAG WITH HMA OVERLAY AND PROPOSED GUTTER FLAG WITHOUT HMA OVERLAY

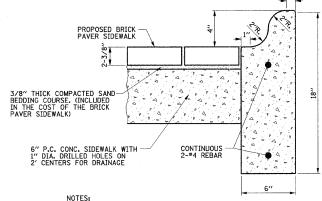

- 1. THE EXISTING TREE IN THE TREE PIT SHALL REMAIN.
- 2. THE INSIDE DIMENSIONS OF THE TREE PIT SHALL BE 6' x 3' OR AS DIRECTED BY THE ENGINEER.
- 3. THE COST OF FURNISHING AND INSTALLING THE *4 REBARS SHALL BE INCLUDED IN THE COST OF THE CONCRETE CURB (SPECIAL), AND NO ADDITIONAL COMPENSATION WILL BE ALLOWED. THE BRICK PAVER SIDEWALK AND P.C. CONC. SIDEWALK WILL BE PAID FOR SEPARATELY.


#### BRICK PAVER SIDEWALK AND CONCRETE CURB (SPECIAL) DETAIL NORTHWEST CORNER OF GOODWIN AVE. & OREGON ST.

PROPOSED BRICK PAVER SIDEWALK 1" TO 1.5" THICK SAND—
BEDDING COURSE
(INCLUDED IN THE COST
OF REMOVE AND REINSTALL
BRICK PAVERS) 4" COMPACTED AGGREGATE BASE COURSE (PAID FOR AS AGGREGATE BASE COURSE, TYPE B)


THE COST OF INSTALLING THE SALVAGED BRICK PAVERS ON THE SAND BEDDING COURSE SHALL BE INCLUDED IN THE COST OF REMOVE AND REINSTALL BRICK PAVERS. THE AGGREGATE BASE COURSE WILL BE PAID FOR SEPARATELY.

# BRICK PAVER SIDEWALK DETAIL

# WITH COMPACTED AGGREGATE BASE

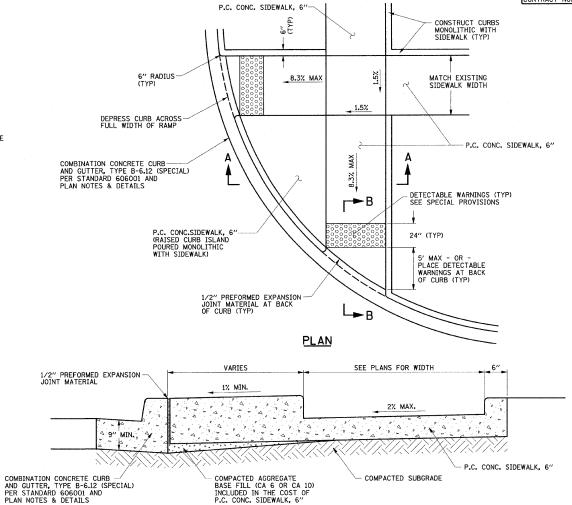

#### SECTION A-A

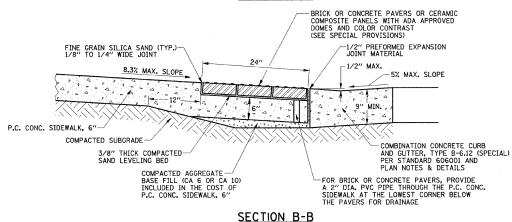

### SIDEWALK RAMP DETAIL

#### SIDEWALK GENERAL NOTES

THE COST OF CONSTRUCTING THE DEPRESSED CURB AS SHOWN SHALL BE CONSIDERED INCLUDED IN THE COST OF CONSTRUCTING THE COMBINATION CONCRETE CURB AND GUTTER TYPE B-6.12 (SPECIAL) AND NO ADDITIONAL COMPENSATION WILL BE ALLOWED.

THE COST OF FURNISHING AND INSTALLING THE 1/2" EXPANSION JOINTS AND THE COST OF CONSTRUCTING THE P.C.C. SIDEWALK THICKNESS TRANSITION, INCLUDING THE ADJACENT CURBING AS SHOWN, SHALL BE INCLUDED IN THE COST OF CONSTRUCTING P.C. CONCRETE SIDEWALK 6" AND NO ADDITIONAL COMPENSATION WILL BE ALLOWED.

THE DETECTABLE WARNINGS SHALL HAVE A CONTRASTING COLOR APPROVED BY THE ENGINEER AND SHALL BE CONSTRUCTED IN ACCORDANCE WITH STANDARD 424001 AND THE STANDARD SPECIFICATIONS. THE DETECTABLE WARNINGS WILL BE PAID FOR AT THE CONTRACT UNIT PRICE PER SQUARE FOOT FOR DETECTABLE WARNINGS.

TRANSVERSE SAWED JOINTS SHALL BE PLACED AT CENTERS EQUAL TO THE SIDEWALK WIDTH UNLESS OTHERWISE DIRECTED BY THE ENGINEER. THE MAXIMUM TRANSVERSE JOINT SPACING SHALL BE 10' UNLESS OTHERWISE DIRECTED BY THE ENGINEER. THE 3/4" EXPANSION JOINTS SHALL BE PLACED AT 100' CENTERS.


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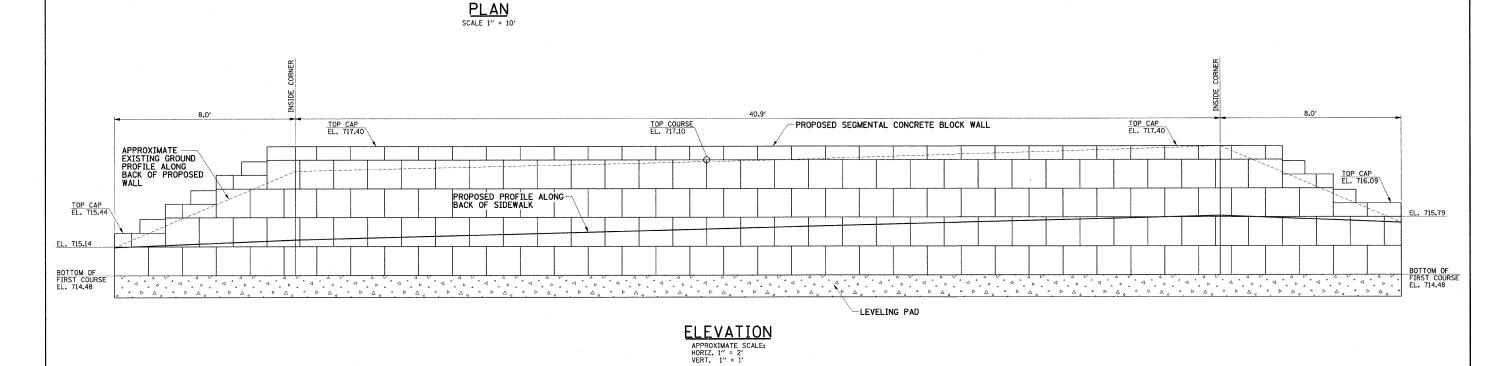
STATE OF ILLINOIS DEPARTMENT OF TRANSPORTATION

SCALE

MISCELLANEOUS DETAILS				F.A.U. RTE.	SECTION	COUNTY	TOTAL SHEETS	SHEET NO.	
				7175	07-00456-00-RS	CHAMPAIGN	75	74	ĺ
					GOODWIN AVENUE	CONTRACT	NO. 91	392	
: NONE	SHEET NO. 74 OF 75 SHEETS	STA.	TO STA.	FED. RC	AD DIST. NO. ILLINOIS FED.	AID PROJECT			





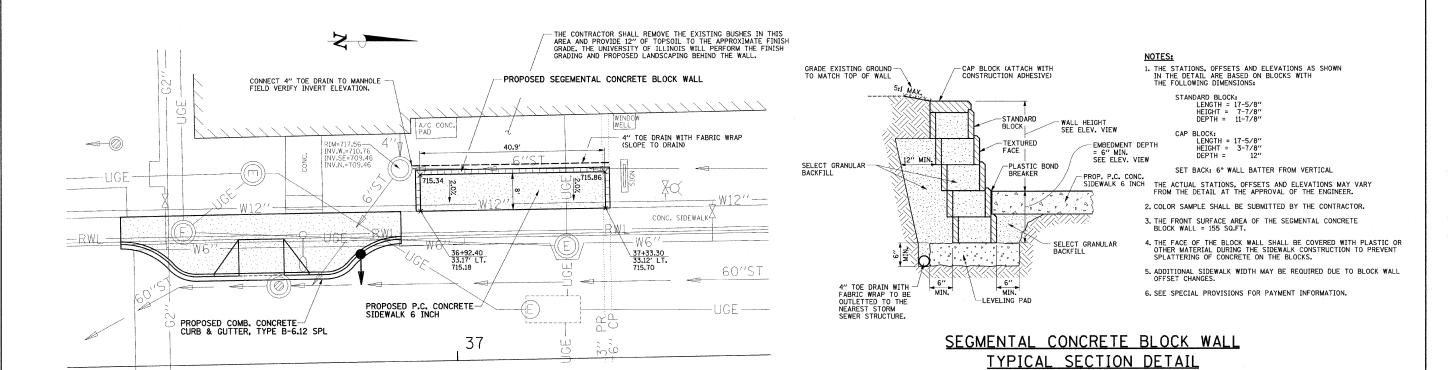

COUNTY TOTAL SHEET NO. CHAMPAIGN 75 75 DESIGNED - JRM REVISED -SECTION FILE NAME = MISCELLANEOUS DETAILS p:\u0070052\plans\sheets\72-MiscDetails.dgm DRAWN REVISED STATE OF ILLINOIS 07-00456-00-RS DEPARTMENT OF TRANSPORTATION CHECKED - RLH REVISED -PLOT DATE = 1/12/2009 7:47:26 PM CONTRACT NO. 91392 GOODWIN AVENUE SCALE : NONE | SHEET NO. 75 OF 75 SHEETS | STA. TO STA. FED. ROAD DIST. NO. | ILLINOIS | FED. AID PROJECT DATE - 01-2009 REVISED -