STATE OF ILLINOIS

DEPARTMENT OF TRANSPORTATION

DIVISION OF HIGHWAYS

PROPOSED HIGHWAY PLANS

F.A.P. 573 / U.S. 30 SECTION: 117 R-2B-R AT E. & W. BRANCH BIG ROCK CREEK **BRIDGE DECK REPAIR**

> **COUNTY: KANE** C-91-497-08

BIG ROCK TOWNSHIP

R. 6 E. CITY OF AUROR (47)Forest Preserve Municipal Airport VILLAGE OF BIG ROCK **VILLAGE OF SUGAR GROVE (47)**

DISTRICT ONE - PLAN PREP ENGINEER: KEN ENG (847) 705-4247

ENGINEERING SCALES. REDUCED SIZED PLANS WILL NOT CONFORM TO STANDARD SCALES. IN MAKING MEASUREMENTS

ON REDUCED PLANS, THE ABOVE SCALES MAY BE USED.

JOINT UTILITY LOCATING INFORMATION FOR EXCAVATORS

2) LOCATION: U.S. 30 OVER

EAST BRANCH BIG ROCK CREEK

S.N. 045-2006

1) LOCATION:

U.S. 30 OVER

WEST BRANCH

S.N. 045-2005

BIG ROCK CREEK

FOR INDEX OF SHEETS, SEE SHEET NO. 2

RURAL - OTHER PRINCIPAL ARTERIAL

DESIGN DESIGNATION:

SPEED LIMIT: 55 MPH

PROJECT LOCATED IN THE

VILLAGE OF BIG ROCK

2007 ADT = 7.100

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LOCATION 1) GROSS & NET LENGTH OF PROJECT = 295.00 FEET = 0.056 MILES **LOCATION 2) GROSS & NET LENGTH OF PROJECT = 244.00 FEET = 0.046 MILES**

CONTRACT NO. 60E63

1-800-892-0123


OR 811



117 R-2B-R KANE ILLINOIS CONTRACT NO. 60F63 FED. ROAD DIST. NO. 1

D-91-497-08



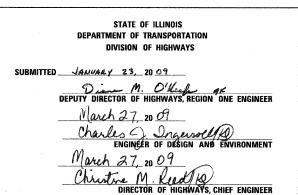



Birinder S. Sachdera BIRINDER S. SACHDEVA, P.E. EXPIRES: 11-30-2009

January 21, 2009



Balaeza N. Shah BHADRESH N. SHAH, S.E., P.E.

COOS,IS YE WHAT

PRINTED BY THE AUTHORITY OF THE STATE OF ILLINOIS

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LIST OF STATE STANDARDS

STANDARD NO.	DESCRIPTION
000001- <i>05</i>	STANDARD SYMBOLS, ABBREVIATIONS AND PATTERNS
701201- <i>03</i>	LANE CLOSURE, 2L, 2W, DAY ONLY, FOR SPEEDS > 45 MPH
701316 <i>-04</i>	LANE CLOSURE, 2L, 2W, BRIDGE REPAIR, FOR SPEEDS > 45 MPH
701901 -0 /	TRAFFIC CONTROL DEVICES
780001 <i>-0</i> 2	TYPICAL PAVEMENT MARKINGS
880001- <i>01</i>	SPAN WIRE MOUNTED SIGNALS AND FLASHING BEACON INSTALLATION

GENERAL NOTES

- 1. THESE PLANS HAVE BEEN PREPARED FROM NOTES RECEIVED FROM IDOT FIELD MAINTENANCE ENGINEERS.
- 2. PLAN DIMENSIONS AND DETAILS RELATIVE TO EXISTING PLANS ARE SUBJECT TO ROUTINE VARIATIONS. THE CONTRACTOR SHALL FIELD VERIFY EXISTING DIMENSIONS AND DETAILS AFFECTING NEW CONSTRUCTION AND MAKE NECESSARY APPROVED ADJUSTMENTS PRIOR TO CONSTRUCTION OR ORDERING MATERIALS. SUCH VARIATIONS SHALL NOT BE CAUSE FOR ADDITIONAL COMPENSATION FOR A CHANGE IN THE SCOPE OF THE WORK, HOWEVER, THE CONTRACTOR WILL BE PAID FOR THE QUANTITY ACTUALLY FURNISHED BASED UPON THE UNIT PRICE.
- 3. FORTY-EIGHT HOURS BEFORE STARTING EXCAVATION, THE CONTRACTOR WILL CALL J.U.L.I.E. (1-800-892-0123) OR 811 TO HAVE THE LOCATION OF EXISTING UTILITIES STAKED.
- 4. THE CONTRACTOR WILL NOT BE ALLOWED TO SET UP A YARD OR FIELD OFFICE ON STATE PROPERTY WITHOUT WRITTEN PERMISSION FROM THE DEPARTMENT.
- 5. SAW CUTTING PRIOR TO ANY REMOVAL ITEMS NOTED ON THE PLANS OR DIRECTED BY THE ENGINEER SHALL BE CONSIDERED INCLUDED IN THE COST OF THE ITEMS BEING REMOVED.
- 6. DO NOT SCALE PLANS FOR CONSTRUCTION DIMENSIONS.
- 7. THE CONTRACTOR SHALL USE CARE IN REMOVING OR EXCAVATING NEAR ALL EXISTING ITEMS WHICH WILL REMAIN. ANY DAMAGE DONE TO EXISTING ITEMS BY THE CONTRACTOR SHALL BE REPAIRED AT THE CONTRACTOR'S EXPENSE.
- 8. WHEN ARTIFICIAL LIGHTING IS UTILIZED IN NIGHT OPERATIONS, THE CONTRACTOR SHALL EXERCISE THE UTMOST PRECAUTIONS IN PREVENTING ADVERSE VISIBILITY TO THE MOTORING PUBLIC AS WELL AS ADJOINING RESIDENTIAL AREAS.
- 9. THE CONTRACTOR SHALL OBTAIN ALL NECESSARY PERMITS, AS REQUIRED, PRIOR TO COMMENCING WITH CONSTRUCTION.
- 10. THE CONTRACTOR SHALL TAKE ALL NECESSARY MEASURES TO ASSURE THAT NO DEBRIS FALLS IN THE CREEK. THE COST OF THIS WORK SHALL BE INCLUDED IN THE VARIOUS PAY ITEMS.
- 11. THE CONTRACTOR SHALL CONTACT THE TRAFFIC CONTROL SUPERVISOR AT (847) 705-4470 A MINIMUM OF 72 HOURS PRIOR TO THE PLACEMENT OF ANY TEMPORARY TRAFFIC CONTROL DEVICES.
- 12. THE CONTRACTOR SHALL CONTACT DON CHIARUGI, THE AREA TRAFFIC FIELD ENGINEER, AT (847) 741-9857 TWO (2) WEEKS PRIOR TO THE PLACEMENT OF PERMANENT PAVEMENT MARKINGS.
- 13. ALL DAMAGE TO EXISTING PAVEMENT MARKINGS OUTSIDE THE REMOVAL LINE SHOWN ON THE PLANS SHALL BE REPLACED AT THE CONTRACTOR'S EXPENSE.

T	INDEX OF SH	EETS. LIST (OF STATE STAI	NDARDS AND	GENERAL NOTES	F.A.P. RTE.	SECTION	COUNTY	TOTAL	
			U.S. 30			573	117 R-2B-R	KANE	40	2
l	0.0, 00							CONTRACT	NO. 6	0E63
,	SCALE: YOME	SMEST NO 1	OF ' SHEETS	STA. VARIOUS	TO STA- VARIOUS	FED. R	OAD DIST. VO. 1 1 TVOIS FED. A	D PROJECT		

	S	UMMARY OF QUANTITIES		URBAN 100% STATE	CONSTR TYPE SFT)	CODE	
	CODE NO	ITEM	UNIT	TOTAL QUANTITIES	WEST BRANCH	EAST BRANCH	
	40600200	BITUMINOUS MATERIALS (PRIME COAT)	TON	1	0.5	0.5	
	40600300	AGGREGATE (PRIME COAT)	TON	2	1	1	
	40600982	HOT-MIX ASPHALT SURFACE REMOVAL - BUTT JOINT	SQ YD	620	310	310	-
	40603340	HOT-MIX ASPHALT SURFACE COURSE, MIX "D", N70	TON	116	60	. 56	
	42001300	PROTECTIVE COAT	SQ YD	1,269	708	561	
	44201796	CLASS D PATCHES, TYPE IV, 12 INCH	SQ YD	44	22	22	
	50102400	CONCRETE REMOVAL	CU YD	39.5	16.4	23.1	
	50300255	CONCRETE SUPERSTRUCTURE	CU YD	43.1	17.6	25.5	
	50300260	BRIDGE DECK GROOVING	SQ YD	1,190	666	524	
	50800205	REINFORCEMENT BARS, EPOXY COATED	POUND	6,660	2,490	4,170	
	50800515	BAR SPLICERS	EACH	54	22	32	
	52000110	PREFORMED JOINT STRIP SEAL	FOOT	208	118	90	
	67000400	ENGINEER'S FIELD OFFICE, TYPE A	CAL MO	6	3	3	
	67100100	MOBILIZATION	L SUM	1	0.5	0.5	
	70101800	TRAFFIC CONTROL AND PROTECTION, (SPECIAL)	L SUM	1	0.5	0.5	
	70103815	TRAFFIC CONTROL SURVEILLANCE	CAL DA	30	15	15	
	70106700	TEMPORARY RUMBLE STRIP	EACH	12	6	6	
	78000200	THERMOPLASTIC PAVEMENT MARKING - LINE 4"	FOOT	699	312	387	
+	78008210	POLYUREA PAVEMENT MARKING TYPE I - LINE 4"	FOOT	632	360	272	
+	78100100	RAISED REFLECTIVE PAVEMENT MARKER	EACH	6	. 2	4	
+	78100105	RAISED REFLECTIVE PAVEMENT MARKER (BRIDGE)	EACH	6	2	4	
	78300200	RAISED REFLECTIVE PAVEMENT MARKER REMOVAL	EACH	12	4	8	

	S	UMMARY OF QUANTITIES		URBAN 100% STATE	CONSTR TYPE	CODE
			UNIT	TOTAL	SFT) WEST	<u>′-2A</u> EAST
	CODE NO	ITEM		QUANTITIES	BRANCH	BRANCH
	80400100	ELECTRIC SERVICE INSTALLATION	EACH	2	. 1	1
	80400200	ELECTRIC UTILITY SERVICE CONNECTION	L SUM	1	0.5	0.5
*	81018700	CONDUIT PUSHED, 3" DIA., GALVANIZED STEEL	FOOT	40	40	
*	81603210	UNIT DUCT, 600V, 3-1C NO.4, 1/C NO.6 GROUND, (EPR-TYPE RHW), 1 1/4" DIA. POLYETHYLENE	FOOT	275	275	
*	81800320	AERIAL CABLE, 3-1/C NO. 4 WITH MESSENGER WIRE	FOOT	2,025	905	1,120
*	81900200	TRENCH AND BACKFILL FOR ELECTRICAL WORK	FOOT	195	195	
*	82103400	LUMINAIRE, SODIUM VAPOR, HORIZONTAL MOUNT, PHOTO-CELL CONTROL, 400 WATT	EACH	11	5	6
*	83057250	LIGHT POLE, WOOD, 45 FOOT, CLASS 4	EACH	2	1	1
*	83057355	LIGHT POLE, WOOD, 60 FOOT, CLASS 4, WITH 15 FT MAST ARM	EACH	11	5	6
*	84100110	REMOVAL OF TEMPORARY LIGHTING UNITS	EACH	11	5	6
	X0322185	BRIDGE DECK LATEX CONCRETE OVERLAY, 2 1/4 INCHES	SQ YD	1,187	672	515
	X0322256	TEMPORARY INFORMATION SIGNING	SQ FT	104	52	52
*	X0323574	MAINTENANCE OF LIGHTING SYSTEM	CAL MO	4	2	2
	X0325775	WET REFLECTIVE TEMPORARY TAPE, TYPE III, 4 INCH	FOOT	3,147	1,585	1,562
	X0325841	WET REFLECTIVE TEMPORARY TAPE, TYPE III, 24 INCH	FOOT	48	24	24
*	X0326135	ELECTRIC SERVICE DISCONNECT, LIGHTING AND TRAFFIC SIGNAL	EACH	2	1	1
*	X8900005	TEMPORARY BRIDGE TRAFFIC SIGNAL INSTALLATION	EACH	2	1	1
*	XX006937	GROUND ROD, 5/8" DIA. × 10 FT.	EACH	4	2	2
	Z0001700	APPROACH SLAB REPAIR (FULL DEPTH)	SQ YD	10	7	3
	Z0001800	APPROACH SLAB REPAIR (PARTIAL DEPTH)	SQ YD	8	2	6
	Z0006204	BRIDGE DECK HYDRO-SCARIFICATION 1/2"	SQ YD	1,187	672	515

* SPECIALTY ITEM

* SPECIALTY ITEM

FILE NAME = D160E63-sht-S00.dgn PLOT DATE = 1/29/2009



INC.	DESIGNED	-	S.J.P.	REVISED	-
RS	DRAWN	-	A.C.S.	REVISED	%
	CHECKED	-	E.J.M.	REVISED	-
-5274	DATE	-	JANUARY 28, 2009	REVISED	-
The second second	AND DESCRIPTION OF THE OWNER, THE	te ne meanix			

 		.A.P. RTE.	SECTION
	U.S. 30	573	117 R-2B-R
SCALE: NONE	SHEET NO. 1 OF 1 SHEETS STA. VARIOUS TO STA. VARIOUS	EED D	OAD DIST. NO. 1 TILLING
SCALE: NONE	SHEET NO. 1 OF 1 SHEETS STA. VARIOUS 10 STA. VARIOUS		OAD DIST, NO.


HOT-MIX ASPHALT MIXTURE REQUIREMENTS										
MIXTURE TYPE	AC TYPE	AIR VOIDS								
PAVEMENT & SHOULDER RESURFACING										
HOT-MIX ASPHALT SURFACE COURSE, MIX "D", N50 (IL 9.5 mm)	PG 64-22	4% @ 50 Gyr.								
CLASS D PATCH										
HOT-MIX ASPHALT BINDER COURSE, IL-19.0, N70	 ★ PG 64-22	4% @ 70 Gyr.								

THE UNIT WEIGHT USED TO CALCULATE HMA MIXTURE QUANTITIES IS 112 LBS/SQ YD/IN.

* WHEN RAP EXCEEDS 20%, THE NEW ASPHALT BINDER IN THE MIX SHALL BE PG 58-22.


NOTES:

- 1. EXISTING PAVEMENT TO BE OVERLAID WILL BE CLEANED AND PRIMED PER ARTICLE 407.06 OF THE 2007 STANDARD SPECIFICATIONS.
- 2. SEE SHEET NO. 36 BUTT JOINT AND HMA TAPER DETAILS FOR ADDITIONAL NOTES AND DETAILS.

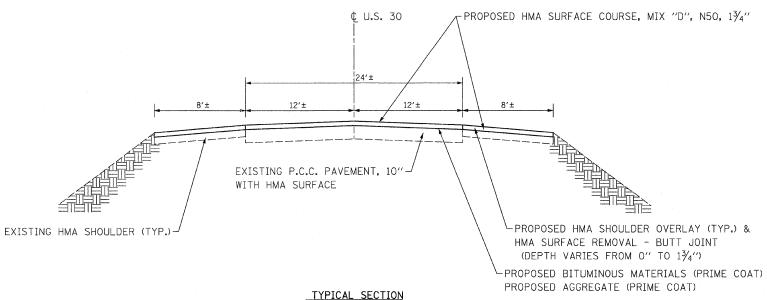

STA. 129+95 TO STA. 130+62.1 BRIDGE OMISSION STA. 130+62.1 TO STA. 132+21.5 STA. 132+21.5 TO STA. 132+90

STA. 186+98 TO STA. 187+57.2 BRIDGE OMISSION STA. 187+57.2 TO STA. 188+81.7 STA. 188+81.7 TO STA. 189+42

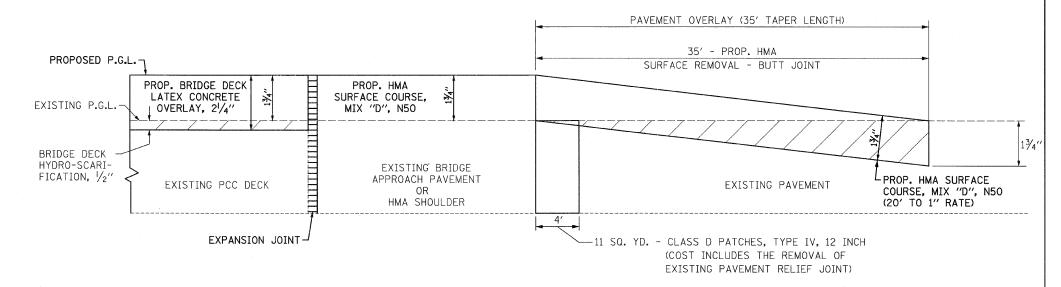

PAVEMENT MILLING AND RESURFACING - 35' TAPER WITH BUTT JOINT

STA. 129+95 TO STA. 130+62.1 STA. 132+21.5 TO STA. 132+90

STA. 186+98 TO STA. 187+57.2 STA. 189+81.7 TO STA. 189+42


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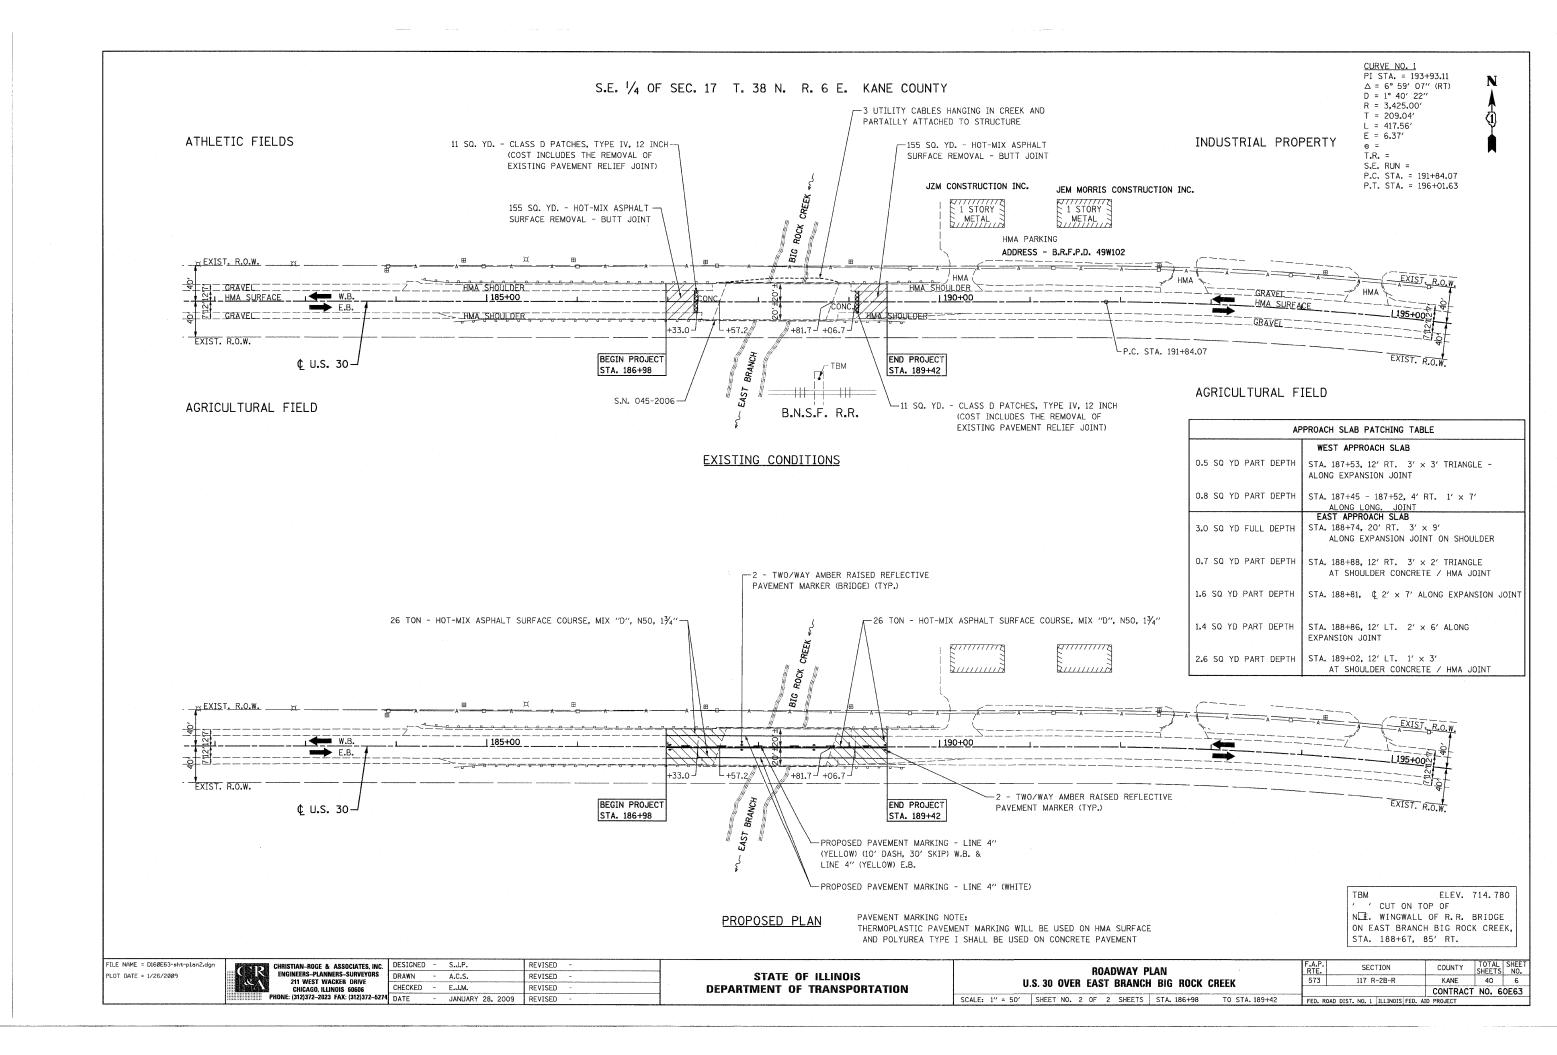
€(R	CHRISTIAN-ROGE & ASSOCIATES, INC. ENGINEERS-PLANNERS-SURVEYORS 211 WEST WACKER DRIVE
100242	CHICAGO, ILLINOIS 60606 PHONE: (312)372–2023 FAX: (312)372–527

	CHRISTIAN-ROGE & ASSOCIATES, INC.	DESIGNED		S.J.P.	REVISED	*
`R	ENGINEERS-PLANNERS-SURVEYORS 211 WEST WACKER DRIVE	DRAWN	-	A.C.S.	REVISED	
M	CHICAGO, ILLINOIS 60606	CHECKED	-	E.J.M.	REVISED	-
	PHONE: (312)372–2023 FAX: (312)372–5274	DATE	-	JANUARY 28, 2009	REVISED	-

STATI	E OF	ILLINOIS
DEPARTMENT	0F	TRANSPORTATION

TYPICAL SECTION & DETAILS	F.A.P. RTE.	SEC	TION	COUNTY	TOTAL SHEETS	
U.S. 30	573	117 R	-2B-R	KANE	40 ,	4
				CONTRACT	NO. 6	0E63
SCALE: NONE SHEET NO. 1 OF 1 SHEETS STA. VARIOUS TO STA. VARIOUS	FED. R	OAD DIST. NO. 1	ILLINOIS FED. A	ID PROJECT		



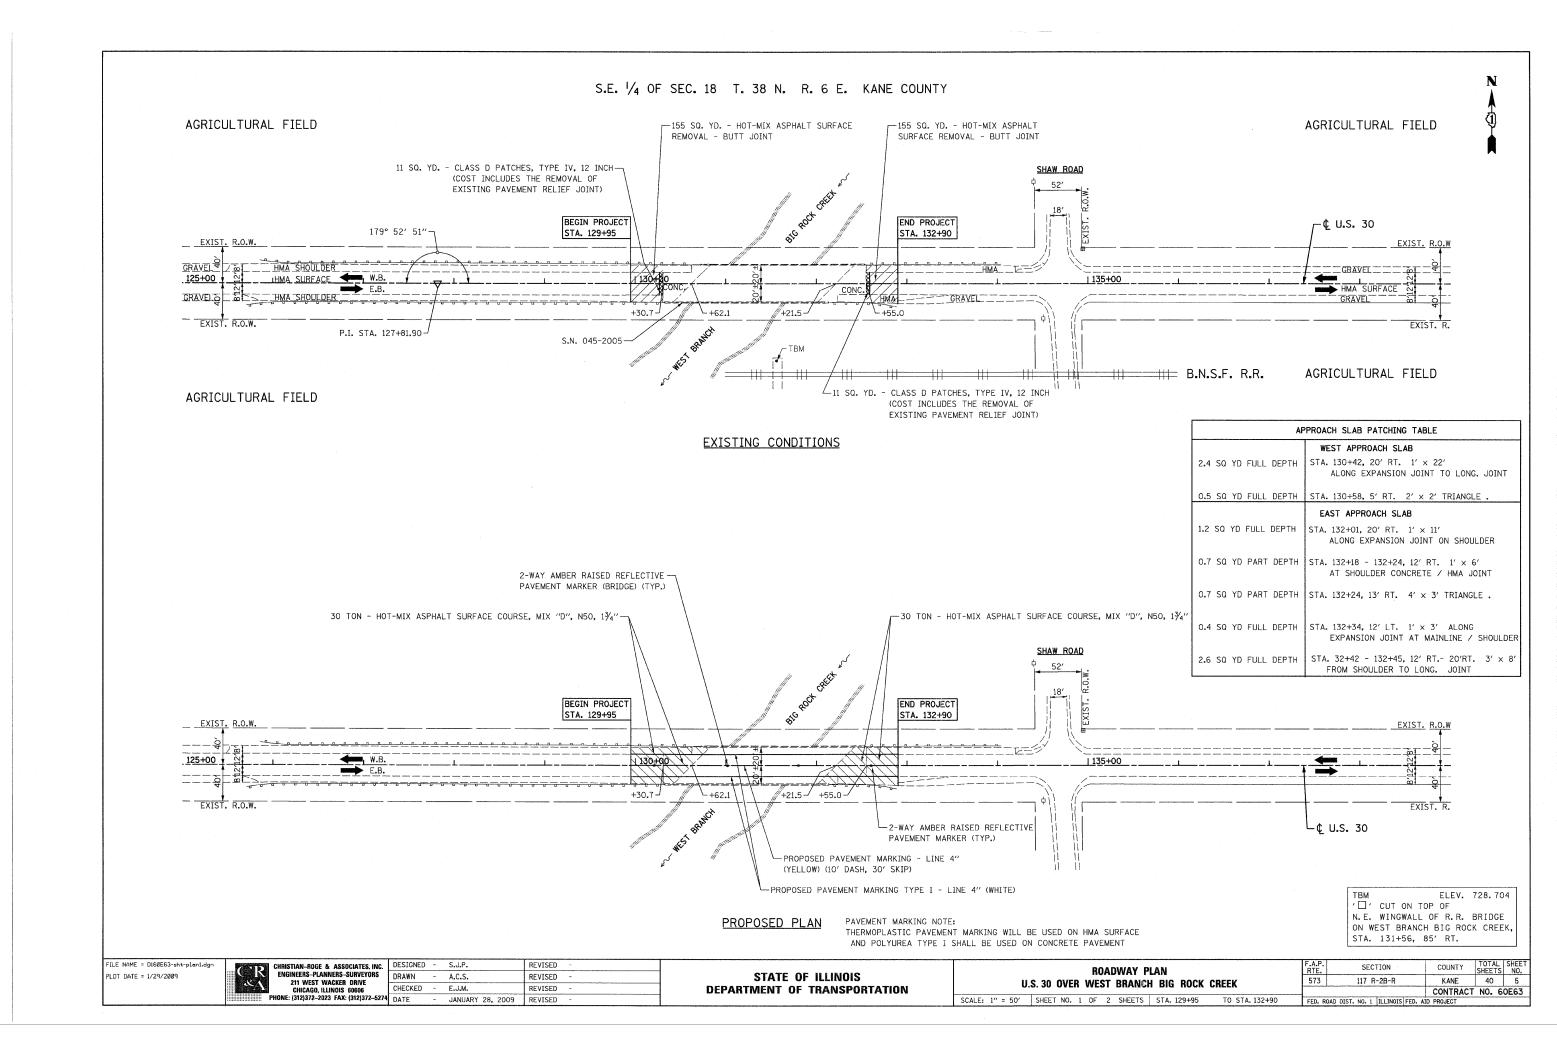

SUGGESTED STAGING AND MAINTENANCE OF TRAFFIC U.S. 30 OVER WEST BRANCH BIG ROCK CREEK U.S. 30 OVER EAST BRANCH BIG ROCK CREEK

CONSTRUCTION STAGING

STAGE I (EASTBOUND LANE CONSTRUCTION)

- HYDROSCARIFY DECK ON EASTBOUND HALF OF BRIDGE AND PLACE BRIDGE DECK LATEX CONCRETE OVERLAY.
- OVERLAY APPROACH PAVEMENT

STAGE II (WESTBOUND LANE CONSTRUCTION)

- HYDROSCARIFY DECK ON WESTBOUND HALF OF BRIDGE AND PLACE BRIDGE DECK LATEX CONCRETE OVERLAY.
- OVERLAY APPROACH PAVEMENT AND PLACE PAVEMENT MARKINGS.

MAINTENANCE OF TRAFFIC

STAGE I


- INSTALL TEMPORARY BRIDGE TRAFFIC SIGNALS AND TEMPORARY LIGHTING. USE DAILY LANE CLOSURES, SEE IDOT STANDARD 701201 - LANE CLOSURE, 2L, 2W, DAY ONLY, FOR SPEEDS > 45 MPH.
- CLOSE EASTBOUND LANE AND MAINTAIN ONE-LANE TWO-WAY TRAFFIC ON WESTBOUND PAVEMENT ACROSS BRIDGE AS SHOWN ON THE SUGGESTED MAINTENANCE OF TRAFFIC AND STAGING PLAN AND IDOT STANDARD 701316.

STAGE II


- SHIFT ONE-LANE TWO-WAY TRAFFIC TO EASTBOUND PAVEMENT ACROSS BRIDGE AS SHOWN ON THE SUGGESTED MAINTENANCE OF TRAFFIC AND STAGING PLAN AND IDOT STANDARD 701316.
- REMOVE TEMPORARY BRIDGE TRAFFIC SIGNALS AND USE DAILY LANE CLOSURES TO RESURFACE THE PAVEMENT ADJACENT TO THE BRIDGE. SEE IDOT STANDARD 701201 - LANE CLOSURE, 2L, 2W, DAY ONLY, FOR SPEEDS > 45 MPH.

TRAFFIC CONTROL GENERAL NOTES

- 1. THE CONTRACTOR SHALL NOT MOUNT SIGNS ON EXISTING SIGNS.
- 2. CONTRACTOR SHALL MAINTAIN SATISFACTORY INGRESS AND EGRESS TO ADJACENT PROPERTIES THROUGHOUT THE CONSTRUCTION.
- 3. INSTALL TEMPORARY SIGN PANEL ASSEMBLY AS SHOWN IN PLANS AND AS DIRECTED BY THE ENGINEER. TO BE PAID FOR BY ITEM "TEMPORARY INFORMATION SIGNING FOR LANE CLOSURE".
- 4. ALL TEMPORARY PAVEMENT MARKING SHALL BE WET REFLECTIVE TEMPORARY TAPE, TYPE III.
- 5. USE SUGGESTED TRAFFIC CONTROL AND STAGING PLAN IN CONJUNCTION WITH STANDARD 701316.
- 6. TEMPORARY RUMBLE STRIPS SHALL BE INSTALLED FOR THE APPROACHES AT EACH BRIDGE AS SHOWN ON STANDARD 701316.

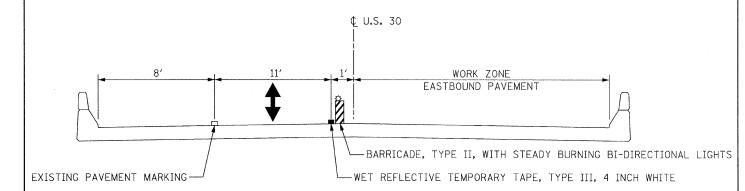

DECK CROSS SECTION - STAGE I U.S. 30 OVER WEST BRANCH BIG ROCK CREEK U.S. 30 OVER EAST BRANCH BIG ROCK CREEK

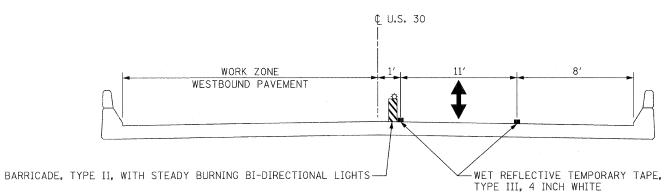

DECK CROSS SECTION - STAGE II U.S. 30 OVER WEST BRANCH BIG ROCK CREEK U.S. 30 OVER EAST BRANCH BIG ROCK CREEK

FILE NAME = D160E63-sht-staging.dg PLOT DATE = 1/26/2009

CHRISTIAN-ROGE & ASSOCIATES, INC.


DESIGNED - S.J.P. REVISED -REVISED DRAWN A.C.S. CHECKED - E.J.M. REVISED PHONE: (312)372-2023 FAX: (312)372-5274 DATE JANUARY 28, 2009 REVISED


STATE OF ILLINOIS **DEPARTMENT OF TRANSPORTATION** SUGGESTED MAINTENANCE OF TRAFFIC NOTES AND DETAILS U.S. 30


SHEET NO. 1 OF 3 SHEETS STA. VARIOUS TO STA. VARIOUS


COUNTY TOTAL SHEE SHEETS NO. SECTION KANE 40 7


CONTRACT NO. 60E63 573 117 R-2B-R

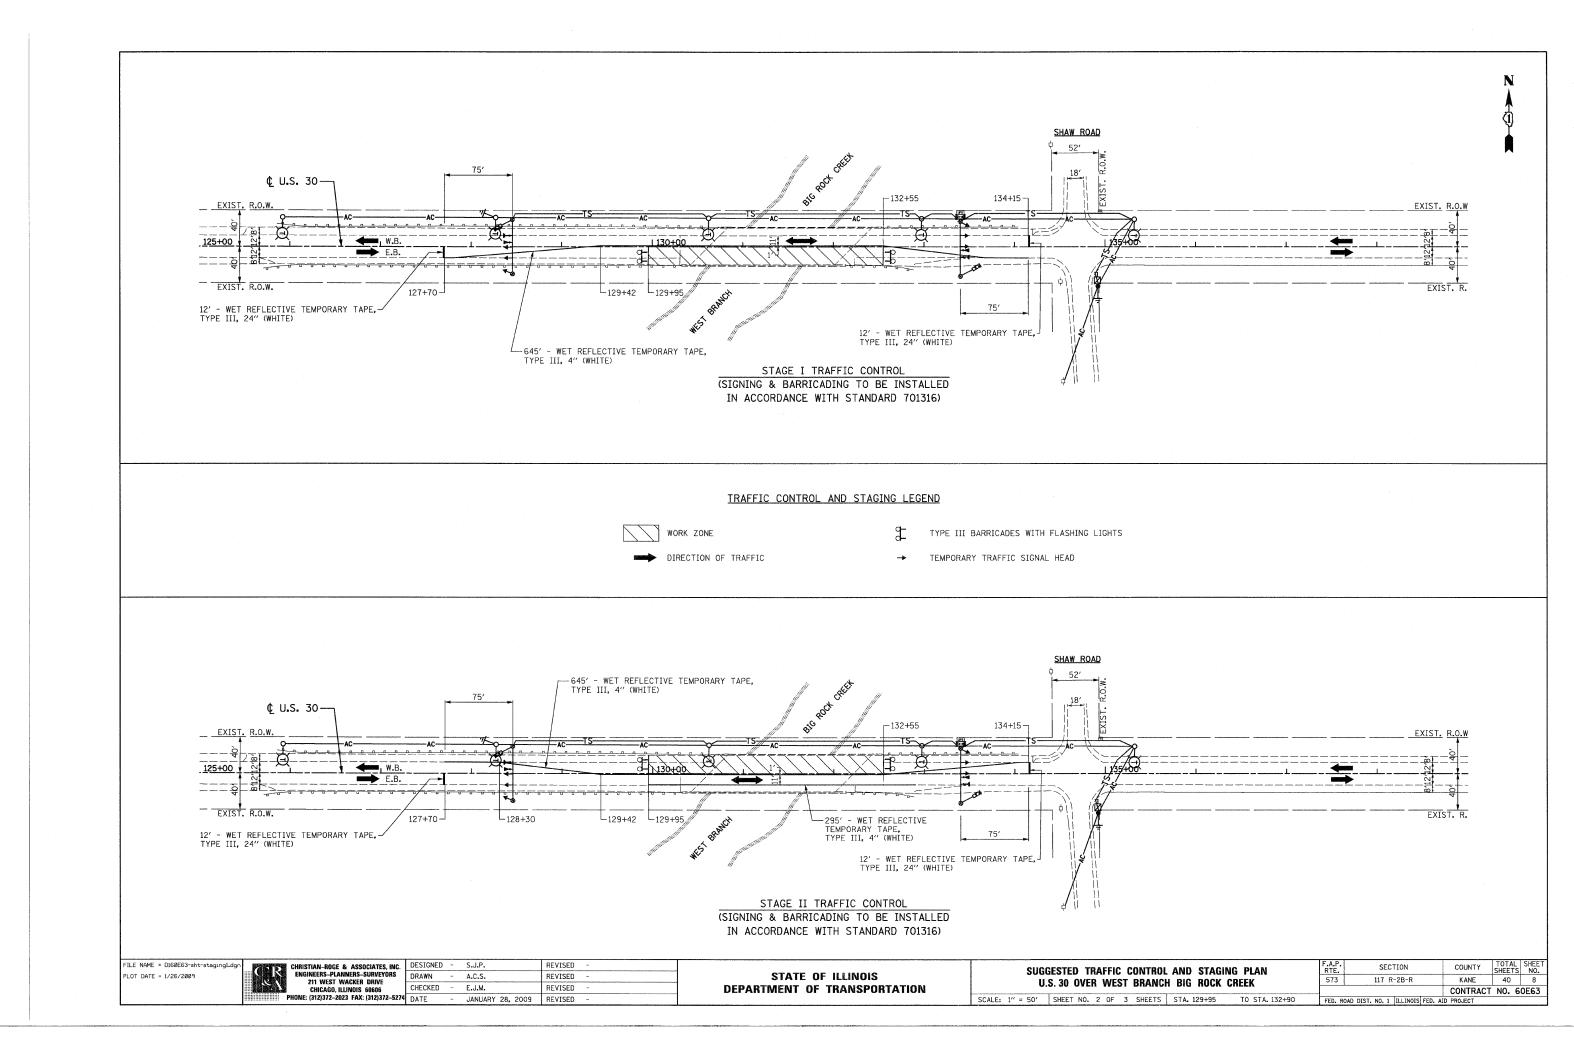

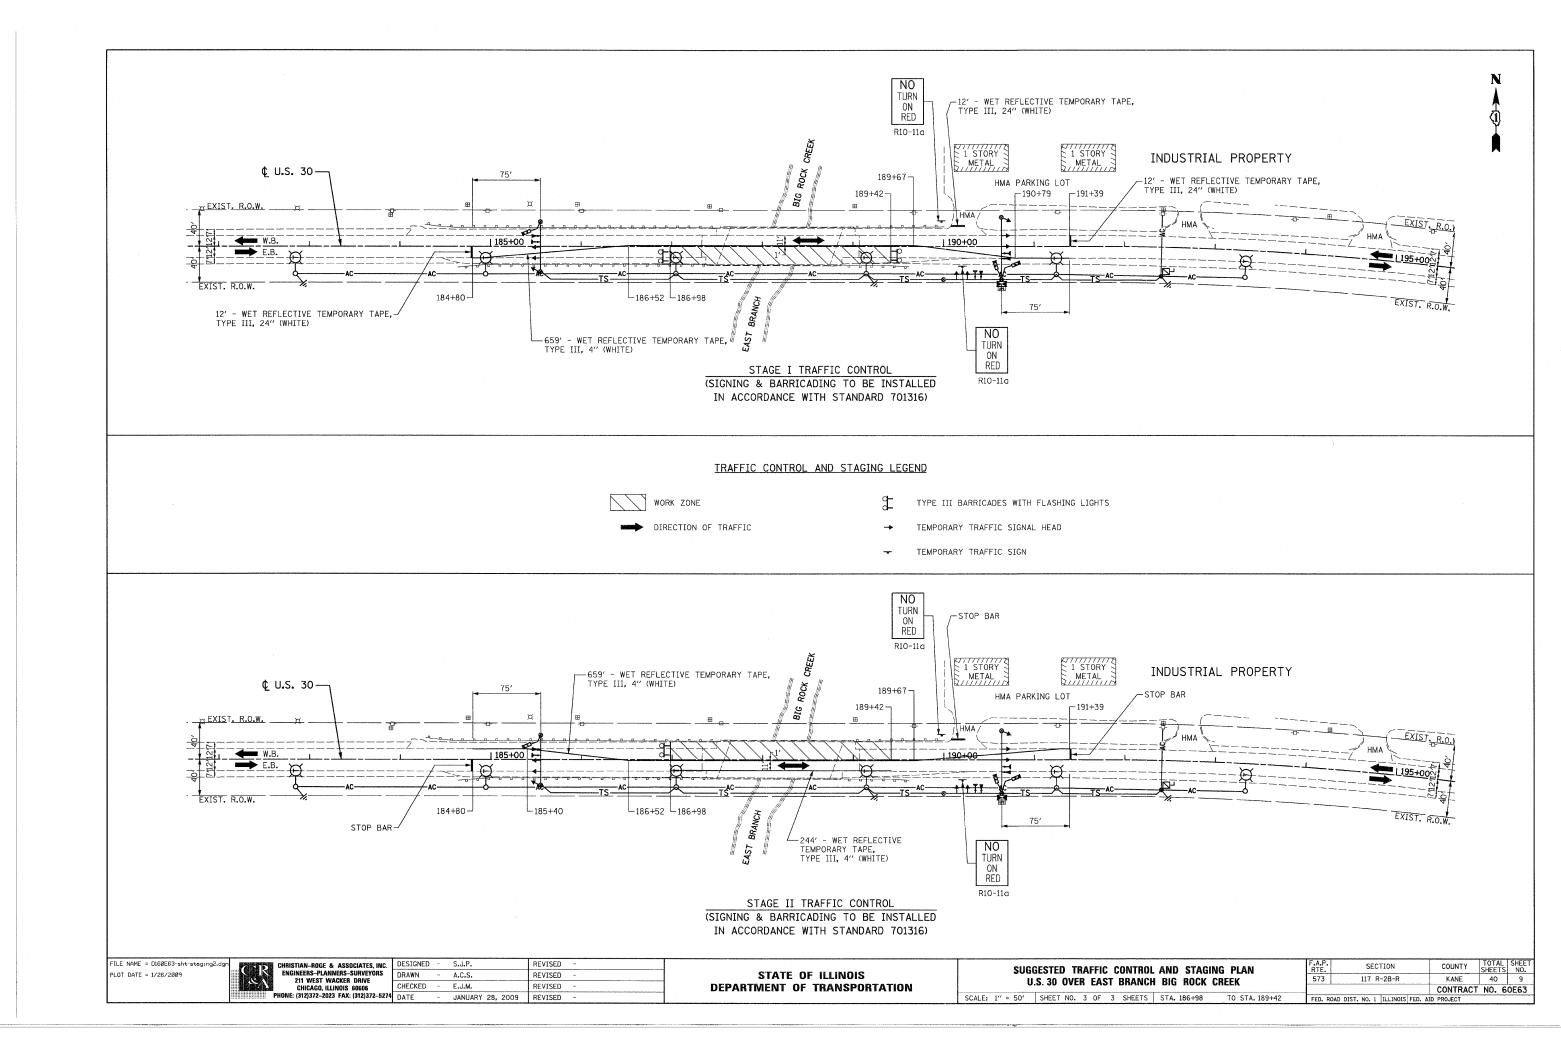

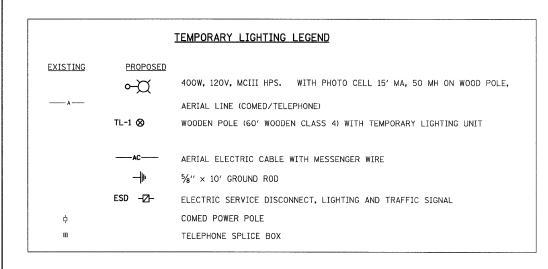

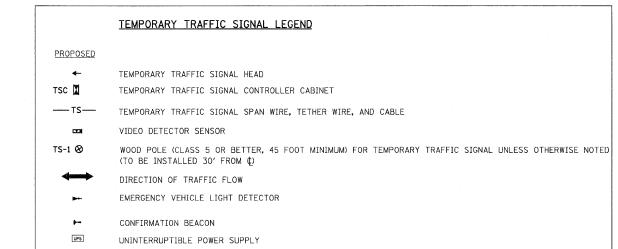


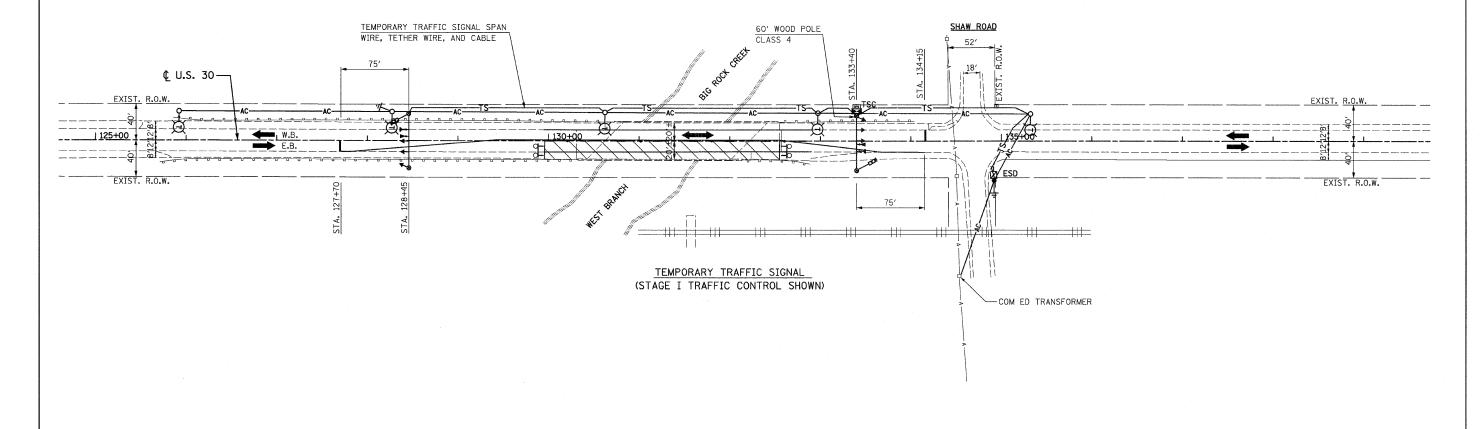


FILE NAME = D160E63-sht-tsl.dgn PLOT DATE = 1/26/2009 CHRISTIAN-ROGE & ASSOCIATES, INC.
ENGINEERS-PLANNERS-SURVEYORS
211 WEST WACKER DRIVE
CHICAGO, ILLINOIS 60606
PHONE: (312)372-2023 FAX: (312)372-5274


STATE OF ILLINOIS
DEPARTMENT OF TRANSPORTATION

				SIGNAL PLAI H BIG ROCK	-
SCALE: 1"	: 50' SHE	ET NO. 1 OF	4 SHEETS	STA, 129+95	TO STA. 132+90

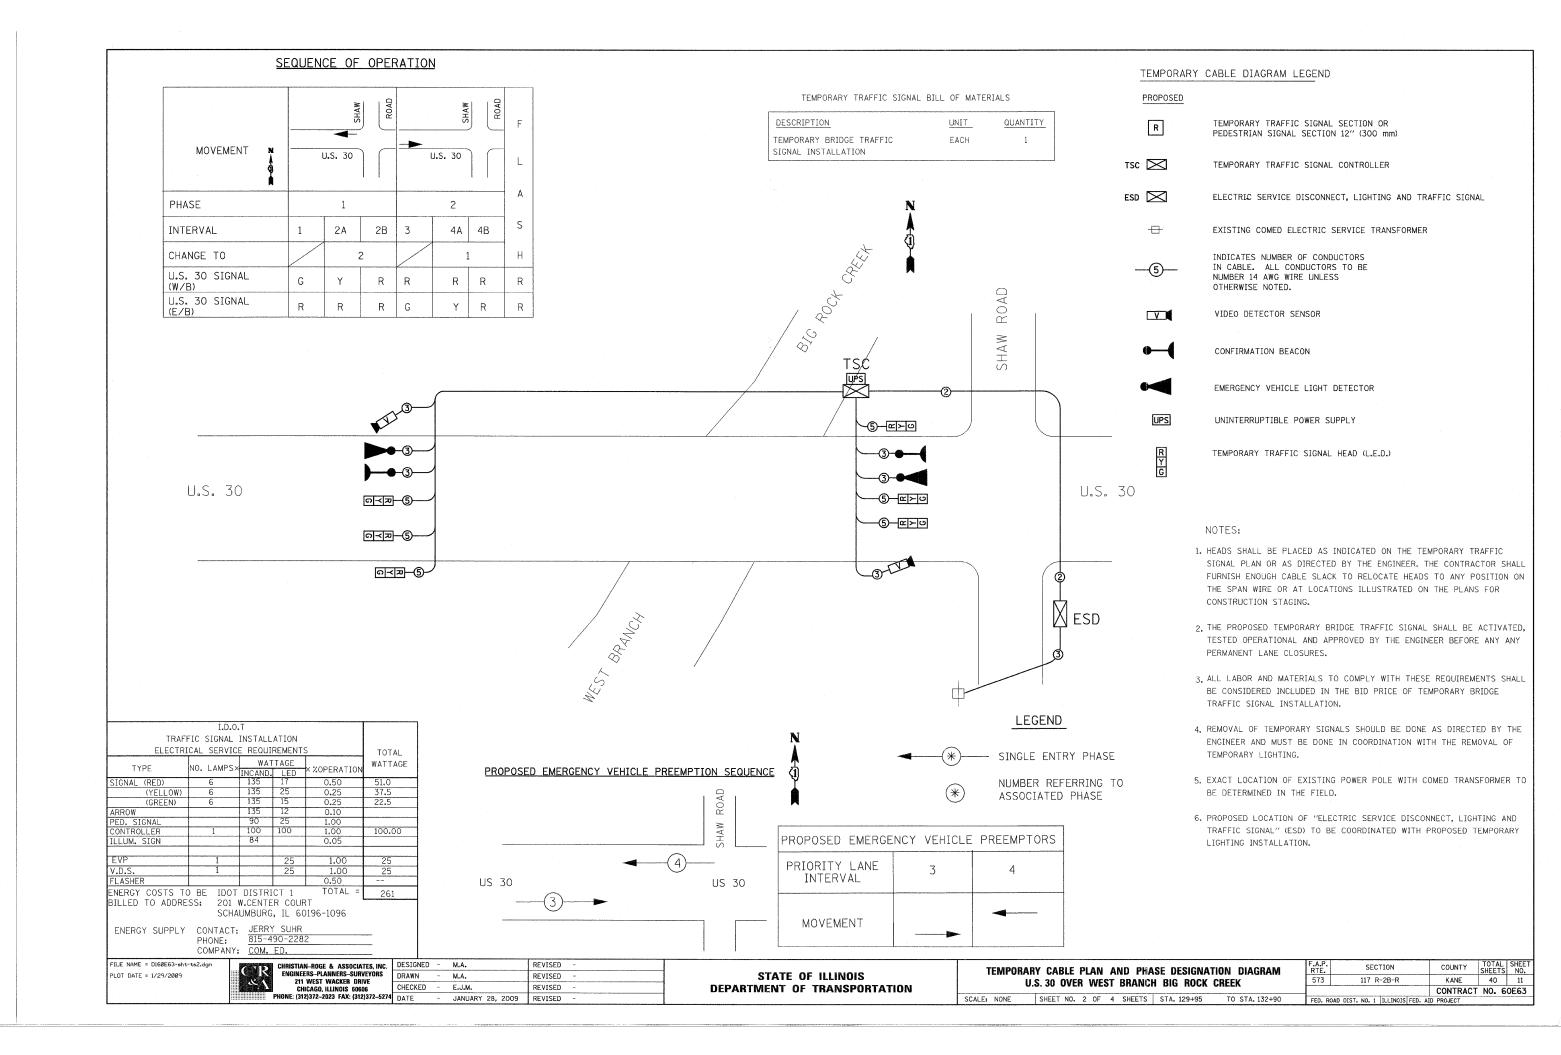

		TEMPORARY LIGHTING LEGEND
EXISTING	PROPOSED	
	⊶¤	400W, 120V, MCIII HPS. WITH PHOTO CELL 15' MA, 50 MH ON WOOD POLE,
A		AERIAL LINE (COMED/TELEPHONE)
	TL-1 ⊗	WOODEN POLE (60' WOODEN CLASS 4) WITH TEMPORARY LIGHTING UNIT
	⊗	WOOD POLE (25' CLASS 4) FOR TEMPORARY LIGHTING
	AC	AERIAL ELECTRIC CABLE WITH MESSENGER WIRE
	 µ	5%" × 10' GROUND ROD
	ESD	ELECTRIC SERVICE DISCONNECT, LIGHTING AND TRAFFIC SIGNAL
ф		COMED POWER POLE
B		TELEPHONE SPLICE BOX

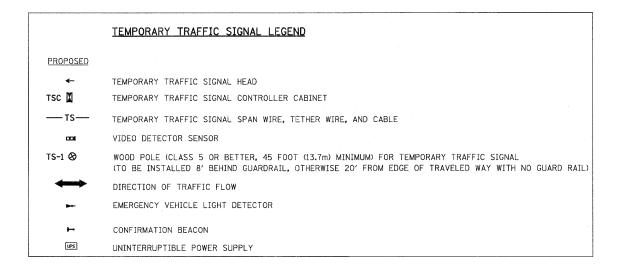

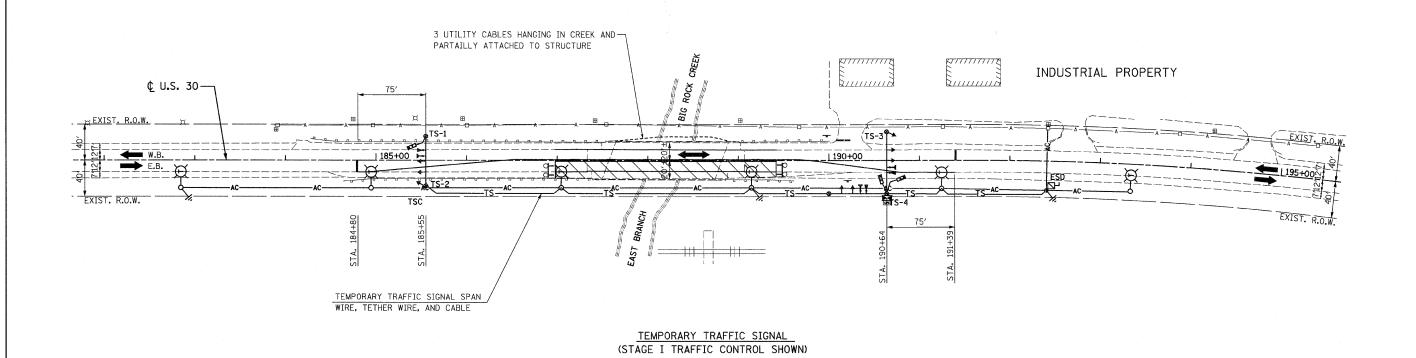

FILE NAME = D160E63-sht-ts3.dgn PLOT DATE = 1/26/2009 CHRISTIAN-ROGE & ASSOCIATES, INC.

ENGINEERS-PLANNERS-SURVEYORS
211 WEST WACKER DRIVE
CHICAGO, ILLINOIS 50606

PHONE: (312)372-2023 FAX: (312)372-5274

DATE

DATE

DATE

M.A.

DRAWN

- M.A.

CHECKED

- CHECKED

- CHECKED


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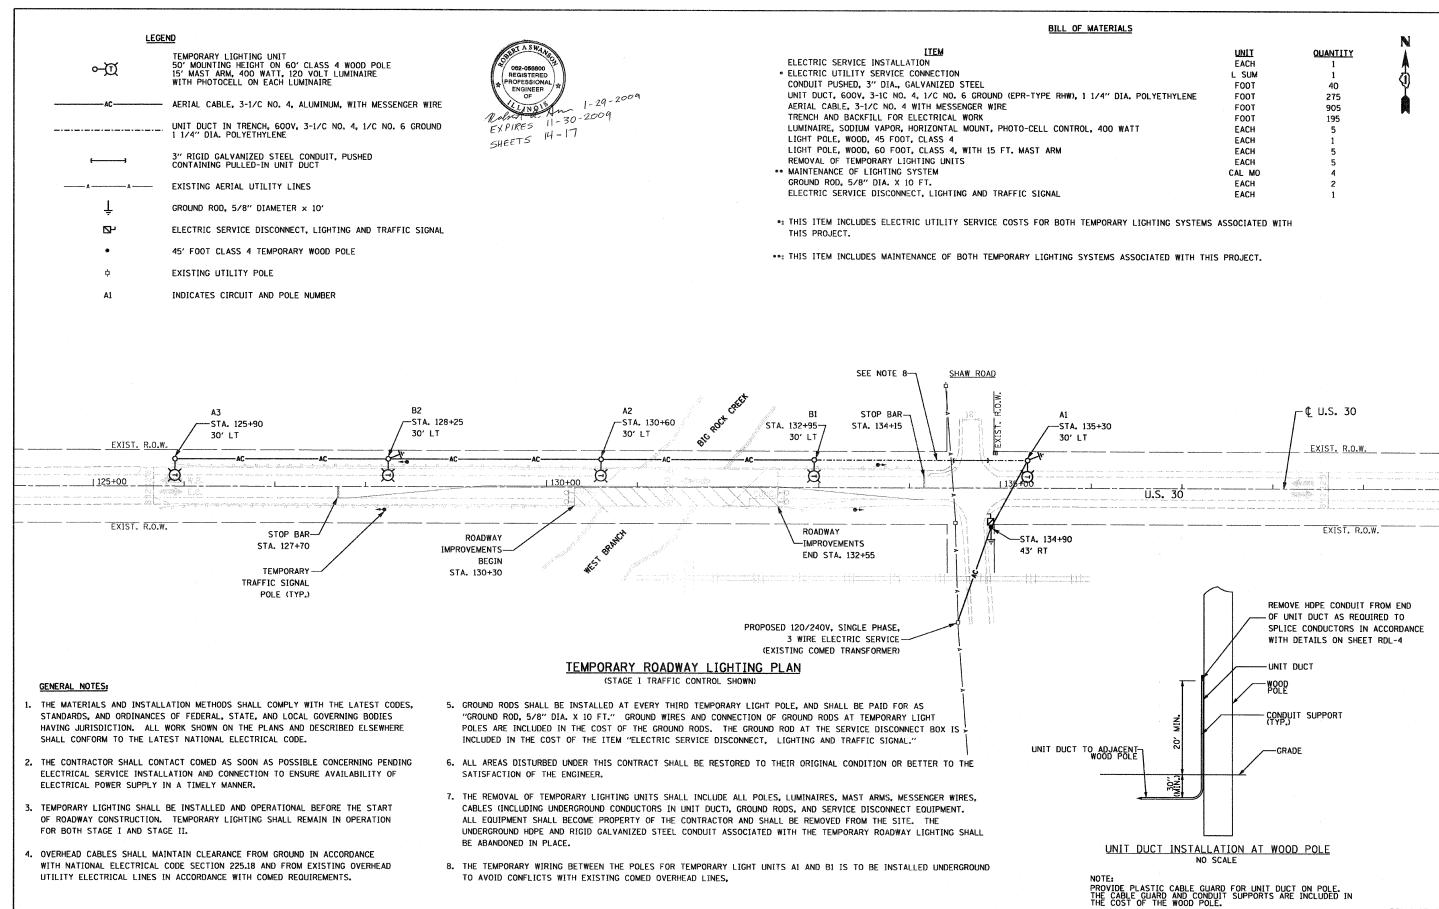
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STATE OF ILLINOIS
DEPARTMENT OF TRANSPORTATION

				TE	MPO)R	ARY	' T	RAFFIC	SIGN	AL PLA	N	
		•	U.S.	30	OVE	R	EAS	ST	BRANCH	l BIG	ROCK	CREEK	
SCALE:	1"' =	50′	SI	HEET	NO.	3	OF	4	SHEETS	STA.	186+98	TO	STA. 189+

F.A.P. RTE.			SI	EC.	TION		Τ	COUNTY	TOTA SHEET	L S	SHEI NO
573	117 R-2B-R					T	KANE	40		12	
								CONTRACT	NO.	60)E6
FED. R	OAD	DIST.	NO.	1	ILLINOIS	FED.	AID	PROJECT	~		




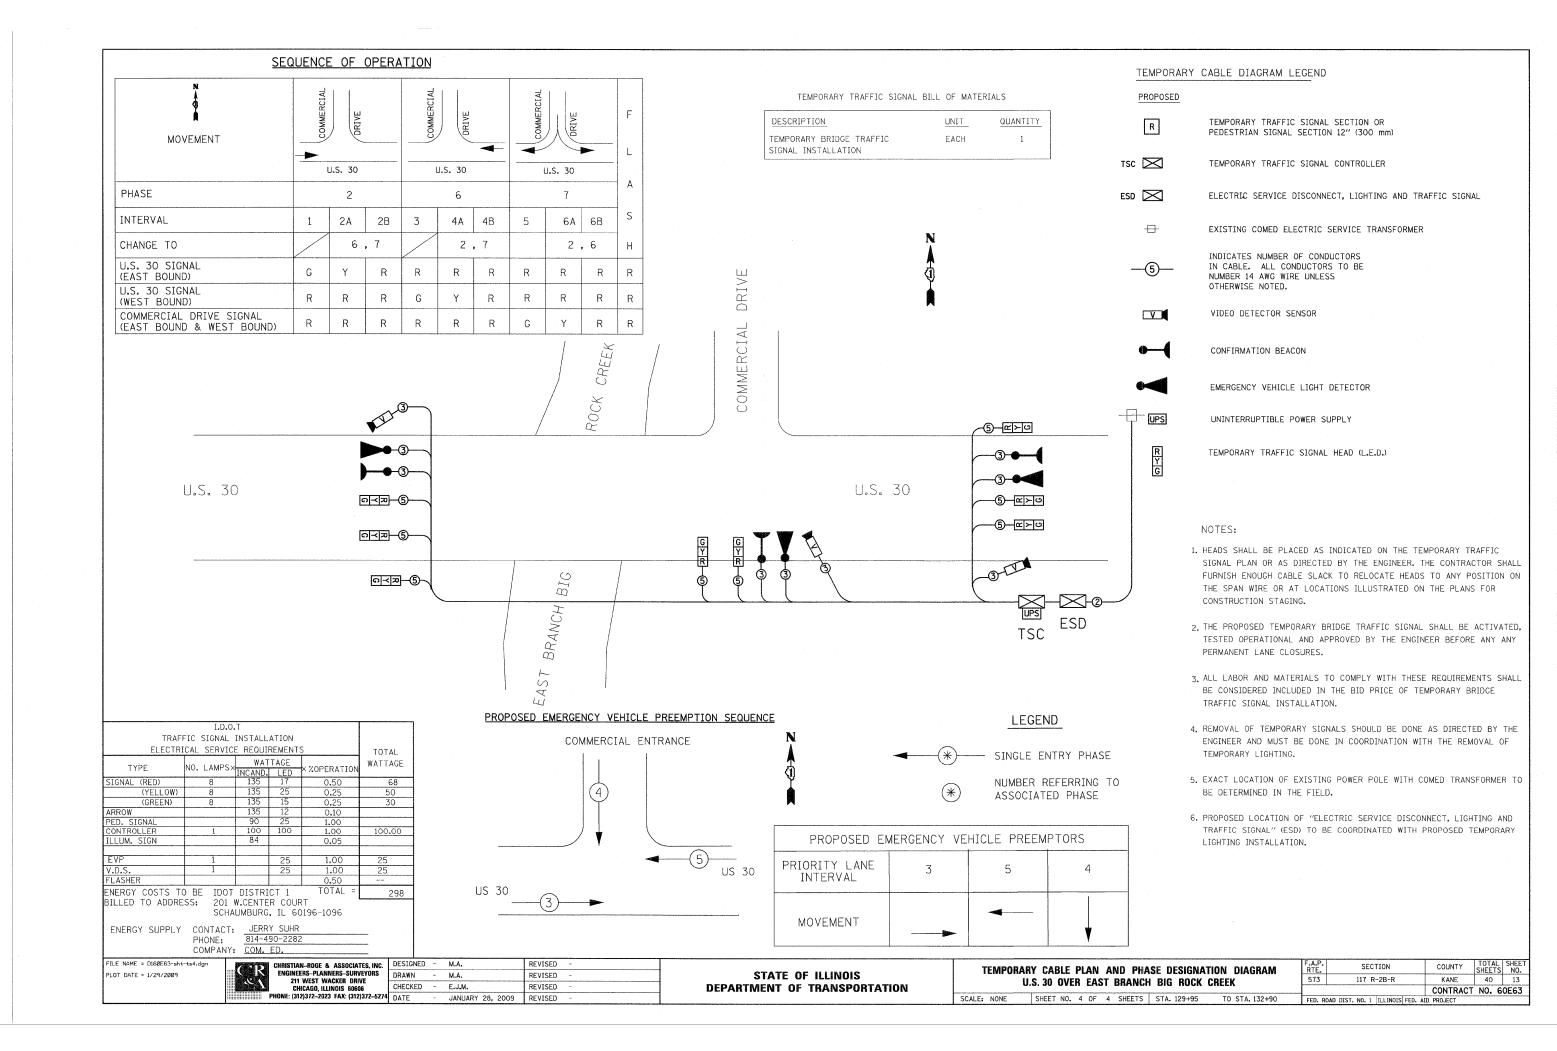

FILE NAME = D160E63-RDL-1.dgm DESIGNED - R.A.S. REVISED TOTAL SHEE SHEETS NO. SECTION SPAAN Tech. Inc. TEMPORARY ROADWAY LIGHTING PLAN PLOT DATE = 1/26/2009 DRAWN - R.P.J. REVISED STATE OF ILLINOIS KANE 40 14 117 R-2B-R U.S. 30 OVER WEST BRANCH BIG ROCK CREEK CHECKED - I.A.B. REVISED **DEPARTMENT OF TRANSPORTATION** CONTRACT NO. 60E63 South Wacker Drive, Suite 2400 JANUARY 26, 2009 REVISED SCALE: 1" = 50' SHEET NO. OF SHEETS STA. 130+30

LEG	<u>END</u>	BILL OF MATERIALS		
⊶ ⊠	TEMPORARY LIGHTING UNIT 50' MOUNTING HEIGHT ON 60' CLASS 4 WOOD POLE 15' MAST ARM, 400 WATT, 120 VOLT LUMINAIRE WITH PHOTOCELL ON EACH LUMINAIRE	ELECTRIC SERVICE INSTALLATION • ELECTRIC UTILITY SERVICE CONNECTION	<u>UNIT</u> EACH L SUM	QUANTITY 1 1
AC	- AERIAL CABLE, 3-1/C NO. 4, ALUMINUM, WITH MESSENGER WIRE	AERIAL CABLE, 3-1/C NO. 4 WITH MESSENGER WIRE LUMINAIRE, SODIUM VAPOR, HORIZONTAL MOUNT, PHOTO-CELL CONTROL, 400 WATT	FOOT EACH	1,120 6
A	EXISTING AERIAL UTILITY LINES	LIGHT POLE, WOOD, 45 FOOT, CLASS 4 LIGHT POLE, WOOD, 60 FOOT, CLASS 4, WITH 15 FT. MAST ARM	EACH EACH	1 6
<u> </u>	GROUND ROD, 5/8" DIAMETER × 10"	REMOVAL OF TEMPORARY LIGHTING UNITS •• MAINTENANCE OF LIGHTING SYSTEM	EACH CAL MO	6 4
⊠-	ELECTRIC SERVICE DISCONNECT, LIGHTING AND TRAFFIC SIGNAL	GROUND ROD, 5/8" DIA. X 10 FT. ELECTRIC SERVICE DISCONNECT, LIGHTING AND TRAFFIC SIGNAL	EACH EACH	2 1
•	45' FOOT CLASS 4 TEMPORARY WOOD POLE	•: THIS ITEM INCLUDES FLECTRIC LITTLITY SERVICE COSTS FOR ROTH TEMPORARY LICE	HTING SYSTEMS AS	SSOCIATED WITH

*: THIS ITEM INCLUDES ELECTRIC UTILITY SERVICE COSTS FOR BOTH TEMPORARY LIGHTING SYSTEMS ASSOCIATED WITH THIS PROJECT.

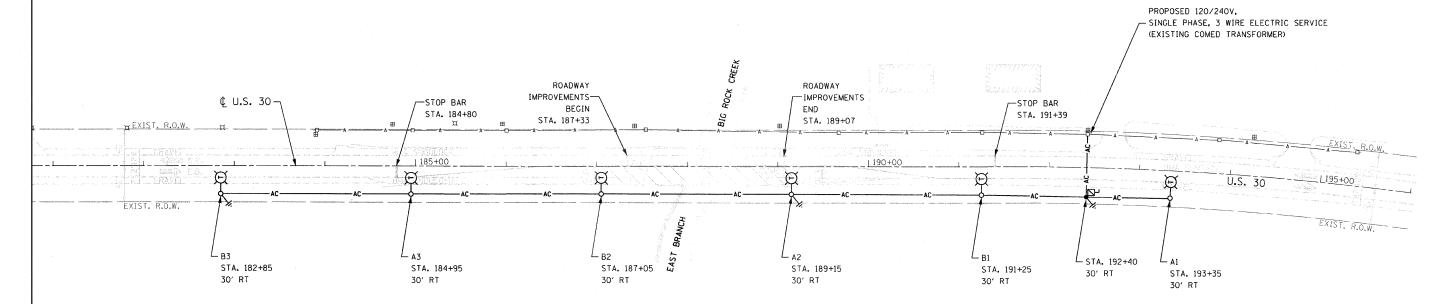

TEMPORARY ROADWAY LIGHTING PLAN

(STAGE I TRAFFIC CONTROL SHOWN)

GENERAL NOTES:

1. THE MATERIALS AND INSTALLATION METHODS SHALL COMPLY WITH THE LATEST CODES, STANDARDS, AND ORDINANCES OF FEDERAL, STATE, AND LOCAL GOVERNING BODIES HAVING JURISDICTION. ALL WORK SHOWN ON THE PLANS AND DESCRIBED ELSEWHERE SHALL CONFORM TO THE LATEST NATIONAL ELECTRICAL CODE.


EXISTING UTILITY POLE

INDICATES CIRCUIT AND POLE NUMBER

- THE CONTRACTOR SHALL CONTACT COMED AS SOON AS POSSIBLE CONCERNING PENDING ELECTRICAL SERVICE INSTALLATION AND CONNECTION TO ENSURE AVAILABILITY OF ELECTRICAL POWER SUPPLY IN A TIMELY MANNER.
- 3. TEMPORARY LIGHTING SHALL BE INSTALLED AND OPERATIONAL BEFORE STAGE I TRAFFIC CONTROL IS IN PLACE. TEMPORARY LIGHTING SHALL REMAIN IN OPERATION DURING BOTH STAGE I AND STAGE II.
- 4. OVERHEAD CABLES SHALL MAINTAIN CLEARANCE FROM GROUND IN ACCORDANCE WITH NATIONAL ELECTRICAL CODE SECTION 225.18.
- 5. GROUND RODS SHALL BE INSTALLED AT EVERY THIRD TEMPORARY LIGHT POLE, AND SHALL BE PAID FOR AS "GROUND ROD, 5/8" DIA. X 10 FT." GROUND WIRES AND CONNECTION OF GROUND RODS AT TEMPORARY LIGHT POLES ARE INCLUDED IN THE COST OF THE GROUND RODS. THE GROUND ROD AT THE SERVICE DISCONNECT BOX IS INCLUDED IN THE COST OF THE ITEM "ELECTRIC SERVICE DISCONNECT, LIGHTING AND TRAFFIC SIGNAL."
- 6. ALL AREAS DISTURBED UNDER THIS CONTRACT SHALL BE RESTORED TO THEIR ORIGINAL CONDITION OR BETTER TO THE SATISFACTION OF THE ENGINEER.
- 7. THE REMOVAL OF TEMPORARY LIGHTING UNITS SHALL INCLUDE ALL POLES, LUMINAIRES, MAST ARMS, MESSENGER WIRES, CABLES, GROUND RODS, AND SERVICE DISCONNECT EQUIPMENT. ALL EQUIPMENT SHALL BECOME PROPERTY OF THE CONTRACTOR AND SHALL BE REMOVED FROM THE SITE.

										RDL-2 OF	F 4
FILE NAME = D16ØE63-RDL-2.dgn		DESIGNED -	R.A.S.	REVISED -		TERROPADY DOADINAY LIQUTING DIANI	F.A.P. RTE.	SECTION	COUNTY	TOTAL SH	EET
PLOT DATE = 1/26/2009	SPAAN Tech, Inc.	DRAWN -	R.P.J.	REVISED -	STATE OF ILLINOIS	TEMPORARY ROADWAY LIGHTING PLAN	573	117 R-2B-R	KANE	SHEETS N	15
€	211 South Worker Drive Suite 2400 phone: 312.277.8800	CHECKED -	I.A.B.	REVISED -	DEPARTMENT OF TRANSPORTATION	U.S. 30 OVER EAST BRANCH BIG ROCK CREEK	313		CONTRACT	NO. 60E	63
	Chicago, Il 60606 seb: www.SpamiTech.com	DATE -	JANUARY 26, 2009	REVISED -		SCALE: 1" = 50' SHEET NO. OF SHEETS STA. 187+33 TO STA. 189+07	FED. ROAD DIST.		PROJECT	1101 001	-

^{••:} THIS ITEM INCLUDES MAINTENANCE OF BOTH TEMPORARY LIGHTING SYSTEMS ASSOCIATED WITH THIS PROJECT.

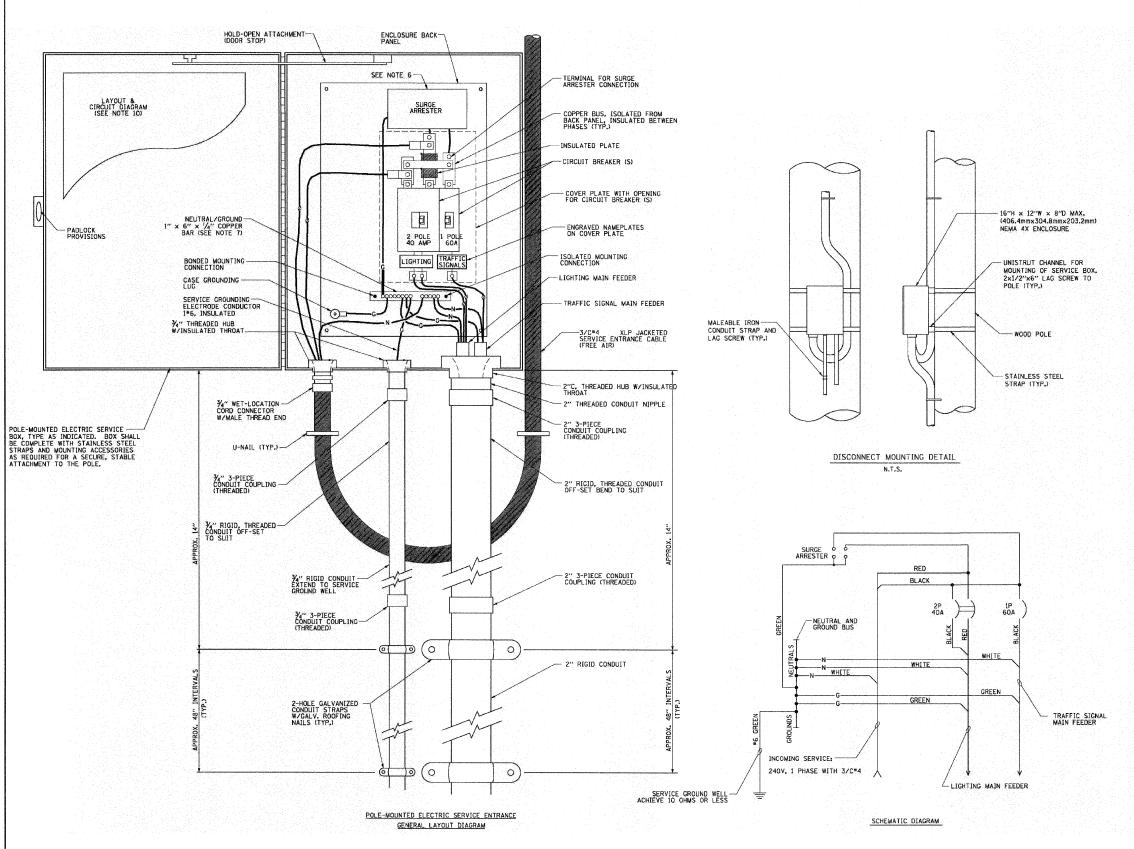

NOTES:

- 1. ELECTRIC SERVICE SHALL BE OF THE VOLTAGE INDICATED OR DESIGNATED BY THE ENGINEER, AND SERVICE DROP CABLE SHALL BE COMPATIBLE WITH THE SERVICE ACCORDINGLY, SOME INSTALLATIONS MAY CALL FOR SERVICE ENTRANCE EQUIPMENT SULTABLE FOR 3-WIRE SERVICE EVEN THOUGH INITIALLY WIRED FOR 2-WIRE SERVICE.
- 2. THE POLE-MOUNTED ELECTRIC SERVICE BOX DETAIL DEPICTS
 THE BASIC CONSTRUCTION OF THE EQUIPMENT. SLIGHT
 MODIFICATIONS APPLY FOR DIFFERING SERVICES AND
 APPLICATIONS AS FOLLOWS:
 - TYPE A FULLY EQUIPPED FOR 240/120V. 3W SERVICE, COMPLETE WITH LIGHTING MAIN BREAKER
 - TYPE AL FULLY EQUIPPED FOR 240/120V. 3W SERVICE. BLANK COVER IN LIEU OF LIGHTING MAIN BREAKER
 - EQUIPPED FOR 120V. SERVICE, COMPLETE WITH 1P, 60A. TRAFFIC SIGNALS MAIN BREAKER

 - TYPE B1 EQUIPPED FOR 120V. SERVICE, COMPLETE WITH 1P, 40A. TRAFFIC SURVEILLANCE MAIN BREAKER
- 3. THE ELECTRIC SERVICE EQUIPMENT ASSEMBLY SHALL BE UL LISTED AS SUITABLE FOR USE AS SERVICE ENTRANCE EQUIPMENT.
- 4. THE ELECTRIC SERVICE EQUIPMENT ENCLOSURE SHALL BE
 NEMA 4X STAINLESS STEEL, NOMINALLY 12"W X 16"H X 8"D, WITH
 A PIANO-HINGED DOOR, STEEL BACK PANEL, FAST-ACTING
 STAINLESS STEEL ENCLOSURE CLAMPS, PADLOCK PROVISIONS
 AND DOOR STOP, HOFFMAN CATALOG NO. A-16H1208SS6LP/A-16
 P12/A-DSTOPK/C-PMK12, OR APPROVED EQUAL.
- 5. CIRCUIT BREAKERS SHALL BE THERMAL MAGNETIC BOLT-ON TYPE WITH A MINIMUM INTERRUPTING CAPACITY OF 25,000 SYMMETRICAL AMPERES AT 240 VOLTS. THEY SHALL BE LOCKABLE IN THE "OFF" POSITION FOR COMPLIANCE WITH OSHA LOCK-OUT/
- 6. THE SURGE PROTECTOR SHALL BE SUITABLE FOR 240/120 VOLT SINGLE PHASE 60HZ AC ELECTRICAL SERVICE, WITH A SURGE ENERGY CAPABILITY OF 2160 JOULES OR BETTER AT 8/20 MICRO-SECONDS, RATED -40 TO 60 DEGREES C, WITH LED OPERATING INDICATORS, AND SHALL BE UL LISTED PER UL 1449, CUTLER-HAMMER
- 7. BUS BARS, CONNECTORS, AND LUGS SHALL BE COPPER, INSULATED AND ISCLATED, AND CONFIGURED TO PREVENT SHORTED CONDITIONS FROM TIGHTENING TERMINATIONS, ETC. THE OVERALL BUS SECTION SHALL BE CONFIGURED BEHIND AN INSULATING BARRIER SHIELD WHICH IS REMOVABLE FOR ACCESS TO CONNECTIONS, OR THE ASSEMBLY SHALL BE A MANUFACTURED SPECIALTY PANELBOARD, CUTLER-HAMMER PRL2A OR APPROVED EDUAL
- B. THE COMBINATION GROUND AND NEUTRAL BAR SHALL BE CONFIGURED WITH SEPARATE GROUND AND NEUTRAL SECTIONS AND SPARE TERMINALS AS INDICATED. THE HEADS OF GROUND SCREWS SHALL BE PAINTED GREEN. THE HEADS OF NEUTRAL SCREWS SHALL BE PAINTED WHITE. THE SERVICE NEUTRAL AND SERVICE GROUNDING ELECTRODE CONDUCTOR SHALL BE TERMINATED ADJACENT TO EACH OTHER AT THE DIVIDE BETWEEN THE SECTIONS AND WIRING SHALL BE TERMINATED ONLY UPON THE APPROPRIATE SECTION.
- THE WIRING TERMINALS, INCLUDING THE GROUND/NEUTRAL BAR SHALL BE ARRANGED TO PROVIDE ADEQUATE ROOM FOR PERFORMING FIELD TERMINATIONS.
- A PLASTIC LAMINATED LAYOUT AND CIRCUIT DIAGRAM SHALL BE MECHANICALLY SECURED TO THE INTERIOR SIDE OF THE ENCLOSURE DOOR.
- A 2-COLOR ENGRAVED PLASTIC NAMEPLATE, ATTACHED WITH SCREWS, AND ENGRAVED AS INDICATED, SHALL BE PROVIDED FOR EACH MAIN
- 12. LUGS AND CONNECTORS SHALL BE RATED FOR 75°C CONDUCTOR.
- 13. THE EXACT MOUNTING HEIGHT OF THE BOX SHALL BE FIELD DETERMINED TO AVOID OBSTRUCTIONS AND PUBLIC ACCESS. TYPICAL HEIGHT SHALL BE APPROXIMATELY 10 FEET ABOVE GRADE.

SECTION

117 R-2B-R

FED. ROAD DIST. NO. 1 ILLINOIS FED. AID PROJECT

RDL-3 OF


COUNTY TOTAL SHEE SHEETS NO. KANE 40 16

U.S. 30 OVER EAST & WEST BRANCH BIG ROCK CREEK SCALE: NONE SHEET NO. OF SHEETS STA.

ILE NAME = D16ØE63-RDL-3.dgn PLOT DATE = 1/26/2009

DESIGNED - R.A.S. REVISED SPAAN Tech, Inc. DRAWN - R.P.J. REVISED CHECKED - I.A.B. REVISED DATE JANUARY 26, 2009 REVISED


ELECTRIC SERVICE DISCONNECT, LIGHTING AND TRAFFIC SIGNAL STATE OF ILLINOIS **DEPARTMENT OF TRANSPORTATION**

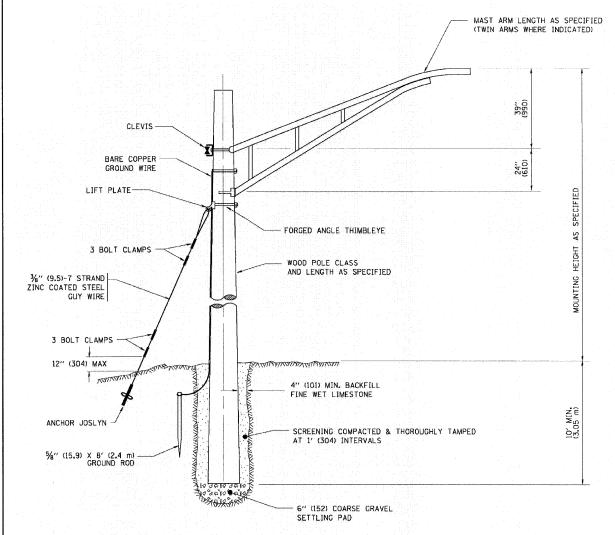


TEMPORARY LIGHT POLE DETAIL

NOTES:

1. ALL DIMENSIONS IN INCHES (MILLIMETERS)
UNLESS OTHERWISE INDICATED

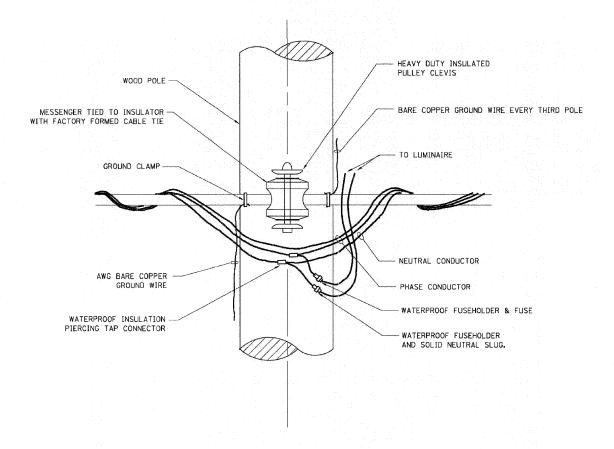

TEMPORARY LIGHT POLE ATTACHMENT DETAIL

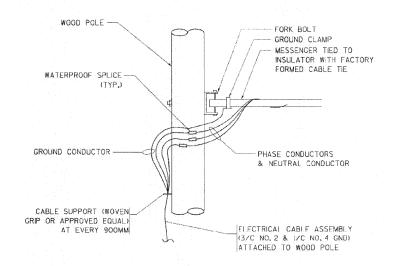

AERIAL CABLE CONNECTION DETAIL N.T.S.

FILE NAME = D160E63-RDL-4.dgn PLOT DATE = 1/26/2009

DESIGNED - R.A.S. REVISED SPAAN Tech, Inc. DRAWN - R.P.J. REVISED CHECKED - I.A.B. REVISED 311 South Wacker Drive, Suite 2400 phone: 312.277.8800 fax: 312.277.8808 Chicago, II 60606 phone: 312.277.8808 web: www.SpantTech.com DATE JANUARY 26, 2009 REVISED


STATE OF ILLINOIS **DEPARTMENT OF TRANSPORTATION**

	U.S. 30	OVER			Y LIGH WEST				CREEK	
SCALE:	NONE:	SHEET	NO.	OF	SHEE	TS	STA.	Т	O STA.	

TOTAL SHEET NO. 40 17 COUNTY SECTION KANE CONTRACT NO. 60E63

RDI -4 OF 4

117 R-2B-R

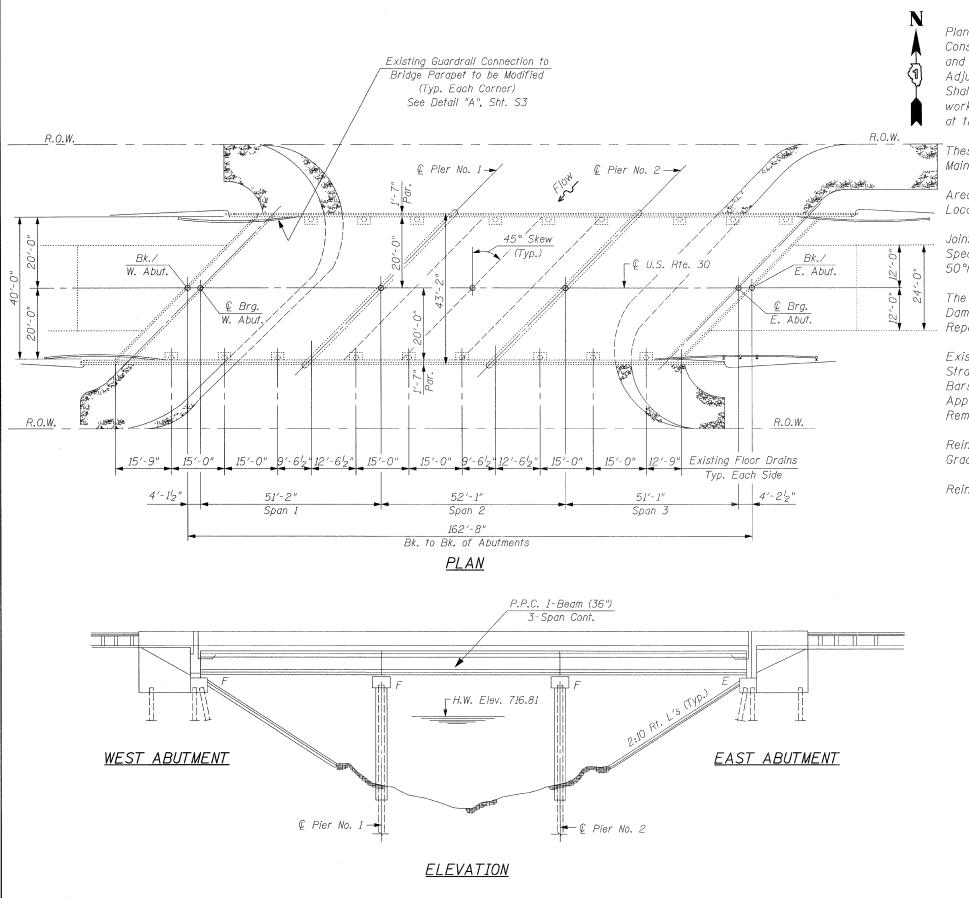

GENERAL NOTES:

Plan Dimensions and Details Relative to Existing Plans are Subject to Nominal Construction Variations. The Contractor Shall Field Verify Existing Dimensions and Details Affecting new Construction and Make Necessary Approved Adjustments Prior to Construction or Ordering of Materials. Such Variations Shall not be Cause for Additional Compensation for a Change in Scope of the work, However, the Contractor will be Paid for the Quantity Actually Furnished at the Unit Price Bid for the Work.

These Plans Have Been Prepared From Notes Received From I.D.O.T. Field Maintenance Engineers.

Areas of Deck Repairs Shown are Estimated. The Engineer Shall Show Actual Locations of Deck Repairs on As-Built Plans.

Joint Openings Shall be Adjusted According to Article 520.04 of the Standard Specifications when the Deck is Poured at an Ambient Temperature Other Than 50°F.

The Contractor Shall use Extreme Care During Concrete Removal so as not to Damage the PPC I-Beams. Any Damage Done to the PPC I-Beams is to be Repaired by the Contractor at the Contractor's Expense.

Existing Reinforcement Bars Extending into the Removal Area Shall be Cleaned, Straightened and Incorporated Into the New Construction. Any Reinforcement Bars that are Damaged During Concrete Removal Shall be Replaced With an Approved Bar Splicer or Anchorage System. Cost is Included With Concrete Removal.

Reinforcement Bars Shall Conform to the Requirements of ASTM A-706, Grade 60. See Special Provisions.

Reinforcement Bars Designated (E) Shall be Epoxy Coated.


TOTAL BILL OF MATERIAL


ITEM	UNIT	QUANTITY
Bridge Deck Hydro-Scarification, ½ Inch	Sq. Yd.	672
Bridge Deck Latex Concrete Overlay, 21/4 Inch	Sq. Yd.	672
Bridge Deck Grooving	Sq. Yd.	666
Reinforcement Bars, Epoxy Coated	Pound	2,490
Concrete Removal	Cu. Yd.	16.4
Concrete Superstructure	Cu. Yd.	17.6
Preformed Joint Strip Seal	Foot	118
Bar Splicers	Each	22
Protective Coat	Sq. Yd.	708





CHRISTIAN-ROGE & ASSOCIATES, INC.
ENGINEERS / PLANNERS / SURVEYORS
211 W. WACKER DRIVE CHICAGO, IL. 60606
PHONE: (312)372-2023 FAX: (312)372-5274

FILE NAME =	USER NAME = IDOT	DESIGNED - B.N.S.	REVISED -			GENERAL PLAN & E	I EVATION		F.A.P. SECTI	ON COUNTY	TOTAL SHEET
plan_elevation.dgn		DRAWN ~ F.M.	REVISED -	STATE OF ILLINOIS				CDEEK	573 117 R-2	B-R KANE	40 18
ì	PLOT SCALE = 50.0000 '/ IN.	CHECKED - B.N.S./J.C.N.	REVISED ~	DEPARTMENT OF TRANSPORTATION		U.S. 30 OVER WEST BRANCH	DIG NOCK	S.N. 045-2005	i i		T NO. 60E63
	PLOT DATE = 1/26/2009	DATE - JANUARY 27, 2009	REVISED -		SCALE:	SHEET NO. S1 OF S18 SHEETS	STA.	TO STA.	FED. ROAD DIST. NO. 1 IL	LINOIS FED. AID PROJECT	

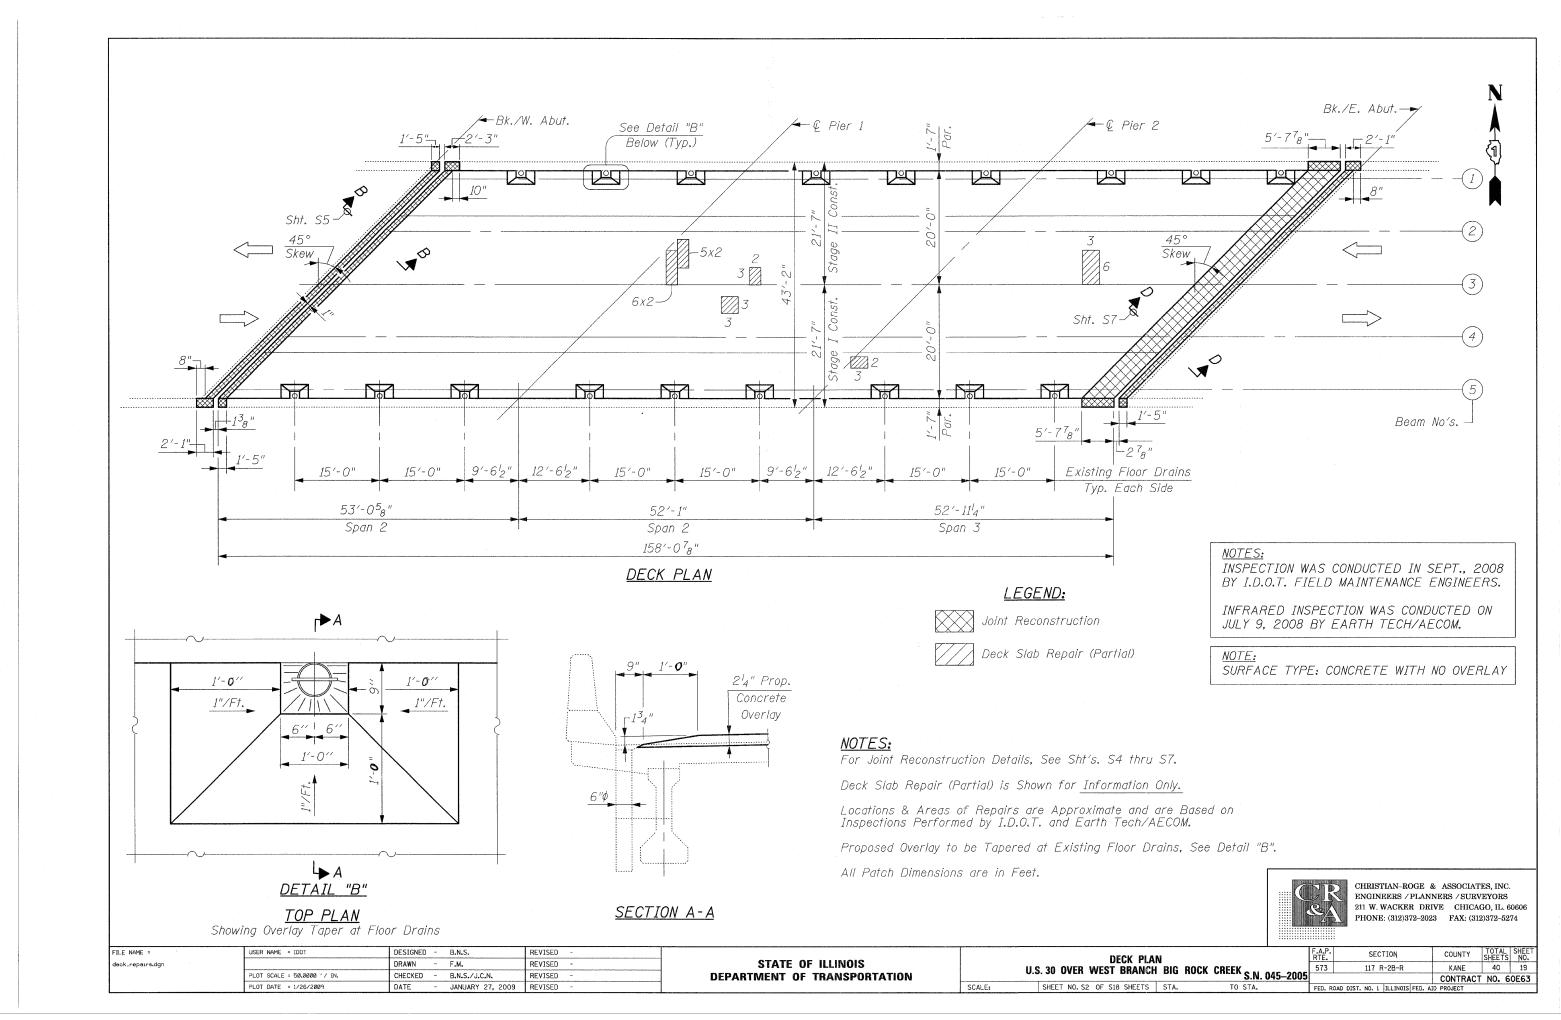

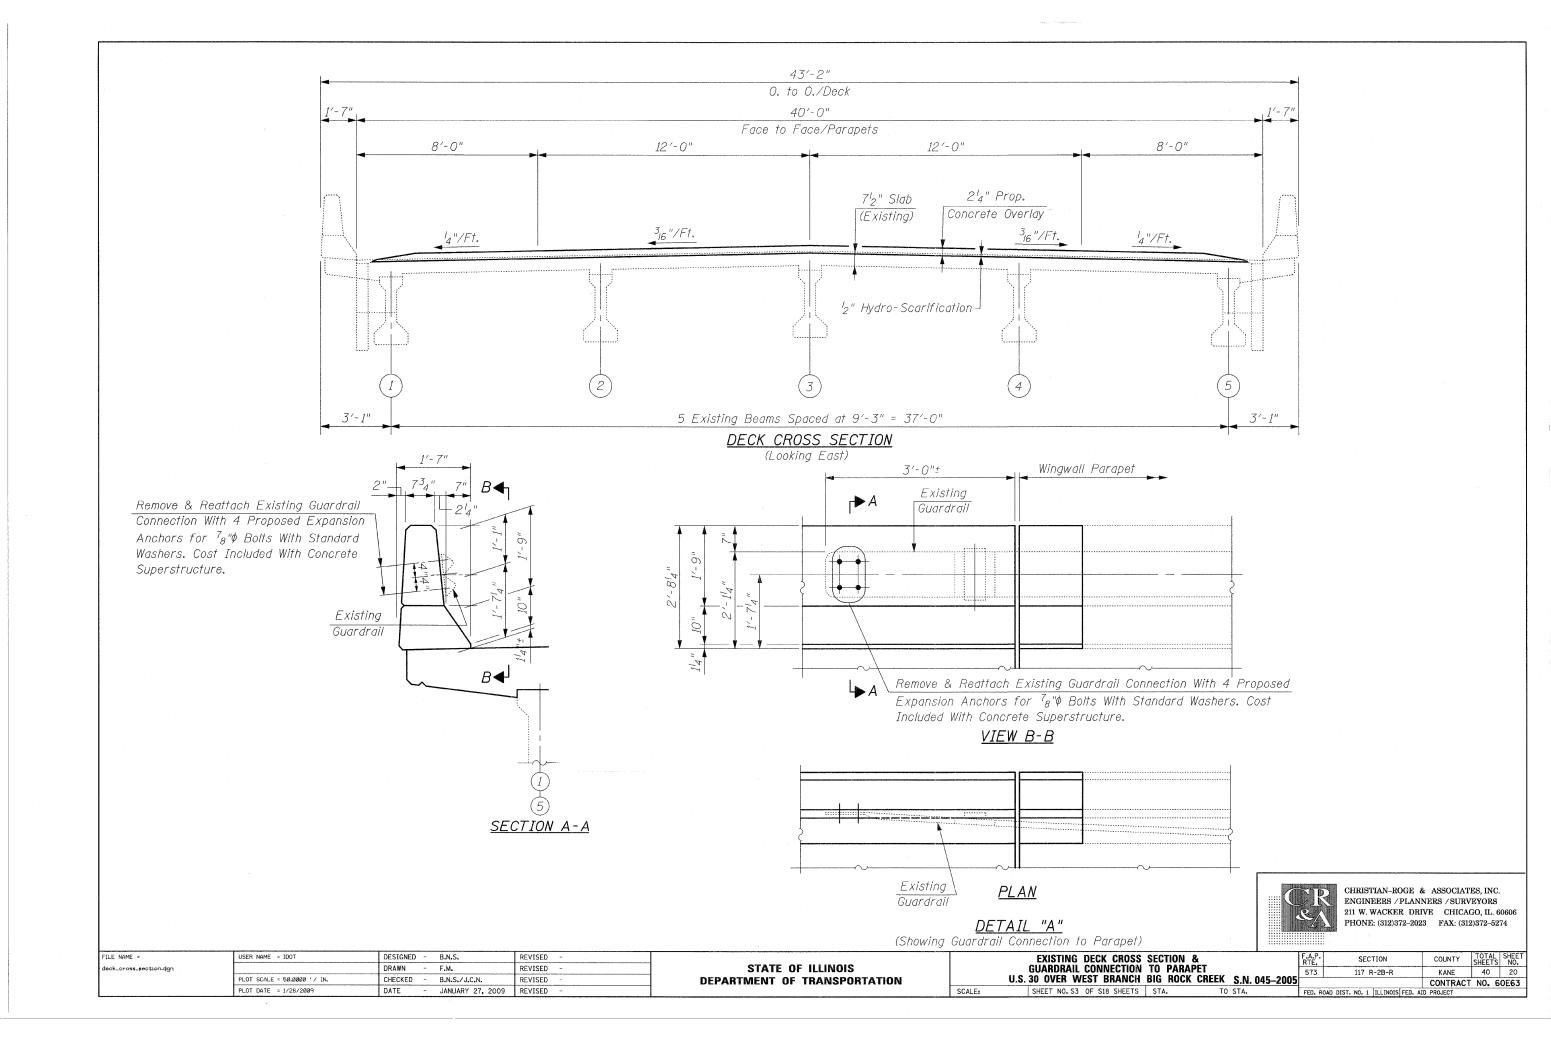

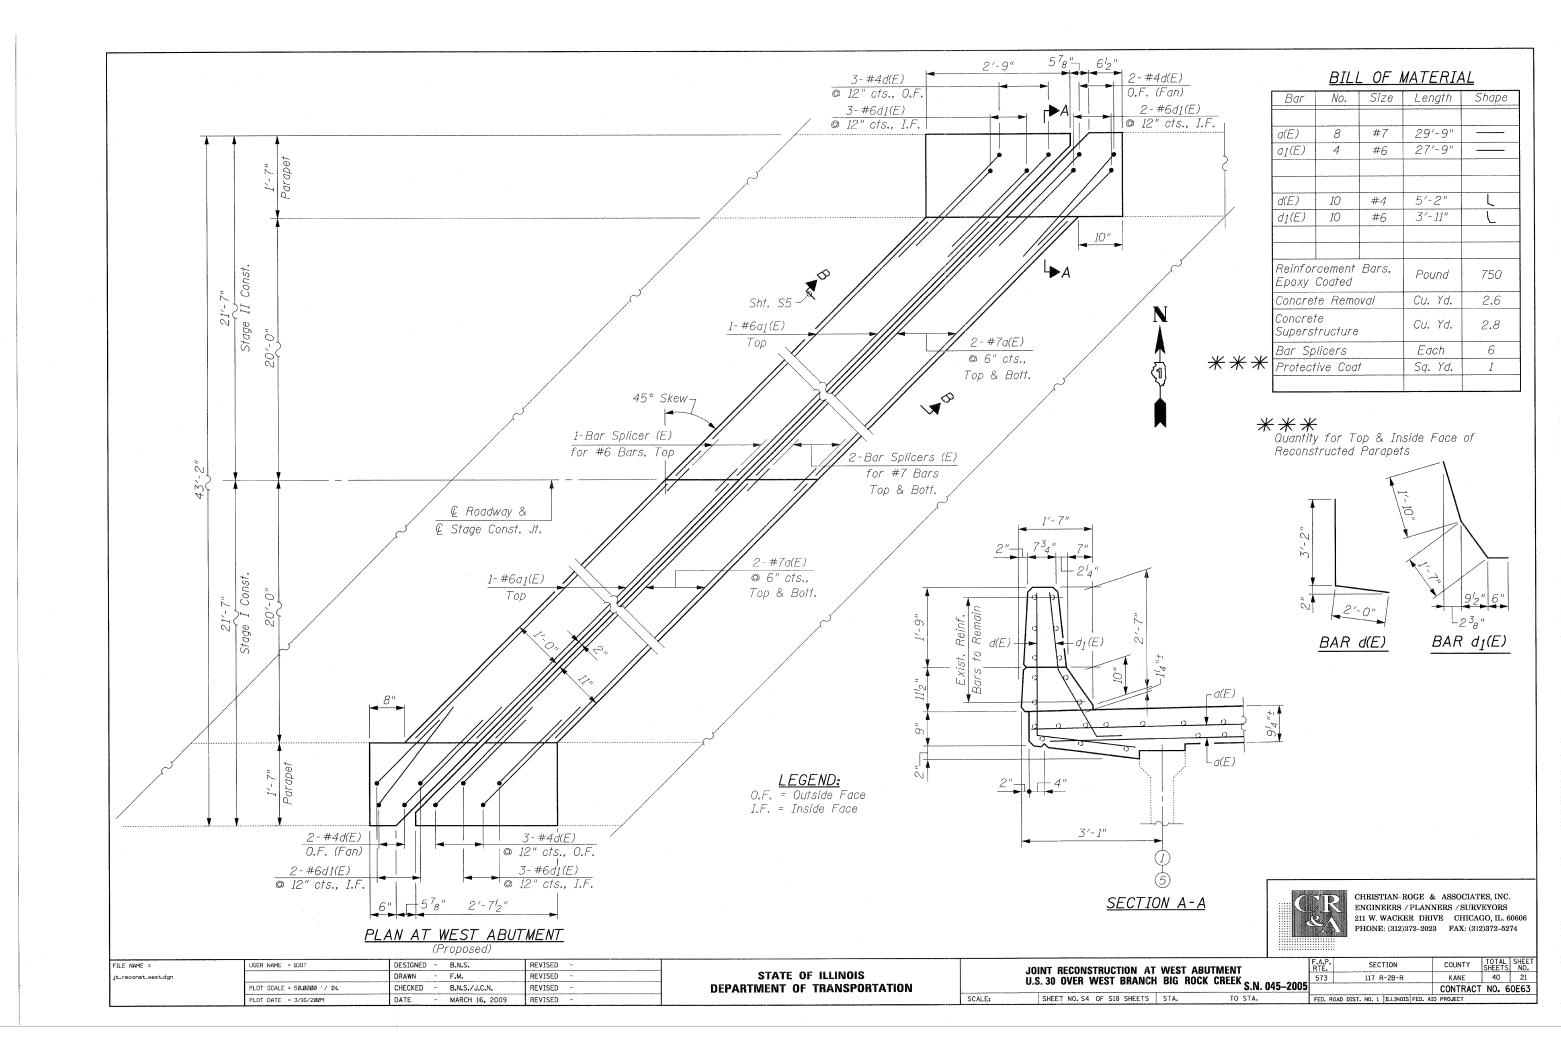

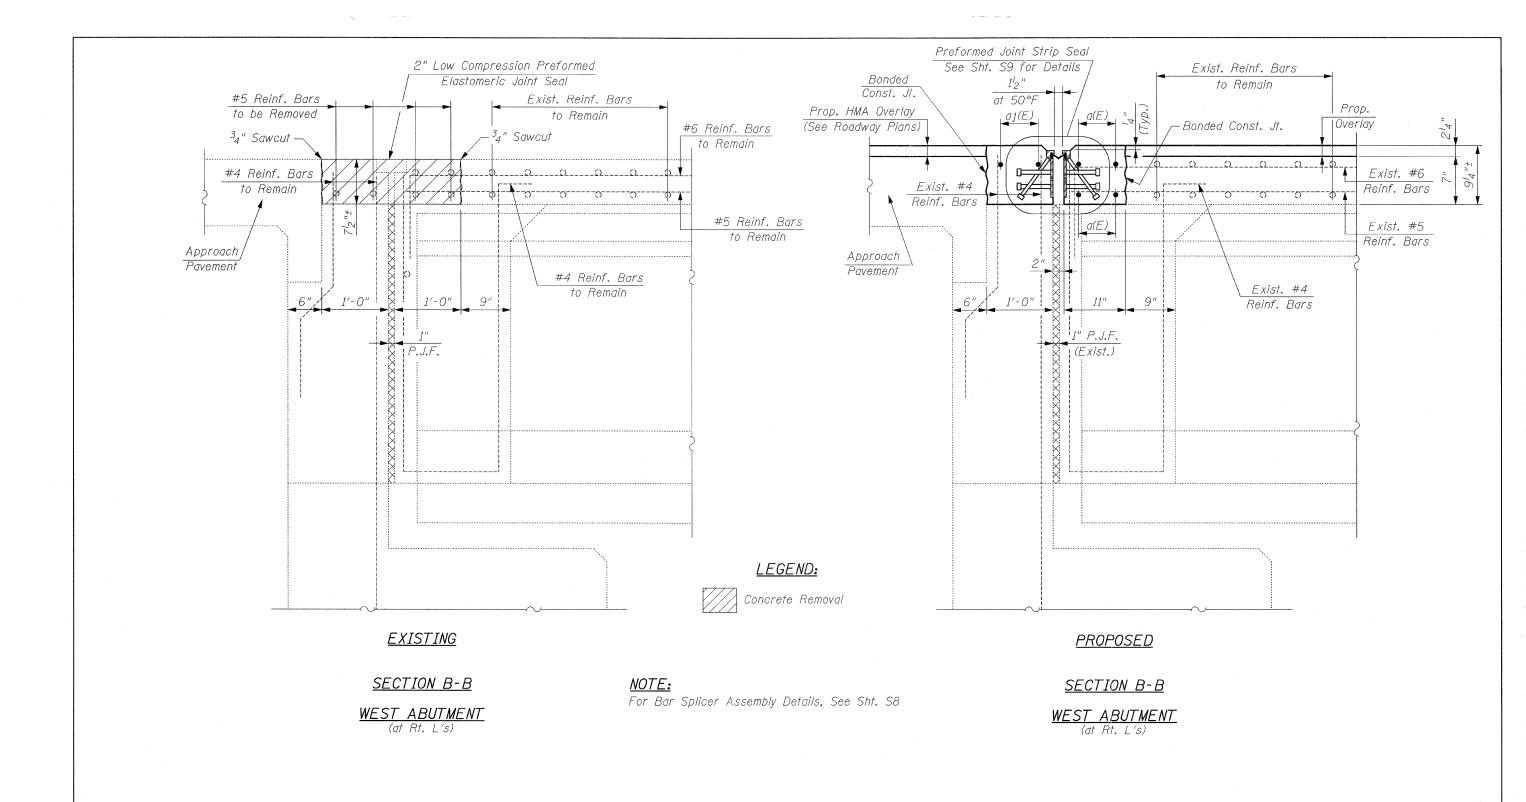

NOTE:

Dimensions are Based on a Rolled Rail Strip Seal Joint. If the Contractor elects to use the Welded Rail Strip Seal Joint, Deck Dimensions may Require Adjustments to Match the Details on Sht. S9

SCALE:




CHRISTIAN-ROGE & ASSOCIATES, INC.
ENGINEERS / PLANNERS / SURVEYORS
211 W. WACKER DRIVE CHICAGO, IL. 60606
PHONE: (312)372-2023 FAX: (312)372-5274


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Jt_reconst_west_details.dgn		DRAWN -	F.M.		REVISED			
	PLOT SCALE = 50.0000 '/ IN.	CHECKED -	B.N.S./J.C.N.		REVISED			
	PLOT DATE = 1/26/2009	DATE -	JANUARY 27, 20	009	REVISED	-		

STATE OF ILLINOIS
DEPARTMENT OF TRANSPORTATION

JOINT RECONSTRUCTION U.S. 30 OVER WEST	DETAILS BRANCH	AT WEST BIG ROCK	ABUTMENT CREEK S.N. 045-	-200
SHEET NO SE OF SIE	SHEETS	STA	TO STA	

F.A.P. RTE.		SEC	CTION			COUNTY	TOTAL SHEETS	SHEE NO.
573	117 R-2B-R					KANE	40	22
					Т	CONTRACT	NO. 6	0E63
FED. R	DAD DIST.	NO. 1	ILLINOIS	FED.	AID	PROJECT		

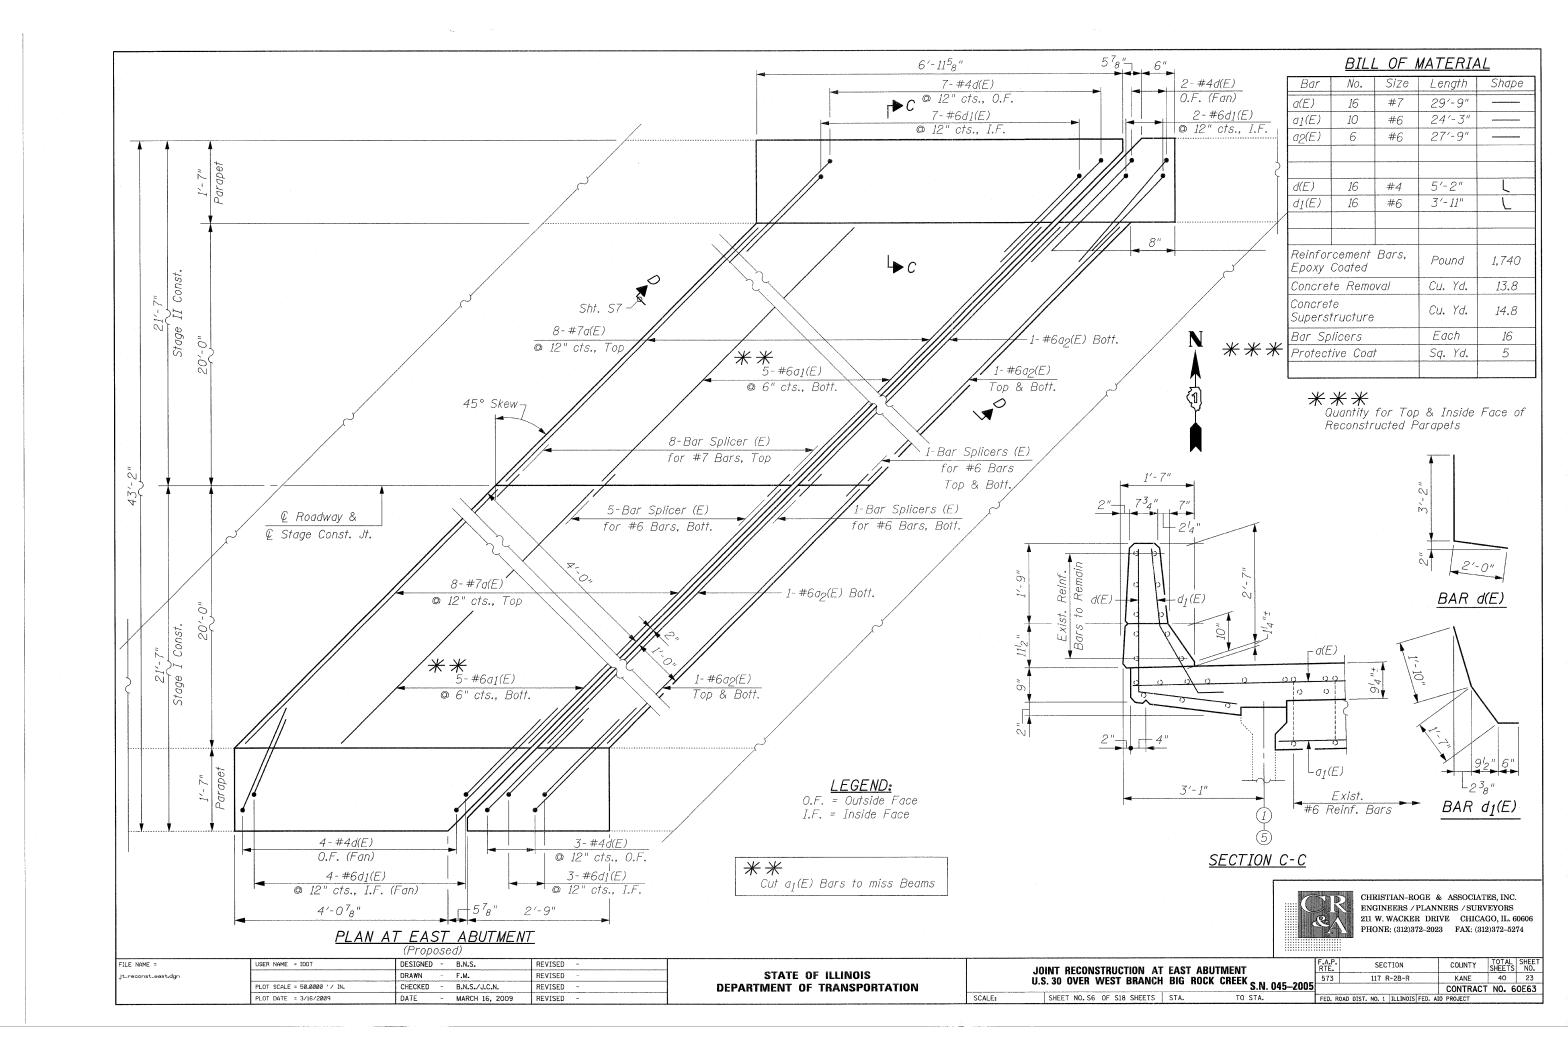

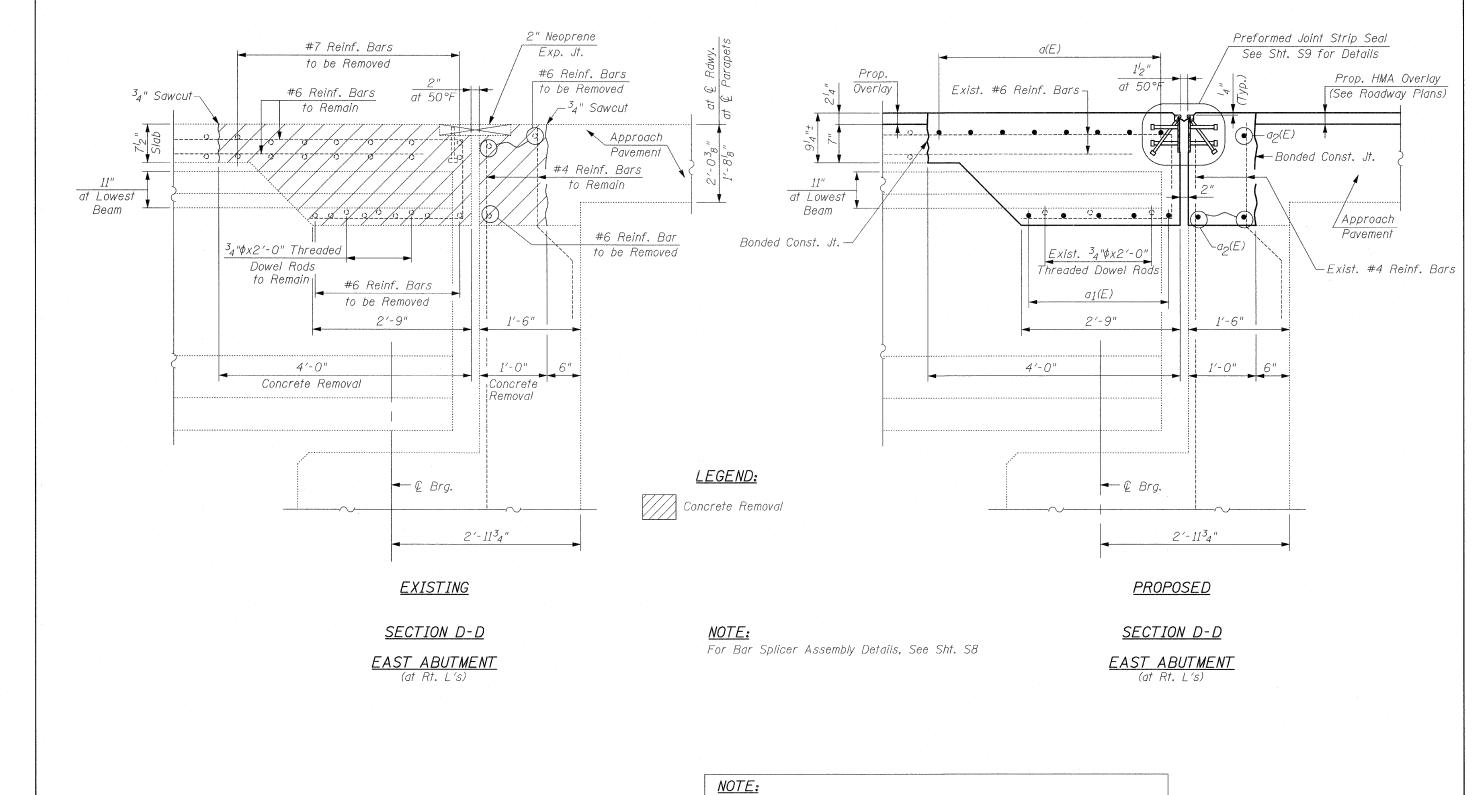

Dimensions are Based on a Rolled Rail Strip Seal Joint. If the Contractor elects to use the Welded Rail Strip Seal Joint, Deck Dimensions may Require Adjustments to Match the Details on Sht. S9

SCALE:




CHRISTIAN-ROGE & ASSOCIATES, INC.
ENGINEERS / PLANNERS / SURVEYORS
211 W. WACKER DRIVE CHICAGO, IL. 60606
PHONE: (312)372-2023 FAX: (312)372-5274

FILE NAME #	USER NAME = IDDT	DESIGNED -	B.N.S.	REVISED -	
jt_reconst_east_detq:le.dgn	7.	DRAWN -	F.M.	REVISED -	
	PLOT SCALE = 50.0000 '/ IN.	CHECKED -	B.N.S./J.C.N.	REVISED -	
	PLOT DATE = 1/26/2009	DATE -	JANUARY 27, 2009	REVISED -	

STATE OF ILLINOIS
DEPARTMENT OF TRANSPORTATION

JOINT U.S	RECONSTR S. 30 OVER	UCTION WEST	DETAILS BRANCH	AT Big	EAST ROCK	ABUTMENT CREEK S.N.	045–200
	SHEET NO. S	7 OF S18	SHEETS	STA.		TO STA.	

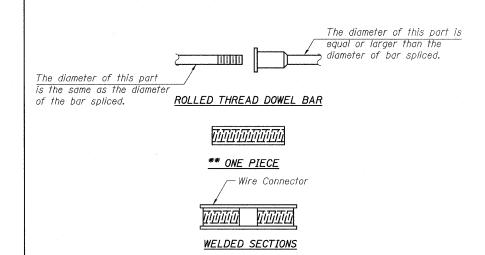

BAR SPLICER ASSEMBLY ALTERNATIVES


**Heavy Hex Nuts conforming to ASTM A 563, Grade C, D or DH may be used.

Bridge Deck

4'-0"

Threaded or Coil

Loop Couplers (E)

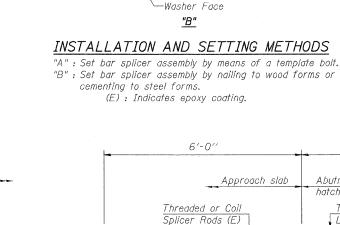

Reinforcement bars

Template

Bolt

Forms-

Stage Construction Line

-Foam Plugs

Threaded or Coil Splicer Rods (E)

Abutment hatch block

Threaded or Coil

Loop Couplers (E)

SCALE:

<u>"A"</u>

FOR INTEGRAL OR SEMI-INTEGRAL ABUTMENTS

Approach Slab

6'-0"

Threaded or Coil

Splicer Rods (E)

Bar Splicer for #5 bar Min. Capacity = 23.0 kips - tension Min. Pull-out Strength = 12.3 kips - tension No. Required = -

Bar Splicer for #5 bar Min. Capacity = 23.0 kips - tension Min. Pull-out Strength = 12.3 kips - tension No. Required = -

FOR STUB

ABUTMENTS

NOTES

Bar splicer assemblies shall be of an approved type and shall develop in tension at least 125 percent of the yield strength of the lapped reinforcement bars.

Splicer rods shall be of minimum 60 ksi yield strength, threaded or coiled full length. All reinforcement bars shall be lapped and tied to the splicer rods or dowel bars. Bar splicer assemblies shall be epoxy coated according to the requirements for reinforcement bars.


Other systems of similar design may be submitted to the Engineer for approval. Approval shall be based on certified test results from an approved testing laboratory that the proposed bar splicer assembly satisfies the following requirements:

Minimum Capacity = $1.25 \times fy \times A_t$

Minimum *Pull-out Strength = $0.66 \times fy \times A_t$ (Tension in kips)

Where fy = Yield strength of lapped reinforcement bars in ksi. A_t = Tensile stress area of lapped reinforcement bars. * = 28 day concrete

	BAR SPLICER ASSEMBLIES								
		Strength Requirements							
Bar Size to be Spliced	Splicer Rod or Dowel Bar Length 		Min. Pull-Out Strength kips - tension						
#4	1′-8′′	14.7	7.9						
#5	2'-2"	23.0	12.3						
#6	2'-7"	33.1	17.4						
#7	3′-5′′	45.1	23.8						
#8	4'-6''	58.9	31.3						
#9	5′-9″	75.0	39.6						
#10	7′-3′′	95.0	50.3						
#11	9'-0''	117.4	61.8						

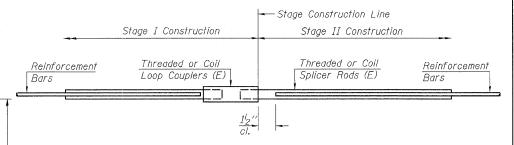

STANDARD

	Bar Size	No. Assemblies Required	Location		
	#6	8	East Abutment		
T	#7	8	East Abutment		
	#6	2	We at Abuston at		
	#7	4	West Abutmeni		

BAR SPLICER ASSEMBLY DETAILS STRUCTURE NO. 045-2005



CHRISTIAN-ROGE & ASSOCIATES, INC. ENGINEERS / PLANNERS / SURVEYORS 211 W. WACKER DRIVE CHICAGO, IL. 60606 PHONE: (312)372-2023 FAX: (312)372-5274

BSD-1 10-1-08

Reinforcement


Bars


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bar_splicer.dgn		DRAWN	-	F.M.	REVISED -
	PLOT SCALE = 50.00000 '/ IN.	CHECKED	~	B.N.S./J.C.N.	REVISED -
	PLOT DATE = 1/26/2009	DATE	-	JANUARY 27, 2009	REVISED -

STATE OF ILLINOIS **DEPARTMENT OF TRANSPORTATION**

BAR SPLICER ASSEMBLY DETAILS U.S. 30 OVER WEST BRANCH BIG ROCK CREEK S.N. 045-2005 SHEET NO. S8 OF S18 SHEETS STA. TO STA.

TOTAL SHEET SHEETS NO. SECTION COLINTY KANE 573 117 R-2B-R CONTRACT NO. 60E63

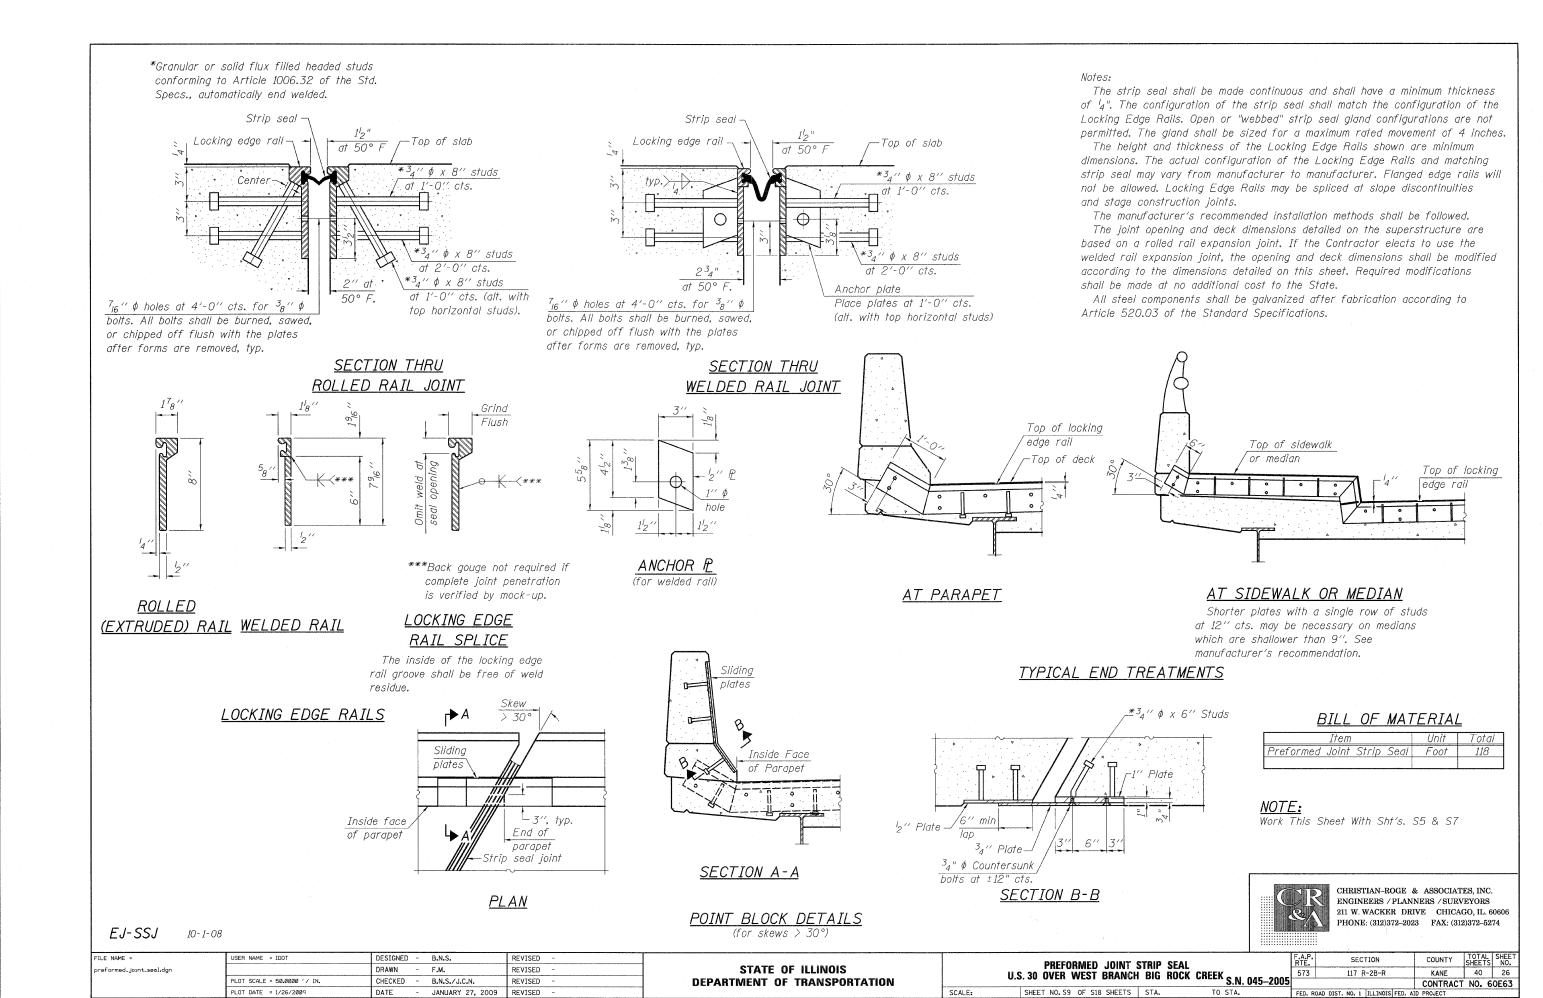

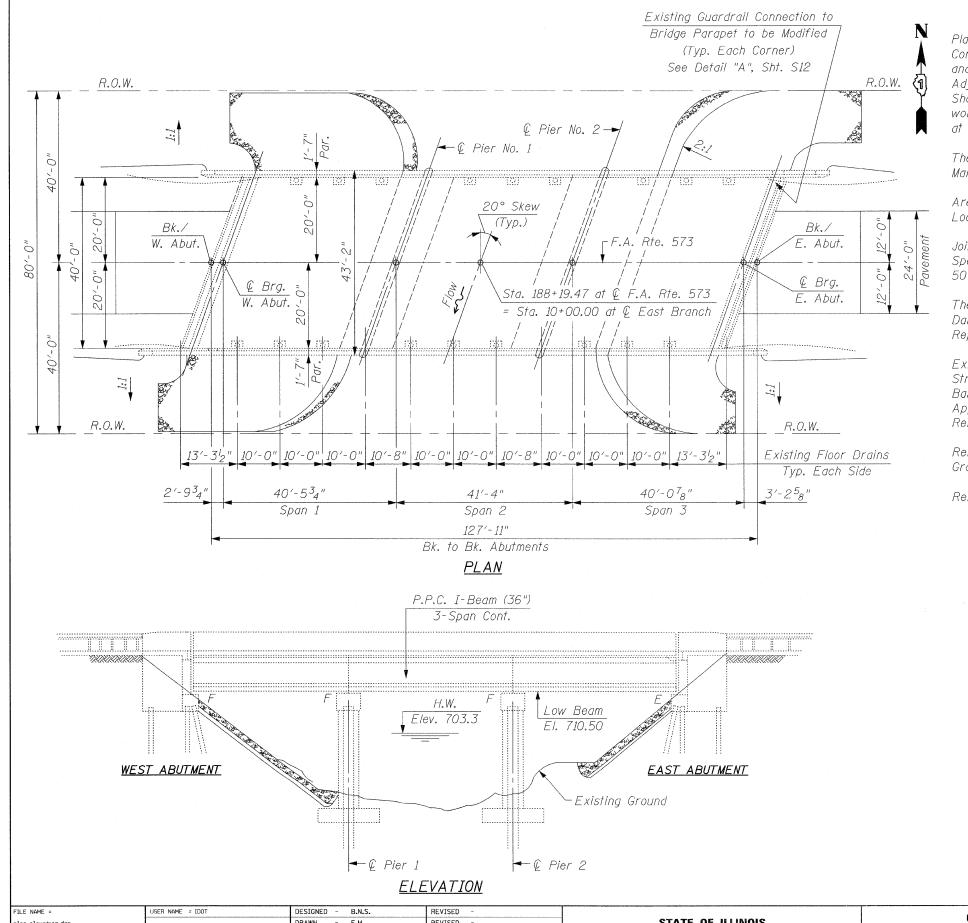

GENERAL NOTES:

Plan Dimensions and Details Relative to Existing Plans are Subject to Nominal Construction Variations. The Contractor Shall Field Verify Existing Dimensions and Details Affecting new Construction and Make Necessary Approved Adjustments Prior to Construction or Ordering of Materials. Such Variations Shall not be Cause for Additional Compensation for a Change in Scope of the work, However, the Contractor will be Paid for the Quantity Actually Furnished at the Unit Price Bid for the Work.

These Plans Have Been Prepared From Notes Received From I.D.O.T. Field Maintenance Engineers.

Areas of Deck Repairs Shown are Estimated. The Engineer Shall Show Actual Locations of Deck Repairs on As-Built Plans.

Joint Openings Shall be Adjusted According to Article 520.04 of the Standard Specifications when the Deck is Poured at an Ambient Temperature Other Than 50°F.

The Contractor Shall use Extreme Care During Concrete Removal so as not to Damage the PPC I-Beams. Any Damage Done to the PPC I-Beams is to be Repaired by the Contractor at the Contractor's Expense.

Existing Reinforcement Bars Extending into the Removal Area Shall be Cleaned, Straightened and Incorporated Into the New Construction. Any Reinforcement Bars that are Damaged During Concrete Removal Shall be Replaced With an Approved Bar Splicer or Anchorage System. Cost is Included With Concrete Removal.

Reinforcement Bars Shall Conform to the Requirements of ASTM A-706, Grade 60. See Special Provisions.

Reinforcement Bars Designated (E) Shall be Epoxy Coated.

TOTAL BILL OF MATERIAL

ITEM	UNIT	QUANTITY
Bridge Deck Hydro-Scarification, 1/2 Inch	Sq. Yd.	515
Bridge Deck Latex Concrete Overlay, 2 ¹ 4 Inch	Sq. Yd.	515
Bridge Deck Grooving	Sq. Yd.	524
Reinforcement Bars, Epoxy Coated	Pound	4,170
Concrete Removal	Cu. Yd.	23.1
Concrete Superstructure	Cu. Yd.	25.5
Preformed Joint Strip Seal	Foot	90
Bar Splicers	Each	32
Protective Coat	Sq. Yd.	561





CHRISTIAN-ROGE & ASSOCIATES, INC.
ENGINEERS / PLANNERS / SURVEYORS
211 W. WACKER DRIVE CHICAGO, IL. 60606
PHONE: (312)372-2023 FAX: (312)372-5274

STATE OF ILLINOIS
DEPARTMENT OF TRANSPORTATION

SCALE:

GENERAL PLAN & ELEVATION
U.S. 30 OVER EAST BRANCH BIG ROCK CREEK
S.N. 045-2006
| SHEET NO. S10 OF S18 SHEETS | STA. TO STA.

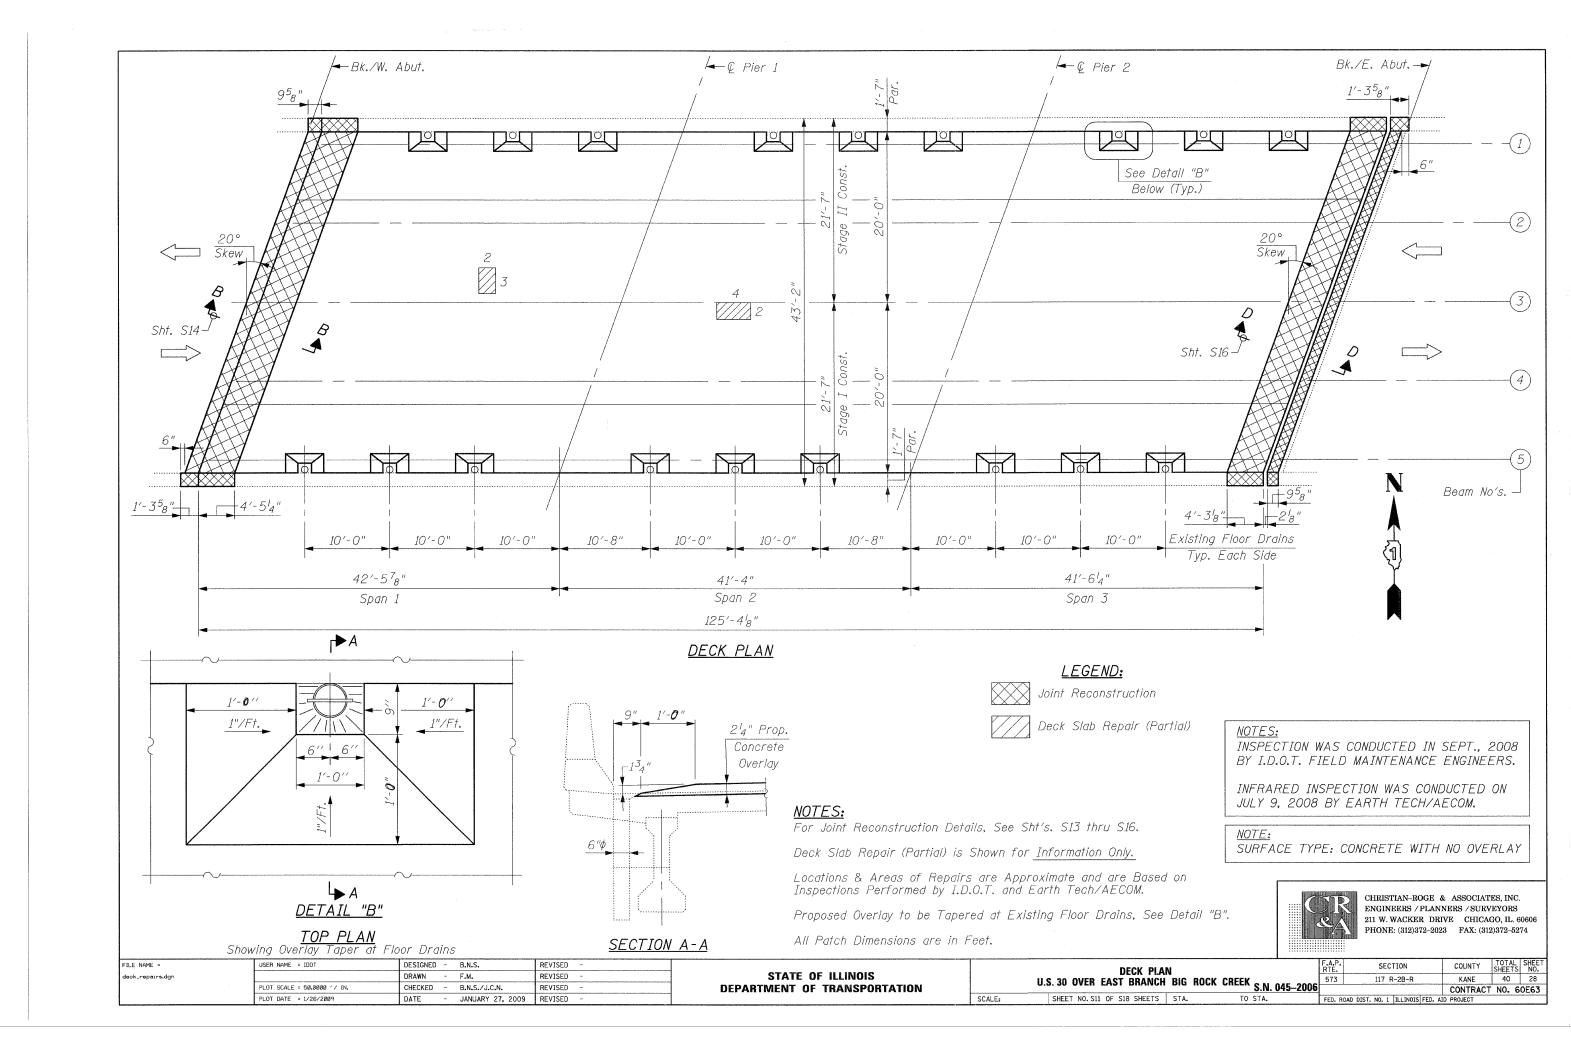

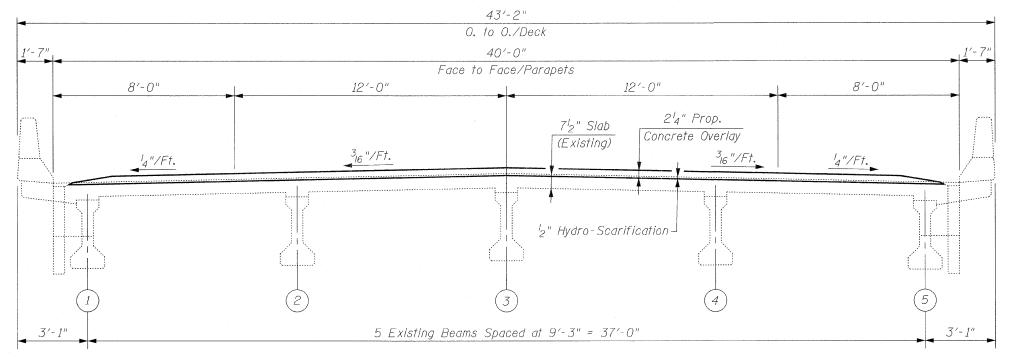

DECK CROSS SECTION (Looking East)


STATE OF ILLINOIS DEPARTMENT OF TRANSPORTATION

Existing

Guardrail

<u>PLAN</u>

DETAIL "A"

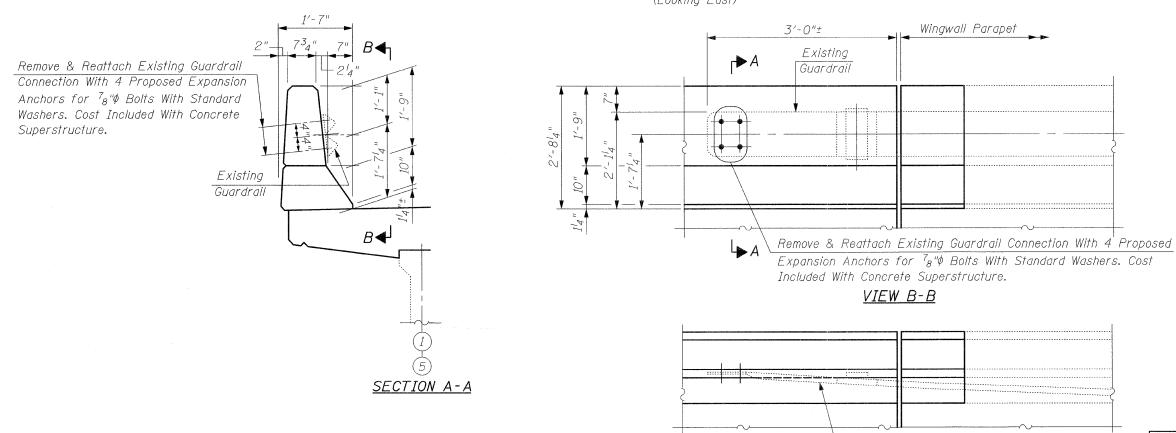




CHRISTIAN-ROGE & ASSOCIATES, INC. ENGINEERS / PLANNERS / SURVEYORS 211 W. WACKER DRIVE CHICAGO, IL. 60606 PHONE: (312)372-2023 FAX: (312)372-5274


(Showing Guardrail Connection to Parapet)

EXISTING DECK CROSS SECTION & F.R. GUARDRAIL CONNECTION TO PARAPET U.S. 30 OVER EAST BRANCH BIG ROCK CREEK S.N. 045–2006 SCALE: SHEET NO. S12 OF S18 SHEETS STA.

.A.P	•	SE	CTION			COUNTY	TOTAL SHEETS	SHEET NO.
573		117	R-2B-R		T	KANE	40	29
						CONTRACT	NO. 6	0E63
ED.	ROAD DIST.	NO.	I ILLINO	IS FED.	AID	PROJECT		

FILE NAME =	USER NAME = IDOT	DESIGNED	-	B.N.S.	REVISED -	
deck_cross_section.dgn		DRAWN	-	F.M.	REVISED -	
	PLOT SCALE = 50.00000 '/ IN.	CHECKED	-	B.N.S./J.C.N.	REVISED -	
	PLOT DATE = 1/26/2009	DATE		IANUARY 27 2009	DEVISED -	

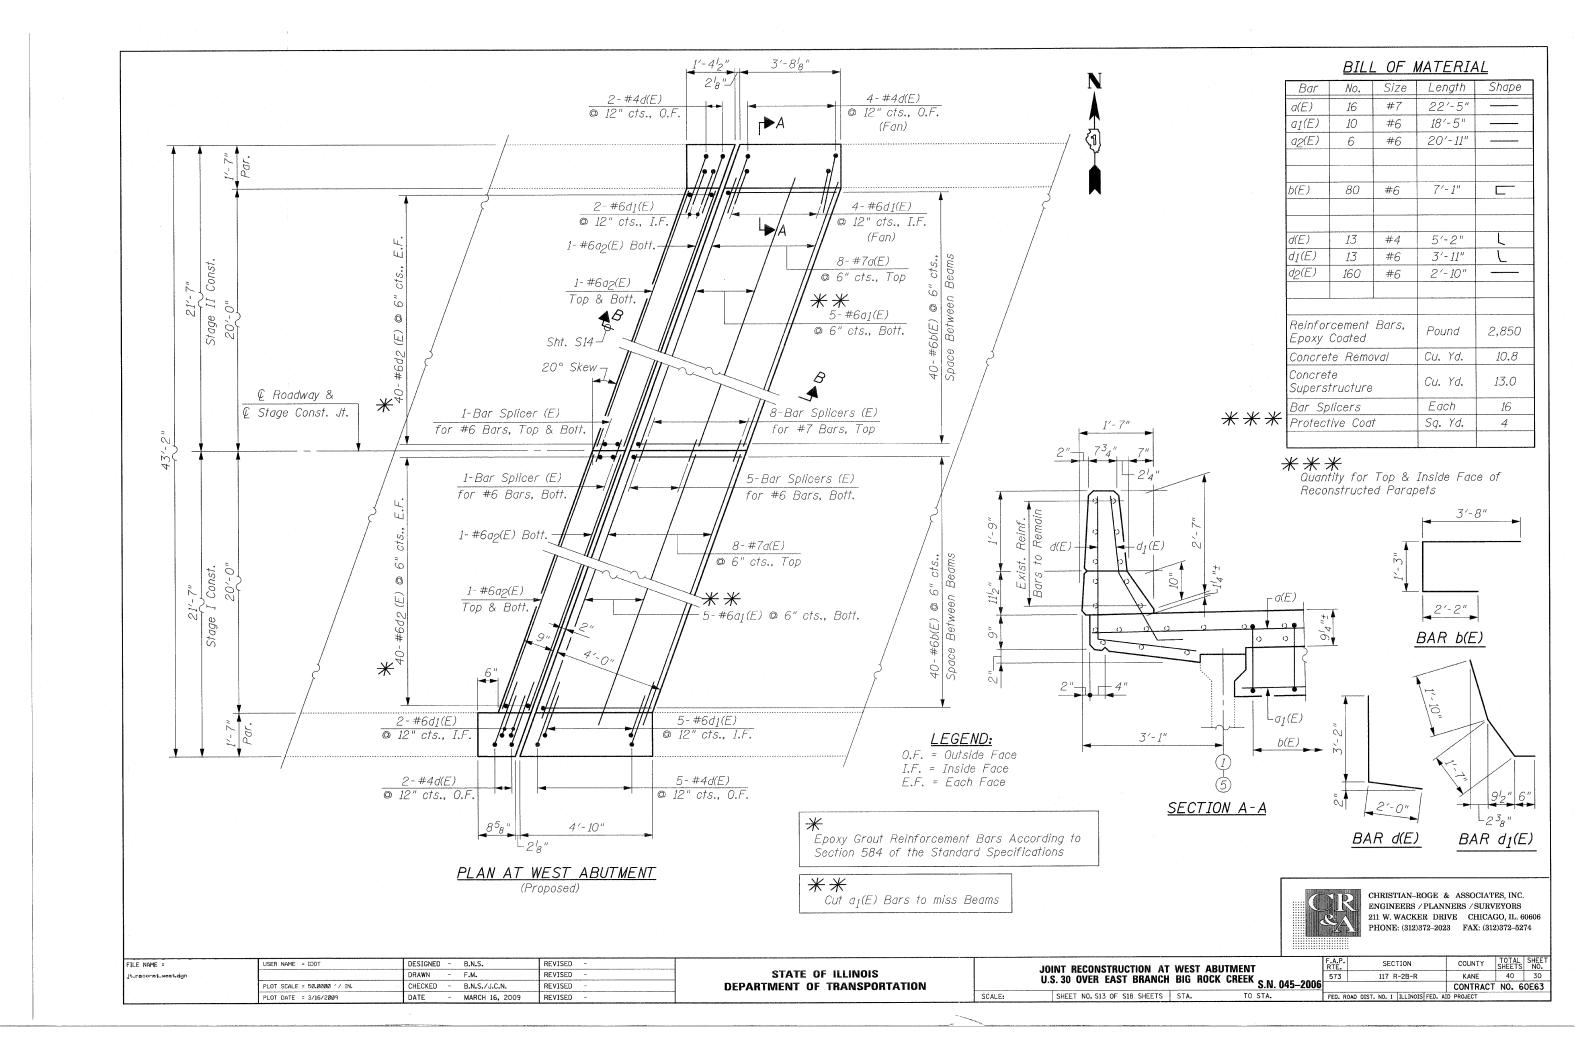

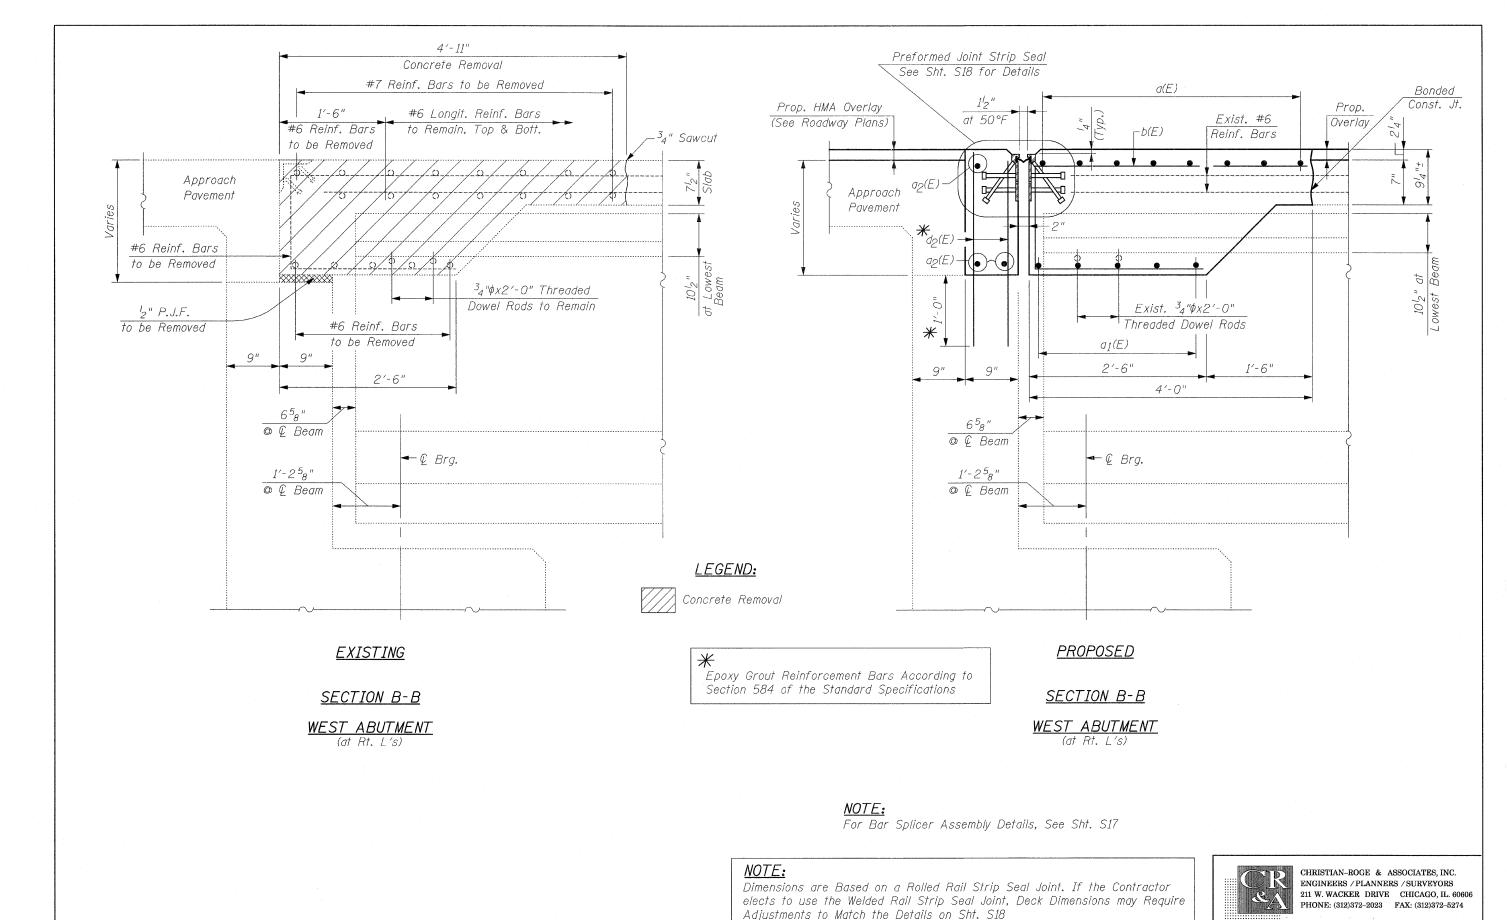



FILE NAME = USER NAME = IDOT DESIGNED - B.N.S. REVISED DRAWN REVISED _reconst_west_details.don PLOT SCALE = 50.0000 '/ IN. CHECKED - B.N.S./J.C.N. REVISED PLOT DATE = 1/26/2009 JANUARY 27, 2009

STATE OF ILLINOIS **DEPARTMENT OF TRANSPORTATION**

SECTION COUNTY TOTAL SHEET NO. 117 R-2B-R

F.A.P. RTE. 573 JOINT RECONSTRUCTION DETAILS AT WEST ABUTMENT IT RECONSTRUCTION DETAILS AT WEST ADDITIONAL U.S. 30 OVER EAST BRANCH BIG ROCK CREEK S.N. 045-2006 KANE 40 31 CONTRACT NO. 60E63 SHEET NO. S14 OF S18 SHEETS STA. FED. ROAD DIST. NO. 1 ILLINOIS FED. AID PROJECT

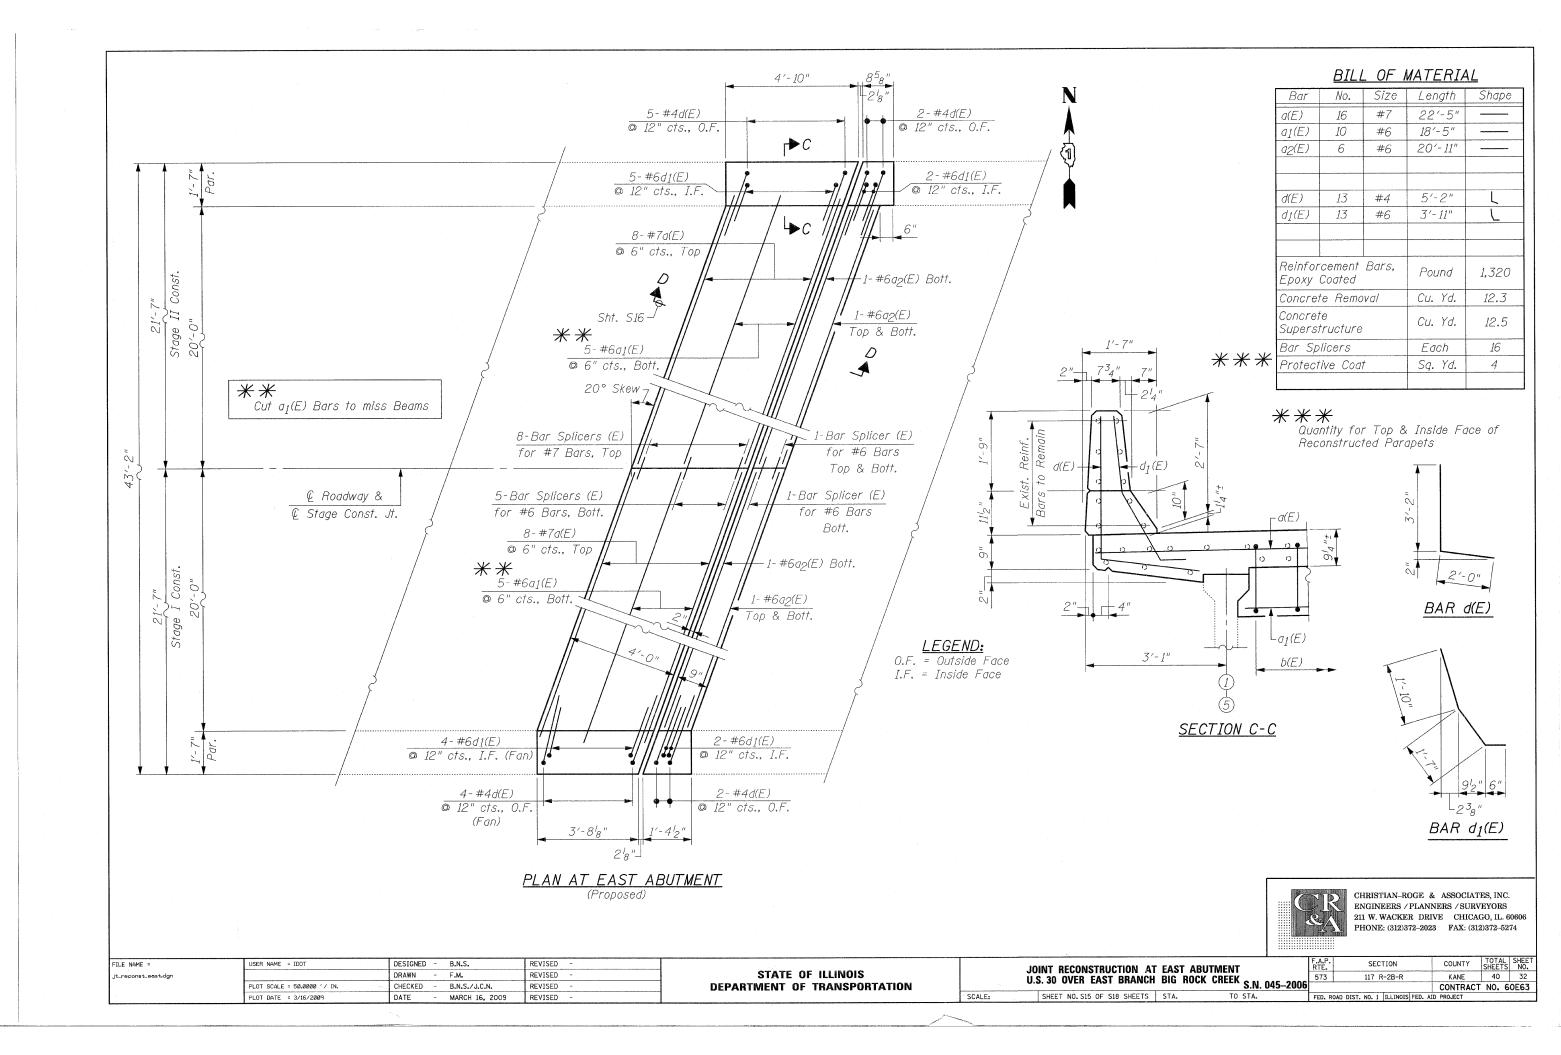

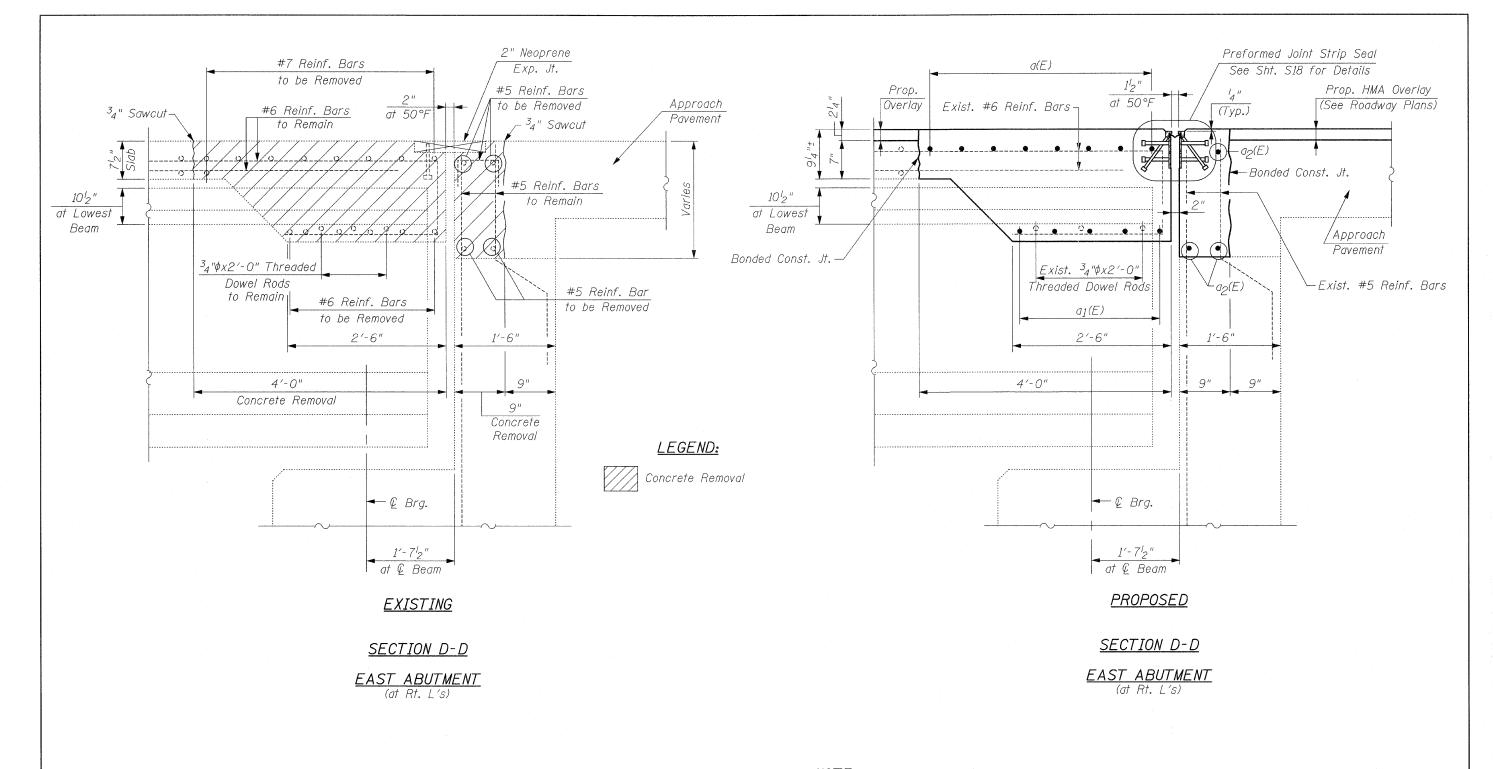

NOTE:

For Bar Splicer Assembly Details, See Sht. S17

NOTE:

Dimensions are Based on a Rolled Rail Strip Seal Joint. If the Contractor elects to use the Welded Rail Strip Seal Joint, Deck Dimensions may Require Adjustments to Match the Details on Sht. S18

SCALE:



CHRISTIAN-ROGE & ASSOCIATES, INC.
ENGINEERS / PLANNERS / SURVEYORS
211 W. WACKER DRIVE CHICAGO, IL. 60606
PHONE: (312)372-2023 FAX: (312)372-5274

FILE NAME =	USER NAME = IDOT	DESIGNED	-	B.N.S.	REVISED	
jt_reconst_east_details.dgn		DRAWN	-	F.M.	REVISED	-
	PLOT SCALE = 50.0000 '/ IN.	CHECKED	-	B.N.S./J.C.N.	REVISED	-
	PLOT DATE = 1/26/2009	DATE	-	JANUARY 27, 2009	REVISED	-

STATE OF ILLINOIS
DEPARTMENT OF TRANSPORTATION

JOINT	RECON	STRUC	CTION	DETAILS	S AT	EAST	ABUTN	IENT	045–200
U.S	S. 30 O	VER E	EAST	BRANCH	BIG	ROCK	CREEK	S.N.	
	SHEET	NO. S16	OF S18	SHEETS	STA.		TO	STA.	

F.A.P. RTE.		SECTION		COUNTY	TOTAL SHEETS	SHEET NO.
573	11	17 R-2B-R		KANE	40	33
	:			CONTRACT	NO. 6	0E63
FED. R	OAD DIST. NO	0. 1 ILLINOIS	FED. AID	PROJECT		



Bar splicer assemblies shall be of an approved type and shall develop in tension at least 125 percent of the yield strength of the lapped reinforcement bars.

Splicer rods shall be of minimum 60 ksi yield strength, threaded or coiled full length. All reinforcement bars shall be lapped and tied to the splicer rods or dowel bars. Bar splicer assemblies shall be epoxy coated according to the requirements for

reinforcement bars.

Other systems of similar design may be submitted to the Engineer for approval. Approval shall be based on certified test results from an approved testing laboratory that the proposed bar splicer assembly satisfies the following requirements:

- Minimum Capacity (Tension in kips) = 1.25 x fy x A_t
- Minimum *Pull-out Strength = $0.66 \times fy \times A_t$ (Tension in kips)

9'-0"

Where fy = Yield strength of lapped reinforcement bars in ksi. A_t = Tensile stress area of lapped reinforcement bars.


* = 28 day concrete

#11

BAR SPLICER ASSEMBLIES Strength Requirements Bar Size to Splicer Rod or Min. Capacity Min. Pull-Out Strength Dowel Bar Length be Spliced kips - tension kips - tension 14.7 7.9 #4 1'-8" #5 2'-2" 23.0 12.3 2'-7" 33.1 17.4 #6 45.1 23.8 #7 3'-5' 58.9 31.3 #8 4'-6' #9 5'-9" 75.0 39.6 #10 7'-3" 95.0 50.3

117.4

61.8

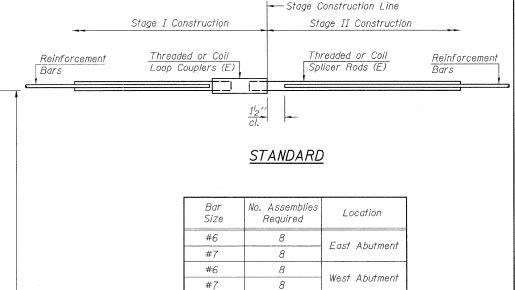

BAR SPLICER ASSEMBLY DETAILS STRUCTURE NO. 045-2006



211 W. WACKER DRIVE CHICAGO, IL. 60606


CONTRACT NO. 60E63

SCALE:

BAR SPLICER ASSEMBLY DETAILS U.S. 30 OVER EAST BRANCH BIG ROCK CREEK S.N. 045-200 SHEET NO. S17 OF S18 SHEETS STA. TO STA.

ENGINEERS / PLANNERS / SURVEYORS PHONE: (312)372-2023 FAX: (312)372-5274 SECTION TOTAL SHEE KANF 573 117 R-2B-R

FED. ROAD DIST. NO. 1 ILLINOIS FED. AID PROJECT

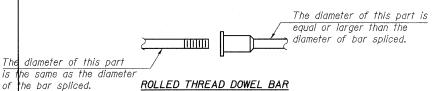

** ONE PIECE Wire Connector

WELDED SECTIONS

BAR SPLICER ASSEMBLY ALTERNATIVES

**Heavy Hex Nuts conforming to ASTM A 563, Grade C, D or DH may be used.

INSTALLATION AND SETTING METHODS

-Washer Face

Stage Construction Line

Foam Plugs

Threaded or Coil

Splicer Rods (E)

Abutment hatch block

Threaded or Coil

Loop Couplers (E)

<u>"A"</u>

Template

Forms-

"A": Set bar splicer assembly by means of a template bolt. "B" : Set bar splicer assembly by nailing to wood forms or cementing to steel forms.

6'-0"


Threaded or Coil

Splicer Rods (E)

Approach slab

(E): Indicates epoxy coating.

Reinforcement bars

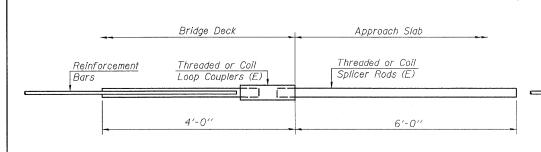

FOR INTEGRAL OR SEMI-INTEGRAL ABUTMENTS

Bar Splicer for #5 bar Min. Capacity = 23.0 kips - tension Min. Pull-out Strength = 12.3 kips - tension No. Required = -


Bar Splicer for #5 bar Min. Capacity = 23.0 kips - tension Min. Pull-out Strength = 12.3 kips - tension No. Required =

FOR STUB **ABUTMENTS**

BSD-1 10-1-08

FILE NAME =	USER NAME = IDOT	DESIGNED	-	B.N.S.	REVISED -
bar_splicer.dgn		DRAWN	**	F.M.	REVISED -
	PLOT SCALE = 50.0000 '/ IN.	CHECKED	-	B.N.S./J.C.N.	REVISED -
	PLOT DATE = 1/26/2009	DATE	-	JANUARY 27, 2009	REVISED -

STATE OF ILLINOIS **DEPARTMENT OF TRANSPORTATION**

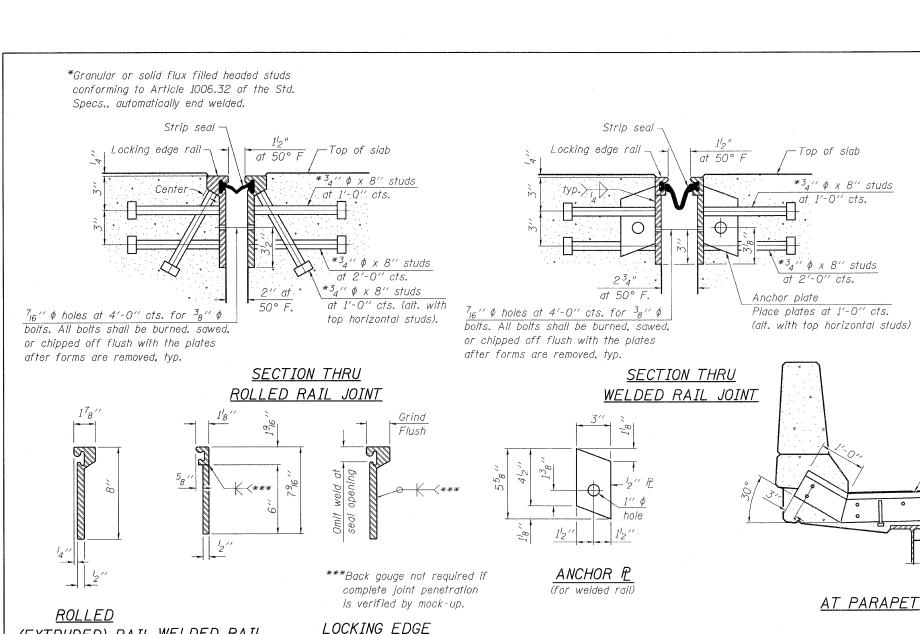

SCALE:

The strip seal shall be made continuous and shall have a minimum thickness of $\frac{1}{4}$ ". The configuration of the strip seal shall match the configuration of the Locking Edge Rails. Open or "webbed" strip seal gland configurations are not permitted. The gland shall be sized for a maximum rated movement of 4 inches.

The height and thickness of the Locking Edge Rails shown are minimum dimensions. The actual configuration of the Locking Edge Rails and matching strip seal may vary from manufacturer to manufacturer. Flanged edge rails will not be allowed. Locking Edge Rails may be spliced at slope discontinuities and stage construction joints.

The manufacturer's recommended installation methods shall be followed. The joint opening and deck dimensions detailed on the superstructure are based on a rolled rail expansion joint. If the Contractor elects to use the welded rail expansion joint, the opening and deck dimensions shall be modified according to the dimensions detailed on this sheet. Required modifications

> Top of sidewalk or median


shall be made at no additional cost to the State.

All steel components shall be galvanized after fabrication according to Article 520,03 of the Standard Specifications.

AT SIDEWALK OR MEDIAN

Shorter plates with a single row of studs at 12" cts. may be necessary on medians which are shallower than 9". See manufacturer's recommendation.

TYPICAL END TREATMENTS

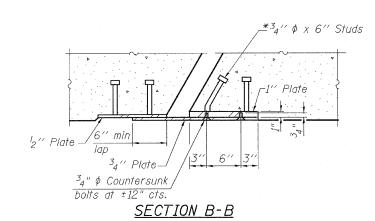

Top of locking edge rail

-Top of deck

BILL OF MATERIAL

Item	Unit	Total
Preformed Joint Strip Seal	Foot	90

NOTE:

Work This Sheet With Sht's. S14 & S16



CHRISTIAN-ROGE & ASSOCIATES, INC. ENGINEERS / PLANNERS / SURVEYORS 211 W. WACKER DRIVE CHICAGO, IL. 60606 PHONE: (312)372-2023 FAX: (312)372-5274

Top of locking edge rail

PLAN

> 30°

L3", typ.

End of

parapet

trip seal joint

RAIL SPLICE

The inside of the locking edge

rail groove shall be free of weld

Slidina

plates

residue.

Inside face

of parapet

LOCKING EDGE RAILS

POINT BLOCK DETAILS (for skews > 30°)

SECTION A-A

Inside Face

of Parapet

plates


EJ-SSJ 10 - 1 - 08

(EXTRUDED) RAIL WELDED RAIL


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preformed_joint_seal.dgn	14.7	DRAWN	-	F.M.	REVISED	**
	PLOT SCALE = 50.0000 '/ IN.	CHECKED	-	B.N.S./J.C.N.	REVISED	-
	PLOT DATE = 1/26/2009	DATE	-	JANUARY 27, 2009	REVISED	-

STATE OF ILLINOIS **DEPARTMENT OF TRANSPORTATION** PREFORMED JOINT STRIP SEAL
U.S. 30 OVER EAST BRANCH BIG ROCK CREEK S.N. 045-2006 SHEET NO. S18 OF S18 SHEETS | STA. TO STA.

TOTAL SHEE SHEETS NO. SECTION COUNTY 117 R-2B-R KANF 40 573 CONTRACT NO. 60E63 FED. ROAD DIST. NO. 1 ILLINOIS FED. AID PROJECT

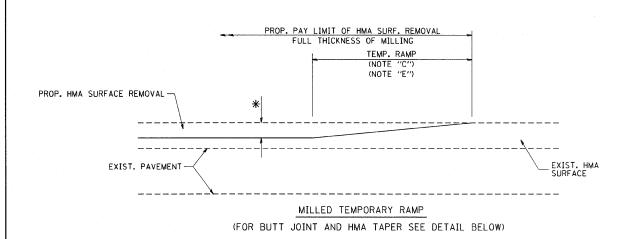


OPTION 1

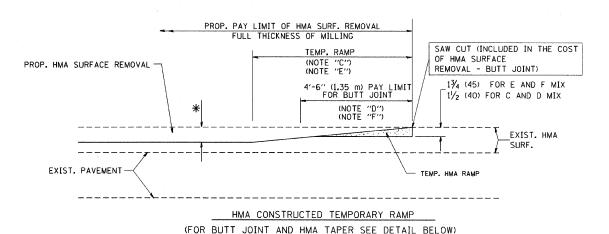

OPTION 2

TYPICAL TEMPORARY RAMP

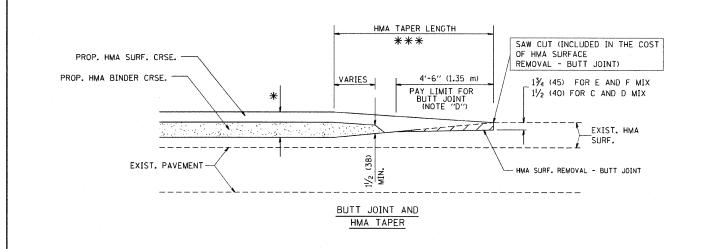



TYPICAL BUTT JOINT AND HMA TAPER FOR MILLING AND RESURFACING

FILE NAME = USER NAME = gaglianobt DESIGNED - M. DE YONG REVISED - R. SHAH 10-25-94 :\diststd\22x34\bd32.dgn DRAWN REVISED - A. ABBAS 03-21-97 PLOT SCALE = 50.0000 '/ IN. CHECKED REVISED - M. GOMEZ 04-06-01 PLOT DATE = 1/4/2008 DATE 06-13-90 REVISED R. BORO 01-01-07

STATE OF ILLINOIS **DEPARTMENT OF TRANSPORTATION**

SECTION **BUTT JOINT AND** 117 R-2B-R KANE 40 36 HMA TAPER DETAILS BD400-05 BD32 CONTRACT NO. 60E63 SCALE: NONE SHEET NO. 1 OF 1 SHEETS STA. VARIOUS TO STA. VARIOUS

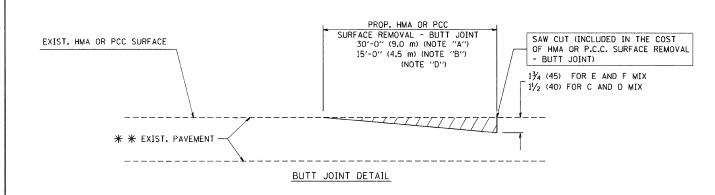

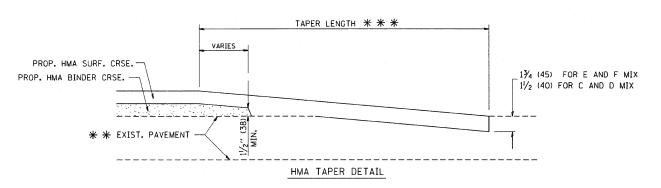

TYPICAL BUTT JOINT AND HMA TAPER FOR RESURFACING ONLY

* * PC CONCRETE, HMA OR HMA RESURFACED PAVEMENT.


NOTES

- A: MAINLINE ROADWAYS AND MAJOR SIDE ROADS.
- B: MINOR SIDE ROADS.
- C: THE TEMP. RAMP SHALL BE CONSTRUCTED IMMEDIATELY UPON REMOVAL OF THE EXISTING HMA SURFACE.
- D: THE BUTT JOINT SHALL BE CONSTRUCTED IMMEDIATELY PRIOR TO PLACING THE PROPOSED HMA COURSES.
- E: TAPER THE TEMP. RAMP AT A RATE OF 3'-O" (900 mm) PER 1 INCH (25 mm) OF MILLING THICKNESS.
- F: INSTALLATION AND REMOVAL OF THE 4'-6" (1.35 m) TEMP. RAMP IS INCLUDED IN COST OF HMA SURFACE REMOVAL - BUTT JOINT
- G: SEE ARTICLE 406.08 AND 406.14 OF THE STANDARD SPECIFICATIONS FOR "HMA AND/OR PCC SURFACE REMOVAL, BUTT JOINT".
- * SEE TYPICAL SECTIONS FOR MILLING THICKNESS.
- ** ** * 20'-0" (6.1 m) PER 1 (25) RESURFACING (NOTE "A") 10'-0" (3.0 m) PER 1 (25) RESURFACING (NOTE "B")

BASIS OF PAYMENT:

THE BUTT JOINT WILL BE PAID FOR AT THE CONTRACT UNIT PRICE PER SOUARE YARD (SOUARE METER) FOR "HOT-MIX ASPHALT SURFACE REMOVAL - BUTT JOINT" OR FOR "PORTLAND CEMENT CONCRETE SURFACE REMOVAL- BUTT JOINT".

ALL DIMENSIONS ARE IN INCHES (MILLIMETERS) UNLESS OTHERWISE SHOWN.

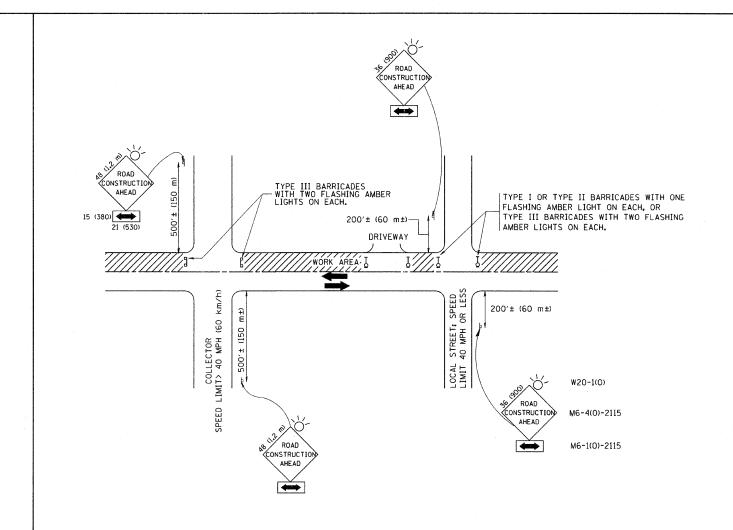

TRAFFIC CONTROL AND PROTECTION FOR SIDE ROADS, INTERSECTIONS, AND DRIVEWAYS

NOTES:

- A. FOR NO LANE RESTRICTION ON THE SIDE ROAD OR DRIVEWAYS
- 1. SIDE ROAD WITH A SPEED LIMIT OF 40 MPH (60 km/h) OR LESS AS SHOWN ON THE DRAWING AND AS DIRECTED BY THE ENGINEER:
- a) ONE ROAD CONSTRUCTION AHEAD SIGN 36 x 36 (900x900) WITH A FLASHER AND FLAG MOUNTED ON IT APPROXIMATELY 200' (60 m) IN ADVANCE OF THE MAIN ROUTE.
- b) THE CLOSED PORTION OF THE MAIN ROUTE SHALL BE PROTECTED BY BLOCKING WITH TYPE I. TYPE II OR TYPE III BARRICADES, 1/3 OF
- 2. SIDE ROAD WITH A SPEED LIMIT GREATER THAN 40 MPH (60 km/h) AS SHOWN ON THE DRAWING AND AS DIRECTED BY THE ENGINEER:
- 0) ONE ROAD CONSTRUCTION AHEAD SIGN 48 \times 48 (1.2 m \times 1.2 m) WITH A FLASHER MOUNTED ON IT APPROXIMATELY 500' (150 m) IN ADVANCE
- b) THE CLOSED PORTION OF THE MAIN ROUTE SHALL BE PROTECTED BY BLOCKING WITH TYPE III BARRICADES, 1/2 OF THE CROSS SECTION OF THE CLOSED PORTION.
- 3. WHEN THE SIDE ROAD LIES BETWEEN THE BEGINNING OF THE MAINLINE SIGNING AND THE WORK ZONE, A SINGLE HEADED ARROW (MG-1) SHALL BE USED IN LIEU OF THE DOUBLE HEADED ARROW (MG-4).

- B. FOR A LANE CLOSURE ON A SIDE ROAD OR DRIVEWAY:
- USE APPLICABLE PORTIONS OF THE TYPICAL APPLICATION OF TRAFFIC CONTROL DEVICES (STD. 701501, STD. 701606 OR THE APPROPRIATE STANDARD). THE SPACING OF SIGNS AND BARRICADES SHALL BE ADJUSTED FOR FIELD CONDITIONS AS DIRECTED BY THE ENGINEER. THE DIRECTIONAL ARROW SHALL BE COVERED OR REMOVED WHEN NO LONGER CONSISTENT WITH THE SIDE ROAD LANE CLOSURE.
- C. ADVANCE WARNING SIGNS ARE TO BE OMITTED ON DRIVEWAY UNLESS OTHERWISE NOTED.
- D. THE TRAFFIC CONTROL AND PROTECTION FOR SIDE ROADS, INTERSECTIONS, AND DRIVEWAYS SHALL BE INCIDENTAL TO THE COST OF SPECIFIED TRAFFIC CONTROL STANDARDS OR ITEMS.

All dimensions are in millimeters (inches) unless otherwise shown.

COUNTY TOTAL SHEETS NO.

KANE 40 37


CONTRACT NO. 60E63

COUNTY


FILE NAME = DESIGNED - LHA USER NAME = gaglianobt REVISED - J. OBERLE 10-18-95 \diststd\22x34\tc10.dgn DRAWN REVISED - A. HOUSEH 03-06-96 PLOT SCALE = 50.000 '/ IN. CHECKED REVISED - A. HOUSEH 10-15-96 PLOT DATE = 1/4/2008 DATE REVISED -T. RAMMACHER 01-06-00


STATE OF ILLINOIS **DEPARTMENT OF TRANSPORTATION**

	TRAFFIC CONTROL AND	PROTECTION FOR		F.A.P. RTE.	SECTION
	SIDE ROADS, INTERSECTION	S AND DRIVEWAVE		573	117 R-2B-R
	SIDE HOADS, HETEHOLOTION	S, AND DINVESSATS			TC-10
SCALE: NONE	SHEET NO. 1 OF 1 SHEETS	STA. VARIOUS	O STA. VARIOUS	FED. RO	DAD DIST. NO. 1 ILLINOIS FED. A

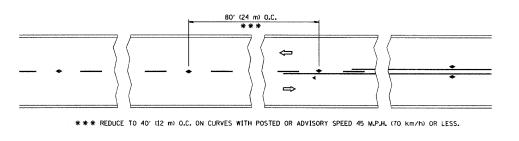


TWO-LANE/TWO-WAY

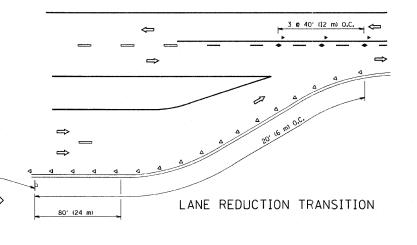


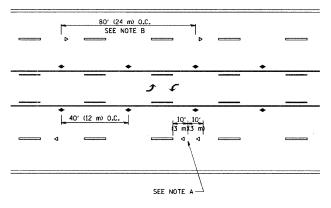

TWO-WAY LEFT TURN

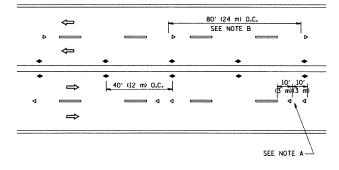

MULTI-LANE/UNDIVIDED

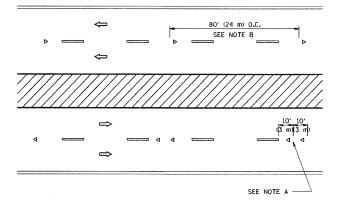

MULTI-LANE/DIVIDED

GENERAL NOTES

- 1. MARKERS USED WITH DASHED LINES SHALL BE CENTERED IN THE GAP BETWEEN SEGMENTS.
- 2. MARKERS USED ADJACENT TO SOLID LINES SHALL BE OFFSET 2 TO 3 (50 TO 75) TOWARD TRAFFIC AS SHOWN.
- MARKERS THROUGH TANGENTS LESS THAN 500' (150 m) IN LENGTH BETWEEN CURVES SHALL BE INSTALLED AT THE LESSER OF THE TWO CURVE SPACINGS.

LANE MARKER NOTES


- B. REDUCE TO 40' (12 m) O.C. ON CURVES WHERE ADVISORY SPEEDS ARE 10 M.P.H (20 km/h) LOWER THAN POSTED SPEEDS.
- A. USE DOUBLE LANE LINE MARKERS SPACED AS SHOWN.

SYMBOLS

- ---- YELLOW STRIPE
- WHITE STRIPE
- ONE-WAY AMBER MARKER
- ONE-WAY CRYSTAL MARKER (W/O)
- ◆ TWO-WAY AMBER MARKER

DESIGN NOTES


- 1. DOUBLE LANE LINE MARKERS SHALL BE USED UNLESS SPECIFIED OTHERWISE.
- 2. EXCEPT AS SHOWN ON THE LANE REDUCTION TRANSITION AND FREEWAY EXIT RAMP DETAIL, MARKERS ARE NOT TO BE SPECIFIED ON RIGHT EDGE LINGS.
- 3. THE EXACT MARKER LIMITS, SPACING, AND COLOR SHOULD BE INCLUDED IN THE PLANS.
- MARKERS SHOULD NOT BE USED ALONGSIDE CURBS EXCEPT FOR EXTREMELY SHORT SECTIONS OF CURBS WHERE NOT MORE THAN TWO MARKERS WOULD BE INVOLVED.

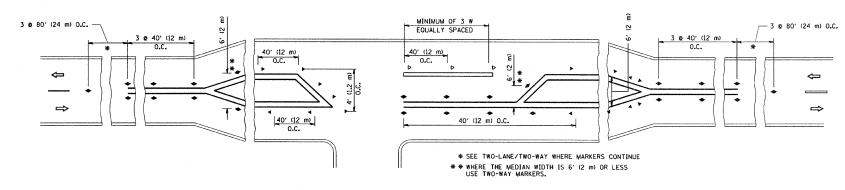

LEFT TURN


All dimensions are in inches (millimeters) unless otherwise shown.

FILE NAME =	USER NAME = gaglianobt	DESIGNED -	REVISED - T. RAMMACHER 09-19-94		TUDIONI ADDILIONTIONIO	F.A.P. SECTION	COUNTY TOTAL SHEET
W:\diststd\22x34\to11.dgn		DRAWN -	REVISED - T. RAMMACHER 03-12-99	STATE OF ILLINOIS	TYPICAL APPLICATIONS	573 117 R-2B-R	KANE 40 38
	PLOT SCALE = 50.000 ' / IN.	CHECKED -	REVISED -T. RAMMACHER 01-06-00	DEPARTMENT OF TRANSPORTATION	RAISED REFLECTIVE PAVEMENT MARKERS (SNOW-PLOW RESISTANT)	TC-11	CONTRACT NO. 60E63
	PLOT DATE = 1/4/2008	DATE -	REVISED -		SCALE: NONE SHEET NO. 1 OF 1 SHEETS STA. VARIOUS TO STA. VARIOUS	FED. ROAD DIST. NO. 1 ILLINOIS FI	

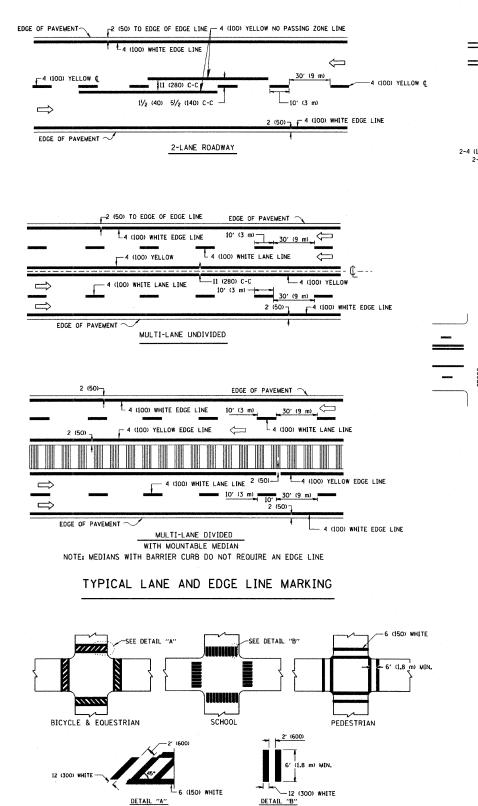


2-4 (100) YELLOW @ 11 (280) C-C-4' (1.2 m) OUTSIDE TO OUTSIDE OF LINES NO DIAGONALS - 2-4 (100) YELLOW @ 11 (280) C-C

4' (1.2 m) WIDE MEDIANS ONLY

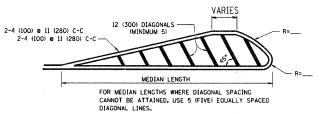


DIAGONAL LINE SPACING: 50' (15 m) C-C (LESS THAN 30MPH (50 km/h)) 75' (25 m) C-C 30MPH (50 km/h) T0 45MPH (70 km/h)) 150' (45 m) C-C (MORE THAN 45MPH (70 km/h))

MEDIANS OVER 4' (1.2 m) WIDE

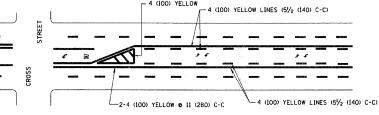


A MINIMUM OF TWO PAIRS OF TURN ARROWS SHALL BE USED, WHITE IN COLOR. ADDITIONAL PAIRS SHALL BE PLACED AT 200' (60 m) TO 300' (90 m) INTERVALS.

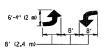

MEDIAN WITH TWO-WAY LEFT TURN LANE

TYPICAL PAINTED MEDIAN MARKING

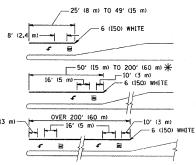


FULL SIZE LETTERS 8' (2.4 m) AND ARROWS SHALL BE USED. \P AREA = 15.6 SO. FT. (1.5 m²) \P AREA = 20.8 SO. FT. (1.9 m²)

★ TURN LANES IN EXCESS OF 400' (120 m) IN LENGTH MAY HAVE AN ADDITIONAL SET OF ARROW - "ONLY" INSTALLED MIDWAY BETWEEN THE OTHER TWO SETS OF ARROW - "ONLY".

TYPICAL LEFT (OR RIGHT) TURN LANE

TYPICAL TURN LANE MARKING

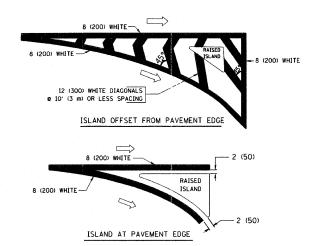

TYPICAL ISLAND MARKING

			T	
TYPE OF MARKING	WIDTH OF LINE	PATTERN	COLOR	SPACING / REMARKS
CENTERLINE ON 2 LANE PAVEMENT	4 (100)	SKIP-DASH	YELLOW	10' (3 m) LINE WITH 30' (9 m) SPACE
CENTERLINE ON MULTI-LANE UNDIVEDED PAVEMENT	2 @ 4 (100)	SOLID	YELLOW	11 (280) C-C
NO PASSING ZONE LINES: FOR ONE DIRECTION FOR BOTH DIRECTIONS	4 (100) 2 g 4 (100)	SOLID SOLID	YELLOW YELLOW	5/2 (140) C-C FROM SKIP-DASH CENTERLINE 11 1280) C-C OMIT SKIP-DASH CENTERLINE BETWEEN
LANE LINES	4 (100) 5 (125) ON FREEWAYS	SKIP-DASH SKIP-DASH	WHITE WHITE	10' (3 m) LINE WITH 30' (9 m) SPACE
DOTTED LINES (EXTENSIONS OF CENTER, LANE OR TURN LANE MARKINGS)	SAME AS LINE BEING EXTENDED	SKIP-DASH	SAME AS LINE BEING EXTENDED	2' (600) LINE WITH 6' (1.8 m) SPACE
EDGE LINES	4 (100)	SOLID	YELLOW-LEFT WHITE-RIGHT	OUTLINE MOUNTABLE MEDIANS IN YELLOW; EDGE LINES ARE NOT USED NEXT TO BARRIER CURB
TURN LAME MARKINGS	6 (150) LINE; FULL SIZE LETTERS & SYMBOLS (8' (2,4m))	SOLID	WHITE	SEE TYPICAL TURN LANE MARKING DETAIL
TWO WAY LEFT TURN MARKING	2 @ 4 (100) EACH DIRECTION	SKIP-DASH AND SOLID	YELLOW	10' (3 m) LINE WITH 30' (9 m) SPACE FOR SKIP-DASH; 5½ (140) C-C BETWEEN SOLID LINE AND SKIP-DASH LINE
	8' (2.4m) LEFT ARROW	IN PAIRS	WHITE	SEE TYPICAL TWO-WAY LEFT TURN MARKING DETAIL
CROSSWALK LINES (PEDESTRIAN) A. DIAGONALS (BIKE & EOUESTRIAN) B. LONGITUDINAL BARS (SCHOOL)	2 & 6 (150) 12 (300) & 45° 12 (300) & 90°	SOLID SOLID SOLID	WHITE WHITE WHITE	NOT LESS THAN 6' (1.8 m) APART 2' (600) APART 2' (600) APART 5' (600) APART SEE TYPICAL CROSSWALK MARKING DETAILS.
STOP LINES	24 (600)	SOLID	WHITE	PLACE 4' 11.2 m) IN ADVANCE OF AND PARALLEL TO CROSSWALK, IF PRESENT, OTHERWISE, PLACE AT DESIRED STOPPING POINT. PARALLEL TO CROSSROAD CENTERLINE, WHERE POSSIBLE
PAINTED MEDIANS	2 & 4 (100) WITH 12 (300) DIAGONALS	SOLID	YELLOW: TWO WAY TRAFFIC	11 (280) C-C FOR THE DOUBLE LINE
	© 45° NO DIAGONALS USED FOR 4' (1.2 m) WIDE MEDIANS		WHITE: ONE WAY TRAFFIC	SEE TYPICAL PAINTED MEDIAN MARKING.
GORE MARKING AND CHANNELIZING LINES	8 (200) WITH 12 (300) DIAGONALS @ 45°	SOLID	WHITE	DIAGONALS: 15' (4.5 m) C-C (LESS THAN 30MPH (50 km/h)) 20' (6 m) C-C 30MPH (50 km/h) TO 45MPH (70 km/h)) 30' (9 m) C-C (OVER 45MPH (70 km/h))
RAILROAD CROSSING	24 (600) TRANSVERSE LINES; "RR" IS 6' (1.8 m) LETTERS; 16 (400) LINE FOR "X"	SOLID	WHITE	SEE STATE STANDARD 780001 AREA 0F: "R"23.6 SO. FT. (0.33 m ²) EACH "X"=54.0 SO. FT. (5.0 m ²)
SHOULDER DIAGONALS	12 (300) c 45°	SOLID	WHITE - RIGHT	50' (15 m) C-C (LESS THAN 30MPH (50 km/h)) 75' (25 m) C-C (30 MPH (50 km/h) TO 45MPH (70 km/h) 1150' (45 m) C-C (OVER 45MPH (70 km/h))

FOR FURTHER DETAILS ON PAVEMENT MARKING REFER TO STANDARD SPECIFICATIONS FOR ROAD AND BRIDGE CONSTRUCTION AND STATE STANDARD 780001.

All dimensions are in inches (millimeters) unless otherwise shown.


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I	FILE NAME =	USER NAME = gaglianobt	DESIGNED -	EVERS	REVISED	-T. RAMMACHER 10-27-94
I	Wi\diststd\22x34\to13.dgn		DRAWN -		REVISED	-A. HOUSEH 10-09-96
ı		PLOT SCALE = 50.000 '/ IN.	CHECKED -		REVISED	-A. HOUSEH 10-17-96
ı		PLOT DATE = 1/4/2008	DATE -	03-19-90	REVISED	-T. RAMMACHER 01-06-00

TYPICAL CROSSWALK MARKING

DETAIL "A"

STATE	OF	ILLINOIS
DEPARTMENT	OF	TRANSPORTATION

	DISTRICT O	NE		F.A.P. RTE.	SECTION	COUNTY	TOTAL SHEETS	SHEET NO.
	TYPICAL PAVEMENT	MADVINGS		573	117 R-2B-R	KANE	40	39
	TITIOAL TAVEINENT	MAIIMIN			TC-13	CONTRACT	NO. 60	DE63
SCALE: NONE	SHEET NO. 1 OF 1 SHEETS	STA. VARIOUS	TO STA. VARIOUS	FED. R	DAD DIST. NO. 1 ILLINOIS FED. A	D PROJECT		

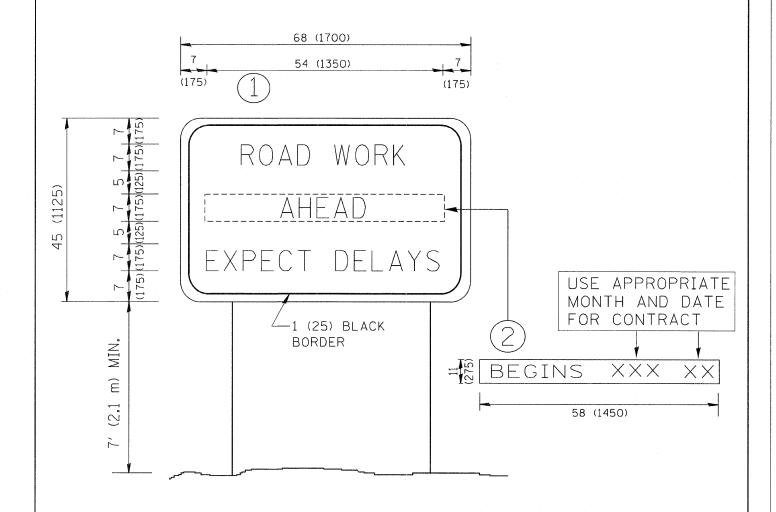

NOTES:

- 1. USE BLACK LETTERING ON ORANGE BACKGROUND.
- 2. ERECT SIGNS IN ADVANCE OF THE LOCATION FOR THE "ROAD CONSTRUCTION AHEAD" SIGN AT LOCATIONS AS DIRECTED BY THE ENGINEER.
- 3. ERECT SIGN (1) WITH INSTALLED PANEL (2) ONE WEEK PRIOR TO THE START OF CONSTRUCTION.
- 4. REMOVE PANEL 2 SOON AFTER THE START OF CONSTRUCTION.
- 5. SEE SPECIAL PROVISION FOR "TEMPORARY INFORMATION SIGNING" FOR ADDITIONAL INFORMATION.
- 6. ONE SIGN ASSEMBLY EQUALS 25.70 SQ. FT. (2.3 SQ. M.)
- 7. SHALL BE PAID FOR AS TEMPORARY INFORMATION SIGNING.

ALL DIMENSIONS ARE IN INCHES (MILLIMETERS)
UNLESS OTHERWISE SHOWN.

PLOT SCALE = 50.000 '/ IN. CHECKED - REVISED -T. RAMMACHER 02-02-99 DEPARTMENT OF TRANSPORTATION	INFORMATION SIGN TC-22 CONTRACT NO. 60E(
Wi\diststd\22x34\tc22.dgn	ANTENIAL NOAD
FILE NAME = USER NAME = geglionobt DESIGNED - R. MIRS 09-15-97	ARTERIAL POAR F.A.P. SECTION COUNTY TOTAL S