STATE OF ILLINOIS

DEPARTMENT OF TRANSPORTATION

DIVISION OF HIGHWAYS


PROPOSED HIGHWAY PLANS

CH ROUTE 92 (FOREST WAY DRIVE) SECTION: 2008-029 I OVER EAST DIVERSION DITCH WINGWALL REPAIR **COUNTY: COOK** C-91-495-08

NEW TRIER TOWNSHIP

GROSS LENGTH OF PROJECT = 130 FEET = 0.025 MILES

NET LENGTH OF PROJECT = 130 FEET = 0.025 MILES

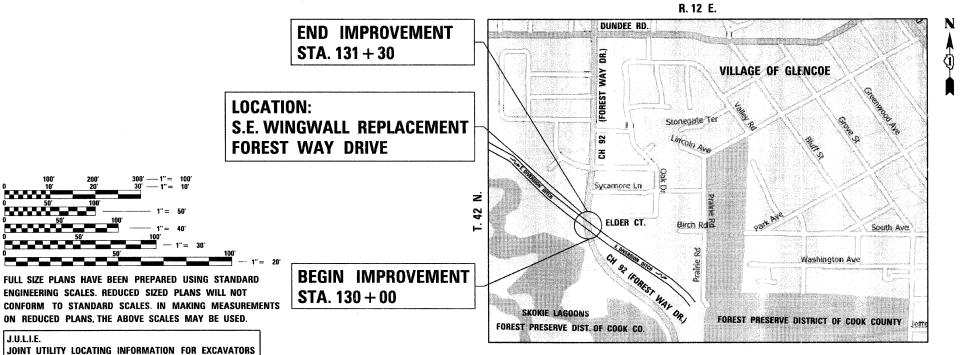

COOK 2008-029 I ILLINOIS CONTRACT NO. 60E61

D-91-495-08



STATE OF ILLINOIS DEPARTMENT OF TRANSPORTATION **DIVISION OF HIGHWAYS**

SUBMITTED JANUARY 23, 20 09

BIRINDER S. SACHDEVA, P.E.

January 21,2009 DATE



Edwert No. 8hoh BHADRESH N. SHAH, S.E., P.E. EXPIRES: 11-30-2010

EXPIRES: 11-30-2009

JANUARY 21,2003

PRINTED BY THE AUTHORITY OF THE STATE OF ILLINOIS

CHRISTIAN-ROGE & ASSOCIATES INC. ENGINEERS - PLANNERS - SURVEYORS 211 W WACKER DRIVE CHICAGO, IL 60606

PROJECT MANAGER KEN ENG (847) 705-4247

DISTRICT ONE - DESIGN

J.U.L.I.E.

OR 811

1-800-892-0123

FOR INDEX OF SHEETS, SEE SHEET NO. 2

DESIGN DESIGNATION:

POSTED SPEED: 30 M.P.H.

MUNICIPALITY INVOLVED:

VILLAGE OF GLENCOE

MINOR ARTERIAL

2008 ADT = 2,300

 \circ

 \circ

 \circ

 \bigcirc

CONTRACT NO. 60E61

INDEX OF SHEETS

1	COVER SHEET
2	INDEX OF SHEETS, LIST OF STATE STANDARDS AND GENERAL NOTES CH 92 (FOREST WAY DRIVE)
3	SUMMARY OF QUANTITIES CH 92 (FOREST WAY DRIVE)
4	TYPICAL SECTIONS AND DETAILS CH 92 (FOREST WAY DRIVE)
5	ALIGNMENT AND TIES CH 92 (FOREST WAY DRIVE)
6	EXISTING AND PROPOSED PLAN AND PROFILE CH 92 (FOREST WAY DRIVE)
7	SUGGESTED TRAFFIC CONTROL AND STAGING PLAN CH 92 (FOREST WAY DRIVE)
8	EROSION CONTROL AND GRADING PLAN CH 92 (FOREST WAY DRIVE)
9	WINGWALL PLAN AND ELEVATION
10	WINGWALL DETAILS
11	SOIL BORING LOGS
12 - 13	CROSS SECTIONS CH 92 (FOREST WAY DRIVE)
14	TRAFFIC CONTROL AND PROTECTION FOR SIDE ROADS, INTERSECTIONS AND DRIVEWAYS

LIST OF STATE STANDARDS

ARTERIAL ROAD INFORMATION SIGN

STANDARD NO.	DESCRIPTION
000001- <i>05</i>	STANDARD SYMBOLS, ABBREVIATIONS AND PATTERNS
630001 ~ 06	STEEL PLATE BEAM GUARDRAIL
635006- <i>03</i>	REFLECTOR AND TERMINAL MARKER PLACEMENT
635011 - 02	REFLECTOR AND MARKER AND MOUNTING DETAILS
701501 - 05	URBAN LANE CLOSURE, 2L, 2W, UNDIVIDED
701901 - 0 1	TRAFFIC CONTROL DEVICES
704001 - 05	TEMPORARY CONCRETE BARRIER

GENERAL NOTES

- 1. FORTY-EIGHT HOURS BEFORE STARTING EXCAVATION, THE CONTRACTOR WILL CALL J.U.L.I.E. (1-800-892-0123) OR 811 TO HAVE THE LOCATION OF EXISTING UTILITIES STAKED.
- 2. THE CONTRACTOR WILL NOT BE ALLOWED TO SET UP A YARD OR FIELD OFFICE ON STATE PROPERTY WITHOUT WRITTEN PERMISSION FROM THE DEPARTMENT.
- 3. SAW CUTTING PRIOR TO ANY REMOVAL ITEMS NOTED ON THE PLANS OR DIRECTED BY THE ENGINEER SHALL BE CONSIDERED INCLUDED IN THE CONTRACT UNIT PRICE FOR CONCRETE REMOVAL.
- 4. DO NOT SCALE PLANS FOR CONSTRUCTION DIMENSIONS.
- 5. THE CONTRACTOR SHALL USE CARE IN REMOVING OR EXCAVATING NEAR ALL EXISTING ITEMS WHICH WILL REMAIN. ANY DAMAGE DONE TO EXISTING ITEMS BY THE CONTRACTOR SHALL BE REPAIRED AT THE CONTRACTOR'S EXPENSE.
- 6. THE CONTRACTOR MUST PROTECT PAVEMENT WHEN DUMPING RIPRAP ONTO THE PAVEMENT AND WILL BE RESPONSIBLE FOR RESTORING PAVEMENT MARKINGS.
- 7. THE CONTRACTOR SHALL OBTAIN ALL NECESSARY PERMITS, AS REQUIRED, PRIOR TO COMMENCING WITH CONSTRUCTION.
- 3. THE CONTRACTOR SHALL TAKE ALL NECESSARY MEASURES TO ASSURE THAT NO DEBRIS FALLS IN THE CREEK. THE COST OF THIS WORK SHALL BE INCLUDED IN THE CONTRACT UNIT PRICE FOR CONCRETE REMOVAL.
- 9. THE CONTRACTOR SHALL CONTACT THE TRAFFIC CONTROL SUPERVISOR AT (847) 705-4470 A MINIMUM OF 72 HOURS PRIOR TO THE PLACEMENT OF ANY TEMPORARY TRAFFIC CONTROL DEVICES.
- 10. THE CONTRACTOR SHALL SUBMIT THEIR FINAL DE-WATERING AND SEDIMENT CONTROL PLANS FOR THE PROJECT PRIOR TO THE START OF WORK.
- 11. THE CONTRACTOR SHALL COORDINATE CONSTRUCTION ACTIVITIES WITH UTILITY COMPANIES.
- 12. THE EXISTING EARTH SHOULDER TO BE REMOVED AND THE EARTH EXCAVATION FOR THE PROPOSED RIP-RAP, ESTIMATES 12" DEPTH, SHALL BE PAID FOR AS REMOVAL AND DISPOSAL OF UNSUITABLE MATERIAL. THE COST OF CLEARING THE AREA WITHIN THE CONSTRUCTION LIMITS SHALL BE INCLUDED IN THE CONTRACT UNIT PRICE FOR REMOVAL AND DISPOSAL OF UNSUITABLE MATERIAL.

1001.STATE

	SUMMARY OF QUANTITIES			CONSTRUCTION TYPE CODE
	SOMMAN OF QUARTITIES		TOTAL	CH 92
CODE NO	ITEM	UNIT	QUANTITIES	SFTY-2A
20201006	GRADING AND SHAPING SHOULDERS	UNIT	. 1	1
20201200	REMOVAL AND DISPOSAL OF UNSUITABLE MATERIAL	CU YD	43	43
21101615	TOPSOIL FURNISH AND PLACE, 4"	SQ YD	28	28
25100635	HEAVY DUTY EROSION CONTROL BLANKET	SQ YD	28	28
28000400	PERIMETER EROSION BARRIER	FOOT	111	111
28100103	STONE RIPRAP, CLASS A2	SQ YD	40	40
28100105	STONE RIPRAP, CLASS A3	SQ YD	16	16
28200200	FILTER FABRIC	SQ YD	57	57
20900110	POROUS GRANULAR BACKFILL	CU YD	140	140
48101500	AGGREGATE SHOULDERS, TYPE B 6"	SQ YD	70	70
50102400	CONCRETE REMOVAL	CU YD	11	11
50200100	STRUCTURE EXCAVATION	CU YD	62	62
50300225	CONCRETE STRUCTURES	CU YD	12	12
50800205	REINFORCEMENT BARS, EPOXY COATED	POUND	1,660	1,660

		SUMMARY OF QUANTITIES			CONSTRUCTION TYPE CODE
-	CODE NO	ITEM	UNIT	TOTAL	CH 92
L	CODE NO	1 I EM	ONTI	QUANTITIES	SFTY-2A
	59100100	GEOCOMPOSITE WALL DRAIN	SQ YD	13	13
4	63000000	STEEL PLATE BEAM GUARD RAIL, TYPE A	FOOT	106	106
4	63100167	TRAFFIC BARRIER TERMINAL, TYPE 1 (SPECIAL) TANGENT	EACH	1	1
	63200310	GUARDRAIL REMOVAL	FOOT	115	115
	67100100	MOBILIZATION	L SUM	. 1	1
	67000400	ENGINEER'S FIELD OFFICE, TYPE A	CAL MO	6	6
	70101800	TRAFFIC CONTROL AND PROTECTION, (SPECIAL)	L SUM	1	1
	70400100	TEMPORARY CONCRETE BARRIER	FOOT	100	100
×	78200410	GUARDRAIL MARKERS, TYPE A	EACH	3	3
*	78201000	TERMINAL MARKER - DIRECT APPLIED	EACH	1	1
	X0321781	MECHANICAL SPLICE	EACH	8	8
	X0322256	TEMPORARY INFORMATION SIGNING	SQ FT	52	52
	X5020501	UNDERWATER STRUCTURE EXCAVATION PROTECTION - LOCATION 1	EACH	1	1
	Z0030240	IMPACT ATTENUATORS, TEMPORARY (NON-REDIRECTIVE), TEST LEVEL 2	EACH	2	2

* SPECIALTY ITEM

FILE NAME = 1024M_sht_SOQ.dgn PLOT DATE = 1/23/2009

-		-
	CHRISTIAN-ROGE & ASSOCIATES, INC.	ŀ
ı		ı
	211 WEST WACKER DRIVE	ŀ
1	CHICAGO, ILLINOIS 60606	ı
- 1		Г

OGE & ASSOCIATES, INC.	DESIGNED -	S.J.P.	REVISED -	
-PLANNERS-SURVEYORS	DRAWN	A.Y.	REVISED -	*
ST WACKER DRIVE GO, ILLINOIS 60606	CHECKED -	S.J.P.	REVISED -	-
2-2023 FAX: (312)372-5274	DATE .	JANUARY 27, 2009	REVISED	


STATE OF ILLINOIS
DEPARTMENT OF TRANSPORTATION


Sl	JMN	ARY OF	QUAN	TITIES
CH	92	(FOREST	WAY	DRIVE)

		CONTRACT	NO. 6	0E61
32	2008-029 I	соок	15	3
Н	SECTION	COUNTY	TOTAL SHEETS	SHEET NO.

1001.STATE

SOALE NOWE CHEEN NO + OF + SHEETS STA 130400

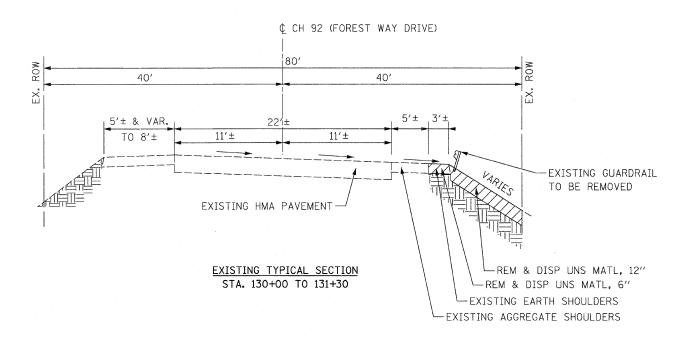

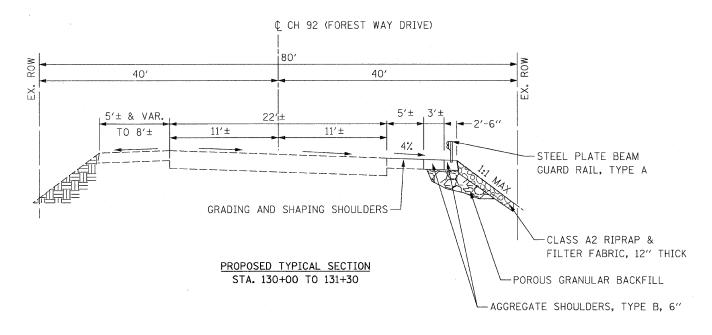

FILE NAME = 1024M_sht_TYP.dgn

PLOT DATE = 1/23/2009 SQL ENGI

CHRISTIAN-ROGE & ASSOCIATES, INC.
ENGINEERS-PLANNERS-SURVEYORS
211 WEST WAZKER DRIVE
CHICAGO, ILLINOIS 60606
PHONE: (312)372-2023 FAX: (312)372-5274

INC.	DESIGNED	-	S.J.P.	REVISED -
DRS	DRAWN	-	A.Y.	REVISED -
	CHECKED	-	S.J.P.	REVISED
2-5274	DATE	-	JANUARY 27, 2009	REVISED -

STATE OF ILLINOIS
DEPARTMENT OF TRANSPORTATION


SCALE:


_	Т	YPIC	AL :	SEC	TIONS	& DETAILS		СН	SECTION
	-					AY DRIVE)		92	2008-029
	SHEET N	NO. 1	OF	1	SHEETS	STA. 130+00	TO STA. 131+15	 	ILLI

CH SECTION COUNTY TOTAL SHEETS NO.


92 2008-029 I COOK 15 4

CONTRACT NO. 60E61

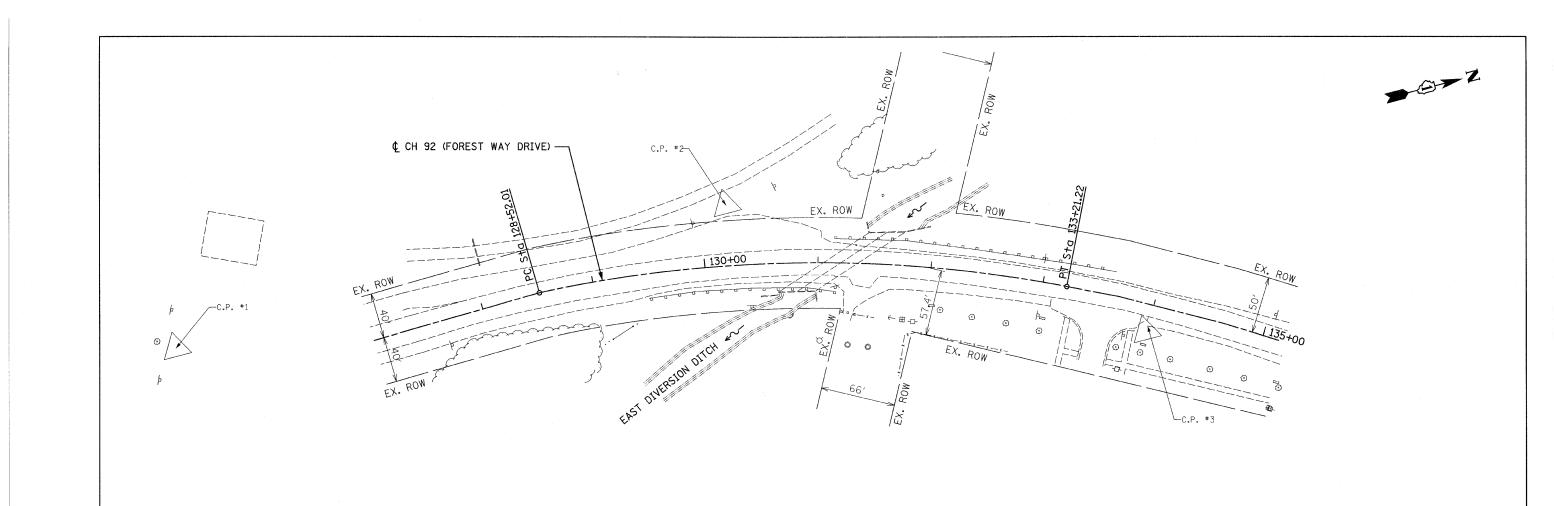


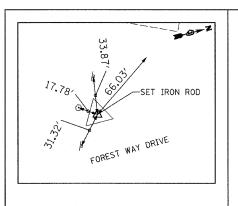

C.P. #1 SET %" IRON ROD STA. 125+30.09, 42.00' LT. N = 5,000.0000 E = 5,000.0000 ELEV. = 633.04

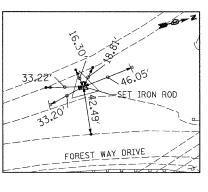

C.P. #2 SET 5%" IRON ROD STA. 130+22.30, 53.60' LT. N = 5,501.9200 E = 5,000.0000 ELEV. = 632.48

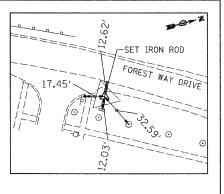

C.P. #3 SET 5// IRON ROD STA. 133+98.75, 23.70' RT. N = 5,832.9464 E = 5,201.1024ELEV. = 630.79

CENTERLINE ALIGNMENT							
	NORTHING	EASTING	STATION				
P. 0. T.	5, 208. 9523	5,036.5212	127+38.00				
P. C.	5, 322. 9234	5,033.5270	128+52, 01				
P. I.	5, 557. 9541	5,067.1449	128+89.92				
P. T.	5, 775. 2292	5, 145. 4914	133+21.22				
P. O. T.	5, 817. 4698	5, 165. 4367	133+67. 93				
P. 0. T.	5, 900. 9790	5, 211. 6800	134+63.39				
P. O. T.	5, 946. 3508	5, 239. 4105	135+16.56				

FOREST WAY DRIVE CURVE DATA
PI STA. = 130+89.92
$\Delta = 23* 22'. 37'' (RT)$
D = 4* 58′ 56″
R = 1,150.00'
T = 237.91'
L = 469.21'
E = 24.35'
e =
T. R. =
S. E. RUN =
P. C. STA. = 128+52,01
P.T. STA. = 133+21.22

FILE NAME = 1024M_sht_Align.dgn

PLOT DATE = 1/23/2009


REVISED REVISED PHONE: (312)372-2023 FAX: (312)372-5274 DATE - JANUARY 27, 2009 REVISED


STATE OF ILLINOIS **DEPARTMENT OF TRANSPORTATION**

ALIGNMENT AND TIES CH 92 (FOREST WAY DRIVE) SCALE: 1" = 40' SHEET NO. 1 OF 1 SHEETS STA. 130+00 TO STA. 131+15

COUNTY TOTAL SHEETS NO.

COOK 15 5 SECTION 2008-029 I CONTRACT NO. 60E61

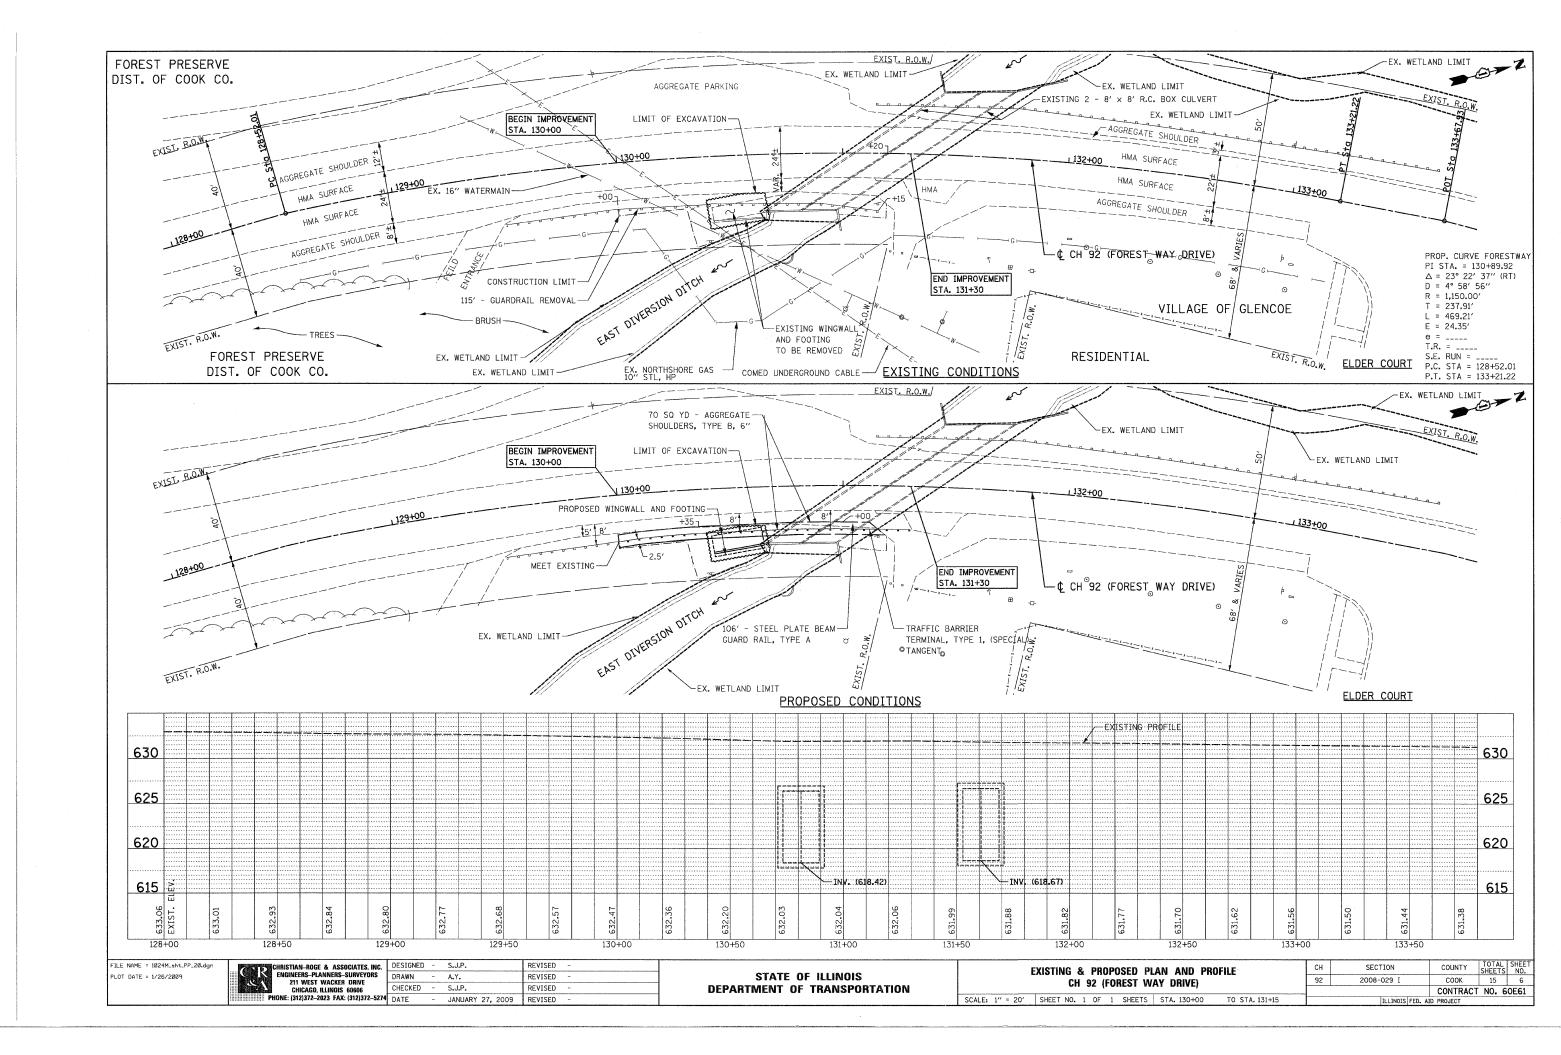

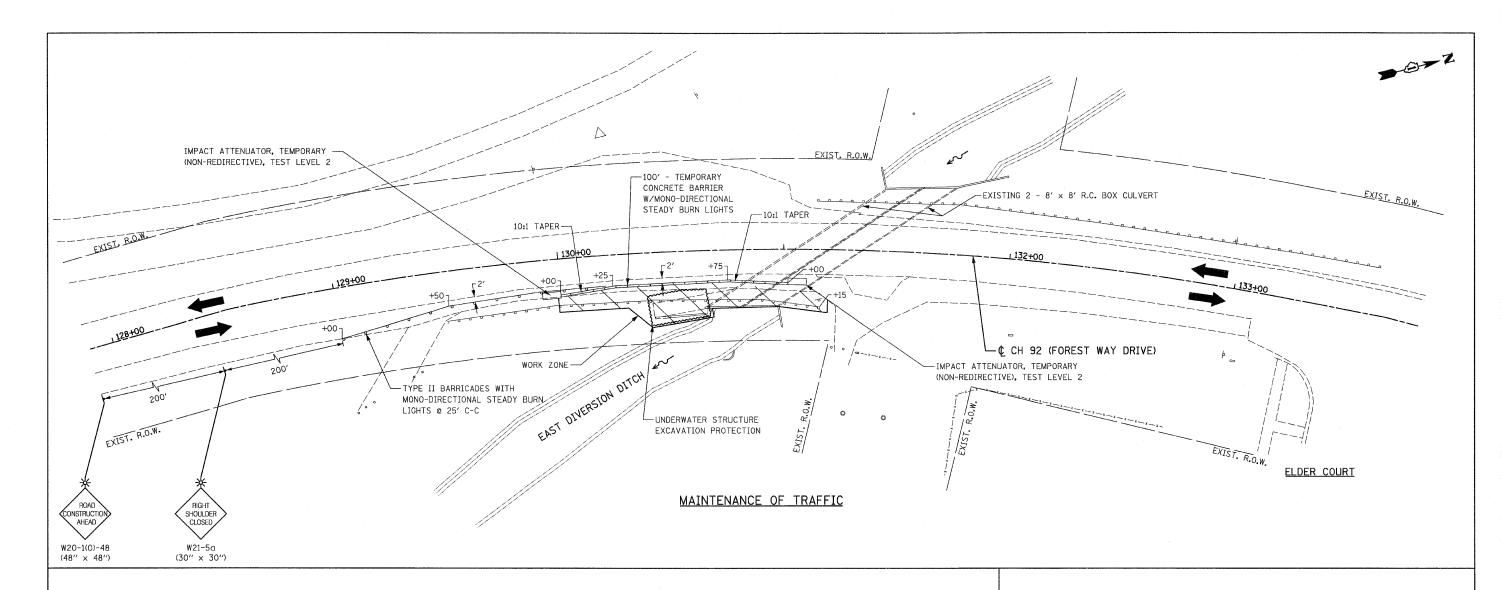

SUGGESTED STAGING AND MAINTENANCE OF TRAFFIC

CONSTRUCTION STAGING

PRE-STAGE

- INSTALL UNDERWATER STRUCTURE EXCAVATION PROTECTION.

WINGWALL RE-CONSTRUCTION

- REMOVE EXISTING GUARDRAIL, RECONSTRUCT WINGWALL,

BACKFILL EXCAVATION AND PLACE RIPRAP.

SHOULDER WORK

- PLACE AGGREGATE SHOULDER AND INSTALL GUARDRAIL.

MAINTENANCE OF TRAFFIC

PRE-STAGE

- USE DAILY LANE CLOSURES AS SHOWN ON IDOT STANDARD 701501, URBAN LANE CLOSURE, 2L, 2W, UNDIVIDED, TO PLACE TEMPORARY CONCRETE BARRIER AND TEMPORARY IMPACT ATTENUATORS.

WINGWALL RE-CONSTRUCTION

- USE DAILY LANE CLOSURES AS SHOWN ON IDOT STANDARD 701501, URBAN LANE CLOSURE, 2L, 2W, UNDIVIDED, DURING CONSTRUCTION ACTIVITIES IN THE WORK ZONE.

SHOULDER WORK

- REMOVE THE CONCRETE BARRIER IMMEDIATELY PRIOR TO PLACING THE AGGREGATE SHOULDER AND GUARDRAIL.
- MAINTAIN THE SHOULDER CLOSURE USING TYPE II BARRICADES W/ MONO-DIRECTIONAL STEADY BURN LIGHTS @ 25' C-C.
- USE DAILY LANE CLOSURES AS SHOWN ON IDOT STANDARD 701501, URBAN LANE CLOSURE, 2L, 2W, UNDIVIDED, DURING ACTIVITIES IN THE WORK ZONE.

FILE NAME = 1024M_sht_MCT.dgn

PLOT DATE = 1/23/2009

CHRISTIAN-ROGE & ASSOCIATES, IN ENGINEERS-PLANNERS-SURVEYORS 211 WEST WACKER DRIVE CHICAGO, ILLINOIS 60606
PHONE: (312)372-2023 FAX: (312)372-8

INC.	DESIGNED	_	S.J.P.	REVISED	ou .
PRS	DRAWN	-	A.Y.	REVISED	-
	CHECKED	-	S.J.P.	REVISED	
! 5274	DATE	-	JANUARY 27, 2009	REVISED	-

STATE OF ILLINOIS DEPARTMENT OF TRANSPORTATION


TRAFFIC CONTROL GENERAL NOTES

- 1. CONTRACTOR SHALL NOT MOUNT SIGNS ON EXISTING SIGNS.
- 2. CONTRACTOR SHALL MAINTAIN SATISFACTORY INGRESS AND EGRESS TO ADJACENT PROPERTIES THROUGHOUT THE CONSTRUCTION.

SUGGESTED TRAFFIC CONTROL AND STAGING PLAN	СН	SECTION	COUNTY	TOTAL	SHEET NO.
CH 92 (FOREST WAY DRIVE)	92	2008-029 I	COOK	15	7
on or hours, and sure			CONTRACT	NO. 6	0E61
SCALE: 1" = 20' SHEET NO. 1 OF 1 SHEETS STA. 130+00 TO STA. 131+15		ILLINOIS FED. A	D PROJECT		

EROSION CONTROL PLAN

- 1. THE CONTRACTOR SHALL USE A SILT CURTAIN WHEN EXCAVATING IN OR NEAR THE WATER.
- 2. ALL PUMPING FROM DE-WATERING SHALL BE FILTERED THROUGH A PORTABLE SEDIMENT TANK OR BAG PRIOR TO OUTLETTING INTO THE DITCH.
- 3. THE TEMPORARY EROSION CONTROL SYSTEMS SHALL BE REMOVED AS DIRECTED BY THE ENGINEER AFTER IT IS LONGER NEEDED.
- 4. EARTH STOCKPILES SHALL NOT BE ALLOWED WITHIN THE CONSTRUCTION SITE.
- 5. SEEDING CLASS 2 AND FERTILIZER SHALL BE PLACED ON ALL DISTURBED AREAS IN ACCORDANCE WITH SECTION 250.
- THE COST OF SEEDING AND FERTILIZER SHALL BE INCLUDED IN THE UNIT PRICE FOR HEAVY-DUTY EROSION CONTROL BLANKET.

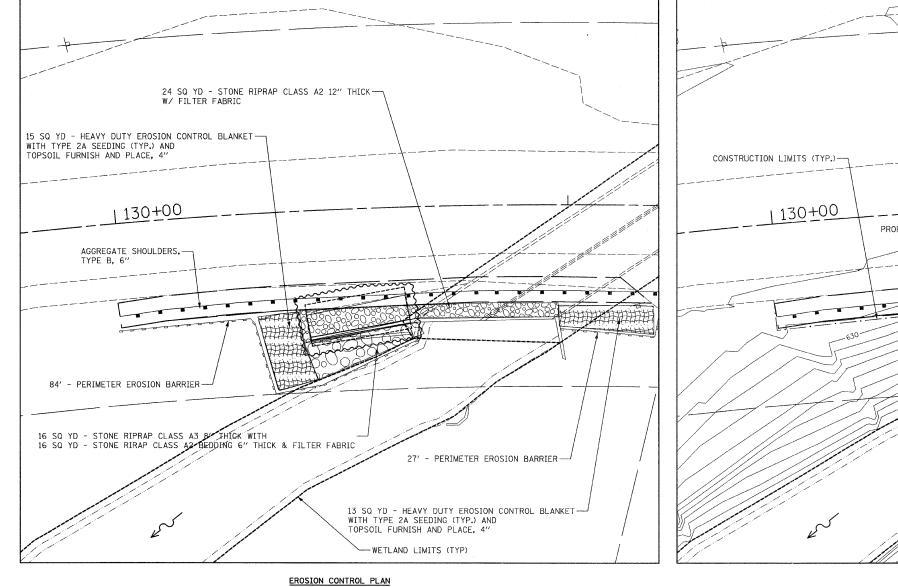

PROPOSED CONTOURS (TYP.)-PROPOSED WINGWALL-EXIST. WINGWALL TO BE REMOVED -WETLAND LIMITS (TYP) GRADING PLAN

FILE NAME = 1024M_sht_GR_10.dgn PLOT DATE = 1/26/2009 CHRISTIAN-ROGE & ASSOCIATES, INC.
ENGINEERS-PLANNERS-SURVEYORS
211 WEST WACKER DRIVE
CHICAGO, ILLINOIS 60606
PHONE: 3912372-2023 FAX: 3312372-5274


NC. DESIGNED - S.J.P. REVISED -
DRAWN - A.Y. REVISED -
CHECKED - S.J.P. REVISED -
5274 DATE - JANUARY 27, 2009 REVISED -


STATE OF ILLINOIS
DEPARTMENT OF TRANSPORTATION

 EROSION
 CONTROL AND GRADING PLAN

 CH
 92 (FOREST WAY DRIVE)

SCALE: 1" = 10' SHEET NO. 1 OF 1 SHEETS STA. 130+00 TO STA. 131+15

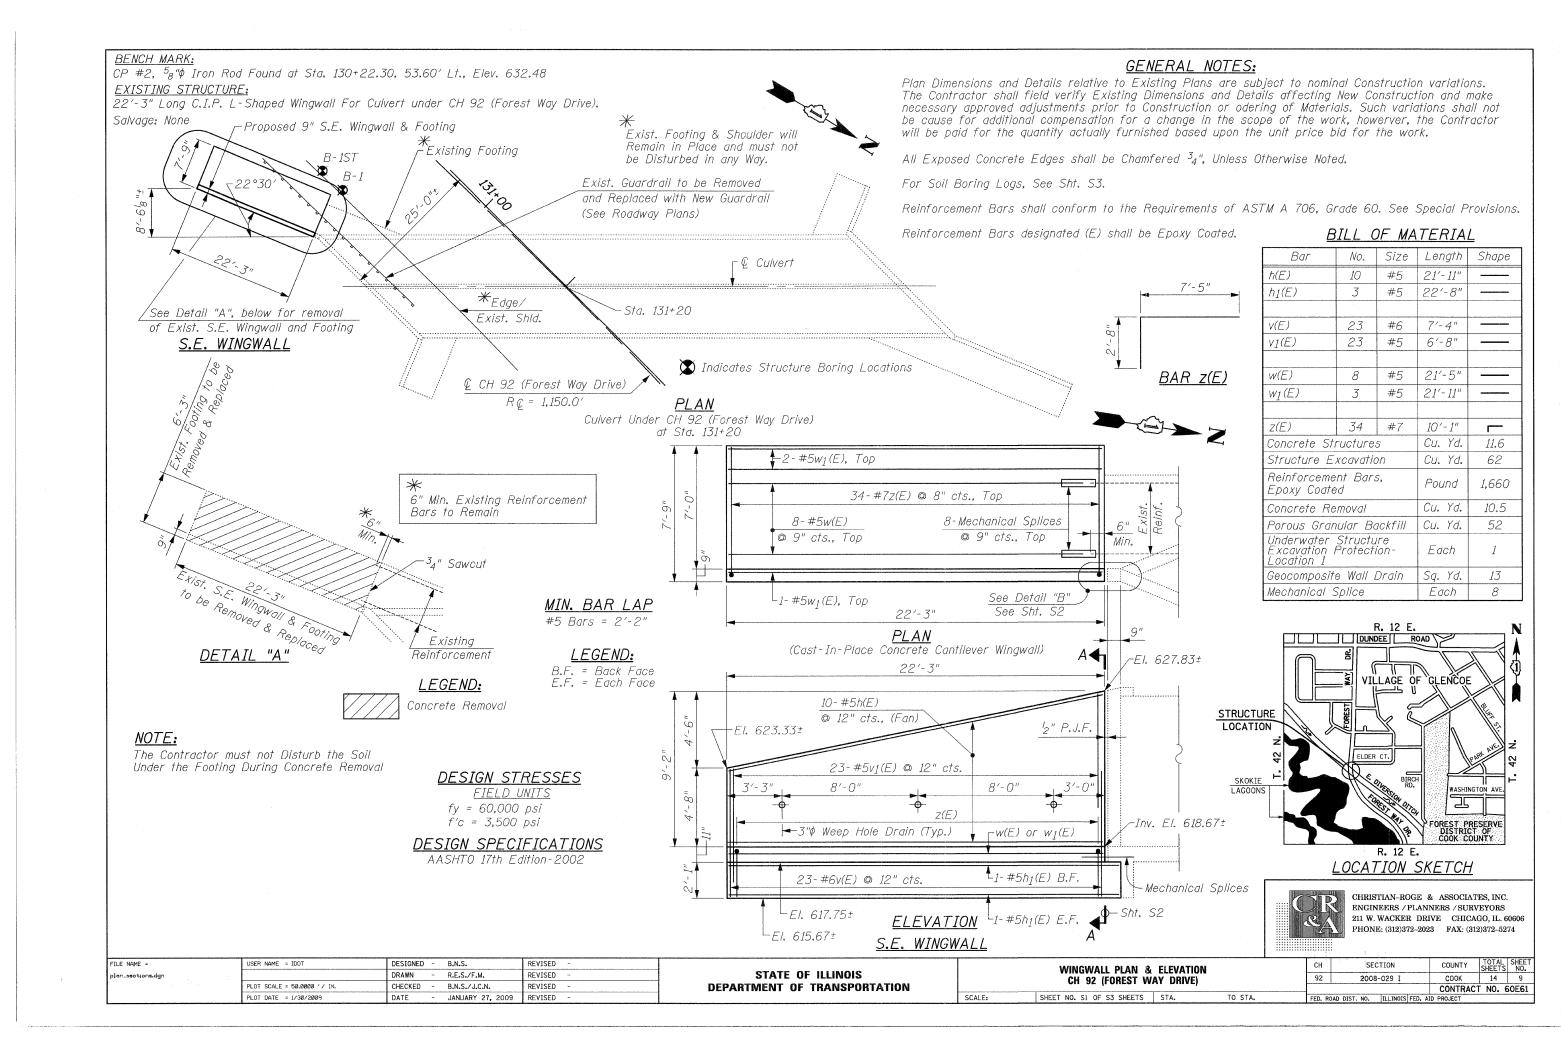

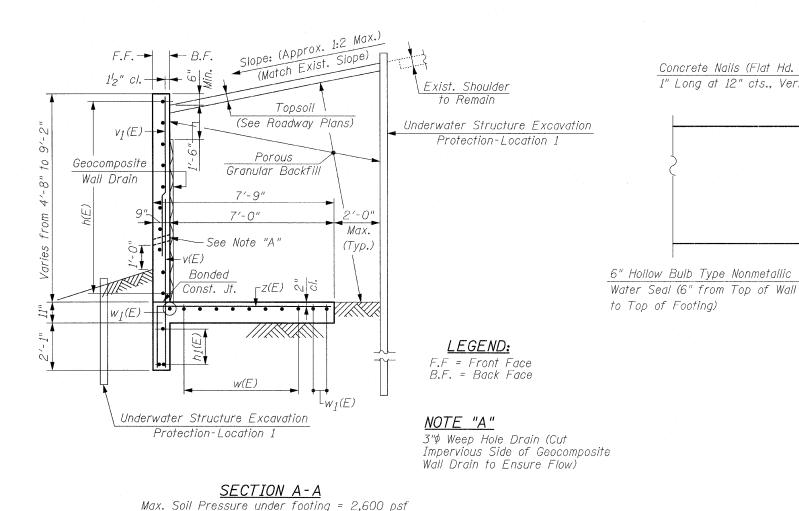

ASTM C881, Type III, Grade 1 DETAIL "B" Cost Included with Concrete Structures

12" Chamfer -

1₂" Premoulded Joint Filler

Cut Existing Water Seal

off Flush with Existing Wall

₋Back Face

Epoxy new Water Seal into 2" Wide Saw Cut Groove.

Type III, Grade 3. Prime Groove with an Epoxy Meeting

Epoxy to Meet the Requirements of ASTM C881,

NOTE:

SCALE:

Concrete Nails (Flat Hd. C.S.)

1" Long at 12" cts., Vertical

Work this Sheet With Sheet S1

TO STA.

CHRISTIAN-ROGE & ASSOCIATES, INC. ENGINEERS / PLANNERS / SURVEYORS 211 W. WACKER DRIVE CHICAGO, IL. 60606 PHONE: (312)372-2023 FAX: (312)372-5274

FILE NAME = USER NAME = IDOT DESIGNED - B.N.S. REVISED DRAWN R.E.S./F.M. REVISED PLOT SCALE = 50.0000 '/ IN. CHECKED - B.N.S./J.C.N. REVISED PLOT DATE = 1/30/2009 DATE - JANUARY 27, 2009 REVISED

STATE OF ILLINOIS **DEPARTMENT OF TRANSPORTATION**

WINGWALL DETAILS CH 92 (FOREST WAY DRIVE) SHEET NO. S2 OF S3 SHEETS STA.

COUNTY TOTAL SHEET NO. SECTION COOK 14 10 CONTRACT NO. 60E61 92 2008-029 I

Page 1 of Page 1 of Wang Engineering, Inc.
Consulting Geotechnical and
Environmental Engineers BORING LOG B-1 BORING LOG B-1ST Wang Engineering, Inc. Consulting Geotechnical and Environmental Engineers Datum: NGVD Datum: NGVD WEI Job No.: 950-09-02 WEI Job No.: 950-09-02 wangeng@wangeng.com Elevation: 630.00 ft wangeng@wangeng.com Elevation: 630.00 ft North: 1990553.00 ft North: 1990558.00 ft 1145 Main Street 1145 Main Street Christian Roge and Associate, Inc. Christian Roge and Associate, Inc. East: 1135627.00 ft East: 1135627.00 ft Lombard, IL 60148 Lombard, IL 60148 Project <u>East Division Ditch Culvert, IDOT D-91-058-08</u> Project <u>East Division Ditch Culvert, IDOT D-91-058-08</u> Telephone: 630 953-9928 Fax: 630 953-9938 Station: Telephone: 630 953-9928 Fax: 630 953-9938 Station: Cook County, Illinois Offset: Cook County, Illinois SOIL AND ROCK SOIL AND ROCK SOIL AND ROCK SOIL AND ROCK DESCRIPTION DESCRIPTION DESCRIPTION DESCRIPTION Medium dense, brown and white SANDY LOAM Hard, black and gray CLAY, √^{628,0} with trace gravel --FILL-Medium stiff, black and gray 0.82 CLAY, with trace gravel and ashpalt Soft to stiff, brown, black, and gray SILTY CLAY LOAM to Stiff to very stiff, black and gra 2.50 SILTY CLAY SILTY CLAY LOAM --LL=31%, PL=16%----LL=31%, PL=16%--Soft, black and gray SILTY CLAY LOAM with little organic 0.25 --LL=45%, PL=22%----LL=45%, PL=22%----LL=25%, PL=17%--Soft, gray SILTY CLAY --LL=25%, PL=17%--Medium stiff to stiff, gray SILTY-1.64 Boring terminated at 14.00 ft 0.74 Medium stiff to very stiff, gray CLAY with little sand and gravel Boring terminated at 36.00 ft GENERAL NOTES WATER LEVEL DATA GENERAL NOTES WATER LEVEL DATA Begin Drilling 07-14-2008 Complete Drilling 07-14-2008 Begin Drilling 07-14-2008 Complete Drilling 07-14-2008 While Drilling DRY While Drilling Drilling Contractor K&S Engineering Drill Rig Dietrich D-50 Drilling Contractor K&S Engineering Drill Rig Dietrich D-50 At Completion of Drilling 👤 At Completion of Drilling Driller _____M&E ___Logger __R. Edelmann _ Checked by ___MLS

SCALE:



Time After Drilling

CHRISTIAN-ROGE & ASSOCIATES, INC. ENGINEERS / PLANNERS / SURVEYORS 211 W. WACKER DRIVE CHICAGO, IL. 60606 PHONE: (312)372–2023 FAX: (312)372–5274

FILE NAME =	USER NAME = IDOT	DESIGNED -	B.N.S.	REVISED -
boring-logs.dgn		DRAWN -	R.E.S./F.M.	REVISED -
	PLOT SCALE = 50.0000 '/ IN.	CHECKED -	B.N.S./J.C.N.	REVISED ~
	PLOT DATE = 1/30/2009	DATE -	JANUARY 27, 2009	REVISED -

Driller M&E Logger R. Edelmann Checked by MLS

Drilling Method 3.25" HSA, Boring backfilled upon completion

STATE OF ILLINOIS **DEPARTMENT OF TRANSPORTATION**

Depth to Water Y NA
The stratification lines represent the approximate boundary between soil types; the actual transition may be gradual.

Time After Drilling NA


	SOIL BORING LOGS CH 92 (FOREST WAY DRIVE	LOGS				
	CH	1 92	(FO	REST W	/AY DRIVE)	
ET	NO	53 (DE S3	SHEETS	STA	TO S


Drilling Method 3.25" HSA, Boring backfilled upon completion


СН		SEC	TION			COUNTY	TOTAL SHEETS	SHE
92	2 2008-029 I				T	COOK	14	1:
						CONTRACT	T NO. 6	OE
CED I	DOAD DICT	NO	TI I TNOTE	EED	ATD	DDO ICCT		

NA

Depth to Water Y NA
The stratification lines represent the approximate boundary between soil types; the actual transition may be gradual.

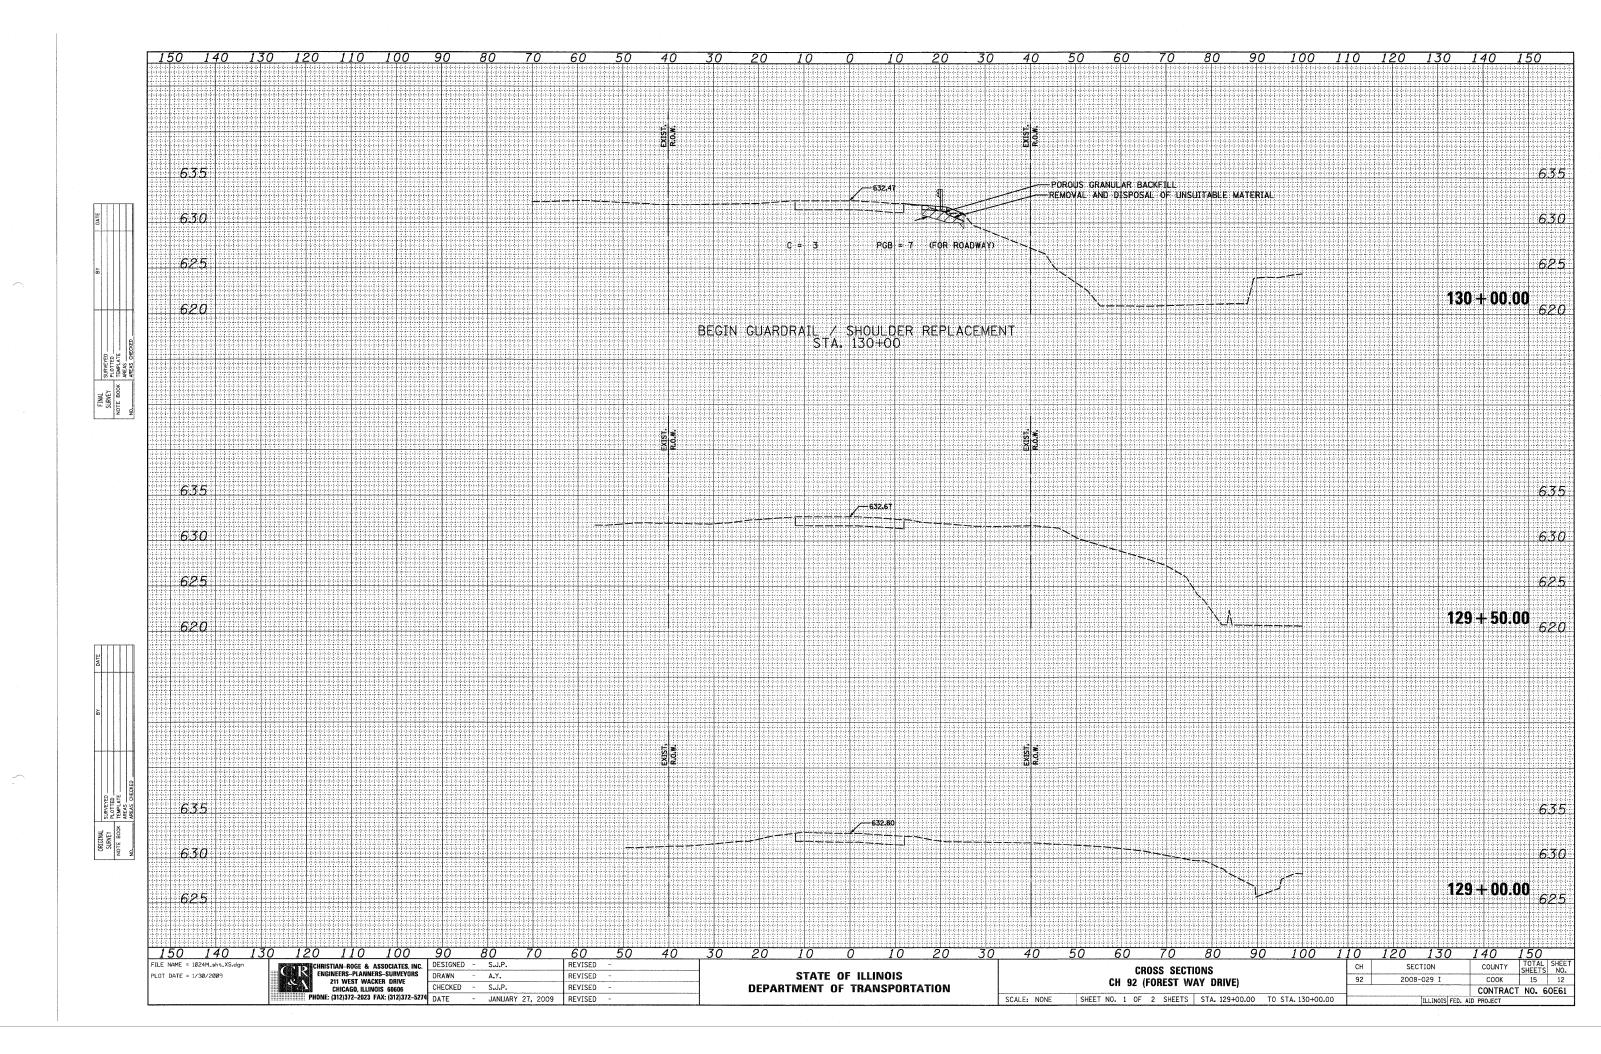

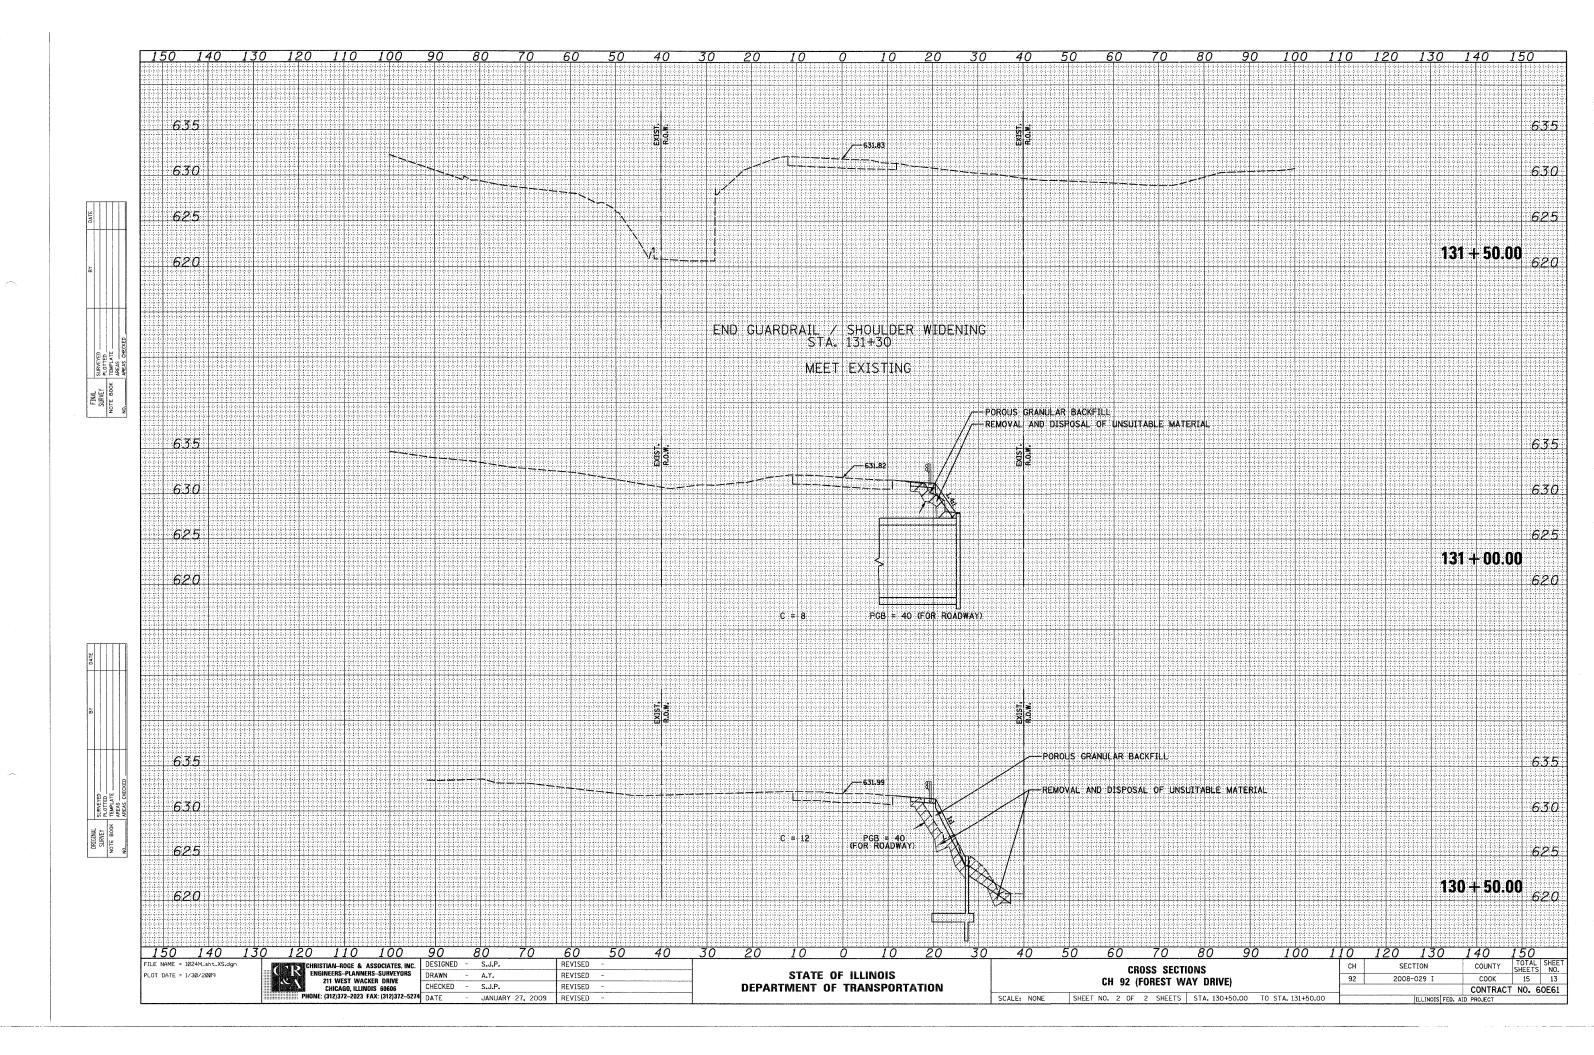

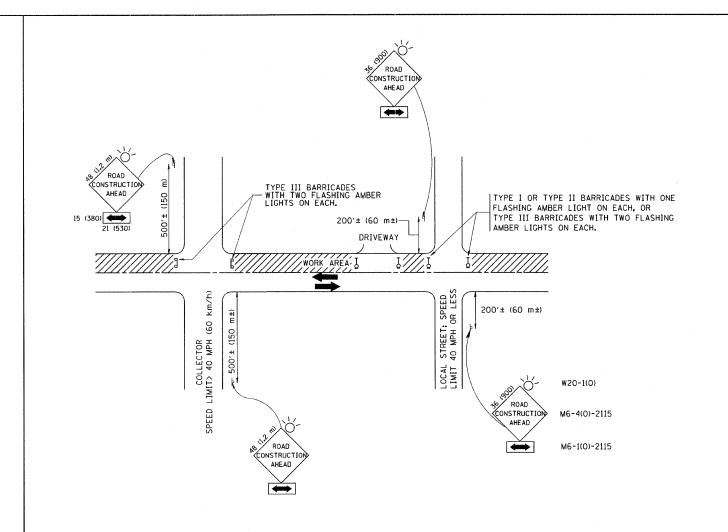

TRAFFIC CONTROL AND PROTECTION FOR SIDE ROADS, INTERSECTIONS, AND DRIVEWAYS

NOTES:

- A. FOR NO LANE RESTRICTION ON THE SIDE ROAD OR DRIVEWAYS
- 1. SIDE ROAD WITH A SPEED LIMIT OF 40 MPH (60 km/h) OR LESS AS SHOWN ON THE DRAWING AND AS DIRECTED BY THE ENGINEER:
- Q) ONE ROAD CONSTRUCTION AHEAD SIGN 36 x 36 (900x900) WITH A FLASHER AND FLAG MOUNTED ON IT APPROXIMATELY 200' (60 m) IN ADVANCE OF THE MAIN ROUTE.
- b) THE CLOSED PORTION OF THE MAIN ROUTE SHALL BE PROTECTED BY BLOCKING WITH TYPE I, TYPE II OR TYPE III BARRICADES, 1/3 OF THE CROSE SECTION OF THE COSED PORTION
- 2. SIDE ROAD WITH A SPEED LIMIT GREATER THAN 40 MPH (60 km/h) AS SHOWN ON THE DRAWING AND AS DIRECTED BY THE ENGINEER:
- a) ONE ROAD CONSTRUCTION AHEAD SIGN 48 x 48 (1.2 m x 1.2 m) WITH A FLASHER MOUNTED ON IT APPROXIMATELY 500' (150 m) IN ADVANCE OF THE MAIN ROUTE.
- b) THE CLOSED PORTION OF THE MAIN ROUTE SHALL BE PROTECTED BY BLOCKING WITH TYPE III BARRICADES, 1/2 OF THE CROSS SECTION OF THE CLOSED PORTION.
- 3. WHEN THE SIDE ROAD LIES BETWEEN THE BEGINNING OF THE MAINLINE SIGNING AND THE WORK ZONE, A SINGLE HEADED ARROW (MG-1) SHALL BE USED IN LIEU OF THE DOUBLE HEADED ARROW (MG-4).


- B. FOR A LANE CLOSURE ON A SIDE ROAD OR DRIVEWAY:
- USE APPLICABLE PORTIONS OF THE TYPICAL APPLICATION OF TRAFFIC CONTROL DEVICES (STD. 701501, STD. 701606 OR THE APPROPRIATE STANDARD). THE SPACING OF SIGNS AND BARRICADES SHALL BE ADJUSTED FOR FIELD CONDITIONS AS DIRECTED BY THE ENGINEER. THE DIRECTIONAL ARROW SHALL BE COVERED OR REMOVED WHEN NO LONGER CONSISTENT WITH THE SIDE ROAD LANE CLOSURE.
- C. ADVANCE WARNING SIGNS ARE TO BE OMITTED ON DRIVEWAY UNLESS OTHERWISE NOTED.
- D. THE TRAFFIC CONTROL AND PROTECTION FOR SIDE ROADS, INTERSECTIONS, AND DRIVEWAYS SHALL BE INCIDENTAL TO THE COST OF SPECIFIED TRAFFIC CONTROL STANDARDS OR ITEMS.

All dimensions are in millimeters (inches) unless otherwise shown.

FILE NAME =	USER NAME = gaglianobt	DESIGNED - LHA	REVISED - J. OBERLE 10-18-95
W:\diststd\22x34\tc10.dgn		DRAWN -	REVISED - A, HOUSEH 03-06-96
	PLOT SCALE = 50.000 ' / IN.	CHECKED -	REVISED - A. HOUSEH 10-15-96
	PLOT DATE = 1/4/2008	DATE - 06-89	REVISED -T. RAMMACHER 01-06-00

STATE	OF	ILLINOIS
DEPARTMENT	0F	TRANSPORTATION

1		TRAFFIC CONTROL AND PROTECTION FOR SIDE ROADS, INTERSECTIONS, AND DRIVEWAYS						COUNTY	SHEETS	NO.
								COOK	15	14
ł		SIDE RUADS, INTERSECTIONS, AND DRIVEWATS					TC-10	CONTRACT	NO. 60)E61
	SCALE: NONE SHEET NO. 1 OF 1 SHEETS STA.130+00 TO STA.131+15						DAD DIST. NO. 1 ILLINOIS FED. AI	D PROJECT		

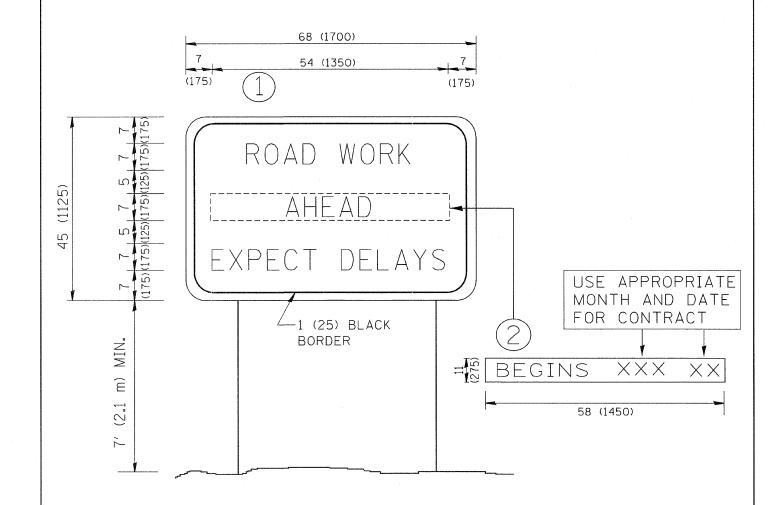

NOTES:

- 1. USE BLACK LETTERING ON ORANGE BACKGROUND.
- 2. ERECT SIGNS IN ADVANCE OF THE LOCATION FOR THE "ROAD CONSTRUCTION AHEAD" SIGN AT LOCATIONS AS DIRECTED BY THE ENGINEER.
- 3. ERECT SIGN (1) WITH INSTALLED PANEL (2) ONE WEEK PRIOR TO THE START OF CONSTRUCTION.
- 4. REMOVE PANEL 2 SOON AFTER THE START OF CONSTRUCTION.
- 5. SEE SPECIAL PROVISION FOR "TEMPORARY INFORMATION SIGNING" FOR ADDITIONAL INFORMATION.
- 6. ONE SIGN ASSEMBLY EQUALS 25.70 SQ. FT. (2.3 SQ. M.)
- 7. SHALL BE PAID FOR AS TEMPORARY INFORMATION SIGNING.

ALL DIMENSIONS ARE IN INCHES (MILLIMETERS)
UNLESS OTHERWISE SHOWN.

FILE NAME =	USER NAME = gaglianobt	DESIGNED -	REVISED - R. MIRS 09-15-97		ARTERIAL ROAD	RTE. SECTION	COUNTY TOTAL SHEET
Wi\diststd\22x34\to22.dgn		DRAWN -	REVISED - R. MIRS 12-11-97	STATE OF ILLINOIS	· .	2008-029 1	COOK 15 15
	PLOT SCALE = 50.000 '/ [N.	CHECKED -	REVISED -T. RAMMACHER 02-02-99	DEPARTMENT OF TRANSPORTATION	INFORMATION SIGN	TC-22	CONTRACT NO. 60E61
	PLOT DATE = 1/4/2008	DATE -	REVISED - C. JUCIUS 01-31-07		SCALE: NONE SHEET NO. 1 OF 1 SHEETS STA. 130+00 TO STA. 131+15	FED. ROAD DIST. NO. 1 ILLINOIS F	ED. AID PROJECT