STATE OF ILLINOIS

DEPARTMENT OF TRANSPORTATION

DIVISION OF HIGHWAYS

PROPOSED HIGHWAY PLANS

FAP 341 / IL. 72 SECTION: N-4-C-I **OVER 1-90 BRIDGE DECK OVERLAY** KANE COUNTY PROJECT: E5P-0341 (046) C-91-091-08

> **RUTLAND TOWNSHIP** R. 7 E.

VILLAGE OF **GILBERTS** 42

GROSS LENGTH OF PROJECT = 393.00 FEET = 0.074 MILES NET LENGTH OF PROJECT = 393.00 FEET = 0.074 MILES


DESIGN SECTION ENGINEER



CHRISTIAN-ROGE & ASSOCIATES INC. ENGINEERS - PLANNERS - SURVEYORS 211 W. WACKER DRIVE CHICAGO, IL. 60606 N-4-C-1

D-91-091-08



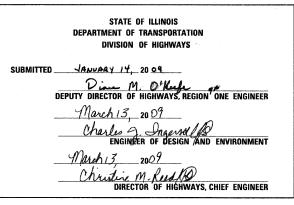



Birinder S. Souldera BIRINDER S. SACHDEVA, P.E. EXPIRES: 11-30-2009

January 12, 2003



Bharesh W. Sonh BHADRESH N. SHAH, S.E., P.E. EXPIRES: 11-30-2010

01/12/09

PRINTED BY THE AUTHORITY OF THE STATE OF ILLINOIS

FOR INDEX OF SHEETS, SEE SHEET NO. 2

DESIGN DESIGNATION: OTHER PRINCIPAL ARTERIAL POSTED SPEED: 40 M.P.H.

2007 ADT = 13.5002021 ADT = 12.150

 \circ

 \circ

 \circ

 \circ

MUNICIPALITY INVOLVED:

VILLAGE OF GILBERTS

PROJECT:

F.A.P. 341 / IL. 72 **OVER I-90** S.N. 045-0074

ENGINEERING SCALES. REDUCED SIZED PLANS WILL NOT CONFORM TO STANDARD SCALES. IN MAKING MEASUREMENTS ON REDUCED PLANS. THE ABOVE SCALES MAY BE USED.

JOINT UTILITY LOCATING INFORMATION FOR EXCAVATORS 1-800-892-0123 OR 811

DISTRICT ONE - DESIGN PROJECT MANAGER: ISAAC KWARTENG (847) 705-4230 PROJECT ENGINEER: RON ZENAROSA (847) 705-4212

CONTRACT NO. 60D72

INDEX OF SHEETS

1	COVER SHEET
2	INDEX OF SHEETS, LIST OF STATE STANDARDS AND GENERAL NOTES IL 72
3	SUMMARY OF QUANTITIES IL 72
4	TYPICAL SECTIONS AND DETAILS IL 72
5	ALIGNMENT, TIES AND PAVEMENT MARKINGS IL 72
6	EXISTING CONDITIONS AND PROPOSED PLAN AND PROFILE IL 72
7	CONSTRUCTION STAGING AND MAINTENANCE OF TRAFFIC NOTES AND DETAILS IL 72
8	SUGGESTED TRAFFIC CONTROL AND STAGING PLAN IL 72
9 - 10	TEMPORARY BRIDGE TRAFFIC SIGNAL PLANS
11	TEMPORARY LIGHTING PLAN IL 72
12	TEMPORARY LIGHTING NOTES AND DETAILS IL 72
13 - 20	STRUCTURAL DRAWINGS IL 72 OVER I-90
21	BUTT JOINT AND HMA TAPER DETAIL
22	TRAFFIC CONTROL AND PROTECTION FOR SIDE ROADS, INTERSECTIONS AND DRIVEWAYS
23	TEMPORARY LIGHT POLE DETAILS
24	TEMPORARY AERIAL CABLE INSTALLATION
25	TYPICAL APPLICATIONS RAISED REFLECTIVE PAVEMENT MARKERS (SNOW-PLOW RESISTANT)
26	DISTRICT ONE TYPICAL PAVEMENT MARKINGS
27 - 28	ISTHA STANDARD - CONSTRUCTION SIGNS
29 - 31	ISTHA STANDARD - LANE CLOSURE DETAILS
32	ISTHA STANDARD - TEMPORARY GORE DETAILS AND SHOULDER CLOSURE DETAILS

LIST OF STATE STANDARDS

STANDA	ARD NO. DESCRIP	TION _
000001	-05 STANDA	RD SYMBOLS, ABBREVIATIONS AND PATTERNS
701201	-03 LANE CL	OSURE, 2L, 2W, DAY ONLY, FOR SPEEDS > 45 MPH
701316	- 04 LANE CL	OSURE, 2L, 2W, BRIDGE REPAIR, FOR SPEEDS > 45 MPH
701901	-0/ TRAFFIC	CONTROL DEVICES
880001	-01 SPAN WI	RE MOUNTED SIGNALS AND FLASHING BEACON INSTALLATION

GENERAL NOTES

- 1. PLAN DIMENSIONS AND DETAILS RELATIVE TO EXISTING PLANS ARE SUBJECT TO ROUTINE VARIATIONS.

 THE CONTRACTOR SHALL FIELD VERIFY EXISTING DIMENSIONS AND DETAILS AFFECTING NEW

 CONSTRUCTION AND MAKE NECESSARY APPROVED ADJUSTMENTS PRIOR TO CONSTRUCTION OR ORDERING

 MATERIALS. SUCH VARIATIONS SHALL NOT BE CAUSE FOR ADDITIONAL COMPENSATION FOR A CHANGE IN

 THE SCOPE OF THE WORK, HOWEVER, THE CONTRACTOR WILL BE PAID FOR THE QUANTITY ACTUALLY

 FURNISHED BASED UPON THE UNIT PRICE.
- 2. FORTY-EIGHT HOURS BEFORE STARTING EXCAVATION, THE CONTRACTOR WILL CALL J.U.L.I.E. (1-800-892-0123) OR 811 TO HAVE THE LOCATION OF EXISTING UTILITIES STAKED.
- 3. THE CONTRACTOR WILL NOT BE ALLOWED TO SET UP A YARD OR FIELD OFFICE ON STATE PROPERTY WITHOUT WRITTEN PERMISSION FROM THE DEPARTMENT.
- 4. SAW CUTTING PRIOR TO ANY REMOVAL ITEMS NOTED ON THE PLANS OR DIRECTED BY THE ENGINEER SHALL BE CONSIDERED INCLUDED IN THE COST OF THE ITEMS BEING REMOVED.
- 5. DO NOT SCALE PLANS FOR CONSTRUCTION DIMENSIONS.

SCALE: MONE

- 6. THE CONTRACTOR SHALL USE CARE IN REMOVING OR EXCAVATING NEAR ALL EXISTING ITEMS WHICH WILL REMAIN. ANY DAMAGE DONE TO EXISTING ITEMS BY THE CONTRACTOR SHALL BE REPAIRED AT THE CONTRACTOR'S EXPENSE.
- 7. WHEN ARTIFICIAL LIGHTING IS UTILIZED IN NIGHT OPERATIONS, THE CONTRACTOR SHALL EXERCISE THE UTMOST PRECAUTIONS IN PREVENTING ADVERSE VISIBILITY TO THE MOTORING PUBLIC AS WELL AS ADJOINING RESIDENTIAL AREAS.
- 8. THE CONTRACTOR SHALL OBTAIN ALL NECESSARY PERMITS, AS REQUIRED, PRIOR TO COMMENCING WITH CONSTRUCTION.
- 9. THE COST OF THE TOLLWAY PERMIT AND BOND AND THE COST OF THE TRAFFIC CONTROL AND PROTECTION ON I-90 (NORTHWEST TOLLWAY) TO INSTALL AND REMOVE THE PROTECTIVE SHIELDING SHALL BE INCLUDED IN THE BID PRICE FOR TRAFFIC CONTROL AND PROTECTION (EXPRESSWAYS).
- 10. THE CONTRACTOR SHALL CONTACT THE TRAFFIC CONTROL SUPERVISOR AT (847) 705-4470 A MINIMUM OF 72 HOURS PRIOR TO THE PLACEMENT OF ANY TEMPORARY TRAFFIC CONTROL DEVICES.
- 11. THE CONTRACTOR SHALL CONTACT DAN CHIARUGI, THE AREA TRAFFIC FIELD ENGINEER, AT (847) 741-9857 TWO (2) WEEKS PRIOR TO THE PLACEMENT OF PERMANENT PAVEMENT MARKINGS.
- 12. ALL DAMAGE TO EXISTING PAVEMENT MARKINGS OUTSIDE THE REMOVAL LINE SHOWN ON THE PLANS SHALL BE REPLACED AT THE CONTRACTOR'S EXPENSE.
- 13. ILLINOIS DEPARTMENT OF TRANSPORTATION SHALL COORDINATE WITH THE VILLAGE OF GILBERTS TO ENSURE APPROPRIATE SIGNAL TIMING FOR THE SATISFACTORY MOVEMENTS OF WESTBOUND RUSH HOUR AND THAT THE SUBDIVISION ENTRANCES SHALL NOT BE BLOCKED BY VEHICLES DURING HOURS OF HEAVY TRAFFIC.
- 14. THE COST FOR ANY TEMPORARY RAMPS SHALL BE INCLUDED IN THE CONTRACT PRICE PER SQUARE YARD FOR HOT MIX ASPHALT SURFACE REMOVAL BUTT JOINT.

SHEET NO. 1 OF 1 SHEETS STA 179400

INDEX OF SHEETS LIST OF STATE STANDARDS AND GENERAL NOTES	F.A.P. RTE.	SECTI
IL 72	341	N-4-0

TO STA 194400

		SUMMARY OF QUANTITIES		URBAN 1004. FEO.	CONSTRUCTION TYPE CODE
	CODE NO	ITEM	UNIT	TOTAL QUANTITIES	IL 72 BRIDGE SFTY-2A
ŀ	40 6 00200	BITUMINOUS MATERIALS (PRIME COAT)	TON	1	1
	40600982	HOT-MIX ASPHALT SURFACE REMOVAL - BUTT JOINT	SQ YD	27	27
	40603340	HOT-MIX ASPHALT SURFACE COURSE, MIX "D", N70	TON	32	32
	44000155	HOT-MIX ASPHALT SURFACE REMOVAL, 1 1/2"	SQ YD	381	381
	50102400	CONCRETE REMOVAL	CU YD	65.0	65.0
	50157300	-PROTECTIVE-SHIEL-D-	-SQ-YD-	700	700
	50300255	CONCRETE SUPERSTRUCTURE	CU YD	65.0	65.0
	50300260	BRIDGE DECK GROOVING	SQ YD	832	832
	50300300	PROTECTIVE COAT	SQ YD	961	961
	50800205	REINFORCEMENT BARS, EPOXY COATED	POUND	15,190	15,190
	50800515	BAR SPLICERS	EACH	122	122
	52000110	PREFORMED JOINT STRIP SEAL	FOOT	225	225
	67000400	ENGINEER'S FIELD OFFICE, TYPE A	CAL MO	6	6
	67100100	MOBILIZATION	L SUM	1	1
	70100100	TRAFFIC CONTROL AND PROTECTION, STANDARD 701316	EACH	1	1
	70100450	TRAFFIC CONTROL AND PROTECTION, STANDARD 701201	L SUM	1	1
	70106800	CHANGEABLE MESSAGE SIGN	CAL MO	2	2
*	78008210	POLYUREA PAVEMENT MARKING TYPE I - LINE 4"	FOOT	1,179	1,179
*	78100100	RAISED REFLECTIVE PAVEMENT MARKER	EACH	4	4
*	78100105	RAISED REFLECTIVE PAVEMENT MARKER (BRIDGE)	EACH	6	6
	78300100	PAVEMENT MARKING REMOVAL	SQ FT	393	393
	78300200	RAISED REFLECTIVE PAVEMENT MARKER REMOVAL	EACH	10	10

		SUMMARY OF QUANTITIES		URBAN 100% FED.	CONSTRUCTION TYPE CODE
1	CODE NO	ITEM	UNIT	TOTAL QUANTITIES	IL 72 BRIDGE SFTY-2A
	80400100	ELECTRIC SERVICE INSTALLATION	EACH	1	1
	80400200	ELECTRIC UTILITY SERVICE CONNECTION	L SUM	1	1
*	81800300	AERIAL CABLE, 3-1/C NO. 2 WITH MESSENGER WIRE	FOOT	1,608	1,608
*	82103400	LUMINAIRE, SODIUM VAPOR, HORIZONTAL MOUNT, PHOTO-CELL CONTROL, 400 WATT	EACH	8	8
*	83057355	LIGHT POLE, WOOD, 60 FOOT, CLASS 4, WITH 15FT MAST ARM	EACH	8	. 8
*	83057435	LIGHT POLE, WOOD, 80 FOOT, CLASS 3, WITH 15FT MAST ARM	EACH	2	2
*	830574 3 0	LIGHT POLE, WOOD, 80 FOOT, CLASS 3	EACH	1	1
*	84100110	REMOVAL OF TEMPORARY LIGHTING UNITS	EACH	8	8
*	X0322141	REMOVE TEMPORARY WOOD POLE	EACH	1	1
	X0322467	TEMPORARY INFORMATION SIGNING FOR LANE CLOSURE	SQ FT	48	48
*	X0323574	MAINTENANCE OF LIGHTING SYSTEM	CAL MO	6	6
	X0325775	WET REFLECTIVE TEMPORARY TAPE, TYPE III, 4 INCH	FOOT	1,481	1,481
*	X0325867	- COMBINATION POLE MOUNTED ELECTRIC SERVICE BOX	-EACH-	-1	-
	X7011015	TRAFFIC CONTROL AND PROTECTION (EXPRESSWAYS)	L SUM	1	1
*	X8900005	TEMPORARY BRIDGE TRAFFIC SIGNAL INSTALLATION	EACH	1	1
*	XX006937	GROUND ROD, 5/8" DIA. × 10 FT.	EACH	2	2
	Z0006229	BRIDGE DECK HYDRO-SCARIFICATION 3"	SQ YD	901	901
	Z0016002	DECK SLAB REPAIR (FULL DEPTH, TYPE II)	SQ YD	44	44
	X0 <i>326346</i>	BRIDGE DECK LATEX CONCRETE OVERLAY, 3 INCHES	SQ YD	901	901
*	X032613 5	ELECTRIC SERVICE DISCONNECT, LIGHTING AND TRAFFIC SIGNAL	EACH	. 1	1

* SPECIALTY ITEM

* SPECIALTY ITEM

FILE NAME = 60072 S00.dgn PLOT DATE = 1/15/2009

L	
	CHRISTIAN-ROGE & ASSOCIATES, INC.
	ENGINEERS-PLANNERS- SURVEYORS
	211 WEST WACKEF DRIVE
THE REAL PROPERTY.	CHICAGO, :LLINOIS 60606
	PHONE: (312)372_2023 FAY: (312)372_5274

C.	DESIGNED		S.J.P.	REVISED	-
	DRAWN	-	A.Y.	REVISED	-
	CHECKED	-	E.J.M.	REVISED	And
274	DATE	**	JANUARY 15, 2009	REVISED	*


SUMMARY OF QUANTITIES	F.A.P. RTE.	SEC FION	COUNTY	TOTAL	SHEET NO.
11 72	341	N-4-C 1	KANE	32	3
He. 76		1000	CONTRACT	NO. 6	0D72
T NO. 1 OF 1 SHEETS STA. 179+00 TO STA. 194+00	FED. R	OAD DIST. NO. 1 THE THOUS FED. A	D PROJECT		

HOT-MIX ASPHALT MIXTURE REQUIREMENTS							
MIXTURE TYPE AC TYPE AIR VOIDS							
PAVEMENT RESURFACING							
HOT-MIX ASPHALT SURFACE COURSE, MIX "D", N70 (IL 9.5 mm), $1\frac{1}{2}$ "	PG 64-22	4% @ 70 Gyr.					


THE UNIT WEIGHT USED TO CALCULATE HMA MIXTURE QUANTITIES IS 112 LBS/SQ YD/IN. * WHEN RAP EXCEEDS 20%, THE NEW ASPHALT BINDER IN THE MIX SHALL BE PG 58-22.

NOTES:

1. EXISTING PAVEMENT TO BE OVERLAID WILL BE CLEANED AND PRIMED PER ARTICLE 407.06 OF THE 2007 STANDARD SPECIFICATIONS.

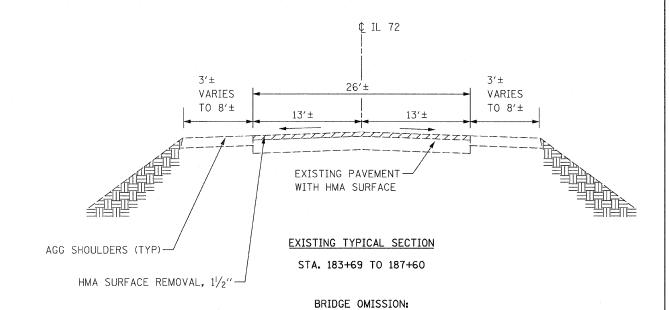

STA. 184+27.70 TO STA. 187+00.01

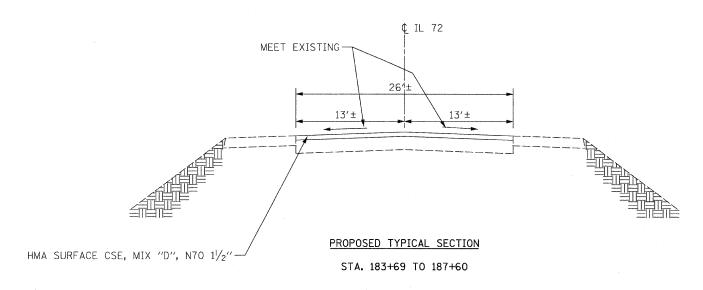

BRIDGE OMISSION: STA. 184+27.70 TO STA. 187+00.01


FILE	NAME	=	6ØD72	typ.dgn
PLOT	DATE	2	1/15/2	ØØ9

m COR	CHRISTIAN-ROGE & ASSOCIATES, INC.
	ENGINEERS-PLANNERS-SURVEYORS
~\A	211 WEST WACKER DRIVE
	CHICAGO, ILLINOIS 60606
	PHONE: (312)372-2023 FAX: (312)372-5274

, INC.	DESIGNED	-	S.J.P.	REVISED	m
ORS	DRAWN	-	A.Y.	REVISED	-
	CHECKED	-	E.J.M.	REVISED	·
25274	DATE	-	JANUARY 15, 2009	REVISED	-

STATE	OF	ILLINOIS	
DEPARTMENT (DF :	TRANSPORTATION	


TYPICAL SECTIONS & DETAILS	F.A.P. RTE.	SECTION	COUNTY	TOTAL SHEETS	SHEET NO.
IL 72	341	N-4-C-1	KANE	32	4
			CONTRACT	NO. 6	D72
SCALE: NONE SHEET NO. 1 OF 1 SHEETS STA. 179+00 TO STA. 194+00	FED. R	OAD DIST. NO. 1 ILLINOIS FED. A	ID PROJECT		

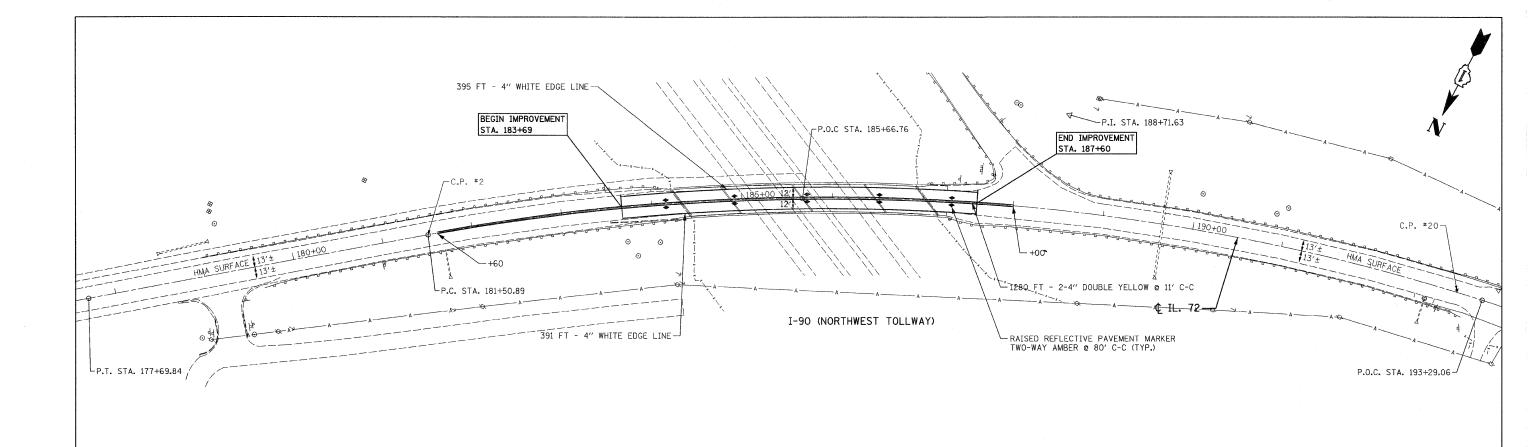

PAVEMENT MARKING NOTES:

1. ALL PAVEMENT MARKINGS ON BRIDGE DECK AND PAVEMENT SHALL BE POLYUREA, TYPE I.

CURVE DATA P.C. STA. 181+50.89 P.I. STA. 188+71.63 P.O.C. STA. 193+29.06 P.T. STA. 195+51.24 R = 2,400.00'L = 1,400.35' \triangle = 2° 23′ 14″ (RT) E = 105.89'D = 2° 23′ 14″ T = 720.74'

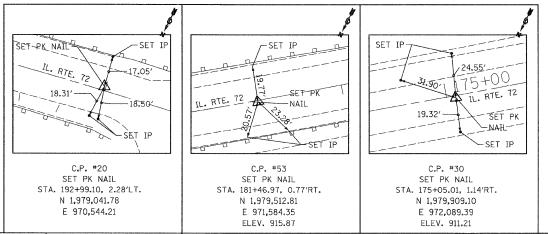

CENTERLINE ALIGNMENT									
PN	POINT	NORTHING	EASTING	STATION					
5000	P. O. T.	1, 979, 979. 67	972, 181. 75	173+88.78					
5004	P. O. T.	1, 979, 745. 34	971,881.27	177+69.84					
5001	P. C.	1, 979, 511. 01	971, 580. 78	181+50.89					
5002	P. C. C.	1, 979, 285. 11	971, 232. 23	185+66. 79					
5005	P. O. C.	1, 979, 038. 73	970, 514. 30	193+29.06					
5003	P. T	1, 979, 011. 00	970. 293. 93	195+51.24					

FILE NAME = 60072 align pm.dgr PLOT DATE = 1/15/2009

PHONE: (312)372-2023 FAX: (312)372-5274 DATE

 CHRISTIAN-ROGE & ASSOCIATES, INC.
 DESIGNED
 S.J.P.


 ENGINEERS-PLANNERS-SURVEYORS
 DRAWN
 A.Y.

 211 WEST WACKER DRIVE
 CHECKED
 E.J.M.
 REVISED -REVISED REVISED JANUARY 15, 2009 REVISED

STATE OF ILLINOIS **DEPARTMENT OF TRANSPORTATION**

COUNTY TOTAL SHEET NO.

KANE 32 5 SECTION ALIGNMENT, TIES, AND PAVEMENT MARKINGS N-4-C-1 IL 72 CONTRACT NO. 60D72 SCALE: 1" = 50' SHEET NO. 1 OF 1 SHEETS STA. 179+00 TO STA. 194+00 FED. ROAD DIST. NO. 1 | ILLINOIS | FED. AID PROJECT

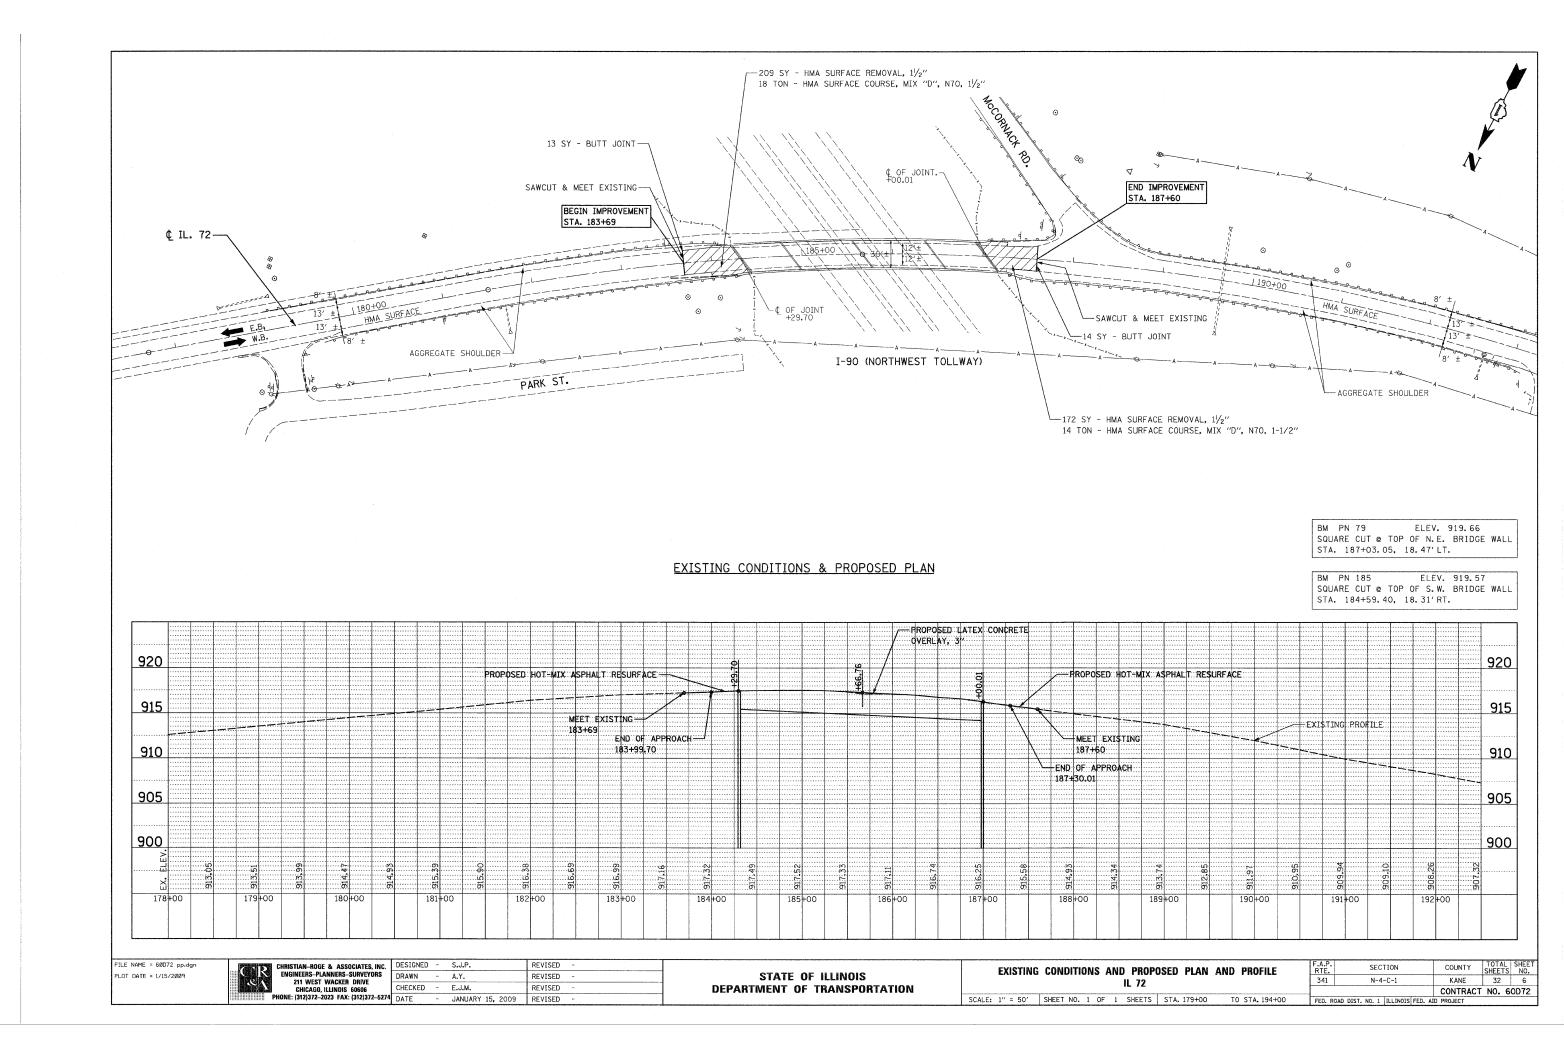

SUGGESTED STAGING AND MAINTENANCE OF TRAFFIC

CONSTRUCTION STAGING

PRE-STAGE

- INSTALL TEMPORARY LIGHTING, TEMPORARY BRIDGE TRAFFIC SIGNAL AND TRAFFIC CONTROL DEVICES FOR STAGE I.
- INSTALL PROTECTIVE SHIELDING.

STAGE I - WESTBOUND LANES

- REMOVE EXISTING CONCRETE OVERLAY, PERFORM DECK SLAB REPAIRS,
RECONSTRUCT TRANSVERSE JOINTS, AND PLACE LATEX CONCRETE WEARING SURFACE.

STAGE II - EASTBOUND LANES

- REMOVE EXISTING CONCRETE OVERLAY, PERFORM DECK SLAB REPAIRS,
 RECONSTRUCT TRANSVERSE JOINTS, AND PLACE LATEX CONCRETE WEARING SURFACE.
- SCARIFY AND RESURFACE BRIDGE APPROACH PAVEMENT.
- REMOVE PROTECTIVE SHIELDING.

MAINTENANCE OF TRAFFIC

PRE-STAGE

- USE DAILY LANE CLOSURES TO INSTALL TEMPORARY LIGHTING AND SIGNALS AND PLACE TRAFFIC CONTROL DEVICES

 FOR STAGE I. USE IDOT STANDARD 701201 LANE CLOSURE, 2L, 2W, DAY ONLY, FOR SPEEDS > 45 MPH.
- USE NIGHTTIME LANE CLOSURES TO INSTALL PROTECTIVE SHIELDING. USE ISHTA SECTION-E STANDARDS.

STAGE I

- CLOSE WESTBOUND LANE AS SHOWN ON THE SUGGESTED TRAFFIC CONTROL AND STAGING PLAN AND ON IDOT STANDARD 701316 LANE CLOSURE, 2L, 2W BRIDGE REPAIR FOR SPEEDS > 45 MPH.
- MAINTAIN ONE-LANE TWO-WAY TRAFFIC ON EASTBOUND PAVEMENT ACROSS BRIDGE.


STAGE II


- CLOSE EASTBOUND LANE AS SHOWN ON THE SUGGESTED TRAFFIC CONTROL AND STAGING PLAN AND ON IDOT STANDARD 701316 LANE CLOSURE, 2L, 2W BRIDGE REPAIR FOR SPEEDS > 45 MPH.
- SHIFT ONE-LANE TWO-WAY TRAFFIC TO WESTBOUND PAVEMENT ACROSS BRIDGE.
- REMOVE TEMPORARY BRIDGE TRAFFIC SIGNALS, LIGHTING AND TRAFFIC CONTROL DEVICES USING DAILY

 LANE CLOSURES. SEE IDOT STANDARD 701201 LANE CLOSURE, 2L, 2W, DAY ONLY, FOR SPEEDS > 45 MPH.
- USE NIGHTTIME LANE CLOSURES TO REMOVE PROTECTIVE SHIELDING. USE ISHTA SECTION-E STANDARDS.

TRAFFIC CONTROL GENERAL NOTES

- 1. USE SUGGESTED TRAFFIC CONTROL AND STAGING PLAN IN CONJUNCTION WITH STANDARD 701316.
- CONTRACTOR SHALL MAINTAIN SATISFACTORY INGRESS AND EGRESS TO ADJACENT PROPERTIES
 THROUGHOUT THE CONSTRUCTION.
- 3. INSTALL TEMPORARY SIGN PANEL ASSEMBLY, AS DIRECTED BY THE ENGINEER, TO BE PAID FOR BY ITEM "TEMPORARY INFORMATION SIGNING FOR LANE CLOSURE".
- 4. ALL TEMPORARY PAVEMENT MARKING SHALL BE WET REFLECTIVE TEMPORARY TAPE, TYPE III.
- 5. THE FIRST TWO SIGNS ENTERING THE WORK ZONE SHALL HAVE MONO-DIRECTIONAL FLASHING BEACONS.
- 6. THE CONTRACTOR SHALL NOT MOUNT TEMPORARY SIGNS ONTO OR OVER EXISTING SIGNS.
- THE COST OF ADDITIONAL SIGNING SHALL BE INCLUDED THE CONTRACT PRICE FOR TRAFFIC CONTROL AND PROTECTION, STANDARD 701316.

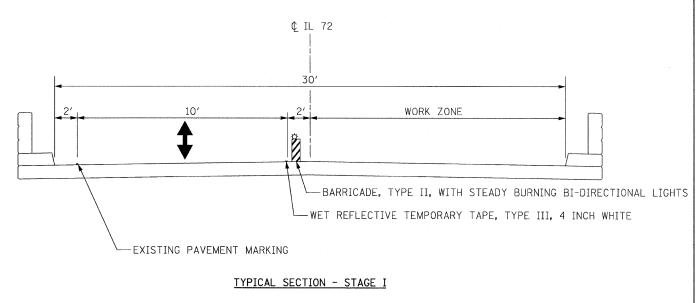

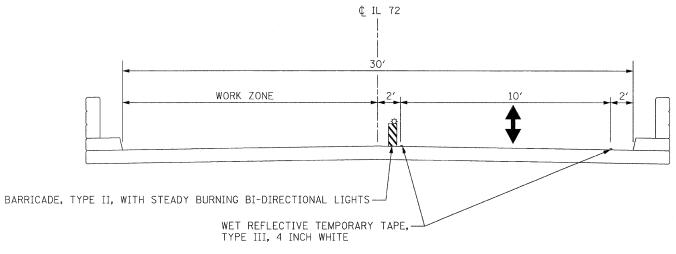

TYPICAL SECTION - STAGE II

TO STA. 194+00

FILE NAME = 60D72 stagingl.dgn PLOT DATE = 1/15/2009

CHRISTIAN-ROGE & ASSOCIATES, INC.
ENGINEERS-PLANNERS-SURVEYORS
211 WEST WACKER DRIVE
CHICAGO, ILLINOIS 60606
PHONE: (312)372-2023 FAX: (312)372-5274
DATE


STATE OF ILLINOIS
DEPARTMENT OF TRANSPORTATION

SUGGESTED MAINTENANCE OF TRAFFIC NOTES AND DETAILS IL 72


SHEET NO. 1 OF 2 SHEETS STA. 179+00


F.A.P. SECTION COUNTY TOTAL SHEET NO. 341 N-4-C-1 KANE 32 7

CONTRACT NO. 60D72

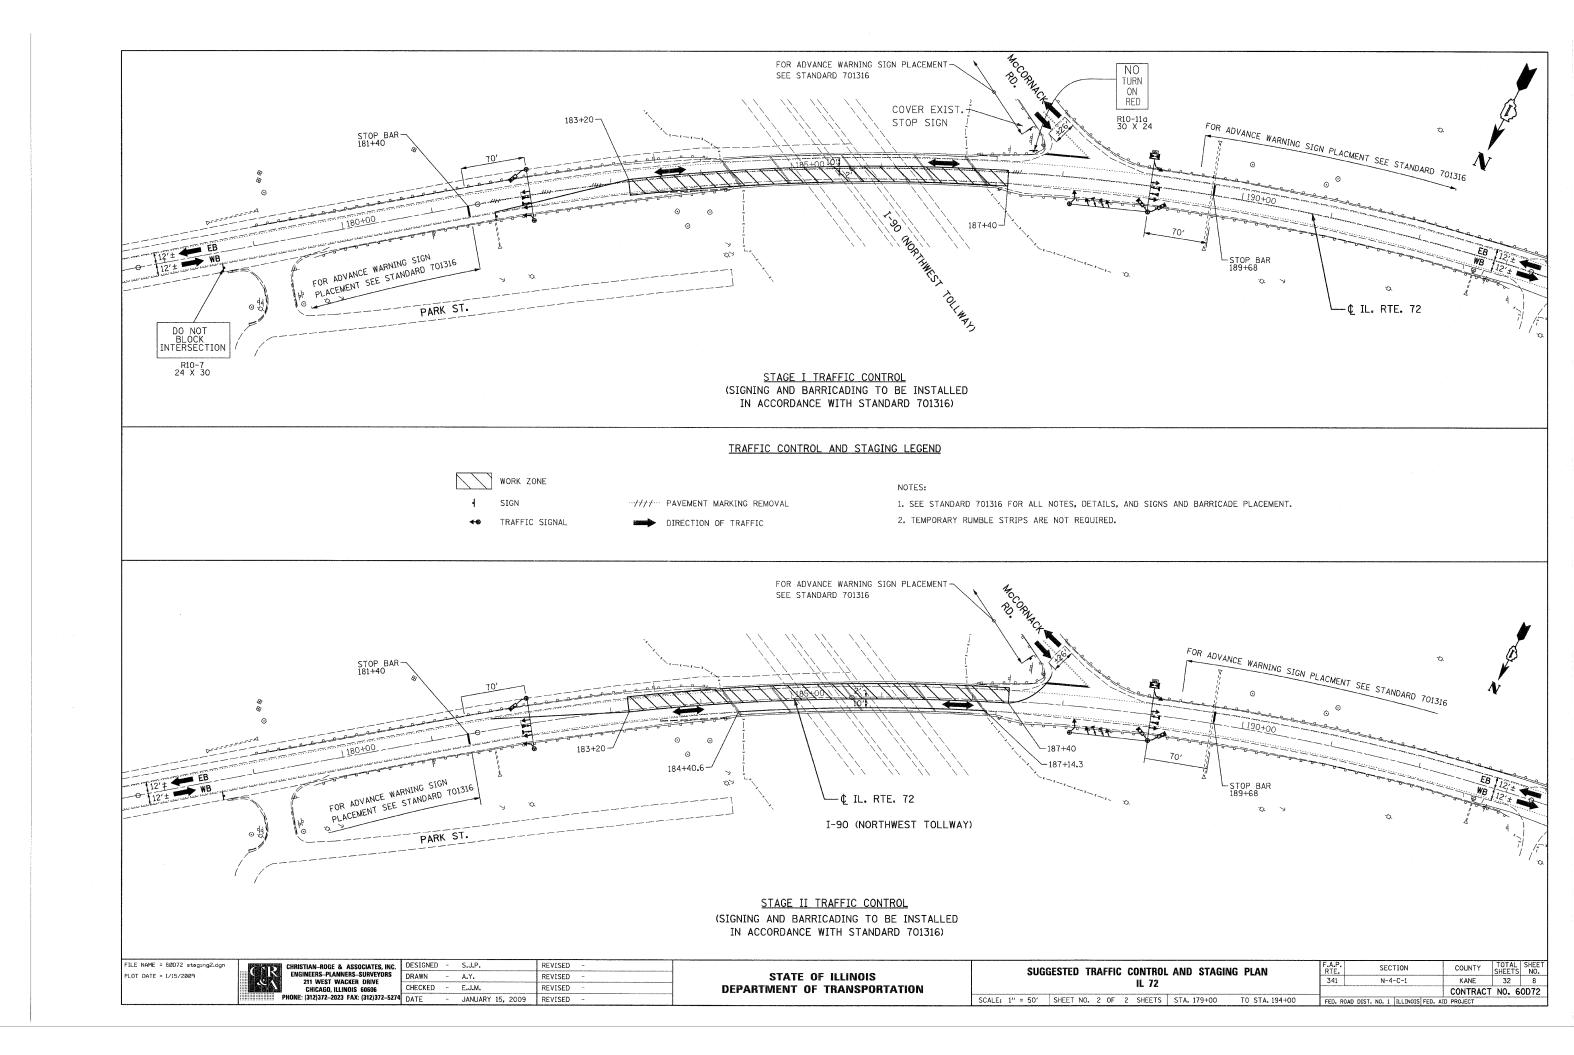

		TEMPORARY LIGHTING LEGEND
EXISTING	PROPOSED	
	\cong	400W, 120V, MCIII HPS. WITH PHOTO CELL 15' MA, 50 MH ON WOOD POLE,
A		AERIAL LINE (COMED/TELEPHONE)
	TL-1 ⊗	WOODEN POLE (60' OR 80' WOODEN CLASS 3 OR 4) WITH TEMPORARY LIGHTING UNIT
	8	WOOD POLE (80' CLASS 4) FOR TEMPORARY LIGHTING
	AC	AERIAL ELECTRIC CABLE WITH MESSENGER WIRE
	1	5/8 " × 10' GROUND ROD
	ESB 🛚	COMBINATION LIGHTING AND TRAFFIC, POLE MOUNTED ELECTRICAL SERVICE BOX
ф		COMED POWER POLE
#		TELEPHONE SPLICE BOX

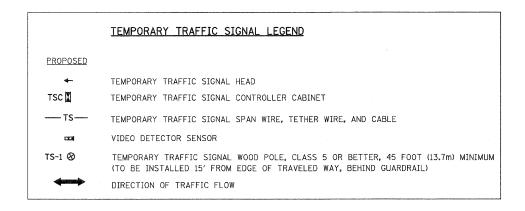

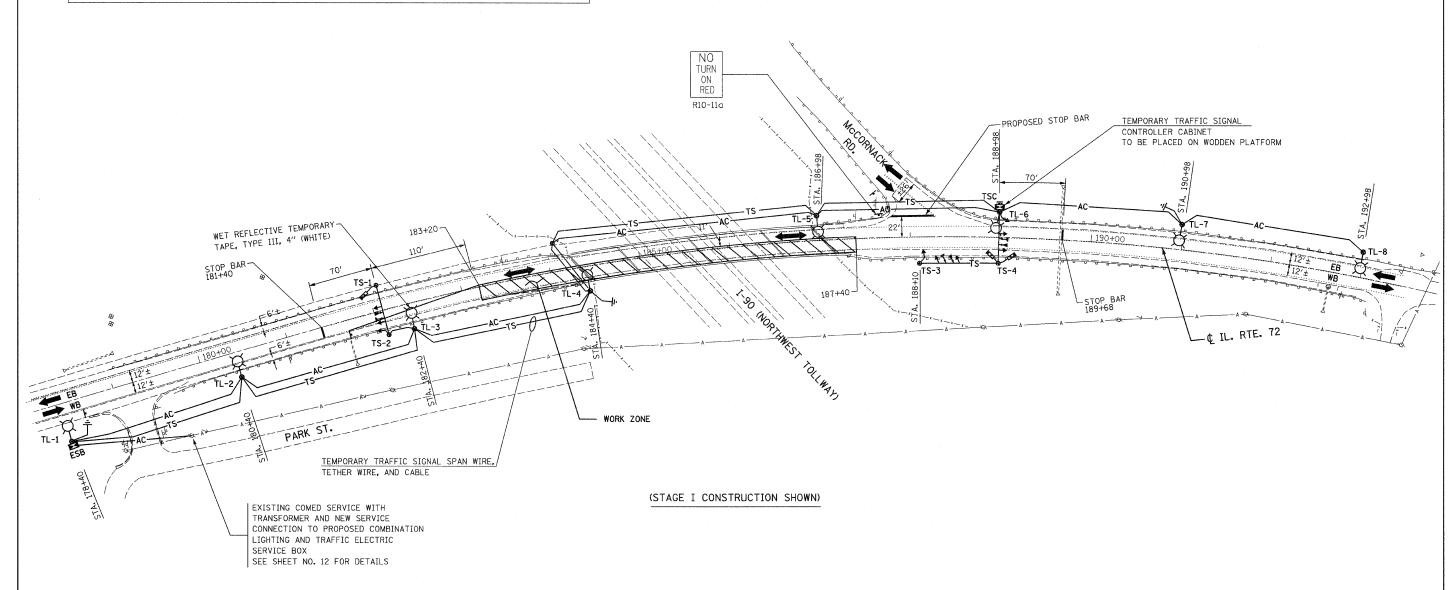



FILE NAME = 60D72 signal 1.dgn PLOT DATE = 1/15/2009 CHRISTIAN-ROGE & ASSOCIATES, INC.
ENGINEERS-PLANNERS-SURVEYORS
211 WEST WACKER DRIVE
CHICAGO, ILLINOIS 66066
PHONE: (312)372-2023 FAX: (312)372-527

INC.	DESIGNED	-	M.A.	REVISED -
RS	DRAWN	-	M.A.	REVISED -
ĺ	CHECKED	-	S.J.P.	REVISED -
-5274	DATE	~	JANUARY 15, 2009	REVISED -

STATE OF ILLINOIS
DEPARTMENT OF TRANSPORTATION

TEMPORARY BRIDGE TRAFFIC SIGNAL PLAN	F.A.P. RTE.	SECTION	COUNTY	TOTAL SHEETS	SHEET NO.	
IL 72	341	N-4-C-1	KANE	32	9	
			CONTRACT	NO. 6	OD72	
CALE: 1" = 50' SHEET NO. 1 OF 2 SHEETS STA. 179+00 TO STA. 194+00	FED. R	OAD DIST, NO. 1 ILLINOIS FED. AI	D PROJECT			

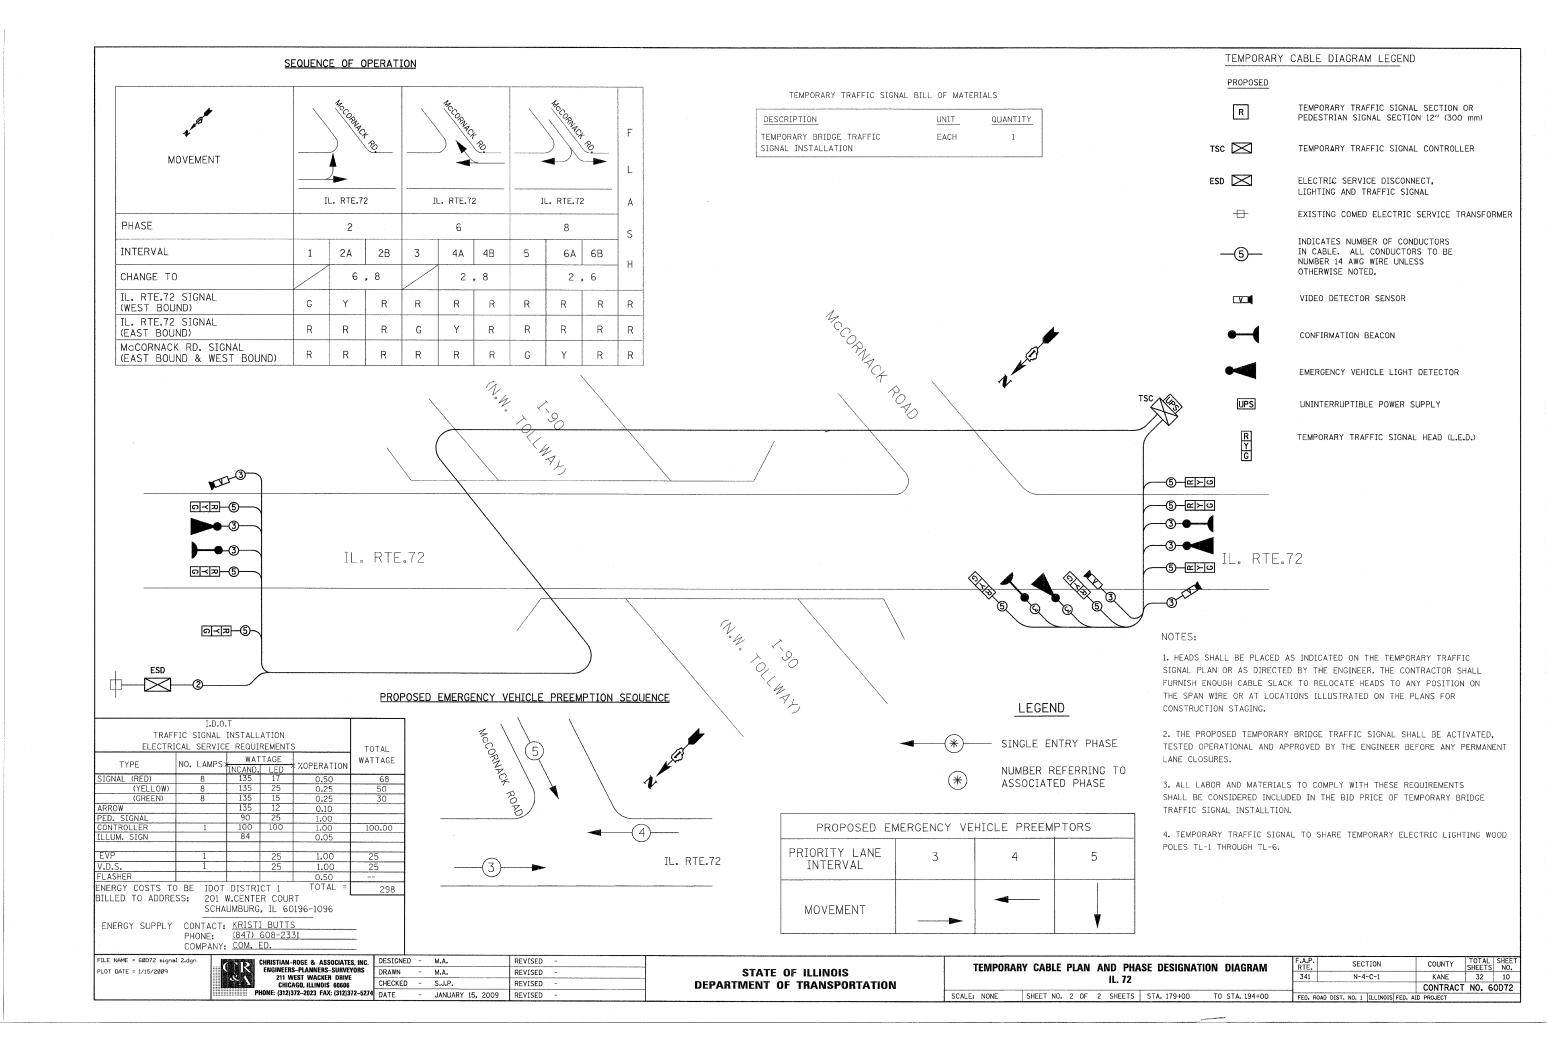

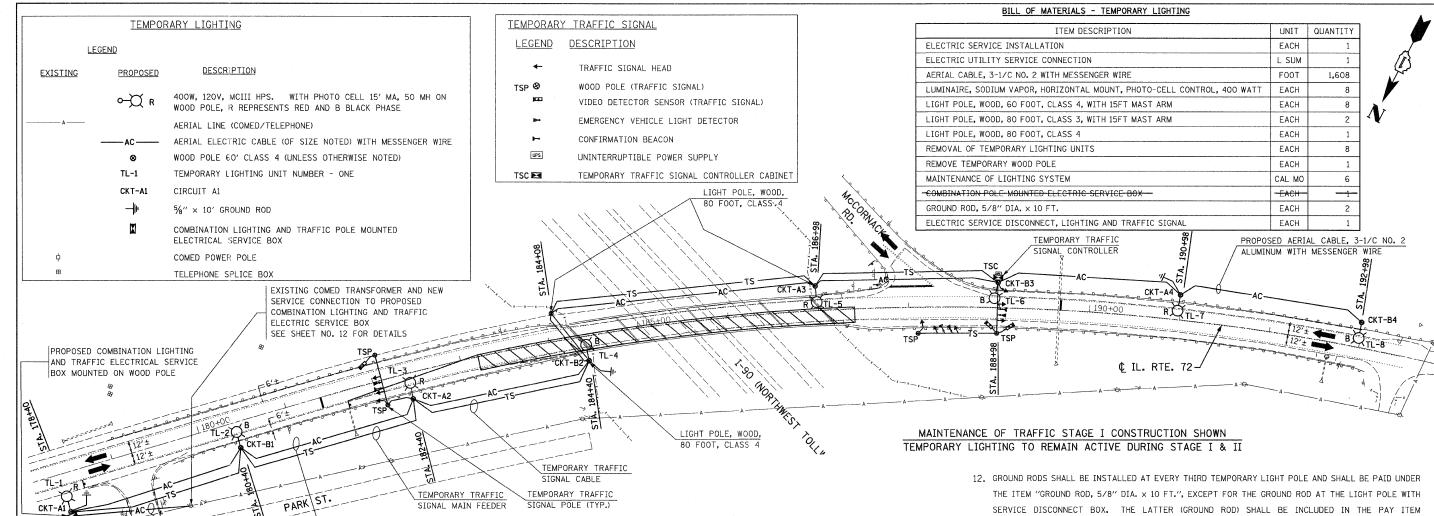

1. THE MATERIALS AND INSTALLATION METHODS SHALL COMPLY WITH THE LATEST CODES, STANDARDS AND ORDINANCES OF FEDERAL, STATE AND LOCAL GOVERNING BODIES HAVING JURISDICTION. ALL WORKS SHOWN ON THE PLANS AND DESCRIBED ELSEWHERE SHALL ALSO CONFORM TO THE LATEST NATIONAL ELECTRICAL CODE.

1 PHASE, 3 WIRE 120/240V

AERIAL SERVICE CABLE

- 2. ALL MATERIAL PARTS OF THE LIGHT POLES SHALL BE GROUNDED AND BONDED CONFORMING TO NEC ARTICLE 250. THE EQUIPMENT GROUND SHALL BE CONTINUOUS AND CONNECTED UP TO THE ELECTRICAL SYSTEM GROUND, THIS WORK SHALL BE INCLUDED IN THE LIGHT POLE PAY ITEM.
- 3. ALL TEMPORARY LIGHT POLES FOR THIS PROJECT SHALL BE LOCATED BEHIND EXISTING GUARDRAIL AND SHALL BE SET 15' BEHIND THE EDGE OF THE TRAVELED WAY, EXCEPT FOR POLE NO. TL-1 WHICH SHALL BE SET 30' BEHIND THE EDGE OF THE TRAVELED WAY. FINAL LOCATIONS OF ALL LIGHT POLES SHALL BE DIRECTED AND APPROVED BY THE ENGINEER.
- 4. THE TEMPORARY LIGHT POLES SHALL HAVE IDENTIFICATION NUMBERS AS SHOWN ON THE PLANS.
- 5. THE CONTRACTOR SHALL BE RESPONSIBLE FOR ANY DAMAGE TO THE LIGHTING AND TRAFFIC SIGNAL INSTALLATION. THE CONTRACTOR SHALL NOT INSTALL DAMAGED EQUIPMENT OR DEFECTIVE DEVICES, INSTEAD THE CONTRACTOR SHALL REPLACE IT WITH NEW ONES AT NO COST TO IDOT AND/OR AS DIRECTED BY THE ENGINEER.

- 6. THE CONTRACTOR SHALL SPLICE AERIAL CABLE AT THE LIGHT POLE USING HEAT SHRINKABLE CAPS WITH THE FACTORY APPLIED WATERPROOF SEALANT. THE INSTALLATION AND REQUIRED MATERIAL SHALL BE INCLUDED IN THE LIGHT POLE PAY ITEM.
- 7. THE CONTRACTOR SHALL FOLLOW THE CONSTRUCTION AND STAGING AS SHOWN ON THE PLANS OR AS DIRECTED BY THE ENGINEER. FURTHERMORE, THE CONTRACTOR SHALL COORDINATE ALL SUCH ACTIVITIES BEING DONE IN THE SAME AREA BY THE UTILITY COMPANIES OR OTHER CONTRACTORS AND SETUP COORDINATION MEETINGS IF NECESSARY WITHOUT ANY ADDITIONAL FINANCIAL COMPENSATION.
- 8. THE PROPOSED TEMPORARY LIGHTING SHALL BE COMPLETED, TESTED, OPERATIONAL AND VERIFIED BY IDOT BEFORE STAGE I TRAFFIC CONTROL IS IN PLACE. THE CONTRACTOR SHALL SUBMIT A STAGING SCHEDULE IDENTIFYING THE STARTING AND COMPLETION DATES PRIOR TO THE COMMENCEMENT OF WORK FOR PROCUREMENT, INSTALLATION AND/OR REMOVAL OF EXISTING MATERIAL AND/OR EQUIPMENT
- 9. ALL AREAS DISTURBED UNDER THIS CONTRACT SHALL BE RESTORED TO THE ORIGINAL CONDITION OR BETTER TO THE SATISFACTION OF THE ENGINEER.
- 10. LIGHTING SHALL BE KEPT OPERATIONAL AND ACTIVE FROM ONE HOUR BEFORE SUNSET TO ONE HOUR AFTER SUNRISE. AS PER "NATIONAL ELECTRIC CODE", OVERHEAD SPANS OF AERIAL CABLE AND MESSENGER WIRE MUST HAVE A VERTICAL CLEARANCE OF 18' MINIMUM ABOVE THE GROUND AT ALL TIMES AND AT ALL LOCATIONS ON THE PROJECT.
- 11. THE CONTRACTOR SHALL INSTALL ALL EQUIPMENT SO AS TO COMPLY WITH REQUIRED ELECTRICAL CLEARANCES PER NATIONAL ELECTRICAL CODE (NEC) SECTION 225-18, NATIONAL ELECTRICAL SAFETY CODE AND COMED REQUIREMENTS.

- "ELECTRIC SERVICE DISCONNECT, LIGHTING AND TRAFFIC SIGNAL".
- 13. THE QUANTITIES AS SHOWN IN THE BILL OF MATERIALS FOR THE TEMPORARY LIGHTING IS APPROXIMATE. THE CONTRACTOR SHALL BE RESPONSIBLE FOR FIELD VERIFYING ALL QUANTITIES PRIOR TO ORDERING ANY MATERIALS OR EQUIPMENT.
- 14. THE TEMPORARY LIGHTING SHALL USE AERIAL CABLES AS SHOWN ON THE PLANS. HOWEVER, THE UNDERGROUND NEW ELECTRICAL INSTALLATION, IF ANY, SHALL BE AT A MINIMUM 30 INCHES BELOW GRADE AND SHALL HAVE ELECTRICAL WARNING TAPE CONFORMING TO IDOT STANDARDS.
- 15. THE CONTRACTOR SHALL NOTIFY THE UTILITY COMPANY AS SOON AS POSSIBLE CONCERNING PENDING ELECTRICAL SERVICE INSTALLATION AND CONNECTION TO ENSURE THE AVAILABILITY OF ELECTRICAL POWER SUPPLY IN A TIMELY MANNER.
- 16. THE CONTRACTOR MAY MODIFY ELECTRICAL IDOT STANDARD DETAILS AS NECESSARY TO SUIT SPECIFIC SITE CONDITIONS. HOWEVER, THE CONTRACTOR SHALL OBTAIN THE ENGINEER'S APPROVAL PRIOR TO THE INSTALLATION.
- 17. THE REMOVAL OF TEMPORARY LIGHTING SHALL INCLUDE, BUT NOT LIMITED TO: ALL WOODEN POLES, LUMINAIRES WITH MAST ARMS, MESSENGER WIRES / CABLES, COM ED SERVICE CABLES, CONDUITS AND/OR SERVICE BOXES AND HAULING AWAY OF THESE ITEMS FROM THE PROJECT SITE. ALL TEMPORARY LIGHTING EQUIPMENT AND MATERIAL REMOVED FROM THE PROJECT SHALL BECOME THE PROPERTY OF THE CONTRACTOR.
- 18. THE EXACT LOCATION OF EXISTING POWER POLES WITH COMED TRANSFORMERS TO BE DETERMINED IN THE FIELD. COMED CONTACT INFORMATION FOR THIS PROJECT IS AS FOLLOWS: FIELD REPRESENTATIVE: KRISTI BUTTS (847) 608-2331

ACCOUNT NO. 31270-17013, TRANSFORMER NO. 421234D4

FILE NAME = 60D72 lightl.dgr CHRISTIAN_ROGE & ASSOCIATES INC PLOT DATE = 1/15/2009 211 WEST WACKER DRIVE CHICAGO, ILLINOIS 60606 PHONE: (312)372-2023 FAX: (312)372-52


:	DESIGNED	-	M.A.	REVISED	-
	DRAWN .	-	M.A.	REVISED	-
	CHECKED	-	R.S.	REVISED	-
74	DATE	-	JANUARY 15, 2009	REVISED	

PROPOSED AERIAL CABLE, 3-1/C NO. 2

ALLIMINUM WITH MESSENGER WIRE

STATE OF ILLINOIS **DEPARTMENT OF TRANSPORTATION**

	TEMPOR	ARY LIGHT	ING PLAN		F.A.P. RTE.	SECTION	COUNTY	TOTAL	SHEET NO.
		IL 72			341	N-4-C-1	KANE	32	11
							CONTRACT	NO. 6	OD72
SCALE: 1" = 50'	SHEET NO. 1 OF	2 SHEETS	STA. 179+00	TO STA. 194+00	FED. RO	DAD DIST. NO. 1 ILLINOIS FED. A	ID PROJECT		

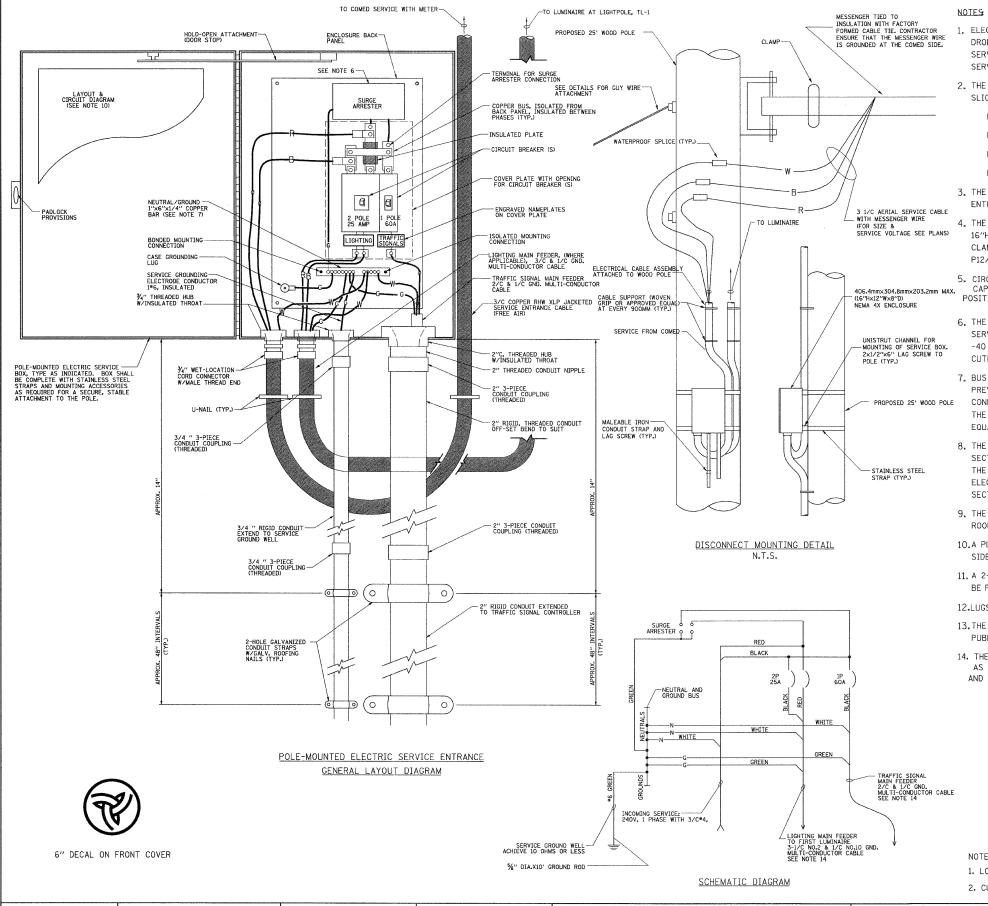

- 1. ELECTRIC SERVICE SHALL BE OF THE VOLTAGE INDICATED OR DESIGNATED BY THE ENGINEER, AND SERVICE DROP CABLE SHALL BE COMPATIBLE WITH THE SERVICE ACCORDINGLY. SOME INSTALLATIONS MAY CALL FOR SERVICE ENTRANCE EQUIPMENT SUITABLE FOR 3-WIRE SERVICE EVEN THOUGH INITIALLY WIRED FOR 2-WIRE SERVICE.
- 2. THE POLE-MOUNTED ELECTRIC SERVICE BOX DETAIL DEPICTS THE BASIC CONSTRUCTION OF THE EQUIPMENT. SLIGHT MODIFICATIONS APPLY FOR DIFFERING SERVICES AND APPLICATIONS AS FOLLOWS:

FULLY EQUIPPED FOR 240/120V. 3W SERVICE, COMPLETE WITH LIGHTING MAIN BREAKER

FULLY EQUIPPED FOR 240/120V. 3W SERVICE, BLANK COVER IN LIEU OF LIGHTING MAIN BREAKER

EQUIPPED FOR 120V. SERVICE, COMPLETE WITH 1P, 60A. TRAFFIC SIGNALS MAIN BREAKER

EQUIPPED FOR 120V. SERVICE, COMPLETE WITH 1P, 40A. TRAFFIC SURVEILLANCE MAIN BREAKER

- 3. THE ELECTRIC SERVICE EQUIPMENT ASSEMBLY SHALL BE UL LISTED AS SUITABLE FOR USE AS SERVICE
- 4. THE ELECTRIC SERVICE EQUIPMENT ENCLOSURE SHALL BE NEMA 4X STAINLESS STEEL, NOMINALLY 12"W X 16"H X 8"D, WITH A PIANO-HINGED DOOR, STEEL BACK PANEL, FAST-ACTING STAINLESS STEEL ENCLOSURE CLAMPS, PADLOCK PROVISIONS AND DOOR STOP, HOFFMAN CATALOG NO. A-16H1208SS6LP/A-16, P12/A-DSTOPK/C-PMK12, OR APPROVED EQUAL.
- 5. CIRCUIT BREAKERS SHALL BE THERMAL MAGNETIC BOLT-ON TYPE WITH A MINIMUM INTERRUPTING CAPACITY OF 25,000 SYMMETRICAL AMPERES AT 120 VOLTS. THEY SHALL BE LOCKABLE IN THE "OFF" POSITION FOR COMPLIANCE WITH OSHA LOCK-OUT/TAG-OUT REQUIREMENTS. HANDLES SHALL BE TRIP FREE.
- 6. THE SURGE PROTECTOR SHALL BE SUITABLE FOR 240/120 VOLT SINGLE PHASE 60HZ AC ELECTRICAL SERVICE, WITH A SURGE ENERGY CAPABILITY OF 2160 JOULES OR BETTER AT 8/20 MICRO- SECONDS, RATED -40 TO 60 DEGREES C., WITH LED OPERATING INDICATORS, AND SHALL BE UL LISTED PER UL 1449, CUTLER-HAMMER CMOV230L065XST OR APPROVED EQUAL.
- 7. BUS BARS, CONNECTORS, AND LUGS SHALL BE COPPER, INSULATED AND ISOLATED, AND CONFIGURED TO PREVENT SHORTED CONDITIONS FROM TIGHTENING TERMINATIONS, ETC. THE OVERALL BUS SECTION SHALL BE CONFIGURED BEHIND AN INSULATING BARRIER SHIELD WHICH IS REMOVABLE FOR ACCESS TO CONNECTIONS, OR THE ASSEMBLY SHALL BE A MANUFACTURED SPECIALTY PANELBOARD, CUTLER-HAMMER PRL2A OR APPROVED EQUAL.
- 8. THE COMBINATION GROUND AND NEUTRAL BAR SHALL BE CONFIGURED WITH SEPARATE GROUND AND NEUTRAL SECTIONS AND SPARE TERMINALS AS INDICATED. THE HEADS OF GROUND SCREWS SHALL BE PAINTED GREEN. THE HEADS OF NEUTRAL SCREWS SHALL BE PAINTED WHITE. THE SERVICE NEUTRAL AND SERVICE GROUNDING ELECTRODE CONDUCTOR SHALL BE TERMINATED ADJACENT TO EACH OTHER AT THE DIVIDE BETWEEN THE SECTIONS AND WIRING SHALL BE TERMINATED ONLY UPON THE APPROPRIATE SECTION.
- 9. THE WIRING TERMINALS, INCLUDING THE GROUND/NEUTRAL BAR SHALL BE ARRANGED TO PROVIDE ADEQUATE ROOM FOR PERFORMING FIELD TERMINATIONS.
- 10.A PLASTIC LAMINATED LAYOUT AND CIRCUIT DIAGRAM SHALL BE MECHANICALLY SECURED TO THE INTERIOR SIDE OF THE ENCLOSURE DOOR.
- 11. A 2-COLOR ENGRAVED PLASTIC NAMEPLATE, ATTACHED WITH SCREWS, AND ENGRAVED AS INDICATED, SHALL BE PROVIDED FOR EACH MAIN BREAKER.

12.LUGS AND CONNECTORS SHALL BE RATED FOR 75 C CONDUCTOR.

- 13. THE EXACT MOUNTING HEIGHT OF THE BOX SHALL BE FIELD DETERMINED TO AVOID OBSTRUCTIONS AND PUBLIC ACCESS. TYPICAL HEIGHT SHALL BE APPROXIMATELY 10 FEET ABOVE GRADE.
- 14. THE FEEDER CABLE (MATERIAL & INSTALLATION) FROM SERVICE DISCONNECT TO THE FIRST LIGHT POLE, AS SHOWN ON PLANS IS INCLUDED UNDER THE PAY ITEM "ELECTRIC SERVICE DISCONNECT, LIGHTING AND TRAFFIC SIGNAL".

CIRCUIT NO.	CIRCUIT BREAKER / POLES	UTILITY DESCRIPTION	LOAD 1 (WATTS)	CURRENT 2 (AMPERES)
Α	25A / 2P	(4) 400W HPS POLE NOS.TL-1,TL-3,TL-5, &TL-7	1,920	16.84
В	20A / 2P	(3) 400W HPS POLE NOS.TL-2, TL-4, & TL-6	1,440	12.63
TOTAL			3,360	29.47

TOTAL SHEE SHEETS NO.

32 12

CONTRACT NO. 60D72

KANF

NOTE:

SCALE: NONE

- 1. LOAD INCLUDES 20% BALLAST LOSSES FOR LUMINAIRES
- 2. CURRENT CALCULATIONS INCLUDE A POWER FACTOR OF 0.95.


FILE NAME = 60072 light2.dgr PLOT DATE = 1/15/2009

CHRISTIAN-ROGE & ASSOCIATES, INC. ENGINEERS-PLANNERS-SURVEYORS 211 WEST WACKER DRIVE SAV. PHONE: (312)372-2023 FAX: (312)372-527

DESIGNED - M.A. REVISED DRAWN M.A. REVISED CHECKED -R.S. REVISED JANUARY 15, 2009 REVISED

STATE OF ILLINOIS **DEPARTMENT OF TRANSPORTATION**

SECTION TEMPORARY LIGHTING NOTES AND DETAILS N-4-C-1 IL 72 SHEET NO. 2 OF 2 SHEETS STA. TO STA. FED. ROAD DIST. NO. 1 | ILLINOIS FED. AID PROJECT

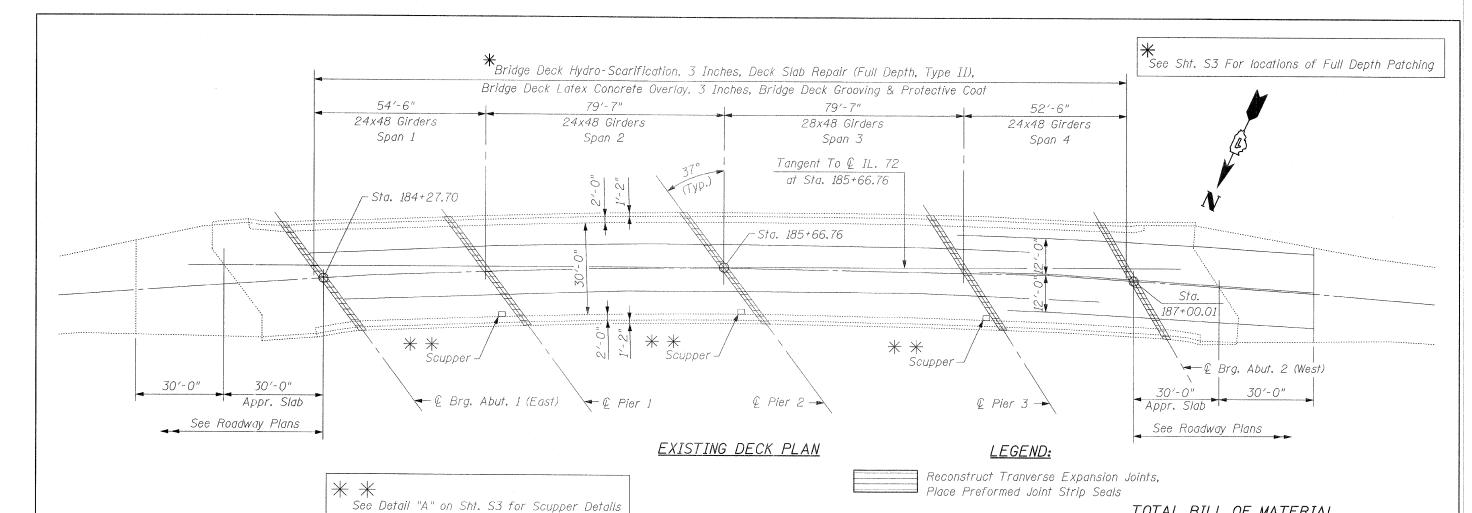

GENERAL NOTES:

- 1. Plan dimensions and details relative to existing plans are subject to routine variations. The Contractor shall field verify existing dimensions and details affecting new construction and make necessary approved adjustments prior to construction or ordering of materials. Such variations shall not be cause for additional compensation for a change in the scope of work, however, the Contractor will be paid for the quantity actually furnished based upon the unit price bid for the work.
- 2. The Contractor should use extreme care during Concrete Removal as not to damage the Existing PPC I-Beams. Any damage caused shall be repaired at no cost to I.D.O.T.
- 3. Areas of Deck Repairs shown are estimated. The Engineer shall show actual locations of Deck Repairs on As-Built Plans.
- 4. Joint openings shall be adjusted according to Article 520.04 of The Standard Specifications when the Deck is poured at an ambient temperature other than 50° F.
- 5. Reinforcement Bars shall conform to the requirements of ASTM A706 Grade 60. See Special Provisions.
- 6. Reinforcement Bars designated (E) shall be Epoxy Coated.

<u>DESIGN STRESSES</u> FIELD UNITS

f'c = 3,500 psify = 60,000 psi (Reinforcement)


TOTAL BILL OF MATERIAL

Item	Unit	Quantity
Concrete Removal	Cu. Yd.	65
Concrete Superstructure	Cu. Yd.	65
Reinforcement Bars, Epoxy Coated	Pound	15,190
Bridge Deck Hydro-Scarification, 3 Inches	Sq. Yd.	901
Bridge Deck Latex Concrete Overlay, 3 Inches	Sq. Yd.	901
Protective Coat	Sq. Yd.	961
Deck Slab Repair (Full Depth, Type II)	Sq. Yd.	44
Preformed Joint Strip Seal	Foot	225
Bridge Deck Grooving	Sq. Yd.	832
Bar Splicers	Each	122

CR &A

CHRISTIAN-ROGE & ASSOCIATES, INC.
ENGINEERS / PLANNERS / SURVEYORS
211 W. WACKER DRIVE CHICAGO, IL. 60606
PHONE: (312)372-2023 FAX: (312)372-5274

	 							i i		*****		E
FILE NAME =	USER NAME = IDOT	DESIGNED -	B.N.S.	REVISED -		Marie Marie			F.A	A.P. CEGITION	001111714	TOTAL ISHEET
plan_elevation.sht		DRAWN -	R.E.S./D.L./F.M.	REVISED -	STATE OF ILLINOIS		GENERAL PL	AN	RTI	E. SECTION	COUNTY	SHEETS NO.
	PLOT SCALE = 50.0000 '/ IN.	CHECKED -	B.N.S./J.C.N.	REVISED -	DEPARTMENT OF TRANSPORTATION		IL. 72 OVER		5_007/ 34	41 N-4-C-I	KANE	32 13
	PLOT DATE = 1/15/2009	DATE -	JANUARY 15, 2009	REVISED -	DEI AITMIENT OF TRANSFORTATION	SCALE.	SHEET NO. ST OF SR SHEETS	S.14. U4.	7-00/4			CT NO. 60D72
		L				JUALL:	SHEET NO. 31 OF 36 SHEETS	31A. 10 STA.	FED	D. ROAD DIST. NO. ILLINOIS FED. AI	D PROJECT	

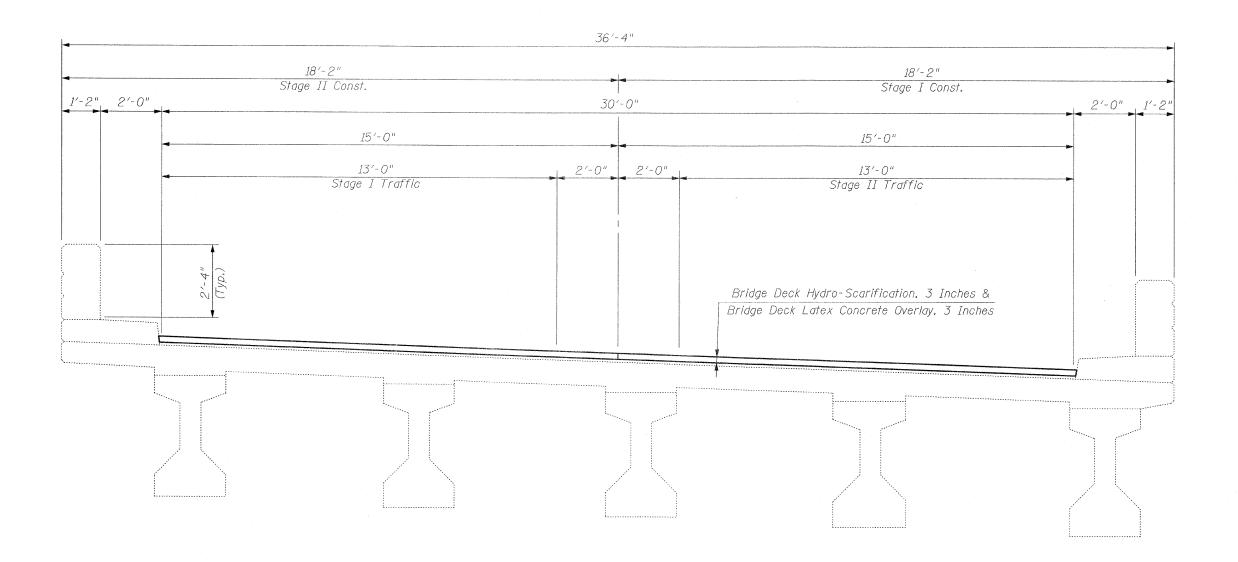


EXISTING DECK CROSS SECTION


(With Prop. Bridge Deck Latex Concrete Overlay, 3 Inches)
(Looking West)





CHRISTIAN-ROGE & ASSOCIATES, INC. ENGINEERS / PLANNERS / SURVEYORS 211 W. WACKER DRIVE CHICAGO, IL. 60606 PHONE: (312)372-2023 FAX: (312)372-5274

							1	*********			;
FILE NAME =	USER NAME = IDOT	DESIGNED - B.N.S.	REVISED -		I			F.A.P.	SECTION	COUNTY	TOTAL SHEET
deck cross sectionisht		DRAWN - R.E.S./D.L./F.M.	REVISED -	STATE OF ILLINOIS		DECK CROSS SECTION		RTE.			SHEETS NO.
	PLOT SCALE = 50.0000 '/ IN.	CHECKED - B.N.S./J.C.N.	REVISED -	DEPARTMENT OF TRANSPORTATION		IL. 72 OVER 1–90	S.N. 045-0074	341	N-4-C-I	KANE	32 14
	PLOT DATE = 1/15/2009	DATE - JANUARY 15, 2009	REVISED -	DEL ANTIBIENT OF THANKS OF THE TOP	SCALE:	SHEET NO. S2 OF S8 SHEETS STA.	TO STA.	FED ROAD DIST N	IO THE TRIOTE CED. AT	CONTRACT D. PROJECT	T NO. 60D72
				<u> </u>	1		10 01/4	TED. NOAD DIST. N	ic. ILLINOIS PED. AI	7 FROJECT	

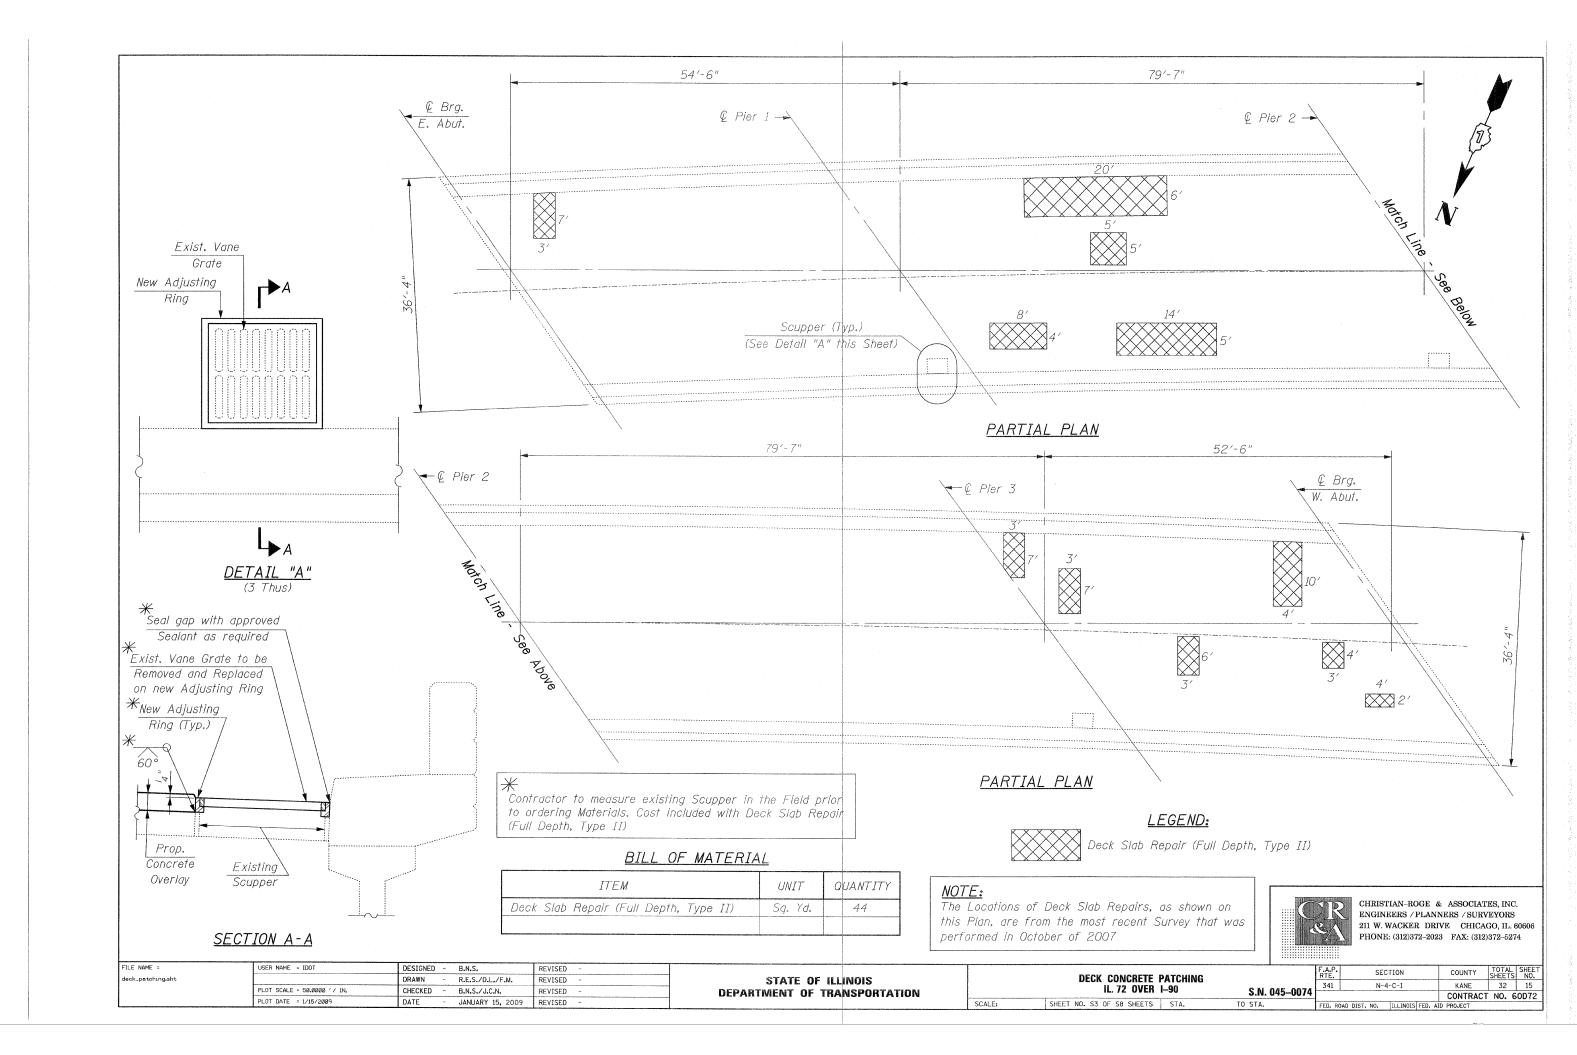

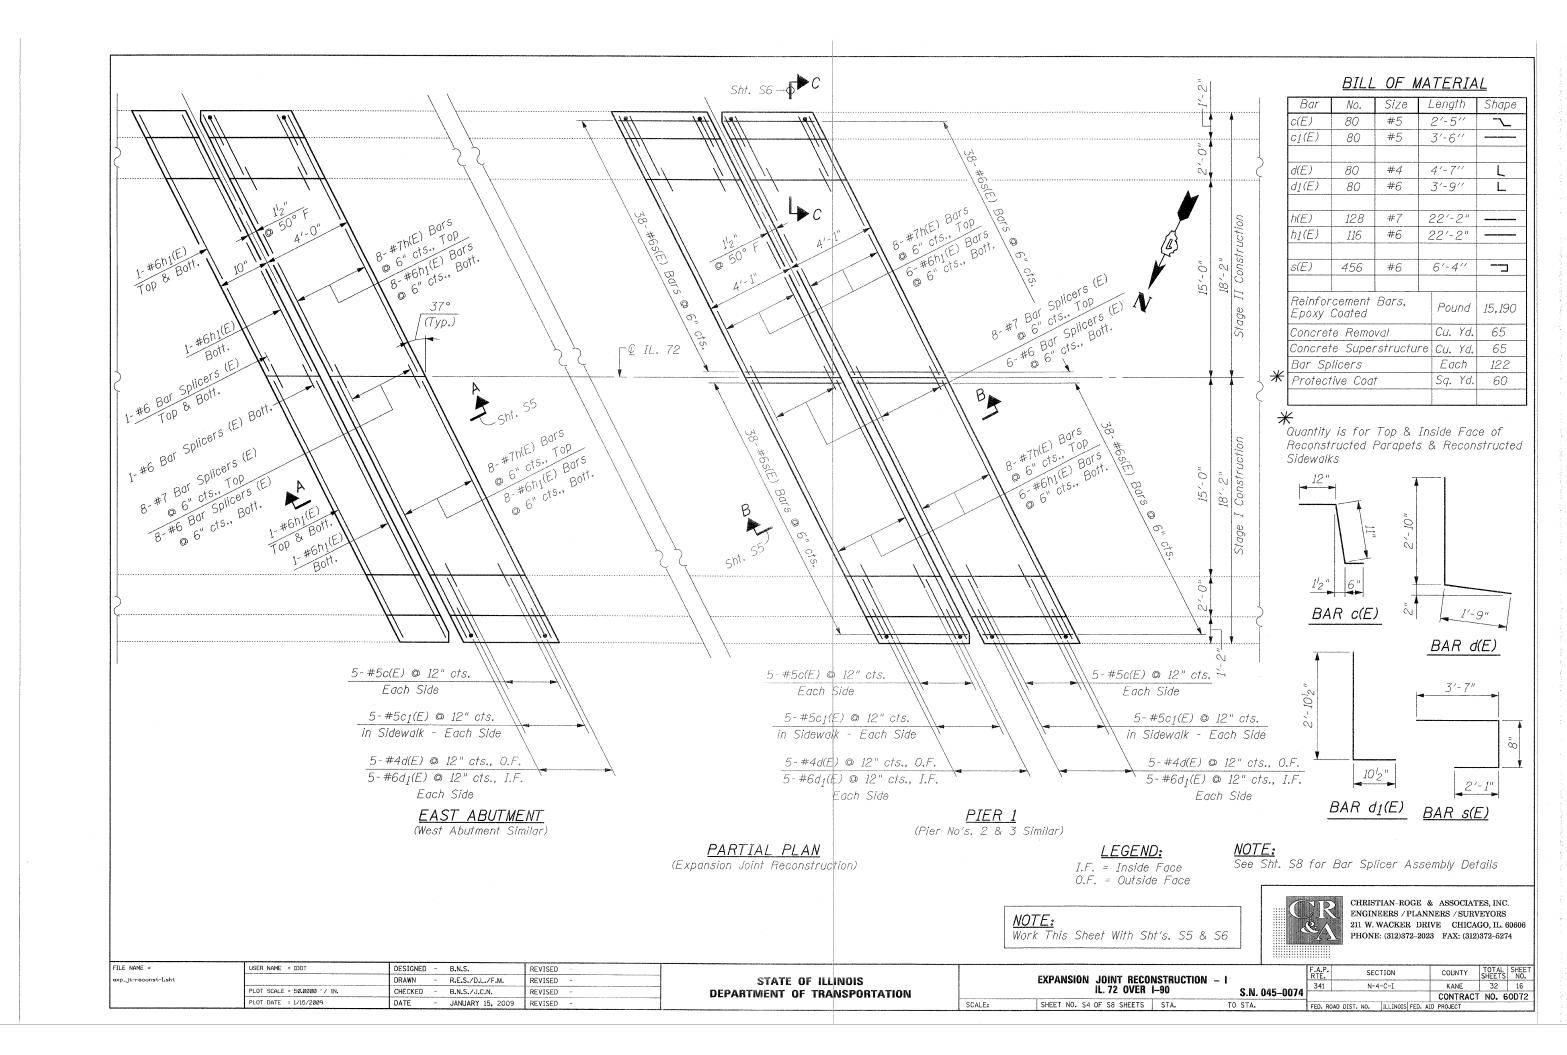


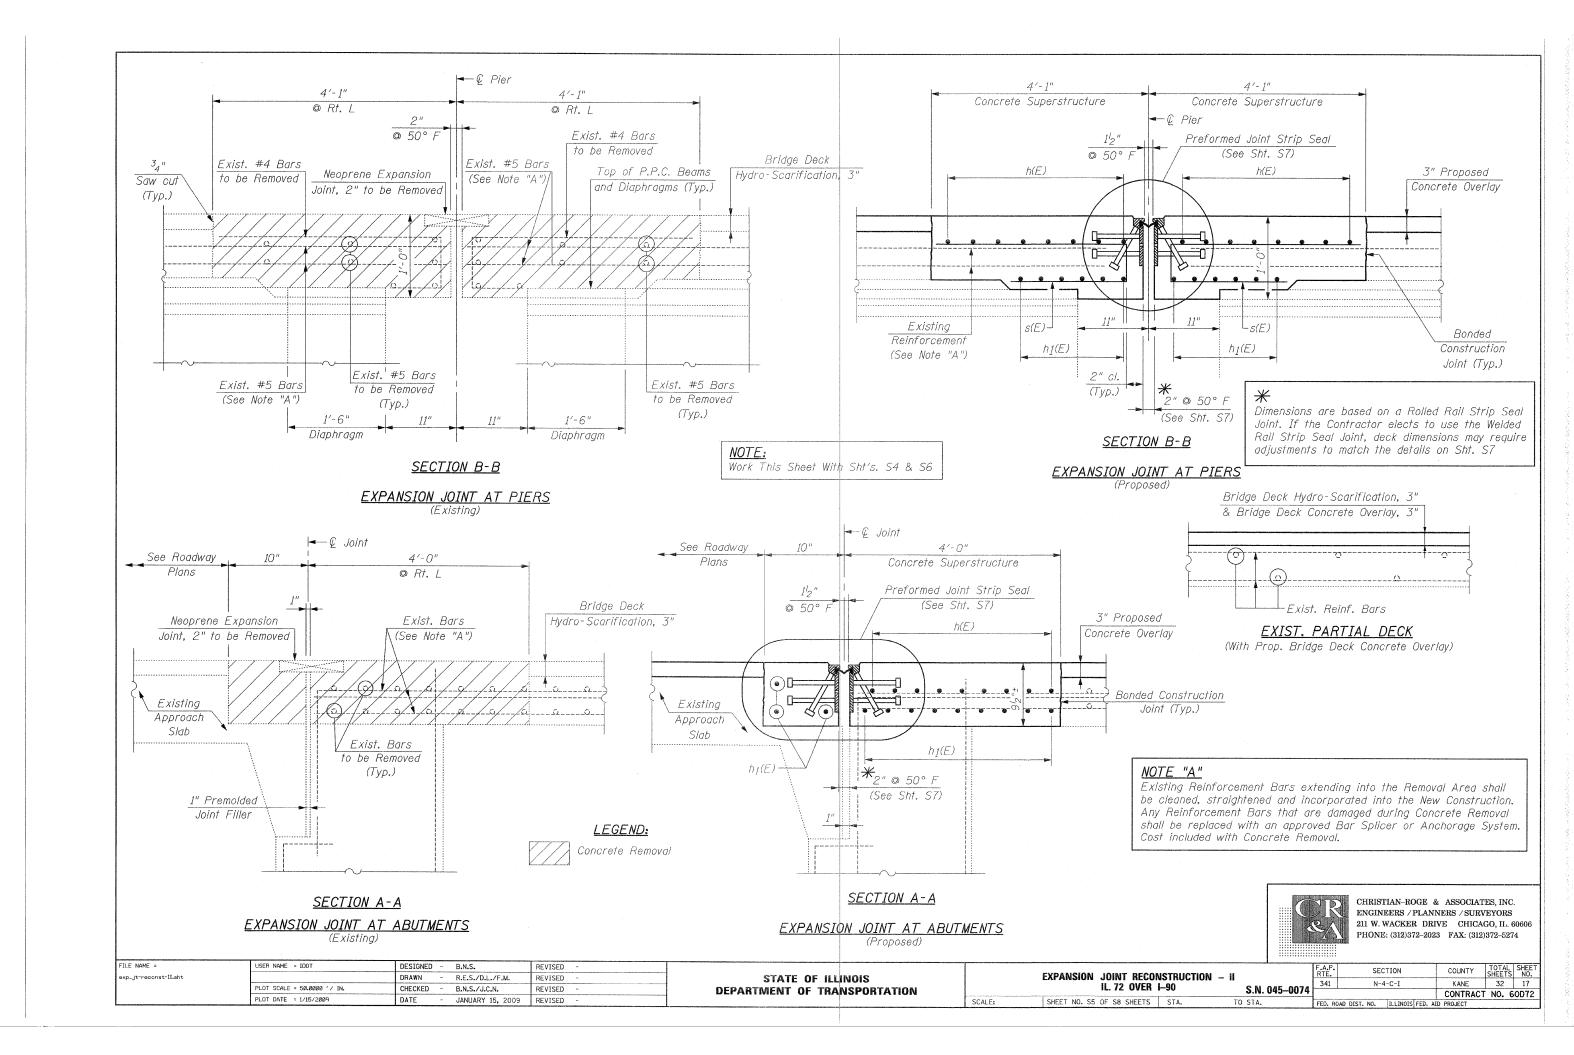


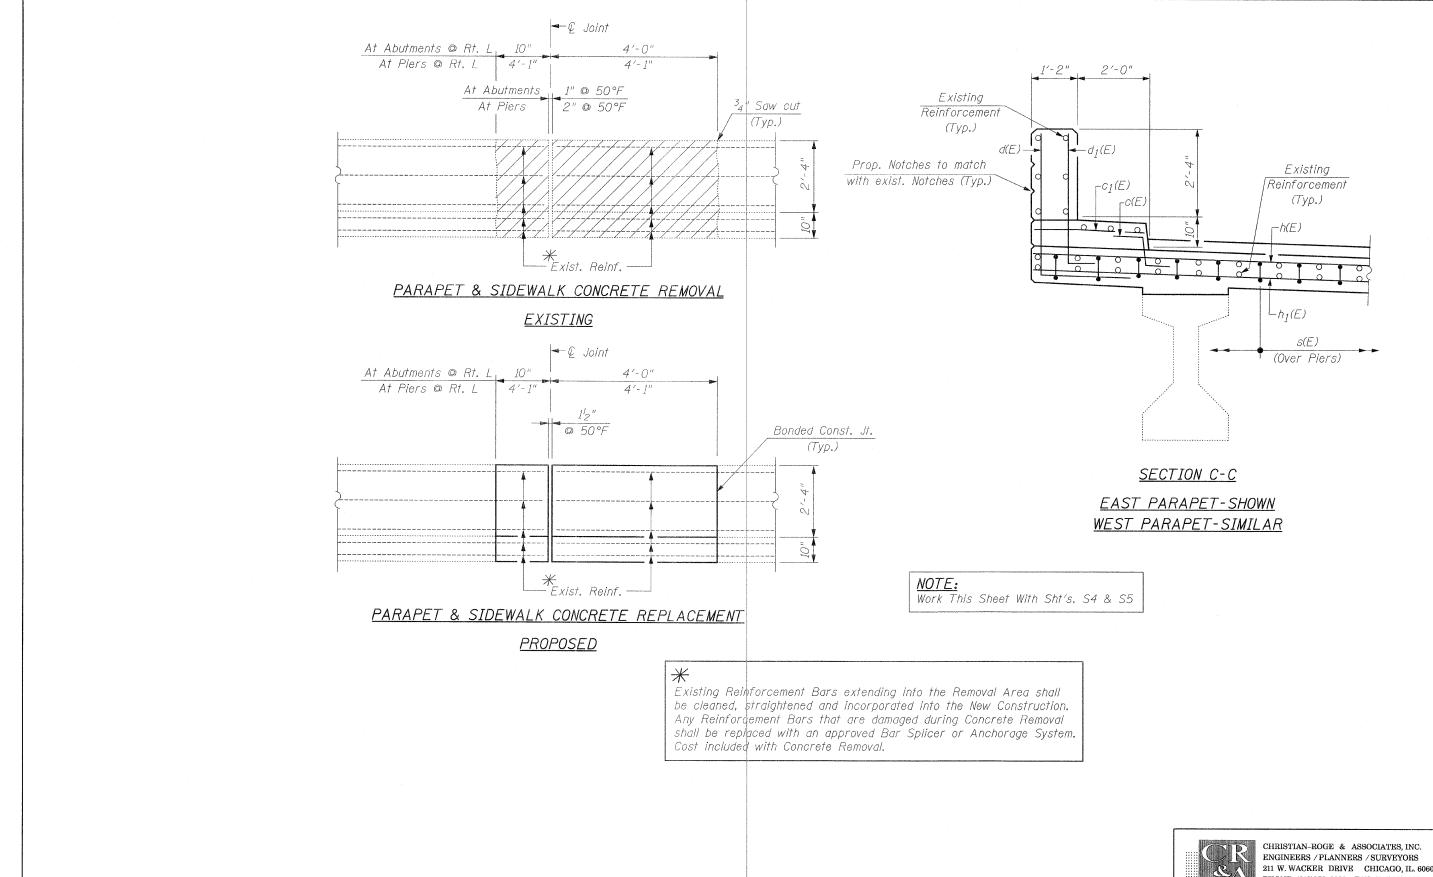

211 W. WACKER DRIVE CHICAGO, IL. 60606 PHONE: (312)372-2023 FAX: (312)372-5274


FILE NAME =	USER NAME = IDOT	DESIGNED - B.N.S.	REVISED -		1			F.A.P.	SECTION	COUNTY	TOTAL SHEET
exp_Jt-reconst-III.sht		DRAWN - R.E.S./D.L./F.M.	REVISED -	STATE OF ILLINOIS		EXPANSION JOINT RECONSTRUCTION -	- 111	NIE.			SHEETS NO.
	PLOT SCALE = 50.0000 '/ IN.	CHECKED - B.N.S./J.C.N.	REVISED -	DEPARTMENT OF TRANSPORTATION	IL. 72 OVER 1–90 S.N			341	N-4-C-I	KANE	T NO. 60D72
	PLOT DATE = 1/15/2009	DATE - JANUARY 15, 2009	REVISED -		SCALE:	SHEET NO. S6 OF S8 SHEETS STA.	TO STA.	FED. ROAD DIST, NO			NO. BODIZ

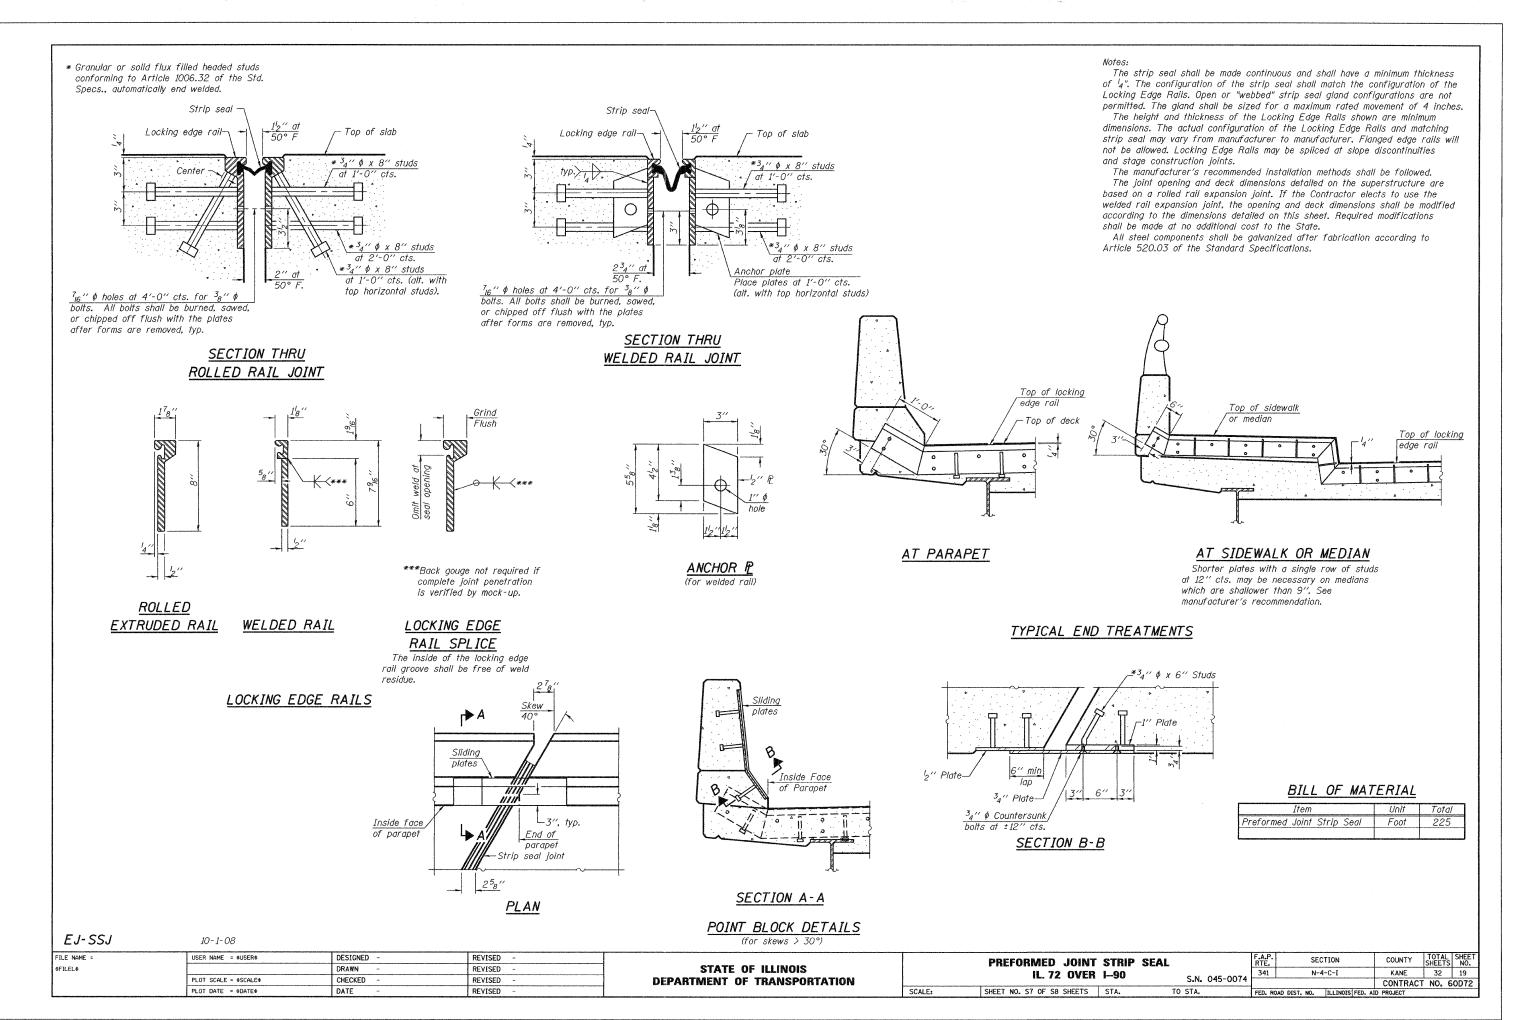

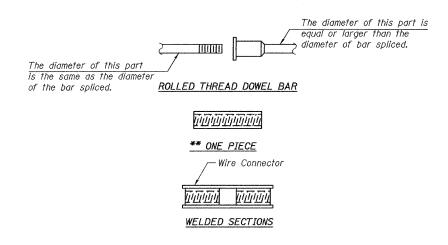



BAR SPLICER ASSEMBLY ALTERNATIVES

**Heavy Hex Nuts conforming to ASTM A 563, Grade C, D or DH may be used.

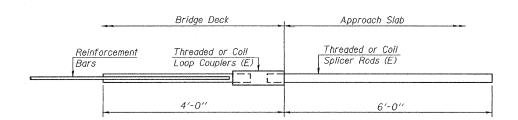


FOR INTEGRAL OR SEMI-INTEGRAL ABUTMENTS

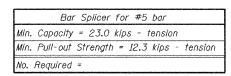

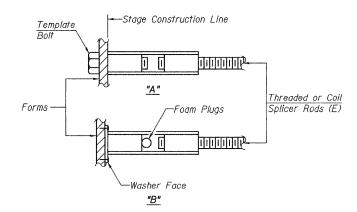

INSTALLATION AND SETTING METHODS

"A": Set bar splicer assembly by means of a template bolt. "B": Set bar splicer assembly by nailing to wood forms or cementing to steel forms. (E): Indicates epoxy coating.

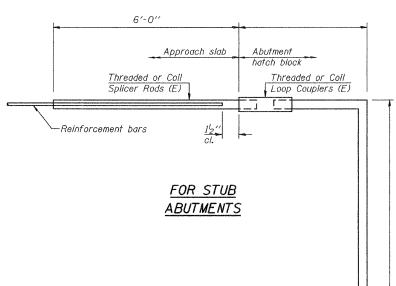

Bar Splicer for #5 bar Min. Capacity = 23.0 kips - tension Min. Pull-out Strength = 12.3 kips - tension No. Required =

Bar splicer assemblies shall be of an approved type and shall develop in tension at least 125 percent of the yield strength of the lapped reinforcement bars.

Splicer rods shall be of minimum 60 ksi yield strength, threaded or coiled full length. All reinforcement bars shall be lapped and tied to the splicer rods or dowel bars. Bar splicer assemblies shall be epoxy coated according to the requirements for reinforcement bars.

Other systems of similar design may be submitted to the Engineer for approval. Approval shall be based on certified test results from an approved testing laboratory that the proposed bar splicer assembly satisfies the following requirements:


Minimum Capacity (Tension in kips) = 1.25 x fy x A_t

(lension iii אועס) Minimum *Pull-out Strength = $0.66 \times fy \times A_t$

(Tension in kips)

Where fy = Yield strength of lapped reinforcement bars in ksi. A_t = Tensile stress area of lapped reinforcement bars.
* = 28 day concrete

	BAR SPLIC	ER ASSEMBLI	ES					
		Strength Requirements						
Bar Size to be Spliced	Splicer Rod or Dowel Bar Length		Min. Pull-Out Strength kips - tension					
#4	1'-8''	14.7	7.9					
#5	2'-2"	23.0	12.3					
#6	2'-7"	33.1	17.4					
#7	3′-5″	45.1	23.8					
#8	4'-6''	58.9	31.3					
#9	5′-9″	75.0	39.6					
#10	7′-3′′	95.0	50.3					
#11	9'-0''	117.4	61.8					

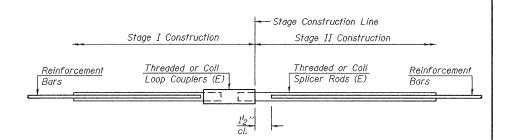

STANDARD

ACRES OF THE PARTY				
Bar Size	No. Assemblies Required	Location		
#6	58	Expansion Joint		
#7	64	Reconstruction		

BSD-1


10-1-08

FILE NAME =	USER NAME = \$USER\$	DESIGNED -	REVISED -
\$FILEL\$		DRAWN -	REVISED -
	PLOT SCALE = #SCALE#	CHECKED -	REVISED -
	PLOT DATE = \$DATE\$	DATE -	REVISED -


STATE OF ILLINOIS **DEPARTMENT OF TRANSPORTATION**

	BAR	SPLIC	ER	ASSEN	ABLY	DETAILS			F.A RT
		IL.	72	OVER	I90		S.N.	045-0074	34
I F.	SHEET	NO. S8 OF	- S8	SHEETS	STA.	TO	STA.		1=

F.A.P. RTE.	SECTION	COUNTY	TOTAL SHEETS	SHEET NO.
341	N-4-C-I	KANE	32	20
		CONTRACT	NO. 6	OD72
FFD. RO	AD DIST. NO. TLLINGIS FED. A	ID PROJECT		

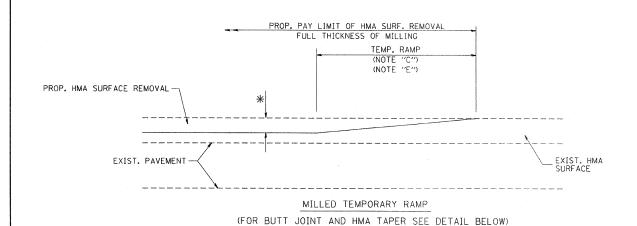


OPTION 1

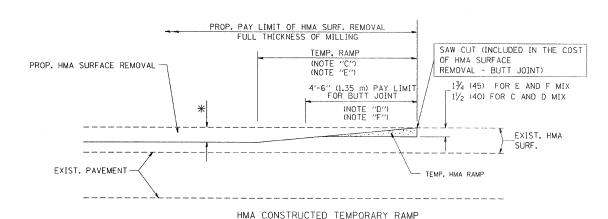

OPTION 2

(FOR BUTT JOINT AND HMA TAPER SEE DETAIL BELOW)

TYPICAL TEMPORARY RAMP

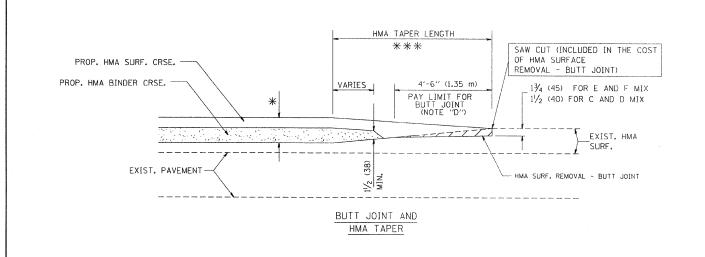

TYPICAL BUTT JOINT AND HMA TAPER FOR MILLING AND RESURFACING


* * EXIST. PAVEMENT

BUTT JOINT DETAIL

PROP. HMA OR PCC

SURFACE REMOVAL - BUTT JOINT 30'-0" (9.0 m) (NOTE "A")

15'-0" (4.5 m) (NOTE "B")

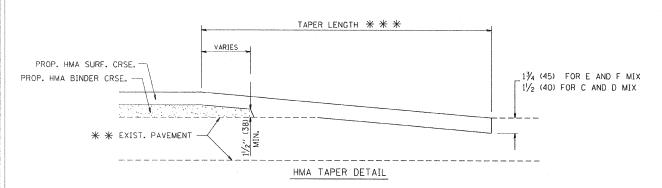

TYPICAL BUTT JOINT AND HMA TAPER FOR RESURFACING ONLY

PC CONCRETE, HMA OR HMA RESURFACED PAVEMENT.

NOTES

EXIST. HMA OR PCC SURFACE

- A: MAINLINE ROADWAYS AND MAJOR SIDE ROADS.
- B: MINOR SIDE ROADS.
- C: THE TEMP. RAMP SHALL BE CONSTRUCTED IMMEDIATELY UPON REMOVAL OF THE EXISTING HMA SURFACE.
- D: THE BUTT JOINT SHALL BE CONSTRUCTED IMMEDIATELY PRIOR TO PLACING THE PROPOSED HMA COURSES.
- E: TAPER THE TEMP, RAMP AT A RATE OF 3'-0" (900 mm) PER 1 INCH (25 mm) OF MILLING THICKNESS.
- F: INSTALLATION AND REMOVAL OF THE 4'-6" (1.35 m) TEMP. RAMP IS INCLUDED IN COST OF HMA SURFACE REMOVAL BUTT JOINT
- G: SEE ARTICLE 406.08 AND 406.14 OF THE STANDARD SPECIFICATIONS FOR "HMA AND/OR PCC SURFACE REMOVAL, BUTT JOINT".
- * SEE TYPICAL SECTIONS FOR MILLING THICKNESS.

BASIS OF PAYMENT:

THE BUTT JOINT WILL BE PAID FOR AT THE CONTRACT UNIT PRICE PER SOUARE YARD (SQUARE METER) FOR "HOIT-MIX ASPHALT SURFACE REMOVAL - BUTT JOINT" OR FOR "PORTLAND CEMENT CONCRETE SURFACE REMOVAL- BUTT JOINT".

ALL DIMENSIONS ARE IN INCHES (MILLIMETERS) UNLESS OTHERWISE SHOWN.


of the Soliday States

SAW CUT (INCLUDED IN THE COST

- BUTT JOINT)

OF HMA OR P.C.C. SURFACE REMOVAL

FILE NAME =	USER NAME = gaglianobt	DESIGNED - M. DE YONG	REVISED - R. SHAH 10-25-94			FAP	SECTION	COUNTY	I TOTAL I	HEET
W:\distatd\22x34\bd32.dgn		DRAWN -	REVISED - A. ABBAS 03-21-9	STATE OF ILLINOIS	BUTT JOINT AND	RTE	SECTION		SHEETS	NO.
	PLOT SCALE = 50.0000 ' / IN.	CHECKED -	REVISED - M. GOMEZ 04-06-		HMA TAPER DETAILS	341	N-4-C-1	KANE	32	21
	PLOT DATE = 1/4/2008	DATE - 06-13-90	REVISED - R BORO 01-01-07	DEFAILMENT OF TRANSPORTATION	SCALE: NONE SHEET NO. 1 OF 1 SHEETS STA 179+00 TO STA 194+00		BD400-05 BD32		T NO. 60E	72
		DATE 00 13 30	THE VISED IN BORD OF OF		SCALE: NONE SHEET NO. 1 OF 1 SHEETS STA. 179+00 TO STA. 194+00	FED. Rr	OAD DIST. NO. 1 ILLINOIS FED.	AID PROJECT		

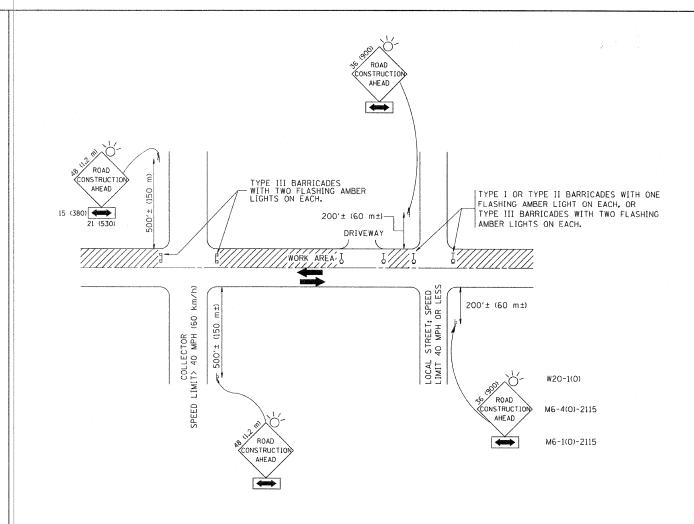

TRAFFIC CONTROL AND PROTECTION FOR SIDE ROADS, INTERSECTIONS, AND DRIVEWAYS

NOTES:

- A. FOR NO LANE RESTRICTION ON THE SIDE ROAD OR DRIVEWAYS
- 1. SIDE ROAD WITH A SPEED LIMIT OF 40 MPH (60 km/h) OR LESS AS SHOWN ON THE DRAWING AND AS DIRECTED BY THE ENGINEER:
- G) ONE ROAD CONSTRUCTION AHEAD SIGN 36 x 36 (900x900) WITH A FLASHER AND FLAG MOUNTED ON IT APPROXIMATELY 200' (60 m) IN ADVANCE OF THE MAIN ROUTE.
- b) THE CLOSED PORTION OF THE MAIN ROUTE SHALL BE PROTECTED BY BLOCKING WITH TYPE I, TYPE II OR TYPE III BARRICADES, 1/3 OF THE CROSS SECTION OF THE CLOSED PORTION.
- 2. SIDE ROAD WITH A SPEED LIMIT GREATER THAN 40 MPH (60 km/h) AS SHOWN ON THE DRAWING AND AS DIRECTED BY THE ENGINEER:
- g) ONE ROAD CONSTRUCTION AHEAD SIGN 48 x 48 (1.2 m x 1.2 m) WITH A FLASHER MOUNTED ON IT APPROXIMATELY 500' (150 m) IN ADVANCE OF THE MAIN ROUTE.
- b) THE CLOSED PORTION OF THE MAIN ROUTE SHALL BE PROTECTED BY BLOCKING WITH TYPE III BARRICADES, 1/2 OF THE CROSS SECTION OF THE CLOSED PORTION.
- 3. WHEN THE SIDE ROAD LIES BETWEEN THE BEGINNING OF THE MAINLINE SIGNING AND THE WORK ZONE, A SINGLE HEADED ARROW (M6-1) SHALL BE USED IN LIEU OF THE DOUBLE HEADED ARROW (M6-4).

- B. FOR A LANE CLOSURE ON A SIDE ROAD OR DRIVEWAY:
- USE APPLICABLE PORTIONS OF THE TYPICAL APPLICATION OF TRAFFIC CONTROL DEVICES (STD. 701501, STD. 701606 OR THE APPROPRIATE STANDARD). THE SPACING OF SIGNS AND BARRICADES SHALL BE ADJUSTED FOR FIELD CONDITIONS AS DIRECTED BY THE ENGINEER. THE DIRECTIONAL ARROW SHALL BE COVERED OR REMOVED WHEN NO LONGER CONSISTENT WITH THE SIDE ROAD LANE CLOSURE.
- C. ADVANCE WARNING SIGNS ARE TO BE OMITTED ON DRIVEWAY UNLESS OTHERWISE NOTED.
- D. THE TRAFFIC CONTROL AND PROTECTION FOR SIDE ROADS, INTERSECTIONS, AND DRIVEWAYS SHALL BE INCIDENTAL TO THE COST OF SPECIFIED TRAFFIC CONTROL STANDARDS OR ITEMS.

All dimensions are in millimeters (inches) unless otherwise shown.


FILE NAME =	USER NAME = gaglianobt	DESIGNED - LHA	REVISED - J. OBERLE 10-18-95
Wi\diststd\22x34\tc10.dgn		DRAWN -	REVISED - A. HOUSEH 03-06-96
	PLOT SCALE = 50.000 '/ IN.	CHECKED -	REVISED - A. HOUSEH 10-15-96
	PLOT DATE = 1/4/2008	DATE - 06-89	REVISED -T. RAMMACHER 01-06-0

STATE OF ILLINOIS DEPARTMENT OF TRANSPORTATION


TR	AFFI	C	CON	TRO	L AND	PROTE	CTION	FOR	
SIDE	ROA	\D:	s, IN	TERS	SECTION	NS, ANI	DRIV	/EWAY	S
 CHEET	NIO		ΔΓ	,	CHECTO	СТ			7.

COUNTY TOTAL SHEETS NO.

KANE 32 22 SECTION N-4-C-1 341 TC-10 CONTRACT NO. 60D72 SCALE: NONE SHEET NO. 1 OF 1 SHEETS STA. 179+00 TO STA. 194+00 FED. ROAD DIST. NO. 1 ILLINOIS FED. AID PROJECT

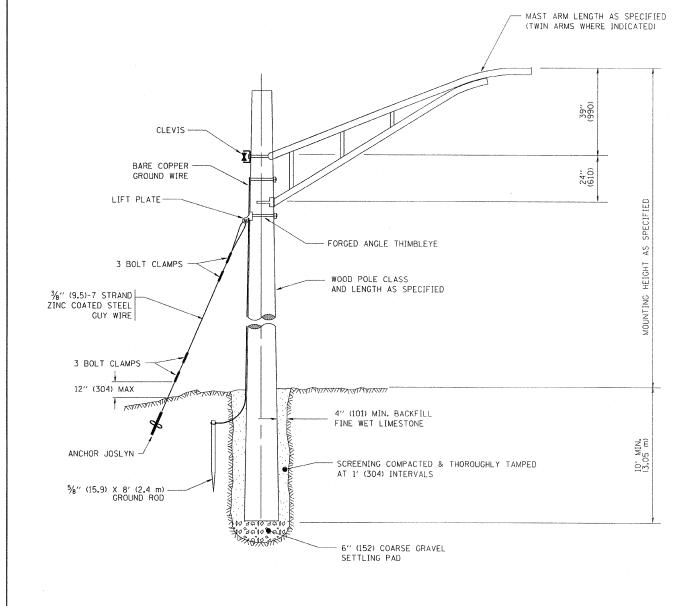


TEMPORARY LIGHT POLE DETAIL

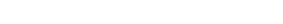


1. ALL DIMENSIONS IN INCHES (MILLIMETERS) UNLESS OTHERWISE INDICATED

NOTES:

TEMPORARY LIGHT POLE ATTACHMENT DETAIL

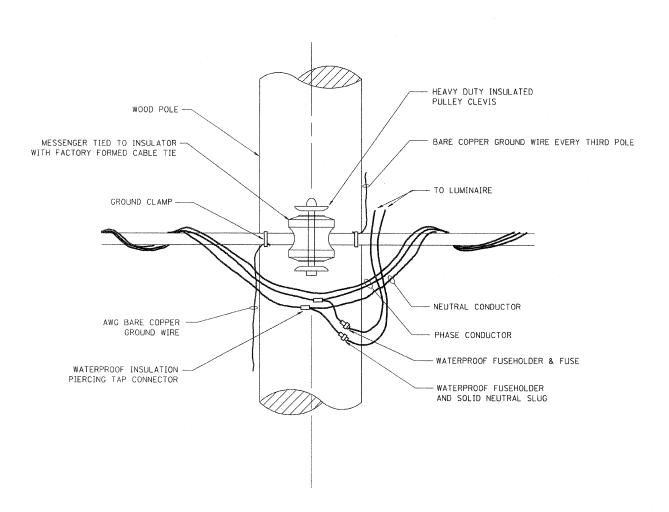

FILE NAME = '	USER NAME = gaglianobt	DESIGNED -	REVISED - 08-08-03		MING IN A SA SA VA LANDING TO SA	F.A.P.	SECTION	COUNTY	TOTAL SHEET
W:\diststd\22x34\be800.dgn		DRAWN -	REVISED -	STATE OF ILLINOIS	TEMPORARY LIGHT POLE DETAILS	RTE.			SHEETS NO.
	PLOT SCALE = 50.000 '/ IN.	CHECKED -	REVISED -	DEPARTMENT OF TRANSPORTATION		341	N-4-C-1	KANE	32 23
	PLOT DATE = 1/4/2008	DATE ~	REVISED -	DELITATION OF TAXABLE OF TAXABLE	SCALE: NONE SHEET NO. 1 OF 1 SHEETS STA. 179+00 TO STA. 194+00	FED. ROAD DIS	BE-800	AID PROJECT	NO. 60D72

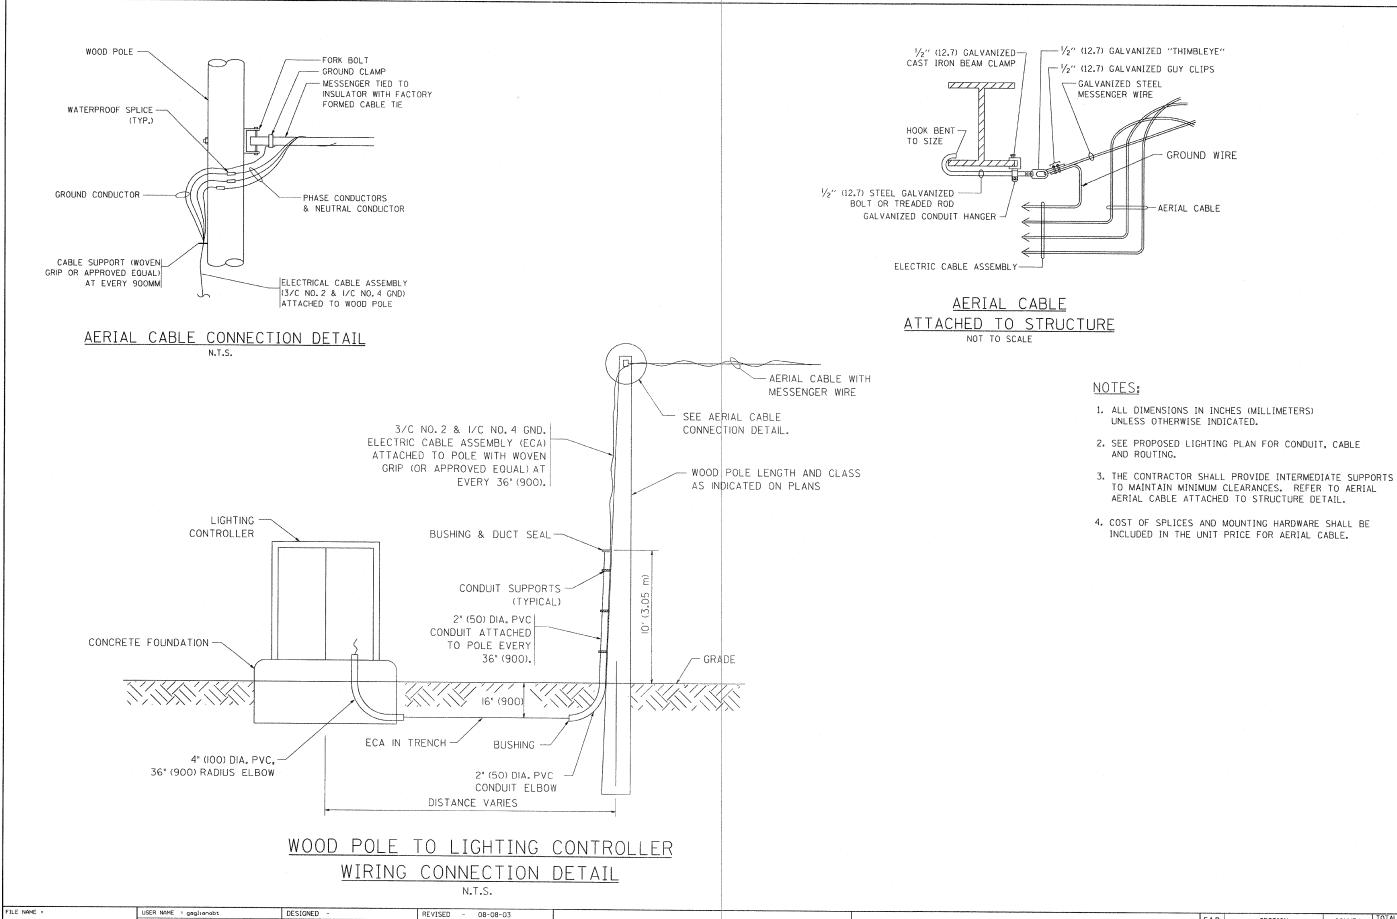

STATE OF ILLINOIS

DEPARTMENT OF TRANSPORTATION

W:\diststd\22x34\be801.dgn

DRAWN

DATE

CHECKED


PLOT SCALE = 50.000 '/ IN.


PLOT DATE = 1/4/2008


REVISED

REVISED

REVISED

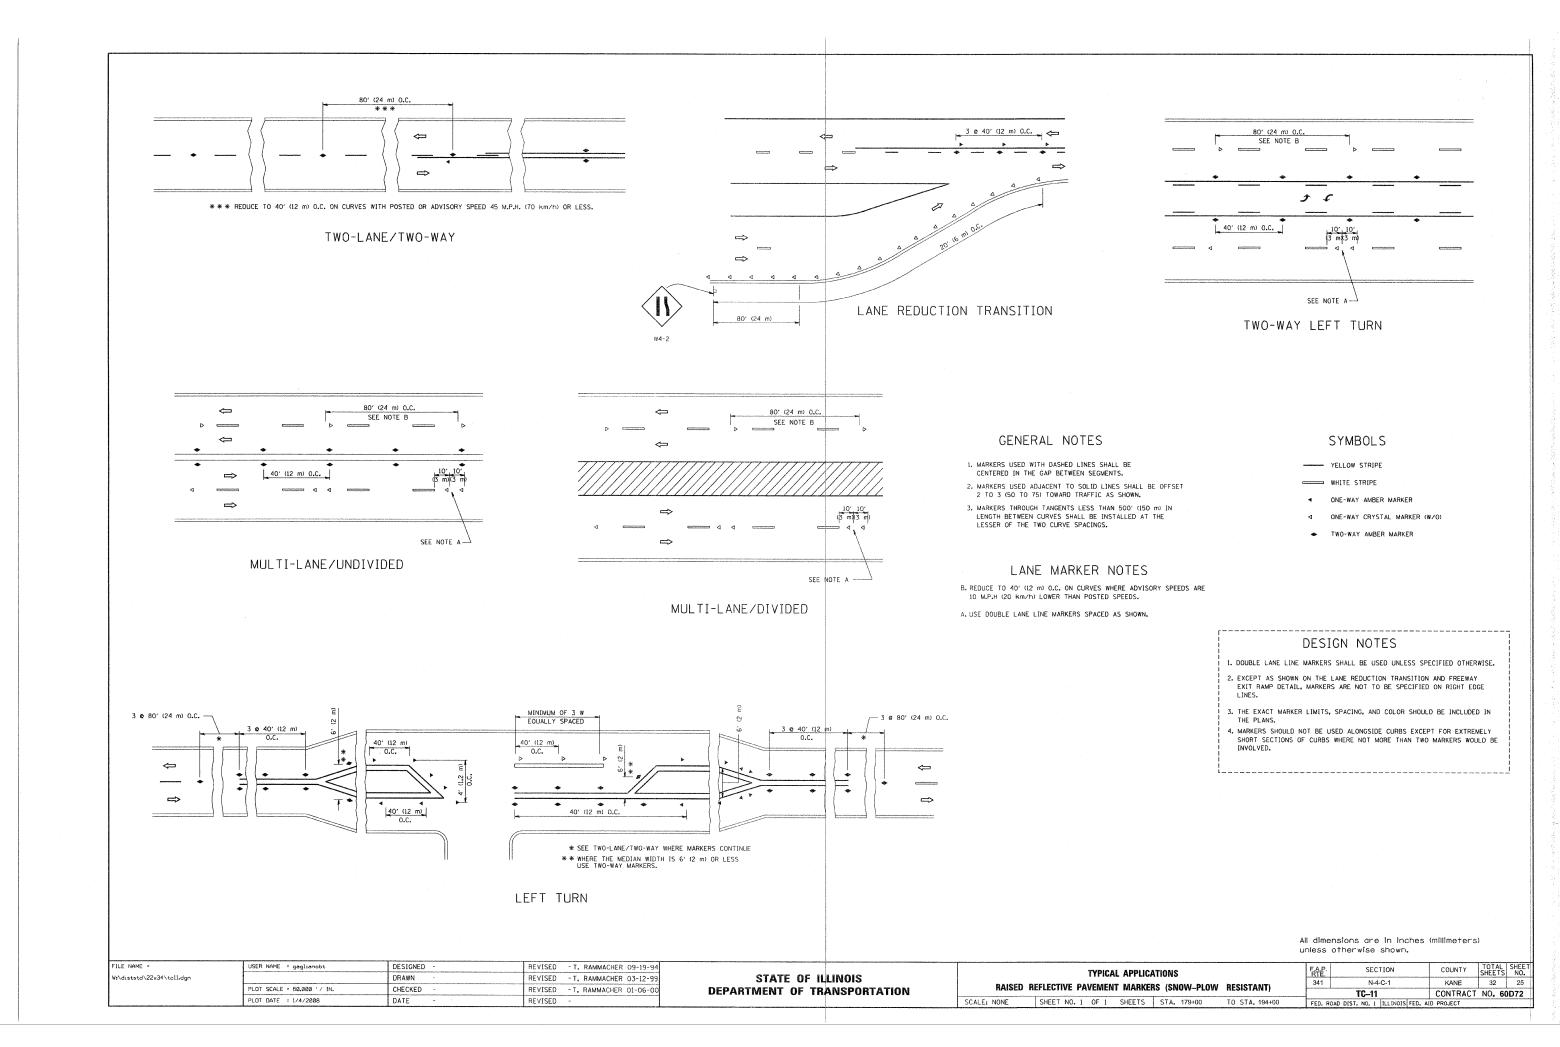

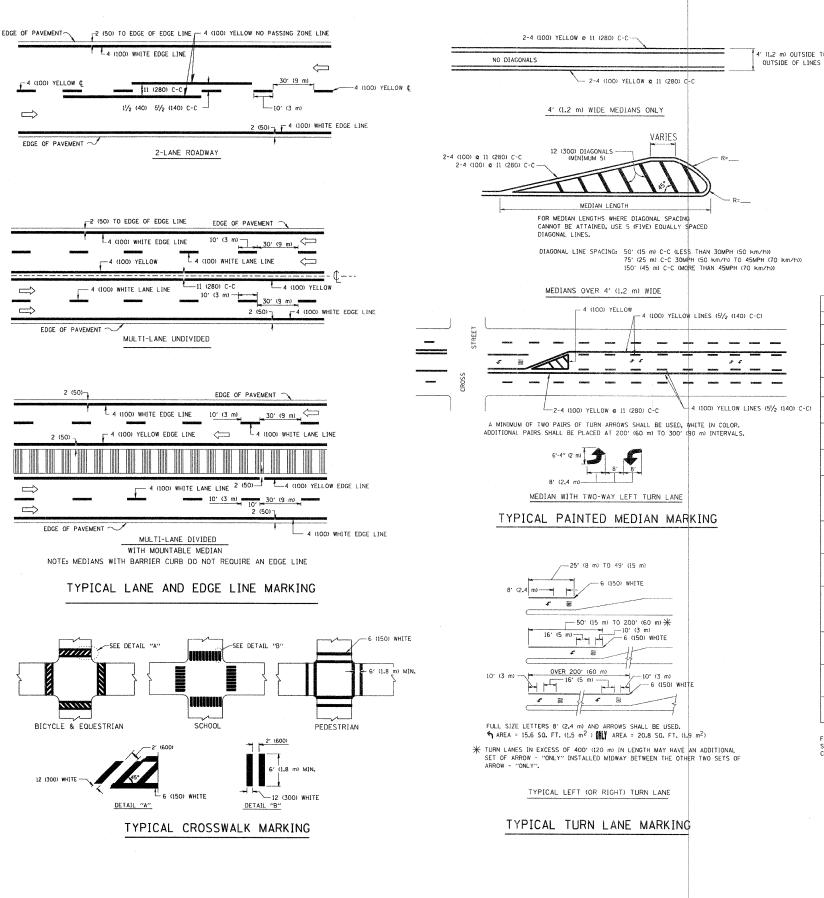

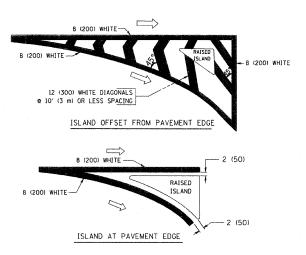


TYPICAL ISLAND MARKING

TYPE OF MARKING	WIDTH OF LINE	PATTERN	COLOR	SPACING / REMARKS
CENTERLINE ON 2 LANE PAVEMENT	4 (100)	SKIP-DASH	YELLOW	10' (3 m) LINE WITH 30' (9 m) SPACE
CENTERLINE ON MULTI-LANE UNDIVEDED PAVEMENT	2 & 4 (100)	SOLID	YELLOW	11 (280) C-C
NO PASSING ZONE LINES: FOR ONE DIRECTION FOR BOTH DIRECTIONS	4 (100) 2 9 4 (100)	SOLID SOLID	YELLOW YELLOW	5½ (140) C-C FROM SKIP-DASH CENTERLINE 11 (280) C-C OMIT SKIP-DASH CENTERLINE BETWEEN
LANE LINES	4 (100) 5 (125) ON FREEWAYS	SKIP-DASH SKIP-DASH	WHITE WHITE	10' (3 m) LINE WITH 30' (9 m) SPACE
DOTTED LINES (EXTENSIONS OF CENTER, LANE OR TURN LANE MARKINGS)	SAME AS LINE BEING EXTENDED	SKIP-DASH	SAME AS LINE BEING EXTENDED	2' (600) LINE WITH 6' (1.8 m) SPACE
EDGE LINES	4 (100)	SOLID	YELLOW-LEFT WHITE-RIGHT	OUTLINE MOUNTABLE MEDIANS IN YELLOW: EDGE LINES ARE NOT USED NEXT TO BARRIER CURB
TURN LANE MARKINGS	6 (150) LINE; FULL SIZE LETTERS & SYMBOLS (8' (2.4m))	SOLID	WHITE	SEE TYPICAL TURN LANE MARKING DETAIL
TWO WAY LEFT TURN MARKING	2 @ 4 (100) EACH DIRECTION	SKIP-DASH AND SOLID	YELLOW	10' (3 m) LINE WITH 30' (9 m) SPACE FOR SKIP-DASH; 51/2 (140) C-C BETWEEN SOLID LINE AND SKIP-DASH LINE
	8' (2.4m) LEFT ARROW	IN PAIRS	WHITE	SEE TYPICAL TWO-WAY LEFT TURN MARKING DETAIL
CROSSWALK LINES (PEDESTRIAN) A. DIAGONALS (BIKE & EOUESTRIAN) B. LONGITUDINAL BARS (SCHOOL)	2 @ 6 (150) 12 (300) @ 45° 12 (300) @ 90°	SOLID SOLID SOLID	WHITE WHITE WHITE	NOT LESS THAN 6' (1.8 m) APART 2' (600) APART 2' (600) APART SEE TYPICAL CROSSWALK MARKING DETAILS.
STOP LINES	24 (600)	SOLID	WHITE	PLACE 4' (1.2 m) IN ADVANCE OF AND PARALLEL TO CROSSMALK, IF PRESENT. OTHERWISE, PLACE AT DESIRED STOPPING POINT. PARALLEL TO CROSSROAD CENTERLINE, WHERE POSSIBLE
PAINTED MEDIANS	2 @ 4 (100) WITH 12 (300) DIAGONALS @ 45° NO DIAGONALS USED FOR 4' (1.2 m) WIDE MEDIANS	SOLID	YELLOW: TWO WAY TRAFFIC WHITE: ONE WAY TRAFFIC	11 (280) C-C FOR THE DOUBLE LINE SEE TYPICAL PAINTED MEDIAN MARKING.
GORE MARKING AND CHANNELIZING LINES	8 (200) WITH 12 (300) DIAGONALS @ 45°	SOLID	WHITE	DIACONALS: 15' (4,5 m) C-C (LESS THAN 30MPH (50 km/h)) 20' (6 m) C-C 30MPH (50 km/h) TO 45MPH (70 km/h)) 30' (9 m) C-C (OVER 45MPH (70 km/h))
RAILROAD CROSSING	24 (600) TRANSVERSE LINES; "RR" IS 6' (1.8 m LETTERS4 16 (400) LINE FOR "X"	SOLID	WHITE	SEE STATE STANDARD 780001 AREA OF: "R"=3.6 SO. FT. (0.33 m²) EACH "X"=54.0 SO. FT. (5.0 m²)
SHOULDER DIAGONALS	12 (300) @ 45°	SOLID	WHITE - RIGHT YELLOW - LEFT	50' (15 m) C-C (LESS THAN 30MPH (50 km/h)) 75' (25 m) C-C (30 MPH (50 km/h) TO 45MPH (70 km/h) 150' (45 m) C-C (0VER 45MPH (70 km/h))

FOR FURTHER DETAILS ON PAVEMENT MARKING REFER TO STANDARD SPECIFICATIONS FOR ROAD AND BRIDGE CONSTRUCTION AND STATE STANDARD 780001.

All dimensions are in inches (millimeters) unless atherwise shown.

FILE NAME =	USER NAME = geglienobt	DESIGNED - EVERS	REVISED -T. RAMMACHER 10-27-94		DIGERRAL AND	F.A.P. SECTION	COUNTY	TOTAL	SHEET
W:\diststd\22x34\tcl3.dgn		DRAWN -	REVISED -A. HOUSEH 10-09-96	STATE OF ILLINOIS	DISTRICT ONE	RTE. 3241 N-4-C-1	KANE	SHEE IS	NU.
	PLOT SCALE = 50.000 '/ IN.	CHECKED -	REVISED -A. HOUSEH 10-17-96	DEPARTMENT OF TRANSPORTATION	TYPICAL PAVEMENT MARKINGS	TC-13	CONTRACT	NO. 6	D72
	PLOT DATE = 1/4/2008	DATE - 03-19-90	REVISED - T. RAMMACHER 01-06-00		SCALE: NONE SHEET NO. 1 OF 1 SHEETS STA. 179+00 TO STA. 194+00	FED. ROAD DIST. NO. 1 ILLINOIS	FED. AID PROJECT		

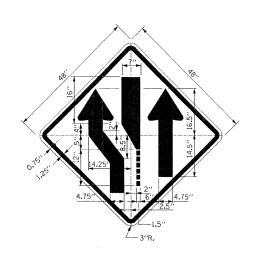

SIGN TS-1


COLOR: BACKGROUND - .

BORDER AND SYMBOL - BLACK

SIZE: 48"×48"

MOUNTING HOLES: SAME AS SHOWN FOR SIGN W1-1 NOTE: SIGN TS-1L IS SHOWN; REVERSE SYMBOL

FOR SIGN TS-1R

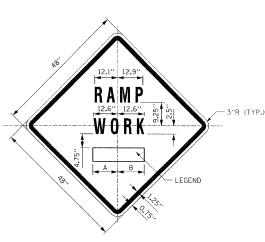

SIGN TS-2

COLOR: BACKGROUND - * BORDER AND SYMBOL - BLACK

SIZE: 48"×48"

20.5"

15''

15''

∠ LEGEND B

SIZE: 48"x60"


- LEGEND A

LETTERING: 7" FEDERAL SERIES D MOUNTING HOLES: SAME AS SHOWN FOR SIGN W1-1

	SIGN NO.	LEGEND	A	В
·	TS-2A TS-2B TS-2C TS-2D TS-2E TS-2F	AHEAD 500 FT 1000 FT 1500 FT 1/2 MILE 1 MILE	15.50" 14.25" 14.88"	15.50" 15.13" 15.75"

0.75"

1.25"

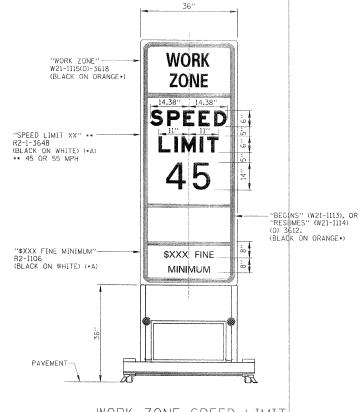

WORK ZONE SPEED LIMIT SIGN ASSEMBLY



SIGN TS-5a & TS-\$b

COLOR: BACKGROUND - WHITE (REFLECTORIZED)(*A)
BORDER AND LETTERS - BLACK ARROW - BLACK

SIZE: 96"×48"

LETTERING: 10" FEDERAL SERIES D MOUNTING HOLES: %6 %, 4 HOLES, SPACED AS SHOWN
NOTE: SIGN TS-50 IS SHOWN, SUBSTITUTE
LEGEND ** FOR *** FOR SIGN TS-5b



COLOR: BACKGROUND - ORANGE BORDER AND LETTERS - BLACK SIZE: 48"×24" LETTERING: 6" FEDERAL SERIES C.

MOUNTING HOLES: 16" DIA., 4 HOLES SPACED AS SHOWN

ON SIGN C20-2A

60" 6.2" 6.2" **END** WORK ZONE SPEED LIMIT 26.5"

SIGN WI-4dR

COLOR: BACKGROUND FLUORESCENT ORANGE TYPE A REFLECTIVE SHEETING PER STANDARD SPECIFICATIONS BORDER AND LETTERS-BLACK

SIZE: 48"x48"

SIGN G20-I103 (BLACK ON ORANGE -*) COLOR: BACKGROUND - ORANGE

BORDER AND LETTERS - BLACK SIZE: 60"x36"

LETTERING: 6" FEDERAL SERIES C, MOUNTING HOLES: 1/6" DIA., 4 HOLES SPACED AS SHOWN

- MOUNTING HOLES TYP. (4 REO'D)

NOTES:

- 1. ALL LETTERING IS DESIGNATED BY SIZE AND SERIES IN ACCORDANCE WITH THE LATEST EDITION OF "STANDARD ALPHABETS FOR HIGHWAY SIGNS AND PAVEMENT MARKINGS" AS PUBLISHED BY THE U.S. DEPARTMENT OF TRANSPORTATION. LETTERING SPACING SHALL BE IN ACCORDANCE WITH THIS GUIDE EXCEPT WHERE NOTED.
- 2. SYMBOLS AND ARROWS SHALL CONFORM TO THE DETAILS SHOWN IN THE LATEST EDITION OF "STANDARD HIGHWAY SIGNS" AS PUBLISHED BY THE U.S. DEPARTMENT OF TRANSPORTATION.
- 3. SEE THE CONTRACT REQUIREMENTS FOR ADDITIONAL NOTES AND SPECIFICATIONS. - FLUORESCENT ORANGE REFLECTIVE SHEETING PER THE STANDARD SPECIFICATIONS. (•A) REFLECTIVE SHEETING PER THE STANDARD SPECIFICATIONS.
- 4. DIMENSIONS INDICATED THUS L ARE BASED ON A REDUCTION IN STANDARD LETTERING SPACING AS SHOWN BELOW:
 11 SPACING REDUCED BY 25%
 L2 SPACING REDUCED BY 40%

DATE

L3 SPACING REDUCED BY 50%

F.A.P RTE.	SECTION	COUNTY	TOTAL SHEETS	SHEET NO.
341	N-4-C-1	KANE	32	27
		CONTRACT 6	0D72	

SHEET 1 OF 2

	Illinois Tollway Open Roads for a Faster Future
REVISIONS	CONCERNICATION CLONIC
	CONSTRUCTION SIGNS

STANDARD E1-00

0.75" 3" R (TYP.) MOUNTING HOLES TYP. (4 REQ'D)

SIGN TS-3

COLOR: BACKGROUND - WHITE (REFLECTORIZED)(+A) BORDER AND LETTERS - BLACK

SIZE: 48"x60" LETTERING: LEGEND - 8" FEDERAL SERIES D MOUNTING HOLES: 1/6"0, 4 HOLES, SPACED AS SHOWN

LETTERING: LEGEND - 6" FEDERAL SERIES C
MOUNTING HOLES: 76" Ø, 4 HOLES, SPACED AS SHOWN

SIGN TS-4

RAMP CLOSURE ADVANCE INFORMATION SIGN


COLOR: BACKGROUND - WHITE (REFLECTORIZED)(*A)

BORDER AND LETTERS - BLACK

- 3" R (TYP.)

-MOUNTING HOLES

APPROVED Jeff laley DATE 1-1-2007 THE VARIABLE MESSAGE WITH DATES FOR THE BOTTOM TWO LINES SHALL BE DETERMINED BY THE ENGINEER AND GIVEN TO THE CONTRACTOR BEFORE THE REQUIRED FIELD ERECTION DATE.

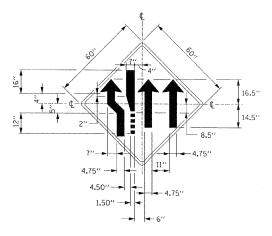


SIGN TS-1CL

COLOR: COLOR - BLACK (NON - REFLECTORIZED)

COLOR: BACKGROUND YELLOW (REFLECTORIZED) PERMANENT USAGE

• FLUORESCENT ORANGE CONSTRUCTION USAGE

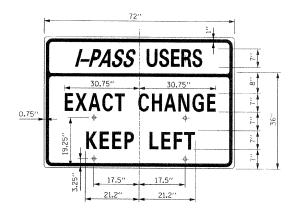


SIGN TS-7

COLOR: BACKGROUND - WHITE (REFLECTORIZED) (*A)
BORDER AND LETTTERS - BLACK

SIZE: 72"x36"

LETTERING: 7" FEDERAL SERIES C


MOUNTING HOLES: 1/6" DIA., 4 HOLES SPACED AS SHOWN

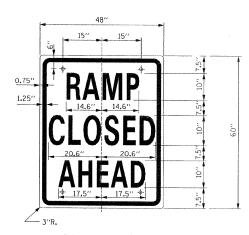

SIGN TS-9

COLOR: BACKGROUND - WHITE (REFLECTURIZED)
BORDER AND LETTTERS - BLACK
SIZE: 48"x60"

LETTERING: 10" FEDERAL SERIES C
MOUNTING HOLES: 10" FEDERAL SERIES C

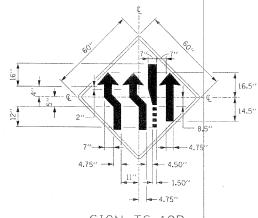


SIGN TS-1CR

COLOR: COLOR - BLACK (NON - REFLECTORIZED)

COLOR: BACKGROUND YELLOW (REFLECTORIZED) PERMANENT USAGE


• FLUORESCENT ORANGE CONSTRUCTION USAGE

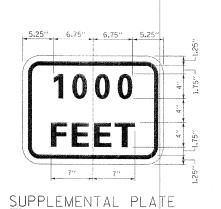

COLOR: BACKGROUND - * FLUORESCENT ORANGE BORDER AND LETTTERS - BLACK


SIZE: 24"x18"

LETTERING: 4" FEDERAL SERIES D
MOUNTING HOLES: 1/6" DIA.

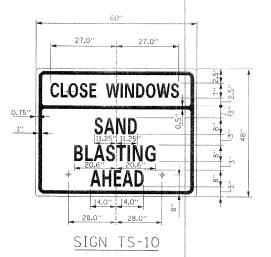


COLOR: BACKGROUND - FLUORESCENT ORANGE BORDER AND LETTTERS - BLACK SIZE: 60"x48"

LETTERING 8" FEDERAL SERIES C, 7" FEDERAL SERIES B MOUNTING HOLES: 16" DIA., 4 HOLES SPACED AS SHOWN

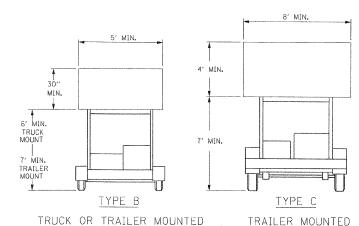

ARROW BOARDS SHALL BE IN ACCORDANCE WITH THE STANDARD SPECIFICATIONS. TYPE C UNITS ARE TO BE USED FOR ALL OPERATIONS 24 HOURS OR MORE IN DURATION AND TYPE B UNITS MAY BE USED FOR OPERATIONS LESS THAN 24 HOURS IN DURATION. ARROW BOARDS SHALL NOT BE USED TO DIRECT PASSING MOVES INTO LANES USED BY OPPOSING TRAFFIC.

FLASHING ARROW BOARDS SIGN TS-8

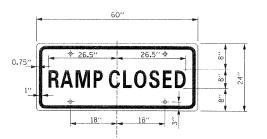

SIGN TS-6

COLOR: BACKGROUND - WHITE (REFLECTURIZED)
BORDER AND LETTTERS - BLACK
SIZE: 60"%24"

LETTERING: 8" FEDERAL SERIES C

MOUNTING HOLES: 1/16" DIA., 4 HOLES SPACED AS SHOWN

GENERAL NOTES:


- ALL LETTERING IS DESIGNATED BY SIZE AND SERIES IN ACCORDANCE WITH THE LATEST EDITION OF "STANDARD ALPHABETS FOR HIGHWAY SIGNS AND PAVEMENT MARKINGS" AS PUBLISHED BY THE U.S. DEPARTMENT OF TRANSPORTATION. LETTERING SPACING SHALL BE IN ACCORDANCE WITH THE GUIDE EXCEPT WHERE NOTED.
- SYMBOLS AND ARROWS SHALL CONFORM TO THE DETAILS SHOWN IN THE LATEST EDITION OF "STANDARD HIGHWAY SIGNS" AS PUBLISHED BY THE U.S. DEPARTMENT OF TRANSPORTATION.
- 3. SEE THE CONTRACT REQUIREMENTS FOR ADDITIONAL NOTES AND SPECIFICATIONS.
- FLUORESCENT ORANGE REFLECTIVE SHEETING PER THE STANDARD SPECIFICATIONS.

(*A) REFLECTIVE SHEETING PER THE STANDARD SPECIFICATIONS.

SHEET 2 OF 2

F.A.P RTE. 341	SECTION N-4-C-1	COUNTY SHE		SHEETS NO.		NO.	Illinois Tollway Open Roads for a Faster Future
		DATE	RE	EVISIO	ONS	CONSTRUCTION SIGNS	
омонициранс	Macalin quantity and the construction of the c		************	n Department and a second		STANDARD E1-00	

APPROVED Solid Francisco DATE 1-1-2007

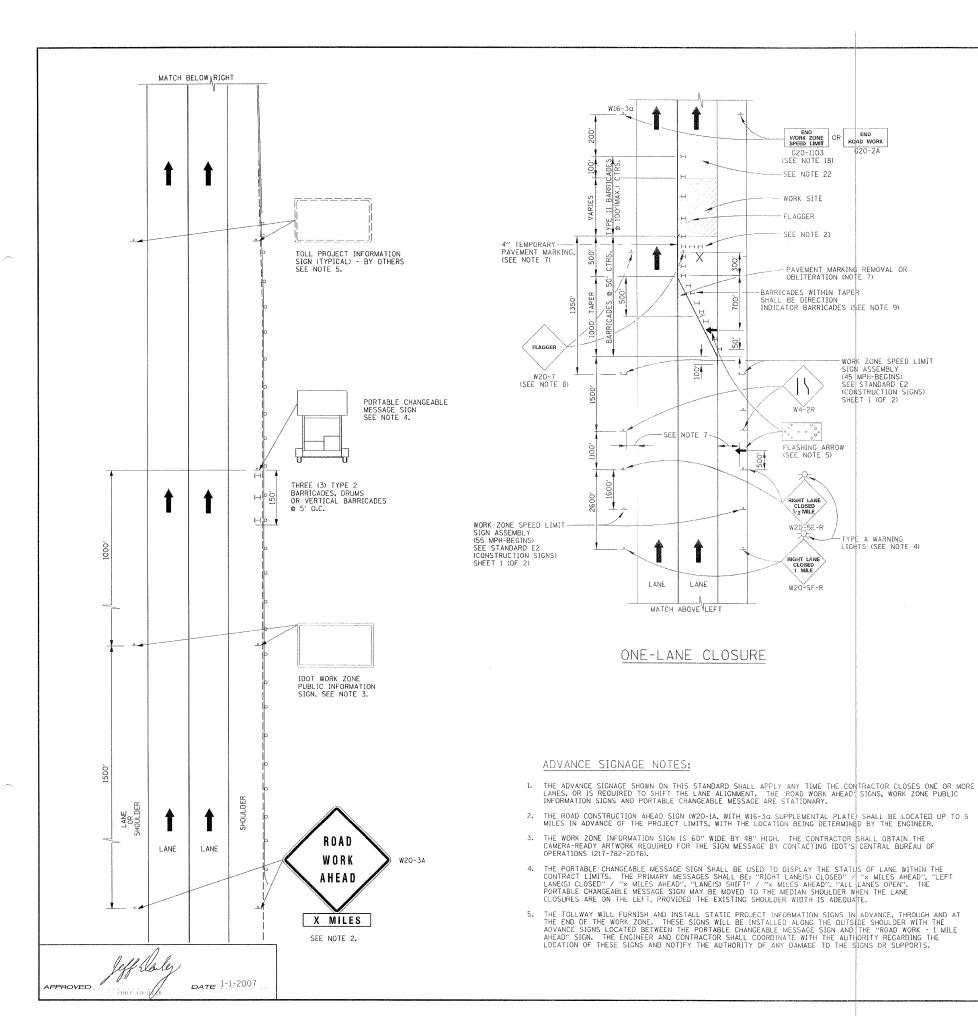

LANE CLOSURE NOTES:

- IF CLOSURES ARE EXPECTED TO PRODUCE TRAFFIC BACKUPS EXTENDING BEYOND THE FIRST WARNING SIGN SHOWN ON THE DETAILS, ADDITIONAL UPSTREAM SIGNS SHALL BE PLACED SO THAT THE TRAFFIC CONTROL ZONE ENCOMPASSES THE ANTICIPATED BACKUP ZONE.
- 2. LONGITUDINAL DIMENSIONS MAY BE ADJUSTED SLIGHTLY TO FIT FIELD CONDITIONS.
- THESE DETAILS ALSO APPLY TO OPPOSITE HAND LANE CLOSURES BY CHANGING SIGN LEGENDS AND ARROW DIRECTIONS TO INDICATE THE APPROPRIATE CLOSURE.
- 4. FOR NIGHT TIME CLOSURES, ONE TYPE A WARNING LIGHT SHALL BE INSTALLED ABOVE EACH OF THE 1 MILE AND 1/2 MILE ADVANCE WARNING SIGNS. FOR DAYLIGHT-ONLY CLOSURES, THE LIGHTS MAY BE 0MITTED AND A MINIMUM OF 18" X 18" ORANGE WARNING FLAG AFFIXED TO THE FIRST SIGN ONLY.
- FOR ANY LANE CLOSURE, FLASHING ARROW BOARDS SHALL BE REQUIRED AND IN OPERATION AT ALL TIMES. THE FLASHING ARROW BOARD IN ADVANCE OF THE TAPER SHALL BE PROTECTED WITH THREE TYPE II BARRICADES AT 50' O.C.
- 6. CONSTRUCTION SIGNS SHALL GENERALLY BE POST-MOUNTED OR ATTACHED TO PORTABLE SUPPORTS AND SHALL BE INSTALLED 8' TO 12' FROM ADJACENT TRAVEL LANE WHEREVER POSSIBLE, IN NO CASE SHALL SIGNS BE LOCATED TO PROVIDE LESS THAN 2' CLEARANCE BETWEEN EDGE OF SIGN AND ADJACENT TRAVEL LANE.
- PAVEMENT MARKING TAPE AND REMOVAL OR OBLITERATION OF EXISTING MARKINGS SHALL BE REQUIRED WHEN THE CLOSURE TIME EXCEEDS FOURS DAYS. THIS WORK SHALL BE MEASURED AND PAID FOR SEPARATELY.
- 8. WHEN A FLAGGER IS NOT ON STATION, THE FLAGGER AHEAD SIGN SHALL BE PROMPTLY REMOVED, COVERED OR TURNED TO FACE AWAY FROM TRAFFIC. SEE NOTE 12 REGARDING MOVING OPERATIONS.
- 9. DIRECTION INDICATOR BARRICADES SHALL BE USED IN LANE TAPERS.
- 10. FOR CLOSURES OTHER THAN SHORT TERM (SUNRISE TO ONE HOUR BEFORE SUNSET), THE MINIMUM HEIGHT OF THE SIGN FROM SHOULDER ELEVATION SHALL BE 7'-0".
- 11. CONES MAY BE USED IN LIEU OF BARRICADES IN THE BUFFER AND WORK AREAS, WHEN THE CLOSURE IS FOR MAINTENANCE OPERATIONS.
- 12. WHENEVER WORKERS ARE PRESENT, ONE WORK ZONE SPEED LIMIT SIGN ASSEMBLY WITH A 45 MPH POSTED SPEED SHALL BE PLACED ADJACENT TO THE OPEN LANE AT A DISTANCE OF 1000' MINIMUM TO 2,500' MAXIMUM IN ADVANCE OF WORKERS THROUGHOUT THE LANE CLOSURE. MOVING OPERATIONS WILL REQUIRE CONTINUOUS ADJUSTMENT OF THE SIGN ASSEMBLY LOCATION TO MAINTAIN THE ABOVE INTERVAL.
- 13. AN ADDITIONAL SIGN ASSEMBLY SHALL BE PLACED 500' BEYOND THE LAST ENTRANCE RAMP FOR EACH INTERCHANGE THAT FALLS WITHIN THE 2,500'.
- 14. THE SIGN ASSEMBLY SHALL BE PLACED NO CLOSER THAN 500' TO ANY OTHER SIGN.
- 15. THE SIGN ASSEMBLY SHALL NOT BE UTILIZED WHEN WORKERS ARE BEHIND A TEMPORARY (MOVABLE BARRIER) WALL.
- 16. THE SIGN ASSEMBLY SHALL BE PROMPTLY REMOVED OR COVERED WHEN WORKERS ARE NOT PRESENT.
- 17. ALL CONFLICTING SPEED LIMIT SIGNS SHALL BE COVERED OR REMOVED.

DATE

- 18. SIGNS WITH G2O-2A, OR AND G2O-1103 SHALL BE IN PLACE WHEN THE SIGN ASSEMBLY (WORK ZONE SPEED LIMIT SIGN) IS UP. THESE SIGNS SHALL ALSO BE REMOVED OR COVERED WHEN THE SIGN ASSEMBLY IS REMOVED OR COVERED, UNLESS STILL REQUIRED BY THE MAINTENANCE OF TRAFFIC PLAN.
- 19. BARRICADES ARE TO BE LOCATED AT JOINT LINE WHEN WORK AREA EXTENDS UP TO JOINT UNLESS OTHERWISE SHOWN ON THE PLANS.
- 20. SEE MAINTENANCE OF TRAFFIC DRAWINGS FOR ADDITIONAL SIGNING IN THIS AREA.
- 21. PLACE CHECK BARRICADES IN ACCORDANCE WITH THE STANDARD SPECIFICATIONS.
- 22. WHEN THE CLOSURE EXTENDS A MINIMUM 2000 FEET PAST THE LAST WORKER, AND THE WIDTH OF THE OPEN LANES HAVE NOT BEEN ALTERED, A WORK ZONE SPEED LIMIT SIGN ASSEMBLY (55-RESUMES) SHALL BE PLACED AT ½ MILE INTERVALS UNTIL THE END OF THE CLOSURE, OR THE NEXT WORK OPERATION.


F.A.P RTE.	SECTION	COUNTY	TOTAL SHEETS	SHEET NO.
341	N-4-C-1	KANE	32	29
		CONTRACT 60D72		

SHEET 1 OF 3


PREVISIONS

LANE CLOSURE DETAILS


STANDARD E2-00

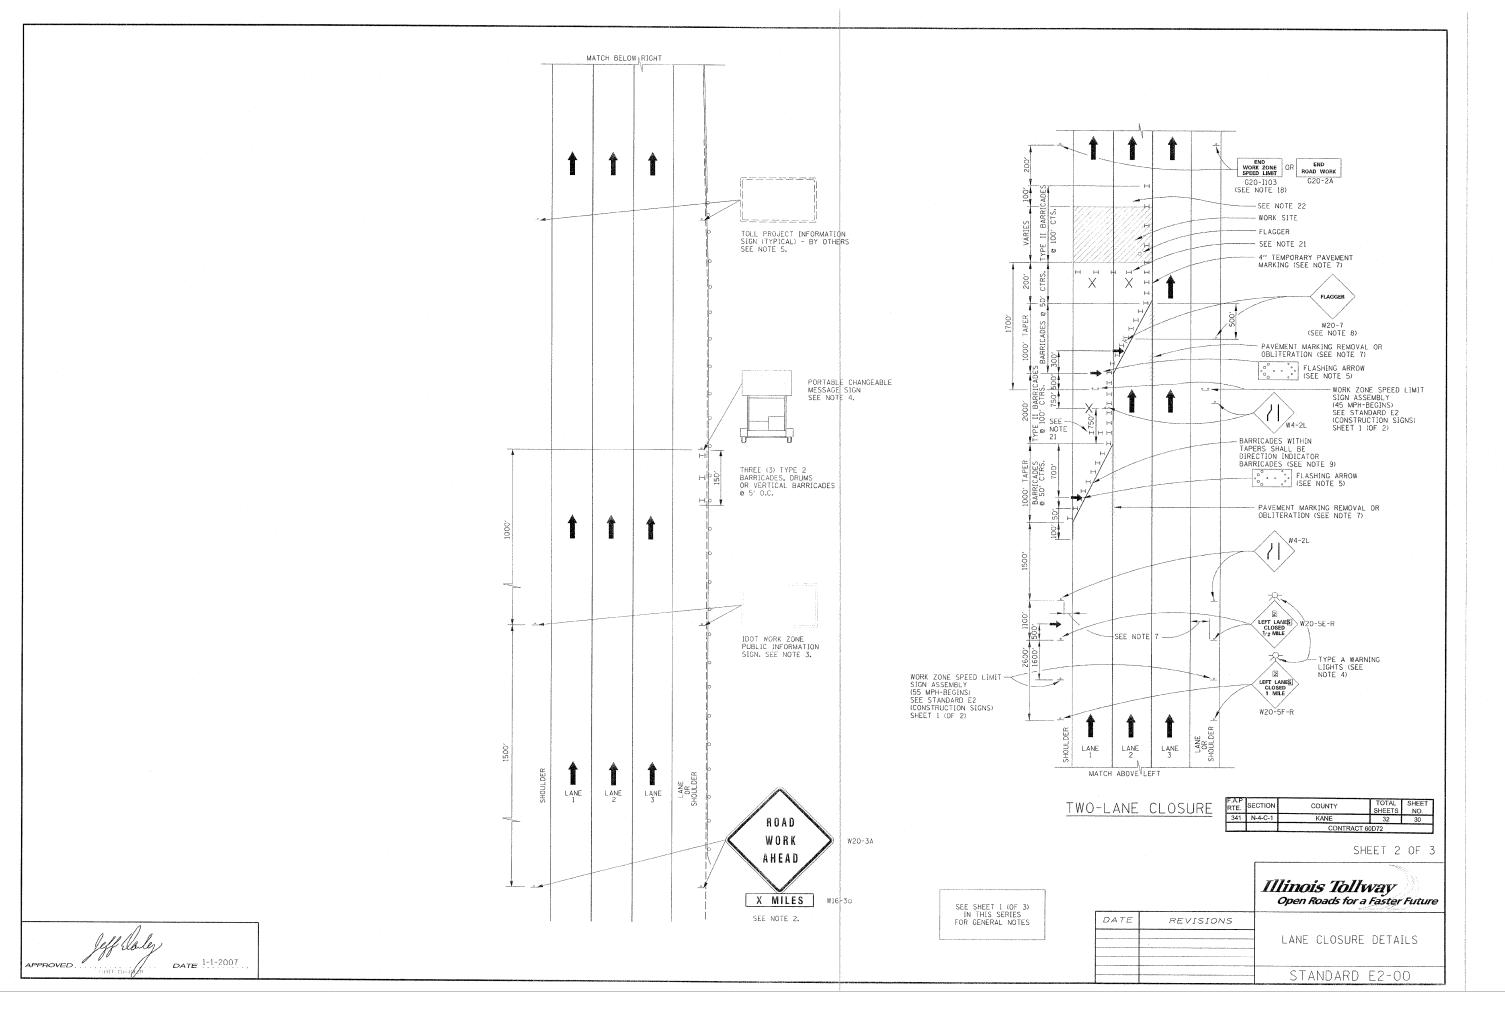

_

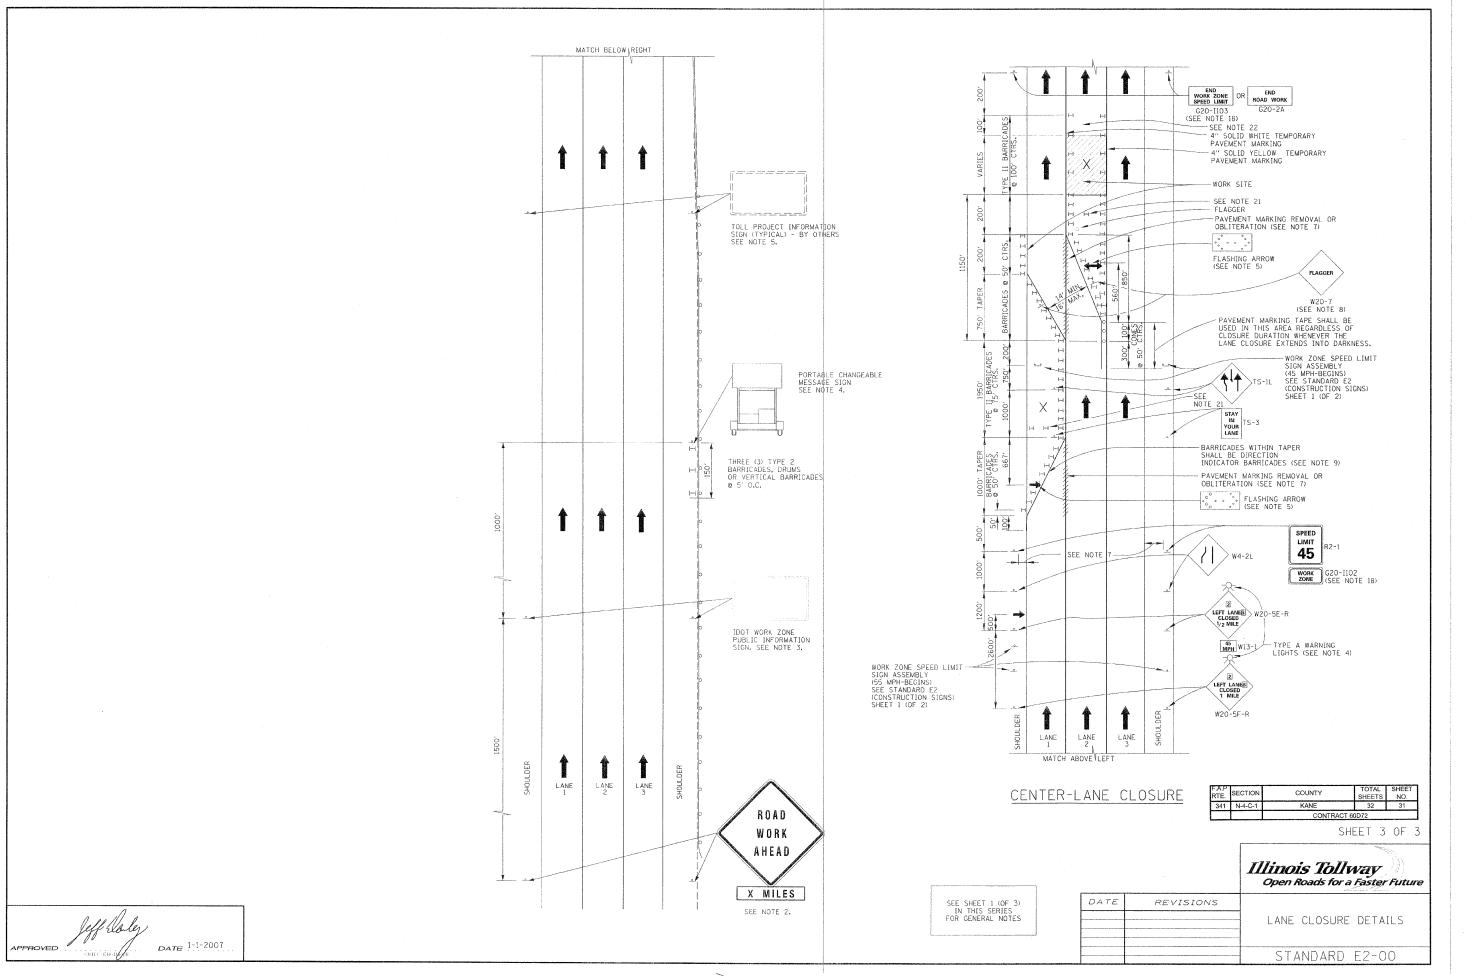

 \sim

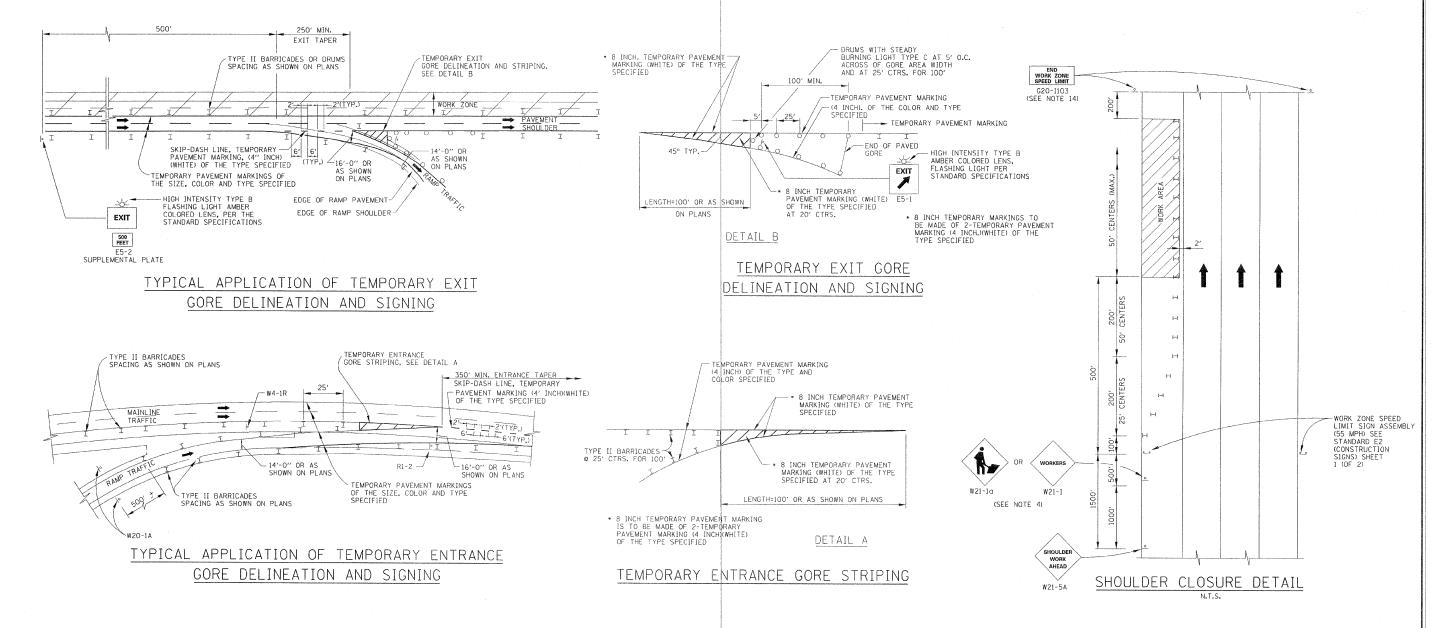

GENERAL NOTES:

- THE SHOULDER SHALL BE CLOSED WHEN A WORK ACTIVITY REQUIRING 15 OR MORE MINUTES IS PERFORMED AT A DISTANCE WHICH IS LESS THAN 15 FEET BUT NO CLOSER THAN 2 FEET THE EDGE OF PAVEMENT.
- 2. THE ADJACENT EXTERIOR LANE SHALL BE CLOSED WHEN WORK IS PERFORMED WITHIN 2 FEET FROM THE EDGE OF PAVEMENT.
- THE CHANNELIZING DEVICES WHICH SEPARATE THE WORK SPACE FROM THE ADJACENT TRAVEL LANE SHALL BE SPACED AT 25' FOR THE NINE DEVICES (200 FEET) AND AT A MAXIMUM OF 50' FOR ALL ADDITIONAL DEVICES.
- WHEN THE WORKSITE IS UNATTENDED, SUBSTITUTE "SHOULDER WORK AHEAD" SIGN FOR THE SECOND SIGN.
- 5. WORKER SIGNS OR SHOULDER WORK SIGNS AND CHANNELIZATION DEVICES ARE PLACED ONLY ON THE SIDE OF THE ROADWAY ON WHICH THE ACTIVITY IS
- 6. FOR SHOULDER CLOSURE EXTENDING OVERNIGHT, BARRICADE TYPE II WITH STEADY BURNING LIGHT, TYPE C SHALL BE USED.
- 7. FOR SHORT TERM CLOSURE (SUNRISE TO ONE HOUR BEFORE SUNSET) NOT EXTENDING INTO DARKNESS, CONES MAY BE USED.
- 8. ONE WORK ZONE SPEED LIMIT SIGN ASSEMBLY (55 MPH BEGINS) SHALL BE PLACED AT A DISTANCE OF 500' TO 2,500' MAXIMUM IN ADVANCE OF WORKERS THROUGHOUT THE SHOULDER CLOSURE, MOVING OPERATIONS MAY REQUIRE CONTINUOUS ADJUSTMENT OF THE SIGN ASSEMBLY LOCATION TO MAINTAIN THE ABOVE INTERVAL.

- AN ADDITIONAL SIGN ASSEMBLY SHALL BE PLACED 500' BEYOND THE LAST ENTRANCE RAMP FOR EACH INTERCHANGE THAT FALLS WITHIN THE 2,500'.
- 10. THE SIGN ASSEMBLY SHALL BE PLACED NO CLOSER THAN 500' TO ANY OTHER SIGN.
- 11. THE SIGN ASSEMBLY SHALL NOT BE UTILIZED WHEN WORKERS ARE BEHIND A TEMPORARY (MOVABLE BARRIER) WALL.
- 12. THE WORK ZONE SPEED LIMIT SIGNS AND SIGN ASSEMBLY SHALL BE PROMPTLY REMOVED OR COVERED WHEN WORKERS ARE NOT PRESENT OR CLOSE TO MOVING TRAFFIC.
- 13. ALL CONFLICTING SPEED LIMIT SIGNS SHALL BE COVERED OR REMOVED.
- 14. "END WORK ZONE SPEED LIMIT" SIGNS SHALL BE IN PLACE ONLY WHEN THE EXISTING POSTED SPEED > 55MPH.
- 15. FOR SHOULDER REPAIRS OR REPLACEMENT THE CHANNELIZING DEVICES SHALL BE PLACED AT THE EDGE OF PAVEMENT WHENEVER THE WORK ACTIVITIES RESULT IN A DROPOFF AT THE EDGE OF PAVEMENT.

COUNTY	TOTAL SHEETS	32
KANE	32	
	KANE	SHEETS

Illinois Tollway
Open Roads for a Faster Future

DATE	REVISIONS	TEMPORARY GORE DETAILS	
		AND SHOULDER CLOSURE DETAILS	
		STANDARD E3-00	

APPROVED PATE 1-1-2007