


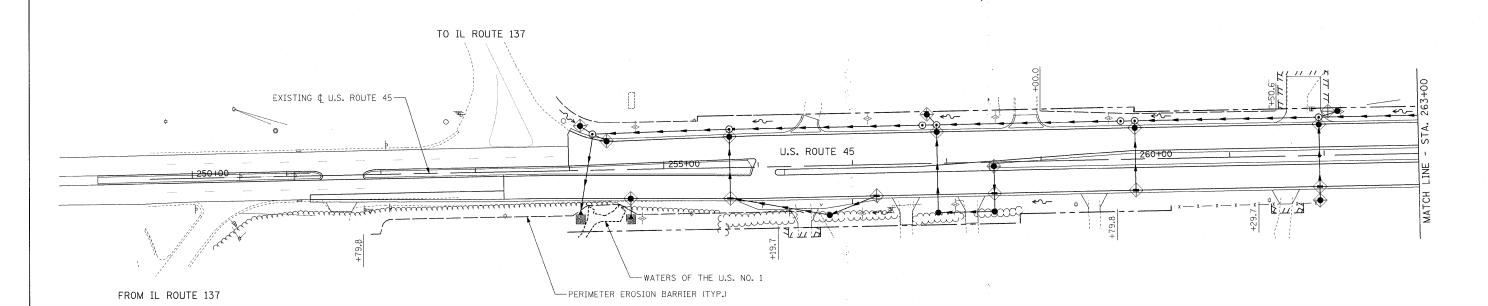

U.S. ROUTE 45 RECONSTRUCTION | CONTRACT NO. 60957

FED. ROAD DIST. NO. | ILLINOIS FED. AID PROJECT



## **EROSION CONTROL LEGEND**

CULVERT INLET FILTER

AGGREGATE DITCH CHECK

PERIMETER EROSION BARRIER

EXISTING STORM SEWER

STORM SEWER OUTLET
EXISTING ROADS

----- WETLAND BOUNDARIES

MANHOLE

DIRECTION OF SURFACE WATER FLOW

AREA OF SOIL DISTURBANCE
DURING STAGE 1 CONSTRUCTION

TEMPORARY PAVEMENT/LANES

## NOTES:

- 1. EROSION CONTROL TO BE IN PLACE BEFORE START OF WORK AND TO REMAIN IN PLACE UNTIL ENGINEER DIRECTS TO REMOVE. CONTRACTOR SHALL BE RESPONSIBLE FOR IMMEDIATE REPAIR/MAINTENANCE OF EROSION CONTROL ITEMS AS DIRECTED BY THE ENGINEER.
- 2. DITCH CHECKS SPACED AT APPROXIMATELY 100' INTERVALS. DITCH CHECKS SHALL ALSO BE USED AT FLARED END INLET STRUCTURES.
- INITIALLY TRAFFIC FLOW IN BOTH DIRECTIONS WILL BE LOCATED ON THE SOUTHBOUND LANES DURING CONSTRUCTION OF NORTHBOUND LANES.
- 4. AFTER CONSTRUCTION OF NORTHBOUND LANES ARE COMPLETED TRAFFIC FLOW WILL BE DIVERTED TO NORTHBOUND AND SOUTHBOUND LANES DURING FINAL STAGES OF CONSTRUCTION.

FILE NAME =	USER NAME = \$USER\$	DESIGNED -	MAP	REVISED -	.™ 	*		
\$FILEL\$		DRAWN -	JRH	REVISED -	STATE OF ILLINOIS		EROSION CONTROL PLA	N - STAGE 2
	PLOT SCALE = \$SCALE\$	CHECKED -	JW	REVISED -	DEPARTMENT OF TRANSPORTATION			
	PLOT DATE = \$DATE\$	DATE -	12-12-08	REVISED -		SCALE: 1" = 50'	SHEET NO. 1 OF 4 SHEETS ST	TA. 249+00 TO STA. 263