04-23-2021 LETTING ITEM 013

STATE OF ILLINOIS **DEPARTMENT OF TRANSPORTATION**

SECTION COUNTY 20-00014-00-RS MCHENRY 19 ILLINOIS CONTRACT NO.61HO3 UQLR(335)

FOR INDEX OF HIGHWAY STANDARDS, SEE SHEET NO. 2


PROJECT LOCATED IN THE VILLAGE OF LAKEWOOD

TRAFFIC DATA


HALIGUS ROAD POSTED SPEED LIMIT: 45 MPH 2017 ADT = 3,150 - 4,700

FUNCTIONAL CLASSIFICATION

MAJOR COLLECTOR

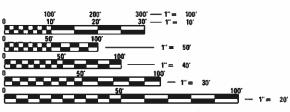

J.U.L.I.E. DESIGN STAGE REQUEST DIG. No. X3100493-00X

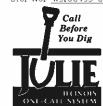

CONTACT JULIE AT 811 OR 800-892-0123 WITH THE FOLLOWING:

CITY-TWNSHP. = VILLAGE OF LAKEWOOD - TOWNSHIP 43 N ONE-CALL SISTEM

48 HOURS (2 working days) BEFORE YOU DIG SEC. & 1/4 SEC. NO. = SECTIONS 10 AND 3


CONTRACT NO. 61H03

PLANS FOR PROPOSED FEDERAL AID HIGHWAY


FAU ROUTE 3869 (HALIGUS ROAD) LAKEWOOD ROAD TO VILLAGE LIMITS **RESURFACING**

> **SECTION: 20-00014-00-RS** PROJECT: UQLR(335)

> > **VILLAGE OF LAKEWOOD MCHENRY COUNTY**

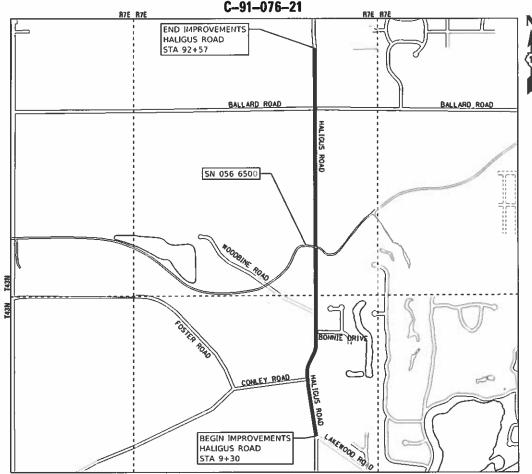

LOCATION MAP GROSS LENGTH = 8,327 FT. = 1.58 MILE NET LENGTH = 8,327 FT. = 1.58 MILE

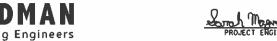


STATE OF ILLINOIS
DEPARTMENT OF TRANSPORTATION JANUARY 27, 2021 Ose Pros (OB)

> PRINTED BY THE AUTHORITY OF THE STATE OF ILLINOIS

B&W PROJECT NO.: 191291

LOCATION OF SECTION INDICATED THUS: -

DATE: 1-5-2021

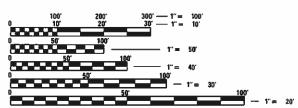

FULL SIZE PLANS HAVE BEEN PREPARED USING STANDARD ENGINEERING SCALES. REDUCED SIZED PLANS WILL NOT CONFORM TO STANDARD SCALES. IN MAKING MEASUREMENTS ON REDUCED PLANS, THE ABOVE SCALES MAY BE USED.

Consulting Engineers

780001-05 TYPICAL PAVEMENT MARKINGS

DISTRICT DETAILS

BD400-05	BUTT JOINT AND HMA TAPER DETAILS
TC-10	TRAFFIC CONTROL & PROTECTION FOR SIDE ROADS, INTERSECTIONS, & DRIVEWAYS
TC-13	DISTRICT ONE TYPICAL PAVEMENT MARKINGS
TC-22	ARTERIAL ROAD INFORMATION SIGN

USER NAME = mornig	DESIGNED -	REVISED -
	DRAWN -	REVISED -
PLOT SCALE = 20.0000 ' / in.	CHECKED -	REVISED -
PLOT DATE = 2/16/2021	DATE - 2-16-2021	FILE - 191291SHT-GenNotes.dgn

STATE OF ILLINOIS DEPARTMENT OF TRANSPORTATION

SCALE:

				WOUNTLY STANDARDS			RTI		
MDE	K OF	SHE	FIS	ΑN	ID HIC	iHWAY	STANDARDS		386
	CHEET	1	OF	1	CHIEFTE	CTA	TO CTA	- 1	

	F.A. RTE.	SECT	ION	COUNTY	TOTAL SHEETS	SHEET NO.	
	3869 20-00014-00-RS				MCHENRY	18	2
					CONTRACT NO. 61H03		
			ILLINOIS	FED. A	ID PROJECT UQLR	(335)	

BAXTER

- 1. ALL CONSTRUCTION SHALL BE DONE IN ACCORDANCE WITH THE DETAILS IN THE PLANS, THE SPECIAL PROVISIONS INCLUDED IN THE CONTRACT DOCUMENTS, AND THE FOLLOWING STATE OF ILLINOIS SPECIFICATIONS: THE 2016 VERSION OF "THE STANDARD SPECIFICATIONS FOR ROAD AND BRIDGE CONSTRUCTION" (REFERRED TO AS THE "STANDARD SPECIFICATIONS"), THE 2021 VERSION OF THE "SUPPLEMENTAL SPECIFICATIONS AND RECURRING SPECIAL PROVISIONS", THE 2009 VERSION OF THE "MANUAL ON UNIFORM TRAFFIC CONTROL DEVICES FOR STREETS AND HIGHWAYS", THE 2019 VERSION OF THE "MANUAL OF TEST PROCEDURES FOR MATERIALS" AND THE 8TH EDITION OF THE "STANDARD SPECIFICATIONS FOR WATER AND SEWER MAIN CONSTRUCTION IN ILLINOIS"
- 2. UTILITY LOCATIONS HAVE NOT BEEN SHOWN ON THESE PLANS. THE CONTRACTOR SHALL BE RESPONSIBLE FOR THE PROTECTION OF ALL UNDERGROUND OR SURFACE UTILITIES, INCLUDING SPRINKLER SYSTEMS, EVEN THOUGH THEY MAY NOT BE SHOWN ON THE PLANS. CONTRACTOR SHALL ALSO VERIFY THE DEPTHS OF THE EXISTING UTILITIES IF NECESSARY TO VERIFY THAT GRADE CONFLICTS WILL NOT OCCUR WITH ANY PROPOSED UTILITIES PRIOR TO CONSTRUCTION AND ORDERING ANY MATERIALS. ANY RELOCATION OR LOWERING OF UTILITIES SHALL BE COORDINATED BY THE CONTRACTOR.
- 3. THE CONTRACTOR SHALL NOTIFY THE VILLAGE PUBLIC WORKS ADMINISTRATOR AT LEAST 48 HOURS IN ADVANCE OF BEGINNING WORK TO OBTAIN VILLAGE UTILITY LOCATIONS.
- THE CONTRACTOR MAY OBTAIN MUNICIPAL WATER IN BULK, AT NC CHARGE, AS LONG AS THERE IS NOT A "WATERING BAN" IN EFFECT. THE INDISCRIMINATE USE OF FIRE HYDRANTS IS STRICTLY PROHIBITED. WATER FOR CONSTRUCTION SHALL BE METERED OR OTHERWISE ACCOUNTED FOR AND A DAILY LOG MAINTAINED. THE CONTRACTOR SHALL PROVIDE THE WATER TRUCK AND DRIVER REQUIRED TO OBTAIN AND TRANSPORT THIS WATER. THE VILLAGE RESERVES THE RIGHT TO RESTRICT OR REFUSE THE USE OF VILLAGE WATER IF DEEMED NECESSARY.
- ACCESS TO PRIVATE DRIVEWAYS SHALL BE PROVIDED AT ALL TIMES EXCEPT DURING ACTUAL CONSTRUCTION ADJACENT THERE TO. TEMPORARY RAMPS SHALL BE CONSTRUCTED AS NEEDED TO PROVIDE SUCH ACCESS, UTILIZING CRUSHED STONE OR CRUSHED GRAVEL AS TEMPORARY
- 6. IT WILL BE THE CONTRACTOR'S RESPONSIBILITY TO NOTIFY THE ENGINEER, RESIDENTS AND THE VILLAGE WHEN ACCESS TO DRIVEWAYS WILL BE TEMPORARILY CLOSED DUE TO CURB AND GUTTER AND/OR DRIVEWAY REPLACEMENT. THE CONTRACTOR SHALL DISTRIBUTE NOTICES PROVIDED BY THE VILLAGE TO RESIDENTS AT LEAST 24 HOURS PRIOR TO PLANNED CLOSURE. EVERY EFFORT SHALL BE MADE TO ACCOMMODATE ACCESS TO THESE PROPERTIES INCLUDING KNOCKING ON DOORS WHEN DRIVEWAYS ARE ABOUT TO BE CLOSED.
- 7. A 1/2-INCH THICK EXPANSION JOINT SHALL BE PROVIDED AT THE JUNCTION OF THE DRIVEWAY APRON AND CURB, AND AT THE JUNCTION OF THE DRIVEWAY APRON AND THE SIDEWALK.
- THE CONTRACTOR SHALL CONTACT THE LOCAL AGENCY MATERIAL INSPECTOR AT LEAST 48 HOURS PRIOR TO ANY CONCRETE OR HOT-MIX ASPHALT MATERIAL DELIVERIES.
- 9. THE DAYS PAVING OPERATION SHOULD RESULT IN A SINGLE TRANSVERSE JOINT. ANY COLD LONGITUDINAL JOINTS WILL NOT BE ACCEPTED. PROVIDING A SINGLE TRANSVERSE JOINT SHALL BE ACCOMPLISHED BY PAVING ONE LANE OF SUFFICIENT LENGTH THAT WILL ALLOW FOR THE PAVING OF THE ADJACENT LANE IN THE SAME DAY
- 10. ALL POSTS, RAILROAD TIES, AND DECORATIVE TIMBER IN CONFLICT WITH THE PROPOSED IMPROVEMENTS SHALL BE REMOVED AND RELOCATED AS DETERMINED BY THE ENGINEER AT THE TIME OF CONSTRUCTION. EVERY EFFORT SHALL BE MADE BY THE CONTRACTOR WHEN REMOVING THESE ITEMS TO PRESERVE THEM FROM HARM. ITEMS NOT RELOCATED SHALL BE PROPERLY DISPOSED OF BY THE CONTRACTOR.
- 11. A PORTABLE BATHROOM(S) SHALL BE PLACED ON THE JOB SITE(S) AND RELOCATED WHEN NECESSARY SO IT IS ACCESSIBLE TO WORKERS. IF WORK IS OCCURRING AT SEVERAL LOCATIONS, ONE PORTABLE BATHROOM SHALL BE PLACED AT EACH LOCATION WITHIN A REASONABLE DISTANCE FROM THE WORK AS DETERMINED BY THE ENGINEER.
- 12. ON RURAL PAVEMENTS BEING RESURFACED THAT DO NOT HAVE A PAVED SHOULDER, MAILBOX TURNOUTS SHALL BE PROVIDED AT EACH EXISTING MAILBOX FOR THE FULL WIDTH OF THE SHOULDER UP TO 6 INCHES FROM THE FACE OF THE EXISTING MAILBOX. MAILBOX TURNOUTS SHALL BE AT LEAST 2 INCHES THICK.
- 13. WHEN MILLED PAVEMENT IS OPEN TO TRAFFIC, THE MAXIMUM GRADE DIFFERENTIAL BETWEEN PASSES OF THE MILLING MACHINE SHALL NOT EXCEED 1 ½ INCHES WHERE THE SPEED LIMIT IS 45 MPH OR LESS, AND SHALL NOT EXCEED 1 INCH WHERE THE SPEED LIMIT IS OVER 45 MPH. A MAXIMUM GRADE DIFFERENCE OF 3 INCHES MAY BE ALLOWED IF THE EDGE OF THE MILLING IS SLOPED A MINIMUM OF 1:3 (V:H), AS DETERMINED BY THE ENGINEER

BAXTER WOODMAN Consulting Engineers

USER NAME = mornig	DESIGNED -	REVISED -
	DRAWN -	REVISED -
PLOT SCALE = 20.0000 ' / in.	CHECKED -	REVISED -
PLOT DATE = 2/5/2021	DATE - 2-4-2021	FILE - 191291SHT-GenNotes.dgn

STATE OF ILLINOIS DEPARTMENT OF TRANSPORTATION

SCALE:

						- 1
OFNEDAL NOT	F.A. RTE.	SECTION	COUNTY	TOTAL SHEETS	SHEET NO.	
GENERAL NOT	FS	3869	20-00014-00-RS	MCHENRY	19	3
				CONTRACT	NO. 6	1H03
SHEET 1 OF 1 SHEETS S	TA TO STA		ILLINOIS EED A	ID DECLET LIGHT	/3351	

STATE OF ILLI	STATE OF ILLINOIS - PROFESSIONAL DESIGN FIRM	DESIGN FIRM	\plotd
LICENSE NO	LICENSE NO 184-001121 - EXPIRES 4/30/2021	5 4/30/2021	\CAD
mornig	2/5/2021	10:34:22 AM	I:\Crysta
MODEL: Default			
FILE NAME: P.C.	FILE NAME: PyCrystaf Lakey KWDVA191391-Halforis Boad Bh 1 INCADISheers 1913	Horse Boad Dh I flicab	Shaarel 1917

BAXTER WOODMAN Consulting Engineers

				80% STU 20% VILLAGE
CODE NO.	ITEM	UNIT	TOTAL QUANTITY	ROADWAY 0005 URBAN
20101400	NITROGEN FERTILIZER NUTRIENT	POUND	90	90
20101500	PHOSPHORUS FERTILIZER NUTRIENT	POUND	90	90
20101600	POTASSIUM FERTILIZER NUTRIENT	POUND	90	90
20101700	SUPPLEMENTAL WATERING	UNIT	· 1	1
20201200	REMOVAL AND DISPOSAL OF UNSUITABLE MATERIAL	CU YD	75	75
21001000	GEOTECHNICAL FABRIC FOR GROUND STABILIZATION	SQ YD	1,394	1.394
21101615	TOPSOIL FURNISH AND PLACE, 4"	SQ YD	3,765	3,765
25000100	SEEDING, CLASS 2A	ACRE	1	1
25100105	MULCH, METHOD 1	ACRE	1	1
28000250	TEMPORARY EROSION CONTROL SEEDING	POUND	100	100
30300001	AGGREGATE SUBGRADE IMPROVEMENT	CU YD	230	230
40600290	BITUMINOUS MATERIALS (TACK COAT)	POUND	14,460	14,460
40600400	MIXTURE FOR CRACKS, JOINTS, AND FLANGWAYS	TON	3	3
40600982	HOT-MIX ASPHALT SURFACE REMOVAL - BUTT JOINT	SQ YD	450	450
40603200	POLYMERIZED HOT-MIX ASPHALT BINDER COURSE, IL-4.75, N50	TON	1,232	1.232

				CONSTRUCTION CODE
				80% STU 20% VILLAGE
CODE NO.	ITEM	UNIT	TOTAL QUANTITY	ROADWAY 0005 URBAN
40604060	HOT-MIX ASPHALT SURFACE COURSE, IL-9.5, MIX "D", N50	TON	2,279	2,279
40800050	INCIDENTAL HOT-MIX ASPHALT SURFACING	TON	81	81
44000157	HOT-MIX ASPHALT SURFACE REMOVAL, 2"	SQ YD	273	273
44000158	HOT-MIX ASPHALT SURFACE REMOVAL, 2 1/2"	SQ YD	21,421	21,421
44201713	CLASS D PATCHES, TYPE I, 6"	SQ YD	215	215
44201717	CLASS D PATCHES, TYPE II, 6"	SQ YD	429	429
44201721	CLASS D PATCHES , TYPE III, 6"	SQ YD	857	857
44201723	CLASS D PATCHES, TYPE IV, 6"	SQ YD	1,286	1,286

48102100	AGGREGATE WEDGE SHOULDER, TYPE B	TON	311	311
66900200	NON-SPECIAL WASTE DISPOSAL	CU YD	75	75
66900530	SOIL DISPOSAL ANALYSIS	EACH	1	1
66901001	REGULATED SUBSTANCES PRE-CONSTRUCTION PLAN	LSUM	1	1
66901003	REGULATED SUBSTANCES FINAL CONSTRUCTION REPORT	LSUM	1	1
66901006	REGULATED SUBSTANCES MONITORING	CAL DA	5	5
67100100	MOBILIZATION	LSUM	1	1
INDICATES	SPECIALTY ITEM			

SCALE:

USER NAME = mornig	DESIGNED -	REVISED -	
	DRAWN -	REVISED -	STATE
PLOT SCALE = 20,0000 * / in.	CHECKED -	REVISED -	DEPARTMENT
PLOT DATE = 2/5/2021	DATE - 2-4-2021	FILE - 191291SHT-SOO.dan	

TE OF ILLINOIS
TOF TRANSPORTATION

CONSTRUCTION CODE

						"	RTE.	SECTION	COUNTY	SHEETS	NO.
	SUIV	IMAF	łΥ	OF QU	IANTI	IES	3869	20-00014-00-RS	MCHENRY	19	4
 									CONTRACT	NO. 6	1H03
SHEET	1	OF	2	SHEETS	STA.	TO STA.		ILLINOIS FED. A	ID PROJECT UQLR	(335)	

				CONSTRUCTI CODE
				80% STU 20% VILLAG
CODE NO.	ITEM	UNIT	TOTAL QUANTITY	ROADWAY 0005 URBAN
70102620	TRAFFIC CONTROL AND PROTECTION STANDARD 701501	LSUM	1	1
70300100	SHORT TERM PAVEMENT MARKING	FOOT	25,935	25,935
70300150	SHORT TERM PAVEMENT MARKING REMOVAL	SQ FT	2,882	2,882
72000100	SIGN PANEL - TYPE 1	. SQ FT	291	291
72400100	REMOVE SIGN PANEL ASSEMBLY - TYPE A	EACH	10	10
72400200	REMOVE SIGN PANEL ASSEMBLY - TYPE B	EACH	2	2
72800100	TELESCOPING STEEL SIGN SUPPORT	FOOT	444	444
78000100	THERMOPLASTIC PAVEMENT MARKING - LETTERS AND SYMBOLS	SQ FT	37	37
78000200	THERMOPLASTIC PAVEMENT MARKING - LINE 4"	FOOT	25,418	25,418
78000400	THERMOPLASTIC PAVEMENT MARKING - LINE 6"	FOOT	221	221
78000650	THERMOPLASTIC PAVEMENT MARKING, LINE - 24"	FOOT	74	74
	REMOVE AND REINSTALL BRICK PAVER	SQ FT	175	175

				CONSTRUCTION CODE 80% STU 20% VILLAGE
CODE NO.	ITEM	UNIT	TOTAL QUANTITY	ROADWAY 0005 URBAN
X4021000	TEMPORARY ACCESS (PRIVATE ENTRANCE)	EACH	13	13
X4022000	TEMPORARY ACCESS (COMMERCIAL ENTRANCE)	EACH	2	2
X4023000	TEMPORARY ACCESS (ROAD)	EACH	10	10
Z0019600	DUST CONTROL WATERING	UNIT	2	2
Z0030850	TEMPORARY INFORMATION SIGNING	SQ FT	155	155
Z0033700	LONGITUDINAL JOINT SEALANT	FOOT	8.470	8.470

* INDICATES SPECIALTY ITEM

	USER NAME = mornig	DESIGNED -	REVISED -
BAXTER WOODMAN		DRAWN -	REVISED -
Consulting Engineers	PLOT SCALE = 20,0000 ' / in.	CHECKED -	REVISED -
_	PLOT DATE = 2/5/2021	DATE - 2-4-2021	FILE - 191291SHT-SOQ.dgn

STATE OF ILLINOIS DEPARTMENT OF TRANSPORTATION

SCALE:

OULINADY OF QUANTITIES	F.A. RTE.	SECTION	COUNTY	TOTAL SHEETS	SHEET NO.
SUMMARY OF QUANTITIES	3869	20-00014-00-RS	MCHENRY	19	5
	1		CONTRACT	NO. 6	LH03
SHEET 2 OF 2 SHEETS STA. TO STA.			ID PROJECT UQLR	(335)	


BAXTER WOODMAN Consulting Engineers

EXISTING 2% & VARIES 2% & VARIES

EXISTING TYPICAL SECTION

HALIGUS ROAD STA 9+30 TO STA 92+57

*PAVEMENT WAS OVERLAID IN 2.5" HMA IN 2008, AFTER THE 2007 CORES WERE TAKEN

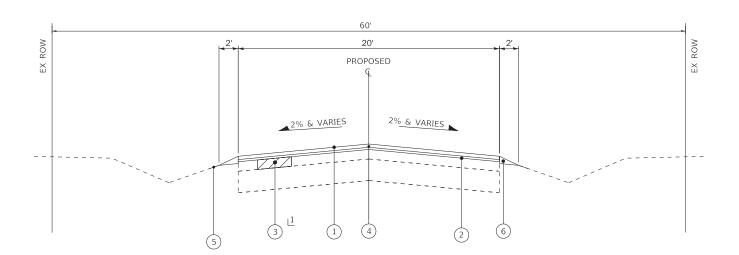

PROPOSED TYPICAL SECTION

HALIGUS ROAD STA 9+30 TO STA 92+57

1 AS DETERMINED BY ENGINEER

EXISTING LEGEND

- EXISTING HMA BINDER & SURFACE COURSE, 6" & VARIES
- \bigcirc B EXISTING AGGREGATE BASE COURSE, 10" & VARIES
- (C) GROUND SURFACE
- HOT-MIX ASPHALT SURFACE REMOVAL, 2 $\frac{1}{2}$ "
- \bigcirc E EXISTING AGGREGATE SHOULDER
- REMOVAL ITEM

PROPOSED LEGEND

- HOT-MIX ASPHALT SURFACE COURSE, IL-9.5, MIX "D", N50 1 $^{3}\!\!\!\!/$ "
- 2 POLYMERIZED HOT-MIX ASPHALT BINDER COURSE, IL - 4.75, N50 - 3/4"
- 3 CLASS D PATCHES
- 4 LONGITUDINAL JOINT SEALANT
- 5 SEEDING, CLASS 2A
- AGGREGATE WEDGE SHOULDER, TYPE B

HOT-MIX ASPHALT MIXTURE REQUIREMENTS

MIXTURE TYPE	AIR VOIDS @ Ndes						
PAVEMENT RESURFACING							
HOT-MIX ASPHALT SURFACE COURSE, IL-9.5, MIX "D", N50 1 3/4"	4% @ 50 Gyr.						
POLYMERIZED HOT-MIX ASPHALT BINDER COURSE, IL-4.75, N50; 3/4"	3.5% @ 50 Gyr.						
DRIVEWAYS							
INCIDENTAL HOT-MIX ASPHALT SURFACING (HMA SURFACE COURSE, IL-9.5, MIX D, N50; 2")	4% @ 50 Gyr.						
PATCHING							
CLASS D PATCHES (HMA BINDER IL-19.0mm)	4% @ 70 Gyr.						

- 1. THE UNIT WEIGHT USED TO CALCULATE ALL HMA SURFACE MIXTURE QUANTITIES IS 112 LBS/SQ YD/IN.
- 2. THE "AC TYPE" FOR POLYMERIZED HMA MIXES SHALL BE "SBS/SBR PG 76 -22" AND FOR NON-POLYMERIZED HMA THE "AC TYPE" SHALL BE "PG 64 -22" UNLESS MODIFIED BY SPECIAL PROVISIONS.
- 3. FOR USE OF RECYCLED MATERIALS SEE SPECIAL PROVISIONS.
- 4. THE LONGITUDINAL JOINT SEALANT SHALL BE PLACED OVER THE POLYMERIZED HMA BINDER


USER NAME = mornig	DESIGNED -	REVISED -
	DRAWN -	REVISED -
PLOT SCALE = 20,0000 ' / in.	CHECKED -	REVISED -
PLOT DATE = 2/5/2021	DATE - 2-4-2021	FILE - 191291SHT-TypSec.dgn

STATE OF ILLINOIS DEPARTMENT OF TRANSPORTATION

TVDICAL SECTIONS	F.A. RTE.	SECTION		SHEETS	SHEET NO.
THIORE SECTIONS	3869	20-00014-00-RS	MCHENRY	19	6
			CONTRACT	NO. 6	1H03
SHEET 1 OF 1 SHEETS STA. TO STA.		ILLINOIS FEE	D. AID PROJECT UQLR(335)	

CONLEY ROAD — HOT-MIX ASPHLAT SURFACE REMOVAL - BUTT JOINT HOT-MIX ASPHALT SURFACE — REMOVAL, 2" INCIDENTAL HOT-MIX ASPHALT SURFACING ¢ HALIGUS ROAD STA 21+26 CONLEY ROAD LINE 4" (WHITE EDGE LINE) (TYP) -LINE 4" (DOUBLE YELLOW, 11" C-C) (TYP) HALIGUS ROAD PRIVATE— ENTRANCE INTERSECTION WARNING STA 23+58 AGGREGATE WEDGE SHOULDER, TYPE B (TYP) D3-1 Haligus Rd HALIGUS RD 8" HEIGHT STA 21+31 Conley Rd D3-1 CONLEY RD 8" HEIGHT STA 21+31 W1-7 TWO-DIRECTION ARROW 48" X 24" STA 21+31 LINE 4" (DOUBLE YELLOW, 11" C-C) (TYP) - REMOVE SIGN PANEL ASSEMBLY - TYPE A STA 24+75 LINE 4" (WHITE EDGE LINE) (TYP) HALIGUS ROAD AGGREGATE WEDGE EX ROW SHOULDER, TYPE B (TYP) MATCH COUNTY TOTAL SHEETS NO.

MCHENRY 19 8 USER NAME = mornig DESIGNED REVISED SECTION BAXTER WOODMAN Consulting Engineers STATE OF ILLINOIS PLAN - HALIGUS ROAD DRAWN REVISED 20-00014-00-RS DEPARTMENT OF TRANSPORTATION LOT SCALE = 20.0000 ' / in. CHECKED REVISED CONTRACT NO. 61H03 DATE FILE - 191291SHT-Plan02.dgn SCALE: 1" = 20' SHEET 2 OF 8 SHEETS STA. 20+00 TO STA. 29+00

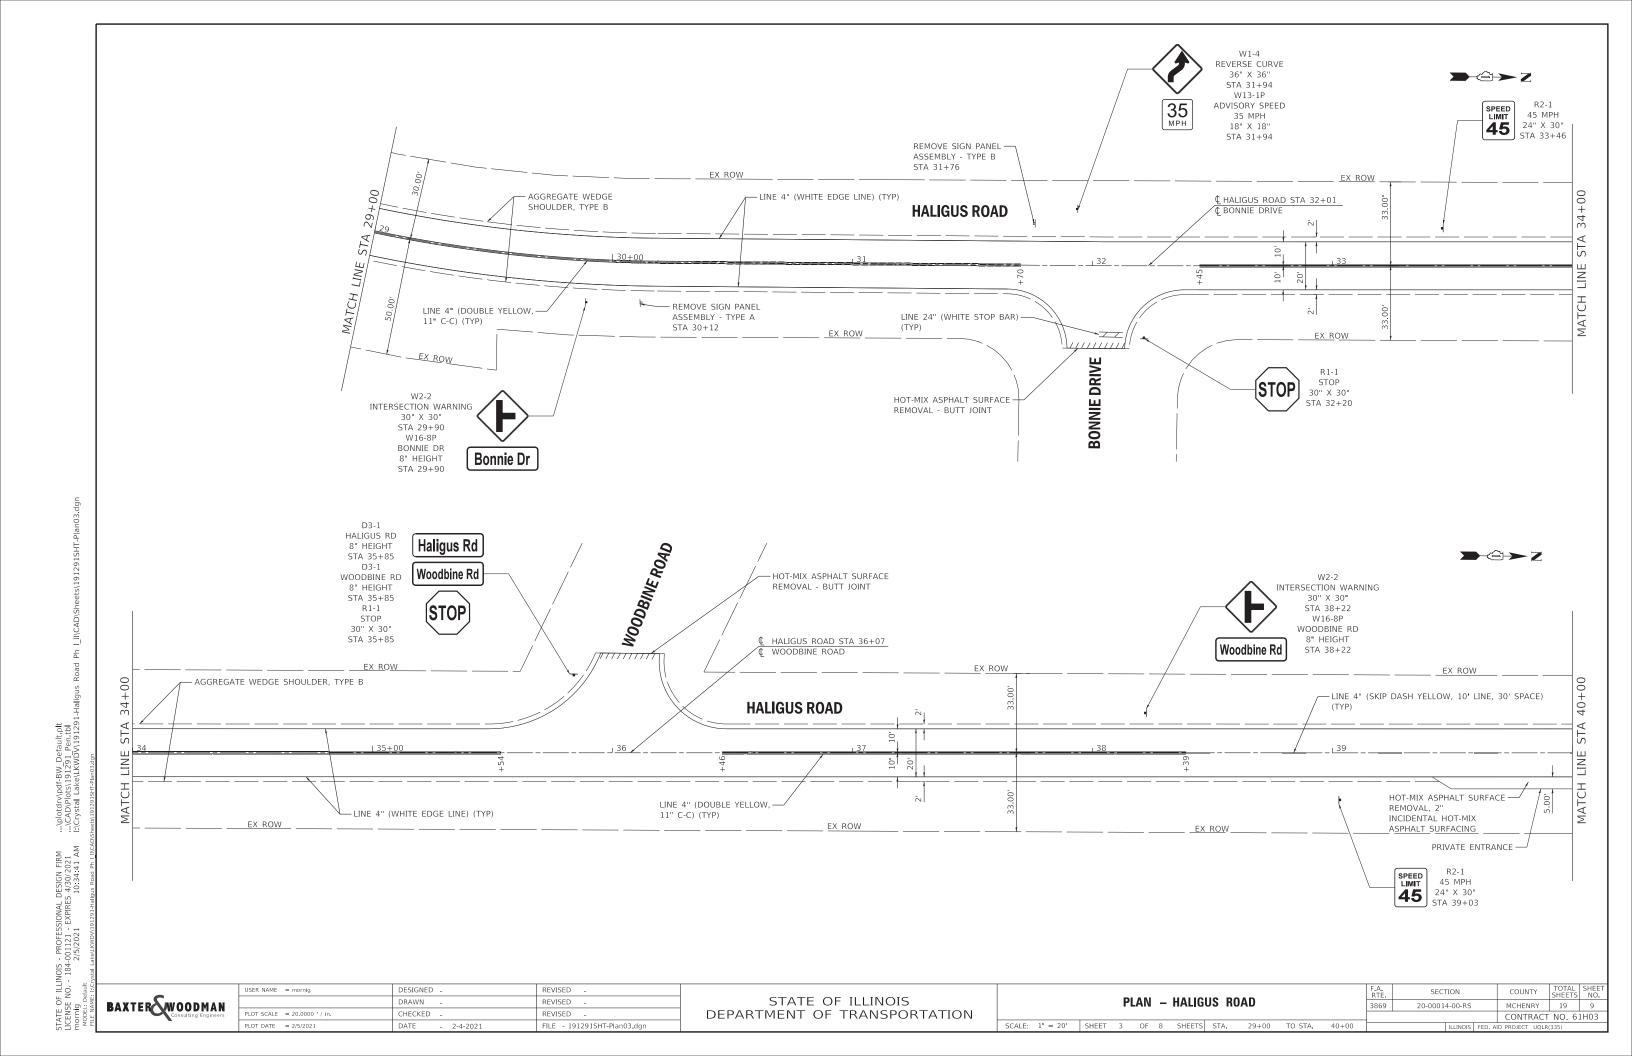

- AGGREGATE WEDGE SHOULDER, TYPE B (TYP) LINE 4" (SKIP DASH YELLOW, 10' LINE, 30' SPACE) **HALIGUS ROAD** <u>| 45+00</u> - LINE 4" (WHITE EDGE LINE) (TYP) EX ROW EX ROW EX ROW **→**Û→Z EX ROW EX ROW - LINE 4" (SKIP DASH YELLOW, 10' LINE, 30' SPACE) (TYP) AGGREGATE WEDGE SHOULDER, TYPE B (TYP) **HALIGUS ROAD** STA HOT-MIX ASPHALT SURFACE REMOVAL, 2"
INCIDENTAL HOT-MIX ASPHALT SURFACING - LINE 4" (WHITE EDGE LINE) (TYP) - PRIVATE ENTRANCE EX ROW USER NAME = mornig DESIGNED -REVISED SECTION COUNTY SHEETS NO.

MCHENRY 19 10 BAXTER WOODMAN Consulting Engineers STATE OF ILLINOIS PLAN - HALIGUS ROAD DRAWN REVISED 20-00014-00-RS DEPARTMENT OF TRANSPORTATION LOT SCALE = 20.0000 ' / in. CHECKED REVISED CONTRACT NO. 61H03 DATE FILE - 191291SHT-Plan04.dgn SCALE: 1" = 20' SHEET 4 OF 8 SHEETS STA. 41+00 TO STA. 53+00


WOODLAND HILLS DRIVE →©→Z \$\frac{1}{2}\$ HALIGUS ROAD STA 54+76
\$\frac{1}{2}\$ WOODLAND HILLS DRIVE HOT-MIX ASPHALT SURFACE - LINE 4" (WHITE EDGE LINE) (TYP) REMOVAL - BUTT JOINT - LINE 6" (WHITE LANE LINE) 20+00 EX ROW EX ROW - WHITE LETTERS & SYMBOLS — LINE 6" (WHITE SKIP DASH, - AGGREGATE WEDGE SHOULDER, TYPE B (TYP) 2' LINE, 6' SPACE) STA STA MATCH LINE - 4" LINE (YELLOW SKIP DASH, 10' LINE, 30' SPACE) (TYP) **HALIGUS ROAD** 4" LINE (DOUBLE YELLOW – 10' C-C) (TYP) EX ROW EX ROW **>**-Û→Z 65+00 EX ROW EX ROW 59+00 AGGREGATE WEDGE SHOULDER, TYPE B (TYP) **HALIGUS ROAD** LINE 4" (WHITE EDGE LINE) (TYP) STA MATCH LINE ↑ _{-0.1} 4" LINE (YELLOW SKIP DASH, 10' LINE, 30' SPACE) (TYP) HOT-MIX ASPHALT SURFACE REMOVAL, 2" INCIDENTAL HOT-MIX ASPHALT SURFACING EX ROW EX ROW WASTEWATER TREATMENT ENTRANCE COMMERCIAL ENTRANCE COUNTY TOTAL SHEET NO.

MCHENRY 19 11 USER NAME = mornig DESIGNED REVISED SECTION BAXTER WOODMAN Consulting Engineers STATE OF ILLINOIS PLAN - HALIGUS ROAD DRAWN REVISED 20-00014-00-RS DEPARTMENT OF TRANSPORTATION LOT SCALE = 20.0000 ' / in. CHECKED REVISED CONTRACT NO. 61H03 DATE SCALE: 1" = 20' SHEET 5 OF 8 SHEETS STA. 53+00 TO STA. 65+00 FILE - 191291SHT-Plan05.dgn

→©→Z EX ROW EX ROW - LINE 4" (WHITE EDGE LINE) (TYP) AGGREGATE WEDGE SHOULDER, TYPE B (TYP) **HALIGUS ROAD** MATCH - COMMERCIAL ENTRANCE 4" LINE (YELLOW SKIP DASH 10' LINE, 30' SPACE) (TYP) EX ROW EX ROW HOT-MIX ASPHALT SURFACE REMOVAL, 2" - HOT-MIX ASPHALT SURFACE GRAVEL DRIVEWAY REMOVAL, 2" INCIDENTAL HOT-MIX INCIDENTAL HOT-MIX ASPHALT SURFACING ASPHALT SURFACING COMMERCIAL ENTRANCE -**WOODLAND HILLS DRIVE →**©→Z R2-1 45 MPH 24" X 30" STA 76+97 HALIGUS ROAD STA 73+74 HOT-MIX ASPHALT SURFACE — REMOVAL - BUTT JOINTS WOODLAND HILLS DRIVE EX ROW 77+00 AGGREGATE WEDGE SHOULDER, TYPE B (TYP - 4" LINE (DOUBLE **HALIGUS ROAD** YELLOW 11" CTC) STA LINE MATCH — REMOVE SIGN PANEL ASSEMBLY - TYPE A STA 72+43 4" LINE (YELLOW SKIP DASH - LINE 4" (WHITE EDGE LINE) (TYP) 10' LINE, 30' SPACE) (TYP) EX ROW EX ROW _E<u>X_ROW</u> W3-1 STOP AHEAD 30" X 30" STA 76+86 W16-8P BALLARD RD Ballard Rd 8" HEIGHT STA 76+86 COUNTY TOTAL SHEETS NO.

MCHENRY 19 12 USER NAME = mornig DESIGNED REVISED SECTION BAXTER WOODMAN Consulting Engineers STATE OF ILLINOIS PLAN - HALIGUS ROAD DRAWN REVISED 20-00014-00-RS DEPARTMENT OF TRANSPORTATION LOT SCALE = 20.0000 ' / in. CHECKED REVISED CONTRACT NO. 61H03 PLOT DATE = 2/5/2021 DATE SCALE: 1" = 20' SHEET 6 OF 8 SHEETS STA. 65+00 TO STA. 77+00 FILE - 191291SHT-Plan06.dgn

REMOVE SIGN PANEL ASSEMBLY - TYPE A **BALLARD ROAD** D3-1 BALLARD RD STA 79+46 R1-1 STOP 30" X 30" STA 79+36 R1-3P **→**©→Z Ballard Rd 8" HEIGHT 79+98 D3-1 STOP Haligus Rd HALIGUS RD 8" HEIGHT STOP AHEAD ALL WAY 18" X 6" 79+98 30" X 30" STOP R1-1 (ALL WAY) STA 81+93 STOP STA 79+36 W16-8P STA 79+16 30" X 30" BALLARD RD R1-3P Ballard Rd STA 80+14 L HALIGUS ROAD STA 79+62 8" HEIGHT ALL WAY R1-3P BALLARD ROAD STA 81+93 ALL WAY 18" X 6" ALL WAY (ALL WAY) STA 79+16 18" X 6" EX ROW STA 80+14 EX ROW 83+00 - AGGREGATE WEDGE SHOULDER, TYPE B (TYP) 4" LINE (WHITE EDGE LINE) (TYP) **HALIGUS ROAD** STA PRIVATE ENTRANCE PRIVATE ENTRANCE MATCH - HOT-MIX ASPHALT SURFACE REMOVAL, 2" REMOVE AND REINSTAL BRICK PAVER INCIDENTAL HOT-MIX ASPHALT SURFACING EX ROW EX ROW EX ROW 4" LINE (DOUBLE YELLOW, 11" C-C) (TYP) R1-1 - REMOVE SIGN PANEL STOP ASSEMBLY - TYPE A 30" X 30" STA 80+14 STA 79+16 R1-3P ALL WAY ALL WAY 18" X 6" HALIGUS ROAD STA 79+61 STOP STA 79+16 BALLARD ROAD STOP 30" X 30" STA 80+14 R1-3P ALL WAY ALL WAY 18" X 6" LINE 24" (WHITE STOP BAR) (TYP) STA 80+14 R1-1 STOP STA 79+79 R1-3P ALL WAY ALL WAY 18" X 6" **→**Û→Z STA 79+79 89+00 EX ROW EX ROW EX ROW - REMOVE SIGN PANEL - AGGREGATE WEDGE SHOULDER, TYPE B (TYP) - 4" LINE (WHITE EDGELINE) (TYP) **HALIGUS ROAD** ASSEMBLY - TYPE A STA STA 83+50 LINE PRIVATE ENTRANCE - HOT-MIX ASPHALT SURFACE - HOT-MIX ASPHALT SURFACE - HOT-MIX ASPHALT SURFACE REMOVAL, 2" REMOVAL, 2" REMOVAL, 2" 4" LINE (DOUBLE YELLOW, INCIDENTAL HOT-MIX INCIDENTAL HOT-MIX INCIDENTAL HOT-MIX 11" C-C) (TYP) ASPHALT SURFACING ASPHALT SURFACING ASPHALT SURFACING PRIVATE ENTRANCE \PRIVATE ENTRANCE USER NAME = mornig DESIGNED REVISED SECTION COUNTY STATE OF ILLINOIS PLAN - HALIGUS ROAD BAXTER WOODMAN DRAWN REVISED 20-00014-00-RS MCHENRY 19 13 LOT SCALE = 20.0000 ' / in. CHECKED REVISED DEPARTMENT OF TRANSPORTATION CONTRACT NO. 61H03 SCALE: 1" = 20' SHEET 7 OF 8 SHEETS STA. 77+00 TO STA. 89+00 PLOT DATE = 2/5/2021 DATE FILE - 191291SHT-Plan07.dgn

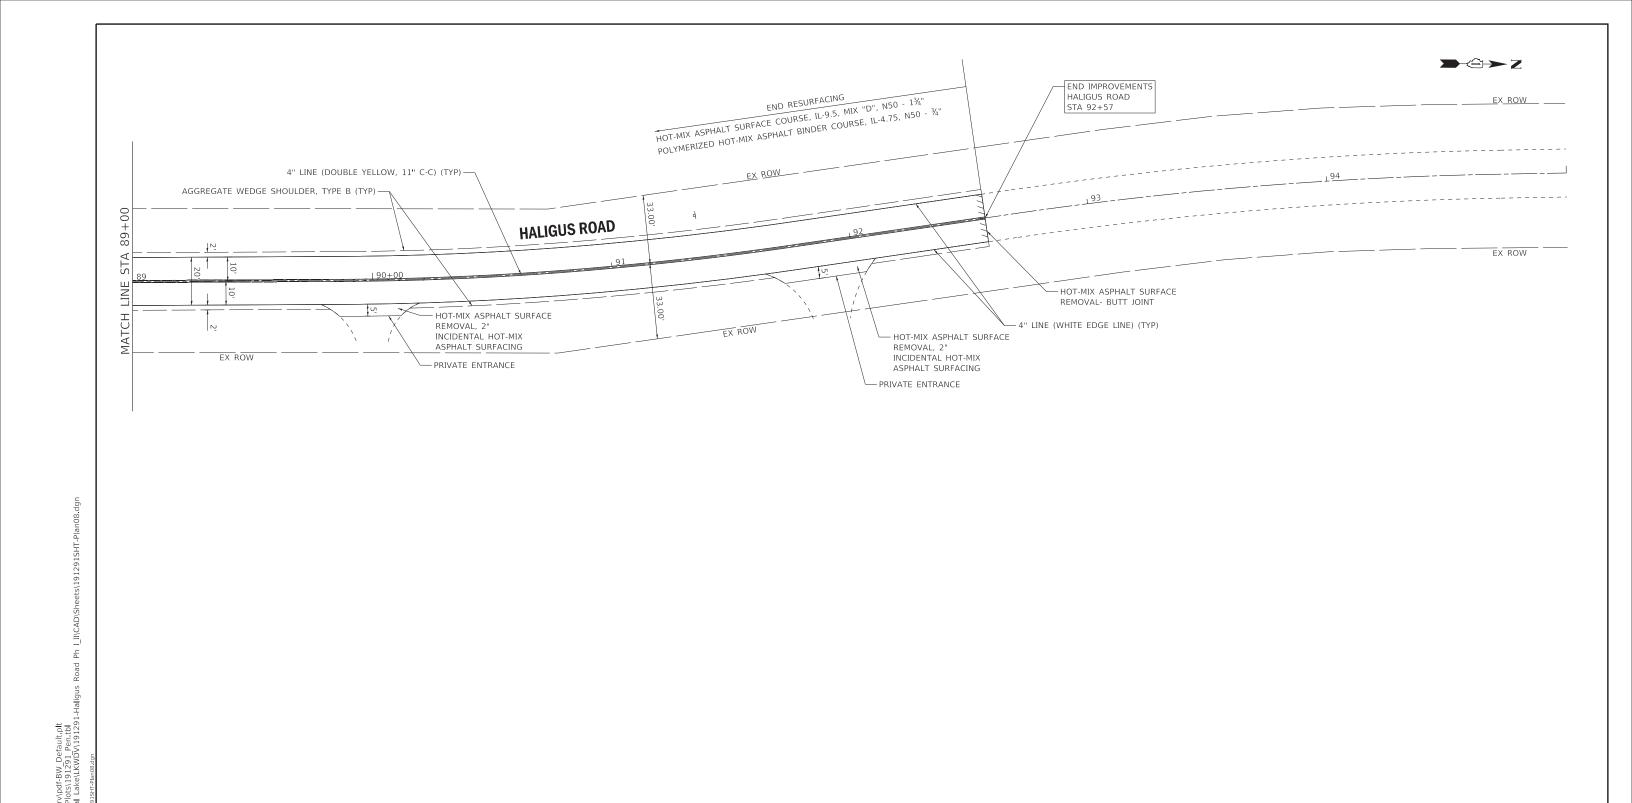



BAXTER WOODMAN Consulting Engineers

USER NAME = mornig	DESIGNED -	REVISED -	
	DRAWN -	REVISED -	
PLOT SCALE = 20,0000 ' / in.	CHECKED -	REVISED -	
PLOT DATE = 2/5/2021	DATE - 2-4-2021	FILE - 191291SHT-Plan08.dgn	
		,	-

STATE OF ILLINOIS DEPARTMENT OF TRANSPORTATION

										F.A. RTE.	SEC	TION		COUNTY	TOTAL SHEETS	SHEET NO.
ì	PLAN - HALIGUS ROAD								3869	20-0001	4-00-RS		MCHENRY	19	14	
														CONTRACT	NO. 6	1H03
SCALE: 1" = 20'	SHEET	8	OF	8	SHEETS	STA.	89+00	TO STA.	95+00			ILLINOIS	FED. A	ID PROJECT UQLR	(335)	

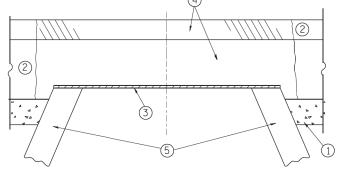

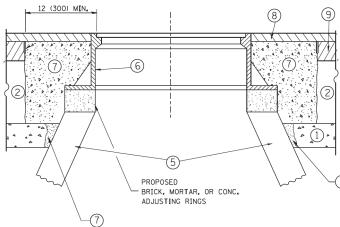

EXISTING BROKEN FRAMES AND LIDS SHALL BE REMOVED AND DISPOSED OF BY THE CONTRACTOR AND SHALL BE REPLACED AS DIRECTED BY THE ENGINEER. REPLACEMENT FRAMES AND LIDS WILL BE PAID FOR IN ACCORDANCE WITH ARTICLE 109,04 OF THE STANDARD SPECIFICATIONS UNLESS A SEPARATE PAY ITEM HAS BEEN PROVIDED.

IF THE EXISTING LIDS ARE OPEN, THE FRAME WILL BE ADJUSTED TO THE ELEVATION OF THE MILLED PAVEMENT SURFACE PRIOR TO THE MILLING OPERATION. THE FRAME WILL NOT BE REMOVED AND COVERED BY THE METAL PLATE.

CITY OF CHICAGO CASTINGS ARE THE PROPERTY OF THE CITY AND THE CONTRACTOR SHALL NOTIFY THE CITY FOR REMOVAL AND DISFOSITION OF THE CASTINGS.

THE METAL PLATE USED TO COVER THE STRUCTURE SHALL REMAIN THE PROPERTY OF THE CONTRACTOR.

WHEN STRUCTURES ARE TO BE ADJUSTED OR RECONSTRUCTED, THE LOWERING AND RAISING OF THE FRAMES AND LIDS WILL NOT BE PAID FOR SEPARATELY BUT WILL BE INCLUDED IN THE COST OF THE CORRESPONDING PAY ITEM.

SCALE: NONE

CONSTRUCTION PROCEDURES

STAGE 1 (BEFORE PAVEMENT MILLING)

- A) REMOVE A MINIMUM OF 12 (300) OF THE PAVEMENT FROM AROUND THE STRUCTURE.
- B) REMOVE THE EXISTING FRAME AND LID FROM THE STRUCTURE.
- C) COVER THE STRUCTURE OPENING WITH A 36 (900) DIAMETER
- D) BACKFILL WITH CRUSHED STONE AND A MINIMUM 11/2 (40) THICK HMA SURFACE MIX APPROVED BY THE ENGINEER.

STAGE 2 (AFTER PAVEMENT MILLING)

- A) REMOVE THE HMA SURFACE MIX AND CRUSHED STONE.
- B) INSTALL THE FRAME AND LID; ADJUST THE FRAME TO ITS FINAL SURFACE ELEVATION.
- C) THE SURROUNDING SPACE SHALL BE FILLED WITH CLASS PP-1*
 CONCRETE TO THE ELEVATION OF THE SURFACE OF THE EXISTING
 BASE COURSE OR THE BINDER COURSE.
- * UNLESS OTHERWISE SPECIFIED IN THE PLANS.

THE PROCEDURE EXPLAINED ABOVE SHALL CONFORM TO THE APPLICABLE PORTIONS OF SECTIONS 353, 406, 602. AND 603 OF THE STANDARD SPECIFICATIONS EXCEPT THAT "THE CONTRACTOR SHALL ADJUST THE STRUCTURES TO THE FINISHED PAVEMENT ELEVATION NO MORE THAN 5 CALENDAR DAYS PRIOR TO PLACEMENT OF THE FINAL LIFT OF SURFACE UNLESS APPROVED BY THE

LEGEND

- 1 SUB-BASE GRANULAR MATERIAL
- (6) FRAME AND LID (SEE NOTES)
- 2 EXISTING PAVEMENT
- (7) CLASS PP-1* CONCRETE
- 3 36 (900) DIAMETER METAL PLATE
- 8 PROPOSED HMA SURFACE COURSE
- PROPOSED CRUSHED STONE AND HMA SURFACE MIX

(5) EXISTING STRUCTURE

9 PROPOSED HMA BINDER COURSE

THE CONTRACTOR WILL BE REQUIRED TO KEEP A RECORD OF THE LOCATIONS OF THE BURIED STRUCTURES ACCORDING TO THE STATION AND DISTANCE LEFT OR RIGHT OF THE CENTERLINE OF PAVEMENT. UPON COMPLETION OF THE WORK, THE CONTRACTOR WILL DELIVER THE RECORD TO THE ENGINEER.

BASIS OF PAYMENT:

REMOVING FRAMES AND LIDS ON DRAINAGE AND UTILITY STRUCTURES IN THE PAVEMENT PRIOR TO MILLING, AND ADJUSTING TO FINAL GRADE PRIOR TO PLACING THE SURFACE COURSE, WILL BE PAID FOR AT THE CONTRACT UNIT PRICE EACH FOR "FRAMES AND LIDS TO BE ADJUSTED

THIS WORK WILL NOT BE PAID FOR WHEN DRAINAGE AND UTILITY STRUCTURES ARE SPECIFIED FOR PAYMENT AS STRUCTURE RECONSTRUCTION.

NEW FRAMES AND LIDS, WHEN SPECIFIED, WILL BE PAID FOR SEPARATELY.

DETAILS FOR FRAMES AND LIDS ADJUSTMENT WITH MILLING

ALL DIMENSIONS ARE IN INCHES (MILLIMETERS) UNLESS OTHERWISE SHOWN

19


DESIGNED - R. SHAH USER NAME = bauerdl FILE NAME = REVISED - R. WIEDEMAN 05-14-04 DRAWN REVISED - R. BORO 01-01-07 REVISED - R. BORO 03-09-11 CHECKED PLOT SCALE = 1968-5000 '/ m REVISED - R. BORO 12-06-11 PLOT DATE = 12/6/2011 DATE 10-25-94

2017 INOIS 184-

STATE OF ILLINOIS **DEPARTMENT OF TRANSPORTATION**

COUNTY **DETAILS FOR** 20-00014-00-RS MCHENRY FRAMES AND LIDS ADJUSTMENT WITH MILLING BD600-03 (BD-8) CONTRACT NO. 61H03 SHEET NO. 1 OF 1 SHEETS STA. AID PROJECT UQLR(335)


OPTION 1

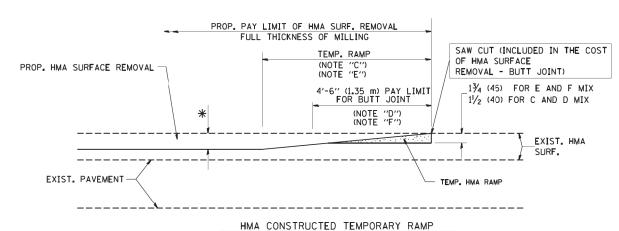

(FOR BUTT JOINT AND HMA TAPER SEE DETAIL BELOW)

OPTION 2


TYPICAL TEMPORARY RAMP

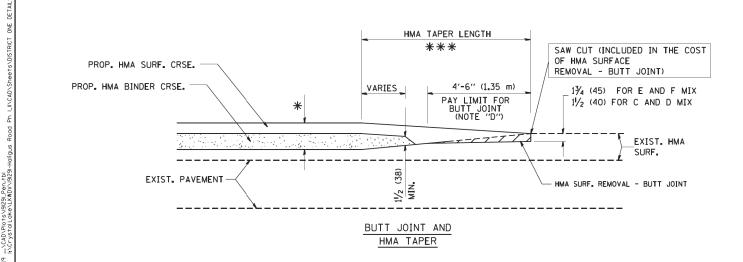


TYPICAL BUTT JOINT AND HMA TAPER FOR MILLING AND RESURFACING

DESIGNED -USER NAME = gaglianobt M. DE YONG REVISED R. SHAH 10-25-94 diststd\22x34\bd32.dgn DRAWN REVISED A. ABBAS 03-21-97 CHECKED REVISED PLOT SCALE = 50.0000 '/ IN. M. GOMEZ 04-06-01 DATE 06-13-90 REVISED R. BORO 01-01-07

STATE OF ILLINOIS
DEPARTMENT OF TRANSPORTATION

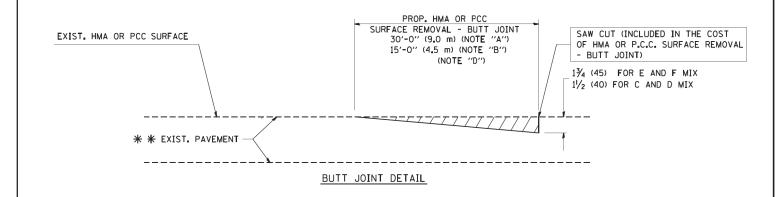

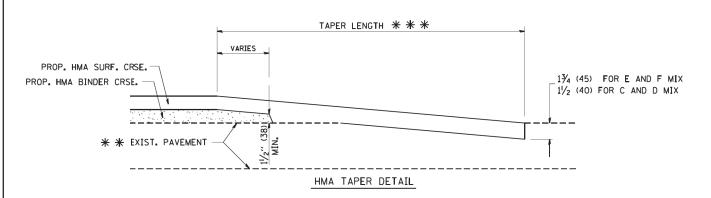

TYPICAL BUTT JOINT AND HMA TAPER FOR RESURFACING ONLY

* * PC CONCRETE, HMA OR HMA RESURFACED PAVEMENT.

NOTES

A: MAINLINE ROADWAYS AND MAJOR SIDE ROADS.

B: MINOR SIDE ROADS.

C: THE TEMP. RAMP SHALL BE CONSTRUCTED IMMEDIATELY UPON REMOVAL OF THE EXISTING HMA SURFACE.

D: THE BUTT JOINT SHALL BE CONSTRUCTED IMMEDIATELY PRIOR TO PLACING THE PROPOSED HMA COURSES.

E: TAPER THE TEMP. RAMP AT A RATE OF 3'-O" (900 mm) PER 1 INCH (25 mm) OF MILLING THICKNESS.

F: INSTALLATION AND REMOVAL OF THE 4'-6" (1.35 m) TEMP. RAMP IS INCLUDED IN COST OF HMA SURFACE REMOVAL - BUTT JOINT

G: SEE ARTICLE 406.08 AND 406.14 OF THE STANDARD SPECIFICATIONS FOR "HMA AND/OR PCC SURFACE REMOVAL, BUTT JOINT".

* SEE TYPICAL SECTIONS FOR MILLING THICKNESS.


** * 20'-0" (6.1 m) PER 1 (25) RESURFACING (NOTE "A") 10'-0" (3.0 m) PER 1 (25) RESURFACING (NOTE "B")

BASIS OF PAYMENT:

THE BUTT JOINT WILL 3E PAID FOR AT THE CONTRACT UNIT PRICE PER SQUARE YARD (SQUARE METER)
FOR "HOT-MIX ASPHALT SURFACE REMOVAL - BUTT JOINT" OR FOR "PORTLAND CEMENT CONCRETE SURFACE REMOVAL- BUTT JOINT".

SCALE: NONE

ALL DIMENSIONS ARE IN INCHES (MILLIMETERS) UNLESS OTHERWISE SHOWN.

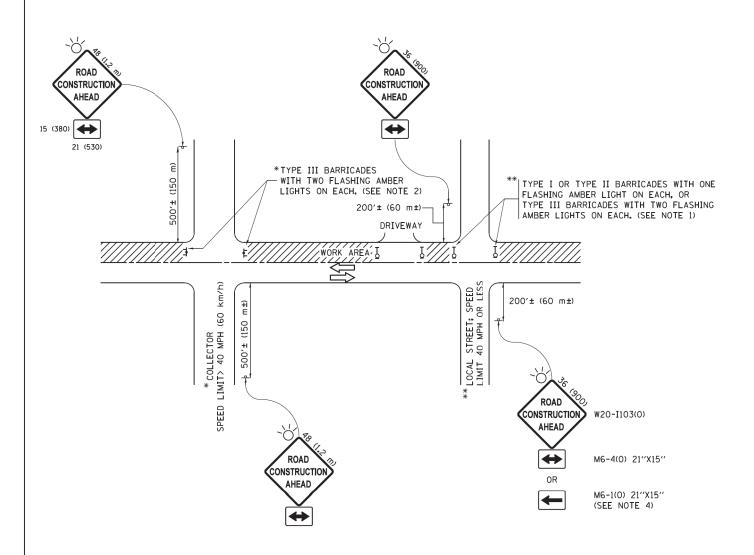

NOTES:

- 1. SIDE ROAD WITH A SPEED LIMIT OF 40 MPH (60 km/h) OR LESS AS SHOWN ON THE DRAWING AND AS DIRECTED BY THE ENGINEER:
 - a) ONE "ROAD CONSTRUCTION AHEAD" SIGN 36 x 36 (900x900) WITH A FLASHER MOUNTED ON IT APPROXIMATELY 200" (60 m) IN ADVANCE OF THE MAIN ROUTE.
 - b) THE CLOSED PORTION OF THE MAIN ROUTE SHALL BE PROTECTED BY BLOCKING WITH TYPE I, TYPE II OR TYPE III BARRICADES, 1/3 OF THE CROSS SECTION OF THE CLOSED PORTION.
- 2. SIDE ROAD WITH A SPEED LIMIT GREATER THAN 40 MPH (60 km/h) AS SHOWN ON THE DRAWING AND AS DIRECTED BY THE ENGINEER:
 - 0) ONE "ROAD CONSTRUCTION AHEAD" SIGN 48 \times 48 (1.2 m \times 1.2 m) WITH A FLASHER MOUNTED ON IT APPROXIMATELY 500" (150 m) IN ADVANCE OF THE MAIN ROUTE.
 - b) THE CLOSED PORTION OF THE MAIN ROUTE SHALL BE PROTECTED BY BLOCKING WITH TYPE III BARRICADES, 1/2 OF THE CROSS SECTION OF THE CLOSED FORTION.
- 3. CONES MAY BE SUBSTITUTED FOR BARRICADES OR DRUMS AT HALF THE SPACING DURING DAY OPERATIONS. CONES SHALL BE A MINIMUM OF 28 (710)
- 4. WHEN THE SIDE ROAD LIES BETWEEN THE BEGINNING OF THE MAINLINE SIGNING AND THE WORK ZONE, A SINGLE HEADED ARROW (M6-1) SHALL BE USED IN LIEU OF THE DOUBLE HEADED ARROW (M6-4).

SCALE: NONE


- 5. WHEN WORK IS BEING PERFORMED ON A SIDE ROAD OR DRIVEWAY, FOLLOW THE APPLICABLE STANDARD(S). THE DIRECTIONAL ARROW (M6-1 OR M6-4) SHALL BE COVERED OR REMOVED WHEN NO LONGER CONSISTENT WITH THE TRAFFIC CONTROL SET-UP.
- 6. ADVANCE WARNING SIGNS ARE TO BE OMITTED ON DRIVEWAYS UNLESS OTHERWISE SPECIFIED IN THE PLANS OR BY THE ENGINEER
- 7. THE TRAFFIC CONTROL AND PROTECTION FOR SIDE ROADS, INTERSECTIONS, AND DRIVEWAYS SHALL BE INCLUDED IN THE COST OF SPECIFIED TRAFFIC CONTROL STANDARDS OR ITEMS.


All dimensions are in inches (millimeters) unless otherwise shown.

FILE NAME = Octomj DESIGNED - L.H.A. REVISED - A. HOUSEH 10-15-96

pwi\\left[R84EBIDINTEG:111nois.goviPWIDOT\Documents\lDOT Offices\District\1\Projects\District\1\Pro

STATE OF ILLINOIS
DEPARTMENT OF TRANSPORTATION

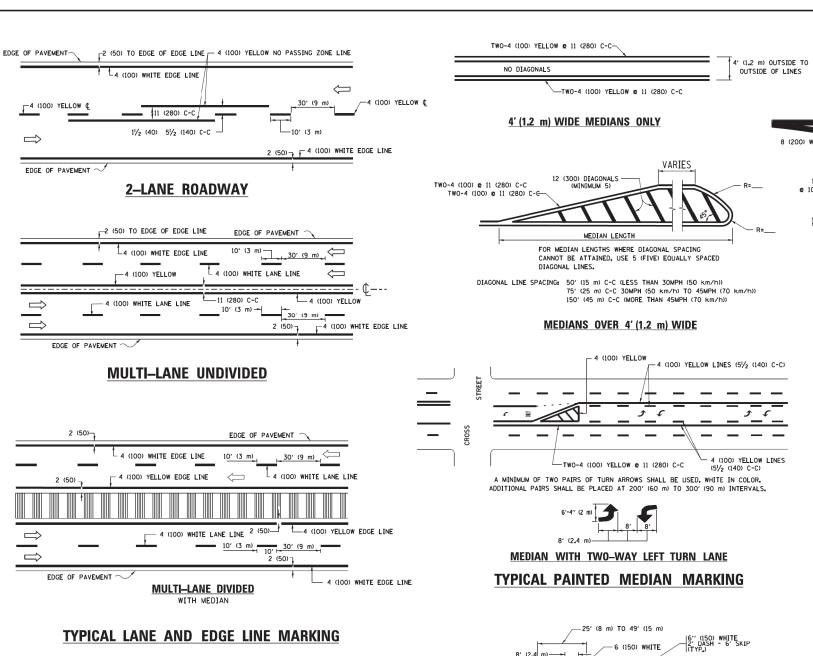

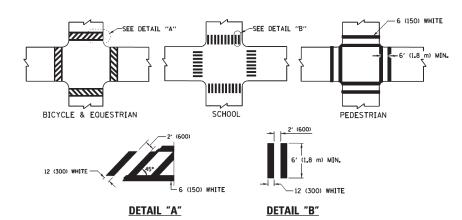

TYPICAL CROSSWALK MARKING

 $oldsymbol{st}$ markings shall be installed parallel to the centerline of the road which it crosses

−50′ (15 m) TO 200′ (60 m) | 10' (3 m) 6 (150) WHITE OVER 200' (60 m)


AREA = 15.6 SO. FT. (1.5 m²) (1.5 m² AREA = 20.8 SO. FT. (1.9 m²)

 \divideontimes Turn lanes in excess of 400' (120 m) in length may have an additional set of arrow - "only" installed midway between the other two sets of

___ 6 (150) WHITE


TYPICAL LEFT (OR RIGHT) TURN LANE


TYPICAL TURN LANE MARKING

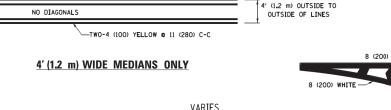






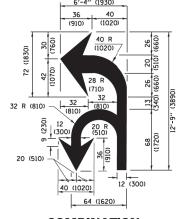

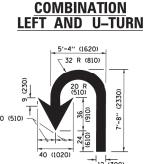

U-TURN

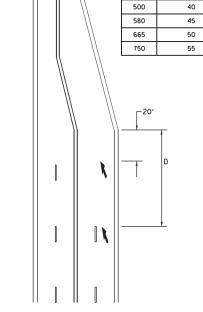

SPEED LIMIT

30

35

425

LANE REDUCTION TRANSITION

* LANE REDUCTION ARROWS REQUIRED AT SPEEDS OF 45 MPH OR GREATER OR WHEN SPECIFIED IN PLANS.

TYPE OF MARKING	WIDTH OF LINE	PATTERN	COLOR	SPACING /REMARKS
CENTERLINE ON 2 LANE PAVEMENT	4 (100)	SKIP-DASH	YELLOW	10' (3 m) LINE WITH 30' (9 m) SPACE
CENTERLINE ON MULTI-LANE UNDIVIDED PAVEMENT	2 @ 4 (100)	SOLID	YELLOW	11 (280) C-C
NO PASSING ZONE LINES: FOR ONE DIRECTION FOR BOTH DIRECTIONS	4 (100) 2 @ 4 (100)	SOLID SOLID	YELLOW YELLOW	5/2 (140) C-C FROM SKIP-DASH CENTERLINE 11 (280) C-C OMIT SKIP-DASH CENTERLINE BETWEEN
LANE LINES	4 (100) 5 (125) ON FREEWAYS	SKIP-DASH SKIP-DASH	WHITE WHITE	10' (3 m) LINE WITH 30' (9 m) SPACE
DOTTED LINES (EXTENSIONS OF CENTER, LANE OR TURN LANE MARKINGS)	SAME AS LINE BEING EXTENDED	SKIP-DASH	SAME AS LINE BEING EXTENDED	2' (600) LINE WITH 6' (1.8 m) SPACE
EDGE LINES	4 (100)	SOLID	YELLOW-LEFT WHITE-RIGHT	OUTLINE MEDIANS IN YELLOW
TURN LANE MARKINGS	6 (150) LINE; FULL SIZE LETTERS & SYMBOLS (8' (2.4m))	SOLID	WHITE	SEE TYPICAL TURN LANE MARKING DETAIL
TWO WAY LEFT TURN MARKING	2 @ 4 (100) EACH DIRECTION 8' (2.4m) LEFT ARROW	SKIP-DASH AND SOLID IN PAIRS	WHITE	10' (3 m) LINE WITH 30' (9 m) SPACE FOR SKIP-DASH; 5½ (140) C-C BETWEEN SOLID LINE AND SKIP-DASH LINE SEE TYPICAL TWO-WAY LEFT TURN MARKING DETAIL
CROSSWALK LINES (PEDESTRIAN) A. DIAGONALS (BIKE & EQUESTRIAN) B. LONGITUDINAL BARS (SCHOOL)	2 e 6 (150) 12 (300) e 45° 12 (300) e 90°	SOLID SOLID SOLID	WHITE WHITE WHITE	NOT LESS THAN 6' (1.8 m) APART 2' (600) APART 2' (600) APART SEE TYPICAL CROSSWALK MARKING DETAILS.
STOP LINES	24 (600)	SOLID	WHITE	PLACE 4' (1.2 m) IN ADVANCE OF AND PARALLEL TO CROSSWALK, IF PRESENT. OTHERWISE, PLACE AT DESIRED STOPPING POINT. PARALLEL TO CROSSROAD CENTERLINE, WHERE POSSIBLE
PAINTED MEDIANS	2 @ 4 (100) WITH 12 (300) DIAGONALS @ 45° NO DIAGONALS USED FOR 4' (1.2 m) WIDE MEDIANS	SOLID	YELLOW: TWO WAY TRAFFIC WHITE: ONE WAY TRAFFIC	11 (280) C-C FOR THE DOUBLE LINE SEE TYPICAL PAINTED MEDIAN MARKING.
GORE MARKING AND CHANNELIZING LINES	8 (200) WITH 12 (300) DIAGONALS @ 45°	SOLID	WHITE	DIACONALS: 15' (4,5 m) C-C (LESS THAN 30MPH (50 km/h)) 20' (6 m) C-C 30MPH (50 km/h) TO 45MPH (70 km/h)) 30' (9 m) C-C (OVER 45MPH (70 km/h))
RAILROAD CROSSING	24 (600) TRANSVERSE LINES; "RR" IS 6' (1.8 m) LETTERS; 16 (400) LINE FOR "X"	SOLID	WHITE	SEE STATE STANDARD 780001 AREA OF1 "R"23.6 SO. FT. (0,33 m²) EACH "X"=54.0 SO. FT. (5.0 m²)
SHOULDER DIAGONALS (REQUIRED FOR SHOULDERS > 8')	12 (300) @ 45°	SOLID	WHITE - RIGHT YELLOW - LEFT	50' (15 m) C-C (LESS THAN 30MPH (50 km/h)) 75' (25 m) C-C (30 MPH (50 km/h) TO 45MPH (70 km/h 150' (45 m) C-C (0VER 45MPH (70 km/h))
U TURN ARROW	SEE DETAIL	SOLID	WHITE	16.3 SF
2 ARROW COMBINATION LEFT AND U TURN	SEE DETAIL	SOLID	WHITE	30.4 SF

FOR FURTHER DETAILS ON PAVEMENT MARKING REFER TO STANDARD SPECIFICATIONS FOR ROAD AND BRIDGE CONSTRUCTION AND STATE STANDARD 780001.

SCALE: NONE

unless otherwise shown.

DESIGNED - EVERS FILE NAME = USER NAME = leusa REVISED - C. JUCIUS 09-09-09 \diststd\22x34\tc13.dgn DRAWN REVISED - C. JUCIUS 07-01-13 CHECKED REVISED -C. JUCIUS 12-21-15 PLOT SCALE = 50.000 ' / 10. PLOT DATE = 6/23/2017 DATE 03-19-90 REVISED -C. JUCIUS 04-12-16

STATE OF ILLINOIS **DEPARTMENT OF TRANSPORTATION**

SECTION COUNTY **DISTRICT ONE** 20-00014-00-RS MCHENRY TYPICAL PAVEMENT MARKINGS TC-13 CONTRACT NO. 61H03 OF 1 SHEETS STA. TO STA. SHEET 1

NOTES:

- 1. USE BLACK LETTERING ON ORANGE BACKGROUND.
- 2. ERECT SIGNS IN ADVANCE OF THE LOCATION FOR THE "ROAD CONSTRUCTION AHEAD" SIGN AT LOCATIONS AS DIRECTED BY THE ENGINEER.
- 3. ERECT SIGN (1) WITH INSTALLED PANEL (2) ONE WEEK PRIOR TO THE START OF CONSTRUCTION.
- 4. REMOVE PANEL (2) SOON AFTER THE START OF CONSTRUCTION.
- 5. SEE SPECIAL PROVISION FOR "TEMPORARY INFORMATION SIGNING" FOR ADDITIONAL INFORMATION.
- 6. ONE SIGN ASSEMBLY EQUALS 25.70 SQ. FT. (2.3 SQ. M.)
- 7. SHALL BE PAID FOR AS TEMPORARY INFORMATION SIGNING.

ALL DIMENSIONS ARE IN INCHES (MILLIMETERS) UNLESS OTHERWISE SHOWN.

	FILE NAME =	USER NAME = gaglianobt	DESIGNED -	REVISED	-	R. MIRS 09-15-97
	W:\diststd\22x34\tc22.dgn		DRAWN -	REVISED	-	R. MIRS 12-11-97
ρį		PLOT SCALE = 50.000 '/ [N.	CHECKED -	REVISED	- T.	RAMMACHER 02-02-99
ρĒ		PLOT DATE = 1/4/2008	DATE -	REVISED	-	C. JUCIUS 01-31-07

STATI	E OF	ILLINOIS
DEPARTMENT	OF	TRANSPORTATION

ARTERIAL ROAD					F.A RTE.	SECTION	COUNTY	TOTAL SHEETS	SHEET NO.		
INFORMATION SIGN						3869	20-00014-00-RS	MCHENRY	19	19	
INFORMATION SIGN							TC-22	CONTRACT NO. 61H03			
ALE: NONE	SHEET NO. 1	OF 1	SHEETS	STA.	TO STA.	FED. ROAD DIST. NO. 1 ILLINOIS FED. AID PROJECT UQLR(335)					