FOR INDEX OF SHEETS, SEE SHEET NO. 2

TRAFFIC DATA

2013 ADT = 32,300

LINCOLN HIGHWAY (US ROUTE 30)

POSTED SPEED LIMIT = 40 MPH

FUNCTIONAL CLASSIFICATION = OTHER PRINCIPAL ARTERIAL

04-23-2021 LETTING ITEM 008

STATE OF ILLINOIS

DEPARTMENT OF TRANSPORTATION

COOK 32 1 19-00105-00-SW XC1F(104)

FOR INDEX OF HIGHWAY STANDARDS, SEE SHEET NO. 2

PLANS FOR PROPOSED FEDERAL AID HIGHWAY

FAP 353 (US ROUTE 30) (LINCOLN HWY) ORCHARD DRIVE TO EAST VILLAGE LIMITS SIDEWALK AND LANDSCAPING **SECTION: 19-00105-00-SW**

PROJECT: XC1F(104)

VILLAGE OF PARK FOREST COOK COUNTY

C-91-254-20

ROCKWELL STREET IMPROVEMENT END STA, 201 + 50

ROCKWELL STREET IMPROVEMENT BEGIN STA. 200 + 00

LOCATION OF SECTION INDICATED THUS: - -

US ROUTE 30 IMPROVEMENTS BEGIN STA, 118 + 32 RT



US ROUTE 30 IMPROVEMENT ENDS STA. 141 + 72 RT

FULL SIZE PLANS HAVE BEEN PREPARED USING STANDARD ENGINEERING SCALES, REDUCED SIZED PLANS WILL NOT CONFORM TO STANDARD SCALES, IN MAKING MEASUREMENTS ON REDUCED PLANS, THE ABOVE SCALES MAY BE USED.


J.U.L.I.E. DESIGN STAGE REQUEST DIG. No. X2970625



CONTACT JULIE AT 811 OR 800-892-0123 WITH THE FOLLOWING:

COUNTY = COOK CITY-TWNSHP. = VILLAGE OF PARK FOREST, ILLINGIS SEC. & 1/4 SEC. NO. = S 1/2 SEC 24, T35N, R13E 48 HOURS 12 working days) BEFORE YOU DIG


CONTRACT NO. 61G99

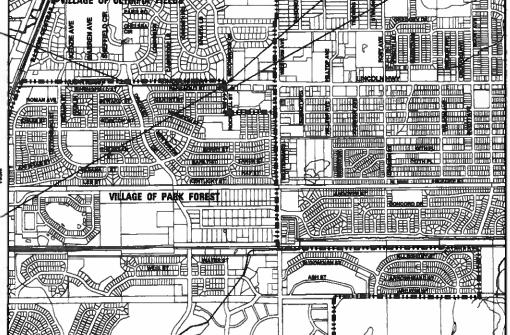

LOCATION MAP N.T.S.

GROSS AND NET LENGTH = 2,490 FT. = 0.472 MILE



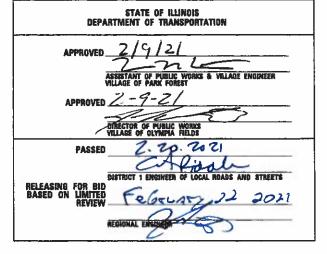

PRINTED BY THE AUTHORITY OF THE STATE OF ILLINOIS

B&W PROJECT NO.: 200138

DATE: 02-09-21

INDEX OF SHEETS

1	COVER SHEET
2	INDEX OF SHEETS, HIGHWAY STANDARDS, GENERAL NOTES, BENCHMARKS AND COMMITMENTS
3 - 4	SUMMARY OF QUANTITIES
5	TYPICAL SECTIONS
6	EARTHWORK SCHEDULE
7 - 9	EXISTING CONDITIONS AND REMOVAL PLAN
10 - 14	PLAN AND PROFILE
15 - 17	EROSION CONTROL PLAN
18 - 20	LANDSCAPING PLAN
21 - 22	ADA RAMP DETAILS
23	CURB OR CURB AND GUTTER REMOVAL AND REPLACEMENT (BD-24)
24	DISTRICT 1 DETAIL - TRAFFIC CONTROL AND PROTECTION FOR SIDE ROADS, INTERSECTIONS AND DRIVEWAYS (TC-10)
25	DISTRICT 1 DETAIL - AERTERIAL ROAD INFORMATION SIGN (TC-22)
26 - 30	CROSS SECTIONS - US ROUTE 30
31 - 32	CROSS SECTIONS - ROCKWELL STREET

DISTRICT ONE DETAILS

STANDARD NO.	LIST OF DESCRIPTION
BD-24	CURB OR CURB AND GUTTER REMOVAL AND REPLACEMENT
TC-10	TRAFFIC CONTROL AND PROTECTION FOR SIDE ROADS, INTERSECTIONS AND DRIVEWAYS
TC-22	ARTERIAL ROAD INFORMATION SIGN

HIGHWAY STANDARDS

001006 DECIMAL OF AN INCH AND OF A FOOT 280001-07 TEMPORARY EROSION CONTROL SYSTEMS 424001-11 PERPENDICULAR CURB RAMPS FOR SIDEWALKS 602301-04 INLET - TYPE A 602601-06 PRECAST REINFORCED CONCRETE FLAT SLAB TOP 604001-05 FRAME AND LIDS TYPE 1
424001-11 PERPENDICULAR CURB RAMPS FOR SIDEWALKS 602301-04 INLET - TYPE A 602601-06 PRECAST REINFORCED CONCRETE FLAT SLAB TOP
602301-04 INLET - TYPE A 602601-06 PRECAST REINFORCED CONCRETE FLAT SLAB TOP
602601-06 PRECAST REINFORCED CONCRETE FLAT SLAB TOP
604001-05 FRAME AND LIDS TYPE 1
604036-03 GRATE TYPE 8
606001-07 CONCRETE CURB TYPE B AND COMBINATION CONCRETE CURB AND GUTTER
701001-02 OFF-RD OPERATIONS, 2L, 2W, MORE THAN 15' (4.5 m) AWAY
701006-05 OFF-RD OPERATIONS, 2L, 2W, 15' (4.5 m) TO 24" (600 mm) FROM PAVEMENT EDGE
701101-05 OFF-RD OPERATIONS, MULTILANE, 15' (4.5 m) TO 24" (600 mm) FROM PAVEMENT EDGE
701106-02 OFF-RD OPERATIONS, MULTILANE, MORE THAN 15' (4.5 m) AWAY
701301-04 LANE CLOSURE, 2L, 2W, SHORT TIME OPERATIONS
701311-03 LANE CLOSURE 2L, 2W MOVING OPERATIONS - DAY ONLY
701606-10 URBAN SINGLE LANE CLOSURE, MULTILANE, 2W WITH MOUNTABLE MEDIAN
701701-10 URBAN LANE CLOSURE, MULTILANE INTERSECTION
701801-06 SIDEWALK, CORNER OR CROSSWALK CLOSURE
701901-08 TRAFFIC CONTROL DEVICES
780001-05 TYPICAL PAVEMENT MARKINGS

COMMITMENTS

THERE ARE NO COMMITMENTS FOR THIS PROJECT

BENCHMARKS

BM #8 SOUTHWEST BOLT ON FIRE HYDRANT SOUTHWEST CORNER OF ORCHARD DRIVE AND US ROUTE 30. EL = 699.35

M *9 SOUTHWEST BOLT ON FIRE HYDRANT AT *2520 ON US ROUTE 30. EL = 707.66

GENERAL NOTES

- 1. IT IS THE CONTRACTOR'S RESPONSIBILITY TO ASCERTAIN EXISTING FIELD CONDITIONS PRIOR TO BIDDING ON THE PROJECT.
- 2. ALL ELEVATIONS SHOWN ON THE PLANS ARE ON THE NAVD88 DATUM.
- SAW CUTTING WILL BE REQUIRED FOR ALL REMOVAL ITEMS AND SHALL BE TO FULL DEPTH AND SHALL RESULT IN A CLEAN STRAIGHT EDGE IN THE PORTION REMAINING.
- 4. THE ELELVATIONS SHOWN ON THE PLANS ARE FINISHED GRADES OR PROPOSED SIDEWALK, UNLESS OTHERWISE NOTED.
- 5. THE LOCATIONS OF PUBLIC UTILITIES SHOWN ON THE PLANS REPRESENTS ONLY THE OPINION OF THE OWNER AND IS ONLY INCLUDED FOR THE CONVENIENCE OF THE BIDDER AND THE ACCURACY IS NOT GUARANTEED. THE CONTRACTOR SHALL BE RESPONSIBLE FOR THE PROTECTION OF ALL UNDERGROUND OR SURFACE UTILITIES, INCLUDING SPRINKLER SYSTEMS, EVEN THOUGH THEY MAY NOT BE SHOWN ON THE PLANS.
- 6. THE CONTRACTOR SHALL NOTIFY THE VILLAGE OF PARK FOREST PUBLIC WORKS DEPARTMENT AT 1-708-503-7702 AT LEAST 48 HOURS IN ADVANCE OF BEGINNING WORK TO OBTAIN VILLAGE UTILITY LOCATIONS.
- 7. THE CONTRACTOR MAY OBTAIN MUNICIPAL WATER IN BULK, AT NO CHARGE, AS LONG AS THERE IS NOT A "WATERING BAN" IN EFFECT. THE INDISCRIMINATE USE OF FIRE HYDRANTS IS STRICTLY PROHIBITED. WATER FOR CONSTRUCTION SHALL BE METERED OR OTHERWISE ACCOUNTED FOR AND A DAILY LOG MAINTAINED. THE CONTRACTOR SHALL PROVIDE THE WATER TRUCK AND DRIVER REQUIRED TO OBTAIN AND TRANSPORT THIS WATER. THE VILLAGE RESERVES THE RIGHT TO RESTRICT OR REFUSE THE USE OF VILLAGE WATER IF DEEMED NECESSARY.
- 8. THE CONTRACTOR SHALL CONTACT THE LOCAL AGENCY MATERIAL INSPECTOR AT LEAST 48 HOURS PRIOR TO ANY CONCRETE DELIVERIES.
- 9. TRANSVERSE EXPANSION JOINTS $\frac{3}{4}$ " SHALL BE PLACED EVERY 50 FEET OR AS DETERMINED BY THE ENGINEER. TRANSVERSE CONTRACTION JOINTS SHALL BE PLACED EVERY 5-FEET.
- O. DETECTABLE WARNINGS SHALL BE CONSTRUCTED WITH THE INSTALLATION OF AN ADA-COMPLIANT CAST-IN-PLACE COMPOSITE 24"X48" MINIMUM NOMINAL SIZE PANEL AS MANUFACTURED BY ARMOR-TILE, ADA SOLUTIONS, INC., OR TUFTILE. THE DOMES LOCATED ON THE PANEL SHALL PARALLEL THE PAVEMENT CROSS WALK WITH THE CLOSEST EDGE LOCATED AT THE BACK OF CURB. THE CONTRASTING PANEL COLOR SHALL BE SELECTED BY THE VILLAGE. INSTALLATION SHALL OCCUR IN ACCORDANCE WITH THE MANUFACTURER'S RECOMMENDATIONS.
- IN AREAS WHERE THE EXISTING SIDEWALK OR CURB AND GUTTER IS TO BE REMOVED AND REPLACED, THE REMOVAL AND DISPOSAL OF ANY ADDITIONAL MATERIAL REQUIRED TO ESTABLISH THE PROPOSED SIDEWALK, OR CURB AND GUTTER SUBGRADE ELEVATION SHALL BE INCLUDED IN THE APPROPRIATE REMOVAL PAY ITEMS.
- TRENCH BACKFILL FOR THIS PROJECT SHALL CONSIST OF CRUSHED CA-6 AND SHALL BE COMPACTED BY METHOD 1 ONLY.
- PRIOR TO CONSTRUCTION OF ANY PROPOSED UTILITIES, THE CONTRACTOR SHALL EXCAVATE AND LOCATE THE EXISTING UTILITIES TO VERIFY THEIR LOCATION, SIZE, AND DEPTH TO INSURE THAT GRADE CONFLICTS WILL NOT OCCUR.
- ANY ADDITIONAL STORM SEWER PIPE REQUIRED TO MAKE THE CONNECTION SHALL BE OF THE SAME SIZE AND MATERIAL TYPE AS THE EXISTING STORM SEWER.
- IF ANY STORM SEWER LATERALS ARE FOUND DURING CONSTRUCTION AND ARE NOT IDENTIFIED ON THE PLANS, THEY SHALL BE CONNECTED TO THE PROPOSED STORM SEWER SYSTEM.
- FRAME ELEVATIONS GIVEN ON THE PLANS ARE ONLY TO ASSIST THE CONTRACTOR IN DETERMINING THE APPROXIMATE OVERALL HEIGHT OF THE STRUCTURE. FRAMES ON ALL NEW STRUCTURES SHALL BE ADJUSTED TO THE FINAL ELEVATION OF THE AREA IN WHICH THEY ARE LOCATED.

- 17. DURING CONSTRUCTION OPERATONS, IF ANY LOOSE MATERIAL IS DEPOSITED IN THE FLOW LINE OF DRAINAGE STRUCTURES SUCH THAT THE NATURAL FLOW OF WATER IS OBSTRUCTED, THE MATERIAL SHALL BE REMOVED AT THE CLOSE OF EACH WORKING DAY. AT THE CONCLUSION OF CONSTRUCTION OPERATIONS, ALL UTILITY STRUCTURES SHALL BE FREE FROM DUST AND DEBRIS. THE CONTRACTOR'S FAILURE TO PROVIDE THE ABOVE WILL PRECLUDE ANY POSSIBLE ADDED COMPENSATION REQUESTED DUE TO DELAYS OF UNSUITABLE MATERIALS CREATED AS A RESULT THEREOF.
- 18. ALL TREES ARE DESIGNATED TO BE SAVED UNLESS OTHERWISE NOTED ON THE PLANS, AND SHALL BE PROTECTED IN ACCORDANCE WITH THE PROVISIONS OF ARTICLE 201.05 OF THE STANDARD SPECIFICATIONS.
- 19. THE PRESERVATION OF EXISTING TREES IS OF THE UTMOST IMPORTANCE TO THE VILLAGE. ALL TREE PROTECTION, TREE REMOVAL, TREE PRUNING AND ROOT PRUNING SHALL BE COMPLETED BEFORE CONSTRUCTION OPERATIONS COMMENCE IN ANY AREAS. AT NO TIME SHALL THE CONTRACTOR PRUNE OR REMOVE ANY TREES UNLESS SPECIFICALLY DETERMINED BY THE ENGINEER.
- 20. THE CONTRACTOR SHALL MARK ALL TREES TO BE REMOVED IN A MANNER MEETING THE APPROVAL OF THE ENGINEER PRIOR TO THE START OF REMOVAL OPERATIONS. ALL TREES TO BE REMOVED SHALL BE APPROVED BY THE ENGINEER PRIOR TO REMOVAL.
- 21. A PORTABLE BATHROOM OR TOILET SHALL BE PLACED ON THE JOB SITE(S) AND RELOCATED WHEN NECESSARY SO IT IS ACCESSIBLE TO WORKERS. IF WORK IS OCCURRING AT SEVERAL LOCATIONS, ONE PORTABLE BATHROOM SHALL BE PLACED AT EACH LOCATION WITHIN A REASONABLE DISTANCE FROM THE WORK AS DETERMINED BY THE ENGINEER.
- 22. MATERIALS RESULTING FROM THE REMOVAL OF PAVEMENT, DRIVEWAYS, CURB AND GUTTER, HOT-MIX ASPHALT SURFACES, ETC. SHALL BE REMOVED AT THE END OF EACH DAY TO AN APPROVED SITE. IN THE JUDGMENT OF THE ENGINEER, SHOULD IT BE NECESSARY TO REMOVE SUCH MATERIALS, THE ENGINEER WILL HAVE THE MATERIAL REMOVED AND THE CONTRACTOR WILL BE BILLED (CHARGED) ACCORDINGLY.
- 23. STORAGE OF CONSTRUCTION MATERIALS AND EQUIPMENT SHALL BE APPROVED BY THE ENGINEER. STORAGE OF CONSTRUCTION MATERIALS AND EQUIPMENT IS NOT PERMITTED IN IDOT RIGHT-OF-WAY.
- 24. ANY DAMAGE TO PAVEMENT, SIDEWALK, CURB OR ANY OTHER PORTION OF THE ROADWAY NOT SPECIFICALLY TO BE REMOVED AND REPLACED SHALL BE REPAIRED OR REPLACED BY THE CONTRACTOR AT NO ADDITIONAL CHARGE.
- 25. LANE CLOSURES ON US ROUTE 30 SHALL BE MINIMIZED AND SHALL BE LIMITED TO A MAXIMUM OF ONE CLOSED LANE AND THE CLOSURE RESTRICTED TO THE DAYTIME HOURS OF 9AM TO 3PM. SHALL STRICTLY FOLLOW HIGHWAY STANDARDS 701001, 701006, 701101, 701106, 701301, 701311, 701606, 701701,701801, AND 701901 AS APPROPRIATE.
- 26. AN IEPA FORM LPC-662 HAS BEEN PROVIDED BY THE VILLAGE AND IS INCLUDED IN THE SPECIAL PROVISIONS.
- 27. THE CONTRACTOR SHALL CONTACT THE IDDT TRAFFIC CONTROL SUPERVISOR AT KALPANA.KANNAN-HOSADURGA@ILLINOIS.GOV 72 HOURS IN ADVANCE OF BEGINNING WORK.
- 28. THE RECOMMENDED TOPSOIL REMOVAL DEPTH IS FOR ESTIMATING PURPOSES. THE ACTUAL REMOVAL DEPTH AND THE QUANTITY OF TOPSOIL REMOVAL SHOULD BE VERIFIED IN THE FIELD.

BAXTER WOODMAN

USER NAME = 488cac	DESIGNED - AKS	REVISED -
	DRAWN - CJC	REVISED -
PLOT SCALE = 1.0000 ' / in.	CHECKED - CAC	REVISED -
PLOT DATE = 2/19/2021	DATE - 02-19-21	FILE - 200138-SHT-GNTES.dan

INDEX OF SH	IEETS.	HIGHWA	Y STAI	IDARD	S. GENERAL I	NOTES,	F.A.P. RTE.	SECT	ΓΙΟΝ		COUNTY	TOTAL SHEETS	
					MENTS		353	19-00105	5-00-SW		COOK	32	
			,								CONTRACT	NO.	ē
SCALE:	SHEET	OF	SHEETS	STA.	TO STA.				ILLINOIS F	ED All	PROJECT XC1E/	104)	7

					80% FED 20% LOCAL
***************************************					ROADWAY
	CODE NO.	ITEM	UNIT	TOTAL QUANTITY	0021
			***	Q0/11/11/	URBAN
*	20100110	TREE REMOVAL (6 TO 15 UNITS DIAMETER)	UNIT	42	42
*	20100210	TREE REMOVAL (OVER 15 UNITS DIAMETER)	UNIT	36	36
					30
ż	20101100	TREE TRUNK PROTECTION	EACH	82	82
*	20101200	TREE ROOT PRUNING	EACH	5	5
¥	20101200	TREE PRUNING (1 TO 10 INCH DIAMETER)	EACH	4	4
•	20101300	TREE PROVING (1 TO TO INCHI DIAMETER)	EACH	4	4
*	20101350	TREE PRUNING (OVER 10 INCH DIAMETER)	EACH	1	1
* SP	20101700	SUPPLEMENTAL WATERING	UNIT	62	62
	20200100	EARTH EXCAVATION	CU YD	92	92
*************	20201200	REMOVAL AND DISPOSAL OF UNSUITABLE MATERIAL	CU YD	611	611
	20400800	FURNISHED EXCAVATION	CU YD	311	311
	21001000	GEOTECHNICAL FABRIC FOR GROUND STABILIZATION	SQ YD	411	411
	21101505	TOPSOIL EXCAVATION AND PLACEMENT	CU YD	251	251
	21400100	GRADING AND SHAPING DITCHES .	FOOT	85	85
×	25000210	SEEDING, CLASS 2A	ACRE	0.3	0.3
		NITROGEN FERTILIZER NUTRIENT	POUND	27	27

SP SPECIAL PROVISION

			CONSTRUCTION CODE
			80% FED 20% LOCAL
ITEM	UNIT	TOTAL QUANTITY	ROADWAY 0021 URBAN
PHORUS FERTILIZER NUTRIENT	POUND	27	27
SSIUM FERTILIZER NUTRIENT	POUND	27	27
CH, METHOD 2	ACRE	0.3	0.3
ORARY EROSION CONTROL SEEDING	POUND	30	30
METER EROSION BARRIER	FOOT	305	305
FILTERS	EACH	26	26
ORARY EROSION CONTROL BLANKET	SQ YD	1,243	1,243
REGATE SUBGRADE IMPROVEMENT	CU YD	138	138
REGATE BASE COURSE, TYPE B 4"	SQ YD	1,405	1,405
ECTIVE COAT	SQ YD	1,427	1,427
LAND CEMENT CONCRETE SIDEWALK, 5 INCH	SQ FT	12,635	12,635
CTABLE WARNINGS	SQ FT	30	30
NALK REMOVAL	SQ FT	395	395
S D PATCHES, TYPE I, 6 INCH	SQ YD	8	8
S D PATCHES, TYPE III, 6 INCH	SQ YD	23	23
S D PA			

^{*} INDICATES SPECIALTY ITEM

SP SPECIAL PROVISION

	USER NAME == 488cac	DESIGNED AKS	REVISED -			F.A.P.	SECTION	COUNTY	TOTAL 5	SHEET NO.
BAXTERSWOODMAN		DRAWN - CJC	REVISED -	STATE OF ILLINOIS	SUMMARY OF QUANTITIES	353	19-00105-00-SW	соок	32	3
Consulting Engineers	PLOT SCALE = 1.0000 ' / in	CHECKED ~ CAC	REVISED .	DEPARTMENT OF TRANSPORTATION				CONTRAC	T NO. 61	1G99
₹	PLOT DATE = 2/19/2021	DATE - 02-19-21	FILE - 200138-SHT-SOQ.dgn		SCALE: N.T.S. SHEET 1 OF 2 SHEETS STA. TO STA.		ILLINOIS FED. A	ID PROJECT XC1F		

CONSTRUCTION CODE

						80% FED 20% LOCAL
						ROADWAY
		CODE NO.	ITEM	UNIT	TOTAL QUANTITY	0021
						URBAN
		55080050	STORM SEWERS, CLASS B. TYPE 1 12"	FOOT	141	141
		60236200	INLETS, TYPE A, TYPE 8 GRATE	EACH	1	1
	,	60258200	MANHOLES TO BE RECONSTRUCTED WITH NEW TYPE 1 FRAME, CLOSED LID	EACH	1	1
		60255500	MANHOLES TO BE ADJUSTED	EACH	2	2
		60266600	VALVE BOXES TO BE ADJUSTED	EACH	1	1
		67100100	MOBILIZATION	L SUM	1	1
		70102625	TRAFFIC CONTROL AND PROTECTION, STANDARD 701606	L SUM	1	1
		70102635	TRAFFIC CONTROL AND PROTECTION, STANDARD 701701	L SUM	1	1
		70102640	TRAFFIC CONTROL AND PROTECTION, STANDARD 701801	L SUM	1	1
*	SP	85000200	MAINTENANCE OF EXISTING TRAFFIC SIGNAL INSTALLATION	EACH	1	1
*	SP	89502376	REBUILD EXISTING HANDHOLE	EACH	4	4
	* SP	B0001716	TREE, AMELANCHIER X GRANDIFLORA APPLE, (APPLE SERVICEBERRY), 2" CALIPER, TREE FORM, BALLED AND	EACH	3	3
	* SP	B2006320	TREE, SYRINGA RETICULATA IVORY SILK (IVORY SILK JAPANESE TREE LILAC), 2-1/2" CALIPER, TREE FORM, BALLED AND	EACH	2	2
	۲۲	K0013000	PERENNIAL PLANTS, PRAIRIE TYPE, 2" DIAMETER BY 4" DEEP PLUG	UNIT	11	11

* SP K0029634 WEED CONTROL, PRE-EMERGENT GRANULAR HERBICIDE

CONSTRUCTION CODE
80% FED 20% LOCAL
T T

					20% LOCAL
				TOTAL	ROADWAY
	CODE NO.	ITEM	UNIT	TOTAL QUANTITY	0021
				90,40,111	URBAN
* SP	K1003679	MULCH	CU YD	3	3
SP	X2130010	EXPLORATION TRENCH, SPECIAL	FOOT	40	40
SP	Z0013798	CONSTRUCTION LAYOUT	LSUM	1	1
SP	Z0022800	FENCE REMOVAL	FOOT	10	10
SP	Z0030850	TEMPORARY INFORMATION SIGNING	SQ FT	77.1	77.1
		COMBINATION CONCRETE CURB AND GUTTER REMOVAL AND			
SP	Z0004562	REPLACEMENT	FOOT	80	80

^{*} INDICATES SPECIALTY ITEM
SP SPECIAL PROVISION

BAXTER WOODNAN Consulting Engineers

USER NAME = 488cac	DESIGNED - AKS	REVISED -
	DRAWN + CJC	REVISED -
PLOT SCALE = 1.0000 ' / in	CHECKED ~ CAC	REVISED .
PLOT DATE = 2/19/2021	DATE - 02-19-21	FILE - 200138-SHT-SOQ.dgn

POUND

10


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CONSTRUCTION CODE

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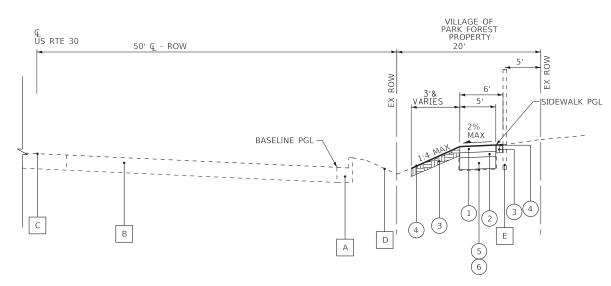
F.A.P. RTE.	SECTION	COUNTY	TOTAL SHEETS	SHEET NO.						
353	19-00105-00-SW	COOK	32	4						
*		CONTRAC	T NO. 6	1G99						
	ILLINOIS FED. AID PROJECT XC1F(104)									

^{*} INDICATES SPECIALTY ITEM
SP SPECIAL PROVISION



EXISTING TYPICAL SECTION

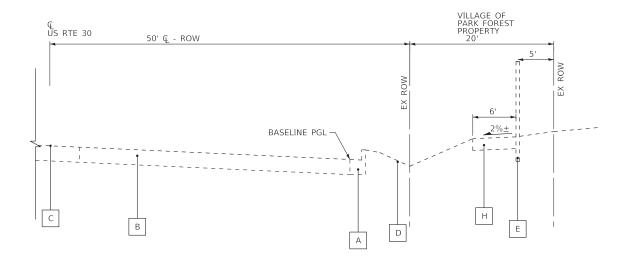STA 118+00 TO STA 141+72 RT, US ROUTE 30



PROPOSED TYPICAL SECTION STA 118+00 TO STA 141+72 RT, US ROUTE 30

HOT-MIX ASPHALT MIXTURE REQUIREMENTS

MIX TYPE	AIR VOIDS @ Ndes
CLASS D PATCHES	
HOT-MIX ASPHALT SURFACE COURSE, MIX "D", N50 (IL 9.5mm): 1 1/2"	4% @ 50 GYR
HOT-MIX ASPHALT BINDER COURSE, IL-19.0mm: 4 1/2"	4% @ 50 GYR

THE UNIT WEIGHT USED TO CALCULATE ALL HOT-MIX ASPHALT SURFACE MIXTURE QUANTITIES IS 112LB/SY-IN.

THE 'AC TYPE' FOR POLYMERIZED HMA MIXES SHALL BE 'SBS/SBR PG 76-22" AND FOR NON-POLYMERIZED HMA THE "AC TYPE" SHALL BE "PG 64-22" UNLESS MODIFIED BY SPECIAL PROVISIONS.

FOR USE OF RECYLCLED MATERIALS SEE SPECIAL PROVISIONS.

EXISTING LEGEND


- A B-6.24 CURB AND GUTTER
- B PAVEMENT
- C PAINTED MEDIAN
- D GROUND
- E FENCE
- F CURB
- G PARKING LOT
- H TOPSOIL REMOVAL 12"

PROPOSED LEGEND

- 1) PORTLAND CEMENT CONCRETE SIDEWALK 5"
- 2) AGGREGATE BASE COURSE, TYPE B- 4"
- 3 TOPSOIL EXCAVATION AND PLACEMENT (DEPTH 6")
- 4 SEEDING, CLASS 2A AND MULCH METHOD 2
- 5 * AGGREGATE SUBGRADE IMPROVEMENT (CU YD)
- 6 * GEOTECHNICAL FABRIC FOR GROUND STABLILIZATION (SQ YD)

EXISTING TYPICAL SECTION

STA 200+00 TO STA 201+50, ROCKWELL ST ROW

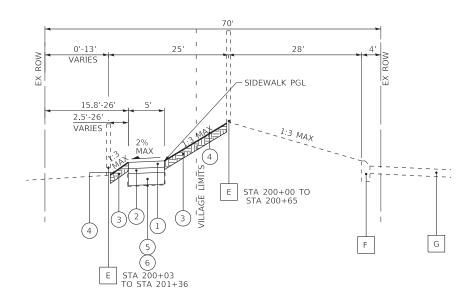

PROPOSED TYPICAL SECTION

STA 200+00 TO STA 201+50, ROCKWELL ST ROW

* AGGREGATE SUBGRADE IMPROVEMENT (ASI) HAS BEEN PROVIDED FOR USE AT THE LOCATIONS INDICATED FOR SOILS THAT TEND TO BE UNSUITABLE OR UNSTABLE. THE ACTUAL NEED FOR REMOVAL AND REPLACEMENT WITH ASI WILL BE DETERMINED IN THE FIELD AT THE TIME OF CONSTRUCTION BY THE ENGINEER. ALL POTENTIALLY UNSTABLE SOILS SHOULD BE TESTED WITH A STATIC CONE PENETROMETER AND TREATED IN ACCORDANCE WITH ARTICLE 301.04 AND THE UNDERCUT GUIDELINES IN THE IDOT SUBGRADE STABILITY MANUAL. IF UNSTABLE AND/OR UNSUITABLE MATERIAL IS ENCOUNTERED, THE SOIL SHALL BE REMOVED AND REPLACED WITH ASI OR EMBANKMENT AS DETERMINED BY THE ENGINEER. IF UNSTABLE AND/OR UNSUITABLE MATERIAL IS NOT ENCOUNTERED, THEN THE QUANTITY SHALL BE DEDUCTED AND NO ADDITIONAL COMPENSATION WILL BE DUE THE CONTRACTOR. A QUANTITY OF REMOVAL AND DISPOSAL OF UNSUITABLE MATERIAL SHALL ALSO BE DEDUCTED WITH NO ADDITIONAL COMPENSATION DUE THE CONTRACTOR. POTENTIAL UNDERCUT LOCATIONS ARE LISTED ON EACH TYPICAL SECTION.



USER NAME = 488cac	DESIGNED - AKS	REVISED -
	DRAWN - CJC	REVISED -
PLOT SCALE = 10.0000 ' / in.	CHECKED - CAC	REVISED -
PLOT DATE = 2/19/2021	DATE - 02-19-21	FILE - 200138-SHT_TYP.dgn

STATE OF ILLINOIS
DEPARTMENT OF TRANSPORTATION

		TVDIO				F.A.P. RTE.	SECTION	COUNTY	TOTAL SHEETS	SHEET NO.
		TYPICA	AL SECT	IONS	353	19-00105-00-SW	соок	32	5	
								CONTRACT	ΓNO. 6	51G99
NONE	SHEET	OF	SHEETS	STA	TO STA		II I INOIC FED	AID DROJECT VC15	(104)	

							EARTHWORK							
		1	2	3	4	5	6	7	8	9	10	11	12	13
	ATION TO STA	TOPSOIL EXCAVATION	TOPSOIL EXCAVATION FOR PLACEMENT (25% SHRINKAGE)	TOPSOIL EXCAVATION AND PLACEMENT (DEPTH 6")	TOPSOIL BALANCE WASTE (+) OR SHORTAGE (-)	AGGREGATE SUBGRADE IMPROVEMENT	UNSUITABLE EXCAVATION (TOPSOIL)	REMOVAL & DISPOSAL OF UNSUITABLE MATERIAL	EARTH EXCAVATION	CHANNEL EXCAVATION	TOTAL SUITABLE EXCAVATION	EXCAVATION TO BE USED IN EMBANKMENT (15% SHRINKAGE)	EMBANKMENT	EARTHWORK BALANCE WASTE (+) OR SHORTAGE (-)
		(CU YD)	(CU YD)	(CU YD)	(CU YD)	(CU YD)	(CU Y D)	(CU YD)	(CU Y D)	(CU YD)	(CU YD)	(CU YD)	(CU YD)	(CU YD)
	UTE 30 .N HWY)	+805	+606	+185	+421	+132	+421	+553	+70	-	+70	+62	+351	(-289)
118+40.00	118+50.00	4.8	3.6	0.6	+3.0	-	3.0	3.0	0.3	0.0	0.3	0.3	2.0	-1.7
118+50.00	119+00.00	21.2	16.0	4.0	+12.0	5.6	12.0	17.6	1.7	0.0	1.7	1.5	6.9	-5.4
119+00.00	119+50.00	18.6	14.0	4.7	+9.3	11.1	9.3	20.4	1.3	0.0	1.3	1.1	6.4	-5.3
119+50.00	120+00.00	18.7	14.1	4.7	+9.4	11.1	9.4	20.5	1.0	0.0	1.0	0.9	8.9	-8.0
120+00.00 120+50.00	120+50.00 121+00.00	18.8	14.2 14.1	4.9 4.9	+9.3 +9.2	5.6 -	9.3 9.2	14.9 9.2	0.7 0.4	0.0 0.0	0.7 0.4	0.7 0.4	9.9 10.3	-9.2 -9.9
120+30.00	121+50.00 121+50.00	18.8 18.6	14.0	4.7	+9.3	_	9.3	9.3	0.4	0.0	0.9	0.4	7.3	-9.9 -6.5
121+50.00	122+00.00	18.6	14.0	4.7	+9.3	5.6	9.3	14.9	1.3	0.0	1.3	1.2	4.4	-3.2
122+00.00	122+50.00	17.9	13.4	4.4	+9.0	11.1	9.0	20.1	0.7	0.0	0.7	0.7	8.2	-7.5
122+50.00	123+00.00	17.1	12.8	4.1	+8.7	5.6	8.7	14.2	0.8	0.0	0.8	0.7	9.8	-9.1
123+00.00	123+50.00	16.9	12.7	3.9	+8.8	-	8.8	8.8	1.3	0.0	1.3	1.2	7.3	-6.1
123+50.00	124+00.00	16.8	12.6	3.8	+8.8	-	8.8	8.8	1.1	0.0	1.1	1.0	7.9	-6.9
124+00.00	124+50.00	16.8	12.6	3.8	+8.8	5.6	8.8	14.4	1.6	0.0	1.6	1.4	7.3	-5.9
124+50.00	125+00.00	16.8	12.6	3.8	+8.8	11.1	8.8	19.9	1.7	0.0	1.7	1.5	7.2	-5.7
125+00.00	125+50.00	16.9	12.8	3.8	+9.0	5.6	9.0	14.5	1.4	0.0	1.4	1.2	7.6	-6.4
125+50.00 126+00.00	126+00.00	17.0	12.8 12.7	3.9 3.9	+8.9 +8.8	-	8.9 8.8	8.9 8.8	1.7 1.9	0.0 0.0	1.7 1.9	1.5 1.7	7.3 7.0	-5.8 -5.3
126+00.00	126+50.00 127+00.00	16.9 16.9	12.7	3.8	+8.9	_	8.9	8.9	1.7	0.0	1.7	1.5	7.0	-5.7
127+00.00	127+50.00	16.8	12.7	3.8	+8.9	_	8.9	8.9	2.3	0.0	2.3	2.0	6.5	-4.5
127+50.00	128+00.00	16.8	12.6	3.8	+8.8	-	8.8	8.8	3.7	0.0	3.7	3.2	4.6	-1.4
128+00.00	128+50.00	16.9	12.7	4.0	+8.7	-	8.7	8.7	3.7	0.0	3.7	3.2	4.6	-1.4
128+50.00	129+00.00	17.0	12.8	4.0	+8.8	5.6	8.8	14.3	3.4	0.0	3.4	2.9	5.4	-2.5
129+00.00	129+50.00	16.8	12.7	3.9	+8.8	11.1	8.8	19.9	3.1	0.0	3.1	2.7	5.7	-3.0
129+50.00 130+00.00	130+00.00 130+50.00	16.7 16.9	12.6 12.7	3.8 3.8	+8.8 +8.9	5.6	8.8 8.9	14.4 8.9	1.6 1.2	0.0 0.0	1.6 1.2	1.4 1.1	7.3 7.6	-5.9 -6.5
130+50.00	131+00.00	17.0	12.8	3.8	+9.0	_	9.0	9.0	1.1	0.0	1.1	1.0	8.3	-7.3
131+00.00	131+50.00	16.9	12.7	3.7	+9.0	-	9.0	9.0	1.1	0.0	1.1	1.0	8.2	-7.2
131+50.00	132+00.00	16.7	12.6	3.7	+8.9	-	8.9	8.9	1.9	0.0	1.9	1.7	6.5	-4.8
132+00.00	132+50.00	16.7	12.6	3.7	+8.9	5.6	8.9	14.4	1.7	0.0	1.7	1.5	6.9	-5.4
132+50.00	133+00.00	16.7	12.6	3.7	+8.9	11.1	8.9	20.0	1.5	0.0	1.5	1.3	7.2	-5.9
133+00.00 133+50.00	133+50.00 134+00.00	16.7 16.7	12.6 12.6	3.7 3.7	+8.9 +8.9	5.6 -	8.9 8.9	14.4 8.9	1.4 1.9	0.0 0.0	1.4 1.9	1.3 1.7	7.3 6.8	-6.0 -5.1
134+00.00	134+00.00	16.7	12.6	3.7	+8.9	_	8.9	8.9	1.8	0.0	1.8	1.6	6.9	-5.1 -5.3
134+50.00	135+00.00	16.8	12.6	3.8	+8.8	-	8.8	8.8	1.0	0.0	1.0	0.9	8.0	-7.1
135+00.00	135+50.00	16.9	12.7	3.9	+8.8	-	8.8	8.8	1.2	0.0	1.2	1.1	7.8	-6.7
135+50.00	136+00.00	16.8	12.7	3.8	+8.9	4.6	8.9	13.5	1.7	0.0	1.7	1.5	7.0	-5.5
136+00.00	136+50.00	16.7	12.6	3.8	+8.8	4.6	8.8	13.5	1.6	0.0	1.6	1.4	7.1	-5.7
136+50.00	137+00.00	16.8	12.6	3.8	+8.8	-	8.8	8.8	1.4	0.0	1.4	1.2	7.5 7.9	-6.3
137+00.00 137+50.00	137+50.00 138+00.00	16.8 16.8	12.6 12.6	3.8 3.9	+8.8 +8.7		8.8 8.7	8.8 8.7	1.1 0.8	0.0	1.1 0.8	1.0 0.7	7.9 8.3	-6.9 -7.6
138+00.00	138+50.00	16.8	12.6	3.8	+8.8	_	8.8	8.8	1.0	0.0	1.0	0.9	8.0	-7.1
138+50.00	139+00.00	16.8	12.6	3.8	+8.8	_	8.8	8.8	1.0	0.0	1.0	0.9	8.0	-7.1
139+00.00	139+50.00	16.8	12.6	3.8	+8.8	-	8.8	8.8	0.3	0.0	0.3	0.3	9.4	-9.1
139+50.00	140+00.00	16.8	12.6	4.0	+8.6	-	8.6	8.6	0.0	0.0	0.0	0.1	10.8	-10.7
140+00.00	140+50.00	16.7	12.6	3.9	+8.7	-	8.7	8.7	0.3	0.0	0.3	0.3	9.8	-9.5
140+50.00 141+00.00	141+00.00 141+50.00	16.7 18.6	12.6 14.0	3.8 4.6	+8.8 +9.4		8.8 9.4	8.8 9.4	1.1 2.3	0.0 0.0	1.1 2.3	1.0 2.0	7.7 7.2	-6.7 -5.2
141+00.00	141+70.00	8.1	6.2	1.1	+5.1	_	5.1	5.1	2.3 1.2	0.0	1.2	1.1	2.9	-5.2 -1.8
	L STREET	+157	+118	+66	+53	+6	+53	+58	+22	-	+22	+19	+40	(-22)
200+01.00	200+25.00	22.4	16.8 18.9	9.2	+7.6 +8.7	_	7.6 8.7	7.6 8.7	3.8 2.0	0.0 0.0	3.8 2.0	3.2 1.8	2.8 7.8	0.4 -6.0
200+25.00 200+50.00	200+50.00 200+65.00	25.1 15.8	11.9	10.2 6.4	+8.7 +5.5	- 0.7	5.5	6.2	2.0 0.1	0.0	0.1	0.2	6.7	-6.5
200+30.00	200+75.00	11.6	8.7	4.8	+3.9	0.9	3.9	4.8	1.9	0.0	1.9	1.6	3.3	-1.7
200+75.00	201+00.00	29.4	22.1	12.4	+9.7	2.3	9.7	12.0	9.0	0.0	9.0	7.7	5.0	2.7
201+00.00	201+25.00	30.5	23.0	13.1	+9.9	1.2	9.9	11.1	4.5	0.0	4.5	3.9	7.2	-3.3
201+25.00	201+41.00	22.0	16.5	9.5	+7.0	-	7.0	7.0	0.0	0.0	0.0	0.0	7.3	-7.3
T07	ALS	962	724	251	474	138	474	611	92	0	92	81	391	-311

COLUMN 1 = TOPSOIL REMOVAL DEPTH 12"

 $COLUMN 2 = [COLUMN 1] \times 0.75$

COLUMN 3 = FROM CROSS SECTION END AREAS, DEPTH 6"
COLUMN 4 = [COLUMN 2] - [COLUMN 3]

COLUMN 5 = ASSUMED TO BE 1' DEPTH

COLUMN 6 = [COLUMN 4] (IF COLUMN 4 > 0)COLUMN 7 = [COLUMN 5] + [COLUMN 6]COLUMN 8 = FROM CROSS SECTION END AREAS

COLUMN 9 = EXCAVATION WITHIN CHANNEL OUTSIDE OF STRUCTURE
COLUMN 10 = [COLUMN 8]
COLUMN 11 = [COLUMN 10] x 0.85

COLUMN 12 = FROM CROSS SECTION END AREAS

COLUMN 13 = [COLUMN 11] - [COLUMN 12]

BAXTER WOODMAN Consulting Engineers

USER NAME = 488cac	DESIGNED -	AKS	REVISED -
	DRAWN -	CJC	REVISED -
PLOT SCALE = 1.0000 ' / in.	CHECKED -	CAC	REVISED -
PLOT DATE = 2/19/2021	DATE -	02-19-21	FILE - 200138-SHT-SOQ.dgn

STATE OF ILLINOIS **DEPARTMENT OF TRANSPORTATION**

EARTH EXCAVATION

MATERIAL

<u>TOTAL</u>

92

CU YD

CU YD

CU YD


EARTHWORK PAY ITEM SUMMARY


REMOVAL AND DISPOSAL OF UNSUITABLE


TOPSOIL EXCAVATION AND PLACEMENT

FARTINACRY COUERING	F.A.P. RTE.	SECTION	COUNTY	TOTAL	SHEET NO.
EARTHWORK SCHEDULE	353	199099950956W	COOK	32	6
			CONTRACT	NO.	61G99
SCALE: N.T.S. SHEET 1 OF 1 SHEETS STA. TO STA.		ILLINOIS FE	D. AID PROJECT XC1F	(104)	

AGGREGATE SUBGRADE IMPROVEMENT CU YD CHANNEL EXCAVATION CU YD FURNISHED EXCAVATION CU YD

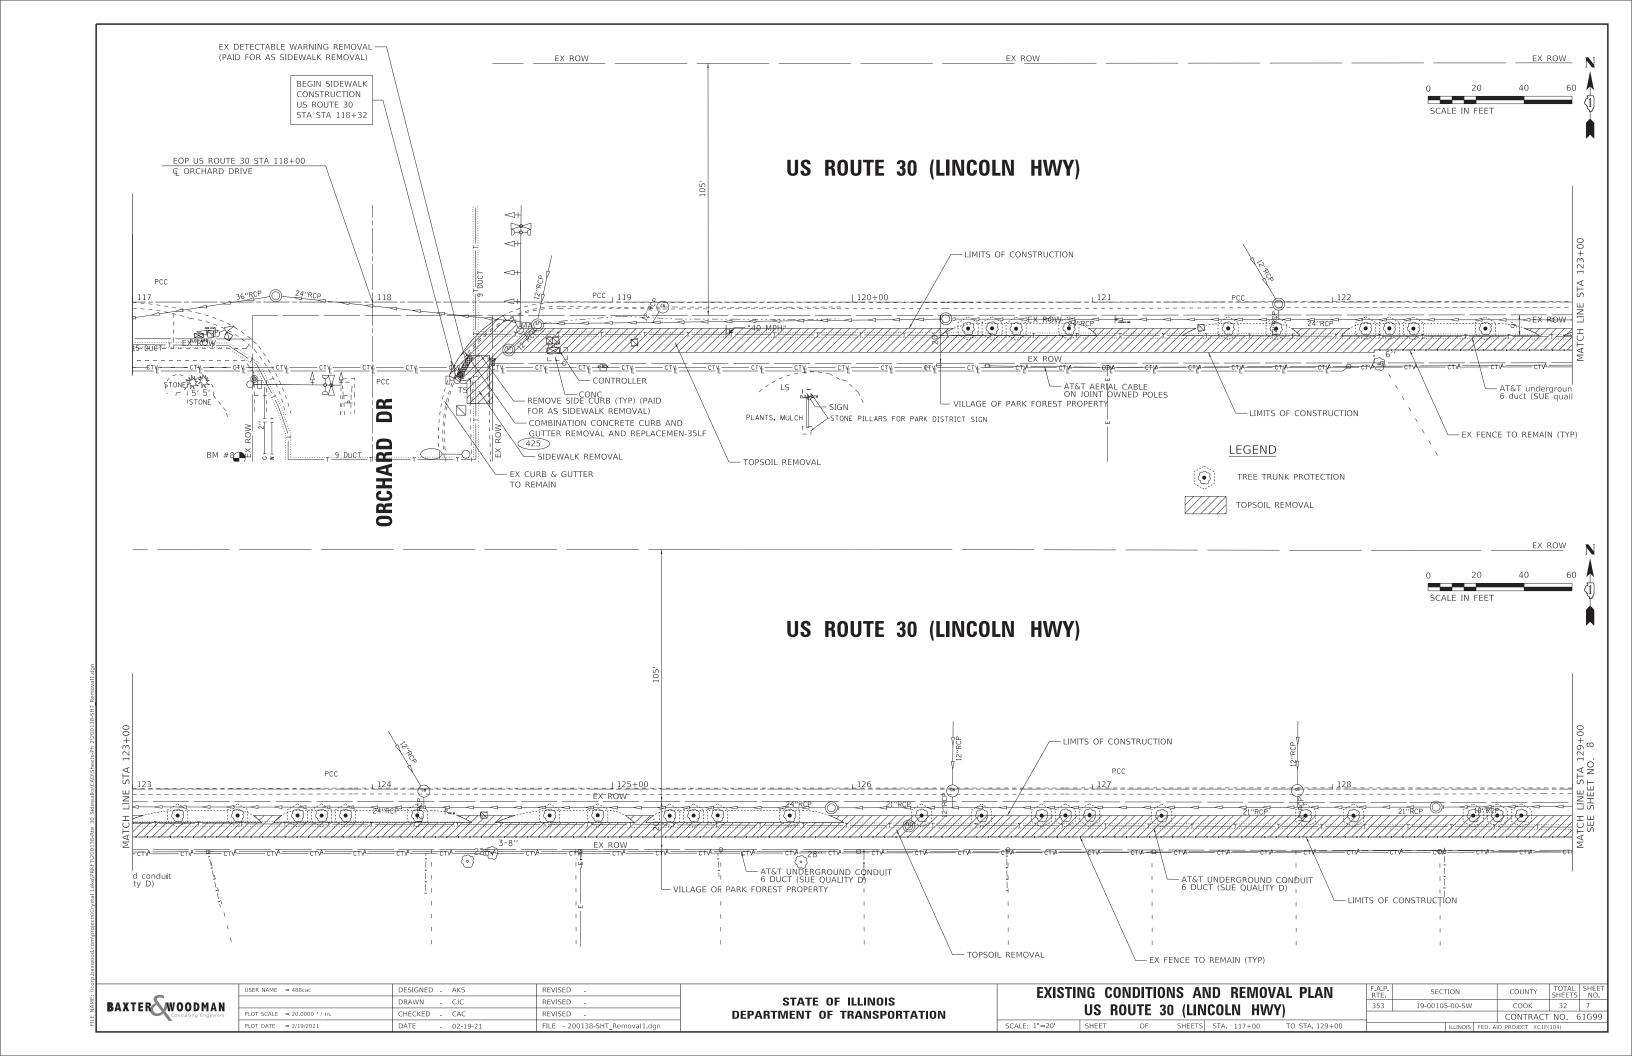

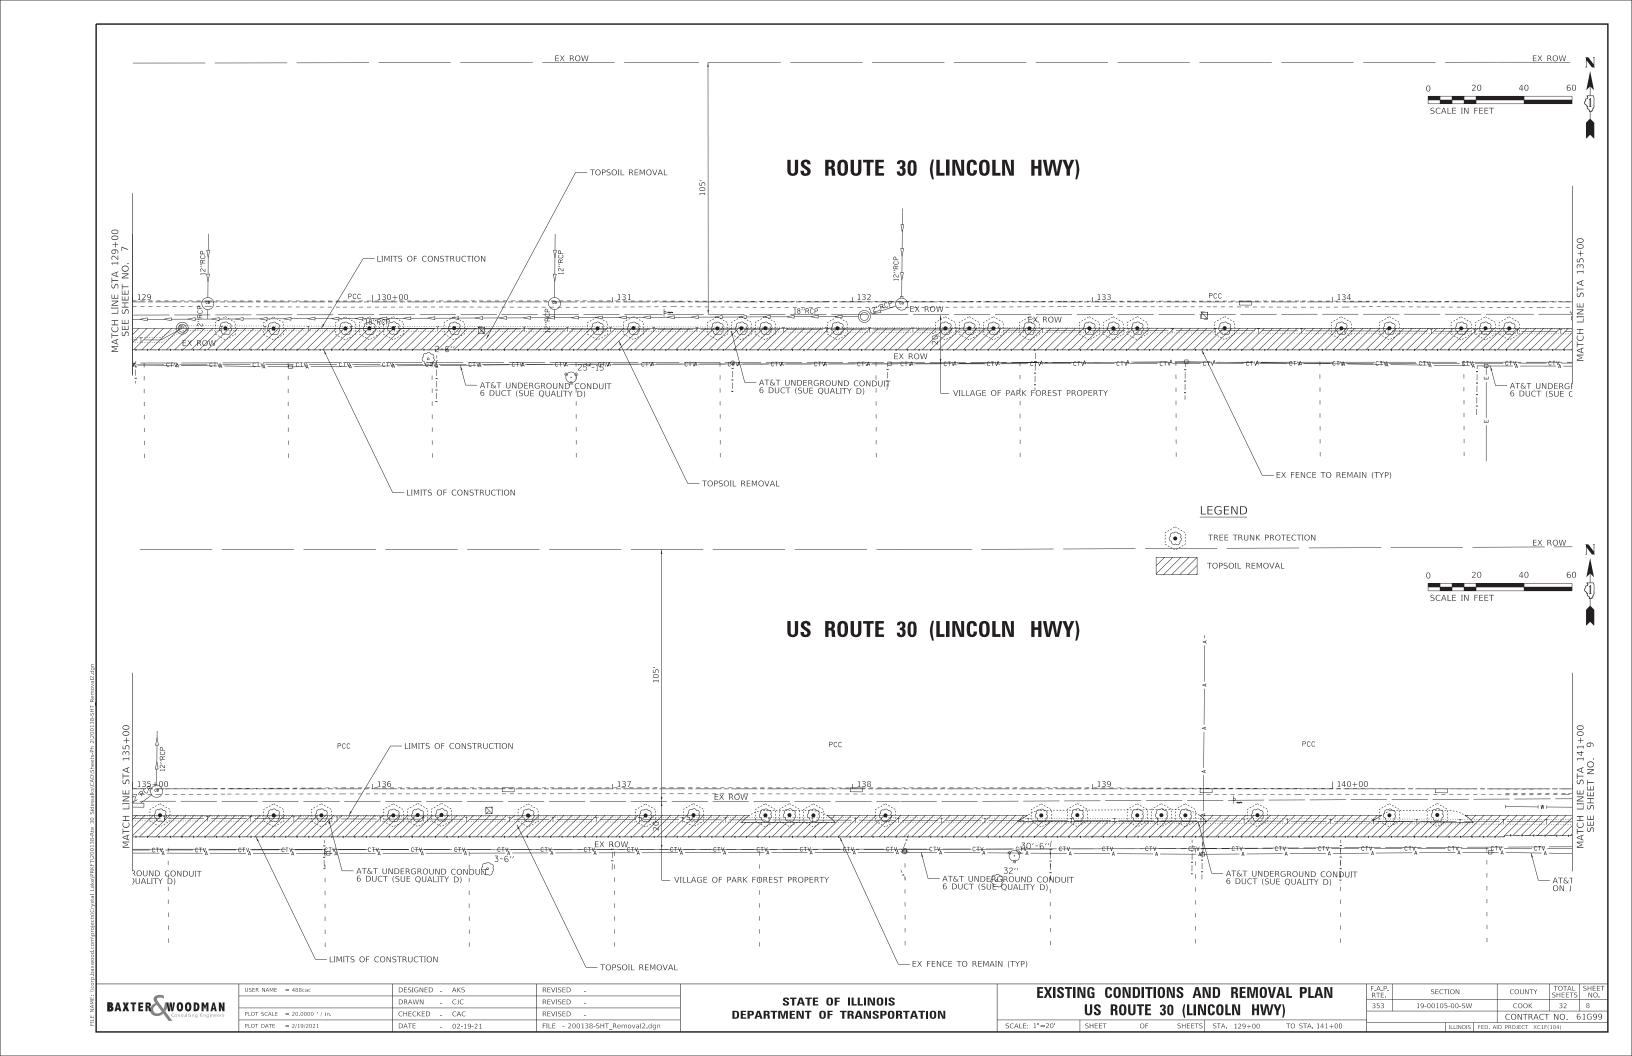

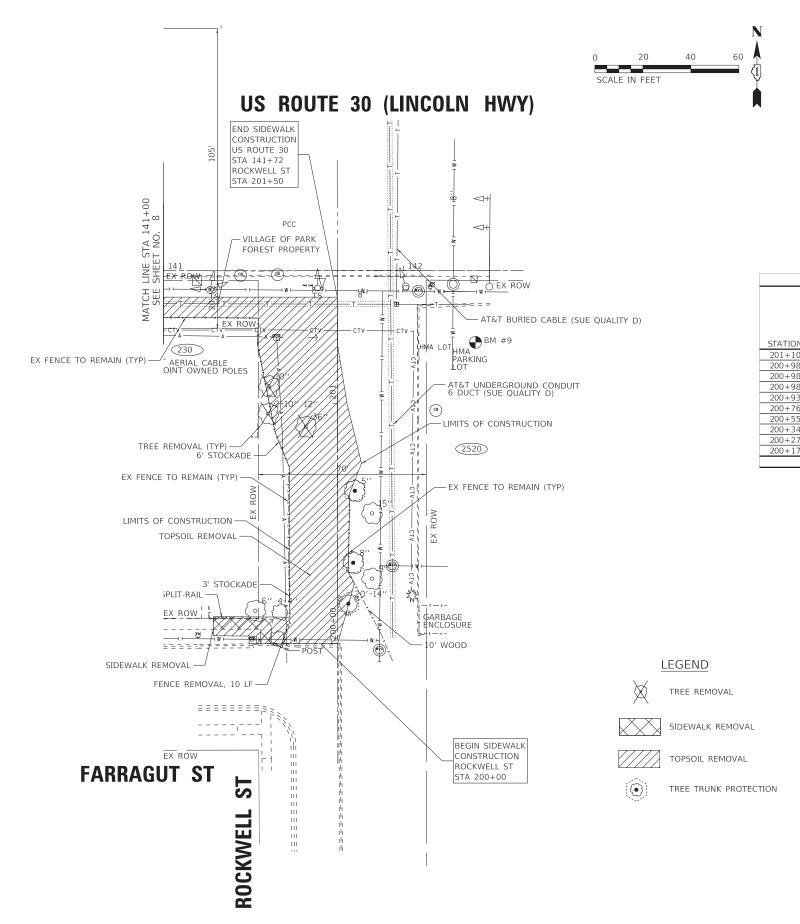

							_	
		TREE	REMOVAL/TREE	ROOT PRUNIN	NG/TREE PRUN	ING SCHEDUL	.E	
				20100110 TREE REMOVAL	20100110 TREE REMOVAL	20101200	20101300	20101350
		Tree Diameter	TREE REMOVAL	(6 TO 15 UNITS DIAMETER)	(6 TO 15 UNITS DIAMETER)	TREE ROOT PRUNING	TREE PRUNING (1 TO 10 INCH DIAMETER)	TREE PRUNING (OVER 10 INCH DIAMETER)
STATION	OFFSET		EACH	UNIT	UNIT	EACH	EACH	EACH
201+10	28.6' LT	10	1	10				
200+98	28.9' LT	10	1	10				
200+98	28.9' LT	10	1	10				
200+98	28.9' LT	12	1	12				
200+93	13.3' LT	36	1		36			
200+76	7.8' RT	5				1	1	
200+55	14.3' RT	15				1		1
200+34	6.4' RT	8				1	1	
200+27	14.3' RT	9				1	1	·
200+17	4.6' RT	14				1	1	
	TOTALS		5	42	36	5	4	1


BAXTER WOODMAN Consulting Engineers


USER NAME = 488cac	DESIGNED - AKS	REVISED -
	DRAWN - CJC	REVISED -
PLOT SCALE = 20.0000 ' / in.	CHECKED - CAC	REVISED -
PLOT DATE = 2/19/2021	DATE - 02-19-21	FILE - 200138-SHT Removal3.dgn


STATE OF ILLINOIS DEPARTMENT OF TRANSPORTATION


EXISTII	NG CON	DITIO	NS AN	ND	REMOV	/AL PLAN	
	US RO	UTE 3	O (LIN	COL	N HW	Y)	-
: 1"=20'	SHEET	OF	SHEETS	STA.	141+00	TO STA. 142+50	


F.A.P. RTE.	SECT	COUNTY		TOTAL SHEETS	SHEE		
353	19-00105-00-SW			COOK		32	9
				CONTRAC	СТ	NO. 6	1G9
		ILLINOIS	FED. A	D PROJECT XC	1F(10	04)	

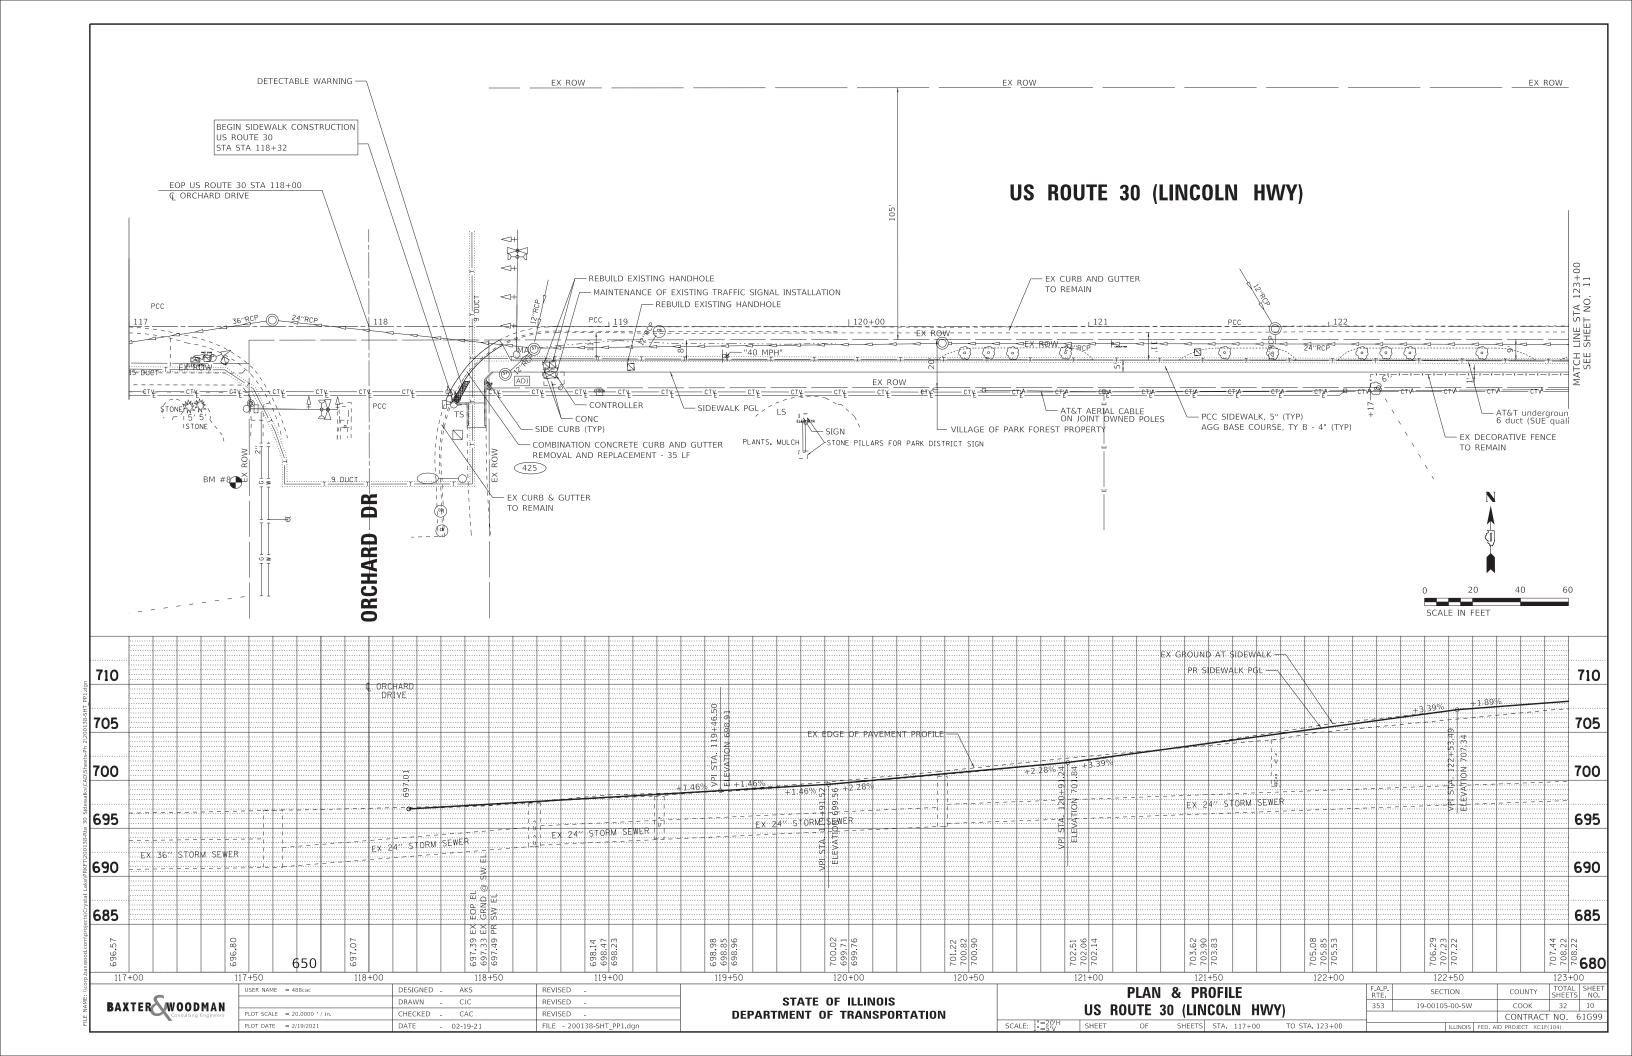


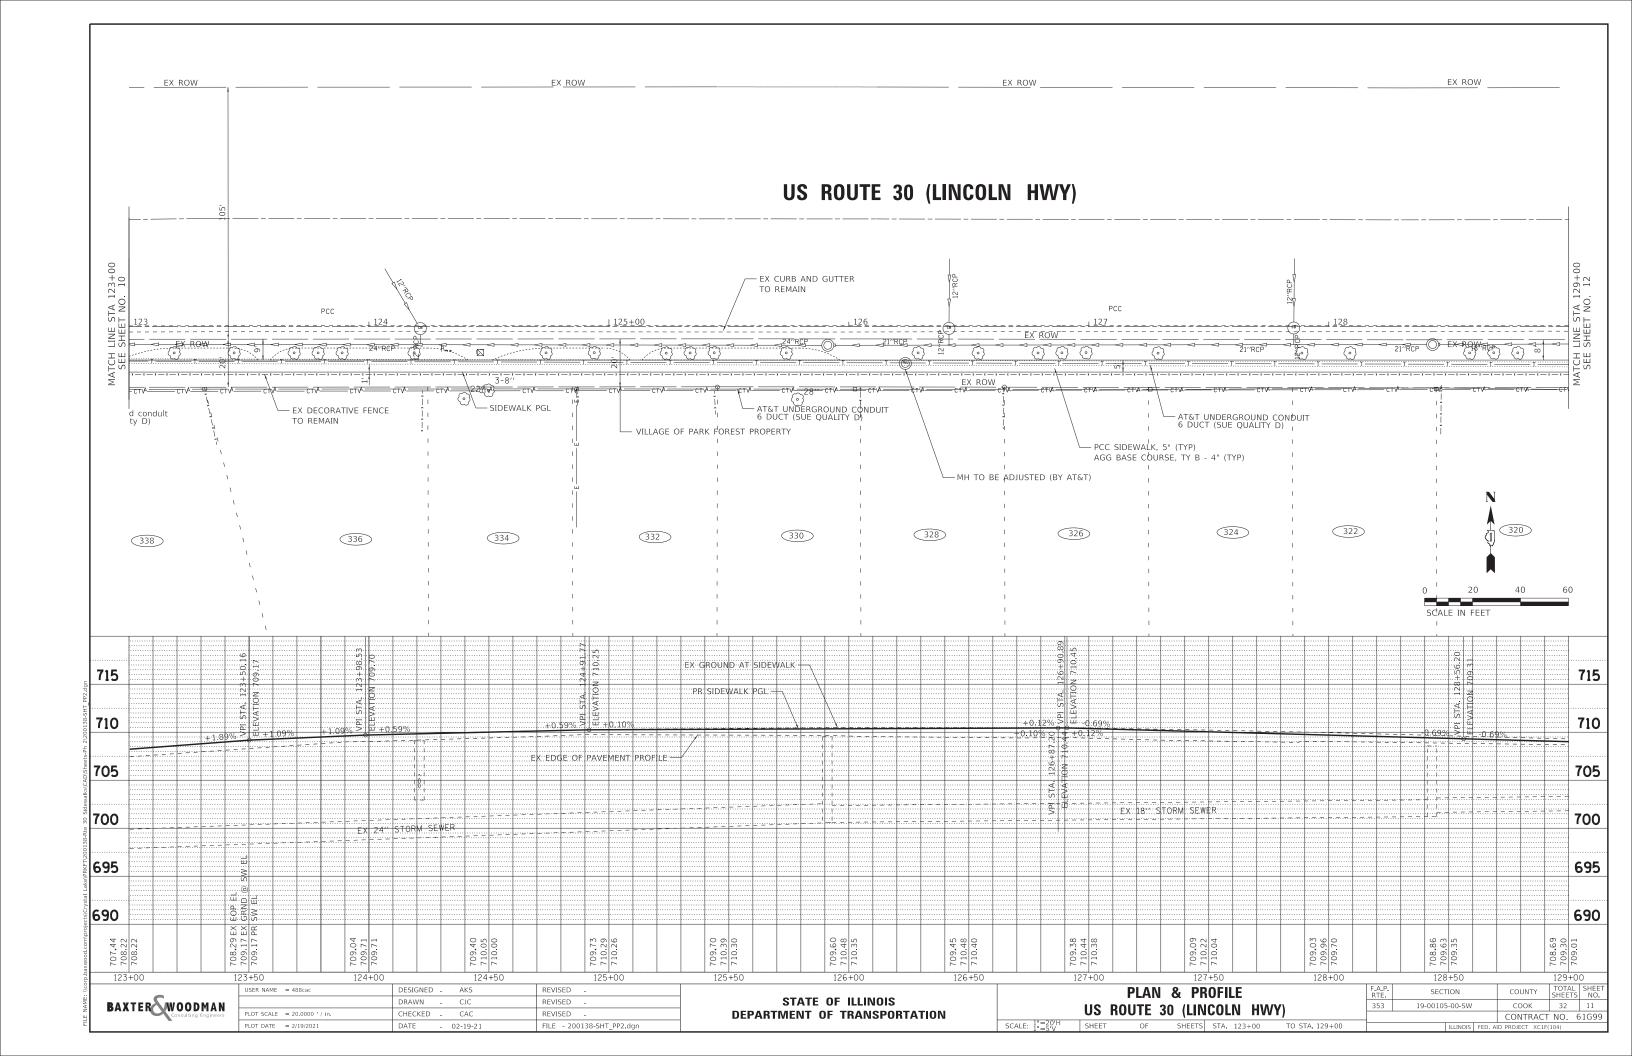


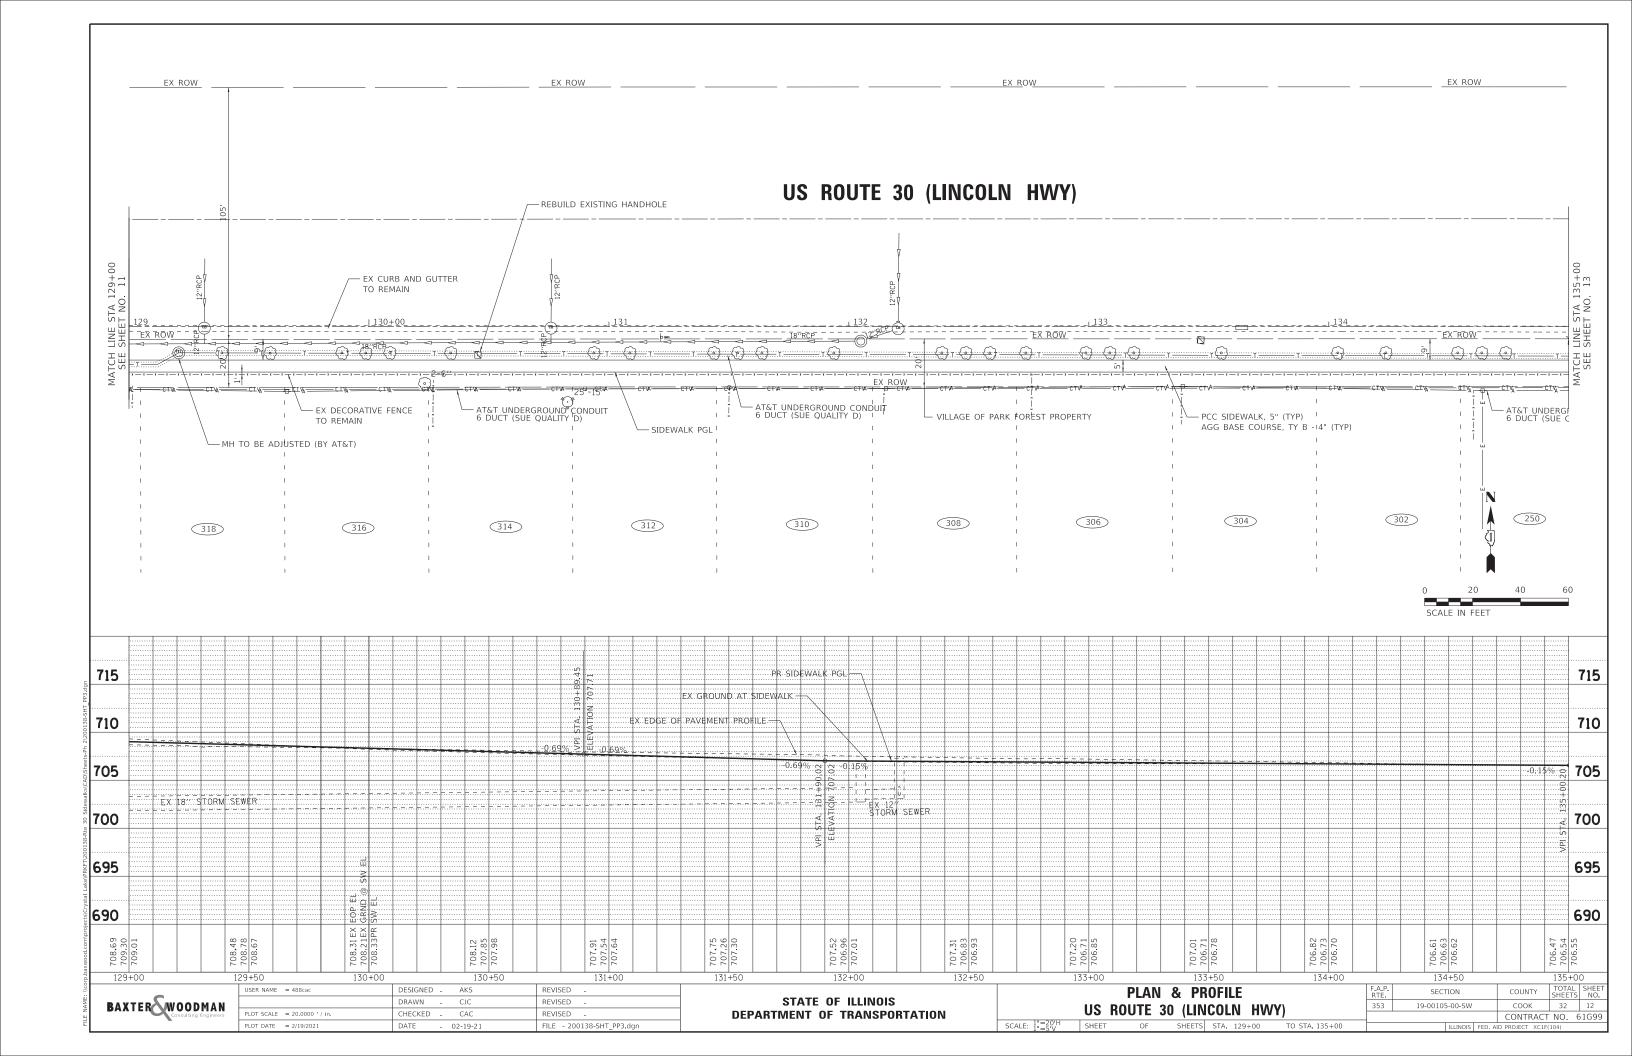


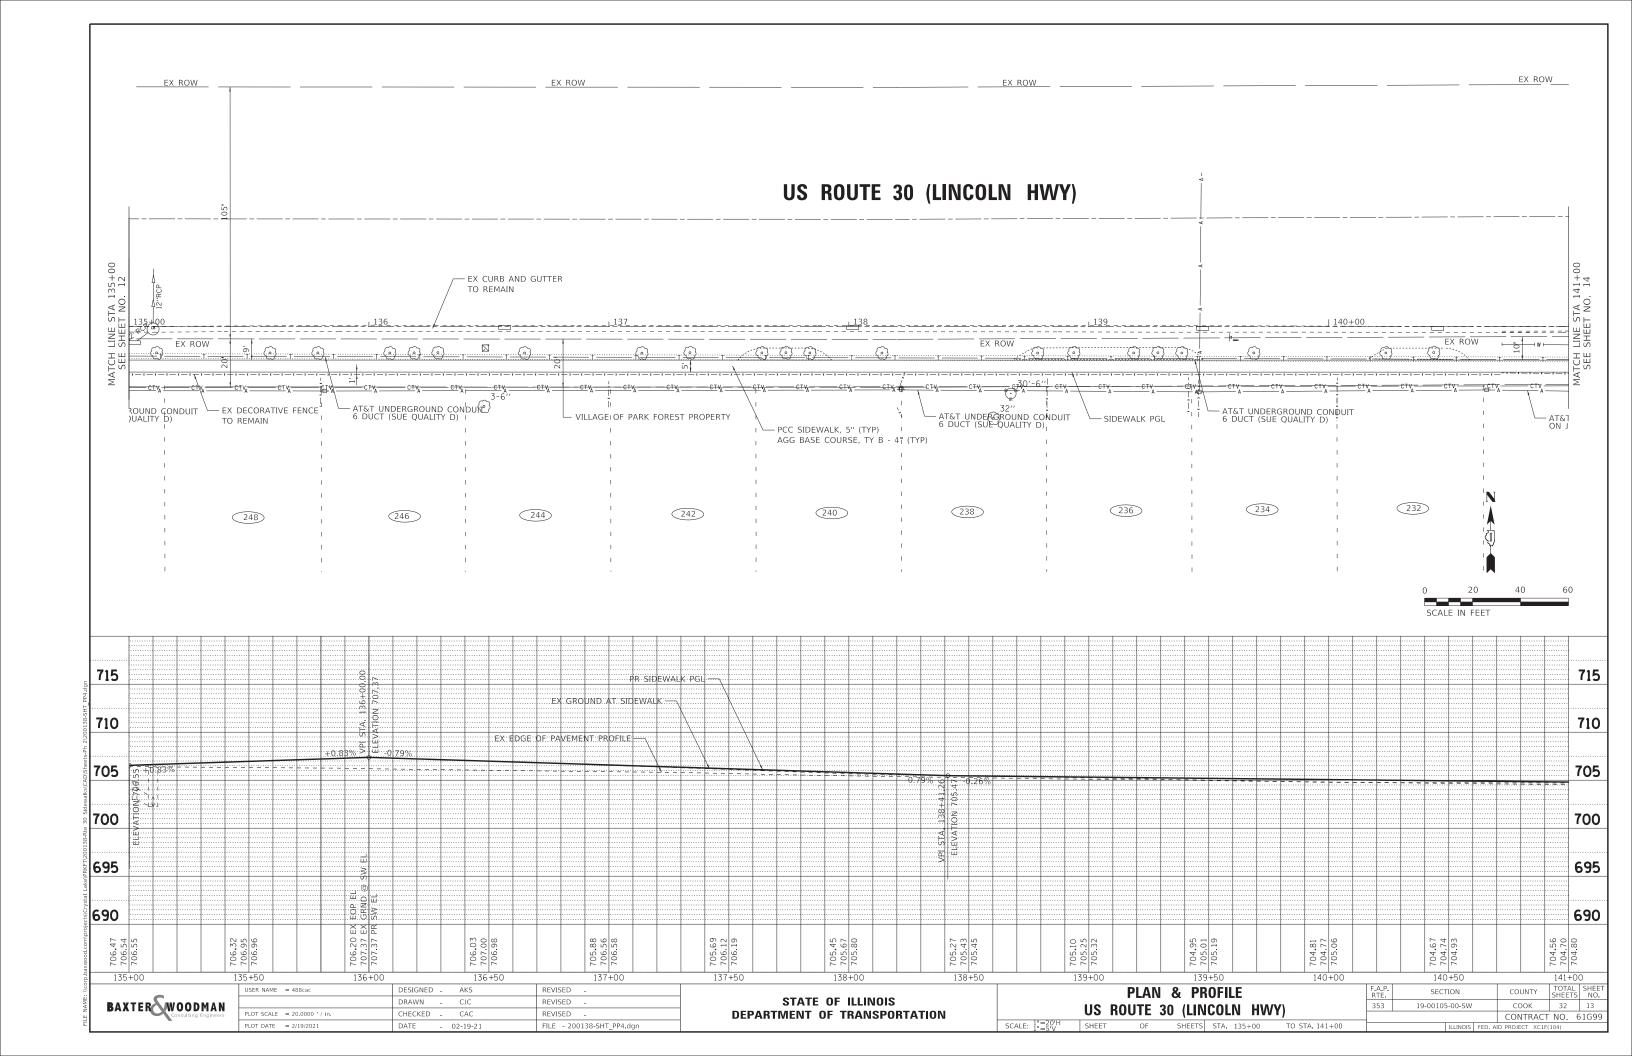

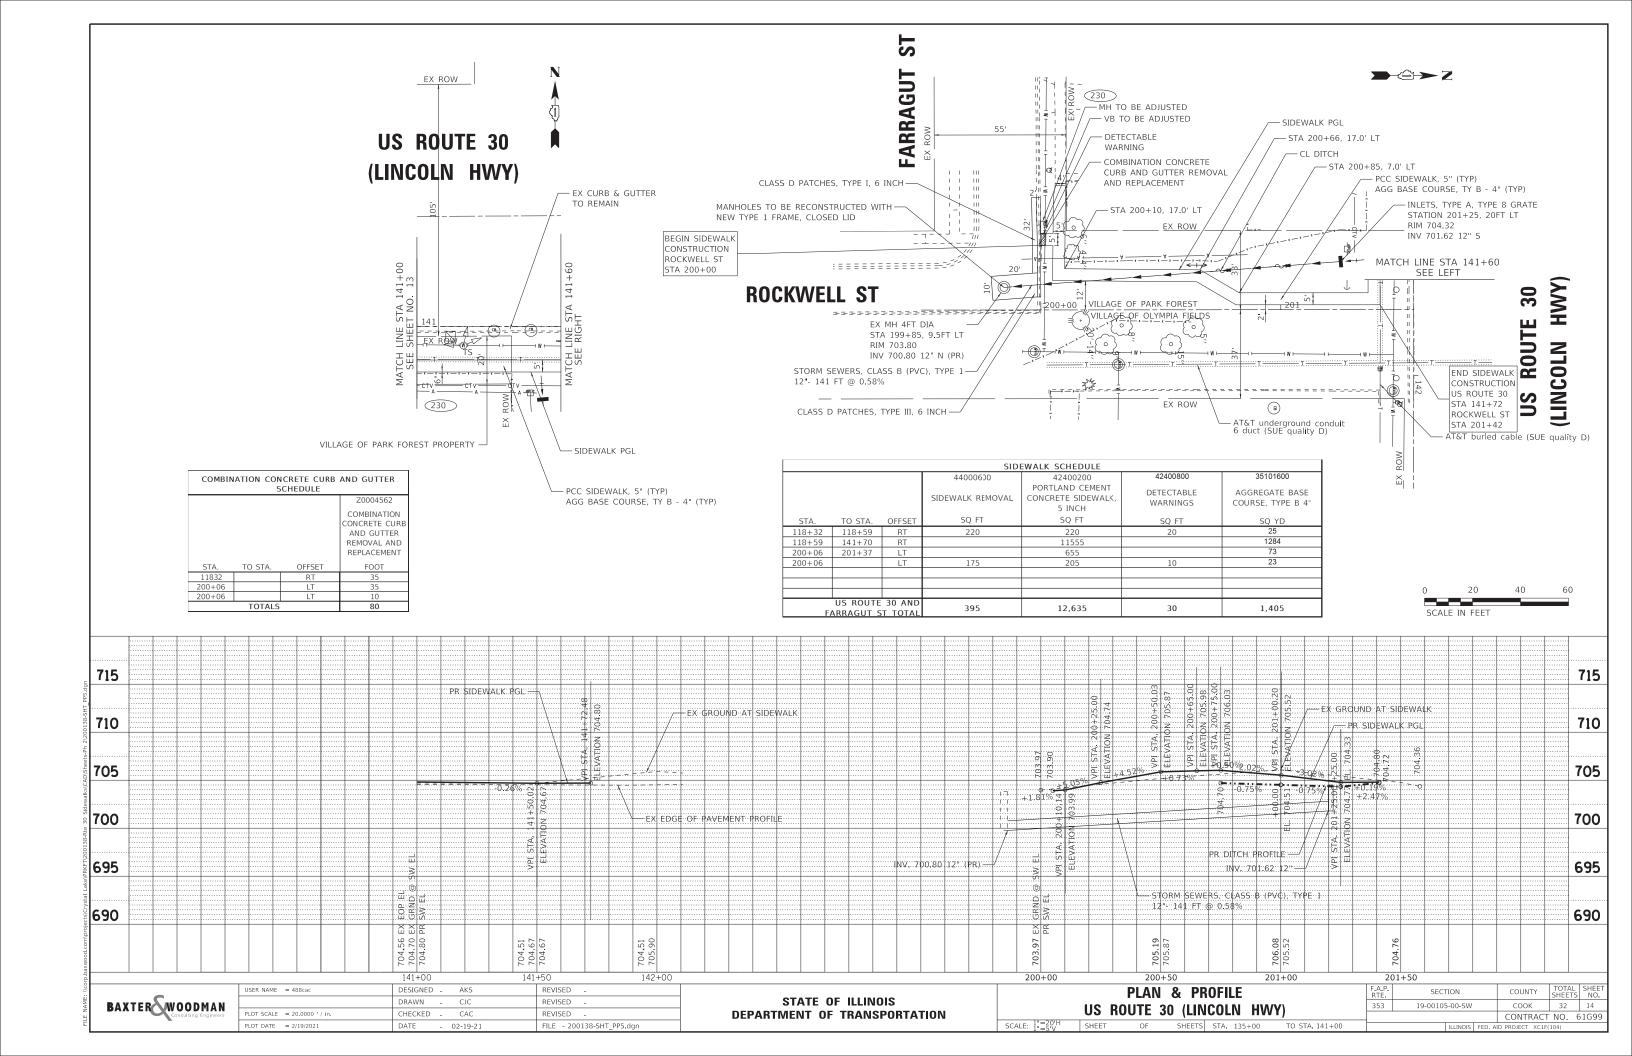

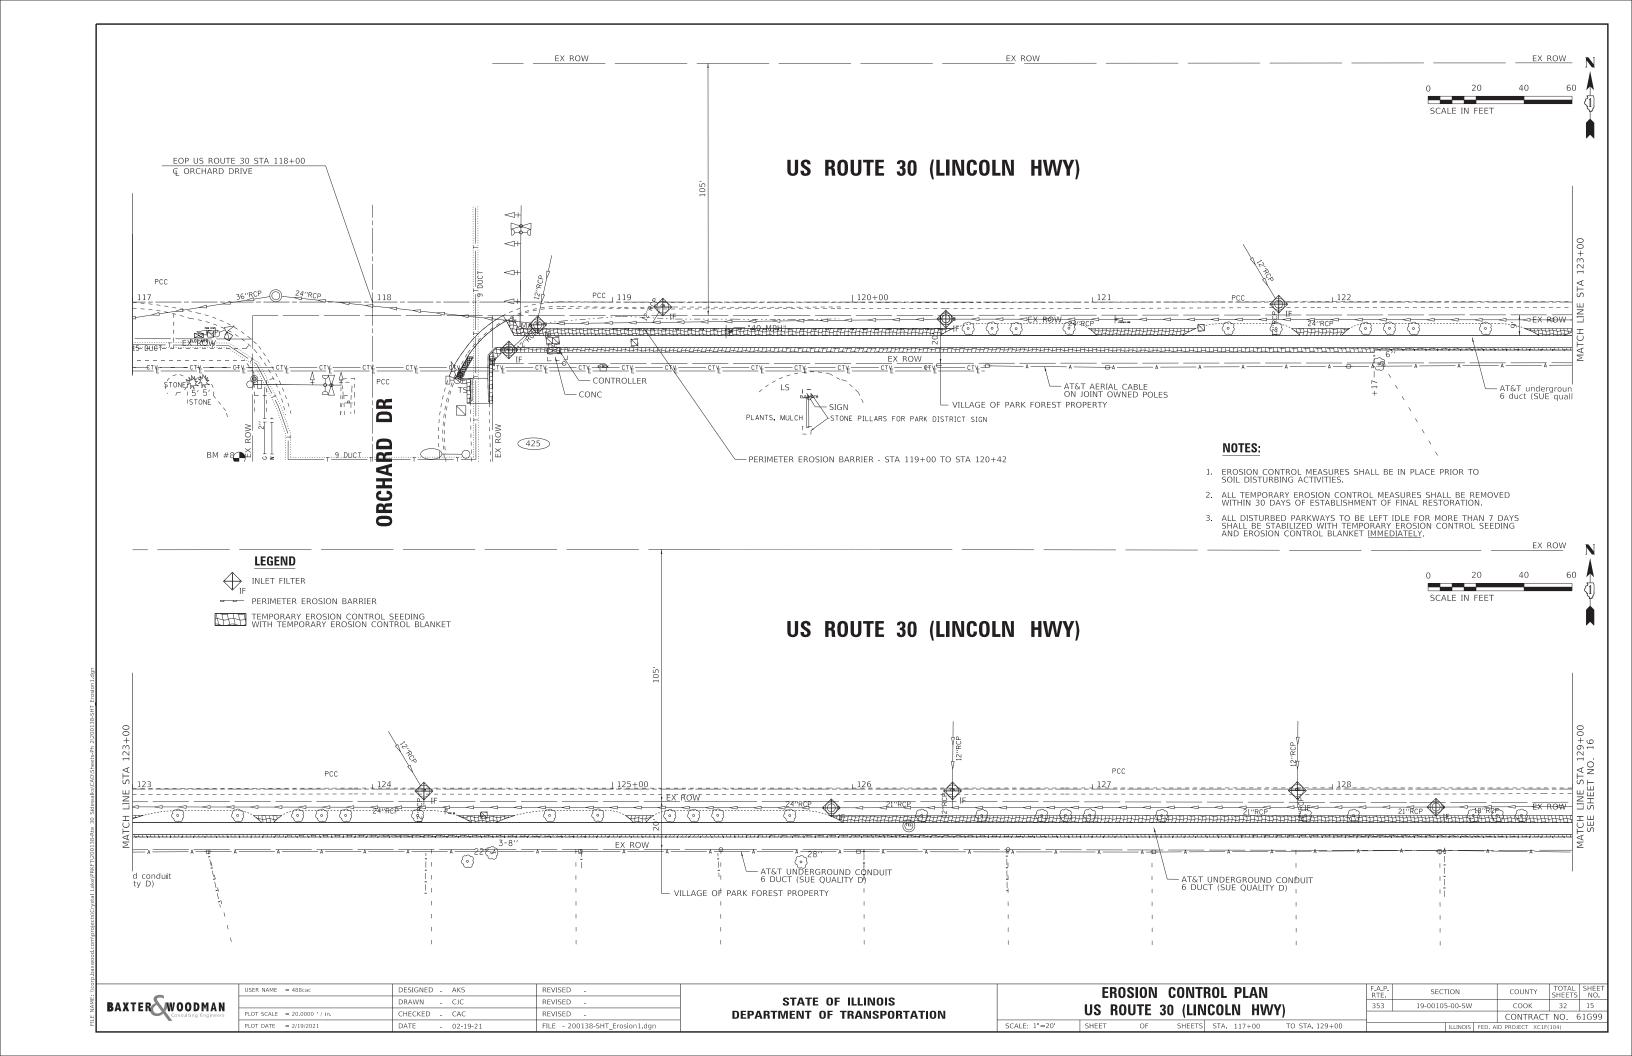

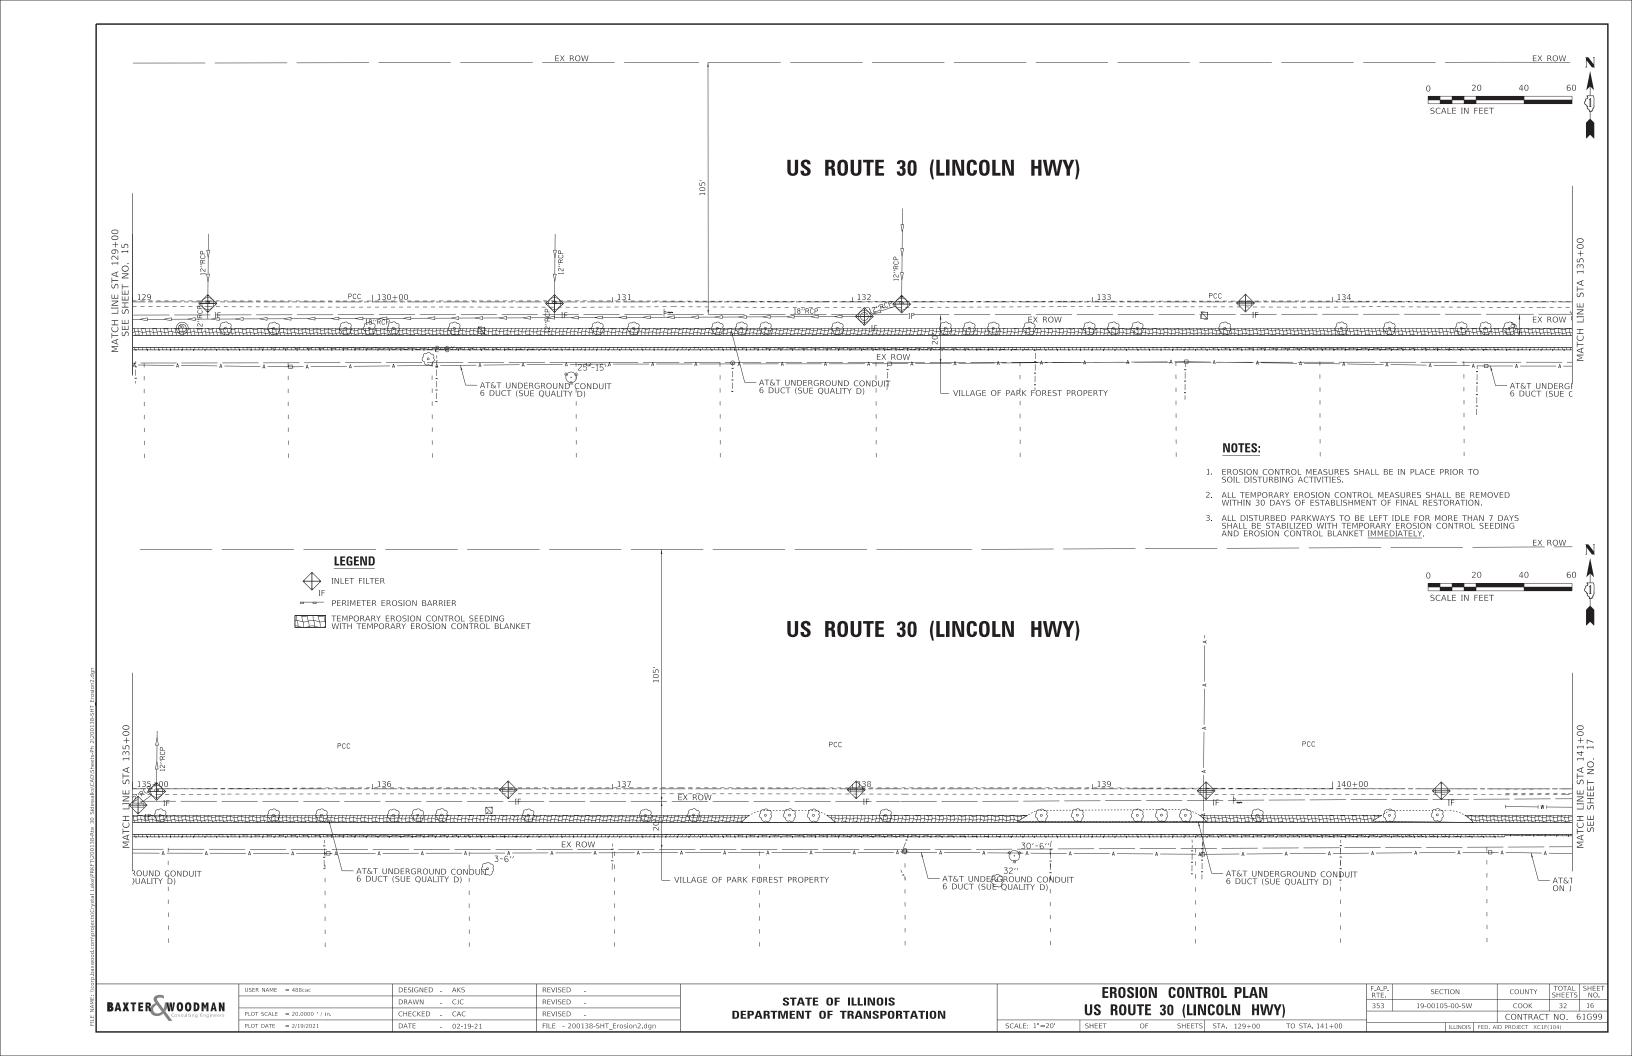

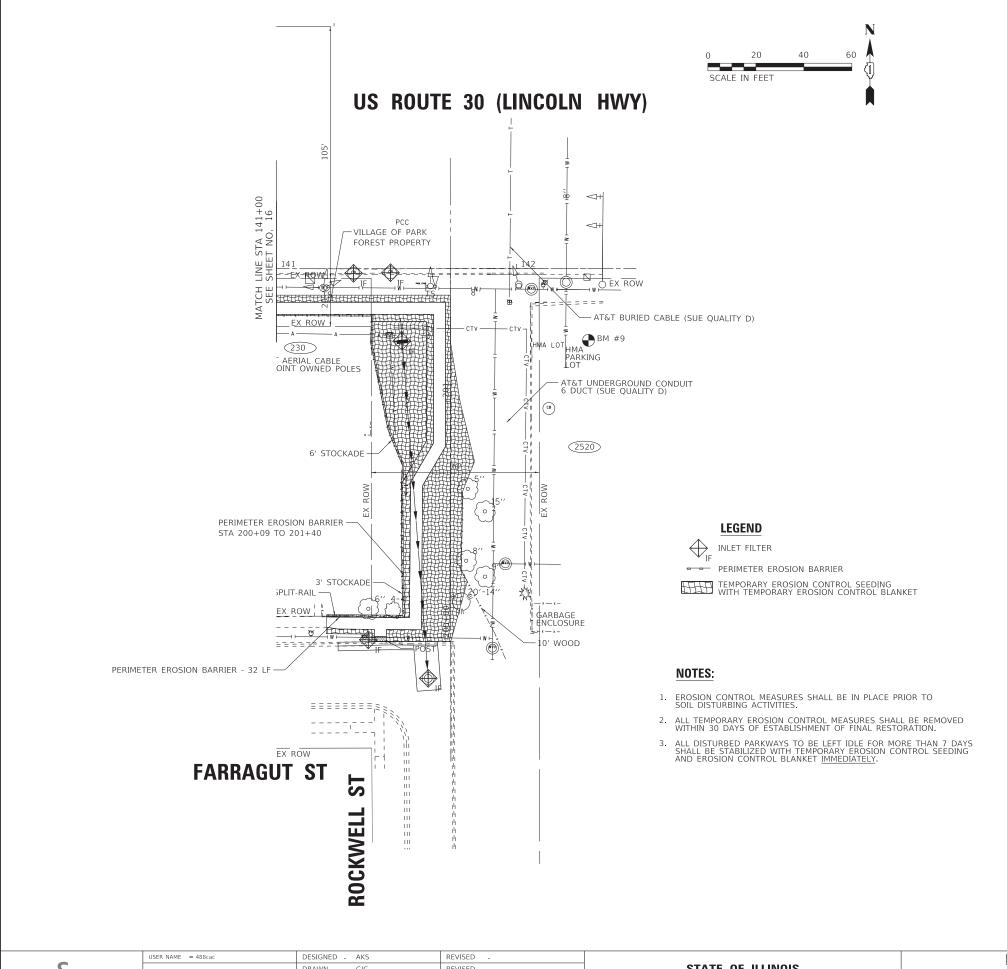



BAXTER WOODMAN Consulting Engineers


USER NAME = 488CBC	DESIGNED - AKS	REVISED -
	DRAWN - CJC	REVISED -
PLOT SCALE = 20.0000 ' / in.	CHECKED - CAC	REVISED -
PLOT DATE = 2/19/2021	DATE - 02-19-21	FILE - 200138-SHT_Erosion3.dgn

EROSION CONTROL PLAN									
	US ROL	JTE 3	0 (LIN	COLN HW	(Y)				
SCALE: 1"=20'	SHEET	OF	SHEETS	STA. 141+00	TO STA. 142+50				

F.A.P. RTE	SECTION		COUNTY	TOTAL SHEETS	SHEET NO.
353	19-00105-00-SW	COOK	32	17	
			CONTRACT	NO. 6	1G99
	THIMOIS	EED A	ID DROJECT VC1E/	104)	

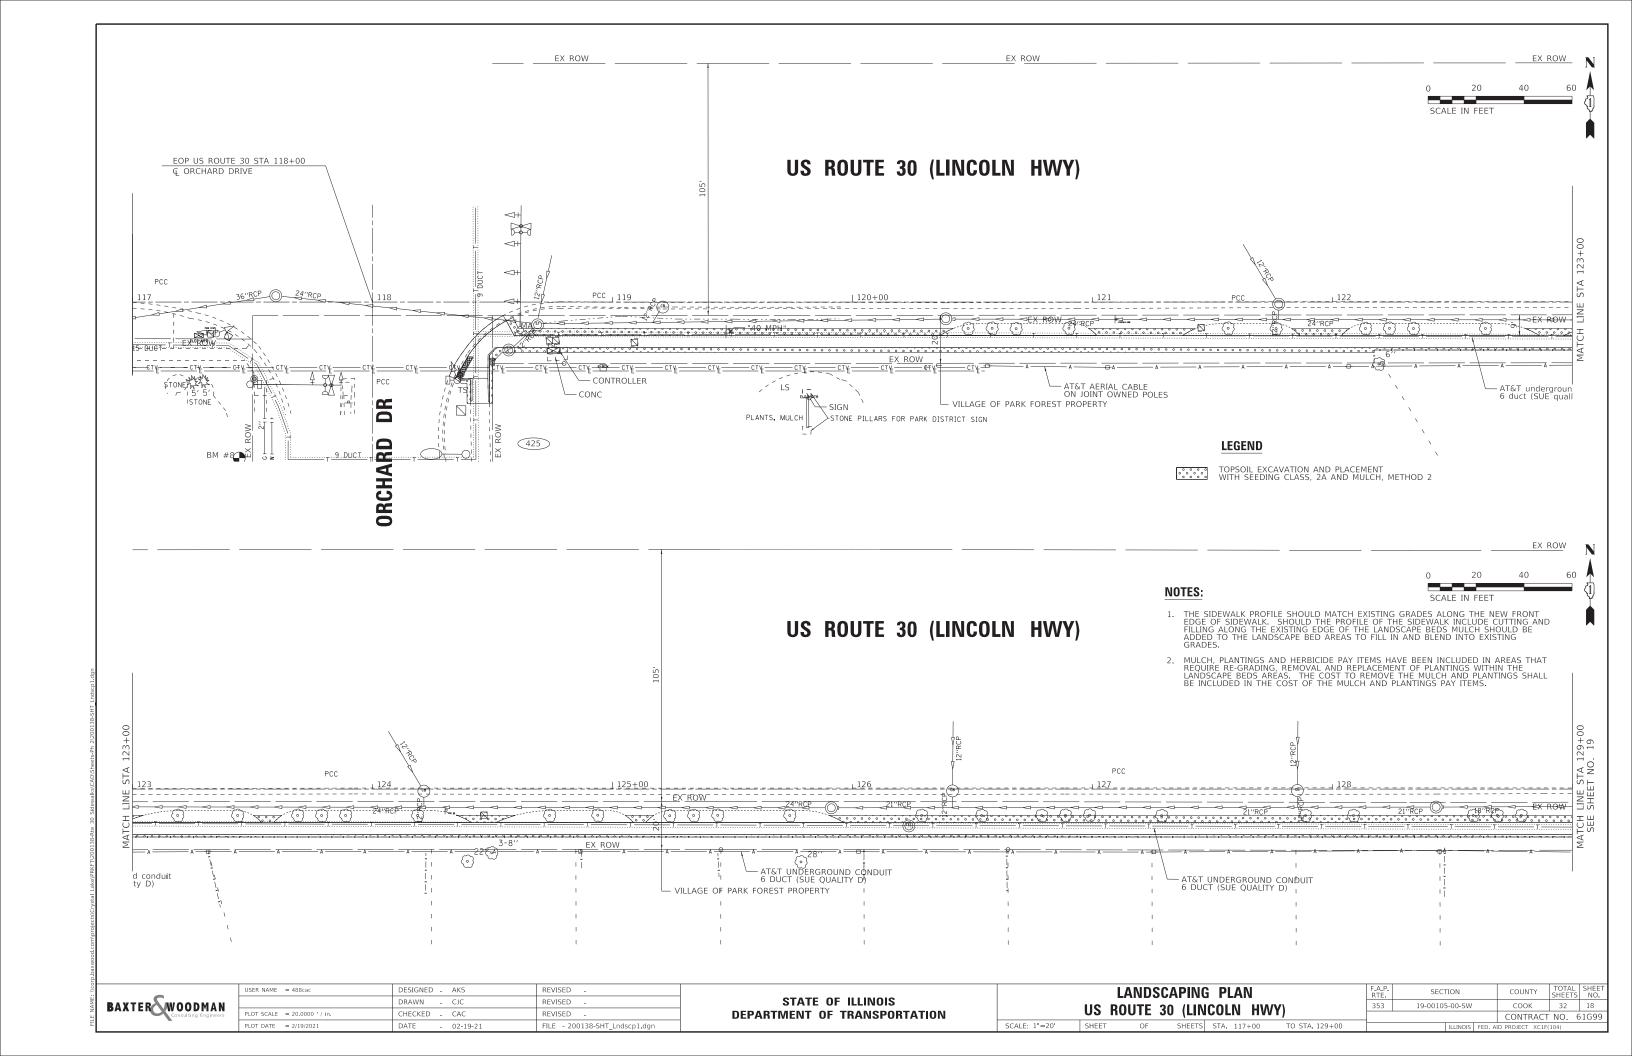

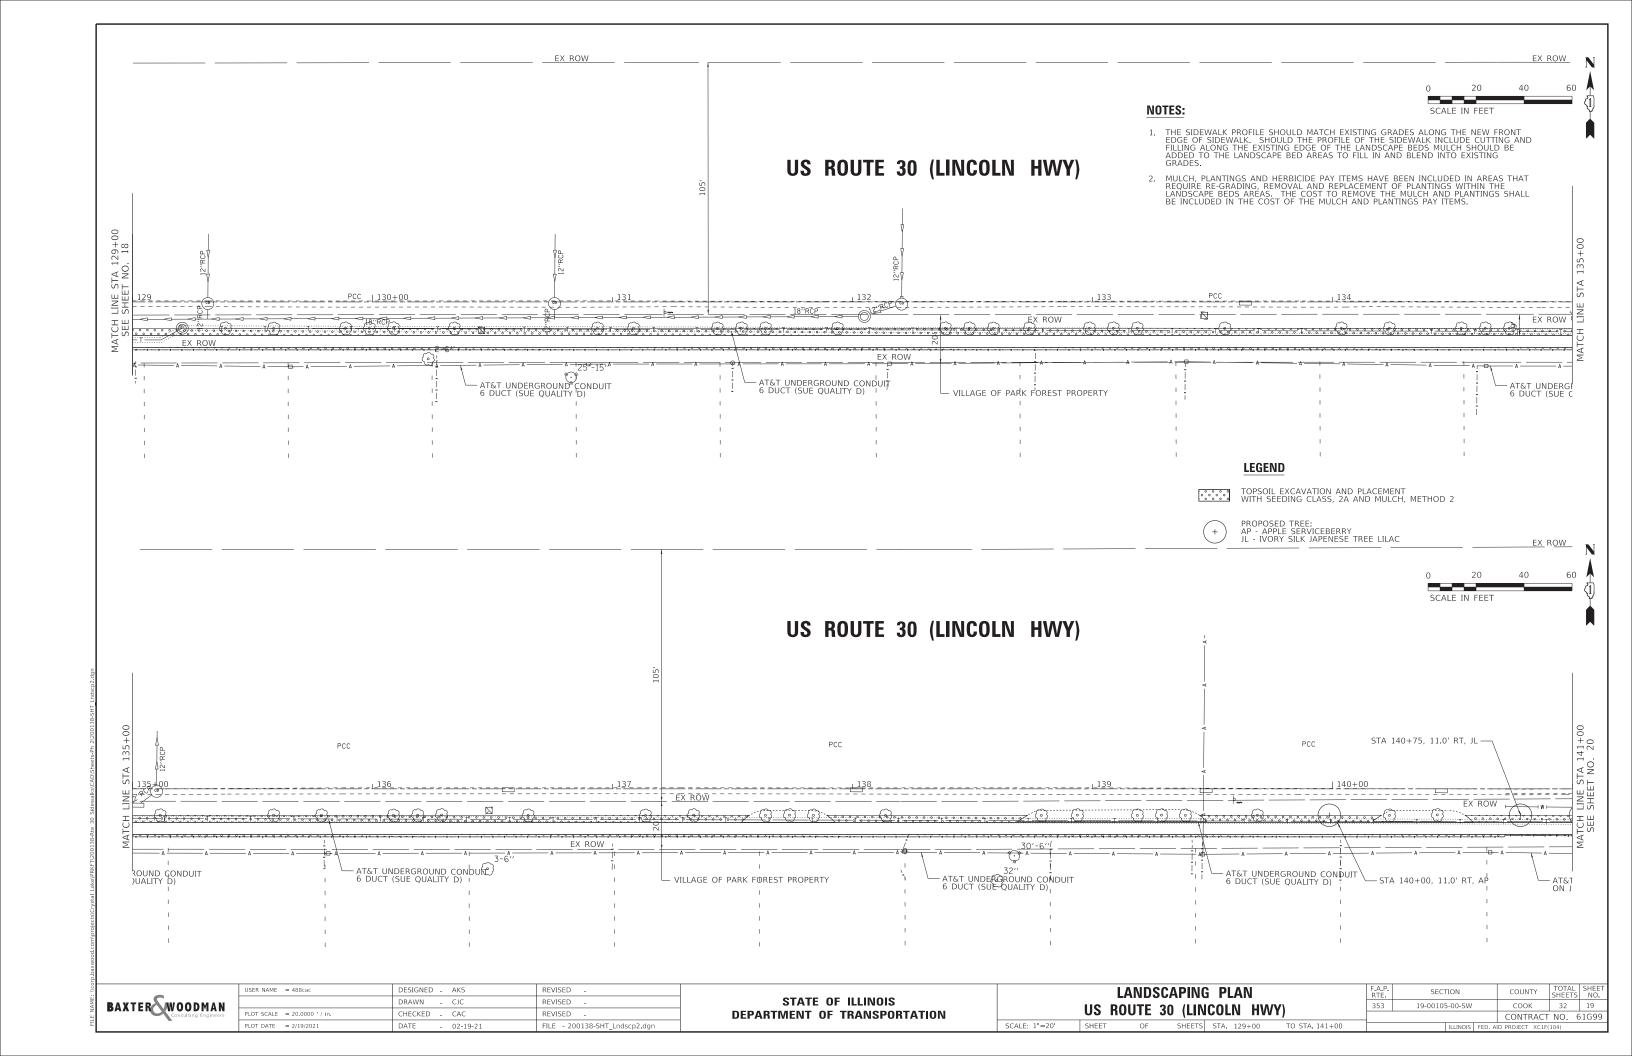

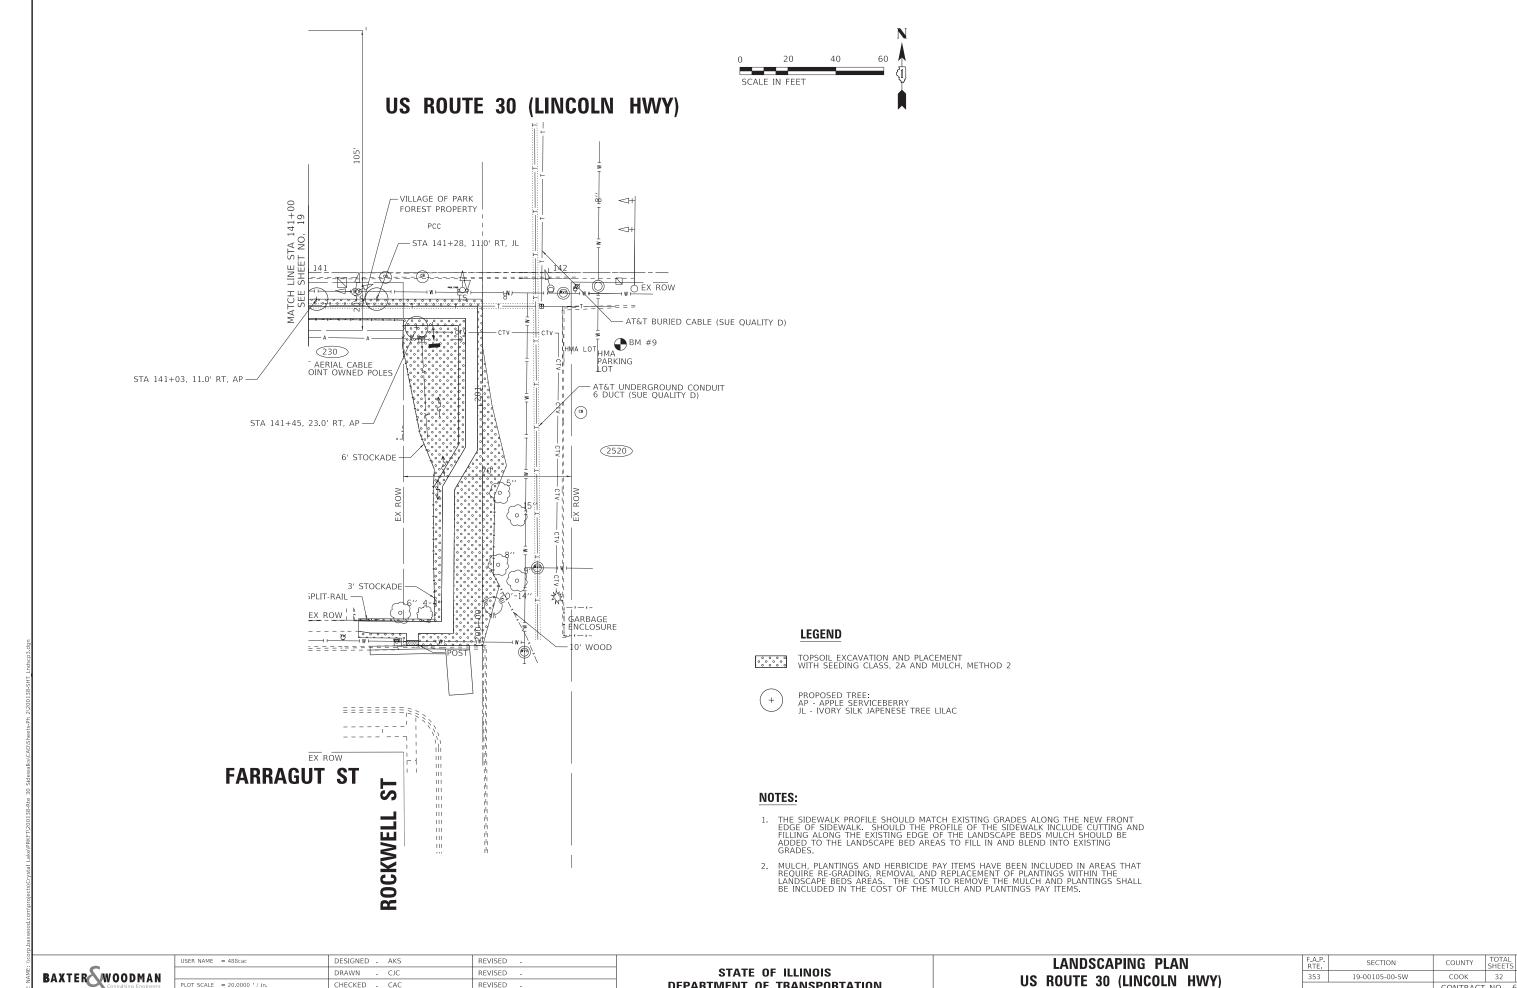



LOT SCALE = 20.0000 ' / in. CHECKED - CAC REVISED PLOT DATE = 2/19/2021 FILE - 200138-SHT Lndscp3.dan


DEPARTMENT OF TRANSPORTATION

US ROUTE 30 (LINCOLN HWY) OF SHEETS STA. 141+00 TO STA. 142+50

32 20 CONTRACT NO. 61G99

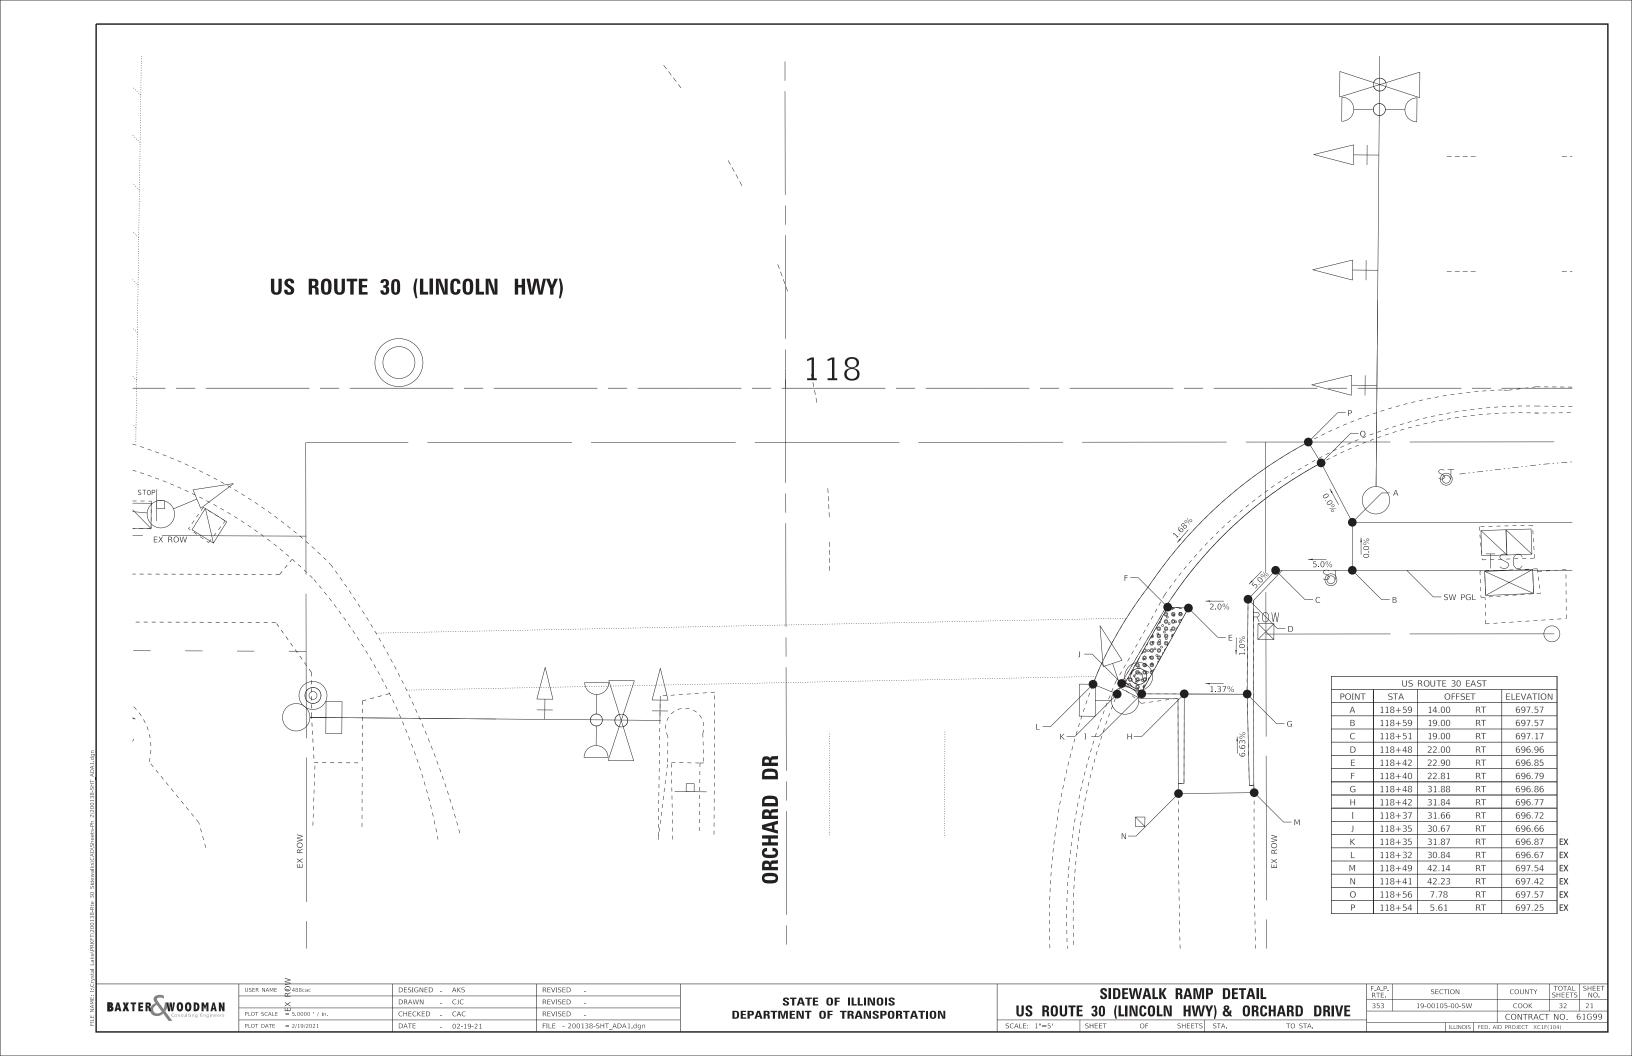

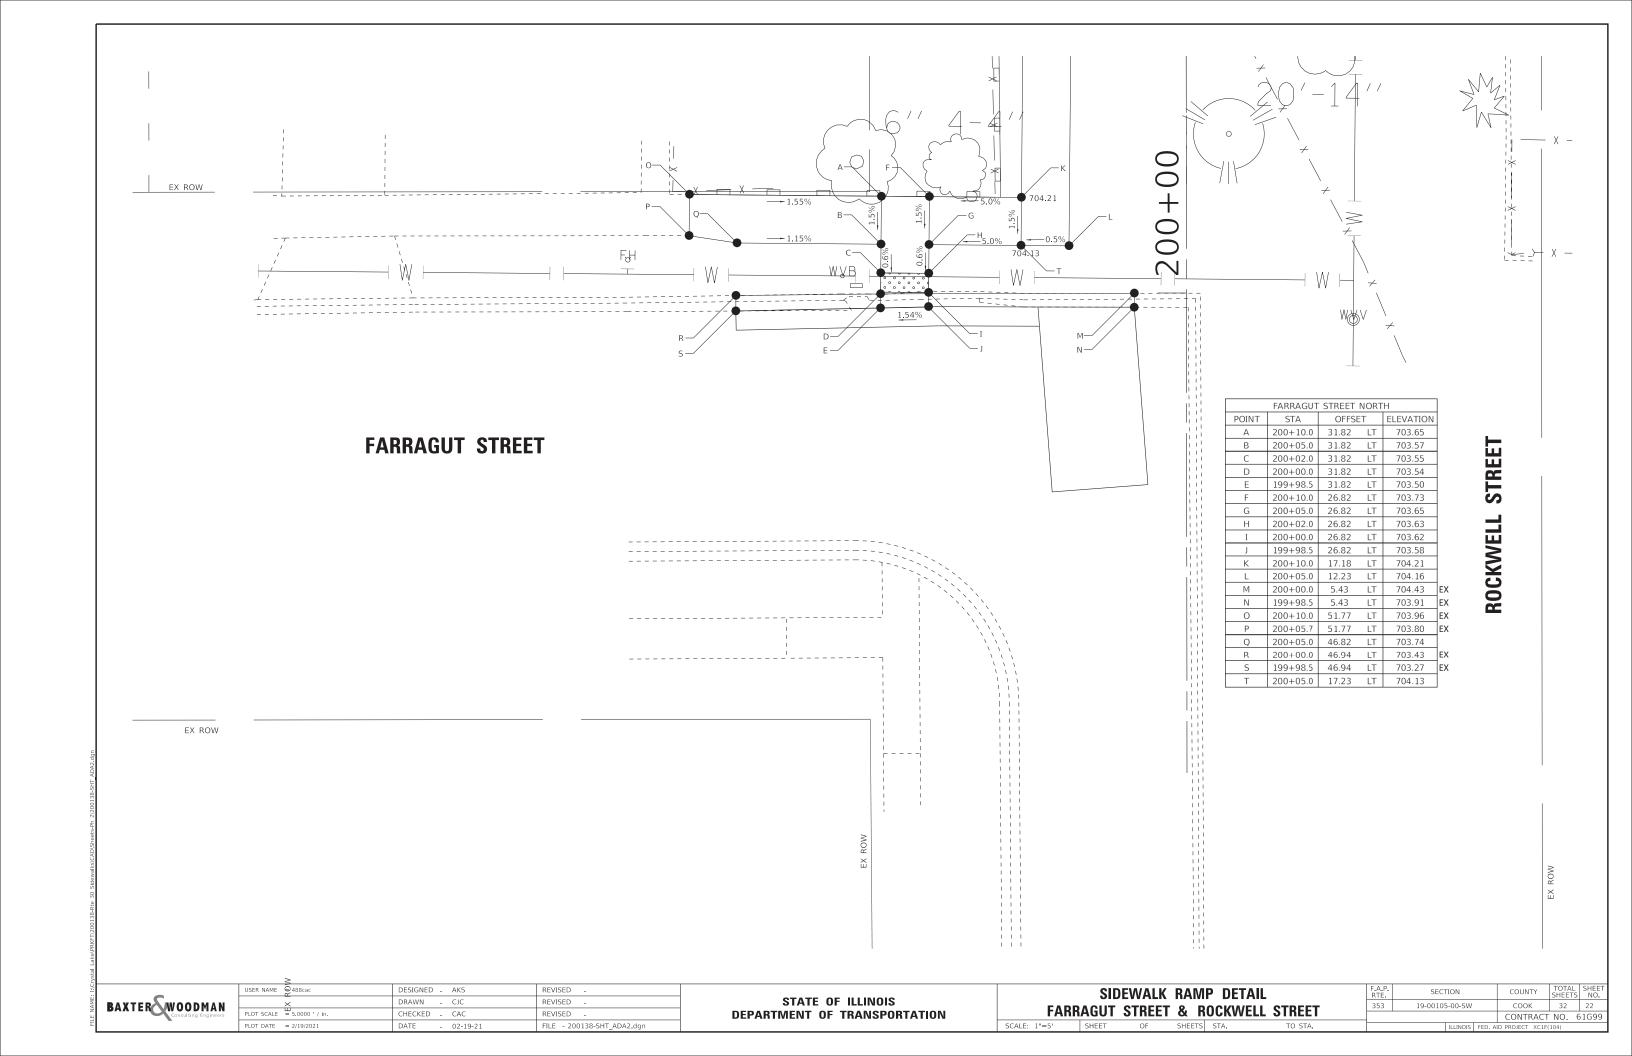

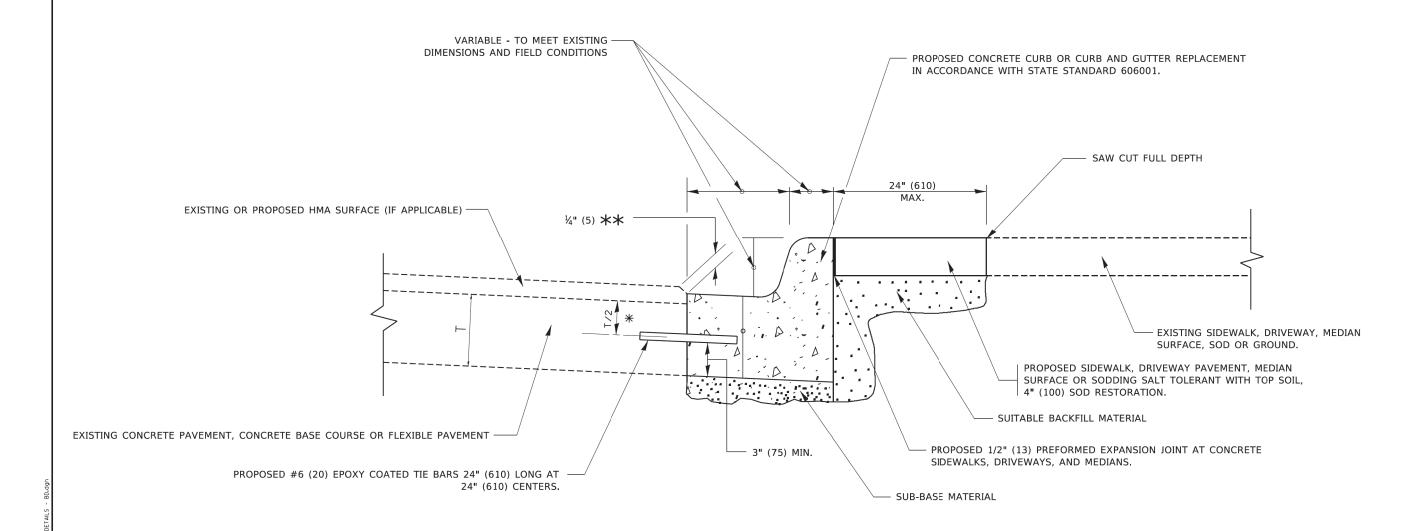


- 🛨 3" (75) MINIMUM FROM TOP AND BOTTOM OF THE CONCRETE PAVEMENT OR BASE COURSE.
- $\star\star$ IF THE FINAL SURFACE OF THE PAVEMENT IS CONCRETE, THE GUTTER IS TO BE FLUSH WITH THE PAVEMENT.

CURB OR CURB AND GUTTER REMOVAL AND REPLACEMENT

ALL DIMENSIONS ARE IN INCHES (MILLIMETERS) UNLESS OTHERWISE SHOWN.

USER NAME = footemj	DESIGNED - A. HOUSEH	REVISED - A. ABBAS 03-21-97			CURB OR CURB AND GUTTER		RTE.	SECTION	COUNTY	SHEET	L SHEE	۱ء ک.
	DRAWN -	REVISED - M. GOMEZ 01-22-01	STATE OF ILLINOIS		REMOVAL AND REPLACEMENT		\$FAU	19-00105-00-SW	СООК	32	23	
PLOT SCALE = 50.0000 ' / in.	CHECKED -	REVISED - R. BORO 12-15-09	DEPARTMENT OF TRANSPORTATION		NEIVIOVAL AND NEPLAGEIVIEIVI			BD600-06 (BD-24)	CONTRAC	T NO. 6	61G99	
PLOT DATE = 7/11/2019	DATE - 03-11-94	REVISED - K. SMITH 07-11-19		SCALE: NONE	SHEET 1 OF 1 SHEETS STA.	TO STA.		ILLINOIS FED	. AID PROJECT XC	C1F(104)		_

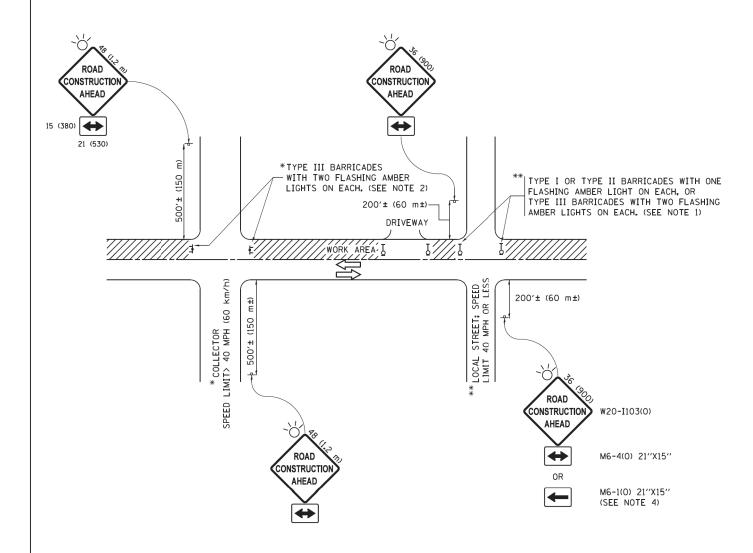

NOTES:

- 1. SIDE ROAD WITH A SPEED LIMIT OF 40 MPH (60 km/h) OR LESS AS SHOWN ON THE DRAWING AND AS DIRECTED BY THE ENGINEER:
 - a) ONE "ROAD CONSTRUCTION AHEAD" SIGN 36 x 36 (900x900) WITH A FLASHER MOUNTED ON IT APPROXIMATELY 200" (60 m) IN ADVANCE OF THE MAIN ROUTE.
 - b) THE CLOSED PORTION OF THE MAIN ROUTE SHALL BE PROTECTED BY BLOCKING WITH TYPE I, TYPE II OR TYPE III BARRICADES, 1/3 OF THE CROSS SECTION OF THE CLOSED PORTION.
- 2. SIDE ROAD WITH A SPEED LIMIT GREATER THAN 40 MPH (60 km/h) AS SHOWN ON THE DRAWING AND AS DIRECTED BY THE ENGINEER:
 - a) ONE "ROAD CONSTRUCTION AHEAD" SIGN 48 \times 48 (1.2 m \times 1.2 m) WITH A FLASHER MOUNTED ON IT APPROXIMATELY 500" (150 m) IN ADVANCE OF THE MAIN ROUTE.
 - b) THE CLOSED PORTION OF THE MAIN ROUTE SHALL BE PROTECTED BY BLOCKING WITH TYPE III BARRICADES, 1/2 OF THE CROSS SECTION OF THE CLOSED FORTION.
- 3. CONES MAY BE SUBSTITUTED FOR BARRICADES OR DRUMS AT HALF THE SPACING DURING DAY OPERATIONS. CONES SHALL BE A MINIMUM OF 28 (710)
- 4. WHEN THE SIDE ROAD LIES BETWEEN THE BEGINNING OF THE MAINLINE SIGNING AND THE WORK ZONE, A SINGLE HEADED ARROW (M6-1) SHALL BE USED IN LIEU OF THE DOUBLE HEADED ARROW (M6-4).

SCALE: NONE

- 5. WHEN WORK IS BEING PERFORMED ON A SIDE ROAD OR DRIVEWAY, FOLLOW THE APPLICABLE STANDARD(S). THE DIRECTIONAL ARROW (M6-1 OR M6-4) SHALL BE COVERED OR REMOVED WHEN NO LONGER CONSISTENT WITH THE TRAFFIC CONTROL SET-UP.
- 6. ADVANCE WARNING SIGNS ARE TO BE OMITTED ON DRIVEWAYS UNLESS OTHERWISE SPECIFIED IN THE PLANS OR BY THE ENGINEER.
- 7. THE TRAFFIC CONTROL AND PROTECTION FOR SIDE ROADS, INTERSECTIONS, AND DRIVEWAYS SHALL BE INCLUDED IN THE COST OF SPECIFIED TRAFFIC CONTROL STANDARDS OR ITEMS.

All dimensions are in inches (millimeters) unless otherwise shown.

	FILE NAME =	USER NAME = footemj	DESIGNED - L.H.A.	REVISED	- A. HOUSEH 10-15-96
	pw:\\IL084EBIDINTEG.:1ll:no:s.gov:PWIDOT\Do	cuments\IDOT Offices\District 1\Projects\Dist	at ∂R‰wn \CADD a ta\CADsheets\tc10.dgn	REVISED	-T. RAMMACHER 01-06-00
98		PLOT SCALE = 50.000 ' / in.	CHECKED -	REVISED	- A. SCHUETZE 07-01-13
488	Default	PLOT DATE = 9/15/2016	DATE - 06-89	REVISED	- A. SCHUETZE 09-15-16

STATE OF	ILLINOIS
DEPARTMENT OF	TRANSPORTATION

TRAFFIC CONTROL AND PROTECTION FOR						F.A. RTE.	SEC
CI	SIDE ROADS, INTERSECTIONS, AND DRIVEWAYS						19-00105
JI	SIDE NUADS, INTENSECTIONS, AND DRIVEWATS						TC-10
	SHEET 1	OF 1	SHEETS	STA.	TO STA.		

| F.A. | SECTION | COUNTY | TOTAL SHEETS | NO SHEETS |

NOTES:

1. USE BLACK LETTERING ON ORANGE BACKGROUND.

SCALE: NONE

- 2. ERECT SIGNS IN ADVANCE OF THE LOCATION FOR THE "ROAD CONSTRUCTION AHEAD" SIGN AT LOCATIONS AS DIRECTED BY THE ENGINEER.
- 3. ERECT SIGN (1) WITH INSTALLED PANEL (2) ONE WEEK PRIOR TO THE START OF CONSTRUCTION.
- 4. REMOVE PANEL (2) SOON AFTER THE START OF CONSTRUCTION.
- 5. SEE SPECIAL PROVISION FOR "TEMPORARY INFORMATION SIGNING" FOR ADDITIONAL INFORMATION.
- 6. ONE SIGN ASSEMBLY EQUALS 25.70 SQ. FT. (2.3 SQ. M.)
- 7. SHALL BE PAID FOR AS TEMPORARY INFORMATION SIGNING.

ALL DIMENSIONS ARE IN INCHES (MILLIMETERS) UNLESS OTHERWISE SHOWN.

FILE NAME =	USER NAME = gaglianobt	DESIGNED -	REVISED - R. MIRS 09-15-97
W:\diststd\22x34\tc22.dgn		DRAWN -	REVISED - R. MIRS 12-11-97
	PLOT SCALE = 50.000 '/ IN.	CHECKED -	REVISED -T. RAMMACHER 02-02-99
	PLOT DATE = 1/4/2008	DATE -	REVISED - C JUCIUS 01-31-07

STATI	E OF	ILLINOIS
DEPARTMENT	OF	TRANSPORTATION

	7.11.7-11.11.2			F.A RTE.	SECTION	COUNTY	TOTAL SHEETS	SHEE1 NO.	
					\$FAU	19-00105-00-SW	COOK	32	25
	INFURMATION SIGN					TC-22	CONTRACT	NO. 610	399
E	SHEET NO. 1 OF 1 SI	HEETS	STA.	TO STA.	FED. RO	DAD DIST. NO. 1 ILLINOIS FED. AL	D PROJECT XC1	F(104)	

