FOR INDEX OF SHEETS, SEE SHEET NO. 2 FOR LIST OF HIGHWAY STANDARDS SEE SHEET NO. 2

04/23/2021 LETTING ITEM 004

STATE OF ILLINOIS

| F.AU | SECTION | COURTY | STAR SHEET | RILE | SECTION | COURTY | STAR SHEET | RILE |

HIGHWAY CLASSIFICATION
PARK BOULEVARD - MAJOR COLLECTOR

TRAFFIC DATA PARK BOULEVARD 2016 ADT = 4,650


POSTED SPEED LIMIT PARK BOULEVARD = 25 MPH

DESIGN SPEED LIMIT PARK BOULEVARD = 25 MPH

DEPARTMENT OF TRANSPORTATION PLANS FOR PROPOSED FEDERAL AID HIGHWAY

FAU 2958 (PARK BOULEVARD) FROM FAU 1321 (IRVING PARK ROAD — IL 19) TO FROM FAU 1322 (SCHAUMBURG ROAD) RESURFACING

> SECTION: 15-00063-00-RS PROJECT NO.: UN5W(157) **VILLAGE OF STREAMWOOD COOK COUNTY**

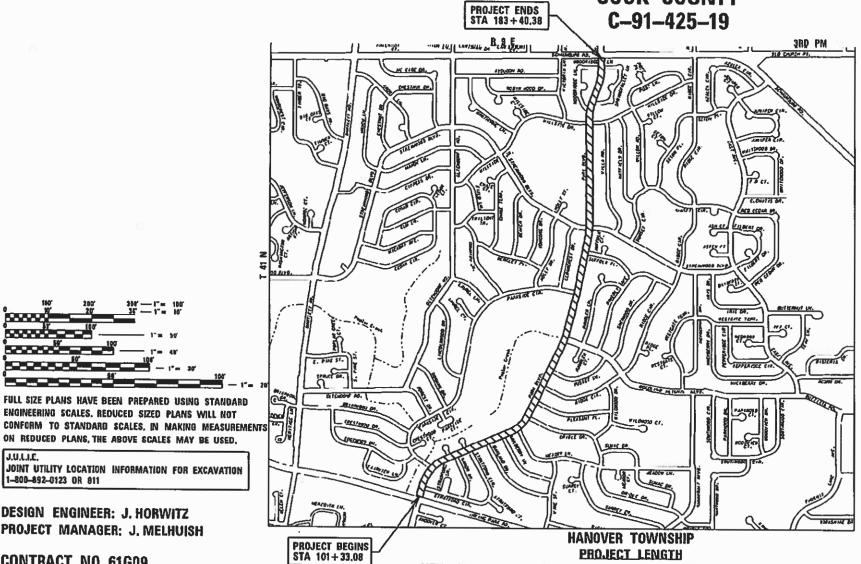



PROJECT LOCATION MAP

N.T.S.





420 NORTH FRONT STREET, SUITE 100 | MCHCNRY, ILLIHOIS 50050 815.385,1778 | TOB Free: 800,128,7605 | Pax: 819.385,1781 | HRGree ILLINOIS PROFESSIONAL DESIGN FIRM #184-001122

MARCH 23 20 21

PRINTED BY THE AUTHORITY OF THE STATE OF ILLINOIS

J.U.L.I.E. JOINT UTILITY LOCATION INFORMATION FOR EXCAVATION 1-800-892-0123 OR 811

DESIGN ENGINEER: J. HORWITZ PROJECT MANAGER: J. MELHUISH

CONTRACT NO. 61G09

NET AND GROSS LENGTH OF PROJECT = 8,290 FT. = 1.57 MILES

0

0

0

0

INDEX OF SHEETS

1	COVER	SHEET

INDEX OF SHEETS, STATE STANDARDS, DISTRICT ONE DETAILS AND GENERAL NOTES

SUMMARY OF QUANTITIES

TYPICAL SECTIONS

8 - 11 REMOVAL PLANS

12 - 15 RESURFACING PLANS 16 - 21 INTERSECTION PLANS

22 VILLAGE OF STREAMWOOD DETAILS

23 - 30 DISTRICT ONE DETAILS

STATE STANDARDS

STANDARD NO.	LIST OF DESCRIPTION
000001-08	STANDARD SYMBOLS, ABBREVIATIONS AND PATTERNS
420001-09	PAVEMENT JOINTS
424001-11	PERPENDICULAR CURB RAMPS FOR SIDEWALKS
424021-06	DEPRESSED CORNER FOR SIDEWALKS
424026-03	ENTRANCE / ALLEY PEDESTRIAN CROSSINGS
442201-03	CLASS C AND D PATCHES
701101-05	OFF-RD OPERATIONS, MULTILANE, 15' (4.5 m) TO 24" (600 mm) FROM PAVEMENT EDGE
701427-05	LANE CLOSURE, MULTILANE INTERMITTENT OR MOVING OPER., FOR SPEEDS < 40 MPH
701601-09	URBAN LANE CLOSURE, MULTILANE, 1W OR 2W WITH NONTRAVERSABLE MEDIAN
701701-10	URBAN LANE CLOSURE, MULTILANE INTERSECTION
701801-06	SIDEWALK, CORNER OR CROSSWALK CLOSURE
701901-08	TRAFFIC CONTROL DEVICES
780001-05	TYPICAL PAVEMENT MARKINGS

DISTRICT ONE DETAILS

<u>IA1</u>	<u>IDARD NO.</u>	LIST OF DESCRIPTION
	BD-08	DETAILS FOR FRAMES AND LIDS ADJUSTMENT WITH MILLING
	BD-22	PAVEMENT PATCHING FOR HMA SURFACED PAVEMENT
	BD-24	CURB OR CURB AND GUTTER REMOVAL AND REPLACEMENT
	BD-32	BUTT JOINT AND HMA TAPER DETAILS
	TC-10	TRAFFIC CONTROL AND PROTECTION FOR SIDE ROADS, INTERSECTIONS, AND DRIVEWAYS $% \left(1\right) =\left(1\right) \left(1\right$
	TC-13	DISTRICT ONE TYPICAL PAVEMENT MARKINGS
	TC-16	SHORT TERM PAVEMENT MARKING LETTERS AND SYMBOLS
	TC-22	ARTERIAL ROAD INFORMATION SIGN

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USER NAME = dstancz	DESIGNED - JRM	REVISED - XX/XX/XXXX	
	DRAWN - DMS	REVISED - XX/XX/XXXX	
PLOT SCALE =	CHECKED -	REVISED - XX/XX/XXXX	
PLOT DATE = 2/5/2021	DATE -	REVISED - XX/XX/XXXX	

GENERAL NOTES

- ALL REFERENCES TO "STANDARD SPECIFICATIONS" IN THESE GENERAL NOTES SHALL BE INTERPRETED TO MEAN "STANDARD SPECIFICATIONS FOR ROAD AND BRIDGE CONSTRUCTION" ADOPTED BY THE ILLINOIS DEPARTMENT OF TRANSPORTATION, APRIL 1, 2016. ALL WORK TO BE COMPLETED IN ACCORDANCE WITH THE STANDARD SPECIFICATIONS.
- BEFORE STARTING ANY EXCAVATION, THE CONTRACTOR SHALL CALL "JULIE" (JOINT UTILITY LOCATION INFORMATION FOR EXCAVATION) AT 8-1-1 FOR FIELD LOCATIONS OF BURIED UTILITIES (48 HOURS NOTIFICATION IS REQUIRED).
- 3. ALL ELEVATIONS SHOWN ON THE PLANS ARE ON THE NAVD 88 DATUM.
- 4. OFFSET LOCATIONS GIVEN IN THE PLANS FOR STRUCTURES, EDGE OF PAVEMENT, ETC. ARE FROM THE
- SAW CUTTING OF PAVEMENTS, CURB AND GUTTER, SIDEWALK, ETC. SHALL BE TO FULL DEPTH AND SHALL RESULT IN A CLEAN STRAIGHT EDGE ON THE PORTION REMAINING.
- MATERIALS RESULTING FROM THE REMOVAL OF ASPHALT SURFACES, CONCRETE REMOVAL, UTILITY STRUCTURE ADJUSTMENTS, GRADING WORK, ETC. SHALL BE REMOVED AT THE END OF EACH DAY TO AN APPROVED SITE. IN THE JUDGEMENT OF THE ENGINEER, SHOULD IT BE NECESSARY TO REMOVE SUCH
- 7. SIDEWALK REMOVAL AND REPLACEMENT, DRIVEWAY REMOVAL AND REPLACEMENT, AND COMBINATION CONCRETE CURB AND GUTTER REMOVAL AND REPLACEMENT AS SHOWN ON THE PLANS IS FOR INFORMATIONAL PURPOSES ONLY. ACTUAL LOCATIONS AND QUANTITIES TO BE DETERMINED AND MARKED BY THE ENGINEER PRIOR TO CONSTRUCTION
- 8. RESURFACING ALONG PARK BOULEVARD SHALL BE DONE IN ONE PASS.

STORM SEWERS, WATER MAINS, AND UTILITIES

- THE CONTRACTOR SHALL BE RESPONSIBLE FOR CONTACTING THE OWNERS OF ALL UTILITIES PRIOR TO CONSTRUCTION TO DETERMINE THE LOCATION OF ALL UTILITY EQUIPMENT. THE CONTRACTOR SHALL COOPERATE WITH ALL UTILITY OWNERS IN ACCORDANCE WITH THE STANDARD SPECIFICATIONS IF UTILITY RELOCATION, ADJUSTMENT, OR PROTECTION IS NECESSARY.
- 2. THE LOCATION OF EXISTING DRAINAGE STRUCTURES, STORM SEWERS, WATER MAINS, SANITARY SEWERS, AND ANY OTHER PUBLIC OR PRIVATE UTILITIES AS SHOWN ON THE PLANS IS APPROXIMATE AND THEIR EXACT LOCATION IS TO BE DETERMINED IN THE FIELD BY THE CONTRACTOR.
- THE CONTRACTOR SHALL BE RESPONSIBLE FOR THE PROTECTION OF ALL UNDERGROUND AND SURFACE UTILITIES EVEN THOUGH THEY MIGHT NOT BE SHOWN ON THE PLANS.
- THE CONTRACTOR SHALL USE ALL NECESSARY PRECAUTIONS AND PROTECTION MEASURES REQUIRED TO MAINTAIN EXISTING UTILITIES, SEWERS, AND APPURTENANCES THAT MUST BE KEPT IN OPERATION.
- ANY LOOSE MATERIAL DEPOSITED IN THE FLOW LINE OF DRAINAGE STRUCTURES, WHICH OBSTRUCTS THE NATURAL FLOW OF WATER SHALL BE REMOVED AT THE CLOSE OF EACH WORKING DAY. PRIOR TO ACCEPTANCE OF THE IMPROVEMENT, ALL DRAINAGE STRUCTURES SHALL BE FREE OF DIRT AND DEBRIS.
- ALL FRAMES, GRATES, LIDS, AND BOXES SCHEDULED TO BE REMOVED FROM EXISTING STRUCTURES SHALL REMAIN THE PROPERTY AND BE DELIVERED TO THE PUBLIC WORKS DEPARTMENT. THE PHONE NUMBER FOR DELIVERY ARRANGEMENT IS (630)736-3850.
- 7. ALL FRAMES WITH CLOSED LIDS TO BE FURNISHED AS PART OF THE CONTRACT FOR CONSTRUCTION, ADJUSTMENT OR RECONSTRUCTION OF ANY MANHOLE, CATCH BASIN, OR INLET, SHALL HAVE CAST INTO THE LID ONE OF THE FOLLOWING WORDS: ALL LIDS TO BE USED ON STORM SEWER STRUCTURES SHALL BEAR THE MORD OF THE FOLLOWING WORDS:
- THE INDISCRIMINATE USE OF FIRE HYDRANTS OR EXISTING STREAMS, CREEKS, WETLANDS OR PONDS IS STRICTLY PROHIBITED. THE CONTRACTOR SHALL PROVIDE A WATER TRUCK AND DRIVER AS REQUIRED TO OBTAIN AND TRANSPORT THIS WATER. THE CONTRACTOR SHALL BE RESPONSIBLE FOR OBTAINING WATER FROM AN APPROVED SOURCE. IF THIS WATER IS FROM A SOURCE OTHER THAN HIS YARD, WRITTEN APPROVAL FROM THE AGENCY HAVING JURISDICTION FOR THE SOURCE OF THE WATER MUST BE RECEIVED BY THE ENGINEER PRIOR TO USE OF THE WATER.

SIGNING AND STRIPING

SEE IDOT DISTRICT ONE DETAILS AND PLAN SHEETS FOR PAVEMENT MARKING DETAILS.

COMMITMENTS

NO COMMITMENTS WERE MADE FOR THIS PROJECT.

- SEQUENCE OF CONSTRUCTION ROADWAY IT WILL BE THE CONTRACTOR'S RESPONSIBILITY TO NOTIFY RESIDENTS AND THE VILLAGE WHEN ACCESS TO THEIR DRIVEWAYS WILL BE TEMPORARILY CLOSED DUE TO CONCRETE CURB AND GUTTER INSTALLATION OR SIDEWALK CONSTRUCTION. AT LOCATIONS WHERE NEW GUTTER OR SIDEWALK IS TO BE INSTALLED ACROSS A DRIVEWAY, THE CONTRACTOR SHALL CONTACT THE HOMEOWNER 48 HOURS PRIOR TO REMOVING THE PAVEMENT. THE CONTRACTOR SHALL DISTRIBUTE NOTICES, PROVIDED BY THE VILLAGE, TO RESIDENTS. EVERY EFFORT SHALL BE MADE TO ACCOMODATE ACCESS TO THESE PROPERTIES (KNOCK ON DOORS WHEN A DRIVEWAY IS ABOUT TO BE CLOSED).
- THE CONTRACTOR SHALL NOT BE ALLOWED TO CLOSE A DRIVEWAY FOR MORE THAN 48 HOURS UNDER ANY CIRCUMSTANCES. THE CONTRACTOR SHALL BE RESPONSIBLE FOR MAINTAINING BARRICADES TO PREVENT TRAFFIC FROM USING DRIVEWAYS DURING THIS PERIOD.

				ROADWAY
				75% FEDERAL
				25% LOCAL
PAYCODE	ITEM DESCRIPTION	UNIT	TOTAL	0005
20201200	REMOVAL AND DISPOSAL OF UNSUITABLE MATERIAL	CU YD	152	152
21101615	TOPSOIL FURNISH AND PLACE, 4"	SQ YD	187	187
25000210	SEEDING, CLASS 2A	ACRE	0.25	0.25
25000400	NITROGEN FERTILIZER NUTRIENT	POUND	17	17
25000600	POTASSIUM FERTILIZER NUTRIENT	POUND	17	. 17
25100630	EROSION CONTROL BLANKET	SQ YD	867	867
25200110	SODDING, SALT TOLERANT	SQ YD	187	187
25200200	SUPPLEMENTAL WATERING	UNIT	10	10
40600290	BITUMINOUS MATERIALS (TACK COAT)	POUND	32,015	32,015
40600400	MIXTURE FOR CRACKS, JOINTS, AND FLANGEWAYS	TON	50	50
				,
40600982	HOT-MIX ASPHALT SURFACE REMOVAL - BUTT JOINT	SQ YD	420	420
40603200	POLYMERIZED HOT-MIX ASPHALT BINDER COURSE, IL-4.75, N50	TON	2,609	2,609
40604060	HOT-MIX ASPHALT SURFACE COURSE, IL-9.5, MIX "D", N50	TON	5,312	5,312
42300200	PORTLAND CEMENT CONCRETE DRIVEWAY PAVEMENT, 6 INCH	SQ YD	240	240
42400800	DETECTABLE WARNINGS	SQ FT	1,090	1,090

SPECIAL PROVISION SPECIALTY ITEM CONSTRUCTION TYPE CODE 0042

SE TO NOT TO A DESCRIPTION OF THE PROPERTY OF

USER NAME = dstancz	DESIGNED - JRM	REVISED - XX/XX/XXXX	
	DRAWN - DMS	REVISED - XX/XX/XXXX	
PLOT SCALE =	CHECKED -	REVISED - XX/XX/XXXX	
PLOT DATE = 2/5/2021	DATE -	REVISED - XX/XX/XXXX	

STATE OF ILLINOIS DEPARTMENT OF TRANSPORTATION

SCALE: N.T.S.

SUMMARY OF QUANTITIES		F.A.U SECTION NO.		COUNTY	TOTAL	SHEE NO.					
		2958	15-00063-00-RS	COOK	30	3					
			PARK	BUULEV	AND				CONTRAC	T NO.	61G0
	SHEET	1	OF 4	SHEETS	STA.	TO STA.	FED. RO	AD DIST. NO. ILLINOIS FED.	AID PROJECT		

				ROADWAY
				75% FEDERAL
PAYCODE	ITEM DESCRIPTION	UNIT	TOTAL	25% LOCAL 0005
44000160	HOT-MIX ASPHALT SURFACE REMOVAL, 2 3/4"	SQ YD	47,424	47,424
		34 15	71,727	7,,121
44000200	DRIVEWAY PAVEMENT REMOVAL	SQ YD	240	240
44000600	SIDEWALK REMOVAL	SQ FT	12,800	12,800
44201761	CLASS D PATCHES, TYPE I, 10 INCH	SQ YD	205	205
44201765	CLASS D PATCHES, TYPE II, 10 INCH	SQ YD	240	240
44201769	CLASS D PATCHES, TYPE 111, 10 INCH	SQ YD	305	305
44201771	CLASS D PATCHES, TYPE IV, 10 INCH	SQ YD	340	340
60406100	FRAMES AND LIDS, TYPE 1, CLOSED LID	EACH	18	18
67100100	MOBILIZATION	L SUM	1	1
70102630	TRAFFIC CONTROL AND PROTECTION, STANDARD 701601	L SUM	1	1
70102635	TRAFFIC CONTROL AND PROTECTION, STANDARD 701701	L SUM	1	1
70102640	TRAFFIC CONTROL AND PROTECTION, STANDARD 701801	L SUM	1	1
70300100	SHORT TERM PAVEMENT MARKING	FOOT	9,263	9,263
70300150	SHORT TERM PAVEMENT MARKING REMOVAL	SQ FT	6,110	6,110
78000100	THERMOPLASTIC PAVEMENT MARKING - LETTERS AND SYMBOLS	SQ FT	471	471

SPECIAL PROVISION SPECIALTY ITEM

CONSTRUCTION TYPE CODE 0042

USER NAME = dstencz	DESIGNED - JRM	REVISED	-	XX/XX/XXXX
	DRAWN - DMS	REVISED	-	XX/XX/XXXX
PLOT SCALE =	CHECKED -	REVISED	-	XX/XX/XXXX
PLOT DATE = 2/5/2021	DATE -	REVISED		XX/XX/XXXX

STATE OF ILLINOIS
DEPARTMENT OF TRANSPORTATION

SUMMARY OF QUANTITIES PARK BOULEVARD							
SCALE: N.T.S.	SHEET	2	OF	4	SHEETS	STA.	TO STA.

| FED. ROAD DIST. NO. | COUNTY | TOTAL SHEET NO. | COUNTY | COUNTY

					ROADWAY
					25% LOCA
	PAYCODE	ITEM DESCRIPTION	UNIT	TOTAL	0005
	78000200	THERMOPLASTIC PAVEMENT MARKING - LINE 4"	FOOT	28,324	28,324
	78000400	THERMOPLASTIC PAVEMENT MARKING - LINE 6"	FOOT	562	562
	78000600	THERMOPLASTIC PAVEMENT MARKING - LINE 12"	FOOT	1,418	1,418
	78000650	THERMOPLASTIC PAVEMENT MARKING - LINE 24"	FOOT	340	340
	78008230	POLYUREA PAVEMENT MARKING TYPE I - LINE 6"	FOOT	100	100
	70008230	FOLIUMEA FAVEMENT MARKING TIPE I - LINE 0	FOOT	190	190
	78008270	POLYUREA PAVEMENT MARKING TYPE I - LINE 24"	FOOT	30	30
	88600600	DETECTOR LOOP REPLACEMENT	FOOT	368	368
*	X0320050	CONSTRUCTION LAYOUT (SPECIAL)	L SUM	1	1
			2 334		-
*	X0326806	WASHOUT BASIN	L SUM	1	1
*	X4021000	TEMPORARY ACCESS (PRIVATE ENTRANCE)	EACH	5	5
*	X4240430	PORTLAND CEMENT CONCRETE SIDEWALK 5 INCH, SPECIAL	SQ FT	12,800	12,800
	X4400501	COMBINATION CURB AND GUTTER REMOVAL AND REPLACEMENT LESS THAN OR EQUAL TO 10 FEET	FOOT	500	500
*	X6030310	FRAMES AND LIDS TO BE ADJUSTED (SPECIAL)	EACH	69	69
*	Z0004562	COMBINATION CONCRETE CURB AND GUTTER REMOVAL AND REPLACEMENT	FOOT	5 250	5 250
	20004302	SOMETHING SOMETHE COME AND GOTTER REMOVAL AND REPLACEMENT	F001	5,250	5,250
*	Z0030850	TEMPORARY INFORMATION SIGNING	SQ FT	52	52

SPECIAL PROVISION SPECIALTY ITEM

CONSTRUCTION TYPE CODE 0042

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USER NAME = dstancz	DESIGNED - JRM	REVISED - XX/XX/XXXX
	DRAWN - DMS	REVISED - XX/XX/XXXX
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 PLOT DATE = 2/5/2021	DATE -	REVISED - XX/XX/XXXX

STAT	E OF	ILLINOIS	
DEPARTMENT	0F	TRANSPORTATION	

SCALE: N.T.S.

SUMMARY OF QUANTITIES			F.A.U RTE.	SECTIO	ON NO.		COUNTY	TOTAL	SHEET NO.				
PARK BOULEVARD			2958	15-0006	3-00-R	5	COOK	30	5				
		1.7	11111	DOOLLY	AND						CONTRAC	NO.	61G09
SHEET	3	OF	4	SHEETS	STA.	TO STA.	FED. RO	DAD DIST. NO.	ILLINOIS	FED. AI	D PROJECT		

					ROADWAY
					75% FEDERAL
					25% LOCAL
	PAYCODE	ITEM DESCRIPTION	UNIT	TOTAL	0005
X	Z0076600	TRAINEES	HOUR	500	
Х	Z0076604	TRAINEES TRAINING PROGRAM GRADUATE	HOUR	500	

SPECIAL PROVISION

SPECIALTY ITEM


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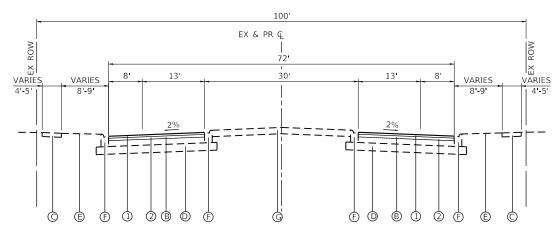
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FILE NAME 1995/5-7-sun. Oldon
FILE NAME 1995/5-1-sun. Oldon
FILE NAME 1995/5-sun. Oldon
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	DRAWN - DMS	REVISED - XX/XX/XXXX
PLOT SCALE =	CHECKED -	REVISED - XX/XX/XXXX
PLOT DATE = 2/5/2021	DATE -	REVISED - XX/XX/XXXX

STATE OF ILLINOIS DEPARTMENT OF TRANSPORTATION

	SUMMARY OF QUANTITIES		F.A.U RTÉ.	SECTION NO.	COUNTY	TOTAL	SHEET NO.
	PARK BOULEVARD		2958	15-00063-00-RS	COOK	30	6
	I Alik BOOLLYAND				CONTRAC	T NO.	61G09
 SCALE: N.T.S.	SHEET 4 OF 4 SHEETS STA.	TO STA.	FED. ROAD	DIST. NO. (ILLINDIS FED. A	ID PROJECT		



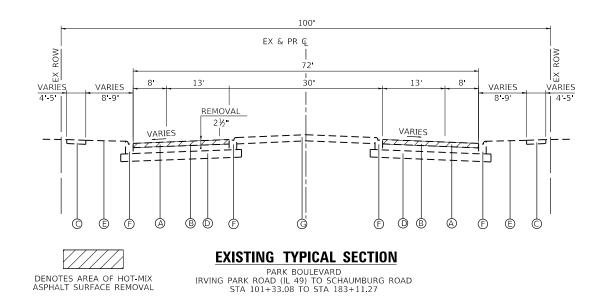

PROPOSED TYPICAL SECTION

PARK BOULEVARD
IRVING PARK ROAD (IL 49) TO SCHAUMBURG ROAD
STA 101+33.08 TO STA 183+11.27

EXISTING LEGEND

- A HOT-MIX ASPHALT SURFACE REMOVAL, 2 ¾
- B HOT-MIX ASPHALT PAVEMENT, (12" & VARIES)
- O PORTLAND CEMENT CONCRETE SIDEWALK (SPOT REMOVAL & REPLACEMENT AS DIRECTED BY THE ENGINEER)
- D AGGREGATE SUBBASE, (4"-6")
- © EXISTING GROUND
- © COMBINATION CONCRETE CURB & GUTTER, TYPE B-6.12 (SPOT REMOVAL & REPLACEMENT AS DIRECTED BY THE ENGINEER)
- G LANDSCAPED MEDIAN

PROPOSED LEGEND

- ① HOT-MIX ASPHALT SURFACE COURSE, MIX "D", IL-9.5, N50; 2"
- ② POLYMERIZED HMA BINDER COURSE, IL-4.75, N50; 1"

NOTES: THE PATCHING QUANTITIES HAVE BEEN ESTIMATED BASED ON FIELD OBSERVATION DURING DESIGN.

SCALE: N.T.S.

NOTES:

PAVEMENT RESURFACING

PATCHING (see note)

1. THE UNIT WEIGHT TO CALCULATE ALL HMA SURFACE MIXTURE QUANTITIES IS 112 LBS/SQ YD/IN.

HOT-MIX ASPHALT MIXTURE REQUIREMENTS

MIXTURE TYPE

HMA SURFACE COURSE, MIX "D", IL-9.5, N50; 2"

CLASS D PATCHES, (HMA BINDER, IL-19mm)

POLYMERIZED HMA BINDER COURSE, IL-4.75, N50; 1"

4.0% @ 50 GYR.

3.5% @ 50 GYR.

4.0% @ 70 GYR.


- THE "AC TYPE" FOR POLYMERIZED HMA MIXES SHALL BE "SBS/SBR PG 76-22" AND FOR NON-POLYMERIZED HMA THE "AC TYPE" SHALL BE "PG 64-22" UNLESS MODIFIED BY SPECIAL PROVISIONS.
- 3. FOR USE OF RECYCLED MATERIAL SEE SPECIAL PROVISIONS.

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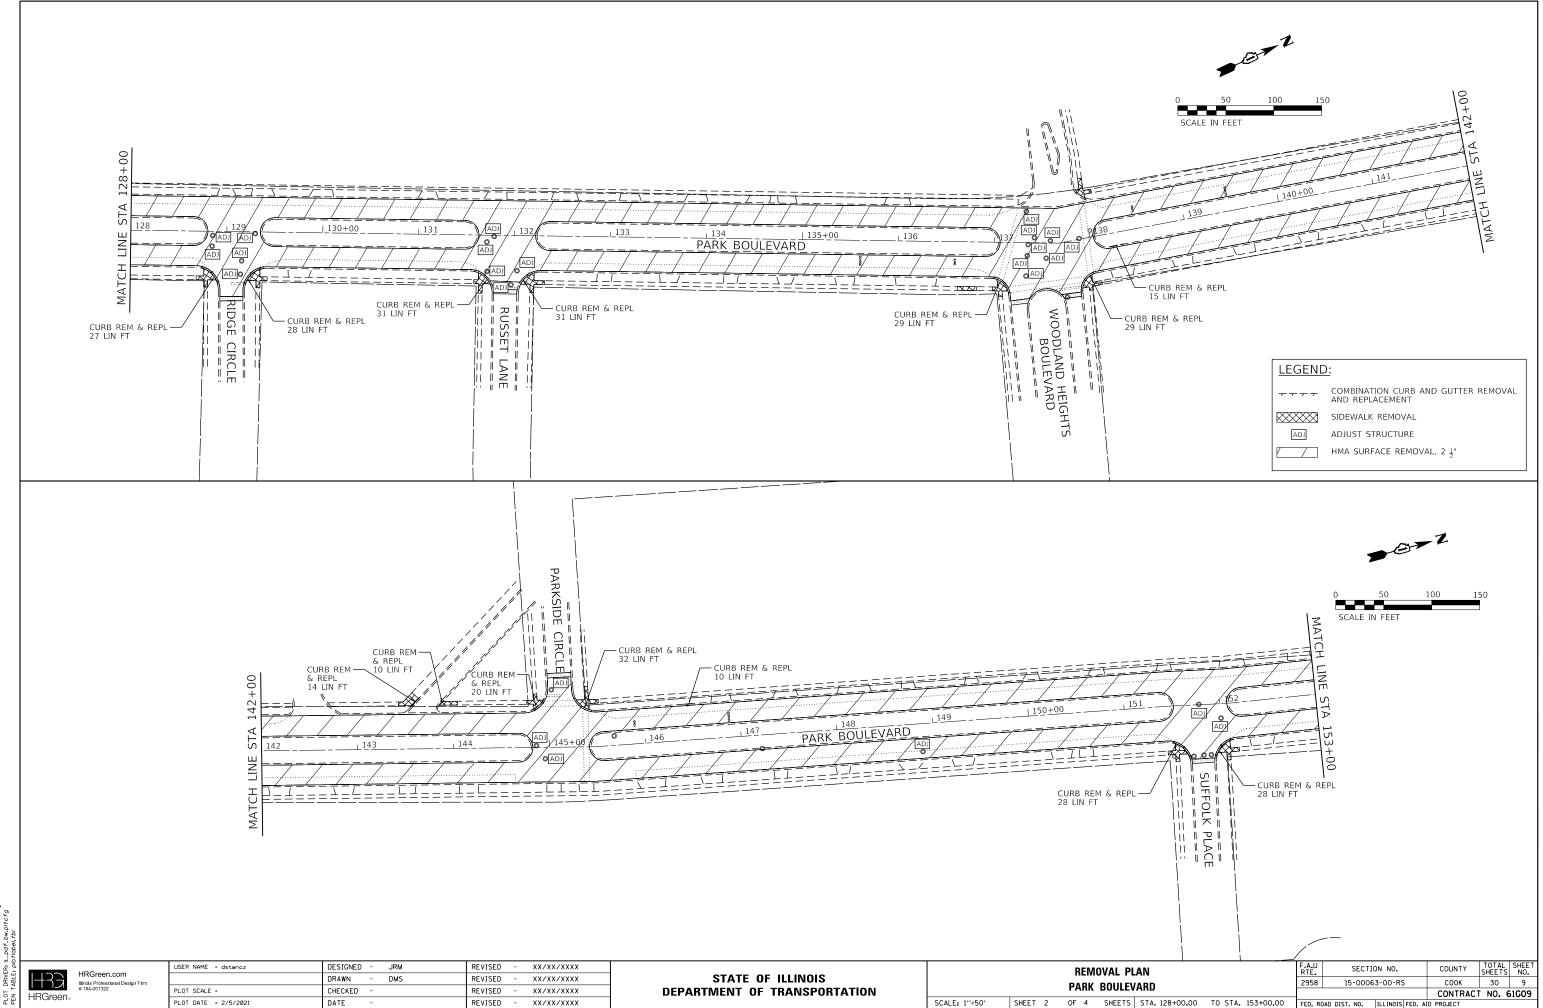
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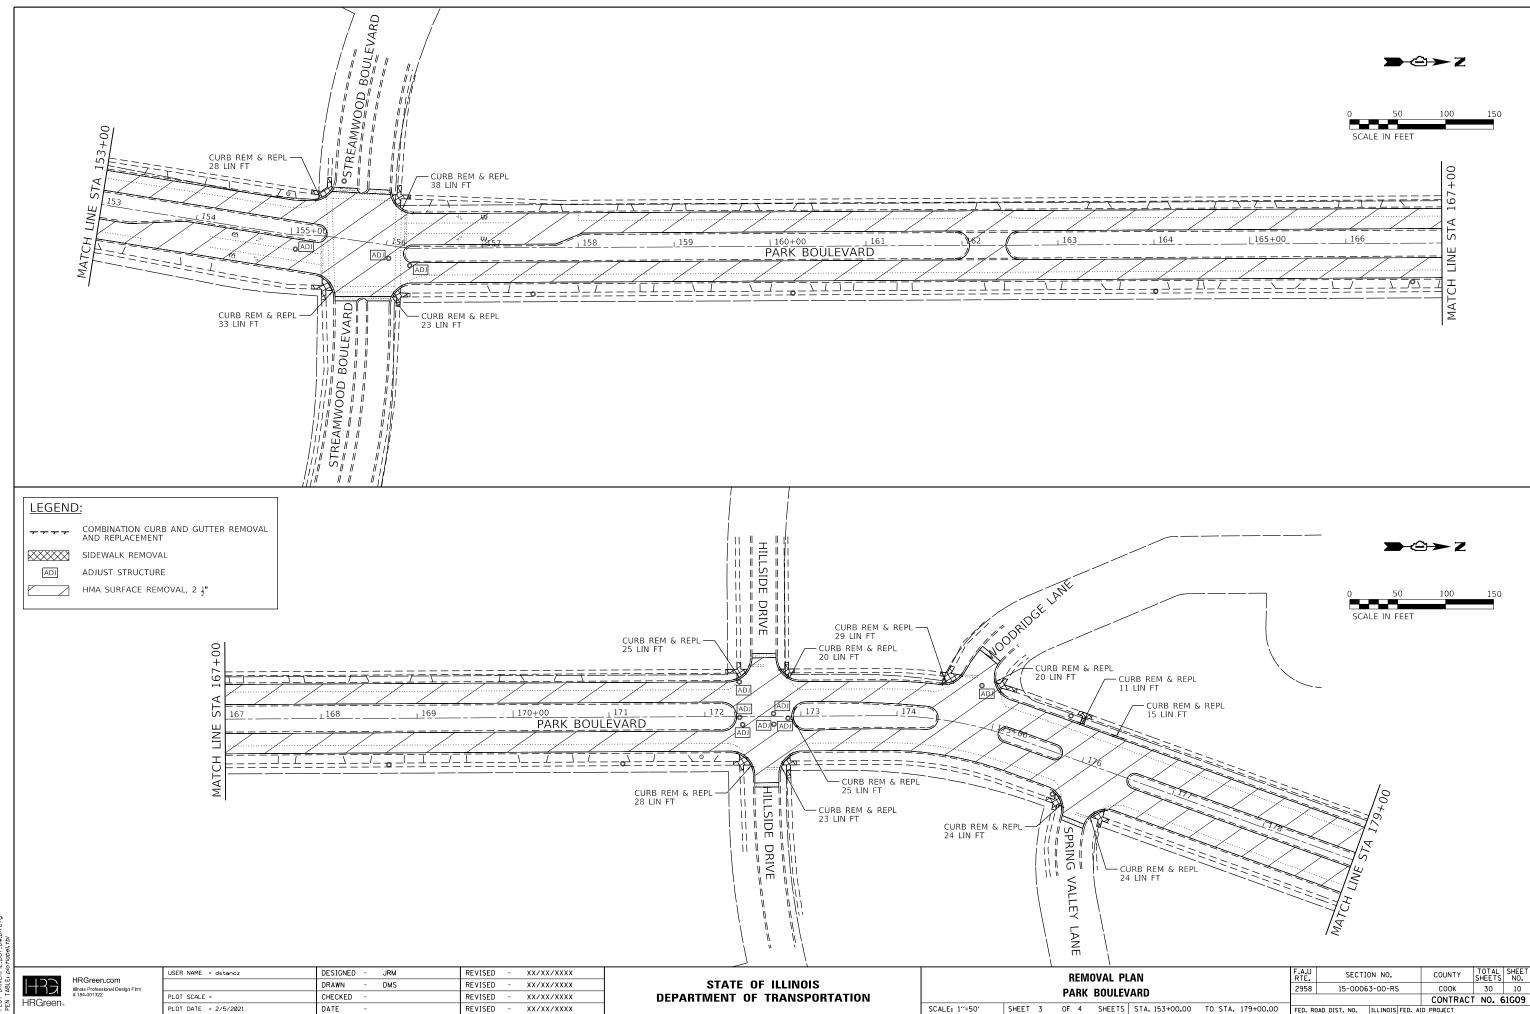
STATE OF ILLINOIS	
DEPARTMENT OF TRANSPORTATION	

TYPICAL SECTIONS				F.A.U RTE.	SECTION NO.	COUNTY	TOTAL SHEETS	SHEET NO.	
	PARK BOULEVARD					15-00063-00-RS	соок	30	7
							CONTRAC	T NO. 6	31G09
1	OF 1	SHEETS	STA. 101+33.08	TO STA. 183+40.38	FED. RC	AD DIST. NO. ILLINOIS FED. A	ID PROJECT		




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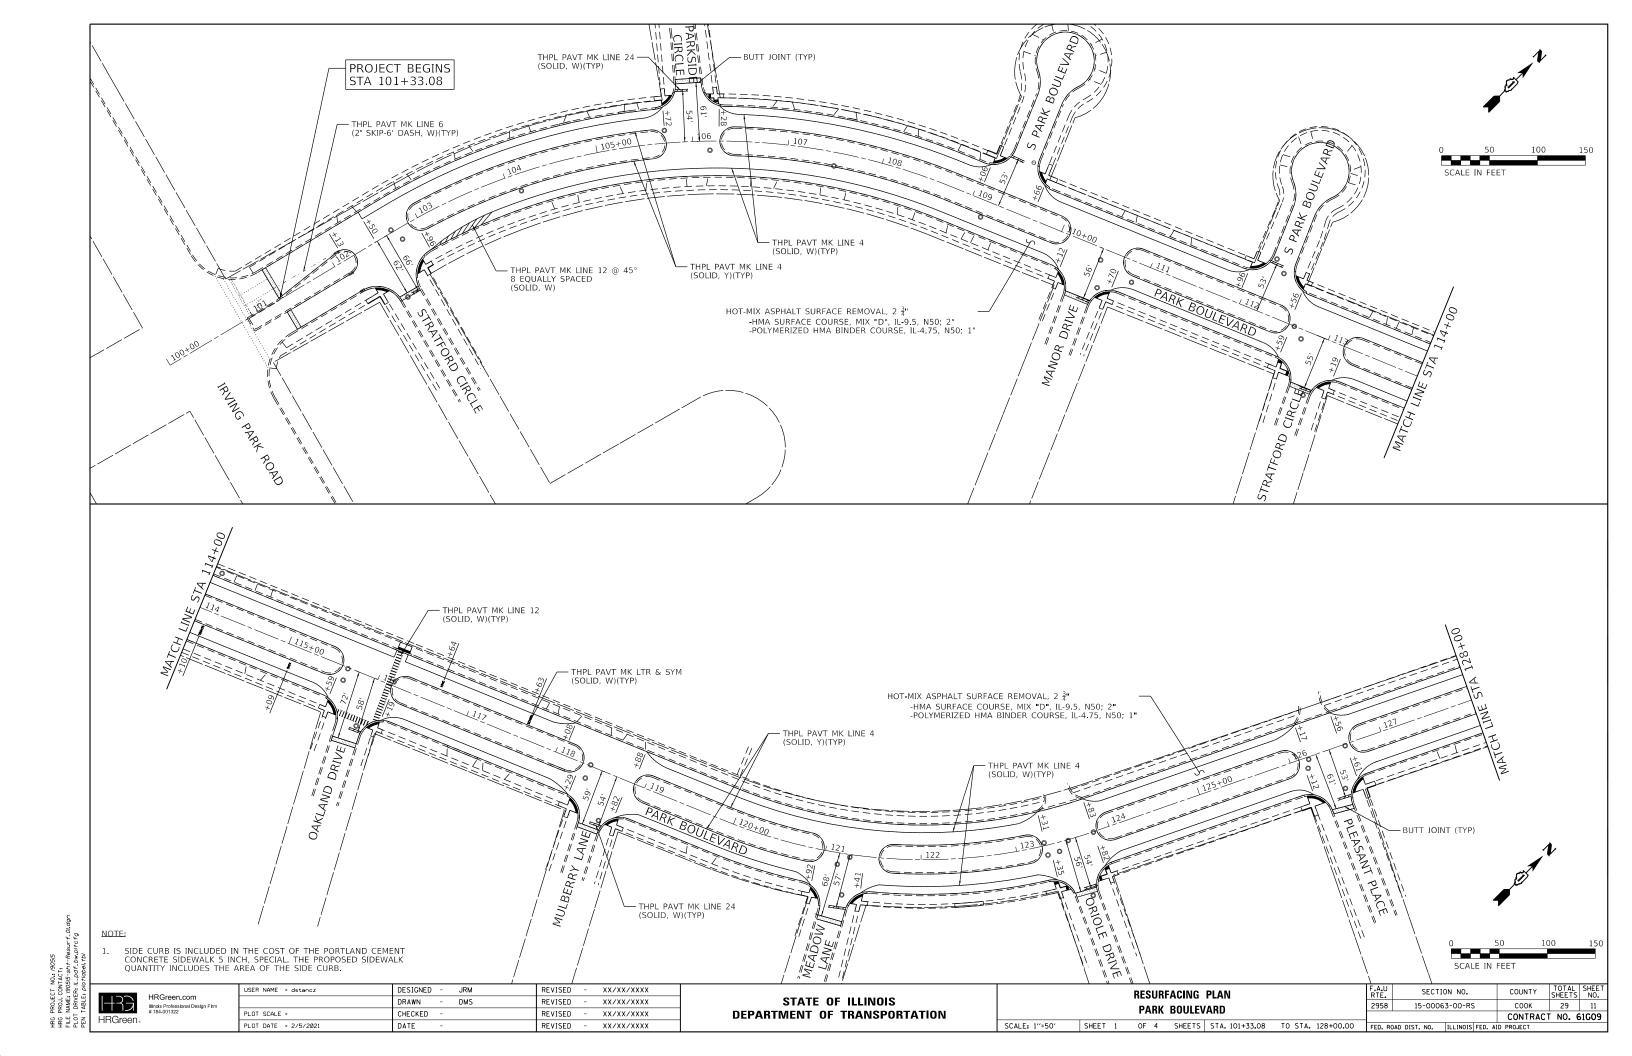
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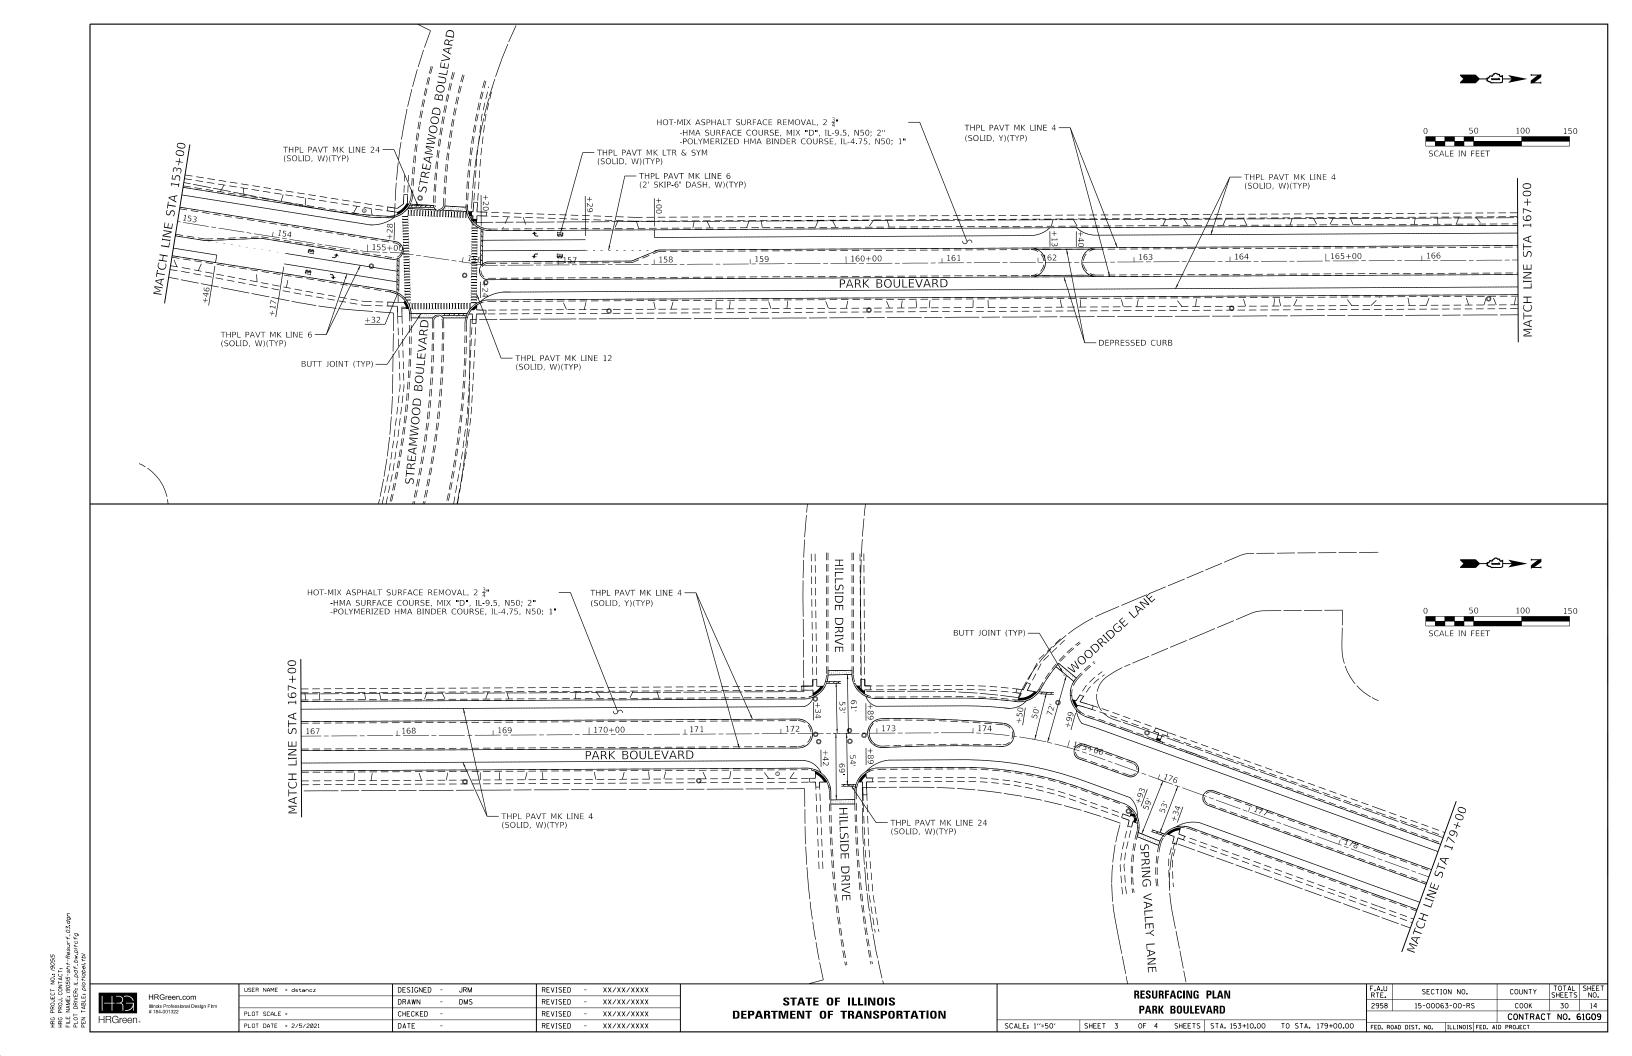
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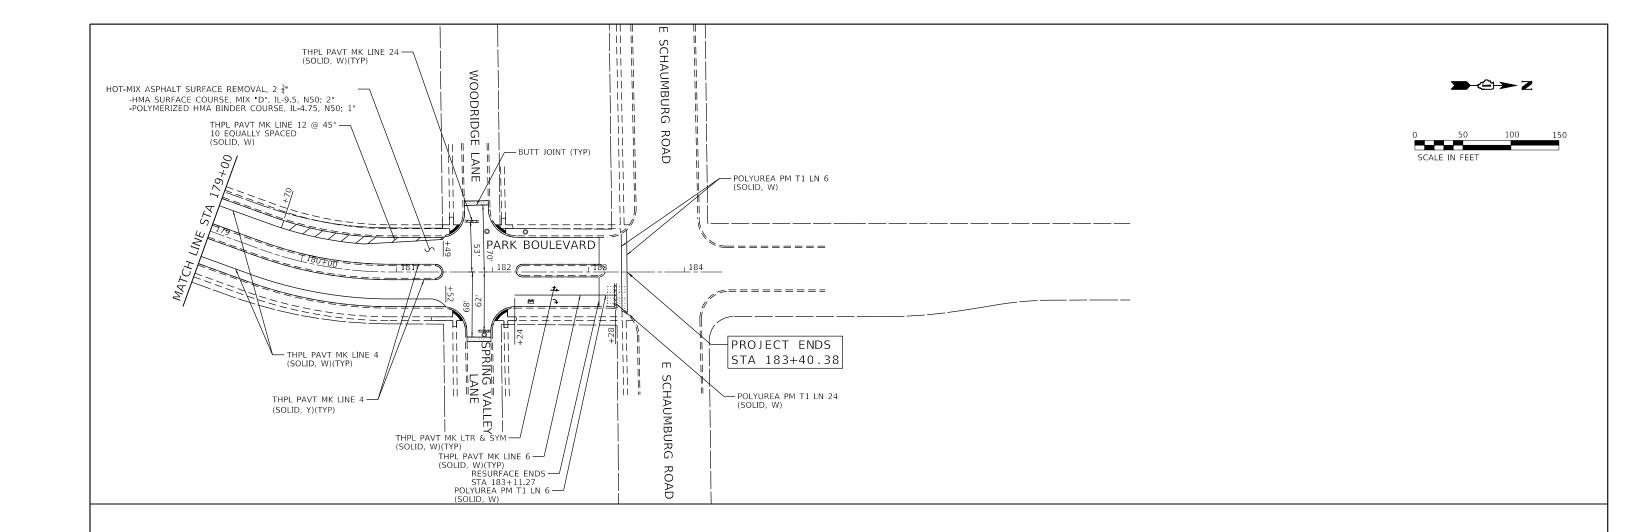
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PLOT SCALE =	CHECKED -	REVISED - XX/XX/XXXX
PLOT DATE = 2/5/2021	DATE -	REVISED - XX/XX/XXXX

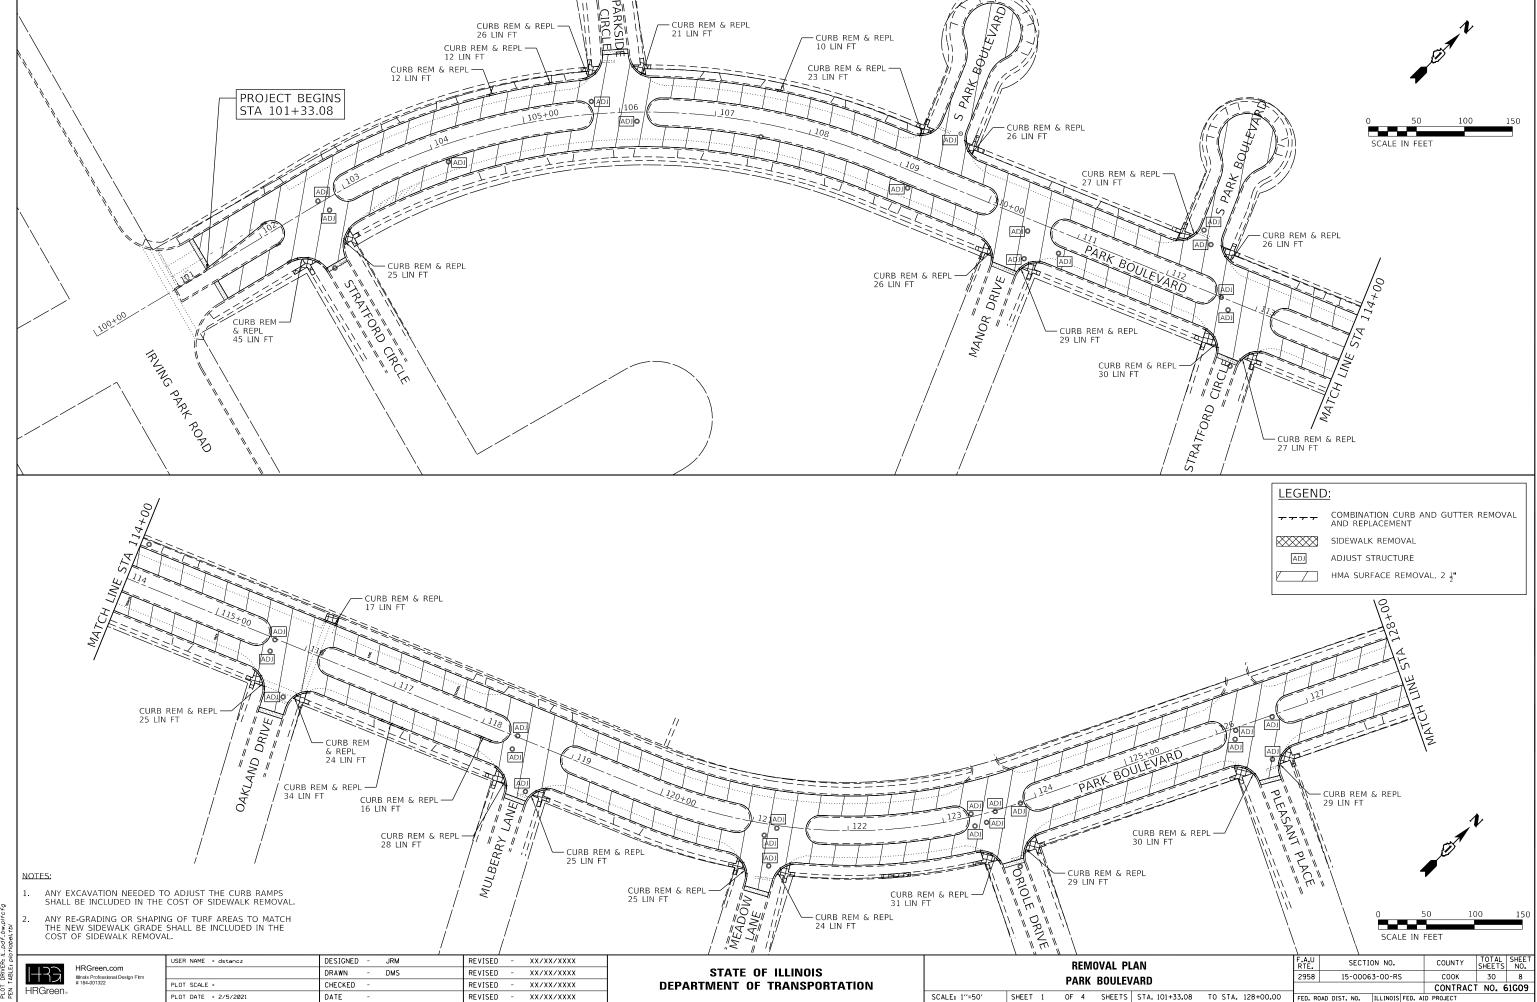STATI	OF ILLINOIS	
DEPARTMENT	OF TRANSPORTAT	ΓΙΟΝ

REMOVAL PLAN								F.A.U RTE.	SECTI	ON NO.	COUNTY	TOTAL SHEETS	SHEET NO.
	PARK BOULEVARD							2958	15-0006	3-00-RS	COOK	30	11
TAIIK DOOLLYAIID										CONTRACT	NO.	61G09	
SCALE: 1"=50"	SHEET 4	OF	4	SHEETS	STA. 179+00.00	TO STA.	183+40.38	FED. RC	DAD DIST. NO.	ILLINOIS FED. A	D PROJECT		



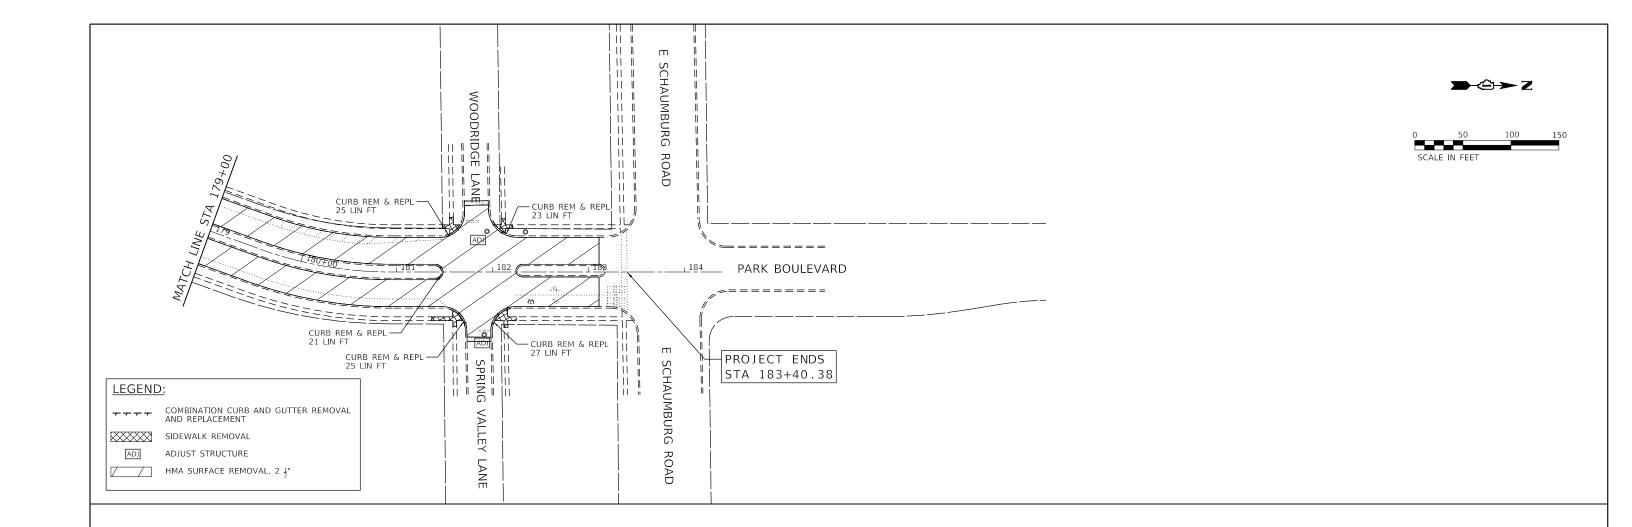




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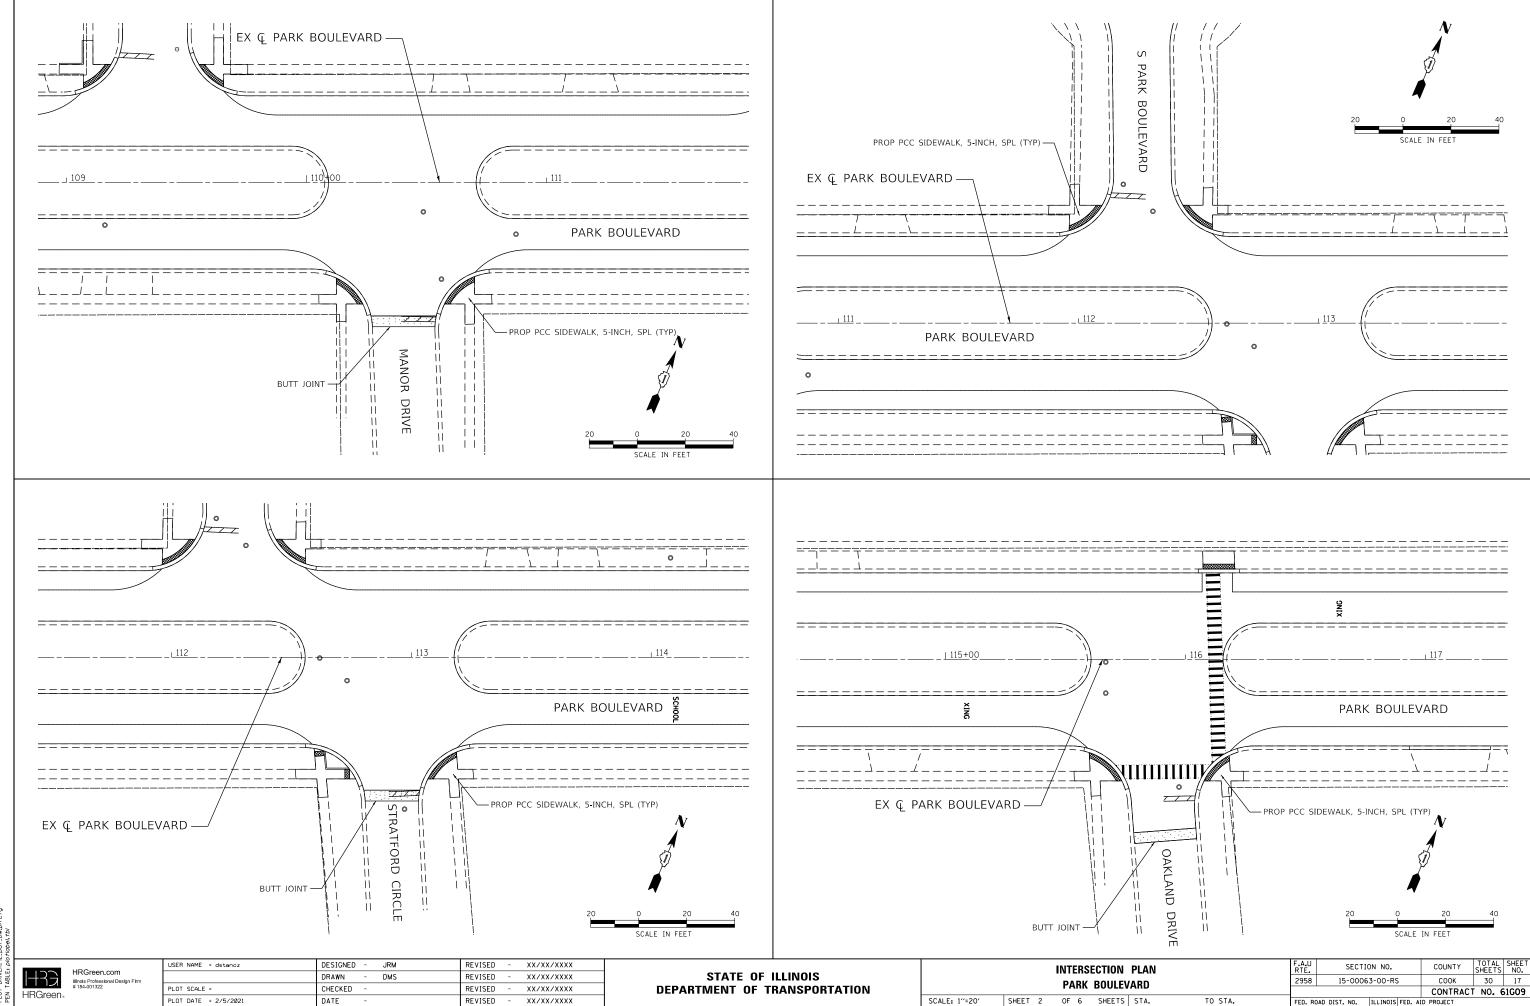
HRGreen.	HRGreen.com Illinois Professional Design Firm # 184-001322


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	DRAWN - DMS	REVISED - XX/XX/XXXX
PLOT SCALE =	CHECKED -	REVISED - XX/XX/XXXX
PLOT DATE = 2/5/2021	DATE -	REVISED - XX/XX/XXXX


STATI	OF ILLINOIS	
DEPARTMENT	OF TRANSPORTATION	NC

	RESURFACING PLAN								COUNTY	SHEETS	NO.
		PARK	BOULEV	2958	15-00063	3-00-RS	соок	30	15		
		I AIII	DOULLY	AIID					CONTRACT	NO.	61G09
SCALE: 1"=50"	SHEET 4	OF 4	SHEETS	STA. 179+00.00	TO STA. 183+40.38	FED. RO	DAD DIST. NO.	ILLINOIS FED. AI	D PROJECT		




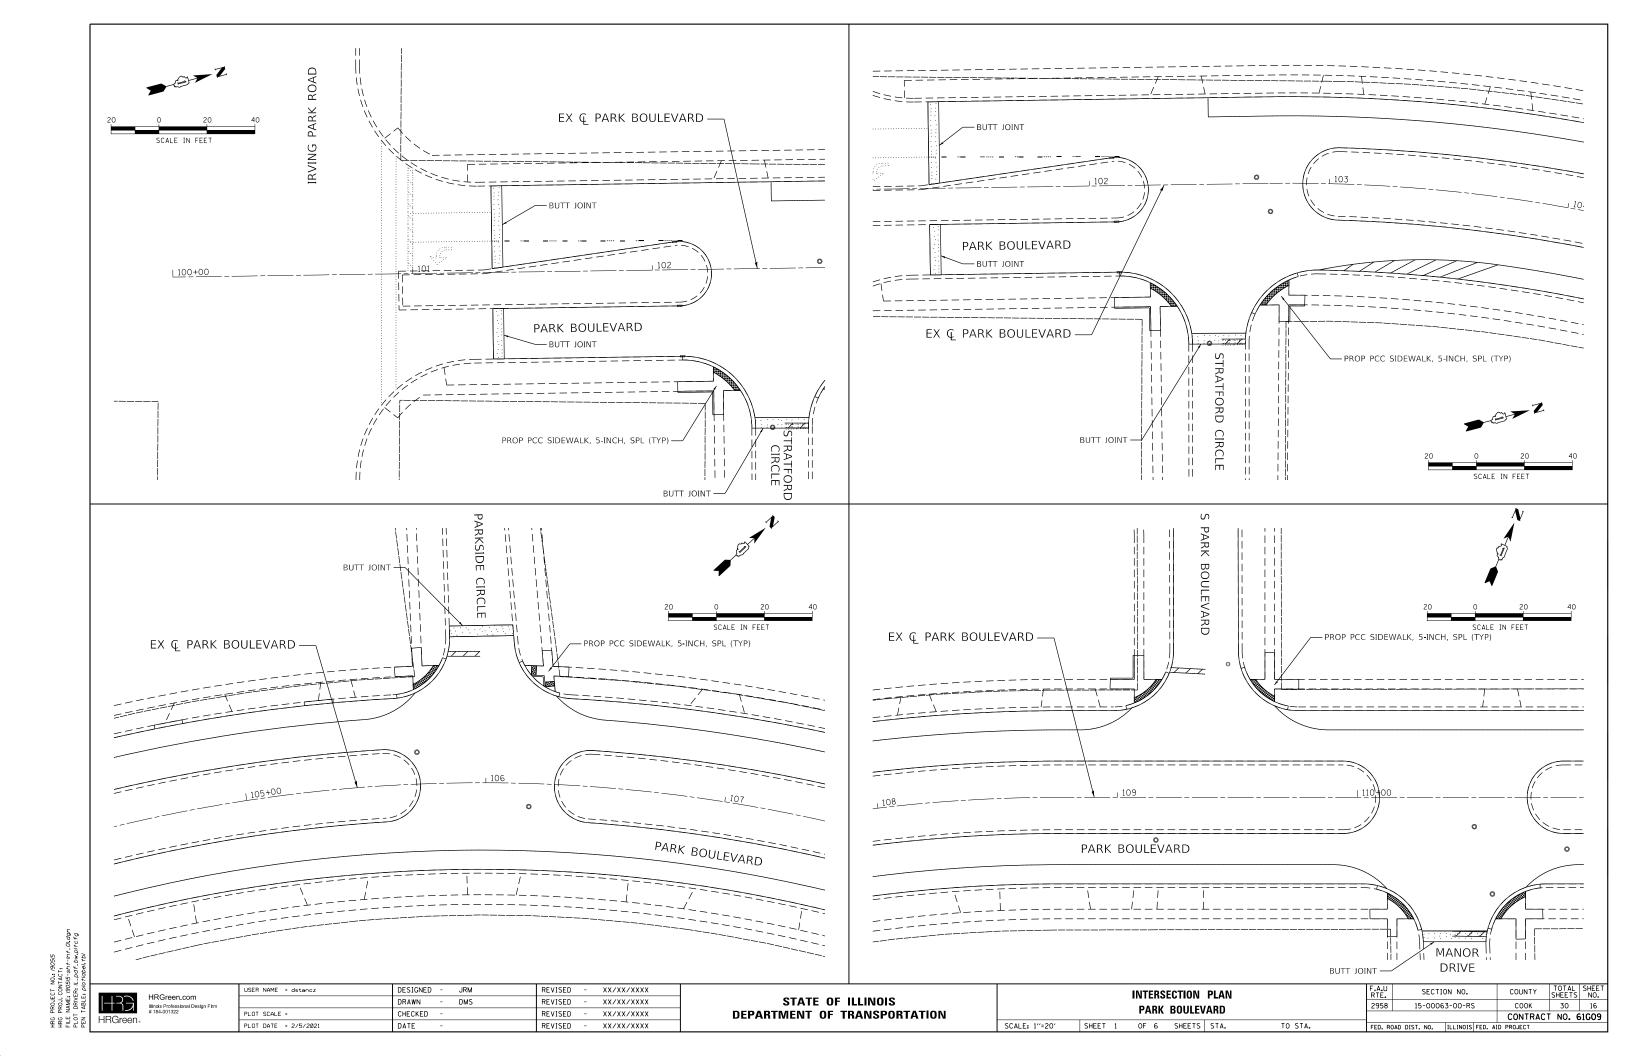

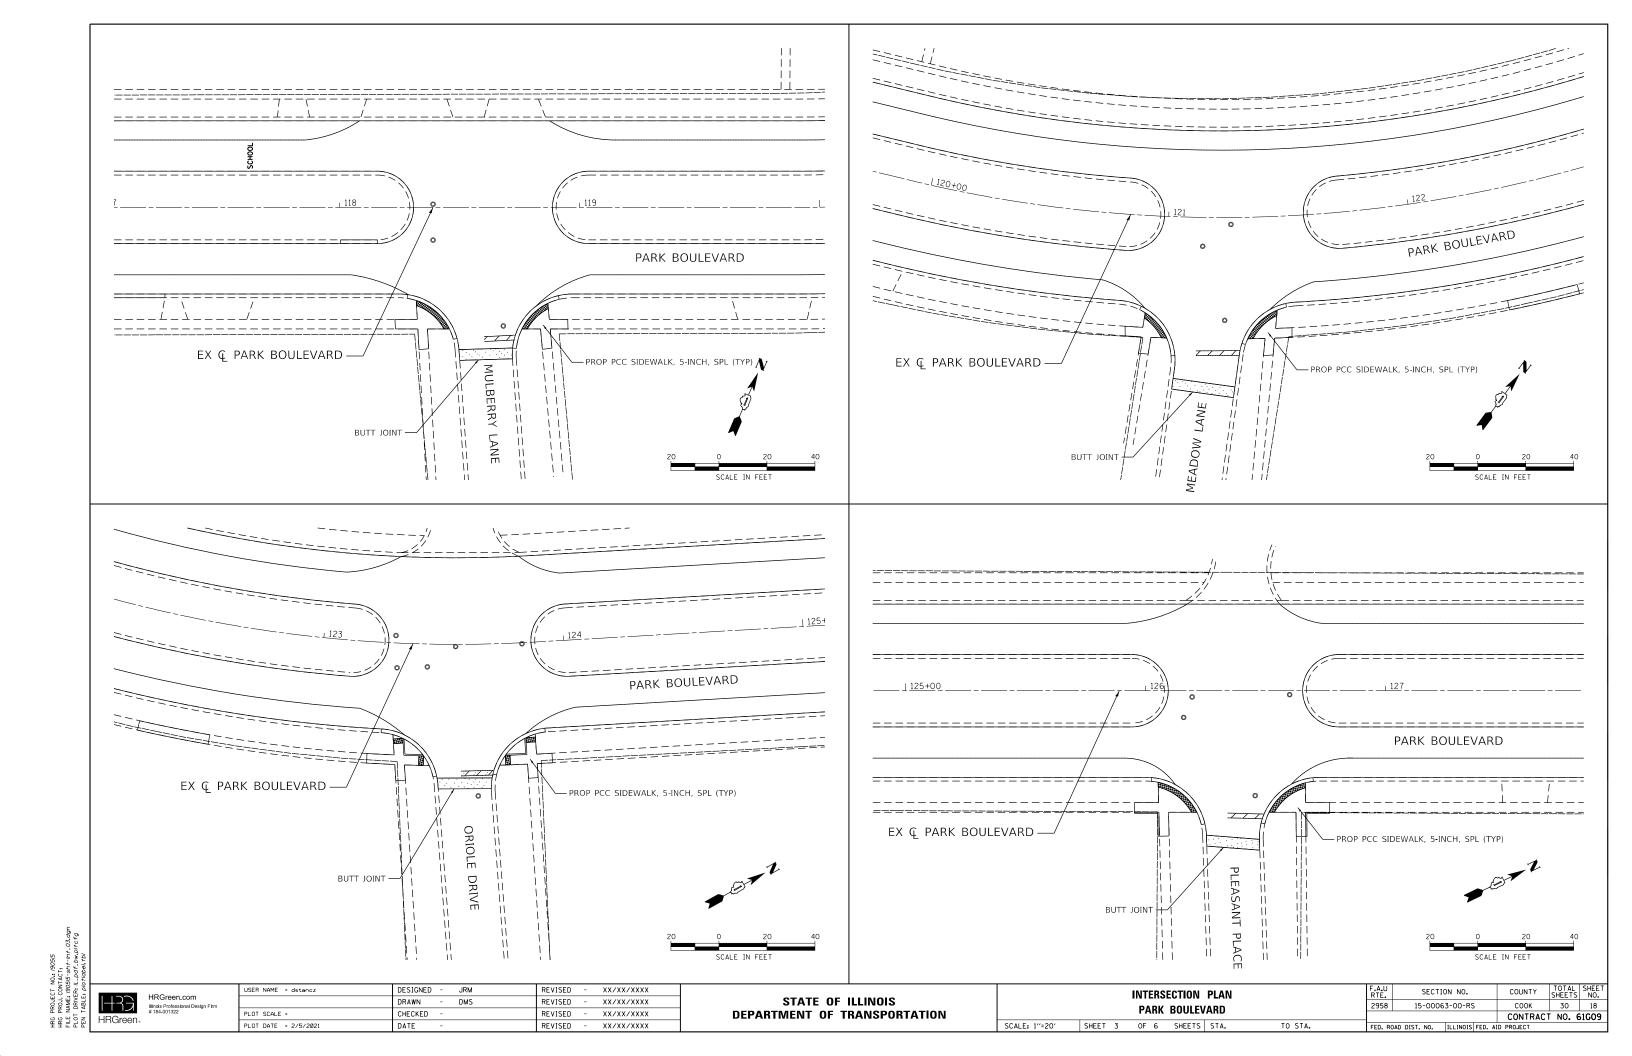


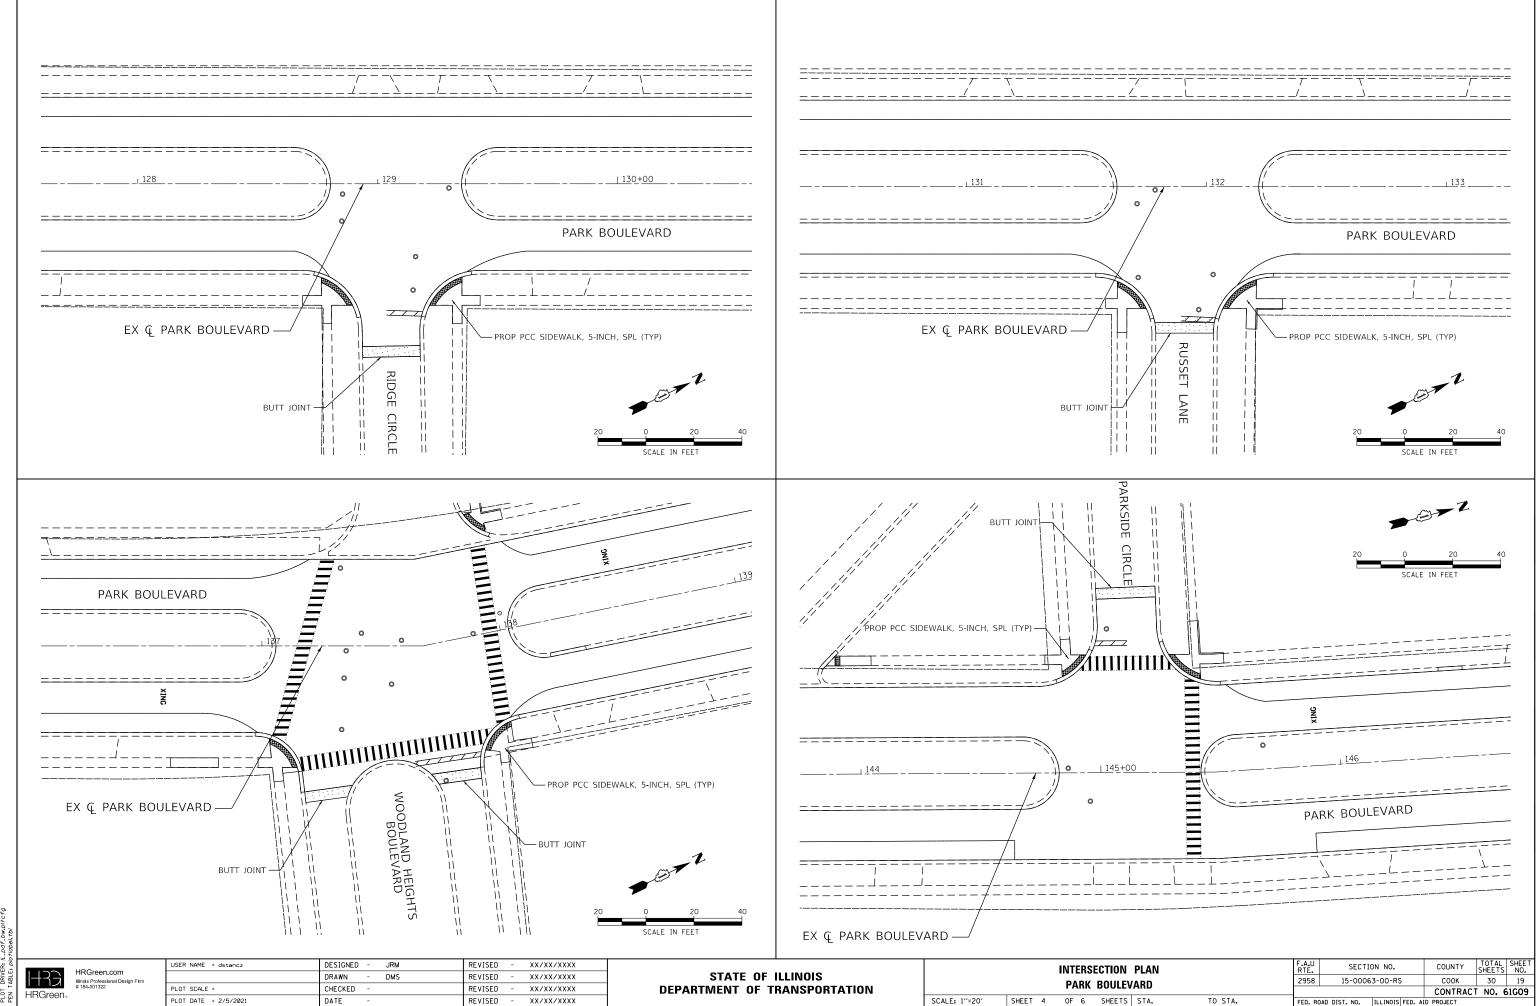

HRG PROJECT NO. 1905/5
HRG PROJ. CONTACT.
FILE NAME. 1905/5-517-inf_04.dgn
PLOT DRIVER: L._Loff_b.w.pirtrg
PEN TABLE: plot10bel.tbl

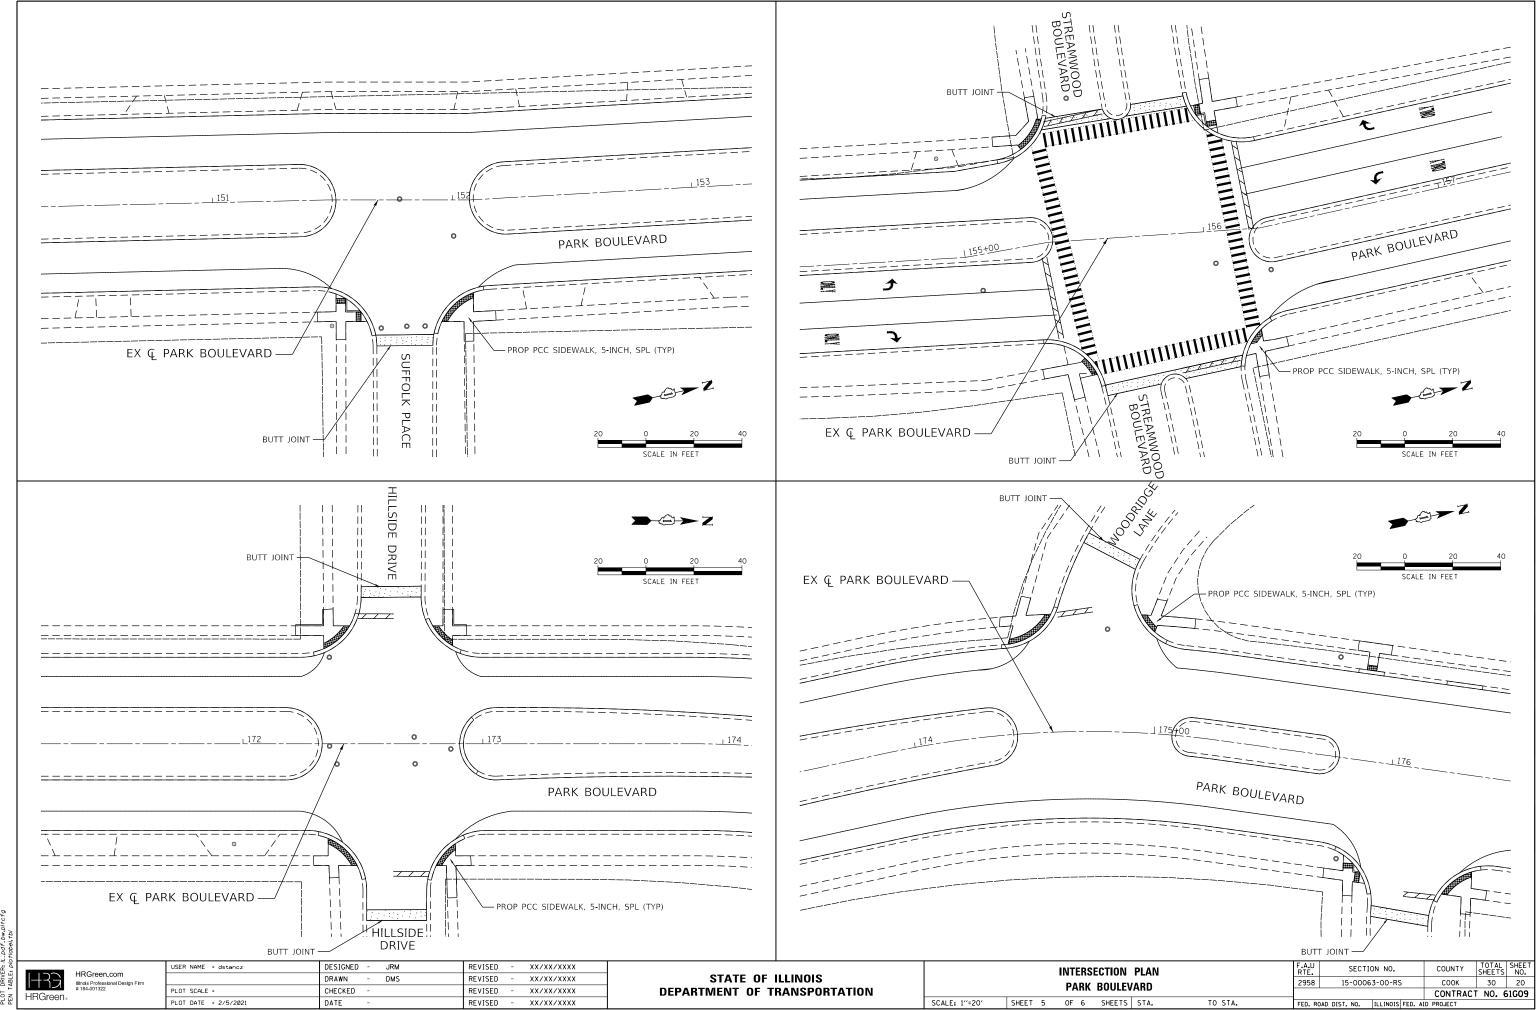


HRG PROJECT NO.: 1905/5 HRG PROJ. CONTACT: FILE NAME: 1905/5-Shr.Int. 05.dgn PLOT DRIVER: (L.pdf.bw.pitcfg PEN TABLE: plotiobel.tbl

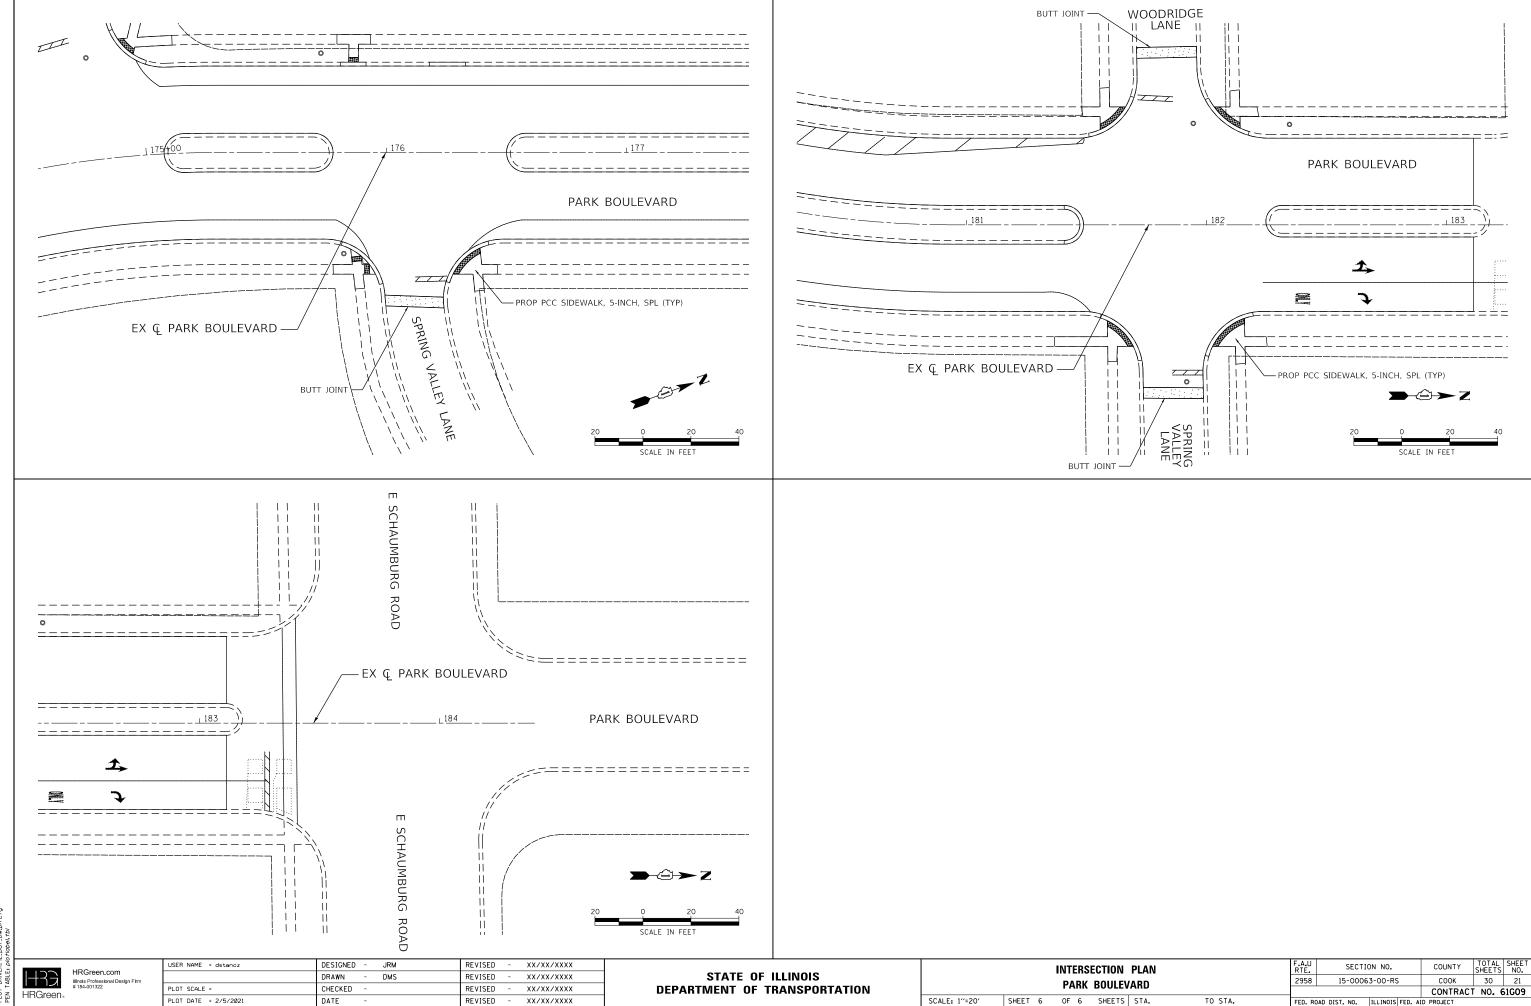


HRG PROJECT NO. 1905/5 HRG PROJ. CONTACT: FILE NAME: 1905/5-SH-Int_06.dgn PLOI DRIVER: IL_DOff_bw_pitcfg PEN TABLE: plot/doel.tbl

PCC SIDEWALK

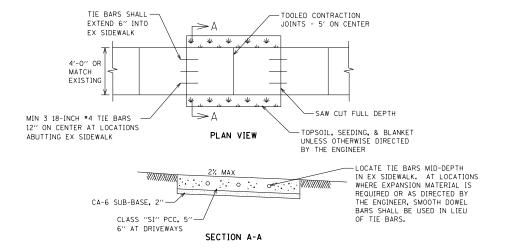

PCC CURB & GUTTER

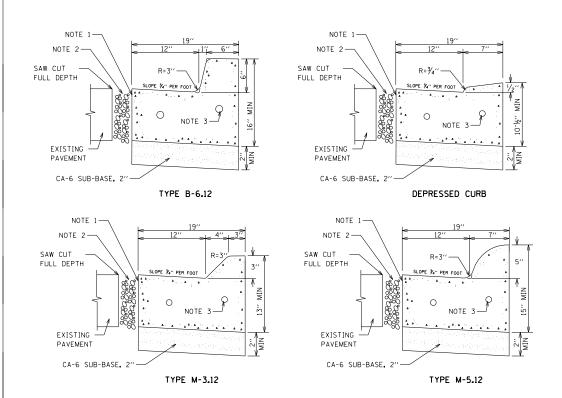


NOTE 1 - THE MINIMUM THICKNESS OF CONCRETE AT THE FACE OF THE GUTTER SHALL BE 10"


NOTE 2 - ON ALL RESURFACING STREETS AND AS DIRECTED BY THE ENGINEER IN THE MISCELLANEOUS AREAS THE GAP BETWEEN THE EXISTING PAVEMENT AND THE NEW CURB SHALL BE BACKFILLED WITH 8" OF PCC BASE COURSE. THE GAP BETWEEN THE PCC BASE COURSE AND PAVEMENT SURFACE SHALL BE BACKFILLED WITH 2" OF TEMPORARY STONE AT ALL LOCATIONS WHERE THE CURB IS DEPRESSED.

NOTE 3 - TIE BARS OR SMOOTH DOWELL BARS SHALL BE PROVIDED AT VERTICAL FACES OF EXISTING CURB & GUTTER.

PCC DRIVEWAY, COMMERCIAL

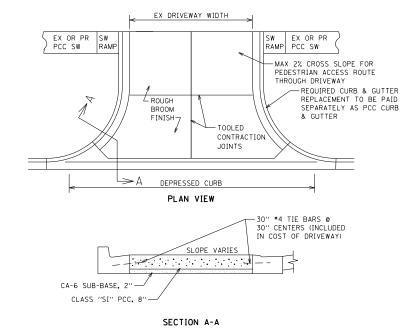

CONCRETE WASHOUT AREA

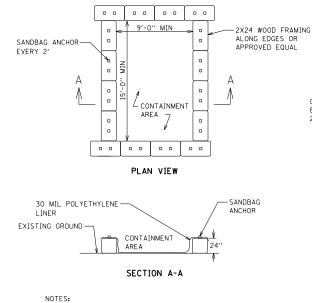


MAINTAINING WASHOUT FACILITY SHALL INCLUDE REMOVING AND DISPOSING OF HARDENED CONCRETE AND SLURRY AND RETURNING THE FACILITY TO A FUNCTIONAL CONDITION

WASHOUT FACILITY SHALL BE CLEANED OR RECONSTRUCTED IN A NEW AREA ONCE WASHOUT BECOMES TWO-THIRDS FULL


SCALE: N.T.S.

PCC DRIVEWAY, RESIDENTIAL

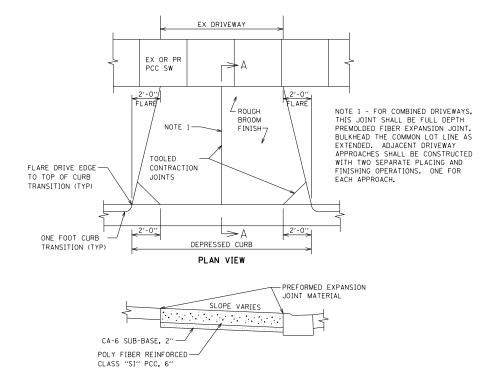

SECTION A-A


TYPICAL SIDEWALK CORNER REPLACEMENTS

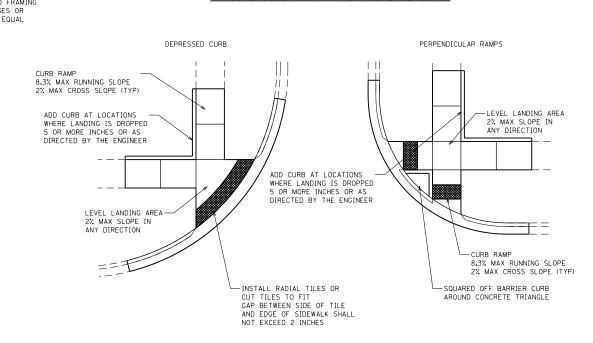


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HRGreen-	

USER NAME = dstancz	DESIGNED - JRM	REVISED -	XX/XX/XXXX
	DRAWN - DMS	REVISED -	XX/XX/XXXX
PLOT SCALE =	CHECKED -	REVISED -	XX/XX/XXXX
PLOT DATE = 2/5/2021	DATE -	REVISED -	XX/XX/XXXX

VILLAGE	OF ST	REAMWO	OOD	DETAILS	F.A.U RTE.	SECTION NO.	COUNTY	TOTAL SHEETS	SHEET NO.	
	DARK	BOULEV	ΛRN		2958	15-00063-00-RS	соок	30	22	
	I AIIK	DOULLY	אווט				CONTRAC	T NO. 6	51G09	
SHEET 1	OF 1	SHEETS	STA.	TO STA.	FED R	DAD DIST NO. TILLINGIS FED. A	ID PROJECT			

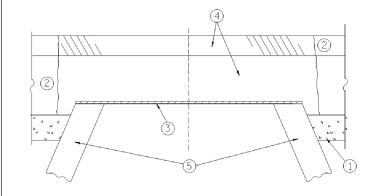

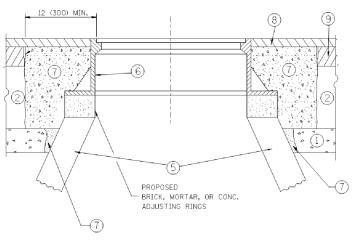

NOTES:

EXISTING BROKEN FRAMES AND LIDS SHALL BE REMOVED AND DISPOSED OF BY THE CONTRACTOR AND SHALL BE REPLACED AS DIRECTED BY THE ENGINEER. REPLACEMENT FRAMES AND LIDS WILL BE PAID FOR IN ACCORDANCE WITH ARTICLE 109.04 OF THE STANDARD SPECIFICATIONS UNLESS A SEPARATE PAY ITEM HAS BEEN PROVIDED.

IF THE EXISTING LIDS ARE OPEN, THE FRAME WILL BE ADJUSTED TO THE ELEVATION OF THE MILLED PAVEMENT SURFACE PRIOR TO THE MILLING OPERATION. THE FRAME WILL NOT BE REMOVED AND COVERED BY THE METAL PLATE.

CITY OF CHICAGO CASTINGS ARE THE PROPERTY OF THE CITY AND THE CONTRACTOR SHALL NOTIFY THE CITY FOR REMOVAL AND DISPOSITION OF THE CASTINGS.

THE METAL PLATE USED TO COVER THE STRUCTURE SHALL REMAIN THE PROPERTY OF THE CONTRACTOR.

WHEN STRUCTURES ARE TO BE ADJUSTED OR RECONSTRUCTED, THE LOWERING AND RAISING OF THE FRAMES AND LIDS WILL NOT BE PAID FOR SEPARATELY BUT WILL BE INCLUDED IN THE COST OF THE CORRESPONDING PAY ITEM.

SCALE: NONE

CONSTRUCTION PROCEDURES

STAGE 1 (BEFORE PAVEMENT MILLING)

- A) REMOVE A MINIMUM OF 12 (300) OF THE PAVEMENT FROM AROUND THE STRUCTURE.
- B) REMOVE THE EXISTING FRAME AND LID FROM THE STRUCTURE.
- C) COVER THE STRUCTURE OPENING WITH A 36 (900) DIAMETER METAL PLATE.
- D) BACKFILL WITH CRUSHED STONE AND A MINIMUM 11/2 (40) THICK HMA SURFACE MIX APPROVED BY THE ENGINEER.

STAGE 2 (AFTER PAVEMENT MILLING)

- A) REMOVE THE HMA SURFACE MIX AND CRUSHED STONE.
- B) INSTALL THE FRAME AND LID; ADJUST THE FRAME TO ITS FINAL SURFACE ELEVATION.
- C) THE SURROUNDING SPACE SHALL BE FILLED WITH CLASS PP-1*
 CONCRETE TO THE ELEVATION OF THE SURFACE OF THE EXISTING
 BASE COURSE OR THE BINDER COURSE.
- *UNLESS OTHERWISE SPECIFIED IN THE PLANS.

THE PROCEDURE EXPLAINED ABOVE SHALL CONFORM TO THE APPLICABLE PORTIONS OF SECTIONS 353, 406, 602, AND 603 OF THE STANDARD SPECIFICATIONS EXCEPT THAT "THE CONTRACTOR SHALL ADJUST THE STRUCTURES TO THE FINISHED PAVEMENT ELEVATION NO MORE THAN 5 CALENDAR DAYS PRIOR TO PLACEMENT OF THE FINAL LIFT OF SURFACE UNLESS APPROVED BY THE ENGINEER."

LEGEN

- 1 SUB-BASE GRANULAR MATERIAL
- (6) FRAME AND LID (SEE NOTES)
- 2 EXISTING PAVEMENT
- (7) CLASS PP-1* CONCRETE
- 3 36 (900) DIAMETER METAL PLATE
- (8) PROPOSED HMA SURFACE COURSE
- PROPOSED CRUSHED STONE AND HMA SURFACE MIX
- (5) EXISTING STRUCTURE

9 PROPOSED HMA BINDER COURSE

LOCATION OF STRUCTURES:

THE CONTRACTOR WILL BE REQUIRED TO KEEP A RECORD OF THE LOCATIONS OF THE BURIED STRUCTURES ACCORDING TO THE STATION AND DISTANCE LEFT OR RIGHT OF THE CENTERLINE OF PAVEMENT. UPON COMPLETION OF THE WORK, THE CONTRACTOR WILL DELIVER THE RECORD TO THE ENGINEER.

BASIS OF PAYMENT:

REMOVING FRAMES AND LIDS ON DRAINAGE AND UTILITY STRUCTURES IN THE PAVEMENT PRIOR TO MILLING, AND ADJUSTING TO FINAL GRADE PRIOR TO PLACING THE SURFACE COURSE, WILL BE PAID FOR AT THE CONTRACT UNIT PRICE EACH FOR "FRAMES AND LIDS TO BE ADJUSTED (SPECIAL)."

THIS WORK WILL NOT BE PAID FOR WHEN DRAINAGE AND UTILITY STRUCTURES ARE SPECIFIED FOR PAYMENT AS STRUCTURE RECONSTRUCTION.

NEW FRAMES AND LIDS, WHEN SPECIFIED, WILL BE PAID FOR SEPARATELY.


DETAILS FOR FRAMES AND LIDS ADJUSTMENT WITH MILLING

ALL DIMENSIONS ARE IN INCHES (MILLIMETERS) UNLESS OTHERWISE SHOWN

DESIGNED R. SHAH USER NAME = bauerdl REVISED - R. WIEDEMAN 05-14-04 :\pw_work\pwidot\bauerdl\d0108315\bd0 DRAWN REVISED - R. BORO 01-01-C7 LOT SCALE = 1968.5000 '/ m CHECKED REVISED - R. BORO 03-09-11 - R. BORO 12-06-11 PLOT DATE = 12/6/2011 DATE REVISED

STATE OF ILLINOIS
DEPARTMENT OF TRANSPORTATION

| FRAMES AND LIDS | ADJUSTMENT WITH MILLING | FED. ROAD DIST. NO. 1 OF 1 SHEET | STA. TO STA. | FED. ROAD DIST. NO. 1 LILLING'S FED. ROAD DIST. NO. 1 LILLING'

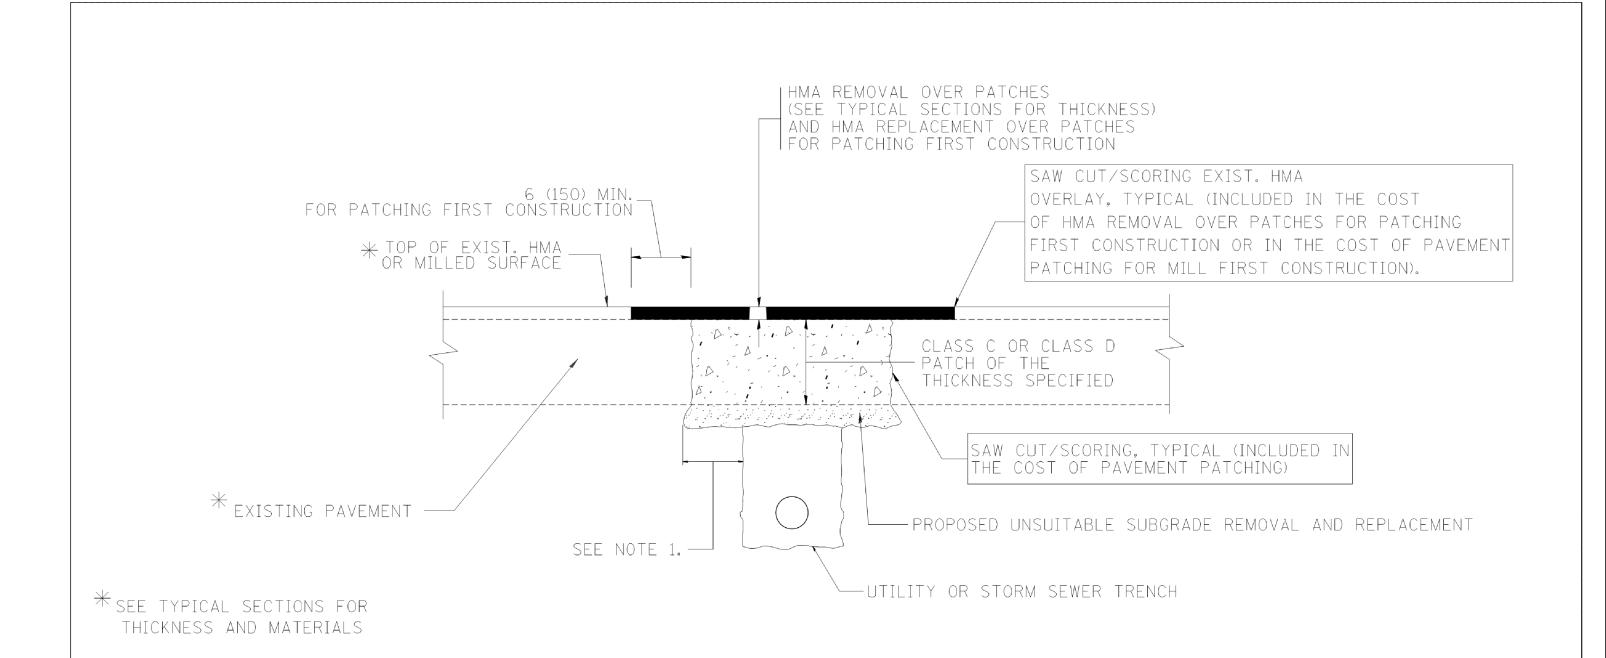

NOTES:

- 1. THE WIDTH OF THE FULL DEPTH PATCH OVER A TRENCH SHALL BE 12 (300) WIDER ON EACH SIDE OF THE TRENCH.
- 2. FOR METHOD OF MEASUREMENT AND BASIS OF PAYMENT, SEE RECURRING SPECIAL PROVISION "PATCHING WITH HOT-MIX ASPHALT OVERLAY REMOVAL".

SEQUENCE OF CONSTRUCTION (PATCHING FIRST)

- 1. REMOVE THE EXISTING HMA MATERIAL OVER THE AREA TO BE PATCHED.
- 2. REMOVE AND REPLACE WITH CLASS C OR D PATCH.
- 3. REPLACE HMA MATERIAL OVER THE AREA TO BE PATCHED.

SEQUENCE OF CONSTRUCTION (MILLING FIRST)

- 1. MILL HMA FIRST IF THERE IS AT LEAST $4\frac{1}{2}$ INCHES OR MORE OF HMA MATERIAL ON TOP OF THE EXISTING PAVEMENT OR IF THE PAVEMENT IS FULL DEPTH HMA. A MINIMUM OF 2 INCHES OF HMA MATERIAL SHALL BE IN PLACE AFTER MILLING.
- 2. REMOVE AND REPLACE WITH FULL DEPTH CLASS D PATCHES TO TOP OF MILLED SURFACE.


ALL DIMENSIONS ARE IN INCHES (MILLIMETERS) UNLESS OTHERWISE SHOWN.

	FILE NAME =	USER NAME = bauerdl	DESIGNED - R. SHAH	REVISED -	A. ABBAS 04-27-98	
ΞE:	c:\projects\diststd22x34\bd22.dgn		DRAWN -	REVISED -	R. BORO 01-01-07	
ĭ		PLOT SCALE = 50.000 ' / IN.	CHECKED -	REVISED -	R. BORO 09-04-07	
PEN		PLOT DATE = 10/27/2008	DATE - 10-25-94	REVISED -	K. ENG 10-27-08	

STATE	OF ILLINOIS	
DEPARTMENT 0	F TRANSPORTATION	

SCALE: NONE

	PAVEMENT PATCHING FOR HMA SURFACED PAVEMENT						F.A.U. RTE.	SECTION	COUNTY	TOTAL	SHEET NO.
							2958	15-00063-00-RS	соок	30	24
		11417	1 3	UNITAGED F	WATMEN			BD400-04 (BD-22)	CONTRACT	NO.	61G09
HEET	NO. :	1 (OF 1	SHEETS	STA.	TO STA.	FED. R	DAD DIST. NO. 1 ILLINOIS FED.	AID PROJECT		

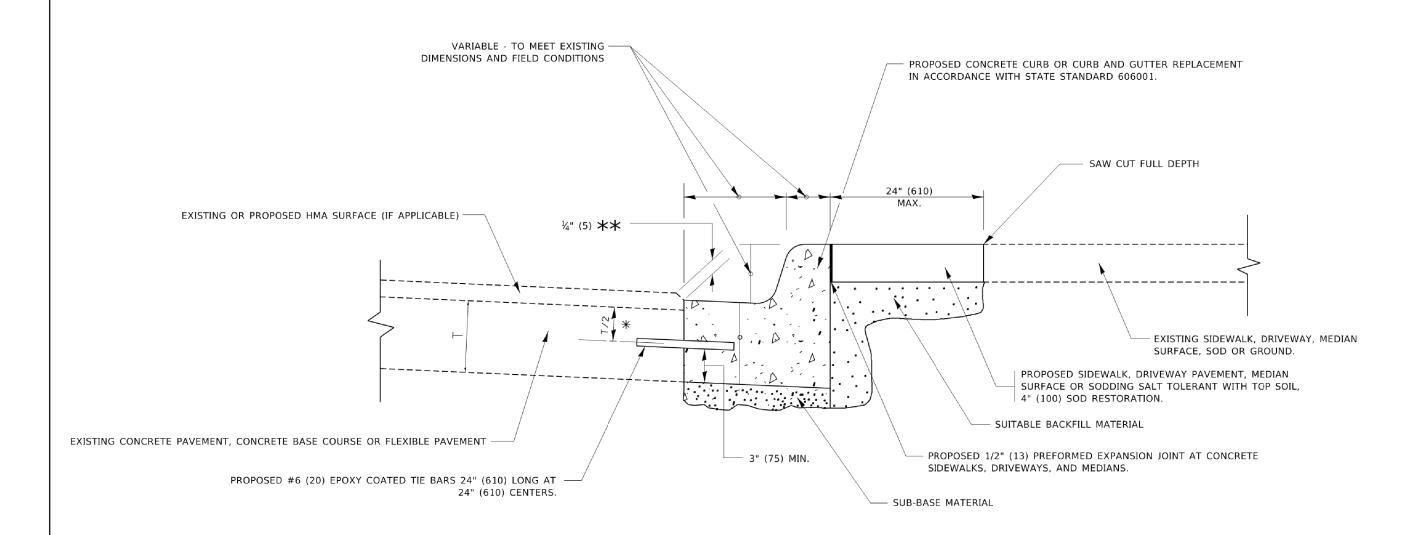


- X 3" (75) MINIMUM FROM TOP AND BOTTOM OF THE CONCRETE PAVEMENT OR BASE COURSE.
- $\star\star$ IF THE FINAL SURFACE OF THE PAVEMENT IS CONCRETE, THE GUTTER IS TO BE FLUSH WITH THE PAVEMENT.

CURB OR CURB AND GUTTER REMOVAL AND REPLACEMENT

ALL DIMENSIONS ARE IN INCHES (MILLIMETERS) UNLESS OTHERWISE SHOWN.

Md :		USER NAME = footemj	DESIGNED - A. HOUSEH	REVISED - A. A	ABBAS 03-21-97		CURB OR CURB AND GUTTER	F.A.U RTE.	SECTION	COUNTY	TOTAL SHEET!	SHE
ARFE			DRAWN -	REVISED - M. G	GOMEZ 01-22-01	STATE OF ILLINOIS	REMOVAL AND REPLACEMENT	2958	15-00063-00-RS	соок	30	25
EN EN	-	PLOT SCALE = 50.0000 ' / in. PLOT DATE = 7/11/2019	CHECKED -	REVISED - R. B	BORO 12-15-09	DEPARTMENT OF TRANSPORTATION	SCALE: NONE SHEET 1 OF 1 SHEETS STA. TO STA.	F	BD600-06 (BD-24)	CONTRACT	NO.	61G0

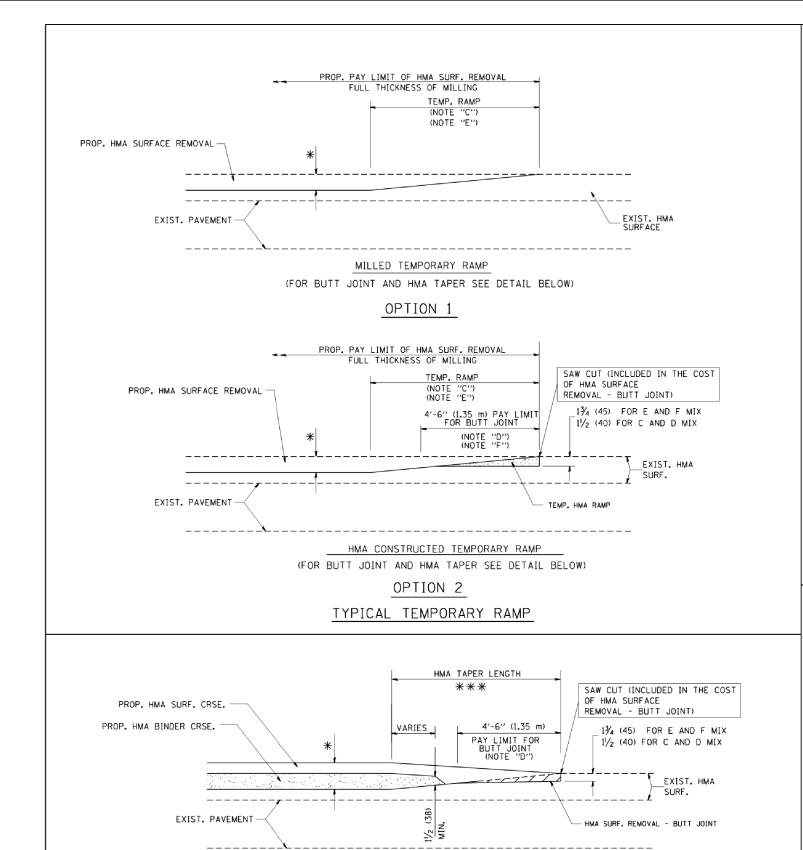

TYPICAL BUTT JOINT AND HMA TAPER FOR MILLING AND RESURFACING

06-13-90

REVISED

REVISED

REVISED

REVISED

DESIGNED - M. DE YONG

DRAWN

DATE

CHECKED

USER NAME = gaglianobt

PLOT DATE = 1/4/2008

BUTT JOINT AND

HMA TAPER

R. SHAH 10-25-94 A. ABBAS 03-21-97 M. GOMEZ 04-06-01 R. BORO 01-01-07

OTHERWISE SHOWN. AL SHEE 26


ALL DIMENSIONS ARE IN INCHES (MILLIMETERS) UNLESS

61G09

DEPARTM

							F.A.U. RTE.	SECTION	COUNTY	TOTAL
STATE OF ILLINOIS MENT OF TRANSPORTATION							2958	15-00063-00-RS	COOK	30
							l	BD400-05 BD32	CONTRACT	NO.
	SCALE: NONE	SHEET NO. 1 (OF 1	SHEETS	STA.	TO STA.	FED. R	OAD DIST. NO. 1 ILLINOIS FED. AI	D PROJECT	

PROP. HMA OR PCC SURFACE REMOVAL - BUTT JOINT SAW CUT (INCLUDED IN THE COST EXIST. HMA OR PCC SURFACE 30'-0" (9.0 m) (NOTE "A") OF HMA OR P.C.C. SURFACE REMOVAL 15'-0" (4.5 m) (NOTE "B") BUTT JOINT) (NOTE "D") 13/4 (45) FOR E AND F MIX 1/2 (40) FOR C AND D MIX * * EXIST. PAVEMENT BUTT JOINT DETAIL

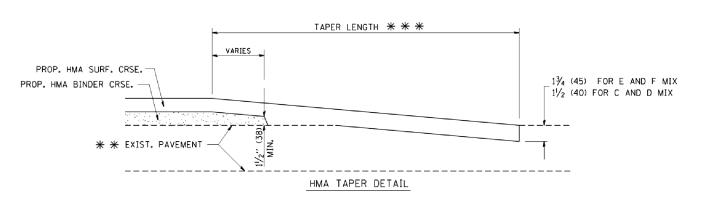

TYPICAL BUTT JOINT AND HMA TAPER FOR RESURFACING ONLY

* * PC CONCRETE, HMA OR HMA RESURFACED PAVEMENT.


NOTES

- A: MAINLINE ROADWAYS AND MAJOR SIDE ROADS.
- B: MINOR SIDE ROADS.
- C: THE TEMP. RAMP SHALL BE CONSTRUCTED IMMEDIATELY UPON REMOVAL OF THE EXISTING HMA SURFACE.
- D: THE BUTT JOINT SHALL BE CONSTRUCTED IMMEDIATELY PRIOR TO PLACING THE PROPOSED HMA COURSES.
- E: TAPER THE TEMP. RAMP AT A RATE OF 3'-0" (900 mm) PER 1 INCH (25 mm) OF MILLING THICKNESS.
- F: INSTALLATION AND REMOVAL OF THE 4'-6" (1.35 m) TEMP. RAMP IS INCLUDED IN COST OF HMA SURFACE REMOVAL - BUTT JOINT
- G: SEE ARTICLE 406.08 AND 406.14 OF THE STANDARD SPECIFICATIONS FOR "HMA AND/OR PCC SURFACE REMOVAL, BUTT JOINT".
- * SEE TYPICAL SECTIONS FOR MILLING THICKNESS.
- * * * * 20'-0" (6.1 m) PER 1 (25) RESURFACING (NOTE "A") 10'-0" (3.0 m) PER 1 (25) RESURFACING (NOTE "B")

BASIS OF PAYMENT:

THE BUTT JOINT WILL BE PAID FOR AT THE CONTRACT UNIT PRICE PER SOUARE YARD (SOUARE METER) FOR "HOT-MIX ASPHALT SURFACE REMOVAL - BUTT JOINT" OR FOR "PORTLAND CEMENT CONCRETE SURFACE REMOVAL- BUTT JOINT".

:\diststd\22x34\bd32.dgr

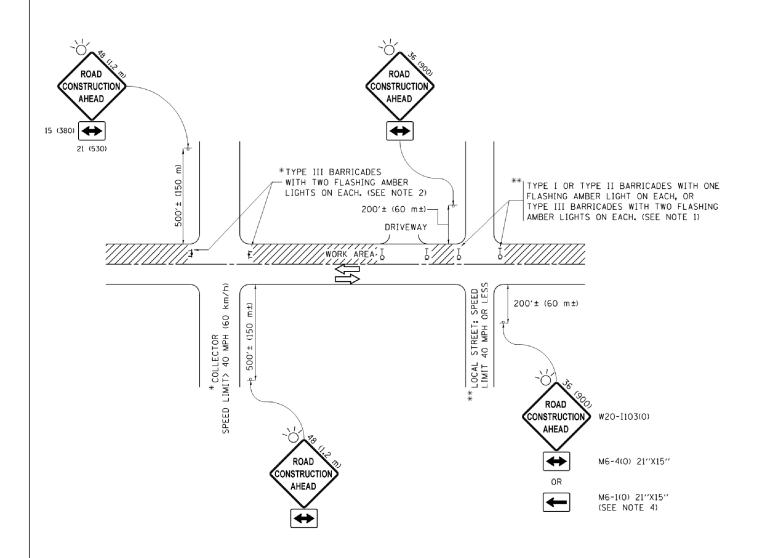

NOTES:

- 1. SIDE ROAD WITH A SPEED LIMIT OF 40 MPH (60 km/h) OR LESS AS SHOWN ON THE DRAWING AND AS DIRECTED BY THE ENGINEER:
 - ONE "ROAD CONSTRUCTION AHEAD" SIGN 36 x 36 (900x900) WITH A FLASHER MOUNTED ON IT APPROXIMATELY 200" (60 m) IN ADVANCE OF THE MAIN ROUTE.
 - b) THE CLOSED PORTION OF THE MAIN ROUTE SHALL BE PROTECTED BY BLOCKING WITH TYPE I, TYPE II OR TYPE III BARRICADES, 1/3 OF THE CROSS SECTION OF THE CLOSED PORTION.
- 2. SIDE ROAD WITH A SPEED LIMIT GREATER THAN 40 MPH (60 km/h) AS SHOWN ON THE DRAWING AND AS DIRECTED BY THE ENGINEER:
 - a) ONE "ROAD CONSTRUCTION AHEAD" SIGN 48 \times 48 (1.2 m \times 1.2 m) WITH A FLASHER MOUNTED ON IT APPROXIMATELY 500' (150 m) IN ADVANCE OF THE MAIN ROUTE.
 - b) THE CLOSED PORTION OF THE MAIN ROUTE SHALL BE PROTECTED BY BLOCKING WITH TYPE III BARRICADES, 1/2 OF THE CROSS SECTION OF THE CLOSED PORTION.
- 3. CONES MAY BE SUBSTITUTED FOR BARRICADES OR DRUMS AT HALF THE SPACING DURING DAY OPERATIONS. CONES SHALL BE A MINIMUM OF 28 (710)
- 4. WHEN THE SIDE ROAD LIES BETWEEN THE BEGINNING OF THE MAINLINE SIGNING AND THE WORK ZONE, A SINGLE HEADED ARROW (M6-1) SHALL BE USED IN LIEU OF THE DOUBLE HEADED ARROW (M6-4).

SCALE: NONE

- 5. WHEN WORK IS BEING PERFORMED ON A SIDE ROAD OR DRIVEWAY, FOLLOW THE APPLICABLE STANDARD(S). THE DIRECTIONAL
 ARROW (M6-1 OR M6-4) SHALL BE COVERED OR REMOVED WHEN NO LONGER CONSISTENT WITH THE TRAFFIC CONTROL SET-UP.
- 6. ADVANCE WARNING SIGNS ARE TO BE OMITTED ON DRIVEWAYS UNLESS OTHERWISE SPECIFIED IN THE PLANS OR BY THE
- 7. THE TRAFFIC CONTROL AND PROTECTION FOR SIDE ROADS, INTERSECTIONS, AND DRIVEWAYS SHALL BE INCLUDED IN THE COST OF SPECIFIED TRAFFIC CONTROL STANDARDS OR ITEMS.


All dimensions are in inches (millimeters) unless otherwise shown.

FILE NAME =	USER NAME = footemj	DESIGNED - L.H.A.	REVISED	- A. HOUSEH 10-15-96
pw:\\ILØ84EBIDINTEG.:1ll:no:s.gov:PWIDOT\Do	puments\IDOT Offices\District 1\Projects\Dist	St ∂R`AWM \CADD a ta\CADsheets\tc10.dgn	REVISED	-T. RAMMACHER 01-06-00
	PLOT SCALE = 50.000 '/ in.	CHECKED -	REVISED	- A. SCHUETZE 07-01-13
Default	PLOT DATE = 9/15/2016	DATE - 06-89	REVISED	 A. SCHUETZE 09-15-16

STATI	E OF	: ILLINOIS
DEPARTMENT	0F	TRANSPORTATION

TRAFFIC CONTROL AND PROTECTION FOR						F.A. RTE.	SECTION	
ÇI	SIDE ROADS, INTERSECTIONS, AND DRIVEWAYS					2958 15-00063-00-RS		
31	SIDE NOADS, INTERSECTIONS, AND DRIVEWATS						TC-10	
	SHEET 1	OF 1	SHEETS	STA.	TO STA.		ILLINOIS FED. A	

COUNTY COOK 30 27 CONTRACT NO. 61G09 ILLINOIS FED. AID PROJECT

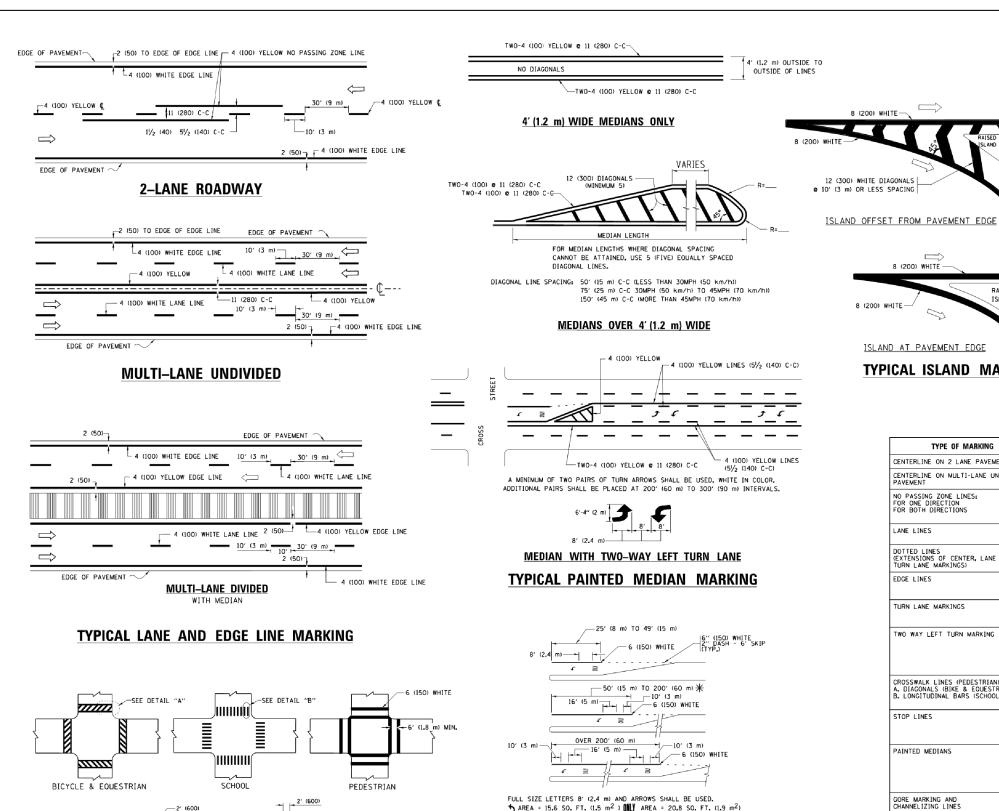

↑ AREA = 15.6 SO. FT. (1.5 m²) (NLY AREA = 20.8 SO. FT. (1.9 m²) * TURN LANES IN EXCESS OF 400' (120 m) IN LENGTH MAY HAVE AN ADDITIONAL SET OF ARROW - "ONLY" INSTALLED MIDWAY BETWEEN THE OTHER TWO SETS OF

TYPICAL LEFT (OR RIGHT) TURN LANE

TYPICAL TURN LANE MARKING

DESIGNED -EVERS C. JUCIUS 09-09-09 REVISED ents\IDOT Offices\District 1\Projects\I St**DRAWM**\CADData\CADsheets\to13.do REVISED C. JUCIUS 07-01-13 CHECKED REVISED C. JUCIUS 12-21-15 DATE 03-19-90 REVISED C. JUCIUS 04-12-16

TYPICAL CROSSWALK MARKING

* MARKINGS SHALL BE INSTALLED PARALLEL TO THE CENTERLINE OF

12 (300) WHITE

DETAIL "B"

6 (150) WHITE

THE ROAD WHICH IT CROSSES

DETAIL "A"

STATE OF ILLINOIS **DEPARTMENT OF TRANSPORTATION** 8 (200) WHITE -

ISLAND AT PAVEMENT EDGE

TYPICAL ISLAND MARKING

8 (200) WHITE-

RAISED

2 (50)


CONSTRUCTION AND STATE STANDARD 780001. SECTION COUNTY DISTRICT ONE 2958 15-00063-00-RS COOK 30 28 TYPICAL PAVEMENT MARKINGS CONTRACT NO. 61G09 OF 1 SHEETS STA. TO STA. SCALE: NONE SHEET 1

D(FT) SPEED LIMIT 345 30 425 500 580 665 50 750 40 (1020) 64 (1620) **COMBINATION** LEFT AND U-TURN 5'-4" (1620)

> LANE REDUCTION TRANSITION * LANE REDUCTION ARROWS REQUIRED AT SPEEDS OF 45 MPH OF GREATER OR WHEN SPECIFIED IN PLANS.

TYPE OF MARKING	WIDTH OF LINE	PATTERN	COLOR	SPACING /REMARKS
CENTERLINE ON 2 LANE PAVEMENT	4 (100)	SKIP-DASH	YELLOW	10' (3 m) LINE WITH 30' (9 m) SPACE
CENTERLINE ON MULTI-LANE UNDIVIDED PAVEMENT	2 @ 4 (100)	SOLID	YELLOW	11 (280) C-C
NO PASSING ZONE LINES: FOR ONE DIRECTION FOR BOTH DIRECTIONS	4 (100) 2 0 4 (100)	SOLID SOLID	YELLOW YELLOW	5½ (140) C-C FROM SKIP-DASH CENTERLINE 11 (280) C-C OMIT SKIP-DASH CENTERLINE BETWEEN
LANE LINES	4 (100) 5 (125) ON FREEWAYS	SKIP-DASH SKIP-DASH	WHITE WHITE	10' (3 m) LINE WITH 30' (9 m) SPACE
DOTTED LINES (EXTENSIONS OF CENTER, LANE OR TURN LANE MARKINGS)	SAME AS LINE BEING EXTENDED	SKIP-DASH	SAME AS LINE BEING EXTENDED	2' (600) LINE WITH 6' (1.8 m) SPACE
EDGE LINES	4 (100)	SOLID	YELLOW-LEFT WHITE-RIGHT	OUTLINE MEDIANS IN YELLOW
TURN LANE MARKINGS	6 (150) LINE; FULL SIZE LETTERS & SYMBOLS (8' (2.4m))	SOLID	WHITE	SEE TYPICAL TURN LANE MARKING DETAIL
TWO WAY LEFT TURN MARKING	2 @ 4 (100) EACH DIRECTION 8' (2.4m) LEFT ARROW	SKIP-DASH AND SOLID IN PAIRS	YELLOW	10' (3 m) LINE WITH 30' (9 m) SPACE FOR SKIP-DASH, 5½ (140) C-C BETWEEN SOLID LINE AND SKIP-DASH LINE SEE TYPICAL TWO-WAY LEFT TURN MARKING DETAIL
CROSSWALK LINES (PEDESTRIAN) A. DIAGONALS (BIKE & EQUESTRIAN) B. LONGITUDINAL BARS (SCHOOL)	2 © 6 (150) 12 (300) © 45° 12 (300) © 90°	SOLID SOLID SOLID	WHITE WHITE WHITE	NOT LESS THAN 6' (1,8 m) APART 2' (600) APART 2' (600) APART 5EE TYPICAL CROSSWALK MARKING DETAILS,
STOP LINES	24 (600)	SOLID	WHITE	PLACE 4' (1.2 m) IN ADVANCE OF AND PARALLEL TO CROSSMALK, IF PRESENT. OTHERWISE, PLACE AT DESIRED STOPPING POINT. PARALLEL TO CROSSROAD CENTERLINE, WHERE POSSIBLE
PAINTED MEDIANS	2 @ 4 (100) WITH 12 (300) DIAGONALS @ 45° NO DIAGONALS USED FOR 4' (1.2 m) WIDE MEDIANS	SOLID	YELLOW: TWO WAY TRAFFIC WHITE: ONE WAY TRAFFIC	11 (280) C-C FOR THE DOUBLE LINE SEE TYPICAL PAINTED MEDIAN MARKING.
GORE MARKING AND CHANNELIZING LINES	8 (200) WITH 12 (300) DIAGONALS @ 45°	SOLID	WHITE	DIAGONALS: 15' (4.5 m) C-C (LESS THAN 30MPH (50 km/h)) 20' (6 m) C-C 30MPH (50 km/h) TO 45MPH (70 km/h)) 30' (9 m) C-C (0VER 45MPH (70 km/h))
RAILROAD CROSSING	24 (600) TRANSVERSE LINES; "RR" IS 6' (1.8 m) LETTERS; 16 (400) LINE FOR "X"	SOLID	WHITE	SEE STATE STANDARD 780001 AREA OF: "R"=3.6 SO. FT. (0.33 m²) EACH "X"=54.0 SO. FT. (5.0 m²)
SHOULDER DIAGONALS (REQUIRED FOR SHOULDERS ≥ 8')	12 (300) @ 45°	SOLID	WHITE - RIGHT YELLOW - LEFT	50' (15 m) C-C (LESS THAN 30MPH (50 km/h)) 75' (25 m) C-C (30 MPH (50 km/h) TO 45MPH (70 km/h) 150' (45 m) C-C (0VER 45MPH (70 km/h))
U TURN ARROW	SEE DETAIL	SOLID	WHITE	16.3 SF
2 ARROW COMBINATION LEFT AND U TURN	SEE DETAIL	SOLID	WHITE	30.4 SF

II TUDN

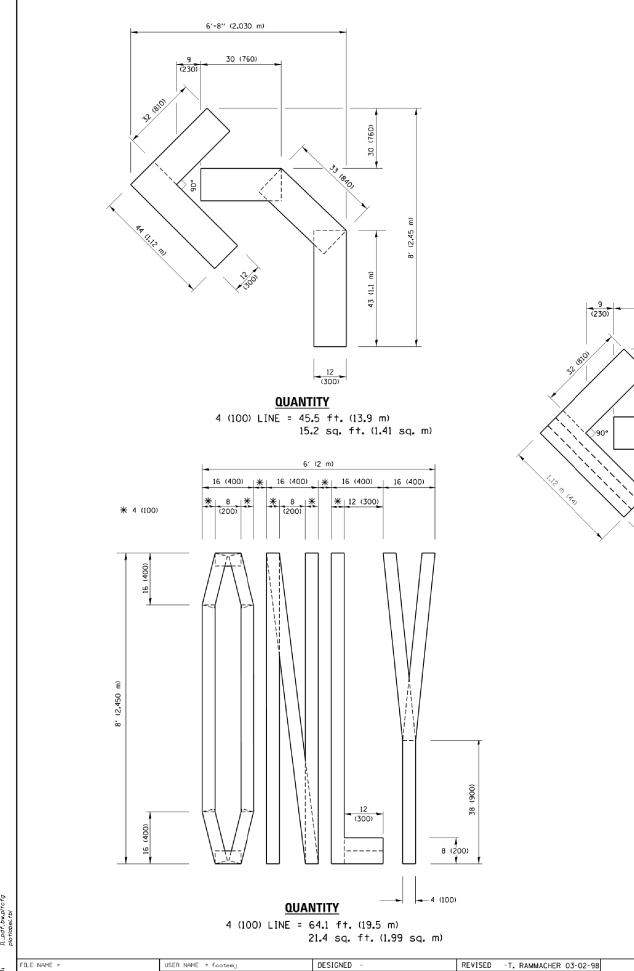

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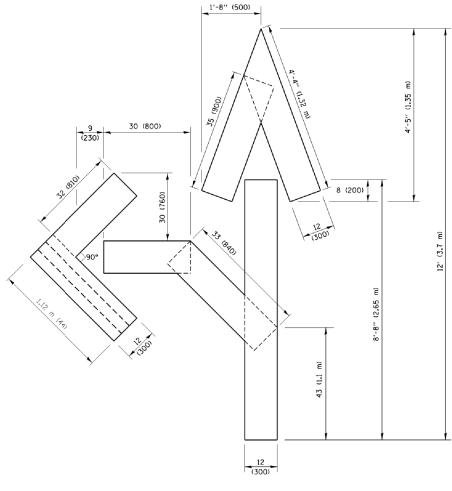
CHECKED

09-18-94

DATE

PLOT SCALE = 50.0000 '/ in.

PLOT DATE = 9/15/2016




QUANTITY

4 (100) LINE = 82.5 ft. (25.1 m) 27.5 sq. ft. (2.53 sq. m)

NOTE:

ALL QUANTITIES OF PLACEMENT ARE REPRESENTED IN LINEAR FEET OF 4" LINES TO MATCH THE 4" TEMPORARY TAPE PAY ITEM AND REPRESENTS THE TOTAL QUANTITY OF 4" TAPE REQUIRED.

STATE OF ILLINOIS

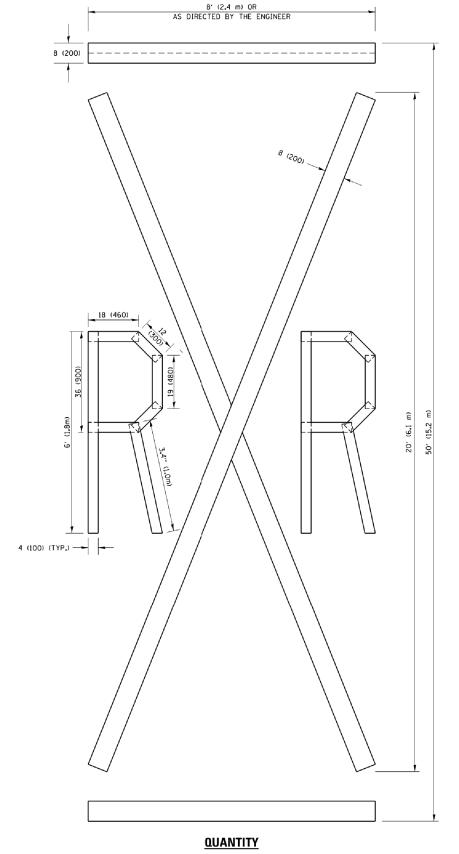

4 (100) LINE = 225.9 ft. (68.9 m) 75.3 sq. ft. (6.99 sq. m)

> All dimensions are in inches (millimeters) unless otherwise shown.

> > CONTRACT NO. 61G09

REVISED - E. GOMEZ 08-28-00 REVISED - E. GOMEZ 08-28-00 REVISED - A. SCHUETZE 09-15-16

DEPARTMENT OF TRANSPORTATION SCALE: NONE


SHORT TERM PAVEMENT MARKING LETTERS AND SYMBOLS SHEET NO. 1 OF 1 SHEETS STA.

SECTION COUNTY 15-00063-00-RS СООК 30 29 2958

TC-16

FED. ROAD DIST. NO. 1 | ILLINOIS FED. AID PROJECT

w:\\ILØ84EBIDINTEG.:111:no:s.gov:PWIDOT\Do

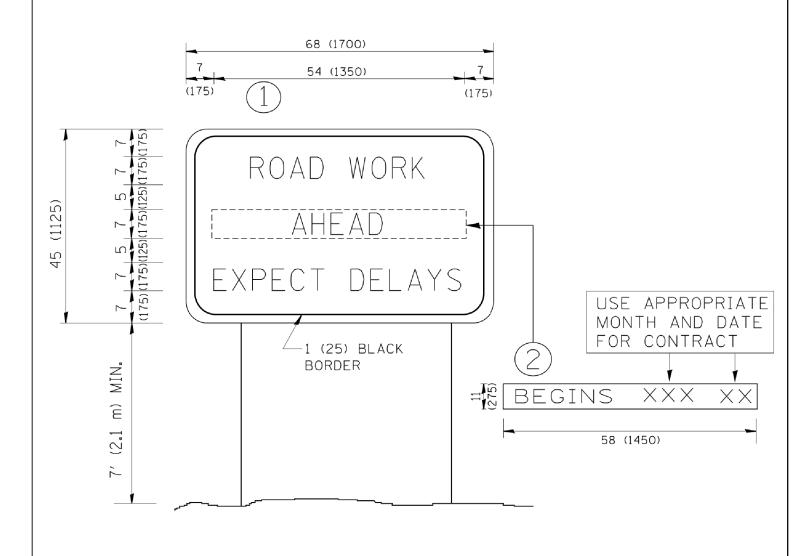

NOTES:

- 1. USE BLACK LETTERING ON ORANGE BACKGROUND.
- 2. ERECT SIGNS IN ADVANCE OF THE LOCATION FOR THE "ROAD CONSTRUCTION AHEAD" SIGN AT LOCATIONS AS DIRECTED BY THE ENGINEER.
- 3. ERECT SIGN () WITH INSTALLED PANEL (2) ONE WEEK PRIOR TO THE START OF CONSTRUCTION.

TO STA.

- 4. REMOVE PANEL (2) SOON AFTER THE START OF CONSTRUCTION.
- 5. SEE SPECIAL PROVISION FOR "TEMPORARY INFORMATION SIGNING" FOR ADDITIONAL INFORMATION.
- 6. ONE SIGN ASSEMBLY EQUALS 25.70 SQ. FT. (2.3 SQ. M.)
- 7. SHALL BE PAID FOR AS TEMPORARY INFORMATION SIGNING.

ALL DIMENSIONS ARE IN INCHES (MILLIMETERS) UNLESS OTHERWISE SHOWN.

l					
I	FILE NAME =	USER NAME = gaglianobt	DESIGNED -	REVISED	- R. MIRS 09-15-97
I	W:\diststd\22x34\tc22.dgn		DRAWN -	REVISED	- R. MIRS 12-11-97
I		PLOT SCALE = 50.000 '/ IN.	CHECKED -	REVISED	-T. RAMMACHER 02-02-9
I		PLOT DATE = 1/4/2008	DATE -	REVISED	- C. JUCTUS 01-31-07

	ARTERIAL ROAD					
		INFO	DRMATION	SIGN		
SCALE: NONE	SHEET NO. 1	OF 1	SHEETS	STA.		

F.A.U. RTE.	SECT	TION	COUNTY	TOTAL SHEETS	SHEE NO.	
2958	15-0006	3-00-RS	COOK	30	30	
	TC-22		CONTRACT	NO. 6	51GO	
FED. R	DAD DIST. NO. 1	ILLINOIS F	ED. AI	ID PROJECT		