04-22-2016 LETTING ITEM 128

FOR INDEX OF SHEETS, SEE SHEET NO. 2

TRAFFIC DATA

MILL ROAD (MAJOR COLLECTOR) 2012 ADT = 3,500

MARY JANE LANE (LOCAL) ADT = 300

VICTORIA LANE (LOCAL)

ADT = 300

POSTED SPEED LIMIT: 30 MPH DESIGN SPEED LIMIT: 30 MPH

POSTED SPEED LIMIT: 20 MPH DESIGN SPEED LIMIT: 20 MPH

POSTED SPEED LIMIT: 20 MPH

DESIGN SPEED LIMIT: 20 MPH

FOR INDEX OF HIGHWAY STANDARDS, SEE SHEET NO. 2

STATE OF ILLINOIS **DEPARTMENT OF TRANSPORTATION DIVISION OF HIGHWAYS**

PLANS FOR PROPOSED FEDERAL AID HIGHWAY

FAU 2625 MILL ROAD (I-290 TO IRVING PARK ROAD), MARY JANE LANE (MILL ROAD TO PROSPECT AVENUE), **VICTORIA LANE (MILL ROAD TO PROSPECT AVENUE)**

> SECTION: 14-00051-00-RS PROJECT: M-4003(303) JOB: C-91-260-14

RESURFACING AND WATERMAIN IMPROVEMENTS

CITY OF WOOD DALE **DuPAGE COUNTY**

MUN 4028 VICTORIA LANE **IMPROVEMENT ENDS** STA 132+95

FAU 2625 MILL ROAD **OMISSION ENDS** STA 77+00

FAU 2625 MILL ROAD IMPROVEMENT ENDS OMISSION BEGINS STA 62+83

MUN 4028 VICTORIA LANE IMPROVEMENT BEGINS STA 120+19

MUN 4025 MARY JANE LANE IMPROVEMENT BEGINS STA 100+12

ENGINEERING SCALES, REDUCED SIZED PLANS WILL NOT CONFORM TO STANDARD SCALES. IN MAKING MEASUREMENTS ON REDUCED PLANS, THE ABOVE SCALES MAY BE USED.

J.U.L.I.E. DESIGN STAGE REQUEST DIG. No. A3012822



CONTACT JULIE AT 811 OR 800-892-0123 WITH THE FOLLOWING:


CITY-TWNSHP. = WOOD DALE-ADDISON

MILINOIS

SEC. & 1/4 SEC. NU. = 311 E 1/2

48 HOURS (2 working days) BEFORE YOU DIG

CONTRACT NO. 61C6

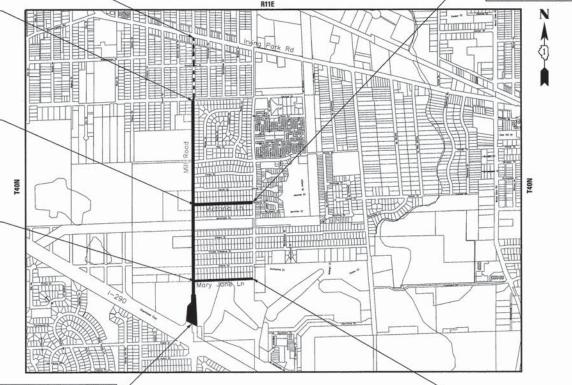

FAU 2625 MILL ROAD IMPROVEMENT BEGINS

GROSS LENGTH = 9,114 FT. = 1.726 MILES

MUN 4025 MARY JANE LANE IMPROVEMENT ENDS STA 113+00



14-00051-00-RS

M-4003(303)

DuPAGE 31 ILLINOIS CONTRACT NO. 61C6



DEPARTMENT OF TRANSPORTATION DIVISION OF HIGHWAYS

PRINTED BY THE AUTHORITY OF THE STATE OF ILLINOIS

B&W PROJECT NO.: 150676

DATE: 01-25-16

STA 11+50

NET LENGTH = 7,697 FT. = 1.458 MILES

GENERAL NOTES

- ALL CONSTRUCTION SHALL BE DONE IN ACCORDANCE WITH THE DETAILS IN THE PLANS, THE SPECIAL PROVISIONS INCLUDED IN THE CONTRACT DOCUMENTS, AND THE LATEST EDITION OF THE FOLLOWING STATE OF ILLINOIS SPECIFICATIONS: "THE STANDARD SPECIFICATIONS FOR ROAD AND BRIDGE CONSTRUCTION" (REFERRED TO AS THE "STANDARD SPECIFICATIONS"), THE "SUPPLEMENTAL SPECIFICATIONS AND RECURRING SPECIAL PROVISIONS", THE "MANUAL ON UNIFORM TRAFFIC CONTROL DEVICES FOR STREETS AND HIGHWAYS", THE "MANUAL OF TEST PROCEDURES FOR MATERIALS" AND THE "STANDARD SPECIFICATIONS FOR WATER AND SEWER MAIN CONSTRUCTION IN
- 2. THE LOCATIONS OF PUBLIC OR PRIVATE UTILITIES SHOWN ON THE PLANS REPRESENTS ONLY THE OPINION OF THE CITY AND IS ONLY INCLUDED FOR THE CONVENIENCE OF THE BIDDER AND THE ACCURACY IS NOT GUARANTEED. THE CONTRACTOR SHALL BE RESPONSIBLE FOR THE PROTECTION OF ALL UNDERGROUND OR SURFACE UTILITIES, INCLUDING SPRINKLER SYSTEMS, EVEN THOUGH THEY MAY NOT BE SHOWN ON THE PLANS.
- 3. THE CONTRACTOR SHALL NOTIFY THE CITY PUBLIC WORKS DIRECTOR, MATT YORK 630-787-3765, AT LEAST 48 HOURS IN ADVANCE OF BEGINNING WORK TO OBTAIN CITY UTILITY LOCATIONS.
- 4. THE CONTRACTOR MAY OBTAIN MUNICIPAL WATER IN BULK, AT NO CHARGE, AS LONG AS THERE IS NOT A "WATERING BAN" IN EFFECT. THE INDISCRIMINATE USE OF FIRE HYDRANTS IS STRICTLY PROHIBITED. WATER FOR CONSTRUCTION SHALL BE METERED OR OTHERWISE ACCOUNTED FOR AND A DAILY LOG MAINTAINED. THE CONTRACTOR SHALL PROVIDE THE WATER TRUCK AND DRIVER REQUIRED TO OBTAIN AND TRANSPORT THIS WATER. THE CITY RESERVES THE RIGHT TO RESTRICT OR REFUSE THE USE OF CITY WATER IF DEEMED NECESSARY.
- 5. ACCESS TO PRIVATE DRIVEWAYS SHALL BE PROVIDED AT ALL TIMES EXCEPT DURING ACTUAL CONSTRUCTION ADJACENT THERE TO. TEMPORARY RAMPS SHALL BE CONSTRUCTED AS NEEDED TO PROVIDE SUCH ACCESS, UTILIZING AGGREGATE SURFACE COURSE FOR TEMPORARY ACCESS
- 6. IT WILL BE THE CONTRACTOR'S RESPONSIBILITY TO NOTIFY THE ENGINEER, RESIDENTS AND THE CITY WHEN ACCESS TO DRIVEWAYS WILL BE TEMPORARILY CLOSED DUE TO CURB AND GUTTER AND/OR DRIVEWAY REPLACEMENT. THE CONTRACTOR SHALL DISTRIBUTE NOTICES PROVIDED BY THE CITY TO RESIDENTS AT LEAST 24 HOURS PRIOR TO PLANNED CLOSURE. EVERY EFFORT SHALL BE MADE TO ACCOMMODATE ACCESS TO THESE PROPERTIES INCLUDING KNOCKING ON DOORS WHEN DRIVEWAYS ARE ABOUT TO BE CLOSED.
- 7. THE CONTRACTOR SHALL CONTACT THE LOCAL AGENCY MATERIAL INSPECTOR (SOIL AND MATERIAL CONSULTANTS - THOMAS JOHNSON - 847-870-0544) AT LEAST 48 HOURS PRIOR TO ANY CONCRETE OR HOT-MIX ASPHALT MATERIAL DELIVERIES.
- 8. THE DAYS PAVING OPERATION SHOULD RESULT IN A SINGLE TRANSVERSE JOINT. ANY COLD LONGITUDINAL JOINTS WILL NOT BE ACCEPTED. PROVIDING A SINGLE TRANSVERSE JOINT SHALL BE ACCOMPLISHED BY PAVING ONE LANE OF SUFFICIENT LENGTH THAT WILL ALLOW FOR THE PAVING OF THE ADJACENT LANE IN THE SAME DAY.
- 9. IN AREAS WHERE THE EXISTING DRIVEWAY, SIDEWALK, OR CURB AND GUTTER IS TO BE REMOVED AND REPLACED, THE REMOVAL AND DISPOSAL OF ANY ADDITIONAL MATERIAL REQUIRED TO ESTABLISH THE PROPOSED DRIVEWAY, SIDEWALK, OR CURB AND GUTTER SUBGRADE ELEVATION SHALL BE INCLUDED IN THE APPROPRIATE REMOVAL PAY ITEMS.
- 10. THE CONTRACTOR WILL BE REQUIRED TO USE A STEEL PLATE OR PLATES TO CLOSE ANY GAPS OCCURRING WHEN A FRAME IS OFFSET FROM THE STRUCTURE. THE STEEL PLATE SHALL BE 1/2-INCH THICK AND APPROXIMATELY 6-INCH WIDE BY 24-INCH LONG. SOME ADJUSTMENT IN SIZE MAY BE NECESSARY TO PREVENT THE STEEL PLATE FROM OVERHANGING THE OUTSIDE OF THE STRUCTURE WALL. THE STEEL PLATE SHALL BE BEDDED IN AND COVERED WITH MORTAR. THIS WORK SHALL BE INCLUDED IN THE COST OF STRUCTURE ADJUSTMENTS OR STRUCTURE RECONSTRUCTIONS.
- 11. THE CURB SHALL BE TAPERED TO THE GUTTER IN A FIVE (5) FOOT LENGTH WHEREVER THE CURB AND GUTTER TERMINATES, WITH AN EXPANSION JOINT PLACED AT THE START OF THE TAPER.
- 12. IN ALL TRENCHES CROSSING DRIVEWAYS, SIDEWALKS, AND ALL PROPOSED AND EXISTING ROADWAYS, THE MATERIAL FOR THE TOP 12 INCHES SHALL BE CA-6 CRUSHED GRAVEL OR CRUSHED STONE AND BE INCLUDED IN THE PAY ITEM FOR TRENCH BACKFILL.
- 13. DURING CONSTRUCTION, THE CONTRACTOR WILL BE PERMITTED TO LIMIT ON-STREET PARKING IN ORDER TO COMPLETE CONSTRUCTION OPERATIONS. THE CONTRACTOR WILL BE REQUIRED TO COORDINATE WITH THE MUNICIPALITY A MINIMUM OF 48 HOURS IN ADVANCE. IT WILL BE THE RESPONSIBILITY OF THE CONTRACTOR TO PLACE ADVANCE SIGNS TO ALERT RESIDENTS AND COMMUTERS OF THE CONSTRUCTION WORK. THE PLACEMENT OF THESE SIGNS SHALL TAKE PLACE 48 HOURS IN ADVANCE IN ORDER TO ALLOW SUFFICIENT TIME FOR RESIDENTS AND GENERAL PUBLIC TO REVISE THEIR PARKING PATTERNS.
- 14.ALL NEW CLOSED MANHOLE LIDS SHALL BE LABELED "WATER", "STORM", OR "SANITARY" ACCORDING TO THE TYPE OF STRUCTURE ON WHICH IT IS INSTALLED

THE CONTRACTOR SHALL SUBMIT A PRE-PLANNED SEQUENCE OF WORK AT THE PRECONSTRUCTION CONFERENCE FOR REVIEW AND APPROVAL. WORK SHALL BE SCHEDULED TO MINIMIZE INCONVENIENCE TO RESIDENTS AND TO MAINTAIN A REASONABLE LEVEL OF CONSTRUCTION EFFICIENCY. THE CITY RESERVES THE RIGHT TO RESTRICT WORK ON ANY AREA IF TRAFFIC CONTROL OPERATIONS BECOME

SUGGESTED SEQUENCE OF CONSTRUCTION:

- PRIOR TO CONSTRUCTION, INSTALL ALL TEMPORARY EROSION CONTROL DEVICES NECESSARY AND ESTABLISH ALL TRAFFIC CONTROL REQUIRED.
- CONSTRUCT CURB AND GUTTER REPAIRS ON ONE SIDE OF THE STREET AT A TIME, TO MINIMIZE CONGESTION. PROVIDE ACCESS TO DRIVEWAYS WITH TEMPORARY AGGREGATE AFTER 72 HOURS OF CURING TIME.
- MILL PAVEMENT AND INSTALL CLASS D PATCHES (MILL ROAD, MARY JANE LANE) OR COMPLETE AGGREGATE BASE REPAIRS (VICTORIA LANE).
- INSTALL PIPE DRAINS, CONNECTING SUMP LINES TO THE CURB, IF NOT ALREADY CONNECTED TO THE STORM SEWER, AS DIRECTED BY THE ENGINEER.
- REPEAT STEPS 3 AND 4 FOR THE OTHER SIDE OF THE STREET.
- BACKFILL BEHIND THE CURB AND RESTORE PARKWAYS.
- INSTALL HMA BINDER COURSE. BINDER COURSE SHALL BE INSTALLED WITHIN 10 DAYS OF THE START OF HMA MILLING.
- BEGIN INSTALLING DRIVEWAYS

AFTER ALL STAGES HAVE BEEN COMPLETED:

- A. FINISH DRIVEWAYS AND PARKWAY GRADING AND INSTALL TOPSOIL AND SOD.
- INSTALL HMA SURFACE COURSE.
- COMPLETE PUNCH LIST ITEMS AND REMOVE TEMPORARY EROSION CONTROL ITEMS ONCE SOD ESTABLISHES

CONSTRUCTION STAGING NOTES:

- ALL STREETS SHALL BE OPEN TO TRAFFIC AT THE END OF EACH DAY WITH BARRICADES PLACED AROUND ALL PARKED EQUIPMENT, STOCKPILES AND STEEP EMBANKMENTS
- ALL RESIDENTS SHALL HAVE ACCESS TO THEIR DRIVEWAYS AT THE END OF EACH DAY, EXCEPT DURING ADJACENT CURB AND GUTTER CONSTRUCTION OR CONCRETE DRIVEWAY
- ACCESS FOR MAIL SERVICE, GARBAGE COLLECTION, SCHOOL BUSES AND EMERGENCY VEHICLES MUST BE MAINTAINED AT ALL TIMES.

INDEX OF SHEETS

COVER SHEET

24

- INDEX OF SHEETS, HIGHWAY STANDARDS AND GENERAL NOTES 2
- 3 5 SUMMARY OF QUANTITIES
- EXISTING AND PROPOSED TYPICAL SECTIONS
- 9 13 GEOMETRIC PLAN - MILL ROAD
- 14 15 GEOMETRIC PLAN MARY JANE LANE
- 16 17 GEOMETRIC PLAN VICTORIA LANE
- MISCELLANEOUS DETAILS 18
- (BD-08) DETAILS FOR FRAMES AND LIDS ADJUSTMENT WITH MILLING 19
- (BD-24) CURB OR CURB AND GUTTER REMOVAL AND REPLACEMENT
- (BD-32) BUTT JOINT AND HMA TAPER DETAILS 21
- (TC-10) TRAFFIC CONTROL AND PROTECTION FOR SIDE ROADS, INTERSECTIONS, AND DRIVEWAYS 22
- (TC-13) TYPICAL PAVEMENT MARKINGS (TC-22) ARTERIAL ROAD INFORMATION SIGN

HIGHWAY STANDARDS

000001-06	STANDARD SYMBOLS, ABBREVIATIONS AND PATTERNS
280001-07	TEMPORARY EROSION CONTROL SYSTEMS
424001-08	PERPENDICULAR CURB RAMPS FOR SIDEWALKS
424011-02	CORNER PARALLEL CURB RAMPS FOR SIDEWALKS
424016-02	MID-BLOCK CURB RAMPS FOR SIDEWALKS
424021-03	DEPRESSED CORNER FOR SIDEWALKS
442201-03	CLASS C AND D PATCHES
604001-04	FRAME AND LIDS TYPE 1
606001-06	CONCRETE CURB TYPE B AND COMBINATION CONCRETE CURB AND GUTTER
701006-05	OFF-RD OPERATIONS, 2L, 2W, 15' (4.5 m) TO 24" (600 mm) FROM PAVEMENT
701301-04	LANE CLOSURE, 2L, 2W, SHORT TIME OPERATIONS
701311-03	LANE CLOSURE 2L, 2W MOVING OPERATIONS - DAY ONLY
701501-06	URBAN LANE CLOSURE, 2L, 2W, UNDIVIDED
701801-06	SIDEWALK, CORNER OR CROSSWALK CLOSURE
701901-05	TRAFFIC CONTROL DEVICES
780001-05	TYPICAL PAVEMENT MARKINGS

2016 INOIS

BAXTER WOODMAN

SUMMARY OF QUANTITIES

			CONSTRUCTION CODE				
				CONSTRUCTION CODE			
				MILL ROAD 75% FED 25% CITY	MARY JANE LANE	VICTORIA LANE	
CODE			TOTAL	ROADWAY	NON ·	NON	
NO.	МЕЛ	UNIT	QUANTITY	URBAN 00045	PARTICIPATING 000.5	PARTICIPATING 000 5	
20101000	TEMPORARY FENCE	FOOT	100	100			
20101100	TREE TRUNK PROTECTION	EACH	5	5			
20101200	TREE ROOT PRUNING	EACH	5	5			
20200100	EARTH EXCAVATION	CUYD	138	96	21	21	
20201200	REMOVAL AND DISPOSAL OF UNSUITABLE MATERIAL	CUYD	197	60	20	117	
21001000	GEOTECHNICAL FABRIC FOR GROUND STABILIZATION	SQYD	290			290	
21101615	TOPSOIL FURNISH AND PLACE, 4"	SQYD	893	537	178	178	
25000400	NTROGEN FERTILIZER NUTRIENT	POUND	13	7	3	3	
25000500	PHOSPHORUS FERTILIZER NUTRIENT	POUND	13	7	3	3	
25000600	POTASSIUM FERTILIZER NUTRIENT	POUND	13	7	3	3	
25200110	SODDING, SALTTOLERANT	SQYD	893	537	178	178	
25200200	SUPPLEMENTAL WATERING	UNIT	15	9	3	3	
28000250	TEMPORARY EROSION CONTROL SEEDING	POUND	20	12	4	4	
28000400	PERIMETER BROSION SA RRIER	FOOT	100	100			
28000510	INLET FILTERS	EACH	50	29	11	10	

				CONSTRUCTION CODE		
				MILL ROAD 75% FED 25% CITY	MARY JANELANE	VICTORIA LAN
	T			ROADWAY	NON	NON:
CODE	ПЕМ	UNIT	TOTAL	URBAN	PARTICIPATING	PARTICIPATING
NO.			QUANTITY	000 <i>\$</i>	000.5	0005
30300112	AGGREGATE SUBGRADE IMPROVEMENT 12"	SQYD	290			290
35101582	A GGREGATE BASE COURSE, TYPE B 2"	SQYD	63	63		
35101600	A GGREGATE BASE COURSE, TYPE B 4"	SQYD	924	634	145	145
35102000	AGGREGATE BASE COURSE, TYPE B 8"	SQYD	213	79	34	100
35800100	PREPARATION OF BASE	SQYD	3,620			3,620
35800200	A GGREGATE BASE REPAIR	TON	104			104
40600290	BITUMINOUS MATERIALS (TACK COAT)	POUND	23,170	11,200	2,190	9,780
40600400	MIXTURE FOR CRACKS, JOINTS, AND FLANGEWAYS	TON	30	25	5	
40000000	LEVEL BAS DINIDER ANA CHINE METHOD). AND	TON	1.140	954	186	
40600625	LEVELING BINDER (MACHINE METHOD), N50	TON	1,140	904	100	
40600982	HOT-MIX ASPHALT SURFACE REMOVAL - BUTT JOINT	SQYD	183	158	12	13
40603080	HOT-MIX A SPHALT BINDER COURSE, IL-19.0, N50	TON	531			531
40603335	HOT-MIX A SPHALT SURFACE COURSE, MIX "D", N50	TON	2,479	1,717	335	427
42001300	PROTECTIVE COAT	SQYD	1,701	992	237	472
42200200	POOTI AND COURT COMPRETE DRIVENIA V PAVENIATE 7 INVE	SQYD	63	63		
42300300	PORTLAND CEMENT CONCRETE DRIVEWAY PAVEMENT, 7 INCH	3010	- 03	65		
42400200	PORTLAND CEMENT CONCRETE SIDEWALK 5 INCH	SQFT	7,390	5,050	1,170	1,170

BAXTER WOODMAN

DESIGNED - JDM
DRAWN - KAR
CHECKED - JJF REVISED - PER IDOT REVIEW 1-20-16 REVISED REVISED FILE - 150676SHT-RD-S00.dgn

STATE OF ILLINOIS
DEPARTMENT OF TRANSPORTATION

SUMMARY OF QUANTITIES STA.

COUNTY TOTAL SHEET NO. 19-00-RS DUPAGE 24 3 CONTRACT NO. 61C61 F.A.U. SECTION 2625 14-00051-00-RS

SUMMARY OF QUANTITIES

				CONSTRUCTION CODE		
				MILL ROAD 75% FED 25% CITY	MARY JANELANE 100% CITY	VICTORIA LANE
0000			TOTAL	ROADWAY	NON	NON
NO.	ПЕМ	UNIT	TOTAL QUANTITY	URBAN 000 5	PARTICIPATING 000\$	PARTICIPATING 000 5
42400400	PORTLAND CEMENT CONCRETE SIDEWALK 7 INCH	SQFT	910	650	130	130
42400800	DETECTABLE WARNINGS	SQFT	56	56		
44000159	HOT-MIX ASPHALT SURFACE REMOVAL, 2 1/2"	SQYD	19,810	16,580	3,230	
44000166	HOT-MIX ASPHALT SURFACE REMOVAL, 4 1/4"	SQYD	3,620			3,620
44000200	DRIVEWAY PAVEMENT REMOVAL	SQYD	276	142	34	100
44000600	SIDEWALK REMOVAL	SQFT	8,800	6,200	1,300	1,300
44201692	CLASS D PATCHES, TYPE II, 4 INCH	SQYD	100		100	
44201694	CLASS DIPATCHES, TYPE III, 4 INCH	SQYD	100		100	
44201696	CLASS DPATCHES, TYPE IV., 4 INCH	SQYD	425		425	
44201765	CLASS DIPATCHES, TYPE II, 10 INCH	SQYD	266	266		
44201769	CLASS D PATCHES, TYPE III, 10 INCH	SQYD	432	432		
44201771	CLASS D PATCHES, TYPE IV, 10 INCH	SQYD	1,687	1,687		
44300200	STRIP REFLECTIVE CRACK CONTROL TREATMENT	FOOT	6,430	5,140	1,290	
56500600	DOMESTIC WATER SERVICE BOXES TO BE ADJUSTED	EACH	5	5		
60250200	CATCH BASINS TO BE ADJUSTED	EACH	5		2	3

				CONSTRUCTION CODE		
				MILL ROAD 75% FED	MARY JANE LANE	VICTORIA LANE
				25% CITY	100% CITY	100% CITY
CODE	мет	UNIT	TOTAL	ROADWAY URBAN	NON PARTICIPATING	NON PARTICIPATING
NO.		100000	QUANTITY	00045	000.5	0005
60260100	INLETS TO BE ADJUSTED	EACH	16	12	2	2
60406100	FRAMES AND LIDS, TYPE 1, CLOSED LID	EACH	1	1		
blosto va			×			
66300105	CALCIUM CHLORIDE APPLIED	TON	-11			11
66900200	NON-SPECIAL WASTE DISPOSAL	CUYD	335	156	41	138
66900450	SPECIAL WASTE PLANS AND REPORTS	LSUM	1.00	0.66	0.17	0.17
66900530	SOIL DISPOSAL ANALYSIS	EACH	9	7	1	1
67000400	ENGINEER'S FIELD OFFICE, TYPE A	CAL MO	3	3		
67100100	MOBILIZATION	LSUM	1.00	0.66	0.17	0.17
70102620	TRAFFIC CONTROL AND PROTECTION, STANDARD 701501	LSUM	1.00	0.66	0.17	0.17
70402640	TRAFFIC CONFESCIONAL ESCRIPTION STANDARD TO 701901	LSUM	1.00	0.66	0.17	0.17
70102640	TRAFFIC CONTROL AND PROTECTION, STANDARD 701801	LSOM	1.00	0.86	0.17	0.17
70300100	SHORT-TERM PAVEMENT MARKING	FOOT	3,849	2,567	644	638
70300150	SHORT TERM PAVEMENT MARKING REMOVAL	SQFT	1,284	856	215	213
78000100	THERMOPLASTIC PAVEMENT MARKING - LETTERS AND SYMBOLS	SQFT	290		290	
78000200	THERMOPLASTIC PAVEMENT MARKING - LINE 4"	FOOT	3,550	3,550		
78000400	THERMOPLASTIC PAVEMENT MARKING - LINE 6"	FOOT	760	760		

REVISED - PER IDOT REVIEW 1-20-16 REVISED REVISED -FILE - 150676SHT-RD-S00.dgn

STATE OF ILLINOIS
DEPARTMENT OF TRANSPORTATION

SUMMARY OF QUANTITIES SCALE: NONE STA. TO STA.

BAXTER WOODMAN DRAWN - KAR
CHESKED - JUF

				CONSTRUCTION CODE		
			×	MILL ROAD 75% FED 25% CITY	MARY JANELANE 100% CITY	VICTORIA LA NE 100% CITY
CODE NO.	мел	UNIT	TOTAL QUANTITY	ROADWAY URBAN 000.5	NON PARTICIPATING 000.5	NON PARTICIPATING 000.5/
78000600	THERMOPLASTIC PAVEMENT MARKING - LINE 12"	FOOT	420	420		
78000650	THERMOPLASTIC PAVEMENT MARKING - LINE 24"	FOOT	195	195		
78300100	PAVEMENT MARKING REMOVAL	SQFT	108	108		
Z0004510	HOT-MIX ASPHALT DRIVEWAY PAVEMENT, 3"	SQYD	213	79	34	100
Z0004562	COMBINATION CONCRETE CURB AND GUTTER REMOVAL AND REPLACEMENT	FOOT	2,710	1,250	320	1,140
Z0013798	CONSTRUCTION LAYOUT	LSUM	1.00	0.66	0.17	0.17
Z0030850	TEMPORARY INFORMATION SIGNING	SQFT	52	52		
X4021000	TEMPORARY ACCESS (PRIVATE ENTRANCE)	EACH	34			34
X4023000	TEMPORARY ACCESS (ROAD)	EACH	2			2
X6030310	FRAMES AND LIDS TO BE ADJUSTED (SPECIAL)	EACH	14	13	1	
xx009097	SPEED HUMP REMOVAL	EACH	4		4	
X X009098	SPEED HUMP REPLACEMENT	EACH	4		4	

INDICATED OF	PECIALTY (TEM					


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DESIGNED - JDM REVISED - PER IDOT REVIEW 1-20-16 DRAWN - KAR CHECKED - JJF REVISED REVISED 01-25-16 FILE - 150676SHT-RD-S00.dgn

STATE OF ILLINOIS
DEPARTMENT OF TRANSPORTATION

SUMMARY OF QUANTITIES

F.A.U. SECTION 2625 14-00051-00-RS

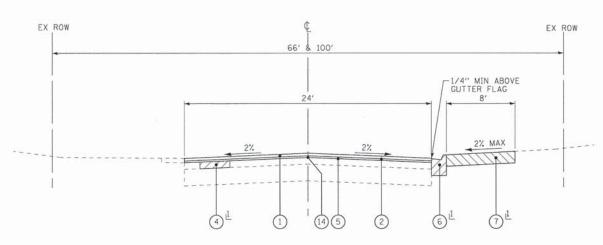

PROPOSED TYPICAL SECTION
MILL ROAD STA 11+50 TO STA 23+00
(NOT TO SCALE)

AS DETERMINED BY THE ENGINEER

EXISTING LEGEND

(A) EXISTING HOT-MIX ASPHALT PAVEMENT

(B) EXISTING AGGREGATE BASE COURSE

(C) EXISTING SIDEWALK

(D) EXISTING CONCRETE CURB AND GUTTER

(E) EXISTING SHOULDER

F GROUND SURFA

G HOT-MIX ASPHALT SURFACE REMOVAL, 2 1/2"
H HOT-MIX ASPHALT SURFACE REMOVAL, 4 1/4"

REMOVAL ITEM

PROPOSED LEGEND

HOT-MIX ASPHALT SURFACE COURSE, MIX "D", N50 - 1 3/4"

LEVELING BINDER (MACHINE METHOD), NSO - 3/4" AVG
PREPARATION OF BASE

4 CLASS D PATCHES, 10" MILL ROAD, 4" MARY JANE LANE

BITUMINOUS MATERIALS (TACK COAT)

COMBINATION CONCRETE CURB AND GUTTER REMOVAL AND REPLACEMENT

SIDEWALK REMOVAL
PCC SIDEWALK, 5"
AGGREGATE BASE COURSE, TYPE B, 4"

PARKWAY RESTORTION
OF INSULTABLE MATER

PARKWAY RESTORATION
(REMOVAL AND DISPOSAL OF UNSUITABLE MATERIAL
TOPSOIL FURNISH AND PLACE, 4"
SODDING, SALT TOLERANT)

(9) HOT-MIX ASPHALT SURFACE COURSE, MIX "D", N50 - 2"

10) HOT-MIX ASPHALT BINDER COURSE, IL-19.0, N50 - 2 1/2"

REMOVAL AND DISPOSAL OF UNSUITABLE MATERIAL AGGREGATE SUBGRADE IMPROVEMENT 12"

(12) AGGREGATE BASE REPAIR

GEOTECHNICAL FABRIC FOR GROUND STABILIZATION

(14) STRIP REFLECTIVE CRACK CONTROL

BAXTER WOODMAN CHARLES Engineers CH

STATE OF ILLINOIS
DEPARTMENT OF TRANSPORTATION

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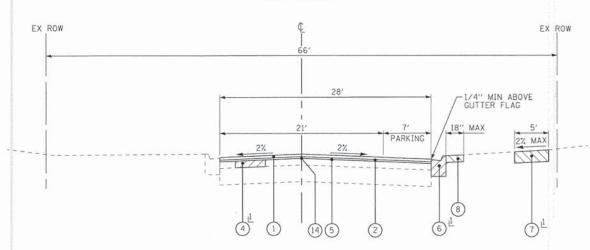
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EX ROW

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EXISTING TYPICAL SECTION MILL ROAD STA 23+00 TO STA 36+80, STA 37+88 TO STA 59+62 (NOT TO SCALE)



PROPOSED TYPICAL SECTION

AL AS DETERMINED BY THE ENGINEER

MILL ROAD STA 23+00 TO STA 36+80, STA 37+88 TO STA 59+62

(NOT TO SCALE)

HOT-MIX ASPHALT MIXTURE REQUIREMENTS

CONTRACTOR SHALL MILL BEFORE PATCHING.

MIXTURE TYPE	AIR VOIDS @ Ndes
PAVEMENT RESURFACING	
HOT-MIX ASPHALT SURFACE COURSE, MIX "D", N50 (IL 9.5 mm) - 1 3/4"	4% @ 50 Gyr.
LEVELING BINDER (MACHINE METHOD), N50 - 3/4"	4% @ 50 Gyr.
FULL DEPTH PAVEMENT	
HOT-MIX ASPHALT SURFACE COURSE, MIX "D", N50 (IL 9.5 mm) - 2"	4% @ 50 Gyr.
HOT-MIX ASPHALT BINDER COURSE, IL-19.0, N50- 2 1/2"	4% @ 50 Gyr.
DRIVEWAY PAVEMENT	
HOT-MIX ASPHALT SURFACE COURSE, MIX "D", N50 (IL 9.5 mm) - 3"	4% @ 50 Gyr.
PATCHING	
CLASS D PATCHES (HMA BINDER IL-19.0mm) - 4", 10"	4% @ 70 Gyr.

THE UNIT WEIGHT USED TO CALCULATE ALL HMA MIXTURE QUANTITIES IS 112 LBS/SQ YD/IN.

THE "AC TYPE" FOR POLYMERIZED HMA MIXES SHALL BE "SBS/SBR PG 76-22" AND FOR NON-POLYMERIZED HMA THE "AC TYPE" SHALL BE "PG 64-22" UNLESS MODIFIED BY THE DISTRICT ONE SPECIAL PROVISIONS.

FOR USE OF RECYCLED MATERIALS SEE DISTRICT ONE SPECIAL PROVISIONS.

TYPICAL SECTIONS AND HOT-MIX ASPHALT MIXTURE REQUIREMENTS

| F,A,U, RTE. | SECTION | COUNTY | TOTAL SHEET | NO. 2625 | 14-00051-00-RS | DUPAGE | 24 | 6 | CONTRACT | NO. 61C61

STATE OF ILLINOIS LICENSE NO. - 184-C

EXISTING LEGEND

EXISTING HOT-MIX ASPHALT PAVEMENT EXISITNG AGGREGATE BASE COURSE

0 EXISTING SIDEWALK 0

EXISTING CONCRETE CURB AND GUTTER

EXISTING SHOULDER GROUND SURFACE

G

Н

HOT-MIX ASPHALT SURFACE REMOVAL, 2 1/2"

HOT-MIX ASPHALT SURFACE REMOVAL, 4 1/4" REMOVAL ITEM

HOT-MIX ASPHALT SURFACE COURSE, MIX "D", N50 - 1 3/4"

LEVELING BINDER (MACHINE METHOD), N50 - 3/4" AVG

PREPARATION OF BASE

4 CLASS D PATCHES, 10" MILL ROAD, 4" MARY JANE LANE

(5) BITUMINOUS MATERIALS (TACK COAT)

COMBINATION CONCRETE CURB AND GUTTER REMOVAL AND REPLACEMENT

7 SIDEWALK REMOVAL PCC SIDEWALK, 5" AGGREGATE BASE COURSE, TYPE B. 4"

PARKWAY RESTORATION (REMOVAL AND DISPOSAL OF UNSUITABLE MATERIAL TOPSOIL FURNISH AND PLACE, 4" SODDING, SALT TOLERANT)

9 HOT-MIX ASPHALT SURFACE COURSE, MIX "D", N50 - 2"

HOT-MIX ASPHALT BINDER COURSE, IL-19.0, N50 - 2 1/2"

(11) REMOVAL AND DISPOSAL OF UNSUITABLE MATERIAL AGGREGATE SUBGRADE IMPROVEMENT 12"

(12) AGGREGATE BASE REPAIR

GEOTECHNICAL FABRIC FOR GROUND STABILIZATION


(14) STRIP REFLECTIVE CRACK CONTROL

DESIGNED - JDM REVISED - PER IDOT REVIEW 1-20-16 REVISED BAXTER WOODMAN DRAWN - KAR REVISED CHECKED - JJF 01-25-16 FILE - 150676SHT-RD-TypSec.do


STATE OF ILLINOIS DEPARTMENT OF TRANSPORTATION

COUNTY TOTAL SHEET NO.

DUPAGE 24 7 SECTION TYPICAL SECTIONS 2625 14-00051-00-RS CONTRACT NO. 61C61 TO STA. SCALE: NONE

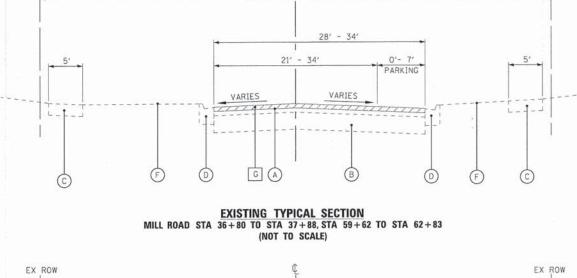

EX ROW

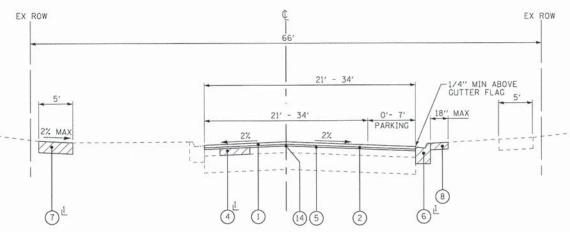


PROPOSED TYPICAL SECTION
MILL ROAD STA 36+80 TO STA 37+88, STA 59+62 TO STA 62+83 1 AS DETERMINED BY THE ENGINEER (NOT TO SCALE)

EX ROW

PROPOSED LEGEND

EXISTING TYPICAL SECTION MARY JANE LANE STA 100+12 TO STA 113+00 (NOT TO SCALE)

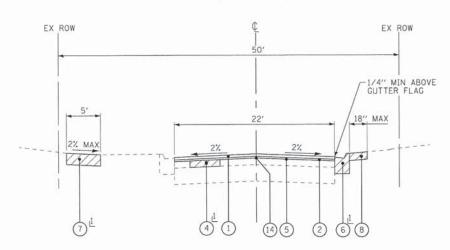

PROPOSED TYPICAL SECTION
MARY JANE LANE STA 100+12 TO STA 113+00
(NOT TO SCALE)

2

4

(5)

7

1 AS DETERMINED BY THE ENGINEER

EXISTING LEGEND

A EXISTING HOT-MIX ASPHALT PAVEMENT
B EXISTING AGGREGATE BASE COURSE
C EXISTING SIDEWALK
D EXISTING CONCRETE CURB AND GUTTER
E EXISTING SHOULDER
F GROUND SURFACE

HOT-MIX ASPHALT SURFACE REMOVAL, 2 1/2"

H HOT-MIX ASPHALT SURFACE REMOVAL, 4 1/4"

REMOVAL ITEM

PROPOSED LEGEND

LEVELING BINDER (MACHINE METHOD), N50 - 3/4" AVG

HOT-MIX ASPHALT SURFACE COURSE, MIX "D", N50 - 1 3/4"

PREPARATION OF BASE

CLASS D PATCHES, 10" MILL ROAD, 4" MARY JANE LANE

BITUMINOUS MATERIALS (TACK COAT)

COMBINATION CONCRETE CURB AND GUTTER REMOVAL AND REPLACEMENT

SIDEWALK REMOVAL
PCC SIDEWALK, 5"
AGGREGATE BASE COURSE, TYPE B, 4"

PARKWAY RESTORATION
 (REMOVAL AND DISPOSAL OF UNSUITABLE MATERIAL
 TOPSOIL FURNISH AND PLACE, 4"
 SODDING, SALT TOLERANT)
 HOT-MIX ASPHALT SURFACE COURSE, MIX "D", N50 - 2"

10 HOT-MIX ASPHALT BINDER COURSE, IL-19.0, N50 - 2 1/2"

11 REMOVAL AND DISPOSAL OF UNSUITABLE MATERIAL AGGREGATE SUBGRADE IMPROVEMENT 12"

AGGREGATE BASE REPAIR

(13) GEOTECHNICAL FABRIC FOR GROUND STABILIZATION

14 STRIP REFLECTIVE CRACK CONTROL

BAXTER WOODMAN

 DESIGNED
 JDM
 REVISED
 PER IDOT REVIEW 1-20-16

 DRAWN
 KAR
 REVISED

 CHECKED
 JJF
 REVISED

 DATE
 01-25-16
 FILE
 150676SHT-RD-TypSec.dgr

STATE OF ILLINOIS
DEPARTMENT OF TRANSPORTATION

EX ROW


66'

VARIES

VARIES

F) C


EXISTING TYPICAL SECTION VICTORIA LANE STA 120+19 TO STA 132+95 (NOT TO SCALE)

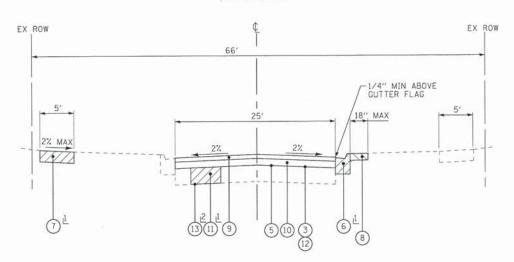

PROPOSED TYPICAL SECTION
VICTORIA LANE STA 120+19 TO STA 132+95
(NOT TO SCALE)

::55 AM inCrystalLake\WDDLC\I56676-MilRoad - Street and

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KRSK NC. -84-001121- EXPRES 4/30/2017
2/12/2016
B402:55 AM 1/Crystollake

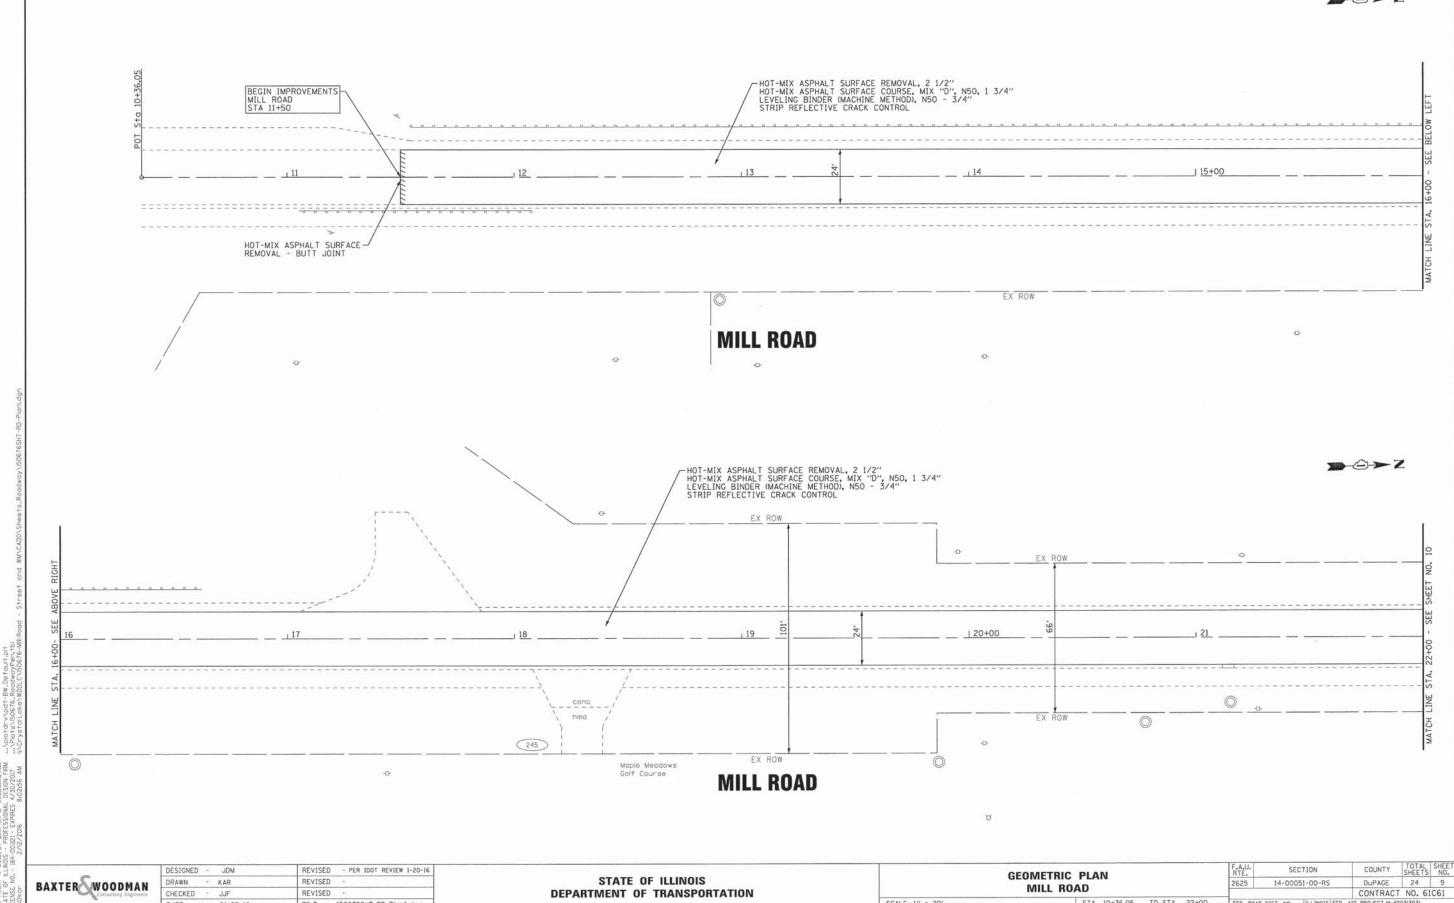

DEPARTMENT OF TRANSPORTATION

MILL ROAD

SCALE: 1" = 20"


OF ILLINOIS -E NO. - 184-01


CHECKED - JJF


01-25-16


REVISED


FILE - 150676SHT-RD-Plan1.dgn

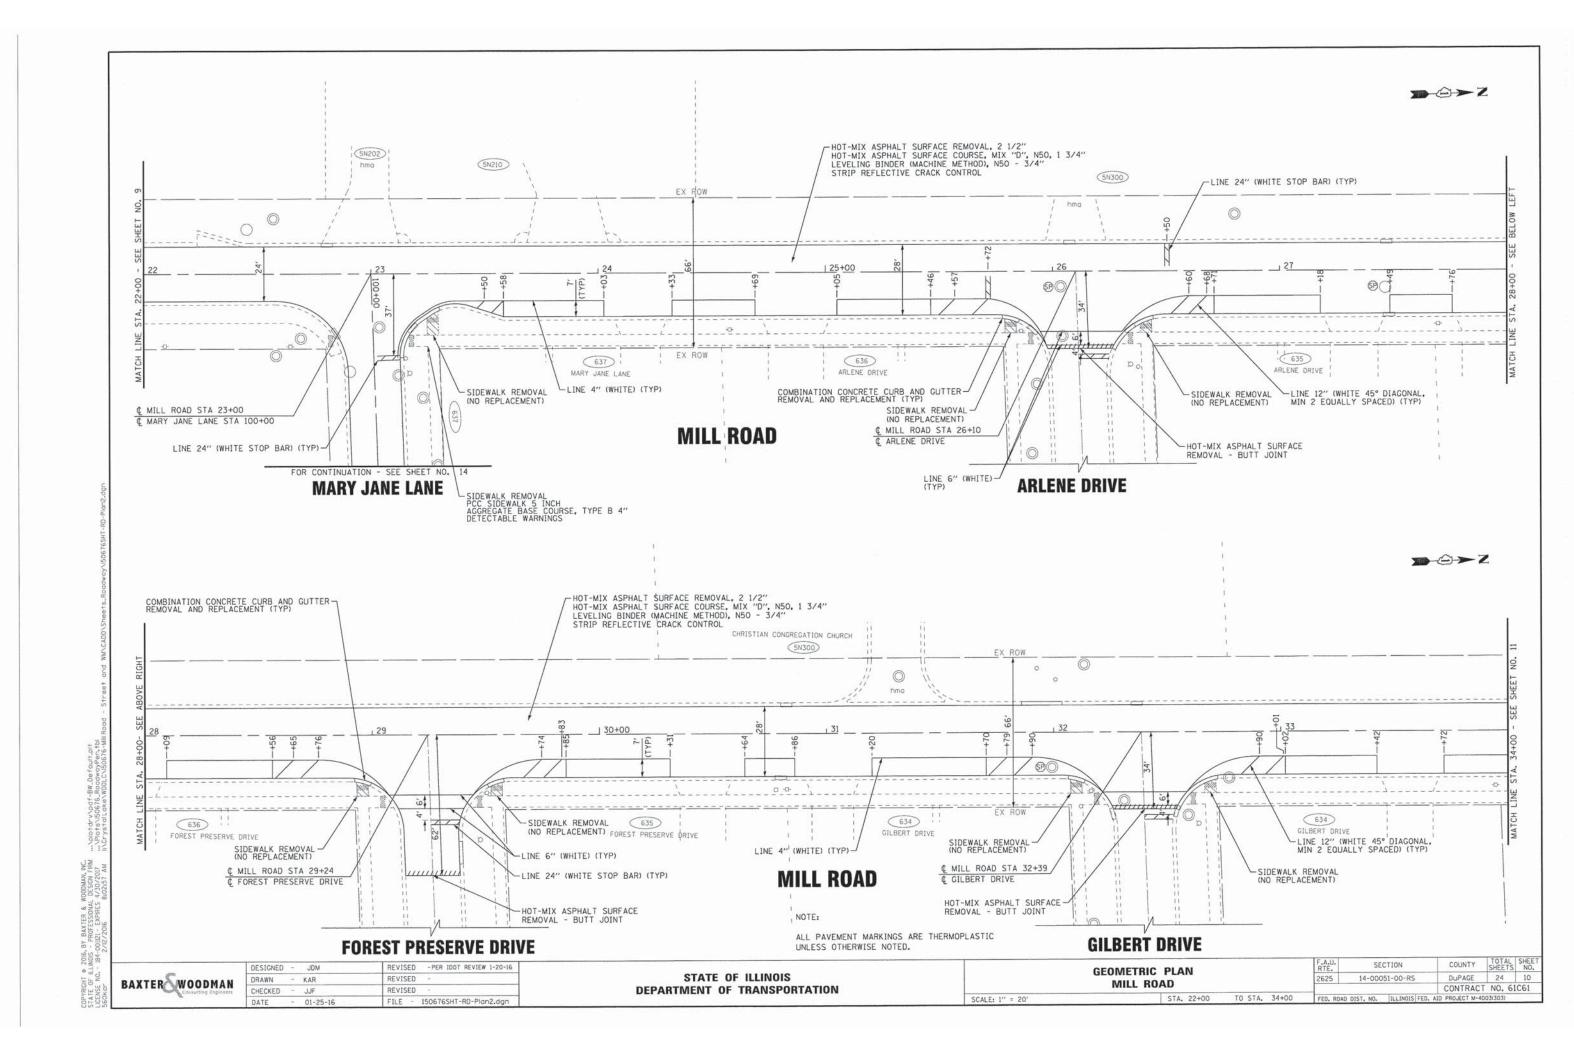


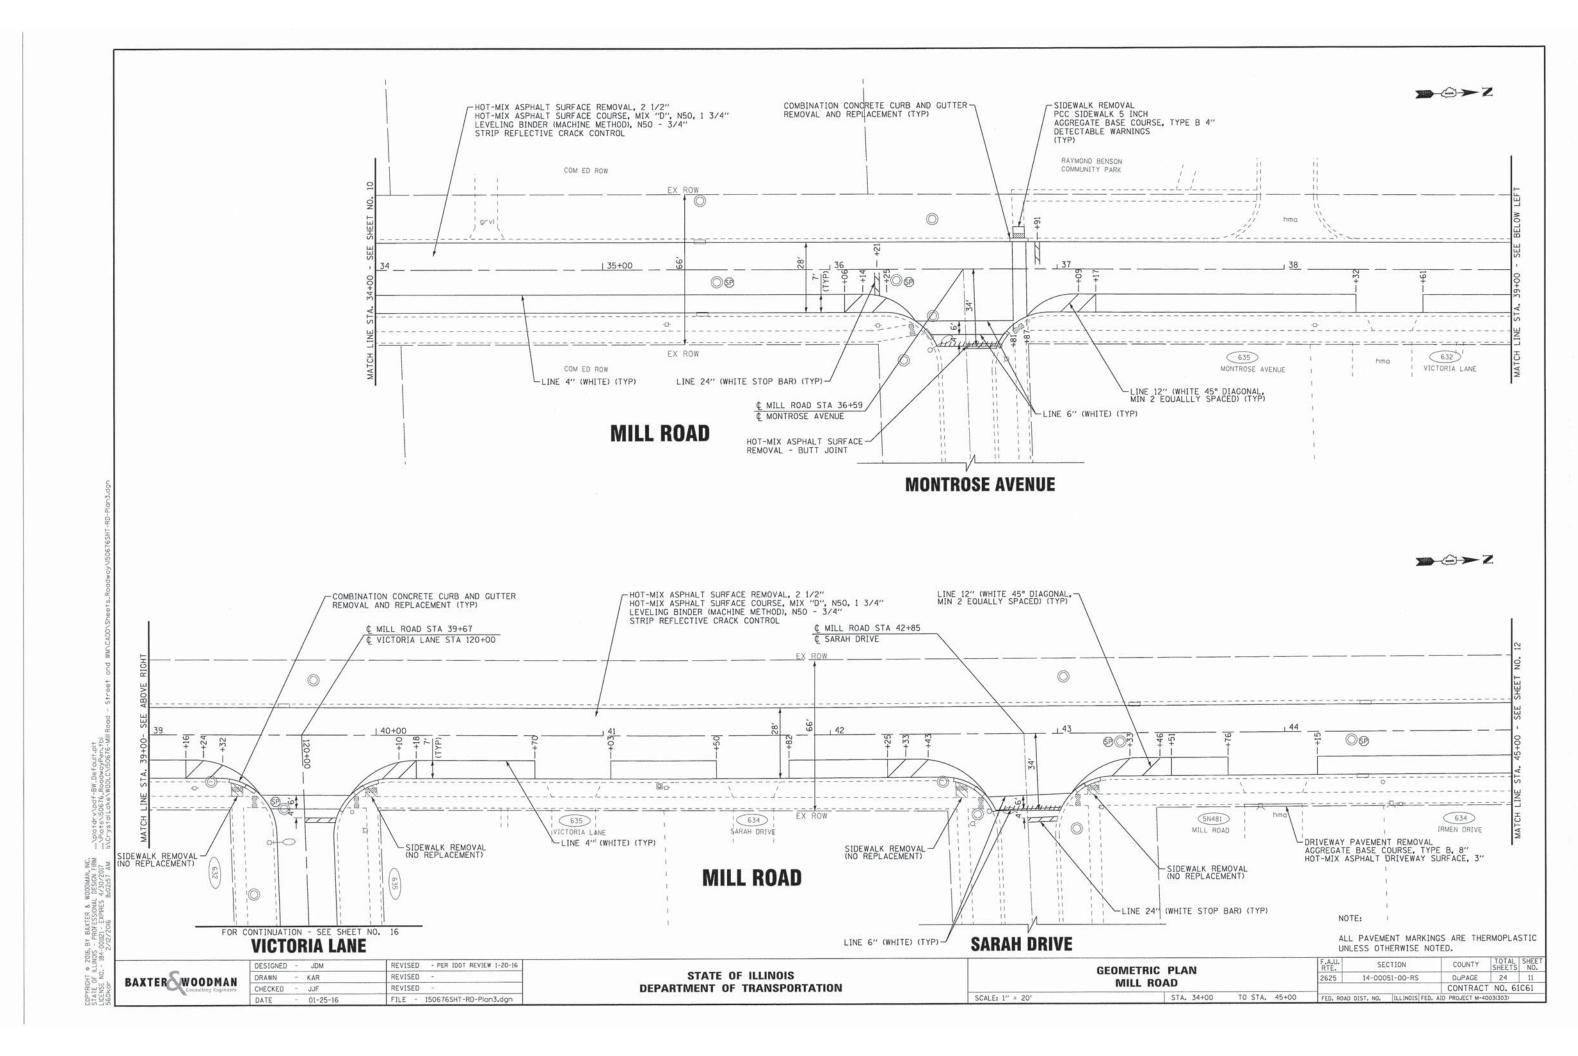

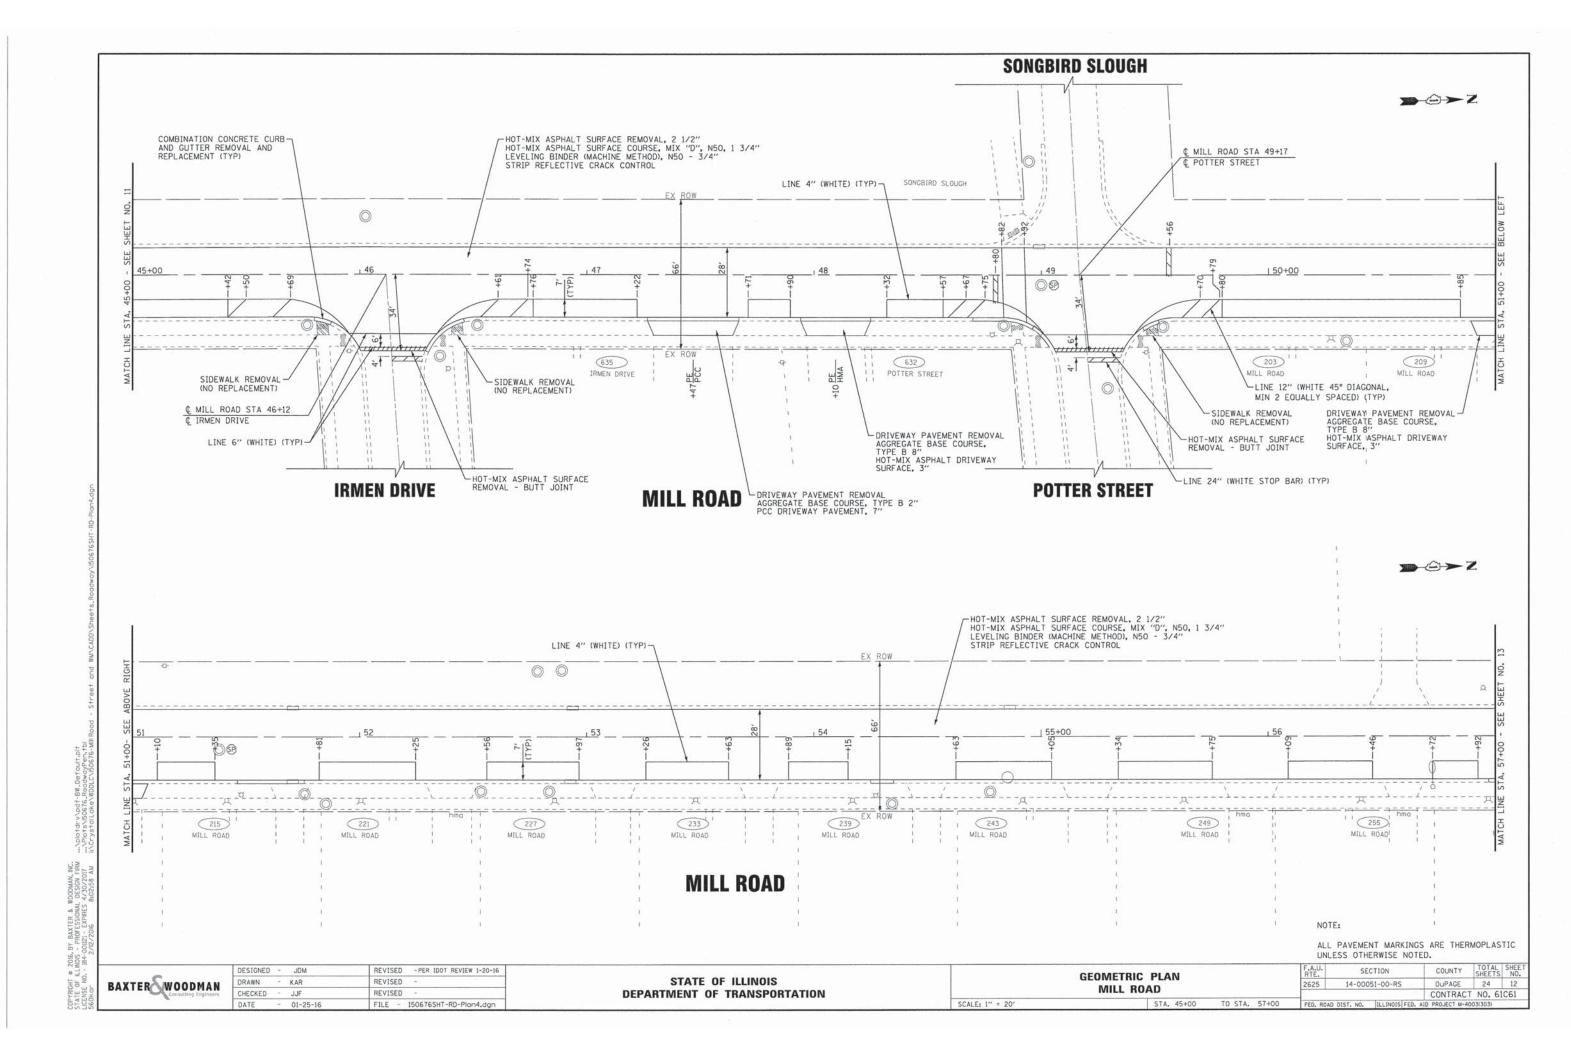

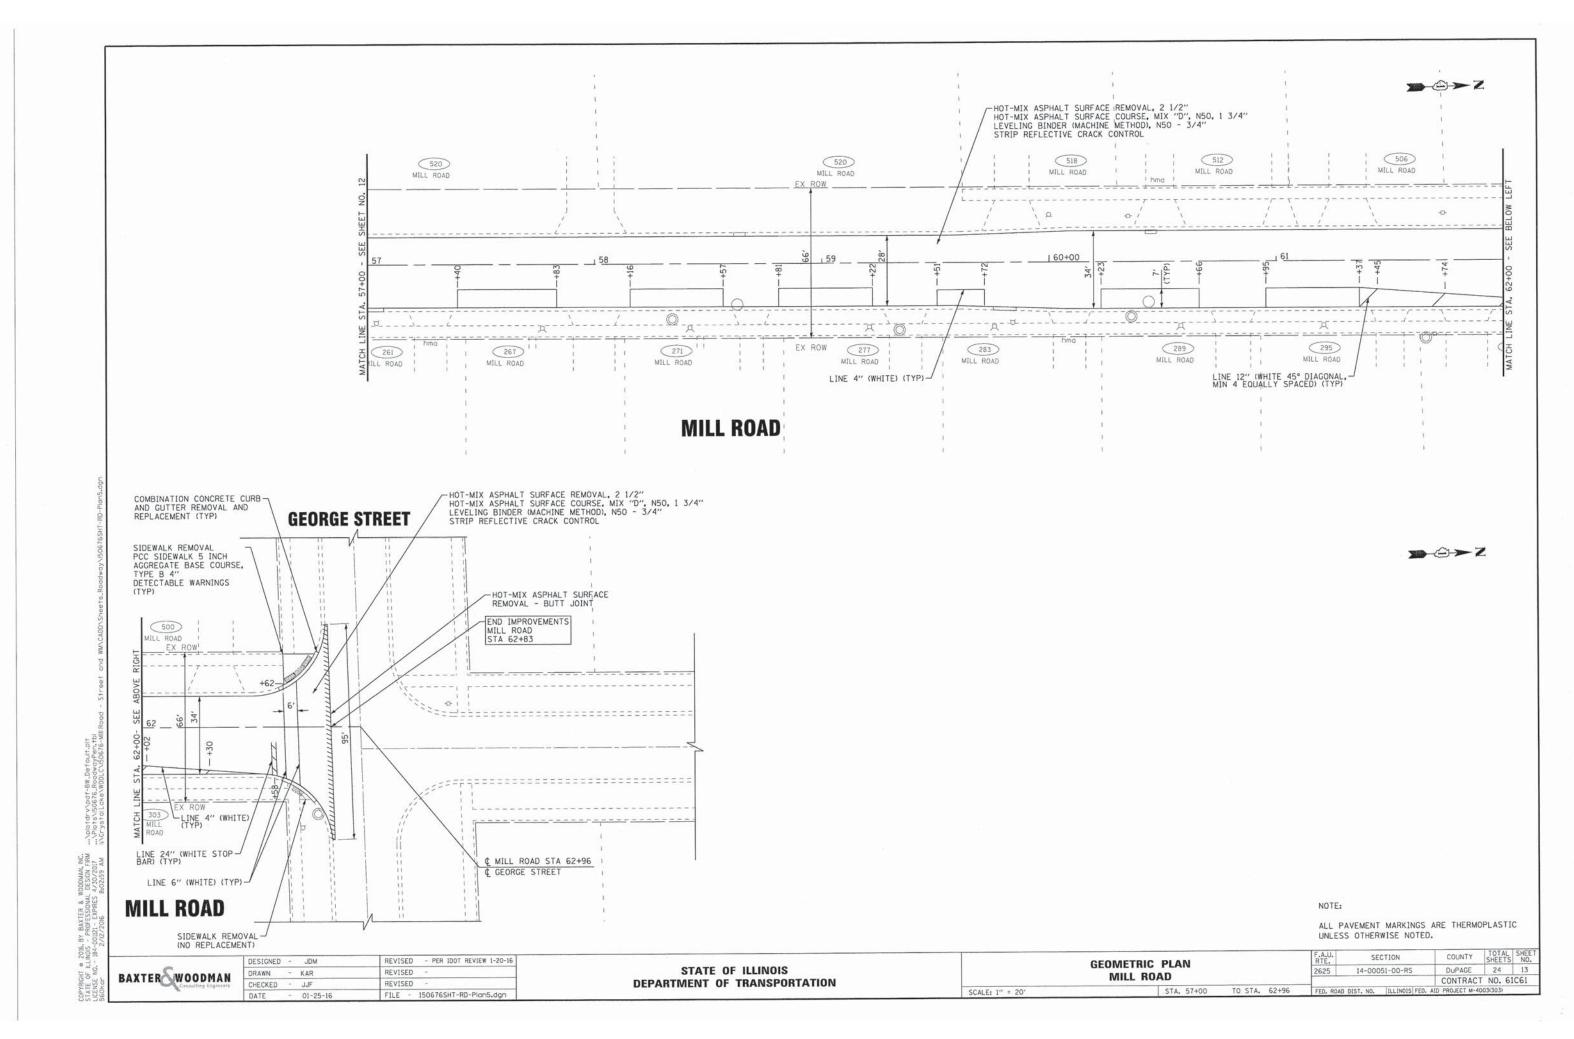

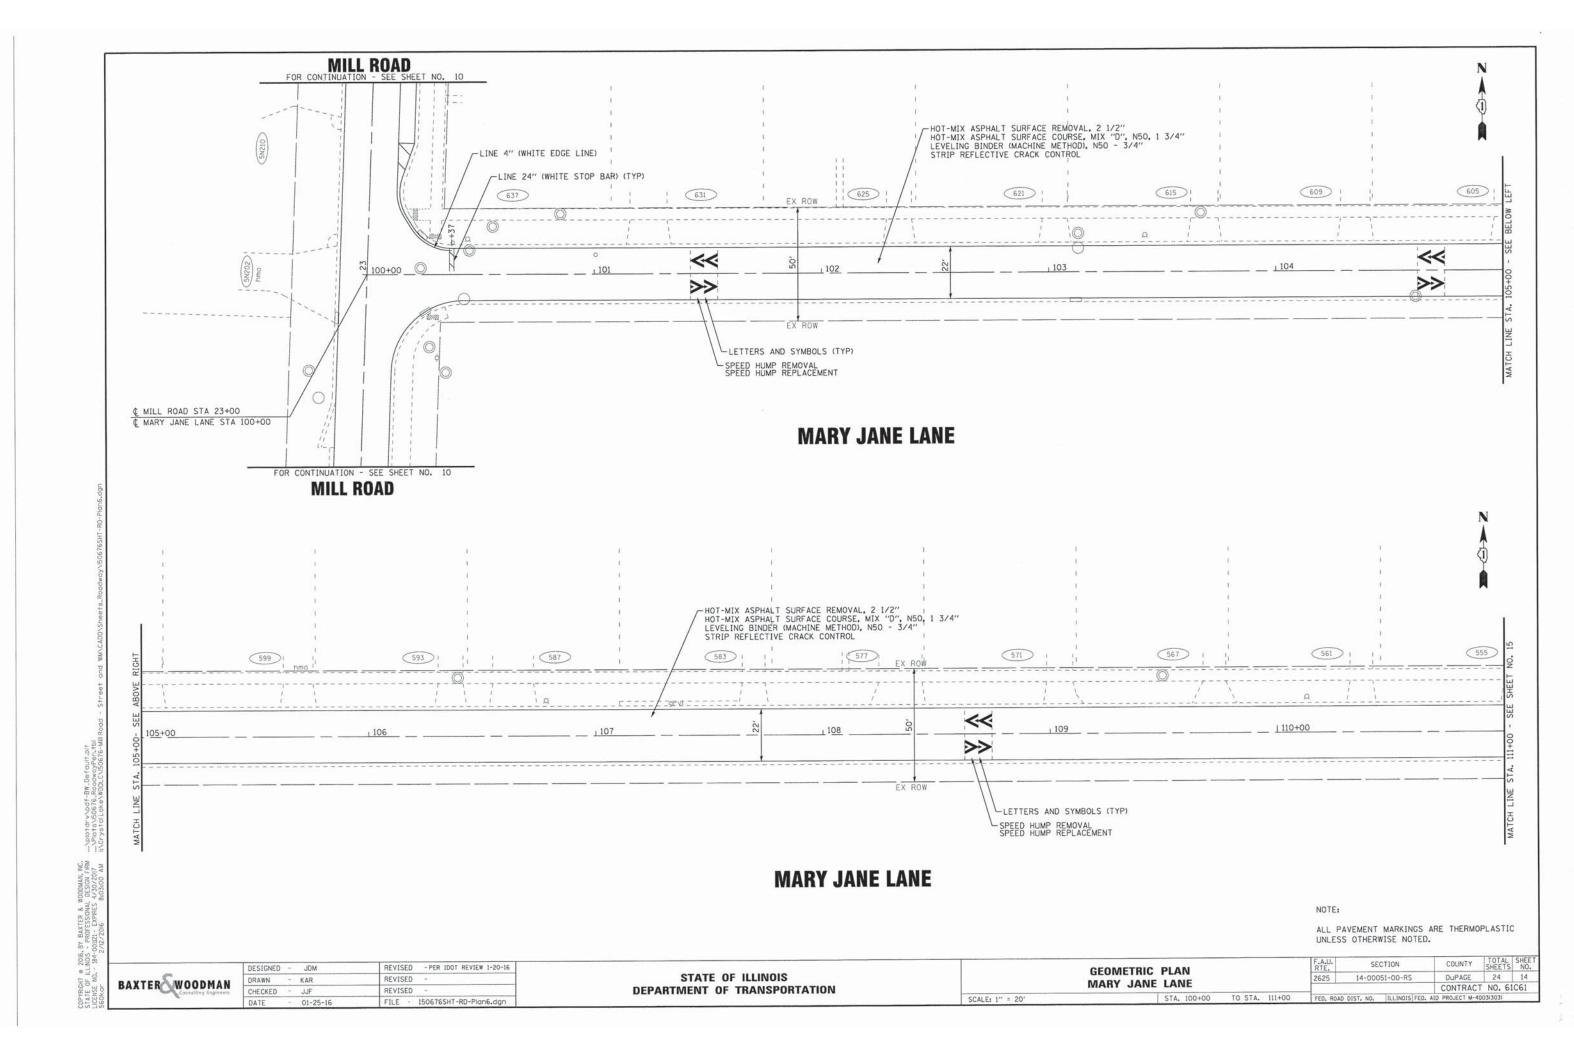

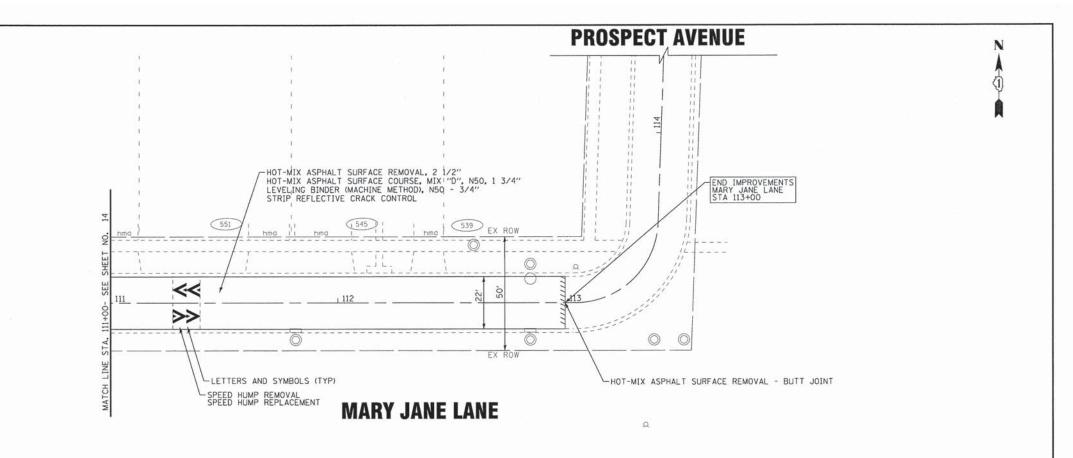

DESIGNED - JDM REVISED - PER IDOT REVIEW 1-20-16 BAXTER WOODMAN REVISED DRAWN - KAR REVISED CHECKED - JJF 01-25-16 FILE - 150676SHT-RD-Plan7.dgn

STATE OF ILLINOIS DEPARTMENT OF TRANSPORTATION

GEOMETRIC PLAN MARY JANE LANE


SCALE: 1" = 20'


COUNTY TOTAL SHEET NO.

DUPAGE 24 15

CONTRACT NO. 61C61 SECTION 2625

TO STA. 114+34 STA. 111+00

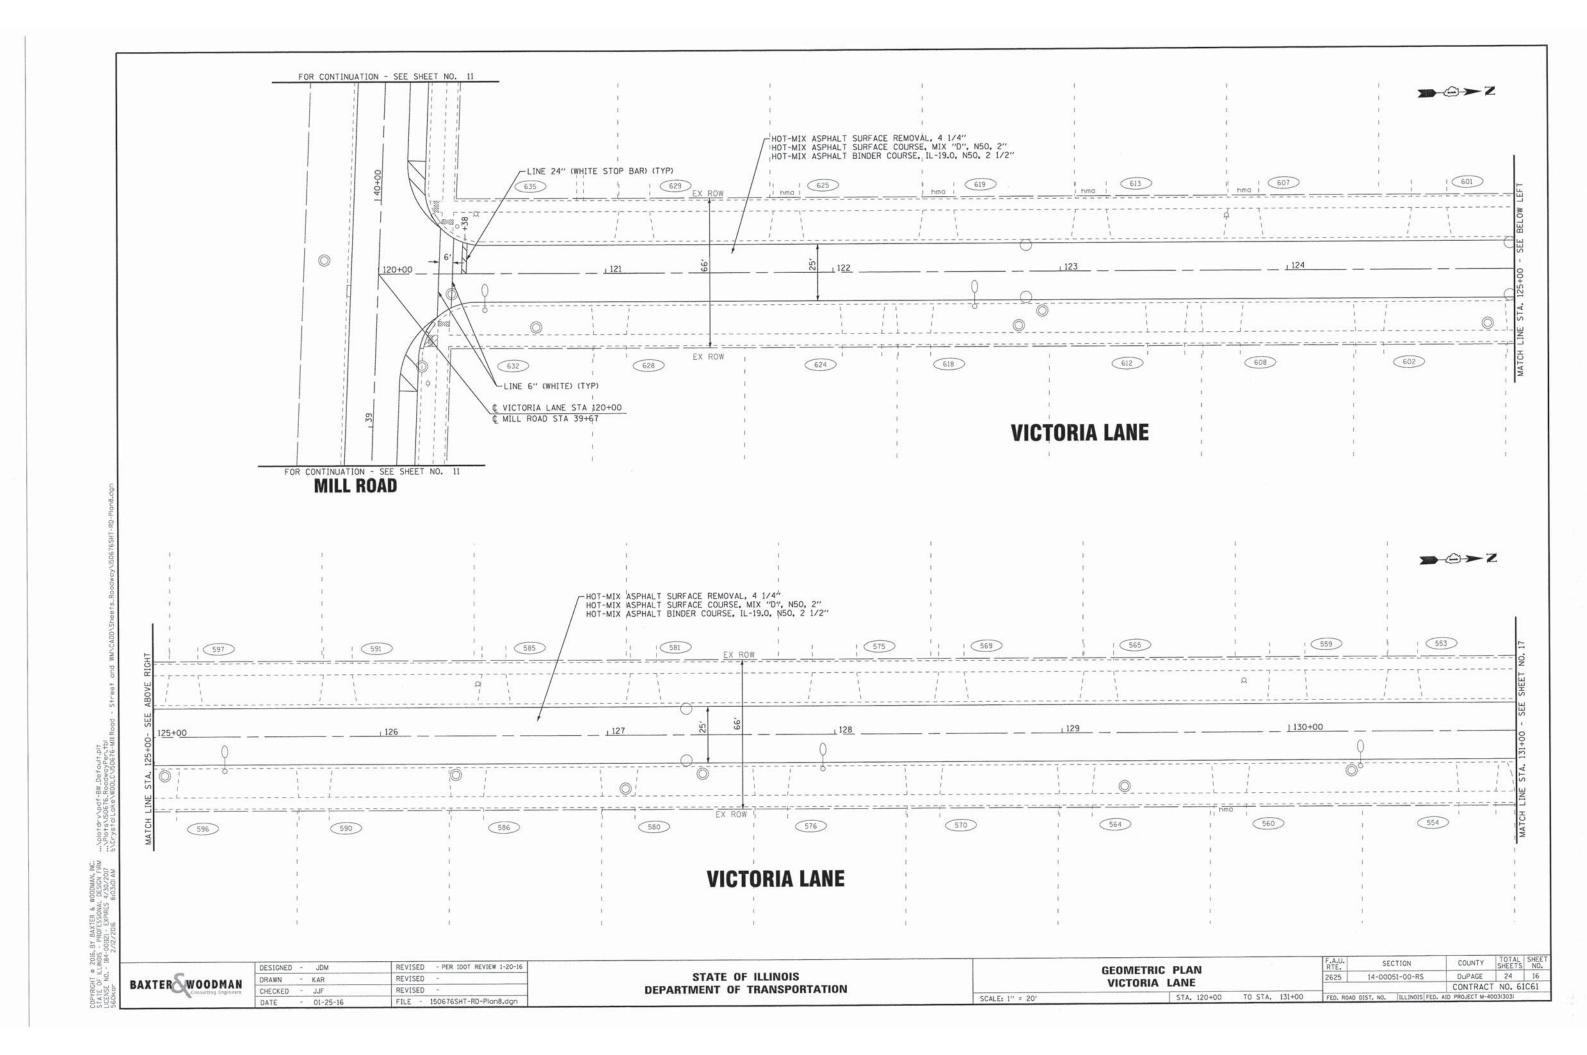

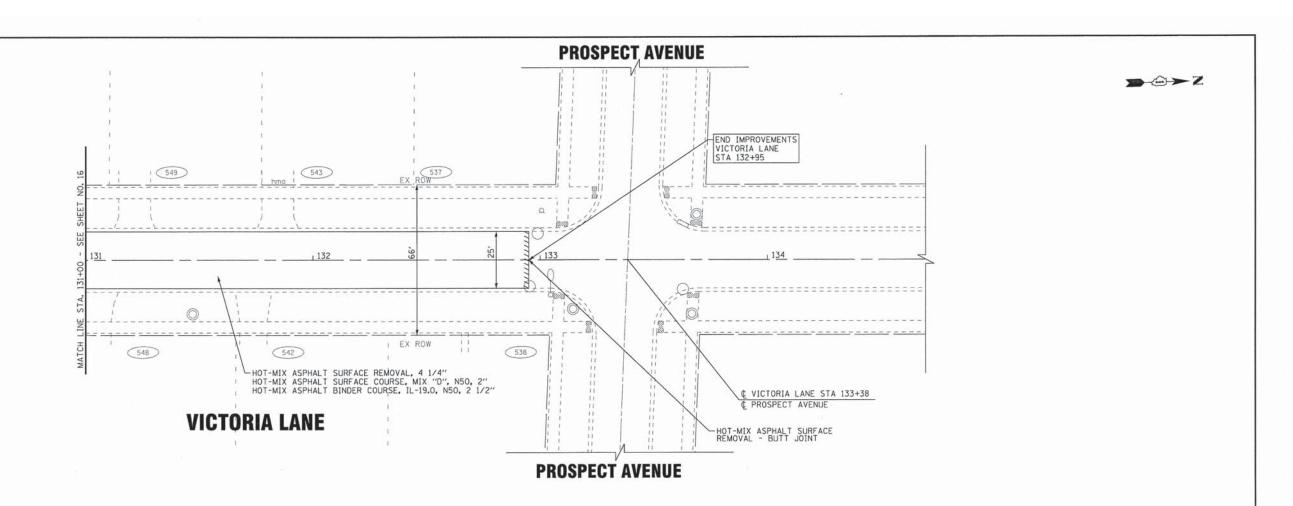

BAXTER WOODMAN

REVISED - PER IDOT REVIEW 1-20-16 DESIGNED - JDM DRAWN - KAR REVISED REVISED CHECKED - JJF FILE - 150676SHT-RD-Plan9.dgn 01-25-16

STATE OF ILLINOIS DEPARTMENT OF TRANSPORTATION VICTORIA LANE

SCALE: 1" = 20"

COUNTY TOTAL SHEETS NO.

DUPAGE 24 17

CONTRACT NO. 61C61 SECTION 14-00051-00-RS 2625

GEOMETRIC PLAN


TO STA. 134+70

STEEL MESH -REPLACEABLE-FILTER BAG PLAN GENERAL NOTES: FRAME: TOP RING CONSTRUCTED FROM 1 1/4" × 1 1/4" × 1/8" ANGLE.

BASE RING CONSTRUCTED OF 1 1/2" × 1/2" × 1/8" CHANNEL. HANDLES


& SUSPENSION BRACKETS CONSTRUCTED FROM 1/4" × 1 1/4" FLAT.

ALL STEEL CONFORMING TO ASTM-A36. REPLACEABLE BAG: CONSTRUCTED FROM 4 OZ./SO. YD. NON-WOVEN POLYPROPYLENE GEOTEXTILE REINFORCED WITH POLYESTER MESH. CONNECTED TO BASE RING WITH STAINLESS STEEL STRAP & LOCK. SECTION INLET PROTECTION INLET FILTER

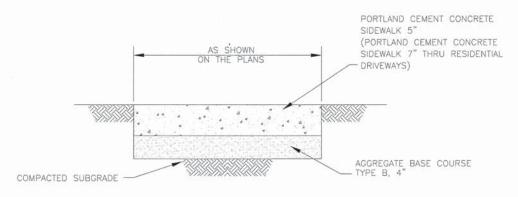

NOTE: PROVIDE FIBER 3/4" EXPANSION JOINTS WHERE NEW SIDEWALK MEETS EXISTING AND AT 50' O.C. MAX. AND PROVIDE CONTROL JOINTS AT 5' O.C.

PORTLAND CEMENT CONCRETE (P.C.C.) SIDEWALK, 5-INCH NO SCALE

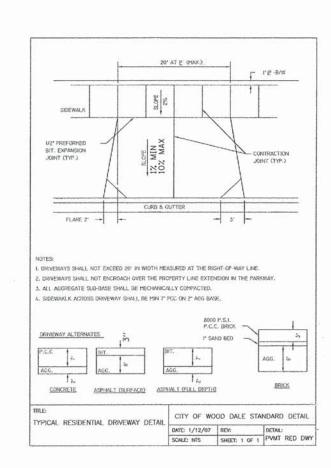

BAXTER WOODMAN Consulting Engineers

REVISED - PER IDOT REVIEW 1-20-16 DESIGNED - JDM DRAWN - KAR REVISED CHECKED - JJF REVISED FILE - 150676SHT-RD-MiscDetails. - 01-25-16

SECTION MISCELLANEOUS DETAILS SCALE: NONE

STATE OF ILLINOIS DEPARTMENT OF TRANSPORTATION

COUNTY TOTAL SHEET NO. 2625 14-00051-00-RS DUPAGE 24 18

CONTRACT NO. 61C61

FED. ROAD DIST. NO. | ILLINOIS| FED. AID PROJECT M-4003(303) STA. TO STA.

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(4) 2 3 12 (300) MIN. 9 -6

NOTES:

. .. .

EXISTING BROKEN FRAMES AND LIDS SHALL BE REMOVED AND DISPOSED OF BY THE CONTRACTOR AND SHALL BE REPLACED AS DIRECTED BY THE ENGINEER. REPLACEMENT FRAMES AND LIDS WILL BE PAID FOR IN ACCORDANCE WITH ARTICLE 109.04 OF THE STANDARD SPECIFICATIONS UNLESS A SEPARATE PAY ITEM HAS BEEN PROVIDED.

PROPOSED

BRICK, MORTAR, OR CONC. ADJUSTING RINGS

IF THE EXISTING LIDS ARE OPEN, THE FRAME WILL BE ADJUSTED TO THE ELEVATION OF THE MILLED PAVEMENT SURFACE PRIOR TO THE MILLING OPERATION. THE FRAME WILL NOT BE REMOVED AND COVERED BY THE METAL PLATE.

CITY OF CHICAGO CASTINGS ARE THE PROPERTY OF THE CITY AND THE CONTRACTOR SHALL NOTIFY THE CITY FOR REMOVAL AND DISPOSITION OF THE CASTINGS.

THE METAL PLATE USED TO COVER THE STRUCTURE SHALL REMAIN THE PROPERTY OF THE CONTRACTOR.

WHEN STRUCTURES ARE TO BE ADJUSTED OR RECONSTRUCTED. THE LOWERING AND RAISING OF THE FRAMES AND LIDS WILL NOT BE PAID FOR SEPARATELY BUT WILL BE INCLUDED IN THE COST OF THE CORRESPONDING PAY ITEM.

CONSTRUCTION PROCEDURES

STAGE 1 (BEFORE PAVEMENT MILLING)

- A) REMOVE A MINIMUM OF 12 (300) OF THE PAVEMENT FROM
- AROUND THE STRUCTURE.
 B) REMOVE THE EXISTING FRAME AND LID FROM THE STRUCTURE.
- C) COVER THE STRUCTURE OPENING WITH A 36 (900) DIAMETER METAL PLATE.
- D) BACKFILL WITH CRUSHED STONE AND A MINIMUM 11/2 (40) THICK HMA SURFACE MIX APPROVED BY THE ENGINEER.

STAGE 2 (AFTER PAVEMENT MILLING)

- A) REMOVE THE HMA SURFACE MIX AND CRUSHED STONE.
- B) INSTALL THE FRAME AND LID: ADJUST THE FRAME TO ITS FINAL SURFACE ELEVATION.
- C) THE SURROUNDING SPACE SHALL BE FILLED WITH CLASS PP-1* CONCRETE TO THE ELEVATION OF THE SURFACE OF THE EXISTING BASE COURSE OR THE BINDER COURSE.
- * UNLESS OTHERWISE SPECIFIED IN THE PLANS.

THE PROCEDURE EXPLAINED ABOVE SHALL CONFORM TO THE APPLICABLE PORTIONS OF SECTIONS 353, 406. 602, AND 603 OF THE STANDARD SPECIFICATIONS EXCEPT THAT "THE CONTRACTOR SHALL ADJUST THE STRUCTURES TO THE FINISHED PAVEMENT ELEVATION NO MORE THAN 5 CALENDAR DAYS PRIOR TO PLACEMENT OF THE FINAL LIFT OF SURFACE UNLESS APPROVED BY THE

LEGEND

- 1 SUB-BASE GRANULAR MATERIAL
- (6) FRAME AND LID (SEE NOTES)
- (2) EXISTING PAVEMENT
- (7) CLASS PP-1* CONCRETE
- 3 36 (900) DIAMETER METAL PLATE
- (8) PROPOSED HMA SURFACE COURSE
- PROPOSED CRUSHED STONE AND HMA SURFACE MIX 5 EXISTING STRUCTURE
- 9 PROPOSED HMA BINDER COURSE

LOCATION OF STRUCTURES:

THE CONTRACTOR WILL BE REQUIRED TO KEEP A RECORD OF THE LOCATIONS OF THE BURIED STRUCTURES ACCORDING TO THE STATION AND DISTANCE LEFT OR RIGHT OF THE CENTERLINE OF PAVEMENT. UPON COMPLETION OF THE WORK, THE CONTRACTOR WILL DELIVER THE RECORD TO THE ENGINEER.

BASIS OF PAYMENT:

REMOVING FRAMES AND LIDS ON DRAINAGE AND UTILITY STRUCTURES IN THE PAVEMENT PRIOR TO MILLING, AND ADJUSTING TO FINAL GRADE PRIOR TO PLACING THE SURFACE COURSE, WILL BE PAID FOR AT THE CONTRACT UNIT PRICE EACH FOR "FRAMES AND LIDS TO BE ADJUSTED (SPECIAL),"

THIS WORK WILL NOT BE PAID FOR WHEN DRAINAGE AND UTILITY STRUCTURES ARE SPECIFIED FOR PAYMENT AS STRUCTURE RECONSTRUCTION.

NEW FRAMES AND LIDS, WHEN SPECIFIED, WILL BE PAID FOR SEPARATELY.

DETAILS FOR FRAMES AND LIDS ADJUSTMENT WITH MILLING

ALL DIMENSIONS ARE IN INCHES (MILLIMETERS) UNLESS OTHERWISE SHOWN

SECTION

TOTAL SHEET SHEETS NO.

COUNTY

DUPAGE


CONTRACT NO. 61C61

AID PROJECT M-4003(303)

DESIGNED - R. SHAH REVISED - R. WIEDEMAN 05-14-04 FILE NAME : DRAWN REVISED - R. BORO 01-01-07 REVISED - R. BORO 03-09-11 CHECKED -PLOT SCALE = 1968,5000 1/ m REVISED - R. BORO 12-06-11 PLOT DATE = 12/6/2011 DATE - 10-25-94

STATE OF ILLINOIS DEPARTMENT OF TRANSPORTATION


DETAILS FOR 14-00051-00-RS FRAMES AND LIDS ADJUSTMENT WITH MILLING BD600-03 (BD-8) SHEET NO. 1 OF 1 SHEETS STA. SCALE: NONE

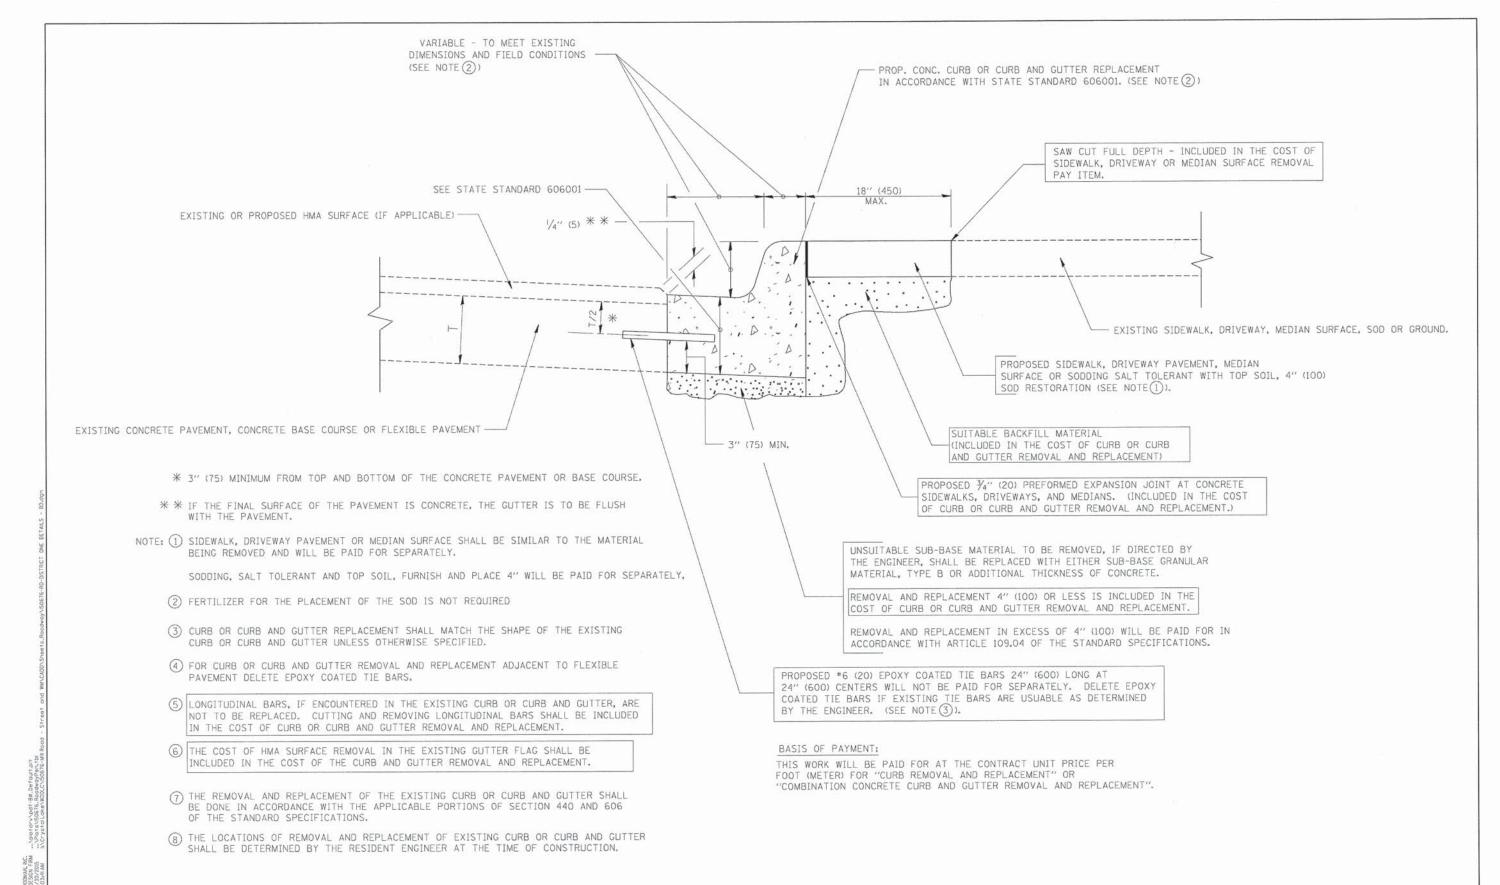


CURB OR CURB AND GUTTER REMOVAL AND REPLACEMENT

ALL DIMENSIONS ARE IN INCHES (MILLIMETERS) UNLESS OTHERWISE SHOWN.

SECTION COUNTY R. SHAH 10-03-96 ILE NAME : USER NAME = dravakosgn CURB OR CURB AND GUTTER DuPAGE 24 20 DRAWN A. ABBAS 03-21-97 STATE OF ILLINOIS 14-00051-00-RS REMOVAL AND REPLACEMENT CONTRACT NO. 61C61 REVISED - M. GOMEZ 01-22-01 **DEPARTMENT OF TRANSPORTATION** BD600-06 (BD-24) PLOT SCALE = 50.000 ' / IN. CHECKED TO STA. PLOT DATE = 12/15/2009 DATE 03-11-94 REVISED -R. BORO 12-15-09

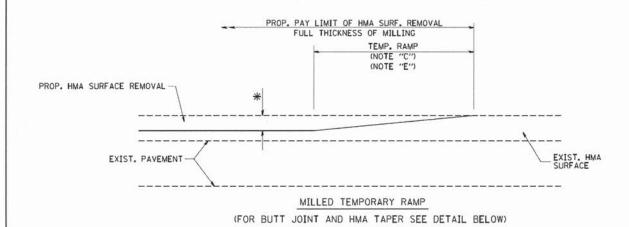


OPTION 1

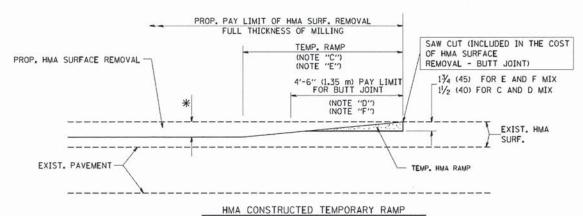

(FOR BUTT JOINT AND HMA TAPER SEE DETAIL BELOW)

OPTION 2


TYPICAL TEMPORARY RAMP

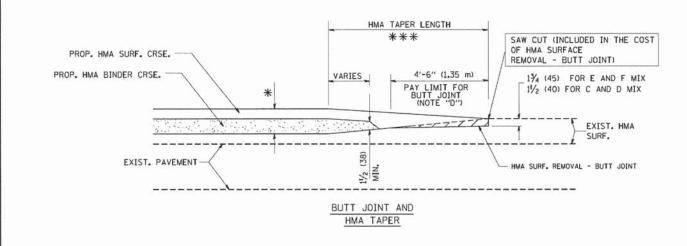


TYPICAL BUTT JOINT AND HMA TAPER FOR MILLING AND RESURFACING

STATE OF ILLINOIS DEPARTMENT OF TRANSPORTATION

COUNTY TOTAL SHEET NO. BUTT JOINT AND DuPAGE 24 21 14-00051-00-RS HMA TAPER DETAILS CONTRACT NO. 61C61 BD400-05 BD32 SHEET NO. 1 OF 1 SHEETS STA. TO STA. SCALE: NONE

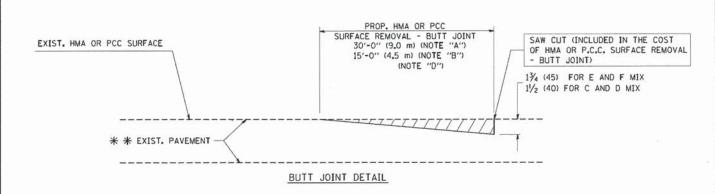

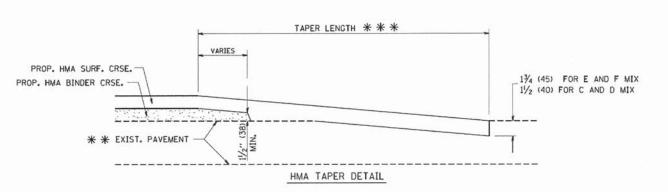

TYPICAL BUTT JOINT AND HMA TAPER FOR RESURFACING ONLY

* * PC CONCRETE, HMA OR HMA RESURFACED PAVEMENT.

NOTES

- A: MAINLINE ROADWAYS AND MAJOR SIDE ROADS.
- B: MINOR SIDE ROADS.
- C: THE TEMP. RAMP SHALL BE CONSTRUCTED IMMEDIATELY UPON REMOVAL OF THE EXISTING HMA SURFACE.
- D: THE BUTT JOINT SHALL BE CONSTRUCTED IMMEDIATELY PRIOR TO PLACING THE PROPOSED HMA COURSES.
- E: TAPER THE TEMP. RAMP AT A RATE OF 3'-0" (900 mm) PER 1 INCH (25 mm) OF MILLING THICKNESS.
- F: INSTALLATION AND REMOVAL OF THE 4'-6" (1.35 m) TEMP. RAMP IS INCLUDED IN COST OF HMA SURFACE REMOVAL - BUTT JOINT
- G: SEE ARTICLE 406.08 AND 406.14 OF THE STANDARD SPECIFICATIONS FOR "HMA AND/OR PCC SURFACE REMOVAL, BUTT JOINT".
- * SEE TYPICAL SECTIONS FOR MILLING THICKNESS.
- ** * * 20'-0" (6.1 m) PER 1 (25) RESURFACING (NOTE "A") 10'-0" (3.0 m) PER 1 (25) RESURFACING (NOTE "B")


BASIS OF PAYMENT:

THE BUTT JOINT WILL BE PAID FOR AT THE CONTRACT UNIT PRICE PER SQUARE YARD (SQUARE METER) FOR "HOT-MIX ASPHALT SURFACE REMOVAL - BUTT JOINT" OR FOR "PORTLAND CEMENT CONCRETE SURFACE REMOVAL- BUTT JOINT".

ALL DIMENSIONS ARE IN INCHES (MILLIMETERS) UNLESS OTHERWISE SHOWN.

FILE NAME = SER NAME # gaglianobt \diststd\22x34\bd32.dgn PLOT SCALE = 50,0000 '/ IN

DESIGNED - M. DE YONG REVISED - R. SHAH 10-25-94 REVISED DRAWN A. ABBAS 03-21-97 CHECKED REVISED M. GOMEZ 04-06-01 PLDT DATE = 1/4/2008 DATE 06-13-90 REVISED - R. BORO 01-01-07

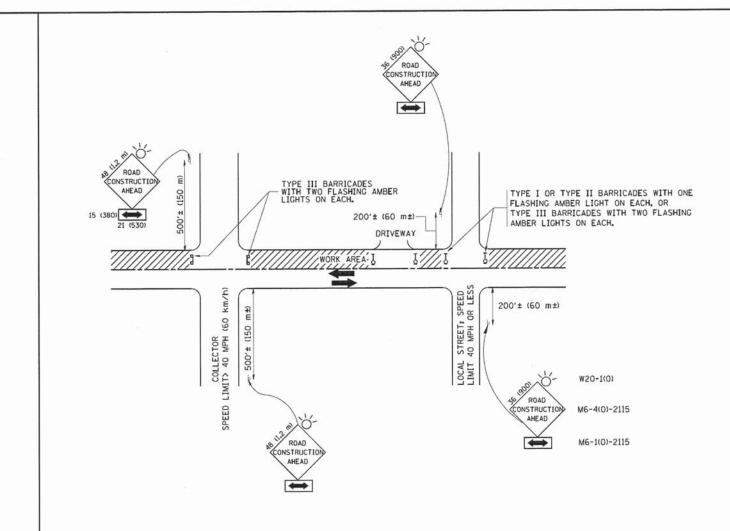

TRAFFIC CONTROL AND PROTECTION FOR SIDE ROADS, INTERSECTIONS, AND DRIVEWAYS

NOTES:

- A. FOR NO LANE RESTRICTION ON THE SIDE ROAD OR DRIVEWAYS
- SIDE ROAD WITH A SPEED LIMIT OF 40 MPH (60 km/h) OR LESS AS SHOWN ON THE DRAWING AND AS DIRECTED BY THE ENGINEERs
- O) ONE ROAD CONSTRUCTION AHEAD SIGN 36 x 36 (900x900) WITH A FLASHER AND FLAG MOUNTED ON IT APPROXIMATELY 200' (60 m) IN ADVANCE OF THE MAIN ROUTE.
- b) THE CLOSED PORTION OF THE MAIN ROUTE SHALL BE PROTECTED BY BLOCKING WITH TYPE I, TYPE II OR TYPE III BARRICADES, 1/3 OF THE CROSS SECTION OF THE CLOSED PORTION.
- 2. SIDE ROAD WITH A SPEED LIMIT GREATER THAN 40 MPH (60 km/h)
 AS SHOWN ON THE DRAWING AND AS DIRECTED BY THE ENGINEER:
- O) ONE ROAD CONSTRUCTION AHEAD SIGN 48 x 48 (1.2 m x 1.2 m) WITH A FLASHER MOUNTED ON 1T APPROXIMATELY 500' (150 m) IN ADVANCE OF THE MAIN ROUTE.
- b) THE CLOSED PORTION OF THE MAIN ROUTE SHALL BE PROTECTED BY BLOCKING WITH TYPE III BARRICADES, 1/2 OF THE CROSS SECTION OF THE CLOSED PORTION.
- WHEN THE SIDE ROAD LIES BETWEEN THE BEGINNING OF THE MAINLINE SIGNING AND THE WORK ZONE, A SINGLE HEADED ARROW (MG-1) SHALL BE USED IN LIEU OF THE DOUBLE HEADED ARROW (MG-4).

B. FOR A LANE CLOSURE ON A SIDE ROAD OR DRIVEWAY:

- USE APPLICABLE PORTIONS OF THE TYPICAL APPLICATION OF TRAFFIC CONTROL DEVICES (STD. 701501, STD. 701606 OR THE APPROPRIATE STANDARD). THE SPACING OF SIGNS AND BARRICADES SHALL BE ADJUSTED FOR FIELD CONDITIONS AS DIRECTED BY THE ENGINEER, THE DIRECTIONAL ARROW SHALL BE COVERED OR REMOVED WHEN NO LONGER CONSISTENT WITH THE SIDE ROAD LANE CLOSURE.
- C. ADVANCE WARNING SIGNS ARE TO BE OMITTED ON DRIVEWAY UNLESS OTHERWISE NOTED.
- D. THE TRAFFIC CONTROL AND PROTECTION FOR SIDE ROADS, INTERSECTIONS, AND DRIVEWAYS SHALL BE INCIDENTAL TO THE COST OF SPECIFIED TRAFFIC CONTROL STANDARDS OR ITEMS.

All dimensions are in millimeters (inches) unless otherwise shown.


FILE NAME * USER NAME * goglionobt DESIGNED - LHA REVISED - J. OBERLE 10-18-95

DRAWN - REVISED - A. HOUSEH 03-06-96

PLOT SCALE = 50.000 '/ IN. CHECKED - REVISED - A. HOUSEH 10-15-96

PLOT DATE * 1/4/2008 DATE - 06-89 REVISED -T. RAMMACHER 01-06-00

STATE OF ILLINOIS
DEPARTMENT OF TRANSPORTATION

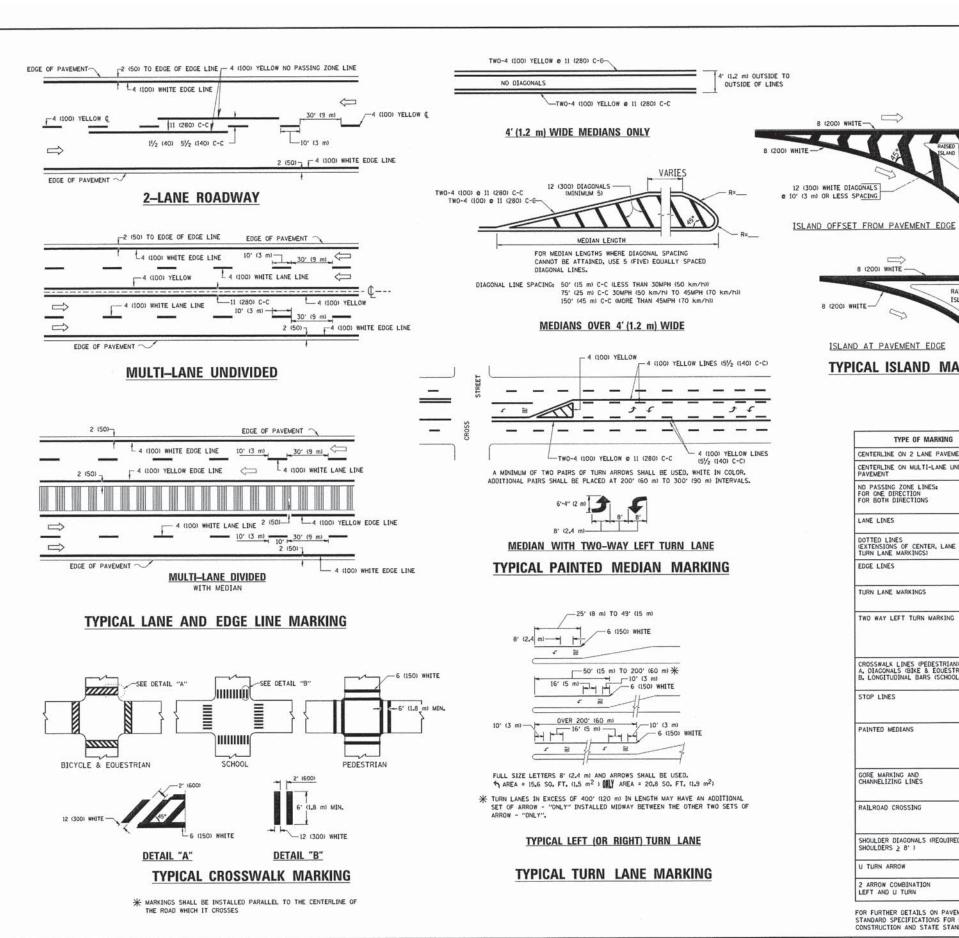

USER NAME = hszekrf

PLOT SCALE = 50.000 '/ in.

PLOT DATE = 12/21/2015

FILE NAME =

WANTED THE STATE OF THE PROPERTY OF THE PROPER

DESIGNED - EVERS

- 03-19-90

CHECKED


DATE

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REVISED -

REVISED -

REVISED -

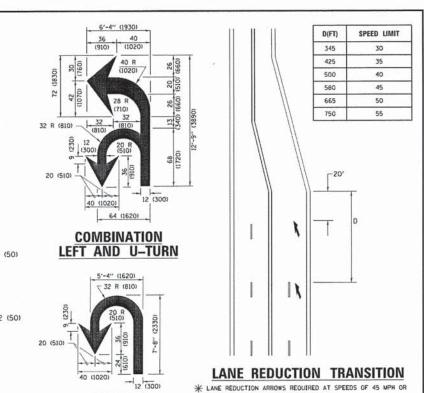

		<u>U-1</u>	TURN	CREATER OR WHEN SPECIFIED IN PLANS.
TYPE OF MARKING	WIDTH OF LINE	PATTERN	COLOR	SPACING /REMARKS
CENTERLINE ON 2 LANE PAVEMENT	4 (100)	SKIP-DASH	YELLOW	10' (3 m) LINE WITH 30' (9 m) SPACE
CENTERLINE ON MULTI-LANE UNDIVIDED PAVEMENT	2 e 4 (100)	SOL1D	YELLOW	11 (280) C-C
NO PASSING ZONE LINES: FOR ONE DIRECTION FOR BOTH DIRECTIONS	4 (100) 2 o 4 (100)	SOLID SOLID	YELLOW	5½ (140) C-C FROM SKIP-DASH CENTERLINE 11 1280) C-C OMIT SKIP-DASH CENTERLINE BETWEEN
LANE LINES	4 (100) 5 (125) ON FREEWAYS	SKIP-DASH SKIP-DASH	WHITE WHITE	10' (3 m) LINE WITH 30' (9 m) SPACE
DOTTED LINES (EXTENSIONS OF CENTER, LANE OR TURN LANE MARKINGS)	SAME AS LINE BEING EXTENDED	SKIP-DASH	SAME AS LINE BEING EXTENDED	2' (600) LINE WITH 6' (1.8 m) SPACE
EDGE LINES	4 (100)	SOLID	YELLOW-LEFT WHITE-RIGHT	OUTLINE MEDIANS IN YELLOW
TURN LANE MARKINGS	6 (150) LINE; FULL SIZE LETTERS & SYMBOLS (8' (2.4m))	SOLID	WHITE	SEE TYPICAL TURN LANE MARKING DETAIL
TWO WAY LEFT TURN MARKING	2 c 4 (100) EACH DIRECTION B' (2.4m) LEFT ARROW	SKIP-DASH AND SOLID IN PAIRS	YELLOW	10' (3 m) LINE WITH 30' (9 m) SPACE FOR SKIP-DASH; 5½ (140) C-C BETWEEN SOLID LINE AND SKIP-DASH LINE E SEE TYPICAL TWO-WAY LEFT TURN MARKING DETAIL
CROSSWALK LINES (PEDESTRIAN) A. DIAGONALS (BIKE & EQUESTRIAN) B. LONGITUDINAL BARS (SCHOOL)	2 e 6 (150) 12 (300) e 45° 12 (300) e 90°	SOLID SOLID SOLID	WHITE WHITE WHITE	NOT LESS THAN 6' (I.8 m) APART 2' (500) APART 2' (600) APART SEE TYPICAL CROSSWALK MARKING DETAILS.
STOP LINES	24 (600)	SOLID	WHITE	PLACE 4' (1.2 m) IN ADVANCE OF AND PARALLE, TO CROSSMALK, IF PRESENT. OTHERWISE, PLACE AT DESIRED STOPPING POINT, PARALLEL TO CROSSROAD CENTERLINE, WHERE POSSIBLE
PAINTED MEDIANS	2 © 4 (100) WITH 12 (300) DIAGONALS © 45° NO DIAGONALS USED FOR 4' (1.2 m) WIDE MEDIANS	SOLID	YELLOW: TWO WAY TRAFFIC WHITE: ONE WAY TRAFFIC	11 (280) C-C FOR THE DOUBLE LINE SEE TYPICAL PAINTED MEDIAN MARKING.
GORE MARKING AND CHANNELIZING LINES	8 (200) WITH 12 (300) DIAGONALS @ 45*	SOL10	WHITE	DIACONALS: 15' (4,5 m) C-C (LESS THAN 30MPH (50 km/h)) 20' (6 m) C-C 30MPH (50 km/h) TO 45MPH (70 km/h)) 30' (9 m) C-C (OVER 45MPH (70 km/h))
RAILROAD CROSSING	24 (600) TRANSVERSE LINES: "RR" IS 6' (1.8 m) LETTERS; 16 (400) LINE FOR "X"	SOLID	WHITE	SEE STATE STANDARD 780001 AREA OF: "M"3.6 SQ. FT. (0.33 m ²) EACH "X"454.0 SQ. FT. (5.0 m ²)
SHOULDER DIAGONALS (REQUIRED FOR SHOULDERS ≥ 8')	12 (300) a 45°	SOLID	WHITE - RIGHT YELLOW - LEFT	50' (15 m) C-C (LESS THAN 30MPH (50 km/h)) 75' (25 m) C-C (30 MPH (50 km/h) T0 45MPH (70 km/h)) 150' (45 m) C-C (0VER 45MPH (70 km/h))
U TURN ARROW	SEE DETAIL	SOL10	WHITE	16.3 SF
2 ARROW COMBINATION LEFT AND U TURN	SEE DETAIL	SOLID	WHITE	30.4 SF

FOR FURTHER DETAILS ON PAVEMENT MARKING REFER TO STANDARD SPECIFICATIONS FOR ROAD AND BRIDGE CONSTRUCTION AND STATE STANDARD 780001.

8 (200) WHITE -


ISLAND AT PAVEMENT EDGE

TYPICAL ISLAND MARKING

RAISED

All dimensions are in inches (millimeters) unless otherwise shown.

-T. RAMMACHER 10-27-94			DISTRICT ONE				F.A. RTÉ.	SECTION	COUNTY	SHEETS	NO.
- C. JUCIUS 09-09-09	STATE OF ILLINOIS		TYPICAL PAVEMENT MARKINGS					2625 14-00051-00-RS	DuPAGE	DuPAGE 24 23	
- C. JUCIUS 07-01-13	DEPARTMENT OF TRANSPORTATION		111	IGAL PA	VEIVIEIVI IVIANKIIVUS). 		TC-13	CONTRAC	T NO. 61	C61
- C. JUCIUS 12-21-15		SCALE: NONE	SHEET 1	OF 1	SHEETS STA.	TO STA.		ILLINOIS FEO	AID PROJECT M-	1003(303)	

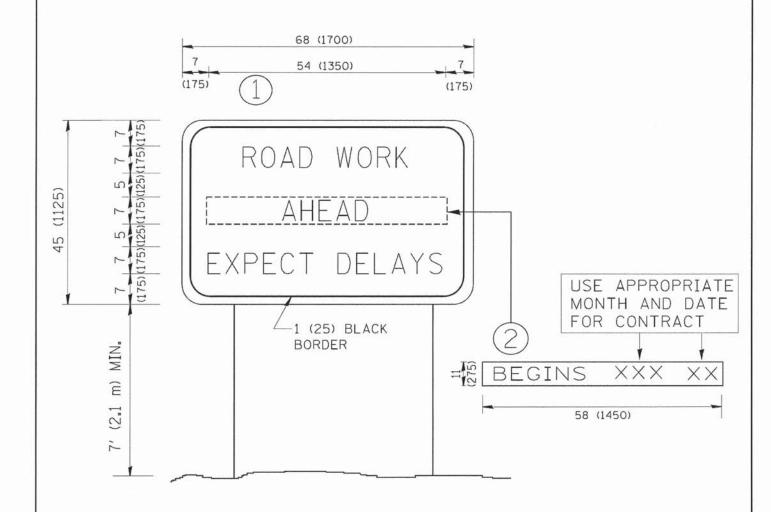

NOTES:

- 1. USE BLACK LETTERING ON ORANGE BACKGROUND.
- 2. ERECT SIGNS IN ADVANCE OF THE LOCATION FOR THE "ROAD CONSTRUCTION AHEAD" SIGN AT LOCATIONS AS DIRECTED BY THE ENGINEER.
- 3. ERECT SIGN (1) WITH INSTALLED PANEL (2) ONE WEEK PRIOR TO THE START OF CONSTRUCTION.
- 4. REMOVE PANEL (2) SOON AFTER THE START OF CONSTRUCTION.
- 5. SEE SPECIAL PROVISION FOR "TEMPORARY INFORMATION SIGNING" FOR ADDITIONAL INFORMATION.
- 6. ONE SIGN ASSEMBLY EQUALS 25.70 SQ. FT. (2.3 SQ. M.)
- 7. SHALL BE PAID FOR AS TEMPORARY INFORMATION SIGNING.

ALL DIMENSIONS ARE IN INCHES (MILLIMETERS) UNLESS OTHERWISE SHOWN.

	FILE NAME =	USER NAME = gaglianobt	DESIGNED -	REVISED - R. MIRS 09-15-97
	W:\diststd\22x34\tc22.dgn		DRAWN -	REVISED - R. MIRS 12-11-97
Y O		PLOT SCALE = 50.000 ' / IN.	CHECKED -	REVISED -T. RAMMACHER 02-02-99
260		PLOT DATE = 1/4/2008	DATE -	REVISED - C. JUCIUS 01-31-07

STATE	0	ILLINOIS
DEPARTMENT	OF	TRANSPORTATION

	ARTERIAL RO	F.A RTE.	SECTION	COUNTY	TOTAL	SHEET NO.		
	INCODERATION	CICN		2625	14-00051-00-RS	DUPAGE	24	24
	INFORMATION SIGN				TC-22	CONTRAC	T NO. 610	261
SCALE: NONE	SHEET NO. 1 OF 1 SHEETS	STA.	TO STA.	FED. ROAD	DIST. NO. 1 ILLINOIS FED.	AID PROJECT M-4	(202)(003)	