04-22-2016 LETTING ITEM 125

FOR INDEX OF SHEETS, SEE SHEET NO. 2

FOR INDEX OF HIGHWAY STANDARDS, SEE SHEET NO. 2

PROJECT LOCATED IN THE VILLAGE OF BEECHER

## STATE OF ILLINOIS DEPARTMENT OF TRANSPORTATION DIVISION OF HIGHWAYS

# PLANS FOR PROPOSED FEDERAL AID PROJECT

FAU ROUTE 407 (CHURCH ROAD) AT CARDINAL CREEK BOULEVARD FAU ROUTE 424 (CARDINAL CREEK BLVD) AT CHURCH ROAD FAP ROUTE 332 (DIXIE HIGHWAY) AT MILLER STREET FAU ROUTE 423 (PENFIELD STREET) AT HODGES STREET

TRAFFIC DATA

CHURCH ROAD
POSTED SPEED LIMIT = 30 MPH, 2014 ADT = 1,050 VPD

CARDINAL CREEK BOULEVARD
POSTED SPEED LIMIT = 30 MPH, 2014 ADT = < 1,000 VPD

DIXIE HIGHWAY
POSTED SPEED LIMIT = 35 MPH, 2014 ADT = 8,850 VPD

PENFIELD STREET
POSTED SPEED LIMIT = 25 MPH, 2014 ADT = 1,800 VPD

**DESIGN DESIGNATION** 

**CHURCH ROAD - MAJOR COLLECTOR** 

CARDINAL CREEK BOULEVARD - MAJOR COLLECTOR

PROJECT LOCATION

PROJECT LOCATION

PENFIELD STREET

**DIXIE HIGHWAY** 

**DIXIE HIGHWAY - PRINCIPAL ARTERIAL** 

PENFIELD STREET - MAJOR COLLECTOR

0 100' 200' 300' -- 1" = 100' 10' 20' 30' -- 1" = 10' 10' 10' 1" = 50' 100' 100' 1" = 40' 100' 100' 1" = 30' 100' 100' 1" = 20' 100' 100' 1" = 20' 100' 100' 1" = 20' 100' 100' 1" = 20' 100' 1" = 20' 100' 1" = 20' 100' 1" = 20' 100' 1" = 20' 100' 1" = 20' 100' 1" = 20' 100' 1" = 20' 1" = 20' 100' 1" = 20' 1"

FULL SIZE PLANS HAVE BEEN PREPARED USING STANDARD ENGINEERING SCALES. REDUCED SIZED PLANS WILL NOT CONFORM TO STANDARD SCALES. IN MAKING MEASUREMENTS ON REDUCED PLANS, THE ABOVE SCALES MAY BE USED.

J.U.L.I.E. DESIGN STAGE REQUEST DIG. No. <u>A1892825</u>



CONTACT JULIE AT 811 OR 800-892-0123
WITH THE FOLLOWING:

COUNTY = WILL

CITY-TWNSHP. = BEECHER - WASHINGTON


SEC. & 1/4 SEC, NO. = 16S, T33N, R14E

48 HOURS (2 working days) BEFORE YOU DIG

CONTRACT NO. 61C56

SAFE ROUTES TO SCHOOL PROJECT: STRS-4009(348) SECTION: 14-00018-00-SG VILLAGE OF BEECHER WILL COUNTY

PROJECT LOCATION CHURCH ROAD CARDINAL CREEK BOULEVARD

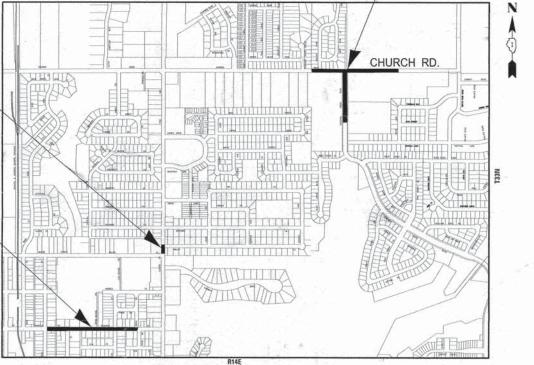

SECTION 16S, T33N, R14E, OF THE THIRD PRINCIPAL MERIDIAN
WASHINGTON TOWNSHIP
GROSS LENGTH = 4,400 FT. = 0.83 MILE

GROSS LENGTH = 4,400 FT. = 0.83 MILENET LENGTH = 4,400 FT. = 0.83 MILE



FAU 407
FAU 427
FAU 424
STRS-4009(348)
ILLINOIS CONTRACT NO. 61C56

AU 423

AU 6AVESS STEPHENSON REMERACO BOOKE ME HENRY LAKE

CARROLL

OGLE

AU 620

CARROLL

OGLE







PRINTED BY THE AUTHORITY OF THE STATE OF ILLINOIS

B&W PROJECT NO.: 150194

DATE: 11-20-15

#### **GENERAL NOTES**

- 1. ALL CONSTRUCTION SHALL BE DONE IN ACCORDANCE WITH THE DETAILS IN THE PLANS, THE SPECIAL PROVISIONS INCLUDED IN THE CONTRACT DOCUMENTS, AND THE LATEST EDITION OF THE FOLLOWING STATE OF ILLINOIS SPECIFICATIONS: "THE STANDARD SPECIFICATIONS FOR ROAD AND BRIDGE CONSTRUCTION" (REFERRED TO AS THE "STANDARD SPECIFICATIONS"), THE "SUPPLEMENTAL SPECIFICATIONS AND RECURRING SPECIAL PROVISIONS", THE "MANUAL ON UNIFORM TRAFFIC CONTROL DEVICES FOR STREETS AND HIGHWAYS". THE "MANUAL OF TEST PROCEDURES FOR MATERIALS" AND THE "STANDARD SPECIFICATIONS FOR WATER AND SEWER MAIN CONSTRUCTION IN
- 2. UTILITY LOCATIONS HAVE NOT BEEN SHOWN ON THESE PLANS THE CONTRACTOR SHALL BE RESPONSIBLE FOR THE PROTECTION OF ALL UNDERGROUND OR SURFACE UTILITIES, INCLUDING SPRINKLER SYSTEMS, EVEN THOUGH THEY MAY NOT BE SHOWN ON THE PLANS. THE CONTRACTOR SHALL ALSO VERIFY THE DEPTHS OF THE EXISTING UTILITIES IF NECESSARY TO VERIFY THAT GRADE CONFLICTS WILL NOT OCCUR WITH ANY PROPOSED UTILITIES PRIOR TO CONSTRUCTION AND ORDERING ANY MATERIALS. ANY RELOCATION OR LOWERING OF UTILITIES SHALL BE COORDINATED BY THE CONTRACTOR. THE COST OF THIS EXPLORATION SHALL BE INCLUDED IN THE COST OF THE PROPOSED UTILITY CONSTRUCTION.
- 3. THE CONTRACTOR SHALL NOTIFY THE VILLAGE PUBLIC WORKS ADMINISTRATOR AT LEAST 48 HOURS IN ADVANCE OF BEGINNING WORK TO OBTAIN VILLAGE UTILITY LOCATIONS.
- 4. THE CONTRACTOR MAY OBTAIN MUNICIPAL WATER IN BULK, AT NO CHARGE, AS LONG AS THERE IS NOT A "WATERING BAN" IN EFFECT. THE INDISCRIMINATE USE OF FIRE HYDRANTS IS STRICTLY PROHIBITED WATER FOR CONSTRUCTION SHALL BE METERED OR OTHERWISE ACCOUNTED FOR AND A DAILY LOG MAINTAINED. THE CONTRACTOR SHALL PROVIDE THE WATER TRUCK AND DRIVER REQUIRED TO OBTAIN AND TRANSPORT THIS WATER. THE VILLAGE RESERVES THE RIGHT TO RESTRICT OR REFUSE THE USE OF VILLAGE WATER IF DEEMED NECESSARY.
- 5. ACCESS TO PRIVATE DRIVEWAYS SHALL BE PROVIDED AT ALL TIMES EXCEPT DURING ACTUAL CONSTRUCTION ADJACENT THERE TO. TEMPORARY RAMPS SHALL BE CONSTRUCTED AS NEEDED TO PROVIDE SUCH ACCESS, UTILIZING CRUSHED STONE OR CRUSHED GRAVEL.
- 6. IT WILL BE THE CONTRACTOR'S RESPONSIBILITY TO NOTIFY THE ENGINEER, RESIDENTS AND THE VILLAGE WHEN ACCESS TO DRIVEWAYS WILL BE TEMPORARILY CLOSED DUE TO CURB AND GUTTER AND/OR DRIVEWAY REPLACEMENT. THE CONTRACTOR SHALL DISTRIBUTE NOTICES PROVIDED BY THE VILLAGE TO RESIDENTS AT LEAST 24 HOURS PRIOR TO PLANNED CLOSURE. EVERY EFFORT SHALL BE MADE TO ACCOMMODATE ACCESS TO THESE PROPERTIES INCLUDING KNOCKING ON DOORS WHEN DRIVEWAYS ARE ABOUT TO BE CLOSED.
- 7. TRANSVERSE EXPANSION JOINTS %" SHALL BE PLACED EVERY 50 FEET OR AS DETERMINED BY THE ENGINEER. TRANSVERSE CONTRACTION JOINTS SHALL BE PLACED EVERY 5-FEET
- 8. A 1/2-INCH THICK EXPANSION JOINT SHALL BE PROVIDED AT THE JUNCTION OF THE DRIVEWAY APRON AND CURB, AND AT THE JUNCTION OF THE DRIVEWAY APRON AND THE SIDEWALK. THIS WORK WILL BE INCLUDED IN THE COST OF PORTLAND CEMENT CONCRETE DRIVEWAY PAVEMENT.
- 9. DETECTABLE WARNINGS SHALL BE CONSTRUCTED WITH THE INSTALLATION OF ULTRA-ADA PADS #726, 24"X60" MINIMUM NOMINAL SIZE PANEL MANUFACTURED BY ULTRA TECH. THE DOMES LOCATED ON THE PANEL SHALL PARALLEL THE PAVEMENT CROSS WALK WITH THE CLOSEST EDGE LOCATED AT THE BACK OF CURB. THE CONTRASTING PANEL COLOR SHALL BE SELECTED BY THE VILLAGE. INSTALLATION SHALL OCCUR IN ACCORDANCE WITH THE MANUFACTURER'S RECOMMENDATIONS.
- 10. IN AREAS WHERE THE EXISTING DRIVEWAY, SIDEWALK, OR CURB AND GUTTER IS TO BE REMOVED AND REPLACED, THE REMOVAL AND DISPOSAL OF ANY ADDITIONAL MATERIAL REQUIRED TO ESTABLISH THE PROPOSED DRIVEWAY, SIDEWALK, OR CURB AND GUTTER SUBGRADE ELEVATION SHALL BE INCLUDED IN THE APPROPRIATE REMOVAL PAY ITEMS.
- 11.ALL POSTS, RAILROAD TIES, AND DECORATIVE TIMBER IN CONFLICT WITH THE PROPOSED IMPROVEMENTS SHALL BE REMOVED AND RELOCATED AS DETERMINED BY THE ENGINEER AT THE TIME OF CONSTRUCTION AND SHALL BE INCLUDED IN THE COST OF EARTH EXCAVATION. EVERY EFFORT SHALL BE MADE BY THE CONTRACTOR WHEN REMOVING THESE ITEMS TO PRESERVE THEM FROM HARM. ITEMS NOT RELOCATED SHALL BE PROPERLY DISPOSED OF BY THE CONTRACTOR.
- 12.THE IDOT DISTRICT 1 DETAIL FOR COMBINATION CONCRETE CURB AND GUTTER REMOVAL AND REPLACEMENT SHOWN IN THE PLANS SHALL BE MODIFIED TO INCLUDE THE FOLLOWING. THE WORK SHALL INCLUDE SAW-CUTTING AND REMOVING THE EXISTING PAVEMENT A MINIMUM OF 6-INCHES MEASURED FROM THE EXISTING EDGE OF PAVEMENT, AND FILLING THE 6" GAP WITH CLASS SI CONCRETE TO AN ELEVATION 2-1/2" BELOW THE PROPOSED CURB AND GUTTER FLAG. IF THE CONCRETE IS POURED HIGHER THAN 2-1/2" FROM THE GUTTER FLAG FOR STREETS TO BE RESURFACED, THE CONTRACTOR WILL BE REQUIRED TO GRIND ADDITIONAL CONCRETE TO THE REQUIRED 2-1/2" DEPTH. THE AREA BEHIND THE PROPOSED CURB AND GUTTER SHALL BE RESTORED WITH NATIVE SOD IN ACCORDANCE WITH SECTION 1081.03 RATHER THAN SALT TOLERANT SOD.
- 13.THE CONTRACTOR SHALL CONTACT THE IDOT TRAFFIC CONTROL SUPERVISOR, ANDREW SCHUETZE AT (847) 705-4470 72 HOURS IN ADVANCED OF BEGINNING WORK ON IL 1 (DIXIE HIGHWAY).

## BAXTER WOODMAN

ESIGNED	-	LJF	REVISED -
RAWN	+	KAR	REVISED -
HECKED	-	TMS	REVISED -
ATE		11-20-15	FILE - 150194SHT-GenNotes.dgn

VILLAGE OF BEECHER

SAFE ROUTES TO SCHOOL

#### SHEET NO. TITLE

INDEX OF SHEETS

13

SCALE: NONE

- COVER SHEET
- GENERAL NOTES, HIGHWAY STANDARDS AND INDEX OF SHEETS
- SUMMARY OF QUANTITIES
- TYPICAL SECTIONS 4 5
  - SIDEWALK PLANS
  - SIGNAGE PLAN CARDINAL CREEK BOULEVARD AND CHURCH ROAD
  - SIGNAGE PLAN IL ROUTE 1 (DIXIE HIGHWAY)
- SIGNAGE PLAN PENFIELD STREET AT HODGES STREET
- MISCELLANEOUS DETAILS 10
- 11 DISTRICT ONE DETAIL - BD24 CURB OR CURB AND GUTTER REMOVAL AND REPLACEMENT
- DISTRICT ONE DETAIL TCIO TRAFFIC CONTROL AND PROTECTION FOR SIDE ROADS, INTERSECTIONS, AND DRIVEWAYS 12 DISTRICT ONE DETAIL - TC13 DISTRICT ONE TYPICAL PAVEMENT MARKINGS
- DISTRICT ONE DETAIL TC22 ARTERIAL ROAD INFORMATION SIGN

#### LICUMAN CTANDADDC

878001-10 CONCRETE FOUNDATION DETAILS

HIGHWA	AY STANDAKUS
000001-06	STANDARD SYMBOLS, ABBREVIATIONS AND PATTERNS
280001-07	TEMPORARY EROSION CONTROL SYSTEMS
424001-08	PERPENDICULAR CURB RAMPS FOR SIDEWALKS
424006-02	DIAGONAL CURB RAMPS FOR SIDEWALKS
424011-02	CORNER PARALLEL CURB RAMPS FOR SIDEWLAKS
424016-02	MID-BLOCK CURB RAMPS FOR SIDEWLAKS
606001-06	CONCRETE CURB TYPE B AND COMBINATION CONCRETE CURB AND GUTTER
701006-05	OFF-RD OPERATIONS, 2L, 2W, SHORT TIME OPERATIONS
701301-04	LANE CLOSURE, 2L, 2W, SHORT TIME OPERATIONS
701502-06	URBAN LANE CLOSURE, 2L, 2W, WITH BIDIRECTIONAL LEFT TURN LANE
701701-10	URBAN LANE CLOSER, MULTILANE INTERSECTION
701801-06	SIDEWALK, CORNER OR CROSSWALK CLOSURE
701901-05	TRAFFIC CONTROL DEVICES
720001-01	SIGN PANEL MOUNTING DETAILS
720006-04	SIGN PANEL ERECTION DETAILS
728001-01	TELESCOPING STEEL SIGN SUPPORT
880001-01	SPAN WIRE MOUNTED SIGNALS AND FLASHING BEACON INSTALLATION

SECTION F.A. RTE. **GENERAL NOTES, HIGHWAY STANDARDS** 14-00018-00-SG WILL AND INDEX OF SHEETS CONTRACT NO. 61C56 STA.

CODE NO.	ITEM DESCRIPTION	UNIT	TOTAL	CONSTRUCTION TYPE CODE 0021
21101625	TOPSOIL FURNISH AND PLACE, 6"	SQ YD	51	51
25000400	NITROGEN FERTILIZER NUTRIENT	POUND	1	1
25000500	PHOSPHORUS FERTILIZER NUTRIENT	POUND	1	1
25000600	POTASSIUM FERTILIZER NUTRIENT	POUND	1	1
25200100	SODDING	SQ YD	51	51
25200200	SUPPLEMENTAL WATERING	UNIT	3	3
35101600	AGGREGATE BASE COURSE, TYPE B 4"	SQ YD	124	124
40800050	INCIDENTAL HOT-MIX ASPHALT SURFACING	TON	1	1
42001300	PROTECTIVE COAT	SQ YD	125	125
42400200	PORTLAND CEMENT CONCRETE SIDEWALK 5 INCH	SQ FT	1112	1112
42400800	DETECTABLE WARNINGS	SQ FT	132	132
44000600	SIDEWALK REMOVAL	SQ FT	932	932
67100100	MOBILIZATION	LSUM	1	1
66900200	NON-SPECIAL WASTE DISPOSAL	CUYD	29	29
66900450	SPECIAL WASTE PLANS AND REPORTS	LSUM	1	1
66900530	SOIL DISPOSAL ANALYSIS	EACH	1	1
70102622	TRAFFIC CONTROL AND PROTECTION, STANDARD 701502	LSUM	1	1
	TRAFFIC CONTROL AND PROTECTION, STANDARD 701701	LSUM	1	1
70102640		LSUM	1	1
		SQFT	409	409
	SIGN PANEL - TYPE 1			
72400100	REMOVE SIGN PANEL ASSEMBLY - TYPE A	EACH	9	9
72800100	TELESCOPING STEEL SIGN SUPPORT	FOOT	240	240
78000600	THERMOPLASTIC PAVEMENT MARKING - LINE 12"	FOOT	366	366

*	INDICATES SPECIALTY ITEM
#	INDICATES SPECIAL PROVISION

DESIGNED	-	LJF	REVISED -
DRAWN	-	KAR	REVISED -
CHECKED	-	TMS	REVISED -
DATE	-	11-20-15	FILE - 150194SHT-S00.dgn

VILLAGE OF BEECHER SAFE ROUTES TO SCHOOL

				FAU 424 FAP 332 FAU 423				
		3803 1803 1 <u>2</u>		F.A. RTÉ.	SECTION	COUNTY	TOTAL	SHEET NO.
S	UMMARY OF QUAN	ITITIES			14-00018-00-SG	WILL	14	3
						CONTRAC	T NO. 61	C56
CALE: NONE	STA.	. TO S	STA.	FED. ROAD	DIST. NO.   ILLINOIS FED.	AID PROJECT STR	S-4009(348)	


CODE NO.	ITEM DESCRIPTION	UNIT	TOTAL	CONSTRUCTION TYPE CODE 0021
78300100	PAVEMENT MARKING REMOVAL	SQ FT	366	366
Z0004562	COMBINATION CONCRETE CURB AND GUTTER REMOVAL AND REPLACEMENT	FOOT	118	118
Z0030850	TEMPORARY INFORMATION SIGNING	SQ FT	182	182
Z0017400	DRAINAGE & UTILITY STRUCTURES TO BE ADJUSTED	EACH	2	2
X0325714	FLASHING BEACON, POST MOUNTED, SOLAR POWERED INSTALLATION	EACH	6	6


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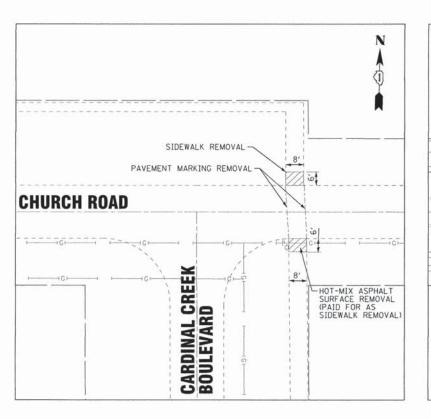
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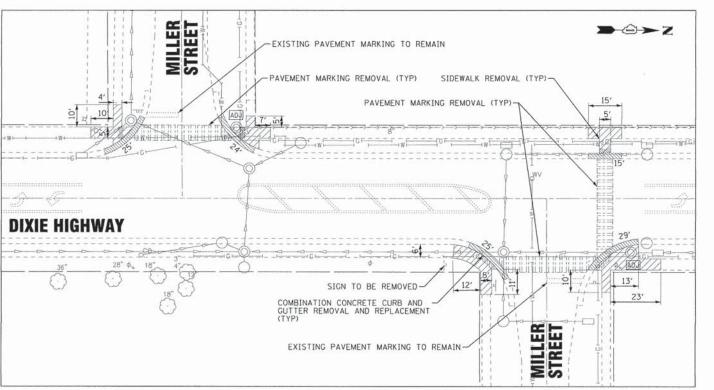
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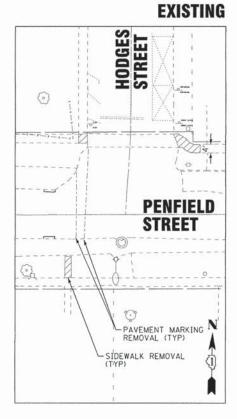
BAXTER WOODMAN










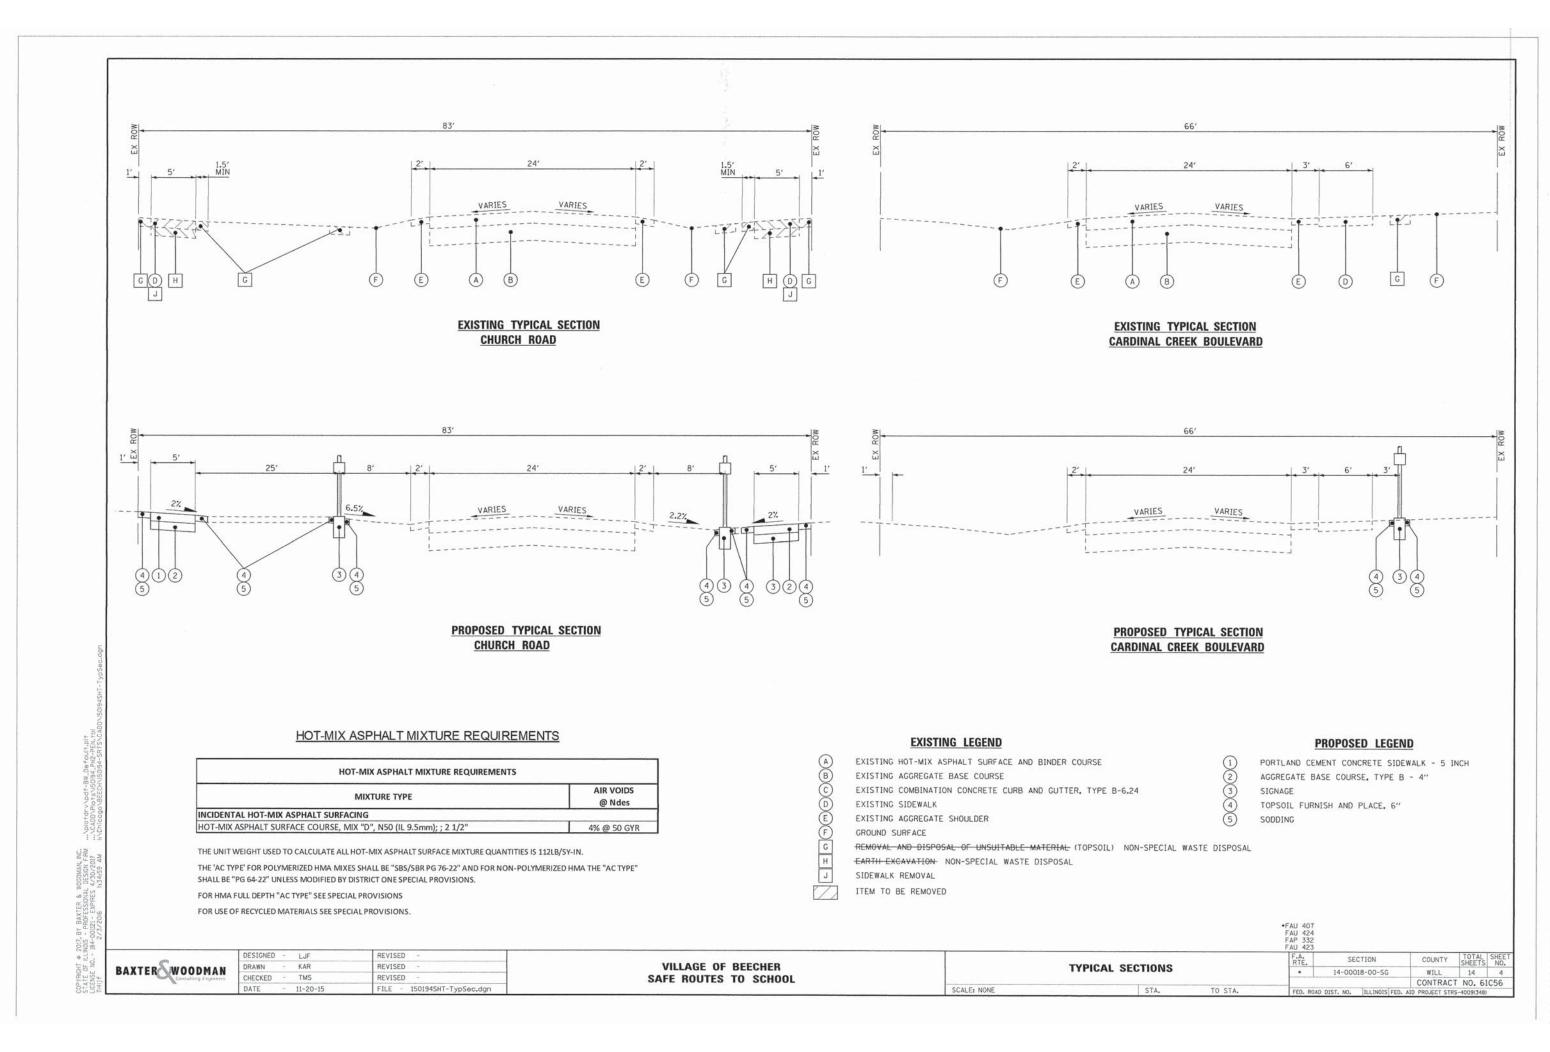

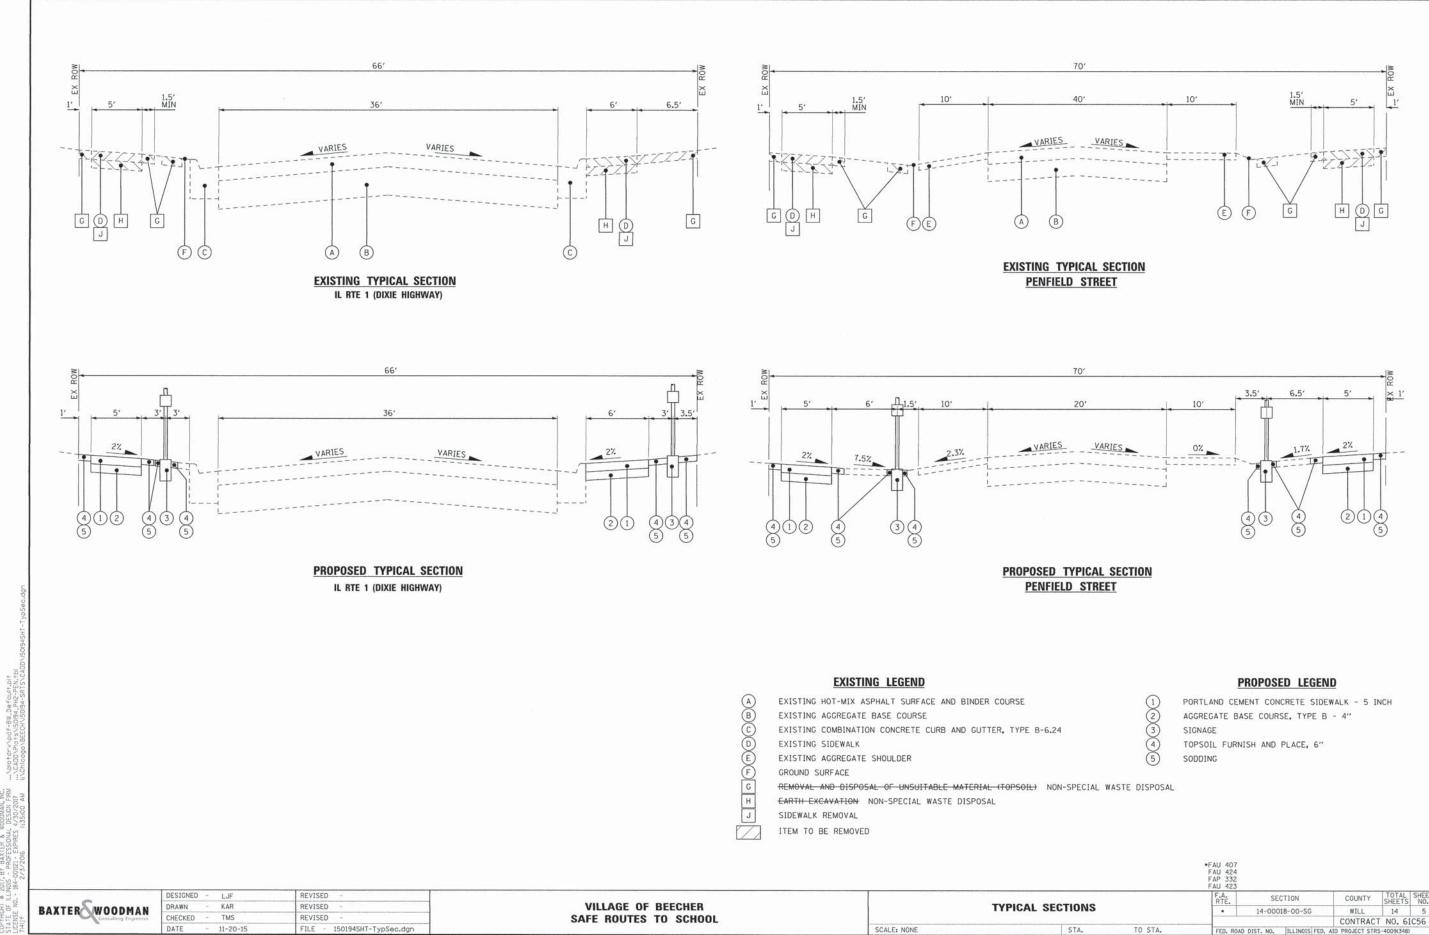

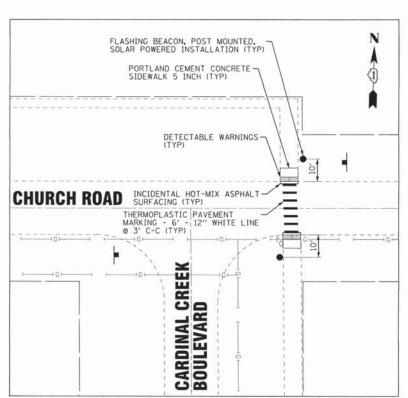

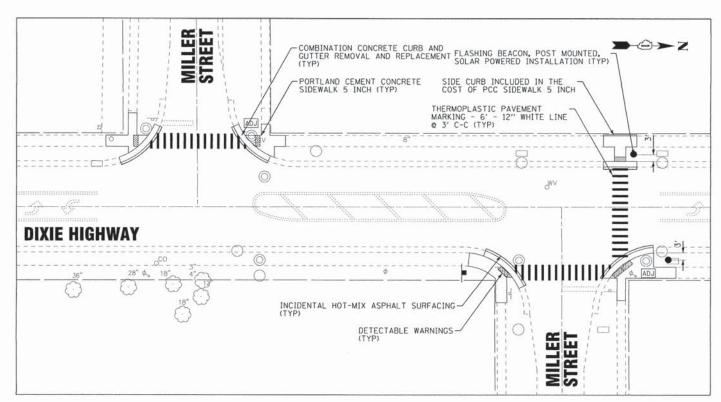

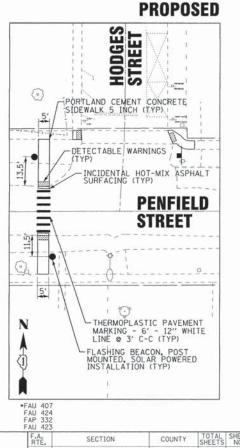

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 DESIGNED
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 DATE
 11-20-15
 FILE
 150194SHT-Plan4\_SIDEWALK
 DETAILS.dgn


VILLAGE OF BEECHER SAFE ROUTES TO SCHOOL SIDEWALK PLANS


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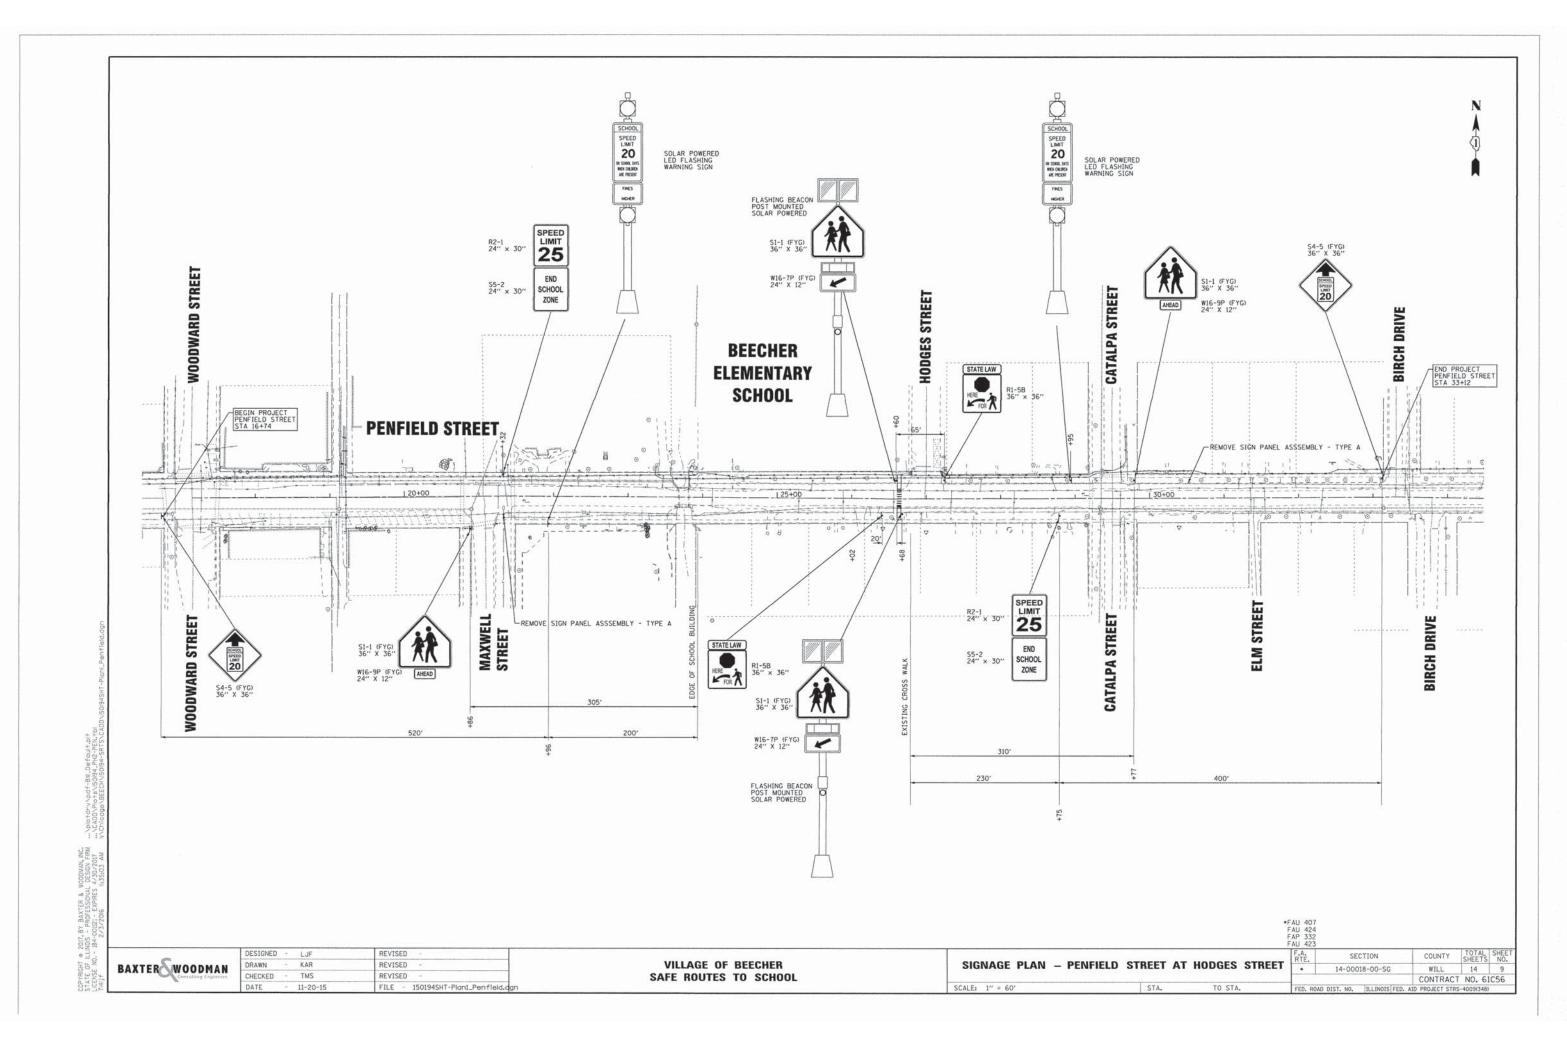
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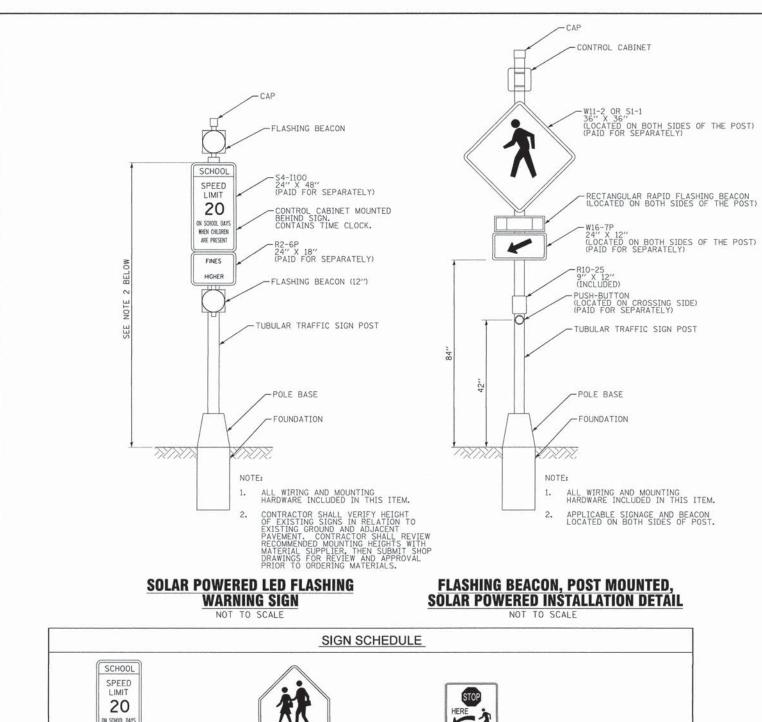
| SECTION | COUNTY | SHEETS | NO. |
| 14-00018-00-SG | WILL | 14 | 6 |
| CONTRACT NO. 61C56 |
| ROAD DIST. NO. | ILLINOIS|FED. AID PROJECT STRS-4009(348)


CONTINUE DE LLINOIS PROFESSIONAL DESIGN FIRM .... CADDVAC+VOGF-BW D8-FOUH-LICENSE NO. - 184-001121 - EXPIRES 4/30/2017 .... CADDVPG+8\50194\_PHZ-PE





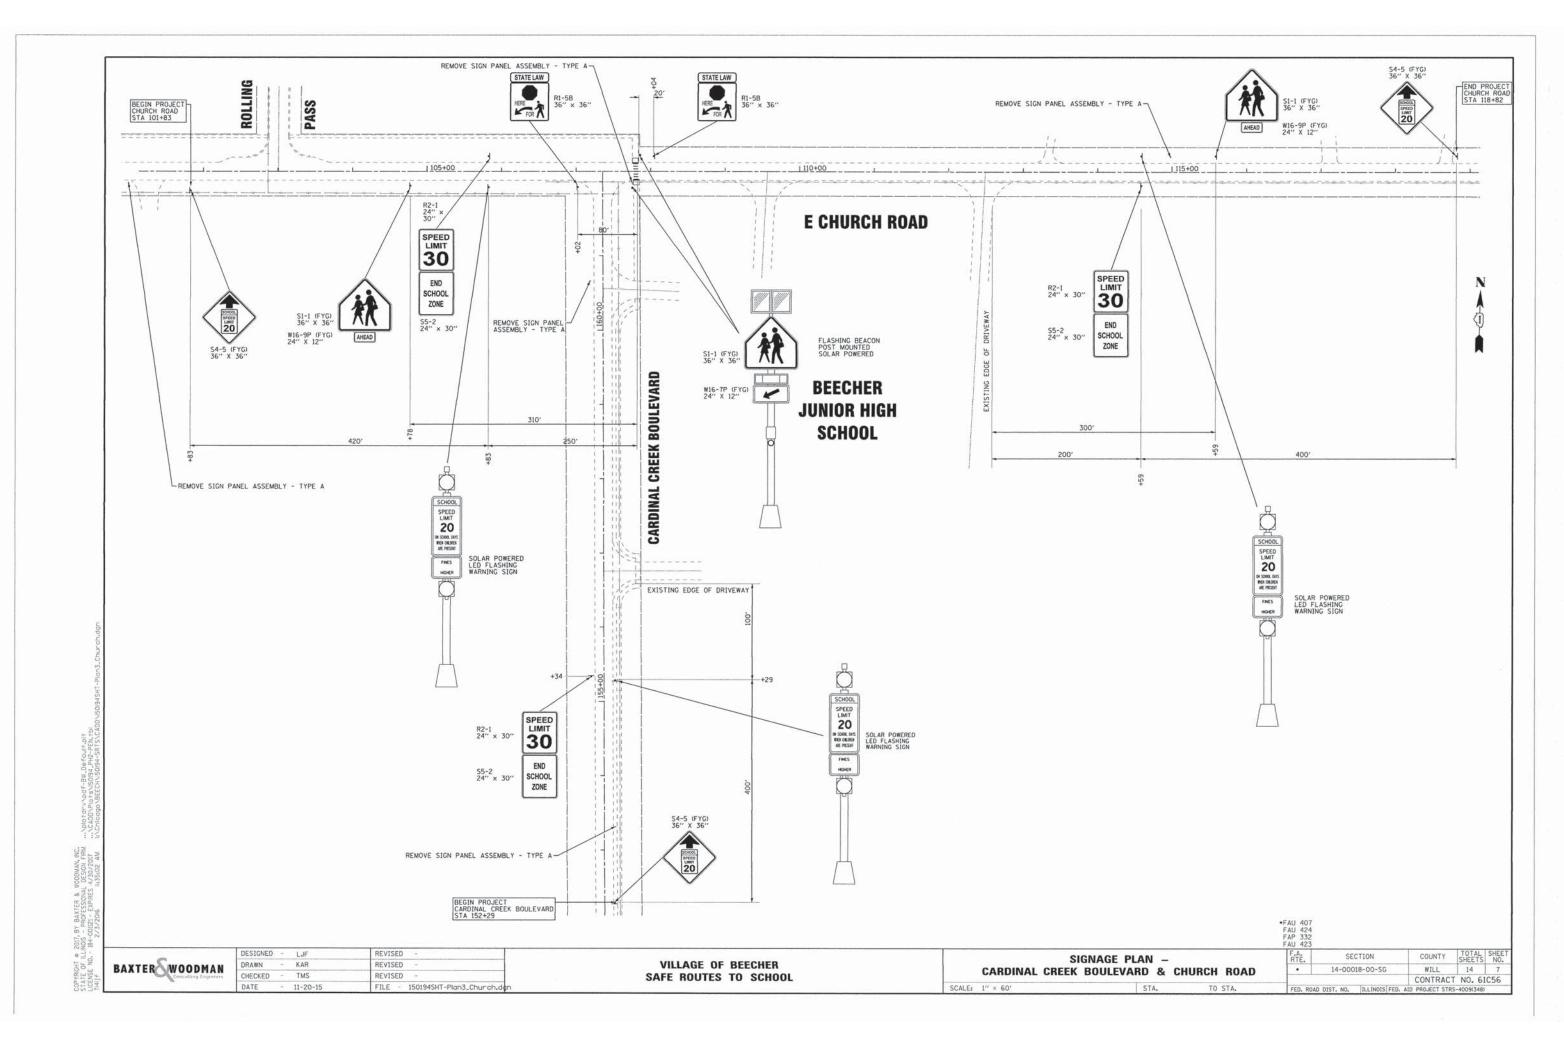

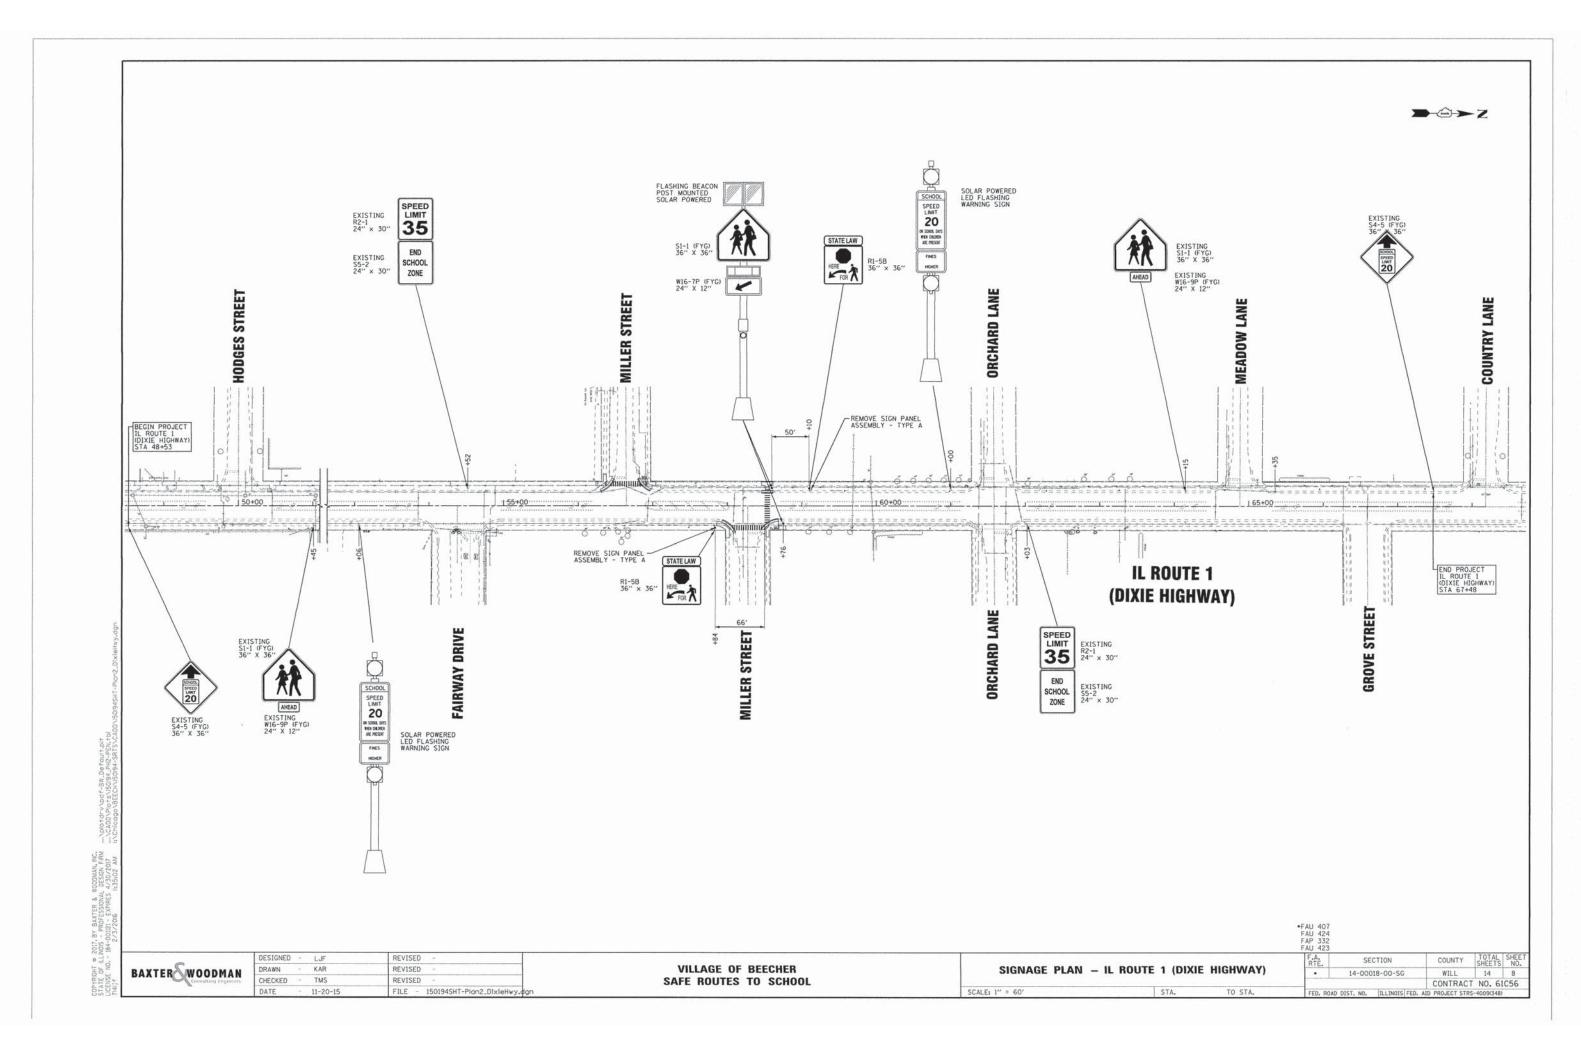

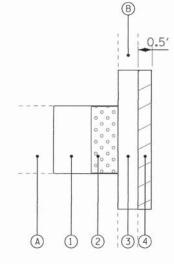

#### **EXISTING LEGEND**

#### PROPOSED LEGEND

A EXISTING SIDEWALK

SCALE: 1" = 60'

- B EXISTING CURB AND GUTTER
- (2) DETECTABLE WARNINGS
- - 3 PROPOSED CONCRETE CURB AND GUTTER

1) PORTLAND CEMENT CONCRETE SIDEWALK

4 INCIDENTAL HOT-MIX ASPHALT SURFACING

**INCIDENTAL HOT-MIX ASPHALT PAVING DETAIL** 


ON SCHOOL DAY: WHEN CHLOREN ARE PRESENT S4-I100 24" X 48' R62E (CAL) PUSH BUTTON FOR PEDESTRIAN FINES HIGHER CROSS WITH CAUTION K \* STATE LAW BLACK LEGEND AND BORDER ON FLOURESCENT YELLOW-GREEN BACKGROUND W16-7PR (FYG) 12" x 24" W16-7PL (FYG) 12" × 24" PUSHBUTTON SIGN 9" X 12"

• SIGN SHOULD BE FLOURESCENT YELLOW-GREEN IN COLOR

REVISED DRAWN REVISED BAXTER WOODMAN CHECKED TMS REVISED FILE - 150194SHT-Detalls.dgn

VILLAGE OF BEECHER SAFE ROUTES TO SCHOOL MISCELLANEOUS DETAILS

F.A. RTE. SECTION COUNTY WILL 14-00018-00-SG CONTRACT NO. 61C56

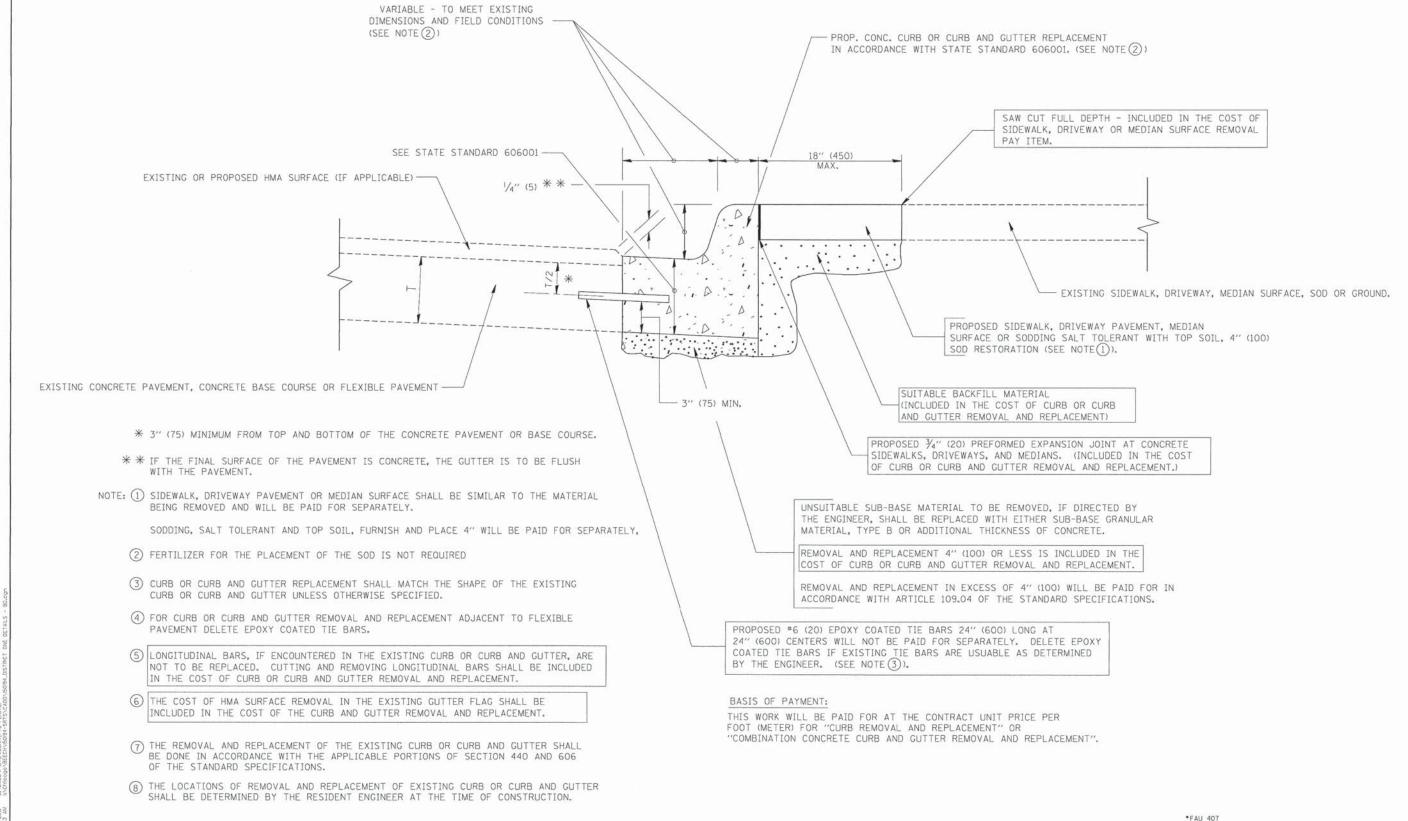

### CURB OR CURB AND GUTTER REMOVAL AND REPLACEMENT

\*FAU 407 FAU 424 FAP 332 FAU 423

ALL DIMENSIONS ARE IN INCHES (MILLIMETERS) UNLESS OTHERWISE SHOWN.

184-	FILE NAME =	USER NAME = drivakosgn	DESIGNED - A. HOUSEH	REVISED - R. SHAH 10-03-96			CURB OR CURB AND GUTTER	F.A.	. SECTION	COUNTY	TOTAL	SHEE NO.
8	c:\pe_work\p=idot\drivekosgn\d0108315\bd	24.dgn	DRAWN -	REVISED - A. ABBAS 03-21-97  REVISED - M. GOMEZ 01-22-01	STATE OF ILLINOIS	1	REMOVAL AND REPLACEMENT		14-00018-00-SG	WILL	14	11
ZIGENS ZIGIJE		PLOT DATE = 12/15/2009	DATE - 03-11-94	REVISED - R. BORO 12-15-09	DEPARTMENT OF TRANSPORTATION	SCALE: NONE	SHEET NO. 1 OF 1 SHEETS STA. TO ST	A. FED	BD600-06 (BD-24)  ROAD DIST. NO. 1 ILLINOIS FED	CONTRACT	NO. 610	56

ROAD ROAD TYPE III BARRICADES WITH TWO FLASHING AMBER LIGHTS ON EACH. AHEAD TYPE I OR TYPE II BARRICADES WITH ONE FLASHING AMBER LIGHT ON EACH, OR TYPE III BARRICADES WITH TWO FLASHING 200'± (60 m±)-AMBER LIGHTS ON EACH. DRIVEWAY WORK AREA ! 200'± (60 m±) 09) STREET; COLLECTOR LIMIT> 40 MPH LOCAL W20-1(0) ROAD CONSTRUCTION M6-4(0)-2115 AHEAD  $\stackrel{\sim}{\longrightarrow}$ M6-1(0)-2115

#### TRAFFIC CONTROL AND PROTECTION FOR SIDE ROADS, INTERSECTIONS, AND DRIVEWAYS

#### NOTES:

- A. FOR NO LANE RESTRICTION ON THE SIDE ROAD OR DRIVEWAYS
- SIDE ROAD WITH A SPEED LIMIT OF 40 MPH (60 km/h) OR LESS AS SHOWN ON THE DRAWING AND AS DIRECTED BY THE ENGINEER:
- Q) ONE ROAD CONSTRUCTION AHEAD SIGN 36 x 36 (900x900) WITH A FLASHER AND FLAG MOUNTED ON IT APPROXIMATELY 200° (60 m) IN ADVANCE OF THE MAIN ROUTE.
- b) THE CLOSED PORTION OF THE MAIN ROUTE SHALL BE PROTECTED BY BLOCKING WITH TYPE I, TYPE II OR TYPE III BARRICADES, 1/3 OF THE CROSS SECTION OF THE CLOSED PORTION.
- 2. SIDE ROAD WITH A SPEED LIMIT GREATER THAN 40 MPH (60 km/h) AS SHOWN ON THE DRAWING AND AS DIRECTED BY THE ENGINEER:
- d) ONE ROAD CONSTRUCTION AHEAD SIGN 48 x 48 (1.2 m x 1.2 m) WITH A FLASHER MOUNTED ON IT APPROXIMATELY 500' (150 m) IN ADVANCE OF THE HALLY POLITY.
- b) THE CLOSED PORTION OF THE MAIN ROUTE SHALL BE PROTECTED BY BLOCKING WITH TYPE III BARRICADES, 1/2 OF THE CROSS SECTION OF THE CLOSED PORTION.
- WHEN THE SIDE ROAD LIES BETWEEN THE BEGINNING OF THE MAINLINE SIGNING AND THE WORK ZONE, A SINGLE HEADED ARROW (MG-1) SHALL BE USED IN LIEU OF THE DOUBLE HEADED ARROW (MG-4).

- B. FOR A LANE CLOSURE ON A SIDE ROAD OR DRIVEWAY:
- USE APPLICABLE PORTIONS OF THE TYPICAL APPLICATION OF TRAFFIC CONTROL DEVICES (STD. 701501, STD. 701606 OR THE APPROPRIATE STANDARD). THE SPACING OF SIGNS AND BARRICADES SHALL BE ADJUSTED FOR FIELD CONDITIONS AS DIRECTED BY THE ENGINEER. THE DIRECTIONAL ARROW SHALL BE COVERED OR REMOVED WHEN NO LONGER CONSISTENT WITH THE SIDE ROAD LANE CLOSURE.
- C. ADVANCE WARNING SIGNS ARE TO BE OMITTED ON DRIVEWAY UNLESS OTHERWISE NOTED.
- D. THE TRAFFIC CONTROL AND PROTECTION FOR SIDE ROADS, INTERSECTIONS, AND DRIVEWAYS SHALL BE INCIDENTAL TO THE COST OF SPECIFIED TRAFFIC CONTROL STANDARDS OR ITEMS.

FAU 407 FAU 424 FAP 332 FAU 423

All dimensions are in millimeters (inches) unless otherwise shown.

FILE NAME = USER NAME = gaglianobt DESIGNED - LHA REVISED - J. OBERLE 10-18-95

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PLOT SCALE = 50.000 '/ IN. CHECKED - REVISED - A. HOUSEH 03-06-96


PLOT DATE = 1/4/2008 DATE - 06-89 REVISED - T. RAMMACHER 01-06-06


STATE OF ILLINOIS
DEPARTMENT OF TRANSPORTATION

TRAFFIC CONTROL AND PROTECTION FOR
SIDE ROADS, INTERSECTIONS, AND DRIVEWAYS
LEE NONE SHEET NO. 1 OF 1 SHEETS STA.

13619 AM 17CHICAGO \BEECH \ISO194-SP

E OF LLINOIS - PROFESSIONAL DESIGN FRA ... NOIOTATVADEF-BW.D. SE NO. - 184-001121 - EXPRES 470/2015 A ACTHOROGAN RETAINED AN ACTHOROGAN REFERENCED.

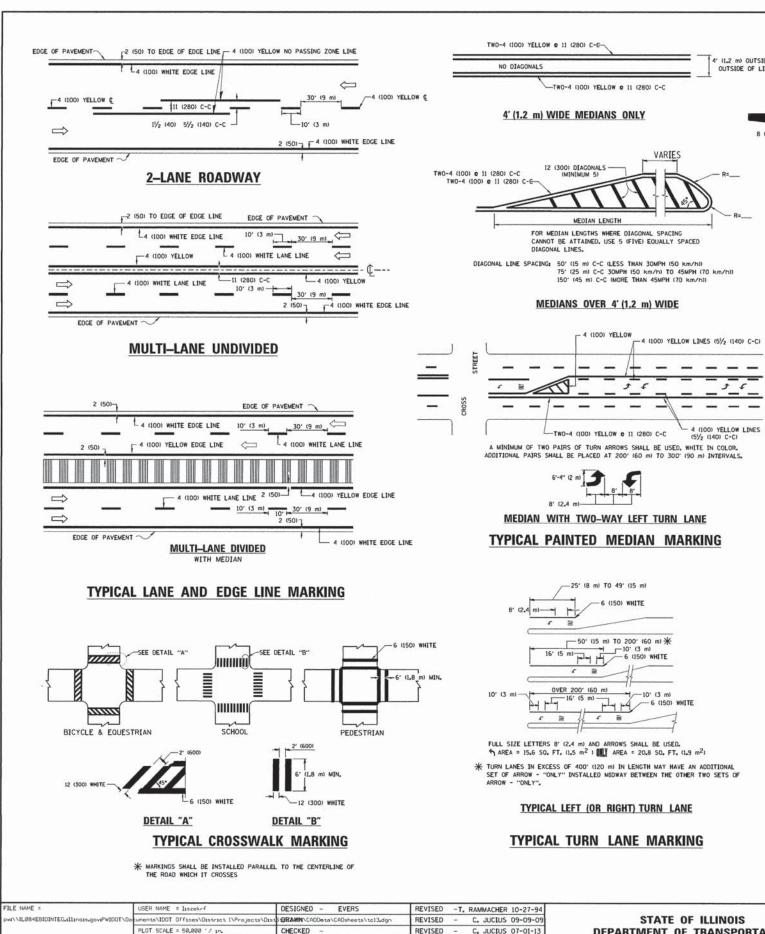

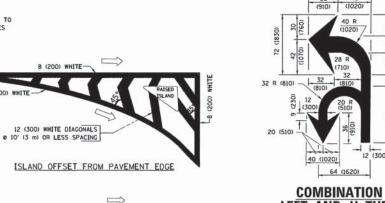





TYPICAL ISLAND MARKING

4' (1.2 m) OUTSIDE TO

OUTSIDE OF LINES

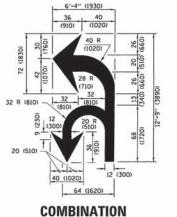



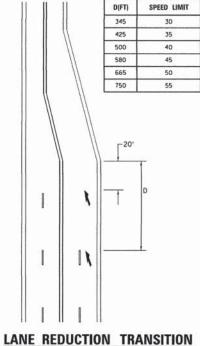

\* LANE REDUCTION ARROWS REQUIRED AT SPEEDS OF 45 MPH OR GREATER OR WHEN SPECIFIED IN PLANS.

TYPE OF MARKING	WIDTH OF LINE	PATTERN	COLOR	SPACING /REMARKS
CENTERLINE ON 2 LANE PAVEMENT	4 (100)	SKIP-DASH	YELLOW	10' (3 m) LINE WITH 30' (9 m) SPACE
CENTERLINE ON MULTI-LANE UNDIVIDED PAVEMENT	2 0 4 (100)	SOLID	YELLOW	11 (280) C-C
NO PASSING ZONE LINES: FOR ONE DIRECTION FOR BOTH DIRECTIONS	4 (100) 2 6 4 (100)	SOLID SOLID	YELLOW	5½ (140) C-C FROM SKIP-DASH CENTERLINE 11 (280) C-C OMIT SKIP-DASH CENTERLINE BETWEEN
LANE LINES	4 (100) 5 (125) ON FREEWAYS	SKIP-DASH SKIP-DASH	WHITE WHITE	10' (3 m) LINE WITH 30' (9 m) SPACE
DOTTED LINES (EXTENSIONS OF CENTER, LANE OR TURN LANE MARKINGS)	SAME AS LINE BEING EXTENDED	SKIP-DASH	SAME AS LINE BEING EXTENDED	2' (600) LINE WITH 6' (1,8 m) SPACE
EDGE LINES	4 (100)	SOLID	YELLOW-LEFT WHITE-RIGHT	OUTLINE MEDIANS IN YELLOW
TURN LANE MARKINGS	6 (150) LINE; FULL SIZE LETTERS & SYMBOLS (8' (2,4m))	SOLID	WHITE	SEE TYPICAL TURN LANE MARKING DETAIL
TWO WAY LEFT TURN MARKING	2 0 4 (100) EACH DIRECTION 8' (2.4m) LEFT ARROW	SKIP-DASH AND SOLID IN PAIRS	YELLOW	10' (3 m) LINE WITH 30' (9 m) SPACE FOR SKIP-DASH: 5½ (140) C-C BETWEEN SOLID LINE AND SKIP-DASH LINE SEE TYPICAL TWO-WAY LEFT TURN MARKING OFFICE TURN
CROSSWALK LINES (PEDESTRIAN) A. DIAGONALS (BIKE & EQUESTRIAN) B. LONGITUDINAL BARS (SCHOOL)	2 <b>e</b> 6 (150) 12 (300) <b>e</b> 45° 12 (300) <b>e</b> 90°	SOLID SOLID SOLID	WHITE WHITE WHITE	NOT LESS THAN 6' (1,8 m) APART 2' (600) APART 2' (600) APART SEE TYPICAL CROSSWALK MARKING DETAILS.
STOP LINES	24 (600)	SOLID	WHITE	PLACE 4" (1.2 m) IN ADVANCE OF AND PARALLE, TO CROSSMALK, IF PRESENT. OTHERWISE, PLACE AT DESIRED STOPPING POINT, PARALLEL TO CROSSROAD CENTERLINE, WHERE POSSIBLE
PAINTED MEDIANS	2 0 4 (100) WITH 12 (300) DIAGONALS 0 45° NO DIAGONALS USED FOR 4' (1.2 m) WIDE MEDIANS	SOLID	YELLOW: TWO WAY TRAFFIC WHITE: ONE WAY TRAFFIC	11 (280) C-C FOR THE DOUBLE LINE SEE TYPICAL PAINTED MEDIAN MARKING.
GORE MARKING AND CHANNELIZING LINES	8 (200) WITH 12 (300) DIAGONALS @ 45°	SOLIO	WHITE	DIAGONALS: 15' (4.5 m) C-C (LESS THAN 30MPH (50 km/h)) 20' (6 m) C-C 30MPH (50 km/h) T0 45MPH (70 km/h)) 30' (9 m) C-C (0VER 45MPH (70 km/h))
RAILROAD CROSSING	24 (600) TRANSVERSE LINES; "RR" IS 6' (1,8 m) LETTERS; 16 (400) LINE FOR "X"	SOLID	WHITE	SEE STATE STANDARD 780001 AREA OF: "R"=3.6 SO. FT. (0.33 m²) EACH "X"=54.0 SO. FT. (5.0 m²)
SHOULDER DIAGONALS (REQUIRED FOR SHOULDERS > 8')	12 (300) e 45°	SOLID	WHITE - RIGHT YELLOW - LEFT	50' (15 m) C-C (LESS THAN 30MPH (50 km/h)) 75' (25 m) C-C (30 MPH (50 km/h) T0 45MPH (70 km/h) 150' (45 m) C-C (0VER 45MPH (70 km/h))
U TURN ARROW	SEE DETAIL	SOLID	WHITE	16.3 SF
2 ARROW COMBINATION LEFT AND U TURN	SEE DETAIL	SOLID	WHITE .	A9-46F

FOR FURTHER DETAILS ON PAVEMENT MARKING REFER TO STANDARD SPECIFICATIONS FOR ROAD AND BRIDGE CONSTRUCTION AND STATE STANDARD 780001.

FAP 332 All dimensions are in inches (millimeters) FAU 423

DISTRICT ONE STATE OF ILLINOIS 14-00018-00-SG WILL TYPICAL PAVEMENT MARKINGS **DEPARTMENT OF TRANSPORTATION** CONTRACT NO. 61056 TC-13 REVISED - C. JUCIUS 12-21-15 SHEET 1 OF 1 SHEETS STA. TO STA. . AID PROJECT TRS-4009(348)

PLOT DATE = 12/21/2015

DATE

03-19-90

