FOR INDEX OF SHEETS AND HIGHWAY STANDARDS SEE SHEET NO. 2

STATE OF ILLINOIS 04-22-2016 LETTING ITEM 009

DEPARTMENT OF TRANSPORTATION
DIVISION OF HIGHWAYS

PLANS FOR PROPOSED FEDERAL AID HIGHWAY

MUN 0062/0062A (DENNY ROAD)

FAP 520 (BLISS ROAD) TO EAST VILLAGE LIMITS

RESURFACING

SECTION: 14-00029-00-RS


PROJECT NUMBER: M-4003(657)

VILLAGE OF SUGAR GROVE

KANE COUNTY

C-91-194-16


DESIGN DESIGNATION
DENNY ROAD
MAJOR COLLECTOR
DESIGN SPEED = 45 M.P.H.
POSTED SPEED = 45 M.P.H.
ADT (2014) = 1.500 VPD

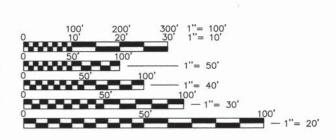

FULL SIZE PLANS HAVE BEEN PREPARED USING STANDARD ENGINEERING SCALES, REDUCED SIZED PLANS WILL NOT CONFORM TO STANDARD SCALES, IN MAKING MEASUREMENTS ON REDUCED PLANS, THE ABOVE SCALES MAY BE USED.



CONTRACT NO. 61C62

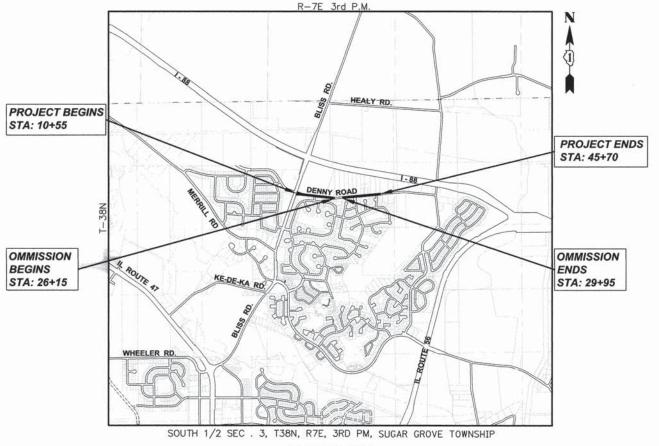

LOCATION MAP

GROSS LENGTH OF PROJECT = 3,515 FEET (0.666 MILES) NET LENGTH OF PROJECT = 3,135 FEET (0.594 MILES) Engineering Enterprises, Inc.
Consulting Engineers

52 Wheeler Road Sugar Grove, Illinois 60554 630.466.6700 / www.eeiweb.com




SECTION

KANE

CONTRACT NO. 61C62

17

0062 14-00029-00-RS

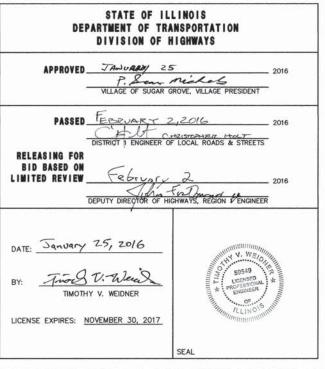

PRINTED BY THE AUTHORITY OF THE STATE OF ILLINOIS

NO SUBSTITUTIONS OR VARIANCES WILL BE PERMITTED TO ANY STANDARD NOTES OR ORDINANCES UNLESS APPROVED OTHERWISE IN WRITING PRIOR TO COMMENCING

ALL TRAFFIC CONTROL AND OTHER ADVISORY SIGNS NEEDED FOR CONSTRUCTION ARE TO BE FURNISHED BY THE CONTRACTOR IN ACCORDANCE WITH ARTICLE 107.14 OF THE

THE CONTRACTOR SHALL AT ALL TIMES PROVIDE PROTECTION FOR TRAFFIC AS CALLED FOR IN THE APPLICATION OF TRAFFIC CONTROL DEVICES, THE STANDARD SPECIFICATIONS. THE SPECIAL PROVISIONS AND THE PLANS

THE CONTRACTOR SHALL BE RESPONSIBLE FOR CONTACTING THE OWNERS OF ALL UTILITIES PRIOR TO CONSTRUCTION TO DETERMINE THE LOCATION OF ALL EXISTING AND PROPOSED UTILITY EQUIPMENT. THE CONTRACTOR SHALL COOPERATE WITH ALL UTILITY OWNERS AS PROVIDED FOR IN THE STANDARD SPECIFICATIONS IF UTILITY RELOCATION,

THE LOCATION OF EXISTING DRAINAGE STRUCTURES, STORM SEWERS, WATER MAINS, SANITARY SEWERS, FIELD TILES AND ANY OTHER PUBLIC OR PRIVATE UTILITIES AS SHOWN ON THE PLANS IS APPROXIMATE AND NOT NECESSARILY COMPLETE; THEIR EXACT LOCATION IS TO BE DETERMINED IN THE FIELD BY THE CONTRACTOR. THIS WORK SHALL BE CONSIDERED INCLUDED IN THE COST OF GRADING AND SHAPING

THE CONTRACTOR SHALL BE RESPONSIBLE FOR THE PROTECTION OF ALL UNDERGROUND AND SURFACE UTILITIES EVEN THOUGH THEY MAY NOT BE SHOWN ON THE PLANS. ANY UTILITY THAT IS DAMAGED DURING CONSTRUCTION SHALL BE RESTORED TO A CONDITION EQUAL TO THAT EXISTING BEFORE THE DAMAGE OCCURRED. THIS WORK SHALL BE ARRANGED BY THE UTILITY COMPANY AND SHALL BE AT THE CONTRACTOR'S

IF EXISTING UTILITY LINES OF ANY NATURE ARE ENCOUNTERED WHICH CONFLICT IN LOCATION WITH NEW CONSTRUCTION, THE CONTRACTOR SHALL NOTIFY THE ENGINEER SO THAT THE CONFLICT MAY BE RESOLVED.

UNDER NO CIRCUMSTANCES SHALL THE CONTRACTOR OPERATE ANY VALVES OR HYDRANTS.

THE CONTRACTOR SHALL PROTECT AND CAREFULLY PRESERVE ALL SECTION OR SUBSECTION MONUMENTS, PROPERTY CORNERS, AND REFERENCE MARKERS UNTIL THE OWNER, THE OWNER'S AGENT, OR AN AUTHORIZED SURVEYOR HAS WITNESSED OR OTHERWISE REFERENCED THEIR LOCATIONS.

ALL OFFSET LOCATIONS GIVEN ON THE DETAILED PLANS ARE FROM THE CENTERLINE AS SHOWN ON THE PLANS.

MISCELLANEOUS

SAWING OF REMOVAL ITEMS AS NOTED ON THE PLANS, SPECIFIED IN THE STANDARD SPECIFICATIONS, OR AS REQUIRED BY THE ENGINEER SHALL BE INCLUDED IN THE COST OF THE ITEM BEING REMOVED.

AT ALL MAINLINE SIDE ROAD AND DRIVEWAY BUTT JOINT LOCATIONS, THE EXISTING SURFACE SHALL BE CUT TO A MINIMUM THICKNESS OF TWO (2) INCHES AS INDICATED

THE THICKNESS OF ASPHALT MIXTURES SHOWN IN THE PLANS ARE NOMINAL. DEVIATIONS MAY OCCUR DUE TO IRREGULARITIES IN THE SURFACES OR BASES ON WHICH THE ASPHALT MIXTURES ARE TO BE PLACED.

THE CONTRACTOR SHALL BE REQUIRED TO MAKE ARRANGEMENTS FOR THE PROPER BRACING, SHORING AND OTHER REQUIRED PROTECTION OF ALL ROADWAYS, STRUCTURES, POLES, CABLES AND PIPE LINES, BEFORE CONSTRUCTION BEGINS. THE CONTRACTOR SHALL BE RESPONSIBLE FOR ANY DAMAGE TO THE STREETS OR ROADWAYS AND ASSOCIATED STRUCTURES AND SHALL MAKE REPAIRS AS NECESSARY TO THE SATISFACTION OF THE ENGINEER AT THEIR OWN EXPENSE. ANY SHEETING AND/OR SHORING USED FOR THIS IMPROVEMENT SHALL BE CONSIDERED INCLUDED IN THE COST OF GRADING AND SHAPING DITCHES.

THE CONTRACTOR SHALL PROTECT ALL EXISTING FACILITIES (E.G. CURB, DRIVEWAYS, PAVEMENT) THAT ARE NOT INDICATED TO BE REMOVED ON THE PLANS. ANY FACILITY THAT IS DAMAGED DURING CONSTRUCTION SHALL BE RESTORED TO A CONDITION EQUAL TO THAT EXISTING BEFORE THE DAMAGE OCCURRED AT THE CONTRACTOR'S EXPENSE.

IS THE CONTRACTOR'S RESPONSIBILITY TO ASCERTAIN EXISTING FIELD CONDITIONS BEFORE BIDDING ON THIS CONTRACT.

EXISTING PAVEMENT THICKNESSES SHOWN ON THE PLANS ARE APPROXIMATE, BASED ON AVAILABLE INFORMATION AT THE TIME OF DESIGN. ANY ADDITIONAL COSTS REQUIRED BY THE CONTRACTOR DUE TO THICKNESSES OTHER THAN THOSE SHOWN ON THE PLANS WILL BE INCLUDED IN THE COST OF THE CONTRACT

WHERE NEW WORK MEETS EXISTING FEATURES TO REMAIN. THE CONTRACTOR SHALL FIELD CHECK ALL DIMENSIONS AND ELEVATIONS BEFORE PROCEEDING WITH CONSTRUCTION. IMMEDIATELY NOTIFY THE ENGINEER OF ANY DISCREPANCIES.

THE CONTRACTOR WILL BE REQUIRED TO COMPLY WITH ALL STATE REGULATIONS REGARDING AIR, WATER AND NOISE POLLUTION. THE CONTRACTOR IS PROHIBITED FROM BURNING ANY MATERIAL WITHIN OR ADJACENT TO THE IMPROVEMENT.

ALL DISTURBED AREAS WITHIN THE PROJECT THAT ARE NOT OTHERWISE SURFACED SHALL BE CLEANED, LAYERED WITH TOPSOIL, AND SODDED AS SHOWN IN THE PLANS. LIMITS SHOWN ON THE PLANS ARE THE MAXIMUM PAY WIDTHS FOR PAYMENT PURPOSES. ADDITIONAL AREAS DAMAGED BY MACHINERY, CONSTRUCTION EQUIPMENT. CONTRACTOR NEGLIGENCE OR OVER-EXCAVATION SHALL BE RESTORED TO A CONDITION EQUAL TO THAT EXISTING BEFORE THE DAMAGE OCCURRED AT THE COST OF THE

THE CONTRACTOR SHALL DISPOSE OF AND REMOVE FROM THE SITE EACH DAY ALL CURB AND GUTTER, PAVEMENT AND ALL OTHER EXCAVATED MATERIAL NOT FOR SALVAGE. THE COST FOR HAULING AND TRUCKING TO DISPOSAL LOCATIONS WILL BE NCLUDED IN THE COST OF THE ITEM BEING REMOVED.

THE ENGINEER IS NOT RESPONSIBLE FOR THE CONSTRUCTION MEANS, METHODS, TECHNIQUES, SEQUENCES OR PROCEDURES, TIME OF PERFORMANCE, PROGRAMS OR FOR ANY SAFETY PRECAUTIONS USED BY THE CONTRACTOR. THE CONTRACTOR IS SOLELY RESPONSIBLE FOR EXECUTION OF THEIR WORK IN ACCORDANCE WITH THE CONTRACT

THE CONTRACTOR SHALL BE RESPONSIBLE FOR PROTECTING FRESH CONCRETE FROM DAMAGE AND VANDALISM. ANY DAMAGED OR VANDALIZED CONCRETE SHALL BE REMOVED AND REPLACED AT THE CONTRACTOR'S EXPENSE.

BACKFILL AREAS ADJACENT TO COMBINATION CONCRETE CURB AND GUTTER REMOVAL AND REPLACEMENT SHALL BE BACKFILLED WITH CLASS SI CONCRETE AND HAVE AN HMA OVERLAY AS SHOWN IN THE SPECIAL DETAIL. THE CLASS SI CONCRETE WILL BE CONSIDERED INCLUDED IN THE COST OF COMBINATION CONCRETE CURB AND GUTTER

PATCHING LOCATIONS SHALL BE MARKED IN THE FIELD BY THE ENGINEER.

TOPSOIL, SEEDING, FERTILIZER AND EROSION CONTROL BLANKET SHALL BE PLACED ADJACENT TO AGGREGATE SHOULDER AS DIRECTED BY THE ENGINEER. THE ENGINEER SHALL REVIEW THE SITE CONDITIONS WITH THE CONTRACTOR AFTER SHOULDER

ANY FARTH EXCAVATION REQUIRED TO CONSTRUCT NEW SIDEWALK OR ANY SPOILS FROM GRADING AND SHAPING DITCHES SHALL BE DISPOSED OF ON SITE ADJACENT TO SHOULDERS AND AS DIRECTED BY THE ENGINEER.

DENNY ROAD SHALL BE OPEN TO TRAFFIC AT ALL TIMES. WHEN IT IS NECESSARY TO CLOSE ONE LANE OF TRAFFIC DUE TO CONSTRUCTION, THE CONTRACTOR SHALL MAINTAIN TWO-WAY TRAFFIC DURING CONSTRUCTION HOURS WITH THE USE OF TRAFFIC CONTROL DEVICES, SIGNS AND FLAGGERS AS APPLICABLE IN THE TRAFFIC CONTROL

ANY AREAS ON DRIVEWAYS OUTSIDE THE LIMITS OF MAINLINE PAVING SHALL BE RESURFACED WITH INCIDENTAL HOT-MIX ASPHALT SURFACING PAY ITEM AS INDICATED

THE CONTRACTOR SHALL CONTACT THE IDOT TRAFFIC CONTROL SUPERVISOR AT (847) 705-4470 A MINIMUM OF 72 HOURS IN ADVANCE OF BEGINNING WORK.

IT IS THE RESPONSIBILITY OF THE CONTRACTOR TO CONTACT ANY RESIDENT OR BUSINESS OF ANY REMOVAL AND REPLACEMENT ACTIVITIES THAT WILL INHIBIT OR PROHIBIT ACCESS TO THEIR DRIVEWAY, IN WRITING, A MINIMUM OF 48 HOURS BUT NOT MORE THAN 72 HOURS, PRIOR TO THE COMMENCEMENT OF THESE ACTIVITIES. THE MORNING OF THE WORK, THE CONTRACTOR SHALL AGAIN NOTIFY THE OWNER VERBALLY, TO ALLOW THE OWNER TIME TO MOVE THEIR VEHICLE SO AS NOT TO PROHIBIT THE VEHICLE FROM LEAVING THE DRIVEWAY UPON REMOVAL OF ANY MATERIAL. THE NO GIVEN OUT BY THE CONTRACTOR SHALL PROVIDE INFORMATION REGARDING THE ANTICIPATED DATE THAT FULL ACCESS WILL BY RESTORED. COORDINATION BETWEEN ACTIVITIES SHOULD ALLOW ALL WORK TO BE DONE IN A TIMELY MANNER SO AS TO PERMIT ACCESS TO THE ROADWAY. ANY ADDITIONAL COST OF STAGING REQUIRED TO MAINTAIN ACCESS IS CONSIDERED INCLUDED IN THE COST OF INCIDENTAL HOT-MIX ASPHALT SURFACING.

INDEX OF SHEETS

SHEET NO. SHEET DESCRIPTION

- COVER SHEET AND LOCATION MAP
- GENERAL NOTES, HIGHWAY STANDARDS SUPPLEMENTAL LEGEND, AND INDEX OF SHEETS
- SUMMARY OF QUANTITIES
- 4.-5. TYPICAL SECTIONS
- 6.-9. GENERAL PLAN
- DETAILS

DISTRICT ONE DETAILS

- (TC-10) TRAFFIC CONTROL AND PROTECTION FOR SIDE ROADS, INTERSECTIONS, AND DRIVEWAYS
- (TC-11) TYPICAL APPLICATIONS RAISED REFLECTIVE PAVEMENT MARKERS (SNOW-PLOW RESISTANT)
- (TC-13) DISTRICT ONE TYPICAL PAVEMENT MARKINGS
- (TC-16) PAVEMENT MARKING LETTERS AND SYMBOLS FOR TRAFFIC STAGING
- (BD-22) PAVEMENT PATCHING FOR HMA SURFACED
- (BD-24) CURB OR CURB AND GUTTER REMOVAL AND REPLACEMENT
- 17. (BD-32) BUTT JOINT AND HMA TAPER DETAILS

HIGHWAY STANDARDS

DESCRIPTION STD. NO. STANDARD SYMBOLS, ABBREVIATIONS, 000001-06 AND PATTERNS PERPENDICULAR CURB RAMP FOR SIDEWALKS 442201-03 CLASS C AND D PATCHES 606001-06 CONCRETE CURB TYPE B AND COMBINATION CONBINATION CONCRETE OFF-ROAD OPERATIONS 2L, 2W, 15' (4.5m) TO 24" (600mm) 701006-05 FROM PAVEMENT EDGE 701011-04 OFF-RD MOVING OPERATIONS, 2L, 2W, DAY ONLY 701201-04 LANE CLOSURE, 2L, 2W, DAY ONLY, FOR SPEEDS ≥ 45 MPH LANE CLOSURE, 2L, 2W, SHORT TIME OPERATIONS 701301-04 LANE CLOSURE, 2L, 2W, SLOW MOVING OPERATIONS DAY ONLY, 701306-03 LANE CLOSURE, 2L, 2W MOVING OPERATIONS - DAY ONLY 701311-03 701336-06 LANE CLOSURE, 2L, 2W, WORK AREAS IN SERIES, FOR SPEEDS ≥ 45 MPH SIDEALK, CORNER OR CROSSWALK CLOSURE 701801-06 701901-05 TRAFFIC CONTROL DEVICES 780001-05 TYPICAL PAVEMENT MARKINGS

SUPPLEMENTAL LEGEND

SEE IDOT HIGHWAY STANDARDS FOR ADDITIONAL INFORMATION



HOT-MIX ASPHALT SURFACE REMOVAL - BUTT JOINT



HOT-MIX ASPHALT SURFACE REMOVAL - 1" AND VARIABLE



INCIDENTAL HOT-MIX ASPHALT SURFACING



INC.			
JSER NAME =	DESIGNED -	REVISED -	
	DRAWN -	REVISED -	
PLOT SCALE =	CHECKED -	REVISED -	
PLOT DATE =	DATE -	REVISED -	

STATE OF ILLINOIS **DEPARTMENT OF TRANSPORTATION**

GENERAL NOTES, HIGHWAY STANDARDS, SUPPLEMENTAL LEGEND AND INDEX OF SHEETS

N E.	SECTION	COUNTY	TOTAL	SHEET NO.
62	14-00029-00-RS	KANE	17	2
-		CONTRACT	NO. 6	61062

SCALE: N.T.S.

FED. ROAD DIST. NO. 1 ILLINOIS

SHEET NO. 1 OF 1 SHEETS STA.

-	CODE NUMBER	ITEM	UNIT	TOTAL QUANTITY ROADWAY 75% FEDERAL 25% LOCAL
_	20200100	EARTH EXCAVATION	CUYD	0005
Ι.	21400100	GRADING AND SHAPING DITCHES	FOOT	115
F			ACRE	0.6
t	25000210	SEEDING, CLASS 2A		54
	25000400	NITROGEN FERTILIZER NUTRIENT	POUND	
E	25000500	PHOSPHORUS FERTILIZER NUTRIENT	POUND	54
	25000600	POTASSIUM FERTILIZER NUTRIENT	POUND	54
H	25100630	EROSION CONTROL BLANKET	SQ YD	2,880
F	35101600	AGGREGATE BASE COURSE, TYPE B 4"	SQ YD	57
F	40600290	BITUMINOUS MATERIALS (TACK COAT)	POUND	6,750
F	40600400	MIXTURE FOR CRACKS, JOINTS, AND FLANGEWAYS	TON	2
F	40600827	POLYMERIZED LEVELING BINDER (MACHINE METHOD), IL-4.75, N50	TON	561
+	40600982	HOT-MIX ASPHALT SURFACE REMOVAL - BUTT JOINT	SQ YD	239
1	40603335	HOT-MIX ASPHALT SURFACE COURSE, MIX "D", N50	TON	1,122
t	40800029	BITUMINOUS MATERIALS (TACK COAT)	POUND	145
t	40800050	INCIDENTAL HOT-MIX ASPHALT SURFACING	TON	40
+	42400200	PORTLAND CEMENT CONCRETE SIDEWALK 5 INCH	SQ FT	500
F	42400800	DETECTABLE WARNINGS	SQ FT	40
F	44000153	HOT-MIX ASPHALT SURFACE REMOVAL, 1"	SQ YD	9,165
Ŧ	44000600	SIDEWALK REMOVAL	SQ FT	320
#	44201690	CLASS D PATCHES, TYPE I, 4 INCH	SQ YD	10
#				
\pm	44201692	CLASS D PATCHES, TYPE II, 4 INCH	SQ YD	30
\pm	44201694	CLASS D PATCHES, TYPE III, 4 INCH	SQ YD	60
+	44201696	CLASS D PATCHES, TYPE IV, 4 INCH	SQ YD	900
+	48102100	AGGREGATE WEDGE SHOULDER, TYPE B	TON	280
F	67100100	MOBILIZATION	LSUM	1
+	70100450	TRAFFIC CONTROL AND PROTECTION, STANDARD 701201	LSUM	1
+	70100460	TRAFFIC CONTROL AND PROTECTION, STANDARD 701306	LSUM	1
#	70100600	TRAFFIC CONTROL AND PROTECTION, STANDARD 701336	LSUM	1
+	70102640	TRAFFIC CONTROL AND PROTECTION, STANDARD 701801	LSUM	1
+	70106800	CHANGEABLE MESSAGE SIGN	CAL MO	2
+	70300100	SHORT TERM PAVEMENT MARKING	FOOT	930
+	70300150	SHORT TERM PAVEMENT MARKING REMOVAL	SQ FT	130
-	78000100	THERMOPLASTIC PAVEMENT MARKING - LETTERS AND SYMBOLS	SQ FT	64
	78000200	THERMOPLASTIC PAVEMENT MARKING - LINE 4"	FOOT	11,942
-	78000400	THERMOPLASTIC PAVEMENT MARKING - LINE 6"	FOOT	322
+	78000600	THERMOPLASTIC PAVEMENT MARKING - LINE 12"	FOOT	42
+	78000650	THERMOPLASTIC PAVEMENT MARKING - LINE 24"	FOOT	69
+	78100100	RAISED REFLECTIVE PAVEMENT MARKER	EACH	29
I				
+	78300200	RAISED REFLECTIVE PAVEMENT MARKER REMOVAL	EACH	29
+	X2110100	TOPSOIL FURNISH AND PLACE, SPECIAL	CUYD	320
1	74401150	HOT-MIX ASPHALT SURFACE REMOVAL, VARIABLE DEPTH	SQ YD	835
F	Z0004562	COMBINATION CONCRETE CURB AND GUTTER REMOVAL AND REPLACEMENT	FOOT	436

Δ INDICATES SPECIALTY ITEM
* SEE SPECIAL PROVISIONS


COPYRIGHT © 2016 ENGINEERING ENTERPRISES, INC.


Engineering Enterprises, Inc.	USER NAME =	DESIGNED -	REVISED -	
		DRAWN -	REVISED -	
	PLOT SCALE =	CHECKED -	REVISED -	
	630.466.6700 / www.eelweb.com	PLOT DATE =	DATE -	REVISED -

STATE OF ILLINOIS	
DEPARTMENT OF TRANSPORTATION	ı

SCALE: N.T.S.

CUMMADY)F 011	ANTITIES		MUN RTE.	SECTION	COUNTY	TOTAL	SHEET NO.
SUMMARY O	יטט זנ	ANIIIIES		0062	14-00029-00-RS	KANE	17	3
						CONTRAC	T NO. 6	51C62
SHEET NO. 1 OF 1 S	HEETS	STA.	TO STA.	FED. ROAD	DIST. NO. 1 ILLINOIS			

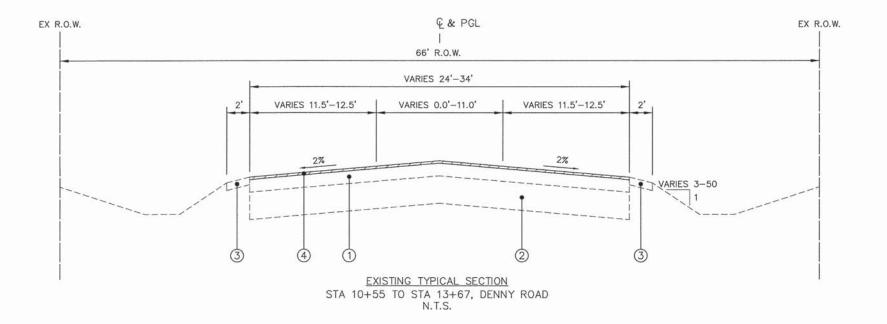

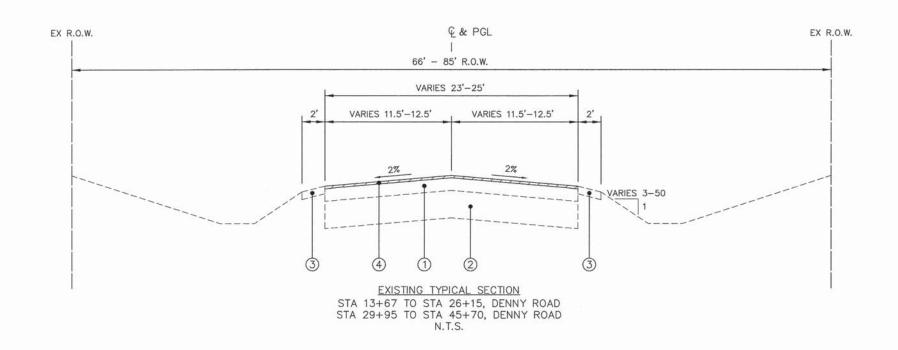

LEGEND

- 1) EXISTING 3" 9" ASPHALT PAVEMENT
- (2) EXISTING 10" 21" AGGREGATE BASE
- (3) EXISTING 2' AGGREGATE SHOULDER
- (4) HOT-MIX ASPHALT SURFACE REMOVAL, 1.0"
- (5) HOT-MIX ASPHALT SURFACE COURSE, MIX "D", N50, 2.0"
- 6 POLYMERIZED LEVELING BINDER (MACHINE METHOD), IL-4.75, N50, 1.0"
- (7) BITUMINOUS MATERIALS (TACK COAT)
- (8) AGGREGATE WEDGE SHOULDER, TYPE B
- 9 TOPSOIL, SEEDING CLASS 2A, FERTILIZER AND EROSION CONTROL BLANKET (LOCATIONS AS DIRECTED BY THE ENGINEER)

COPYRIGHT © 2016 ENGINEERING ENTERPRISES, INC.

Engineering Enterprises, Inc. consulting Engineers 52 Wheeler Road Sugar Grove, Illinois 60554 63,466.6702 / www.celireb.com

	USER NAME =	DESIGNED -	REVISED -	
C,		DRAWN -	REVISED -	
ı	PLOT SCALE =	CHECKED -	REVISED -	
	PLOT DATE =	DATE -	REVISED -	

STATE OF ILLINOIS DEPARTMENT OF TRANSPORTATION

TYPICAL SECTIONS


SCALE: N.T.S. | SHEET NO. 1 OF 2 SHEETS | STA. TO STA.


m Schmidt - Tab: 04 Typ Se

COUNTY TOTAL SHEET NO.

KANE 17 5

CONTRACT NO. 61C62

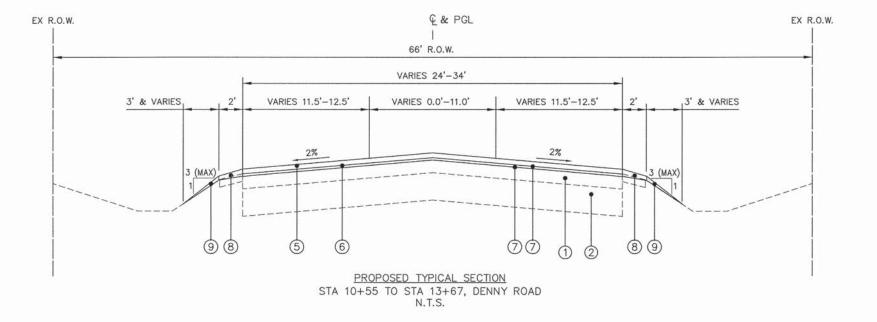

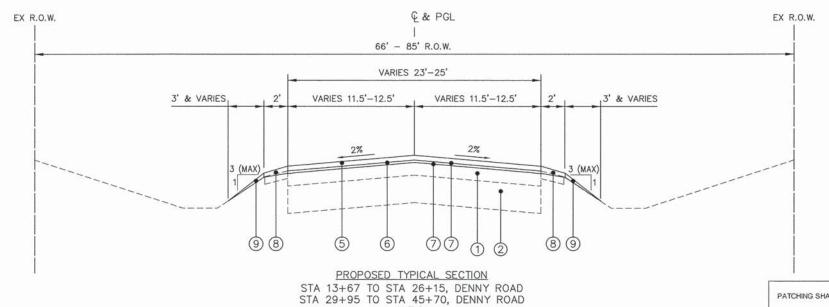

LEGEND

- (1) EXISTING 3" 9" ASPHALT PAVEMENT
- (2) EXISTING 10" 21" AGGREGATE BASE
- (3) EXISTING 2' AGGREGATE SHOULDER
- (4) HOT-MIX ASPHALT SURFACE REMOVAL, 1.0"
- (5) HOT-MIX ASPHALT SURFACE COURSE, MIX "D", N50, 2.0"
- 6) POLYMERIZED LEVELING BINDER (MACHINE METHOD), IL-4.75, N50, 1.0"
- (7) BITUMINOUS MATERIALS (TACK COAT)
- 8) AGGREGATE WEDGE SHOULDER, TYPE B
- 9 TOPSOIL, SEEDING CLASS 2A, FERTILIZER AND EROSION CONTROL BLANKET (LOCATIONS AS DIRECTED BY THE ENGINEER)

PATCHING SHALL BE PERFORMED AFTER MILLING

HOT-MIX ASPHALT MIXTURE REQUIREMENTS

OPERATION	MIXTURE TYPE	AIR VOIDS @ N _{des}
DENNY ROAD	POLYMERIZED LEVELING BINDER (MACHINE METHOD), IL-4.75, N50, 1"	3.5% @ 50 Gyr.
RESURFACING	HOT-MIX ASPHALT SURFACE COURSE, MIX "D", N50 (IL-9.5 mm), 2"	4% @ 50 Gyr.
DRIVEWAYS	INCIDENTAL HOT-MIX ASPHALT SURFACING HMA SURFACE COURSE, IL-9.5mm, MIX D, N50, 2"	4% @ 50 Gyr.
PATCHING	CLASS D PATCHES, 4 INCH HMA BINDER COURSE, IL-19.0, N70, 4" (IN 1 LIFT)	4% @ 70 Gyr.

THE UNIT WEIGHT USED TO CALCULATE ALL HMA SURFACE MIXTURE QUANTITIES IS 112 LBS/SQ YD/INCH.

THE "AC TYPE" FOR POLYMERIZED HMA MIXES SHALL BE "SBS/SBR PG 76-22" AND FOR NON-POLYMERIZED HMA THE "AC TYPE" SHALL BE "PG 64-22" UNLESS MODIFIED BY DISTRICT ONE SPECIAL PROVISIONS.

FOR HMA FULL DEPTH "AC TYPE" SEE SPECIAL PROVISIONS.

FOR USE OF RECYCLED MATERIALS SEE SPECIAL PROVISIONS.


Engineering Enterprise
consultring Engineers
52 Wheeler Rood
Sugar Crow, Illinois 60554
630,466,6700 / www.eeliveb.com


JSER NAME =	DESIGNED -	REVISED -	
	DRAWN -	REVISED -	
PLOT SCALE =	CHECKED -	REVISED -	
PLOT DATE =	DATE -	REVISED -	


STATE OF ILLINOIS DEPARTMENT OF TRANSPORTATION


SCALE: N.T.S.


	TVDIOAL	MUN RTE.	SECTION		
	TYPICAL SECTIONS				14-00029-00-RS
_	CUEET NO 2 OF 2 CL	EETS STA	TO STA	550 0040	ater up a la amorel

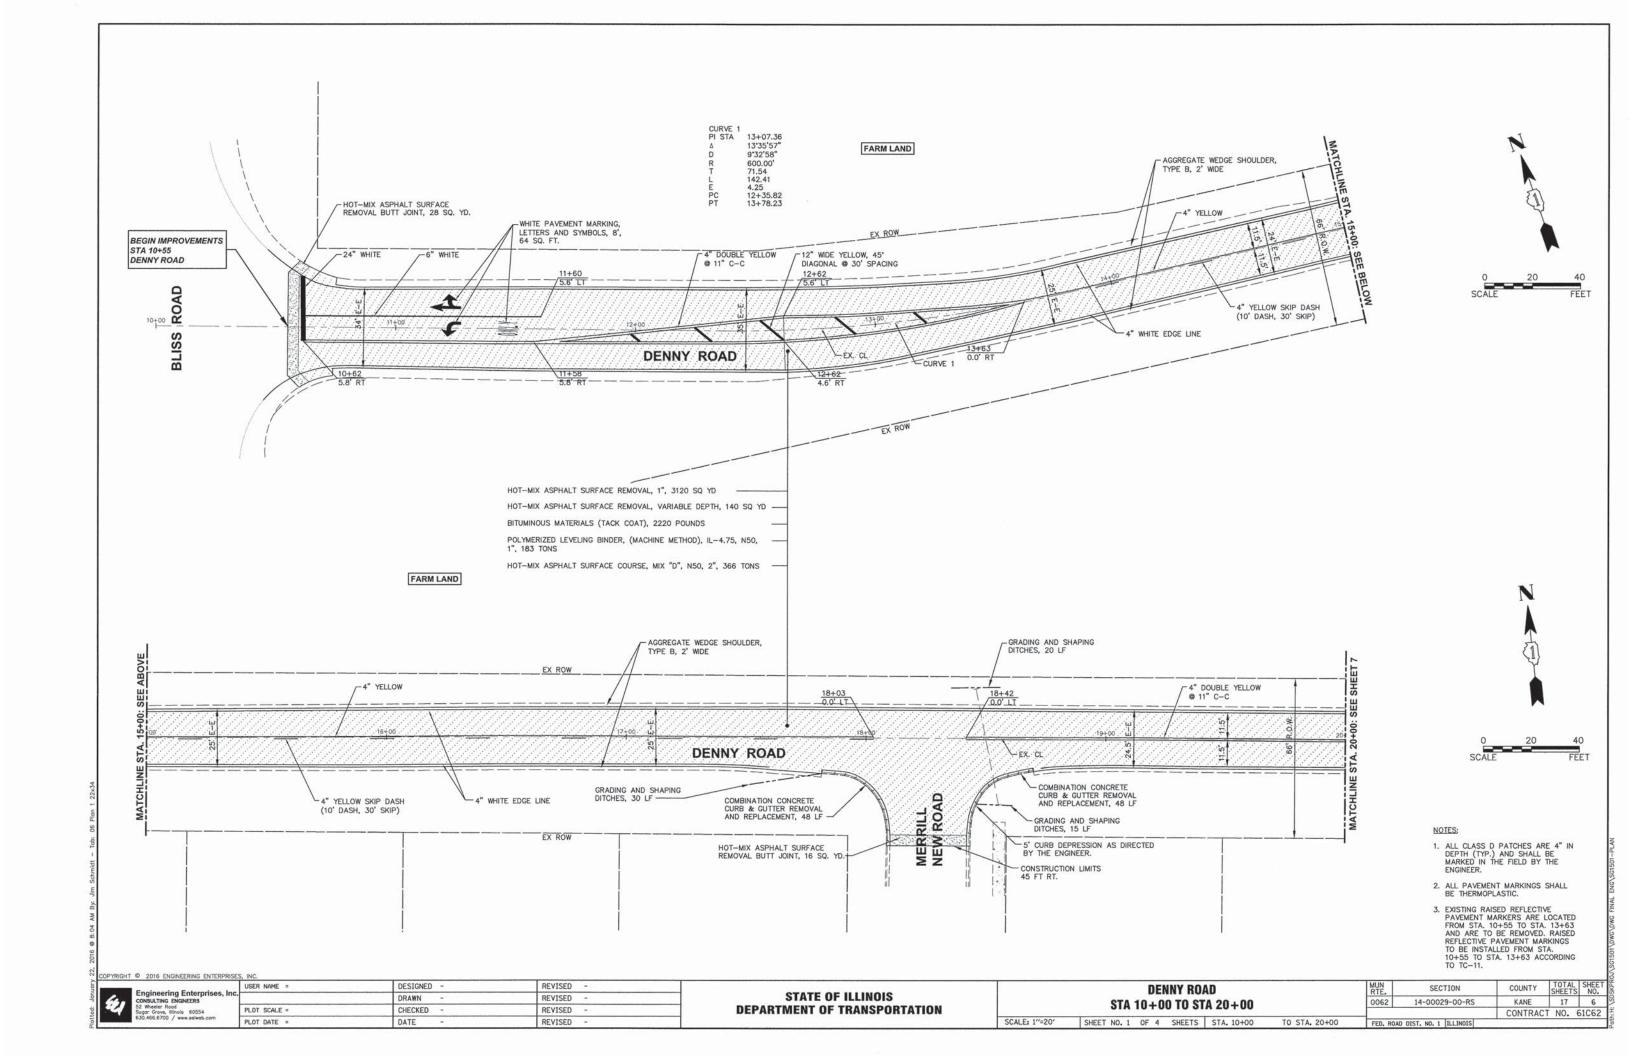


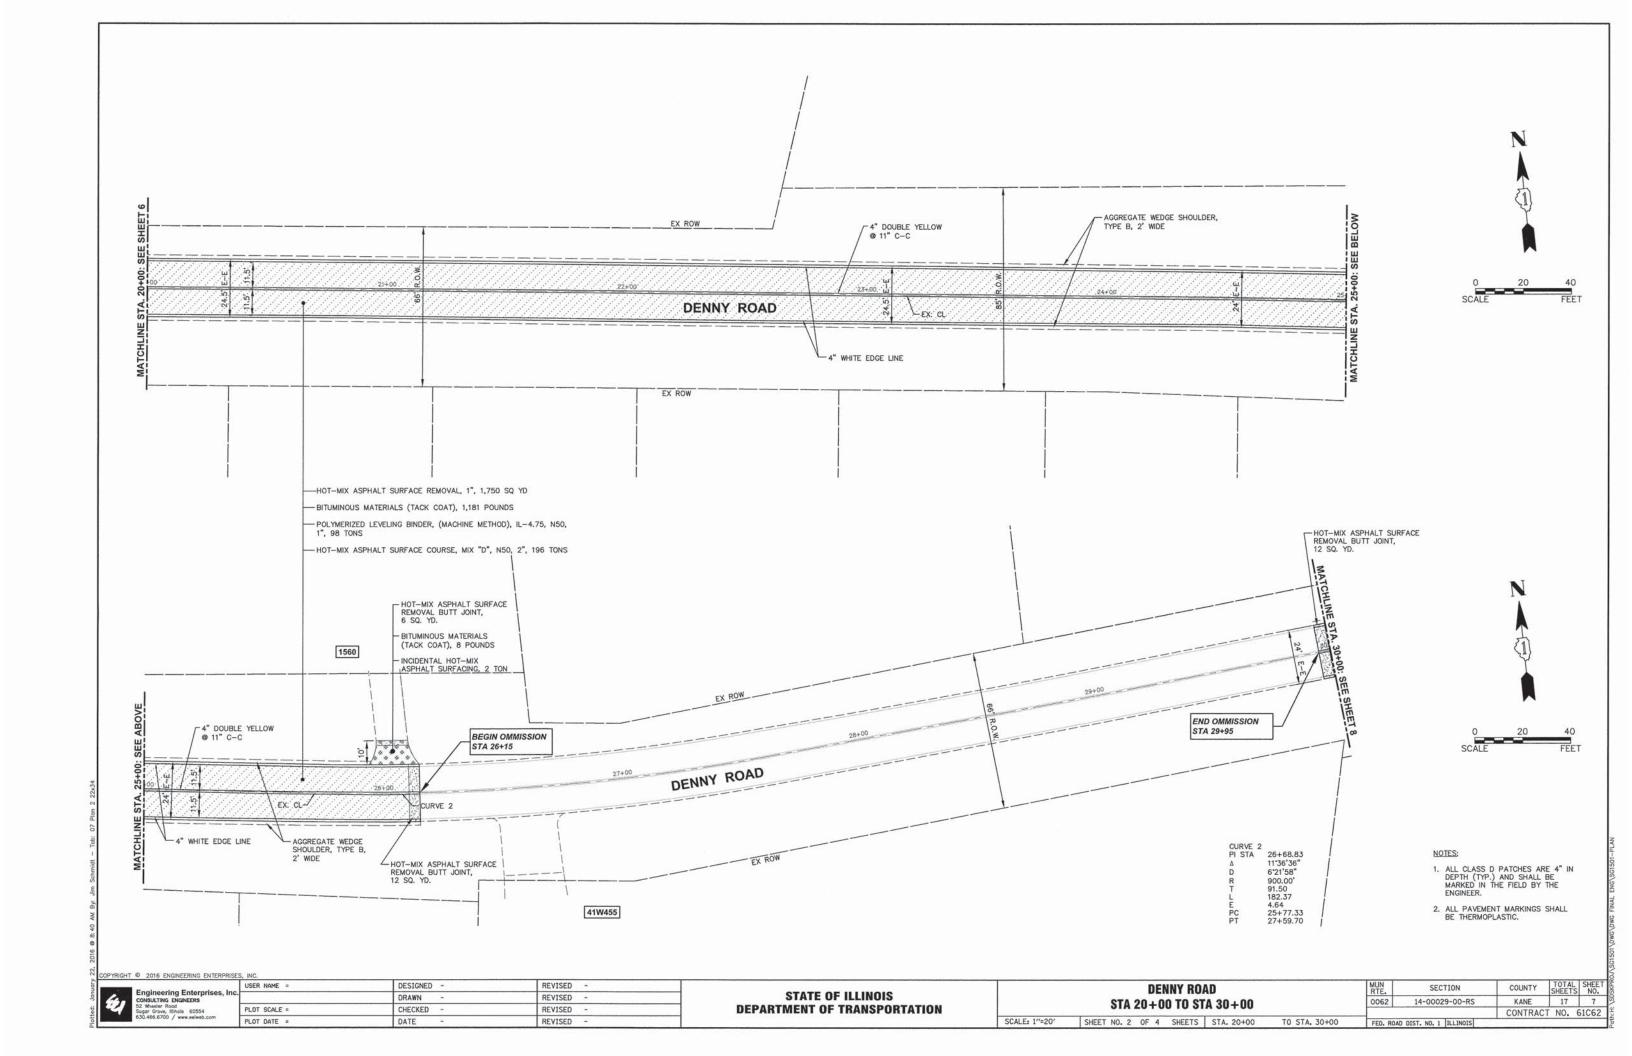

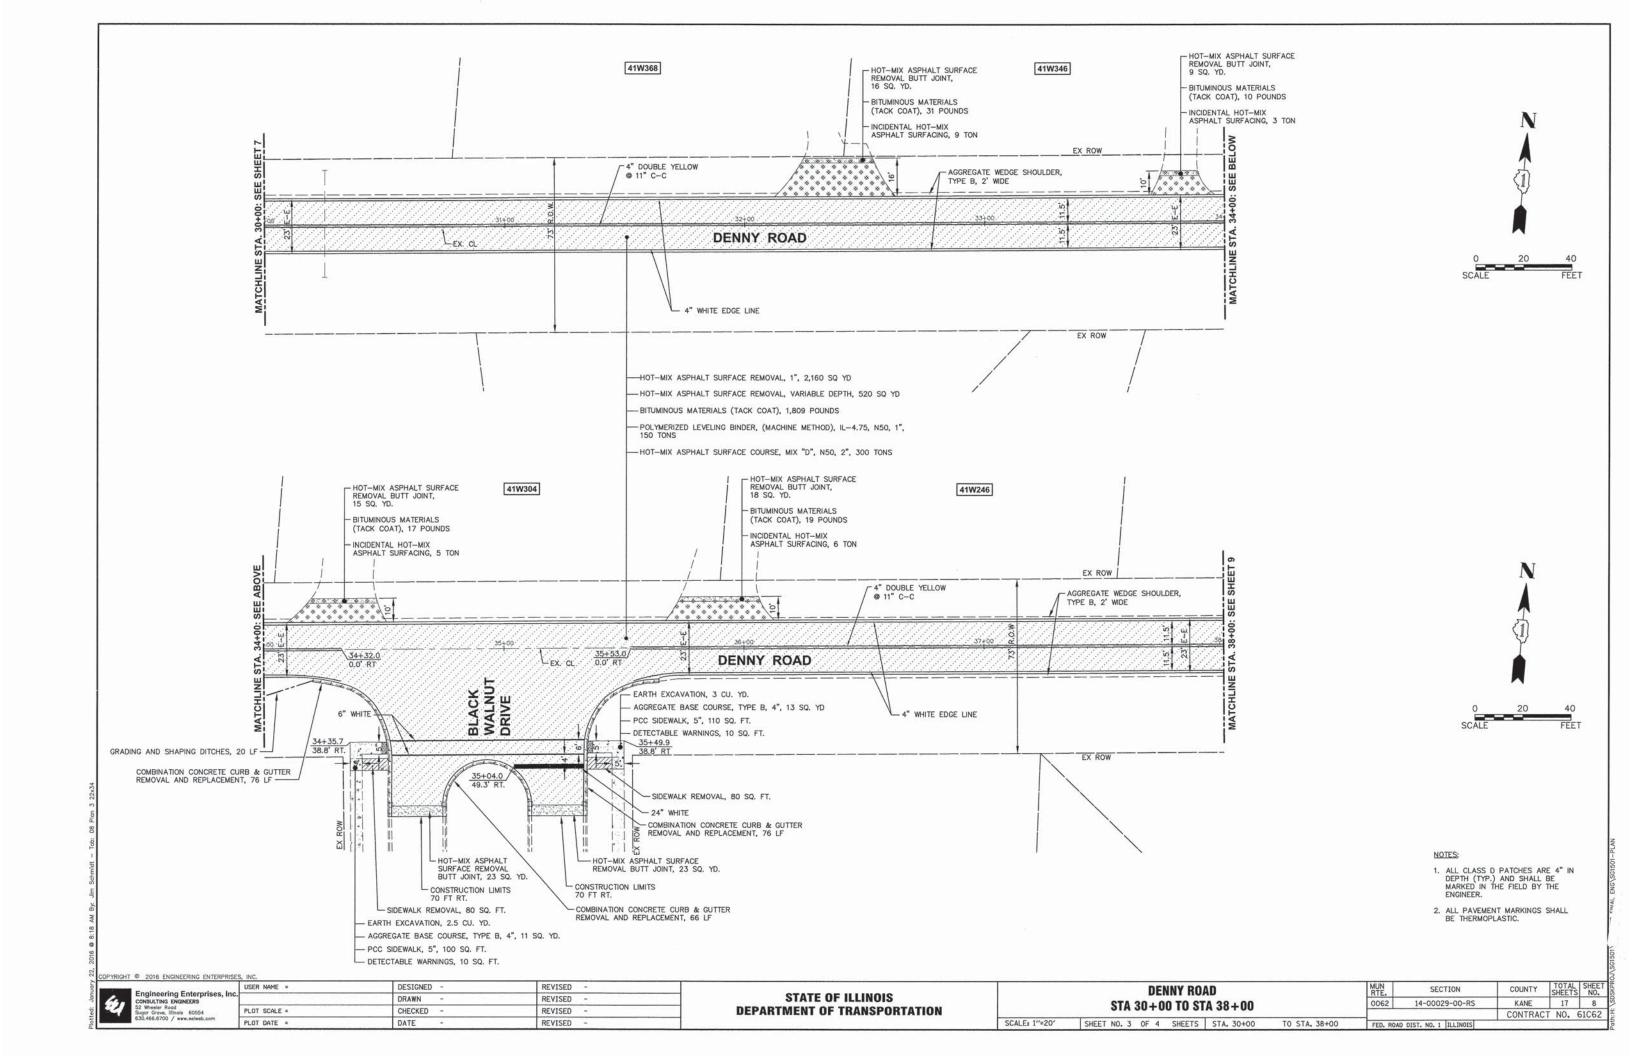

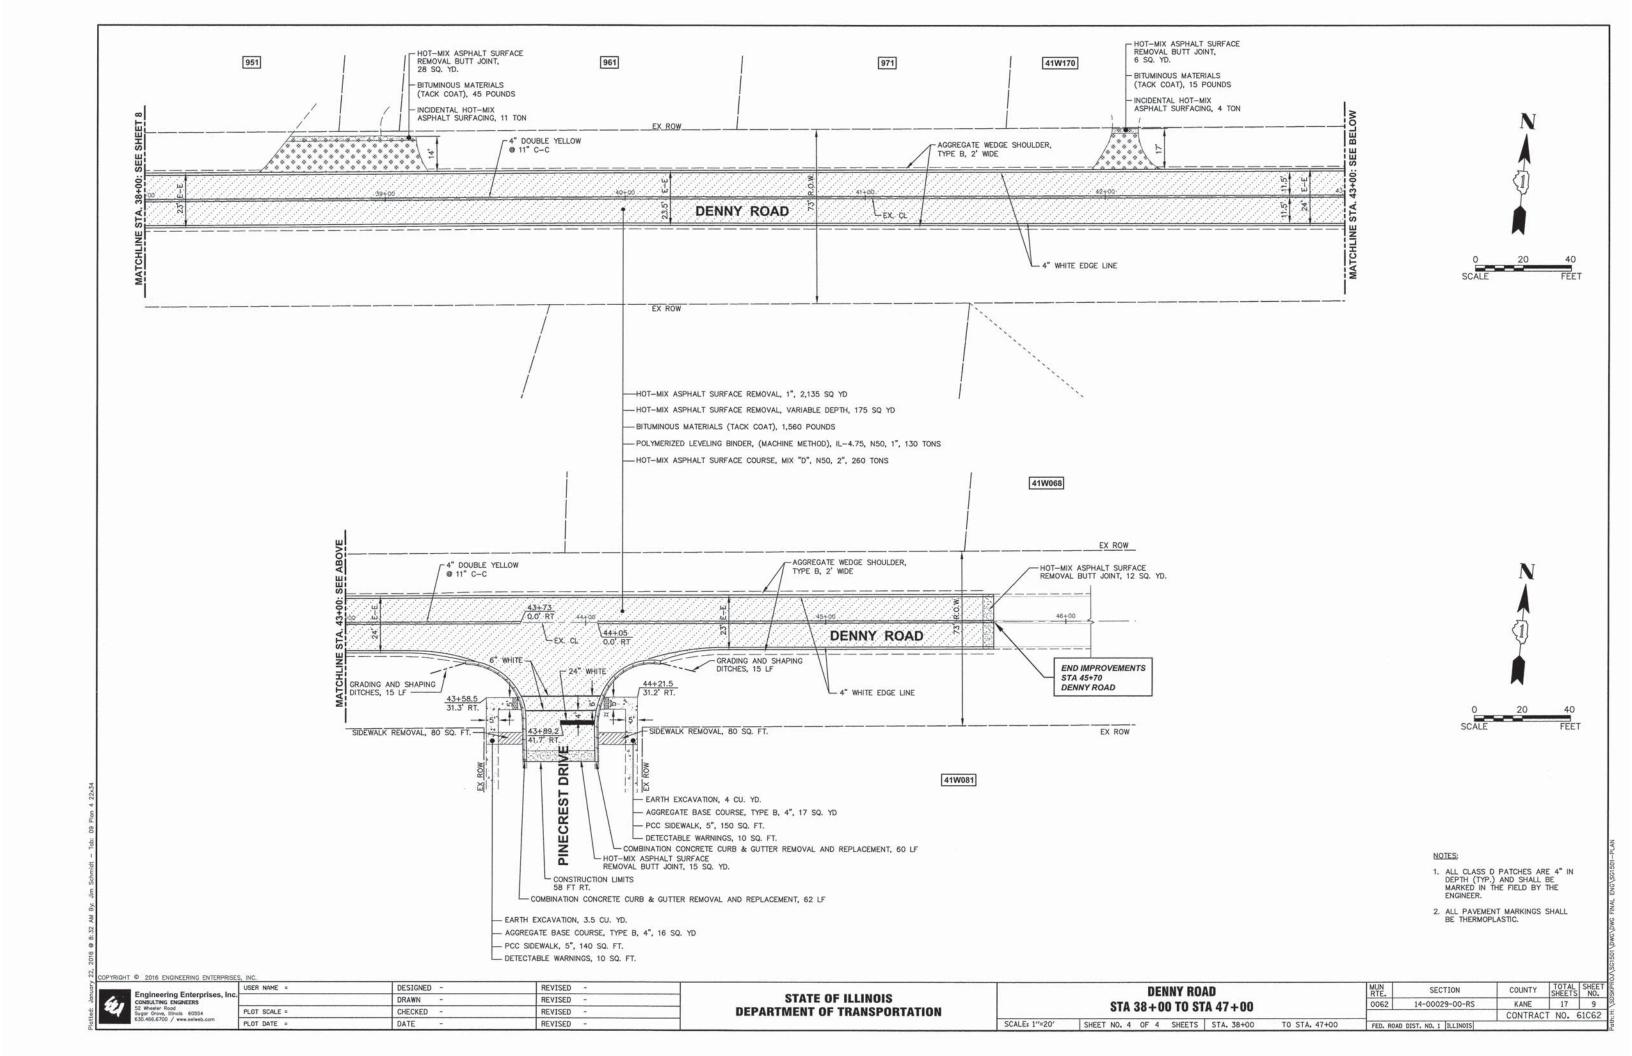

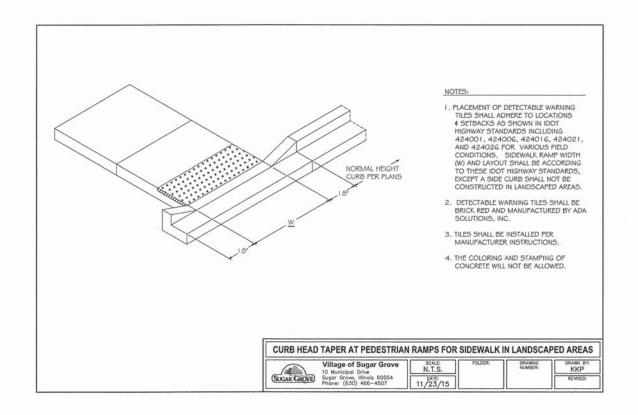

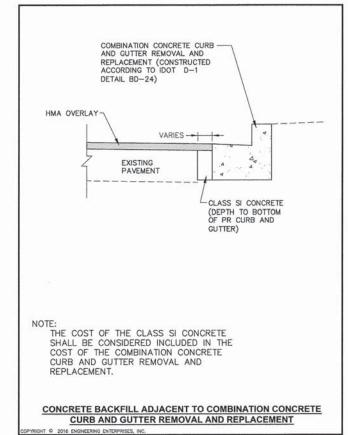


Engineering Enterprises, Inc CONSULTING ENGINEERS 52 Wheeler Rood Sugar Grove, Illinois 60554 630,466.6700 / www.eelweb.com

USER NAME = DESIGNED -REVISED -DRAWN REVISED PLOT SCALE = CHECKED -REVISED PLOT DATE = DATE REVISED -

STATE OF ILLINOIS **DEPARTMENT OF TRANSPORTATION**

COUNTY TOTAL SHEET NO.

KANE 17 10 SECTION DETAILS 0062 14-00029-00-RS CONTRACT NO. 61C62 SCALE: N.T.S. SHEET NO. 1 OF 1 SHEETS STA. TO STA. FED. ROAD DIST. NO. 1 ILLINOIS

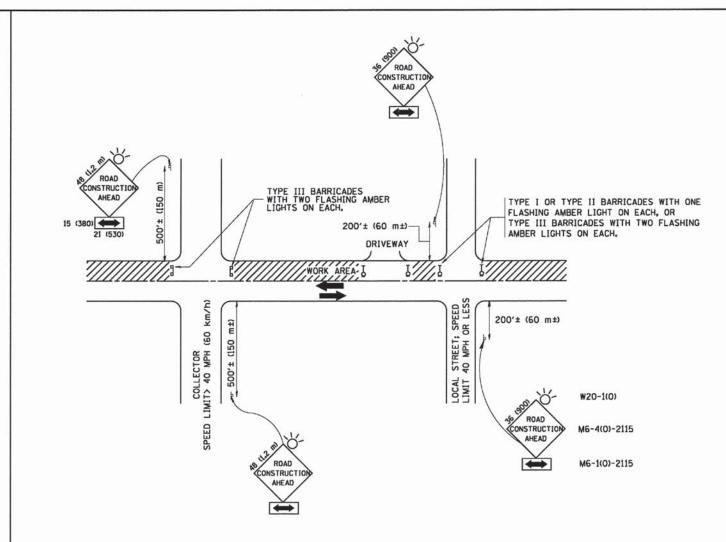

TRAFFIC CONTROL AND PROTECTION FOR SIDE ROADS, INTERSECTIONS, AND DRIVEWAYS

NOTES:

- A. FOR NO LANE RESTRICTION ON THE SIDE ROAD OR DRIVEWAYS
- 1. SIDE ROAD WITH A SPEED LIMIT OF 40 MPH (60 km/h) OR LESS AS SHOWN ON THE DRAWING AND AS DIRECTED BY THE ENGINEERS
- O) ONE ROAD CONSTRUCTION AHEAD SIGN 36 x 36 (900x900) WITH A FLASHER AND FLAG MOUNTED ON IT APPROXIMATELY 200' (60 m) IN ADVANCE
- b) THE CLOSED PORTION OF THE MAIN ROUTE SHALL BE PROTECTED BY BLOCKING WITH TYPE I, TYPE II OR TYPE III BARRICADES, 1/3 OF THE CROSS SECTION OF THE CLOSED PORTION.
- 2. SIDE ROAD WITH A SPEED LIMIT GREATER THAN 40 MPH (60 km/h) AS SHOWN ON THE DRAWING AND AS DIRECTED BY THE ENGINEERS
- O) ONE ROAD CONSTRUCTION AHEAD SIGN 48 x 48 (1.2 m x 1.2 m) WITH A FLASHER MOUNTED ON IT APPROXIMATELY 500' (150 m) IN ADVANCE OF THE MAIN ROUTE.
- b) THE CLOSED PORTION OF THE MAIN ROUTE SHALL BE PROTECTED BY BLOCKING WITH TYPE III BARRICADES, 1/2 OF THE CROSS SECTION OF THE CLOSED PORTION.
- 3. WHEN THE SIDE ROAD LIES BETWEEN THE BEGINNING OF THE MAINLINE SIGNING AND THE WORK ZONE, A SINGLE HEADED ARROW (MG-1) SHALL BE USED IN LIEU OF THE DOUBLE HEADED ARROW (MG-4).

SCALE: NONE

B. FOR A LANE CLOSURE ON A SIDE ROAD OR DRIVEWAY:

- USE APPLICABLE PORTIONS OF THE TYPICAL APPLICATION OF TRAFFIC CONTROL DEVICES (STD. 701501, STD. 701606 OR THE APPROPRIATE STANDARD). THE SPACING OF SIGNS AND BARRICADES SHALL BE ADJUSTED FOR FIELD CONDITIONS AS DIRECTED BY THE ENGINEER. THE DIRECTIONAL ARROW SHALL BE COVERED OR REMOVED WHEN NO LONGER CONSISTENT WITH THE SIDE ROAD LANE CLOSURE.
- C. ADVANCE WARNING SIGNS ARE TO BE OMITTED ON DRIVEWAY UNLESS OTHERWISE NOTED.

0062

D. THE TRAFFIC CONTROL AND PROTECTION FOR SIDE ROADS, INTERSECTIONS, AND DRIVEWAYS SHALL BE INCIDENTAL TO THE COST OF SPECIFIED TRAFFIC CONTROL STANDARDS OR ITEMS.


COPYRIGHT © 2016 ENGINEERING ENTERPRISES, FILE NAME = DESIGNED - LHA REVISED - J. OBERLE 10-18-95 USER NAME = gaglianobt W:\diststd\22x34\tc10.dgn DRAWN REVISED A. HOUSEH 03-06-96 PLOT SCALE = 50.000 '/ IN. CHECKED REVISED - A. HOUSEH 10-15-96 PLOT DATE = 1/4/2008 DATE 06-89 REVISED -T. RAMMACHER 01-06-00

STATE OF ILLINOIS **DEPARTMENT OF TRANSPORTATION**

TRAFFIC CONTROL AND PROTECTION FOR SIDE ROADS, INTERSECTIONS, AND DRIVEWAYS SHEET NO. 1 OF 1 SHEETS STA. TO STA.


All dimensions are in millimeters (inches) unless otherwise shown. TOTAL SHEET SHEETS NO. SECTION COUNTY KANE 14-00029-00-RS 17 TC-10 CONTRACT NO. 61062


FED. ROAD DIST. NO. 1 ILLINOIS FED. AID PROJECT - STP

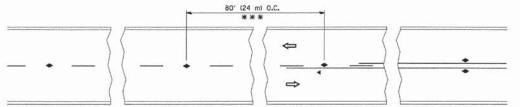


*** REDUCE TO 40' (12 m) O.C. ON CURVES WITH POSTED OR ADVISORY SPEED 45 M.P.H. (70 km/h) OR LESS.

TWO-LANE/TWO-WAY

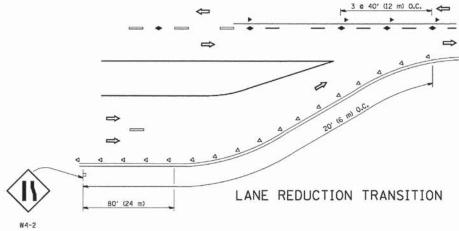


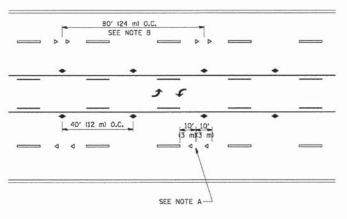

TWO-WAY LEFT TURN

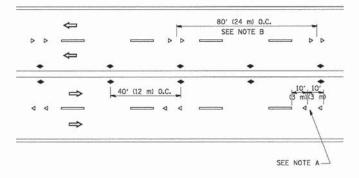

MULTI-LANE/UNDIVIDED

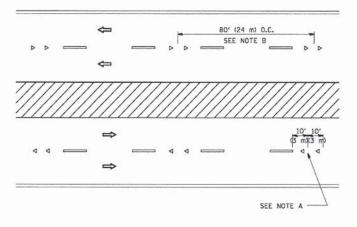

MULTI-LANE/DIVIDED

GENERAL NOTES

- MARKERS USED WITH DASHED LINES SHALL BE CENTERED IN THE GAP BETWEEN SEGMENTS.
- 2. MARKERS USED ADJACENT TO SOLID LINES SHALL BE OFFSET 2 TO 3 (50 TO 75) TOWARD TRAFFIC AS SHOWN.
- MARKERS THROUGH TANGENTS LESS THAN 500' (150 m) IN LENGTH BETWEEN CURVES SHALL BE INSTALLED AT THE LESSER OF THE TWO CURVE SPACINGS.

LANE MARKER NOTES

- A. USE DOUBLE LANE LINE MARKERS SPACED AS SHOWN.
- B. REDUCE TO 40' (12 m) O.C. ON CURVES WHERE ADVISORY SPEEDS ARE 10 M.P.H (20 km/h) LOWER THAN POSTED SPEEDS.

SYMBOLS

- YELLOW STRIPE
- WHITE STRIPE
- ONE-WAY AMBER MARKER
- ONE-WAY CRYSTAL MARKER (₩/O)
- ◆ TWO-WAY AMBER MARKER

DESIGN NOTES


- 1. DOUBLE LANE LINE MARKERS SHALL BE USED UNLESS SPECIFIED OTHERWISE.
- EXCEPT AS SHOWN ON THE LANE REDUCTION TRANSITION AND FREEWAY EXIT RAMP DETAIL, MARKERS ARE NOT TO BE SPECIFIED ON RIGHT EDGE LINES.
- 3. THE EXACT MARKER LIMITS, SPACING, AND COLOR SHALL BE INCLUDED IN THE PLANS WHEN STANDARD SPECIFICATIONS ARE NOT BEING USED.
- MARKERS SHOULD NOT BE USED ALONGSIDE CURBS EXCEPT FOR EXTREMELY SHORT SECTIONS OF CURBS WHERE NOT MORE THAN TWO MARKERS WOULD BE INVOLVED.


3 e 80' (24 m) 0.C. MINIMUM OF 3 W EQUALLY SPACED 40' (12 m) O.C. 40' (12 m) O.C. ** SEE TWO-LANE/TWO-WAY WHERE MARKERS CONTINUE ** WHERE THE MEDIAN WIDTH IS 6' (2 m) OR LESS USE TWO-WAY MARKERS.


LEFT TURN

All dimensions are in inches (millimeters) unless otherwise shown.

COPYRIGHT © 2016 ENGINEERING ENTERPRISE	S, INC.					unless otherwise shown.	
FILE NAME =	USER NAME = leyso	DESIGNED -	REVISED -T. RAMMACHER 09-19-94		TYPICAL APPLICATIONS	MUN SECTION	COUNTY TOTAL SHEET
5 c:\pw_work\pwidot\leysa\d0106315\tcl1.dgn		DRAWN -	REVISED -T. RAMMACHER 03-12-99	STATE OF ILLINOIS		0062 14-00029-00-RS	KANE 17 12
ÿ	PLOT SCALE = 50.000 '/ IN.	CHECKED -	REVISED -T. RAMMACHER 01-06-00	DEPARTMENT OF TRANSPORTATION	RAISED REFLECTIVE PAVEMENT MARKERS (SNOW-PLOW RESISTANT)	TC-11	CONTRACT NO. 61C62
Hold	PLOT DATE = 3/2/2011	DATE -	REVISED - C. JUCIUS 09-09-09	######################################	SCALE: NONE SHEET NO. 1 OF 1 SHEETS STA. TO STA.	FED. ROAD DIST. NO. 1 ILLINOIS FED.	AID PROJECT - STP

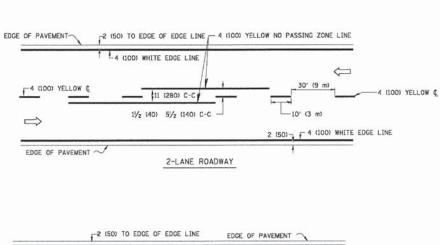


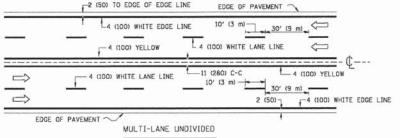

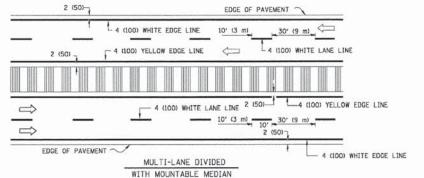


NOTE: MEDIANS WITH BARRIER CURB DO NOT REQUIRE AN EDGE LINE


TYPICAL LANE AND EDGE LINE MARKING

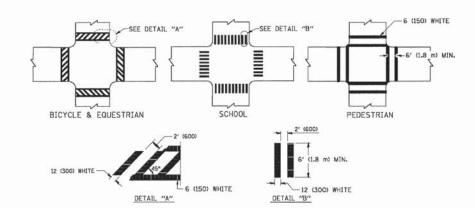

TYPICAL CROSSWALK MARKING

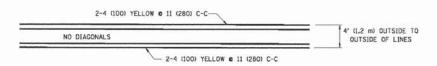


4' (1.2 m) WIDE MEDIANS ONLY

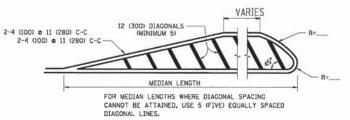


DIAGONAL LINE SPACING: 50' (15 m) C-C (LESS THAN 30MPH (50 km/h))
75' (25 m) C-C (30MPH (50 km/h)) 70 45MPH (70 km/h))
150' (45 m) C-C (MORE THAN 45MPH (70 km/h))

MEDIANS OVER 4' (1.2 m) WIDE

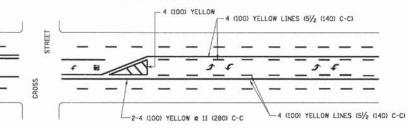


A MINIMUM OF TWO PAIRS OF TURN ARROWS SHALL BE USED, WHITE IN COLOR, ADDITIONAL PAIRS SHALL BE PLACED AT 200' (60 m) TO 300' (90 m) INTERVALS.

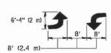

MEDIAN WITH TWO-WAY LEFT TURN LANE

TYPICAL PAINTED MEDIAN MARKING

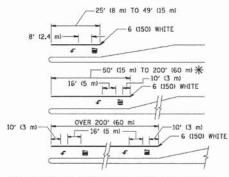


FULL SIZE LETTERS 8' (2.4 m) AND ARROWS SHALL BE USED. \P AREA = 15.6 SO. FT. (1.5 m²) \P AREA = 20.8 SO. FT. (1.9 m²)

* TURN LANES IN EXCESS OF 400' (120 m) IN LENGTH MAY HAVE AN ADDITIONAL SET OF ARROW - "ONLY" INSTALLED MIDWAY BETWEEN THE OTHER TWO SETS OF ARROW - "ONLY".

TYPICAL LEFT (OR RIGHT) TURN LANE

TYPICAL TURN LANE MARKING

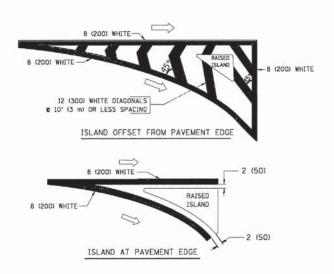

TYPICAL ISLAND MARKING

TYPE OF MARKING	WIDTH OF LINE	PATTERN	COLOR	SPACING / REMARKS
CENTERLINE ON 2 LANE PAVEMENT	4 (100)	SKIP-DASH	YELLOW	10' (3 m) LINE WITH 30' (9 m) SPACE
CENTERLINE ON MULTI-LANE UNDIVIDED PAVEMENT	2 2 4 (100)	SOLID	YELLOW	11 (280) C-C
NO PASSING ZONE LINES: FOR ONE DIRECTION FOR BOTH DIRECTIONS	4 (100) 2 p 4 (100)	SOLID SOLID	YELLOW YELLOW	5½ (140) C-C FROM SKIP-DASH CENTERLINE 11 (280) C-C OMIT SKIP-DASH CENTERLINE BETWEEN
LANE LINES	4 (100) 5 (125) ON FREEWAYS	SKIP-DASH SKIP-DASH	WHITE WHITE	10' (3 m) LINE WITH 30' (9 m) SPACE
DOTTED LINES (EXTENSIONS OF CENTER, LANE OR TURN LANE MARKINGS)	SAME AS LINE BEING EXTENDED	SKIP-DASH	SAME AS LINE BEING EXTENDED	2' (600) LINE WITH 6' (1.8 m) SPACE
EDGE LINES	4 (100)	SOLID	YELLOW-LEFT WHITE-RIGHT	OUTLINE MOUNTABLE MEDIANS IN YELLOW: EDGE LINES ARE NOT USED NEXT TO BARRIER CURB
TURN LANE MARKINGS	6 (150) LINE; FULL SIZE LETTERS & SYMBOLS (8' (2.4m))	SOLID	WHITE	SEE TYPICAL TURN LANE MARKING DETAIL
TWO WAY LEFT TURN MARKING	2 m 4 (100) EACH DIRECTION	SKIP-DASH AND SOLID	YELLOW	10' (3 m) LINE WITH 30' (9 m) SPACE FOR SKIP-DASH; 5½ (140) C-C BETWEEN SOLID LINE AND SKIP-DASH LINE
	8' (2.4m) LEFT ARROW	IN PAIRS	WHITE	SEE TYPICAL TWO-WAY LEFT TURN MARKING DETAIL
CROSSWALK LINES (PEDESTRIAN) A. DIAGONALS (BIKE & EQUESTRIAN) B. LONGITUDINAL BARS (SCHOOL)	2 c 6 (150) 12 (300) c 45° 12 (300) c 90°	SOLID SOLID SOLID	WHITE WHITE WHITE	NOT LESS THAN 6' (1.8 m) APART 2' (600) APART 2' (600) APART SEE TYPICAL CROSSWALK MARKING DETAILS.
STOP LINES	24 (600)	SOLIO	WHITE	PLACE 4' (1.2 m) IN ADVANCE OF AND PARALLEL TO CROSSMALK, IF PRESENT. OTHERWISE, PLACE AT DESIRED STOPPING POINT. PARALLEL TO CROSSROAD CENTERLINE, WHERE POSSIBLE
PAINTED MEDIANS	2 m 4 (100) WITH 12 (300) DIAGONALS 0 45° NO DIAGONALS USED FOR 4' (1.2 m) WIDE MEDIANS	SOLIO	YELLOW: TWO WAY TRAFFIC WHITE: ONE WAY TRAFFIC	11 (280) C-C FOR THE DOUBLE LINE SEE TYPICAL PAINTED MEDIAN MARKING.
GORE MARKING AND CHANNELIZING LINES	8 (200) WITH 12 (300) DIAGONALS @ 45°	SOLID	WHITE	DIAGONALS: 15' (4.5 m) C-C (LESS THAN 30MPH (50 km/h)) 20' (6 m) C-C 30MPH (50 km/h) TO 45MPH (70 km/h)) 30' (9 m) C-C (OVER 45MPH (70 km/h))
RAILROAD CROSSING	24 (600) TRANSVERSE LINES; "RR" IS 6' (1.8 m) LETTERS; 16 (400) LINE FOR "X"	SOLID	WHITE	SEE STATE STANDARD 780001 AREA OF: "?""-3.6 SO. FT. (0.33 m²) EACH "X"=54,0 SO. FT. (5.0 m²)
SHOULDER DIAGONALS	12 (300) e 45°	SOLID	WHITE - RIGHT YELLOW - LEFT	50' (15 m) C-C (LESS THAN 30MPH (50 km/h)) 75' (25 m) C-C (30 MPH (50 km/h) TO 45MPH (70 km/h) 150' (45 m) C-C (0VER 45MPH (70 km/h))

FOR FURTHER DETAILS ON PAVEMENT MARKING REFER TO STANDARD SPECIFICATIONS FOR ROAD AND BRIDGE CONSTRUCTION AND STATE STANDARD 780001.

SCALE:


All dimensions are in inches (millimeters) unless otherwise shown.


YRIGHT © 2016 ENGINEERING ENTERPRISES INC

COPYRIGHT © 2016 ENGINEERING	ENTERPRISES, INC.		
FILE NAME =	USER NAME = drzvakosgn	DESIGNED - EVERS	REVISED -T. RAMMACHER 10-27-94
c:\pw_work\pwidot\drivakosgn\d0108315\tc\3.dgn		DRAWN -	REVISED -C. JUCIUS 09-09-09
100 100	PLOT SCALE = 50.000 '/ IN.	CHECKED -	REVISED -
	PLOT DATE = 9/9/2009	DATE - 03-19-90	REVISED -


STATE OF ILLINOIS
DEPARTMENT OF TRANSPORTATION

DISTRICT ONE TYPICAL PAVEMENT MARKINGS			MUN RTE.	SECTION	COUNTY	TOTAL	SHEET NO.			
			0062	14-00029-00-RS	KANE	17				
			TC-13		CONTRACT	NO.	61C62			
NONE	SHEET NO. 1 C	DF 1	SHEETS	STA.	TO STA.	FED. ROAD DIST. NO. 1 ILLINOIS FED. AID PROJECT - STP				

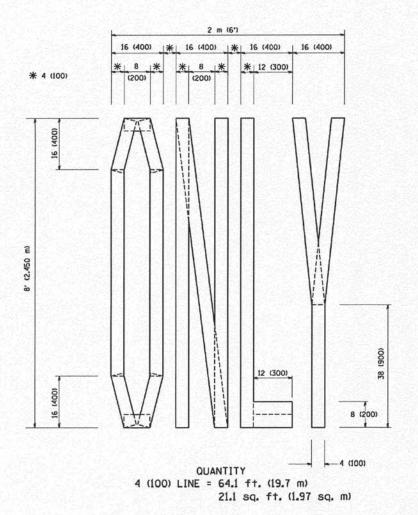

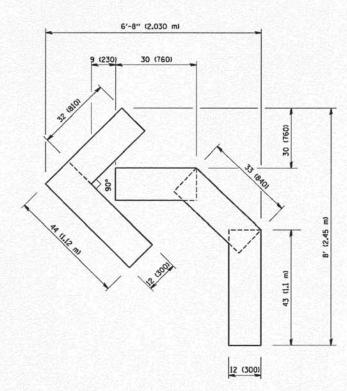

OUANTITY 4 (100) LINE = 45.5 ft. (13.9 m) 15.2 sq. ft. (1.39 sq. m)

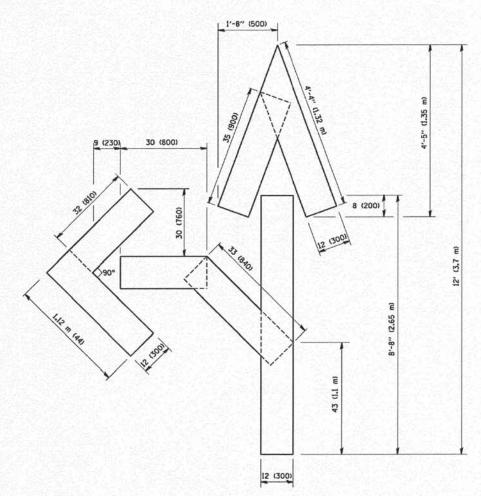


OUANTITY 4 (100) LINE = 82.5 ft. (25.3 m) 27.5 sq. ft. (2.53 sq. m)

All dimensions are in inches (millimeters) unless otherwise shown.

COPYRIGHT @ 2016 ENGINEERING ENTERPRISES, INC COUNTY SHEETS NO.

KANE 17 14 DESIGNED -REVISED -T. RAMMACHER 06-05-96 JSER NAME = gaglianobt SECTION PAVEMENT MARKING LETTERS AND SYMBOLS STATE OF ILLINOIS REVISED -T. RAMMACHER 11-04-97 DRAWN Wr\diststd\22x34\to16.dgn 14-00029-00-RS 0062 FOR TRAFFIC STAGING TC-16 CONTRACT NO. 61C62
FED. ROAD DIST. NO. 1 | ILLINOIS FED. AID PROJECT - STP PLOT SCALE = 50.0000 '/ IN. CHECKED REVISED -T. RAMMACHER 03-02-98 **DEPARTMENT OF TRANSPORTATION** PLOT DATE = 1/4/2008 DATE - 09-18-94 REVISED -E. GOMEZ 08-28-00 SCALE: NONE SHEET NO. 1 OF 1 SHEETS STA. TO STA.

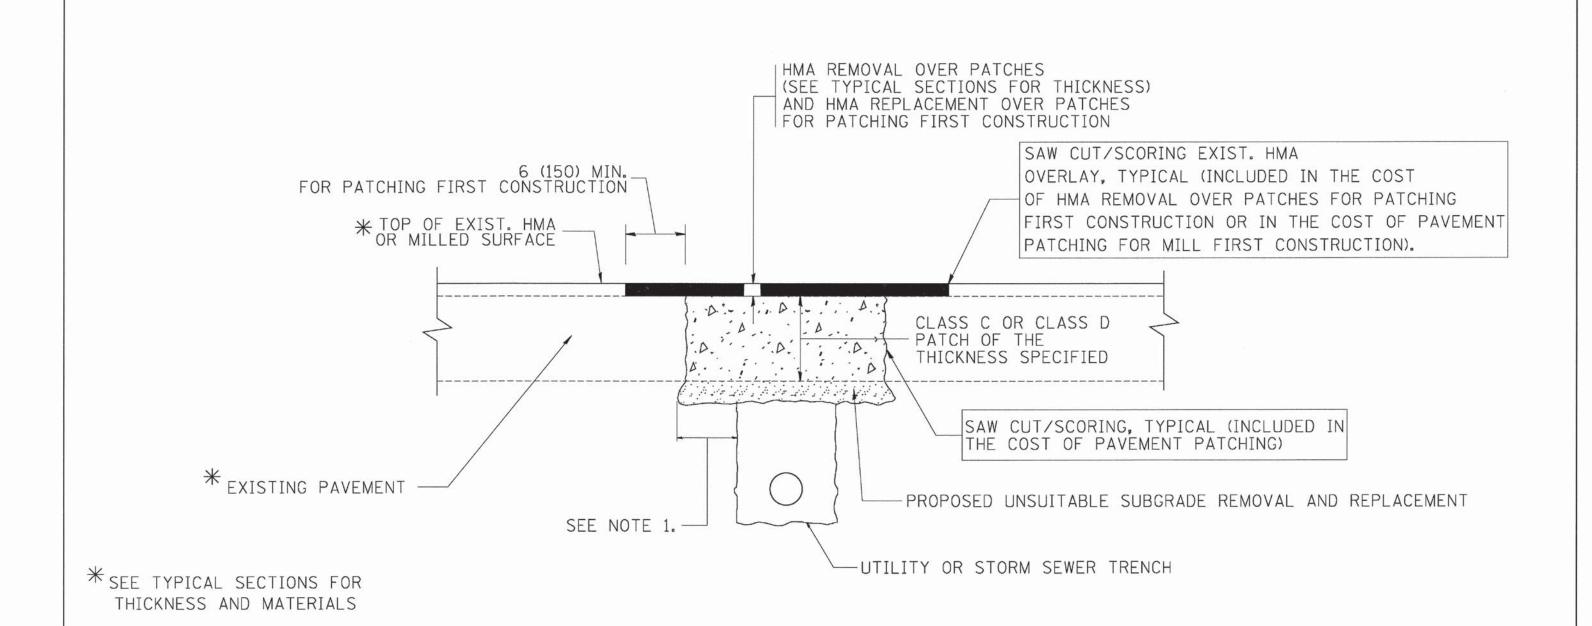

NOTES:

- 1. THE WIDTH OF THE FULL DEPTH PATCH OVER A TRENCH SHALL BE 12 (300) WIDER ON EACH SIDE OF THE TRENCH.
- 2. FOR METHOD OF MEASUREMENT AND BASIS OF PAYMENT, SEE RECURRING SPECIAL PROVISION "PATCHING WITH HOT-MIX ASPHALT OVERLAY REMOVAL".

SEQUENCE OF CONSTRUCTION (PATCHING FIRST)


- 1. REMOVE THE EXISTING HMA MATERIAL OVER THE AREA TO BE PATCHED.
- 2. REMOVE AND REPLACE WITH CLASS C OR D PATCH.
- 3. REPLACE HMA MATERIAL OVER THE AREA TO BE PATCHED.

SEQUENCE OF CONSTRUCTION (MILLING FIRST)

- 1. MILL HMA FIRST IF THERE IS AT LEAST 41/2 INCHES OR MORE OF HMA MATERIAL ON TOP OF THE EXISTING PAVEMENT OR IF THE PAVEMENT IS FULL DEPTH HMA. A MINIMUM OF 2 INCHES OF HMA MATERIAL SHALL BE IN PLACE AFTER MILLING.
- 2. REMOVE AND REPLACE WITH FULL DEPTH CLASS D PATCHES TO TOP OF MILLED SURFACE.

ALL DIMENSIONS ARE IN INCHES (MILLIMETERS) UNLESS OTHERWISE SHOWN.

FILE NAME =	USER NAME = bouerdl	DESIGNED - R. SHAH	REVISED - A. ABBAS 04-27-98			PAVEMENT PATCHING FOR		UN TE. SECTION	COUNTY	TOTAL SHE	ET.
উ a:\projects\diststd22x34\bd22.dgn		DRAWN -	REVISED - R. BORO 01-01-07	STATE OF ILLINOIS	1			062 14-00029-00-RS	KANE	17 1	5
p	PLOT SCALE = 50.000 '/ IN.	CHECKED -	REVISED - R. BORO 09-04-07	DEPARTMENT OF TRANSPORTATION	HMA SURFACED PAVEMENT			BD400-04 (BD-22)	CONTRACT	NO. 610	52
PLOT DATE = 10/27/2008	DATE - 10-25-94	REVISED - K. ENG 10-27-08		SCALE: NONE	SHEET NO. 1 OF 1 SHEETS STA. TO ST	A. FE	D. ROAD DIST. NO. 1 ILLINOIS FED.	AID PROJECT - STP	,	-	

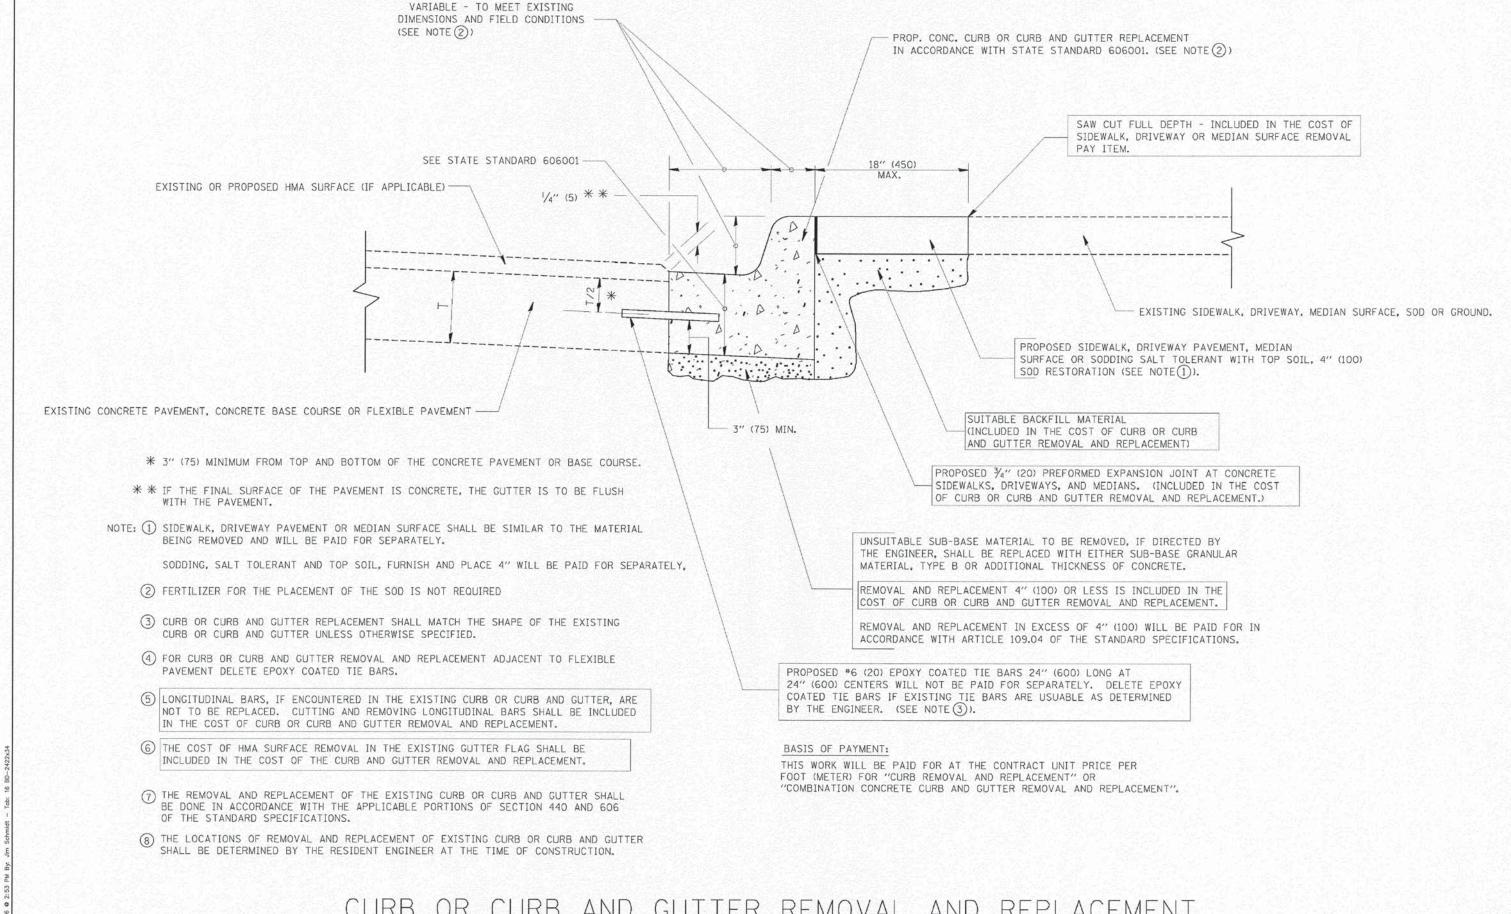

OR CURB AND GUTTER REMOVAL AND REPLACEMENT

ALL DIMENSIONS ARE IN INCHES (MILLIMETERS) UNLESS OTHERWISE SHOWN.

DESIGNED A. HOUSEH DRAWN REVISED A. ABBAS 03-21-97 LOT SCALE = 50.000 '/ IN. CHECKED REVISED M. GOMEZ 01-22-01 DATE 03-11-94 REVISED R. BORO 12-15-09


STATE OF ILLINOIS **DEPARTMENT OF TRANSPORTATION**

CURB OR CURB AND GUTTER REMOVAL AND REPLACEMENT SHEET NO. 1 OF 1 SHEETS STA.


TO STA.

SCALE: NONE

COUNTY TOTAL SHEET NO. 14-00029-00-RS KANE BD600-06 (BD-24) CONTRACT NO. 61C62

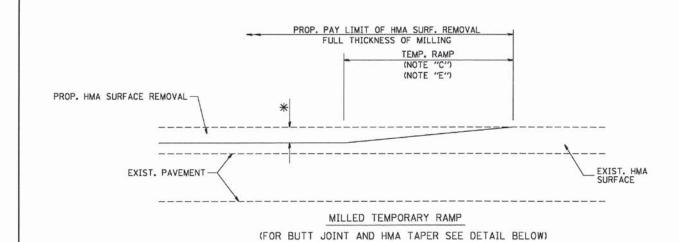


OPTION 1

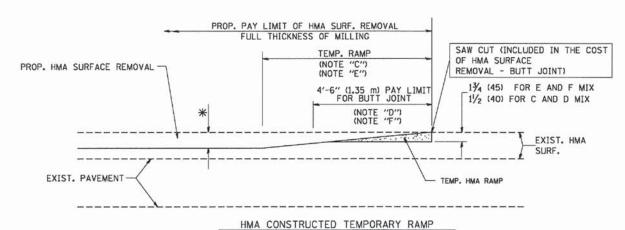

(FOR BUTT JOINT AND HMA TAPER SEE DETAIL BELOW)


OPTION 2

TYPICAL TEMPORARY RAMP

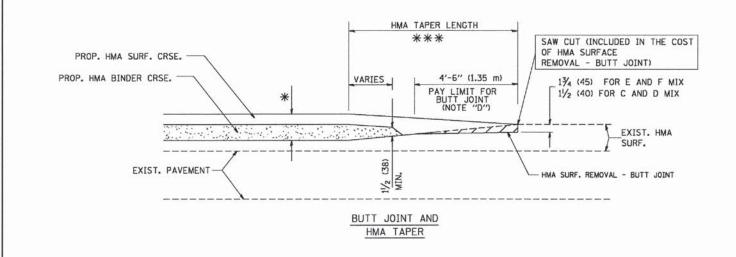


TYPICAL BUTT JOINT AND HMA TAPER FOR MILLING AND RESURFACING


COPYRIGHT © 2016 ENGINEERING ENTERPRI FILE NAME =

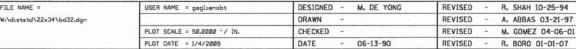

STATE OF ILLINOIS **DEPARTMENT OF TRANSPORTATION**

COUNTY BUTT JOINT AND 14-00029-00-RS HMA TAPER DETAILS BD400-05 BD32 CONTRACT NO. 61C62 SHEET NO. 1 OF 1 SHEETS STA. TO STA. FED. ROAD DIST. NO. 1 |ILLINOIS | FED. AND PROJECT - STP

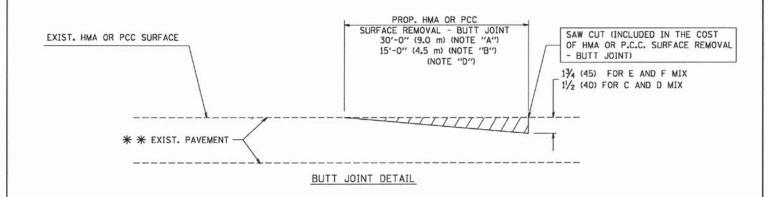

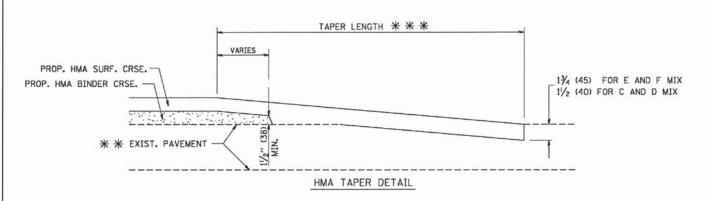

TYPICAL BUTT JOINT AND HMA TAPER FOR RESURFACING ONLY

* * PC CONCRETE, HMA OR HMA RESURFACED PAVEMENT.

NOTES

- A: MAINLINE ROADWAYS AND MAJOR SIDE ROADS.
- B: MINOR SIDE ROADS.
- C: THE TEMP. RAMP SHALL BE CONSTRUCTED IMMEDIATELY UPON REMOVAL OF THE EXISTING HMA SURFACE.
- D: THE BUTT JOINT SHALL BE CONSTRUCTED IMMEDIATELY PRIOR TO PLACING THE PROPOSED HMA COURSES.
- E: TAPER THE TEMP. RAMP AT A RATE OF 3'-0" (900 mm) PER 1 INCH (25 mm) OF MILLING THICKNESS.
- F: INSTALLATION AND REMOVAL OF THE 4'-6" (1.35 m) TEMP. RAMP IS INCLUDED IN COST OF HMA SURFACE REMOVAL - BUTT JOINT
- G: SEE ARTICLE 406.08 AND 406.14 OF THE STANDARD SPECIFICATIONS FOR "HMA AND/OR PCC SURFACE REMOVAL. BUTT JOINT".
- * SEE TYPICAL SECTIONS FOR MILLING THICKNESS.
- ** * * 20'-0" (6.1 m) PER 1 (25) RESURFACING (NOTE "A") 10'-0" (3.0 m) PER 1 (25) RESURFACING (NOTE "B")

BASIS OF PAYMENT:

THE BUTT JOINT WILL BE PAID FOR AT THE CONTRACT UNIT PRICE PER SOUARE YARD (SQUARE METER) FOR "HOT-MIX ASPHALT SURFACE REMOVAL - BUTT JOINT" OR FOR "PORTLAND CEMENT CONCRETE SURFACE REMOVAL- BUTT JOINT".

ALL DIMENSIONS ARE IN INCHES (MILLIMETERS) UNLESS OTHERWISE SHOWN.