

FOR INDEX OF SHEETS, SEE SHEET NO. 2

STATE OF ILLINOIS

DEPARTMENT OF TRANSPORTATION

DIVISION OF HIGHWAYS

PLANS FOR PROPOSED FEDERAL AID HIGHWAY

F.A.U. ROUTE 1398 (CHICAGO AVENUE)
F.A.U. ROUTE 1419A (MADISON STREET)
CENTRAL AVENUE TO CICERO AVENUE
PEDESTRIAN IMPROVEMENTS
SECTION 13-B3514-00-SW
PROJECT SRTS-4009(252)
CITY OF CHICAGO
COOK COUNTY

C-88-043-13

DESIGN SPEED


CHICAGO AVENUE AND MADISON STREET - 30 MPH

POSTED SPEED

CHICAGO AVENUE AND MADISON STREET - 30 MPH


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CHICAGO AVENUE - 19,400 (2014) MADISON AVENUE - 19,500 (2014)

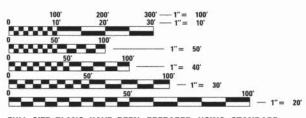

FULL SIZE PLANS HAVE BEEN PREPARED USING STANDARD ENGINEERING SCALES. REDUCED SIZED PLANS WILL NOT CONFORM TO STANDARD SCALES. IN MAKING MEASUREMENTS ON REDUCED PLANS, THE ABOVE SCALES MAY BE USED.

PRIOR TO CONSTRUCTION, THE CONTRACTOR IS REQUIRED TO CALL D.I.G.G.E.R. AT 312–744–7000 FOR UNDERGROUND UTILITY LOCATIONS.

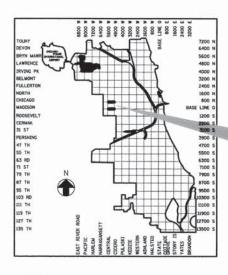

GROSS LENGTH = 8818 FT. = 1.670 MILE NET LENGTH = 697 FT. = 0.132 MILE

LOCATION MAP (NOT TO SCALE)

ECT LOCATIONS A REAL AND	IN. CENTRAL AV.	N. FINE AV.	W. RICE	S S	N. LOREL AV.	N. LOCKWOOD AV.	N. LARANIE AV.	N. LEAMINGTON AV	N. LECLAIRE AV.	LAVERGA	W. RICE ST	N. ILANON AV.	N. CIOERO AV.
AVE. AVE. AVE. AVE. AVE. AVE. AVE. AVE.			LOTUS										<u> </u>
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PAGESTERED P.E., STATE OF ILLINOIS NO. 062–054315; EXPIRES 11–30–2017



PLANS PREPARED B



IO N. LaSalle St, Suite 2624 - Chicago, Illinois 60602 Fel: 312.726.5910- Fax: 312.726.5911 

	DEPARTMENT OF T	RANSPORTATION
APPROVED:	Mile Awader	/-/9-16 PROJECT MANAGER /DATE
APPROVED:	1//2-	PROJECT COORDINATOR /DATE
APPROVED: DEPUTY COMI	MISIONER, DIVISION	J- /9 -16 DF PROJECT DEVELOPMENT /DATE
APPROVED: DEPL	Famil B. UTY COMMISSIONER,	DIVISION OF ENGINEERING /DATE
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	STATE OF ILLINOIS DEPARTMENT OF TRANSPORTATION DIVISION OF HIGHWAYS
	PASSED FERRINGER 2016 CHRISTOPHER HOLT DISTRICT ONE ENGINEER OF LOCAL ROADS AND STREETS
LEASING ASED ON	

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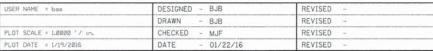
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STATE OF ILLINOIS DEPARTMENT OF TRANSPORTATION

CHICAGO	WEST	SIDE		ES TO	ENHANCEMENTS
SCALE: N.T.S	SHEET	1	 	ETS ST	TO STA.

	ILLINOIS FED.	AID PROJECT		
		CONTRACT	NO.	61C49
398/ 419A	13-B3514-00-SW	COOK	67	2
A.U. TE.	SECTION	COUNTY	TOTAL	SHEET NO.

LIST OF ILLINOIS DOT HIGHWAY STANDARDS

280001-07	TEMPORARY EROSION CONTROL SYSTEMS
701501-06	URBAN LANE CLOSURE, 2L, 2W, UNDIVIDED
701502-06	URBAN LANE CLOSURE, 2L, 2W, WITH BIDIRECTIONAL LEFT TURN LANE
701602-07	URBAN LANE CLOSURE, MULTILANE, 2W WITH BIDIRECTIONAL LEFT TURN LANE
701701-10	URBAN LANE CLOSURE, MULTILANE INTERSECTION
701801-06	SIDEWALK, CORNER OR CROSSWALK CLOSURE
701901-05	TRAFFIC CONTROL DEVICES

LIST OF ILLINOIS DOT HIGHWAY DISTRICT ONE STANDARD DETAILS

TC-10	TRAFFIC CONTROL AND PROTECTION FOR SIDE ROADS
TC-14	TRAFFIC CONTROL AND PROTECTION AT TURN BAYS (TO REMAIN OPEN TO TRAFFIC)
TC-24	CITY OF CHICAGO PAVEMENT MARKINGS

GENERAL NOTES

- 1. ANY REFERENCE TO 'STANDARD SPECIFICATIONS' THROUGHOUT THE PLANS OR SPECIAL PROVISIONS WILL BE INTERPRETED TO BE THE ILLINOIS DEPARTMENT OF TRANSPORTATION (IDOT) 'STANDARD SPECIFICATIONS FOR ROAD AND BRIDGE CONSTRUCTION' (SSRBC), ADOPTED APRIL 1, 2016, AND THE IDOT SUPPLEMENTAL SPECIFICATIONS', ADOPTED APRIL 1, 2016.
- 2. ALL DIMENSIONS SHOWN ON THE PLANS ARE TO THE FACE OF THE CURB, UNLESS OTHERWISE
- 3. ALL PROPOSED STATION AND OFFSET ANNOTATION REFERENCES THE CONSTRUCTION CENTERLINE. THE OFFSETS PROVIDED FOR PROPOSED DRAINAGE STRUCTURES LOCATED IN THE CURB LINES REFER TO THE CENTER OF THE RIM. THE CENTER OF THE RIM IS TO BE LOCATED AT THE EDGE OF PAVEMENT. THE RIM ELEVATIONS PROPOSED ARE THE ELEVATIONS AT THE EDGE OF PAVEMENT.
- ALL ELEVATIONS SHOWN ON THE PLANS ARE BASED ON CHICAGO CITY DATUM WHICH IS 579.88
 FEET ABOVE MEAN SEA LEVEL, 1935 ADJUSTMENT.
- THE CONTRACTOR MUST TAKE ALL NECESSARY SAFETY PRECAUTIONS TO PROTECT ABUTTING PROPERTY, UTILITIES, PEDESTRIANS, AND VEHICULAR TRAFFIC.
- . IT IS CALLED TO THE CONTRACTOR'S ATTENTION THAT CERTAIN PERMITS AND FEES WILL BE REQUIRED BY VARIOUS DEPARTMENTS OF THE CITY OF CHICAGO. ALL PERMITS ARE INCIDENTAL.
- 7. ALL WORK BEGUN DURING A CONSTRUCTION SEASON MUST BE COMPLETED PRIOR TO THE END OF THAT SEASON. THE CONTRACTOR SHALL LIMIT PAVEMENT REMOVAL OPERATIONS TO AN AREA IN WHICH BASE COURSE, AND/OR PROPOSED MEDIAN CURB/ WALL CAN REASONABLY BE PLACED WITHIN 15 WORKING DAYS. THIS AREA SHALL BE DETERMINED BY THE CONSTRUCTION SCHEDULE SUBMITTED AND APPROVED AT THE START OF WORK.
- PARKING METER AND PARKING PAY BOX WORK REQUIRED DUE TO CONSTRUCTION MUST BE PERFORMED BY THE CITY OF CHICAGO DEPARTMENT OF REVENUE ONLY. THE CONTRACTOR SHALL PAY ALL FEES REQUIRED BY SECTION 9-68-050 OF THE MUNICIPAL CODE OF CHICAGO. REFER TO SECTION E OF "UNDICIPAL TERMS AND CONDITIONS (CITY OF CHICAGO)" IN THE SPECIAL PROVISIONS. THIS INCLUDES ANY AND ALL PARKING METERS AND PARKING PAY BOXES TO BE INSTALLED, REMOVED OR RELOCATED AT THE PROJECT LOCATION OR AT ANY AND ALL LOCATIONS DIRECTLY OR INDIRECTLY INVOLVED WITH THE PROJECT.
- THE CTA SHALL REMOVE/REPLACE ALL CTA BUS STOP SIGNS AND BUS SHELTERS WITHIN THE PROJECT LIMITS. THE CONTRACTOR MUST CONTACT THE CTA AT 312-681-4176 AT LEAST TWO WEEKS PRIOR TO SIDEWALK REMOVAL OPERATIONS TO COORDINATE THIS WORK.

MAINTENANCE OF TRAFFIC NOTES

- THE CONTRACTOR MUST MAINTAIN ONE LANE OF TRAFFIC IN EACH DIRECTION AT ALL TIMES WITH MINIMUM LANE WIDTHS AS SHOWN IN THE MAINTENANCE OF TRAFFIC PLANS.
- THE CONTRACTOR IS REQUIRED TO NOTIFY THE ILLINOIS DEPARTMENT OF TRANSPORTATION, DISTRICT ONE, BUREAU OF TRAFFIC AND THE COMISSIONER OF ANY DAMAGE TO TRAFFIC CONTROL DEVICES.
- TRAFFIC WILL BE MAINTAINED ON ALL STREETS AND PARKING WILL BE PROHIBITED WITHIN 50 FEET OF THE CONSTRUCTION AREA AT ALL TIMES. THE CONTRACTOR IS REQUIRED TO NOTIFY THE DIVISION OF ENGINEERING-TRAFFIC SECTION 48 HOURS BEFORE COMMENCING CONSTRUCTION.
- 4. WHEN THE PAVEMENT CONSTRUCTED IS PORTLAND CEMENT CONCRETE BASE COURSE OR PORTLAND CEMENT CONCRETE PAVEMENT, IT SHALL NOT BE OPENED TO TRAFFIC, INCLUDING CONSTRUCTION TRAFFIC, UNTIL AFTER THE SPECIFIED CURING PERIOD AS DEFINED IN ARTICLE 701.17(c)(5) OF THE 'STANDARD SPECIFICATIONS' AND UNTIL THE JOINTS HAVE BEEN SEALED.
- 5. THE CONTRACTOR'S VEHICLES SHALL ALWAYS MOVE WITH AND NOT AGAINST OR ACROSS THE FLOW OF TRAFFIC. THESE VEHICLES SHALL ENTER OR LEAVE THE WORK AREA IN A MANNER WHICH WILL NOT BE HAZARDOUS TO OR INTERFERE WITH NORMAL TRAFFIC AND SHALL NOT PARK OR STOP EXCEPT WITHIN DESIGNATED WORK AREAS. PERSONAL VEHICLES WILL NOT BE PERMITTED TO PARK WITHIN THE RIGHT-OF-WAY EXCEPT IN SPECIFIC AREAS DESIGNATED BY THE COMMISSIONER.
- ACCESS TO EXISTING CROSS ROADS AND DRIVES MUST BE MAINTAINED AT ALL TIMES DURING CONSTRUCTION.
- 7. ADEQUATE PROVISIONS FOR PEDESTRIAN TRAFFIC MUST BE PROVIDED AT ALL TIMES.
- 8. SEE SHEET 24 FOR ADDITIONAL NOTES.

CIVIL NOTES

- 1. THE ENTIRE AREA WHICH IS TO RECEIVE 'BITUMINOUS MATERIALS (PRIME COAT)' MUST BE SWEPT CLEAN BEFORE THE MATERIAL IS APPLIED. THE SWEEPINGS WILL NOT BE DEPOSITED IN THE GUTTER OR ON THE CURB, PARKWAY, OR SIDEWALK, BUT ARE TO BE PICKED UP AND DISPOSED OF PROPERLY BEYOND THE LIMITS OF THE PROJECT ON THE SAME DAY THAT THE SWEEPING IS DONE. THE WORK WILL NOT BE PAID FOR SEPARATELY, BUT WILL BE CONSIDERED INCIDENTAL TO 'BITUMINOUS MATERIALS (PRIME COAT)'.
- IF AN EXISTING MAILBOX MUST BE REMOVED OR RELOCATED TO COMPLETE THE WORK, THE CONTRACTOR MUST NOTIFY THE POST OFFICE. THE COST OF ANY COORDINATION WITH THE POST OFFICE WILL BE CONSIDERED INCIDENTAL TO 'SIDEWALK REMOVAL (SPECIAL)'.
- WHEN THE PAVEMENT CONSTRUCTED IS PORTLAND CEMENT CONCRETE BASE COURSE OR PORTLAND CEMENT CONCRETE PAVEMENT, THE PAVEMENT JOINTING SYSTEM IS TO BE CONSTRUCTED IN ACCORDANCE WITH THE 'STANDARD SPECIFICATIONS', THE CONTRACT SPECIFICATIONS, AND THE STANDARD DETAILS.
- 4. THE EXISTING PAVEMENT IS REQUIRED TO BE SAWCUT IN ORDER TO PROVIDE FOR A STRAIGHT EDGE BUTT JOINT WHERE COMBINATION CONCRETE CURB AND GUTTER IS TO BE REPLACED, WHERE FULL DEPTH PATCHES ARE TO BE CONSTRUCTED, WHERE TRENCHES FOR PROPOSED DRAINAGE STRUCTURES ARE TO BE EXCAVATED, AS SHOWN ON THE PLANS, AND AS DIRECTED BY THE COMMISSIONER. FOR COMBINATION CONCRETE CURB AND GUTTER, THE SAWCUT IS REQUIRED TO BE DEEP ENOUGH TO PENETRATE THE EXISTING BASE COURSE WHERE NECESSARY TO ASSURE A STRAIGHT EDGE FOR THE FULL DEPTH OF COMBINATION CONCRETE CURB AND GUTTER. FOR PATCHES AND DRAINAGE STRUCTURES, THE SAWCUT SHALL BE FULL DEPTH. ALL OTHER SAWCUTTING WILL BE TO THE DEPTHS SHOWN ON THE PLANS OR GIVEN IN THE SPECIFICATIONS. ALL SAWCUTTING SHOWN ON THE PLANS OR OTHERWISE REQUIRED FOR THIS WORK WILL BE CONSIDERED INCIDENTAL TO THE ADJACENT REMOVAL ITEM(S).

UTILITY NOTES

- 1. PLAN DIMENSIONS AND DETAILS RELATIVE TO EXISTING STRUCTURES HAVE BEEN TAKEN FROM EXISTING PLANS AND ARE SUBJECT TO NOMINAL CONSTRUCTION VARIATIONS. IT SHALL BE THE CONTRACTOR'S RESPONSIBILITY TO VERIFY SUCH DIMENSIONS AND DETAILS IN THE FIELD AND MAKE THE NECESSARY APPROVED ADJUSTMENTS PRIOR TO CONSTRUCTION OR ORDERING MATERIALS. SUCH VARIATIONS WILL NOT BE CAUSE FOR ADDITIONAL COMPENSATION FOR A CHANGE IN THE SCOPE OF THE WORK: HOWEVER, THE CONTRACTOR WILL BE PAID AT THE CONTRACT UNIT PRICE FOR THE WORK.
- THE CONTRACTOR IS RESPONSIBLE FOR CONTACTING THE CHICAGO UTILITY ALERT NETWORK AT (312) 744-7000 OR J.U.L.I.E. AT (800) 892-0123 SO THAT UTILITIES AND THEIR APPURTENANCES MAY BE LOCATED AND ADJUSTED OR MOVED, IF NECESSARY, AT LEAST 48 HOURS PRIOR TO THE START OF CONSTRUCTION OPERATIONS. THE CONTRACTOR MUST COOPERATE WITH ALL UTILITY OWNERS AS PROVIDED FOR IN THE 'STANDARD SPECIFICATIONS'.
- THE CITY DOES NOT GUARANTEE THE COMPLETENESS OR ACCURACY OF THE INFORMATION SHOWN ON THE PLANS REGARDING UTILITIES, EITHER PUBLIC OR PRIVATE, SUCH AS SEWERS, MANHOLES, CATCH BASINS, GAS AND WATER MAIN, TELEPHONE AND ELECTRICAL DUCT LINES, AND SIMILAR STRUCTURES. THE CONTRACTOR MUST VERIFY THE EXACT LOCATION OF ALL UTILITIES THAT MAY INTERFERE WITH THE CONSTRUCTION OPERATIONS AND MUST REPORT TO THE COMMISSIONER ANY OMISSIONS AND DIFFERENCES FROM LOCATIONS SHOWN ON THE PLANS. THE COST OF THIS WORK WILL BE CONSIDERED INCIDENTAL TO THE CONTRACT.
- 4. THE CONTRACTOR IS REQUIRED TO PROTECT ANY EXISTING AND NEW UTILITIES WHEN CONSIDERED NECESSARY BY THE COMMISSIONER, USING METHODS APPROVED BY THE COMMISSIONER. THE CONTRACTOR WILL BRACE AND SUPPORT THE UTILITIES PROPERLY TO PREVENT SETTLEMENT, DISPLACEMENT, OR CHANGE TO THE UTILITIES. THE COST OF UTILITY PROTECTION AS SPECIFIED IN HEREIN WILL BE CONSIDERED INCIDENTAL TO THE CONTRACT.
- 5. ANY UTILITY THAT IS DAMAGED DURING CONSTRUCTION WILL BE REPAIRED OR REPLACED BY THE CONTRACTOR AT HIS/HER OWN EXPENSE.
- 6. EXCEPT AS NOTED ON THE PLANS, IN THE GENERAL NOTES, AND IN THE SPECIFICATIONS, UTILITY RELOCATION OR ADJUSTMENT WILL BE PERFORMED BY THE RESPECTIVE UTILITY OWNERS AT THEIR OWN EXPENSE AND WILL NOT BE CONSIDERED PART OF THIS CONTRACT. THE CONTRACTOR WILL NOTIFY THE AFFECTED UTILITY OWNERS AND SCHEDULE HIS/HER WORK ACCORDINGLY. THE COST OF THIS COORDINATION WILL BE CONSIDERED INCIDENTAL TO THE CONTRACT.
- 7. ANY PAVEMENT REMOVAL AND REPLACEMENT OPERATION TO BE DIRECTLY ABOVE A COMMONWEALTH EDISON (COMED) COMPANY LINE WILL BE CLOSELY COORDINATED WITH COMED. REPRESENTATIVES FROM THE CITY OF CHICAGO DEPARTMENT OF TRANSPORTATION AND COMED MUST BE PRESENT DURING PERFORMANCE OF THIS WORK, AS ARRANGED BY THE CONTRACTOR.
- 8. THE CONTRACTOR MUST TAKE EXTRA PRECAUTION WHEN WORKING NEAR COMED OVERHEAD WIRES. THESE WIRES ARE NOT INSULATED.

DEPARTMENT OF WATER MANAGEMENT NOTES

- THE UTILITY COMPANY/GOVERNMENT AGENCY AND ITS CONTRACTORS ARE RESPONSIBLE FOR THE ADEQUATE PROTECTION OF THE EXISTING SEWERS, DRAIN CONNECTIONS, SEWER STRUCTURES AND BENCH MONUMENTS DURING CONSTRUCTION OF NEW UTILITIES AND/OR ADJUSTMENT TO EXISTING UTILITIES AND THE USE OF HEAVY EQUIPMENT WITHIN THE LIMITS OF THE PROJECT.
- IT IS THE RESPONSIBILITY OF THE UTILITY COMPANY/GOVERNMENT AGENCY AND ITS CONSULTANTS/CONTRACTORS TO OBTAIN THE NECESSARY BACKGROUND INFORMATION FROM THE SEWER UNIT OF THE DEPARTMENT OF WATER MANAGEMENT (DWM) IN MEETING REQUIREMENTS FOR DESIGN DRAWINGS/CONTRACT PLANS AND FOR EXISTING FACILITIES PROTECTION DURING THE CONSTRUCTION STAGE. RECORDS FROM THE SEWER UNIT OF THE DWM INCLUDE; EXISTING SEWERS, DRAIN CONNECTIONS, SEWER STRUCTURES, BENCHMARK LOCATIONS, ORDINANCE GRADES, AGE OF SEWER AND PIPE MATERIAL. WHEN REPLACING CURB AND GUTTER, ORDINANCE GRADES MUST BE SHOWN ON THE PLAN. TO THE EXTENT POSSIBLE, THE PROPOSED TOP-OF-CURB GRADES MUST BE WITHIN 0.2 FEET OF THE APPROVED ORDINANCE GRADE. COPIES OF SEWER RECORDS AND BENCHMARKS CAN BE OBTAINED BY PAYMENT AT THE SEWER UNIT OF THE DEPARTMENT OF BUILDINGS (DOB), LOCATED AT CITY HALL, 121 N. LASALLE STREET ROOM 804, CHICAGO, ILLINOIS 60602.
- 3. THE SEWER UNIT OF THE DOB MUST BE NOTIFIED AT LEAST 48 HOURS IN ADVANCE OF CONSTRUCTION, WITH THE NAME AND TELEPHONE NUMBER OF THE RESIDENT ENGINEER WHO COULD BE CONTACTED FOR ANY SEWER EMERGENCY.
- PRIOR TO START OF CONSTRUCTION, A PERMIT IS REQUIRED FROM THE SEWER UNIT OF THE DOB FOR ANY UNDERGROUND SEWER WORK INCLUDING ADJUSTMENT OF SEWER STRUCTURES AND REMOVAL/REPLACEMENT OF FRAMES AND LIDS. PERMIT MUST BE OBTAINED BY DRAIN-LAYER CURRENTLY LICENSED FROM THE SEWER UNIT OF THE DOB.
- 5. THE CONTRACTOR IS RESPONSIBLE FOR THE ADEQUATE PROTECTION OF THE EXISTING SEWERS, DRAIN CONNECTIONS, SEWER STRUCTURES, AND BENCH MONUMENTS DURING CONSTRUCTION OPERATIONS AND USE OF HEAVY EQUIPMENT IN THE LIMITS OF THE PROJECT.
- 6. THE CONTRACTOR MUST LOCATE AND PROMPTLY AND PROPERLY CONNECT TO THE NEW SEWERS ALL LIVE HOUSE DRAINS, CATCH BASIN DRAINS AND OTHER EXISTING LATERALS, DRAINS AND SEWERS, OF WHATEVER NATURE, WHICH ARE CONNECTED TO THE EXISTING SEWERS BEING REPAIRED OR REPLACED.
- 7. EXISTING CATCH BASIN LATERALS TO BE REUSED MUST BE RODDED AND FLUSHED IN THE PRESENCE OF THE SEWER UNIT OF THE DWM INSPECTOR. A NEW CONNECTION TO THE MAIN SEWER IS REQUIRED IF THE EXISTING CATCH BASIN LATERAL IS NOT APPROVED BY THE SEWER INSPECTOR.
- 8. WHEN A SEWER STRUCTURE IS ABANDONED, ALL PIPE OPENINGS MUST BE PLUGGED, STRUCTURES FILLED WITH TRENCH BACK-FILL, LIDS AND FRAMES REMOVED AND SURFACE RESTORED AS PER THE DWM 2014 REGULATIONS FOR SEWER CONSTRUCTION AND STORMWATER MANAGEMENT AVAILABLE AT HTTP://WWW.CITYOFCHICAGO.ORG/CITY/EN/DEPTS/WATER.HTML
- 9. THE CONTRACTOR IS REQUIRED TO REPLACE ANY BROKEN FRAMES AND LIDS OF SEWER STRUCTURES WITH STANDARD FRAMES AND LIDS OF THE DWM. IN ADJUSTMENT OR RECONSTRUCTION OF SEWER STRUCTURES, ANY NON-STANDARD FRAMES AND LIDS MUST BE REPLACED WITH STANDARD FRAMES AND LIDS. IN ADJUSTMENT OR RECONSTRUCTION OF INLETS, ANY NON-STANDARD INLETS (GUTTER BOXES) MUST BE REPLACED WITH DWM STANDARD INLETS.
- 10. THE FRAMES AND LIDS OF SEWER STRUCTURES TO BE ABANDONED, REMOVED, OR FILLED MUST BE SALVAGED AND DELIVERED TO WATER MANAGEMENT LOCATED AT 3901 S. ASHLAND AVENUE. DELIVERY MUST TAKE PLACE BETWEEN 10:00 AM AND 2:00 PM MONDAY THROUGH FRIDAY. CALL (312) 747-1777 TO ARRANGE FOR DELIVERY.
- 11. IN LOCATIONS WHERE THE MAIN SEWER IS NOT BEING REPLACED AND THE EXISTING DRAINAGE FACILITIES ARE DISTURBED OR DAMAGED DURING CONSTRUCTION BY THE CONTRACTOR, IT WILL BE THE CONTRACTOR'S RESPONSIBILITY TO RESTORE AND REPLACE THE DAMAGED FACILITIES AT HIS/HER EXPENSE TO THE SATISFACTION OF THE DWM.
- 12. IN CASE OF ANY DAMAGE TO THE CITY'S SEWER SYSTEM, PRIVATE AND PUBLIC DRAIN CONNECTIONS, AND/OR BENCH MONUMENTS, THE CONTRACTOR MUST CONTACT THE SEWER UNIT OF THE DOB IMMEDIATELY AT PHONE NUMBER (312) 744-3351. THE CONTRACTOR MUST, AT HIS/HER COST, REPLACE THE AFFECTED SEWERS, DRAIN CONNECTIONS, SEWER STRUCTURES AND/OR BENCH MONUMENTS AS NECESSARY, THE SEWER FLOWS MUST BE MAINTAINED AT ALL TIMES.
- 13. FLOW RESTRICTORS MUST BE INSTALLED IN ALL CATCH BASINS, OUTSIDE OF THE CENTRAL BUSINESS DISTRICT. FLOW RESTRICTORS MUST NOT BE INSTALLED IN CLOSE PROXIMITY TO VIADUCT AREAS, BUS STOPS OR EMERGENCY ENTRANCES. FLOW RESTRICTORS ARE AVAILABLE FOR PICK-UP AT THE DWM'S CENTRAL DISTRICT, LOCATED AT 3901 S. ASHLAND AVENUE, BY CALLING (312) 747-1777, BETWEEN 7:00 AM-3:00 PM, 48 HOURS IN ADVANCE.
- 14. ON WORK COMPLETION, THE CONTRACTOR MUST PROVIDE THE SEWER UNIT OF THE DWM, FOR REVIEW AND ACCEPTANCE, A DVD OF THE SEWER MAINS. THIS WORK WILL BE INCIDENTAL TO THE CONTRACT.
- 15. AS-BUILT PLANS OF NEW OR REPLACED SEWERS IN THE PUBLIC RIGHT-OF-WAY MUST BE SUBMITTED TO THE DWM SEWER DESIGN SECTION WITHIN 30 DAYS AFTER COMPLETION OF THE PROJECT AND WILL BE INCLUDED AS A PUNCH LIST ITEM PRIOR TO ACCEPTANCE OF THE PROJECT.

DEPARTMENT OF WATER MANAGEMENT NOTES (cont.)

- 16. THE AS-BUILT PLANS OF NEW OR REPLACED SEWERS MUST BE SEALED BY A PROFESSIONAL ENGINEER OR REGISTERED LAND SURVEYOR AND BE SUBMITTED WITH THE 'AS BUILT RECORD DRAWINGS FORM (CITY OF CHICAGO)' IN THE SPECIAL PROVISIONS, PLAN AND PROFILE DRAWINGS OF THE SEWERS AND SEWER STRUCTURES MUST BE SUBMITTED ON A COMPACT DISK IN .TIF FORMAT, ALL ELECTRONIC FILES MUST BE SUBMITTED IN A FILE FOLDER WITH ONE FILE NAME REFLECTING THE ADDRESSES OF THE PROJECT, WITH STREET NAME FIRST: (E.G. JACKSON ST. 300-500 S.) A HARD COPY OF THE AS-BUILT PLANS MUST ALSO BE SUBMITTED.
- 17. REFER TO SEWER UNIT OF THE DWM 2014 REGULATIONS FOR SEWER CONSTRUCTION AND STORMWATER MANAGEMENT AVAILABLE AT HTTP://WWW.CITYOFCHICAGO.ORG/CITY/EN/DEPTS/WATER.HTML FOR COMPLETE REGUIREMENTS ON SEWER CONSTRUCTION IN THE PUBLIC WAY BY PRIVATE CONTRACTORS.
- 18. THE LOCATION OF PROPOSED WATER LINES, METER VAULTS, VALVES AND RPZ'S SHOWN ON THE PLANS ARE APPROXIMATE. THE CONTRACTOR SHALL MARK THE LAYOUT AND LOCATION OF THE WATER LINES, METER VAULTS, VALVES, AND RPZ'S FOR REVIEW BY COMMISSIONER PRIOR TO ANY EXCAVATION.
- 19. THE CONTRACTOR SHALL VERIFY THE LOCATION OF ALL PROPOSED WATER SERVICE CONNECTIONS PRIOR TO MOVING THE FIRE HYDRANTS. THE CITY OF CHICAGO, DEPARTMENT OF WATER MANAGEMENT WILL PERFORM THE WATER SERVICE CONNECTION TO THE EXISTING WATER MAIN. IT SHALL BE THE CONTRACTOR'S RESPONSIBILITY TO OBTAIN ALL NECESSARY PERMITS AND PAY THE ASSOCIATED FEES. ALL PERMIT FEES WILL BE CONSIDERED INCIDENTAL TO THE CONTRACT.
- 20. THE CONTRACTOR SHALL DETERMINE WHEN FLAT SLAB TOPS ARE REQUIRED ON MANHOLES. NO ADDITIONAL COMPENSATION SHALL BE ALLOWED FOR THE USE OF FLAT SLAB TOPS.
- DRAINAGE STRUCTURE FLAT-TOPS AND CONES SHALL BE TURNED SO THAT THE FRAMES ARE CLOSEST TO THE CENTERLINE OF THE ROAD. ALL FLAT-TOPS AND CONES ARE ASSUMED TO BE ECCENTRIC.
- 22. AS-BUILT PLANS MUST BE SUBMITTED SOON AFTER WORK COMPLETION. FINAL PAYMENT WILL NOT BE MADE TO THE CONTRACTOR UNTIL THE SEWER UNIT OF THE DWM ACKNOWLEDGES RECEIPT OF "AS-BUILT PLANS".
- 23. NO ADDITIONAL PAYMENT FOR PREMIUM TIME WILL BE ALLOWED FOR NIGHT OR WEEKEND WORK NECESSARY FOR THE SHUT-DOWN AND RECONNECTION OF THE WATER MAIN ON THIS PROJECT.

ELECTRICAL NOTES

- ALL PROPOSED CONDUIT, MANHOLES, BOXES, CONTROLLERS AND APPURTENANCES SHOWN ARE DIAGRAMMATIC ONLY TO CONVEY THE SCOPE OF WORK, THE ACTUAL LOCATIONS MUST BE VERIFIED BY THE CONTRACTOR PRIOR TO INSTALLATION.
- TRENCHED CONDUITS MUST BE INSTALLED A MINIMUM OF 30 INCHES DEPTH AND POSITIONED IN FIELD TO AVOID CONFLICT WITH TREE ROOTS, ROADWAY SEWER DRAINS, AND OTHER EXISTING AND PROPOSED UTILITIES. THE CONTRACTOR MUST INCREASE THE DEPTH OF TRENCH AND CONDUITS TO AVOID CONFLICTS AS REQUIRED AT NO ADDITIONAL COST TO CITY.
- THE CONTRACTOR WILL NOT DE-ENERGIZE ANY EXISTING ELECTRICAL EQUIPMENT WITHOUT PRIOR APPROVAL FROM THE COMMISSIONER.
- 4. WHERE THE CONTRACTOR'S EXCAVATION MEETS AN OBSTRUCTION OR EXISTING FOUNDATION, THE CONTRACTOR MUST NOTIFY THE COMMISSIONER FOR DIRECTION PRIOR TO FURTHER EXCAVATION. THE CONTRACTOR MUST RESTORE ANY DAMAGE TO EXISTING SYSTEMS OR UTILITIES AND REMOVE OBSTRUCTIONS AND FOUNDATIONS TO THE SATISFACTION OF THE COMMISSIONER, THIS WORK WILL BE INCLUDED IN THE APPROPRIATE EXCAVATION PAY ITEM.
- 5. ALL NEW ELECTRICAL WORK INSTALLED UNDER THIS CONTRACT MUST BE DONE IN SUCH A MANNER AS NOT TO DAMAGE EXISTING LANDSCAPE (TREES, BUSHES, ETC.) DURING PROGRESSION OF WORK, IF THE CONTRACTOR HAS A CONFLICT WITH THE EXISTING LANDSCAPE HE MUST STOP WORK AND IMMEDIATELY NOTIFY THE COMMISSIONER FOR RESOLUTION
- 5. THE ELECTRICAL CONTRACTOR MUST CONTACT INSPECTIONAL SERVICES OF CITY OF CHICAGO BUREAU OF ELECTRICITY AT 312-746-5048 FOR WALK THROUGH PRIOR TO THE START OF ELECTRICAL CONSTRUCTION.
- THE CONTRACTOR MUST SUBMIT TO THE COMISSIONER 3 COPIES OF ALL CATALOG CUTS FOR REVIEW/APPROVAL ON ALL ELECTRICAL MATERIAL TO BE INSTALLED FOR BUREAU OF ELECTRICITY MAINTENANCE.

LANDSCAPING NOTES

- THE CONTRACTOR IS REQUIRED TO OBTAIN A PERMIT TO REMOVE, PLANT, SPRAY, OR IN ANY WAY AFFECT THE GENERAL HEALTH OR STRUCTURE OF TREES IN THE PUBLIC WAY. THIS PERMIT MAY BE OBTAINED FROM THE DEPUTY COMMISSIONER OF CITY OF CHICAGO BUREAU OF FORESTRY.
- 2. TREES MUST BE TAGGED BY C.D.O.T. CONTACT KEN MARTIN AT (312)744-1863.
- 3. WHEN DIRECTED BY THE ENGINEER, SUPPLEMENTAL WATERING SHALL BE APPLIED TO ALL SEEDED AREAS PRIOR TO FINAL ACCEPTANCE AT A RATE SPECIFIED BY THE ENGINEER. THE COST OF THIS WORK WILL BE CONSIDERED INCIDENTAL TO THE CONTRACT.
- 4. THE CONTRACTOR SHALL ADHERE TO THE LIMITS OF RESOTRATION SHOWN. AREAS OUTSIDE THESE LIMITS THAT ARE DAMAGED OR DISTURBED BY THE CONTRACTOR SHALL BE RESTORED BY THE CONTRACTOR AT HIS EXPENSE, AND NO ADDITIONAL COMPENSATION WILL BE ALLOWED.

ADA NOTES

1. FOR THE LATEST CITY OF CHICAGO ADA REQUIREMENTS FOR THE PLANS GO TO WWW.CITYOFCHICAGO.ORG , GO TO THE CITY DEPARTMENTS TAB AT THE TOP, THEN GO TO THE TRANSPORTATION SECTION, AND THEN GO TO THE CONSTRUCTION DETAILS TO GET THE MOST RECENT ADA CONSTRUCTION STANDARDS.

PAY ITEM SPECIFIC NOTES

SUBBASE GRANULAR MATERIAL. TYPE B

- LIMESTONE, CRUSHED CONCRETE, OR ANY OTHER LIME BEARING MATERIAL WILL NOT BE PERMITTED WITHIN 2 FEET OF ANY PLANTING MATERIALS. ONLY NON-LIMESTONE GRANULAR MATERIAL SHALL BE PERMITTED WITHIN 2 FEET OF ANY PLANTING MATERIAL. THIS SHALL BE CONSIDERED INCIDENTAL TO SUBBASE GRANULAR MATERIAL, TYPE B.
- PREPARATION OF THE SUBGRADE WILL NOT BE PAID FOR SEPARATELY BUT CONSIDERED INCIDENTAL TO SUBBASE GRANULAR MATERIAL, TYPE B.

HOT-MIX ASPHALT BINDER AND/OR SURFACE

HE CONTRACTOR MUST PROVIDE ADDITIONAL TRAFFIC CONTROL DEVICES AND FLAGMEN WHEN PLACING BINDER/SURFACE COURSES ON ROADWAYS OPEN TO TRAFFIC. THE USE OF TWO CERTIFIED FLAGMEN WILL BE MANDATORY AT ALL TIMES, ADDITIONAL TRAFFIC CONTROL DEVICES AND FLAGMEN WILL NOT BE PAID FOR SEPARATELY BUT CONSIDERED INCIDENTAL TO THE APPLICABLE ASPHALT ITEMS, FAILURE TO PROVIDE ADEQUATE TRAFFIC CONTROL OR TWO FLAGPERSONS WILL BE CONSIDERED A TRAFFIC CONTROL DEFICIENCY AND THE CONTRACTOR WILL BE CHARGED FOR TRAFFIC CONTROL DEFICIENCY IN ACCORDANCE WITH THE ITEM TRAFFIC CONTROL AND PROTECTION.

THERMOPLASTIC PAVEMENT MARKING LINE AND/OR LETTERS AND SYMBOLS

- . THIS WORK SHALL BE DONE AT EACH LOCATION WHERE PAVEMENT MARKINGS ARE REQUIRED WITHIN 3 WORKING DAYS AFTER THE FINAL BITUMINOUS SUBFACE IS IN PLACE
- THE CONTRACTOR SHALL PROTECT ALL MARKINGS FROM TRAFFIC UNTIL THE THERMOPLASTIC/PREFORMED PLASTIC HAS SET SUFFICIENTLY TO ASSUME TRAFFIC. ANY DAMAGE TO THE MARKINGS DUE TO TRAFFIC SHALL BE REPLACED IMMEDIATELY BY THE CONTRACTOR AT HIS/HER EXPENSE.

PAVEMENT MARKING REMOVAL

PAVEMENT MARKING REMOVAL WILL NOT BE PAID FOR WHEN THE EXISTING MARKING IS REMOVED BY PAVEMENT REMOVAL, CURB AND GUTTER REMOVAL, OR OTHER PENDUAL TEMS

PAVEMENT REMOVAL AND HMA SURFACE REMOVAL

 HMA SURFACE REMOVAL OVER PAVEMENT REMOVAL AREAS WILL NOT BE PAID SEPARATELY BUT WILL BE INCLUDED IN PAVEMENT REMOVAL PAY ITEM QUANTITY.

STANDARD SYMBOLS WATER DISTRIBUTION PEOPLES GAS LIGHT AND COKE H G H H G H ABANDONED GAS FIBER OPTIC COMMONWEALTH EDISON CITY ELECTRIC _T____T___T__ ILLINOIS BELL TELEPHONE EXISTING SEWER 0000 PROPOSED SEWER FIRE HYDRANT LIGHT STANDARD BUFFALO BOX, WATER OR GAS STREET LIGHTING CONTROL BOX HANDHOLE. INLET, EXISTING INLET TO BE ADJUSTED INLET TO BE REMOVED

CATCH BASIN TO BE CONSTRUCTED

CATCH BASIN TO BE REMOVED

CATCH BASIN TO BE FILLED

CATCH BASIN TO BE ADJUSTED

SEWER MANHOLE TO BE REMOVED

SEWER MANHOLE TO BE FILLED

CATCH BASIN, EXISTING

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SEWER MANHOLE TO BE FILLED

A SEWER MANHOLE TO BE ADJUSTED

WATER METER

A WATER METER TO BE ADJUSTED

TREFS EXISTING

TREES TO BE REMOVED
VEGETATION
CONTROL POINT

PAVEMENT CORE

△ ▷ SIDEWALK RAMPS FOR PEOPLE WITH DISABILITIES

___ EXISTING SIGN

0.00 EXISTING ELEVATION

0.00 PROPOSED ELEVATION

X.XX B/C BACK OF CURB ELEVATION

/X.XX FL FLOW LINE ELEVATION

ORDINANCE GRADE

CIVILTECH

SUMMARY OF QUANTITIES

				TOTAL	CONSTRUCTION TYPE CODE	
COD	E NO.	ITEM DESCRIPTION	UNIT	QUANTITY	ROADWAY RECON 0004	SAFETY 0021
2070	00220	POROUS GRANULAR EMBANKMENT	CUYD	285		285
2800	00500	INLET AND PIPE PROTECTION	EACH	38	38	
3110	01400	SUBBASE GRANULAR MATERIAL, TYPE B 6"	SQ YD	43	43	
3530	00400	PORTLAND CEMENT CONCRETE BASE COURSE 9"	SQ YD	40	40	
4060	00535	LEVELING BINDER (HAND METHOD), N70	TON	40	40	
4060	00990	TEMPORARY RAMP	SQ YD	10	10	
4060	03340	HOT-MIX ASPHALT SURFACE COURSE, MIX "D", N70	TON	80	80	
4080	00029	BITUMINOUS MATERIALS (TACK COAT)	POUND	350	350	
4200	01300	PROTECTIVE COAT	SQ YD	1000		1000
6700	00500	ENGINEER'S FIELD OFFICE, TYPE B	CAL MO	6	6	
6710	00100	MOBILIZATION	L SUM	1	1	
7010	06800	CHANGEABLE MESSAGE SIGN	CAL MO	24		24
7010	07004	PAVEMENT MARKING BLACKOUT TAPE, 4"	FOOT	3100		3100
7030	00210	TEMPORARY PAVEMENT MARKING - LETTERS AND SYMBOLS	SQ FT	255		255
7030	00220	TEMPORARY PAVEMENT MARKING - LINE 4"	FOOT	348		348
7030	00240	TEMPORARY PAVEMENT MARKING - LINE 6"	FOOT	8335		8335
7030	00280	TEMPORARY PAVEMENT MARKING - LINE 24"	FOOT	100		100
7800	00100	THERMOPLASTIC PAVEMENT MARKING - LETTERS AND SYMBOLS	SQFT	535		535
7800	00200	THERMOPLASTIC PAVEMENT MARKING - LINE 4"	FOOT	7295		7295
7800	00400	THERMOPLASTIC PAVEMENT MARKING - LINE 6"	FOOT	825		825
7800	00600	THERMOPLASTIC PAVEMENT MARKING - LINE 12"	FOOT	260		260
7800	00650	THERMOPLASTIC PAVEMENT MARKING - LINE 24"	FOOT	3045		3045
7830	00100	PAVEMENT MARKING REMOVAL	SQFT	3750		3750
Z001	13798	CONSTRUCTION LAYOUT	L SUM	1	1	
Z001	17700	DRAINAGE & UTILITY STRUCTURES TO BE RECONSTRUCTED	EACH	3	3	
Z001	18900	DRILL AND GROUT DOWEL BARS	EACH	100		100
Z002	24478	FLEXIBLE DELINEATORS	EACH	57		57



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PLOT DATE = 2/1/2016	DATE - 02/01/16	REVISED -	

DENOTES SPECIALTY ITEMS
 DENOTES SPECIAL PROVISION


SUMMARY OF QUANTITIES

			UNIT	TOTAL	CONSTRUCTION TYPE CODE	
	CODE NO.	Z0026400 FURNISHING AND PLACING SAND FILL		QUANTITY	ROADWAY RECON 0004	SAFETY 0021
SP	Z0026400	FURNISHING AND PLACING SAND FILL	CUYD	35		35
* SP	X0325130	TUBULAR TRAFFIC SIGN POST	EACH	1		1
SP	X0326862	STRUCTURES TO BE ADJUSTED	EACH	6	6	
SP	X0327039	TEMPORARY ACCESS ROAD (SPECIAL)	L SUM	1	1	
* SP	X2600003	PUNCHED SIGN POST - DRILL MOUNT	EACH	62		62
* SP	X2600007	REMOVE AND SALVAGE SIGN PANEL	EACH	2		2
SP	X4240430	PORTLAND CEMENT CONCRETE SIDEWALK 5 INCH, SPECIAL	SQFT	1550		1550
SP	X4240800	DETECTABLE WARNINGS (SPECIAL)	SQ FT	388		388
SP	X4400500	COMBINATION CURB AND GUTTER REMOVAL (SPECIAL)	FOOT	150	150	
SP	X4401198	HOT-MIX ASPHALT SURFACE REMOVAL, VARIABLE DEPTH	SQ YD	670	670	
SP	X4403700	MEDIAN REMOVAL (SPECIAL)	SQFT	520	520	
SP	X4404400	PAVEMENT REMOVAL (SPECIAL)	SQ YD	630	630	
SP	X4404700	SIDEWALK REMOVAL (SPECIAL)	SQFT	1680		1680
SP	X6061005	CONCRETE CURB, TYPE B (SPECIAL)	FOOT	1420		1420
SP	X6061700	COMBINATION CONCRETE CURB AND GUTTER, TYPE B (SPECIAL)	FOOT	150	150	
SP	X6065760	CONCRETE MEDIAN SURFACE, 8"	SQFT	3830		3830
SP	X7010216	TRAFFIC CONTROL AND PROTECTION, (SPECIAL)	L SUM	1	1	
* SP	X7200105	SIGN PANEL - TYPE 1 (SPECIAL)	SQFT	325		325
* SP	XX001532	PROJECT SIGN	EACH	4		4
SP	XX009093	PORTLAND CEMENT CONCRETE ADA RAMP 5 INCH	SQFT	815		815
SP	xx609694	PORTLAND CEMENT CONCRETE ADA RAMP 8 INCH	SQFT	655		655

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 ⁻ DENOTES SPECIALTY ITEMS
SP - DENOTES SPECIAL PROVISION



EXISTING TYPICAL SECTION (LOOKING EAST)

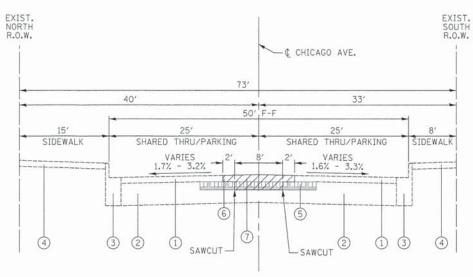
CHICAGO AVENUE AND PINE AVENUE CHICAGO AVENUE AND LOTUS AVENUE CHICAGO AVENUE AND LOCKWOOD AVENUE CHICAGO AVENUE AND LATROBE AVENUE

EXISTING LEGEND

- 1 HOT-MIX ASPHALT SURFACE TO REMAIN
- 2 PORTLAND CEMENT CONCRETE BASE COURSE TO REMAIN
- 3 COMBINATION CONCRETE CURB AND GUTTER TO REMAIN
- 4 CONCRETE SIDEWALK TO REMAIN
- 5 BURIED GRANITE STREETCAR TRACKS
- (6) HOT-MIX ASPHALT SURFACE REMOVAL, VARIABLE DEPTH (2.75" TO 3" DEPTH)
- (7) PAVEMENT REMOVAL (SPECIAL)




REMOVAL ITEMS

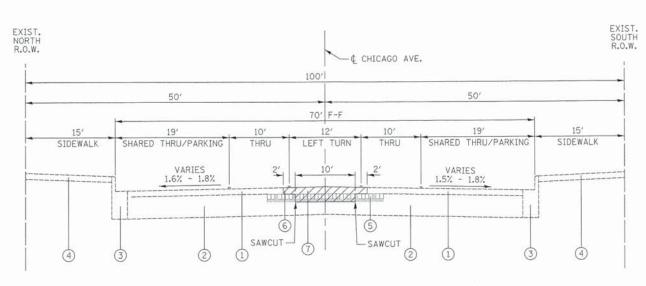

EXISTING TYPICAL SECTION
(LOOKING EAST)

CHICAGO AVENUE AND LAMON AVENUE

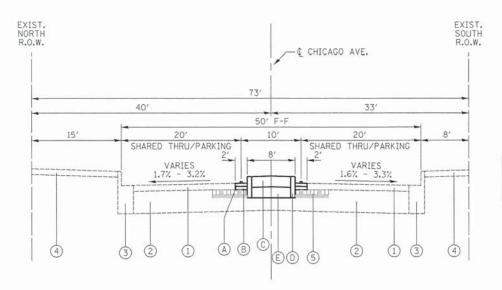


PROPOSED TYPICAL SECTION (LOOKING EAST)

CHICAGO AVENUE AND PINE AVENUE CHICAGO AVENUE AND LOTUS AVENUE CHICAGO AVENUE AND LOCKWOOD AVENUE CHICAGO AVENUE AND LATROBE AVENUE

PROPOSED LEGEND

- (A) HOT-MIX ASPHALT SURFACE COURSE, MIX "D", N70, 2"
- B LEVELING BINDER (HAND METHOD), N70 (DEPTH VARIES)
- C CONCRETE MEDIAN SURFACE, 8"
 (SEE DETAILS ON SHEETS 53 &54)
- (SEE DETAILS ON SHEETS 53 &54)
- E POROUS GRANULAR EMBANKMENT

NOTE: EXCAVATION SPOILS FROM CONSTRUCTION OF ADA RAMPS AT CHICAGO AVENUE/LOTUS AVENUE SHOULD BE PLACED BENEATH CONCRETE MEDIAN SURFACE, 8" REPLACING A PORTION OF THE POROUS GRANULAR EMBANKMENT.

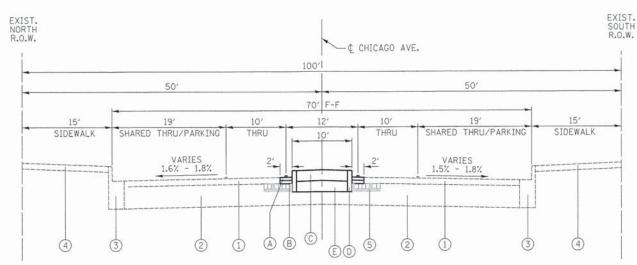

HMA MIXTURE REQUIREMENT

PAY ITEM	AIR VOIDS @ Ndes
HOT-MIX ASPHALT PAVEMENT	
HOT-MIX ASPHALT SURFACE COURSE, MIX "D", N70 (IL-9.5 mm) (2")	4% @ 70 GYR.
LEVELING BINDER (HAND METHOD), N70 (IL 9.5mm) (3/4" - 4 1/2")	4% @ 70 GYR.

OTES:


- 1. THE UNIT WEIGHT TO CALCULATE ALL HOT-MIX ASPHALT MIXTURES IS 112 LB/SY-IN.
- 2. THE "AC TYPE" FOR NON-POLYMERIZED HMA SHALL BE "PG 64-22" UNLESS MODIFIED BY DISTRICT ONE SPECIAL PROVISIONS.
- 3. FOR PERCENT OF RAP, SEE DISTRICT ONE SPECIAL PROVISIONS.

PROPOSED TYPICAL SECTION (LOOKING EAST) CHICAGO AVENUE AND LAMON AVENUE

CIVILTECH


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PLOT DATE = 1/19/2016	DATE - 01/22/16	REVISED -	

CHICAGO	WEST	SIDE	SAF	FR	OUTES	TO SCI	HOOL ENHANCEMENTS	F.A.U. RTE. 1398/ 1419A	SECTION	COUNTY	TOTAL	SHEET NO.
UIIIUAGU								1398/ 1419A	13-B3514-00-SW	COOK	67	7
	TYPI	CAL	SEC	HUI	15 - CI	HICAGO	AVENUE			CONTRACT	NO.	61C49
E: N.T.S	SHEET	1	OF	1	SHEETS	STA.	TO STA.	ILLINOIS FED. AID PROJECT				

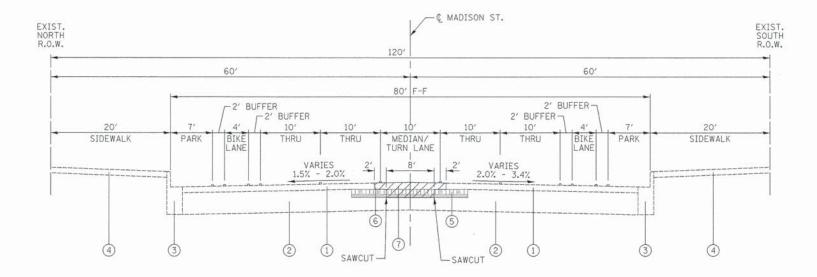

EXISTING TYPICAL SECTION
(LOOKING EAST)

MADISON STREET - ALL LOCATIONS

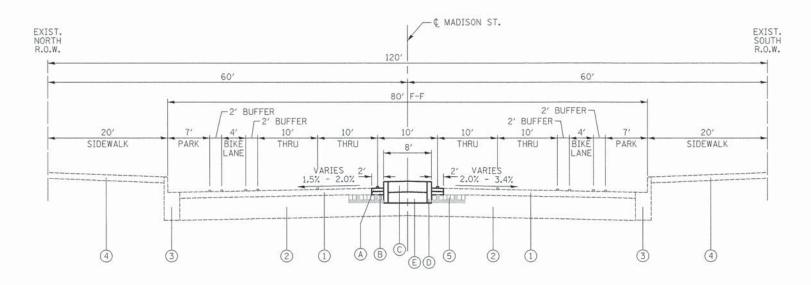

PROPOSED TYPICAL SECTION
(LOOKING EAST)

MADISON STREET - ALL LOCATIONS

EXISTING LEGEND

- 1 HOT-MIX ASPHALT SURFACE TO REMAIN
- 2 PORTLAND CEMENT CONCRETE BASE COURSE TO REMAIN
- 3 COMBINATION CONCRETE CURB AND GUTTER TO REMAIN
- 4 CONCRETE SIDEWALK TO REMAIN
- 5 BURIED GRANITE STREETCAR TRACKS
- 6 HOT-MIX ASPHALT SURFACE REMOVAL, VARIABLE DEPTH (2.75" TO 3" DEPTH)
- 7 PAVEMENT REMOVAL (SPECIAL)



PROPOSED LEGEND

- A HOT-MIX ASPHALT SURFACE COURSE, MIX "D", N70, 2"
- (B) LEVELING BINDER (HAND METHOD), N70 (DEPTH VARIES)
- C CONCRETE MEDIAN SURFACE, 8" (SEE DETAILS ON SHEETS 53 &54)
- (D) CONCRETE CURB, TYPE B, SPECIAL (SEE DETAILS ON SHEETS 53 &54)
- E POROUS GRANULAR EMBANKMENT

HMA MIXTURE REQUIREMENT

PAY ITEM	AIR VOIDS @ Ndes
HOT-MIX ASPHALT PAVEMENT	
HOT-MIX ASPHALT SURFACE COURSE, MIX "D", N70 (IL-9.5 mm) (2")	4% € 70 GYR.
LEVELING BINDER (HAND METHOD), N70 (IL 9.5mm) (3/4" - 4 1/2")	4% € 70 GYR.


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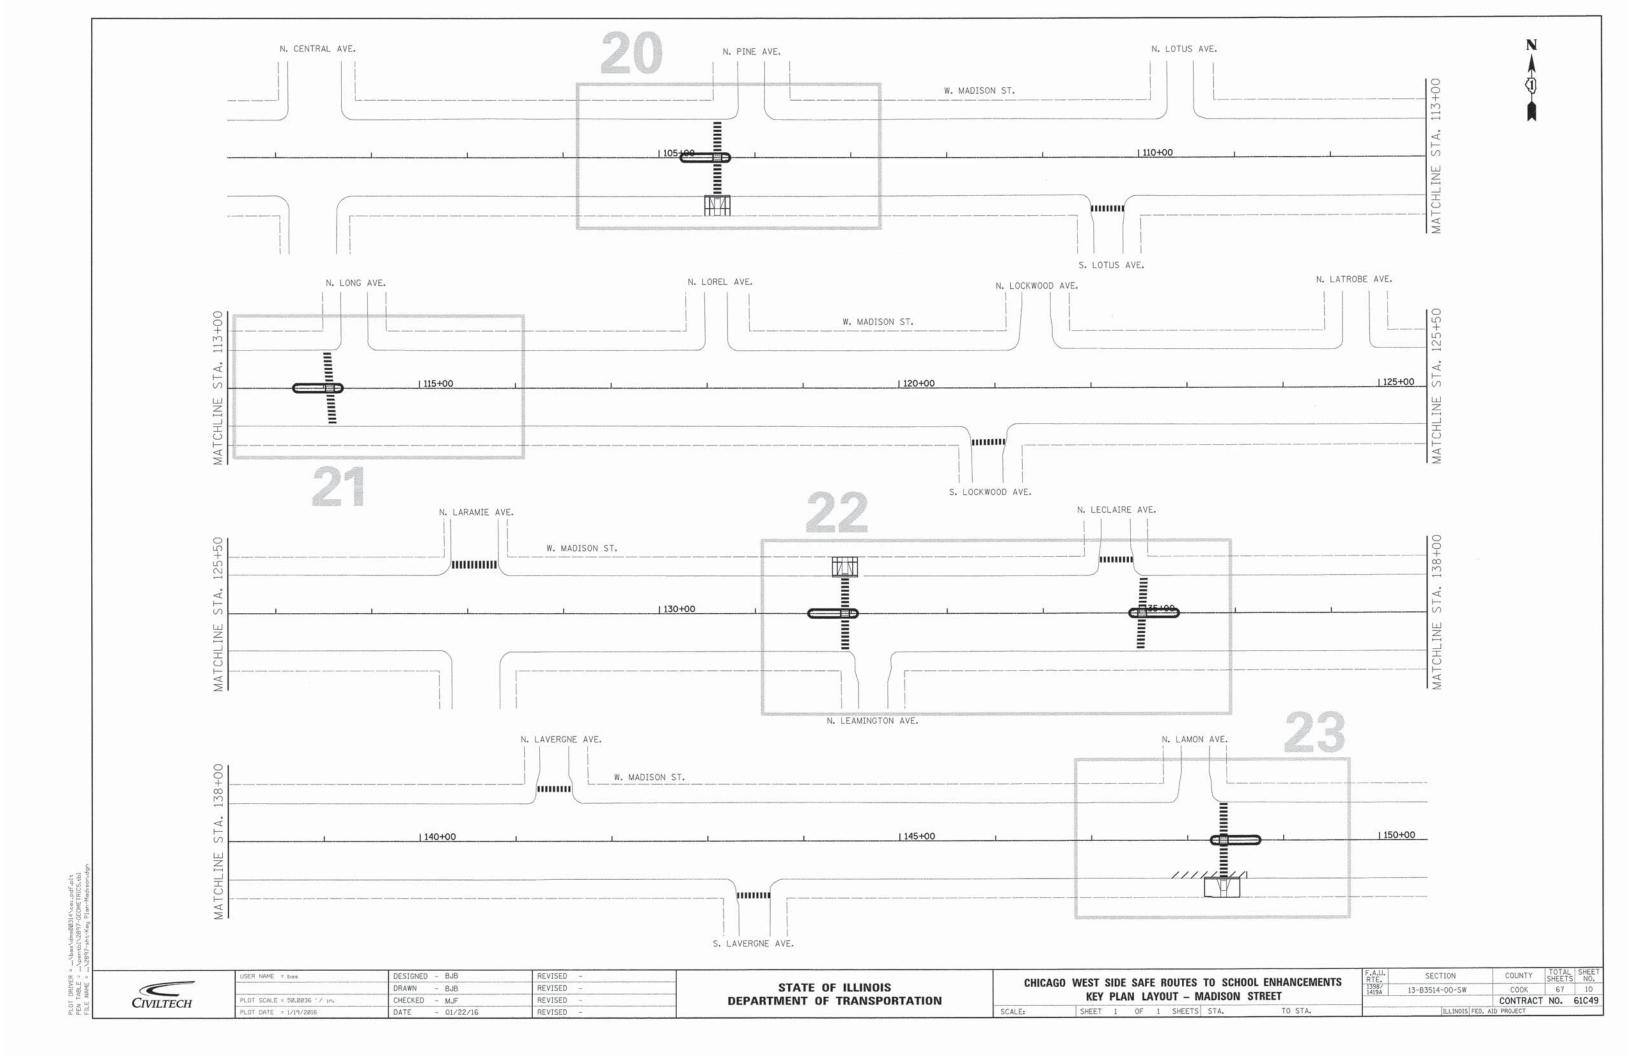
- 1. THE UNIT WEIGHT TO CALCULATE ALL HOT-MIX ASPHALT MIXTURES IS 112 LB/SY-IN.
- 2. THE "AC TYPE" FOR NON-POLYMERIZED HMA SHALL BE "PG 64-22" UNLESS MODIFIED BY DISTRICT ONE SPECIAL PROVISIONS.
- 3. FOR PERCENT OF RAP, SEE DISTRICT ONE SPECIAL PROVISIONS.




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PLOT DATE = 1/19/2016	DATE - 01/22/16	REVISED -	

	ILLINOIS	FED. AII	D PROJECT		
			CONTRACT	NO.	61C49
1398/ 1419A	13-B3514-00-SW		COOK	67	8
RTE.	SECTION		COUNTY	TOTAL	NO.



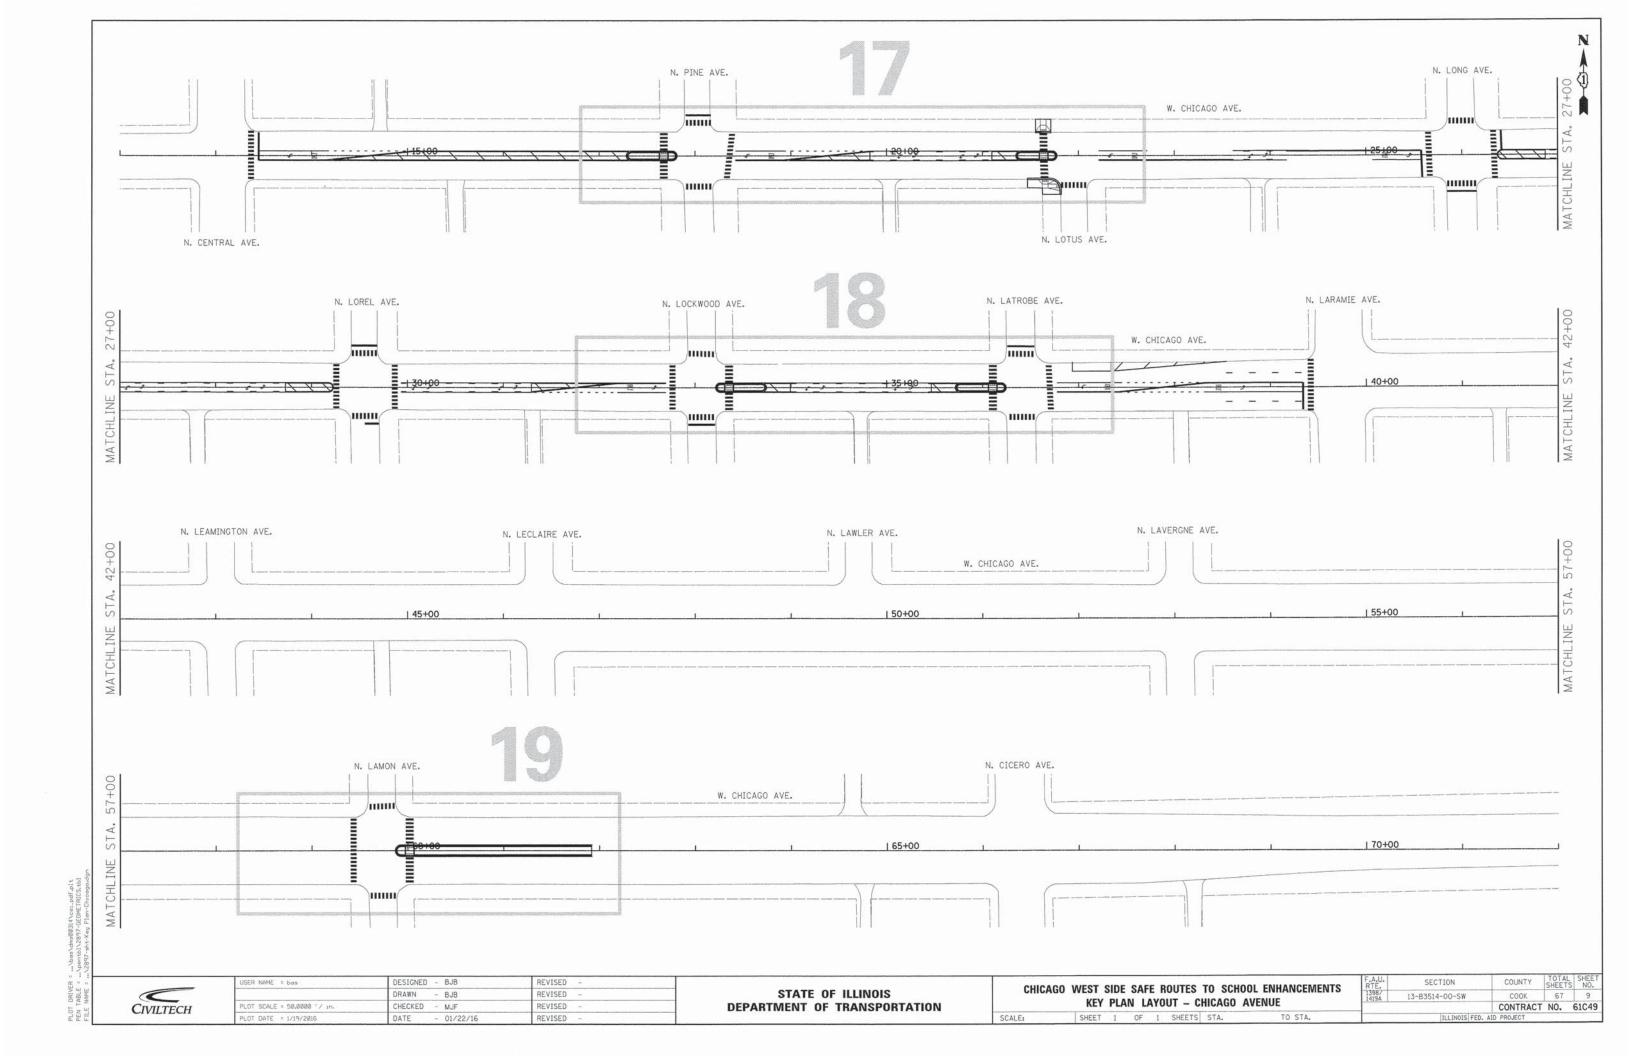

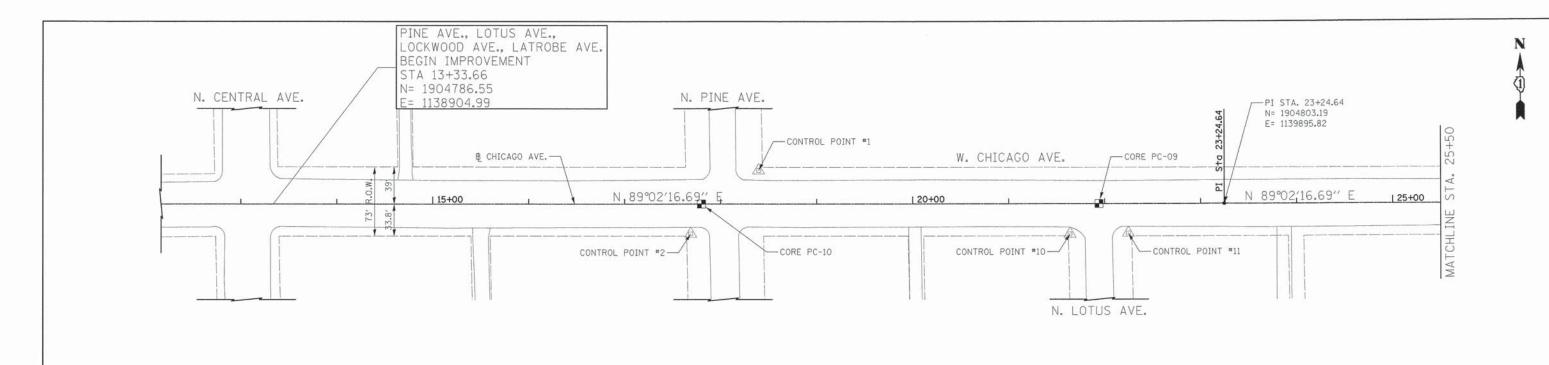

BENCHMARKS


BENCHMARK	NORTHING	EASTING	ELEV	DESCRIPTION				
BM #349	1897244.7	1144605.3	27. 987	11' NORTH OF SOUTH LINE OF W. CONGRESS PKWY. 4.7' WEST OF WEST LINE OF THE FIRST ALLEY EAST OF CICERO A				
BM #398	1905193.1	1144042.3	28. 237	11' NORTH OF SOUTH LINE OF RICE ST. 6.5'EAST OF EAST LINE OF THE FIRST ALLEY WEST OF CICERO AVE.				
BM #403	1904992.4	1138511.3	39. 383	8.8' EAST OF WEST LINE OF PARKSIDE AVE. 182' NORTH OF NORTH LINE OF CHICAGO AVE.				

LOT DATE = 1/19/2016

DATE

01/22/16


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SCALE: 1"=50" SHEET 1 OF 2 SHEETS STA. B.O.P.

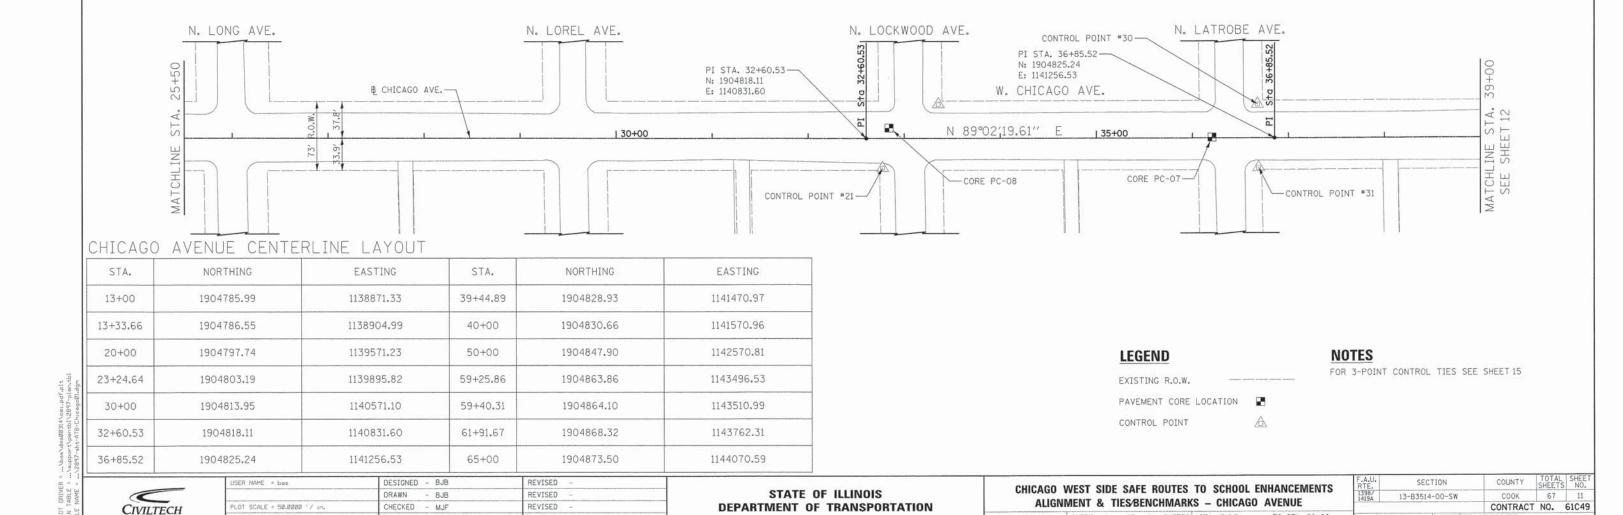
TO STA. 39+00

ILLINOIS FED. AID PROJECT



BENCHMARKS

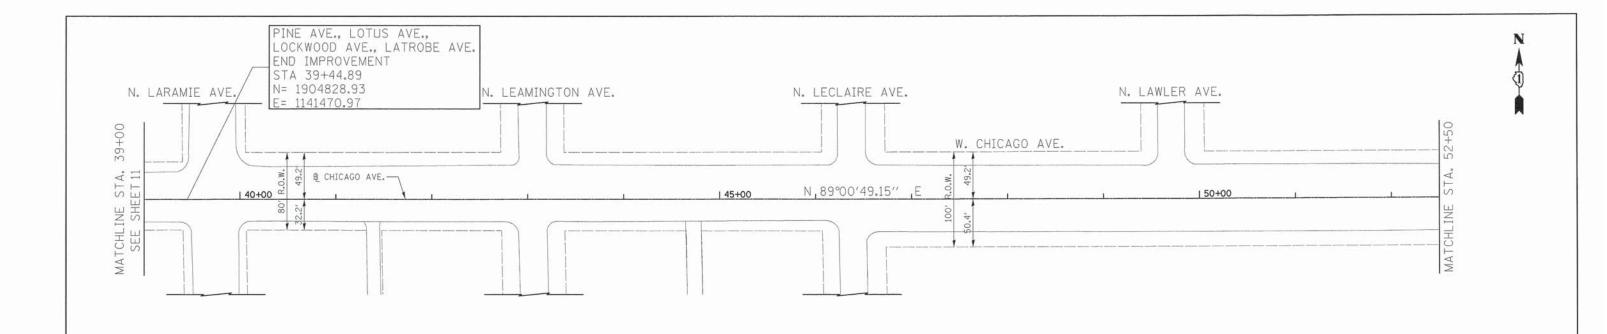BENCHMARK	NORTHING	EASTING	ELEV	DESCRIPTION				
BM #349	1897244.7	1144605.3	27.987	11' NORTH OF SOUTH LINE OF W. CONGRESS PKWY. 4.7' WEST OF WEST LINE OF THE FIRST ALLEY EAST OF CICERO A				
BM #398	1905193.1	1144042.3	28. 237	11' NORTH OF SOUTH LINE OF RICE ST. 6.5' EAST OF EAST LINE OF THE FIRST ALLEY WEST OF CICERO AVE.				
BM #403	1904992.4	1138511.3	39.383	8.8' EAST OF WEST LINE OF PARKSIDE AVE. 182' NORTH OF NORTH LINE OF CHICAGO AVE.				

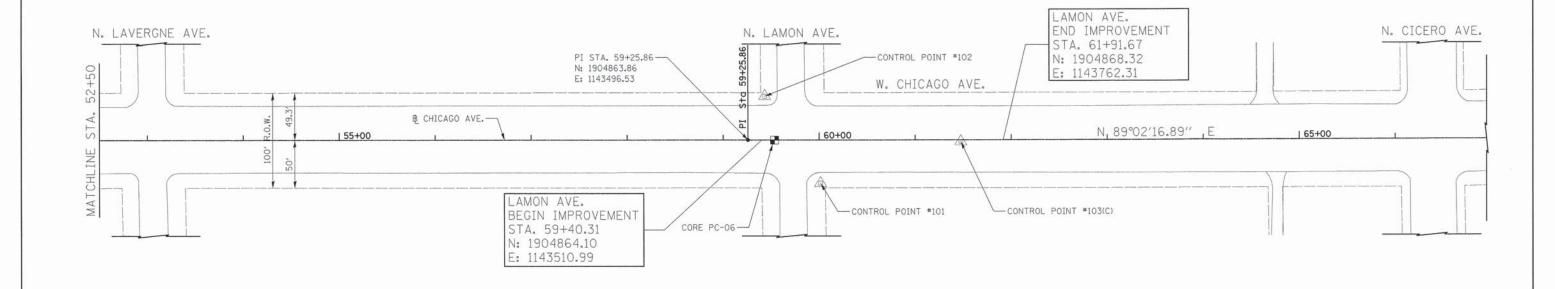

STATE OF ILLINOIS

LEGEND

NOTES

FOR 3-POINT CONTROL TIES SEE SHEET 15

EXISTING R.O.W.

PAVEMENT CORE LOCATION

CONTROL POINT

A

	USER NAME = bos
CIVILTECH	PLOT SCALE = 50.0000 ' / in.
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DESIGNED - BJB

CHECKED - MJF

01/22/16

DATE

REVISED

REVISED


REVISED

REVISED

DEPARTMENT OF TRANSPORTATION

CHICAGO WEST SIDE SAFE ROUTES TO SCHOOL ENHANCEMENTS ALIGNMENT & TIES/BENCHMARKS - CHICAGO AVENUE SCALE: 1"=50" SHEET 2 OF 2 SHEETS STA. 39+00 TO STA. E.O.P.


SECTION 13-B3514-00-SW CONTRACT NO. 61C49

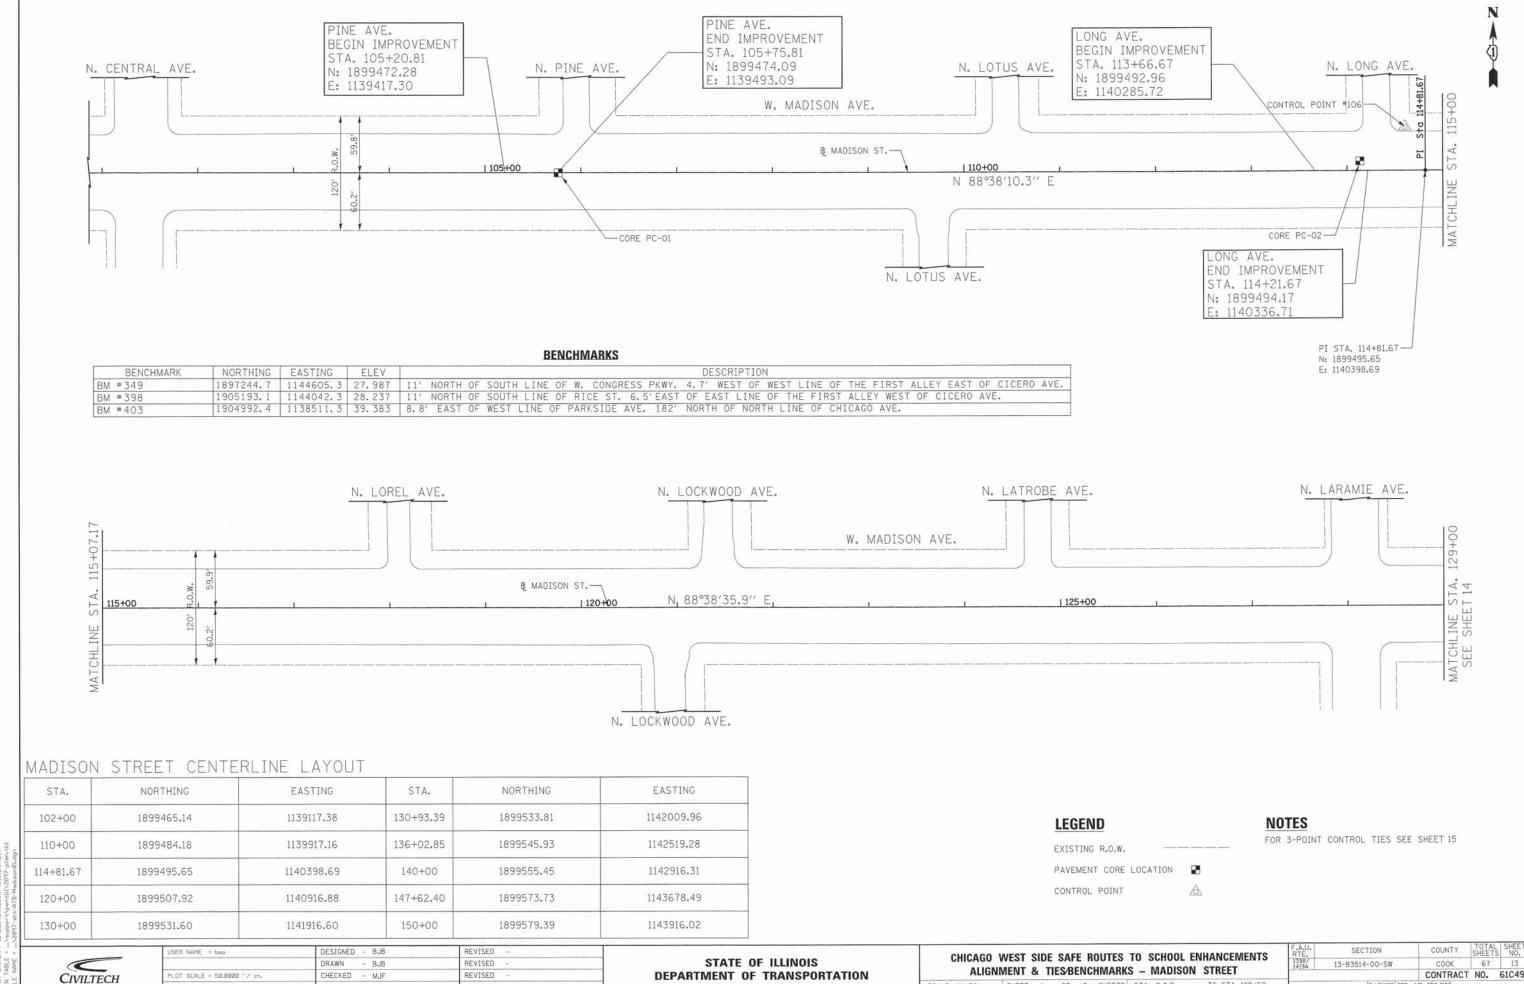

PLOT DATE = 1/19/2016 DATE 01/22/16 REVISED

SHEET 1 OF 2 SHEETS STA. B.O.P. TO STA. 129+50

CONTRACT NO. 61C49

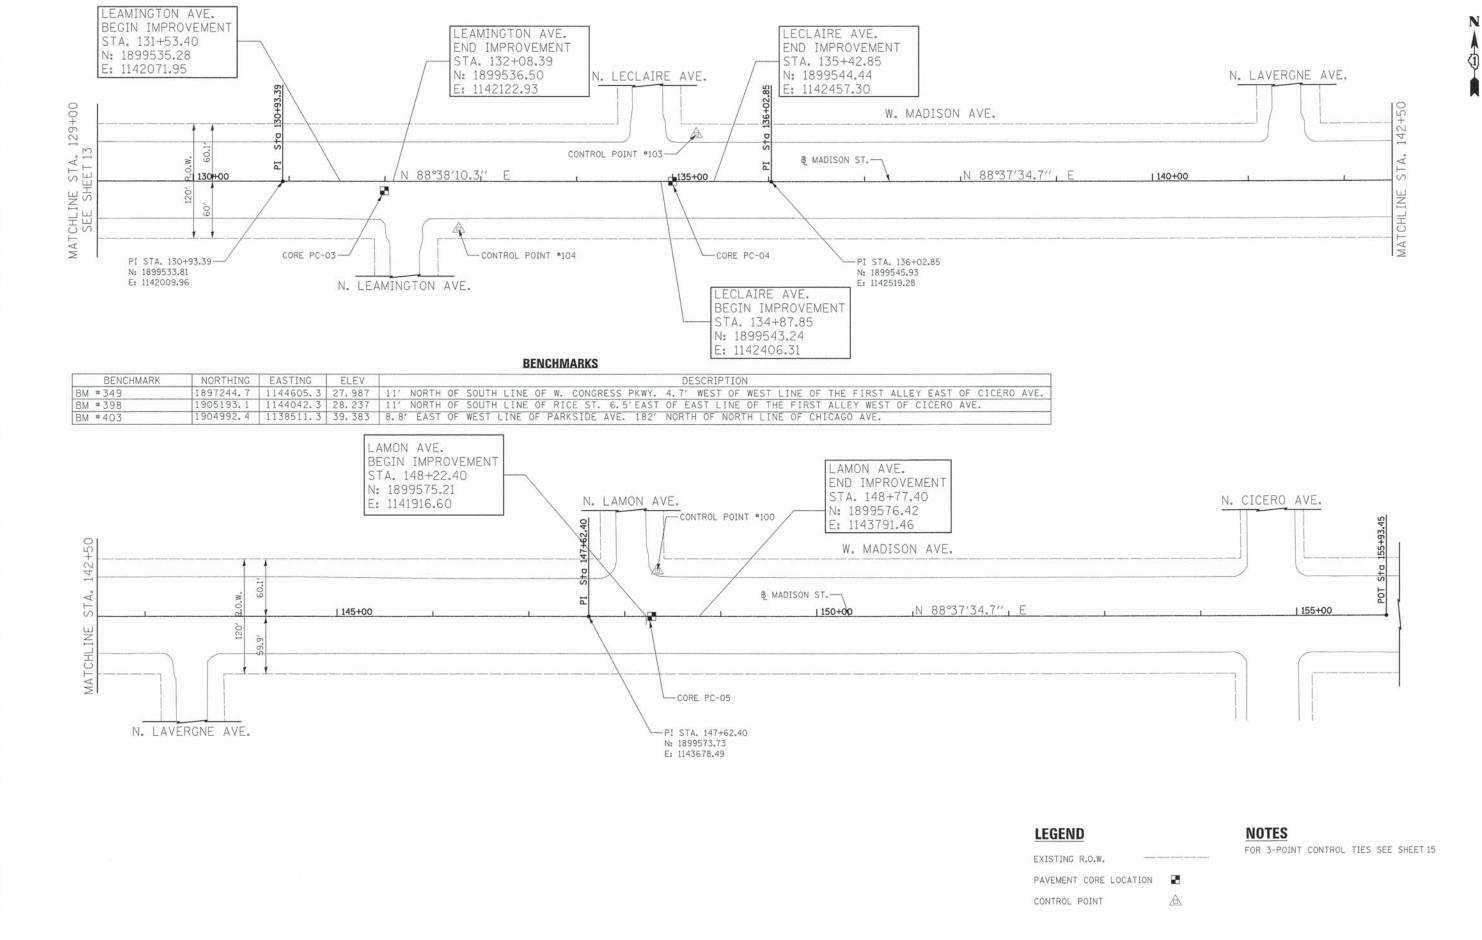

PEN TABLE : ...\support\pentbl\28 FILE NAME : ...\2897-sht-ATB-Mod

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 PLOT SCALE = 50.0000 1/ In.
 CHECKED - MJF
 REVISED


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 DATE - 01/22/16
 REVISED

STATE OF ILLINOIS
DEPARTMENT OF TRANSPORTATION


CHICAGO WEST SIDE SAFE ROUTES TO SCHOOL ENHANCEMENTS
ALIGNMENT & TIES/BENCHMARKS - MADISON STREET

1 1"=50" SHEET 2 OF 2 SHEETS STA. 126+50 TO STA. E.O.P.


ALL SECTION COUNTY TOTAL SHEETS NO. 398/ 13-B3514-00-SW COOK 67 14 CONTRACT NO. 61C49

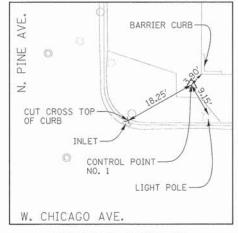

CONTROL POINT #1 N=1904830.26 E=1139410.20 EL=40.15

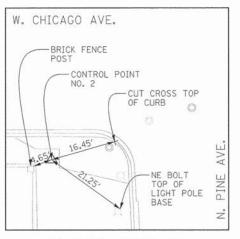


CONTROL POINT #2 N=1904762.39 E=1139340.52 EL=40.10

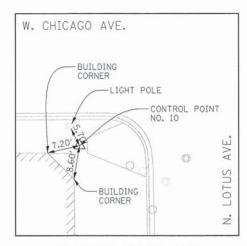


CONTROL POINT #10




CONTROL POINT #11 N=1904770.56 E=1139796.48 EL=38.13

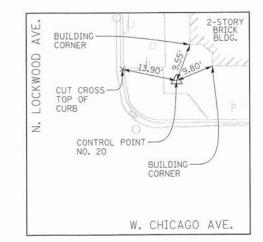


CONTROL POINT #20

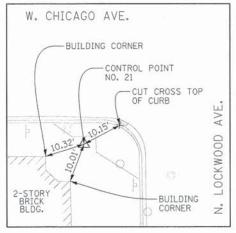


CONTROL POINT #21

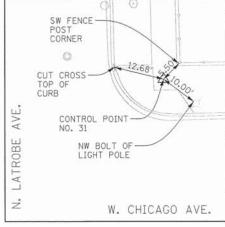

CONTROL POINT #30

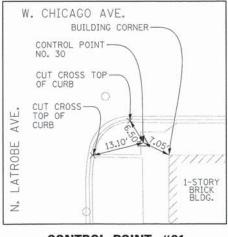


CONTROL POINT #31 N=1904793.98 E=1141240.49 EL=30.21

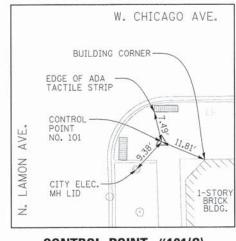


CONTROL POINT #101(C)




CONTROL POINT #102

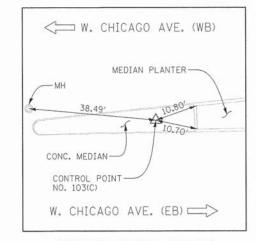


CONTROL POINT #103(C)

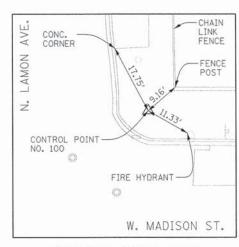



CONTROL POINT #100

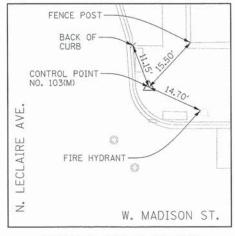

CONTROL POINT #103(M) N=1899592.74 E=1142413.56 EL=30.11

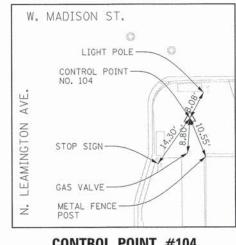

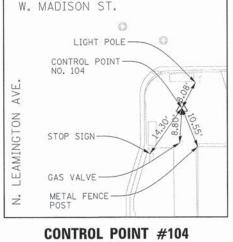

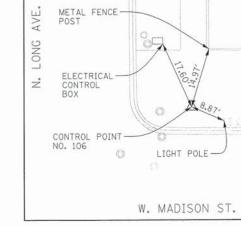

CONTROL POINT #106

CIVILTECH	


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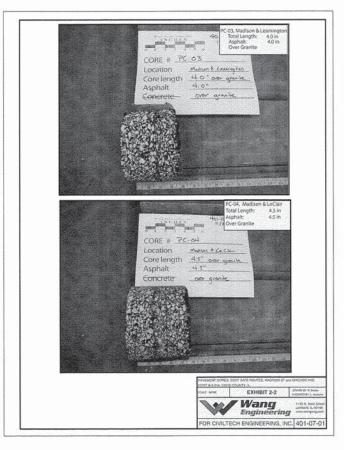
STATE OF ILLINOIS


	하는 얼마를 하게 하는 것이						ENHANCE CONTROL	
E: N.T.S.	SHEET	1	OF	1	SHEETS	STA.	TO STA	


	ILLINOIS FED	CONTRACT	NO.	61C49
1398/ 1419A	13-B3514-00-SW	COOK	67	15
F.A.U. RTE.	SECTION	COUNTY	TOTAL	SHEET NO.


DEPARTMENT OF TRANSPORTATION




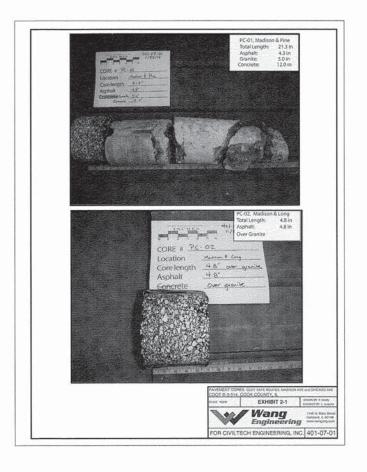

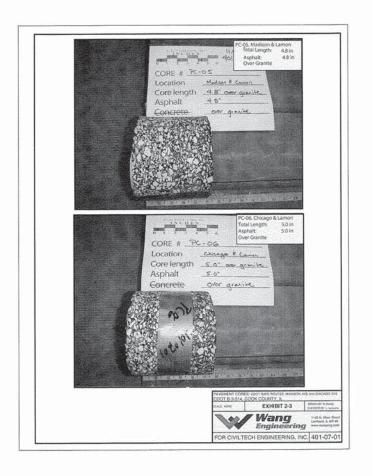

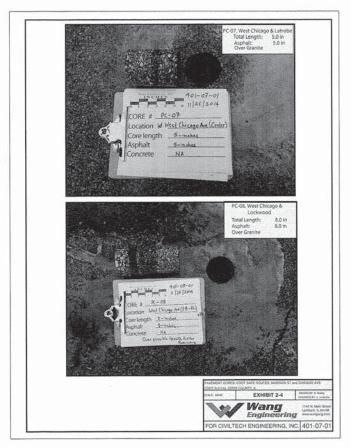

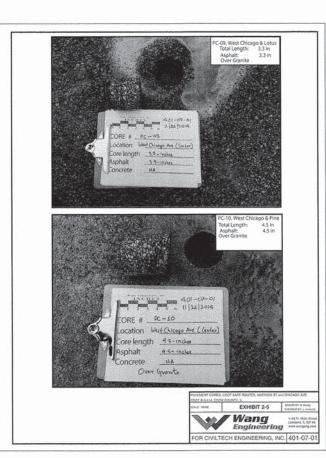

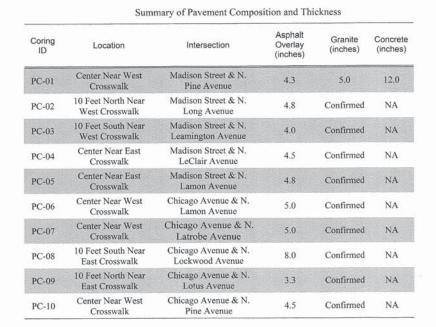


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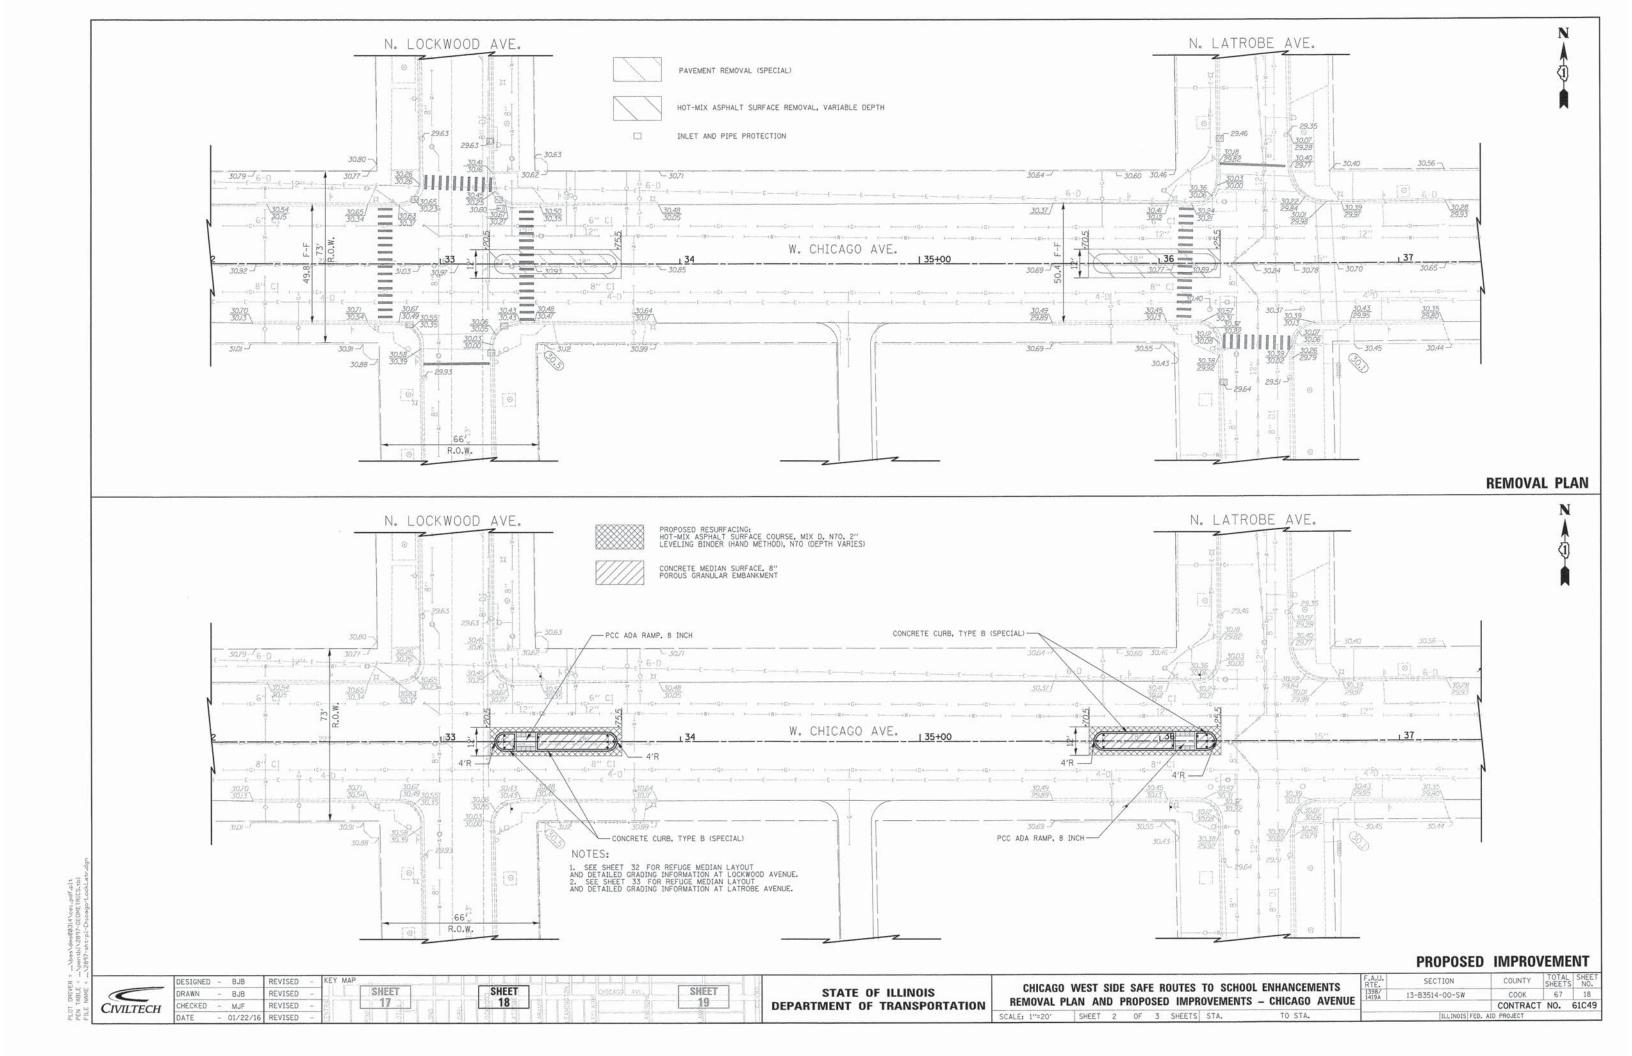
FOR PAVEMENT CORE LOCATIONS SEE SHEETS 11 THRU 14





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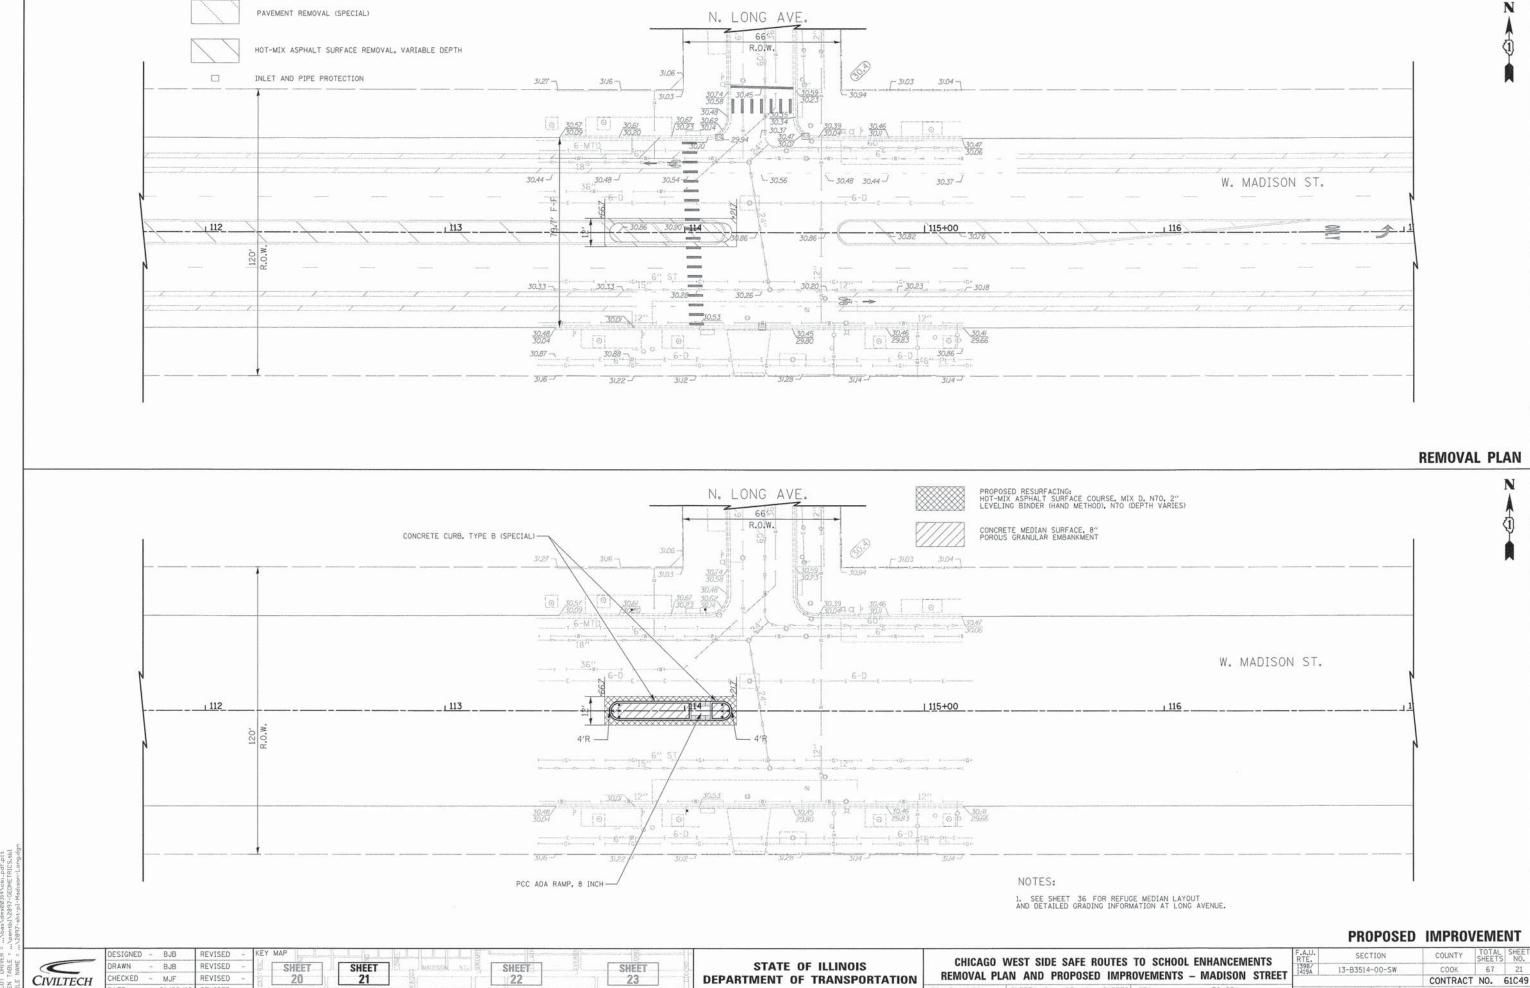
CHICACO	WEST	cine	CAE	E D	OUTES	TO SCHO	OL ENHANCEMENTS	F.A.U. RTE. 1398/ 1419A	SECTION	COUNTY	TOTAL	SHEET NO.
CHICAGO	MESI	SINE					OL ENHANCEMENTS	1398/ 1419A	13-B3514-00-SW	COOK	67	16
			P	AVE	MENT C	ORES				CONTRACT	NO.	61C49
SCALE: N.T.S	SHEET	1	OF	1	SHEETS	STA.	TO STA.		ILLINOIS FED.	AID PROJECT		





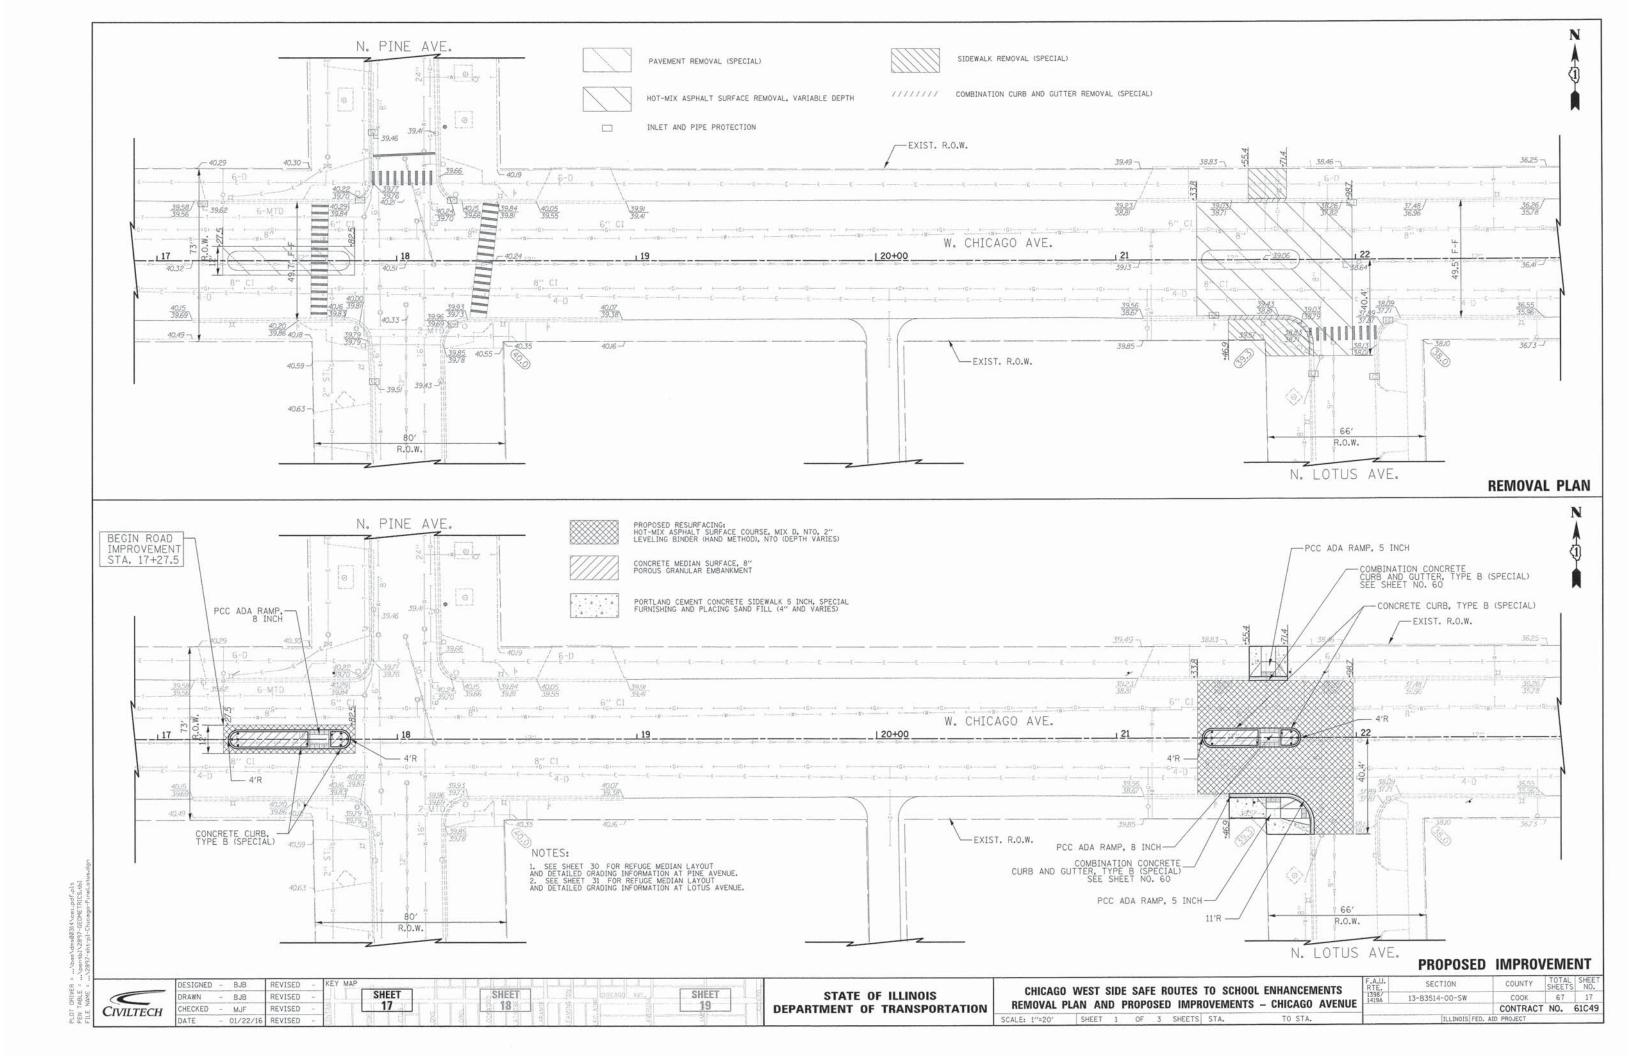

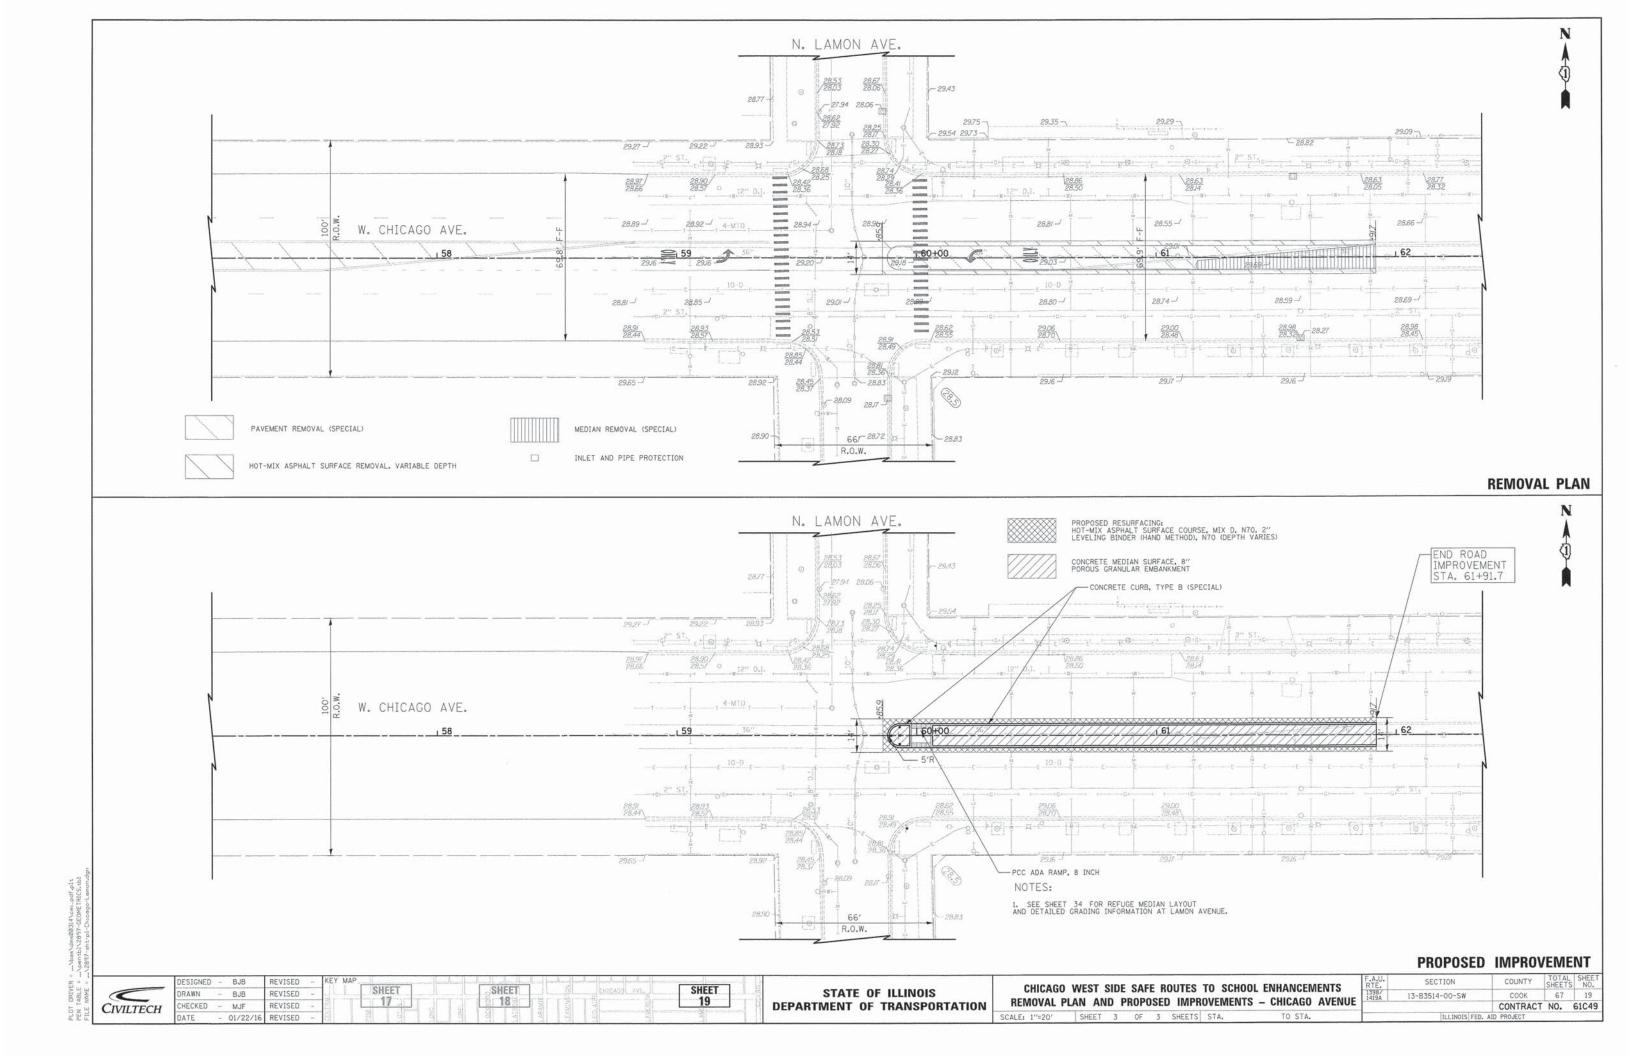

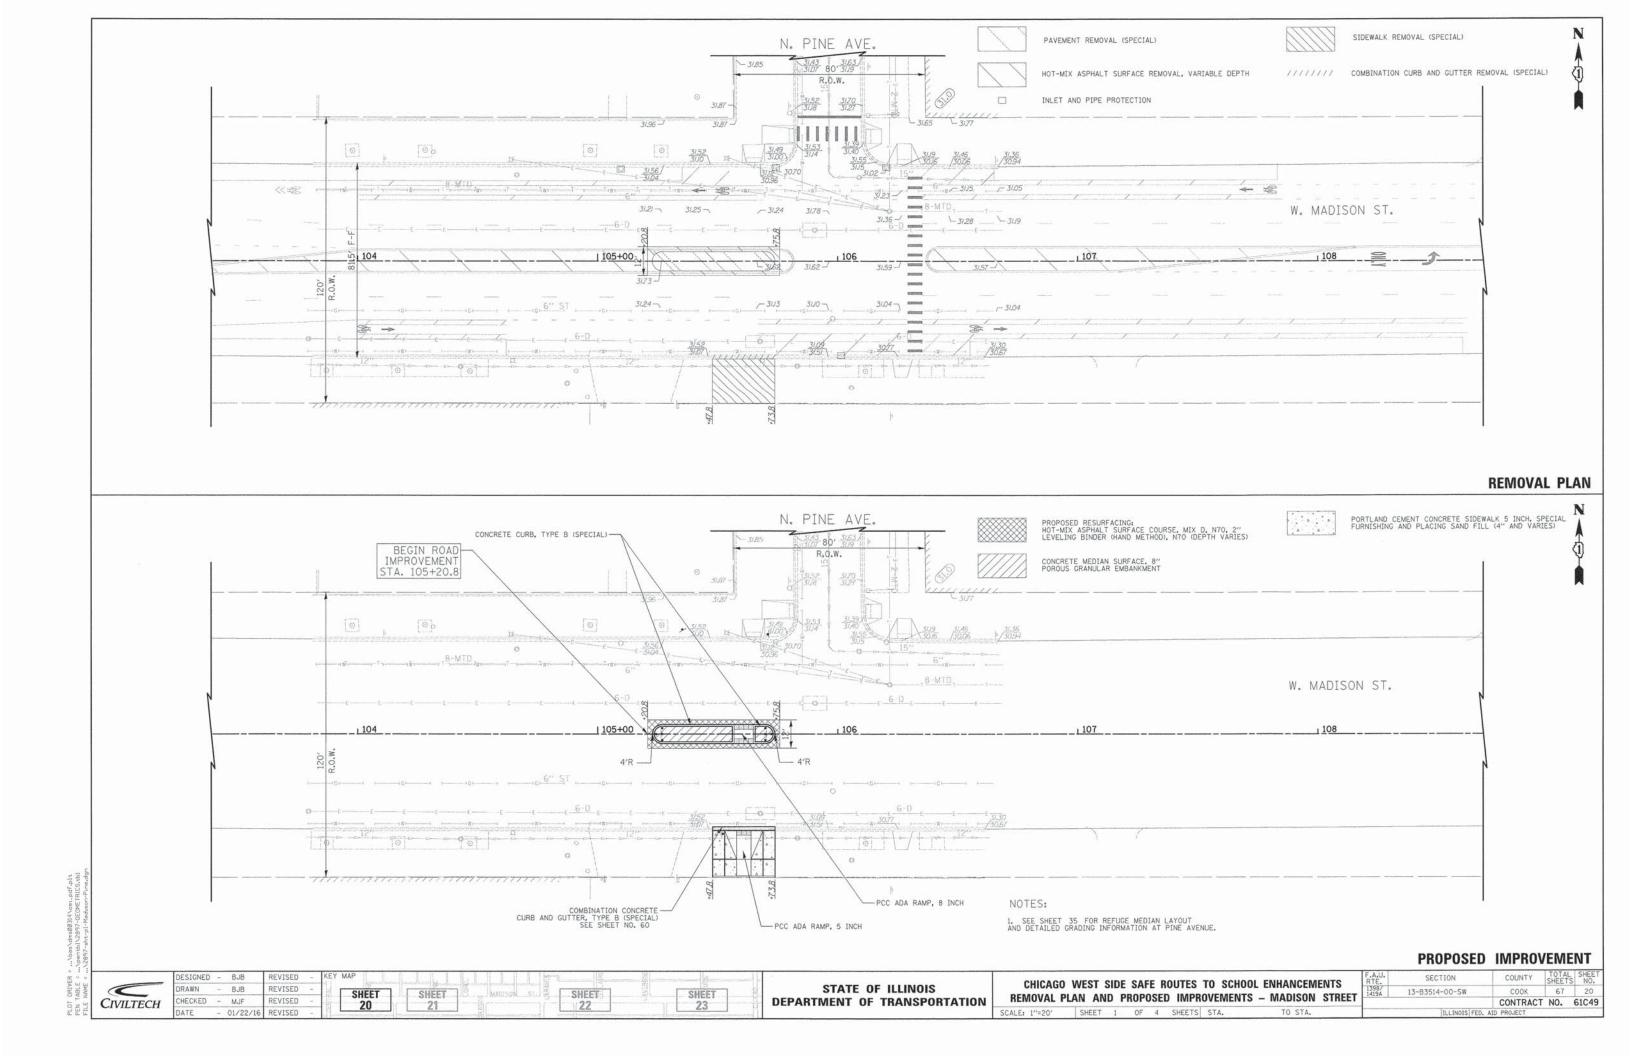



CHECKED - MJF REVISED 20 122

DEPARTMENT OF TRANSPORTATION

REMOVAL PLAN AND PROPOSED IMPROVEMENTS - MADISON STREET SCALE: 1"=20" SHEET 2 OF 4 SHEETS STA.

CONTRACT NO. 61C49

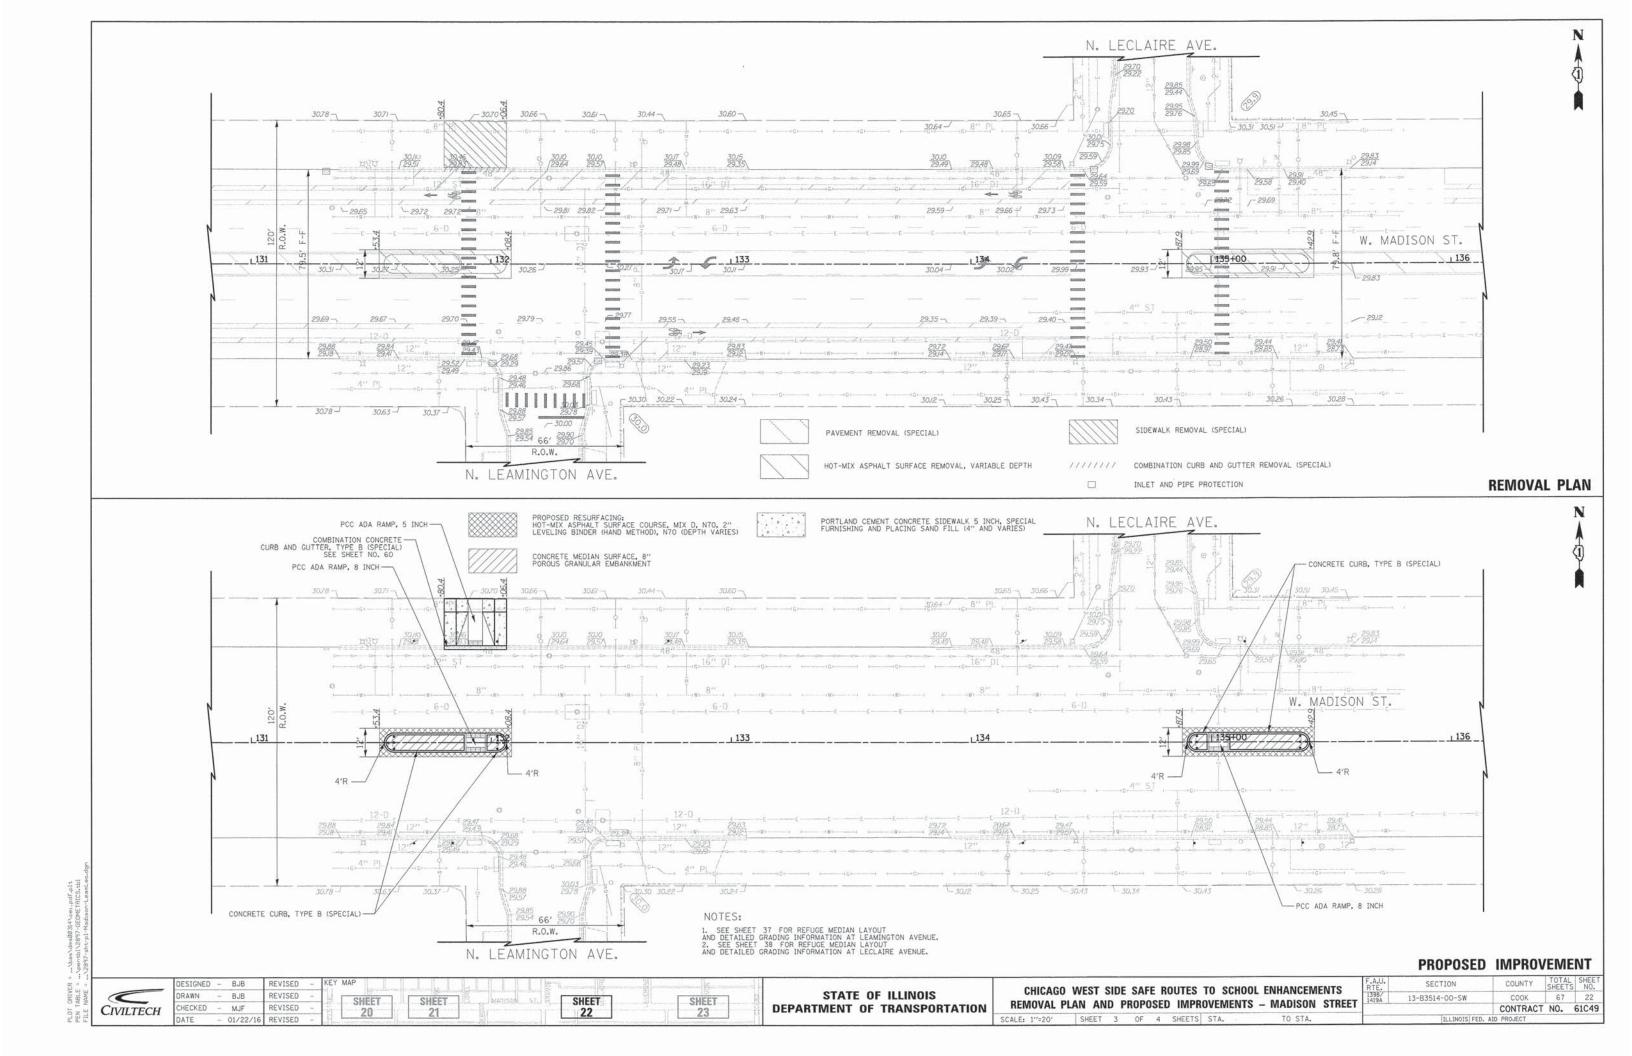

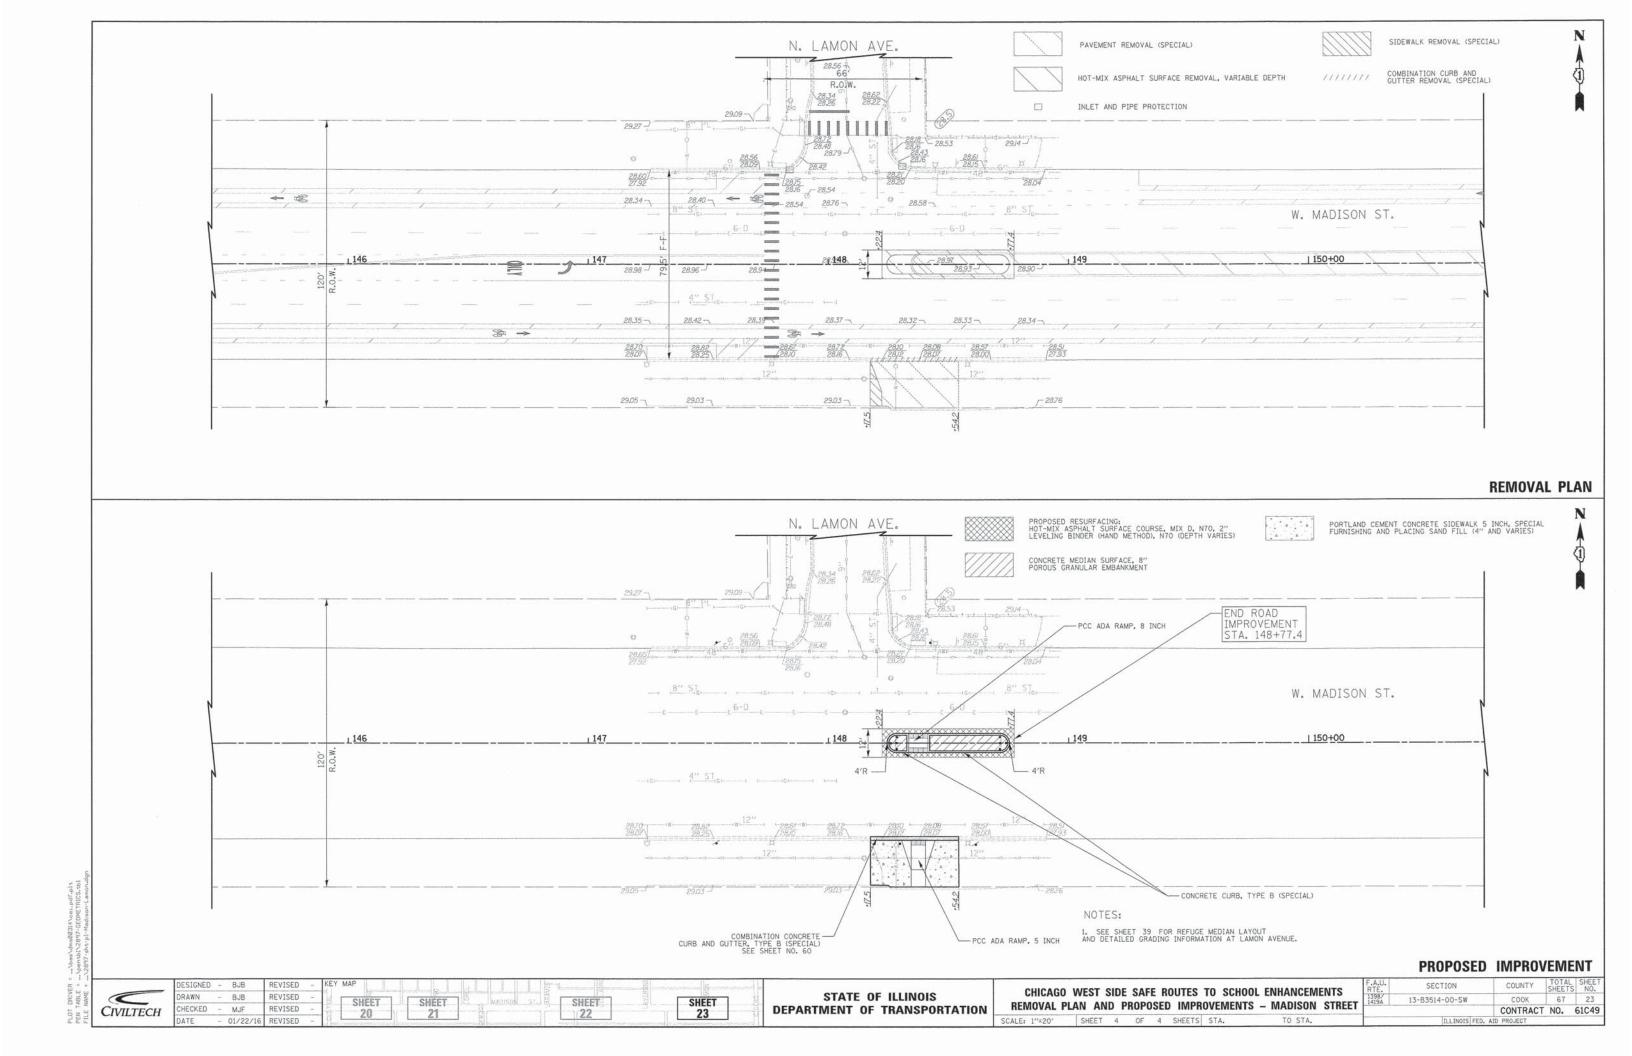

MAINTENANCE OF TRAFFIC NOTES


- 1. THE CONTRACTOR'S ATTENTION IS DIRECTED TO THE FACT THAT WHEN WORK COMMENCES, THE CONTRACTOR SHALL ASSUME THE MAINTENANCE OF ANY PAVEMENT, DRAINAGE FACILITIES, TRAFFIC CONTROL SIGNS, AND TRAFFIC WITHIN THE LIMITS OF THE CONTRACT. THE CONTRACTOR SHALL RETAIN THIS MAINTENANCE RESPONSIBILITY UNTIL THE CITY ASSUMES THE MAINTENANCE. ANY SNOW AND ICE CONTROL REQUIRED DURING THE CONSTRUCTION PERIOD SHALL BE PERFORMED BY OTHERS.
- A MINIMUM OF ONE THROUGH LANE MUST BE PROVIDED ON ALL SIDESTREETS. THE MAINTENANCE OF DRAINAGE FACILITIES, TRAFFIC CONTROL SIGNS, AND PAVEMENT MARKINGS SHALL BE CONSIDERED INCIDENTAL TO "TRAFFIC CONTROL AND PROTECTION (SPECIAL)".
- 3. DURING CONSTRUCTION OPERATIONS, THE CONTRACTOR SHALL TAKE THE NECESSARY PRECAUTIONS TO PROTECT ADJACENT TRAFFIC LANES OPEN TO TRAFFIC FROM DEBRIS BEING BLOWN OR OTHERWISE REMOVED FROM THE CONSTRUCTION AREAS. THE CONTRACTOR SHALL ALSO BE RESPONSIBLE FOR KEEPING DEBRIS OFF THE ADJACENT TRAVELED LANE SURFACE.
- 4. TEMPORARY TRAFFIC CONTROL SIGNS MUST BE INSTALLED AT THE DIRECTION AND UNDER THE SUPERVISION OF THE TRAFFIC MANAGEMENT AUTHORITY OF THE OFFICE OF EMERGENCY MANAGEMENT AND COMMUNICATION, SEVEN (7) DAYS NOTICE MUST BE GIVEN TO OEMC FOR DIRECTION OF SIGNING. THE CONTRACTOR SHALL COORDINATE THE MAINTENANCE OF TRAFFIC WITH THAT OF ADJACENT PROJECTS.
- 5. 24 In X 18 In "SIDEWALK CLOSED" (R11-I101) SIGNS SHALL BE INSTALLED AT LOCATIONS AS SHOWN ON THE PLANS OR AS DIRECTED BY THE TRAFFIC MANAGEMENT AUTHORITY OF THE OFFICE OF EMERGENCY MANAGEMENT AND COMMUNICATION OR THE COMMISSIONER, THIS COST SHALL BE INCLUDED IN THE COST OF "TRAFFIC CONTROL AND PROTECTION (SPECIAL)". THE CONSTRUCTION STAGING SHALL BE COORDINATED TO MAINTAIN PEDESTRIAN ACCESS AT ALL TIMES WITH NO ADDITIONAL COST TO THE PROJECT.
- ADDITIONAL TRAFFIC CONTROL SIGNS MAY BE REQUIRED AS DIRECTED BY THE TRAFFIC MANAGEMENT AUTHORITY OF THE OFFICE OF EMERGENCY MANAGEMENT AND COMMUNICATION. ALL COSTS SHALL BE INCLUDED IN THE COST OF "TRAFFIC CONTROL AND PROTECTION (SPECIAL)".
- 7. ANY SIGNING WORK REQUIRED TO BE DONE BY THE TRAFFIC MANAGEMENT AUTHORITY OF THE OFFICE OF EMERGENCY MANAGEMENT AND COMMUNICATION CREWS WILL BE DONE AT A CHARGE PER SIGN AS PART OF THE CONSTRUCTION PERMIT FEE.
- 8. BEFORE CONSTRUCTION BEGINS, THE CONTRACTOR MUST WALK THROUGH THE JOB WITH THE AUTHORIZED REPRESENTATIVE OF THE CITY OF CHICAGO TO CONFIRM THE NUMBER OF STREET SIGNS.
- ALL TRAFFIC CONTROL SIGNS SHALL BE ACCORDING TO THE MANUAL ON UNIFORM TRAFFIC CONTROL DEVICES AND SHALL MEET WITH APPROVAL OF THE TRAFFIC MANAGEMENT AUTHORITY OF THE OFFICE OF EMERGENCY MANAGEMENT AND COMMUNICATION REGARDING LOCATION, TYPE, SIZE, NUMBER, AND DURATION.
- 10. TRAFFIC CONTROL SIGNS SHALL BE PLACED AS SHOWN ON THE PLANS OR AS OTHERWISE DIRECTED BY THE TRAFFIC MANAGEMENT AUTHORITY OF THE OFFICE OF EMERGENCY MANAGEMENT AND COMMUNICATION.
- 11. DRUMS WITH STEADY BURNING BI-DIRECTIONAL LIGHTS SHALL BE PLACED AT 50 FT CENTERS ON TANGENTS AND 25 FT CENTERS ON TAPERS AND CURVES, UNLESS OTHERWISE NOTED OR DIRECTED BY THE COMMISSIONER.
- 12. ALL LIGHTS SHALL MEET THE REQUIREMENTS FOR TYPE A LOW INTENSITY FLASHING LIGHTS IN ARTICLE 1106.02(d) OF THE STANDARD SPECIFICATIONS. ALL LIGHTS SHALL OPERATE DURING THE HOURS OF DARKNESS. ONLY LIGHTS THAT HAVE BEEN APPROVED BY THE ILLINOIS DEPARTMENT OF TRANSPORTATION SHALL BE USED.
- UNLESS OTHERWISE SPECIFIED BY THE COMMISSIONER, ALL TEMPORARY PAVEMENT MARKINGS SHALL BE PAINT.

- 14. TEMPORARY LETTERS AND SYMBOLS SHALL BE PLACED AS SHOWN ON THE PLANS OR DIRECTED BY THE COMMISSIONER. THIS WORK SHALL BE PAID FOR AS "TEMPORARY PAVEMENT MARKING - LETTERS AND SYMBOLS".
- 15. TEMPORARY PAVEMENT MARKINGS SHALL BE PLACED AS SHOWN ON THE PLANS OR DIRECTED BY THE COMMISSIONER. THIS WORK SHALL BE PAID FOR PER LINEAR FOOT AS "TEMPORARY PAVEMENT MARKING LINE 4", "TEMPORARY PAVEMENT MARKING LINE 24".

 STOP BARS SHALL BE 24-INCH WHITE.

 CROSSWALKS AND SOLID LANE LINES SHALL BE 6-INCH WHITE.

 SKIPDASH LANE LINES SHALL BE 4-INCH WHITE.
- 16. THE CONTRACTOR SHALL RESTORE THE EXISTING PAVEMENT MARKING DESTROYED DURING CONSTRUCTION AS DIRECTED BY THE COMMISSIONER. THIS WORK SHALL BE CONSIDERED INCIDENTAL TO "TRAFFIC CONTROL AND PROTECTION (SPECIAL)".
- 17. ANY EXISTING PAVEMENT MARKING THAT CONFLICTS WITH THE TEMPORARY PAVEMENT MARKING SHALL BE COVERED BY THE CONTRACTOR. THIS WORK WILL BE PAID FOR PER LINEAL FOOT AS "PAVEMENT MARKING BLACKOUT TAPE" OF THE APPLIED LINE WIDTH REQUIRED TO COVER THE EXISTING MARKINGS.
- LANE CLOSURES FOR ALL INTERSECTION IMPROVEMENTS SHALL BE IN ACCORDANCE WITH IDOT STANDARDS 701502 AND 701602.
- SIGNS BEYOND THE LIMITS OF CONSTRUCTION SHALL BE PROVIDED IN ACCORDANCE WITH IDOT STANDARD 701501.
- 20. FOR ADDITIONAL INFORMATION ON TRAFFIC CONTROL AND SIGNING, REFER TO THE IDOT STANDARDS REFERENCED IN THESE PLANS.
- THE COST OF ARROW BOARDS SHALL BE CONSIDERED INCIDENTAL TO "TRAFFIC CONTROL AND PROTECTION (SPECIAL)". CONTRACTOR MUST PROVIDE TOTAL NUMBER OF ARROW BOARDS AS DIRECTED BY THE COMMISSIONER.
- 22. THE CONTRACTOR WILL BE REQUIRED TO PROVIDE AND MAINTAIN ACCESS TO ALL PRIVATE AND COMMERCIAL PROPERTY WITHIN THE WORK AREAS DURING THE CONSTRUCTION PERIOD. THIS WORK SHALL BE PAID FOR AT THE CONTRACT UNIT PRICE PER LUMP SUM FOR "TEMPORARY ACCESS ROAD (SPECIAL)".
- 23. WHERE A HANDICAPPED PEDESTRIAN RAMP IS RESTRICTED DUE TO CLOSURE, TEMPORARY RAMPS SHOULD BE PROVIDED. THIS WORK WILL BE INCIDENTAL TO "TRAFFIC CONTROL AND PROTECTION (SPECIAL")".
- 24. DIMENSIONS SHOWN ON THESE PLANS MAY BE ADJUSTED TO FIT FIELD CONDITIONS AS DIRECTED BY THE ENGINEER. TRAVEL LANE WIDTHS SHALL BE A MINIMUM OF 10'.
- 25. THE CONTRACTOR MAY STAGE HIS CONSTRUCTION IN SEGMENTS FOR MORE EFFICIENT OPERATIONS. IF THE STAGING IS SEGMENTED THE SETUP OF THE TRAFFIC CONTROL DEVICES AT THE BEGINNINGS AND ENDS OF THE SEGMENT SHALL BE SIMILAR TO THAT SHOWN IN THE PLANS. THE CONTRACTOR SHALL NOT BE ENTITLED TO ANY ADDITIONAL COMPENSATION FOR REVISING THE SUGGESTED MAINTENANCE OF TRAFFIC PLANS.
- 26. THE CONTRACTOR SHALL MAINTAIN PEDESTRIAN ACCESS TO ALL PROPERTIES AT ALL TIMES DURING CONSTRUCTION. CONTRACTOR SHALL NOTIFY BUSINESS AND/OR BUILDING OWNER 48 HOURS PRIOR TO SIDEWALK REMOVAL. COORDINATE WITH PROPERTY OWNER DURING AVAILABLE WORKING HOURS. PROPERTY OWNER SHALL BE RESPONSIBLE FOR TRAFFIC CONTROL WITHIN PRIVATE PROPERTY LIMITS.

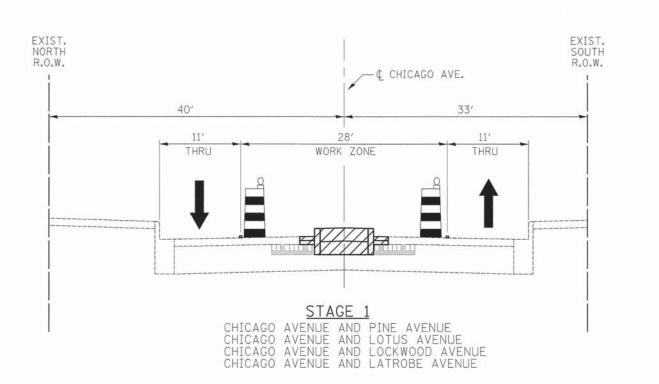

-CONSTRUCT CONCRETE REFUGE MEDIAN
-RESURFACE 2' OF PAVEMENT ADJACENT TO MEDIAN

EXIST. NORTH R.O.W.

50'


19'
SHARED THRU/PARKING

WORK ZONE

STAGE 1

CHICAGO AVENUE AND LAMON AVENUE

-CONSTRUCT CONCRETE REFUGE MEDIAN
-RESURFACE 2' OF PAVEMENT ADJACENT TO MEDIAN

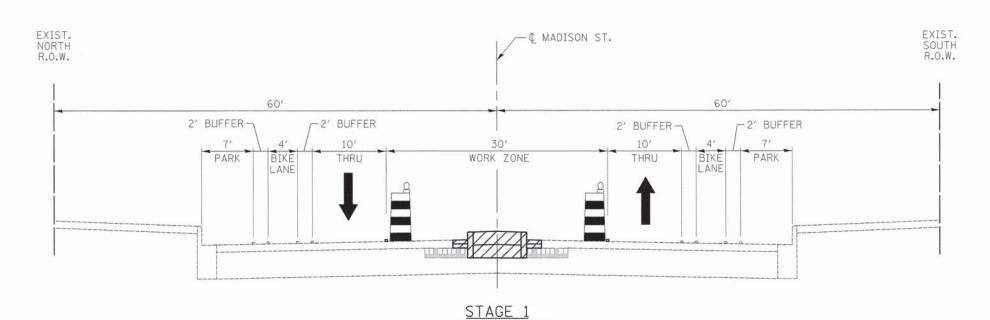


-CONSTRUCT CONCRETE REFUGE MEDIAN
-RESURFACE 2' OF PAVEMENT ADJACENT TO MEDIAN


MADISON STREET


CIVILTECH


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PLOT DATE = 1/19/2016	DATE - 01/22/16	REVISED -	

CHICAGO	WEST SIDE	CAFE	PULLES	TO SCHOO	L ENHANCEMENTS	F.A.U. RTE.	SECTION	COUNTY	TOTAL	SHEET NO.
CHICAGO						1398/ 1419A	13-B3514-00-SW	соок	67	25
	MAINTENAN	NCE U	FIRAFFIC	TYPICAL :	SECTIONS			CONTRACT	NO.	61C49
SCALE: N.T.S	SHEET 1	OF	1 SHEETS	STA.	TO STA.		ILLINOIS FED.	AID PROJECT		

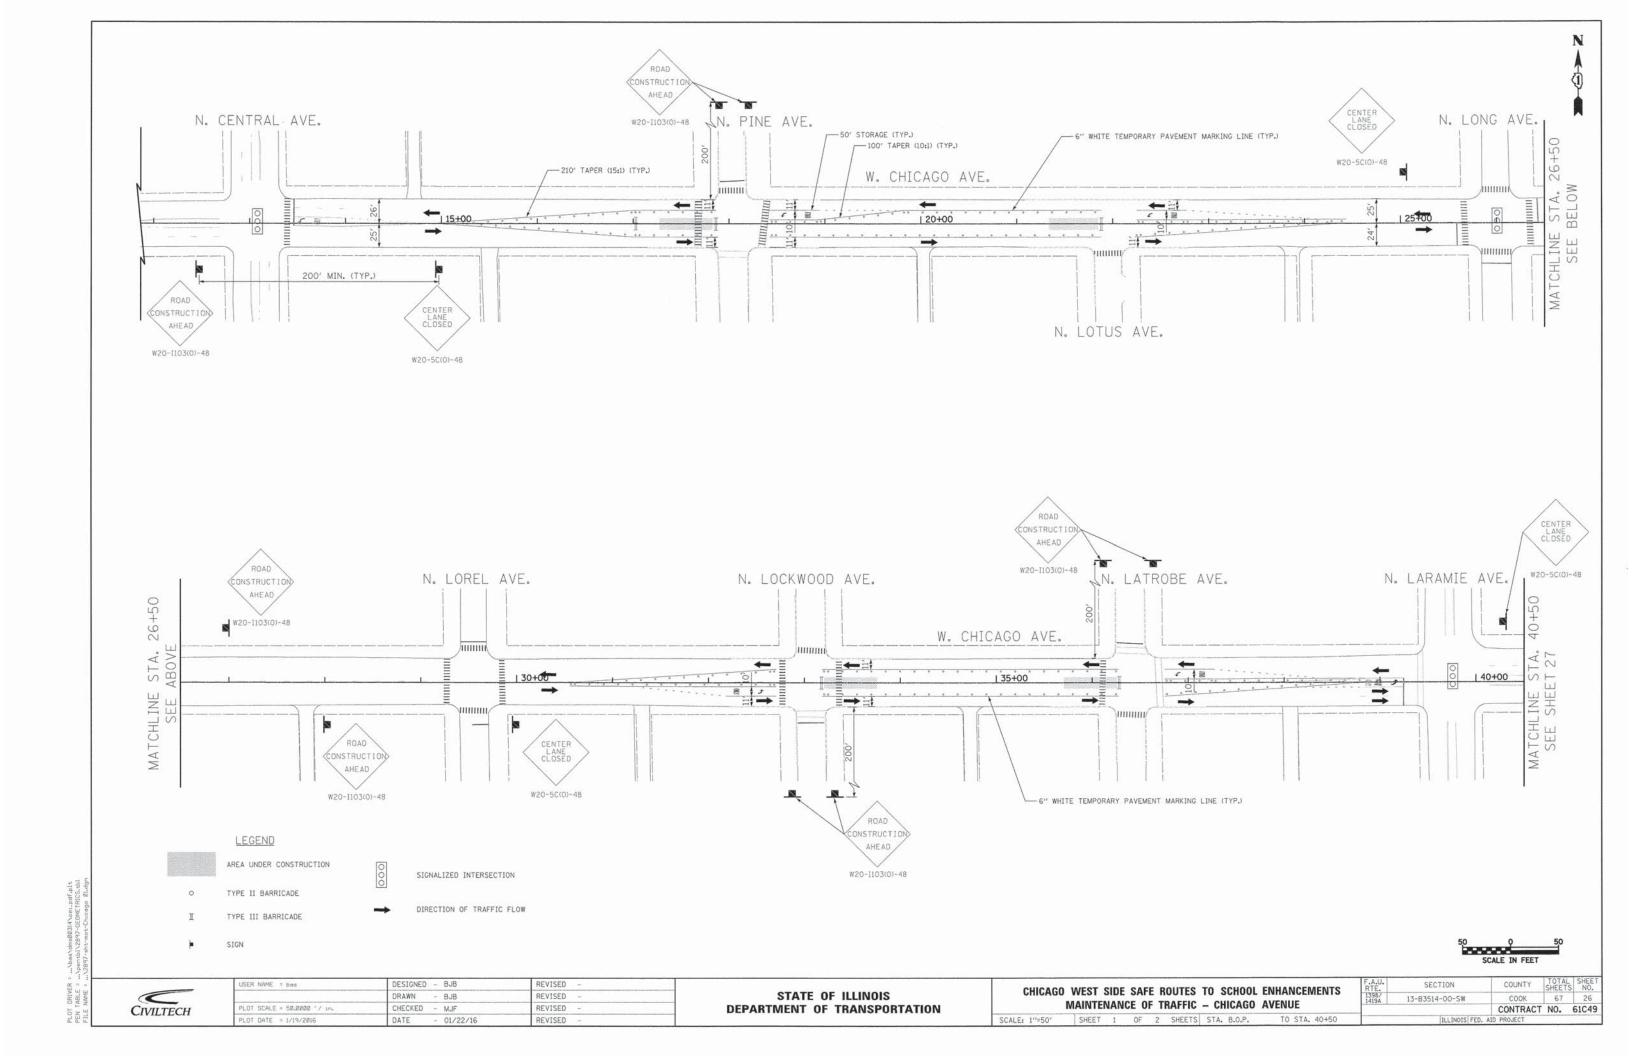

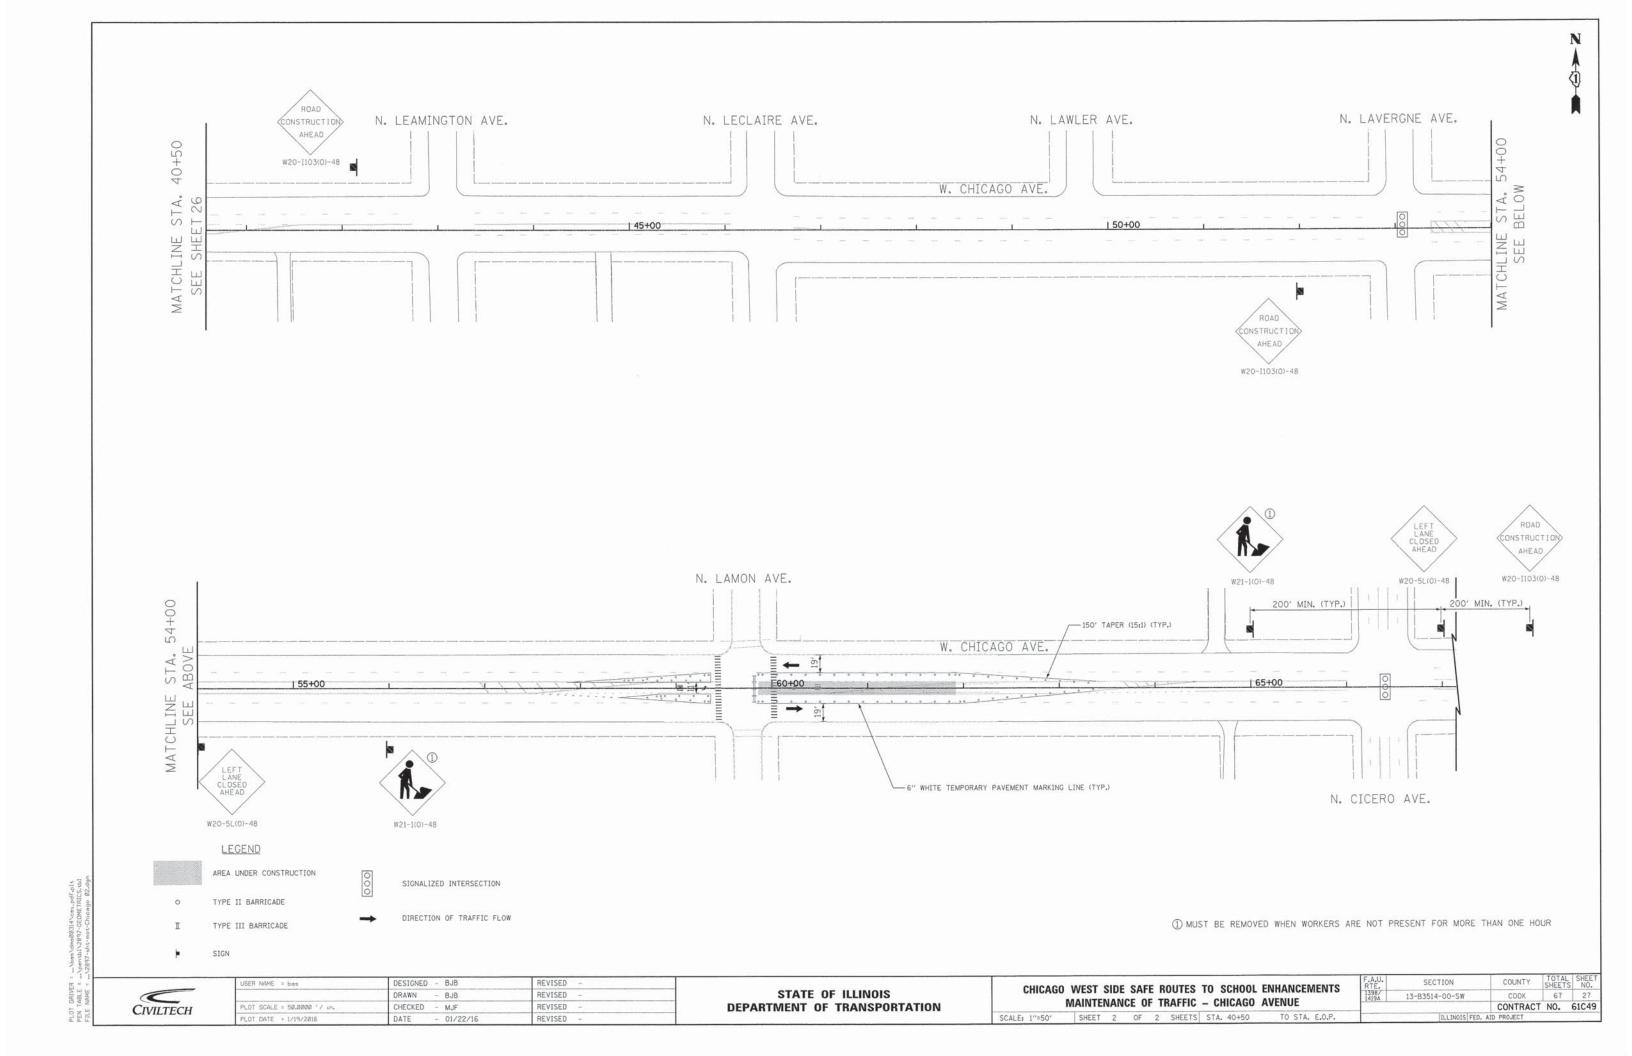


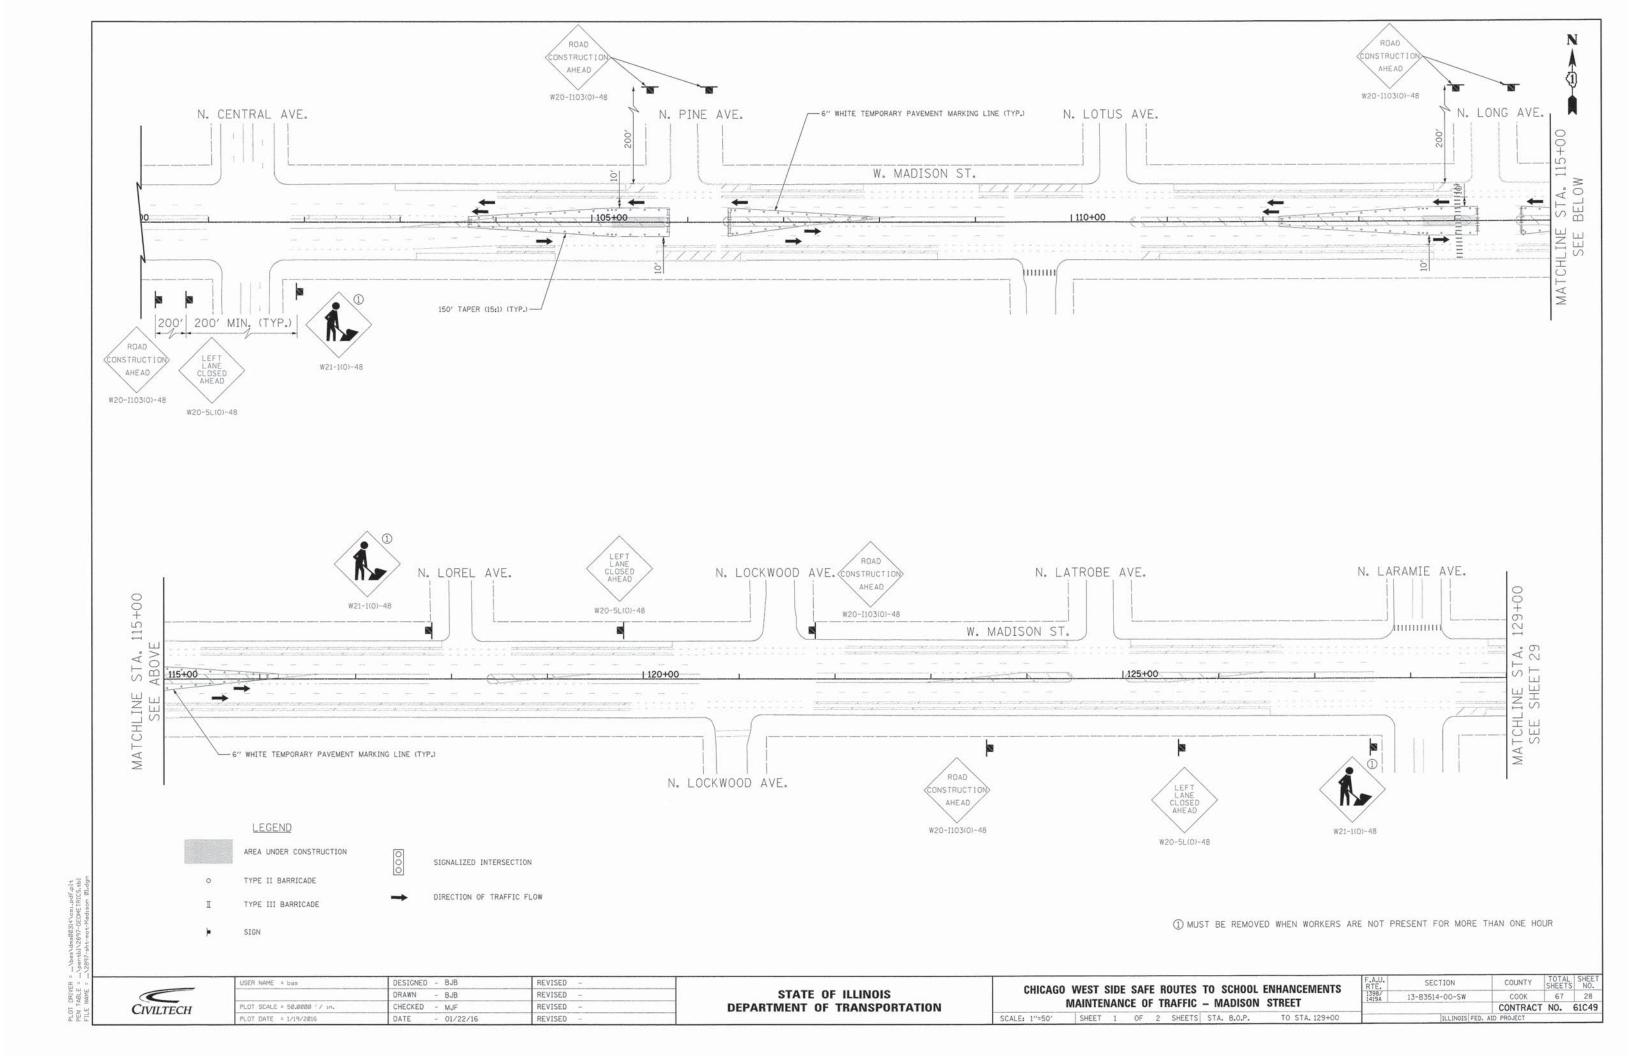

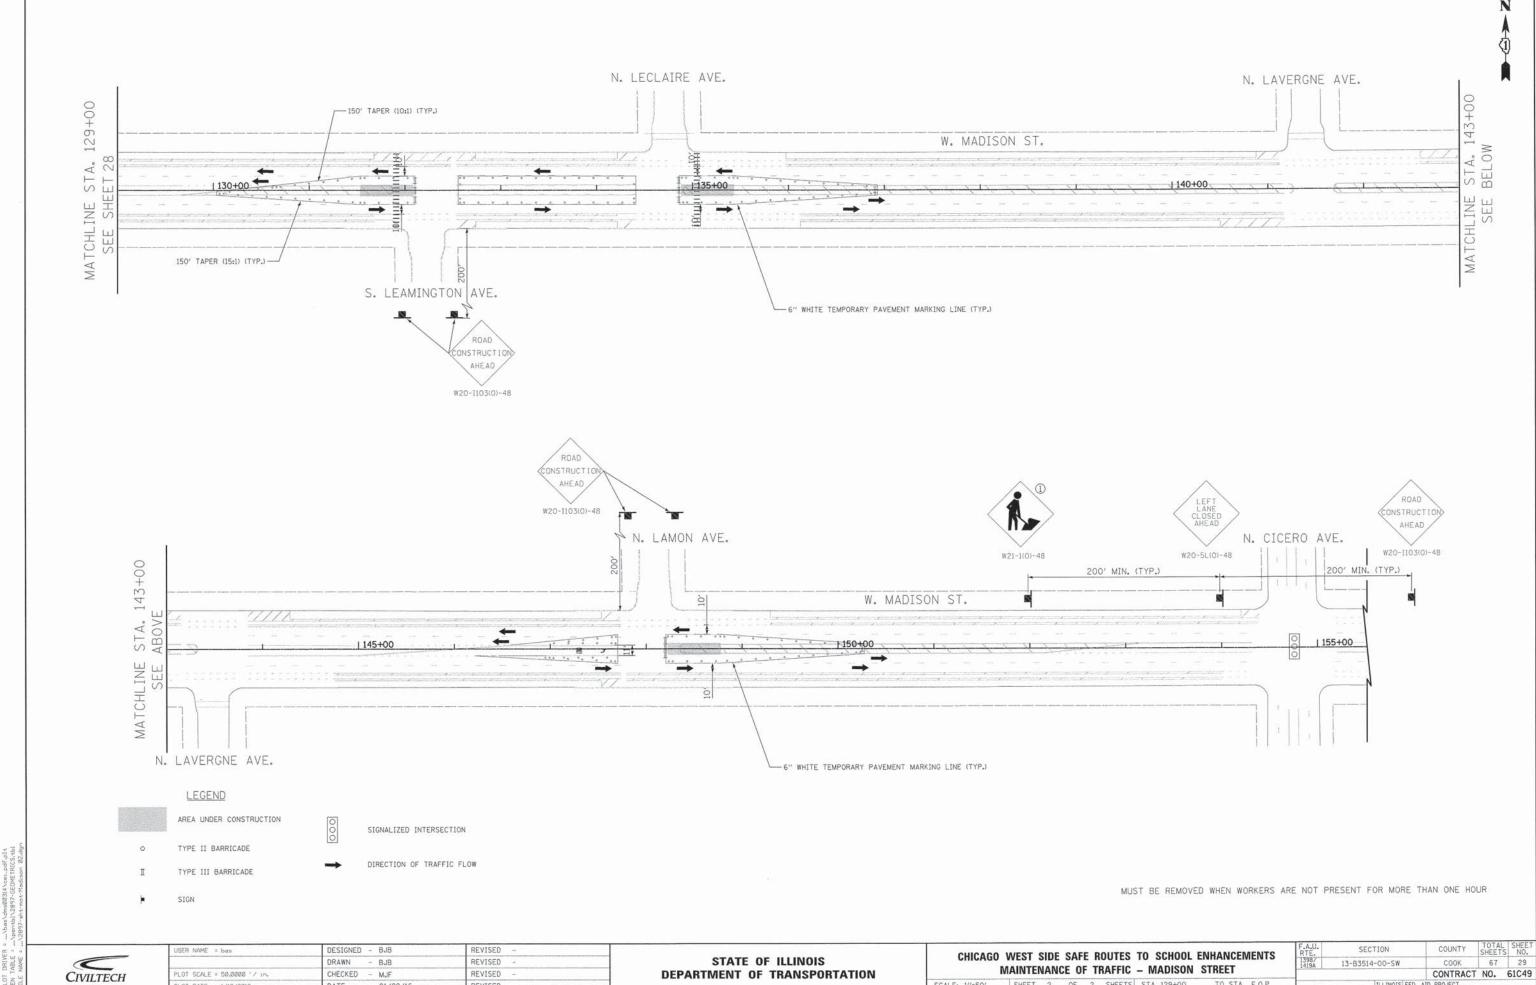

01/22/16

SCALE: 1"=50" SHEET 2 OF 2 SHEETS STA. 129+00 TO STA. E.O.P

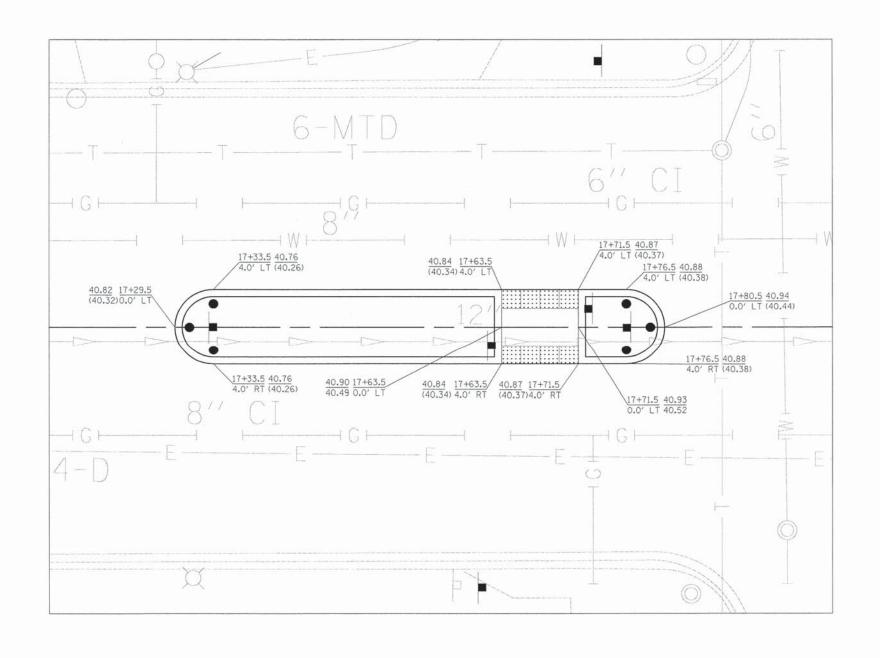

XX+XX.X

TOP OF MEDIAN / CURB ELEVATION FACE OF CURB ELEVATION

(XX.XX)

EXISTING ELEVATION


NOTE: SEE SHEET 53 FOR ADDITIONAL REFUGE MEDIAN LAYOUT INFORMATION.

CIVILTECH

USER NAME = bos	DESIGNED - BJB	REVISED -	
	DRAWN - BJB	REVISED -	
PLOT SCALE = 5.0000 '/ in.	CHECKED - MJF	REVISED -	
PLOT DATE = 1/19/2016	DATE - 01/22/16	REVISED -	

STATE OF ILLINOIS
DEPARTMENT OF TRANSPORTATION

	CHICAGO	WEST :	SIDE	SA	FE	ROUTES	TO S	CHOOL	ENHAN	ICEN	MENTS
	REFUGE	MEDIAN	N A	ND	SID	EWALK	LAYO	UT - C	HICAGO	&	PINE
SCALE:	1"=5"	SHEET	1	OF	1	SHEETS	STA.		TO	STA.	

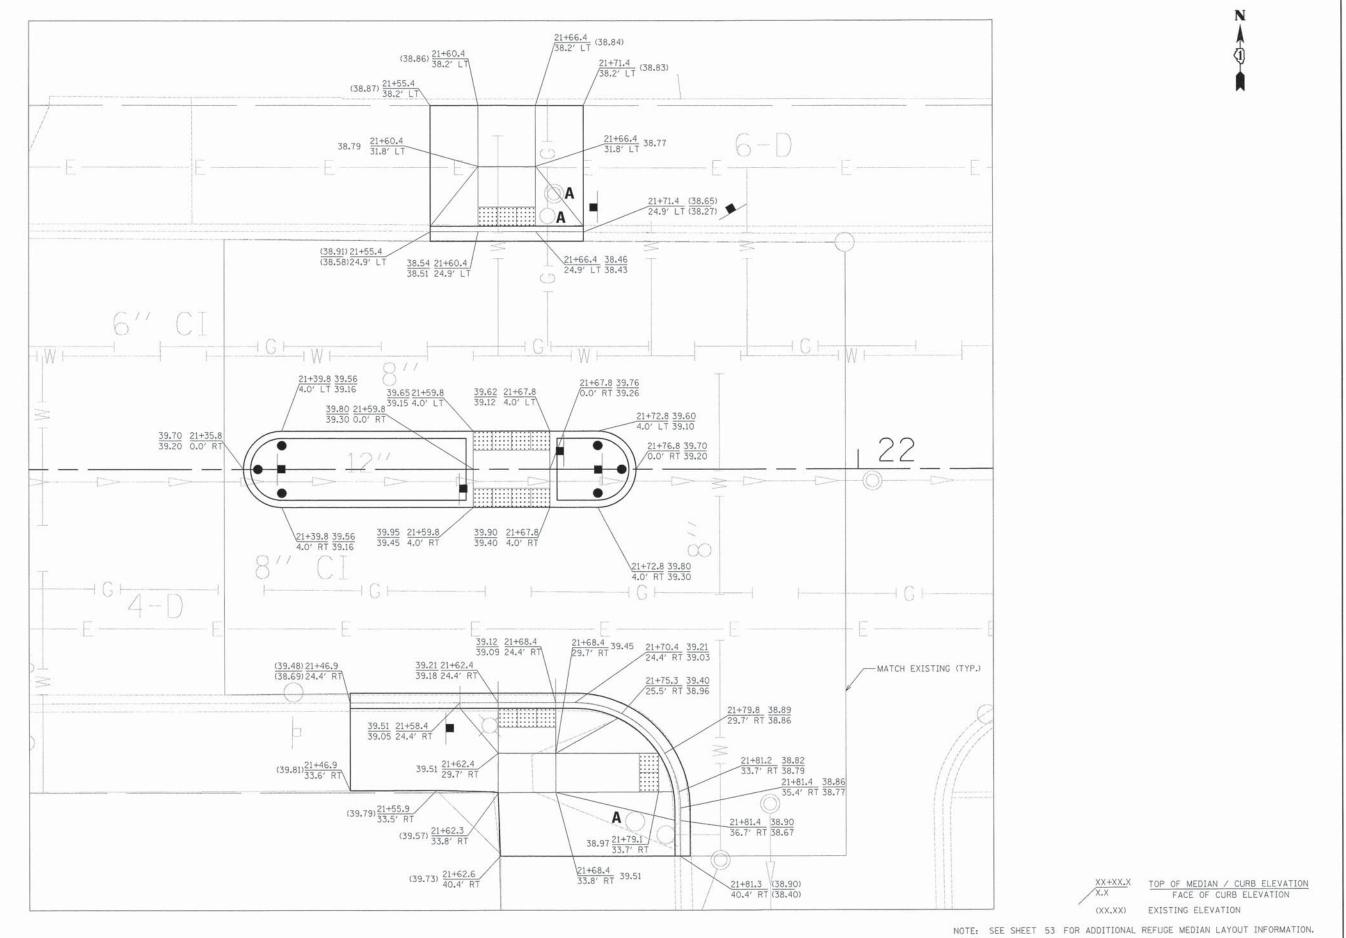

CIVILTECH


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DEPARTMENT OF TRANSPORTATION

CHICAGO WEST SIDE SAFE ROUTES TO SCHOOL ENHANCEMENTS MEDIAN REFUGE AND SIDEWALK LAYOUT - CHICAGO & LOTUS SCALE: 1"=5" SHEET 1 OF 1 SHEETS STA. TO STA.

COUNTY TOTAL SHEETS NO. SECTION 13-B3514-00-SW CONTRACT NO. 61C49

STATE OF ILLINOIS

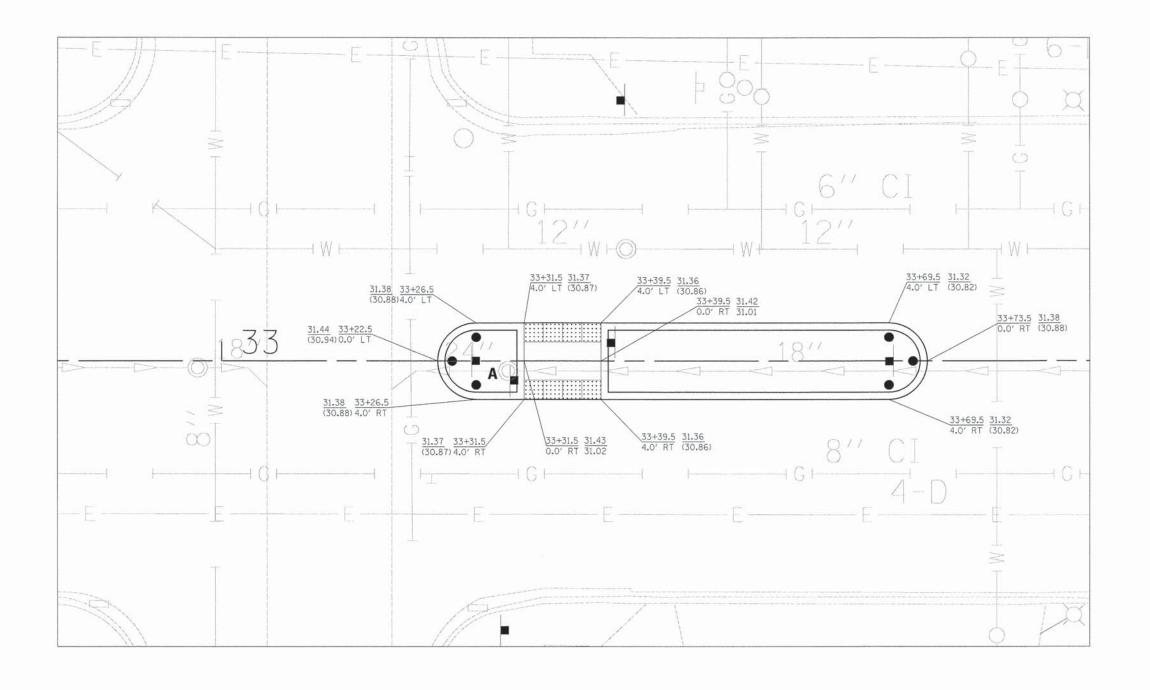

XX+XX.X TOP OF MEDIAN / CURB ELEVATION
FACE OF CURB ELEVATION

(XX.XX) EXISTING ELEVATION

NOTE: SEE SHEET 53 FOR ADDITIONAL REFUGE MEDIAN LAYOUT INFORMATION.


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USER NAME = bes	DESIGNED - BJB	REVISED	
	DRAWN - BJB	REVISED -	
PLOT SCALE = 5.0000 ' / in.	CHECKED - MJF	REVISED -	
PLOT DATE = 1/19/2016	DATE - 01/22/16	REVISED -	

STATE	01	F ILLINOIS
DEPARTMENT	0F	TRANSPORTATION

CHICA	GO WEST	SIDE	SAFE	ROU	TES TO	SCHOOL E	NHAN	ICEMENTS
REFUGE	MEDIAN	AND	SIDEV	VALK	LAYOUT	- CHICA	GO &	LOCKWOOD
F. 1"=5"	SHEE	T 1	OF.	1 SH	FETS ST	Δ.	TO	STA.

	ILLINOIS FED.	AID PROJECT			
		CONTRACT	NO.	61C49	
1398/ 1419A	13-B3514-00-SW	соок	67	32	
F.A.U. RTE.	SECTION	COUNTY	TOTAL	SHEET NO.	

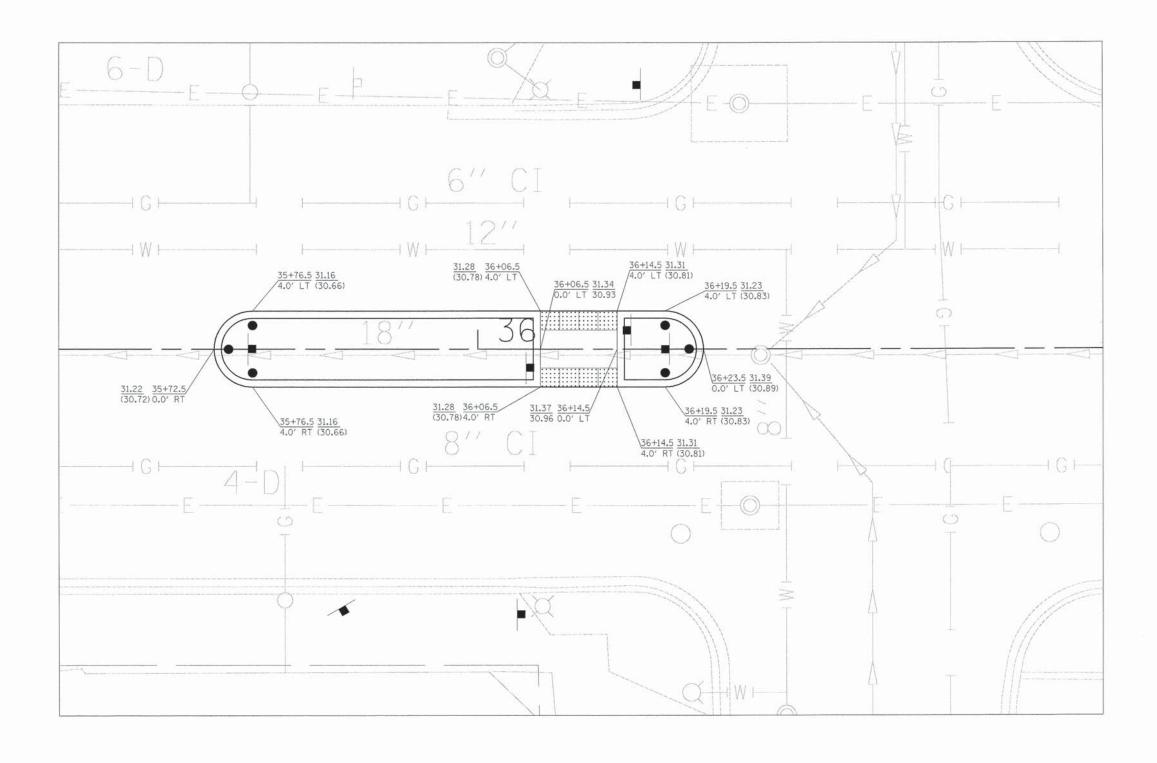

XX+XX.X X.X

TOP OF MEDIAN / CURB ELEVATION FACE OF CURB ELEVATION

(XX.XX) EXISTING ELEVATION


NOTE: SEE SHEET 53 FOR ADDITIONAL REFUGE MEDIAN LAYOUT INFORMATION.


CIVILTECH

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	DRAWN - BJB	REVISED -	
PLOT SCALE = 5.0000 ' / in.	CHECKED - MJF	REVISED ~	
PLOT DATE = 1/19/2016	DATE - 01/22/16	REVISED -	

(CHICAGO	WEST	SIDE	SAF	E	ROUTES	TO :	SCHOOL	ENHA	NCE	MENTS	
R	EFUGE I	VIEDIAN	AND	SID	EW	VALK LA	YOUT	r – CHI	CAGO	&	LATROBE	
CALE:	1"=5"	SHEET	1	OF	1	SHEETS	STA.		TO	STA	۸.	

	ILLINOIS FED.	AID PROJECT		
		CONTRACT	NO.	61C49
1398/ 1419A	13-B3514-00-SW	COOK	67	33
F.A.U. RTE.	SECTION	COUNTY	TOTAL	SHEET NO.

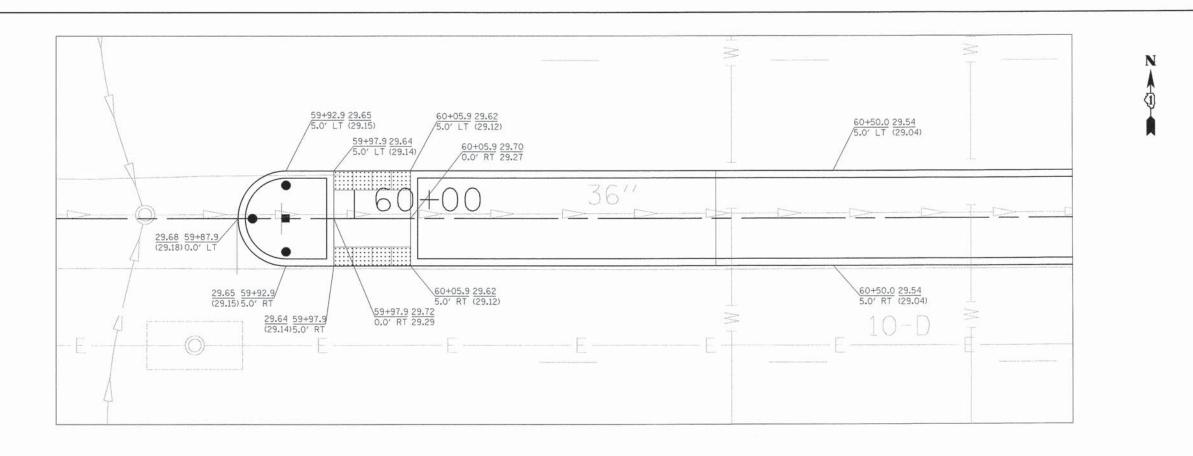

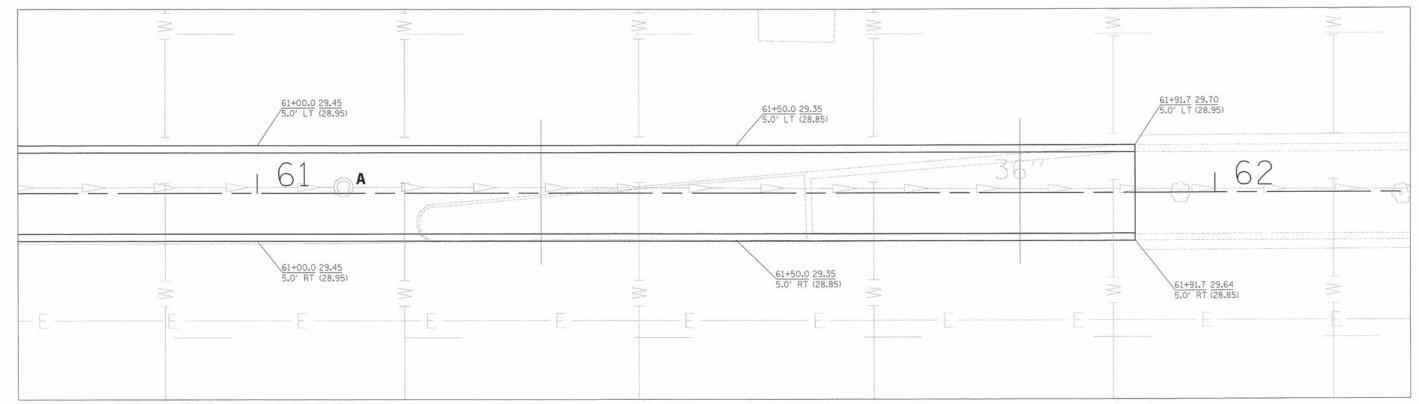

TOP OF MEDIAN / CURB ELEVATION FACE OF CURB ELEVATION

(XX.XX) EXISTING ELEVATION


NOTE: SEE SHEET 54 FOR ADDITIONAL REFUGE MEDIAN LAYOUT INFORMATION.



USER NAME = bes	DESIGNED - BJB	REVISED -	
	DRAWN - BJB	REVISED -	
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PLOT DATE = 1/19/2016	DATE - 01/22/16	REVISED -	

(CHICAGO	WEST	SIDE	SAFE	R	OUTES	TO S	CHOOL	ENHA	NCEMENTS
- 1	REFUGE	MEDIAN	AND	SIE	EV	VALK L	AYOUT.	- CH	IICAGO	& LAMON
ALE:	1"=5"	SHEET	1	OF	1	SHEETS	STA.		TO	STA.

	ILLINOIS FED.	AID PROJECT			
		CONTRACT	NO.	61C49	
398/ 119A	13-B3514-00-SW	COOK	67	34	
A.U. TE.	SECTION	COUNTY	TOTAL	SHEET NO.	

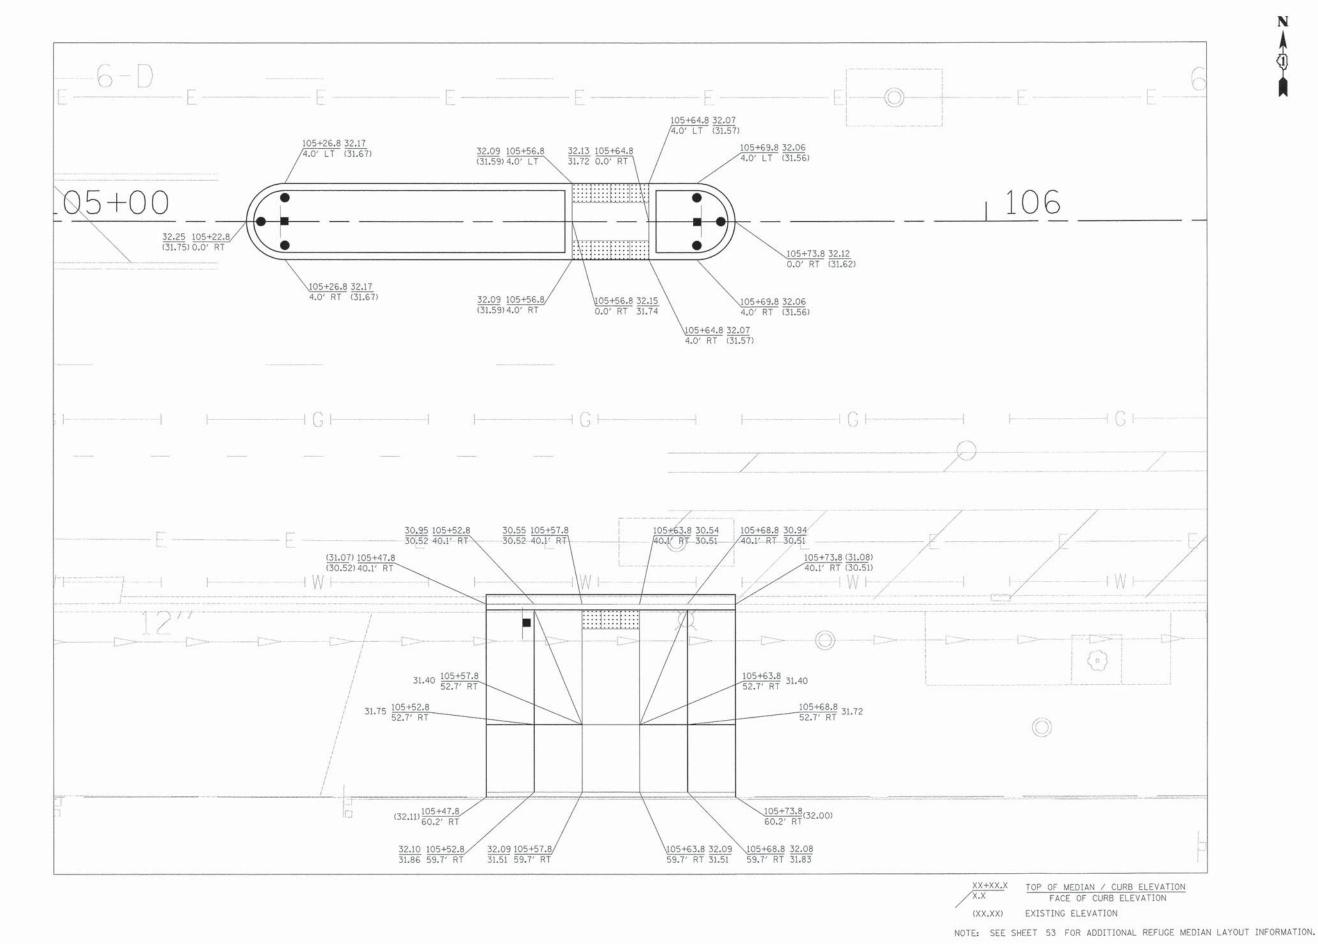

CIVILTECH

DESIGNED - BJB REVISED SER NAME = bas REVISED DRAWN - BJB PLOT SCALE = 5.0000 '/ in. CHECKED - MJF REVISED PLOT DATE = 1/19/2016 - 01/22/16 REVISED

STATE OF ILLINOIS DEPARTMENT OF TRANSPORTATION

CHICAGO WEST SIDE SAFE ROUTES TO SCHOOL ENHANCEMENTS REFUGE MEDIAN AND SIDEWALK LAYOUT - MADISON & PINE SCALE: 1"=5" SHEET 1 OF 1 SHEETS STA.

13-B3514-00-SW CONTRACT NO. 61C49


31.33 114+02.7 (30.83) 4.0' LT 31.33 114+02.7 (30.83)4.0' RT 114+15.7 31.34 4.0' RT (30.84) TOP OF MEDIAN / CURB ELEVATION FACE OF CURB ELEVATION EXISTING ELEVATION NOTE: SEE SHEET 53 FOR ADDITIONAL REFUGE MEDIAN LAYOUT INFORMATION.

PLOT DRIVER = ...\bos\dms88314\cei.pdf.p PEN TABLE = ...\bos\textbl\Z897-5EQNETRICS. FILE NAME = ...\Z897-sht-pl-Madison-Long

CIVILTECH

STATE OF ILLINOIS
DEPARTMENT OF TRANSPORTATION

CHICAGO WEST SIDE SAFE ROUTES TO SCHOOL ENHANCEMENTS
REFUGE MEDIAN AND SIDEWALK LAYOUT - MADISON & LONG

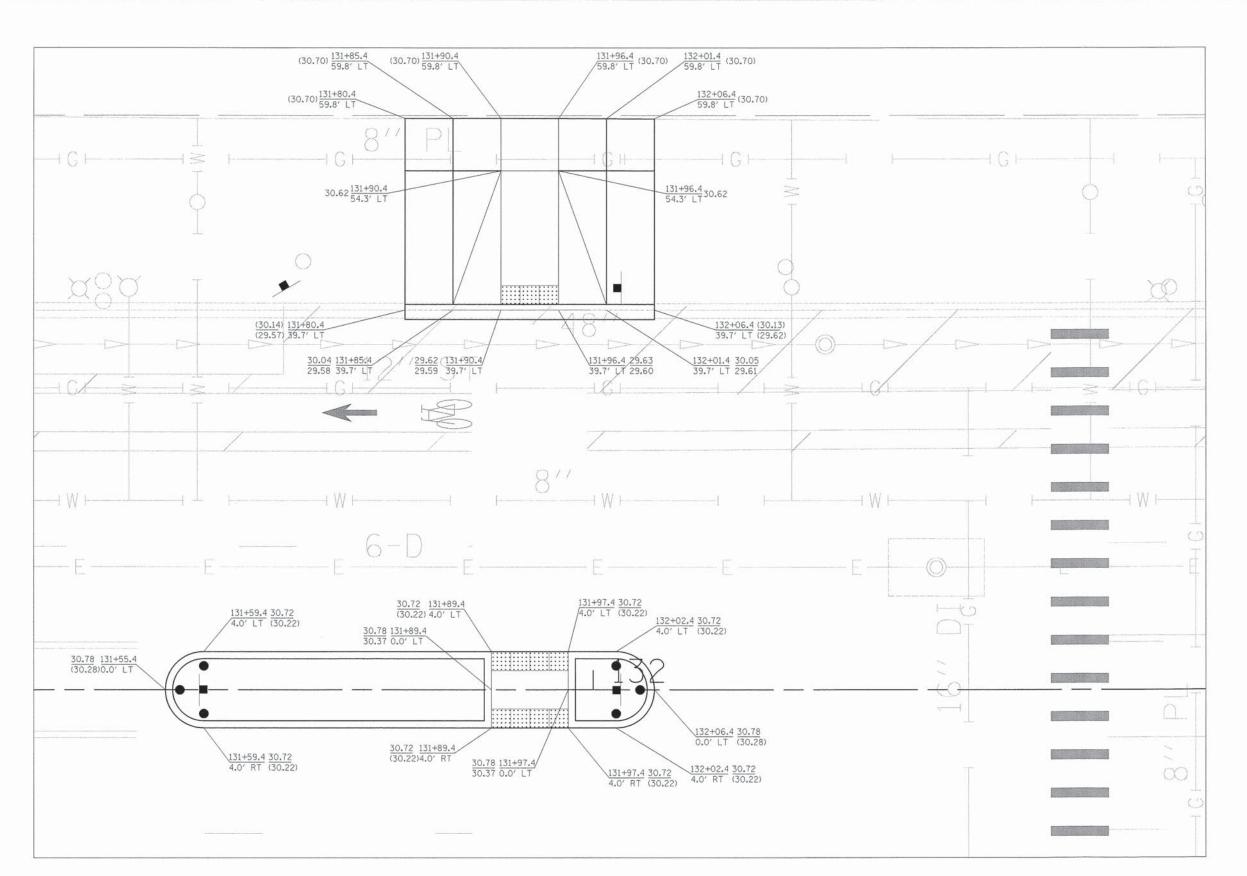

XX+XX.X

TOP OF MEDIAN / CURB ELEVATION FACE OF CURB ELEVATION

(XX.XX) EXISTING ELEVATION


NOTE: SEE SHEET 53 FOR ADDITIONAL REFUGE MEDIAN LAYOUT INFORMATION.



ľ	USER NAME = bas	DESIGNED - BJB	REVISED -	
		DRAWN - BJB	REVISED	
	PLOT SCALE = 5.0000 ' / in.	CHECKED - MJF	REVISED -	
	PLOT DATE = 1/19/2016	DATE - 01/22/16	REVISED -	

							NHANCEMENTS	RT 139 141
REFUGE MEDIA	N AND	SID	EWAL	.K	LAYOUT	r - Madison	& LEAMINGTON	141
SCALE: 1"=5"	SHEET	1	OF	1	SHEETS	STA.	TO STA.	

	ILLINOIS FED.	AID PROJECT		
		CONTRACT	NO.	61C49
398/ 419A	13-B3514-00-SW	COOK	67	37
A.U. TE.	SECTION	COUNTY	TOTAL	SHEET NO.

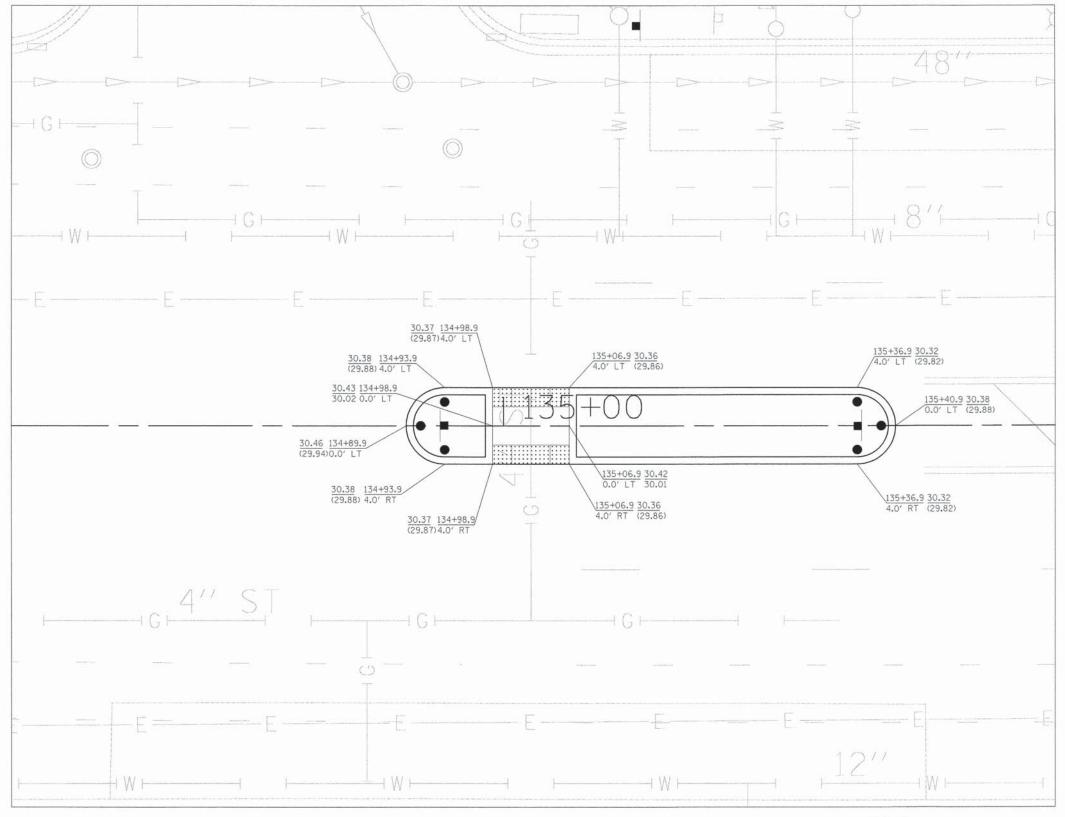

XX+XX.X

TOP OF MEDIAN / CURB ELEVATION
FACE OF CURB ELEVATION

(XX.XX) EXISTING ELEVATION

NOTE: SEE SHEET 53 FOR ADDITIONAL REFUGE MEDIAN LAYOUT INFORMATION.



USER NAME = bas	DESIGNED - BJB	REVISED -	
	DRAWN - BJB	REVISED -	
PLOT SCALE = 5.0000 1/ in.	CHECKED - MJF	REVISED -	
PLOT DATE = 1/19/2016	DATE - 01/22/16	REVISED -	

STATE OF ILLINOIS
DEPARTMENT OF TRANSPORTATION

CH	IICAGO	WEST	SIDE	SAF	E F	ROUTES	TO S	CHOOL ENHAN	CEMENTS
REF	UGE M	EDIAN	AND	SIDE	W	ALK LAY	TUOY	- MADISON 8	& LECLAIRE
SCALE:	1"=5"	SHEET	1	OF	1	SHEETS	STA.	TO :	STA.


U. SECTION COUNTY TOTAL SHEET NO.

13-B3514-00-SW COOK 67 38

CONTRACT NO. 61C49

|| ILLINOIS | FED. AID | PROJECT |



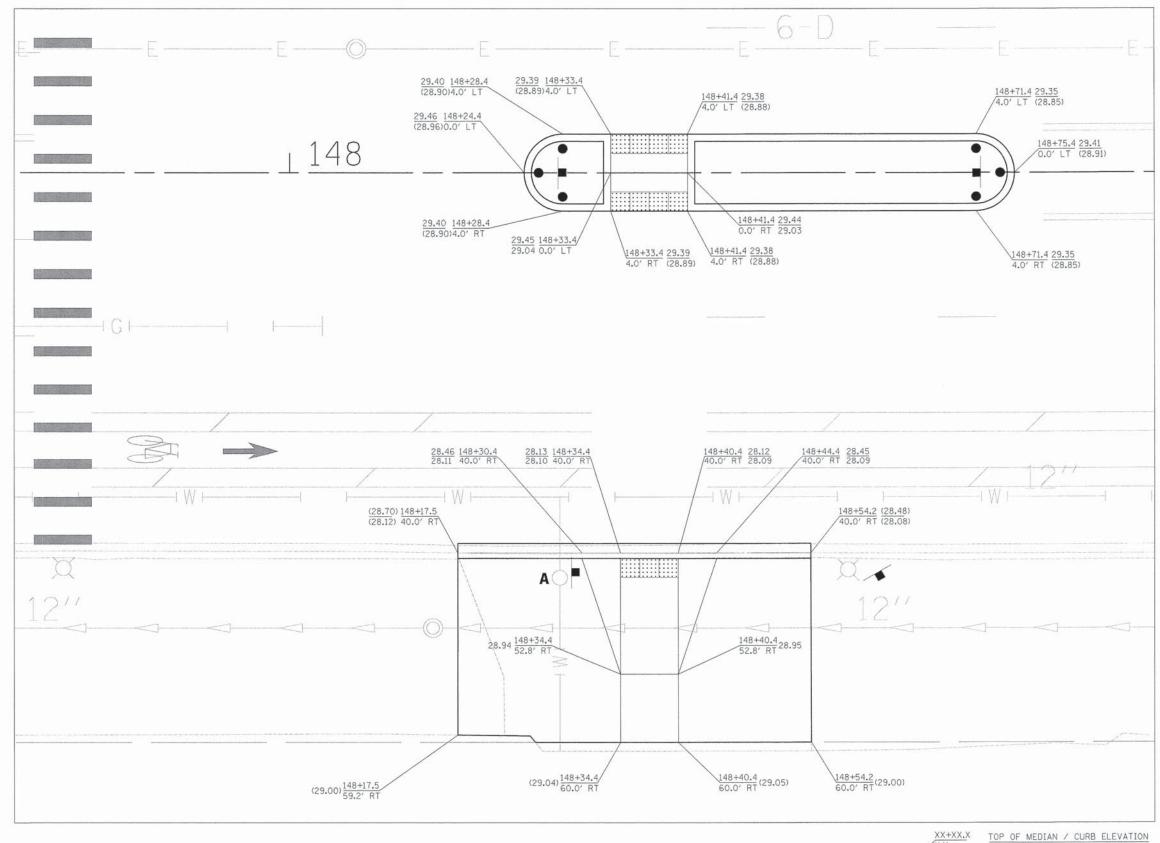

FACE OF CURB ELEVATION

(XX.XX) EXISTING ELEVATION

NOTE: SEE SHEET 53 FOR ADDITIONAL REFUGE MEDIAN LAYOUT INFORMATION.





USER NAME = bon	DESIGNED - BJB	REVISED -	
	DRAWN - BJB	REVISED -	
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PLOT DATE = 1/19/2016	DATE - 01/22/16	REVISED -	


STATE OF ILLINOIS **DEPARTMENT OF TRANSPORTATION**


	C	HICAG	0	WEST	SIDE	SAF	E	ROUT	ES	TO	SCH	OOL	ENHA	NCE	MENTS	
	R	EFUGE	N	IEDIAN	AND	SIE	E	WALK	LA	YOU	Т –	MA	DISON	&	LAMON	
Δi	F.	1//=5/		SHEET	1	OF	1	SHEE	TS	STA		-	TO	STA		


COUNTY | TOTAL | SHEET | NO. | COOK | 67 | 39 | CONTRACT | NO. | 61C49 SECTION 13-B3514-00-SW

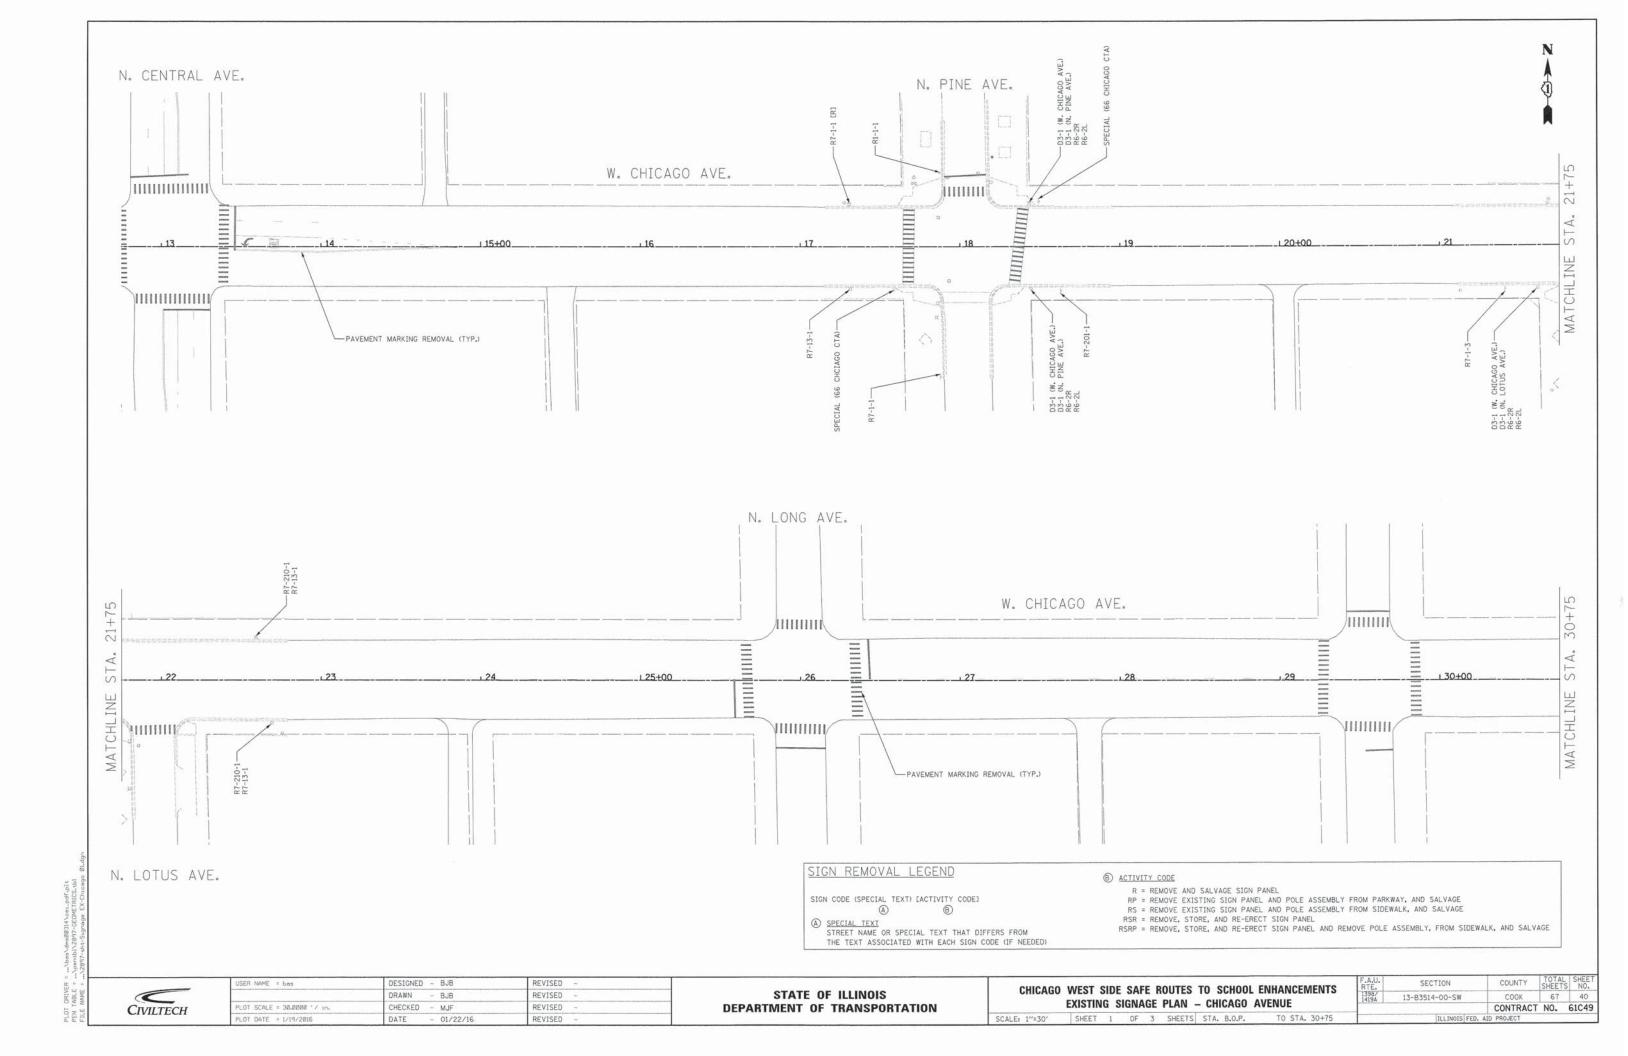


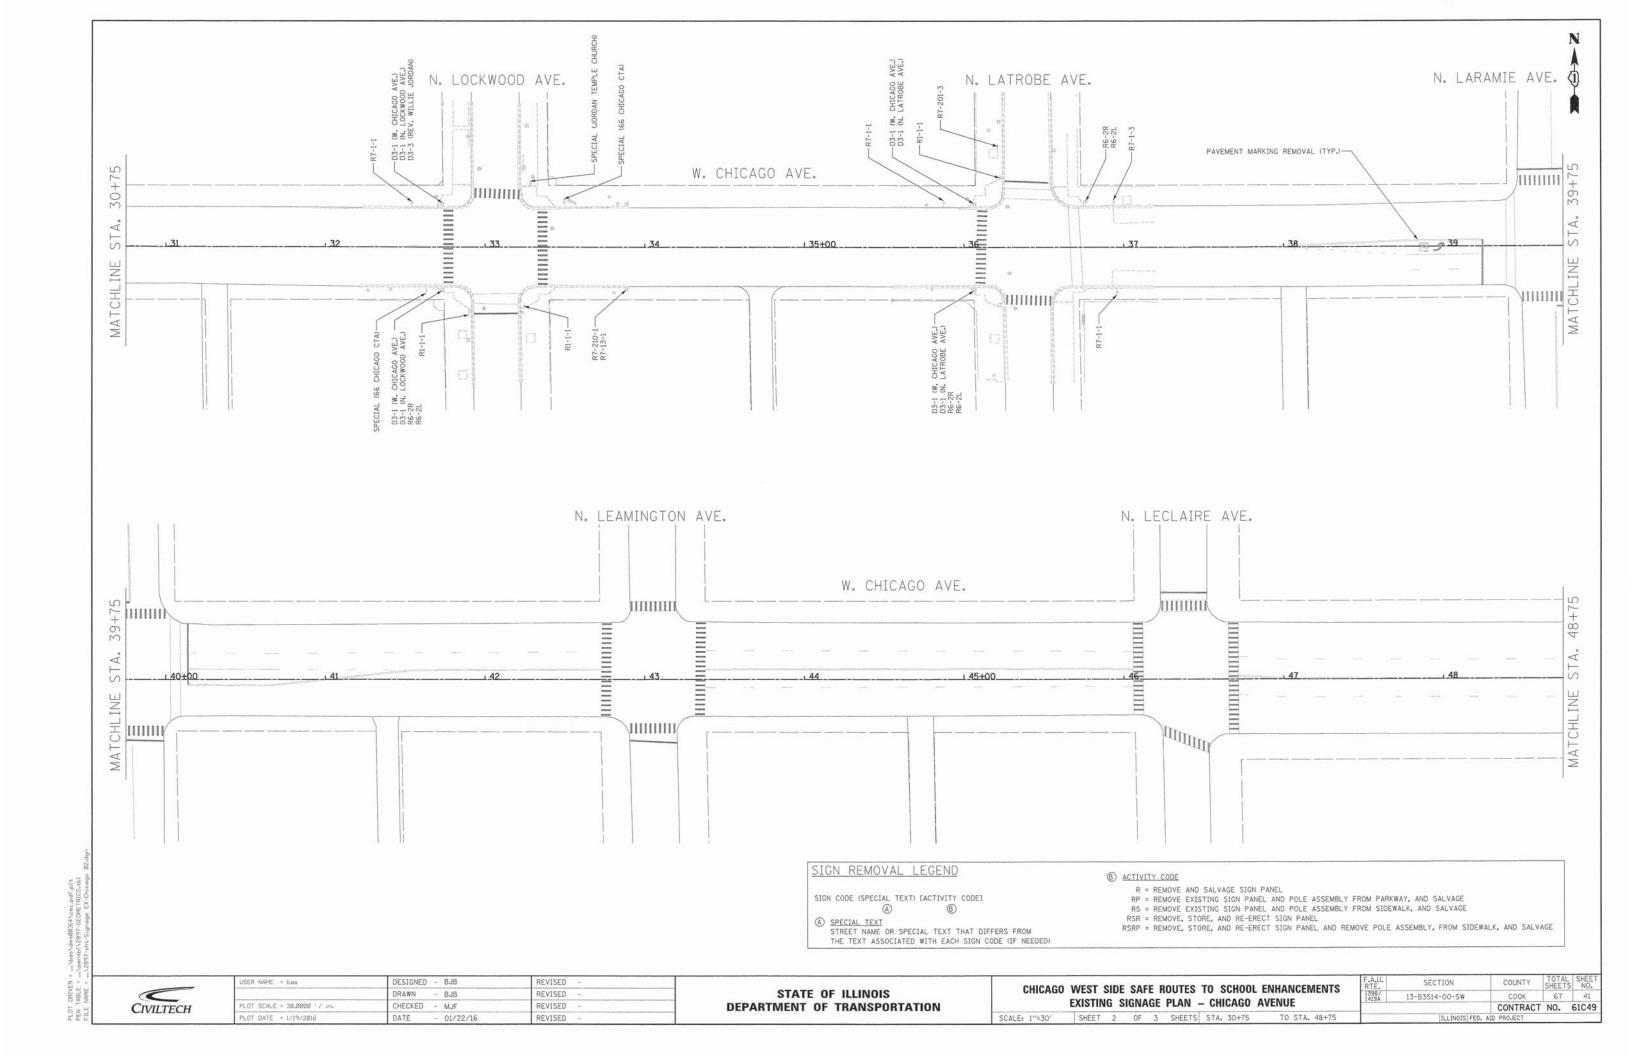


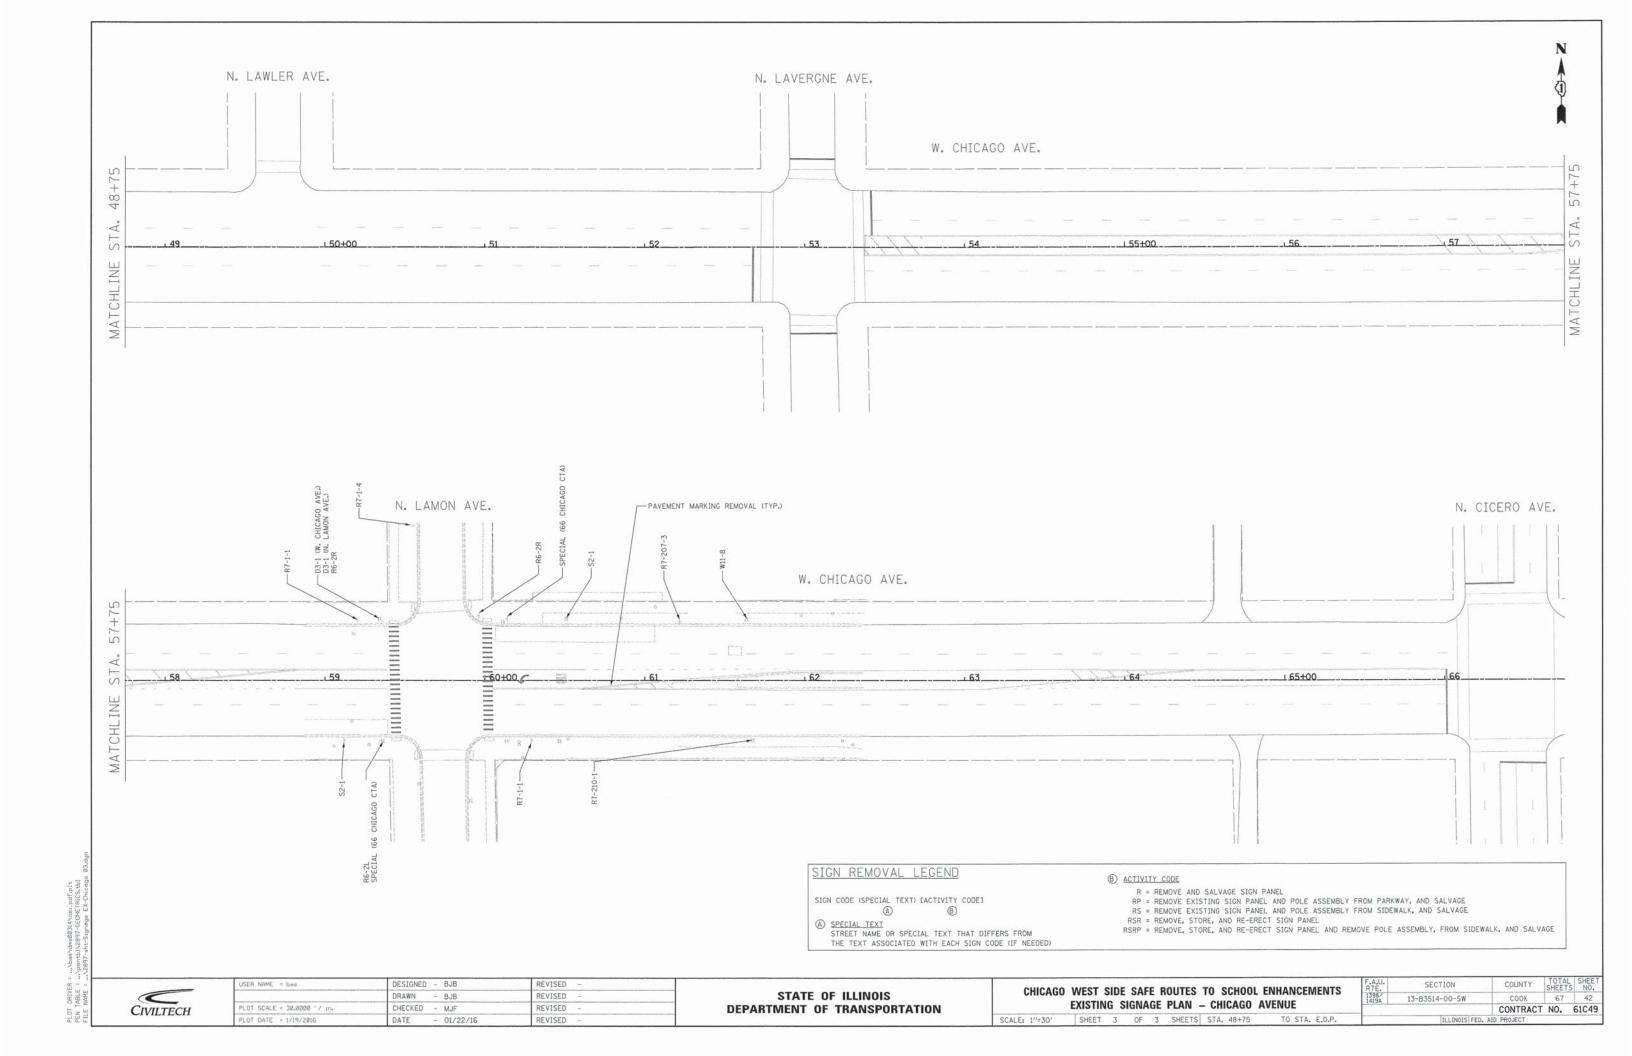


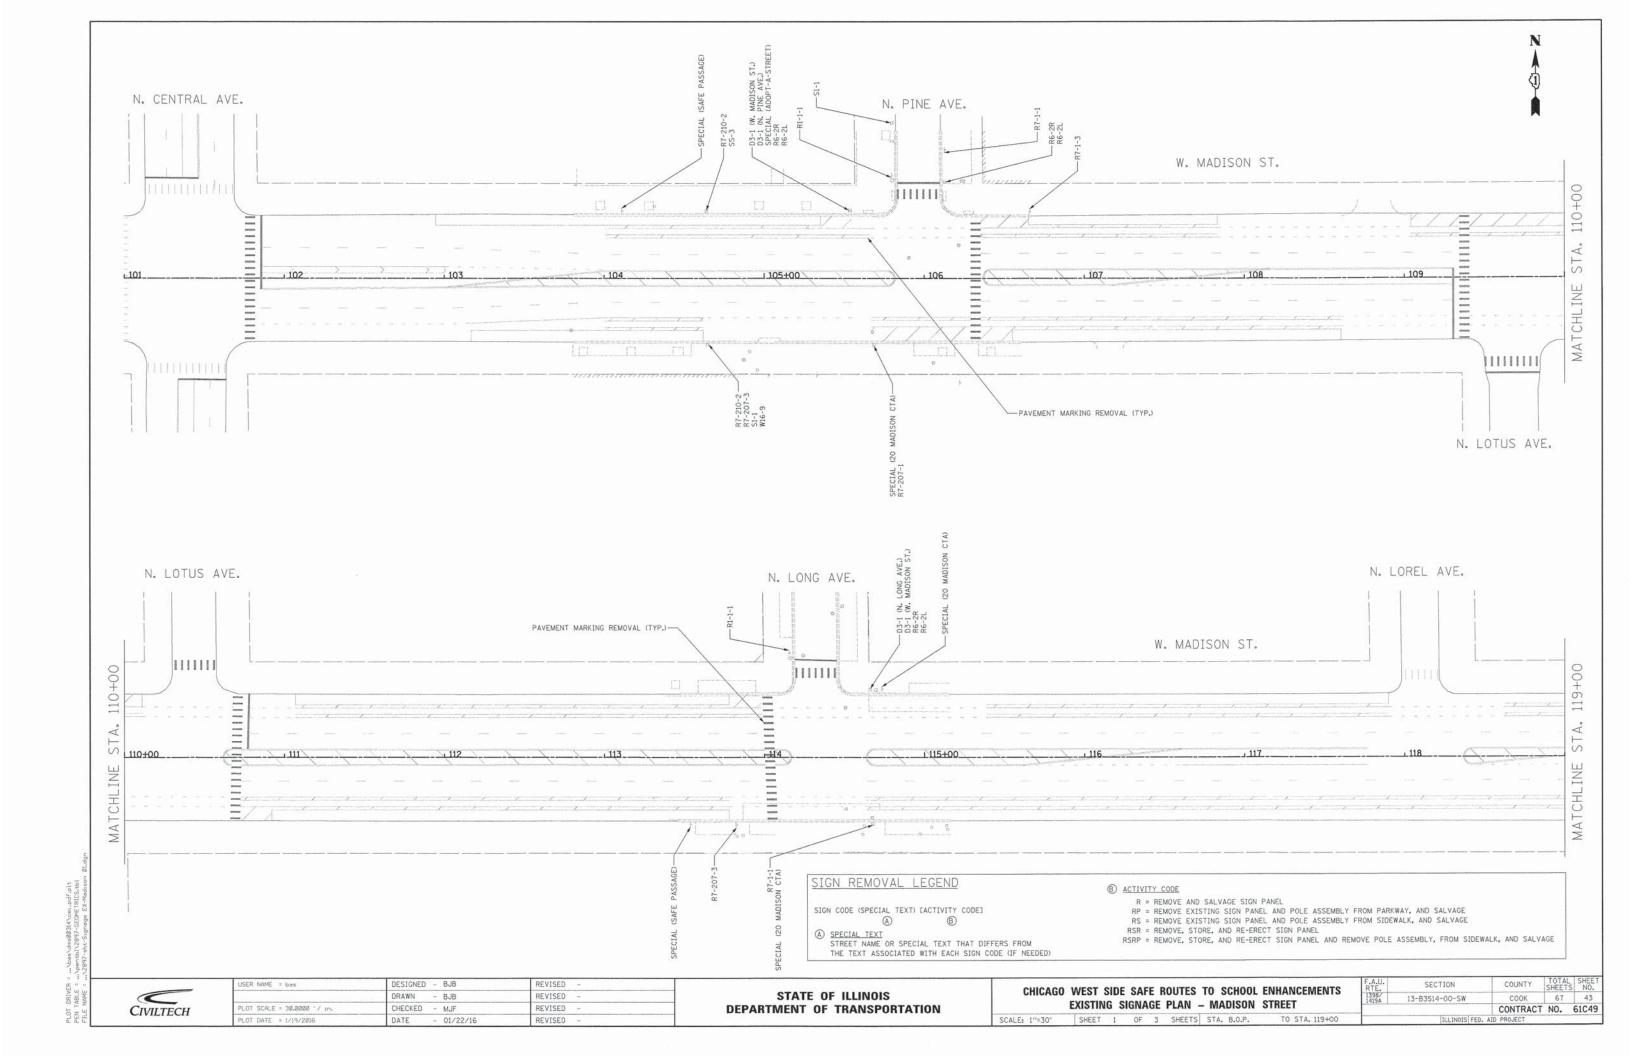


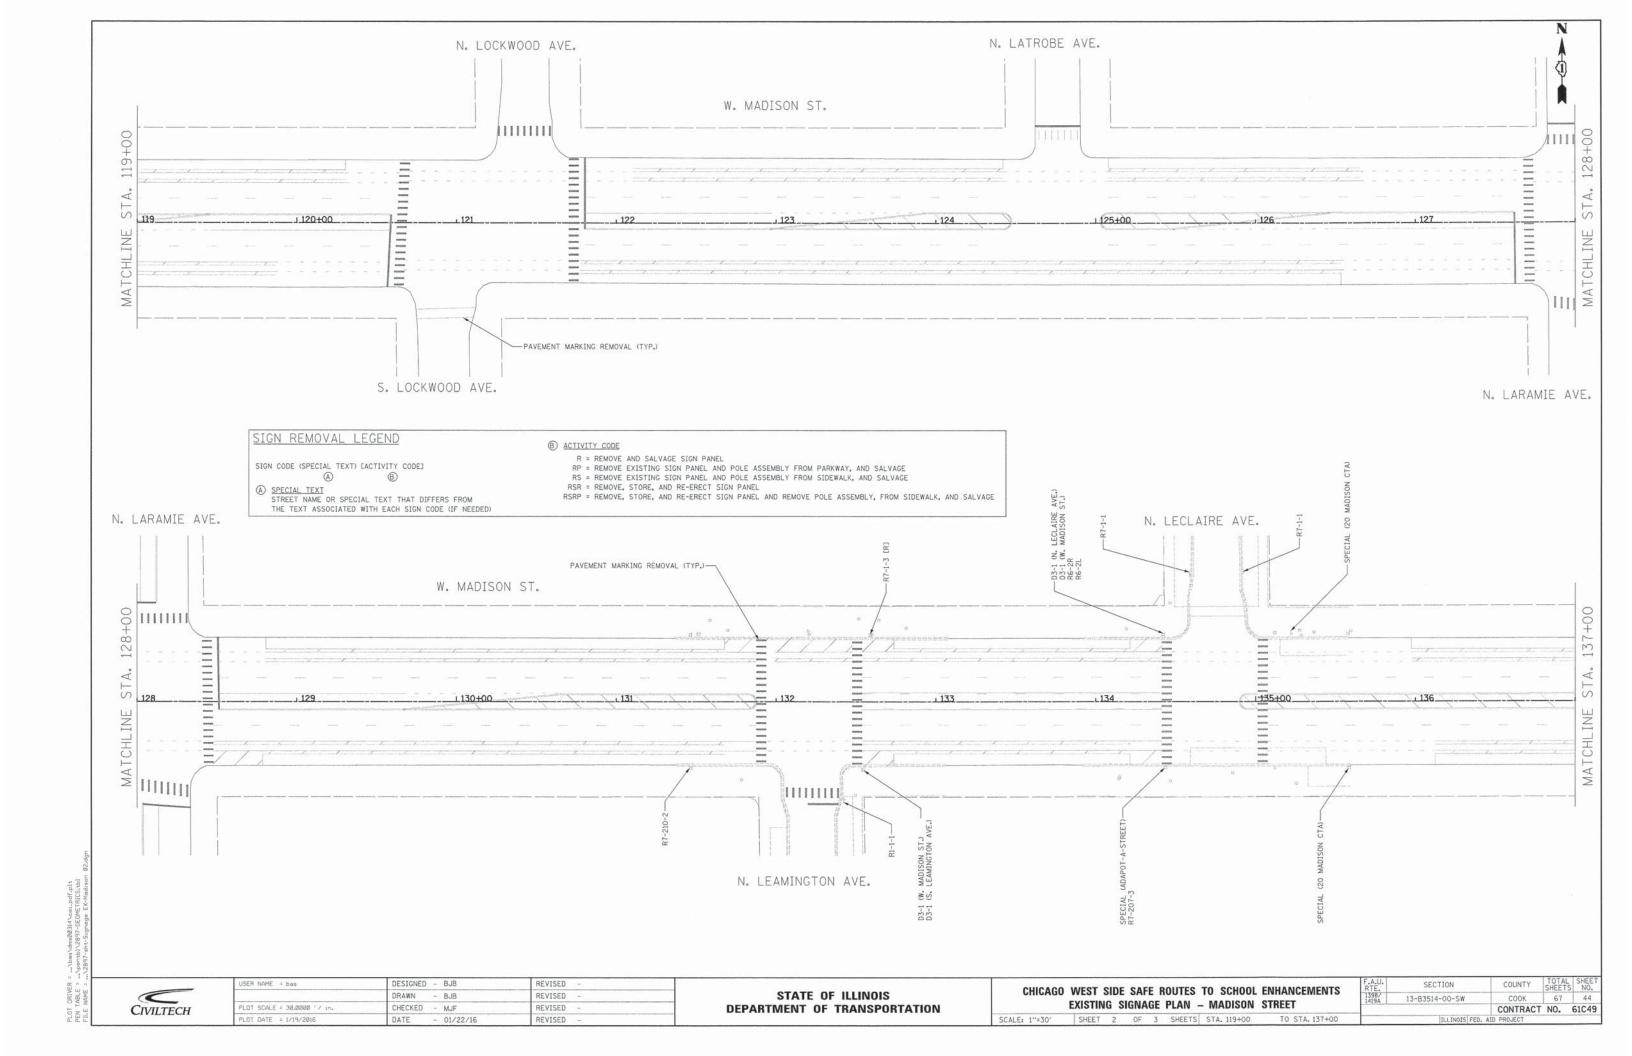


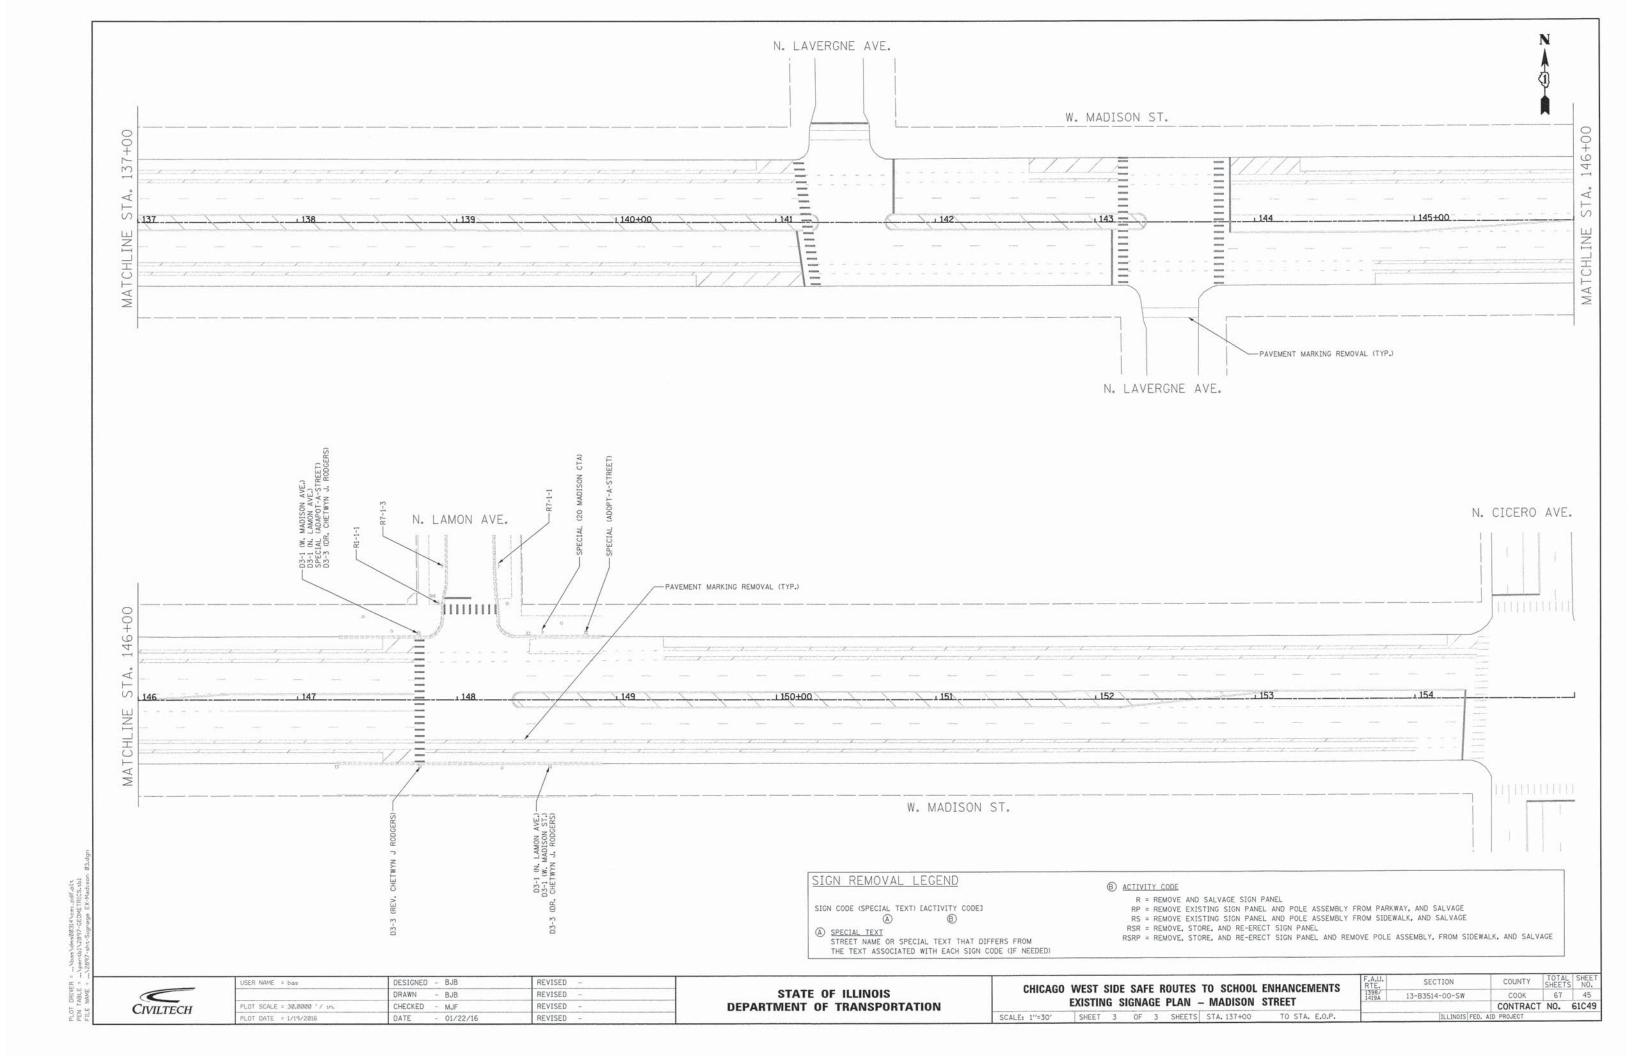


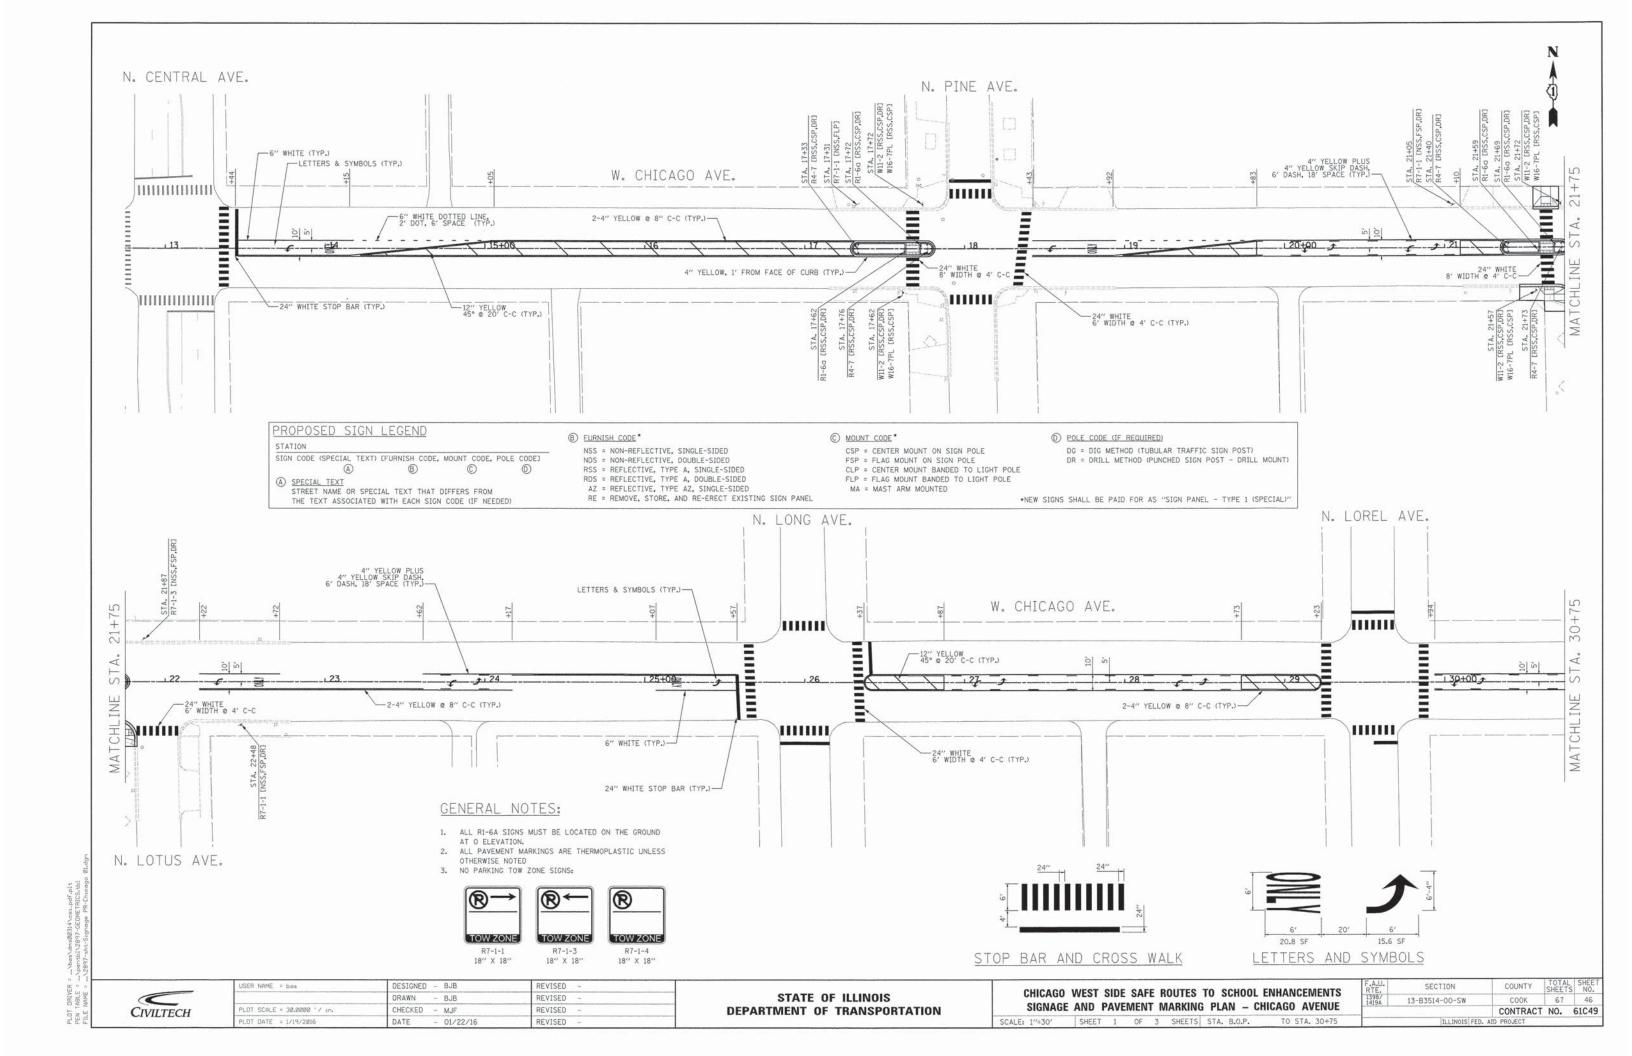


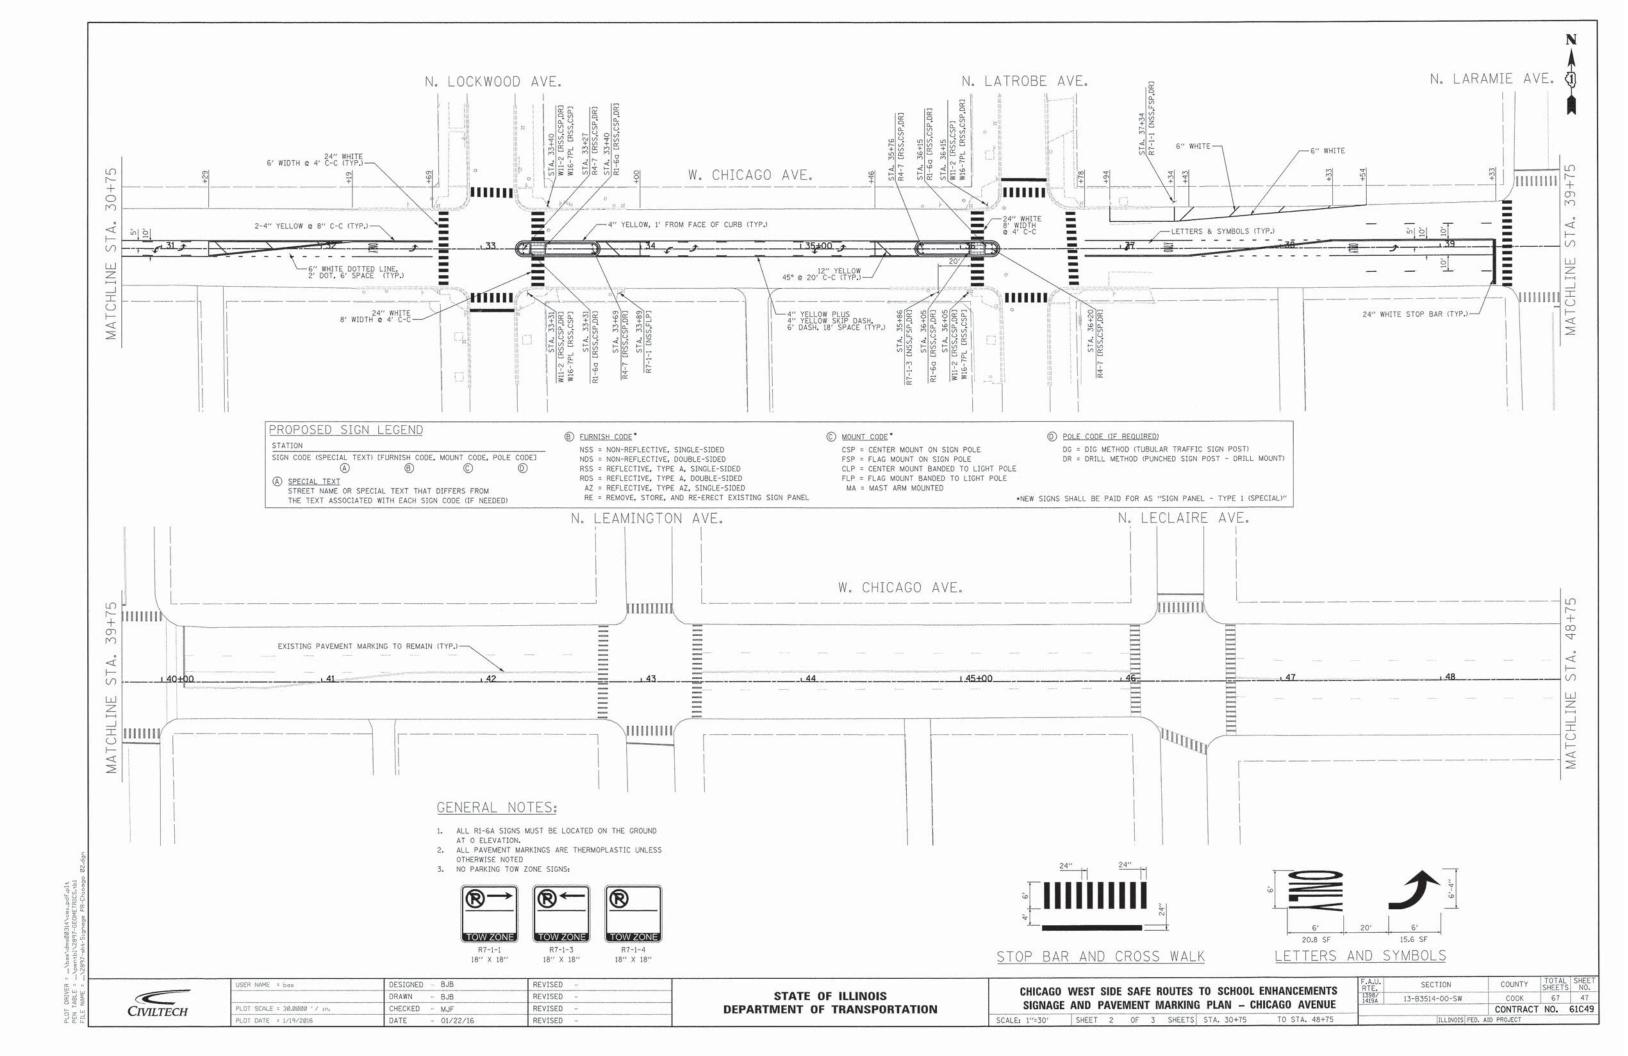

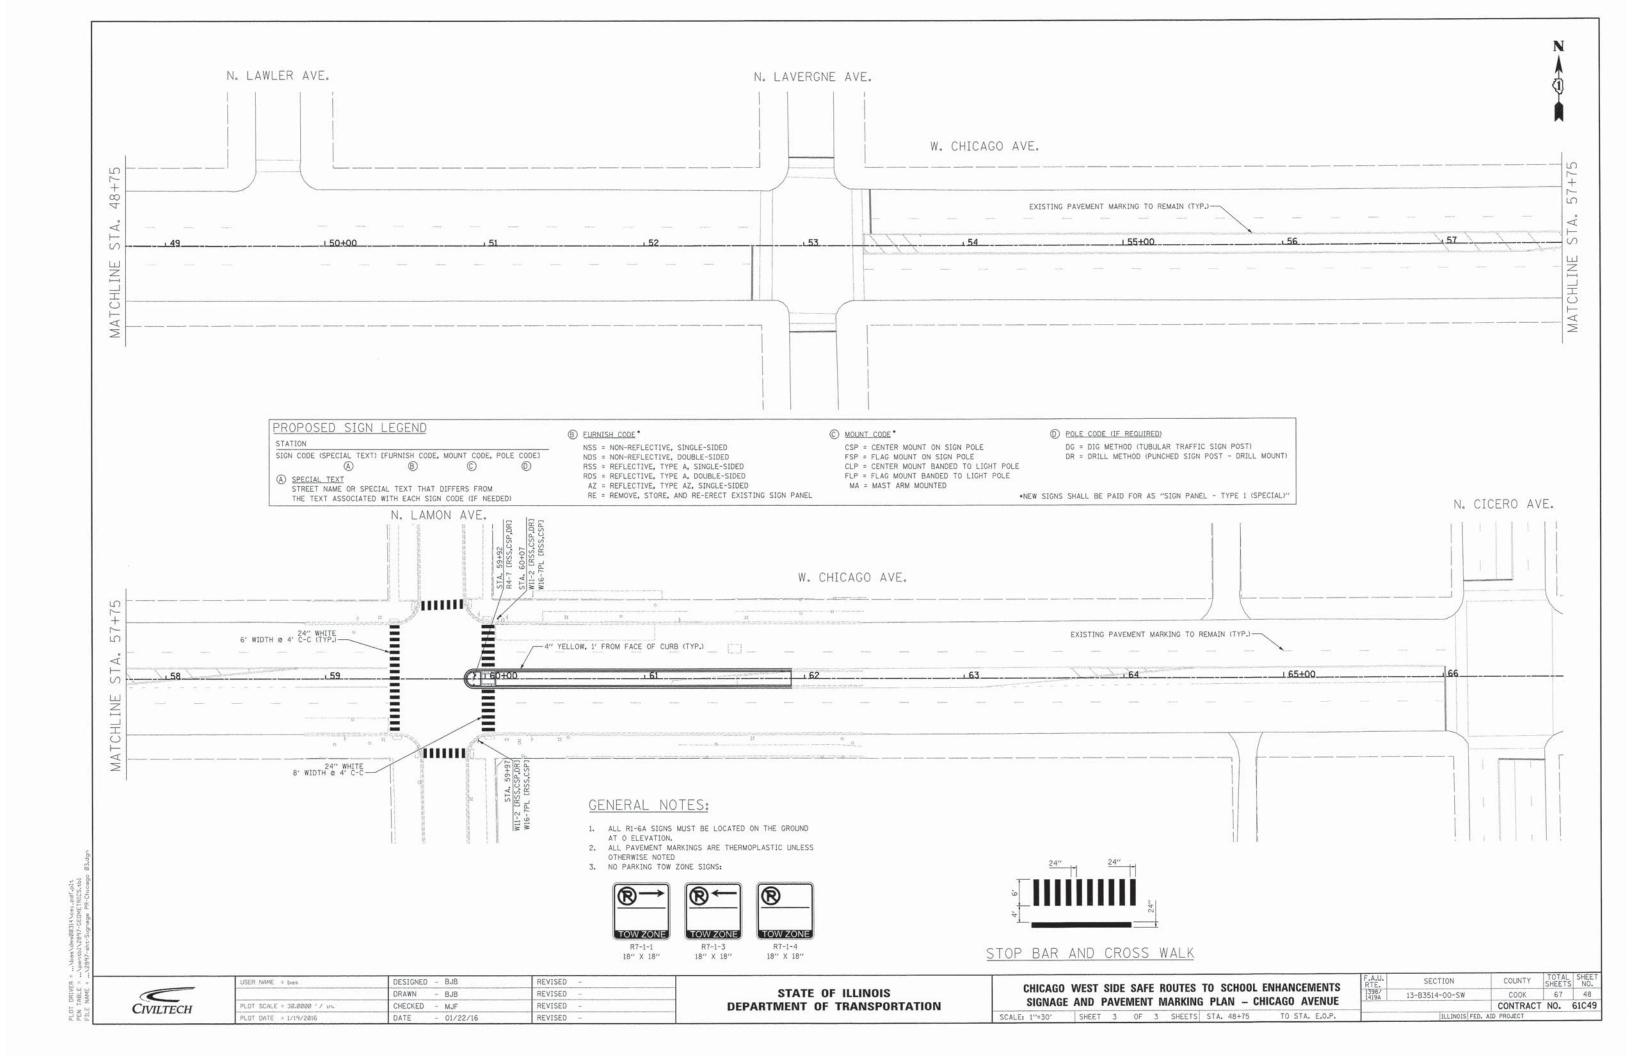

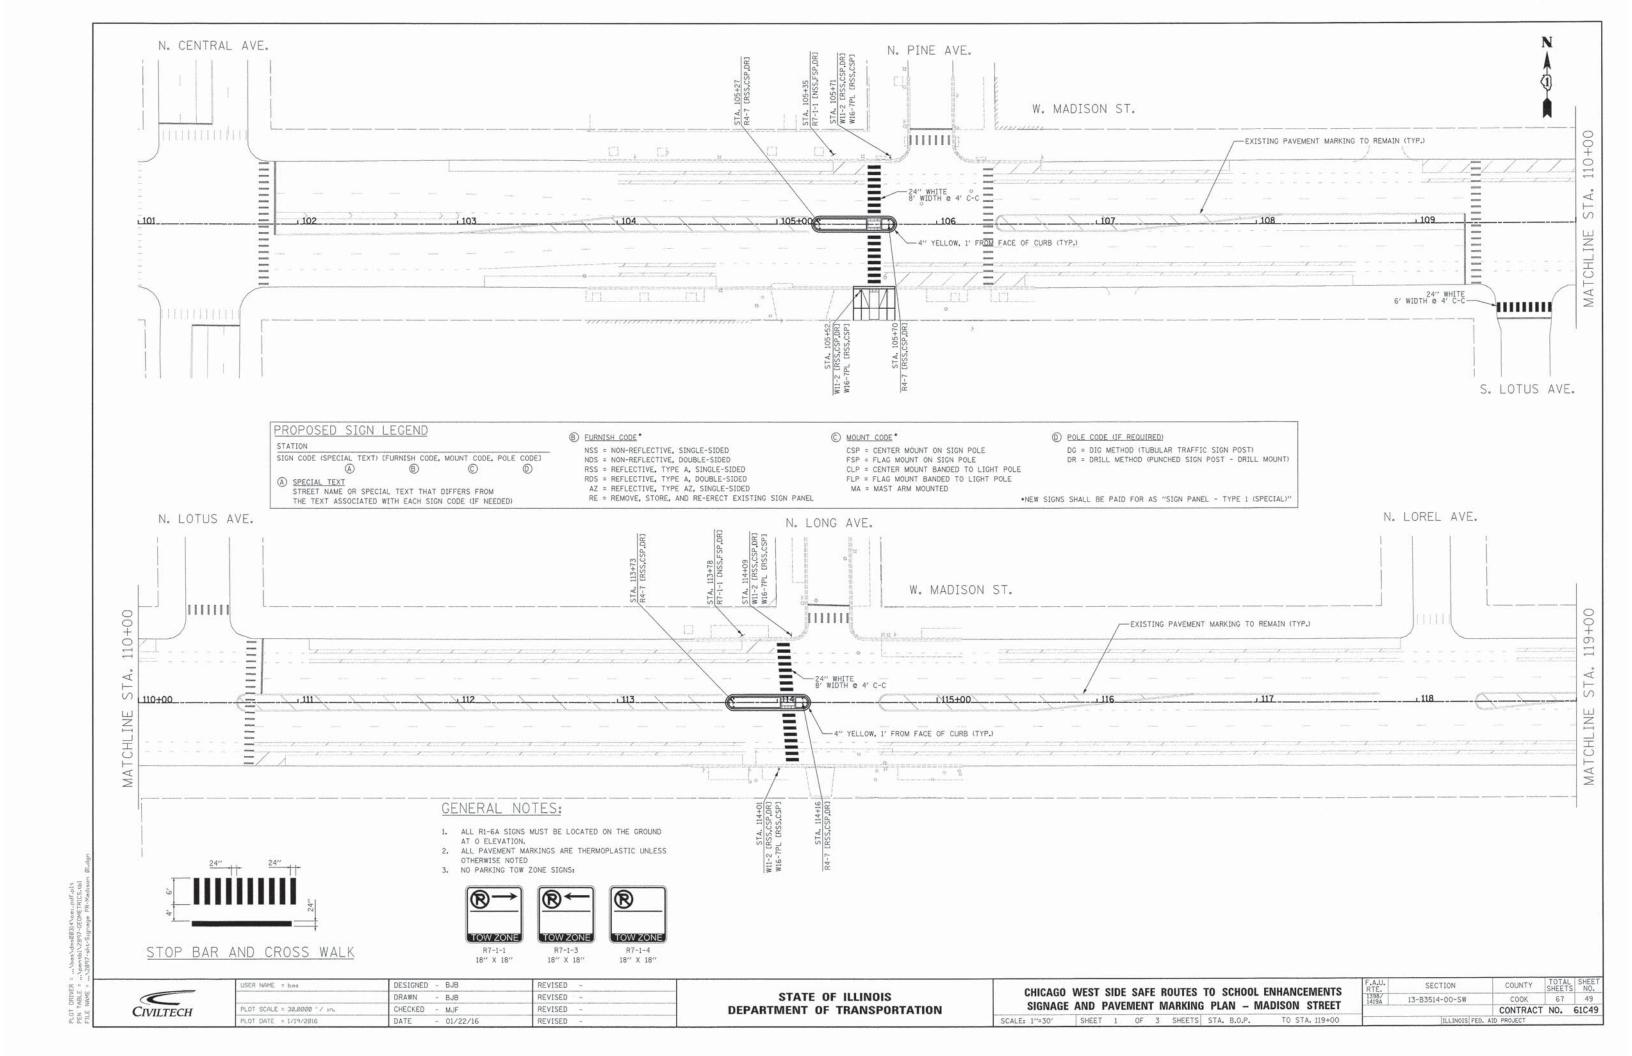

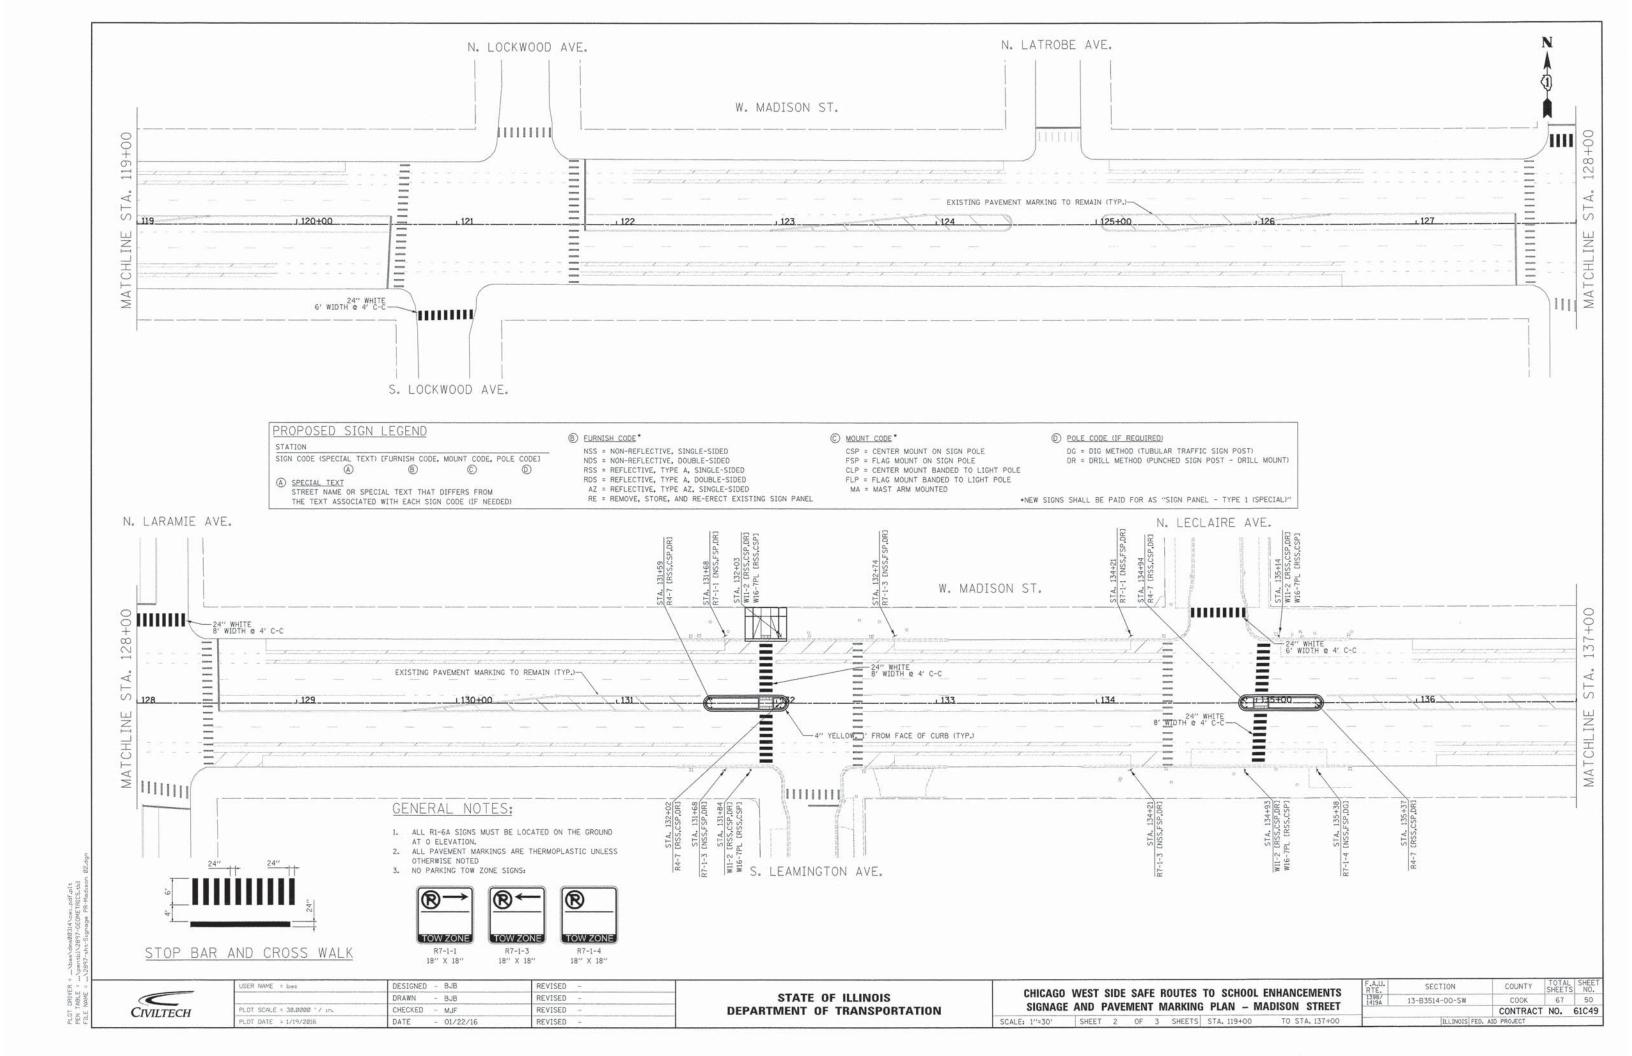

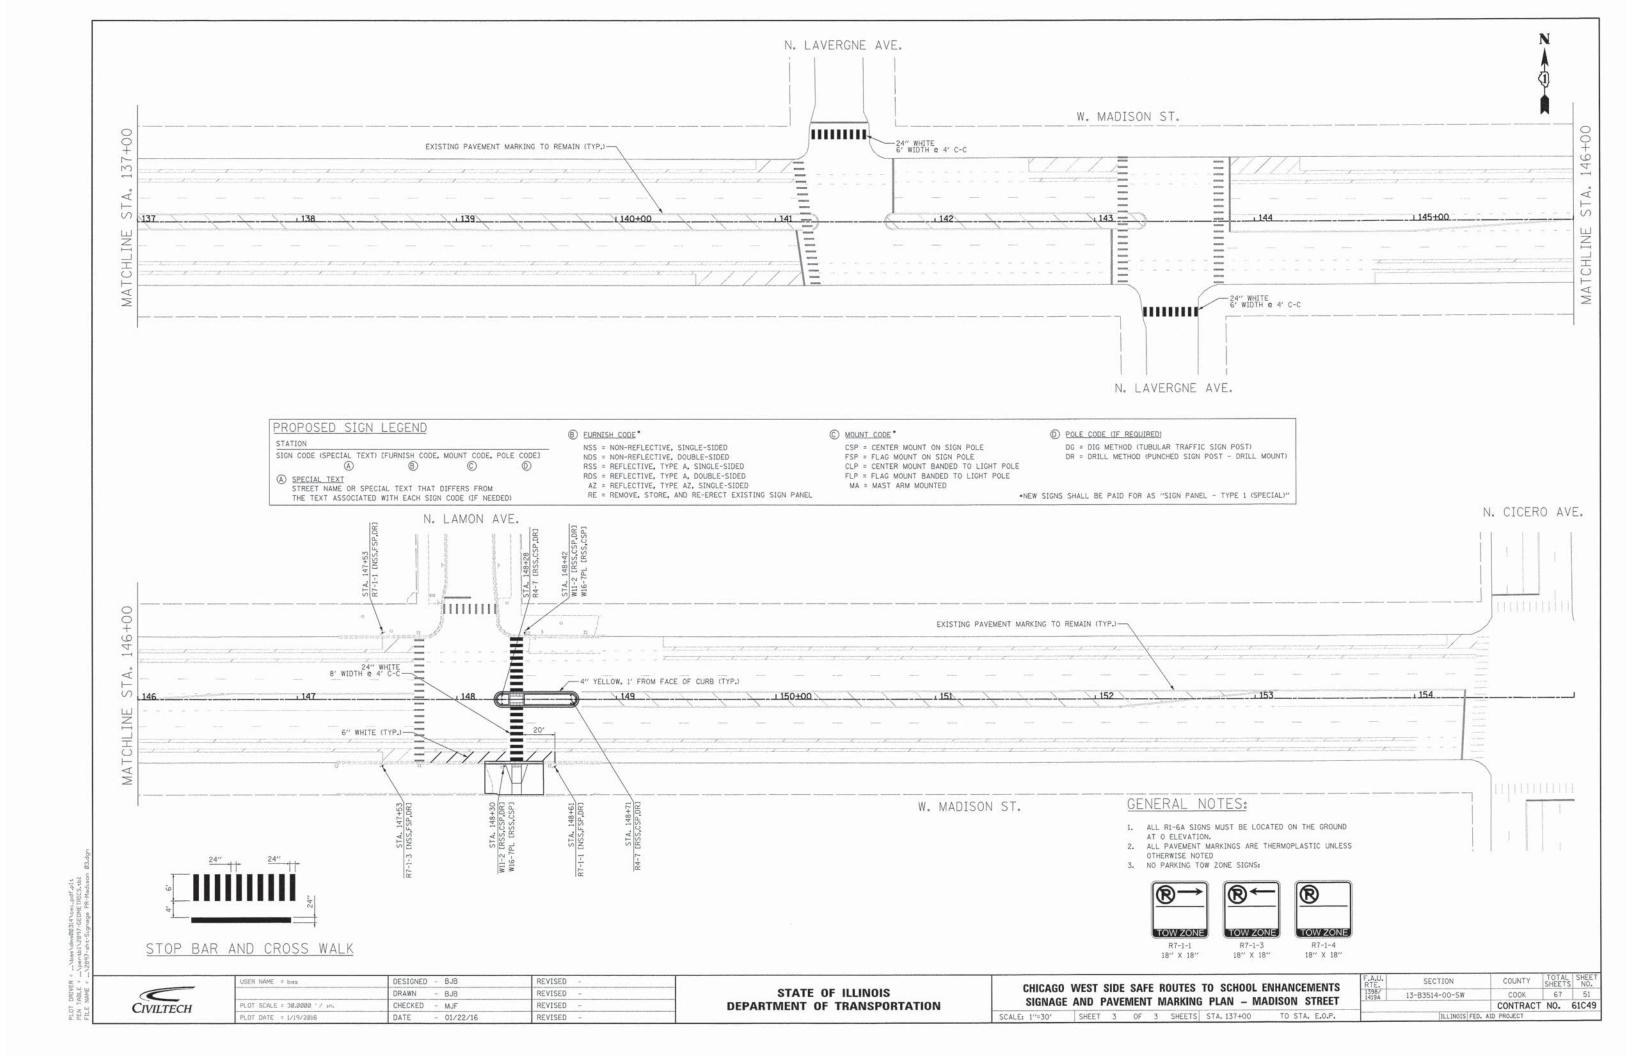

CODE	DESCRIPTION	AREA (SQ FT)	FURNISH AND MOUNT CODES										
CODE	DESCRIPTION		NSS	NDS	RSS	RDS	AZ	RE	CSP	FSP	CLP	FLP	MA
R7-1-3	NO PARKING (SYMBOL) LA	2.25	6							6			
R7-1-1	NO PARKING (SYMBOL) RA	2.25	11			0.112				9		2	
R7-1-4	NO PARKING (SYMBOL)	2.25	1							1			
R4-7	DEVIATE RIGHT (ISLAND)	5.00			19				19				
R1-6a	STOP FOR PEDESTRIANS STATE LAW	3.00			8				8				
W11-2	PEDESTRIAN CROSSING	6.25			20				20				
W16-7PL	ARROW	2.00			20				20				
		TOTALS	18	0	67	0	0	0	67	16	0	2	
	TOTAL AREA FURNISH SIGN PANEL		40.5	-	284	-	-	-	-	-	-	-	-

FURNISH AND MOUNT CODE LEGEND

NSS = NON-REFLECTIVE, SINGLE-SIDED

NDS = NON-REFLECTIVE, DOUBLE-SIDED

RSS = REFLECTIVE, TYPE A, SINGLE-SIDED RDS = REFLECTIVE, TYPE A, DOUBLE-SIDED

AZ = REFLECTIVE, TYPE AZ, SINGLE-SIDED

RE = REMOVE, STORE, AND RE-ERECT EXISTING SIGN PANEL

CSP = CENTER MOUNT ON SIGN POLE FSP = FLAG MOUNT ON SIGN POLE

CLP = CENTER MOUNT BANDED TO LIGHT POLE FLP = FLAG MOUNT BANDED TO LIGHT POLE


MA = MAST ARM MOUNTED




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	DRAWN - BJB	REVISED -	
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PLOT DATE = 1/19/2016	DATE - 01/22/16	REVISED -	

CHICAGO						TO SCHO	OL ENHANCEMENTS TIES
SCALE: N.T.S.	SHEET	1	OF	1	SHEETS	STA.	TO STA.

	ILLINOIS FED. AI	D PROJECT		
		CONTRACT	NO.	61C49
1398/ 1419A	13-B3514-00-SW	COOK	67	52
F.A.U. RTE.	SECTION	COUNTY	TOTAL	SHEET NO.

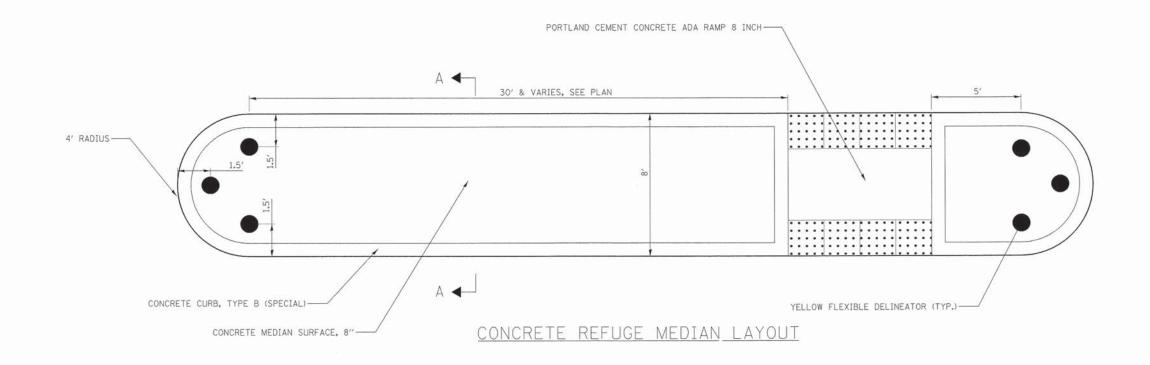

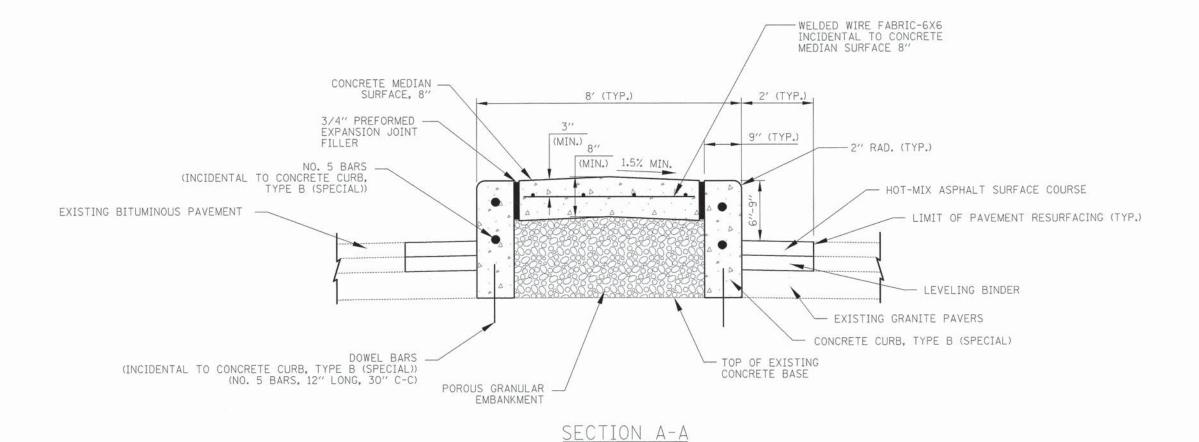


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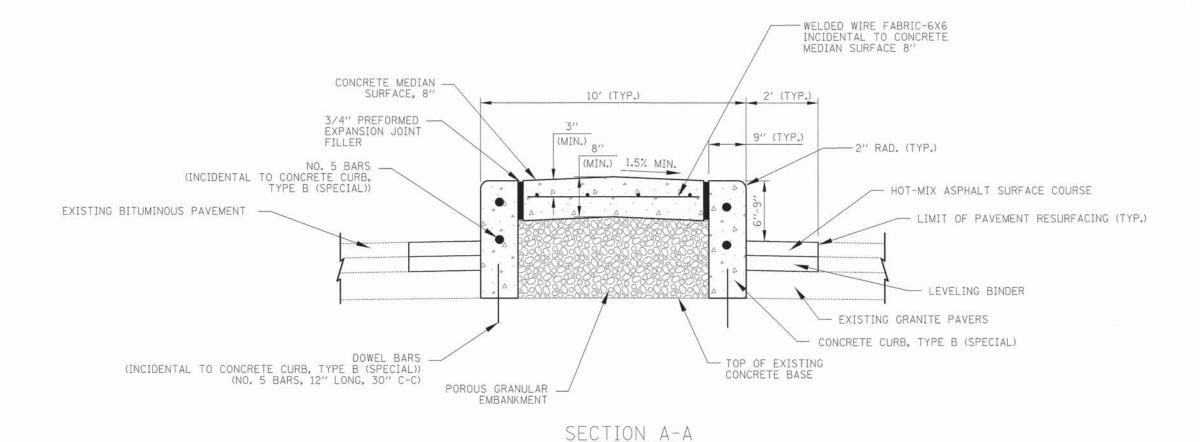
STATE OF ILLINOIS
DEPARTMENT OF TRANSPORTATION

CHICAGO WEST SIDE SAFE ROUTES TO SCHOOL ENHANCEMENTS
REFUGE MEDIAN DETAILS - 8' MEDIAN

SCALE: N.T.S. | SHEET | 1 OF | 1 SHEETS | STA. TO STA.

| F.A.U | SECTION | COUNTY | TOTAL | SHEET | NO. | 13987 | 1419A | 13-B3514-00-SW | COOK | 67 | 53 | CONTRACT | NO. | 61C49 | |



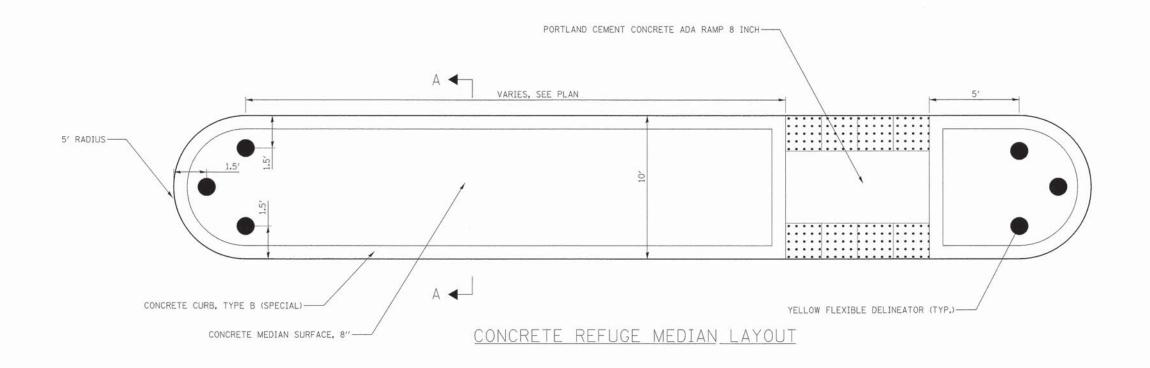


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STATE OF ILLINOIS
DEPARTMENT OF TRANSPORTATION

CHICAGO WEST SIDE SAFE ROUTES TO SCHOOL ENHANCEMENTS
REFUGE MEDIAN DETAILS - 10' MEDIAN

SCALE: N.T.S. SHEET 1 OF 1 SHEETS STA. TO STA.

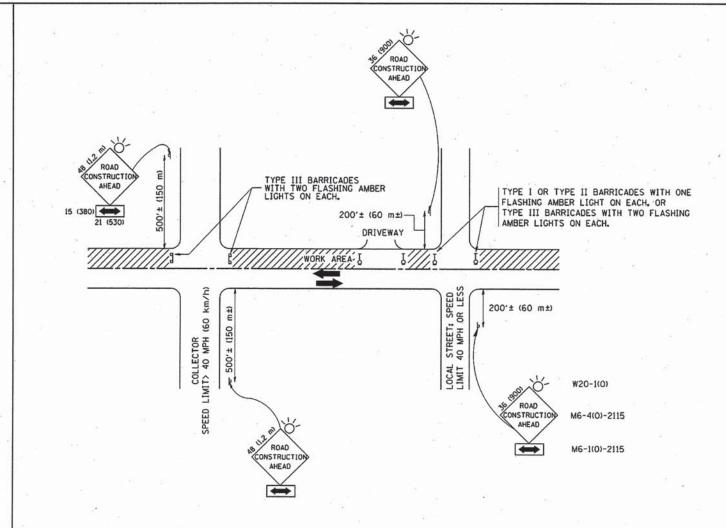

TRAFFIC CONTROL AND PROTECTION FOR SIDE ROADS, INTERSECTIONS, AND DRIVEWAYS

NOTES:

- A. FOR NO LANE RESTRICTION ON THE SIDE ROAD OR DRIVEWAYS
- 1. SIDE ROAD WITH A SPEED LIMIT OF 40 MPH (60 km/h) OR LESS AS SHOWN ON THE DRAWING AND AS DIRECTED BY THE ENGINEERS
- O) ONE ROAD CONSTRUCTION AHEAD SIGN 36 × 36 (900×900) WITH A FLASHER AND FLAG MOUNTED ON IT APPROXIMATELY 200' (60 m) IN ADVANCE OF THE MAIN ROUTE.
- b) THE CLOSED PORTION OF THE MAIN ROLTE SHALL BE PROTECTED BY BLOCKING WITH TYPE 1. TYPE II OR TYPE III BARRICADES, 1/3 OF THE CROSS SECTION OF THE CLOSED PORTION.
- 2. SIDE ROAD WITH A SPEED LIMIT GREATER THAN 40 MPH (60 km/h) AS SHOWN ON THE DRAWING AND AS DIRECTED BY THE ENGINEERS
- O) ONE ROAD CONSTRUCTION AHEAD SIGN 48 x 48 (1,2 m x 1,2 m) WITH A FLASHER MOUNTED ON IT APPROXIMATELY 500' (150 m) IN ADVANCE OF THE MAIN ROUTE,
- b) THE CLOSED PORTION OF THE MAIN ROUTE SHALL BE PROTECTED BY BLOCKING WITH TYPE III BARRICADES, 1/2 OF THE CROSS SECTION OF THE CLOSED PORTION.
- 3. WHEN THE SIDE ROAD LIES BETWEEN THE BEGINNING OF THE MAINLINE SIGNING AND THE WORK ZONE, A SINGLE HEADED ARROW (MG-I) SHALL BE USED IN LIEU OF THE DOUBLE HEADED ARROW (MG-4).

SCALE:

- B. FOR A LANE CLOSURE ON A SIDE ROAD OR DRIVEWAY:
- USE APPLICABLE PORTIONS OF THE TYPICAL APPLICATION OF TRAFFIC CONTROL DEVICES (STD. 701501, STD. 701606 OR THE APPROPRIATE STANDARD). THE SPACING OF SIGNS AND BARRICADES SHALL BE ADJUSTED FOR FIELD CONDITIONS AS DIRECTED BY THE ENGINEER. THE DIRECTIONAL ARROW SHALL BE COVERED OR REMOVED WHEN NO LONGER CONSISTENT WITH THE SIDE ROAD LANE CLOSURE.
- C. ADVANCE WARNING SIGNS ARE TO BE OMITTED ON DRIVEWAY UNLESS OTHERWISE NOTED.
- D. THE TRAFFIC CONTROL AND PROTECTION FOR SIDE ROADS, INTERSECTIONS, AND DRIVEWAYS SHALL BE INCIDENTAL TO THE COST OF SPECIFIED TRAFFIC CONTROL STANDARDS OR ITEMS.


All dimensions are in millimeters (inches) unless otherwise shown.



USER NAME = bas	DESIGNED - BJB	REVISED -	
	DRAWN - BJB	REVISED -	
PLOT SCALE = 1.0000 '/ in.	CHECKED - MJF	REVISED -	
PLOT DATE = 1/19/2016	DATE - 01/22/16	REVISED -	

STATE OF ILLINOIS
DEPARTMENT OF TRANSPORTATION

	TR	IDOT DISTRICT 1 DETAILS TRAFFIC CONTROL AND PROTECTION FOR											
	SIDE	ROA	DS, IN	ITER	SECTIONS	S, AND	DRIVEWAYS						
	SHEET	1	OF	1	SHEETS	STA.	TO STA.						

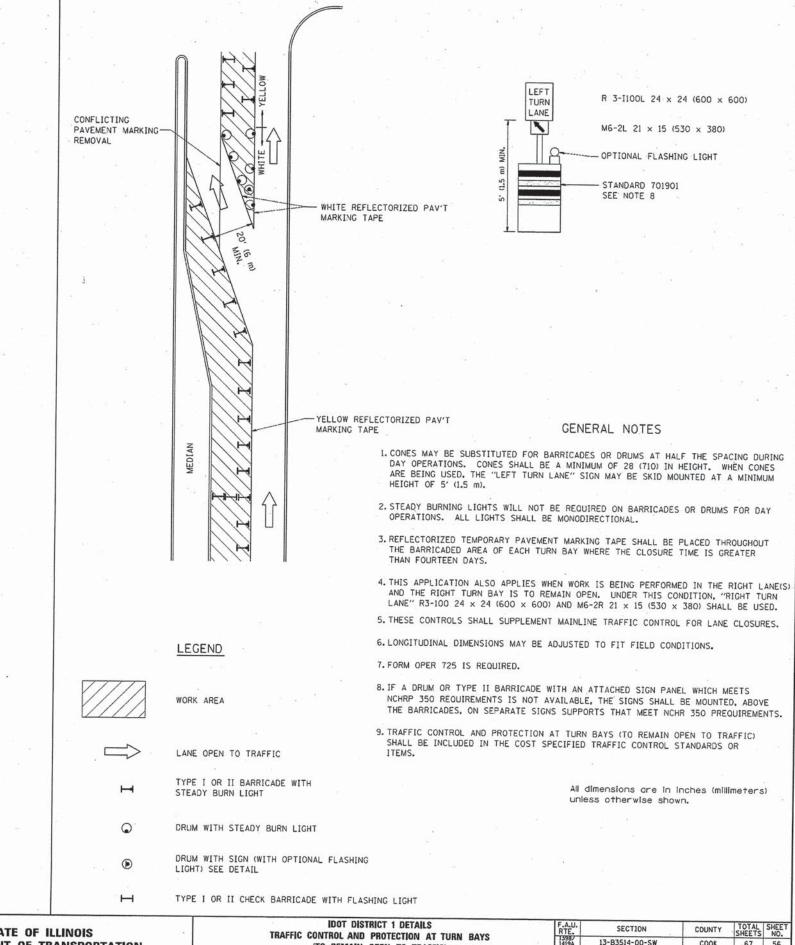

CIVILTECH


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PLOT DATE = 1/19/2016	DATE - 01/22/16	REVISED -	\neg


STATE OF ILLINOIS DEPARTMENT OF TRANSPORTATION

SCALE:

TRAFFIC					DETAILS CTION AT TURN	DAVO	
IIIAIIIO					TO TRAFFIC)	BATS	
SHEET	1	OF	1	SHEETS	STA.	TO STA.	

COUNTY TOTAL SHEETS NO. COOK 67 56 13-B3514-00-SW CONTRACT NO. 61C49 TC-14

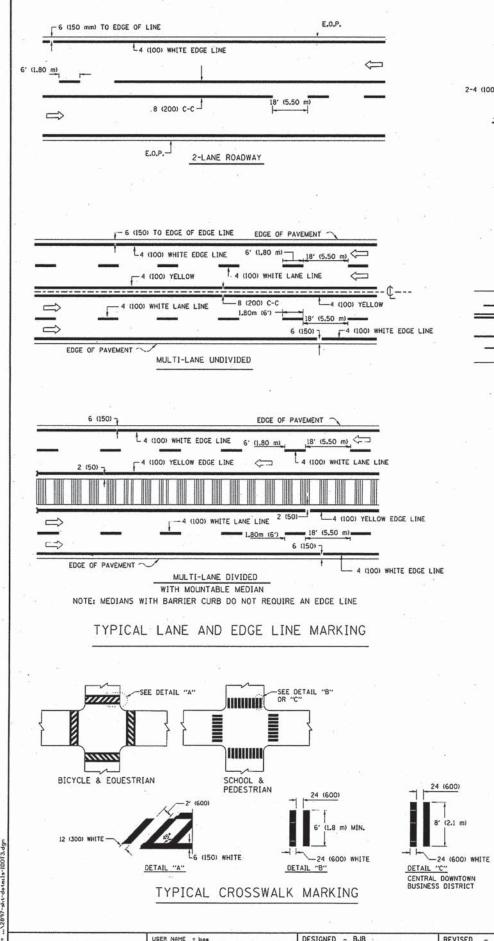


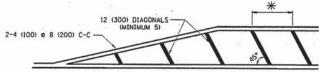

*FOR MEDIAN LENGTHS WHERE DIAGONAL SPACING CANNOT BE ATTAINED, USE 5 (FIVE) EQUALLY SPACED DIAGONAL LINES.

* DIAGONAL LINE SPACING: 20' (6.1 m) C-C

PAINTED MEDIANS

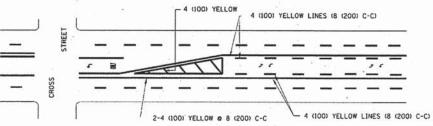


A MINIMUM OF TWO PAIRS OF TURN ARROWS SHALL BE USED, WHITE IN COLOR.
ADDITIONAL PAIRS SHALL BE PLACED AT 200' (50 m) TO 300' (90 m) INTERVALS



MEDIAN WITH TWO-WAY LEFT TURN LANE

TYPICAL PAINTED MEDIAN MARKING

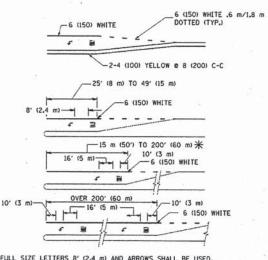


FULL SIZE LETTERS 8' (2.4 m) AND ARROWS SHALL BE USED. \P AREA = 15.8 SO. FT. (1.47 m²) ONLY AREA = 22.9 SO. FT. (2.13 m²)

* TURN LANES IN EXCESS OF 400' (120 m) IN LENGTH MAY HAVE AN ADDITIONAL SET OF ARROW - "ONLY" INSTALLED MIDWAY BETWEEN THE OTHER TWO SETS OF ARROW - "ONLY".

TYPICAL LEFT (OR RIGHT) TURN LANE

TYPICAL TURN LANE MARKING

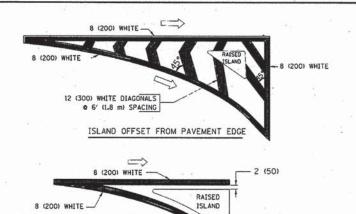

TYPICAL ISLAND MARKING

ISLAND AT PAVEMENT EDGE

-2 (50)


TYPE OF MARKING	WIDTH OF LINE	PATTERN	COLOR	SPACING / REMARKS
CENTERLINE ON 2 LANE PAVEMENT	4 (100)	SKIP-DASH	YELLOW	6' (1.80 m) LINE WITH 18' (5.50 m) SPACE
CENTERLINE ON MULTI-LANE UNDIVIDED PAVEMENT	2 @ 4 (100)	SOLID	YELLOW	8 (200) C-C
NO PASSING ZONE LINES: FOR ONE DIRECTION FOR BOTH DIRECTIONS	4 (100) 2 © 4 (100)	SOLID SOLID	YELLOW	8 (200) C-C
LANE LINES	4 (100) 5 (125) ON FREEWAYS	SKIP-DASH SKIP-DASH	WHITE WHITE	6' (1.80 m) LINE WITH 18' (5.50 m) SPACE
DOTTED LINES (EXTENSIONS OF CENTER, LANE OR TURN LANE MARKINGS)	SAME AS LINE BEING EXTENDED	SKIP-DASH	SAME AS LINE BEING EXTENDED	2' (600) LINE WITH 6' (1.8) SPACE
EDGE LINES	4 (100)	SOLID	YELLOW-LEFT WHITE-RIGHT	OUTLINE MOUNTABLE MEDIANS IN YELLOW: EDGE LINES ARE NOT USED NEXT TO BARRIER CURB
TURN LANE MARKINGS	6 (150) LINE; FULL SIZE LETTERS & SYMBOLS (8' (2.4 m))	SOLID	WHITE	SEE TYPICAL TURN LANE MARKING DETAIL
TWO WAY LEFT TURN MARKING	2 @ 4 (100) EACH DIRECTION	SKIP-DASH AND SOLID	YELLOW	6' (1.8 m) LINE WITH 18' (5.50 m) SPACE FOR SKIP-DASH: 8 (200) C-C BETWEEN SOLID LINE AND SKIP-DASH LINE
	8' (2.4 m) LEFT ARROW	IN PAIRS	WHITE	SEE TYPICAL TWO-WAY LEFT TURN MARKING DETAIL
CROSSWALK LINES A. DIAGONALS (BIKE & EQUESTRIAN) B. LONGITUDINAL BARS (SCHOOL & PEDESTRIAN)	12 (300) e 45° 24 (600) e 90°	SOLID SOLID	WHITE	2' (600) APART 2' (600) APART SEE TYPICAL CROSSWALK MARKING DETAILS.
STOP LINES	24 (600)	SOLID	WHITE	PLACE 4' (1.2 m) IN ADVANCE OF AND PARALLEL TO CROSSWALK, IF PRESENT. OTHERWISE, PLACE AT DESIRED STOPPING POINT. PARALLEL TO CROSSROAD CENTERLINE, WHERE POSSIBLE
PAINTED MEDIANS	2 © 4 (100) WITH 12 (300) DIAGONALS © 45°	SOLID	YELLOW: TWO WAY TRAFFIC WHITE: ONE WAY TRAFFIC	8 (200) C-C FOR THE DOUBLE LINE SEE TYPICAL PAINTED MEDIAN MARKING.
GORE MARKING AND CHANNELIZING LINES	8 (200) WITH 12 (300) DIAGONALS @ 45°	SOLID	WHITE	DIAGONALS: 20' (6,1 m) (LESS THAN 30 MPH (50 km/h))
RAILROAD CROSSING	24 (600) TRANSVERSE LINES: "RR" IS 6' (L8 m) LETTERS: 16 (400) LINE FOR "X"	SOLID	WHITE	SEE STATE STANDARD 780001 AREA OF: "R"2-3.6 SO. FT. (0.33m ²) EACH "X"254.0 SO. FT. (5.0 m ²)


FOR FURTHER DETAILS ON PAVEMENT MARKING REFER TO STREET MARKING STANDARDS, PRINTED BY CITY OF CHICAGO, DEPARTMENT OF TRANSPORTATION, BURGAU OF TRAFFIC.

ALL DIMENSIONS ARE IN INCHES (MILLIMETERS) UNLESS OTHERWISE SHOWN.

	USER NAME = bas	DESIGNED - BJB	REVISED -	
		DRAWN - BJB	REVISED -	
CIVILTECH	PLOT SCALE = 1.0000 '/ in.	CHECKED - MJF	REVISED -	
OTTABLE CIT	PLOT DATE = 1/19/2016	DATE - 01/22/16	REVISED -	

IDOT DISTRICT 1 DETAILS						F.A.U. RTE.	SECTION	COUNTY	TOTAL	SHEET NO.		
CITY OF CHICAGO				1398/ 1419A 13-B3514-00-SW		COOK	COOK 67					
TYPICAL PAVEMENT MARKINGS			TC-	24	CONTRACT	NO.	61C49					
SCALE:	SHEET	1	OF	3	SHEETS	STA.	TO STA.		ILLINOIS FED.			01010

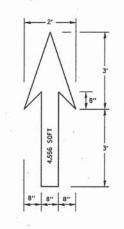


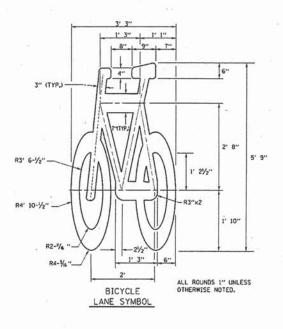

NOTE:
1.) FOR BIKE LANE SYMBOLS ONLY, USE PRE-FORMED THERMOPLASTIC WITH A MINIMUM THICKNESS OF 90 MILS, MINIMUM SKID RESISTANCE VALUE OF 60 BPN. & A MINIMUM INDEX OF REFRACTION OF 1.50.

2.) THE RESIDENT ENGINEER SHALL CONTACT MR. BEN GOMBERG AT 312-744-8093 AT LEAST ONE CALENDAR WEEK PRIOR TO INSTALLING BIKE LANE SYMBOLS.

TYPICAL BIKE LANE SYMBOLS DRAWING #28

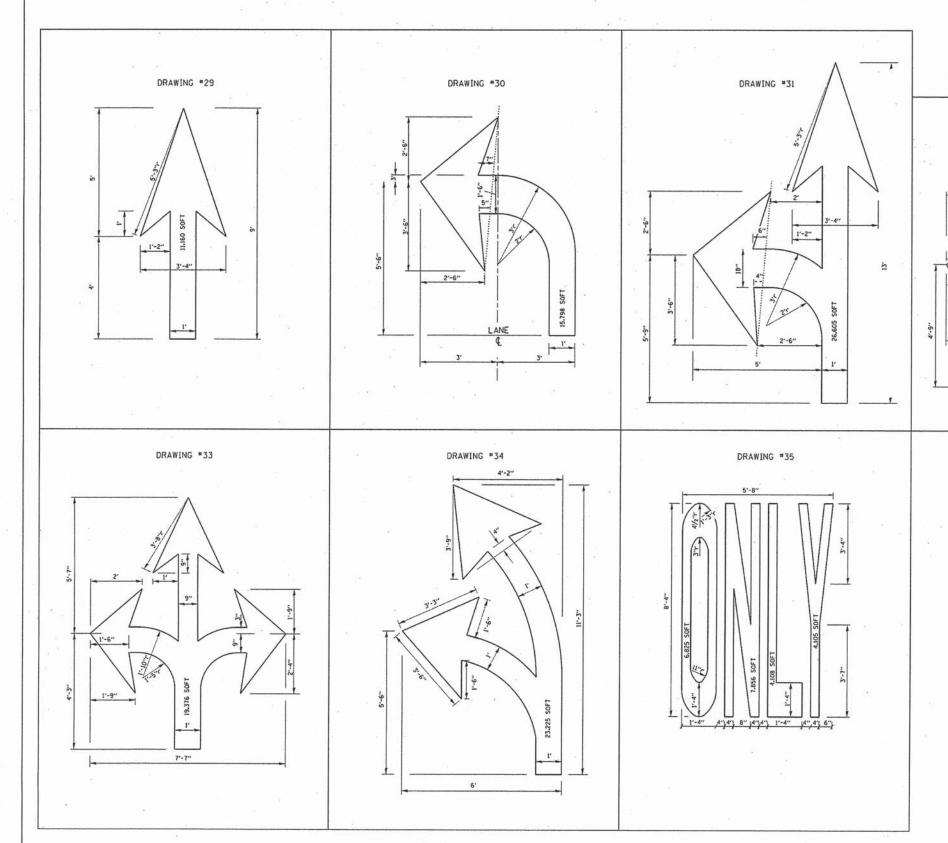

CIVILTECH

USER NAME = bos	DESIGNED - BJB	REVISED -
	DRAWN - BJB	REVISED -
PLOT SCALE = 1.0000 '/ in.	CHECKED - MJF	REVISED -
PLOT DATE = 1/19/2016	DATE - 01/22/16	REVISED -

STATE OF ILLINOIS **DEPARTMENT OF TRANSPORTATION**

			IDOT	DI	STRICT 1	DETAILS	
		т		5.11.5	OF CHIC	AGO MARKINGS	
CALE:	SHEET	2	OF	3	SHEETS	STA.	TO S

 COUNTY
 TOTAL SHEETS NO.


 COOK
 67
 58


 CONTRACT NO.
 61C49
 SECTION 13-B3514-00-SW TC-24

ALL MARKINGS SHALL BE SOLID WHITE UNLESS OTHERWISE NOTED IN THE

PLANS

DRAWING #32

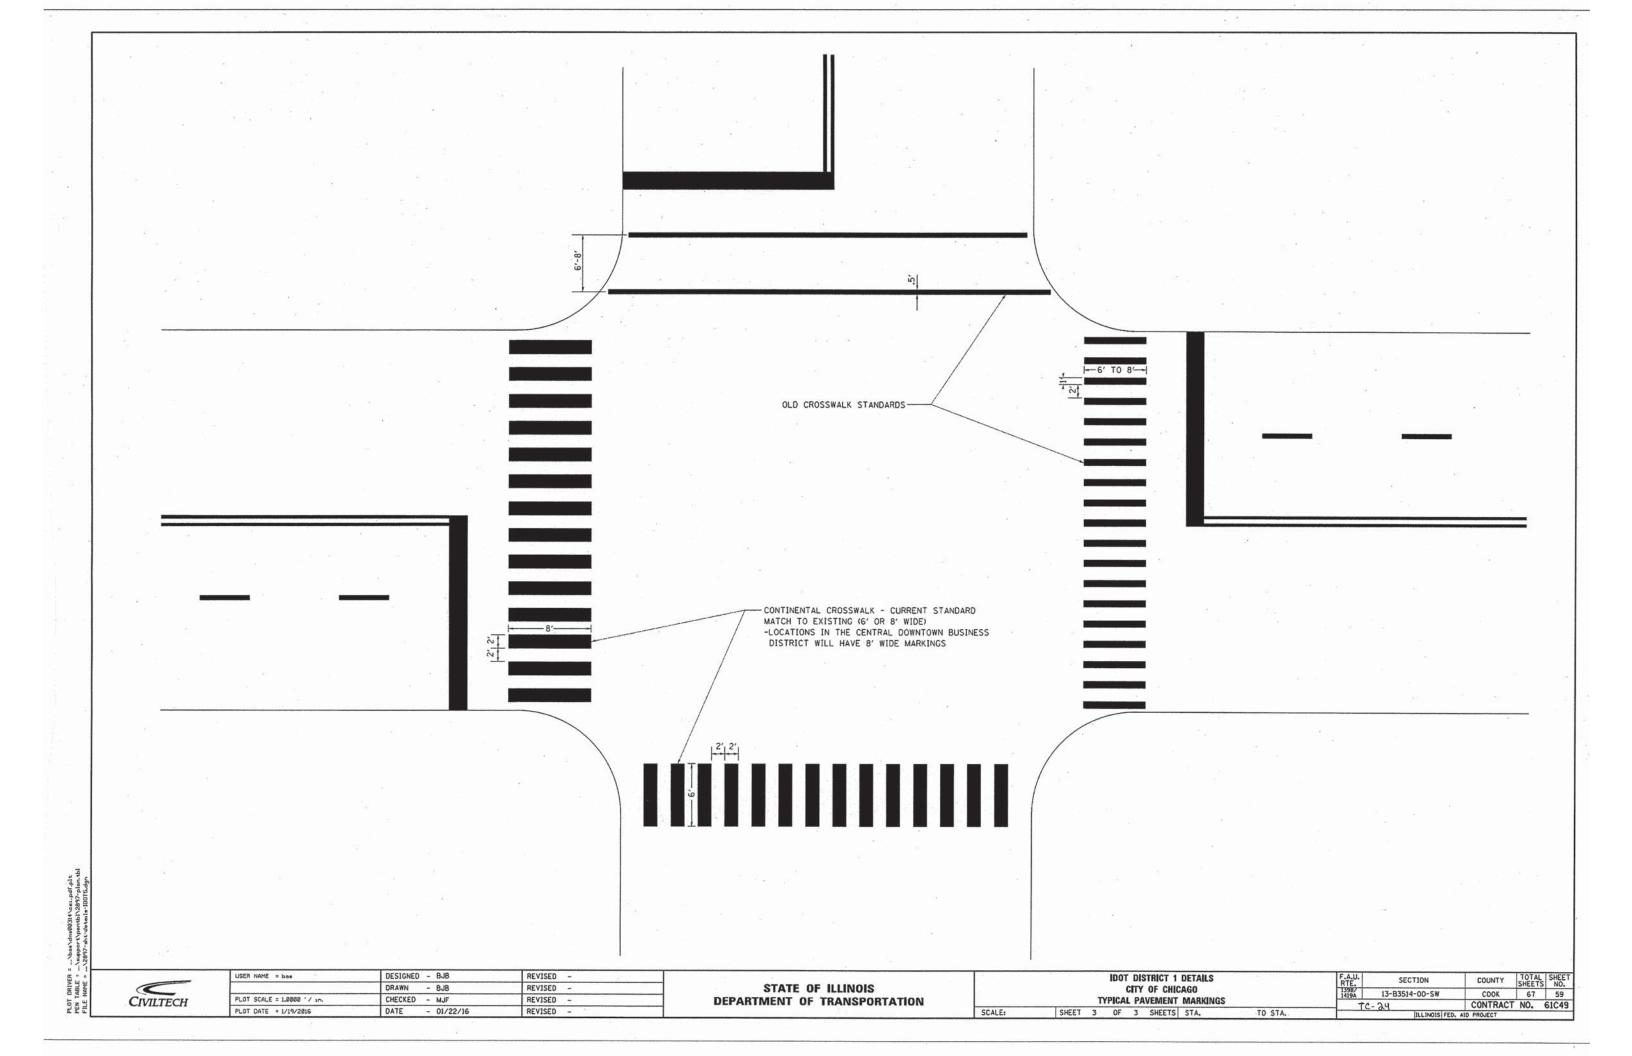

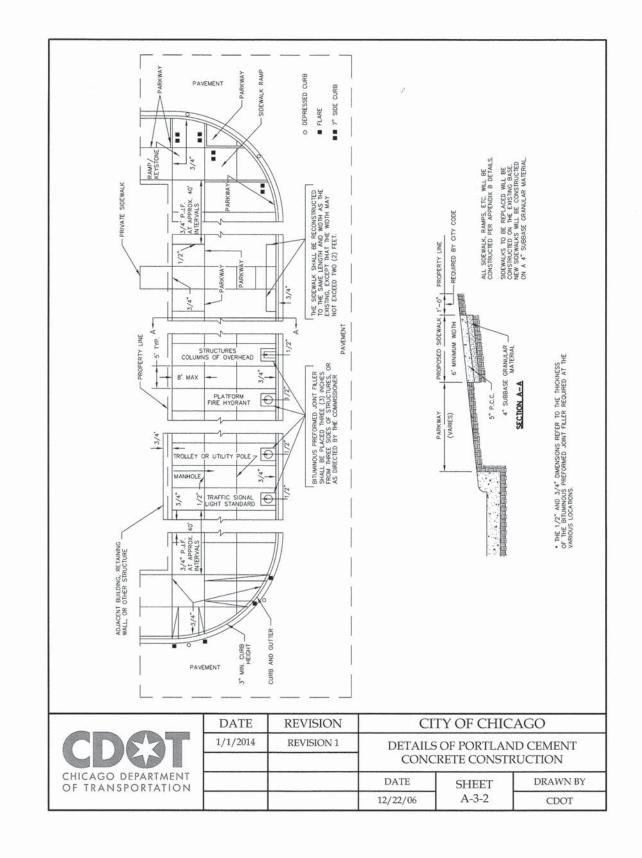

NOTE: H = VARIABLE 3" TO 9"

X = THICKNESS OF PAVEMENT


Y = ONE HALF THE THICKNESS OF CONCRETE PAVEMENT OR CONCRETE BASE.

Z = 10" OR THICKNESS OF PAVEMENT — WHICHEVER IS GREATER

TYPE B OR TYPE 4 CURB

BARRIER CURB

TYPE BV. 12 OR TYPE 3 CURB & GUTTER

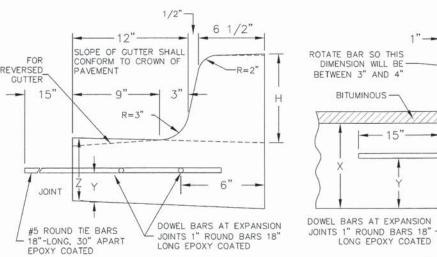

JOINTS IN CURB, COMBINED CURB & GUTTER

TRANSVERSE JOINTS OF A TYPE SIMILAR TO THAT USED IN THE ADJACENT PAVEMENT SHALL BE INSTALLED IN THE TRANSVERSE JOINTS OF A TYPE SIMILAR TO THAT USED IN THE ADJACENT PAVEMENT SHALL BE INSTALLED IN THE CURB, GUTTER AND COMBINED CURB & GUTTER IN PROLONGATION WITH THE JOINTS IN THE PAVEMENT. THE DETAILS OF THE TRANSVERSE JOINTS IN THE CURB, GUTTER AND COMBINED CURB & GUTTER SHALL BE APPROVED BY THE COMMISSIONER. CURB, GUTTER OR COMBINED CURB & GUTTER IS CONSTRUCTED ADJACENT TO A FLEXIBLE BASE PAVEMENT, 1" THICK EXPANSION JOINTS COMPOSED OF BITUMINOUS PERFORMED JOINT FILLER SHALL BE INSTALLED IN THE CURB AND/OR GUTTER AT POINTS OF CURVATURE AND AT CONSTRUCTION JOINTS. CONTRACTION JOINTS SHALL ALSO BE PLACED BETWEEN THESE EXPANSION JOINTS AT DISTANCES NOT EXCEEDING 20 FEET. ALL TIE BARS SHALL BE DEFORMED-ALL DOWEL BARS SHALL BE SMOOTH.

NOTE: ALL TIE BARS AND DOWEL BARS TO BE EPOXY COATED.

SCALE:

*AT LOCATIONS REQUIRING DEPRESSED CURBS SEE THE ADA STANDARDS FOR CONSTRUCTION DETAILS

	DATE	REVISION	CI	TY OF CHIC	AGO
CDXT	1/1/2014	REVISION 1	CONC	CRETE CURB &	GUTTER
CHICAGO DEPARTMENT OF TRANSPORTATION			DATE	SHEET	DRAWN BY
OF TRANSPORTATION			12/12/06	A-2-6	CDOT


CIVILTECH


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	DRAWN - BJB	REVISED -	
PLOT SCALE = 1.0000 '/ in.	CHECKED - MJF	REVISED -	
PLOT DATE = 1/19/2016	DATE - 01/22/16	REVISED -	

STATE OF ILLINOIS **DEPARTMENT OF TRANSPORTATION**

CHICAGO	WEST	SIDE	SAF	FR	OUTES	то ѕсноо	L ENHANCEMENTS	F.A.U. RTE. 1398/ 1419A	SECTION	COUNTY	TOTAL SHEETS	SHEET NO.
omondo		CDOT STANDARD						1398/ 1419A	13-B3514-00-SW	COOK	67	60
								_		CONTRACT	NU.	61C49
	SHEET	1	OF	2	SHEETS	STA.	TO STA.		ILLINOIS FED.	AID PROJECT		

#6 TIE BARS, 30" APART EPOXY COATED

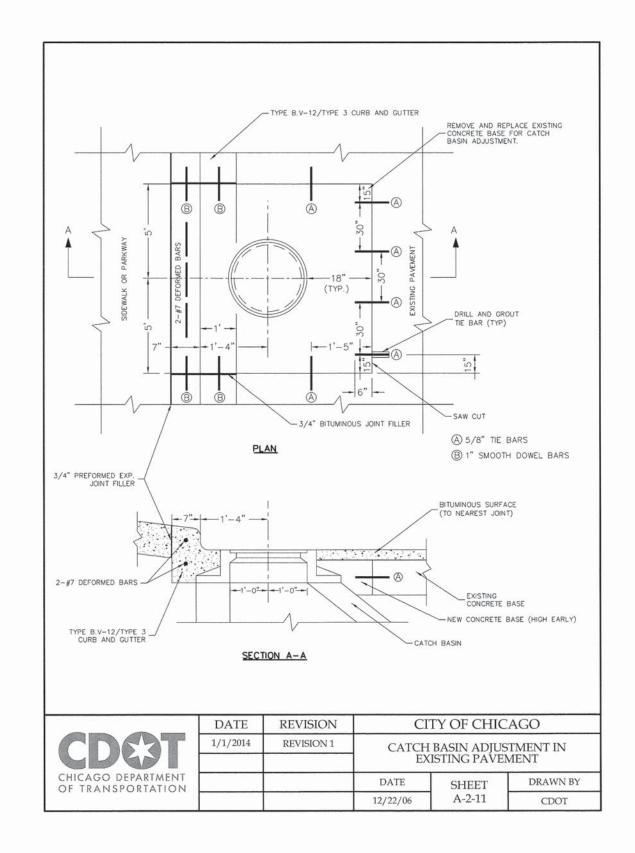

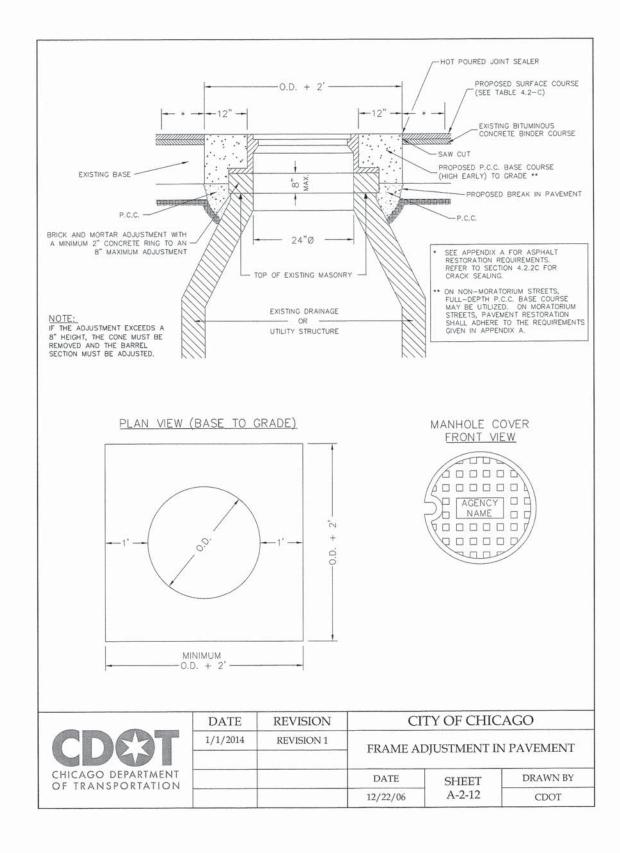





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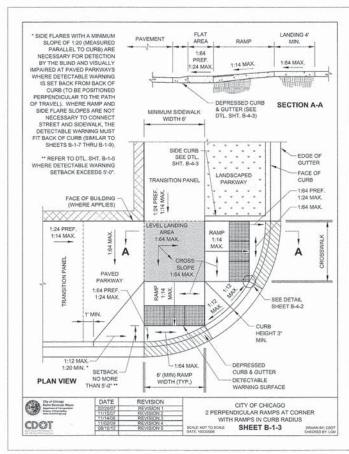



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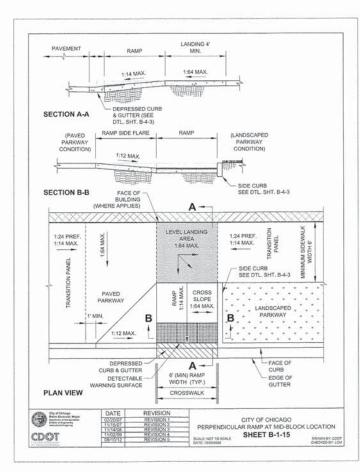
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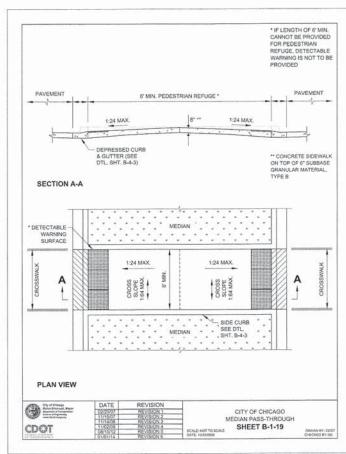






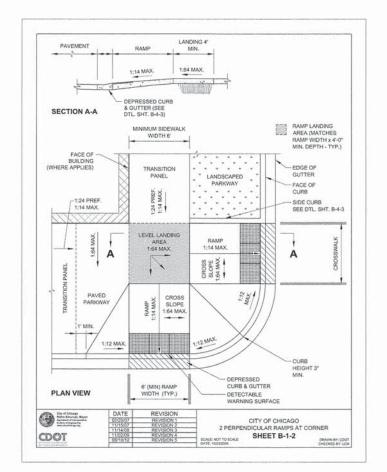

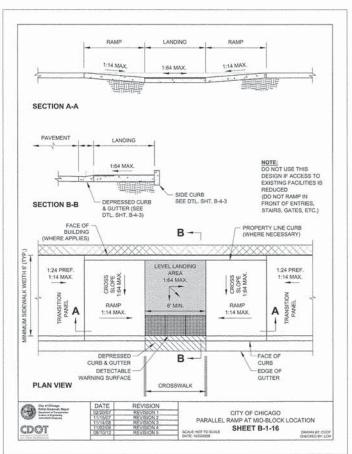

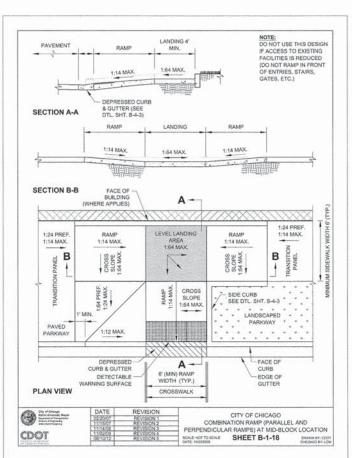




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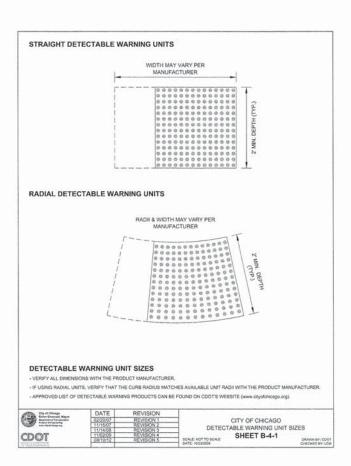
STATE OF ILLINOIS
DEPARTMENT OF TRANSPORTATION

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CONTRACT NO. 61C49

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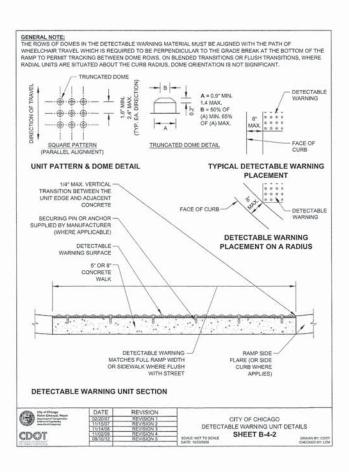


GENERAL NOTES:

- 1. THE DETECTABLE WARNING USED SHALL BE CHOSEN FROM THE CHICAGO DEPARTMENT OF TRANSPORTATION LIST OF APPROVED DETECTABLE WARNING PRODUCTS (MVAILABLE ON THE CITY OF CHICAGO WEBSITE, IT IS NOT ACCEPTABLE TO NISTALL TWO DIFFERENT DETECTABLE WARNING PRODUCTS ADJACENT TO ONE ANOTHER AT ANY LOCATION. BY THE CENTRAL BUSINESS DISTRICT, GRANITE OR OTHER SPECIALTY PAVING MATERIALS MAY BE SUBMITTED TO THE COMBISSIONER FOR APPROVAL.
- 2. THE DETECTABLE WARNING MUST BE INSTALLED A MAXIMUM OF 8" OR LESS FROM FACE OF CURB (SEE DETAIL SHEET B-4-2).
- SHEET 18-42).

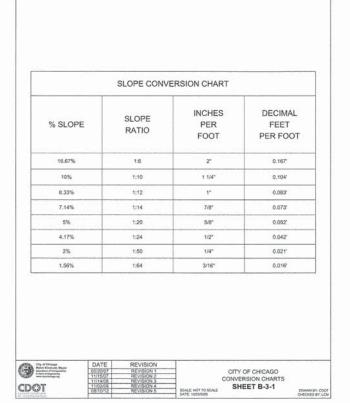 3. THE DETECTABLE WARNING MUST COVER FULL WIDTH OF RAMP EXCLUDING SIDE FLARES FOR A MINIMUM UNOBSTRUCTED DEPTH OF 24". THE DETECTABLE WARNING LOCATED ON THE SURFACES OF RAMPS IS TYPICALLY ORIENTED PERPENDICULAR TO THE RUN OF THE RAMP UNLESS SPECIAL. CIRCUMSTANCES OCCUR (SEE DETAIL SHEET 81-15). THE DETECTABLE WARNING MUST SE PROVIDED FOR A MINIMUM DEPTH OF 24" FOR THE ENTIRE LENGTH OF THE SIDEWALK WHERE THE SIDEWALK IS FLUSH WITH THE STREET (DEPRESSED CURS OR FLUSH TRANSITION). IF IT IS NECESSARY TO CUT A UNIT(S) IN THE PROVISION OF A COMPLIANT RAMP OR SIDEWALK WITH 24" MINIMUM DEPTH OF DETECTABLE WARNING, THE UNITS SHALL BE CUT IN A NEAT AND WORKMAN LIKE MANNER PER MANUFACTURERS REQUIREMENTS WITH A MINIMUM OF THREE PINS OR ANCHOR POINTS (WHERE APPLICABLE). THE UNITS SHALL BE ARRANGED SO THAT THE CUT UNITS ARE LARGE ENOUGH TO BE PROPERLY AND ADEQUATELY SECURED. CUT UNITS SHALL NOT BE USED UNLESS ALL OTHER DESIGN OPTIONS HAVE BEEN EXHAUSTED. THE USE OF SALVAGE PIECES FROM UNITS THAT ARE CUT WILL NOT BE PERMITTED WITHOUT WINITETED WITHOUT WINITETED WITHOUT WINITETED WITHOUT WINITETED WITHOUT WINITETED WITHOUT WINITETED WITHOUT BE REMOVED FROM THE SITE AND DISPOSED OF PROPERLY.
- WHERE APPLICABLE, A COMBINATION OF STRAIGHT AND RADIAL DETECTABLE WARNING COMPOUND AND LARGE RADII. CONTRACTOR MUST MAKE THIS DETERMINATION AND VER
- 5. THE DETECTABLE WARNING MUST CONTRAST WITH ADJACENT PAVEMENT. IF LIGHT COLORED PAVEMENT IS USED THE DETECTABLE WARNING COLOR SHALL BE RED. IF A DARK COLORED PAVEMENT IS USED THE DETECTABLE WARNING COLOR SHALL BE VELLOW. CONTRACTOR TO VERIFY THAT PROPER CONTRAST IS
- 7. RAMP WIDTH MUST BE A MINIMUM OF 6'-0" AND IN INCREMENTS OF 1'-0", EXCEPT WHEN USING THE PERPENDICULAR RAMP AT CORNER (OR OTHER SPECIAL, CDOT APPROVED CONDITIONS), WHICH HAS A MINIMUM WIDTH 0F 4-0".
- 8. THE MAXIMUM ALLOWABLE RAMP RUNNING SLOPE IS 1:14, MEASURED AT ANY PORTION OF THE RAMP, IF POSSIBLE, A MORE GRADUAL SLOPE SHALL BE USED, GRADE BREAKS AT THE TOP AND BOTTOM OF RAMPS SHALL BE PERPENDICULAR TO THE DIRECTION OF RAMP RUN.
- THE MAXIMUM ALLOWABLE RAMP CROSS SLOPE IS 1:64, MEASURED AT ANY PORTION OF THE RAMP. IF POSSIBLE, A MORE GRADUAL SLOPE SHALL BE USED.
- 10. THE MAXIMUM ALLOWABLE RAMP LANDING SLOPE IS 1;64, MEASURED AT ANY LOCATION AND IN ANY DIRECTION ON THE LANDING. THE RAMP LANDING WIDTH SHALL MATCH THE FULL WIDTH OF THE RAMP FOR A MINIMUM UNDOSTRUCTED DEPTH OF 4-0°. RAMP LANDINGS SHALL BE PROVIDED AT THE TOP AND/OR BOTTOM OF RAMPS WHERE TURNING IS REQUIRED.
- 11. RAMP SIDE FLARES SHALL BE INSTALLED AT ANY LOCATION WHERE THE SURFACE ADJACENT TO THE RAMP SURFACE IS INTENDED FOR PEDESTRIAN USE. TRIPPING HAZARDS, INCLUDING STEPS, DROP-OFFS, OR CURBS SHALL NOT BE LOCATED WITHIN THE LIMITS OF THE SIDEWAIK, RAMP SIDE PLARES ARE NOT REQUIRED WHERE THE SURFACE ADJACENT TO THE RAMP SURFACE IS LANGSCAPED OR IS OCCUPIED BY A BARRIER THAT BLOCKS PEDESTRIAN ACCESS. EXCEPTIONS TO THIS RULL MAY BE SUBMITTED TO THE COMMISSIONER FOR APPROVAL.

DATE	REVISION			
02/20/07	REVISION 1		CITY OF CHICAGO	
11/15/07	REVISION 2			
11/14/08	REVISION 3	11.5		
11/02/09	REVISION 4		SHEET B-3-2	
08/10/12	REVISION 5	SCALE NOT TO SCALE	OTTERT DO E	DRAWN BY; COOT
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GENERAL NOTES (CONTINUED):

- 12. UTILITIES, SUCH AS LIGHT POLES, TRAFFIC POLES AND HYDRANTS, MAY BE LOCATED IN THE FLARE OF THE RAMP BUT ARE NOT ALLOWED ON THE RAMP SUFFACE OR LANDING AREAS. EXISTING UTILITY STRUCTURE LIDS MAY REMAIN WITHIN THE FLARE OR ON THE SURFACE OF THE RAMP IF THE REQUIREMENTS OF GENERAL NOTE #19 ARE MET.
- 13. ALL LOCATIONS WITH TYPE 4 OR TYPE B CURB (EXCEPT ALLEY APRONS) SHALL BE CONSTRUCTED AS CURB AND GUTTER TYPE BV.12 THROUGH THE LIMITS OF THE CORNER AND THE CURB RAMPS.
- 14. ALTERATIONS SHALL NOT DECREASE THE ACCESSIBILITY TO EXISTING FACILITIES, SIDEWALKS LEADING TO EXISTING FACILITIES, OR DOOR OR GATE ACCESS POINTS TO FACILITIES. THE ELEVATION AT THE EXISTING PROPERTY LINE OR FACILITY ACCESS POINT SHALL BE MAINTAINED AT A MINIMUM, ANY ALTERATIONS ADJACENT TO OR AFFECTING A FACILITY ACCESS POINT SHALL BE MAINTAINED AT A MINIMUM ANY ALTERATIONS ADJACENT TO OR AFFECTING A FACILITY ACCESS POINT SHALL RESULT IN IMPROVED ACCESS OR AT A MINIMUM A PREPLICATION OF EXISTING DOMESTIONS. FACILITIES INCLUDE. BUT ARE NOT LIMITED TO PROVIDE BUT ARE NOT LIMITED TO STORY.
- 15. THE MINIMUM CROSSWALK WIDTH IS 6-0°, CROSSWALKS SHALL BE LOCATED AS SHOWN IN THE PLAN SHEETS DEPENDING ON THE TYPE OF CURB RAMP USED, BEYOND THE CURB FACE AT THE BASE OF CURB RAMPS, A CLEAR SPACE OF 4-0° BY 4-0° MINIMUM SHALL BE PROVIDED WITHIN THE STRIPES OF THE CROSSWALK (WHERE PROVIDED).
- 16. IF SIDEWALK AND ALLEY ARE AT THE SAME GRADE, A RAMP IS NOT REQUIRED. IF SIDEWALK AND DRIVEWAY ARE AT THE SAME GRADE, A RAMP IS NOT REQUIRED BUT DETECTABLE WARNING UNITS ARE STILL REQUIRED IF THE DRIVEWAY HAS TRAFFIC CONTROL DEVICES (I.E. TRAFFIC SIGNALS).
- 17. MAIN LINE SIDEWALK SHALL HAVE A MAXIMUM CROSS SLOPE NOT TO EXCEED 1:84 FOR THE FULL WIDTH OF WALK UNLESS OTHERWISE APPROVED BY THE COMMISSIONER, WHERE TURNING IS REQUIRED AND WHERE SIDEWALKS INLERSECT, THE SLOPE OF THE SIDEWALK SHALL NOT EXCEED 1:84 IN ANY DIRECTION.
- 18. MAIN LINE SIDEWALK RUNNING SLOPES SHALL NOT EXCEED 1:24 OR THE GENERAL GRADE ESTABLISHED FOR THE ADJACENT STREET, WHICH EVER IS HIGHER.
- 19. THERE SHALL BE NO VERTICAL LEVEL DIFFERENCES BETWEEN SURFACES GREATER THAN 1/4" ON THE MAIN LINE SIDEWALK. THERE SHALL BE NO HORIZONTAL GAPS OR OPENINGS GREATER THAN 1/2" ON THE MAIN LINE SIDEWALK.
- 20. WHERE OBSTRUCTIONS EXIST ON THE MAINLINE SIDEWALK, THE CLEAR WIDTH OF USEABLE SIDEWALK SHALL NOT BE LESS THAN 4-0". OBSTRUCTIONS INCLUDE, BUT ARE NOT LAMITED TO SIDEWALK BENCHES, FIRE HYDRANTS, SIGNAL OR LIGHT POLES, NEWSPAPER DISPENSERS, TRASH RECEPTACLES, AND UTLITY PEDESTALS.
- 21. CURB RAMPS AND LANDING (KEYSTONE) TO BE CONSTRUCTED WITH 8" THICK CONCRETE AT ALL TRAFFIC SIGNALIZED INTERSECTIONS AND INDUSTRIAL STREET INTERSECTIONS. AT ALL OTHER LOCATIONS, 5" THICK CONCRETE TO BE USED.
- 22. DEPRESSED CURB. RAMP, OR SIDEWALK DESIGNS OR LAYOUTS SHALL MAINTAIN OR IMPROVE EXISTING DRAINAGE AND THE EXISTING INTERSECTION GEOMETRY SHALL NOT BE MODIFIED WITHOUT CDOT APPROVA
- 23. ALL CONSTRUCTION DOCUMENTS MUST BE STAMPED BY A LICENSED ARCHITECT/LANDSCAPE ARCHITECT/ ENGINEER TO CERTIFY THAT THEY ARE IN ACCORDANCE WITH THE AMERICANS WITH DISABILITIES ACT (ADA) AND ALL CODES AND BUILDING PORDINANCES OF THE CITY OF CHICAGO AND THE STATE OF ALLWIGS.
- 24. NO DEVIATIONS FROM THESE STANDARDS ARE ALLOWED WITHOUT WRITTEN APPROVAL FROM THE

Chy of Chicago Rahm Emanori, Magar Rahm Emanori, Magar Rahm of System In second Strains In	DATE	REVISION	
	02/20/07	REVISION 1	CITY OF CHICAGO
	11/15/07	REVISION 2	GENERAL NOTES (CONTINUED)
	11/14/08	REVISION 3	
COCT	11/02/09	REVISION 4	SHEET B-3-3
CD61	09/10/12	REVISION 5	SCALE: NOT TO SCALE DRAWN BY: COOT
EL STABLISHMAN	01/01/14	REVISION 6	DATE: 10/23/2009 CHECKED BY: DK


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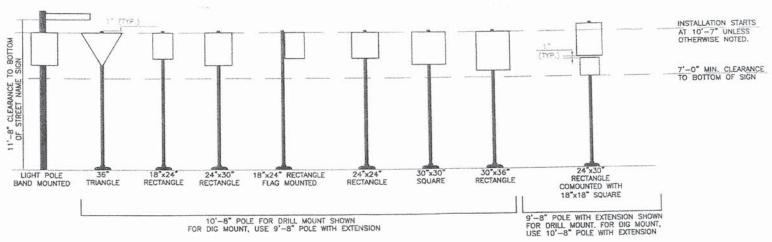
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		CONTRACT	NO.	61C4
1398/ 1419A	13-B3514-00-SW	COOK	67	63
RTE.	SECTION	COUNTY	TOTAL	SHEE NO.

REGULATORY TRAFFIC SIGNS STOP AND ONE—WAY SIGNS (CHICAGO STYLE)




TYPICAL LAYOUT

REGULATORY TRAFFIC SIGNS (CHICAGO STYLE)

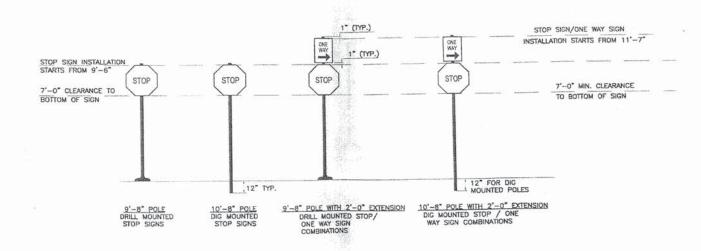


TYPICAL LAYOUT

REGULATORY TRAFFIC SIGNS TRAFFIC SIGNAL CONTROL SERIES (SIGNAL POST)

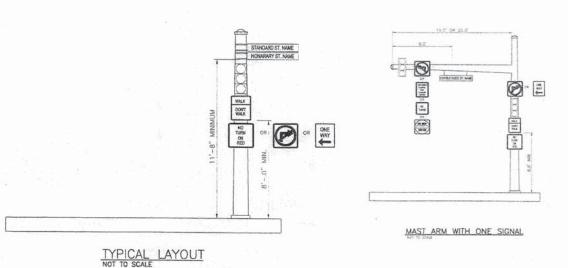


REGULATORY TRAFFIC SIGNS TRAFFIC SIGNAL CONTROL SERIES (MAST ARMS)

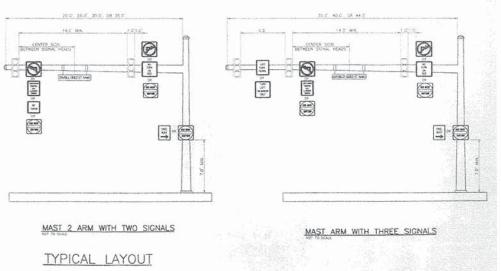

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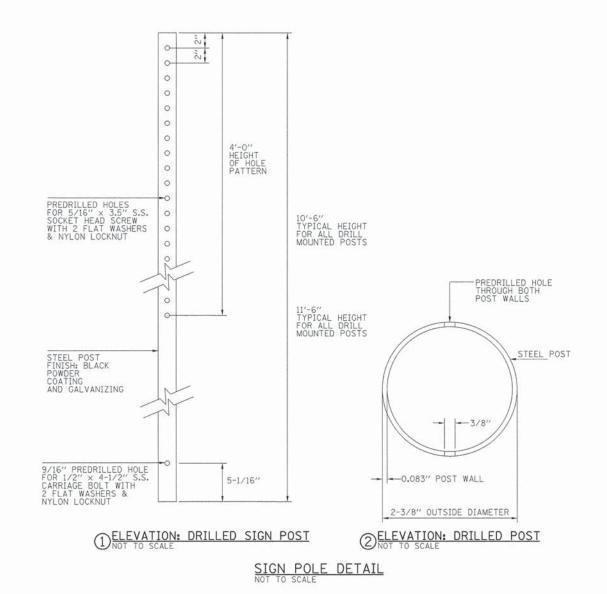
SIGN QUARTERING AT INTERSECTIONS

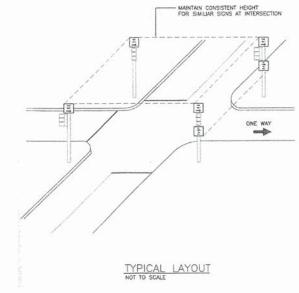

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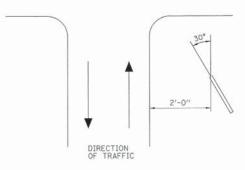
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			S	IGN	ING DET	AILS				CONTRACT	NO.	61C49
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"W","D" & "S" SERIES SIGNS BRACING REQUIRED ON SIGNS OVER 24" IN WIDTH 6" MIN. - 2" SPACING PREFERRED (SEE NOTES) "R" SERIES SIGN TRAFFIC CONTROL 2'-0" MIN. - EXISTING GROUND NOTE: 2" SPACING MAY BE REDUCED IF REQUIRED TO MAINTAIN MIN. 7'-O" CLEARANCE TO BASE OF SIGN.


CENTER MOUNTED SIGN INSTALLATION
NOT TO SCALE




MOUNTING DETAIL

FOR: TRAFFIC CONTROL SIGNS WITH DIRECTIONAL ARROWS

PARKING REGULATIONS SIGNS WITH DIRECTIONAL ARROWS

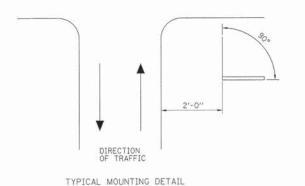

SIGN MOUNTING DETAILS

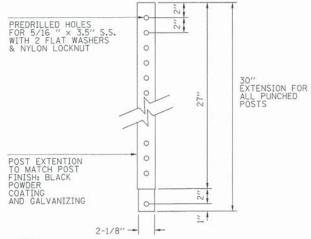


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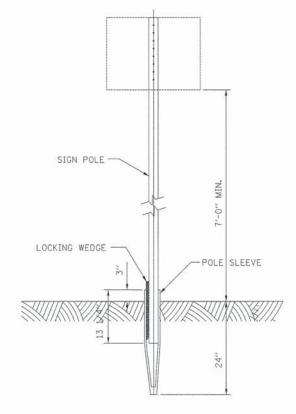
PROVIDE ADDITIONAL TWO SETS OF PREDRILLED HOLES ON EXTENSION, HOLES SHALL BE LOCATED AT 30 33/64 ANGLE TO HOLES SHOWN IN SECTION 3. HOLES SHALL ACCOMMODATE 5/16 "X 3.5" S.S. SOCKET HEAD SCREW WITH 2 FLAT WASHERS AND NYLON LOCKNUT.

SECTION: DRILLED POST EXTENSION NOT TO SCALE




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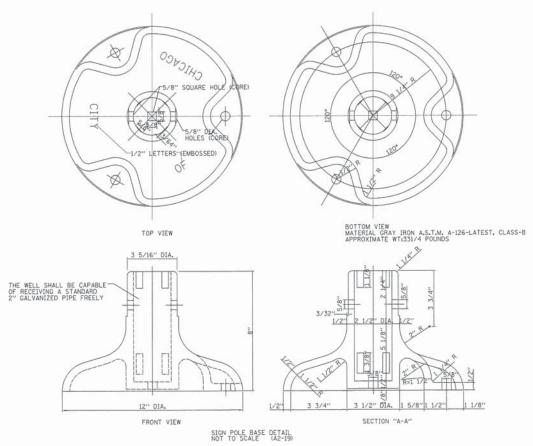


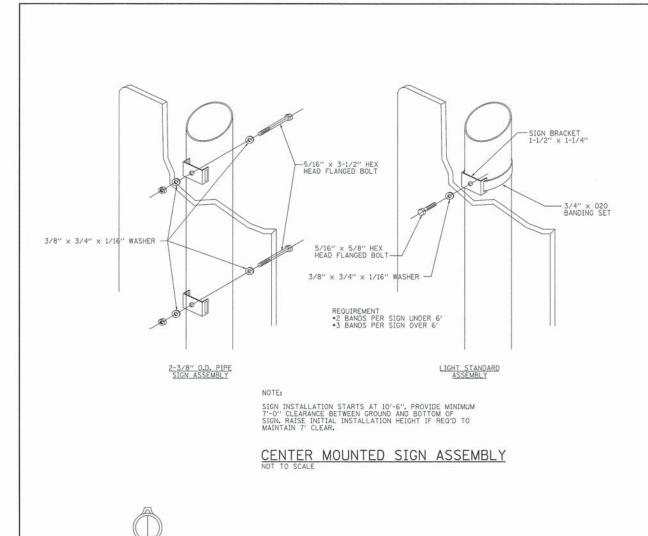

GROUND DIG INSTALLATION DETAIL NOT TO SCALE

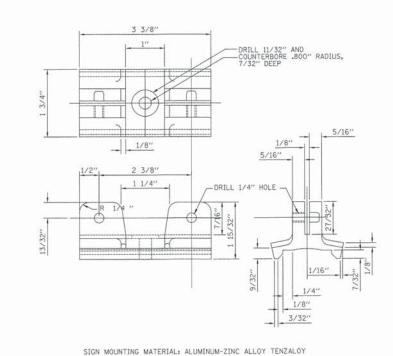

SIGN MOUNTING BRACKET DETAIL (VERSION 2A)



CITY OF CHICAGO SIGN BASE

12 GAUGE	CONTOUR FOR 2-7/8"x2-3/8" PIPE SOCKET 9/16" HOLE
~	8-1/2"

PIPE SOCKET AND WEDGE DETAIL

	_	_	-
		_	

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WEDGE

STATE OF ILLINOIS


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SECTION COUNTY COOK 13-B3514-00-SW CONTRACT NO. 61C49 TILL TNOIS FED. AID PROJECT

POLE SLEEVE


DEPARTMENT OF TRANSPORTATION

REGULATORY PARKING SIGNS (CHICAGO STYLE)

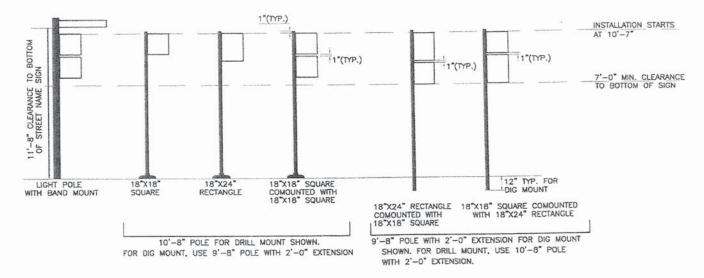

TYPICAL LAYOUT


WARNING AND SCHOOL SIGNS (CHICAGO STYLE)

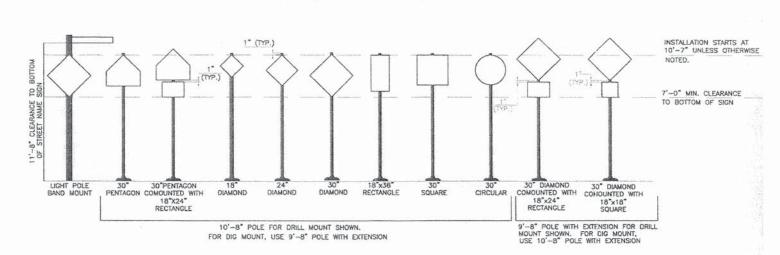

TYPICAL LAYOUT


NOT TO SCALE

SIGN TWINNING ALONG BLOCK

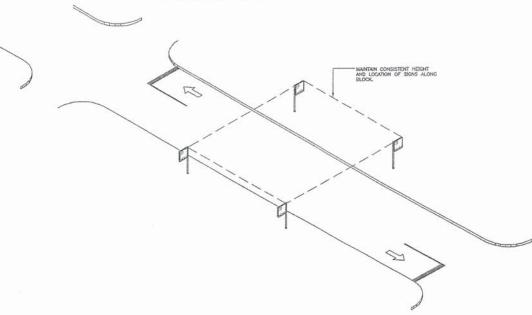

TYPICAL LAYOUT- 660 FOOT BLOCK

GUIDE SIGNS STREET NAME LOCATION AT UNSIGNALIZED INTERSECTION OF TWO LOCAL STREETS

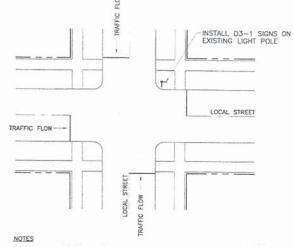

WHEN NO EXISTING LIGHT POLES ARE LOCATED AT INTERSECTION, INSTALL SIGNS ON NORTHEAST CORNER OR ABOVE STOP SIGNS.


- 2. WHEN MORE THAN ONE LIGHT POLE IS LOCATED AT INTERSECTION, INSTALL SIGNS ON ONE POLE USING ORDER OF PREFERENCE SHOWN BELOW.

 (1) NORTHEAST CORNER
 (2) NORTHEAST CORNER
 (3) SOUTHEAST CORNER
 (4) SOUTHEAST CORNER
 (4) SOUTHEAST CORNER

TYPICAL LAYOUT

GUIDE SIGNS STREET NAME LOCATION AT UNSIGNALIZED INTERSECTION OF LOCAL STREET

AND ARTERIAL STREET

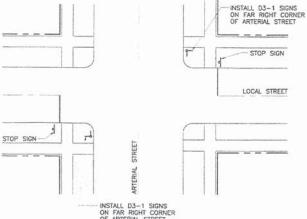

NOTES:

- SIGNS SHOULD BE BANDED TO EXISTING LIGHT POLES WHENEVER POSSIBLE.

TYPICAL LAYOUT

CIVILTECH

DESIGNED - BJB REVISED SECTION CHICAGO WEST SIDE SAFE ROUTES TO SCHOOL ENHANCEMENTS STATE OF ILLINOIS DRAWN BJB REVISED 13-B3514-00-SW COOK SIGNING DETAILS PLOT SCALE = 1.0000 '/ in. CHECKED -MJF REVISED **DEPARTMENT OF TRANSPORTATION** CONTRACT NO. 61C49 TO STA. SHEET 4 OF 4 SHEETS STA. DATE 01/22/16 REVISED