



FAU ROUTE	SECTION	COUNTY	TOTAL SHEETS	SHEET NO.
2637	19-00114-00-RS	DuPAGE	32	1
ILLINOIS			CONTRACT NO. 61H39	

03/11/2022 Letting Item 096

STATE OF ILLINOIS  
DEPARTMENT OF TRANSPORTATION


**PROPOSED PLANS FOR  
FEDERAL AID HIGHWAY  
FAU ROUTE 2637 (FAIRVIEW AVENUE)  
FAU 1504 (55TH STREET) TO FAP 0311 ( US 34 - OGDEN AVENUE)  
RESURFACING  
SECTION No.: 19-00114-00-RS  
PROJECT No: 91TH(535)  
VILLAGE OF DOWNERS GROVE  
DuPAGE COUNTY  
C-91-105-20**

FOR INDEX OF SHEETS, SEE SHEET NO. 2

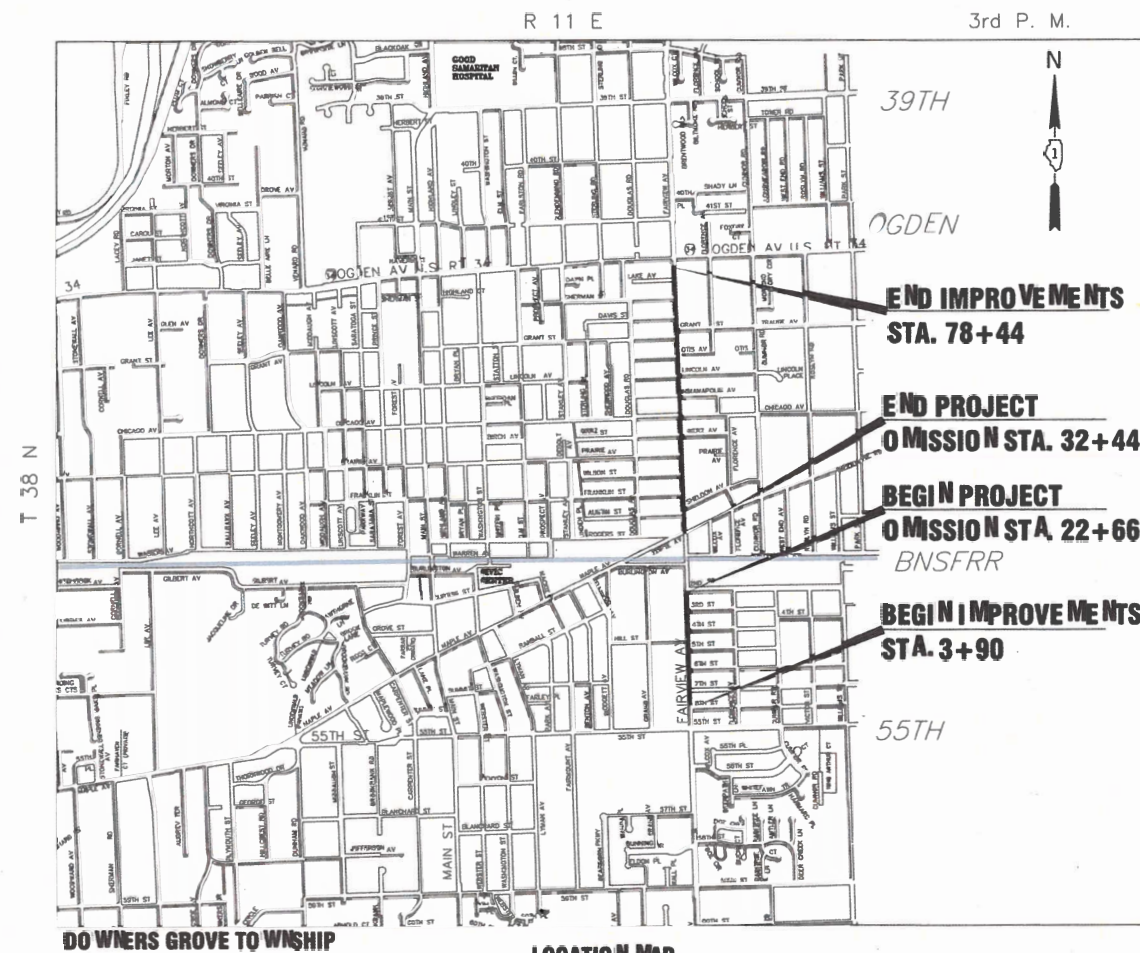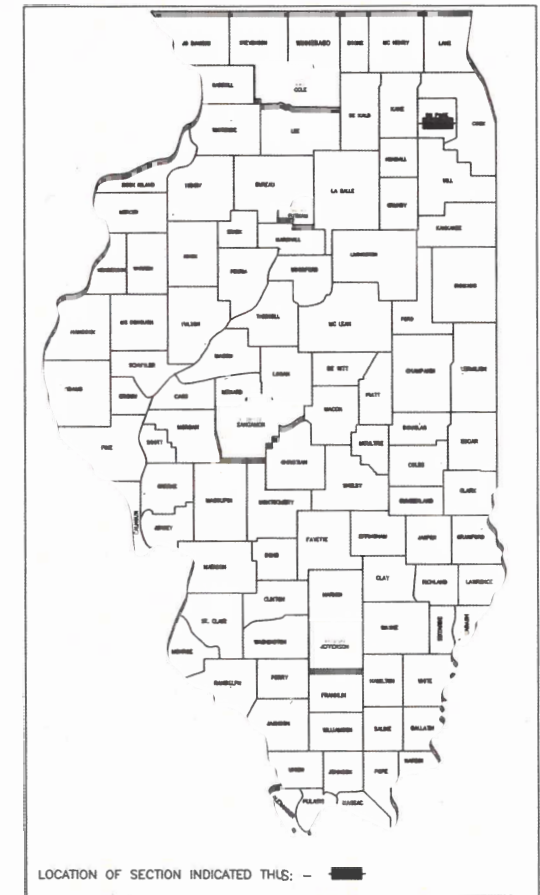

GROSS LENGTH = 7,454.29 FT = 1.411 MILE

NET LENGTH = 6,483.20 FT = 1.228 MILE

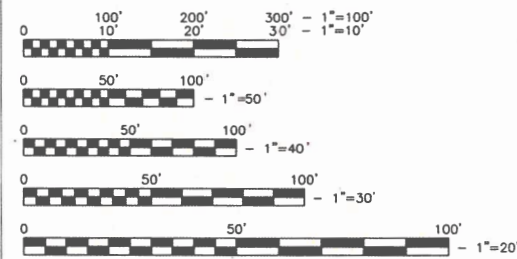

FULL SIZE PLANS HAVE BEEN PREPARED USING STANDARD ENGINEERING SCALES. REDUCED SIZE PLANS WILL NOT CONFORM TO STANDARD SCALES. IN MAKING MEASUREMENTS ON REDUCED PLANS, THE ABOVE SCALES MAY BE USED.

JULIE  
JOINT UTILITY LOCATION INFORMATION FOR EXCAVATION  
1 800-892 0123  
OR 811

CONTRACT NO. 61H39

FEDERAL AID PROGRAM ENGINEER: CARMEN E. RAMOS, P. E. SCHAUMBURG, IL



John M. Welch, P.E.  
Village of Downers Grove  
Expires 1/30/23

**FAIRVIEW AVENUE DESIGN  
DESIGNATION  
MINOR ARTERIAL  
DESIGN SPEED: 30 MPH  
SCHOOL ZONE SPEED: 20 MPH  
ADT = 14,900**

STATE OF ILLINOIS DEPARTMENT OF TRANSPORTATION	
APPROVED	<i>[Signature]</i> 2021
VILLAGE OF DOWNERS GROVE, DIRECTOR OF PUBLIC WORKS	
PASSED	<i>[Signature]</i> 2/22
DISTRICT 1 ENGINEER OF LOCAL ROADS AND STREETS	
RELEASING FOR BID BASED ON LIMITED REVIEW	<i>[Signature]</i> 2022
REGIONAL ENGINEER	

**PRINTED BY THE AUTHORITY  
OF THE STATE OF ILLINOIS**

## INDEX OF SHEETS

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2	INDEX OF SHEETS, HIGHWAY STANDARDS, LIST OF DETAILS, AND GENERAL NOTES
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8	PROPOSED TYPICAL SECTIONS
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12	PLAN SHEET (STA. 36+00 TO STA. 48+00)
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15	PLAN SHEET (STA. 72+00 TO STA. 79+10)
16 - 19	CURB RAMP DETAILS
20 - 21	VILLAGE DETAILS
22 - 32	DISTRICT 1 DETAILS

## HIGHWAY STANDARDS

000001-08	STANDARD SYMBOLS, ABBREVIATIONS, AND PATTERNS
280001-07	TEMPORARY EROSION CONTROL SYSTEMS
424001-11	PERPENDICULAR CURB RAMPS FOR SIDEWALKS
424011-04	CORNER PARALLEL CURB RAMPS FOR SIDEWALKS
424016-05	MID-BLOCK CURB RAMPS FOR SIDEWALKS
442201-03	CLASS C & D PATCHES
606001-08	CONCRETE CURB TYPE B & COMBINATION CONCRETE CURB AND GUTTER
701006-05	OFF-RD OPERATIONS, 2L, 2W, 15' TO 24" FROM PAVEMENT EDGE
701101-05	OFF-RD OPERATIONS, MULTILANE, 15' TO 24" FROM PAVEMENT EDGE
701311-03	LANE CLOSURE, 2L, 2W MOVING OPERATIONS - DAY ONLY
701427-05	LANE CLOSURE, MULTILANE, INTERMITTENT OR MOVING OPER., FOR SPEEDS < 40 MPH
701501-06	URBAN LANE CLOSURE, 2L, 2W, UNDIVIDED
701502-09	URBAN LAND CLOSURE 2L, 2W, WITH BIDIRECTIONAL LEFT TURN LANE
701602-10	URBAN LANE CLOSURE, MULTILANE, 2W WITH BIDIRECTIONAL LEFT TURN LANE
701606-10	URBAN SINGLE LANE CLOSURE, MULTILANE, 2W WITH MOUNTABLE MEDIAN
701701-10	URBAN LANE CLOSURE, MULTILANE INTERSECTION
701801-06	SIDEWALK, CORNER OR CROSSWALK CLOSURE
701901-08	TRAFFIC CONTROL DEVICES
886001-01	DETECTOR LOOP INSTALLATIONS

## LIST OF DETAILS

BD-08	DETAILS FOR FRAMES AND LIDS ADJUSTMENT WITH MILLING
BD-22	PAVEMENT PATCHING FOR HMA SURFACED STREETS
BD-32	BUTT JOINT AND HMA TAPER DETAILS
TC-10	TRAFFIC CONTROL AND PROTECTION FOR SIDE ROADS, INTERSECTIONS AND DRIVEWAYS
TC-13	DISTRICT 1 TYPICAL PAVEMENT MARKINGS DETAIL
TC-14	TRAFFIC CONTROL AND PROTECTION AT TURN BAYS (TO REMAIN OPEN TO TRAFFIC)
TC-16	PAVEMENT MARKING LETTERS & SYMBOLS FOR TRAFFIC STAGING
TC-22	ARTERIAL ROAD INFORMATION SIGN
TC-26	DRIVEWAY ENTRANCE SIGNING
TS-05	DISTRICT 1 STANDARD TRAFFIC SIGNAL DESIGN DETAILS
TS-07	DISTRICT 1 - DETECTOR LOOP INSTALLATION DETAILS FOR ROADWAY RESURFACING

## GENERAL NOTES

- ALL REFERENCES TO THE 'VILLAGE' IN THESE GENERAL NOTES SHALL BE INTERPRETED TO MEAN THE VILLAGE OF DOWNERS GROVE.
- THOSE EXISTING TRAFFIC SIGNS WHICH ARE SO DESIGNATED BY THE ENGINEER SHALL BE REMOVED, STORED AND SUBSEQUENTLY RELOCATED BY THE CONTRACTOR IN ACCORDANCE WITH ARTICLE 107.25. ANY SIGNS WHICH ARE DAMAGED BY THE CONTRACTOR AS DETERMINED BY THE ENGINEER SHALL BE REPLACED IN KIND BY THE CONTRACTOR.
- ALL TRAFFIC CONTROL AND OTHER ADVISORY SIGNS NEEDED FOR CONSTRUCTION ARE TO BE FURNISHED BY THE CONTRACTOR IN ACCORDANCE WITH THE PLANS AND IDOT STANDARDS FOR TRAFFIC CONTROL AND PROTECTION.
- SAW CUTTING OF PAVEMENTS, SIDEWALK, ETC. SHALL BE FULL DEPTH AND SHALL RESULT IN A CLEAN STRAIGHT EDGE ON THE PORTION REMAINING.
- THE CONTRACTOR SHALL BE RESPONSIBLE FOR THE PROTECTION OF ALL UNDERGROUND OR SURFACE UTILITIES EVEN THOUGH THEY MAY NOT BE SHOWN ON THE PLANS. ANY UTILITY THAT IS DAMAGED DURING CONSTRUCTION SHALL BE REPAIRED OR REPLACED TO THE SATISFACTION OF THE ENGINEER.
- WHENEVER, DURING CONSTRUCTION OPERATIONS, ANY LOOSE MATERIAL IS DEPOSITED IN THE FLOW LINE OF DRAINAGE STRUCTURES SUCH THAT THE NATURAL FLOW OF WATER IS OBSTRUCTED, IT SHALL BE REMOVED AT THE CLOSE OF EACH WORKING DAY. AT THE CONCLUSION OF CONSTRUCTION OPERATIONS, ALL DRAINAGE STRUCTURES SHALL BE FREE OF DIRT AND DEBRIS.
- THE CONTRACTOR SHALL NOT OPEN OR SHUT ANY WATER VALVES OR FIRE HYDRANTS WITHOUT PRIOR AUTHORIZATION FROM THE VILLAGE WATER DEPARTMENT.
- THE THICKNESS OF THE HOT-MIX ASPHALT MIXTURES SHOWN IN THE PLANS ARE NOMINAL. DEVIATIONS MAY OCCUR DUE TO IRREGULARITIES IN THE SURFACES OR BASE ON WHICH THEY ARE PLACED. PLAN THICKNESS SHOULD BE CONSIDERED THE MINIMUM THICKNESS PERMITTED.
- MAILBOXES WHICH ARE IN CONFLICT WITH PROPOSED IMPROVEMENTS SHALL BE REMOVED, TEMPORARILY RELOCATED, AND REPLACED UPON COMPLETION OF THE PROPOSED IMPROVEMENTS IN ACCORDANCE WITH ARTICLE 107.20 AND AS DIRECTED BY THE ENGINEER.
- THE CONTRACTOR SHALL CONTACT THE IDOT ARTERIAL DISTRICT ONE TRAFFIC CONTROL SUPERVISOR KALPANA KANNAN-HOSADURGA AT KALPANA.KANNAN-HOSADURGA@ILLINOIS.GOV A MINIMUM OF 72 HOURS IN ADVANCE OF BEGINNING WORK.

## COMMITMENTS

- LOCAL PSI WILL BE COMPLETED IN PHASE 2 IF NECESSARY.
- SPECIAL WASTES WILL BE RISK MANAGED ACCORDING TO SECTION 669 OF THE IDOT "STANDARD SPECIFICATIONS FOR ROAD AND BRIDGE CONSTRUCTION AND SUPPLEMENTAL SPECIFICATIONS AND RECURRING SPECIAL PROVISIONS" AND APPLICABLE PAY ITEMS SHALL BE INCLUDED IN PHASE 2 PLANS AND SPECIFICATIONS AS NECESSARY.
- IMPACT TO DETECTOR LOOPS ON OGDEN AVENUE (US ROUTE 34) WILL BE COORDINATED TO BUREAU OF TRAFFIC THROUGH BLRS IN PHASE 2.

## STATE OF ILLINOIS DEPARTMENT OF TRANSPORTATION

## INDEX OF SHEETS, HIGHWAY STANDARDS, LIST OF DETAILS AND GENERAL NOTES

FILE NAME =	USER NAME -- USER	DESIGNED -- NRH	REVISED	NOT TO SCALE   SHEET NO. 1 OF 1 SHEETS   STA. TO STA.	ILLINOIS   FED. AID PROJECT
FILE NAME =		DRAWN -- NRH	REVISED		
	PLOT SCALE --	CHECKED -- SAV	REVISED		
	PLOT DATE -- 12/17/21	DATE -- 12/17/21	REVISED		

F.A.U. RTE.	SECTION	COUNTY	TOTAL SHEETS	SHEET NO.
2637	19-00114-00-RS	DuPAGE	32	2
CONTRACT NO. 61H39				

CODE NO.	ITEM	UNIT	TOTAL QUANTITY	CONSTRUCTION CODE	
				STP FUNDS	
				70% FED / 30% LA	70% FED / 30% LA
				ROADWAY	TRAINEES
				0005	0042
				URBAN	URBAN
20101100	TREE TRUNK PROTECTION	EACH	10	10	
△ 20101200	TREE ROOT PRUNING	EACH	10	10	
20200100	EARTH EXCAVATION	CU YD	50	50	
21001000	GEOTECHNICAL FABRIC FOR GROUND STABILIZATION	SQ YD	150	150	
21101615	TOPSOIL FURNISH AND PLACE, 4"	SQ YD	700	700	
25200100	SODDING	SQ YD	700	700	
25200200	SUPPLEMENTAL WATERING	UNIT	10	10	
28000510	INLET FILTERS	EACH	80	80	
35101600	AGGREGATE BASE COURSE, TYPE B 4"	SQ YD	520	520	
40600290	BITUMINOUS MATERIALS (TACK COAT)	POUND	18,400	18,400	
40600400	MIXTURE FOR CRACKS, JOINTS, AND FLANGWAYS	TON	50	50	
40600982	HOT-MIX ASPHALT SURFACE REMOVAL - BUTT JOINT	SQ YD	715	715	
40603200	POLYMERIZED HOT-MIX ASPHALT BINDER COURSE, 1L-4.75, N50	TON	1,150	1,150	
40604062	HOT-MIX ASPHALT SURFACE COURSE, 1L-9.5, MIX "D", N70	TON	2,300	2,300	
42300200	PORTLAND CEMENT CONCRETE DRIVEWAY PAVEMENT, 6 INCH	SQ YD	50	50	
42300400	PORTLAND CEMENT CONCRETE DRIVEWAY PAVEMENT, 8 INCH	SQ YD	50	50	

\* DENOTES SPECIAL PROVISION  
△ SPECIALTY ITEMS

STATE OF ILLINOIS  
DEPARTMENT OF TRANSPORTATION

SUMMARY OF QUANTITIES

FILE NAME =	USER NAME - USER	DESIGNED - NRH	REVISED	NOT TO SCALE	SHEET NO. 1 OF 4 SHEETS	STA. TO STA.	F.A.U. RTE.	SECTION	COUNTY	TOTAL SHEETS	SHEET NO.
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PLOT DATE - 12/17/21		DATE - 12/17/21	REVISED				ILLINOIS	FED. AID PROJECT			

CODE NO.	ITEM	UNIT	TOTAL QUANTITY	CONSTRUCTION CODE	
				STP FUNDS	
				70% FED / 30% LA	70% FED / 30% LA
				ROADWAY	TRAINEES
				0005	0042
				URBAN	URBAN
42400800	DETECTABLE WARNINGS	SQ FT	500	500	
44000157	HOT-MIX ASPHALT SURFACE REMOVAL, 2"	SQ YD	26,500	26,500	
44000200	DRIVEWAY PAVEMENT REMOVAL	SQ YD	260	260	
44201773	CLASS D PATCHES, TYPE I, 11 INCH	SQ YD	300	300	
44201777	CLASS D PATCHES, TYPE II, 11 INCH	SQ YD	300	300	
44201781	CLASS D PATCHES, TYPE III, 11 INCH	SQ YD	300	300	
44201783	CLASS D PATCHES, TYPE IV, 11 INCH	SQ YD	300	300	
60265700	VALVE VAULTS TO BE ADJUSTED	EACH	13	13	
60266600	VALVE BOXES TO BE ADJUSTED	EACH	11	11	
60300305	FRAMES AND LIDS TO BE ADJUSTED	EACH	24	24	
60406000	FRAMES AND LIDS, TYPE 1, OPEN LID	EACH	1	1	
60406100	FRAMES AND LIDS, TYPE 1, CLOSED LID	EACH	1	1	
△ 66900200	NON-SPECIAL WASTE DISPOSAL	CU YD	50	50	
△ 66900530	SOIL DISPOSAL ANALYSIS	EACH	1	1	
△ 66901001	REGULATED SUBSTANCES PRE-CONSTRUCTION PLAN	LSUM	1	1	
△ 66901003	REGULATED SUBSTANCES FINAL CONSTRUCTION REPORT	LSUM	1	1	

\* DENOTES SPECIAL PROVISION

△ SPECIALTY ITEMS

STATE OF ILLINOIS  
DEPARTMENT OF TRANSPORTATION

SUMMARY OF QUANTITIES

FILE NAME =	USER NAME - USER	DESIGNED - NRH	REVISED
FILE NAME =		DRAWN - NRH	REVISED
PLOT SCALE =		CHECKED - SAV	REVISED
PLOT DATE - 12/17/21		DATE - 12/17/21	REVISED

NOT TO SCALE | SHEET NO. 2 OF 4 SHEETS | STA. TO STA.

FAU 07C	SECTION	COUNTY	TOTAL SHEETS	SHEET NO.
2637	19-00114-00-RS	DuPAGE	32	4
		CONTRACT NO. 61H39		
		ILLINOIS FED. AID PROJECT		

CODE NO.	ITEM	UNIT	TOTAL QUANTITY	CONSTRUCTION CODE	
				STP FUNDS	
				70% FED / 30% LA ROADWAY	70% FED / 30% LA TRAINEES
				0005 URBAN	0042 URBAN
△ 66901006	REGULATED SUBSTANCES MONITORING	CAL DA	5	5	
67100100	MOBILIZATION	LSUM	1	1	
70102620	TRAFFIC CONTROL AND PROTECTION, STANDARD 701501	LSUM	1	1	
70102622	TRAFFIC CONTROL AND PROTECTION, STANDARD 701502	LSUM	1	1	
70102625	TRAFFIC CONTROL AND PROTECTION, STANDARD 701606	LSUM	1	1	
70102632	TRAFFIC CONTROL AND PROTECTION, STANDARD 701602	LSUM	1	1	
70102635	TRAFFIC CONTROL AND PROTECTION, STANDARD 701701	LSUM	1	1	
70102640	TRAFFIC CONTROL AND PROTECTION, STANDARD 701801	LSUM	1	1	
70300100	SHORT TERM PAVEMENT MARKING	FOOT	4,500	4,500	
70300150	SHORT TERM PAVEMENT MARKING REMOVAL	SQ FT	1,850	1,850	
70306100	TEMPORARY PAVEMENT MARKING LETTERS AND SYMBOLS - TYPE III TAPE	SQ FT	350	350	
△ 78000100	THERMOPLASTIC PAVEMENT MARKING - LETTERS AND SYMBOLS	SQ FT	1,310	1,310	
△ 78000200	THERMOPLASTIC PAVEMENT MARKING - LINE 4"	FOOT	13,140	13,140	
△ 78000400	THERMOPLASTIC PAVEMENT MARKING - LINE 6"	FOOT	3,150	3,150	
△ 78000600	THERMOPLASTIC PAVEMENT MARKING - LINE 12"	FOOT	400	400	
△ 78000650	THERMOPLASTIC PAVEMENT MARKING - LINE 24"	FOOT	820	820	

\* DENOTES SPECIAL PROVISION  
△ SPECIALTY ITEMS

**TEMPORARY LETTERS AND SYMBOLS REMOVAL PAY ITEM NOTE**

REMOVAL OF PAY ITEM 70306100 TEMPORARY PAVEMENT MARKING LETTERS AND SYMBOLS - TYPE III TAPE IS INCLUDED IN PAY ITEM 70300150. PAY ITEM X7030125 TEMPORARY PAVEMENT MARKING REMOVAL MAY STILL BE LISTED IN THE PAY ITEM LISTINGS FOR THE LETTING, BUT IT IS OBSOLETE.


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PLOT DATE -- 12/17/21		DATE -- 12/17/21	REVISED			NOT TO SCALE	SHEET NO. 3 OF 4 SHEETS	STA.	TO STA.	ILLINOIS	FED. AID PROJECT

CODE NO.	ITEM	UNIT	TOTAL QUANTITY	CONSTRUCTION CODE	
				STP FUNDS	
				70% FED / 30% LA ROADWAY	70% FED / 30% LA TRAINEES
				0005 URBAN	0042 URBAN
Δ *	88600600	DETECTOR LOOP REPLACEMENT	FOOT	1,600	1,600
*	X0320050	CONSTRUCTION LAYOUT (SPECIAL)	LSUM	1	1
*	X2070304	POROUS GRANULAR EMBANKMENT, SPECIAL	CU YD	50	50
*	X2800510	INLET FILTER CLEANING	EACH	80	80
*	X4240430	PORTLAND CEMENT CONCRETE SIDEWALK 5 INCH, SPECIAL	SQ FT	4,600	4,600
*	X4400500	COMBINATION CURB AND GUTTER REMOVAL (SPECIAL)	FOOT	1,500	1,500
*	X4404700	SIDEWALK REMOVAL (SPECIAL)	SQ FT	4,600	4,600
*	X6030310	FRAMES AND LIDS TO BE ADJUSTED (SPECIAL)	EACH	24	24
*	X6061005	CONCRETE CURB, TYPE B (SPECIAL)	FOOT	150	150
*	X6064200	COMBINATION CONCRETE CURB & GUTTER, TYPE B-6.12 (SPECIAL)	FOOT	1,500	1,500
*	Z0004510	HOT-MIX ASPHALT DRIVEWAY PAVEMENT, 3"	SQ YD	160	160
*	Z0030850	TEMPORARY INFORMATION SIGNING	SQ FT	180	180
*	Z0076600	TRAINEES	HOUR	500	500
*	Z0076604	TRAINEES TRAINING PROGRAM GRADUATE	HOUR	500	500

\* DENOTES SPECIAL PROVISION


Δ SPECIALTY ITEMS

FILE NAME =	USER NAME - USER	DESIGNED - NRH	REVISED	<b>STATE OF ILLINOIS DEPARTMENT OF TRANSPORTATION</b>	<b>SUMMARY OF QUANTITIES</b>	F.A.U. SECTION COUNTY TOTAL SHEET	
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PLOT SCALE -		CHECKED - SAV	REVISED			CONTRACT NO. 61H39	
PLOT DATE - 12/17/21		DATE - 12/17/21	REVISED			ILLINOIS	FED. AID PROJECT
				NOT TO SCALE	SHEET NO. 4 OF 4 SHEETS	STA. TO STA.	

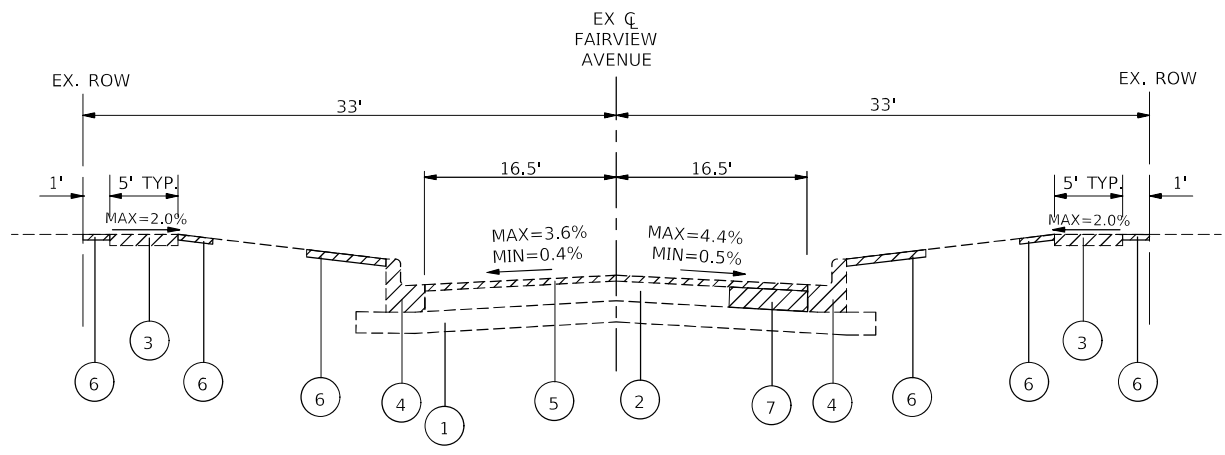


**EXISTING TYPICAL SECTION**

STA. 3+90 TO STA. 21+90, FAIRVIEW AVENUE  
 STA. 36+45 TO STA. 72+66, FAIRVIEW AVENUE

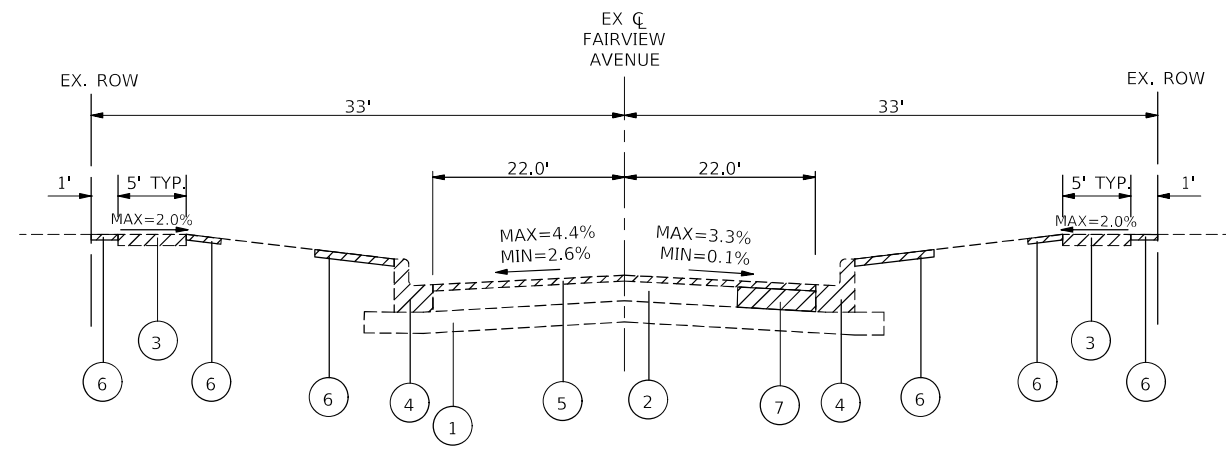


**EXISTING TYPICAL SECTION**

STA. 22+66 TO STA. 35+40, FAIRVIEW AVENUE

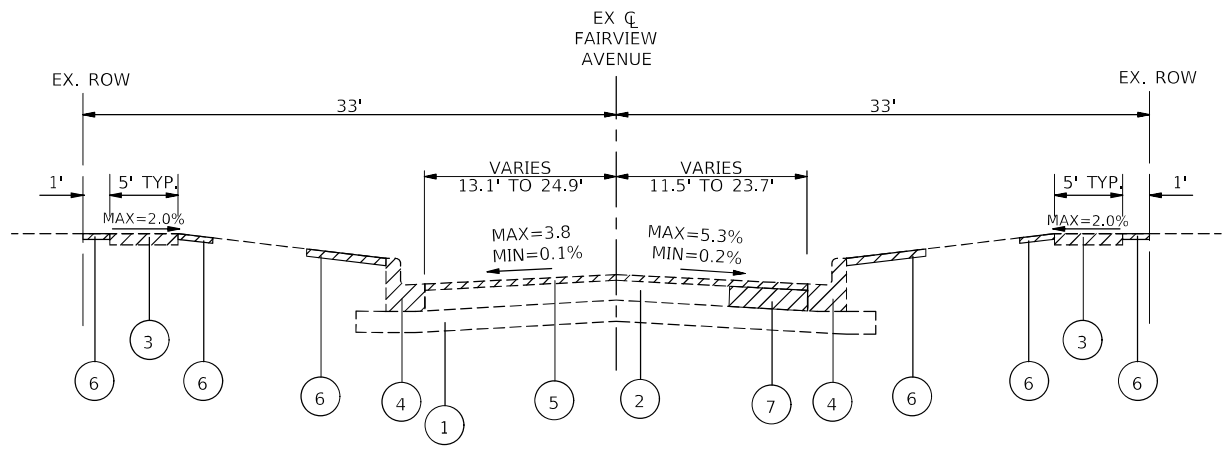

**EXISTING TYPICAL SECTION**

STA. 21+90 TO STA. 22+66, FAIRVIEW AVENUE TAPER SECTION  
 STA. 35+40 TO STA. 36+45, FAIRVIEW AVENUE TAPER SECTION  
 STA. 72+66 TO STA. 74+04, FAIRVIEW AVENUE TAPER SECTION

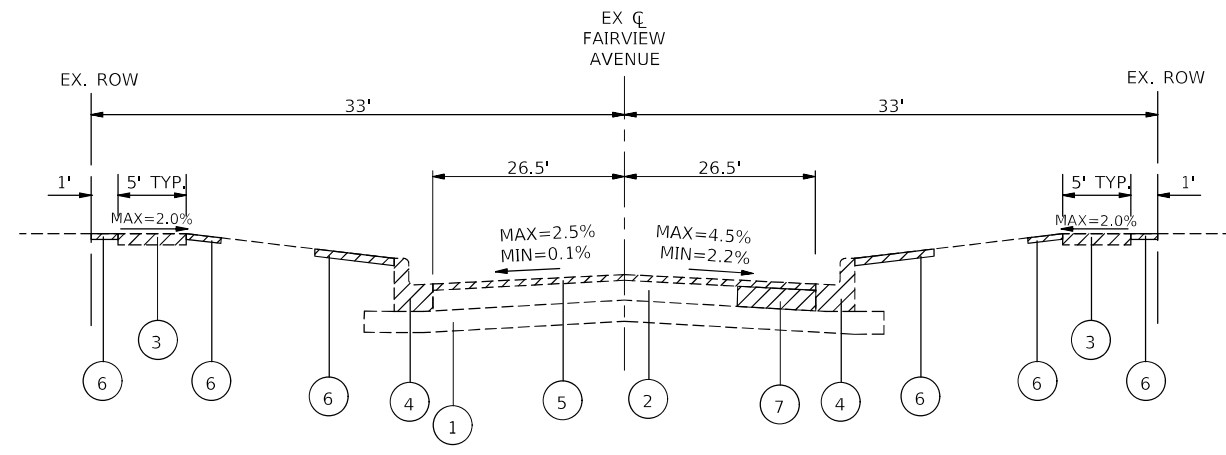

**EXISTING TYPICAL SECTION**

STA. 74+04 TO STA. 78+44, FAIRVIEW AVENUE

NOTE OF NO IMPROVEMENTS INCLUDED IN THIS CONTRACT:  
 OMISSION STA. 22+66 TO STA. 32+38, FAIRVIEW AVENUE

**LEGEND**

- ① EXISTING SUBGRADE
- ② EXISTING HMA BASE, 8" - 11", VARIES
- ③ EXISTING PORTLAND CEMENT CONCRETE SIDEWALK REMOVAL WHERE SHOWN ON PLANS AND AS DETERMINED IN THE FIELD BY ENGINEER
- ④ EXISTING COMBINATION CONCRETE CURB & GUTTER, TYPE B6.12 REMOVAL WHERE SHOWN ON PLANS
- ⑤ EXISTING HMA SURFACE REMOVAL, 2"
- ⑥ EXISTING TURF RESTORATION
- ⑦ EXISTING BASE REMOVAL FOR CLASS D PATCH (LOCATION AND DIMENSIONS DETERMINED BY ENGINEER)

**LEGEND**


REMOVAL ITEMS  
 (WHERE SHOWN ON PLANS OR AS  
 DETERMINED IN THE FIELD BY  
 ENGINEER)

**STATE OF ILLINOIS  
 DEPARTMENT OF TRANSPORTATION**

**EXISTING TYPICAL SECTIONS**


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	PLOT DATE - 11/19/21	DATE - 11/19/21	REVISED

NOT TO SCALE	SHEET NO. 1 OF 1 SHEETS	STA. TO STA.	F.A.U. RTE.	SECTION	COUNTY	TOTAL SHEETS	SHEET NO.	
			263719-00114-00-RS	DuPAGE		32	7	
			CONTRACT NO. 61H39					
			ILLINOIS	FED. AID PROJECT				

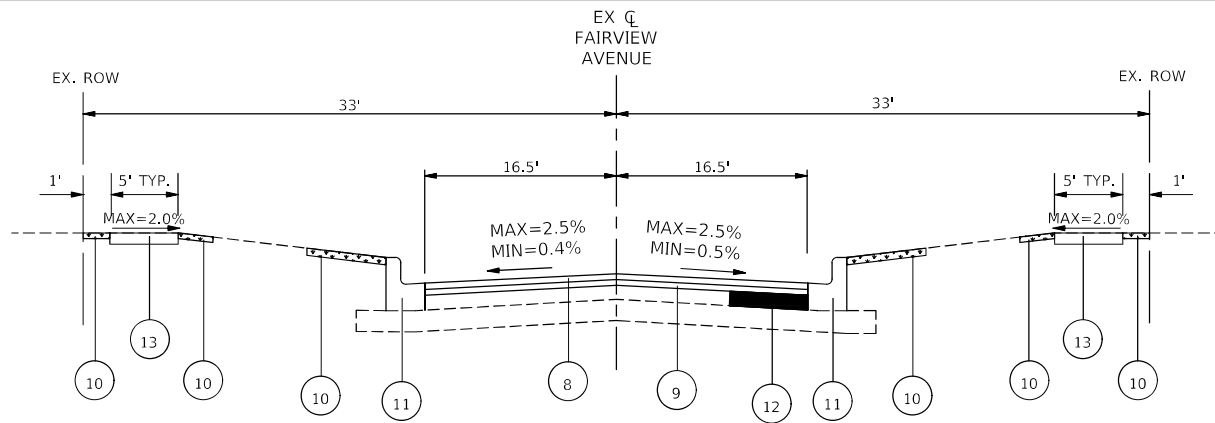


**PROPOSED TYPICAL SECTION**

STA. 3+90 TO STA. 21+90, FAIRVIEW AVENUE  
 STA. 36+45 TO STA. 72+66, FAIRVIEW AVENUE

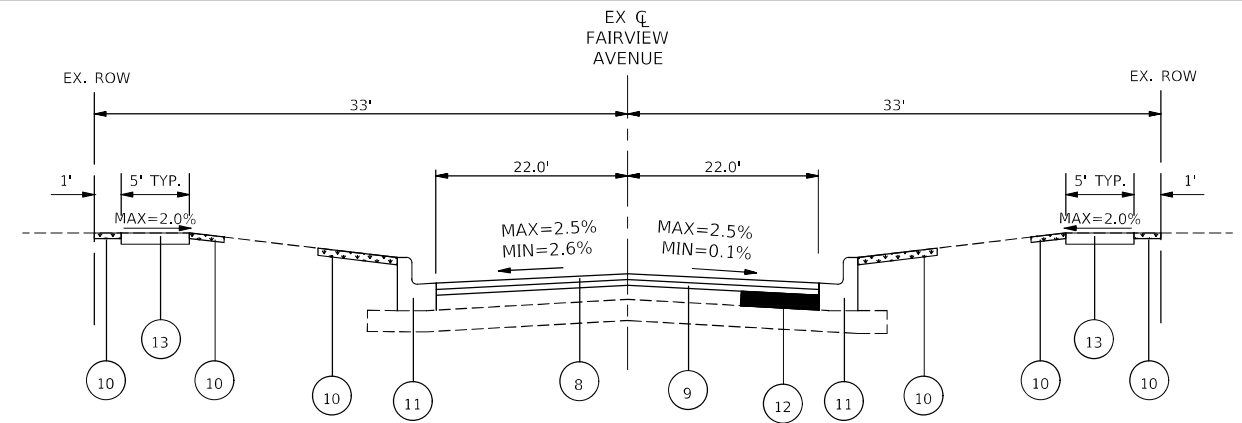

**PROPOSED TYPICAL SECTION**


STA. 22+66 TO STA. 35+40, FAIRVIEW AVENUE

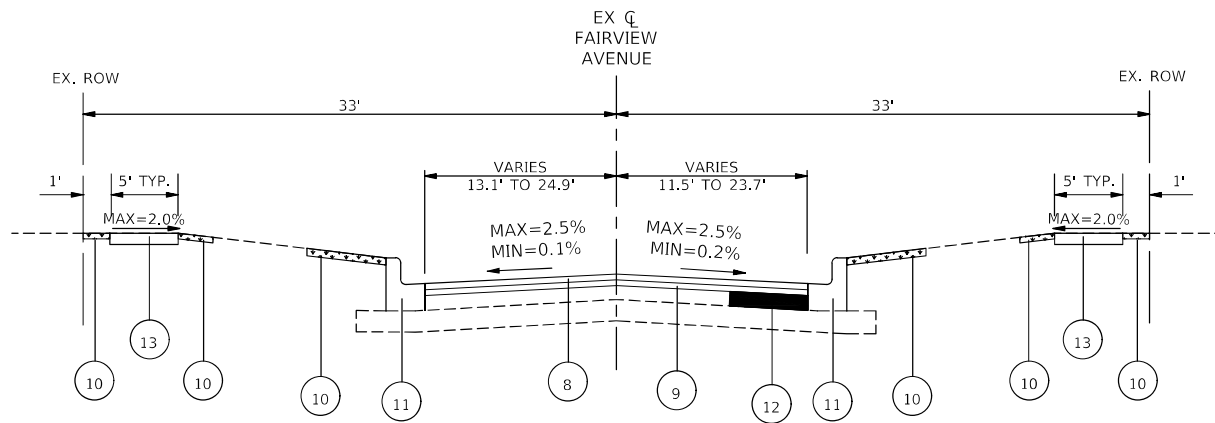

**PROPOSED TYPICAL SECTION**

STA. 21+90 TO STA. 22+66, FAIRVIEW AVENUE TAPER SECTION  
 STA. 35+40 TO STA. 36+45, FAIRVIEW AVENUE TAPER SECTION  
 STA. 72+66 TO STA. 74+04, FAIRVIEW AVENUE TAPER SECTION

NOTE OF NO IMPROVEMENTS INCLUDED IN THIS CONTRACT:  
 OMISSION STA. 22+66 TO STA. 32+38, FAIRVIEW AVENUE

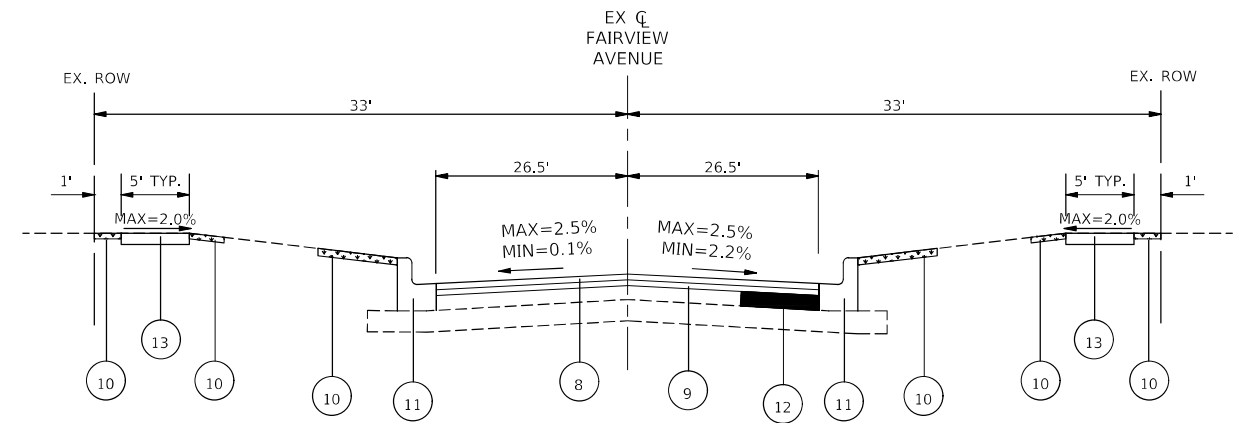

**PROPOSED TYPICAL SECTION**

STA. 74+04 TO STA. 78+44, FAIRVIEW AVENUE

**LEGEND**

- ⑧ PROPOSED HMA SURFACE COURSE, IL-9.5, MIX "D", N70, 1 1/2"
- ⑨ PROPOSED POLYMERIZED HMA BINDER COURSE, IL-4.75, N50, 3/4"
- ⑩ PROPOSED SODDING, SALT TOLERANT & TOP SOIL FURNISH AND PLACE, 4" (LOCATIONS DETERMINED BY ENGINEER)
- ⑪ PROPOSED COMBINATION CONCRETE CURB & GUTTER, TYPE B6.12 REPLACEMENT, WHERE SHOWN ON PLANS AND AS DETERMINED IN THE FIELD BY ENGINEER
- ⑫ CLASS D PATCH (LOCATION AND DIMENSIONS DETERMINED BY ENGINEER), 11"
- ⑬ PROPOSED PORTLAND CEMENT CONCRETE SIDEWALK, WHERE SHOWN ON PLAN AND AS DETERMINED IN THE FIELD BY ENGINEER

**LEGEND**

- CLASS D PATCH
- TURF RESTORATION

**MIXTURES TABLE**

MIXTURE TYPE	AIR VOIDS @ Ndes	QMP
<b>ROADWAYS:</b>		
HOT-MIX ASPHALT SURFACE COURSE, IL-9.5, MIX "D", N70, 1 1/2"	4% @ 70 GYR	LR 1030-2
POLYMERIZED HOT-MIX ASPHALT BINDER COURSE, IL-4.75, N50, 3/4"	3.5% @ 50 GYR	LR 1030-2
<b>HMA DRIVEWAY PAVEMENT 3":</b>		
HOT-MIX ASPHALT SURFACE COURSE, IL-9.5, MIX "D" N50 - 3" (IN 2 LIFTS)	4% @ 50 GYR	LR 1030-2
<b>PATCHING:</b>		
CLASS D PATCHES, HMA BINDER, IL-19.0, N70, 11"	4% @ 70 GYR	LR 1030-2

CONTRACTOR SHALL MILL FIRST BEFORE PATCHING

-THE UNIT WEIGHT USED TO CALCULATE ALL HMA SURFACE MIXTURE QUANTITIES IS 112 LBS/SQYD/IN.

-THE "AC TYPE" FOR POLYMERIZED HMA MIXES SHALL BE "SBS/SBR PG 76 - 22" AND FOR NON-POLYMERIZED HMA THE "AC TYPE" SHALL BE "PG 64 - 22" UNLESS MODIFIED BY RECLAIMED MATERIALS SPECIFICATIONS.

**STATE OF ILLINOIS  
 DEPARTMENT OF TRANSPORTATION**



**PROPOSED TYPICAL SECTIONS**

NOT TO SCALE SHEET NO. 1 OF 1 SHEETS STA. TO STA.

F.A.U. RTE.	SECTION	COUNTY	TOTAL SHEETS	SHEET NO.
2637	19-00114-00-RS	DuPAGE	32	8
CONTRACT NO. 61H39				
ILLINOIS FED. AID PROJECT				

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FILE NAME =		DRAWN - NRH	REVISED
	PLOT SCALE -	CHECKED - SAV	REVISED
	PLOT DATE - 12/17/21	DATE - 12/17/21	REVISED



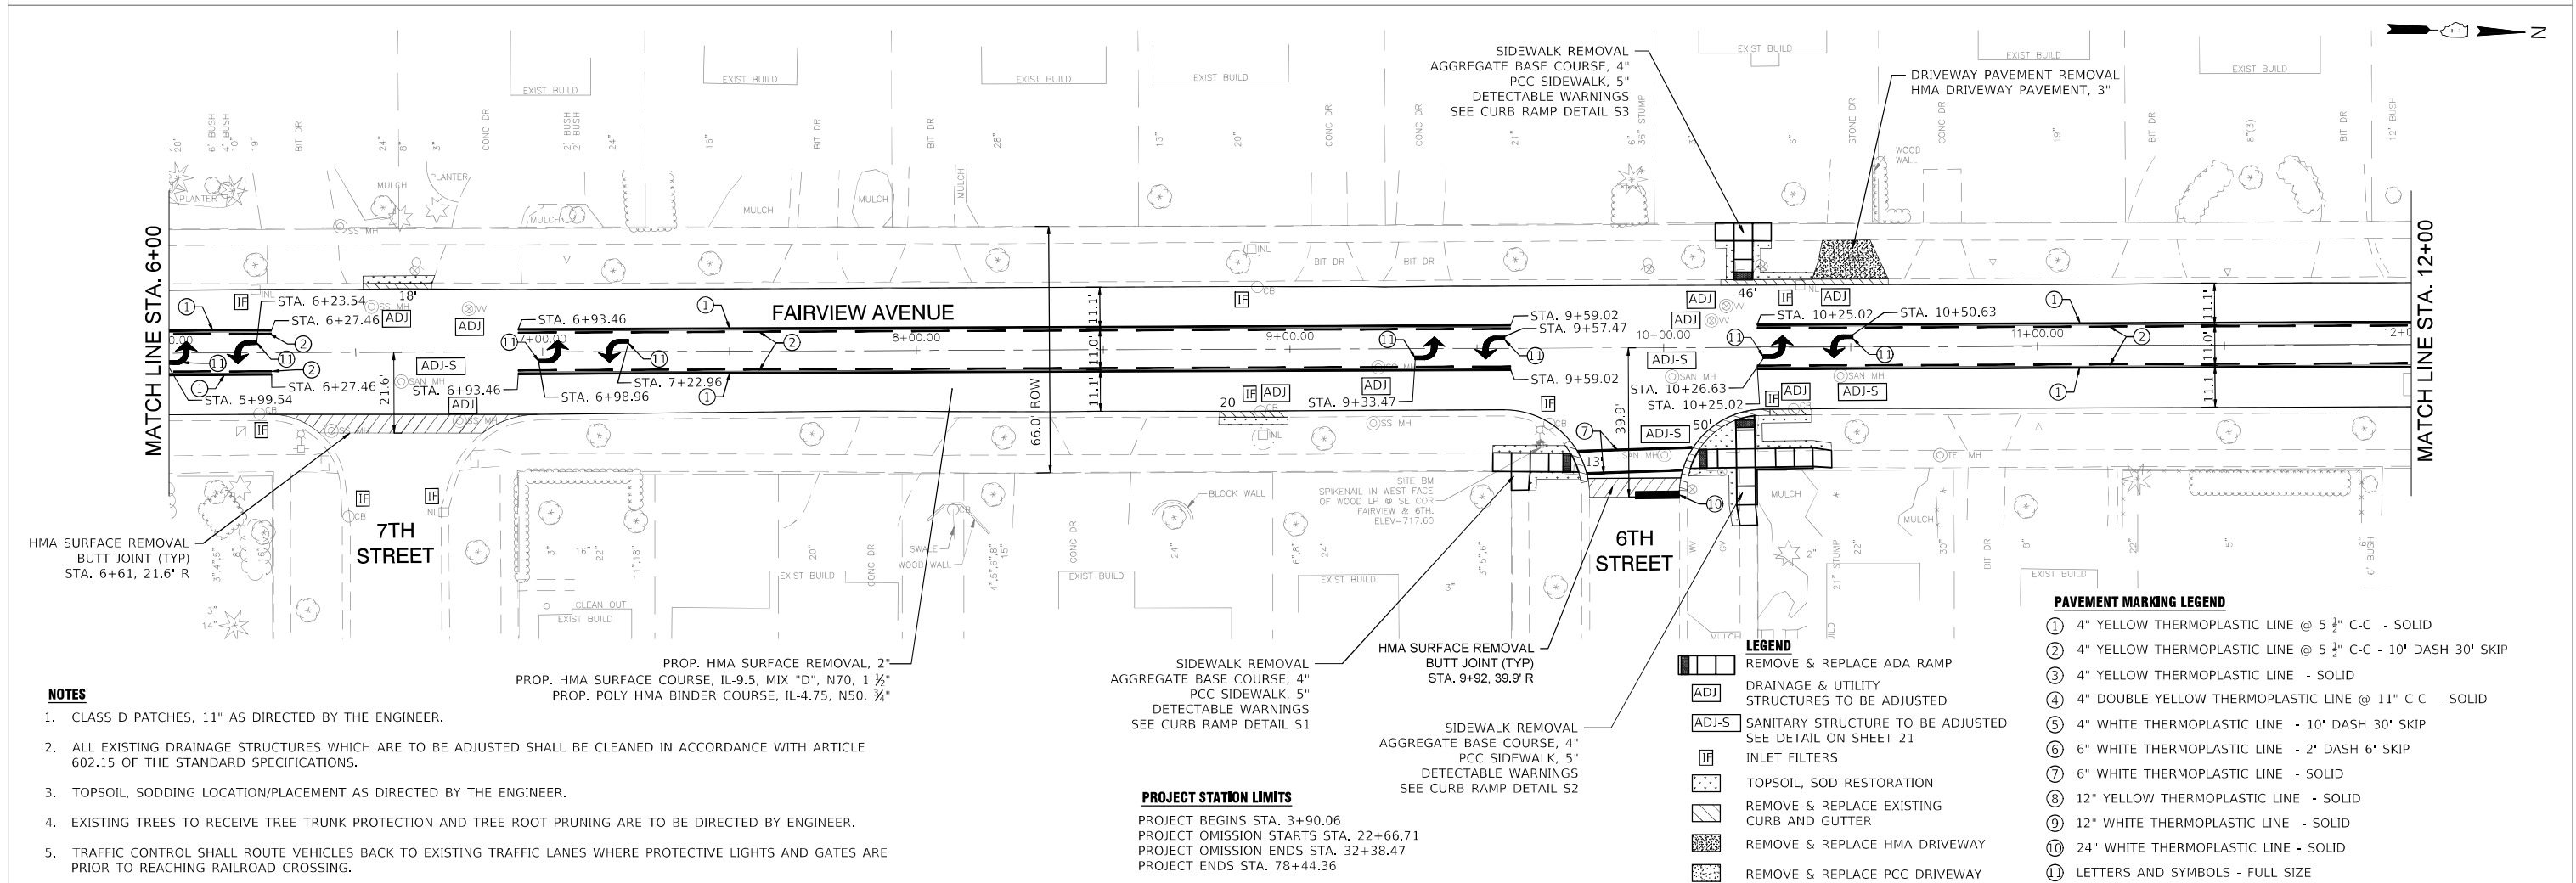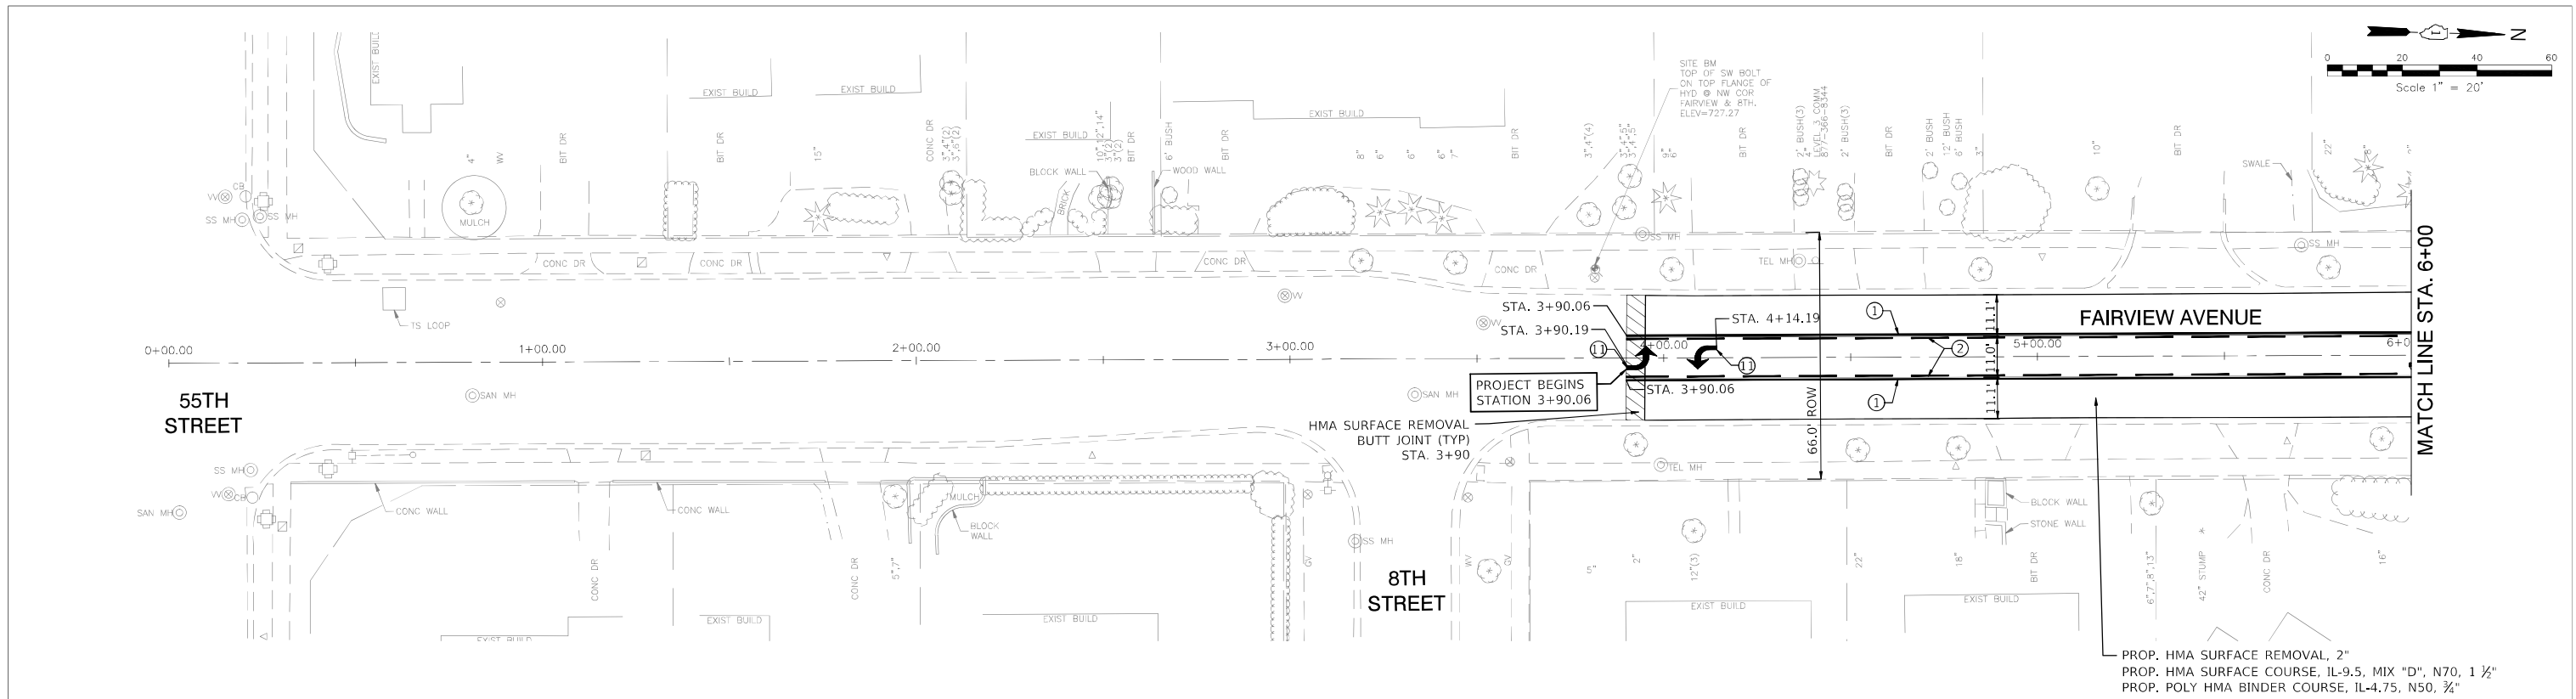

PROP. HMA SURFACE REMOVAL, 2"  
 PROP. HMA SURFACE COURSE, IL-9.5, MIX "D", N70, 1 1/2"  
 PROP. POLY HMA BINDER COURSE, IL-4.75, N50, 3/4"

SIDEWALK REMOVAL  
 AGGREGATE BASE COURSE, 4"  
 PCC SIDEWALK, 5"  
 DETECTABLE WARNINGS  
 SEE CURB RAMP DETAIL S3

DRIVEWAY PAVEMENT REMOVAL  
 HMA DRIVEWAY PAVEMENT, 3"

HMA SURFACE REMOVAL  
 BUTT JOINT (TYP)  
 STA. 6+61, 21.6' R

PROP. HMA SURFACE REMOVAL, 2"  
 PROP. HMA SURFACE COURSE, IL-9.5, MIX "D", N70, 1 1/2"  
 PROP. POLY HMA BINDER COURSE, IL-4.75, N50, 3/4"

SIDEWALK REMOVAL  
 AGGREGATE BASE COURSE, 4"  
 PCC SIDEWALK, 5"  
 DETECTABLE WARNINGS  
 SEE CURB RAMP DETAIL S1

SIDEWALK REMOVAL  
 AGGREGATE BASE COURSE, 4"  
 PCC SIDEWALK, 5"  
 DETECTABLE WARNINGS  
 SEE CURB RAMP DETAIL S2

**PROJECT STATION LIMITS**  
 PROJECT BEGINS STA. 3+90.06  
 PROJECT OMISSION STARTS STA. 22+66.71  
 PROJECT OMISSION ENDS STA. 32+38.47  
 PROJECT ENDS STA. 78+44.36

- PAVEMENT MARKING LEGEND**
- ① 4" YELLOW THERMOPLASTIC LINE @ 5 1/2" C-C - SOLID
  - ② 4" YELLOW THERMOPLASTIC LINE @ 5 1/2" C-C - 10' DASH 30' SKIP
  - ③ 4" YELLOW THERMOPLASTIC LINE - SOLID
  - ④ 4" DOUBLE YELLOW THERMOPLASTIC LINE @ 11" C-C - SOLID
  - ⑤ 4" WHITE THERMOPLASTIC LINE - 10' DASH 30' SKIP
  - ⑥ 6" WHITE THERMOPLASTIC LINE - 2' DASH 6' SKIP
  - ⑦ 6" WHITE THERMOPLASTIC LINE - SOLID
  - ⑧ 12" YELLOW THERMOPLASTIC LINE - SOLID
  - ⑨ 12" WHITE THERMOPLASTIC LINE - SOLID
  - ⑩ 24" WHITE THERMOPLASTIC LINE - SOLID
  - Ⓛ LETTERS AND SYMBOLS - FULL SIZE

- LEGEND**
- ☐ REMOVE & REPLACE ADA RAMP
  - ADJ DRAINAGE & UTILITY STRUCTURES TO BE ADJUSTED
  - ADJ-S SANITARY STRUCTURE TO BE ADJUSTED SEE DETAIL ON SHEET 21
  - IF INLET FILTERS
  - TOPSOIL, SOD RESTORATION
  - REMOVE & REPLACE EXISTING CURB AND GUTTER
  - REMOVE & REPLACE HMA DRIVEWAY
  - REMOVE & REPLACE PCC DRIVEWAY

- NOTES**
- CLASS D PATCHES, 11" AS DIRECTED BY THE ENGINEER.
  - ALL EXISTING DRAINAGE STRUCTURES WHICH ARE TO BE ADJUSTED SHALL BE CLEANED IN ACCORDANCE WITH ARTICLE 602.15 OF THE STANDARD SPECIFICATIONS.
  - TOPSOIL, SODDING LOCATION/PLACEMENT AS DIRECTED BY THE ENGINEER.
  - EXISTING TREES TO RECEIVE TREE TRUNK PROTECTION AND TREE ROOT PRUNING ARE TO BE DIRECTED BY ENGINEER.
  - TRAFFIC CONTROL SHALL ROUTE VEHICLES BACK TO EXISTING TRAFFIC LANES WHERE PROTECTIVE LIGHTS AND GATES ARE PRIOR TO REACHING RAILROAD CROSSING.



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	PLOT DATE -- 12/17/21	DATE -- 12/17/21	REVISED

**STATE OF ILLINOIS  
 DEPARTMENT OF TRANSPORTATION**

**PLAN SHEET (STA. 0+00 TO STA. 12+00)**

SCALE: 1"=20'      SHEET NO. 1 OF 7 SHEETS      STA. 0+00 TO STA. 12+00

F.A.U. RTE.	SECTION	COUNTY	TOTAL SHEETS	SHEET NO.
2637	19-00114-00-RS	DuPAGE	32	9
ILLINOIS			CONTRACT NO. 61H39	
			FED. AID PROJECT	

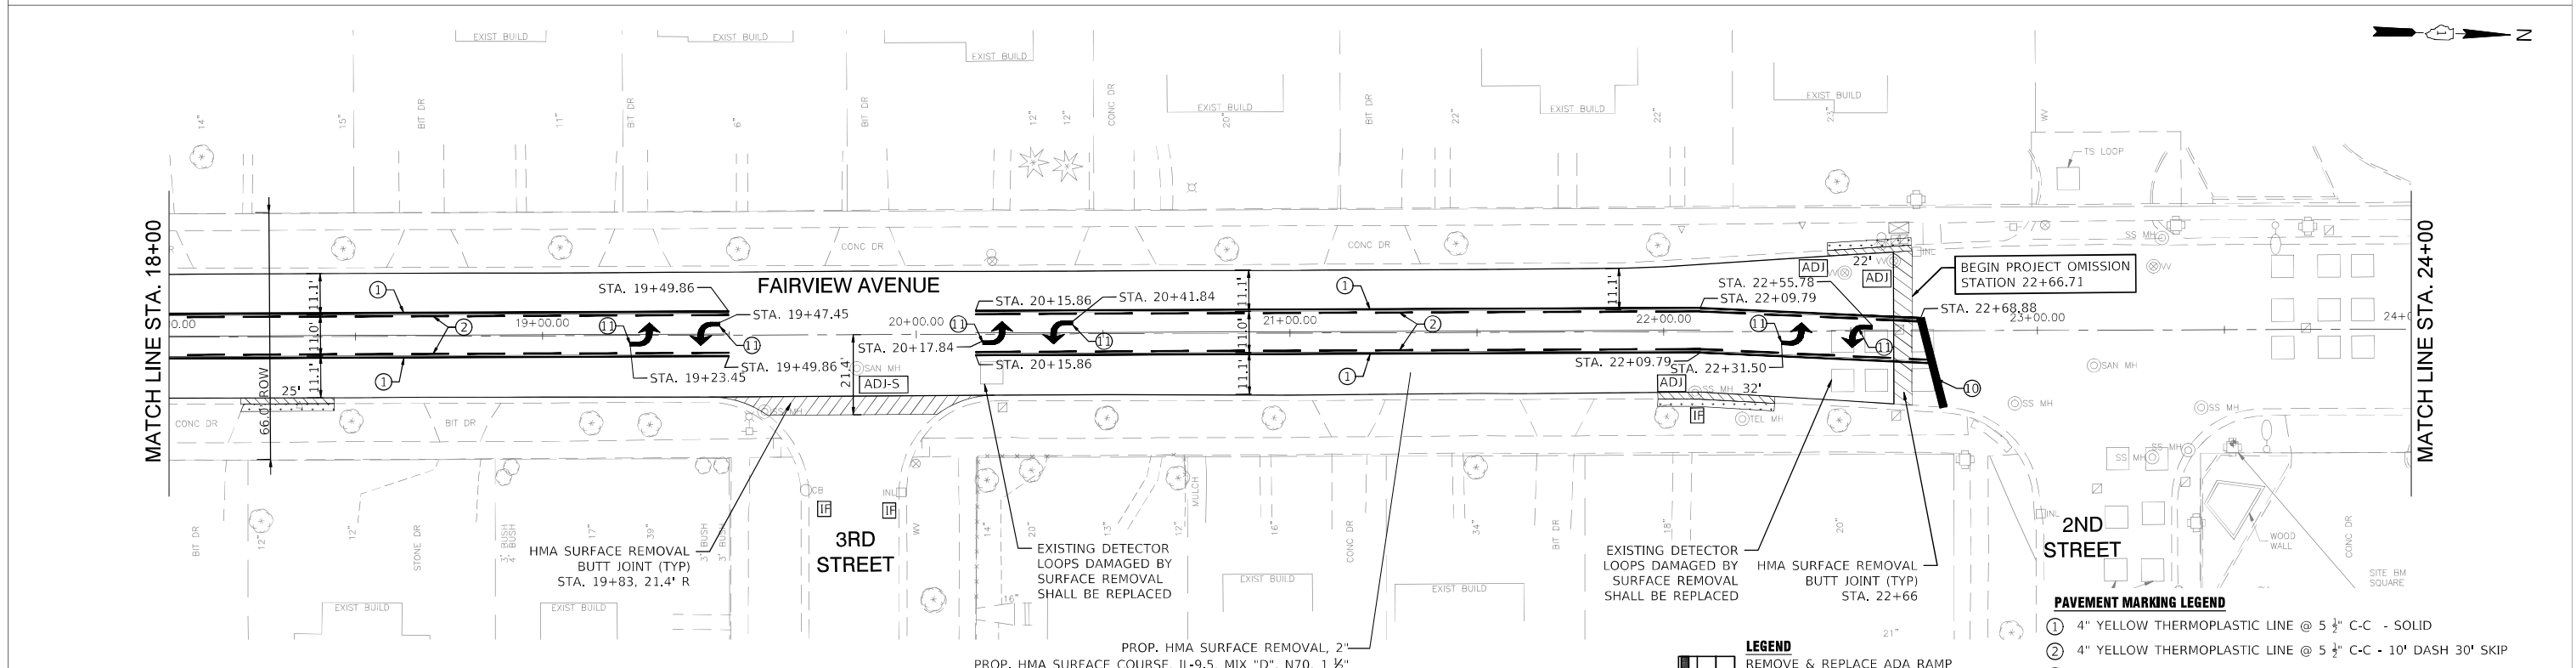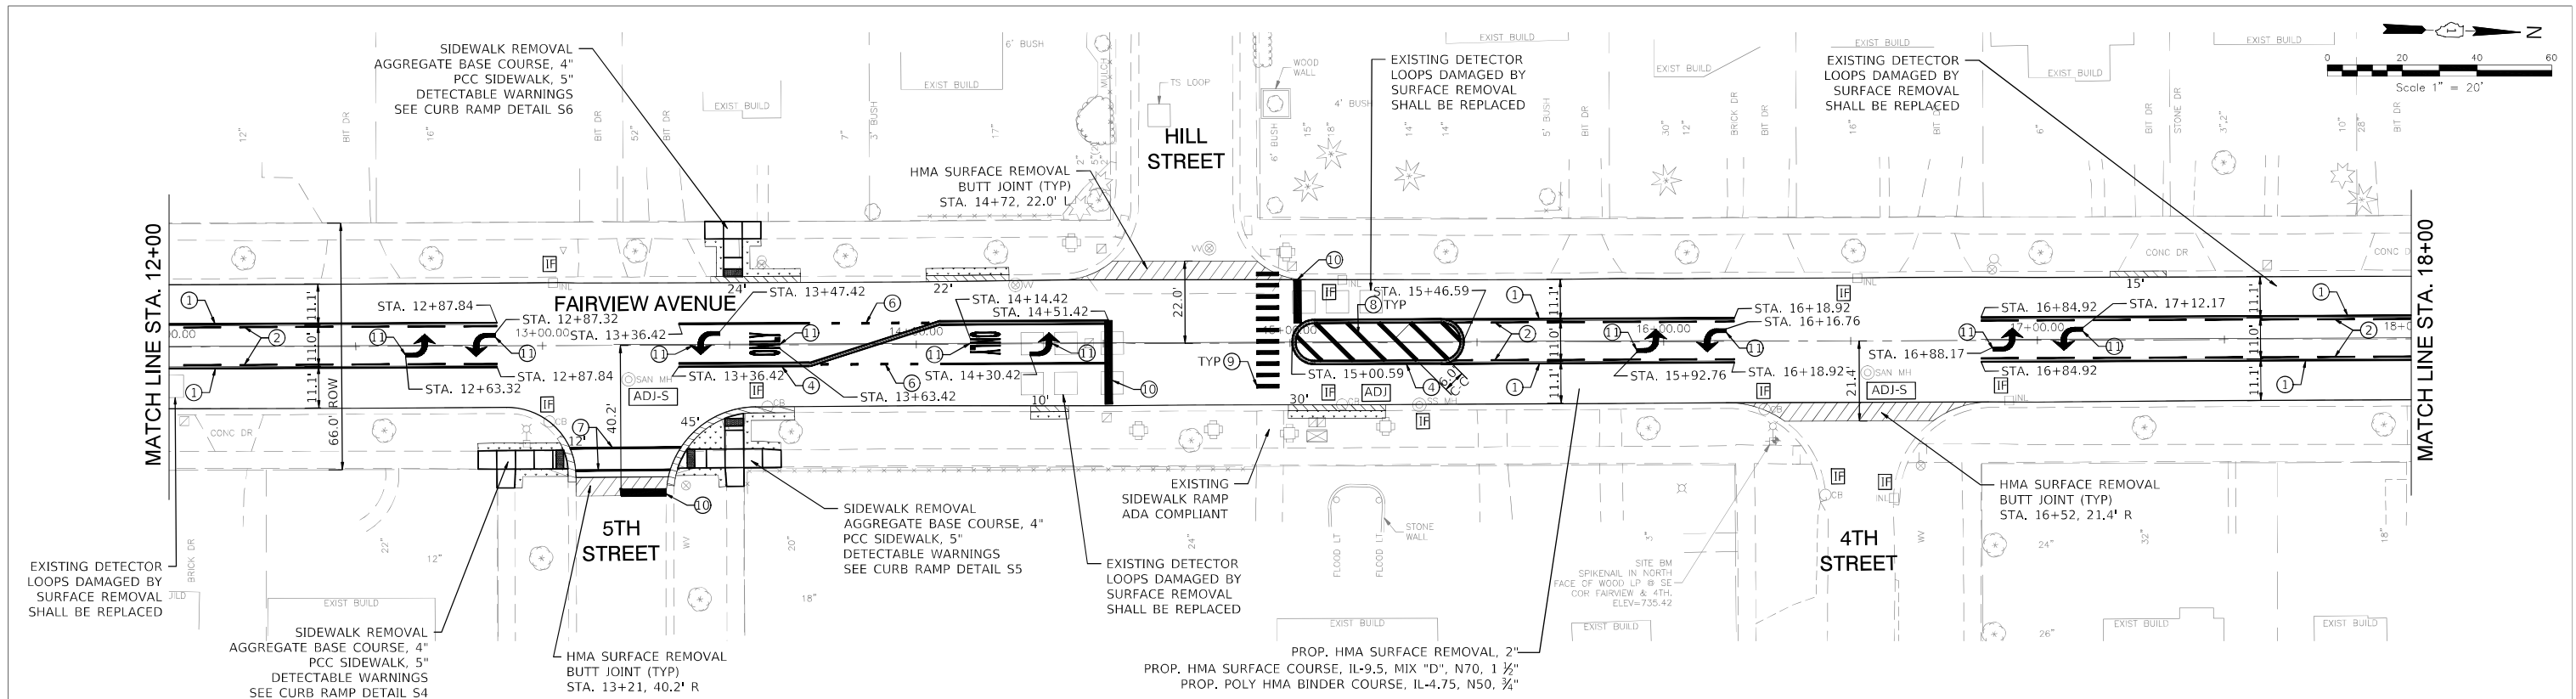

**NOTES**

1. CLASS D PATCHES, 11" AS DIRECTED BY THE ENGINEER.
2. ALL EXISTING DRAINAGE STRUCTURES WHICH ARE TO BE ADJUSTED SHALL BE CLEANED IN ACCORDANCE WITH ARTICLE 602.15 OF THE STANDARD SPECIFICATIONS.
3. TOPSOIL, SODDING LOCATION/PLACEMENT AS DIRECTED BY THE ENGINEER.
4. EXISTING TREES TO RECEIVE TREE TRUNK PROTECTION AND TREE ROOT PRUNING ARE TO BE DIRECTED BY ENGINEER.
5. TRAFFIC CONTROL SHALL ROUTE VEHICLES BACK TO EXISTING TRAFFIC LANES WHERE PROTECTIVE LIGHTS AND GATES ARE PRIOR TO REACHING RAILROAD CROSSING.

**PROJECT STATION LIMITS**

PROJECT BEGINS STA. 3+90.06  
 PROJECT OMISSION STARTS STA. 22+66.71  
 PROJECT OMISSION ENDS STA. 32+38.47  
 PROJECT ENDS STA. 78+44.36

**LEGEND**

- REMOVE & REPLACE ADA RAMP
- DRAINAGE & UTILITY STRUCTURES TO BE ADJUSTED
- SANITARY STRUCTURE TO BE ADJUSTED SEE DETAIL ON SHEET 21
- INLET FILTERS
- TOPSOIL, SOD RESTORATION
- REMOVE & REPLACE EXISTING CURB AND GUTTER
- REMOVE & REPLACE HMA DRIVEWAY
- REMOVE & REPLACE PCC DRIVEWAY

**PAVEMENT MARKING LEGEND**

- ① 4" YELLOW THERMOPLASTIC LINE @ 5 1/2" C-C - SOLID
- ② 4" YELLOW THERMOPLASTIC LINE @ 5 1/2" C-C - 10' DASH 30' SKIP
- ③ 4" YELLOW THERMOPLASTIC LINE - SOLID
- ④ 4" DOUBLE YELLOW THERMOPLASTIC LINE @ 11" C-C - SOLID
- ⑤ 4" WHITE THERMOPLASTIC LINE - 10' DASH 30' SKIP
- ⑥ 6" WHITE THERMOPLASTIC LINE - 2' DASH 6' SKIP
- ⑦ 6" WHITE THERMOPLASTIC LINE - SOLID
- ⑧ 12" YELLOW THERMOPLASTIC LINE - SOLID
- ⑨ 12" WHITE THERMOPLASTIC LINE - SOLID
- ⑩ 24" WHITE THERMOPLASTIC LINE - SOLID
- ⓪ LETTERS AND SYMBOLS - FULL SIZE



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**STATE OF ILLINOIS  
DEPARTMENT OF TRANSPORTATION**

**PLAN SHEET (STA. 12+00 TO STA. 24+00)**

SCALE: 1"=20' SHEET NO. 2 OF 7 SHEETS STA. 12+00 TO STA. 24+00

F.A.U. RTE.	SECTION	COUNTY	TOTAL SHEETS	SHEET NO.
2637	19-00114-00-RS	DuPAGE	32	10
ILLINOIS			CONTRACT NO. 61H39	
FED. AID PROJECT				

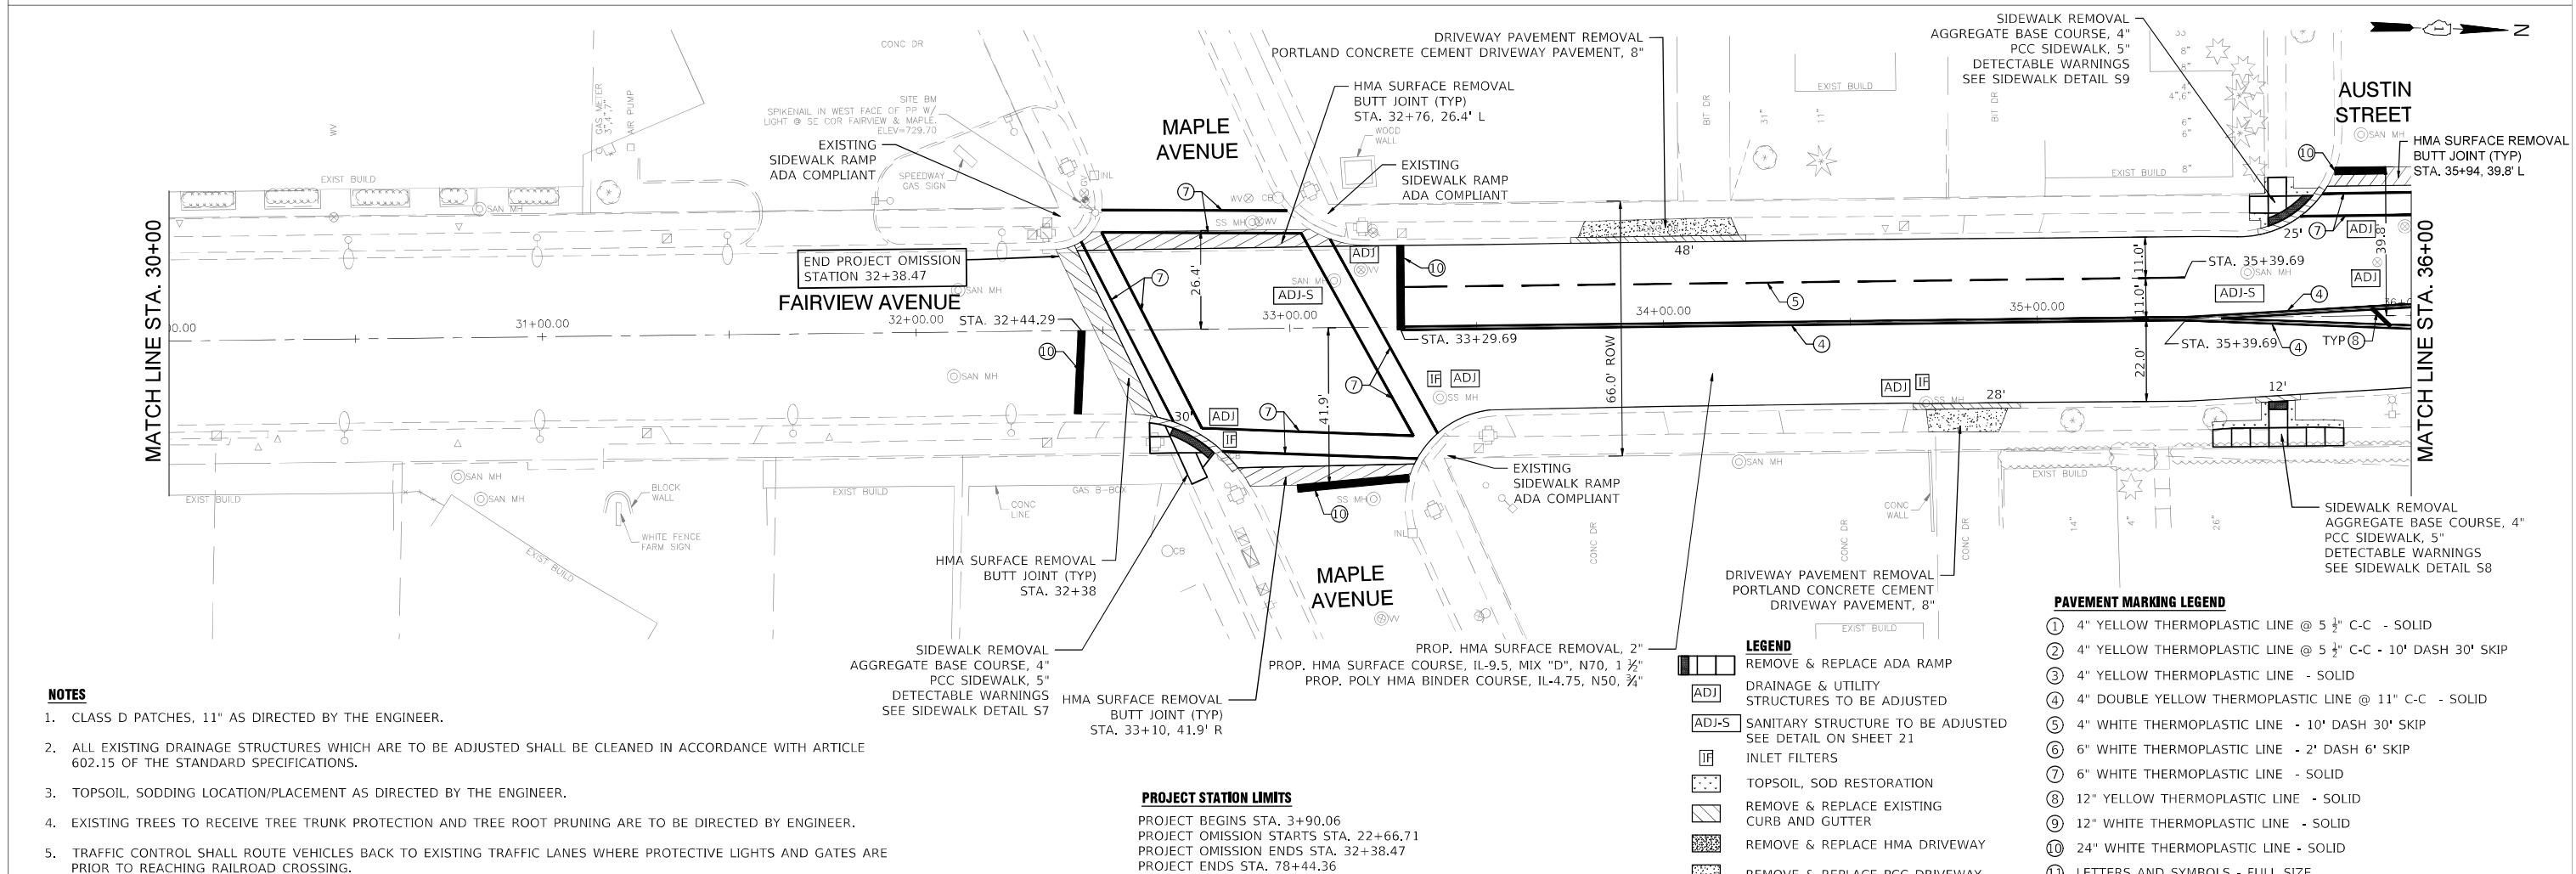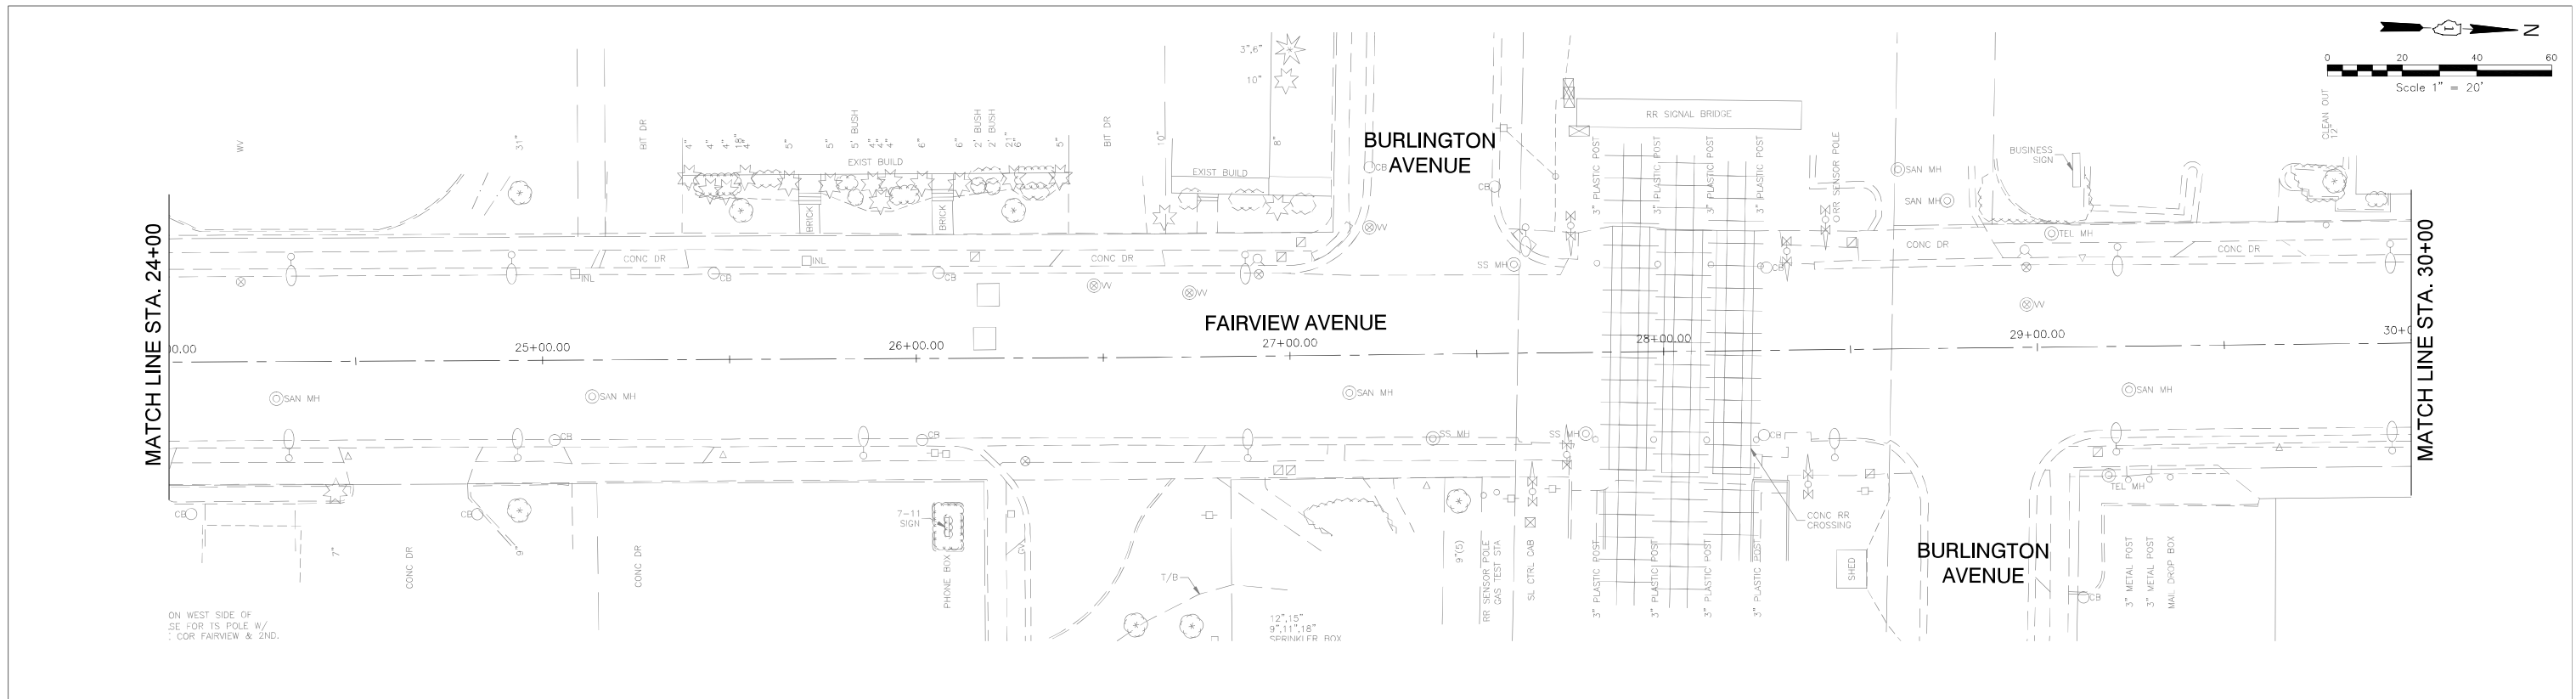

- NOTES**
- CLASS D PATCHES, 11" AS DIRECTED BY THE ENGINEER.
  - ALL EXISTING DRAINAGE STRUCTURES WHICH ARE TO BE ADJUSTED SHALL BE CLEANED IN ACCORDANCE WITH ARTICLE 602.15 OF THE STANDARD SPECIFICATIONS.
  - TOPSOIL, SODDING LOCATION/PLACEMENT AS DIRECTED BY THE ENGINEER.
  - EXISTING TREES TO RECEIVE TREE TRUNK PROTECTION AND TREE ROOT PRUNING ARE TO BE DIRECTED BY ENGINEER.
  - TRAFFIC CONTROL SHALL ROUTE VEHICLES BACK TO EXISTING TRAFFIC LANES WHERE PROTECTIVE LIGHTS AND GATES ARE PRIOR TO REACHING RAILROAD CROSSING.

**PROJECT STATION LIMITS**  
 PROJECT BEGINS STA. 3+90.06  
 PROJECT OMISSION STARTS STA. 22+66.71  
 PROJECT OMISSION ENDS STA. 32+38.47  
 PROJECT ENDS STA. 78+44.36



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**STATE OF ILLINOIS  
 DEPARTMENT OF TRANSPORTATION**

**PLAN SHEET (STA. 24+00 TO STA. 36+00)**

SCALE: 1"=20'      SHEET NO. 3 OF 7 SHEETS      STA. 24+00 TO STA. 36+00

F.A.U. RTE.	SECTION	COUNTY	TOTAL SHEETS	SHEET NO.
2637	19-00114-00-RS	DuPAGE	32	11
ILLINOIS			CONTRACT NO. 61H39	
			FED. AID PROJECT	

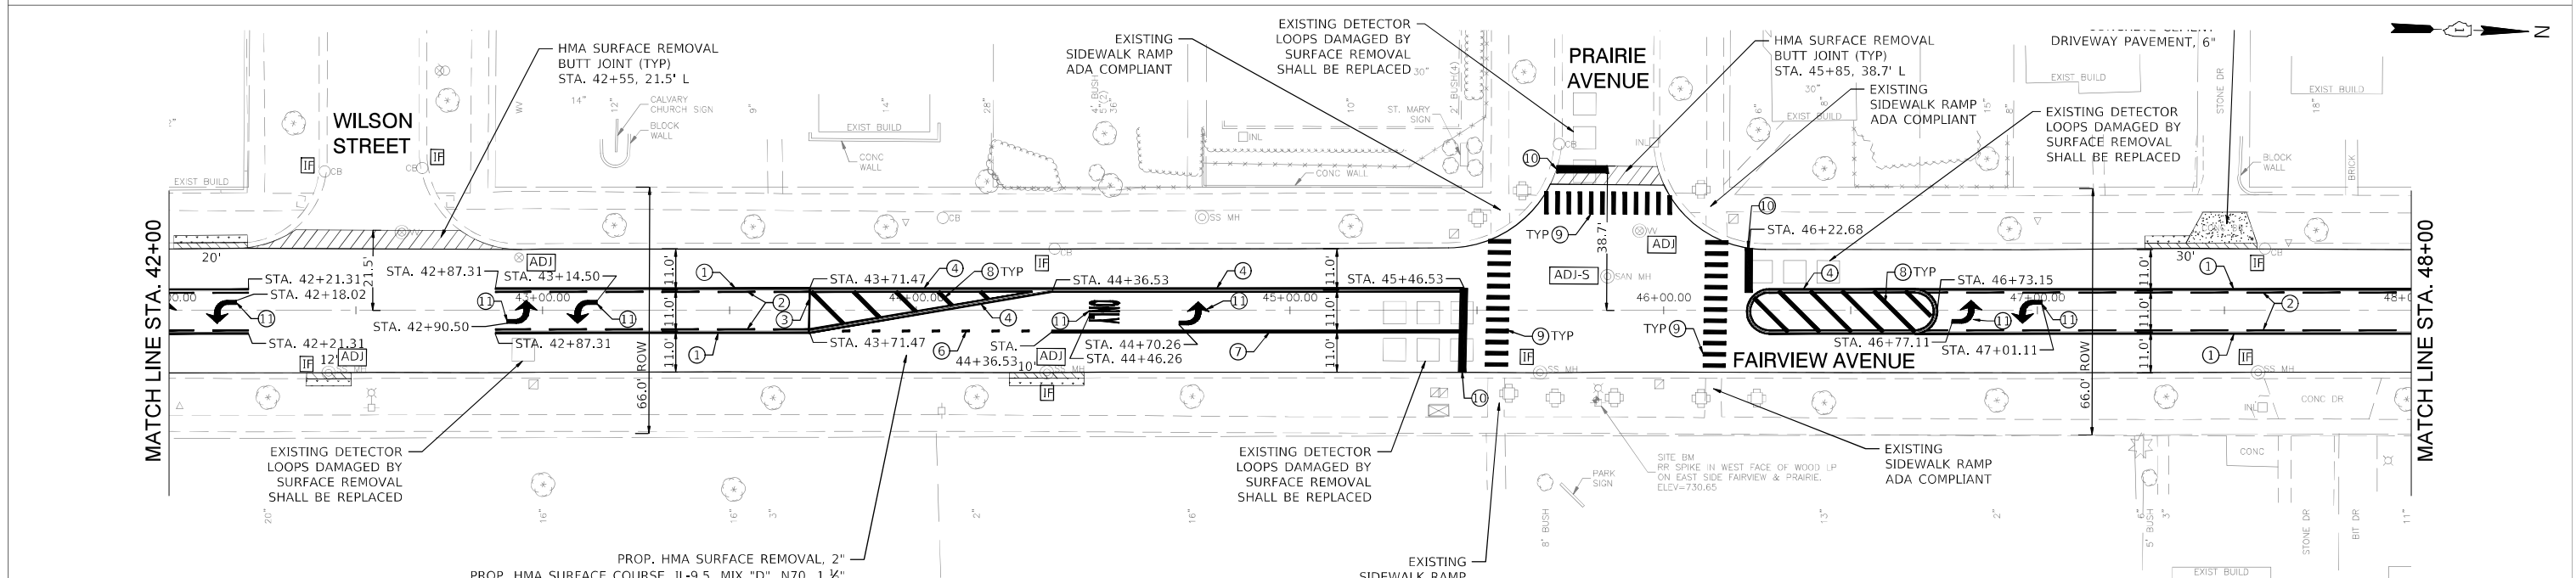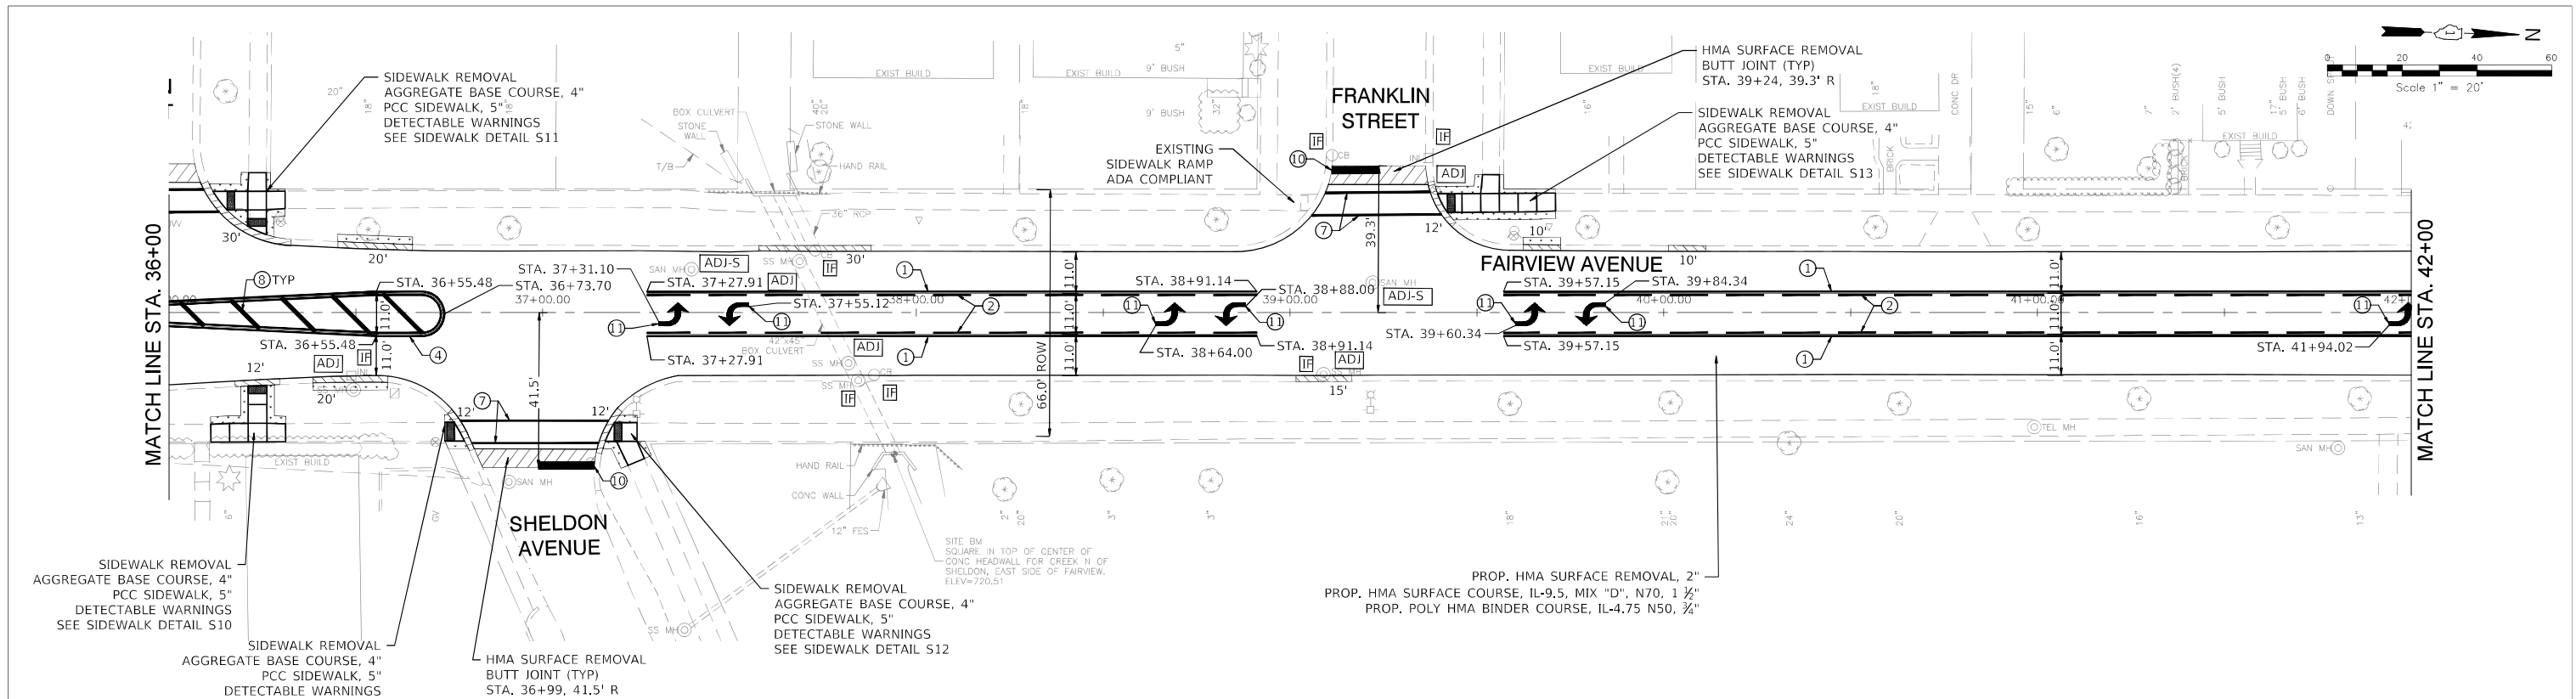

**NOTES**

- CLASS D PATCHES, 11" AS DIRECTED BY THE ENGINEER.
- ALL EXISTING DRAINAGE STRUCTURES WHICH ARE TO BE ADJUSTED SHALL BE CLEANED IN ACCORDANCE WITH ARTICLE 602.15 OF THE STANDARD SPECIFICATIONS.
- TOPSOIL, SODDING LOCATION/PLACEMENT AS DIRECTED BY THE ENGINEER.
- EXISTING TREES TO RECEIVE TREE TRUNK PROTECTION AND TREE ROOT PRUNING ARE TO BE DIRECTED BY ENGINEER.
- TRAFFIC CONTROL SHALL ROUTE VEHICLES BACK TO EXISTING TRAFFIC LANES WHERE PROTECTIVE LIGHTS AND GATES ARE PRIOR TO REACHING RAILROAD CROSSING.

**PROJECT STATION LIMITS**  
 PROJECT BEGINS STA. 3+90.06  
 PROJECT OMISSION STARTS STA. 22+66.71  
 PROJECT OMISSION ENDS STA. 32+38.47  
 PROJECT ENDS STA. 78+44.36

**LEGEND**

[Symbol]	REMOVE & REPLACE ADA RAMP
[Symbol]	DRAINAGE & UTILITY STRUCTURES TO BE ADJUSTED
[Symbol]	SANITARY STRUCTURE TO BE ADJUSTED SEE DETAIL ON SHEET 21
[Symbol]	INLET FILTERS
[Symbol]	TOPSOIL, SOD RESTORATION
[Symbol]	REMOVE & REPLACE EXISTING CURB AND GUTTER
[Symbol]	REMOVE & REPLACE HMA DRIVEWAY
[Symbol]	REMOVE & REPLACE PCC DRIVEWAY

**PAVEMENT MARKING LEGEND**

- 4" YELLOW THERMOPLASTIC LINE @ 5 1/2" C-C - SOLID
- 4" YELLOW THERMOPLASTIC LINE @ 5 1/2" C-C - 10' DASH 30' SKIP
- 4" YELLOW THERMOPLASTIC LINE - SOLID
- 4" DOUBLE YELLOW THERMOPLASTIC LINE @ 11" C-C - SOLID
- 4" WHITE THERMOPLASTIC LINE - 10' DASH 30' SKIP
- 6" WHITE THERMOPLASTIC LINE - 2' DASH 6' SKIP
- 6" WHITE THERMOPLASTIC LINE - SOLID
- 12" YELLOW THERMOPLASTIC LINE - SOLID
- 12" WHITE THERMOPLASTIC LINE - SOLID
- 24" WHITE THERMOPLASTIC LINE - SOLID
- LETTERS AND SYMBOLS - FULL SIZE



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**STATE OF ILLINOIS  
DEPARTMENT OF TRANSPORTATION**

**PLAN SHEET (STA. 36+00 TO STA. 48+00)**

SCALE: 1"=20' SHEET NO. 4 OF 7 SHEETS STA. 36+00 TO STA. 48+00

F.A.U. RTE.	SECTION	COUNTY	TOTAL SHEETS	SHEET NO.
2637	19-00114-00-RS	DuPAGE	32	12
ILLINOIS			CONTRACT NO. 61H39	
FED. AID PROJECT				

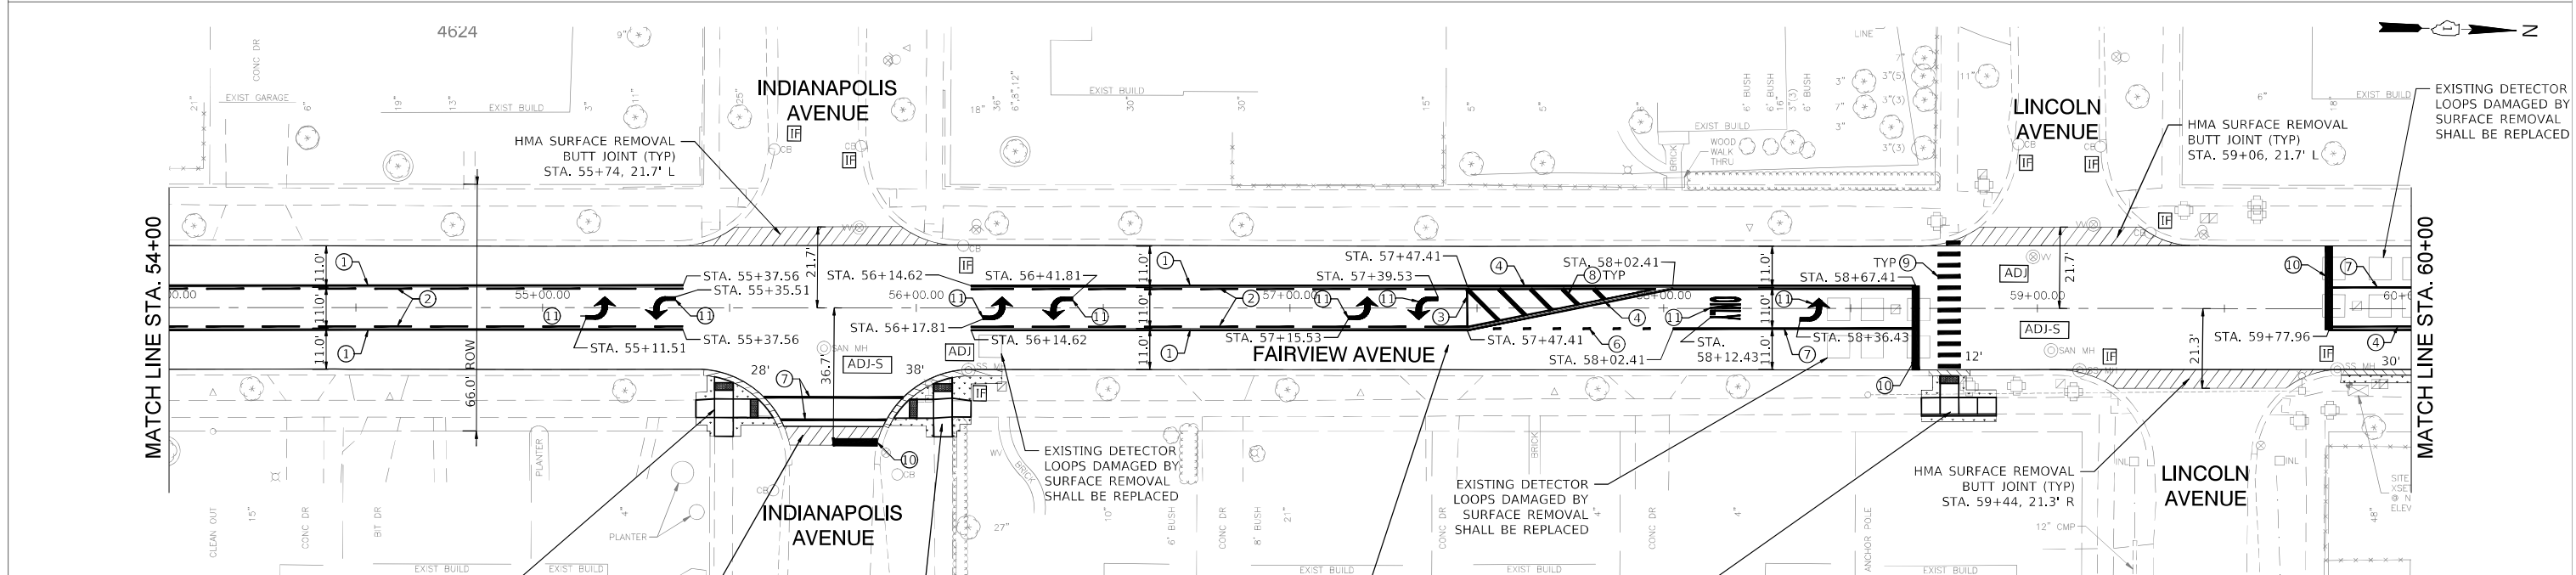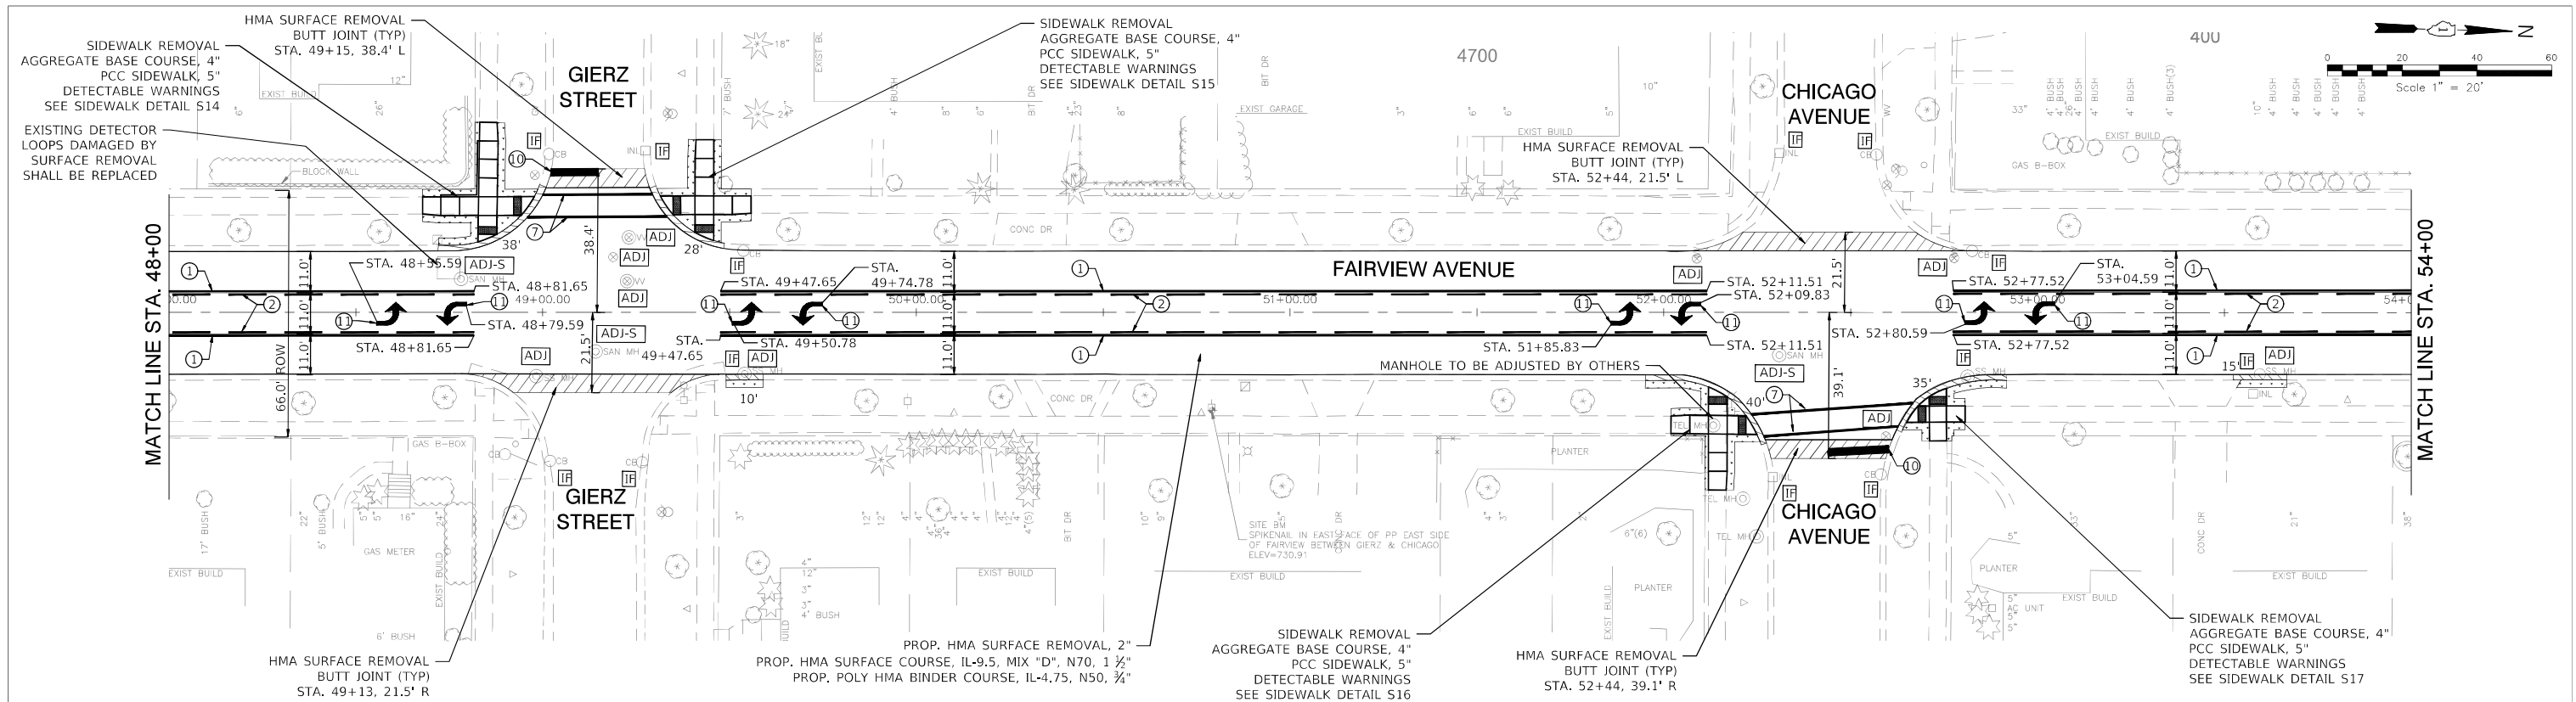

**NOTES**

1. CLASS D PATCHES, 11" AS DIRECTED BY THE ENGINEER.
2. ALL EXISTING DRAINAGE STRUCTURES WHICH ARE TO BE ADJUSTED SHALL BE CLEANED IN ACCORDANCE WITH ARTICLE 602.15 OF THE STANDARD SPECIFICATIONS.
3. TOPSOIL, SODDING LOCATION/PLACEMENT AS DIRECTED BY THE ENGINEER.
4. EXISTING TREES TO RECEIVE TREE TRUNK PROTECTION AND TREE ROOT PRUNING ARE TO BE DIRECTED BY ENGINEER.
5. TRAFFIC CONTROL SHALL ROUTE VEHICLES BACK TO EXISTING TRAFFIC LANES WHERE PROTECTIVE LIGHTS AND GATES ARE PRIOR TO REACHING RAILROAD CROSSING.

**PROJECT STATION LIMITS**

PROJECT BEGINS STA. 3+90.06  
 PROJECT OMISSION STARTS STA. 22+66.71  
 PROJECT OMISSION ENDS STA. 32+38.47  
 PROJECT ENDS STA. 78+44.36

**LEGEND**

- REMOVE & REPLACE ADA RAMP
- DRAINAGE & UTILITY STRUCTURES TO BE ADJUSTED
- SANITARY STRUCTURE TO BE ADJUSTED SEE DETAIL ON SHEET 21
- INLET FILTERS
- TOPSOIL, SOD RESTORATION
- REMOVE & REPLACE EXISTING CURB AND GUTTER
- REMOVE & REPLACE HMA DRIVEWAY
- REMOVE & REPLACE PCC DRIVEWAY

**PAVEMENT MARKING LEGEND**

- ① 4" YELLOW THERMOPLASTIC LINE @ 5 1/2" C-C - SOLID
- ② 4" YELLOW THERMOPLASTIC LINE @ 5 1/2" C-C - 10' DASH 30' SKIP
- ③ 4" YELLOW THERMOPLASTIC LINE - SOLID
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- ⑤ 4" WHITE THERMOPLASTIC LINE - 10' DASH 30' SKIP
- ⑥ 6" WHITE THERMOPLASTIC LINE - 2' DASH 6' SKIP
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- ⑩ 24" WHITE THERMOPLASTIC LINE - SOLID
- Ⓛ LETTERS AND SYMBOLS - FULL SIZE



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**STATE OF ILLINOIS  
 DEPARTMENT OF TRANSPORTATION**

**PLAN SHEET (STA. 48+00 TO STA. 60+00)**

SCALE: 1"=20' SHEET NO. 5 OF 7 SHEETS STA. 48+00 TO STA. 60+00


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2637	19-00114-00-RS	DuPAGE	32	13
ILLINOIS			CONTRACT NO. 61H39	
			FED. AID PROJECT	

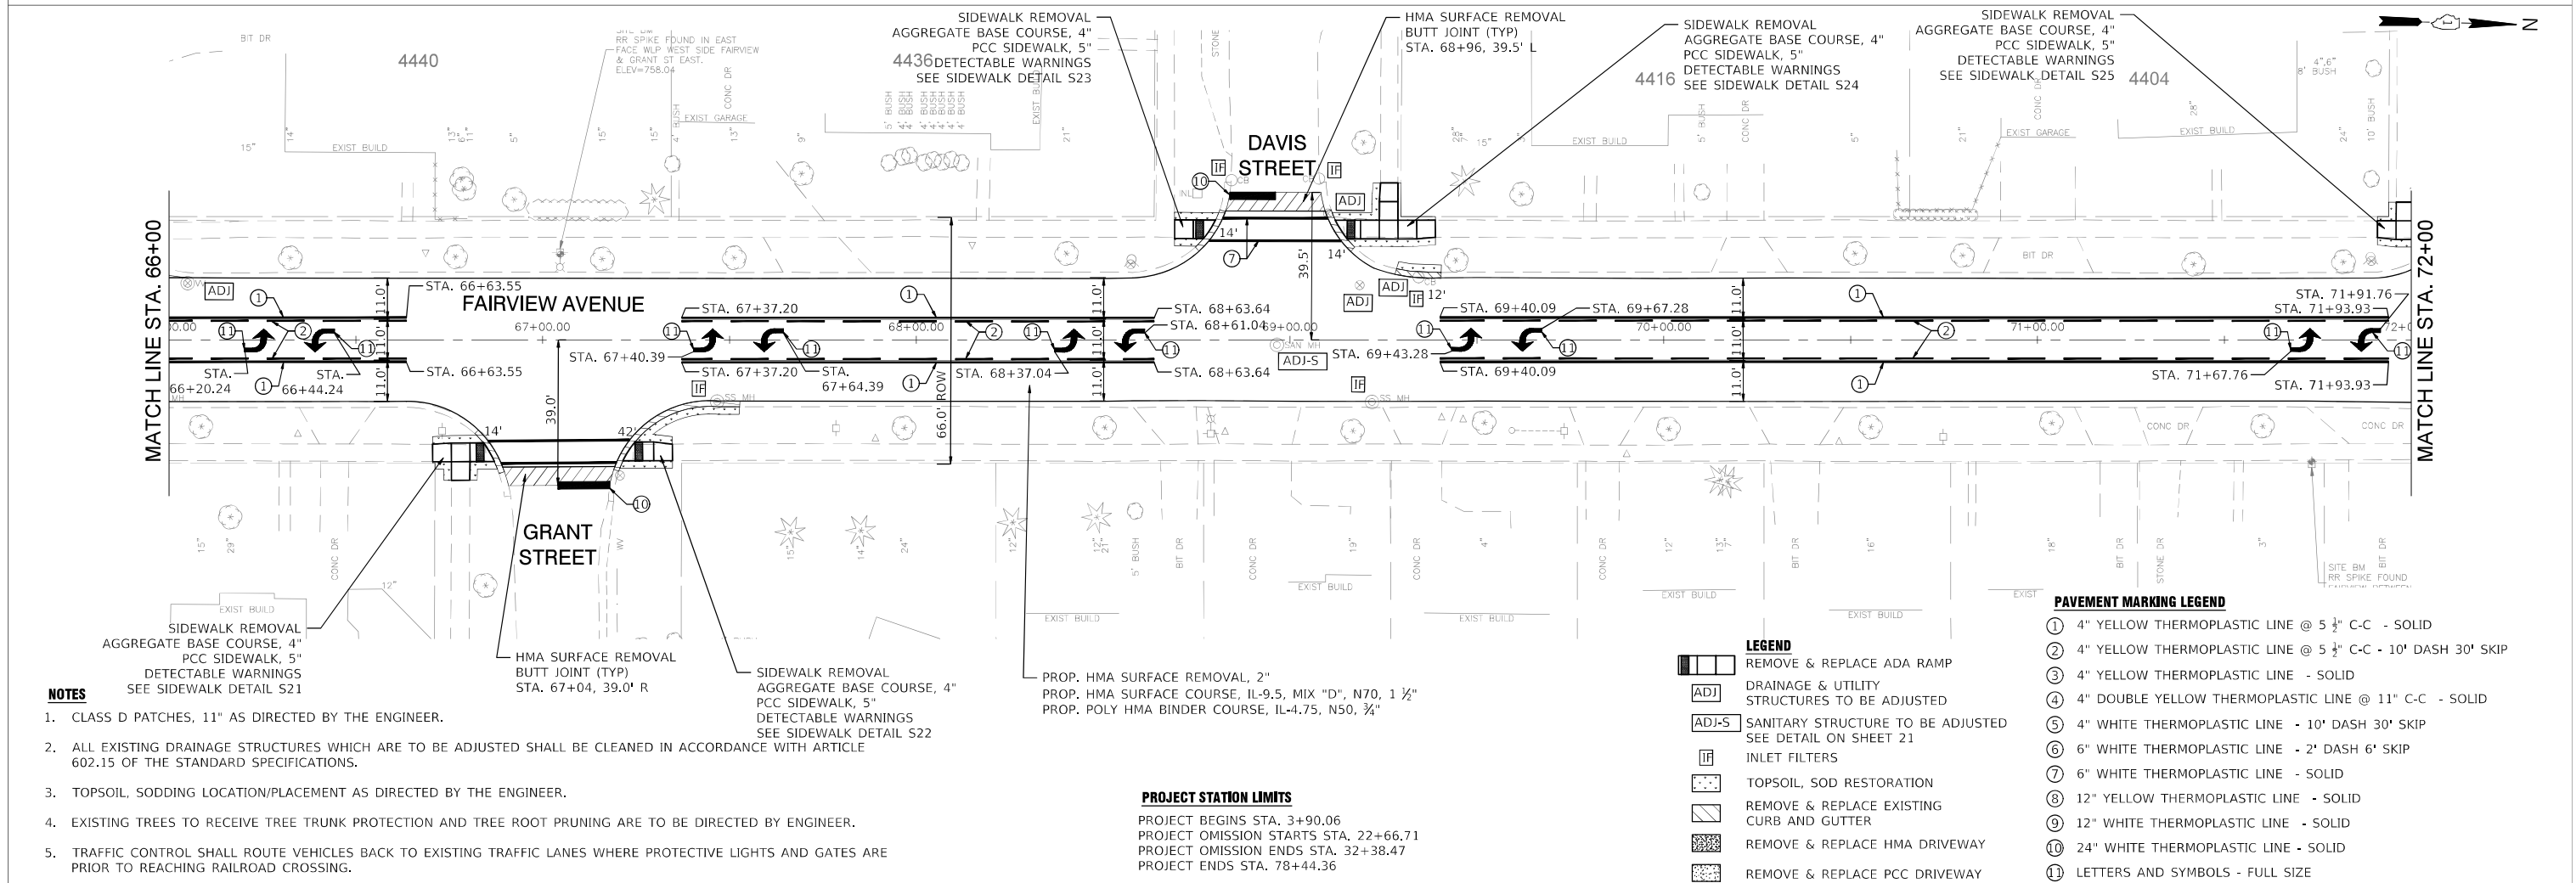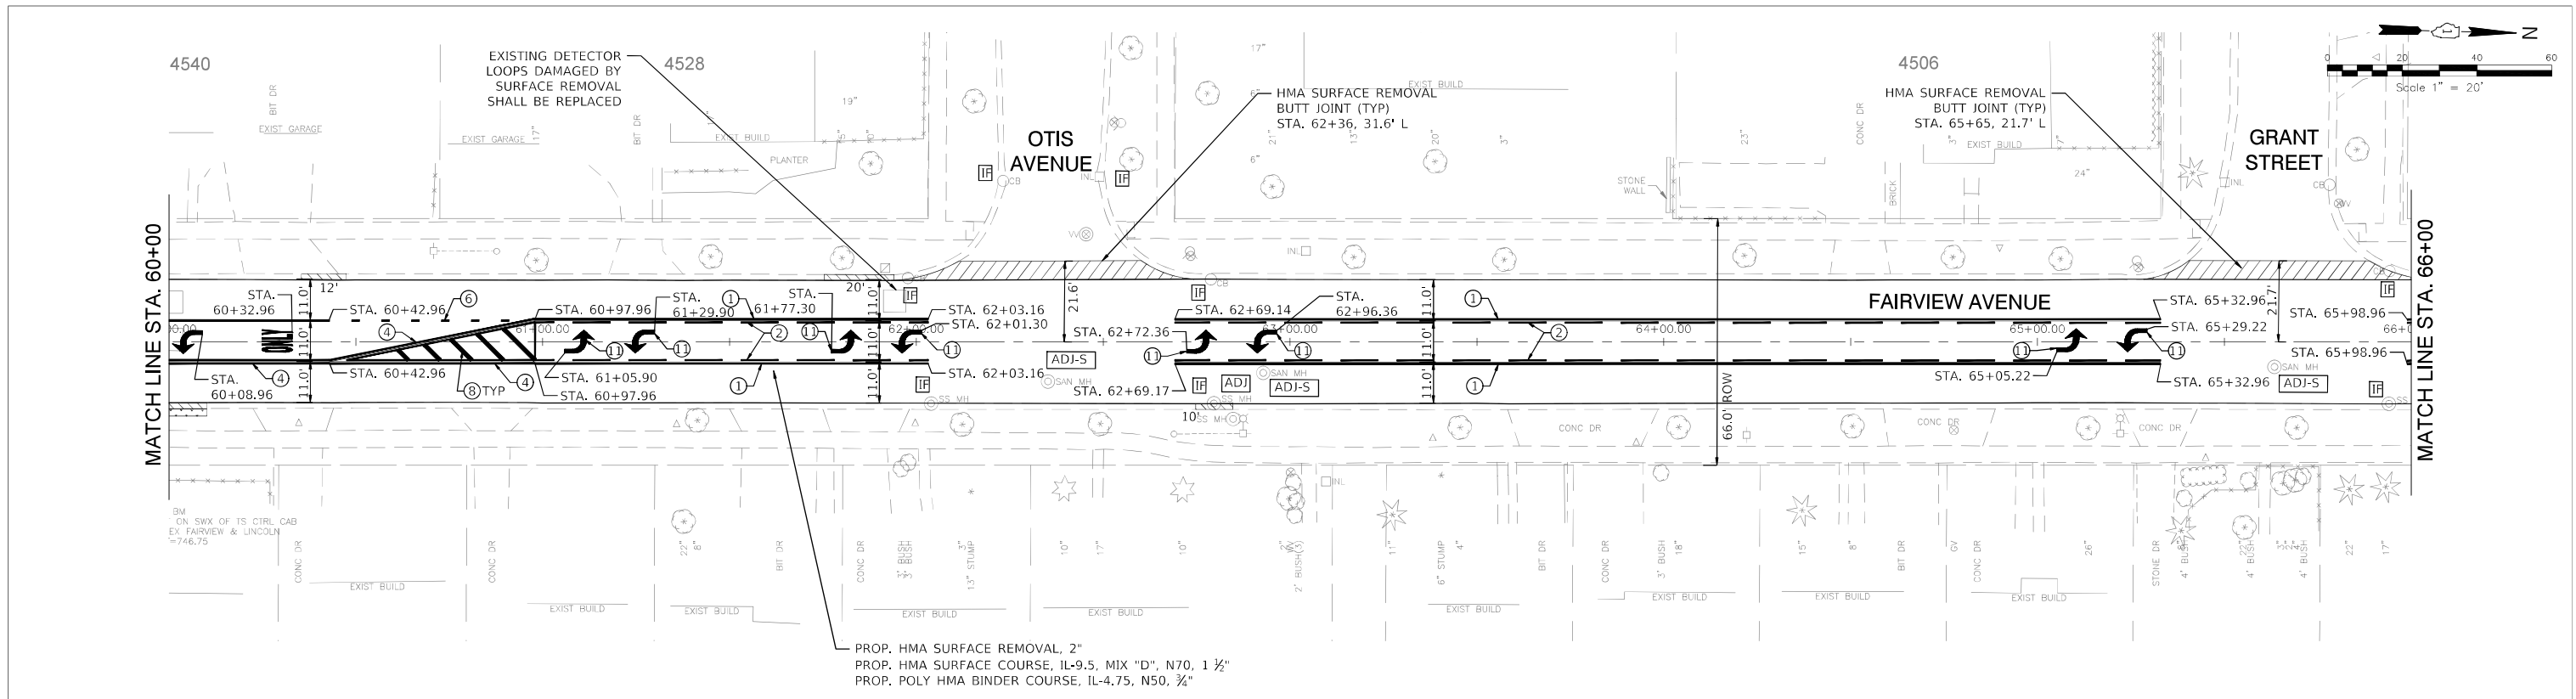


- NOTES**
- CLASS D PATCHES, 11" AS DIRECTED BY THE ENGINEER.
  - ALL EXISTING DRAINAGE STRUCTURES WHICH ARE TO BE ADJUSTED SHALL BE CLEANED IN ACCORDANCE WITH ARTICLE 602.15 OF THE STANDARD SPECIFICATIONS.
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- PAVEMENT MARKING LEGEND**
- ① 4" YELLOW THERMOPLASTIC LINE @ 5 1/2" C-C - SOLID
  - ② 4" YELLOW THERMOPLASTIC LINE @ 5 1/2" C-C - 10' DASH 30' SKIP
  - ③ 4" YELLOW THERMOPLASTIC LINE - SOLID
  - ④ 4" DOUBLE YELLOW THERMOPLASTIC LINE @ 11" C-C - SOLID
  - ⑤ 4" WHITE THERMOPLASTIC LINE - 10' DASH 30' SKIP
  - ⑥ 6" WHITE THERMOPLASTIC LINE - 2' DASH 6' SKIP
  - ⑦ 6" WHITE THERMOPLASTIC LINE - SOLID
  - ⑧ 12" YELLOW THERMOPLASTIC LINE - SOLID
  - ⑨ 12" WHITE THERMOPLASTIC LINE - SOLID
  - ⑩ 24" WHITE THERMOPLASTIC LINE - SOLID
  - Ⓛ LETTERS AND SYMBOLS - FULL SIZE
- LEGEND**
- [Symbol] REMOVE & REPLACE ADA RAMP
  - [ADJ] DRAINAGE & UTILITY STRUCTURES TO BE ADJUSTED
  - [ADJ-S] SANITARY STRUCTURE TO BE ADJUSTED SEE DETAIL ON SHEET 21
  - [IF] INLET FILTERS
  - [Symbol] TOPSOIL, SOD RESTORATION
  - [Symbol] REMOVE & REPLACE EXISTING CURB AND GUTTER
  - [Symbol] REMOVE & REPLACE HMA DRIVEWAY
  - [Symbol] REMOVE & REPLACE PCC DRIVEWAY

**PROJECT STATION LIMITS**  
 PROJECT BEGINS STA. 3+90.06  
 PROJECT OMISSION STARTS STA. 22+66.71  
 PROJECT OMISSION ENDS STA. 32+38.47  
 PROJECT ENDS STA. 78+44.36

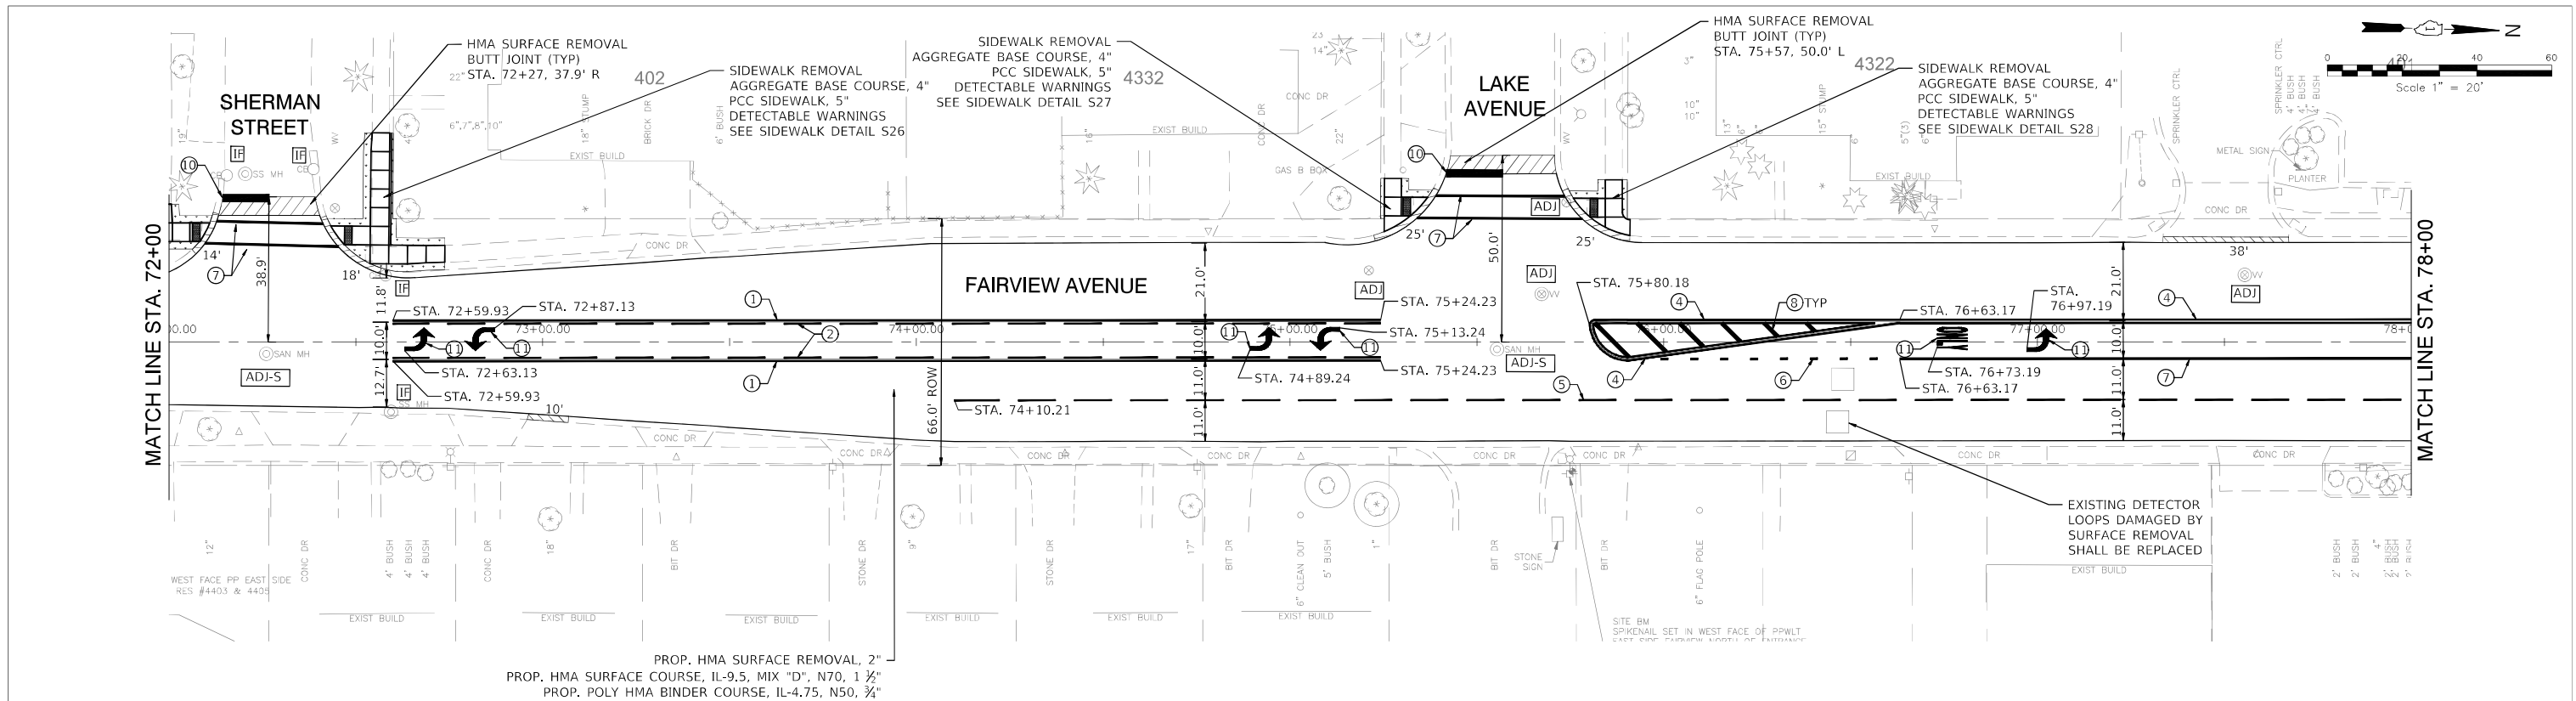

PROP. HMA SURFACE REMOVAL, 2"  
 PROP. HMA SURFACE COURSE, IL-9.5, MIX "D", N70, 1 1/2"  
 PROP. POLY HMA BINDER COURSE, IL-4.75, N50, 3/4"

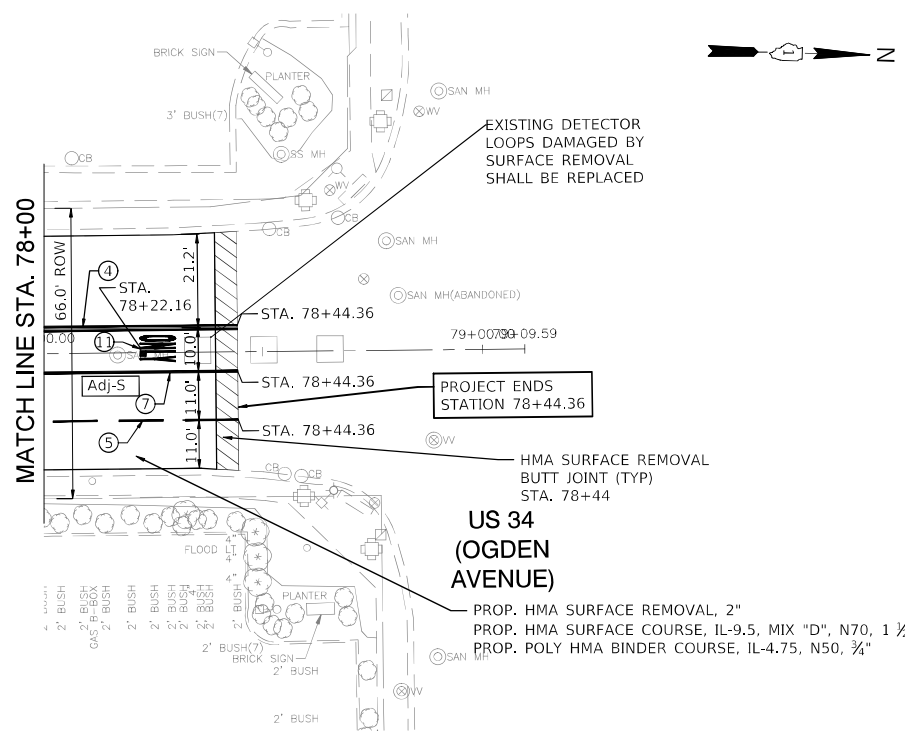

US 34  
 (OGDEN AVENUE)

PROP. HMA SURFACE REMOVAL, 2"  
 PROP. HMA SURFACE COURSE, IL-9.5, MIX "D", N70, 1 1/2"  
 PROP. POLY HMA BINDER COURSE, IL-4.75, N50, 3/4"

**PROJECT STATION LIMITS**

PROJECT BEGINS STA. 3+90.06  
 PROJECT OMISSION STARTS STA. 22+66.71  
 PROJECT OMISSION ENDS STA. 32+38.47  
 PROJECT ENDS STA. 78+44.36

**STATE OF ILLINOIS  
 DEPARTMENT OF TRANSPORTATION**

**NOTES**

- CLASS D PATCHES, 11" AS DIRECTED BY THE ENGINEER.
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**LEGEND**

- REMOVE & REPLACE ADA RAMP
- DRAINAGE & UTILITY STRUCTURES TO BE ADJUSTED
- SANITARY STRUCTURE TO BE ADJUSTED SEE DETAIL ON SHEET 21
- INLET FILTERS
- TOPSOIL, SOD RESTORATION
- REMOVE & REPLACE EXISTING CURB AND GUTTER
- REMOVE & REPLACE HMA DRIVEWAY
- REMOVE & REPLACE PCC DRIVEWAY

**PAVEMENT MARKING LEGEND**

- ① 4" YELLOW THERMOPLASTIC LINE @ 5 1/2" C-C - SOLID
- ② 4" YELLOW THERMOPLASTIC LINE @ 5 1/2" C-C - 10' DASH 30' SKIP
- ③ 4" YELLOW THERMOPLASTIC LINE - SOLID
- ④ 4" DOUBLE YELLOW THERMOPLASTIC LINE @ 11" C-C - SOLID
- ⑤ 4" WHITE THERMOPLASTIC LINE - 10' DASH 30' SKIP
- ⑥ 6" WHITE THERMOPLASTIC LINE - 2' DASH 6' SKIP
- ⑦ 6" WHITE THERMOPLASTIC LINE - SOLID
- ⑧ 12" YELLOW THERMOPLASTIC LINE - SOLID
- ⑨ 12" WHITE THERMOPLASTIC LINE - SOLID
- ⑩ 24" WHITE THERMOPLASTIC LINE - SOLID
- Ⓛ LETTERS AND SYMBOLS - FULL SIZE

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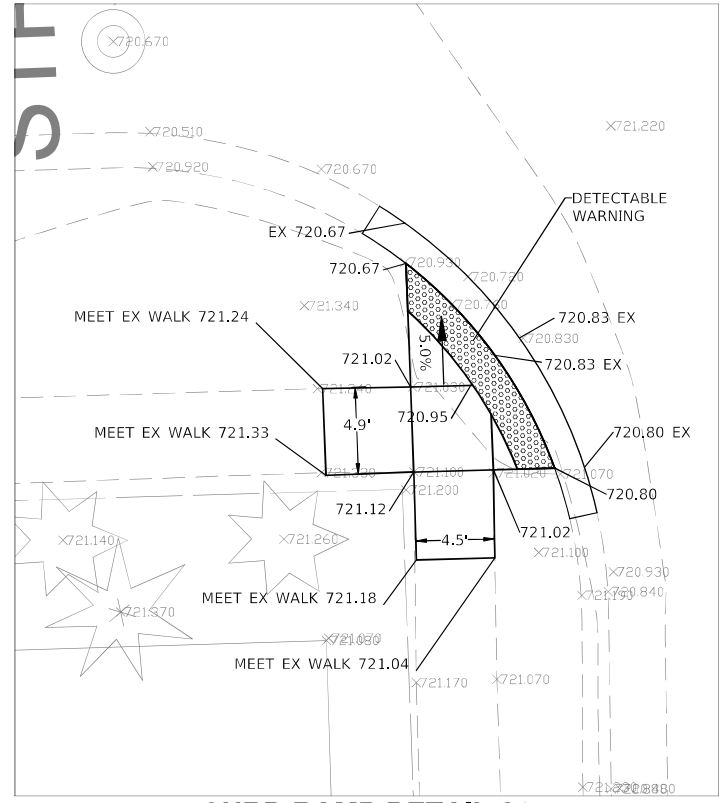
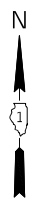
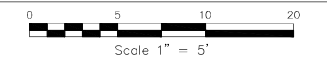
**PLAN SHEET (STA. 72+00 TO STA. 79+10)**

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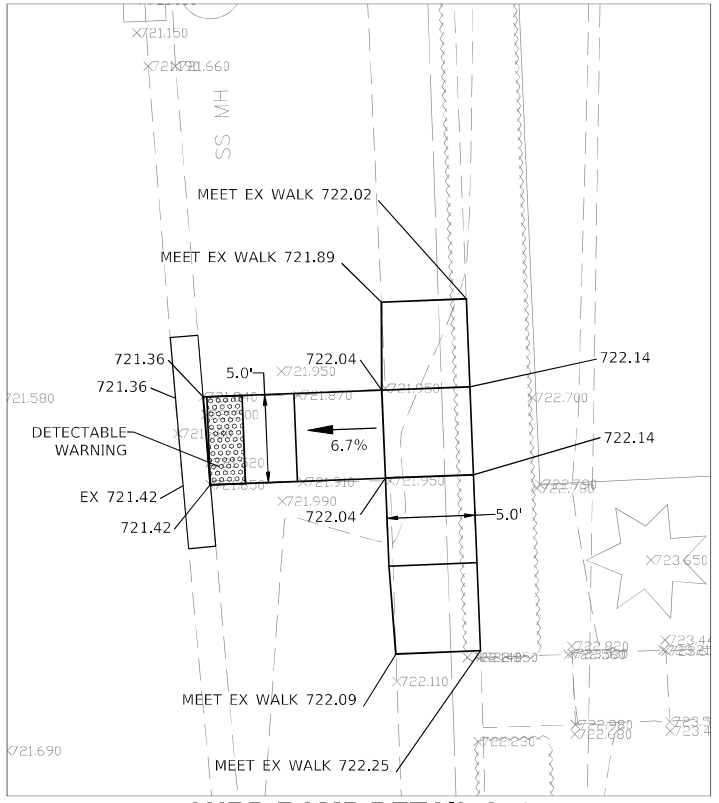
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2637	19-00114-00-RS	DuPAGE	32	15
ILLINOIS			CONTRACT NO. 61H39	
FED. AID PROJECT				









**CURB RAMP DETAIL S9  
STA. 35+65 - LEFT SIDE**




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STA. 36+24 - RIGHT SIDE**

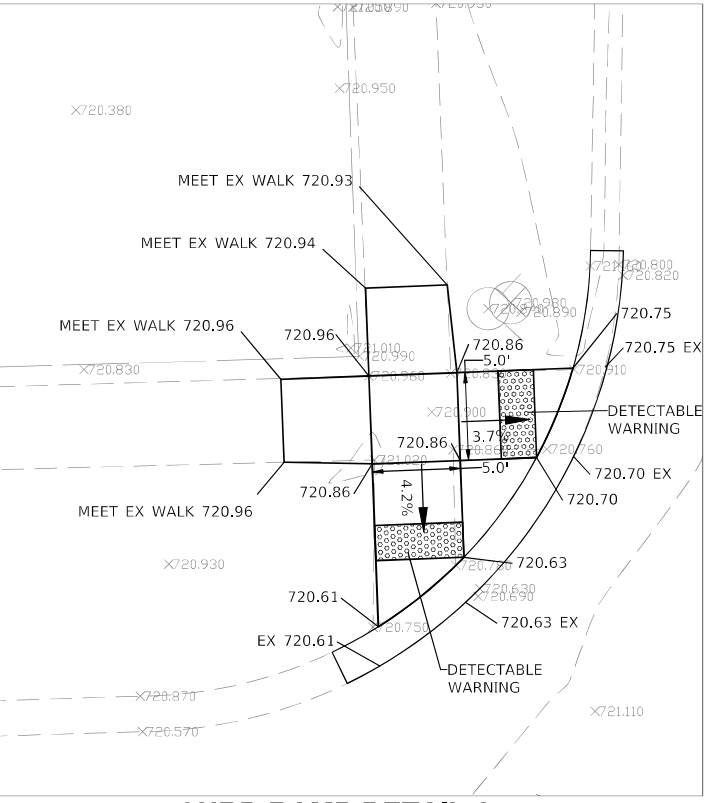


**CURB RAMP DETAIL S11  
STA. 36+24 - LEFT SIDE**

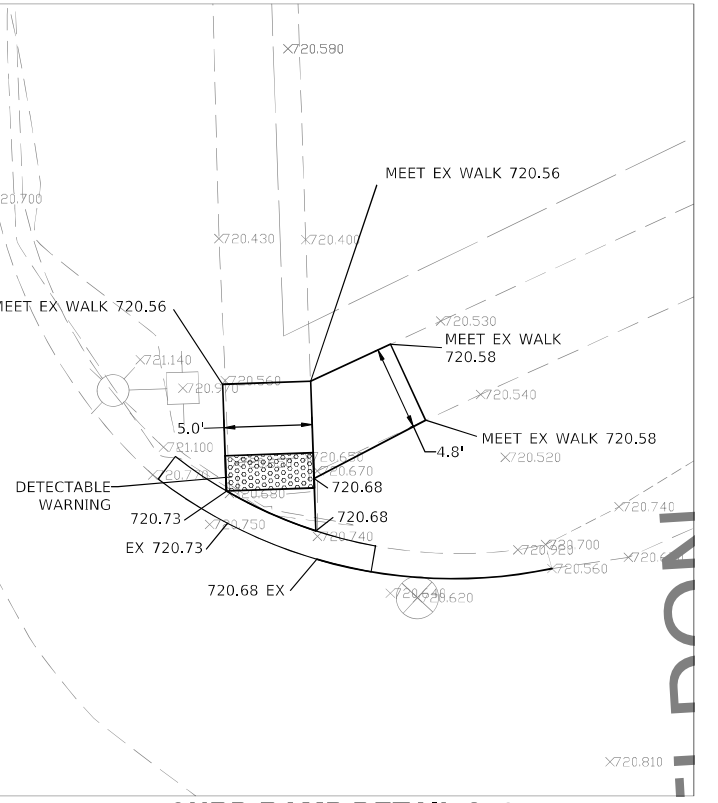


**CURB RAMP DETAIL S12  
STA. 37+23 - RIGHT SIDE**

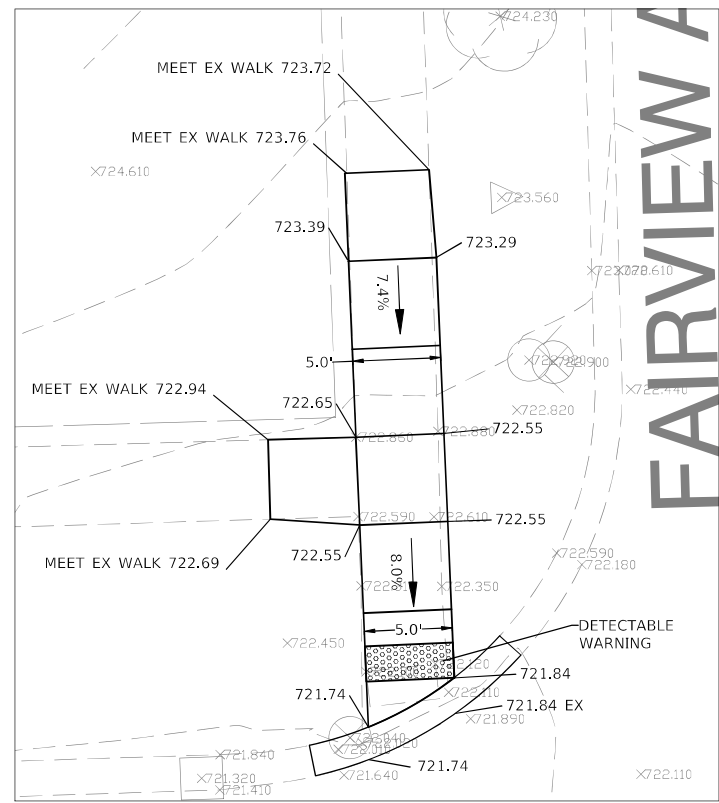


**CURB RAMP DETAIL S13  
STA. 39+50 - LEFT SIDE**

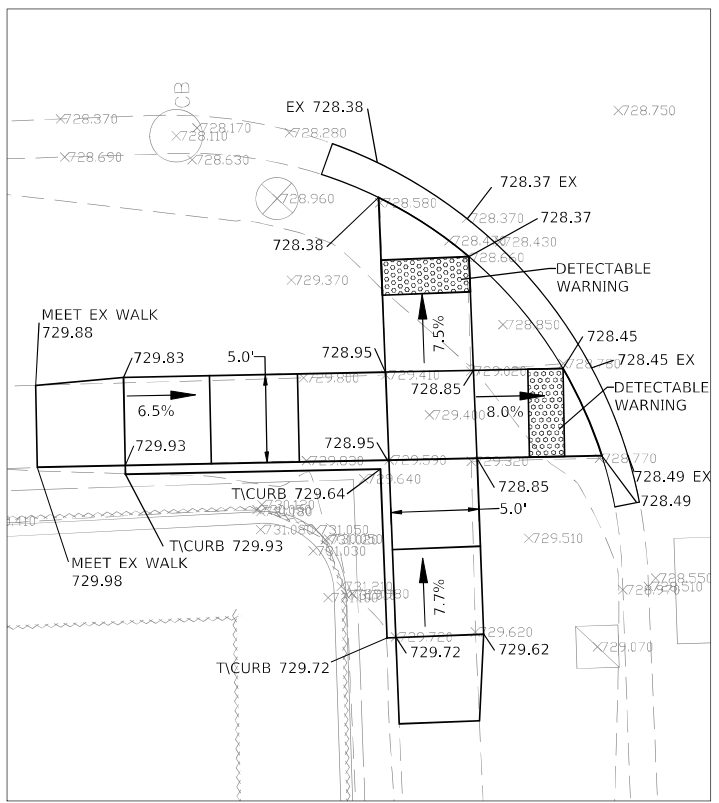

**CURB RAMP DETAIL S14  
STA. 48+85 - LEFT SIDE**

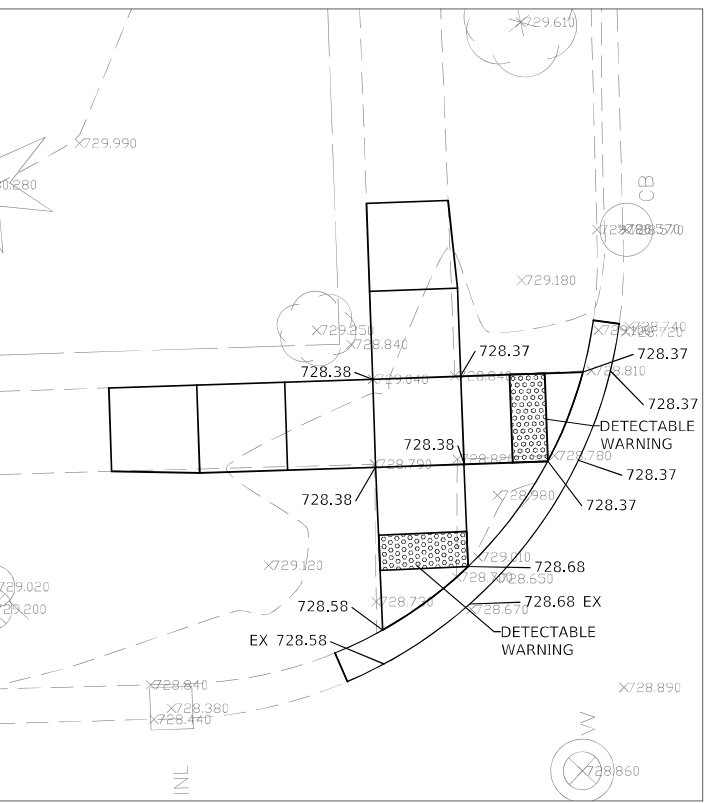

**CURB RAMP DETAIL S15  
STA. 49+43 - LEFT SIDE**

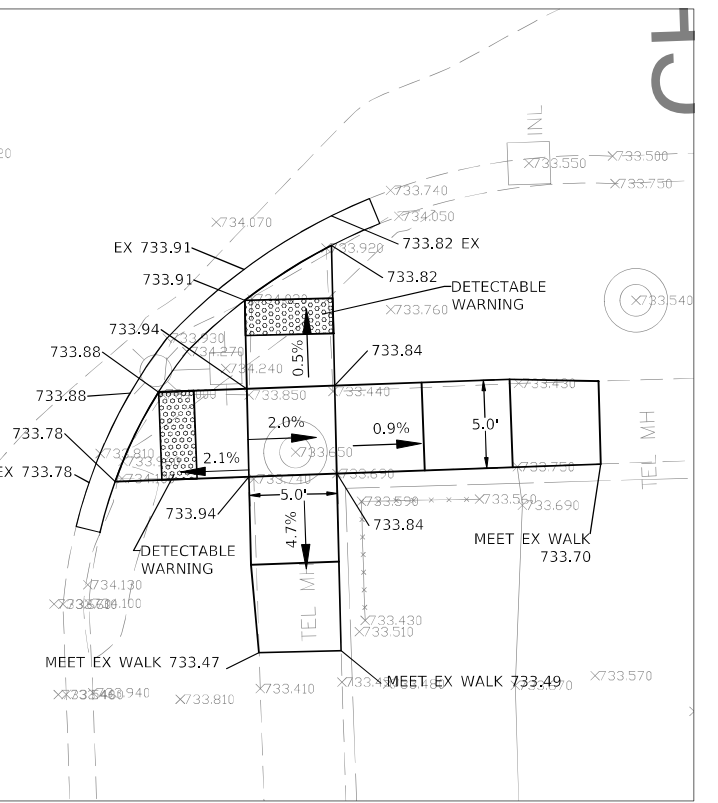

**CURB RAMP DETAIL S16  
STA. 49+43 - LEFT SIDE**



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PLOT DATE - 11/19/21		DATE - 11/19/21	REVISED

**STATE OF ILLINOIS  
DEPARTMENT OF TRANSPORTATION**


**CURB RAMP DETAILS (S9 TO S16)**

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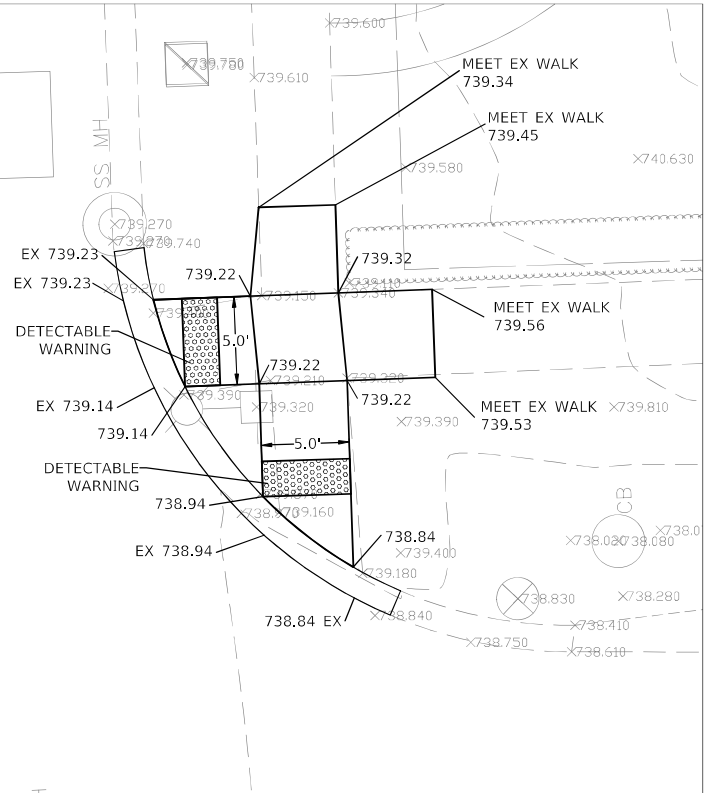
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CONTRACT NO. 61H39				
ILLINOIS FED. AID PROJECT				

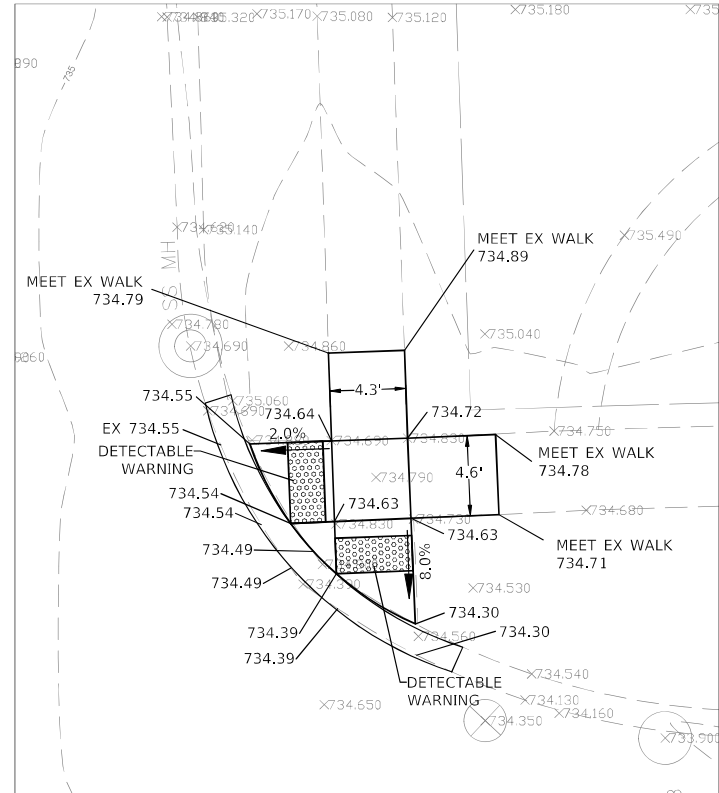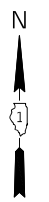


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STA. 52+73 - RIGHT SIDE**

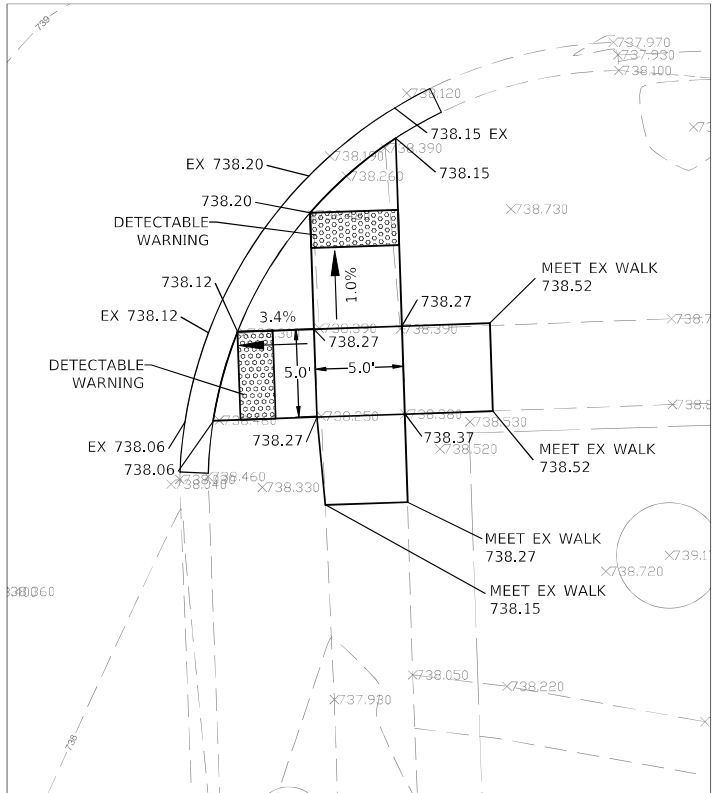


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STA. 55+50 - RIGHT SIDE**




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STA. 56+07 - RIGHT SIDE**

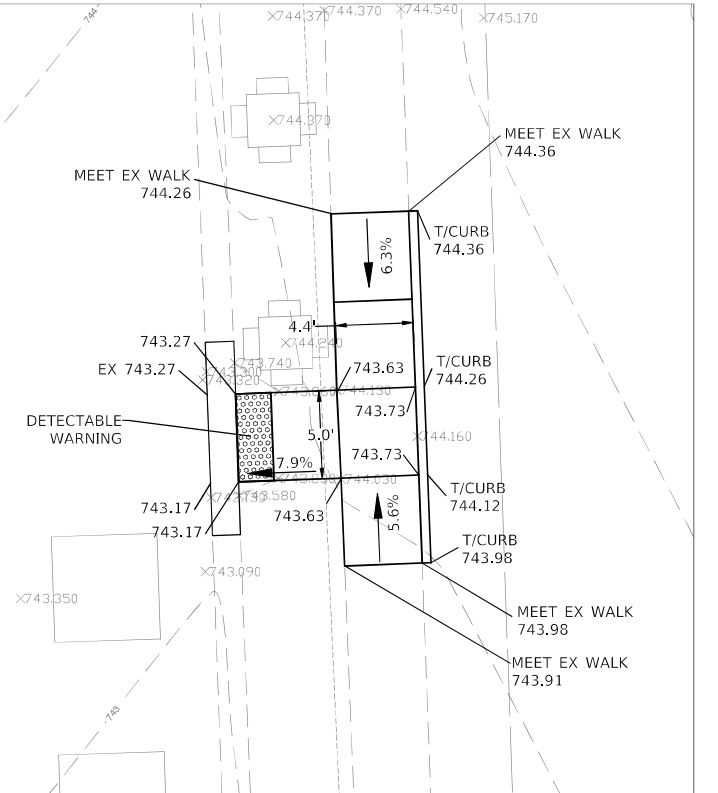


**CURB RAMP DETAIL S20  
STA. 58+77 - RIGHT SIDE**

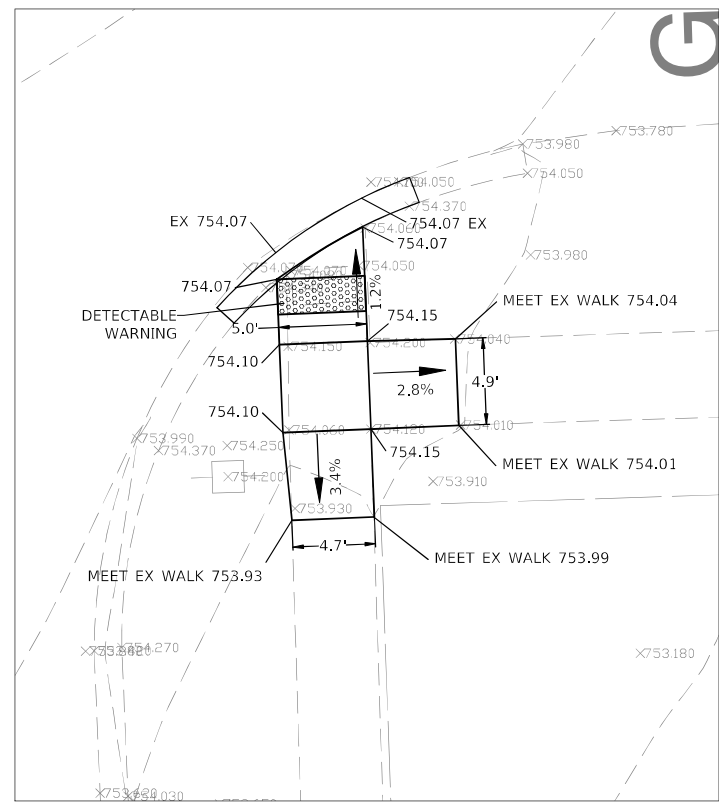


**CURB RAMP DETAIL S21  
STA. 66+80 - RIGHT SIDE**

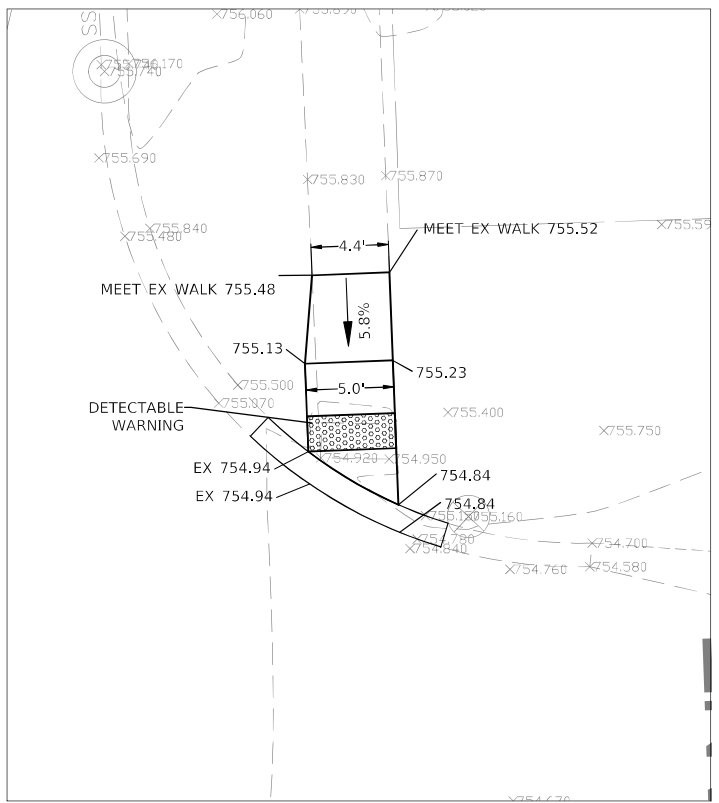

**CURB RAMP DETAIL S22  
STA. 67+30 - RIGHT SIDE**

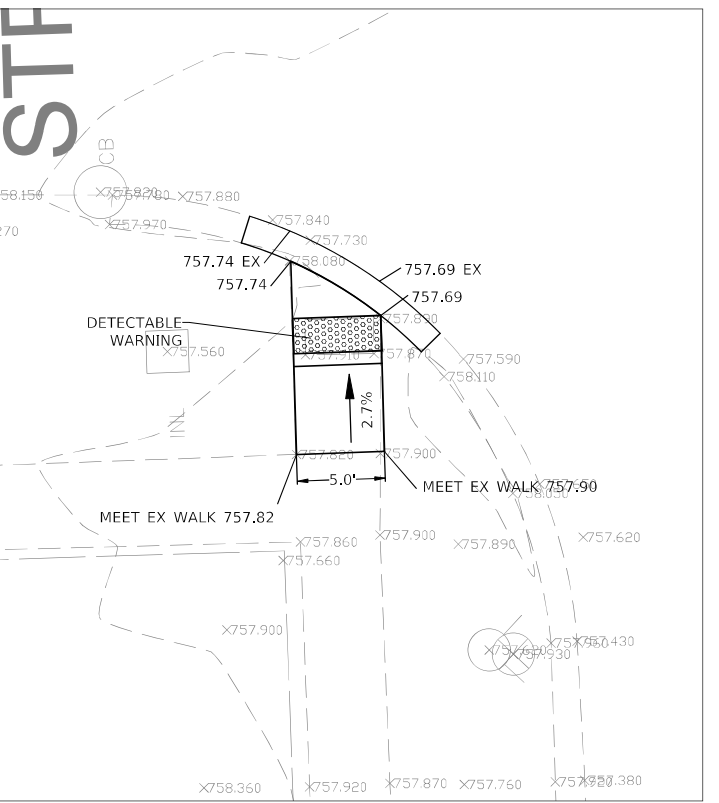

**CURB RAMP DETAIL S23  
STA. 68+73 - LEFT SIDE**

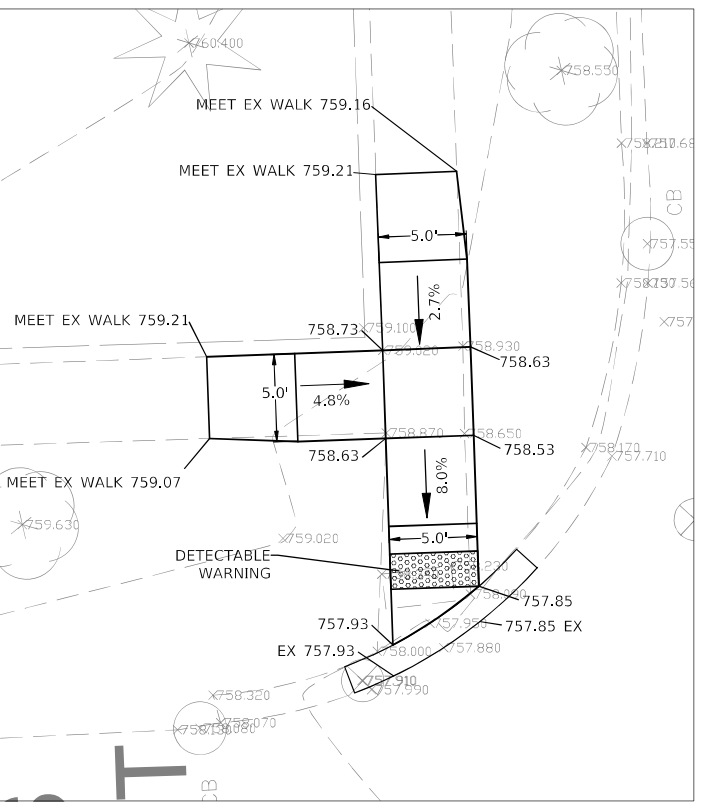

**CURB RAMP DETAIL S24  
STA. 69+24 - LEFT SIDE**

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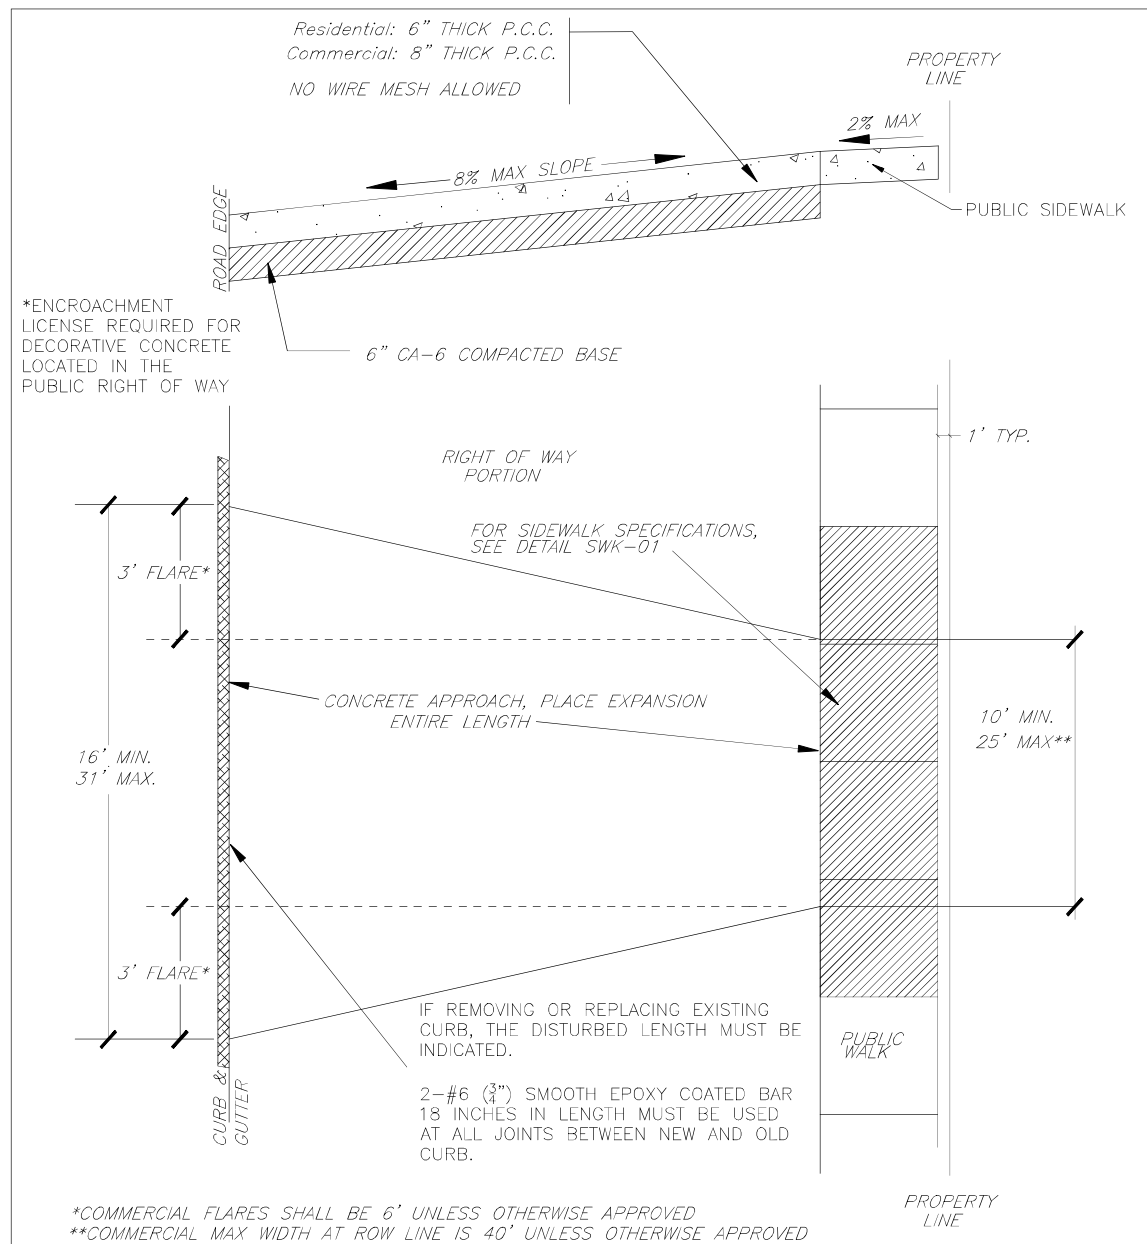
**STATE OF ILLINOIS  
DEPARTMENT OF TRANSPORTATION**

**CURB RAMP DETAILS (S17 TO S24)**


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F.A.U. RTE.	SECTION	COUNTY	TOTAL SHEETS	SHEET NO.
2637	19-00114-00-RS	DuPAGE	32	18
CONTRACT NO. 61H39				
ILLINOIS		FED. AID PROJECT		





N.T.S.	DATE	REVISIONS	DRAWN BY	APPVD BY	STANDARD DETAIL
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DRAWING NO. PVT-09					
I:\LIBRARY\DETAILS\PAVEMENT\PVT-09					

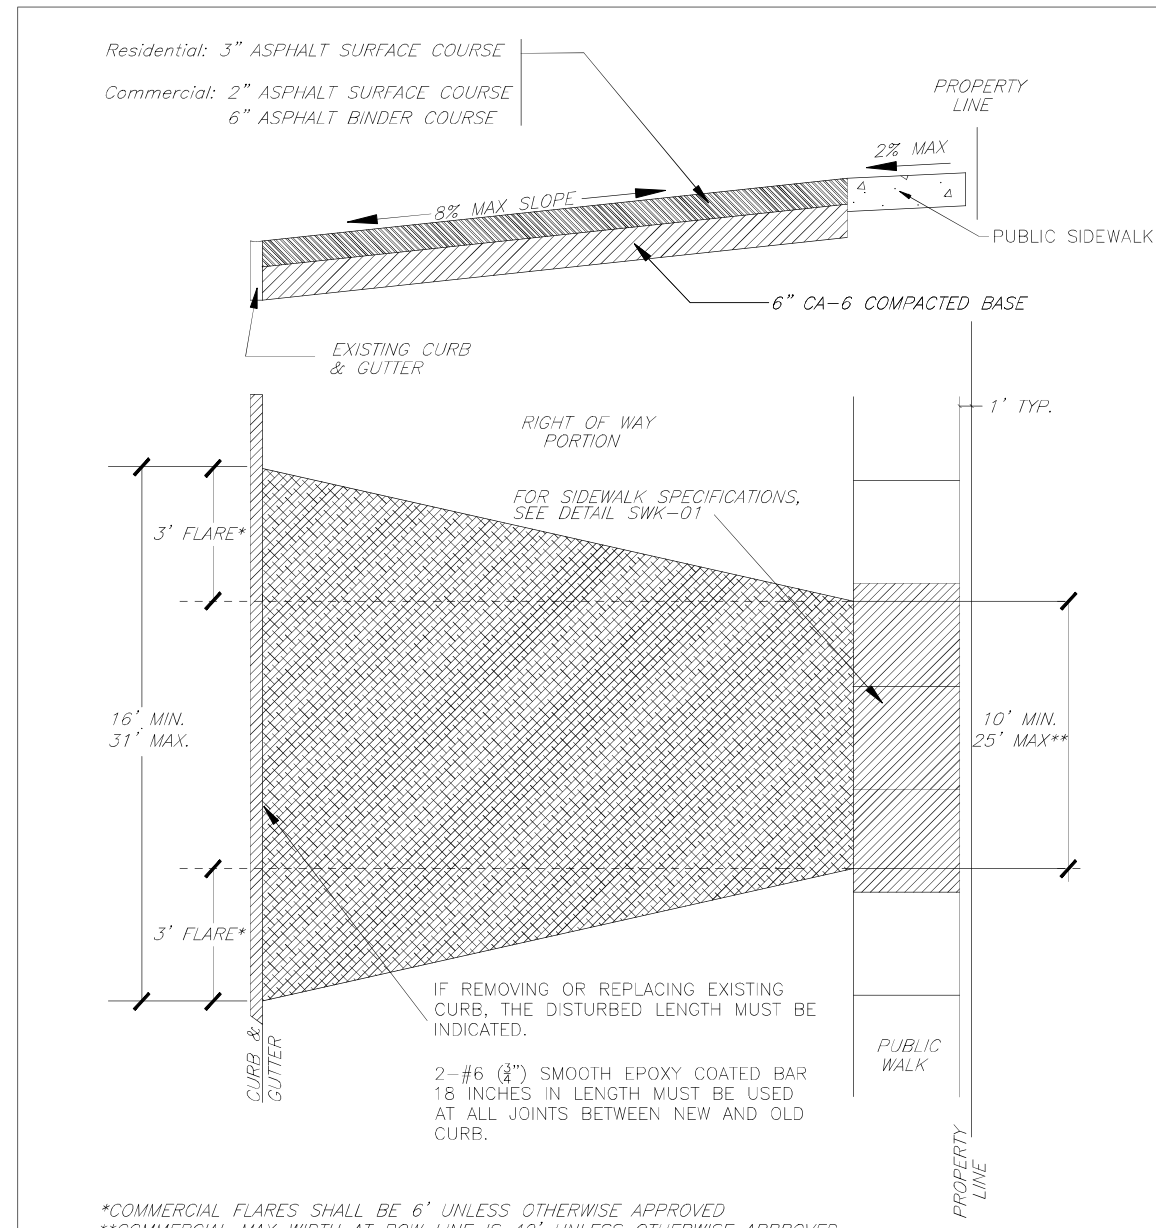

N.T.S.	DATE	REVISIONS	DRAWN BY	APPVD BY	STANDARD DETAIL
	01/01/19		N.R.H.	J.M.W.	ASPHALT APPROACH WITH CURB
DRAWING NO. PVT-03					
I:\LIBRARY\DETAILS\PAVEMENT\PVT-03					


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	PLOT DATE -- 11/19/21	DATE -- 11/19/21	REVISED

**STATE OF ILLINOIS  
DEPARTMENT OF TRANSPORTATION**

**VILLAGE DETAILS**


NOT TO SCALE      SHEET NO. 1 OF 2 SHEETS      STA. TO STA.

F.A.U. RTE.	SECTION	COUNTY	TOTAL SHEETS	SHEET NO.
2637	19-00114-00-RS	DuPAGE	32	20
CONTRACT NO. 61H39				
ILLINOIS FED. AID PROJECT				

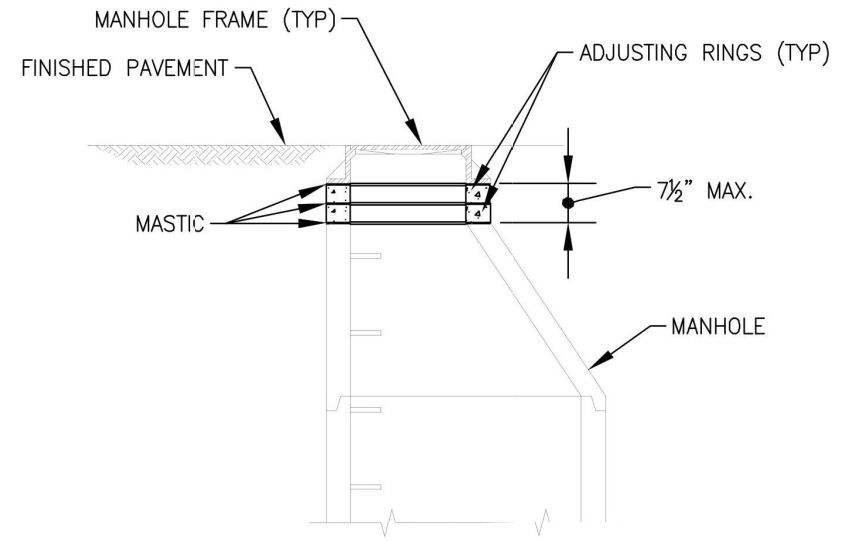

THIS METHOD SHALL BE USED FOR ALL MANHOLES WHICH WILL HAVE LESS THAN SEVEN AND ONE-HALF (7-1/2") INCHES OF ADJUSTMENT BETWEEN THE TOP OF THE CONE AND THE BOTTOM OF THE FRAME WHEN SET AT FINISHED GRADE. TO RAISE THE FRAME, ADJUSTMENT SHALL BE MADE USING PRECAST REINFORCED CONCRETE RINGS. CONCRETE BLOCKS OR BRICKS SHALL NOT BE USED. THE SPACES BETWEEN THE CONE, RINGS AND FRAME SHALL BE COMPLETELY SEALED WITH PREFORMED BITUMINOUS MASTIC (EASY STIK MORTAR SHALL NOT BE USED. TO LOWER THE FRAME, EXISTING ADJUSTMENTS SHALL BE REMOVED AND THE SPACE BETWEEN THE FRAME AND THE CONE SHALL BE COMPLETELY SEALED WITH PREFORMED BITUMINOUS MASTIC GASKET. IF THE MANHOLE WOULD HAVE SEVEN AND ONE-HALF (7-1/2") INCHES OR MORE OF ADJUSTMENTS WHEN SET AT THE FINISHED GRADE OR IF THE FRAME MUST BE LOWERED BY MORE THAN THE AMOUNT OF EXISTING ADJUSTMENT, THE MANHOLE SHALL BE RECONSTRUCTED. REFER TO DOWNERS GROVE SANITARY DISTRICT SPECIFICATIONS FOR MANHOLE RECONSTRUCTION. THE DOWNERS GROVE SANITARY DISTRICT SHALL BE NOTIFIED OF MANHOLES TO BE ADJUSTED PRIOR TO BEGINNING CONSTRUCTION. ONCE COMPLETED, NO SUCH ADJUSTMENT SHALL BE BACKFILLED WITHOUT INSPECTION BY THE DOWNERS GROVE SANITARY DISTRICT.

FRAMES & LIDS TO  
BE ADJUSTED  
(SPECIAL)

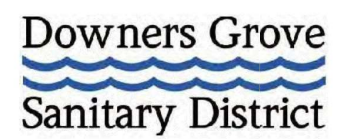

REV. 2-1-15  
REV. 8-12-97  
REV. 10-20-84

FILE NAME =	USER NAME -- USER	DESIGNED -- NRH	REVISED
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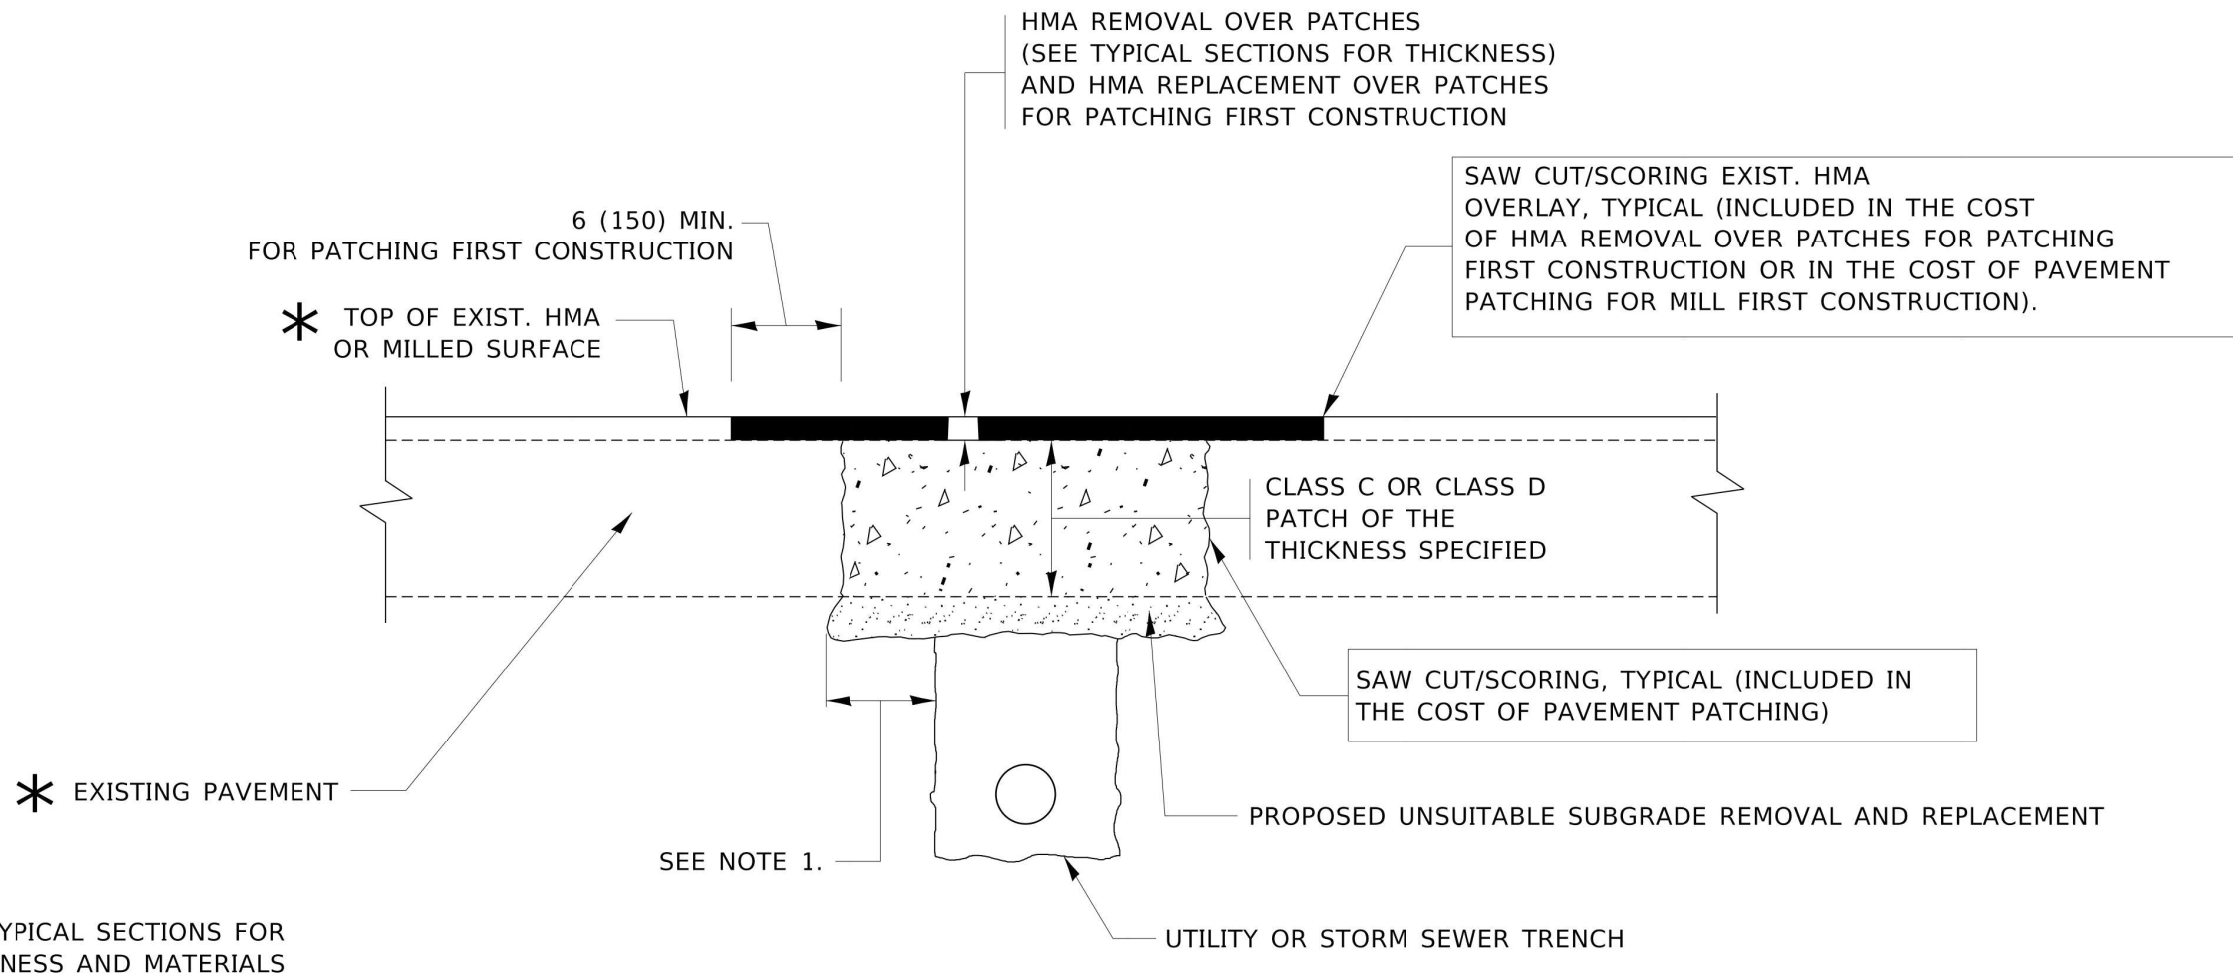
STATE OF ILLINOIS  
DEPARTMENT OF TRANSPORTATION

VILLAGE DETAILS

NOT TO SCALE SHEET NO. 2 OF 2 SHEETS STA. TO STA.

F.A.U. RTE.	SECTION	COUNTY	TOTAL SHEETS	SHEET NO.
2637	19-00114-00-RS	DuPAGE	32	21
CONTRACT NO. 61H39				
ILLINOIS		FED. AID PROJECT		





**NOTES:**

1. THE WIDTH OF THE FULL DEPTH PATCH OVER A TRENCH SHALL BE 12 (300) WIDER ON EACH SIDE OF THE TRENCH.
2. FOR METHOD OF MEASUREMENT AND BASIS OF PAYMENT, SEE RECURRING SPECIAL PROVISION "PATCHING WITH HOT-MIX ASPHALT OVERLAY REMOVAL".

**SEQUENCE OF CONSTRUCTION (PATCHING FIRST)**

1. REMOVE THE EXISTING HMA MATERIAL OVER THE AREA TO BE PATCHED.
2. REMOVE AND REPLACE WITH CLASS C OR D PATCH.
3. REPLACE HMA MATERIAL OVER THE AREA TO BE PATCHED.

**SEQUENCE OF CONSTRUCTION (MILLING FIRST)**

1. MILL HMA FIRST IF THERE IS AT LEAST 4½ INCHES OR MORE OF HMA MATERIAL ON TOP OF THE EXISTING PAVEMENT OR IF THE PAVEMENT IS FULL DEPTH HMA. A MINIMUM OF 2 INCHES OF HMA MATERIAL SHALL BE IN PLACE AFTER MILLING.
2. REMOVE AND REPLACE WITH FULL DEPTH CLASS D PATCHES TO TOP OF MILLED SURFACE.

ALL DIMENSIONS ARE IN INCHES (MILLIMETERS) UNLESS OTHERWISE SHOWN.

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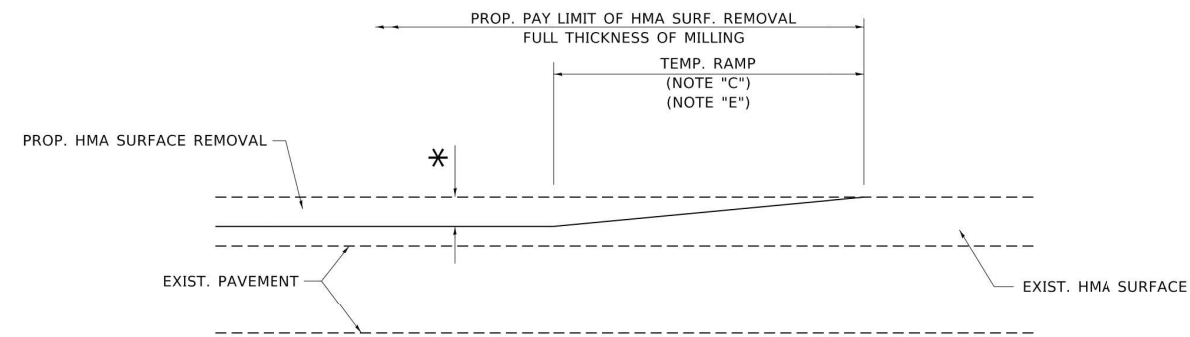
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	DRAWN -	REVISED - R. BORO 01-01-07
PLOT SCALE = 50.0000' / in.	CHECKED -	REVISED - R. BORO 09-04-07
PLOT DATE = 3/27/2019	DATE - 10-25-94	REVISED - K. ENG 10-27-08

**STATE OF ILLINOIS  
DEPARTMENT OF TRANSPORTATION**

**PAVEMENT PATCHING FOR  
HMA SURFACED PAVEMENT**


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F.A.U. RTE. 2637	SECTION 19-00114-00-RS	COUNTY DuPAGE	TOTAL SHEETS 32	SHEET NO. 23
BD400-04 (BD-22)			CONTRACT NO. 61H39	
ILLINOIS FED. AID PROJECT				



**MILLED TEMPORARY RAMP**  
(FOR BUTT JOINT AND HMA TAPER SEE DETAIL BELOW)


**OPTION 1**

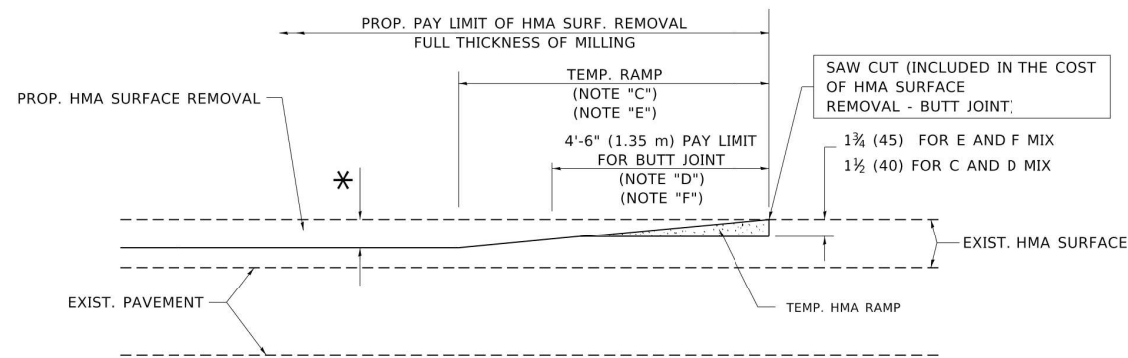


**HMA CONSTRUCTED TEMPORARY RAMP**  
(FOR BUTT JOINT AND HMA TAPER SEE DETAIL BELOW)

**OPTION 2**

**TYPICAL TEMPORARY RAMP**

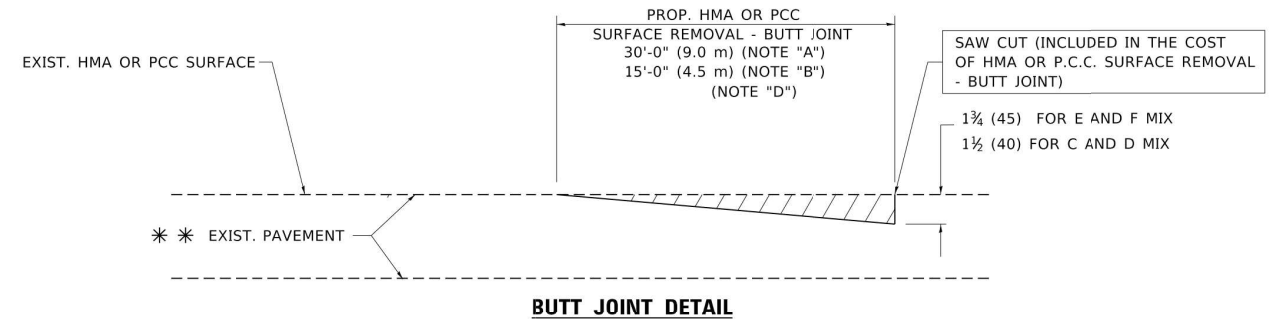

**BUTT JOINT DETAIL**

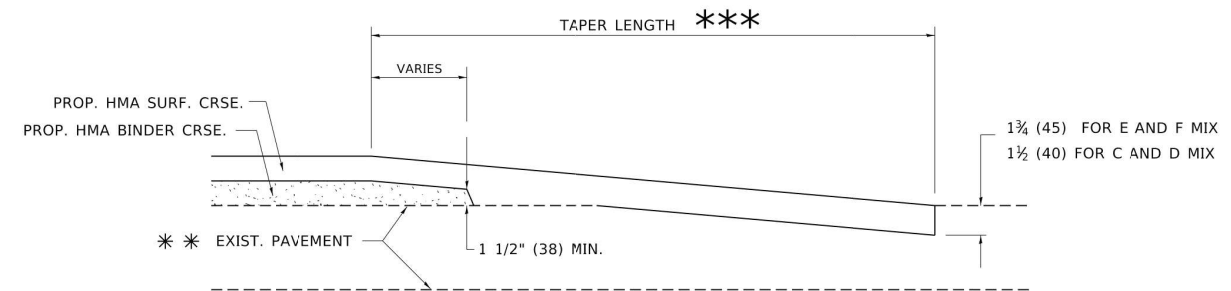

**HMA TAPER DETAIL**

**TYPICAL BUTT JOINT AND HMA TAPER FOR RESURFACING ONLY**

\*\*\* PC CONCRETE, HMA OR HMA RESURFACED PAVEMENT.


**NOTES**

- A. MAINLINE ROADWAYS AND MAJOR SIDE ROADS.
- B. MINOR SIDE ROADS.
- C. THE TEMP. RAMP SHALL BE CONSTRUCTED IMMEDIATELY UPON REMOVAL OF THE EXISTING HMA SURFACE.
- D. THE BUTT JOINT SHALL BE CONSTRUCTED IMMEDIATELY PRIOR TO PLACING THE PROPOSED HMA COURSES.
- E. TAPER THE TEMP. RAMP AT A RATE OF 3'-0" (900 mm) PER 1 INCH (25 mm) OF MILLING THICKNESS.
- F. INSTALLATION AND REMOVAL OF THE 4'-6" (1.35 m) TEMP. RAMP IS INCLUDED IN COST OF HMA SURFACE REMOVAL - BUTT JOINT.  
\* SEE TYPICAL SECTIONS FOR MILLING THICKNESS.
- G. SEE ARTICLE 406.08 AND 406.14 OF THE STANDARD SPECIFICATIONS FOR "HMA AND/OR PCC SURFACE REMOVAL, BUTT JOINT".  
\*\*\* 20'-0" (6.1 m) PER 1 (25) RESURFACING (NOTE "A")  
10'-0" (3.0 m) PER 1 (25) RESURFACING (NOTE "B")

**BASIS OF PAYMENT**

THE BUTT JOINT WILL BE PAID FOR AT THE CONTRACT UNIT PRICE PER SQUARE YARD (SQUARE METER) FOR "HOT-MIX ASPHALT SURFACE REMOVAL - BUTT JOINT" OR FOR "PORTLAND CEMENT CONCRETE SURFACE REMOVAL - BUTT JOINT".

ALL DIMENSIONS ARE IN INCHES (MILLIMETERS) UNLESS OTHERWISE SHOWN.

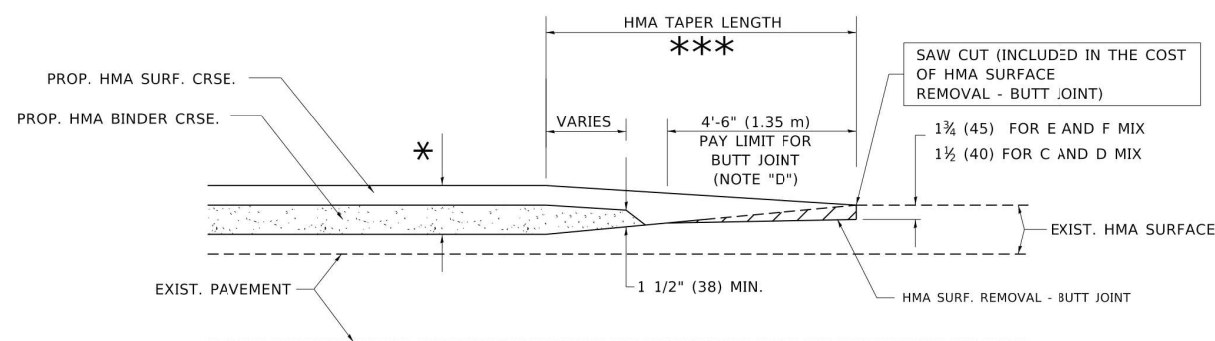

**BUTT JOINT AND HMA TAPER**

**TYPICAL BUTT JOINT AND HMA TAPER FOR MILLING AND RESURFACING**

USER NAME = footemj	DESIGNED - M. DE YONG	REVISED - R. SHAH 10-25-94
	DRAWN -	REVISED - A. ABBAS 03-21-97
PLOT SCALE = 50.0000' / in.	CHECKED -	REVISED - M. GOMEZ 04-06-01
PLOT DATE = 3/27/2019	DATE - 06-13-90	REVISED - R.BORO 01-01-07

**STATE OF ILLINOIS  
DEPARTMENT OF TRANSPORTATION**

**BUTT JOINT AND  
HMA TAPER DETAILS**


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F.A.U. RTE. 2637	SECTION 19-00114-00-RS	COUNTY DuPAGE	TOTAL SHEETS 32	SHEET NO. 24
<b>BD400-05 BD32</b>		CONTRACT NO. 61H39		
ILLINOIS FED. AID PROJECT				

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**NOTES:**


- SIDE ROAD WITH A SPEED LIMIT OF 40 MPH (60 km/h) OR LESS AS SHOWN ON THE DRAWING AND AS DIRECTED BY THE ENGINEER:
  - ONE "ROAD CONSTRUCTION AHEAD" SIGN 36 x 36 (900x900) WITH A FLASHER MOUNTED ON IT APPROXIMATELY 200' (60 m) IN ADVANCE OF THE MAIN ROUTE.
  - THE CLOSED PORTION OF THE MAIN ROUTE SHALL BE PROTECTED BY BLOCKING WITH TYPE I, TYPE II OR TYPE III BARRICADES, 1/3 OF THE CROSS SECTION OF THE CLOSED PORTION.
- SIDE ROAD WITH A SPEED LIMIT GREATER THAN 40 MPH (60 km/h) AS SHOWN ON THE DRAWING AND AS DIRECTED BY THE ENGINEER:
  - ONE "ROAD CONSTRUCTION AHEAD" SIGN 48 x 48 (1.2 m x 1.2 m) WITH A FLASHER MOUNTED ON IT APPROXIMATELY 500' (150 m) IN ADVANCE OF THE MAIN ROUTE.
  - THE CLOSED PORTION OF THE MAIN ROUTE SHALL BE PROTECTED BY BLOCKING WITH TYPE III BARRICADES, 1/2 OF THE CROSS SECTION OF THE CLOSED PORTION.
- CONES MAY BE SUBSTITUTED FOR BARRICADES OR DRUMS AT HALF THE SPACING DURING DAY OPERATIONS. CONES SHALL BE A MINIMUM OF 28 (7.10) IN HEIGHT.
- SIGNING AND THE WORK ZONE, A SINGLE HEADED ARROW (M6-1) SHALL BE USED IN LIEU OF THE DOUBLE HEADED ARROW (M6-4).
- WHEN WORK IS BEING PERFORMED ON A SIDE ROAD OR DRIVEWAY, FOLLOW THE APPLICABLE STANDARD(S). THE DIRECTIONAL ARROW (M6-1 OR M6-4) SHALL BE COVERED OR REMOVED WHEN NO LONGER CONSISTENT WITH THE TRAFFIC CONTROL SET-UP.
- ADVANCE WARNING SIGNS ARE TO BE OMITTED ON DRIVEWAYS UNLESS OTHERWISE SPECIFIED IN THE PLANS OR BY THE ENGINEER.
- THE TRAFFIC CONTROL AND PROTECTION FOR SIDE ROADS, INTERSECTIONS, AND DRIVEWAYS SHALL BE INCLUDED IN THE COST OF SPECIFIED TRAFFIC CONTROL STANDARDS OR ITEMS.

All dimensions are in inches (millimeters) unless otherwise shown.

USER NAME = footemj	DESIGNED - L.H.A.	REVISED - A. HOUSEH 10-15-96	<b>STATE OF ILLINOIS DEPARTMENT OF TRANSPORTATION</b>	<b>TRAFFIC CONTROL AND PROTECTION FOR SIDE ROADS, INTERSECTIONS, AND DRIVEWAYS</b>			F.A.U. RTE.	SECTION	COUNTY	TOTAL SHEETS	SHEET NO.
PLOT SCALE = 50.0000" / in.	CHECKED -	REVISED - T. RAMMACHER 01-06-00		SCALE: NONE	SHEET 1	OF 1 SHEETS	2637	19-00114-00-RS	DuPAGE	32	25
PLOT DATE = 3/4/2019	DATE - 06-89	REVISED - A. SCHUETZE 07-01-13					<b>TC-10</b>		CONTRACT NO. 61H39		
		REVISED - A. SCHUETZE 09-15-16					ILLINOIS FED AID PROJECT				

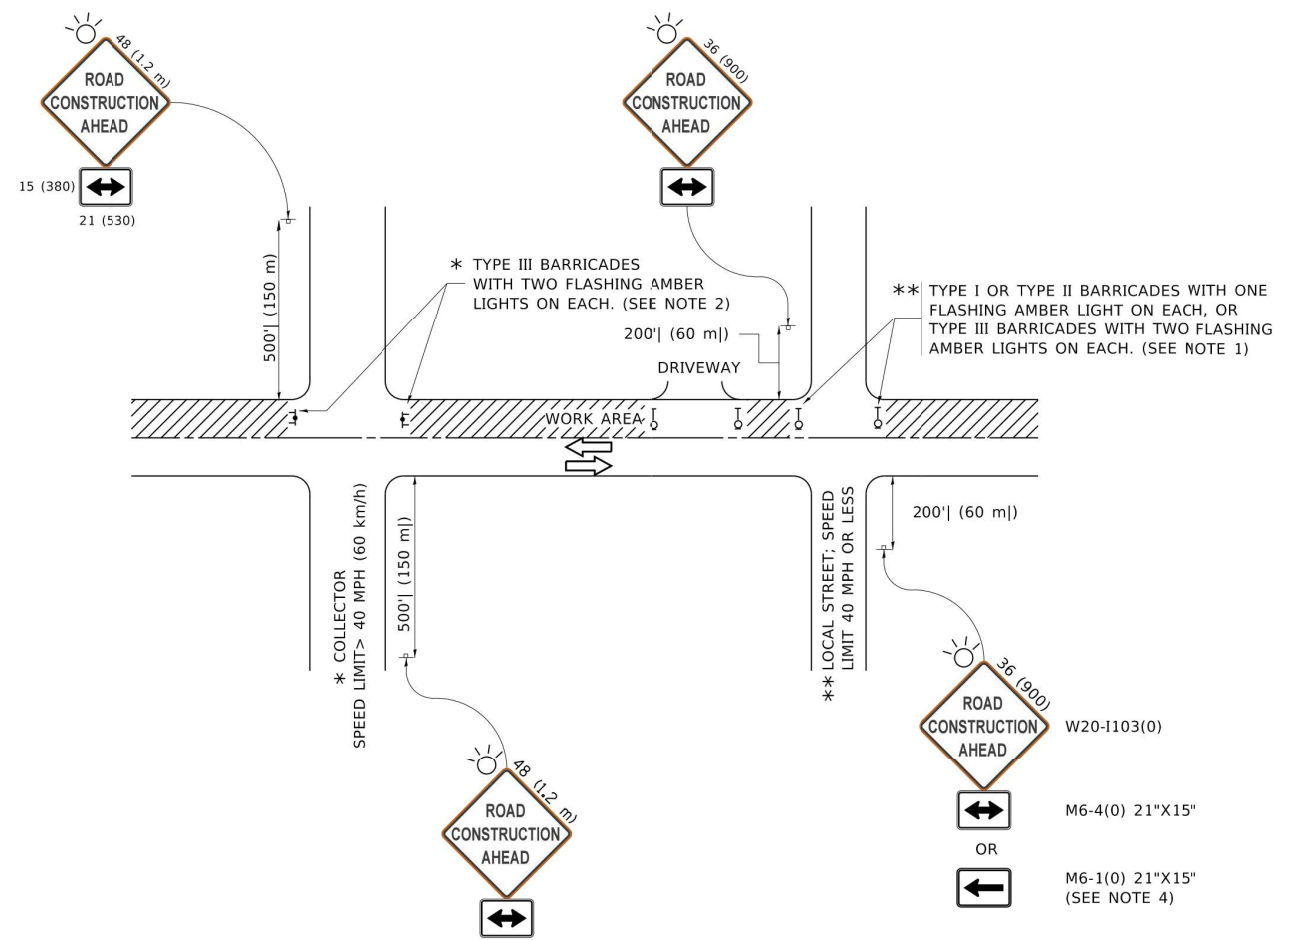


## TURN BAY ENTRANCE AT START OF LANE CLOSURE TAPER

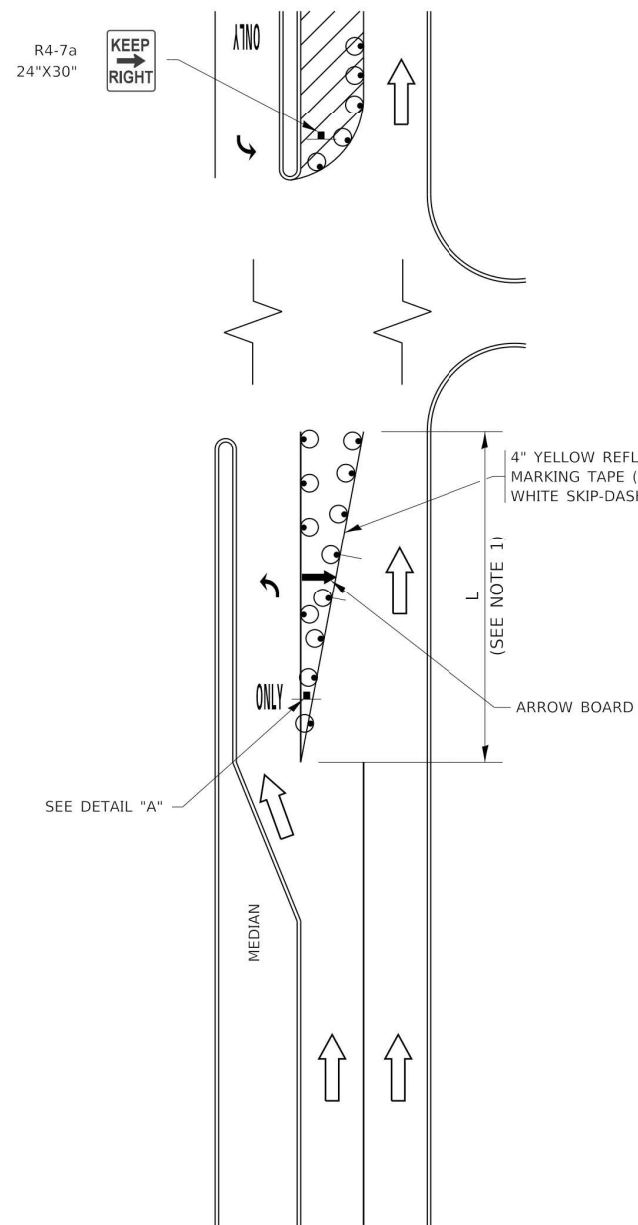

**FIGURE 1**

## TURN BAY ENTRANCE WITHIN A LANE CLOSURE

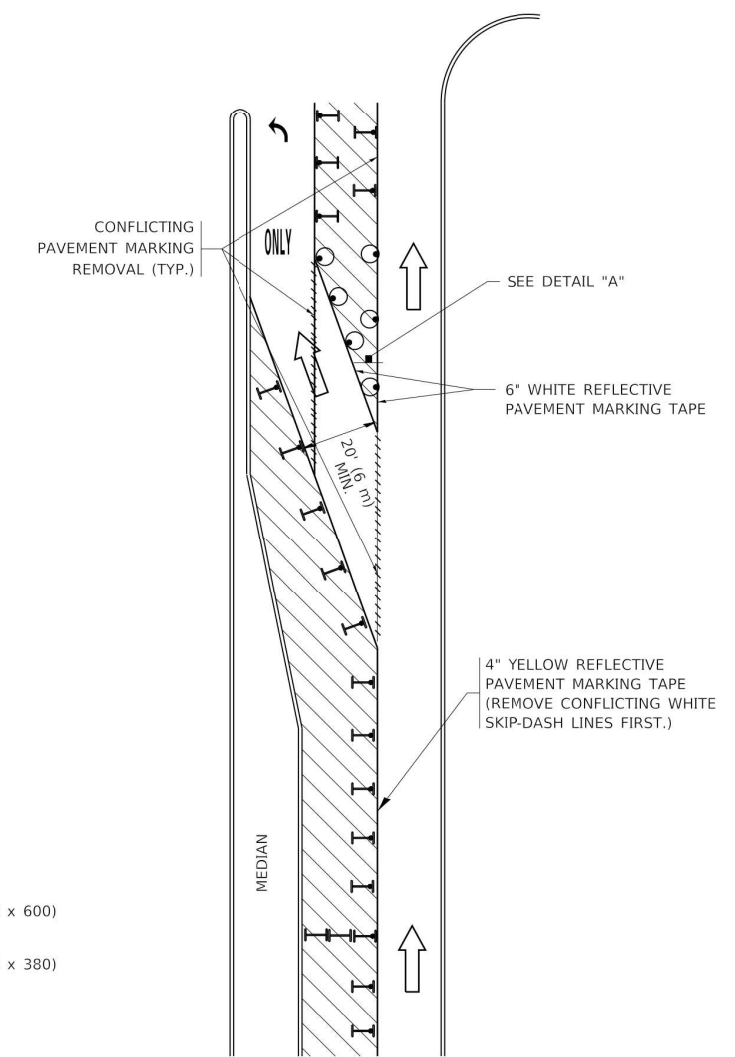


**FIGURE 2**

### LEGEND

- WORK AREA
- LANE OPEN TO TRAFFIC
- ARROW BOARD
- TYPE I OR II BARRICADE OR DRUM WITH STEADY BURN LIGHT
- DRUM WITH STEADY BURN LIGHT
- SIGN ASSEMBLY
- TYPE I OR II CHECK BARRICADE WITH FLASHING LIGHT

### NOTES:

1. A) WHEN "L" IS  $\leq$  THE STORAGE LENGTH OF THE TURN LANE (AS SHOWN IN FIG. 1), USE FIGURE 1.  
B) WHEN "L" IS  $>$  THE STORAGE LENGTH OF THE TURN LANE OR THE TURN LANE IS WITHIN THE LANE CLOSURE, USE FIGURE 2.
2. CONES MAY BE SUBSTITUTED FOR BARRICADES OR DRUMS AT HALF THE SPACING DURING DAY OPERATIONS. CONES SHALL BE A MINIMUM OF 28 (710) IN HEIGHT.
3. LIGHTS WILL NOT BE REQUIRED ON BARRICADES OR DRUMS FOR DAY OPERATIONS. ALL LIGHTS SHALL BE MONODIRECTIONAL.
4. REFLECTIVE TEMPORARY PAVEMENT MARKINGS SHALL BE PLACED THROUGHOUT THE BARRICADED AREAS OF EACH TURN BAY AS SHOWN WHERE THE CLOSURE TIME IS GREATER THAN FOURTEEN (14) DAYS.
5. THIS APPLICATION ALSO APPLIES WHEN WORK IS BEING PERFORMED IN THE RIGHT LANE(S) AND THE RIGHT TURN BAY IS TO REMAIN OPEN. UNDER THIS CONDITION, "RIGHT TURN LANE" R3-1100R 24 x 24 (600 x 600) AND M6-2R 21 x 15 (530 x 330) SHALL BE USED.
6. THESE CONTROLS SHALL SUPPLEMENT MAINLINE TRAFFIC CONTROL FOR LANE CLOSURES.
7. THE SIGNS SHALL BE MOUNTED ABOVE THE BARRICADES/DRUMS ON SEPARATE SIGN SUPPORTS THAT MEET NCHRP 350 OR MASH REQUIREMENTS.
8. TRAFFIC CONTROL AND PROTECTION AT TURN BAYS (TO REMAIN OPEN TO TRAFFIC) SHALL BE INCLUDED IN THE COST OF SPECIFIED TRAFFIC CONTROL STANDARDS OR ITEMS.

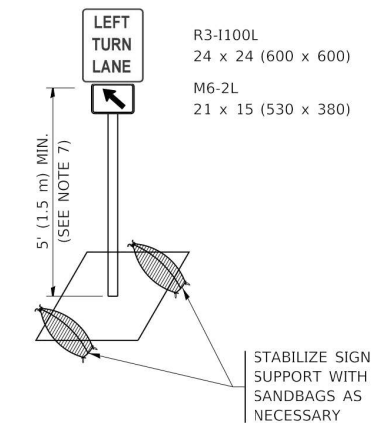

**DETAIL A**

All dimensions are in inches (millimeters) unless otherwise shown.

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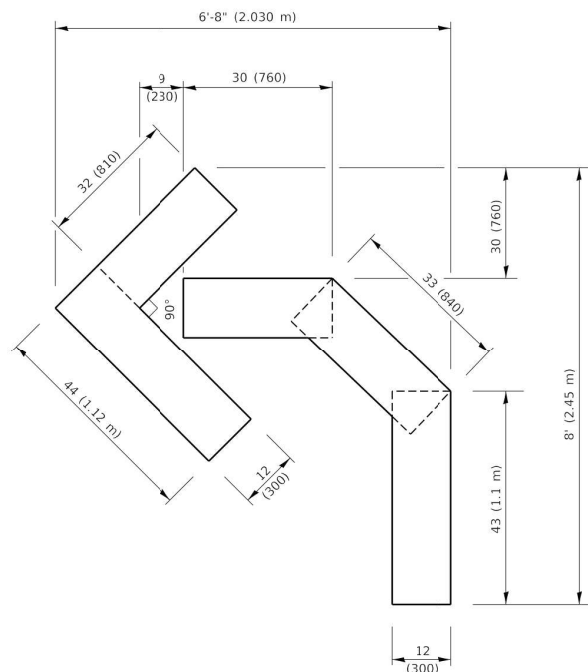
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PLOT SCALE = 50.0000' / in.	CHECKED - A. HOUSEH 10-12-96	REVISED - A. SCHUETZE 09-15-16
PLOT DATE = 3/4/2019	DATE - T. RAMMACHER 01-06-00	REVISED -

**STATE OF ILLINOIS  
DEPARTMENT OF TRANSPORTATION**


**TRAFFIC CONTROL AND PROTECTION AT TURN BAYS  
(TO REMAIN OPEN TO TRAFFIC)**

SCALE: NONE SHEET 1 OF 1 SHEETS STA. TO STA.


F.A.U. RTE. 2637	SECTION 19-00114-00-RS	COUNTY DuPAGE	TOTAL SHEETS 32	SHEET NO. 27
TC-14		CONTRACT NO. 61H39		
ILLINOIS FED. AID PROJECT				



**QUANTITY**  
 4 (100) LINE = 45.5 ft. (13.9 m)  
 15.2 sq. ft. (1.41 sq. m)

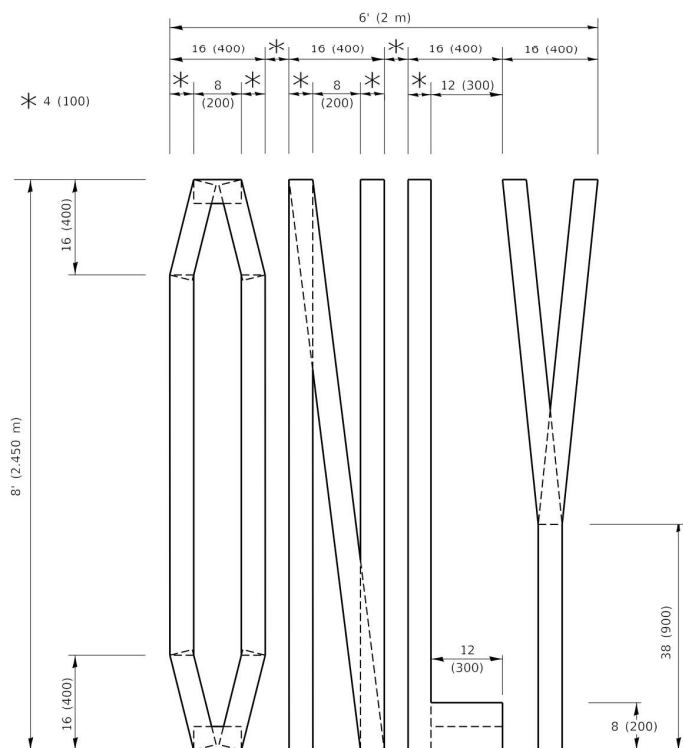


**QUANTITY**  
 4 (100) LINE = 64.1 ft. (19.5 m)  
 21.4 sq. ft. (1.99 sq. m)

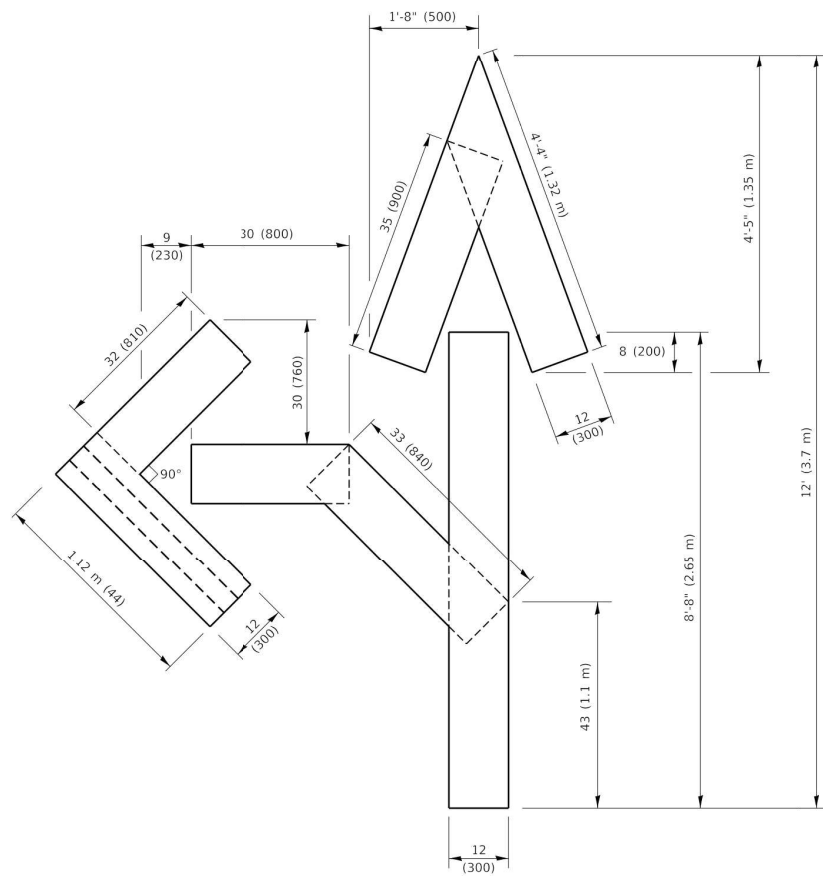

**QUANTITY**  
 4 (100) LINE = 82.5 ft. (25.1 m)  
 27.5 sq. ft. (2.53 sq. m)

**NOTE:**  
 ALL QUANTITIES OF PLACEMENT ARE REPRESENTED IN LINEAR FEET OF 4" LINES TO MATCH THE 4" TEMPORARY TAPE PAY ITEM AND REPRESENTS THE TOTAL QUANTITY OF 4" TAPE REQUIRED.

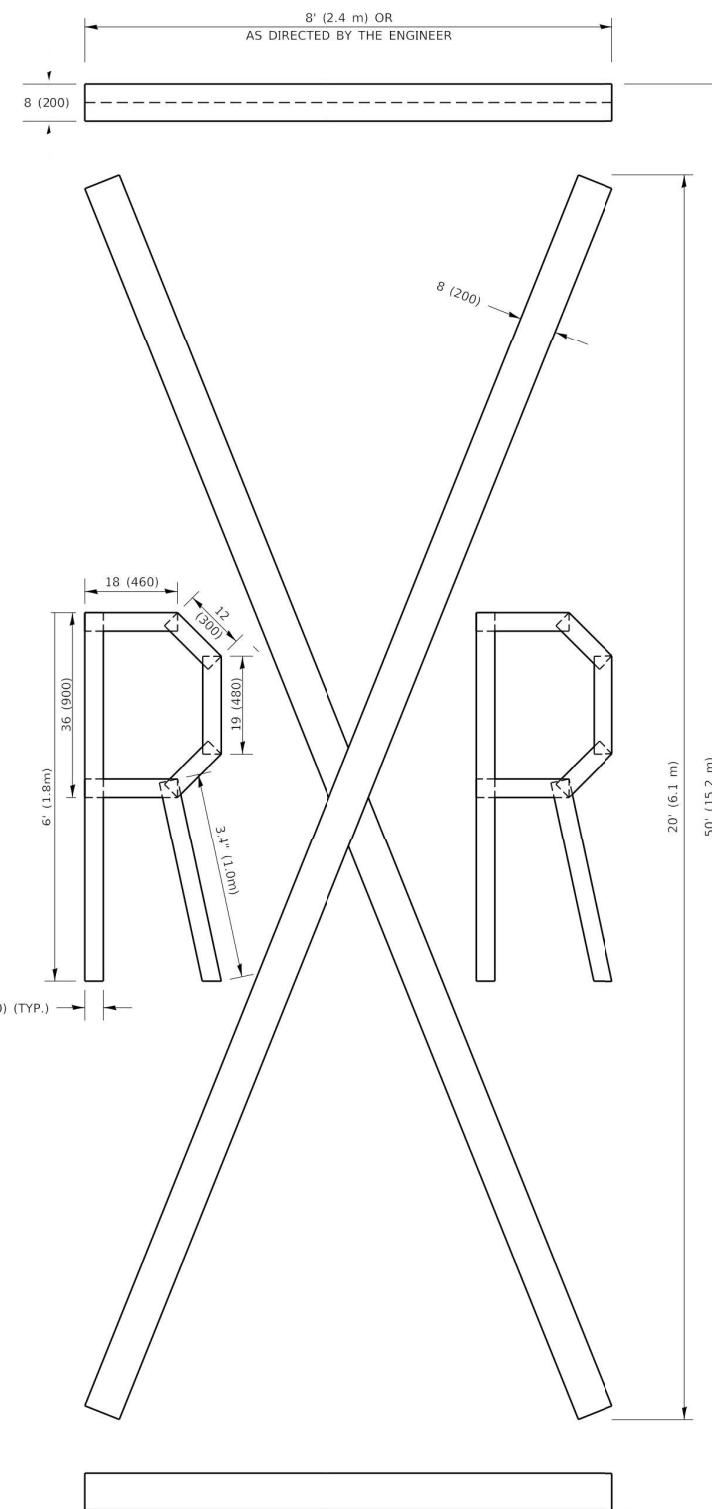

**QUANTITY**  
 4 (100) LINE = 225.9 ft. (68.9 m)  
 75.3 sq. ft. (6.99 sq. m)

All dimensions are in inches (millimeters) unless otherwise shown.

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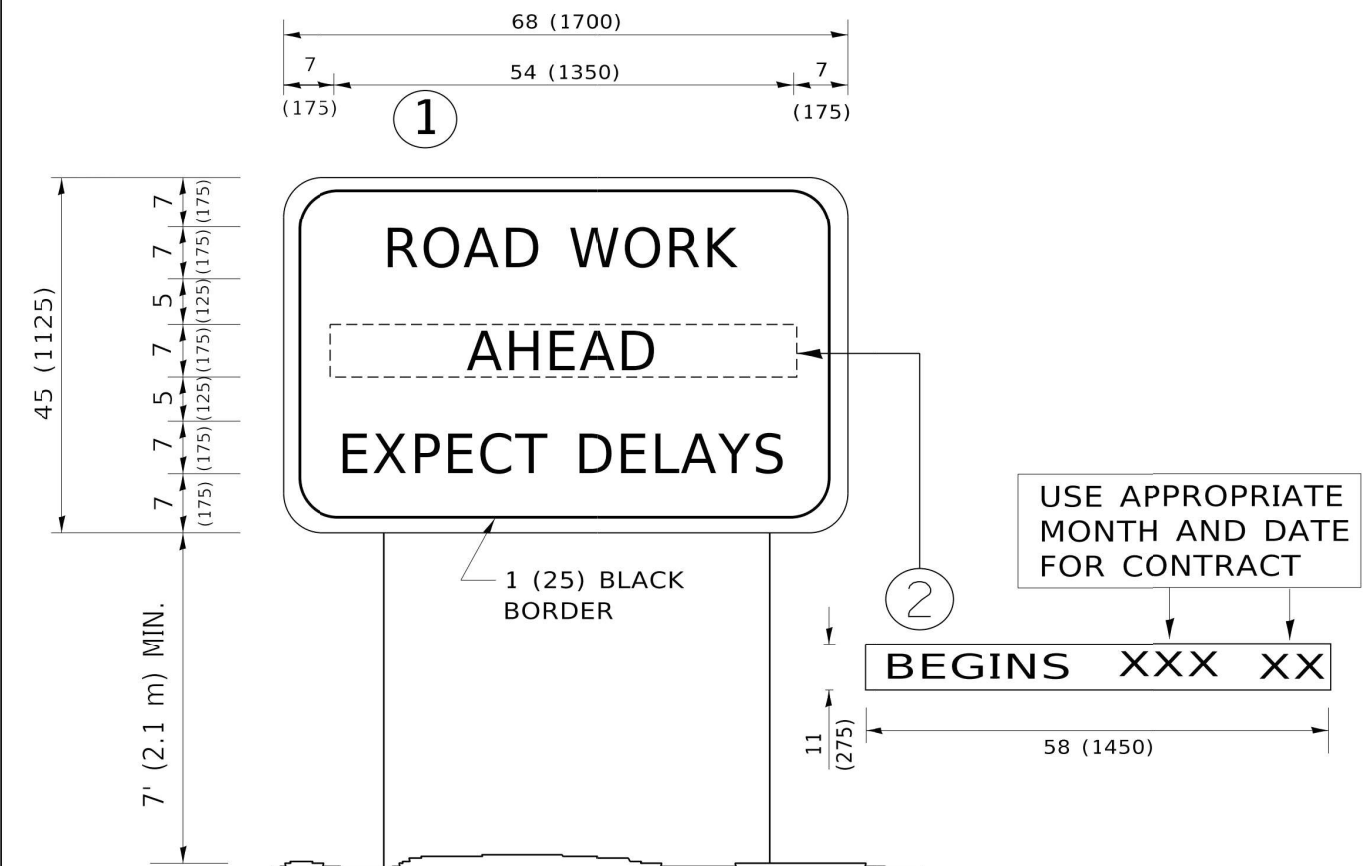
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	DRAWN -	REVISED - E. GOMEZ 08-28-00
PLOT SCALE = 50.0068' / in.	CHECKED -	REVISED - E. GOMEZ 08-28-00
PLOT DATE = 3/4/2019	DATE - 09-18-94	REVISED - A. SCHUETZE 09-15-16

**STATE OF ILLINOIS  
 DEPARTMENT OF TRANSPORTATION**

**SHORT TERM PAVEMENT MARKING LETTERS AND SYMBOLS**

SCALE: NONE SHEET 1 OF 1 SHEETS STA. TO STA.

F.A.U. RTE. 2637	SECTION 19-00114-00-RS	COUNTY DuPAGE	TOTAL SHEETS 32	SHEET NO. 28
TC-16		CONTRACT NO. 61H39		
ILLINOIS FED. AID PROJECT				



**NOTES:**

1. USE BLACK LETTERING ON ORANGE BACKGROUND.
2. ERECT SIGNS IN ADVANCE OF THE LOCATION FOR THE "ROAD CONSTRUCTION AHEAD" SIGN AT LOCATIONS AS DIRECTED BY THE ENGINEER.
3. ERECT SIGN ① WITH INSTALLED PANEL ② ONE WEEK PRIOR TO THE START OF CONSTRUCTION.
4. REMOVE PANEL ② SOON AFTER THE START OF CONSTRUCTION.
5. SEE SPECIAL PROVISION FOR "TEMPORARY INFORMATION SIGNING" FOR ADDITIONAL INFORMATION.
6. ONE SIGN ASSEMBLY EQUALS 25.70 SQ. FT. (2.3 SQ. M.)
7. SHALL BE PAID FOR AS TEMPORARY INFORMATION SIGNING.

ALL DIMENSIONS ARE IN INCHES (MILLIMETERS) UNLESS OTHERWISE SHOWN.


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USER NAME = footemj	DESIGNED -	REVISED - R. MIRS 09-15-97
	DRAWN -	REVISED - R. MIRS 12-11-97
PLOT SCALE = 50.0000" / in.	CHECKED -	REVISED - T. RAMMACHER 02-02-99
PLOT DATE = 3/4/2019	DATE -	REVISED - C. JUCIUS 01-31-07

**STATE OF ILLINOIS**  
**DEPARTMENT OF TRANSPORTATION**

<b>ARTERIAL ROAD INFORMATION SIGN</b>			
SCALE: NONE	SHEET 1	OF 1 SHEETS	STA. TO STA.

F.A.U. RTE. 2637	SECTION 19-00114-00-RS	COUNTY DuPAGE	TOTAL SHEETS 32	SHEET NO. 29
<b>TC-22</b>		CONTRACT NO. 61H39		
ILLINOIS FED. AID PROJECT				

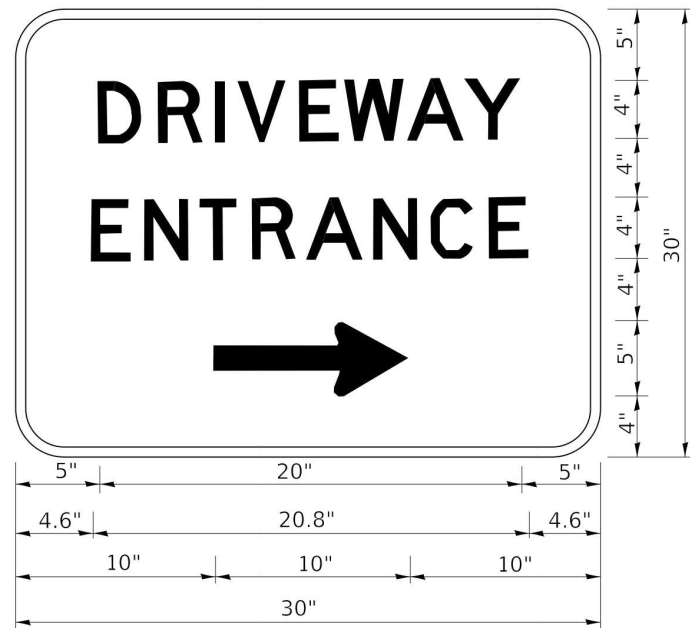

3.0" RADIUS, 0.5" BORDER, WHITE ON GREEN; REFLECTORIZED  
 "DRIVEWAY" D; "ENTRANCE" D; STANDARD ARROW CUSTOM 12.0" x 5.0"

NOTES:

1. HALF OF THE SIGNS WILL REQUIRE A LEFT HAND FACING ARROW.
2. TWO SIGNS SHALL BE USED AT EACH COMMERCIAL ENTRANCE PLACED BACK-TO-BACK: ONE WITH A RIGHT HAND ARROW (SHOWN) SHALL BE PLACED ON THE NEAR RIGHT SIDE THE DRIVEWAY AND ONE WITH A LEFT HAND ARROW SHALL BE PLACED ON THE FAR LEFT SIDE OF THE DRIVEWAY.
3. SIGNS TO BE PAID FOR AS ITEM "TEMPORARY INFORMATION SIGNING".

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 I:\projects\19-00114-00-RS\19-00114-00-RS-01\19-00114-00-RS-01.dwg

USER NAME = leysa	DESIGNED -	REVISED - C. JUCIUS 02-15-07
	DRAWN -	REVISED -
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PLOT DATE = 8/6/2021	DATE -	REVISED -

**STATE OF ILLINOIS  
 DEPARTMENT OF TRANSPORTATION**


**DRIVEWAY ENTRANCE SIGNING**

SCALE: NONE SHEET 1 OF 1 SHEETS STA. TO STA.

F.A.U. RTE. 2637	SECTION 19-00114-00-RS	COUNTY DuPAGE	TOTAL SHEETS 32	SHEET NO. 30
<b>TC-26</b>		CONTRACT NO. 61H39		
ILLINOIS FED. AID PROJECT				


**LOOP DETECTOR NOTES**

1. EACH PAIR OF LOOP WIRES SHALL BE PLACED IN A SEPARATE EMPTY COILABLE NONMETALLIC CONDUIT FROM THE EDGE OF PAVEMENT TO THE HANDHOLE. SPACING BETWEEN THE HOLES DRILLED IN THE PAVEMENT SHALL NOT BE LESS THAN 6" (150 mm). EMPTY COILABLE NONMETALLIC CONDUIT SHALL BE INCLUDED IN THE COST OF THE LOOP WIRE.
2. THE NUMBER OF LOOP TURNS SHALL BE AS RECOMMENDED BY THE AMPLIFIER MANUFACTURER. ALL ADJACENT SIDES OF THE LOOPS SHALL BE INSTALLED IN SUCH A WAY THAT THE CURRENT FLOW IS IN THE SAME DIRECTION TO REINFORCE ITS MAGNETIC FIELDS FOR SMALL VEHICLE DETECTION.
3. EACH LOOP LEAD-IN SHALL BE IDENTIFIED AND PERMANENTLY TAGGED IN THE HANDHOLE. EACH LEAD-IN CABLE TAG SHALL INDICATE THE LOCATION OF THE LOOP, LOOP ROTATION (CLOCKWISE/COUNTERCLOCKWISE), LOOP LEAD-IN DIRECTION (IN OR OUT), LOOP CABLE NUMBER AND LOCATION IN CABINET, AND NUMBER OF TURNS IN THE DETECTOR LOOPS IN WATER PROOF INK AS INDICATED ON THE DISTRICT 1 STANDARD TRAFFIC SIGNAL DESIGN DETAIL. THE CONTRACTOR SHALL MARK LOOP LOCATIONS ON RECORD DRAWINGS AND PRESENT TO THE ENGINEER AFTER FINAL INSPECTION. LOOPS SHALL BE MARKED BY LANE AND LOOP NUMBER. SEE DETAIL BELOW.
4. ALL LOOP CABLE SHALL BE FASTENED WITH PLASTIC TIE WRAP TO THE HANDHOLE HOOKS.
5. IN ASPHALT PAVEMENT, LOOPS SHOULD BE PLACED IN THE BINDER AND DIVEHOLES MARKED AT THE CURB WITH A SAW-CUT. THE SAW-CUT SHALL BE CUT IN ACCORDANCE WITH LOCAL AND E.P.A. DUST CONTROL REQUIREMENTS. DETECTOR LOOP(S) SHALL NOT BE INSTALLED IN WET CONDITIONS AND THE SAW-CUTS MUST BE FREE OF DEBRIS AND RESIDUE SUCH AS DUST AND WATER WHICH IS TO BE ACHIEVED BY THE USE OF COMPRESSED AIR, WIRE BRUSHING AND HEAT DRYING ACCORDING TO SEALANT MANUFACTURER REQUIREMENTS. THE DETECTOR WIRE SHALL BE HELD IN PLACE BY THE USE OF FORM WEDGES. WEDGES SHALL BE SPACED NO MORE THAN 18" (450 mm) APART.
6. LOOP SPLICES SHALL BE SOLDERED USING A SOLDERING IRON. BLOW TORCHES OR OTHER DEVICES WHICH OXIDIZE COPPER CABLE SHALL NOT BE ALLOWED FOR SOLDERING OPERATIONS. SEE DETAIL BELOW RIGHT.
7. PREFORMED DETECTOR LOOPS SHALL BE USED, AS SHOWN ON THE PLANS, WHERE NEW CONCRETE PAVEMENT IS PROPOSED. THE INSTALLATION OF PREFORMED LOOPS SHALL BE IN ACCORDANCE WITH THE DISTRICT 1 SPECIFICATIONS OR AS DIRECTED BY THE ENGINEER.

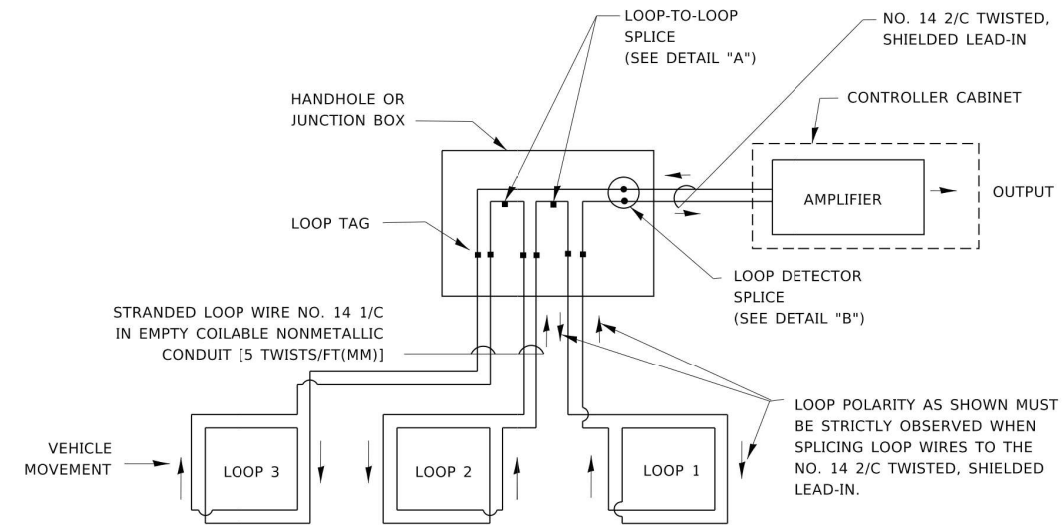


**DETECTOR LOOP WIRING SCHEMATIC**

- LOOPS SHALL BE SPLICED IN SERIES. SAW-CUTS SHALL BE A MINIMUM WIDTH OF 5/16" (8 mm).
- SAW-CUT DEPTHS SHALL BE 3" (75 mm). IF IN CONCRETE,
- THE SAW-CUT DEPTH SHALL BE TO THE TOP OF THE REINFORCEMENT.
- LOOP CORNERS SHALL BE DRILLED WITH A 2" (50 mm) DIAMETER CORE.

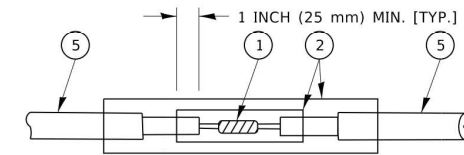


DETAIL "A"  
LOOP-TO-LOOP SPLICE

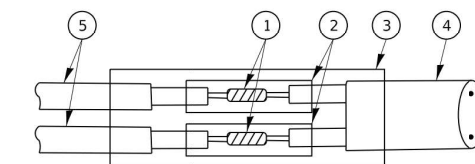


DETAIL "B"  
LOOP-TO-CONTROLLER SPLICE

**TYPE I LOOP**

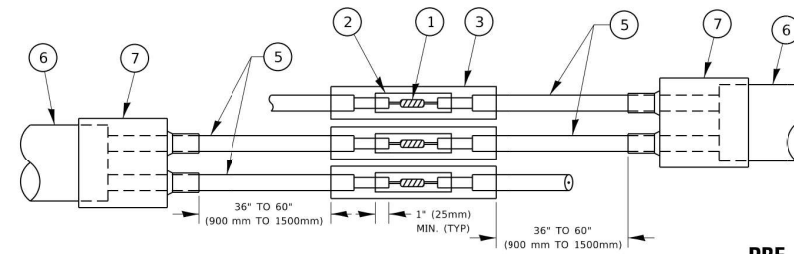

DETAIL "A"  
LOOP-TO-LOOP SPLICE

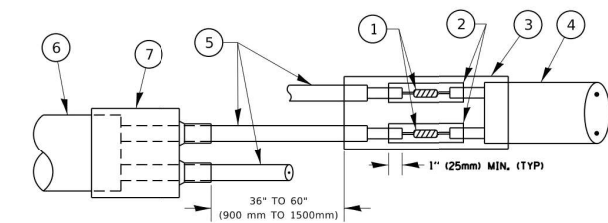


DETAIL "B"  
LOOP-TO-CONTROLLER SPLICE

**PRE-FORMED LOOP**

**LOOP DETECTOR SPLICE**

- ① WESTERN UNION SPLICE SOLDERED WITH ROSIN CORE FLUX. ALL EXPOSED SURFACES OF THE SOLDER SHALL BE SMOOTH. THE WESTERN UNION SPLICES SHALL BE STAGGERED.
- ② WCSMW 30/100 HEAT SHRINK TUBE, MINIMUM LENGTH 3" (75 mm), UNDERWATER GRADE.
- ③ WCS 200/750 HEAT SHRINK TUBE, MINIMUM LENGTH 6" (150 mm), UNDERWATER GRADE.
- ④ NO. 14 2/C TWISTED, SHIELDED CABLE.
- ⑤ LOOP CONDUCTOR WITH FLEXIBLE PLASTIC TUBE. PRE-FORMED LOOP
- ⑥ XL POLYOLEFIN 2 CONDUCTOR
- ⑦ BREAKOUT SEALS. TYCO CBR-2 OR APPROVED EQUAL

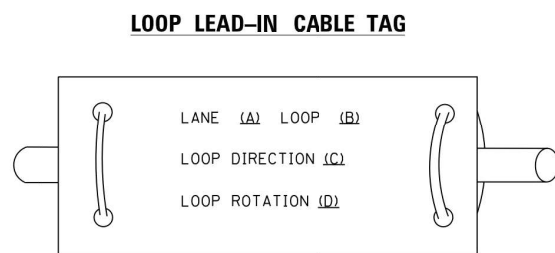

- A. LANE 1 IS THE LANE CLOSEST TO THE CENTERLINE OF THE ROADWAY
- B. LOOP #1 IS THE LOOP IN THE LANE CLOSEST TO THE INTERSECTION.
- C. LABEL LOOP CABLE "IN" OR LOOP CABLE "OUT".
- D. LABEL LOOP CABLE CLOCKWISE OR LOOP CABLE COUNTERCLOCKWISE.

MODEL: Default  
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USER NAME = footemj	DESIGNED -	REVISED -
	DRAWN -	REVISED -
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**STATE OF ILLINOIS  
DEPARTMENT OF TRANSPORTATION**


**DISTRICT ONE  
STANDARD TRAFFIC SIGNAL DESIGN DETAILS**

SCALE: NONE SHEET 1 OF 1 SHEETS STA. TO STA.

F.A.U. RTE. 2637	SECTION 19-00114-00-RS	COUNTY DuPAGE	TOTAL SHEETS 32	SHEET NO. 31
TS-05		CONTRACT NO. 61H39		
ILLINOIS FED. AID PROJECT				

**LOOPS NEXT TO SHOULDERS**

PROVIDE A PAVEMENT REPLACEMENT  
NOTE WHICH SHOULD EQUAL  
3' (900 mm) X WIDTH OF  
PAVED SHOULDER.

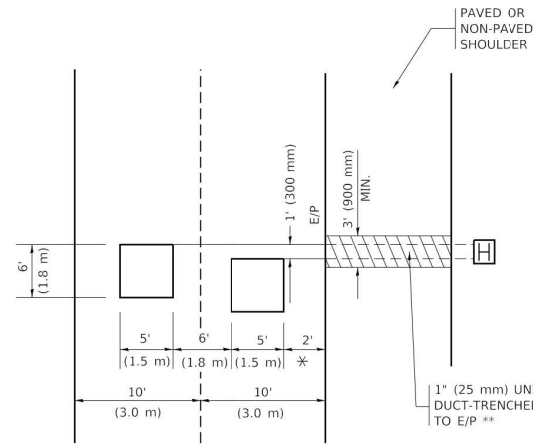


\* = (600 mm)

\*\* UNIT DUCT IS TO BE SHOWN ON PLAN SHEETS  
BUT SHALL NOT BE INCLUDED IN THE PAY ITEMS.

**LEFT TURN LANES WITH MEDIANS**  
VOLUME DENSITY ("FAR OUT" DETECTION)  
ON SAME APPROACH  
(PROTECTED / PERMITTED LEFT TURN PHASING)


HANDHOLE LOCATION MAY  
VARY DEPENDING ON GEOMETRICS  
AND DESIGN OF TRAFFIC SIGNALS.  
HEAVY-DUTY HANDHOLES TO BE  
USED WHEN THE MEDIAN IS  
MOUNTABLE. REFER TO STANDARD  
814001 TO ENSURE THAT HANDHOLE  
FITS IN MEDIAN.

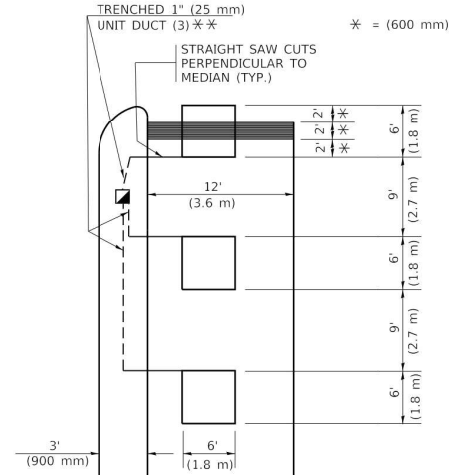

\*\* UNIT DUCT IS TO BE SHOWN ON PLAN SHEETS  
BUT SHALL NOT BE INCLUDED IN THE PAY ITEMS.


NOTE: DUAL LEFT TURNS NOT SHOWN REFER TO  
PLAN SHEET FOR DETECTOR LOOP REPLACEMENT

**LEFT TURN LANES WITHOUT MEDIANS**  
VOLUME DENSITY ("FAR OUT" DETECTION)  
ON SAME APPROACH  
(PROTECTED / PERMITTED LEFT TURN PHASING)

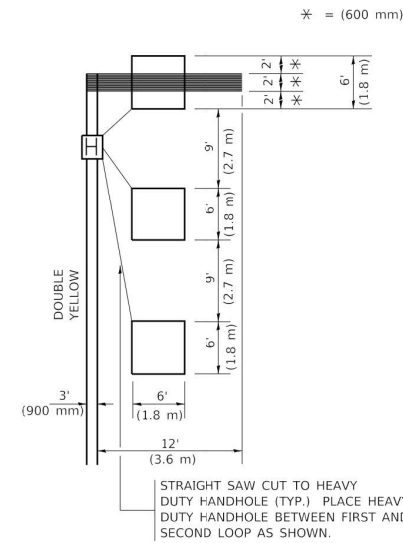


NOTE: DUAL LEFT TURNS NOT SHOWN REFER TO  
PLAN SHEET FOR DETECTOR LOOP REPLACEMENT

**ARTERIAL-VOLUME DENSITY ("FAR OUT" DETECTION)**  
**CROSS STREET-NON VOLUME DENSITY ("FAR OUT" DETECTION)**

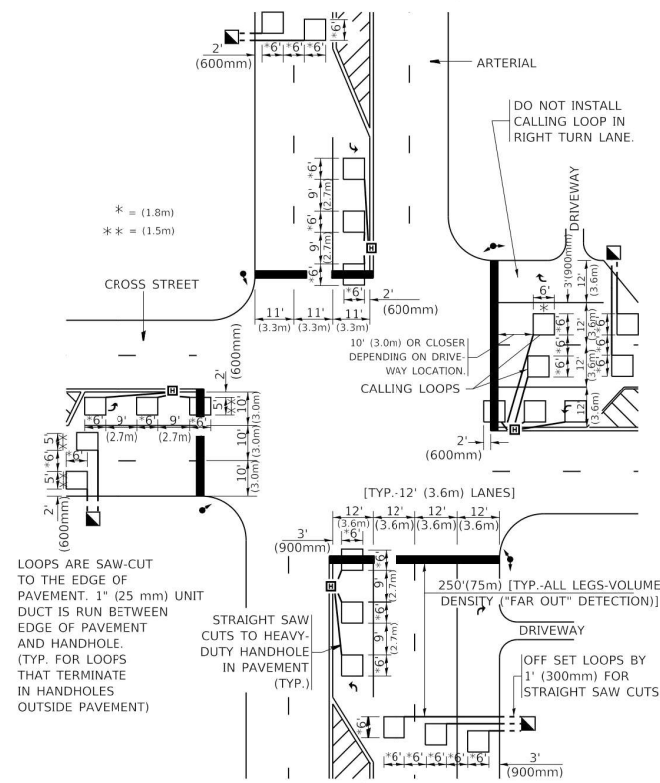

**DETAIL 1**  
N.T.S.

**ARTERIAL-VOLUME DENSITY ("FAR OUT" DETECTION)**  
**CROSS STREET-NON VOLUME DENSITY ("UPTIGHT" PRESENCE DETECTION)**

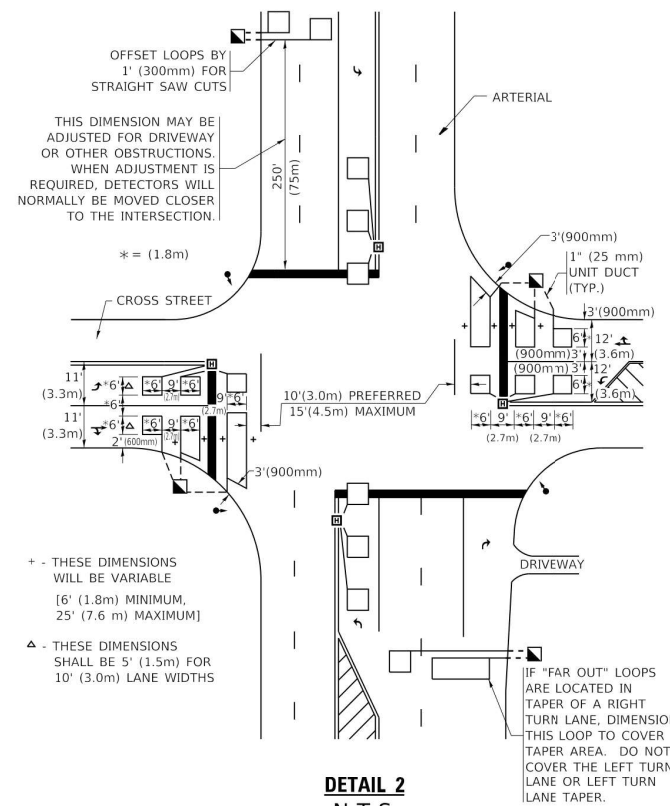

**DETAIL 2**  
N.T.S.

**NOTES:**

**VEHICLES LOOP DETECTORS**

- \* ALL LEAD IN CABLE SHALL BE TWO CONDUCTOR NO. 14 TWISTED, SHIELDED.
- \* EACH DETECTOR LOOP SHALL HAVE ITS OWN SAW CUT FROM THE LOOP TO THE EDGE OF PAVEMENT OR TO A HANDHOLE IN THE PAVEMENT.
- \* EACH DETECTOR LOOP SHALL HAVE ITS OWN ONE INCH (25 mm) UNIT DUCT BETWEEN THE EDGE OF PAVEMENT AND THE FIRST HANDHOLE OR JUNCTION BOX. EACH UNIT DUCT RUN SHALL BE SHOWN ON THE PLANS BY THE DESIGNER, BUT SHALL NOT BE PAID FOR SEPARATELY. THIS ITEM IS INCIDENTAL TO THE PAY ITEM FOR DETECTOR LOOPS.
- \* ONE DIMENSION OF ALL DETECTOR LOOPS SHALL BE SIX FEET (1.8 m)
- \* EACH LANE OF NON-LOCKING, PRESENCE DETECTION AND EACH LANE OF A DOUBLE LEFT TURN LANE REQUIRES A SEPARATE INDUCTIVE LOOP DETECTOR AND LEAD IN CABLE.
- \* WHEN NON-LOCKING, PRESENCE DETECTION IS USED, MORE THAN ONE LOOP PER LANE IS REQUIRED BEHIND THE STOP BAR (i.e. 1-1/2, 1-3/4, 2).
- \* WHEN SYSTEM LOOPS ARE REQUIRED ON AN APPROACH OF AN INTERSECTION, THE LOOPS USED FOR VOLUME DENSITY AND INTERSECTION TIMING SHALL ALSO BE USED AS SYSTEM DETECTORS. EACH ONE OF THESE TYPE OF LOOPS REQUIRES A SEPARATE TWO CONDUCTOR NO. 14 TWISTED SHIELDED CABLE AND A SEPARATE INDUCTIVE LOOP DETECTOR WHEN NEW CONTROLLERS ARE UTILIZED. THE DESIGNER SHALL LABEL THESE TYPES OF LOOPS AS "INTERSECTION AND SAMPLING (SYSTEM) DETECTORS" ON THE SIGNAL LAYOUT, THE INTERCONNECT PLAN AND THE SYSTEM CABLE PLAN. WHEN AN EXISTING CONTROLLER IS UTILIZED FOR THIS TYPE OF DETECTION, THE PAY ITEM "INDUCTIVE LOOP DETECTOR WITH SYSTEM OUTPUT" SHOULD BE USED.

**PLACEMENT OF DETECTORS**

THE FOLLOWING FIGURES REPRESENT THE MOST COMMON DETECTOR LOOP LOCATIONS AND SIZES. ADJUSTMENTS WILL BE NECESSARY FOR SPECIFIC GEOMETRIC CONSIDERATIONS.

LOCATIONS AND DIMENSIONS OF DETECTOR LOOPS ARE REQUIRED ON ALL SIGNAL LAYOUT PLAN SHEETS.

"FAR OUT" DETECTION REFERS TO LOCKING, PRESENCE TYPE DETECTION LOCATED IN THRU LANES, RIGHT TURN LANES, AND RIGHT TURN LANE TAPER AREAS (IF APPLICABLE), USUALLY 250' (75 m) IN ADVANCE OF STOP BARS. "UPTIGHT" DETECTION REFERS TO NON-LOCKING PRESENCE TYPE DETECTION LOCATED IN ALL LANES AND 10'-15' (3.0 m-4.5 m) BEHIND THE CROSSING STREET'S EDGE OF PAVEMENT EXTENDED.

**NOTE:**

ALL DETAILS AND NOTES SHOWN ARE FROM THE I.D.O.T. DISTRICT 1 TRAFFIC SIGNAL DESIGN GUIDELINES DATED JANUARY 1995

THIS DRAWING HAS BEEN PREPARED TO ASSIST THE RESIDENT ENGINEER FOR ALL ROADWAY RESURFACING OR S.M.A.R.T. PROJECTS WHERE THE DIMENSIONS ARE NOT SHOWN ON THE PLANS AND THE FINAL LOCATIONS FOR CROSSWALKS OR STOP BARS ARE NOT DETERMINED.

MODEL: Default  
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PLOT SCALE	= 50.0000 ' / in.	DRAWN	-	REVISED	-
PLOT DATE	= 3/4/2019	CHECKED	= R.K.F.	REVISED	-
		DATE	-	REVISED	-

**STATE OF ILLINOIS**  
**DEPARTMENT OF TRANSPORTATION**

**DISTRICT 1 - DETECTOR LOOP INSTALLATION**  
**DETAILS FOR ROADWAY RESURFACING**

SCALE: NONE SHEET 1 OF 1 SHEETS STA. TO STA.

F.A.U. RTE.	SECTION	COUNTY	TOTAL SHEETS	SHEET NO.
2637	19-00114-00-RS	DuPAGE	32	32
	<b>TS-07</b>	CONTRACT NO.	61H39	
ILLINOIS FED. AID PROJECT				