FOR INDEX OF SHEETS, SEE SHEET NO. 2

PROJECT LOCATED IN: CITY OF CHICAGO

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STATE OF ILLINOIS **DEPARTMENT OF TRANSPORTATION**

PROPOSED HIGHWAY PLANS

F.A.U ROUTE 2798: CENTRAL AVE KENNEDY MAINTENANCE YARD 5027 N. CENTRAL AVE, CHICAGO

SECTION: 2021–144–1 PARKING LOT IMPROVEMENT


> **COOK COUNTY** C-91-016-22



KENNEDY MAINTENANCE YARD

(5027 N CENTRAL AVE, CHICAGO)

RANGE 13 E

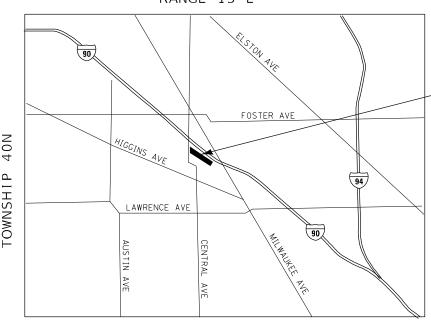

40N TOWNSHIP

> LOCATION MAP NOT TO SCALE

MILLENNIA PROFESSIONAL SERVICES THOMAS V. NGO, P.E. * 062-058379


SIGNATURE AND SEAL APPLIES TO DRWG NO 1 TO 29, 103-110



2798 2021-144-l COOK FED. ROAD DIST. NO. 1 CONTRACT NO. 62P60

D-91-025-22



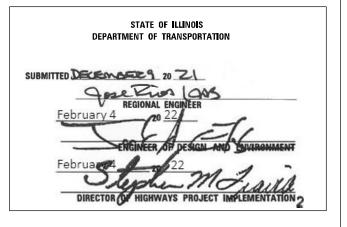



PRINTED BY THE AUTHORITY OF THE STATE OF ILLINOIS

PROJECT ENGINEER: VESELIN VELICHKOV, P.E. (847)705–4432 PROJECT MANAGER: FAWAD AQUEEL, P.E.

CONTRACT NO. 62P60

1-312-744-7000

OR 811

ENGINEERING SCALES. REDUCED SIZED PLANS WILL NOT CONFORM TO STANDARD SCALES. IN MAKING MEASUREMENTS ON REDUCED PLANS, THE ABOVE SCALES MAY BE USED.

JOINT UTILITY LOCATION INFORMATION FOR EXCAVATION

INDEX OF SHEETS

- **COVER SHEET**
- 2 INDEX OF SHEETS, STATE STANDARDS, & GENERAL NOTES
- 3-5 SUMMARY OF QUANTITIES
- TYPICAL SECTION
- EXISTING SITE AND REMOVAL PLAN
- PROPOSED SITE AND PAVEMENT MARKING PLAN
- PROPOSED GRADING AND DRAINAGE PLAN
- SIDEWALK DETAILS 10
- 11 DRIVEWAY DETAILS - DISTANCE BETWEEN R.O.W. AND FACE OF CURB < 15' (4.5m) (BD-01)
- 12 CITY OF CHICAGO DETECTABLE WARNINGS (BD-58)
- 13 TRAFFIC CONTROL AND PROTECTION FOR SIDE ROADS, INTERSECTIONS, AND DRIVEWAYS (TC-10)
- DISTRICT ONE TYPICAL PAVEMENT MARKINGS (TC-13)

LIST OF HIGHWAY STANDARDS

000001-08	STANDARD SYMBOLS, ABBREVIATIONS, AND PATTERNS
604001-05	FRAME AND LIDS TYPE 1
606001-08	CONCRETE CURB TYPE B AND COMBINATION CONCRETE CURB AND GUTTER
701006-05	OFF-RD OPERATIONS, 2L, 2W, 15' (4.5m) TO 24" (600mm) FROM PAVEMENT EDGE
701011-04	OFF-RD MOVING OPERATIONS, 2L, 2W, DAY ONLY
701301 - 04	LANE CLOSURE, 2L, 2W, SHORT TIME OPERATIONS
701501-06	URBAN LANE CLOSURE, 2L, 2W, UNDIVIDED
701801-06	SIDEWALK, CORNER OR CROSSWALK CLOSURE

GENERAL NOTES


- 1. BEFORE STARTING ANY EXCAVATION, THE CONTRACTOR SHALL CALL C.U.A.N. IN CHICAGO FOR FIELD LOCATIONS OF BURIED ELECTRIC, TELEPHONE AND GAS UTILITIES. 48 HOUR NOTIFICATION IS REQUIRED.
- 2. THE CONTRACTOR SHALL COORDINATE CONSTRUCTION ACTIVITIES WITH THE KENNEDY TEAM SECTION TECHNICIAN JEROME BEANE AT 773-725-4733.
- 3. THE CONTRACTOR WILL NOT BE ALLOWED TO SET UP A YARD OR FIELD OFFICE ON STATE PROPERTY WITHOUT WRITTEN PERMISSION FROM THE DEPARTMENT.
- 4. BEFORE BEGINNING ANY WORK, THE CONTRACTOR SHALL RETAIN AND RECORD FOR FUTURE REFERENCES, ALL EXISTING PAVEMENT MARKING LINES AND RAISED REFLECTIVE PAVEMENT MARKERS IN ORDER THAT THESE LOCATIONS CAN BE RE-ESTABLISHED FOR STRIPING. EXACT LOCATIONS OF ALL STRIPING SHALL BE AS DIRECTED BY THE ENGINEER.
- 5. IT SHALL BE THE CONTRACTOR'S RESPONSIBILITY TO VERIFY ALL DIMENSIONS AND CONDITIONS EXISTING IN THE FIELD PRIOR TO CONSTRUCTION AND ORDERING OF MATERIALS.
- 6. THE CONTRACTOR SHALL BE REQUIRED TO PROVIDE ACCESS TO ABUTTING PROPERTY AT ALL TIMES DURING THE CONSTRUCTION OF THIS PROJECT.
- 7. DO NOT SCALE PLANS FOR CONSTRUCTION DIMENSIONS.
- 8. EXISTING BROKEN FRAMES AND LIDS SHALL BE REMOVED AND DISPOSED OF BY THE CONTRACTOR AND SHALL BE REPLACED AS DIRECTED BY THE ENGINEER. REPLACEMENT FRAMES AND LIDS WILL BE PAID FOR ACCORDING TO ARTICLE 109.04 OF THE STANDARD SPECIFICATIONS UNLESS A SEPARATE PAY ITEM HAS BEEN PROVIDED.

COMMITMENTS

NO COMMITMENTS FOR THIS PROJECT



USER NAME = jpham	DESIGNED -	REVISED -	
	DRAWN -	REVISED -	
PLOT SCALE = 2.0000 / in.	CHECKED -	REVISED -	
PLOT DATE = 12/3/2021	DATE -	REVISED -	

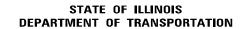

	KENNEDY MAINTENANCE YARD	F.A.U RTE.	SECTION	COUNTY
IND	EX OF SHEETS, STATE STANDARDS, AND GENERAL NOTES	2798	2021-144-I	COOK
IND	EX OF SHEETS, STATE STANDARDS, AND GENERAL NOTES			CONTRA
SCALE: N/A	SHEET NO. 1 OF 1 SHEETS STA. N/A TO STA. N/A	FED. R	ROAD DIST. NO. 1 ILLINOIS FED. A	ID PROJECT

TOTAL SHEET NO.

CONTRACT NO. 62P60

				CONST. TY	PE COD
PAYCODE	ITEM DESCRIPTION	UNIT	TOTAL QUANT I TIES	URBAN	
				100% STATE	
				0005	
20101200	TREE ROOT PRUNING	EACH	2	2	
20200100	EARTH EXCAVATION	CU YD	1130	1130	
211Ø1615	TOPSOIL FURNISH AND PLACE, 4"	SQ YD	142	142	
25200110	SODDING, SALT TOLERANT	SQ YD	142	142	
28000510	INLET FILTERS	EACH	10	10	
31101400	SUBBASE GRANULAR MATERIAL, TYPE B 6"	SO YD	5Ø86	5Ø86	
4Ø6ØØ275	BITUMINOUS MATERIALS (PRIME COAT)	POUND	11443	11443	
40600290	BITUMINOUS MATERIALS (TACK COAT)	POUND	1144	1144	
40603085	HOT-MIX ASPHALT BINDER COURSE, IL-19.0, N70	TON	854	854	
40604062	HOT-MIX ASPHALT SURFACE COURSE, IL-9.5, MIX "D", N70	TON	427	427	
42001300	PROTECTIVE COAT	SQ YD	234	234	
42000300	PORTLAND CEMENT CONCRETE PAVEMENT 8"	SQ YD	84	84	
12000000	TOWNER CENEW CONCRETE TWEETERS C	00 10			
42300400	PORTLAND CEMENT CONCRETE DRIVEWAY PAVEMENT, 8 INCH	SQ YD	418	418	
12300 100	TOWNER CENEW CONCRETE BRIVEWIT THVEHENT, O INCH	33 15	110	110	
42400200	PORTLAND CEMENT CONCRETE SIDEWALK 5 INCH	SQ FT	234	234	
12 100200	TOTALING CENENT CONCRETE SIDEWIER S INCH	33.11	231	231	
44000100	PAVEMENT REMOVAL	SQ YD	5598	5598	
TEPPINE	THE TENT RETOVAL	30 10	33,10		
AAAAAAA	CURB REMOVAL	FOOT	113	110	
44000300	COND NEMOVAL	FUUT	113	113	
44000E00	COMPINATION CURP AND CUTTED DEMOVAL	FOOT	11.4	114	
44000500	COMBINATION CURB AND GUTTER REMOVAL	FOOT SQ FT	114	114	
44000600	SIDEWALK REMOVAL			149	
Z0076604	TRAINEES - TRAINING PROGRAM GRADUATE	HOURS	500	500	

* SPECIALTY ITEM



USER NAME = tngo	DESIGNED -	REVISED -
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				CONST. TYPE CODE	
PAYCOD	ITEM DESCRIPTION	UNIT	TOTAL QUANTITIES	100% STATE	
6025020	CATCH BASINS TO BE ADJUSTED	EACH	3	3	
6030030	FRAMES AND LIDS TO BE ADJUSTED	EACH	3	3	
6040430	FRAMES AND GRATES, TYPE 3	EACH	1	1	
6060060	CONCRETE CURB, TYPE B	FOOT	113	113	
6060500	COMBINATION CONCRETE CURB AND GUTTER, TYPE B-6.24	FOOT	165	165	
6690020	NON-SPECIAL WASTE DISPOSAL	CU YD	1240	1240	
6690053	SOIL DISPOSAL ANALYSIS	EACH	2	2	
669Ø1ØØ	REGULATED SUBSTANCES PRE-CONSTRUCTION PLAN	L SUM	1	1	
669Ø1ØØ	REGULATED SUBSTANCES FINAL CONSTRUCTION REPORT	L SUM	1	1	
669Ø1ØØ	REGULATED SUBSTANCES MONITORING	CAL DA	10	10	
6710010	MOBILIZATION	L SUM	1	1	
7010262	TRAFFIC CONTROL AND PROTECTION, STANDARD 701501	L SUM	1	1	
7010264	TRAFFIC CONTROL AND PROTECTION, STANDARD 701801	L SUM	1	1	
7800020	THERMOPLASTIC PAVEMENT MARKING - LINE 4"	FOOT	853	853	
X424Ø8@	DETECTABLE WARNINGS (SPECIAL)	SQ FT	24	24	
X553760	STORM SEWERS TO BE CLEANED 8"	FOOT	75	75	
	STORM SEWERS TO BE CLEANED 12"	FOOT		90	

* SPECIALTY ITEM

1	MILLENNIA PROFESSIONAL SERVICES	
117	www.millennia.pro	

USER NAME = tngo	DESIGNED -	REVISED -
	DRAWN -	REVISED -
PLOT SCALE = 2.0000 ' / in.	CHECKED -	REVISED -
PLOT DATE = 12/13/2021	DATE -	REVISED -

STATE OF ILLINOIS **DEPARTMENT OF TRANSPORTATION**

KENNEDY MAINTENANCE YARD	
SCHEDULE OF QUANTITIES	

	KENNEDY MAINTENANCE YARD SCHEDULE OF QUANTITIES		F.A.U RTE.	SECTION	COUNTY	TOTAL SHEETS	SHEET NO.		
			2798	2021-144-I	COOK	14	4		
					CONTRACT	NO. 62	2P60		
	SCALE: N/A	SHEET NO. 2 OF .5 SHEETS	STA.	TO STA. ·	FED. RO	DAD DIST. NO. 1 ILLINOIS FED. A	D PROJECT		
П	P:\2019\ME19003.VarVar.PHII\W037.Maintenance Yard Parking Lot\01-CADD\62P60.Kennedy Yard\02-Shts\03-D162P60-sht-S00.dgn								
								REV	-SEP

Yard\02-Shts\03-D162P60-sht-500.dgn	
'ard Parking Lot\01-CADD\62P6B_Kennedy	
NME19003_VarVar_PHIINW037_Maintenance Y	= 2.88888 / Jp.
	LL.

				CONST. TYPE CODE		
PAYCODE	ITEM DESCRIPTION	UNIT	TOTAL QUANTITIES	URBAN 100% STATE		
X67ØØ4Ø7	ENGINEER'S FIELD OFFICE, TYPE A (D1)	CAL MC	6	0005		
X6Ø3Ø2Ø5	FRAMES AND GRATES TO BE ADJUSTED (SPECIAL)	EACH	1	1		
XØ32ØØ5Ø	CONSTRUCTION LAYOUT (SPECIAL)	L SUM	1	1		
ZØØ185ØØ	DRAINAGE STRUCTURES TO BE CLEANED	EACH	11	11		


* SPECIALTY ITEM



USER NAME = jpham	DESIGNED -	REVISED -
	DRAWN -	REVISED -
PLOT SCALE = 2.0000 ' / in.	CHECKED -	REVISED -
PLOT DATE = 12/14/2021	DATE -	REVISED -


KENNEDY MAINTENANCE YARD	F.A.U RTE.	SECTION
SCHEDULE OF QUANTITIES	2798	2021-144-I
SCHEDULE OF QUARTITIES		
ET NO 3 OF F CHEFTS CTA TO CTA		



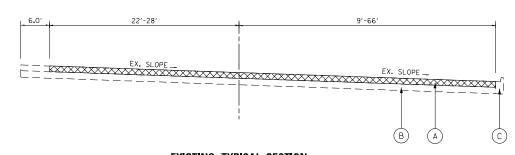

EXISTING TYPICAL SECTION MAINTENANCE YARD

STA. 1+57.7 TO STA. 6+42.5

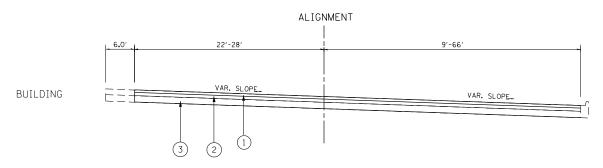

PROPOSED TYPICAL SECTION MAINTENANCE YARD

STA. 1+57.7 TO STA. 6+42.5

EXISTING LEGEND REMOVAL

- A HMA SURFACE REMOVAL 41/2"
- (B) EXISTING SUB-BASE
- C EXISTING CURB AND GUTTER, B.6-24

- 1) HOT-MIX ASPHALT SURFACE COURSE, MIX "D", IL-9.5, N70, 1 1/2"
- 2 HOT-MIX ASPHALT BINDER COURSE, IL-19.0, N70, 3"
- 3) SUBBASE GRANULAR MATERIAL, TYPE B 6"

HOT MIX ASPHALT MIXTURE REQUIREMENTS MIXTURE TYPE PAVEMENT RECONSTRUCTION AIR VOIDS @ Ndes QMP TYPE HOT-MIX ASPHALT SURFACE COURSE, MIX "D", IL-9.5, N70, 1 1/2" 4% @ 70 GYR. QC/QA HOT-MIX ASPHALT BINDER COURSE, IL-19.0, N70, 3" 4% @ 70 GYR. QC/QA

QUALITY CONTROL FOR PERFORMANCE (QCP); PAY FOR PERFORMANCE (PFP) QMP DESIGNATION: QUALITY CONTROL /QUALITY ASSURANCE (QC/QA);

MIXTURE NOTES:

- 1. THE UNIT WEIGHT USED TO CALCULATE ALL HOT-MIX ASPHALT SURFACE MIXTURES IS 112 LBS/SQ YD/IN
- 2. THE "AC TYPE" FOR POLYMERIZED HMA MIXES SHALL BE "SBS/SBR PG 76-22" AND FOR NON-POLYMERIZED HMA THE "AC TYPE" SHALL BE "PG 64-22" UNLESS MODIFIED BY RECLAIMED MATERIALS SPECIFICATIONS.


MILLENNIA

USER NAME = mkochler	DESIGNED - ·	REVISED -
	DRAWN - ·	REVISED -
PLOT SCALE = 20.0000 ' / in.	CHECKED - ·	REVISED -
PLOT DATE = 1/11/2022	DATE - ·	REVISED -

COUNTY SHEETS NO. COOK 14 6

CONTRACT NO. 62P60

POINT NO.	NORTHING	EASTING	ELEVATION
CP#1	1933137.4980	1137872.8310	618.13
CP#2	1933052.5581	1137919.7775	618.98
CP#10	1933090.6998	1138038.5701	618.03
CP#11	1932920.2573	1138328.2855	617.28
CP#13	1932771.9681	1138666.0368	616.74
CP#14	1932672.0523	1138642.2742	616.10
CP#15	1932728.0216	1138537.6353	616.62
BM#1			618.72

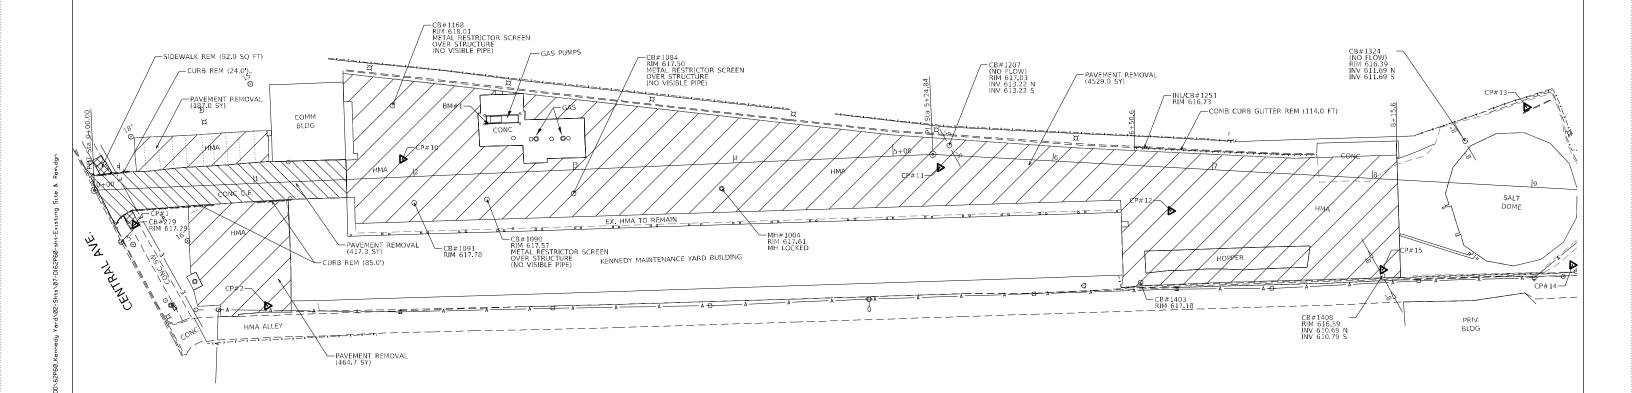

LEGE	ND
	PAVEMENT REMOVAL (HMA)
	PAVEMENT REMOVAL (PCC)
	SIDEWALK REMOVAL



USER NAME = jpham	DESIGNED -	REVISED -
	DRAWN -	REVISED -
PLOT SCALE = 60.0000 ' / in.	CHECKED -	REVISED -
PLOT DATE = 12/14/2021	DATE -	REVISED -


STATE OF ILLINOIS
DEPARTMENT OF TRANSPORTATION

KENNEDY MAINTENANCE YARD					
		EXISTING	SITE	AND REI	MOVAL PLAN
SCALE:	1''=30'	SHEET NO.	OF	SHEETS	STA.

F.A.U RTE.	SECTION	COUNTY	TOTAL SHEETS	SHEET NO.
2798	2021-144-I	COOK	14	7
		CONTRACT	NO. 6	2P60
FED. R	OAD DIST. NO. 1 ILLINOIS FED. A	ID PROJECT		

 OF
 SHEETS
 STA.
 TO STA.
 FED. ROAD DIST. NO. 1 | ILLINOIS| FED. AID PROJECT

 P:\2819\ME19803_VarVar_PHII\\0037_Maintenance
 Yard \81-CADD\\62P68_Kennedy
 Yard\\82-Shts\\87-DI62P68-sht-Existing
 Site & Rem.dgn

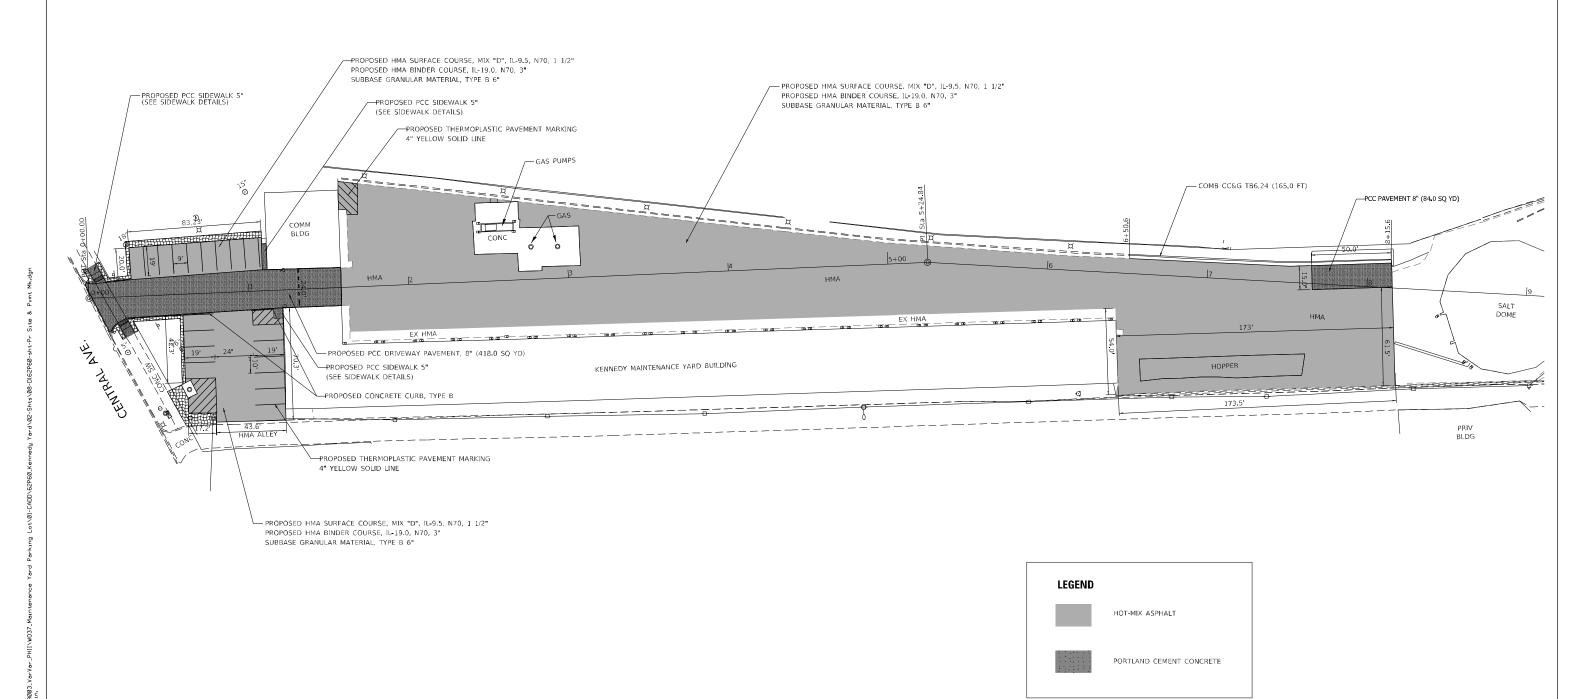

MILLENNIA

COUNTY TOTAL SHEETS NO.
COOK 14 8 USER NAME = jpham DESIGNED -REVISED SECTION KENNEDY MAINTENANCE YARD STATE OF ILLINOIS DRAWN REVISED 2798 2021-144-I **DEPARTMENT OF TRANSPORTATION** PROPOSED SITE AND PAVEMENT MARKING PLAN CHECKED REVISED CONTRACT NO. 62P60 PLOT DATE = 12/14/2021 REVISED SCALE: 1"=30" SHEET NO. OF SHEETS STA.
 OF
 SHEETS
 STA.
 TO
 STA.
 FED. ROAD DIST. NO. 1 | ILLUNDIS| FED. AID PROJECT
 PN-2819\ME19883_VarVer_PHII\W037_Maintenance
 Yard Parking Lot\01-62P68_Kennedy
 Yard\02-Shts\08-D162P68-sht-Pr
 Site & Pvmt Mk.dgr
 DATE

MILLENNIA PROFESSIONAL SERVICES www.millennia.pro

| DRAWN - REVISED - | STATE OF ILLINOIS | | DEPARTMENT OF TRANSPORTATION | | PLOT DATE = 12/11/2021 | DATE - REVISED - | | |

REVISED

DESIGNED -

KENNEDY MAINTENANCE YARD
GRADING AND DRAINAGE PLAN

SCALE: 1"=30' SHEET NO. OF SHEETS STA. TO STA. FED. ROAD DIS




MILLENNIA PROFESSIONAL SERVICES www.millennia.pro


STATE OF ILLINOIS DEPARTMENT OF TRANSPORTATION KENNEDY MAINTENANCE YARD
SIDEWALK DETAILS

SHEET NO. OF SHEETS STA. TO STA.


SCALE: 1"=5"

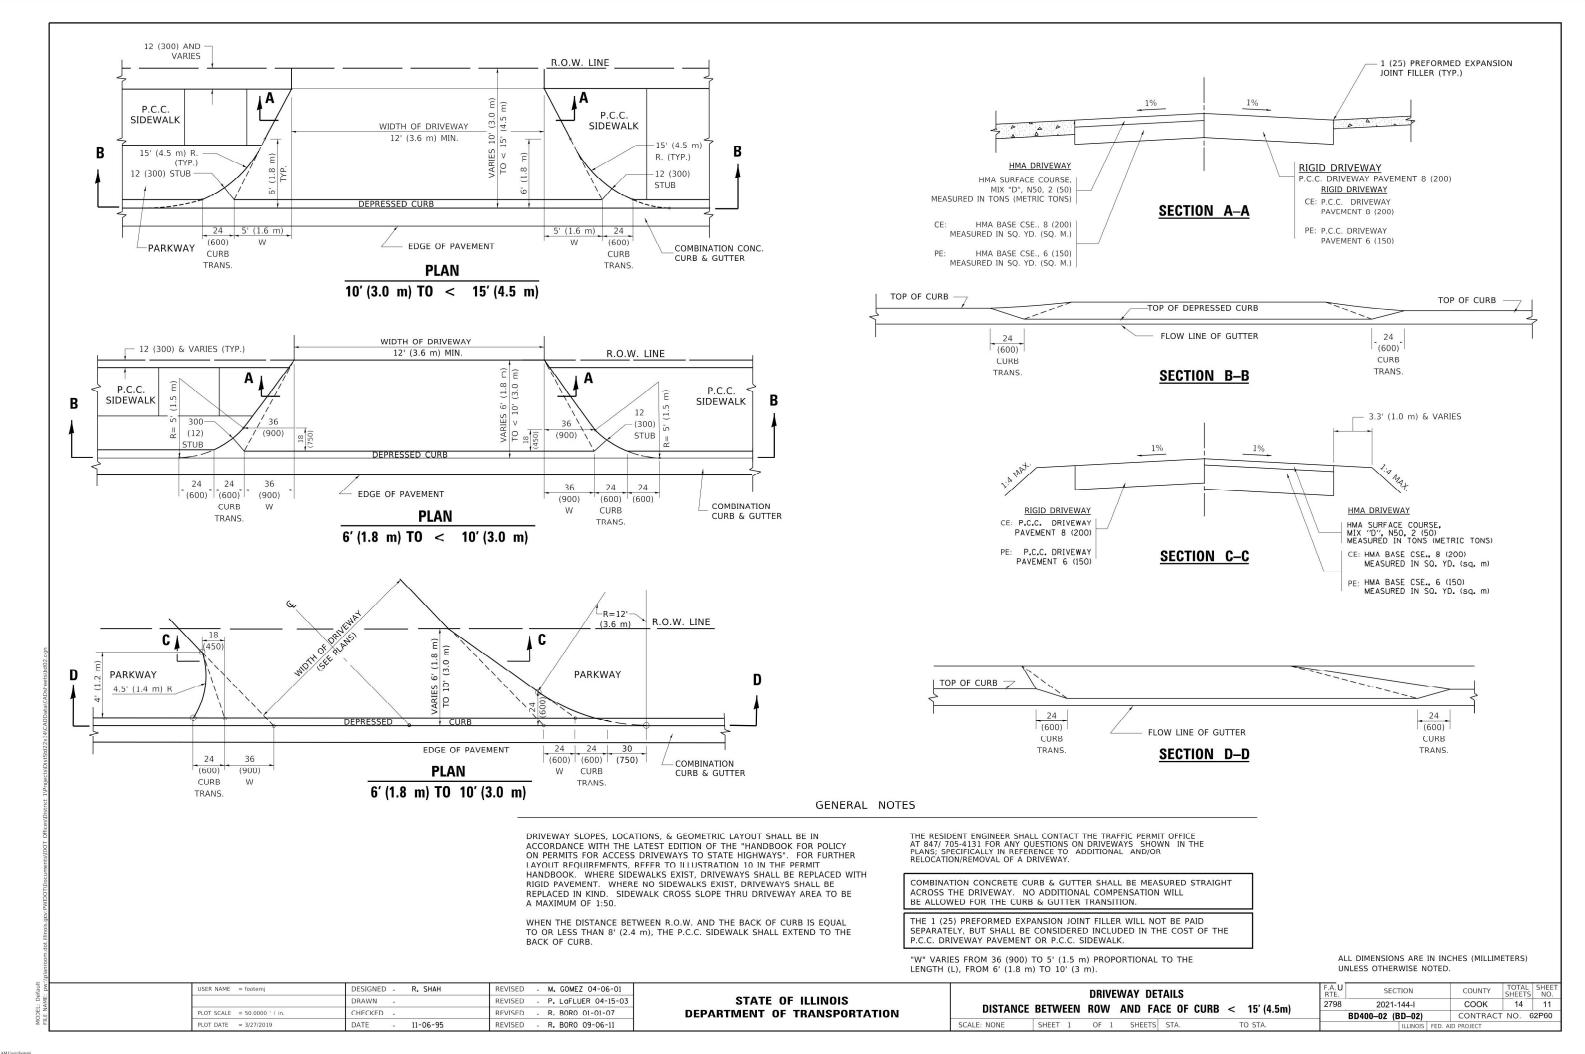

STRAIGHT DETECTABLE WARNING UNITS

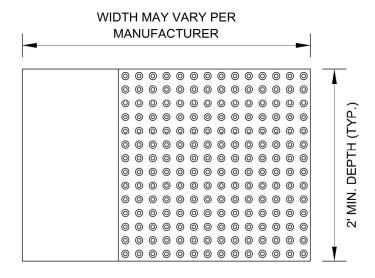

RADIAL DETECTABLE WARNING UNITS

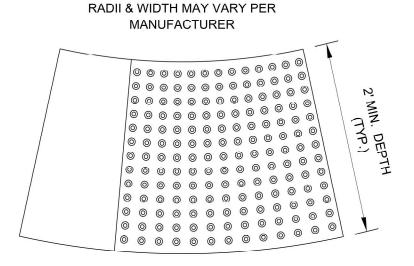


DETECTABLE WARNING UNIT SIZES


- VERIFY ALL DIMENSIONS WITH THE PRODUCT MANUFACTURER.
- IF USING RADIAL UNITS, VERIFY THAT THE CURB RADIUS MATCHES AVAILABLE UNIT RADII WITH THE PRODUCT MANUFACTURER.

GENERAL NOTE:

THE ROWS OF DOMES IN THE DETECTABLE WARNING MATERIAL MUST BE ALIGNED WITH THE PATH OF WHEELCHAIR TRAVEL WHICH IS REQUIRED TO BE PERPENDICULAR TO THE GRADE BREAK AT THE BOTTOM OF THE RAMP TO PERMIT TRACKING BETWEEN DOME ROWS. ON BLENDED TRANSITIONS OR FLUSH TRANSITIONS, WHERE RADIAL UNITS ARE SITUATED ABOUT THE CURB RADIUS, DOME ORIENTATION IS NOT SIGNIFICANT.

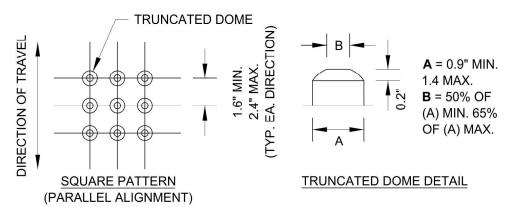


UNIT PATTERN & DOME DETAIL

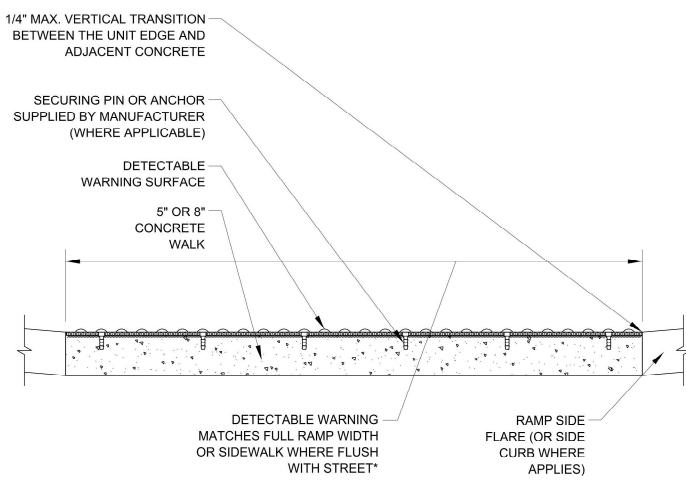

*A BORDER OF 2 INCHES OR LESS AROUND THE DETECTABLE WARNING SURFACE IS
ACCEPTABLE IF REQUIRED FOR PROPER INSTALLATION OF THE DETECTABLE WARNING SURFACE PRODUCT

DETECTABLE WARNING UNIT SECTION

USER NAME = footemj	DESIGNED -	REVISED -		CITY OF CHICAGO	F.A. U	SECTION	COUNTY TOTAL SHEET
	DRAWN -	REVISED -	STATE OF ILLINOIS	The state of the s	2798	2021-144-I	COOK 14 12
PLOT SCALE = 50.0000 ' / in.	CHECKED -	REVISED -	DEPARTMENT OF TRANSPORTATION	DETECTABLE WARNINGS		BD 58	CONTRACT NO. 62P60
PLOT DATE = 10/8/2019	DATE - 06-20-2017	REVISED -		SCALE: NONE SHEET 1 OF 1 SHEETS STA. TO STA.		ILLINOIS F	ED. AID PROJECT

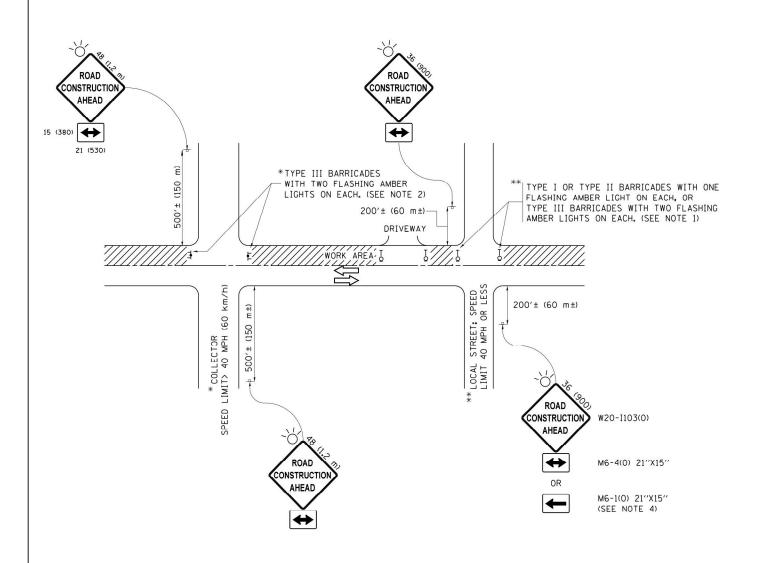

NOTES:

- SIDE ROAD WITH A SPEED LIMIT OF 40 MPH (60 km/h) OR LESS AS SHOWN ON THE DRAWING AND AS DIRECTED BY THE ENGINEER:
 - d) ONE "ROAD CONSTRUCTION AHEAD" SIGN 36 x 36 (900x900) WITH A FLASHER MOUNTED ON IT APPROXIMATELY 200' (60 m) IN ADVANCE OF THE MAIN ROUTE.
 - b) THE CLOSED PORTION OF THE MAIN ROUTE SHALL BE PROTECTED BY BLOCKING WITH TYPE I, TYPE II OR TYPE III BARRICADES, 1/3 OF THE CROSS SECTION OF THE CLOSED PORTION.
- 2. SIDE ROAD WITH A SPEED LIMIT GREATER THAN 40 MPH (60 km/h) AS SHOWN ON THE DRAWING AND AS DIRECTED BY THE ENGINEER:
 - a) ONE "ROAD CONSTRUCTION AHEAD" SIGN 48 x 48 (1.2 m x 1.2 m) WITH A FLASHER MOUNTED ON IT APPROXIMATELY 500" (150 m) IN ADVANCE OF THE MAIN ROUTE.
 - b) THE CLOSED PORTION OF THE MAIN ROUTE SHALL BE PROTECTED BY BLOCKING WITH TYPE III BARRICADES, 1/2 OF THE CROSS SECTION OF THE CLOSED PORTION.
- 3. CONES MAY BE SUBSTITUTED FOR BARRICADES OR DRUMS AT HALF THE SPACING DURING DAY OPERATIONS. CONES SHALL BE A MINIMUM OF 28 (710)
- 4. WHEN THE SIDE ROAD LIES BETWEEN THE BEGINNING OF THE MAINLINE SIGNING AND THE WORK ZONE, A SINGLE HEADED ARROW (M6-1) SHALL BE USED IN LIEU OF THE DOUBLE HEADED ARROW (M6-4).

SCALE: NONE

- 5. WHEN WORK IS BEING PERFORMED ON A SIDE ROAD OR DRIVEWAY, FOLLOW THE APPLICABLE STANDARD(S). THE DIRECTIONAL ARROW (MG-1 OR MG-4) SHALL BE COVERED OR REMOVED WHEN NO LONGER CONSISTENT WITH THE TRAFFIC CONTROL SET-UP.
- 6. ADVANCE WARNING SIGNS ARE TO BE OMITTED ON DRIVEWAYS UNLESS OTHERWISE SPECIFIED IN THE PLANS OR BY THE ENGINEER.
- 7. THE TRAFFIC CONTROL AND PROTECTION FOR SIDE ROADS, INTERSECTIONS, AND DRIVEWAYS SHALL BE INCLUDED IN THE COST OF SPECIFIED TRAFFIC CONTROL STANDARDS OR ITEMS.

All dimensions are in inches (millimeters) unless otherwise shown.


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pw:\\ILØ84EBIDINTEG.ıllınoıs.gov:PWIDOT\Do	cuments\IDOT Offices\District I\Projects\Dist	GRAWN\CADData\CADsheets\tc10.dgn	REVISED	- T.	RAMMACHER 01-06-00
	PLOT SCALE = 50.000 '/ in.	CHECKED -	REVISED	-	A. SCHUETZE 07-01-13
Default	PLOT DATE = 9/15/2016	DATE - 06-89	REVISED	-	A. SCHUETZE 09-15-16


STATE OF ILLINOIS
DEPARTMENT OF TRANSPORTATION

	TRAFFIC CONTROL AND PROTECTION FOR			F.A.U. RTE.	SECTIO		
SIDE ROADS, INTERSECTIONS, AND DRIVEWAYS			2798	2021-14			
J	IDE NUADO, INTENSECTIONS, AND DRIVEVVATS						TC-10
	SHEET 1	OF	1 SHEETS	STA.	TO STA.		Ti I

F.A. U. SECTION COUNTY TOTAL SHEET NO. 2798 2021-144-1 COOK 14 13

| TC-10 | CONTRACT NO. 62P60 | Illlinois | Fed. aid | Project | Proje

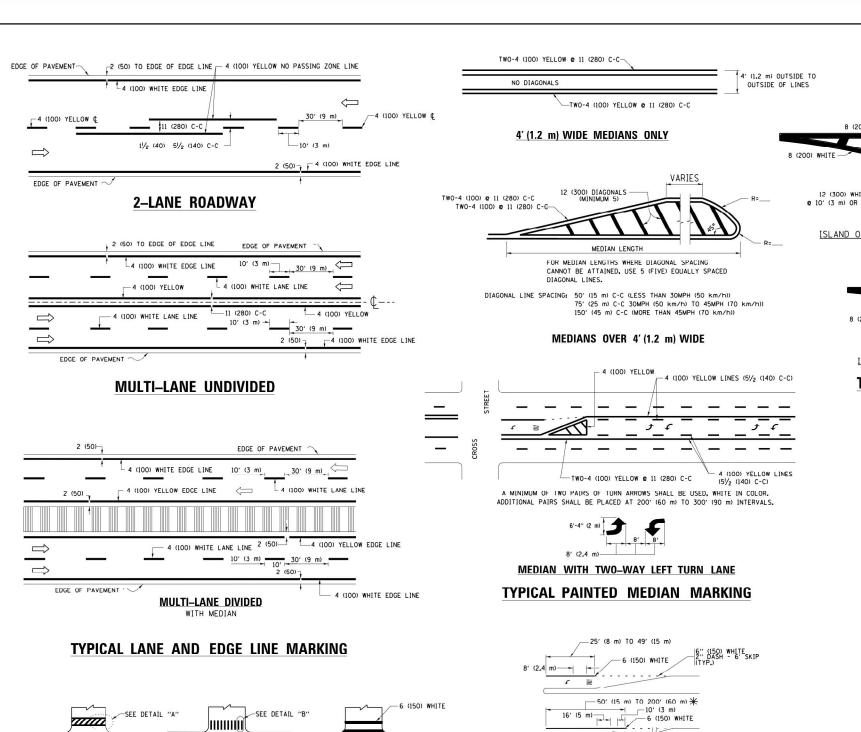

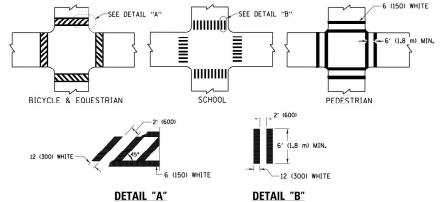

TYPICAL CROSSWALK MARKING

MARKINGS SHALL BE INSTALLED PARALLEL TO THE CENTERLINE OF


OVER 200' (60 m) 6 (150) WHITE

FULL SIZE LETTERS 8' (2.4 m) AND ARROWS SHALL BE USED. AREA = 15.6 SO. FT. (1.5 m2) ONLY AREA = 20.8 SO. FT. (1.9 m2)


* IURN LANES IN EXCESS OF 400' (120 m) IN LENGTH MAY HAVE AN ADDITIONAL SET OF ARROW - "ONLY" INSTALLED MIDWAY BETWEEN THE OTHER TWO SETS OF

TYPICAL LEFT (OR RIGHT) TURN LANE


TYPICAL TURN LANE MARKING

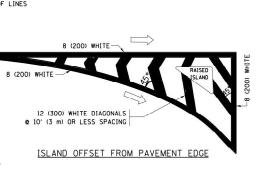



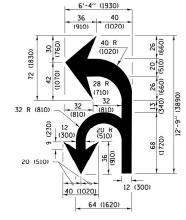

COMBINATION LEFT AND U-TURN

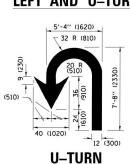

500 580 45 665 50 750 55 -20° LANE REDUCTION TRANSITION

D(FT)

SPEED LIMIT

* LANE REDUCTION ARROWS REQUIRED AT SPEEDS OF 45 MPH OR GREATER OR WHEN SPECIFIED IN PLANS.

TYPE OF MARKING	WIDTH OF LINE	PATTERN	COLOR	SPACING /REMARKS		
CENTERLINE ON 2 LANE PAVEMENT	4 (100)	SKIP-DASH	YELLOW	10' (3 m) LINE WITH 30' (9 m) SPACE		
CENTERLINE ON MULTI-LANE LINDIVIDED PAVEMENT	2 8 4 (100)	SOI ID	YFIIOW	11 (280) C-C		
NO PASSING ZONE LINES: FOR ONE DIRECTION FOR BOTH DIRECTIONS	4 (100) 2 © 4 (100)	SOLID SOLID	YELLOW YELLOW	51/2 (140) C-C FROM SKIP-DASH CENTERLINE 11 (280) C-C OMIT SKIP-DASH CENTERLINE BETWEEN		
LANE LINES	4 (100) 5 (125) ON FREEWAYS	SKIP-DASH SKIP-DASH	WHITE WHITE	10' (3 m) LINE WITH 30' (9 m) SPACE		
DOTTED LINES (EXTENSIONS OF CENTER, LANE OR TURN LANE MARKINGS)	SAME AS LINE BEING EXTENDED	SKIP-DASH	SAME AS LINE BEING EXTENDED	2' (600) LINE WITH 6' (1.8 m) SPACE		
EDGE LINES	4 (100)	SOLID	YELLOW-LEFT WHITE-RIGHT	OUTLINE MEDIANS IN YELLOW		
TURN LANE MARKINGS	6 (150) LINE: FULL SIZE LETTERS & SYMBOLS (8' (2.4m))	SOL ID	WHITE	SEE TYPICAL TURN LANE MARKING DETAIL		
TWO WAY LEFT TURN MARKING	2 @ 4 (100) EACH DIRECTION 8' (2.4m) LEFT ARROW	SKIP-DASH AND SOLID IN PAIRS	YELLOW	10' (3 m) LINE WITH 30' (9 m) SPACE FOR SKIP-DASH; 5½ (140) C-C DETWEEN SOLID LINE AND SKIP-DASH LINE SEE TYPICAL TWO-WAY LEFT TURN MARKING DETAIL		
CROSSWALK LINES (PEDESTRIAN) A. DIACONALS (BIKE & EQUESTRIAN) B. LONGITUDINAL BARS (SCHOOL) 2 @ 6 (150) 12 (300) @ 45° 12 (300) @ 90°		SOLID SOLID SOLID	WHITE WHITE WHITE	NOT LESS THAN 6' (1.8 m) APART 2' (600) APART 2' (600) APART SEE TYPICAL CROSSWALK MARKING DETAILS.		
STOP LINES	24 (600) SOLID		WHITE	PLACE 4' (1.2 m) IN ADVANCE OF AND PARALLEL TO CROSSWALK. IF PRESENT. OTHERWISE, PLACE AT DESIRED STOPPING POINT. PARALLEL TO CROSSROAD CENTERLINE, WHERE POSSIBLE		
PAINTED MEDIANS	2 @ 4 (100) WITH 12 (300) DIAGONALS @ 45° NO DIAGONALS USED FOR 4' (1.2 m) WIDE MEDIANS	SOLID	YELLOW: TWO WAY TRAFFIC WHITE: ONE WAY TRAFFIC	11 (280) C-C FOR THE DOUBLE LINE SEE TYPICAL PAINTED MEDIAN MARKING.		
GORE MARKING AND CHANNELIZING LINES	8 (200) WITH 12 (300) DIAGONALS & 45°	SOLID	WHITE	DIACONALS: 15' (4,5 m) C-C (LESS THAN 30MPH (50 km/h)) 20' (6 m) C-C 30MPH (50 km/h) TO 45MPH (70 km/h)) 30' (9 m) C-C (OVER 45MPH (70 km/h))		
RAILROAD CROSSING 24 (600) TRANSVER LINES: "RR" IS 6' LETTERS: 16 (400) LINE FOR "X"		SOLID	WHITE	SEE STATE STANDARD 780001 AREA OF: "R"=3.6 SO. FT. (0.33 m²) EACH "X"=54.0 SO. FT. (5.0 m²)		
SHOULDER DIAGONALS (REQUIRED FOR SHOULDERS ≥ 8')	12 (300) @ 45°	SOLID	WHITE - RIGHT YELLOW - LEFT	50' (15 m) C-C (LESS THAN 30MPH (50 km/h)) 75' (25 m) C-C (30 MPH (50 km/h) T0 45MPH (70 km/h); 150' (45 m) C-C (0VER 45MPH (70 km/h))		
U TURN ARROW	SEE DETAIL	SOLID	WHITE	16.3 SF		
2 ARROW COMBINATION LEFT AND U TURN	SEE DETAIL	SOLID	WHITE	30.4 SF		

FOR FURTHER DETAILS ON PAVEMENT MARKING REFER TO STANDARD SPECIFICATIONS FOR ROAD AND BRIDGE CONSTRUCTION AND STATE STANDARD 780001.

SCALE: NONE

All dimensions are in inches (millimeters) unless otherwise shown.

FILE NAME = DESIGNED -EVERS JSER NAME = footem. REVISED C. JUCIUS 09-09-09 w:\\ILØ84EBIDINTEG.1111 ents\IDOT Offices\District I\Projects\ taRAWN\CADData\CADsheets\tc13.dor REVISED C. JUCIUS 07-01-13 CHECKED REVISED C. JUCIUS 12-21-15 DATE REVISED C. JUCIUS 04-12-16 03-19-90

STATE OF ILLINOIS **DEPARTMENT OF TRANSPORTATION**

DISTRICT ONE				F.A.U RTE.	SECTION	COUNTY	TOTAL SHEETS	SHEET NO.		
TYPICAL PAVEMENT MARKINGS					2	2798	2021-144-I	соок	14	14
					TC-13		CONTRACT NO. 62P60			
	SHEET 1	OF 1	SHEETS	STA	TO STA.		THE INOTE FED	AID DDO IECT		