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PERTAINS TO
SHEETS 17 THROUGH 29

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PRIMERA ENGINEERS LTD. ROBERT J. DEMING. P.E.

DATE: 12/10/2021 SIGNATURE AND SEAL APPLY TO DRAWINGS: 5-15

> B. Amini BEHZAO AMM, Ph.D., P.E. IL. LIC. NO. 062-067557


DATE: 12/10/2021



STATE OF ILLINOIS **DEPARTMENT OF TRANSPORTATION**

PROPOSED HIGHWAY PLANS

F.A.P. 344: IL 83 OVER US 45 **SECTION 2021–005–BR** PROJECT NHPP-B9BX(410) BRIDGE DECK OVERLAY AND JOINT REPAIR **COOK COUNTY**

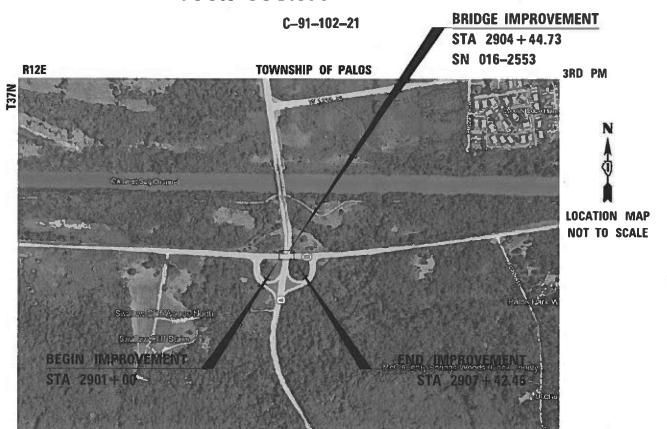

(NOT TO SCALE)


SECTIONS 21 & 22

GROSS LENGTH = 643 FT. = 0.125 MILE NET LENGTH = 643 FT. = 0.125 MILE

PROJECT IS LOCATED IN THE TOWNSHIP OF PALOS IN COOK COUNTY

FOR INDEX OF SHEETS, SEE SHEET NO. 2

IL 83 TRAFFIC DATA: FUNCTIONAL CLASSIFICATION OTHER PRINCIPAL ARTERIAL 2019 ADT = 13900SPEED LIMIT = 55 MPH**US 45 TRAFFIC DATA: FUNCTIONAL CLASSIFICATION** OTHER PRINCIPAL ATERIAL 2019 ADT = 36900SPEED LIMIT = 45 MPH

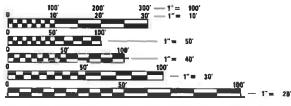

ENGINEERING SCALES, REDUCED SIZED PLANS WILL NOT CONFORM TO STANDARD SCALES. IN MAKING MEASUREMENTS ON REDUCED PLANS, THE ABOVE SCALES MAY BE USED.

J.U.L.I.E. JOINT UTILITY LOCATION INFORMATION FOR EXCAVATORS 1-800-892-0123 OR 811

PROJECT ENGINEER

PRAVEEN KAINI, PE (847) 705-4237

PROJECT MANAGER

J. ALAIN MIDY, PE (847) 221-3056

CONTRACT NO. 62N34

COOK LUNGIS CONTRACT NO. 62N34 **★** 52 + 1 = 53 TOTAL SHEETS

D-91-085-21



STATE OF ILLINOIS DEPARTMENT OF TRANSPORTATION SUBMITTED DECEMBER 14 20 21 Que Rio (08 REGIONAL ENGINEER HIGHWAYS PROJECT IMPLEMENTAT

PRINTED BY THE AUTHORITY OF THE STATE OF ILLINOIS

INDEX OF SHEETS

COVER SHEET HIGHWAY STANDARDS, GENERAL NOTES & COMMITMENTS TO 5 SUMMARY OF QUANTITIES TYPICAL SECTIONS ALIGNMENT SHEET TO 9 REMOVAL PLAN 10 TO 11 PLAN & PROFILE HMA PAVEMENT CONNECTOR DETAIL 13 TO 15 PAVEMENT MARKING & SIGNING PLAN DRAINAGE PLAN 17 TO 29 MOT PLANS GENERAL PLAN AND ELEVATION INDEX OF SHEETS AND BILL OF MATERIAL 31 STAGE CONSTRUCTION DETAILS 33 REMOVAL PLAN TYPICAL SECTION 34 DECK REPAIR PLAN 35 TOP OF WEST APPROACH SLAB ELEVATIONS 37 TOP OF EAST APPROACH SLAB ELEVATIONS EAST APPROACH SLAB PLAN AND CROSS-SECTION 39 APPROACH SLAB DETAILS & BOM PARAPET DETAILS PIER REPAIR DETAILS 41 BAR SPLICER DETAILS 43 TO 52 DISTRICT 1 STANDARD DETAILS

HIGHWAY STANDARDS

000001-08

701426-09

701701-10

701901-08

880001-01

TC-22

DECIMAL OF AN INCH AND OF A FOOT 001006 TEMPORARY EROSION CONTROL SYSTEMS 280001-07 PAVEMENT CONNECTOR (HMA) FOR BRIDGE APPROACH SLAB 420406 515001-04 NAME PLATE FOR BRIDGES PRECAST REINFORCED CONCRETE FLARED END SECTION 542301-03 610001-09 SHOULDER INLET WITH CURB STEEL PLATE BEAM GUARDRAIL 630001-12 BACK SIDE PROTECTION OF GUARDRAIL 630116 TRAFFIC BARRIER TERMINAL, TYPE 2 631011-10 631031-17 TRAFFIC BARRIER TERMINAL, TYPE 6 701006-05 OFF-RD OPERATIONS, 2L, 2W, 15' TO 24" FROM PAVEMENT EDGE 701011-04 OFF-RD MOVING OPERATIONS, 2L, 2W, DAY ONLY 701101-05 OFF-RD OPERATIONS, MULTILANE, 15' TO 24" FROM PAVEMENT EDGE 701106-02 OFF-RD OPERATIONS, MULTILANE, MORE THAN 15' AWAY 701301-04 LANE CLOSURE, 2L, 2W, SHORT TIME OPERATIONS LANE CLOSURE, 2L, 2W, MOVING OPERATIONS - DAY ONLY
LANE CLOSURE, MULTILANE, AT ENTRANCE OR EXIT RAMP, FOR SPEEDS = 45 MPH 701311-03 701411-09 LANE CLOSURE, MULTILANE, DAY OPERATIONS ONLY, FOR SPEEDS ≥ 45 MPH TO 55 MPH 701421-08

STANDARD SYMBOLS, ABBREVIATIONS AND PATTERNS

URBAN LANE CLOSURE, MULTILANE INTERSECTION

TRAFFIC CONTROL DEVICES

ARTERIAL ROAD INFORMATION SIGN

DISTRICT	T ONE STANDARD DETAILS
BD - 03	OUTLET FOR CONRETE CURB AND GUTTER
BD-34	DEPRESSED CURB & GUTTER
TC-10	TRAFFIC CONTROL AND PROTECTION FOR SIDE ROADS, INTERSECTIONS, AND DRIVEWAYS
TC-11	RAISED REFLECTIVE PAVEMENT MARKERS (SNOW PLOW RESISTANT)
TC-12	MULTI-LANE FREEWAY PAVEMENT MARKING
TC-13	DISTRICT ONE TYPICAL MARKINGS
TC-14	TRAFFIC CONTROL AND PROTECTION AT LEFT TURN BAYS (TO REMAIN OPEN TO TRAFFIC)
TC-16	SHORT TERM PAVEMENT MARKING LETTERS AND SYMBOLS
TC-17	TRAFFIC CONTROL FOR FREEWAY SHOULDER CLOSURES AND PARTIAL RAMP CLOSURES

SPAN WIRE MOUNTED SIGNALS AND FLASHING BEACON INSTALLATION

LANE CLOSURE, MULTILANE, INTERMITTENT OR MOVING OPERATTION, FOR SPEEDS ≥ 45 MPH

GENERAL NOTES

ALL CONSTRUCTION WORK SHALL BE PERFORMED IN ACCORDANCE WITH THE APPLICABLE SECTIONS OF THE ILLINOIS DEPARTMENT OF TRANSPORTATION "STANDARD SPECIFICATIONS FOR ROAD AND BRIDGE CONSTRUCTION" ADDPTED JANUARY 1, 2022, SUPPLEMENTAL SPECIFICATIONS AND RECURRING SPECIAL PROVISIONS AND SPECIAL PROVISIONS OF THE BUREAU OF DESIGN AND ENVIRONMENT. ANY REFERENCE TO A STANDARD IN THESE PLANS SHALL BE INTERPRETED TO MEAN JANUARY 1, 2022 EDITION.

THE CONTRACTOR SHALL CONTACT J.U.L.I.E. AT LEAST 48 HOURS PRIOR TO EXCAVATION TO DETERMINE WHICH UTILITIES ARE IN THE AREA.

THE CONTRACTOR SHALL BE RESPONSIBLE FOR COLLECTING AND MAINTAINING AN ELECTRONIC LOG OF ALL STAKEOUT SURVEY THAT IS PERFORMED ON THE JOB, EITHER BY HIM/HER OR ANY SUB-CONTRACTOR PERFORMING THE STAKEOUT. UPON REQUEST, ALL LOGS SHALL BE SUBMITTED TO THE DEPARTMENT. NO ADDITIONAL COMPENSATION WILL BE ALLOWED FOR THIS WORK, BUT SHALL BE CONSIDERED INCIDENTAL TO THE CONTRACT.

THE CONTRACTOR SHALL REFER TO THE SPECIAL PROVISION FOR STRUCTURAL ASSESSMENT REPORTS FOR CONTRACTOR'S MEANS AND METHODS WHEN FORMULATING A WORK PLAN THAT INVOLVES LOADS ON THE DECK.

THE CONTRACTOR IS TO REFER TO THE SPECIAL PROVISION FOR SAW CUTTING CONTRACTION JOINTS IN P.C.C. SIDEWALKS. NO TOOLED JOINTS WILL BE ALLOWED.

IT SHALL BE THE CONTRACTORS RESPONSIBILITY TO VERIFY ALL DIMENSIONS AND CONDITIONS EXISITING IN THE FIELD PRIOR TO CONSTRUCTION AND ORDERING OF MATERIALS.

THE THICKNESS OF HMA SHOWN ON THE PLANS IS THE NOMINAL THICKNESS, DEVIATIONS FROM THE NOMINAL THICKNESS WILL BE PERMITTED WHEN SUCH DEVIATIONS OCCUR DUE TO IRREGULARITIES IN THE EXISTING SURFACE OR BASE ON WHICH THE HMA IS PLACED.

SEEDING WILL NOT BE PERMITTED AT ANY TIME WHEN THE GROUND IS FROZEN, WET, OR IN AN UNTILLABLE CONDITION, LOCATIONS TO BE SEEDED WILL BE DETERMINED BY THE ENGINEER.

THE CONTRACTOR SHALL CONTACT THE ROADSIDE DEVELOPMENT UNIT AT (847) 705-4171 AT LEAST 2 WEEKS PRIOR TO ANY FORESTRY WORK TO IDENTIFY AND MARK TREES TO SAVE WITHING TREE REMOVAL AREAS.

BEFORE BEGINNING ANY WORK, THE CONTRACTOR SHALL RETAIN AND RECORD FOR FUTURE REFERENCE, ALL EXISTING PAVEMENT MARKING LINES AND RAISED REFLECTIVE PAVEMENT MARKERS THAT CONFLICT WITH TEMPORARY MARKINGS, IN ORDER THAT THESE LOCATIONS CAN BE RE-ESTABLISHED FOR PROPOSED STRIPING AT THE COMPLETION OF THIS CONTRACT. EXACT LOCATIONS OF ALL PROPOSED PAVEMENT MARKINGS SHALL BE DIRECTED BY THE RESIDENT ENGINEER.

THE CONTACTOR WILL NOT BE ABLE TO SET UP A YARD OR FIELD OFFICE ON STATE PROPERTY WITHOUT WRITTEN PERMISSION FROM THE DEPARTMENT

ALL DAMAGE TO EXISTING MARKINGS OR RAISED REFLECTIVE PAVEMENT MARKERS OUTSIDE THE REMOVAL LINE SHOWN ON THE PLANS SHALL BE REPLACED AT NO ADDITIONAL COST TO THE DEPARTMENT.

THE CONTRACTOR SHALL MAINTAIN ALL ROADWAYS OPEN TO TRAFFICE AS SHOWN ON THE MAINTENANCE OF TRAFFIC PLANS.

GEOTECHNICAL FABRIC FOR GROUND STABILIZATION AND/OR AGGREGATE SUBGRADE IMPROVEMENT (CU YD) HAVE BEEN PROVIDED FOR USE AT THE LOCATIONS INDICATED FOR SOILS THAT TEND TO BE UNSTABLE AND/OR UNSUITABLE. THE ACTUAL NEED FOR REMOVAL AND REPLACEMENT WITH ABOVE ITEM WILL BE DETERMINED IN THE FIELD AT THE TIME OF CONSTRUCTION BY THE GEOTECHNICAL ENGINEER. ALL POTENTIALLY UNSTABLE SOILS SHOULD BE TESTED WITH A STATIC OR DYNAMIC CONE PENETROMETER AND TREATED IN ACCORDANCE WITH ARTICLE 301.04 OF THE SSRBC AND IDOT SUBGRADE STABILITY MANUAL. IF UNSTABLE AND/OR UNSUITABLE SOILS ARE NOT ENCOUNTERED, THEN THE QUANTITY SHALL BE DEDUCTED AND NO ADDITIONAL COMPENSATION WILL BE DUE TO THE CONTRACTOR.

ANY AGGREGATE SUBGRADE IMPROVEMENT CONTAMINATED AND/OR DAMAGED BY THE CONTRACTOR'S VEHICLES AND/OR EQUIPMENTS IS TO BE REMOVED AND REPLACED AS DIRECT BY THE ENGINEER AT CONTRACTOR EXPENSE.

GENERAL NOTES

THE CONTRACTOR SHALL USE CARE NEAR ANY AND ALL EXISTING ITEMS THAT WILL NOT BE REMOVED. ANY DAMAGE DONE TO EXISTING ITEMS BY THE CONTRACTOR SHALL BE REPAIRED OR REPLACED TO THE SATISFACTION OF THE ENGINEER AT THE CONTRACTOR'S OWN EXPENSE.

DO NOT SCALE PLANS FOR CONSTRUCTION DIMENSIONS.

DURING CONSTRUCTION OPERATIONS, IF ANY LOOSE MATERIAL IS DEPOSITED IN THE FLOW LINE OF DRAINAGE STRUCTURES SUCH THAT THE NATURAL FLOW OF WATER IS OBSTRUCTED, THE MATERIAL SHALL BE REMOVED AT THE CLOSE OF EACH WORKDAY. AT THE CONCLUSION OF CONSTRUCTION OPERATIONS, ALL UTILITY STRUCTURES SHALL BE FREE FROM DUST AND DEBRIS. THE WORK SPECIFIED ABOVE WILL NOT BE PAID SEPARATELY BUT SHALL BE INCLUDED IN THE COST OF CONTRACT.

PERMANENT PAVEMENT MARKINGS SHALL BE AS SPECIFIED IN THE PLANS AND SHALL BE PLACED IN ACCORDANCE WITH THE 'DISTRICT ONE TYPICAL PAVEMENT MARKING' DETAILS. (TC-13, DISTRICT ONE TYPICAL PAVEMENT MARKINGS).

THE SUBGRADE STABILITY SHALL BE VERIFIED BY PROOF ROLLING WITH A FULL LOADED TANDEM AXIE TRUCK

IF ANY STAGE CHANGES REQUIRING THE STOPPING AND/OR THE PACING OF TRAFFIC SHALL TAKE PLACE DURING THE ALLOWABLE HOURS FOR FULL EXPRESSWAY CLOSURES AND SHALL BE APPROVED BY THE DEPARTMENT. THE CONTRACTOR SHALL NOTIFY THE DISTRICT ONE EXPRESSWAY TRAFFIC CONTROL SUPERVISOR AT LEAST 3 WORKING DAYS (WEEKENDS AND HOLIDAYS DO NOT COUNT INTO THIS 72 HOURS NOTIFICATION) IN ADVANCE OF ANY PROPOSED STAGE CHANGE.

A MAINTENANCE OF TRAFFIC PLAN SHALL BE SUBMITTED TO THE DISTRICT ONE EXPRESSWAY TRAFFIC CONTROL SUPERVISOR 14 DAYS IN ADVANCE OF ANY STAGE CHANGES OR FULL EXPRESSWAY CLOSURES. THE MAINTENANCE OF TRAFFIC PLAN SHALL INCLUDE, BUT NOT BE LIMITED TO: LANE AND RAMP CLOSURES, EXISTING GEOMETRICS, AND EQUIPMENT AND MATERIAL LOCATION.

THE CONTRACTOR MUST VERIEY THE EXISTING SUBBASE AND PAVEMENT DEPTH IE APPLICABLE

BACKFILLING STORM SEWER CONSTRUCTED UNDER THE ROADWAY SPECIFICED UNDER ART. 550.071b. c) OF THE SSRBC WILL NOT BE ALLOWED.

COMMITMENTS:

NONE

ILLINOIS DEPARTMENT OF TRANSPORTATION

- 1. THE CONTRACTOR SHALL CONTACT THE DISTRICT ONE TRAFFIC CONTROL SUPERVISOR AT KALPANA.KANNAN-HOSADURGA@ILLINOIS.GOV A MINIMUM OF 72 HOURS IN ADVANCE OF BEGINNING
- 2. THE RESIDENT ENGINEER SHALL CONTACT THE AREA TRAFFIC FIELD TECHNICIAN PATRICE HARRIS AT PATRICE.HARRIS@ILLINOIS.GOV A MINIMUM OF TWO (2) WEEKS PRIOR TO PLACING THE PERMANENT PAVEMENT MARKINGS.

Primera
50 W. ACKSON BUTS, SUEF 600 . CRICAGO E 40019 . POID-400-4019 F PUZZ-400-40

USER NAME = rvandermus	DESIGNED -	REVISED -
	DRAWN - RMV	REVISED -
PLOT SCALE = 2.0000 / in	CHECKED - MPV	REVISED -
PLOT DATE = 1/25/2022	DATE -	REVISED -

STATE OF ILLINOIS
DEPARTMENT OF TRANSPORTATION

HIGHWA	HIGHWAY STANDARDS, GENERAL NOTES & COMMITMENTS						SECTION	COUNTY	TOTAL SHEETS	SHEET NO.
IL 83 OVER US 45						344	2021-005-BR	соок	52	2
	IL 83 UVER US 45							CONTRACT	NO. 62	2N34
	CHEET 3	OF F2	CHEETC	CTA	TO CTA			 		

			Ι	CONSTRUCTION CODE
			-	BR I DGE 0059
		-	TOTAL	80% FED 20% STATE
CODE NO.	ITEM	UNIT	QUANTITY URBAN	IL 83 SN 016-2553
20100500	TREE REMOVAL, ACRES	ACRE	0.1	0.1
20201200	REMOVAL AND DISPOSAL OF UNSUITABLE MATERIAL	CU YD	140	140
20800150	TRENCH BACKFILL	CU YD	10.3	10.3
21001000	GEOTECHNICAL FABRIC FOR GROUND STABILIZATION	SQ YD	379	379
25000210	SEEDING, CLASS 2A	ACRE	0.1	0 . 1
25000400	NITROGEN FERTILIZER NUTRIENT	POUND	7.2	7.2
25000600	POTASSIUM FERTILIZER NUTRIENT	POUND	7.2	7.2
25100635	HEAVY DUTY EROSION CONTROL BLANKET	SQ YD	387	387
30300001	AGGREGATE SUBGRADE IMPROVEMENT	CU YD	136	136
30300112	AGGREGATE SUBGRADE IMPROVEMENT 12"	SQ YD	408	408
35300500	PORTLAND CEMENT CONCRETE BASE COURSE 10"	SQ YD	303	303
35400500	PORTLAND CEMENT CONCRETE BASE COURSE WIDENING 10"	SQ YD	37	37
40603090	HOT-MIX ASPHALT BINDER COURSE, IL-19.0, N90	TON	95	95
40604062	HOT-MIX ASPHALT SURFACE COURSE, IL-9.5, MIX "D", N70	TON	38	38
42000070	PAVEMENT CONNECTOR (HMA) FOR BRIDGE APPROACH SLAB	SQ YD	265	265
44000100	PAVEMENT REMOVAL	SQ YD	242	242
44000500	COMBINATION CURB AND GUTTER REMOVAL	FOOT	53	53
44003100	MEDIAN REMOVAL	SQ FT	3675	3675
44004250	PAVED SHOULDER REMOVAL	SQ YD	130	130
48101620	AGGREGATE SHOULDERS, TYPE B 10"	SQ YD	4.3	4.3
50102400	CONCRETE REMOVAL	CU YD	62.7	62.7
50157300	PROTECTIVE SHIELD	SQ YD	643	643
50300225	CONCRETE STRUCTURES	CU YD	51.3	51.3
50300255	CONCRETE SUPERSTRUCTURE	CU YD	7.8	7.8
50300300	PROTECTIVE COAT	SQ YD	1682	1682
50301350	CONCRETE SUPERSTRUCTURE (APPROACH SLAB)	CU YD	176.9	176.9
50800205	REINFORCEMENT BARS, EPOXY COATED	POUND	63410	63410
50800515	BAR SPLICERS	EACH	588	588
54213657	PRECAST REINFORCED CONCRETE FLARED END SECTIONS 12"	EACH	4	4
550A0050	STORM SEWERS, CLASS A, TYPE 1 12"	FOOT	132	132
59000200	EPOXY CRACK INJECTION	FOOT	10	10
60500060	REMOVING INLETS	EACH	4	4
60605000	COMBINATION CONCRETE CURB AND GUTTER, TYPE B-6.24	FOOT	60	60
63100045	TRAFFIC BARRIER TERMINAL, TYPE 2	EACH	1	1
63100087	TRAFFIC BARRIER TERMINAL, TYPE 6A	EACH	4	4

Primera	
BLVO. SUITE 600 . CHICAGO IL 60651 . P.312-606-6910 F.312-606-8415	

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STATE OF ILLINOIS DEPARTMENT OF TRANSPORTATION

		su	IMMARY	OF QU	F.A. SECTION		COUNTY	TOTAL	SHEET NO.		
	IL 83 OVER US 45							2021-005-BR	соок	52	3
Į			IL 05 (VEIL O	J 7J				CONTRAC	T NO. 6	2N34
	SCALE:	SHEET 3	OF 52	SHEETS	STA.	TO STA.	ILLINOIS FED. AID PROJECT				

				F	CONSTRUCTION CODE BRIDGE
				ŀ	0059 80% FED
ſ	CODE			TOTAL	20% STATE
	NO.	ITEM	UNIT	QUANT I TY URBAN	SN 016-2553
	63200310 63800920	GUARDRAIL REMOVAL MODULAR GLARE SCREEN SYSTEM, TEMPORARY	FOOT FOOT	25 264	25 264
	67100100	MOBILIZATION	L SUM	1	1
*	66900200	NON-SPECIAL WASTE DISPOSAL	CU YD		
*	66900530	SOIL DISPOSAL ANALYSIS	EACH		
*	66901001	REGULATED SUBSTANCES PRE-CONSTRUCTION PLAN	L SUM	1	1
*	66901003	REGULATED SUBSTANCES FINAL CONSTRUCTION REPORT	L SUM	1	1
*	66901006	REGULATED SUBSTANCES MONITORING	CAL DA	7	7
	70103815		CAL DA	365	365
2	70300150 70307100	SHORT TERM PAVEMENT MARKING REMOVAL TEMPORARY PAVEMENT MARKING LETTERS AND SYMBOLS - TYPE IV TAPE	SQ FT SQ FT	5017 217	5017 217
	70307120	TEMPORARY PAVEMENT MARKING - LINE 4" - TYPE IV TAPE	FOOT	10180	10180
	70307130	TEMPORARY PAVEMENT MARKING - LINE 6" - TYPE IV TAPE	FOOT	1146	1146
	70307140	TEMPORARY PAVEMENT MARKING - LINE 8" - TYPE IV TAPE	FOOT	605	605
	70307160	TEMPORARY PAVEMENT MARKING - LINE 12" - TYPE IV TAPE	FOOT	7	7
Į	70307210	TEMPORARY PAVEMENT MARKING - LINE 24" - TYPE IV TAPE	FOOT	213	213
	70400100	TEMPORARY CONCRETE BARRIER	FOOT	1233	1233
	70400200	RELOCATE TEMPORARY CONCRETE BARRIER	FOOT	1056	1056
	70600241	IMPACT ATTENUATORS, TEMPORARY (NON- REDIRECTIVE, NARROW), TEST LEVEL 2	EACH	4	4
9	70600341	IMPACT ATTENUATORS, RELOCATE (NON- REDIRECTIVE, NARROW), TEST LEVEL 2	EACH	8	8
	72400100	REMOVE SIGN PANEL ASSEMBLY - TYPE A	EACH	2	2
*	72400320	REMOVE SIGN PANEL - TYPE 2	SQ FT	24	24
*	78000100	THERMOPLASTIC PAVEMENT MARKING - LETTERS AND SYMBOLS	SQ FT	50	50
*	78000200	THERMOPLASTIC PAVEMENT MARKING - LINE 4"	FOOT	4055	4055
*	78000500	THERMOPLASTIC PAVEMENT MARKING - LINE 8"	FOOT	352	352
*	78000600	THERMOPLASTIC PAVEMENT MARKING - LINE 12"	FOOT	318	318
*	78000650	THERMOPLASTIC PAVEMENT MARKING - LINE 24"	FOOT	80	80
*	78009004	MODIFIED URETHANE PAVEMENT MARKING - LINE 4"	FOOT	3015	3015
-	78009012	MODIFIED URETHANE PAVEMENT MARKING - LINE 12"	FOOT	26	26
*	78100100	RAISED REFLECTIVE PAVEMENT MARKER	EACH	75	75
*	78200005	GUARDRAIL REFLECTORS, TYPE A	EACH	20	20
-	78300200	RAISED REFLECTIVE PAVEMENT MARKER REMOVAL	EACH	75	75
	78300202	PAVEMENT MARKING REMOVAL - WATER BLASTING	SQ FT	6406	6406
*	85000200	MAINTENANCE OF EXISTING TRAFFIC SIGNAL INSTALLATION	EACH	2	2
*	85000500	MAINTENANCE OF EXISTING FLASHING BEACON INSTALLATION	EACH	4	4
*		REBUILD EXISTING HANDHOLE TO HEAVY-DUTY HANDHOLE DETECTOR LOOP REPLACEMENT	EACH FOOT	1 141	1 141
	X0325446	SHOULDER INLET WITH CURB (4 FT SHOULDER) TEMPORARY VIDEO DETECTION	EACH EACH	4	4 1
*	SPECIAL ⁷	<u> </u>	EACH		1

* SPECIALTY ITEM

Primera
80 W. MAXSSON BIVE SUITE 600 CHICAGO IL GOGGI - P-312-405-4013 F-312-405-4013

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STATE OF ILLINOIS
DEPARTMENT OF TRANSPORTATION


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	IL 83 OVER US 45							2021-005-BR	соок	52	4
d			IL 03 0	VEII O	7.7				CONTRACT	NO. 62	2N34
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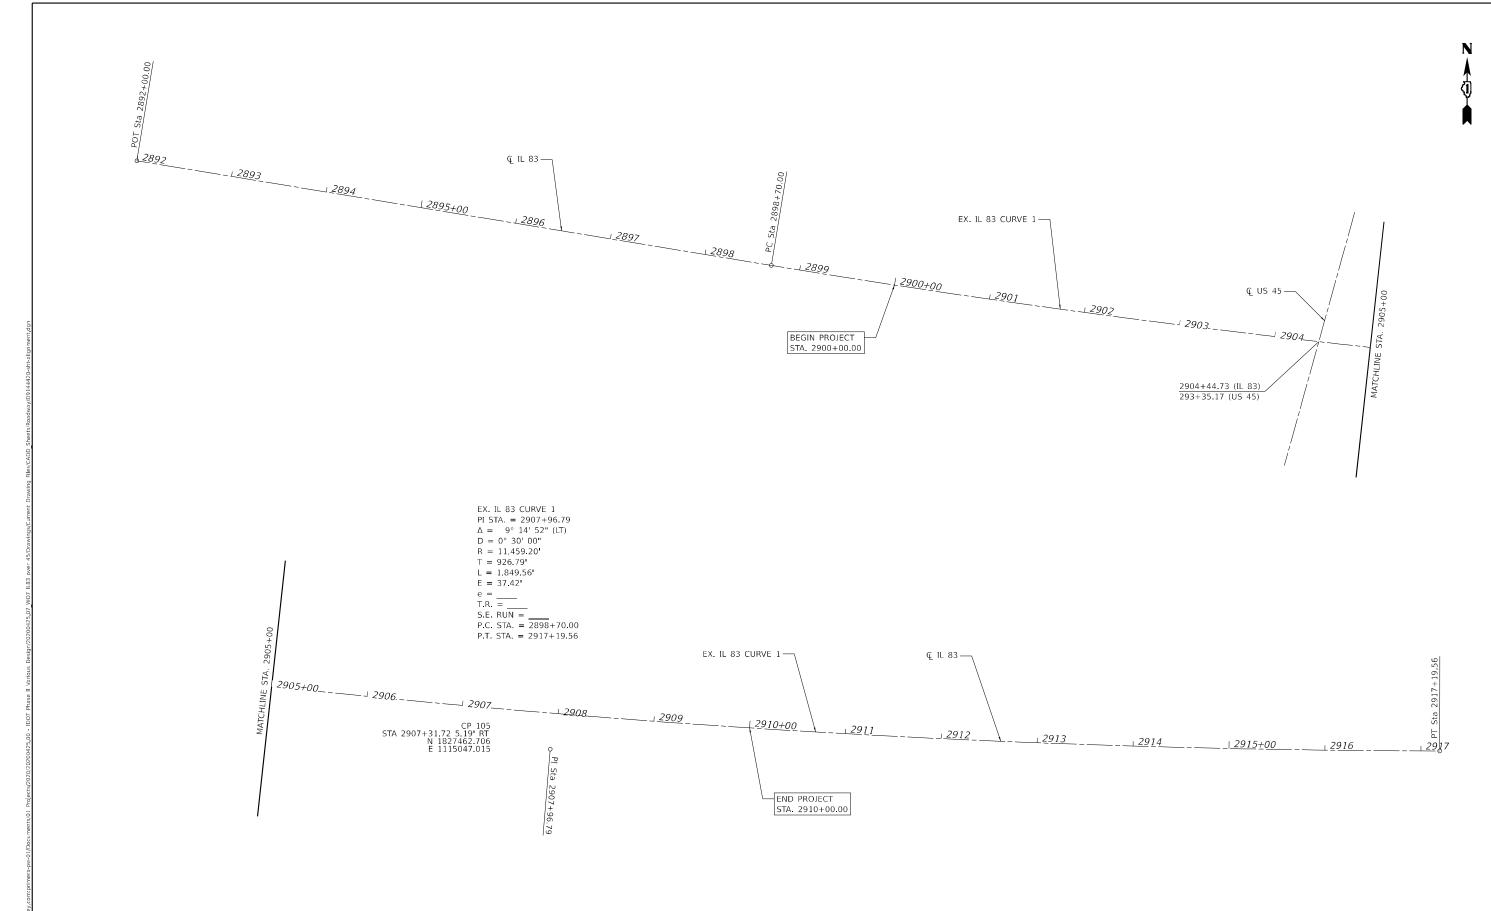
					0059 80% FED 20% STATE
	CODE NO.	ITEM	UNIT	TOTAL QUANT I TY URBAN	IL 83 SN 016-2553
	X5030250	BRIDGE DECK GROOVING (LONGITUDINAL)	SQ YD	1098	1098
	X6333500	TRAFFIC BARRIER TERMINAL REMOVAL	EACH	4	4
2)	X6700407	ENGINEER'S FIELD OFFICE, TYPE A (D1)	CAL MO	12	12
	X7010216	TRAFFIC CONTROL AND PROTECTION, (SPECIAL)	L SUM	1	1
	Z0004552	APPROACH SLAB REMOVAL	SQ YD	214	214
	Z0006016	BRIDGE DECK LATEX CONCRETE OVERLAY, 2 3/4 INCHES	SQ YD	1247	1247
	Z0012130	BRIDGE DECK SCARIFICATION 3/4"	SQ YD	1247	1247
2	Z0012754	STRUCTURAL REPAIR OF CONCRETE (DEPTH EQUAL TO OR LESS THAN 5 INCHES)	SQ FT	8	8
	Z0013798	CONSTRUCTION LAYOUT	L SUM	1	1
	Z0016200	DECK SLAB REPAIR (PARTIAL)	SQ YD	17	17
	Z0029090	DIAMOND GRINDING (BRIDGE SECTION)	SQ YD	1792	1792
		TEMPORARY INFORMATION SIGNING	SQ FT	51.4	51.4
Ø	Z0073510 Z0076600	TEMPORARY TRAFFIC SIGNAL TIMING TRAINEES	EACH HOURS	500	2 500
Ø	Z0076600 Z0076604	TRAINEES - TRAINING PROGRAM GRADUATE	HOURS	500	500
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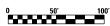
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								52		
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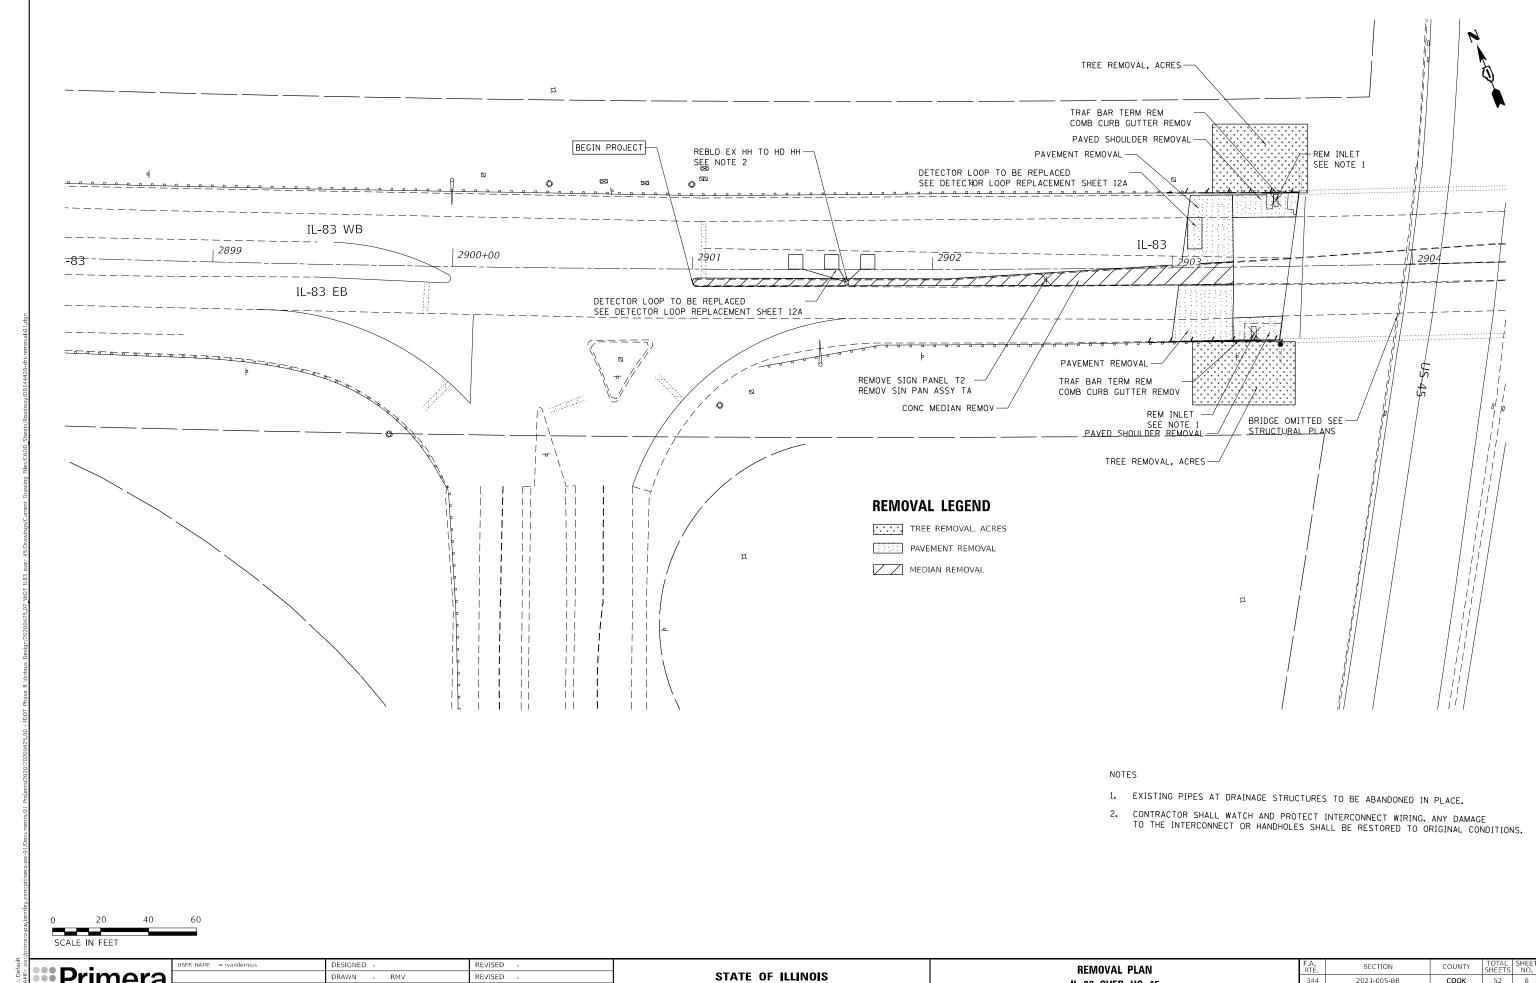


NAME: pv	Primera	
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5	PLOT DATE = 12/17/2021	DATE -	REVISED -

STATE OF	ILLINOIS
DEPARTMENT OF T	RANSPORTATION

ALIGNMENT PLAN					F.A. RTE	SECTION	COUNTY	TOTAL SHEETS	SHEET NO.	
IL 83 OVER US 45				344	2021-005-BR	соок	52	7		
		IL 03 (VEII O	J 7J				CONTRACT	NO. 6	2N34
	SHEET 7	OF 52	SHEETS	STA.	TO STA.		ILLINOIS FE	D. AID PROJECT		

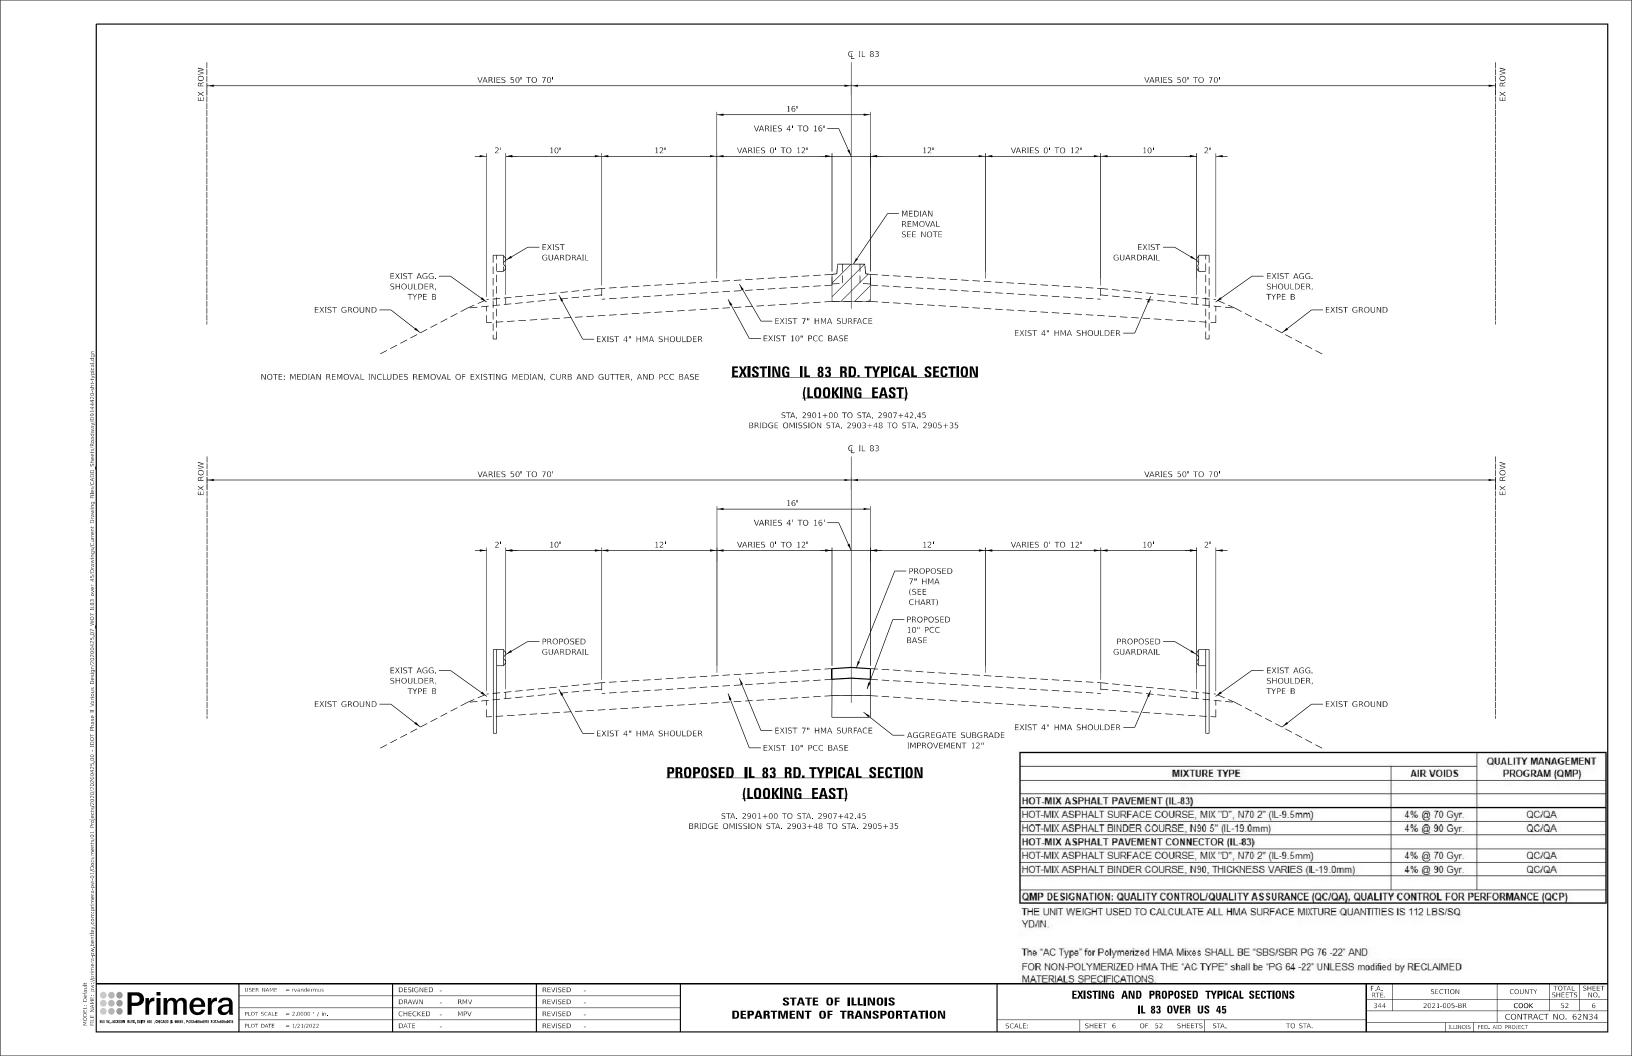


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DEPARTMENT OF TRANSPORTATION


COOK 52 8 2021-005-BR IL 83 OVER US 45 CONTRACT NO. 62N34 SHEET 8 OF 52 SHEETS STA. TO STA.





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STATE OF ILLINOIS
DEPARTMENT OF TRANSPORTATION
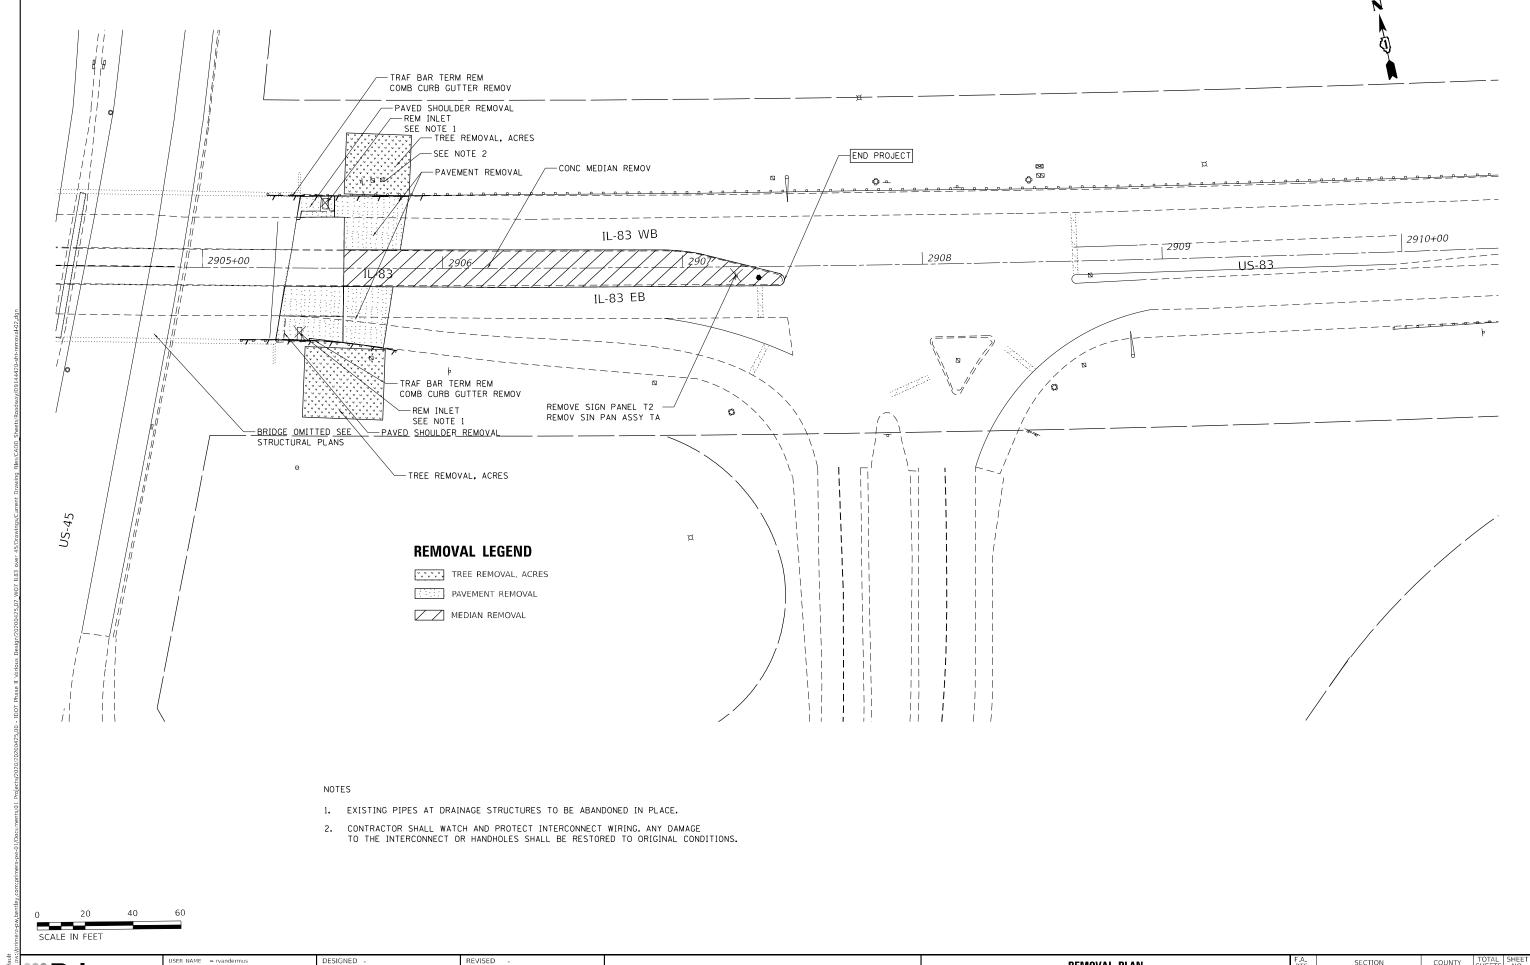
| REMOVAL PLAN | F.A. | SECTION | COUNTY | TOTAL | SHEET | SECTION | COUNTY | SHEET | SOURCE | STALE | SHEET | STALE | SECTION | COUNTY | TOTALE | SHEET | STALE | SHEET | STALE | SHEET | STALE | SECTION | COUNTY | TOTALE | SHEET | STALE | STALE | SHEET | STALE | STALE | STALE | SHEET | STALE |



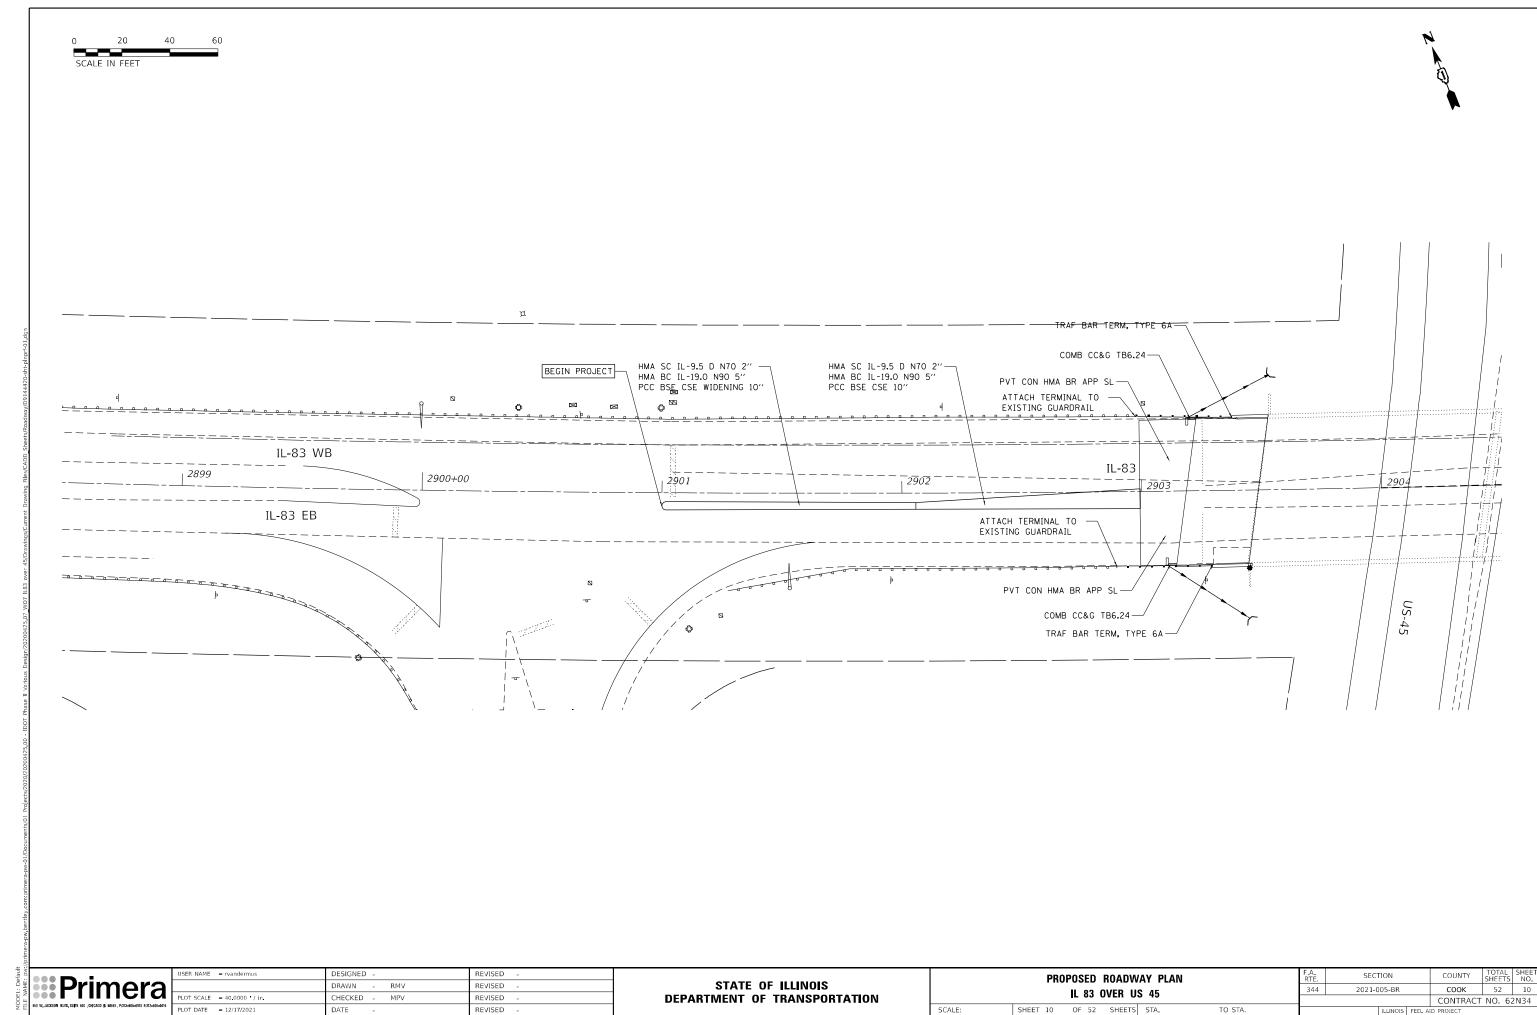


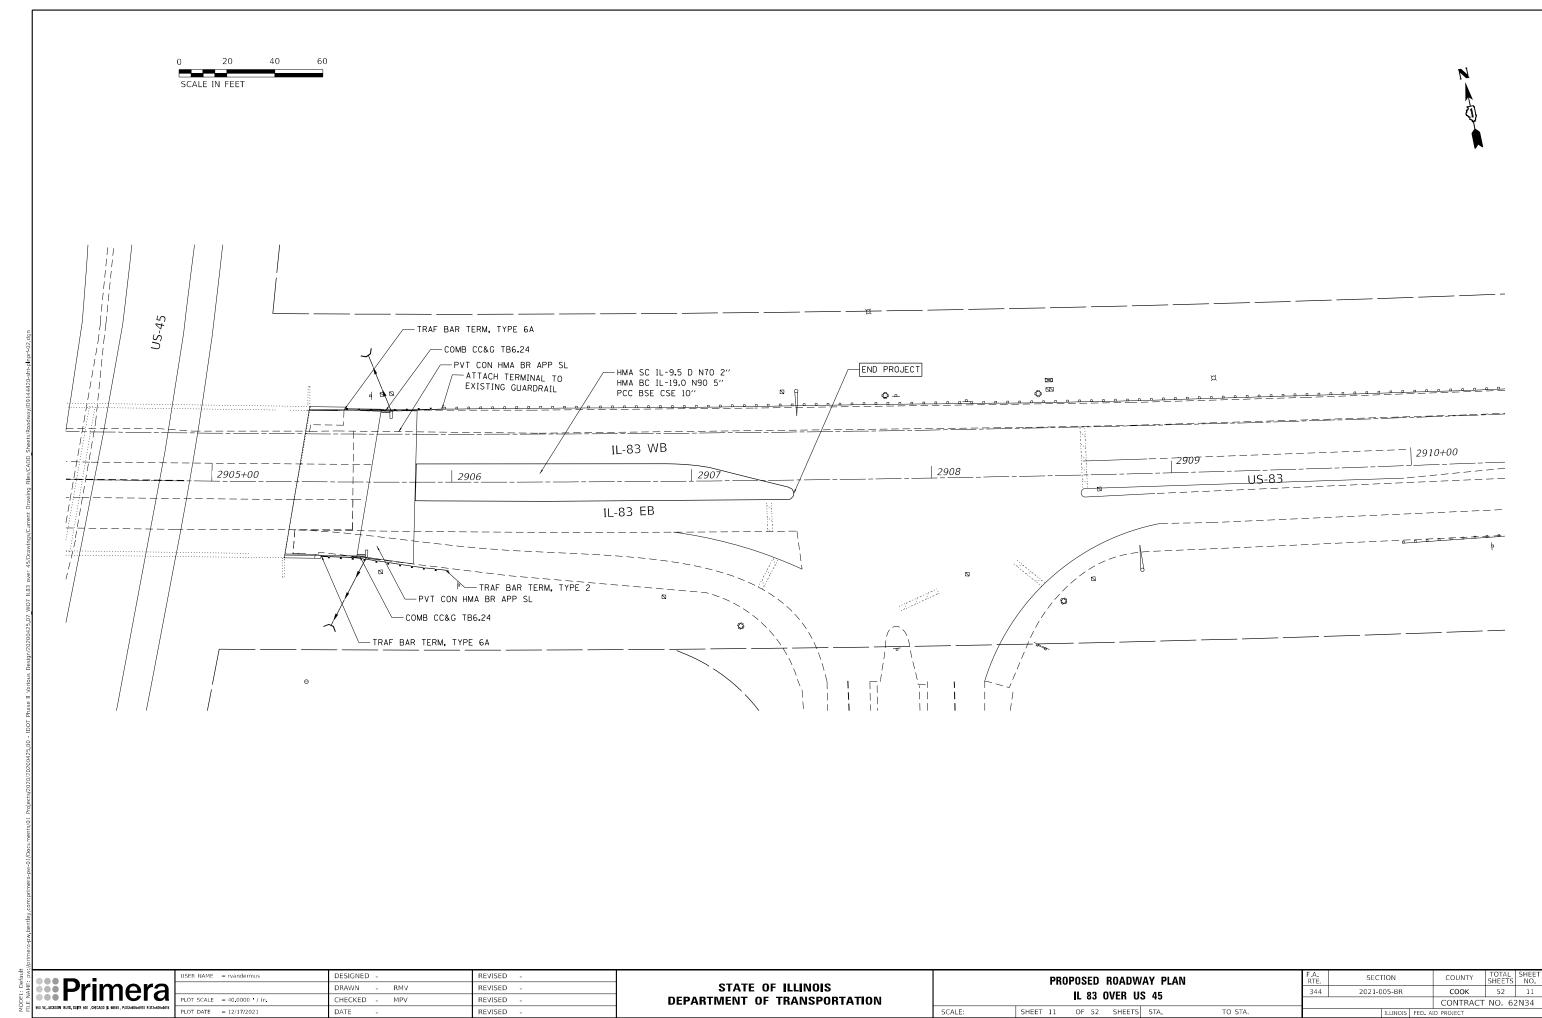

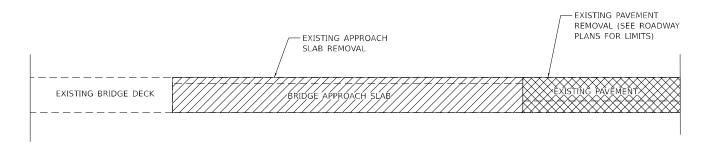1/4"


BUTT JOINT AND HMA TAPER DETAIL (EXISTING)

SEE IDOT STANDARD 420406 FOR ADDITIONAL DETAILS

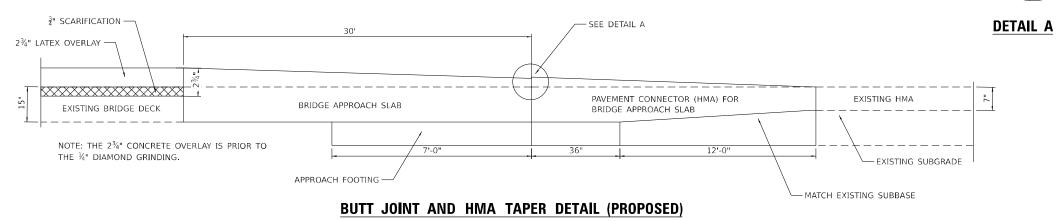


SEE IDOT STANDARD 420406 FOR ADDITIONAL DETAILS

WEST HMA CONNECTOR ELEVATIONS

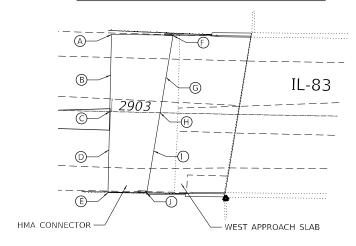

	STATION	OFFSET	ELEVATION BEFORE DIAMOND GRINDING	FINAL ELEVATION
Α	2902+99.19	30.0 LT	610.63	610.61
В	2902+99.20	20.0 LT	611.21	611.19
С	2902+99.22	0	611.62	611.60
D	2902+99.24	20.0 RT	611.17	611.15
E	2902+99.25	30.0 RT	610.80	610.78
F	2903+53.49	30.0 LT	611.84	611.82
G	2903+51.86	20.0 LT	612.03	612.01
Н	2903+48.61	0	612.45	612.43
I	2903+45.36	20.0 RT	611.95	611.93
J	2903+43.73	30.0 RT	611.83	611.81

EAST HMA CONNECTOR ELEVATIONS

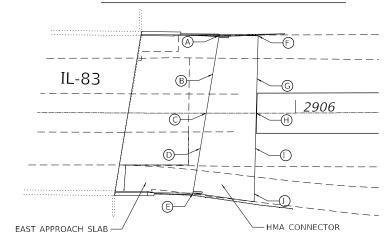


	STATION	OFFSET	ELEVATION BEFORE DIAMOND GRINDING	FINAL ELEVATION
Α	2905+40.36	30.0 LT	611.92	611.90
В	2905+38.73	20.0 LT	612.09	612.07
С	2905+35.48	0	612.47	612.45
D	2905+32.23	20.0 RT	612.11	612.09
Е	2905+30.60	30.0 RT	611.97	611.95
F	2905+85.52	30.0 LT	610.86	610.84
G	2905+85.32	20.0 LT	611.25	611.23
Н	2905+84.82	0	611.87	611.85
I	2905+84.34	20.0 RT	611.39	611.37
J	2905+84.10	30.0 RT	611.21	611.19

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1	550 W. JACKSON BLVD, SUITE 600 , CHICAGO IL 60661 , P:312-606-0910 P:312-606-0415	Г

USER NAME = \$USER\$	DESIGNED -	REVISED -
	DRAWN -	REVISED -
PLOT SCALE = \$SCALE\$	CHECKED -	REVISED -
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STATE OF ILLINOIS	
DEPARTMENT OF TRANSPORTATION	ı

HMA P	AVEMEN	IT CONN	ECTOR	DETAIL		F.A. RTE	SEC ⁻	ПОИ		COUNTY	TOTAL SHEETS	SHEET NO.
											52	12
										CONTRACT	NO.	
SHEET	OF	SHEETS	STA.		TO STA.			ILLINOIS	FED. AI	D PROJECT		

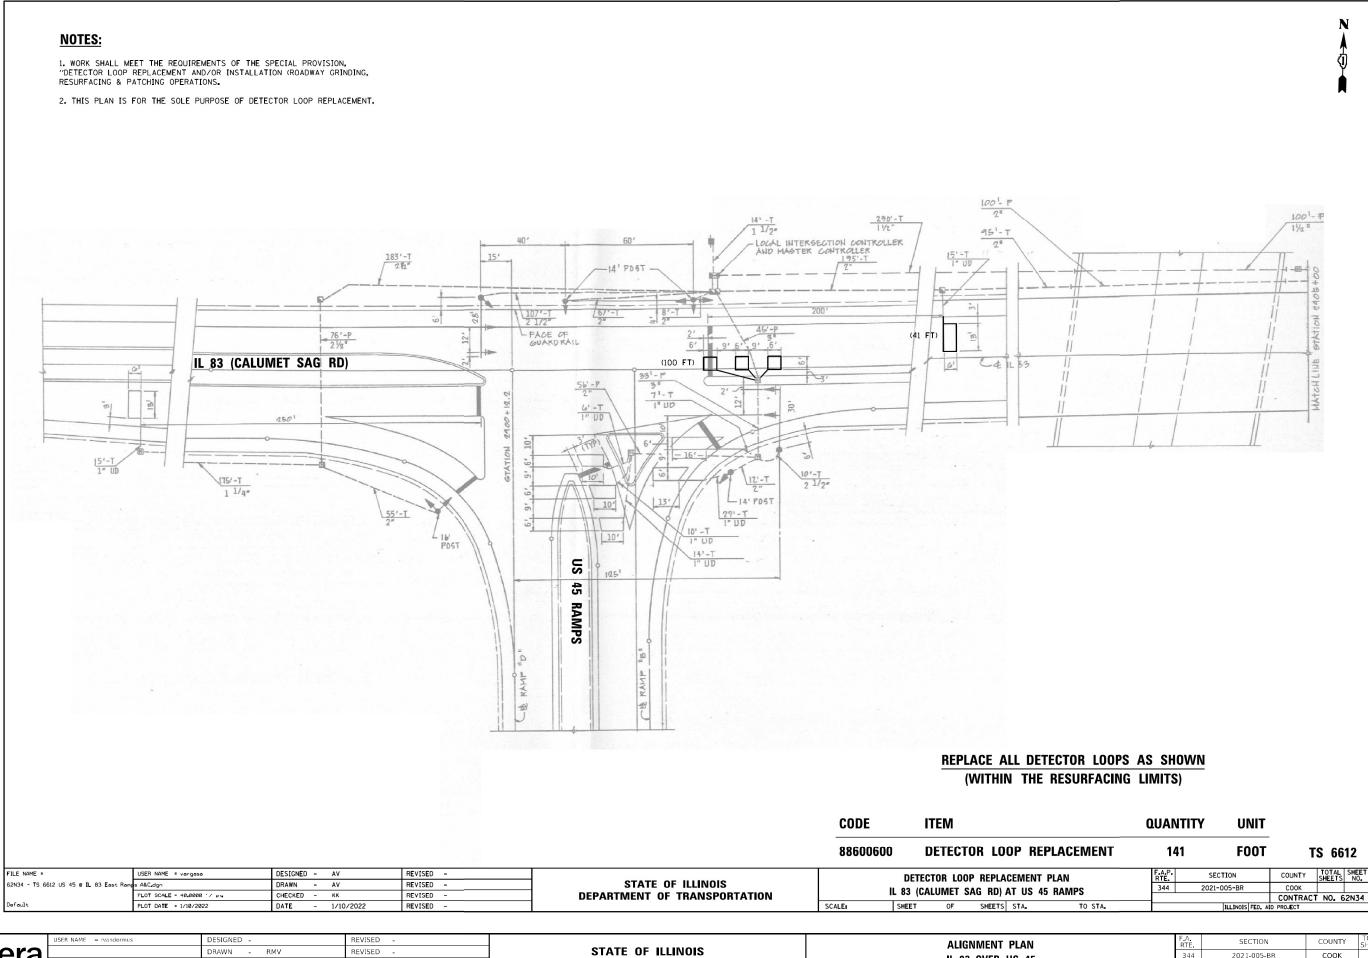

DEPARTMENT OF TRANSPORTATION

COOK 52 12A

CONTRACT NO. 62N34

2021-005-BR

IL 83 OVER US 45

TO STA.

SHEET 12A OF 52 SHEETS STA.

LOT DATE = 1/21/2022


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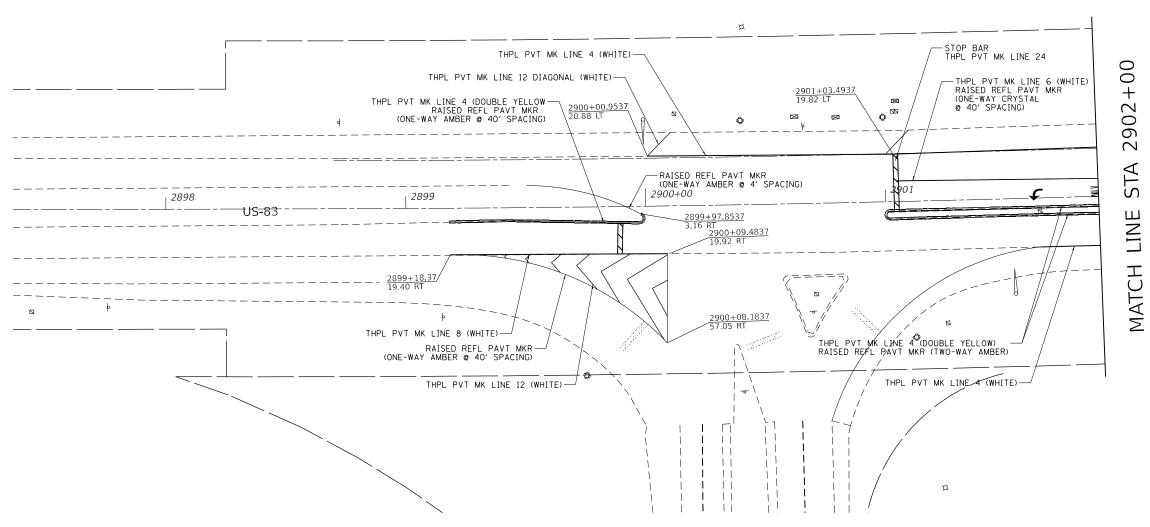
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REVISED







NOTE: FOLLOW IDOT STANDARD 781001-04 FOR RAISED REFLECTIVE PAVEMENT MARKER SPACING DETAILS

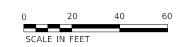
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W. AGESON BLUT, SUITE 600 , CRICAGO R. 60011 , PATA-600-4010 PATA-600-4015

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415	PLOT DATE = 12/17/2021	DATE -	REVISED -

STATE	E OF	ILLINOIS
DEPARTMENT	OF	TRANSPORTATION

					F.A.	SECT	ION	
PA	VEMENT	RTE.	RTE. SECTION					
	IL 83 (344	2021-00	05-BR				
	IL 03 (VLN U	3 43					
HEET 13	OF 52	SHEETS	STA.	TO STA.			ILLINOIS	FEE

F.A. RTE	SECTION	COUNTY	TOTAL SHEETS	SHE	
344	2021-005-BR	соок	52	1	
			CONTRACT	NO. 62	2N3
	ILLINOIS	FED. A	ID PROJECT		

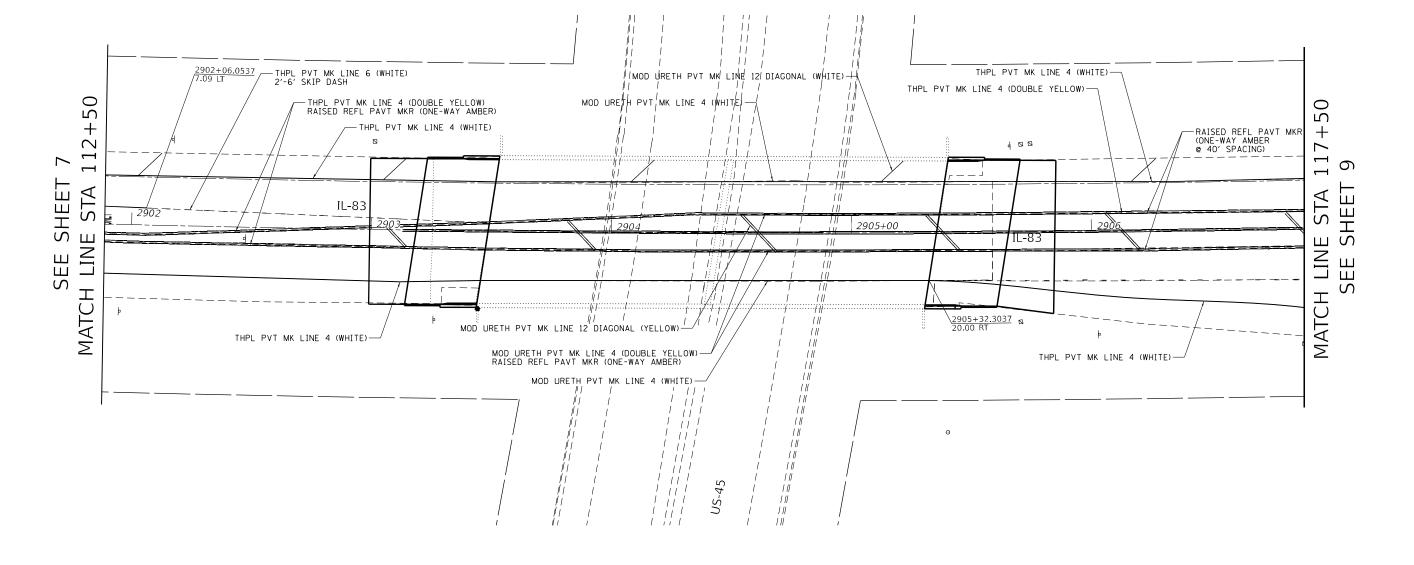


NOTE: FOLLOW IDOT STANDARD 781001-04 FOR RAISED REFLECTIVE PAVEMENT MARKER SPACING DETAILS


	Primera
550 W.JACKSON	BLVD_SUITE 600 _CHICAGO 1. 60861 _P:312-808-0910 P:312-808-0415

	USER NAME = rvandermus	DESIGNED -	REVISED -
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0415	PLOT DATE = 12/17/2021	DATE -	REVISED -

STATI	E 01	F ILLINOIS
DEPARTMENT	OF	TRANSPORTATION

						F.A. RTE			COUNTY	TOTAL SHEETS	SHEE NO.		
IL 83 OVER US 45					344	2021-005-BR			соок	52	14		
			IL 03	OVEN O	J 7J						CONTRACT	NO. 62	2N34
	SHEET	14	OF 52	SHEETS	STA.	TO STA.			ILLINOIS	FED. A	D PROJECT		

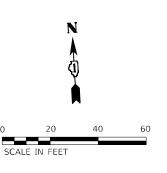

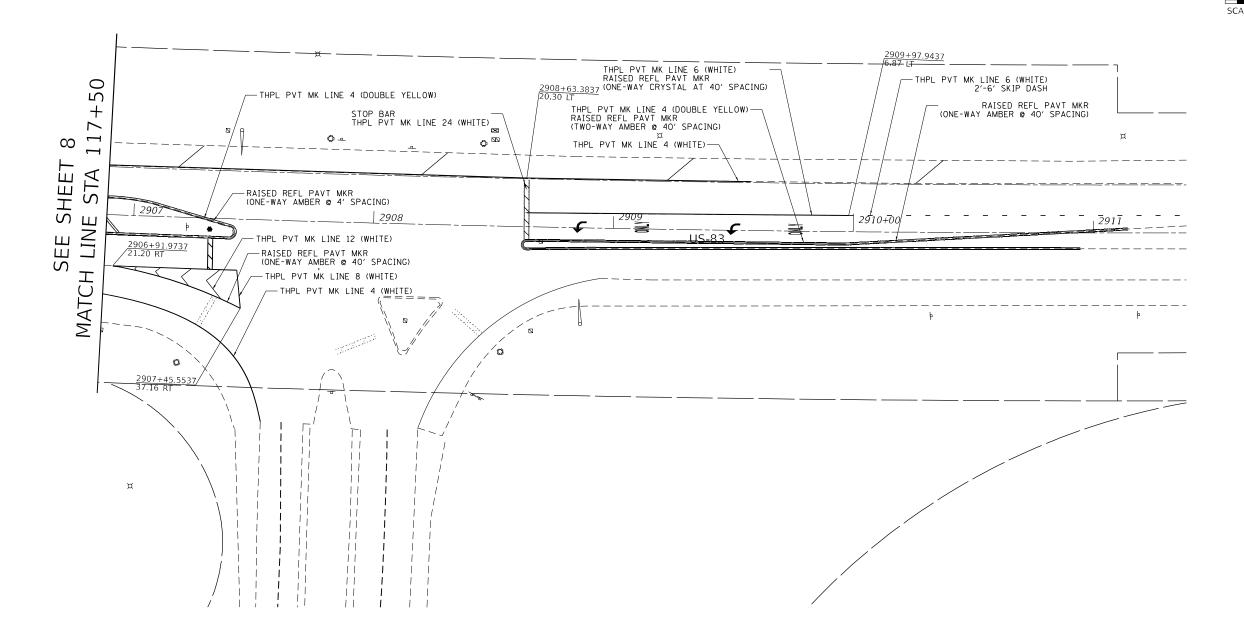


NOTE: FOLLOW IDOT STANDARD 781001-04 FOR RAISED REFLECTIVE PAVEMENT MARKER SPACING DETAILS

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550 W. JACKSON	BLVD_SUITE 600 _CHICAGO 60861 _P:312-608-0910 F:312-608-0415	r

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STATE	OF I	LLINOIS
DEPARTMENT (OF TR	ANSPORTATION

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	PAVEMENT MARKING PLAN					RTE	SECTION		COUNTY	SHEETS	NO
IL 83 OVER US 45					344	2021-005-BR		COOK	52	15	
IL 03 UVEN US 43								CONTRACT	NO. 6	2N34	
	SHEET 15	OF 52	SHEETS	STA.	TO STA.		ILLINOIS	FED. AI	D PROJECT		

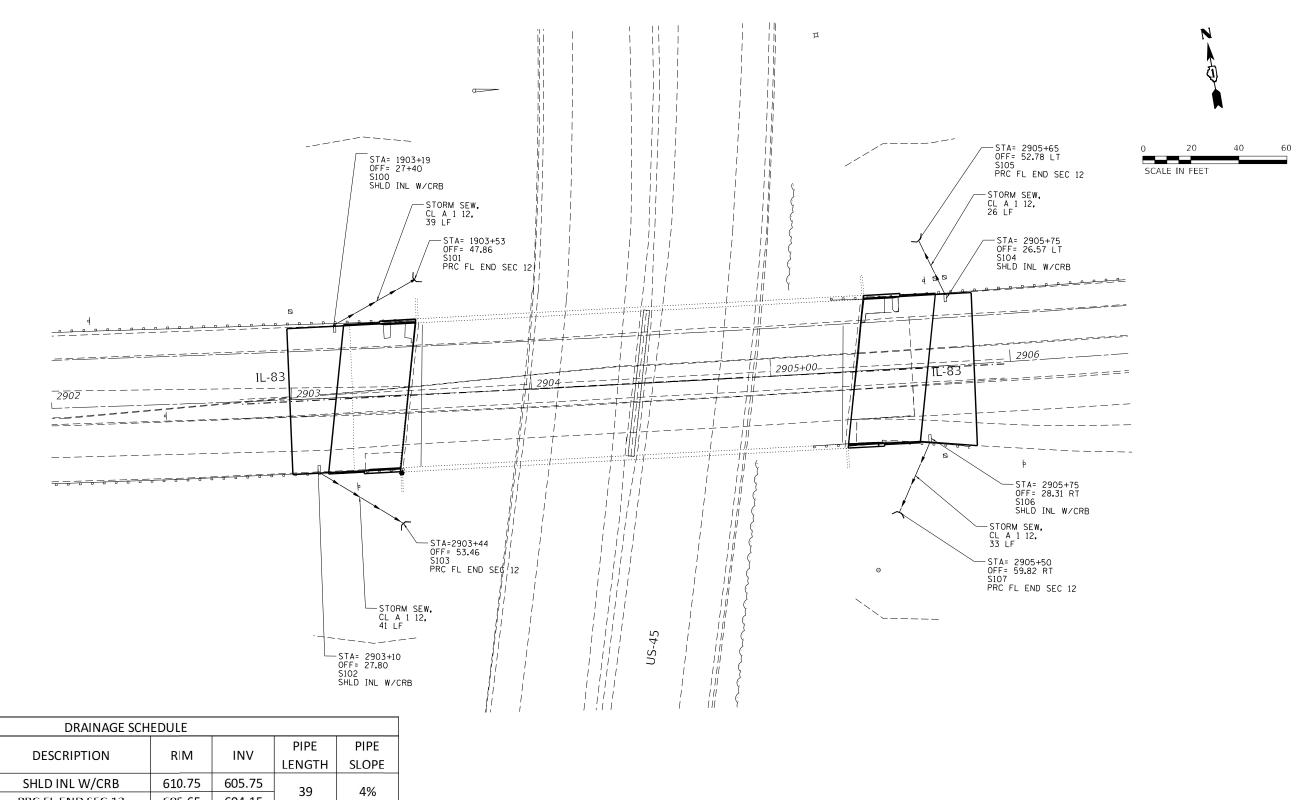

	DRAINAGE SCHEDULE						
STRUCTURE	PAY ITEM	DECEDIATION	RIM	INV	PIPE	PIPE	
NO.	PATITEIVI	DESCRIPTION R		IIV	LENGTH	SLOPE	
S100	X0325446	SHLD INL W/CRB	610.75	605.75	39	4%	
S101	54213657	PRC FL END SEC 12	605.65	604.15	33	470	
S102	X0325446	SHLD INL W/CRB	611.23	606.23	41	7%	
S103	54213657	PRC FL END SEC 12	605.02	603.52	41	7 70	
S104	X0325446	SHLD INL W/CRB	611.23	606.23	26	18%	
S105	54213657	PRC FL END SEC 12	603.16	601.66	20	10%	
S106	X0325446	SHLD INL W/CRB	611.62	606.618	33	17%	
S107	54213657	PRC FL END SEC 12	602.53	601.03	33	1/%	

	Primera
550 W.JACKSON	BLVD_SUITE 600 CHICAGO IL 60861 P:312-608-0910 F:312-608-0415

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	PLOT SCALE = 40.0000 / in.	CHECKED - MPV	REVISED -
DE-0415	PLOT DATE = 12/17/2021	DATE -	REVISED -

STAT	E 01	F ILLINOIS
DEPARTMENT	OF	TRANSPORTATION

DRAINAGE PLAN						F.A. RTE	SECTION		COUNTY	TOTAL SHEETS	SHEET NO.
IL 83 OVER US 45					344	2021-005-BR		соок	52	14	
IL 03 UVLN US 43									CONTRACT	NO. 62	2N34
SHEET	15	OF 52	SHEETS	STA.	TO STA.		ILLINOIS	FED. AI	D PROJECT		


PRE-STAGE TYP. SECTION FOR PROJECT LIMIT


IL-83

MEDIAN REMOVAL WIDTH

STA. 2901+00 TO STA. 2902+06 = 4' STA. 2902+06 TO STA. 2904+35 = 4'-16' STA. 2904+35 TO STA. 2906+89 = 16' STA. 2906+89 TO STA. 2907+40 = 16'-5'

* FROM STA. 2901+02 TO STA. 2902+96 TRAVEL LANE IS REDUCED TO 10' TO ACCOMMODATE LEFT TURN MOVEMENT AT THE INTERSECTION

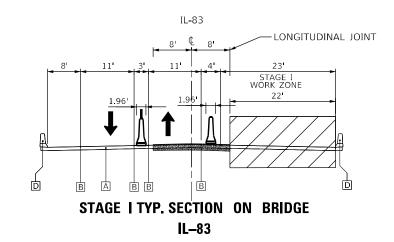

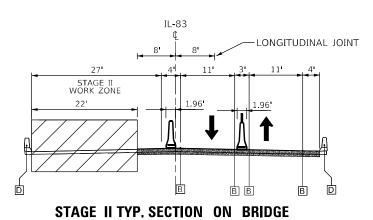

IL-83

LEGEND

- A EXISTING PCC PAVT
- B TEMPORARY PAVEMENT MARKING (FOR DETAILS SEE MOT PLANS)
- © EXISTING CONC MED TY B-6.12
 © EXISTING PARAPET

EXISTING ITEM TO BE REMOVED



TEMPORARY CONCRETE BARRIER WITH MODULAR GLARE SCREEN SYSTEM,TEMPORARY



TEMPORARY CONCRETE BARRIER

COMPLETED PAVEMENT



TYPE II BARRICADE WITH FLASHING LIGHT



WORK AREA


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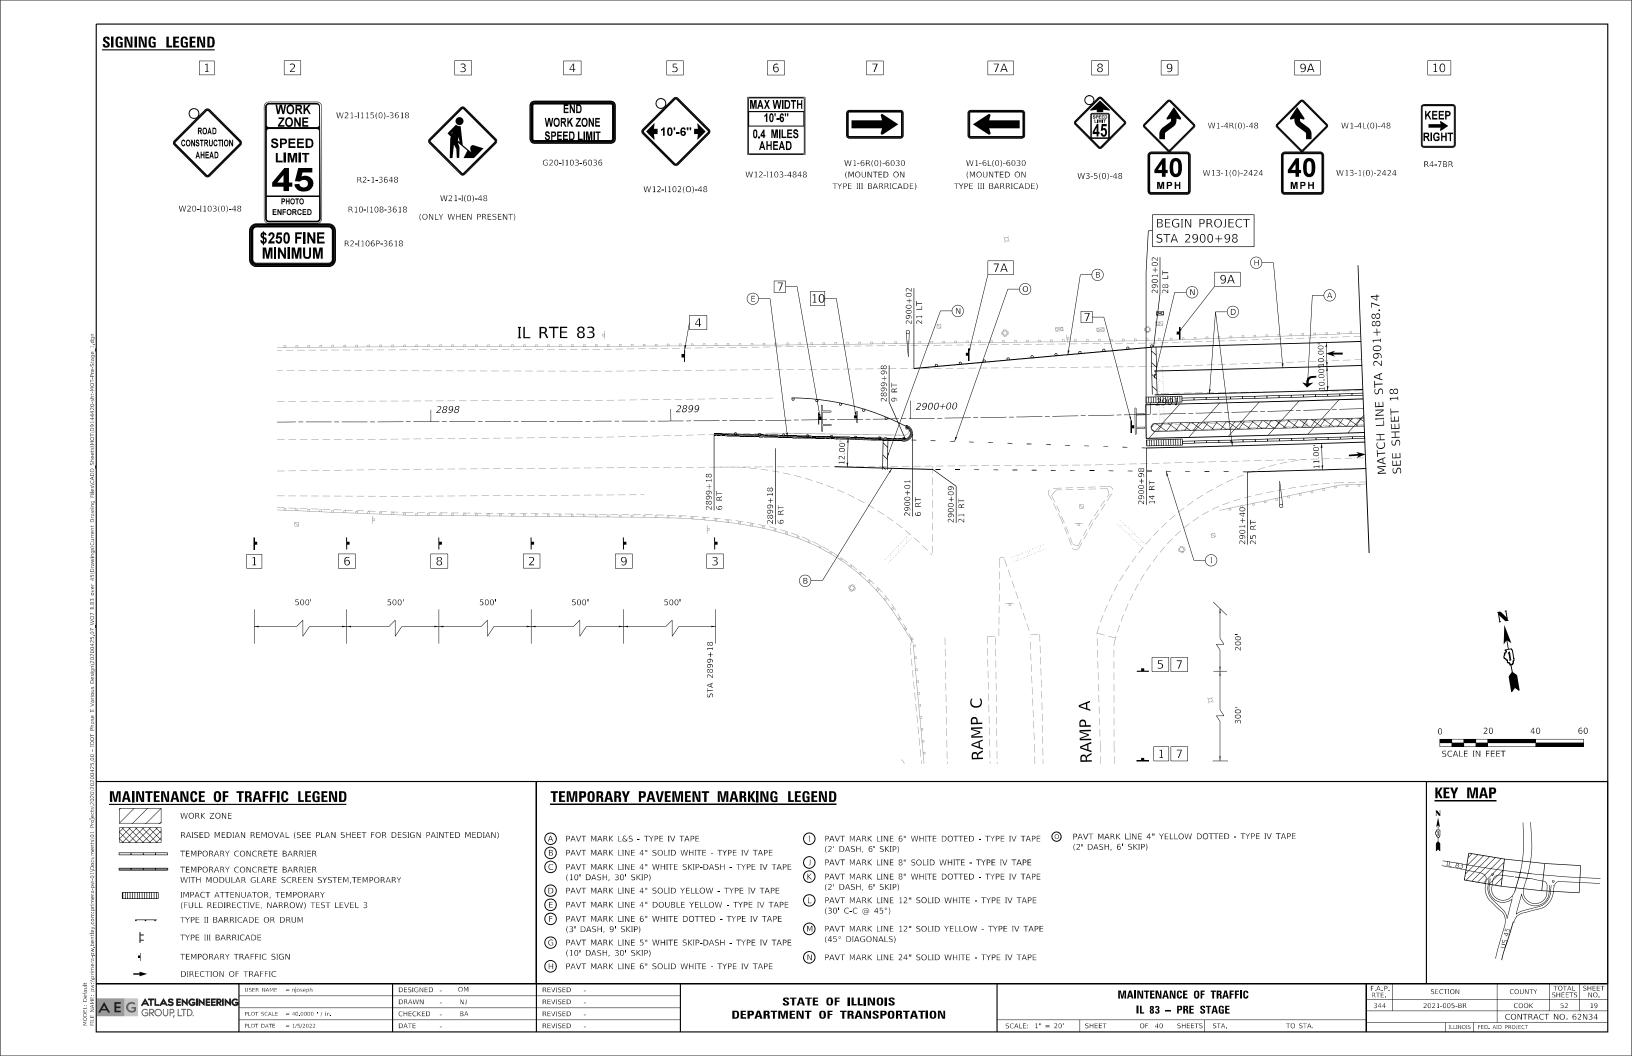
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	PLOT DATE = 1/5/2022	DATE -	REVISED -


STATE OF	ILLINOIS
DEPARTMENT OF T	TRANSPORTATION

SCALE: 1" = 20'

					F.A.P. RTE	SECTION		COUNTY	TOTAL SHEETS	SHEET NO.
					344	2021-005-BR		COOK	52	17
IL 03 - ITFIGAL SECTIONS								CONTRAC	T NO. 62	2N34
	SHEET	OF 40 SHEET	STA.	TO STA.		ILLINOIS	FED. AI	D PROJECT		




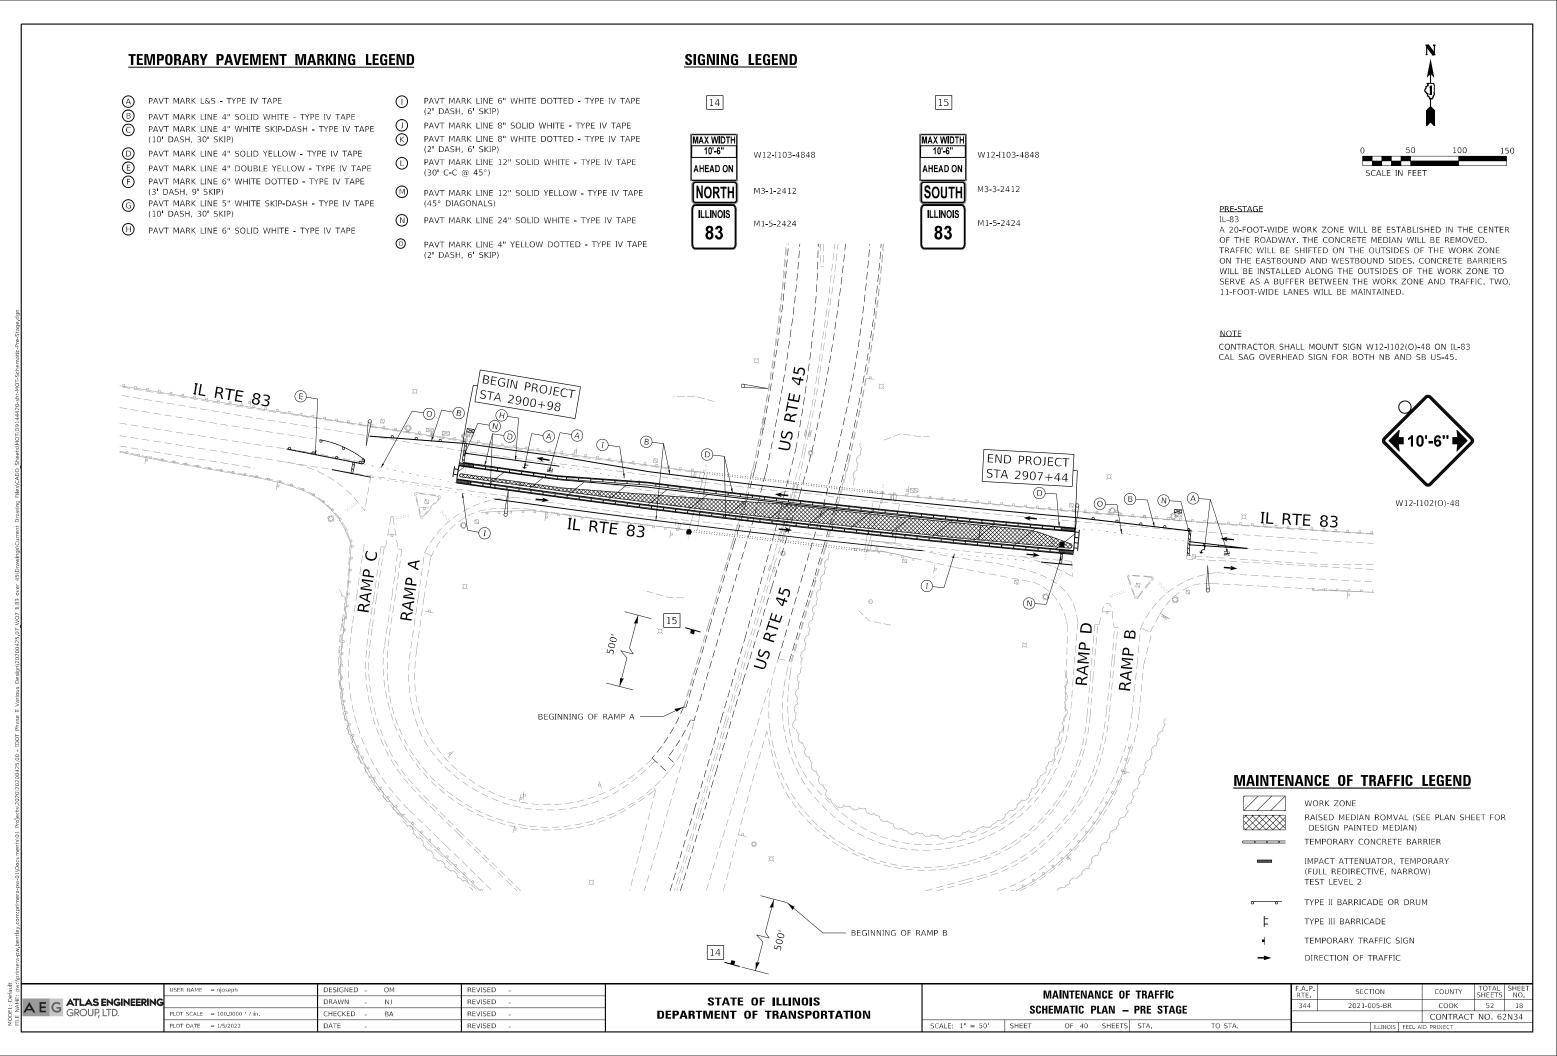


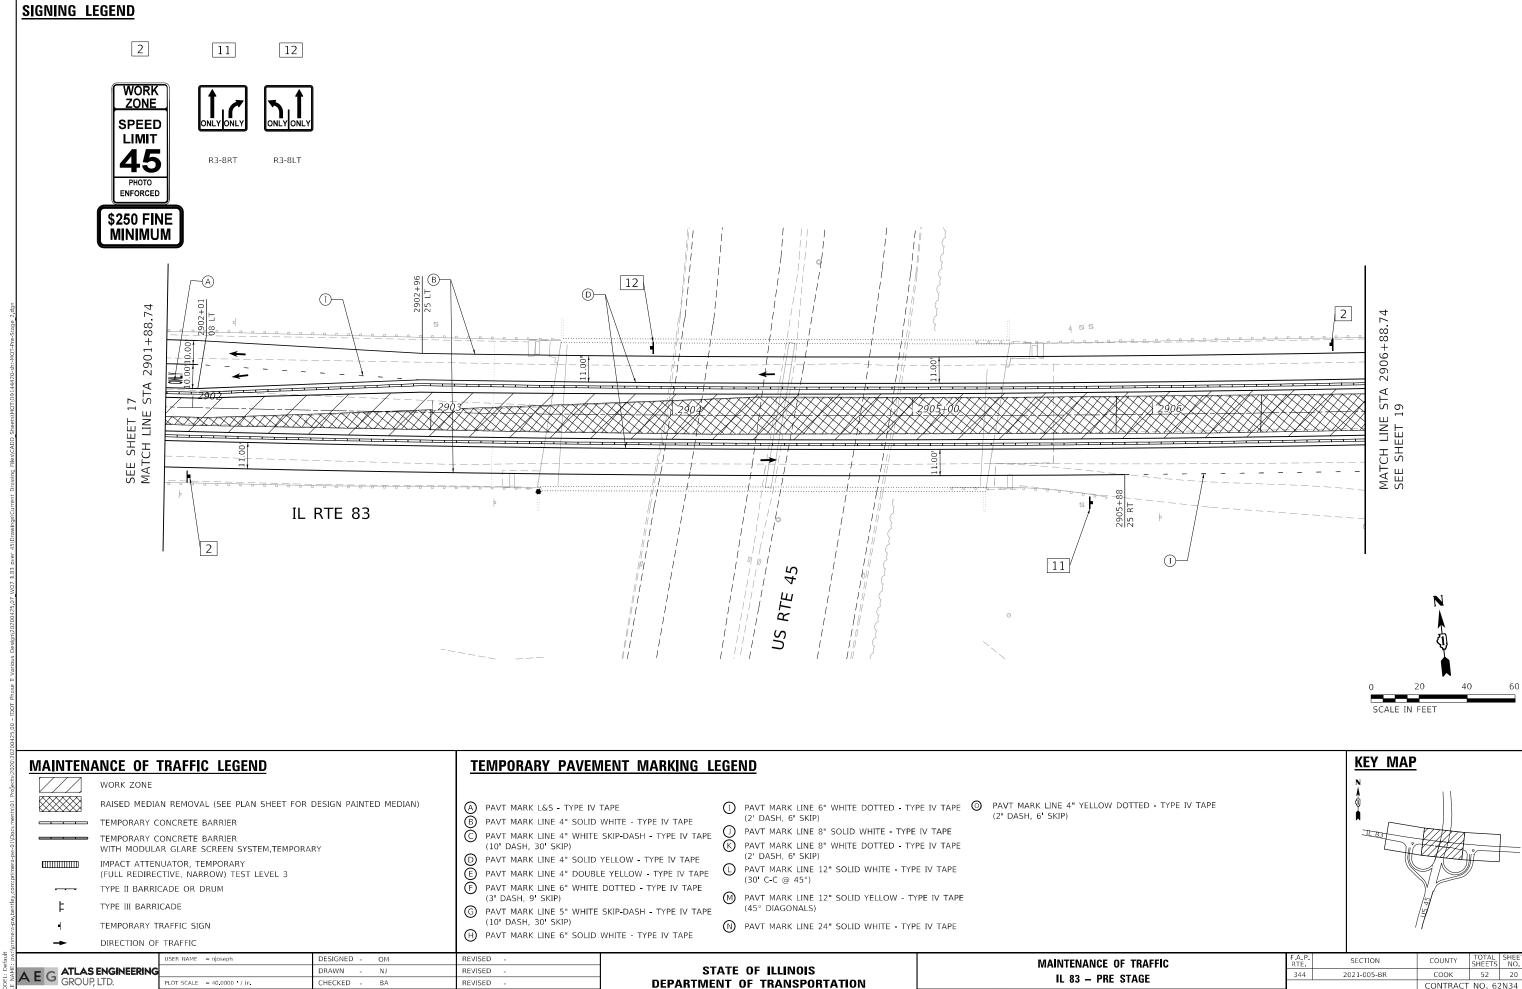



SCALE: 1" = 20' SHEET 22 OF 40 SHEETS STA.


CONTRACT NO. 62N34

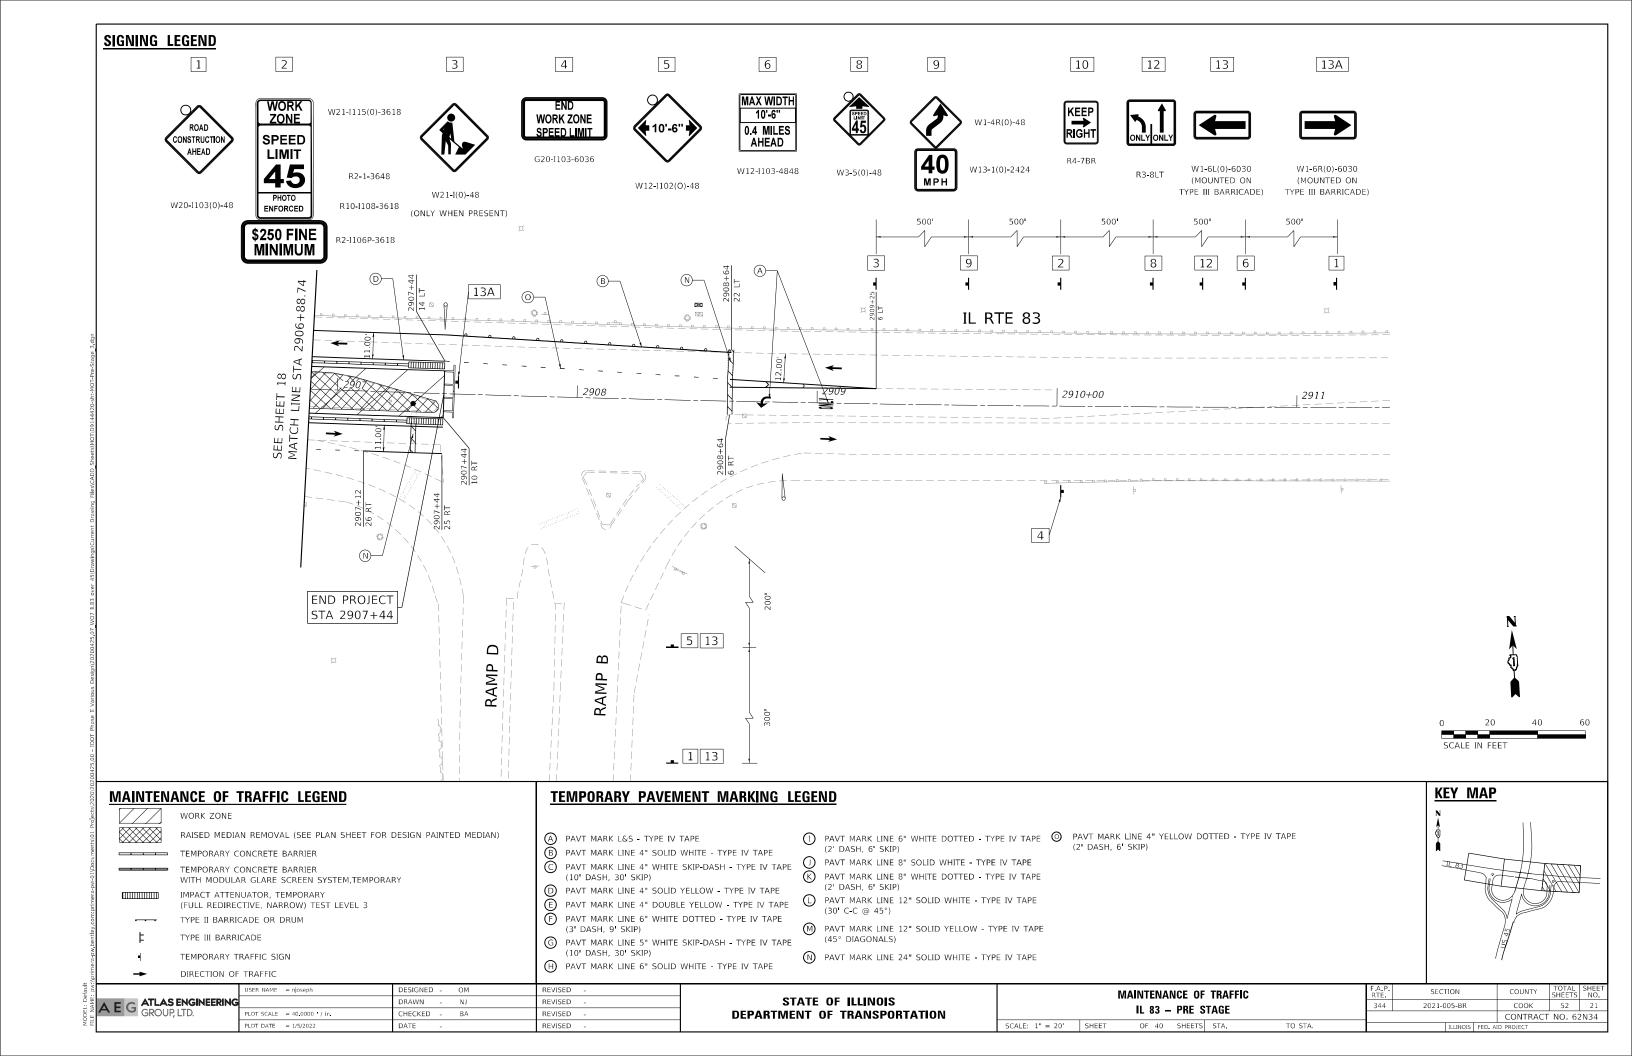


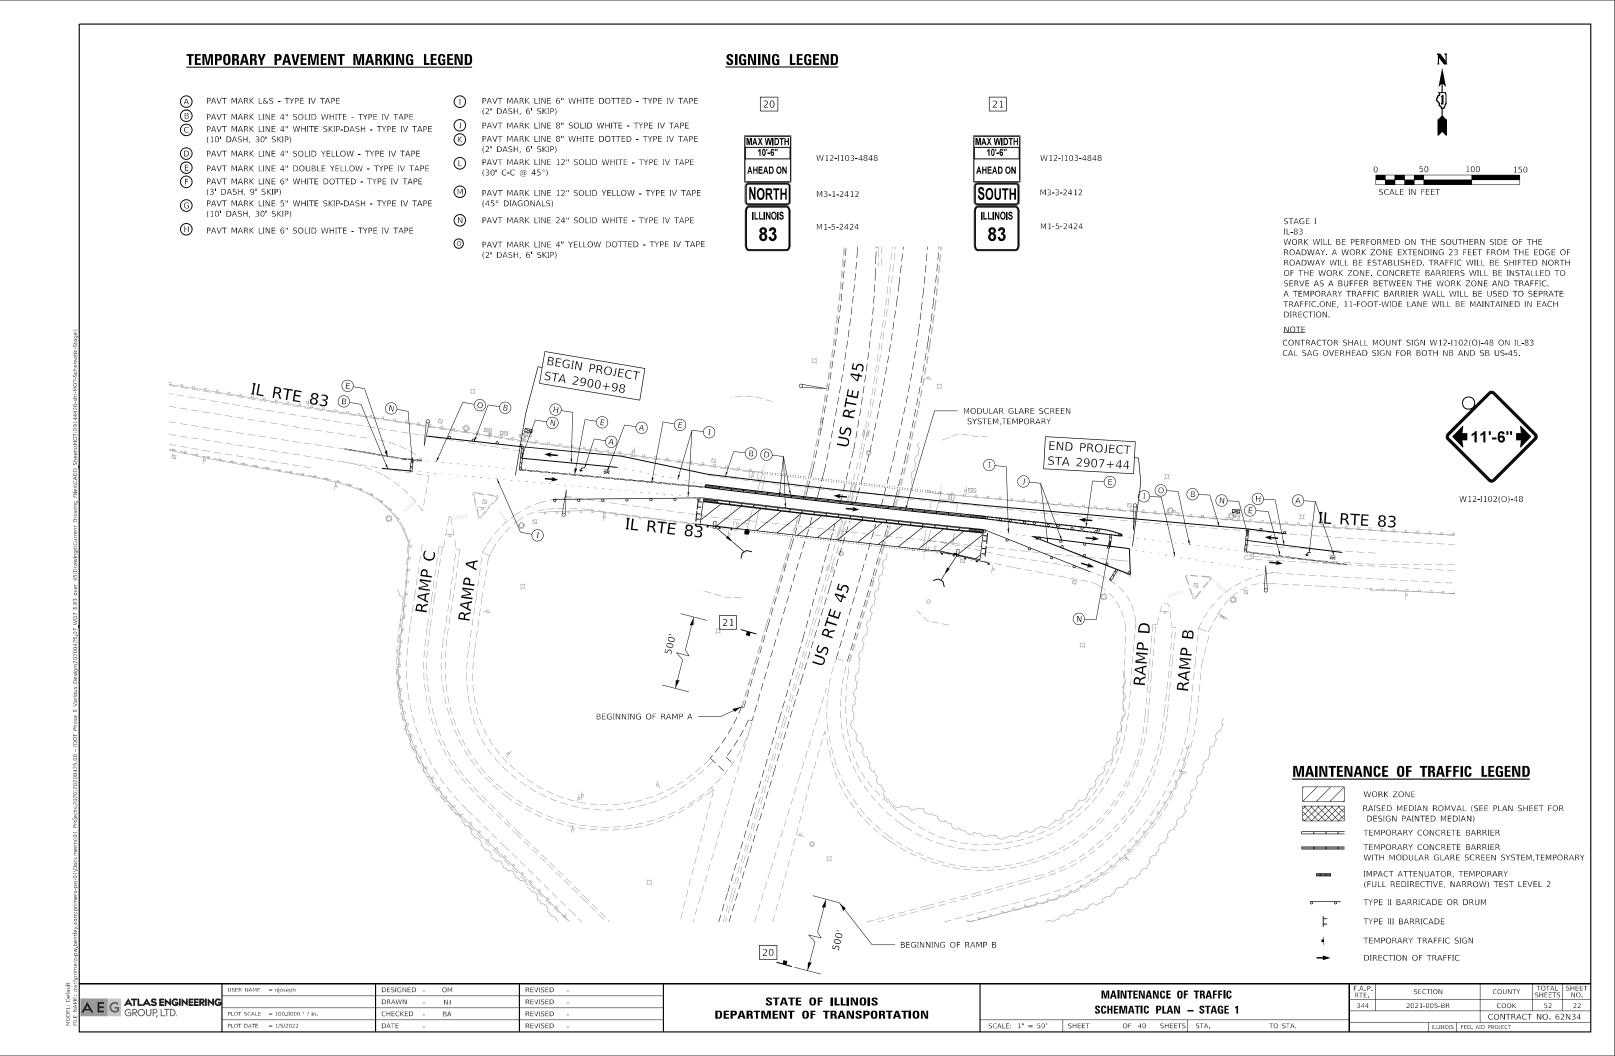


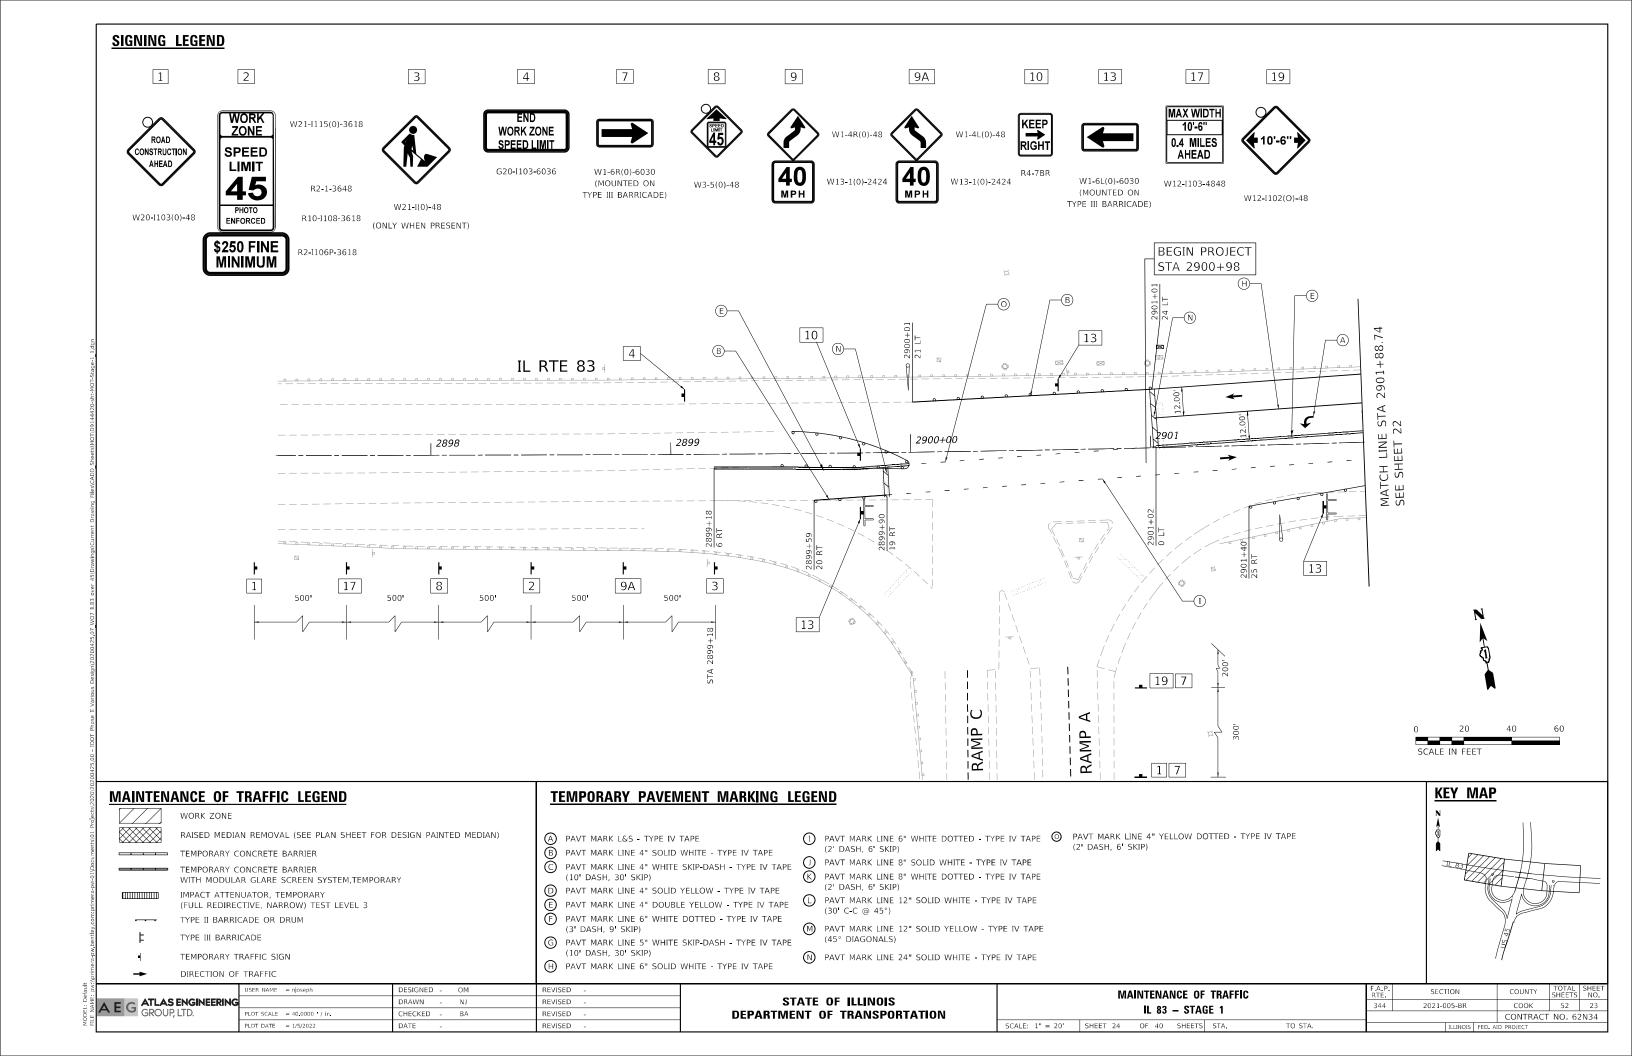


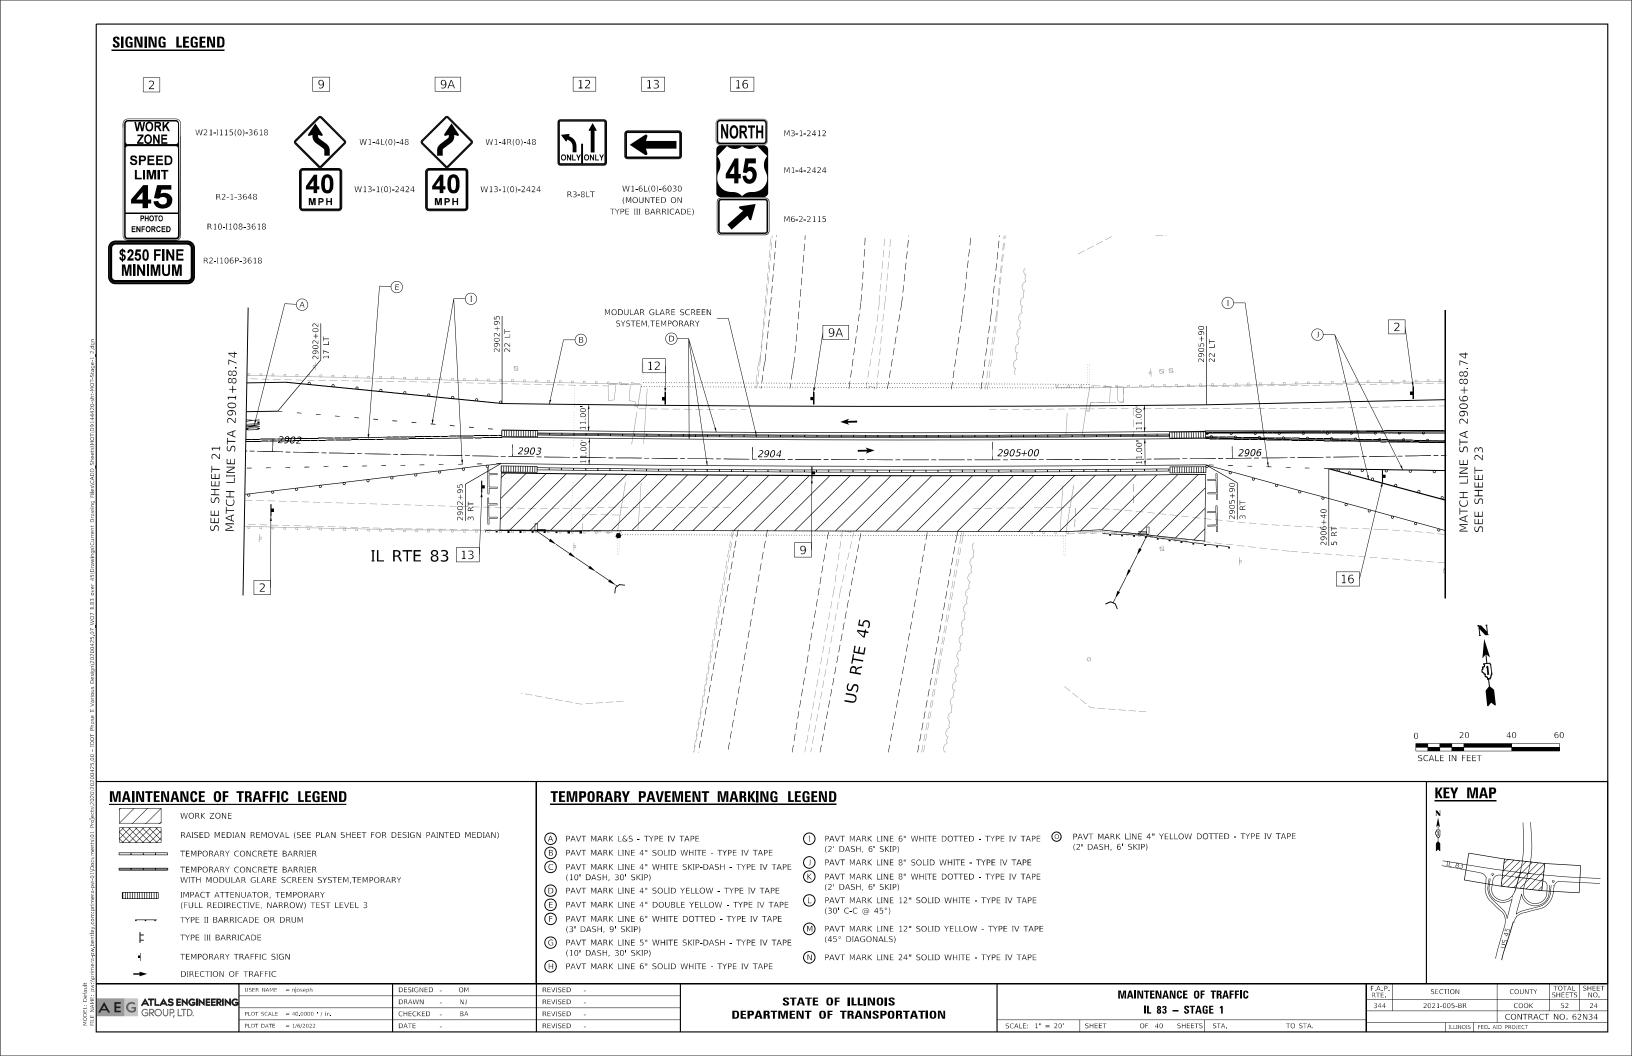


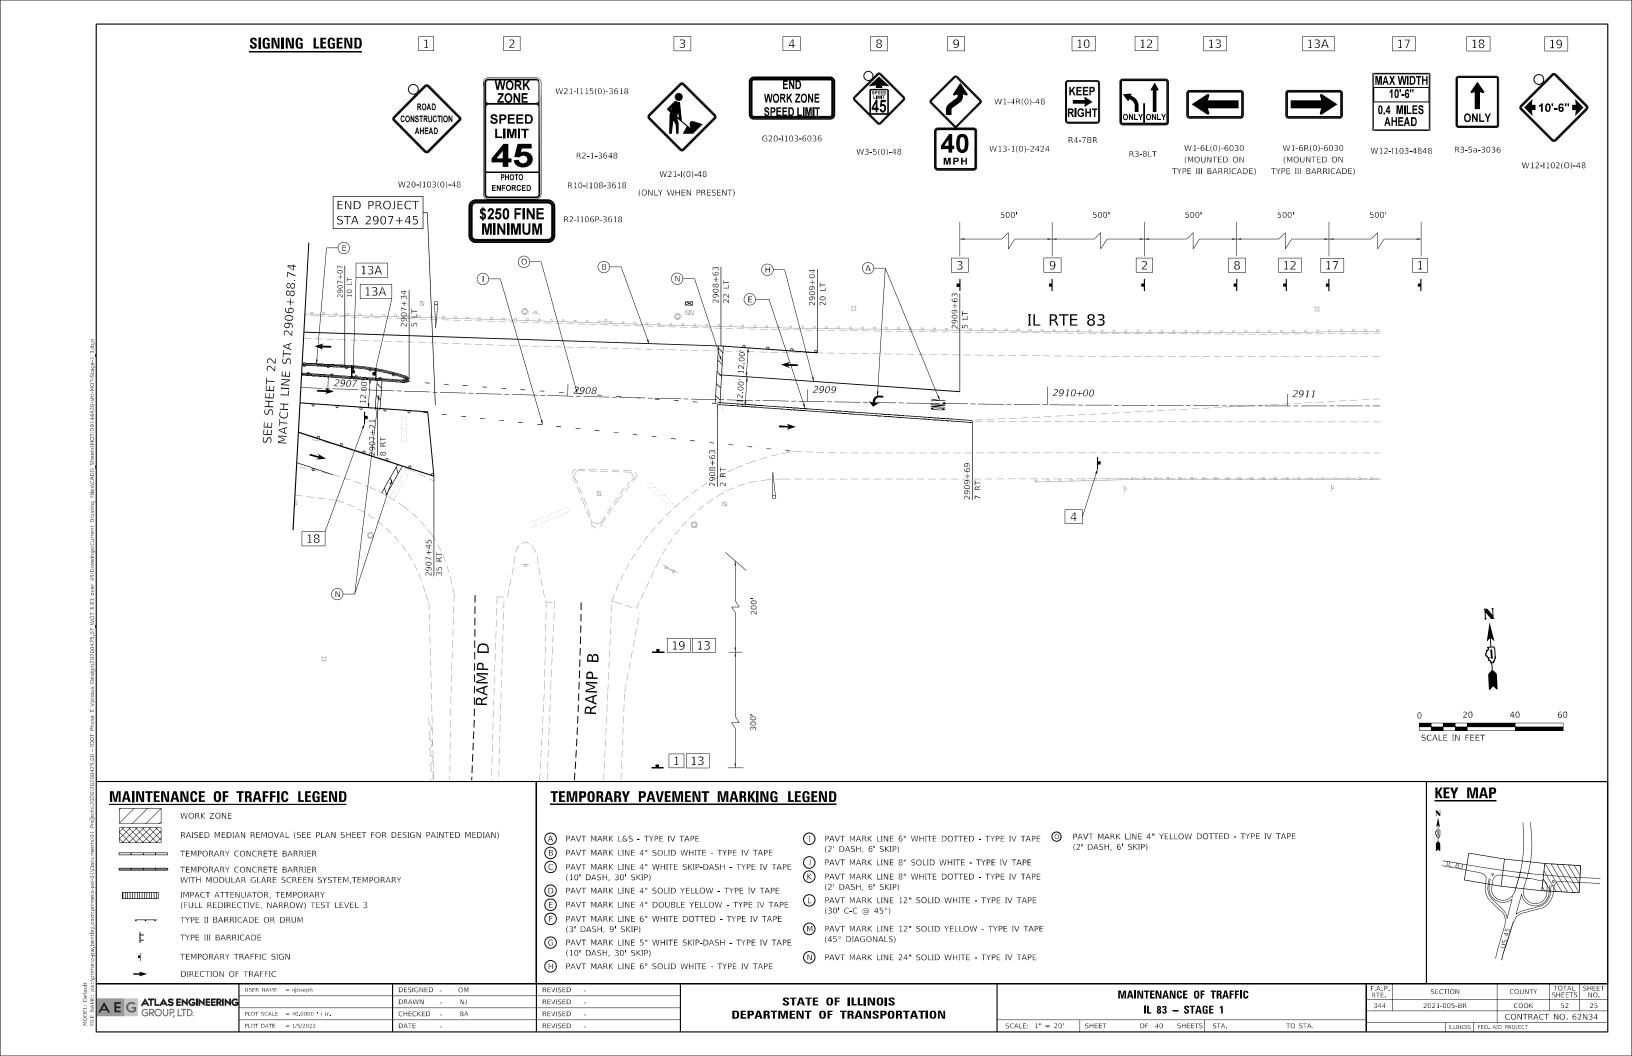


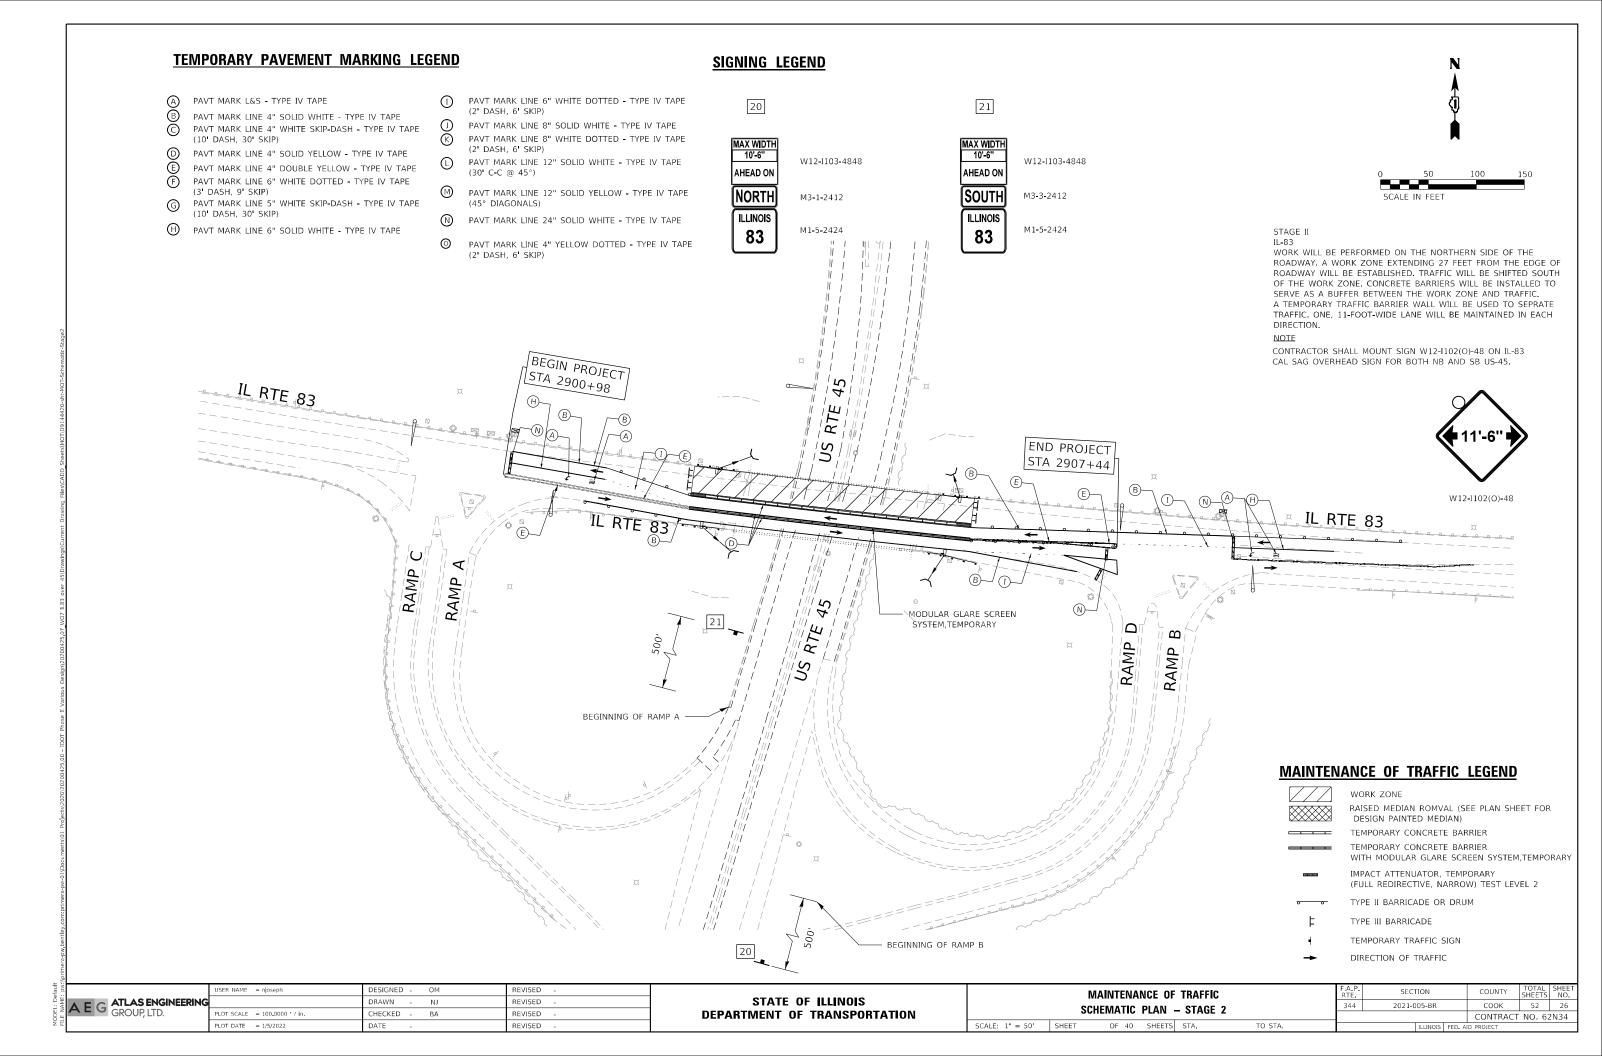

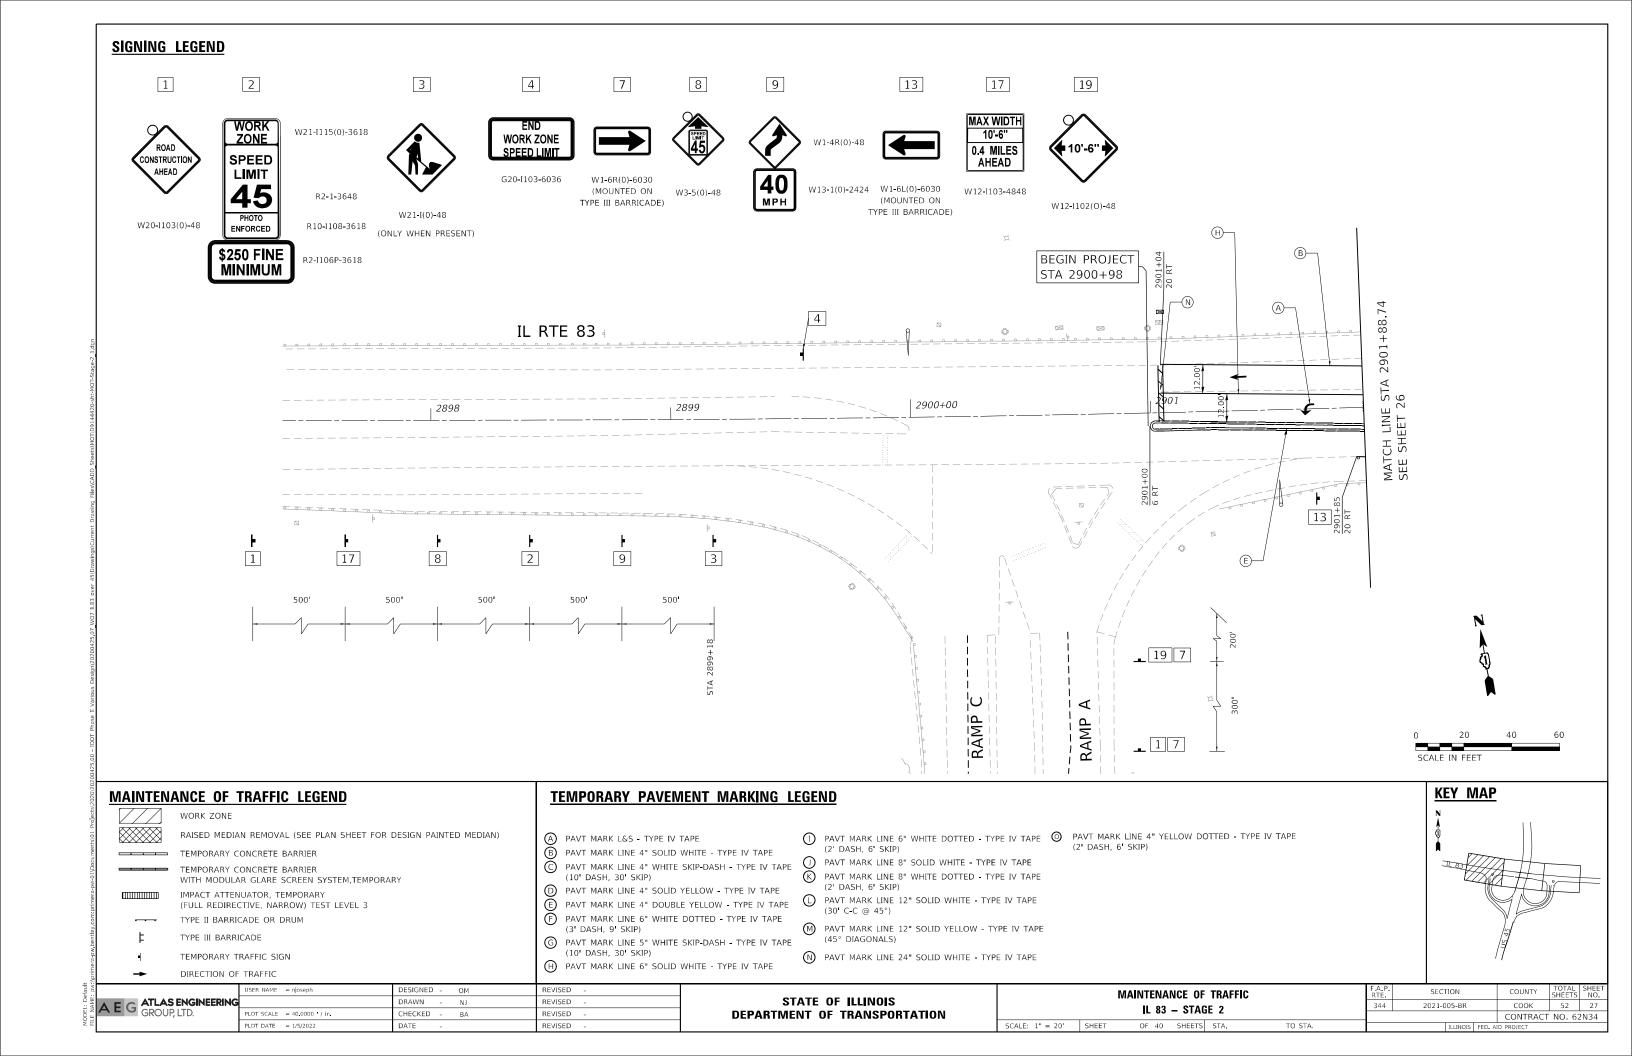

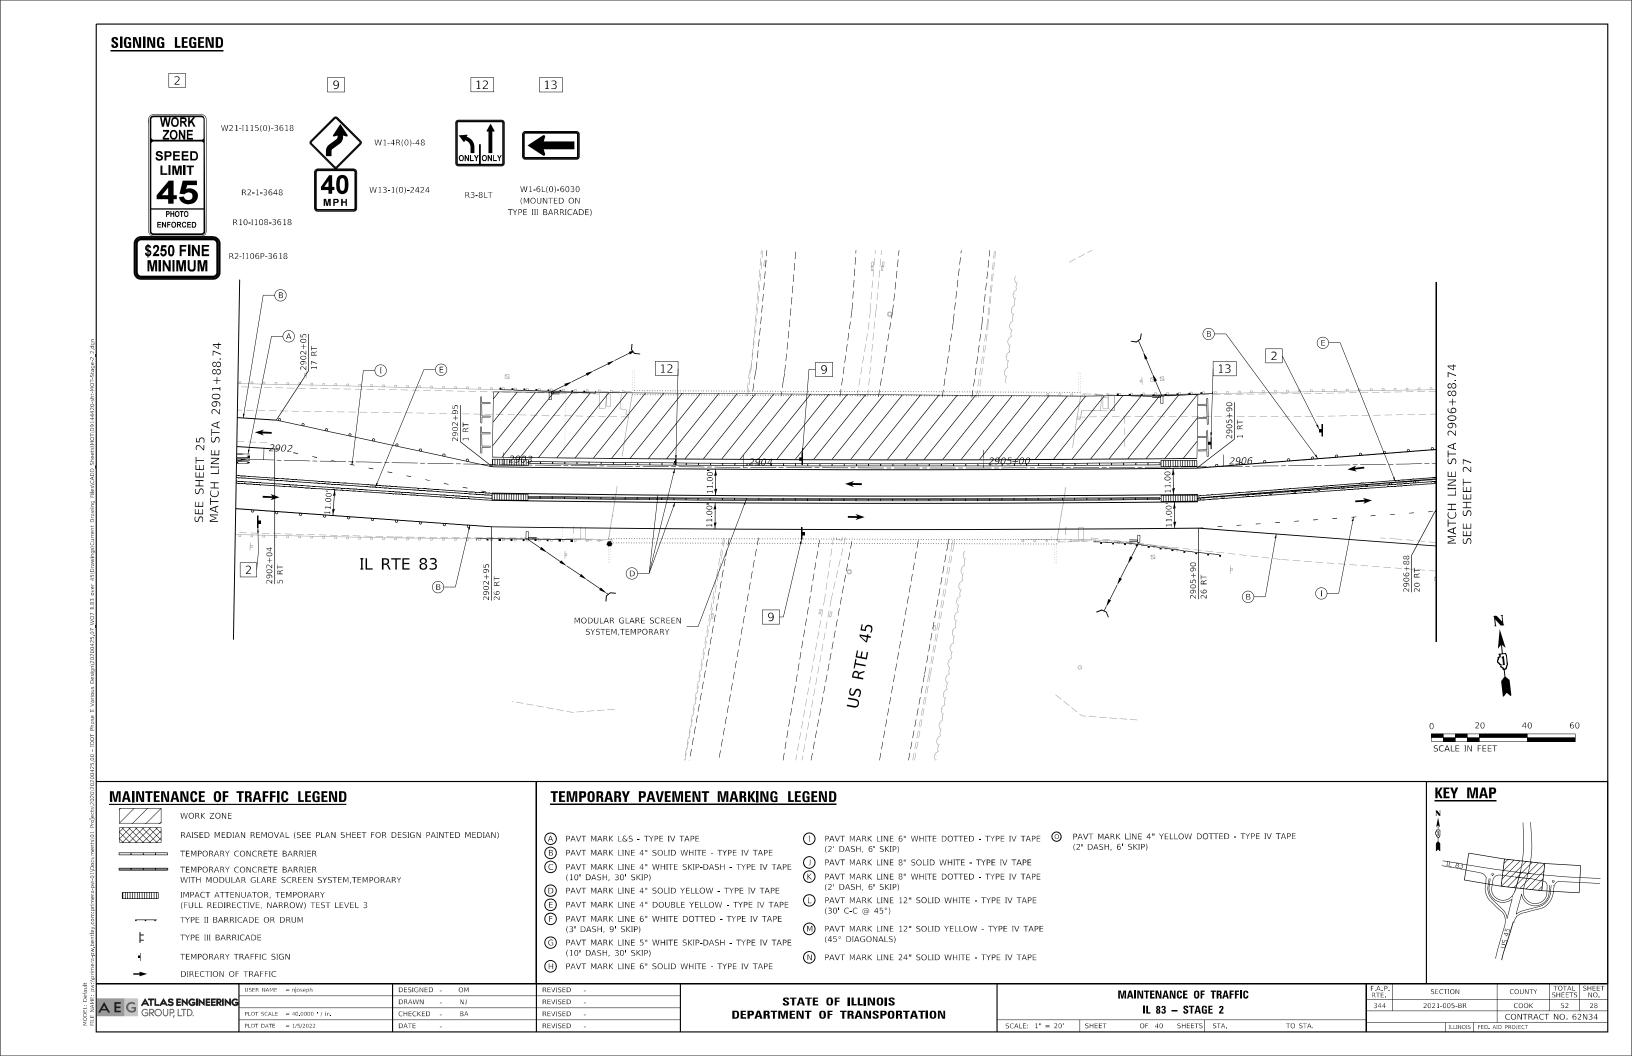

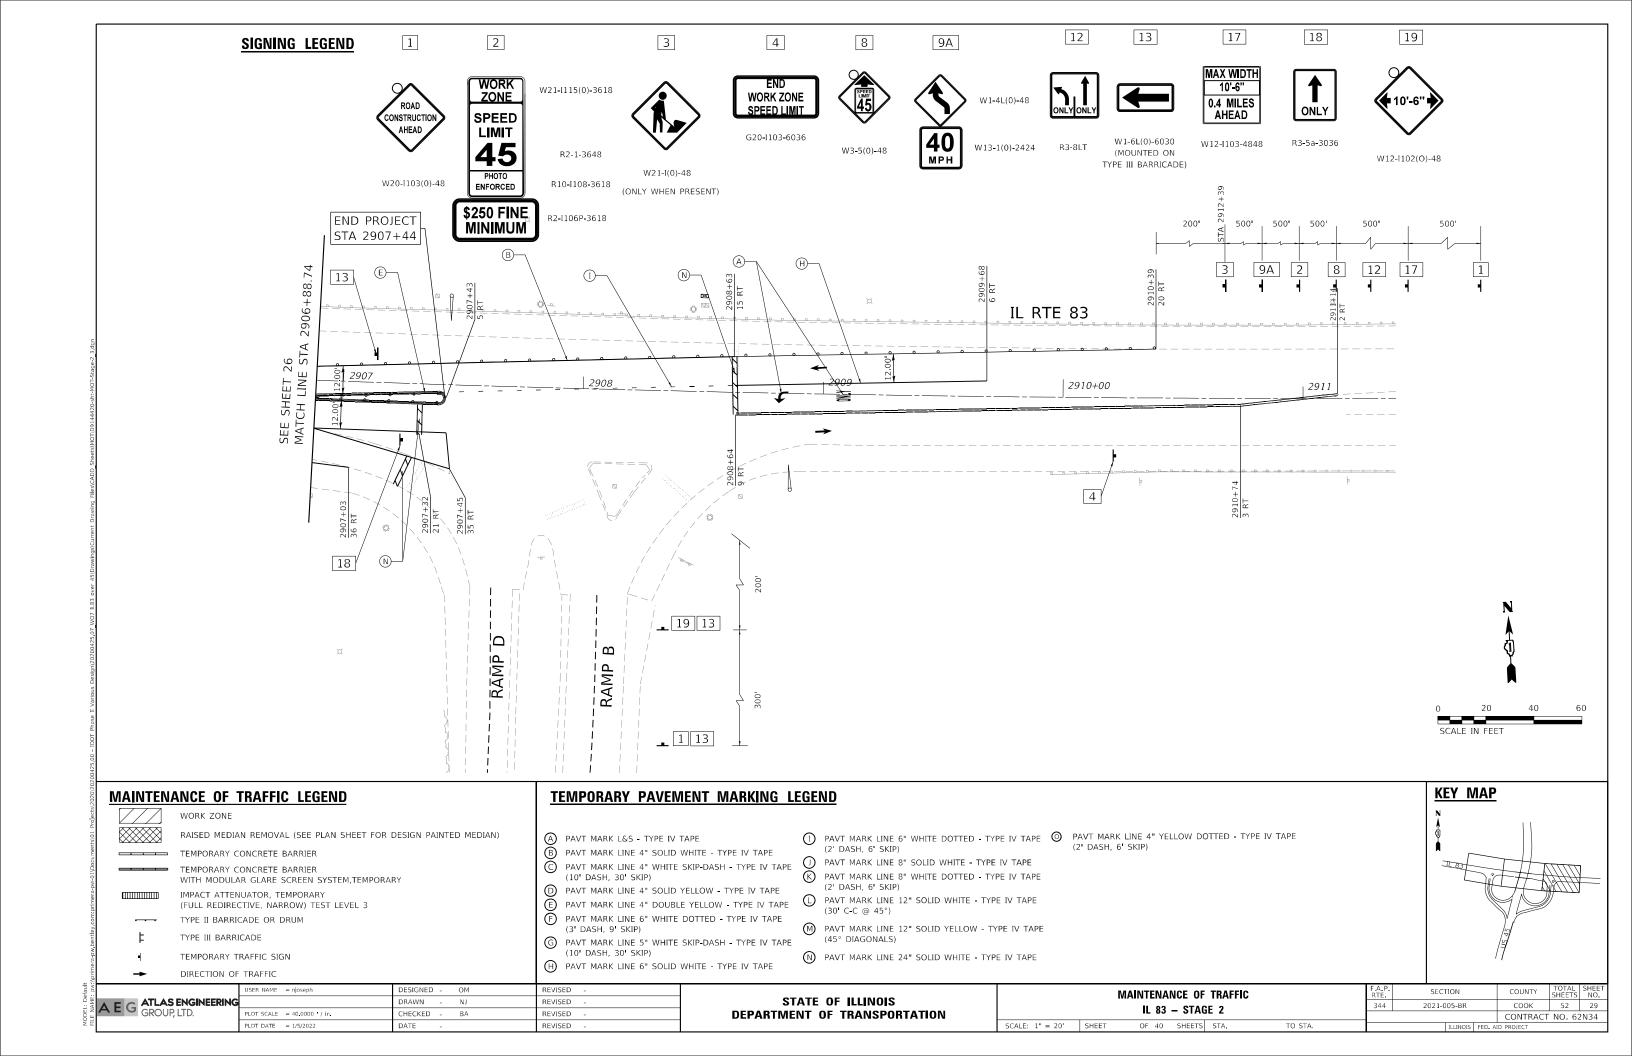

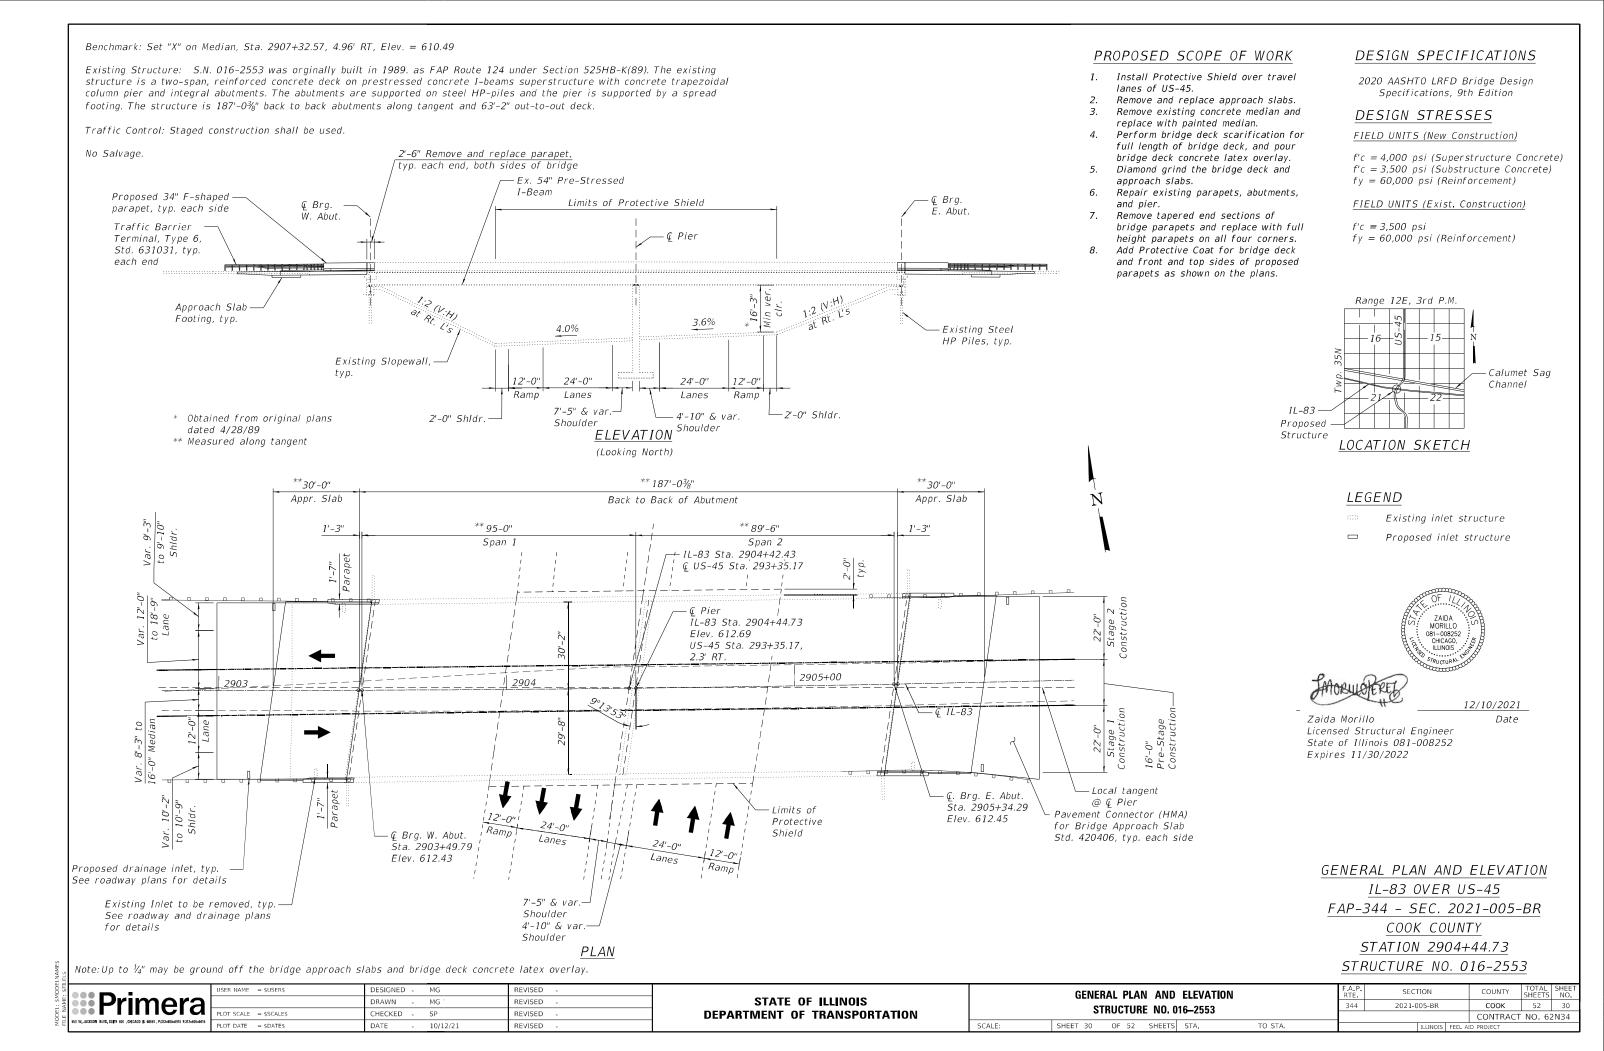

GENERAL NOTES

- 1. Reinforcement bars designated (E) shall be epoxy coated.
- 2. Plan dimensions and details relative to existing plans are subject to nominal construction variations. The Contractor shall field verify existing dimensions and details affecting new construction and make necessary approved adjustments prior to construction or ordering of materials. Such variations shall not be cause for additional compensation for a change in scope of the work, however, the Contractor will be paid for the quantity actually furnished at the unit price bid for the work.
- 3. Protective coat shall be applied to the top and front face of the new parapet, new concrete overlay and approach slab deck.
- 4. Existing reinforcement shall be cleaned and incorporated into the new construction. Cost included with Concrete Superstructure.
- 5. Hand finish of overlay material is required around the floor drains. The cost is included with Bridge Deck Latex Concrete Overlay, $2\frac{3}{4}$ ".
- 6. Stage Construction shall be utilized to maintain traffic during construction.
- 7. See Butt Joint and HMA Taper Detail for Approach Slab Transition details on Sheet 12 of 52.

TOTAL BILL OF MATERIAL


ITEM	UNIT	TOTAL
Concrete Removal	Cu. Yd.	62.7
Protective Shield	Sq. Yd.	643
Concrete Structures	Cu. Yd.	51.3
Concrete Superstructure	Cu. Yd.	7.8
Protective Coat	Sq. Yd.	1,682
Concrete Superstructure (Approach Slab)	Cu. Yd.	176.9
Reinforcement Bars, Epoxy Coated	Pound	63,410
Bar Splicers	Each	588
Bridge Deck Grooving (Longitudinal)	Sq. Yd.	1,098
Approach Slab Removal	Sq. Yd.	214
Bridge Deck Latex Concrete Overlay, 2¾ Inches	Sq. Yd.	1,247
Bridge Deck Scarification ¾"	Sq. Yd.	1,247
Structural Repair of Concrete (Depth Equal to or	Ca Va	8
Less Than 5 Inches)	Sq. Yd	8
Deck Slab Repair (Partial)	Sq. Yd	17
Diamond Grinding (Bridge Section)	Sq. Yd	1,792

INDEX OF SHEETS

- 1. General Plan and Elevation
- 2. Index, General Notes and Bill of Material
- 3. Stage Construction Details
- 4. Removal Plan
- 5. Deck Repair Plan
- 6. Top of West Approach Slab Elevations
- 7. Top of East Approach Slab Elevations
- 8. East Approach Slab Plan and Cross-Section
- 9. Approach Slab Details
- 10. Parapet Removal and Replacement Details
- 11. Scupper Details
- 12. Pier Repairs
- 13. Bar Splicer Assembly and Mechanical Splicer Details

LIST OF ABBREVIATIONS

N.B. S.B. Sta. EI C.I.P S. Abut. N. Abut. Typ. Max. Min. Bot. Exist./Ex. Exp. Shldr P.G.L. E.F. F.F. B.F. I.F. O.F. P.J.F. Bk/ B/ T/ Prop. HP WF CI. SF Sq. Ft. SY Sq .Yd. LF Cu .Ft. Ea Ftg. Appr.	Northbound Southbound Station Elevation Cast-in-place Centerline South Abutment North Abutment Typical Maximum Minimum Bottom Existing Expansion Shoulder Baseline Profile Grade Line Each Face Front Face Back Face Inside Face Outside Face Outside Face Outside Face Preformed Joint Fille Back of Bottom of Top of Proposed H-Pile W-Flange Clearance Square Foot Square Foot Square Foot Square Yard Linear Feet Cubic Feet Each Footing Approach
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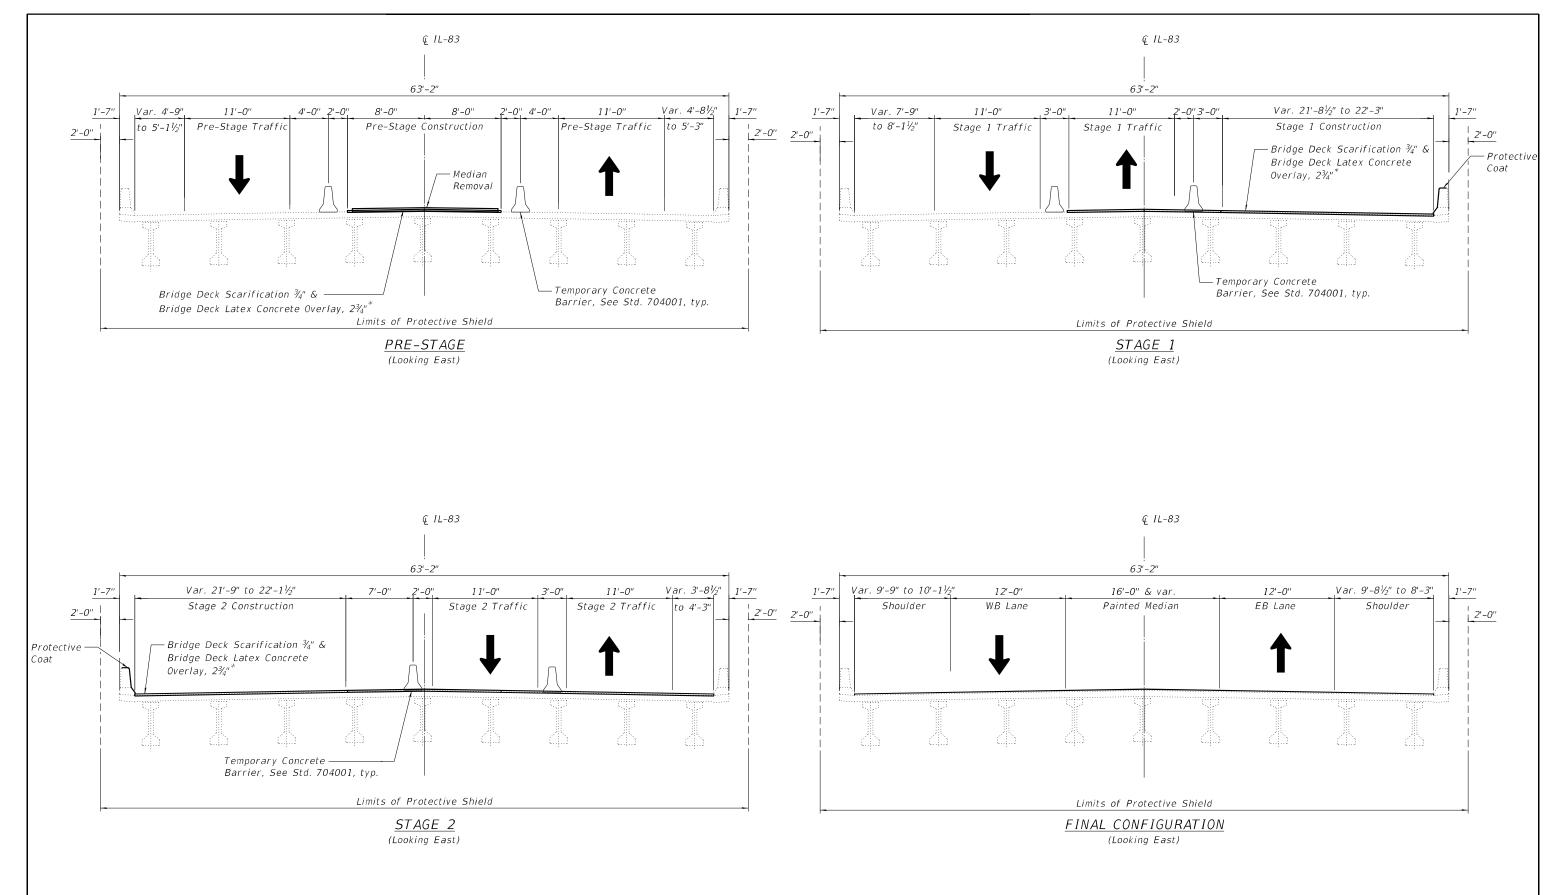

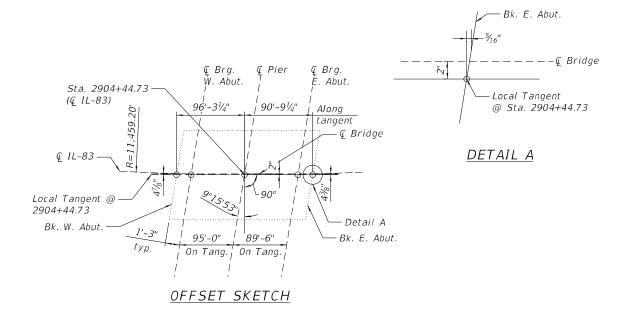
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Ē	550 W. JACKSON BLVD. SUITE 600 . CHICAGO L 60561 . P.312-606-0910 F:312-606-0415

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l	PLOT SCALE = \$SCALE\$	CHECKED	-	SP	REVISED	-
5	PLOT DATE = \$DATE\$	DATE	-	10/12/21	REVISED	-

INDEX, GENERAL NOTES AND BILL OF MATERIAL STRUCTURE NO. 016–2553								
SCALE: N/A	SHEET 31	OF 52	SHEETS	STA.	TO STA.			

	F.A.P. RTE	SEC	TION			COUNTY	TOTAL SHEETS	SHEET NO.
ı	344	2021-0	2021-005-BR		соок	52	31	
4						CONTRACT	NO. 62	2N34
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BILL OF MATERIAL

ITEM	UNIT	TOTAL
Protective Shield	Sq. Yd.	643

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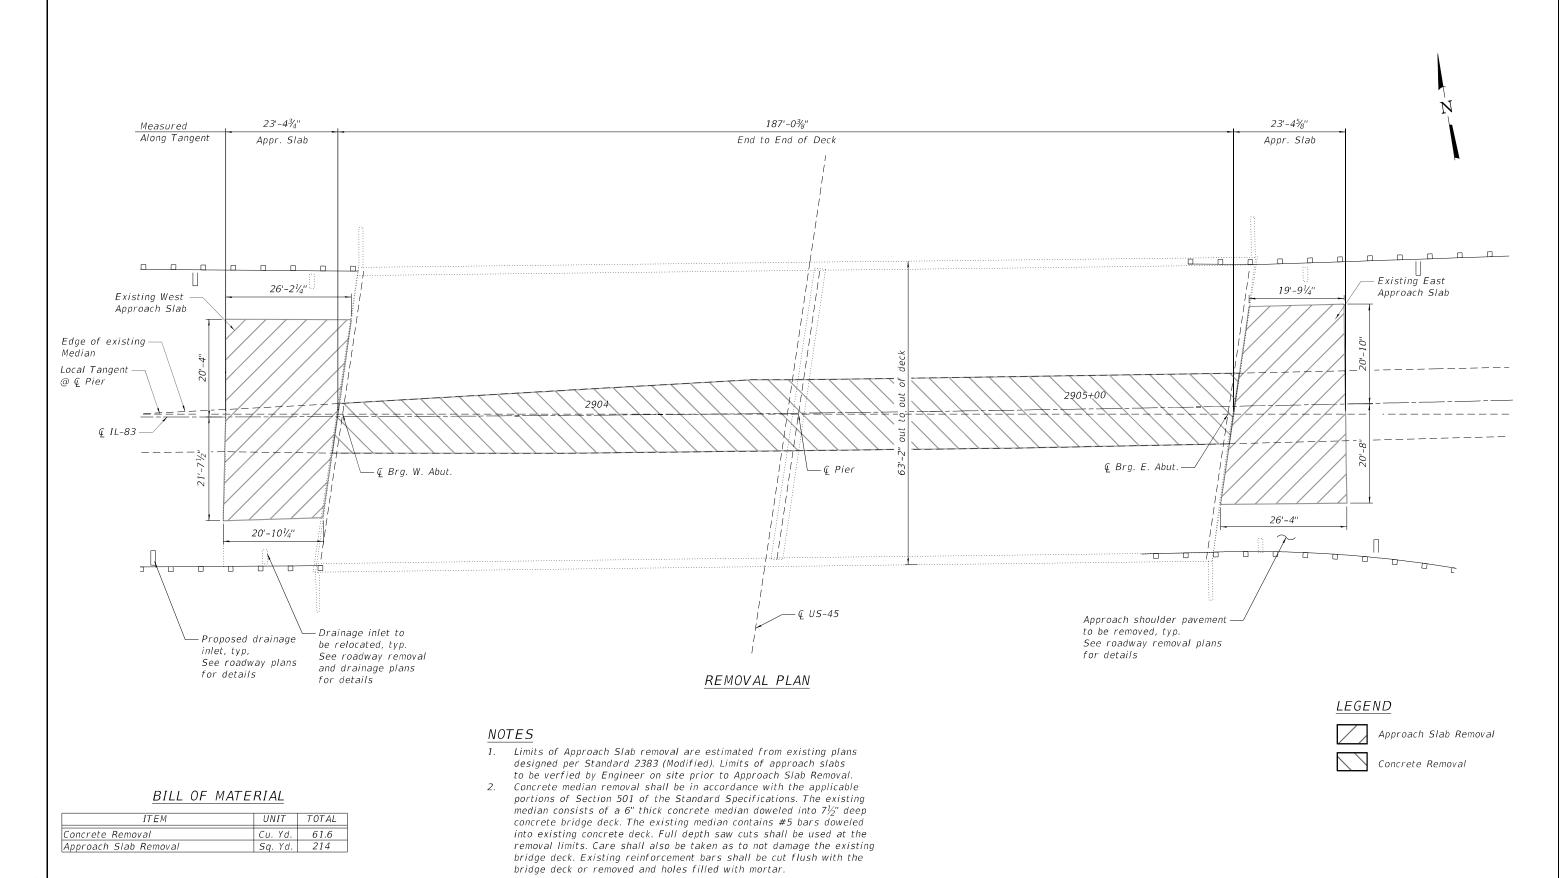
* Prior to 1/4" Diamond Grinding

STATE OF ILLINOIS
DEPARTMENT OF TRANSPORTATION

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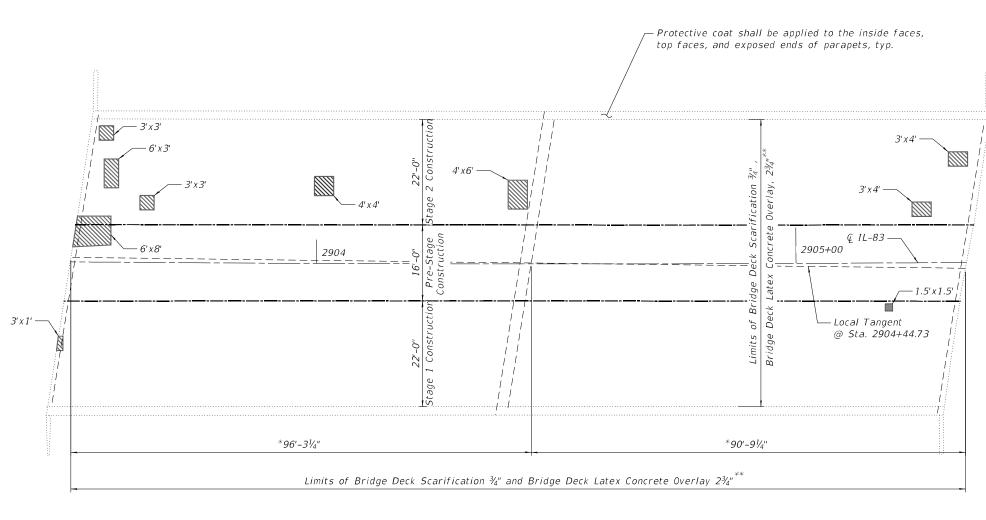


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So N. JACKSON BURD. 100 F 100-101 500 JACKSON BURD. 100 JACKSON BU

STATE OF ILLINOIS
DEPARTMENT OF TRANSPORTATION



* Measured along tangent

** Prior to 1/4" Diamond Grinding

PLAN

LEGEND



Deck Slab Repair (Partial)

BILL OF MATERIAL

ITEM	UNIT	TOTAL
Deck Slab Repair (Partial)	Sq. Yd.	17
Bridge Deck Scarification ¾"	Sq. Yd.	1,247
Bridge Deck Concrete Latex Overlay, 2¾"	Sq. Yd.	1,247
Bridge Deck Grooving (Longitudinal)	Sq. Yd.	831
Diamond Grinding (Bridge Section)	Sq. Yd.	1,164
Protective Coat	Sa. Yd.	1,251

NOTES

- 1. Quantities and limits of repairs shown are estimated for bidding purposes. The actual areas to be repaired, and the type(s) of repairs to be used, will be determined by the Engineer in the field at the time of construction.
- Bridge Deck Scarification shall be performed per IDOT Guide Bridge Special Provision 30 "Bridge Deck Latex Concrete Overlay".
- 3. After bridge deck scarification and cleaning, the Engineer shall sound the scarified deck, and survey the existing reinforcement condition. All remaining unsound concrete and unacceptably corroded reinforcement bars shall be marked for additional removal and/or repairs as applicable.
- Existing spalled areas shown on the deck shall only be repaired after bridge deck scarification has been completed and the Engineer recommends patching existing deck at the locations shown on the plans.
- 5. "Bridge Deck Grooving (Longitudinal)" shall be constructed as directed under Guide Bridge Special Provision 79, and the painted median between travel lanes should be added to the width that is being longitudinally grooved.

	Primera
550 W. JACKSON	BLVD_SUITE 610 _CHICAGO L 60861 _ P:312-808-0910 F:312-808-0415

USER NAME = \$USER\$	DESIGNED - MG	REVISED -
	DRAWN - MG '	REVISED -
PLOT SCALE = \$SCALE\$	CHECKED - SP	REVISED -
PLOT DATE = \$DATE\$	DATE - 10/12/21	REVISED -

STATE OF ILLINOIS **DEPARTMENT OF TRANSPORTATION**

DECK REPAIR PLAN STRUCTURE NO. 016–2553						
SHEET	34	OF	52	SHEETS	STA.	

SECTION COUNTY COOK 52 34 2021-005-BR CONTRACT NO. 62N34

NORTH EDGE OF SHOULDER

Location	Station	Offset	Theoretical Grade Elevations	Theoretical Grade Elevations Adjusted for Grinding
W. End of W. Appr. Slab	2903+23.49	-29.53	611.15	611.17
A	2903+33.49	-29.63	611.37	611.40
В	2903+43.49	-29.72	611.60	611.62
E. End of W. Appr. Slab	2903+53.49	-29.80	611.82	611.84

NORTH EDGE OF PAVEMENT

Location	Station	Offset	Theoretical Grade Elevations	Theoretical Grade Elevations Adjusted for Grinding
W. End of W. Appr. Slab	2903+21.86	-20.00	611.54	611.56
A	2903+31.86	-20.00	611.70	611.72
В	2903+41.86	-20.00	611.85	611.87
E. End of W. Appr. Slab	2903+51.86	-20.00	612.01	612.03

Q IL-83 & PGL

Location	Station	Offset	Theoretical Grade Elevations	Theoretical Grade Elevations Adjusted for Grinding
W. End of W. Appr. Slab	2903+18.61	0	611.92	611.95
A	2903+28.61	0	612.09	612.11
В	2903+38.61	0	612.26	612.28
E. End of W. Appr. Slab	2903+48.61	0	612.43	612.45

SOUTH EDGE OF PAVEMENT

Location	Station	Offset	Theoretical Grade Elevations	Theoretical Grade Elevations Adjusted for Grinding
W. End of W. Appr. Slab	2903+15.36	20.00	611.42	611.44
A	2903+25.36	20.00	611.59	611.61
В	2903+35.36	20.00	611.76	611.78
E. End of W. Appr. Slab	2903+45.36	20.00	611.93	611.95

SOUTH EDGE OF SHOULDER


Location	Station	0ffset	Theoretical Grade Elevations	Theoretical Grade Elevations Adjusted for Grinding
W. End of W. Appr. Slab	2903+13.73	30.58	611.12	611.14
A	2903+23.73	30.47	611.35	611.37
В	2903+33.73	30.37	611.58	611.60
E. End of W. Appr. Slab	2903+43.73	30.28	611.81	611.83

STAGE 1 CONSTRUCTION

Location	Station	Offset	Theoretical Grade Elevations	Theoretical Grade Elevations Adjusted for Grinding
W. End of W. Appr. Slab	2903+17.31	8.00	611.72	611.74
A	2903+27.31	8.00	611.89	611.91
В	2903+37.31	8.00	612.06	612.08
E. End of W. Appr. Slab	2903+47.31	8.00	612.23	612.25

STAGE 2 CONSTRUCTION

Location	Station	0ffset	Theoretical Grade Elevations	Theoretical Grade Elevations Adjusted for Grinding
W. End of W. Appr. Slab	2903+19.91	-8.00	611.77	611.79
A	2903+29.91	-8.00	611.93	611.95
В	2903+39.91	-8.00	612.10	612.12
E. End of W. Appr. Slab	2903+49.91	-8.00	612.26	612.28

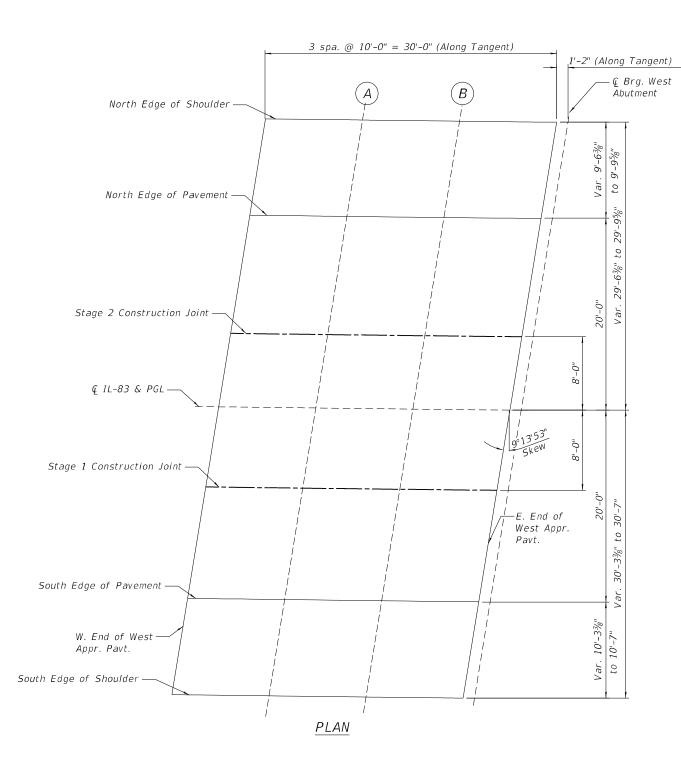



USER NAME = \$USER\$	DESIGNED -	MG	REVISED -
	DRAWN -	MG '	REVISED -
PLOT SCALE = \$SCALE\$	CHECKED -	SP	REVISED -
PLOT DATE = \$DATE\$	DATE -	10/12/21	REVISED -

TOP OF WEST APPROACH SLAB ELEVATIONS STRUCTURE NO. 016–2553		SECTION	COUNTY	TOTAL SHEETS	SHEET NO.
		2021-005-BR	соок	52	35
3111001011L 140: 010-2333			CONTRACT	NO. 62	2N34
SHEET 35 OF 52 SHEETS STA. TO STA.		ILLINOIS FED. A	AID PROJECT		

NORTH EDGE OF SHOULDER

Location	Station	Offset	Theoretical Grade Elevations	Theoretical Grade Elevations Adjusted for Grinding
W. End of E. Appr. Slab	2905+40.36	-29.77	611.90	611.92
С	2905+50.36	-29.68	611.67	611.69
D	2905+60.36	-29.58	611.43	611.45
E. End of E. Appr. Slab	2905+70.36	-29.48	611.20	611.22

NORTH EDGE OF PAVEMENT

Location	Station	Offset	Theoretical Grade Elevations	Theoretical Grade Elevations Adjusted for Grinding
W. End of E. Appr. Slab	2905+38.73	-20.00	612.07	612.09
С	2905+48.73	-20.00	611.89	611.91
D	2905+58.73	-20.00	611.71	611.73
E. End of E. Appr. Slab	2905+68.73	-20.00	611.53	611.55

₡ IL-83 & PGL

Location	Station	Offset	Theoretical Grade Elevations	Theoretical Grade Elevations Adjusted for Grinding
W. End of E. Appr. Slab	2905+35.48	0	612.45	612.48
С	2905+45.48	0	612.33	612.35
D	2905+55.48	0	612.21	612.23
E. End of E. Appr. Slab	2905+65.48	0	612.09	612.11

SOUTH EDGE OF PAVEMENT

Location	Station	Offset	Theoretical Grade Elevations	Theoretical Grade Elevations Adjusted for Grinding
W. End of E. Appr. Slab	2905+32.23	20.00	612.09	612.11
С	2905+42.23	20.00	611.95	611.97
D	2905+52.23	20.00	611.81	611.83
E. End of E. Appr. Slab	2905+62.23	20.00	611.67	611.69

SOUTH EDGE OF SHOULDER

Location	Station	Offset	Theoretical Grade Elevations	Theoretical Grade Elevations Adjusted for Grinding
W. End of E. Appr. Slab	2905+30.6	30.16	611.95	611.97
С	2905+40.6	30.23	611.81	611.83
D	2905+50.6	30.32	611.67	611.69
E. End of E. Appr. Slab	2905+60.6	30.42	611.52	611.54

STAGE 1 CONSTRUCTION

Location	Station	Offset	Theoretical Grade Elevations	Theoretical Grade Elevations Adjusted for Grinding
W. End of E. Appr. Slab	2905+34.18	8.00	612.31	612.33
С	2905+44.18	8.00	612.18	612.20
D	2905+54.18	8.00	612.05	612.07
E. End of E. Appr. Slab	2905+64.18	8.00	611.92	611.94

STAGE 2 CONSTRUCTION


Location	Station	Offset	Theoretical Grade Elevations	Theoretical Grade Elevations Adjusted for Grinding
W. End of E. Appr. Slab	2905+36.78	-8.00	612.30	612.32
С	2905+46.78	-8.00	612.16	612.18
D	2905+56.78	-8.00	612.01	612.03
E. End of E. Appr. Slab	2905+66.78	-8.00	611.86	611.88

		Q Brg. East Abutment 3 spa. @ 10'-0" = 30'-0" (Along Tangent) 1'-2" (Along Tangent) C North Edge of Shoulder
1/4"	Var. 9'-5¾"	North Edge of Pavement
Var. 29'-5¾" to 29'-9¼"	20'-0"	Stage 2 Construction Joint Q IL-83 & PGL
r. 30'-2" to 30'-5"	20'-0"	Stage 1 Construction Joint E. End of East Appr. Pavt. South Edge of Pavement
Var.	Var. 10'-2"	W. End of East

Primera
50 W. AXXXXVII EVIG. SULFE 600 , CRICAGO D. 40041 , POZIN-600-0101 FOID-400-4105

USER NAME = \$USER\$	DESIGNED - MG	REVISED -
	DRAWN - MG	REVISED -
PLOT SCALE = \$SCALE\$	CHECKED - SP	REVISED -
PLOT DATE = \$DATE\$	DATE - 10/12/21	REVISED -

TOP OF EAST APPROACH SLAB ELEVATIONS STRUCTURE NO. 016–2553		SECTION	COUNTY	TOTAL SHEETS	SHEET NO.
		2021-005-BR	соок	52	36
			CONTRACT	NO. 62	2N34
SHEET 36 OF 52 SHEETS STA. TO STA.		ILLINOIS FED. A	ID PROJECT		

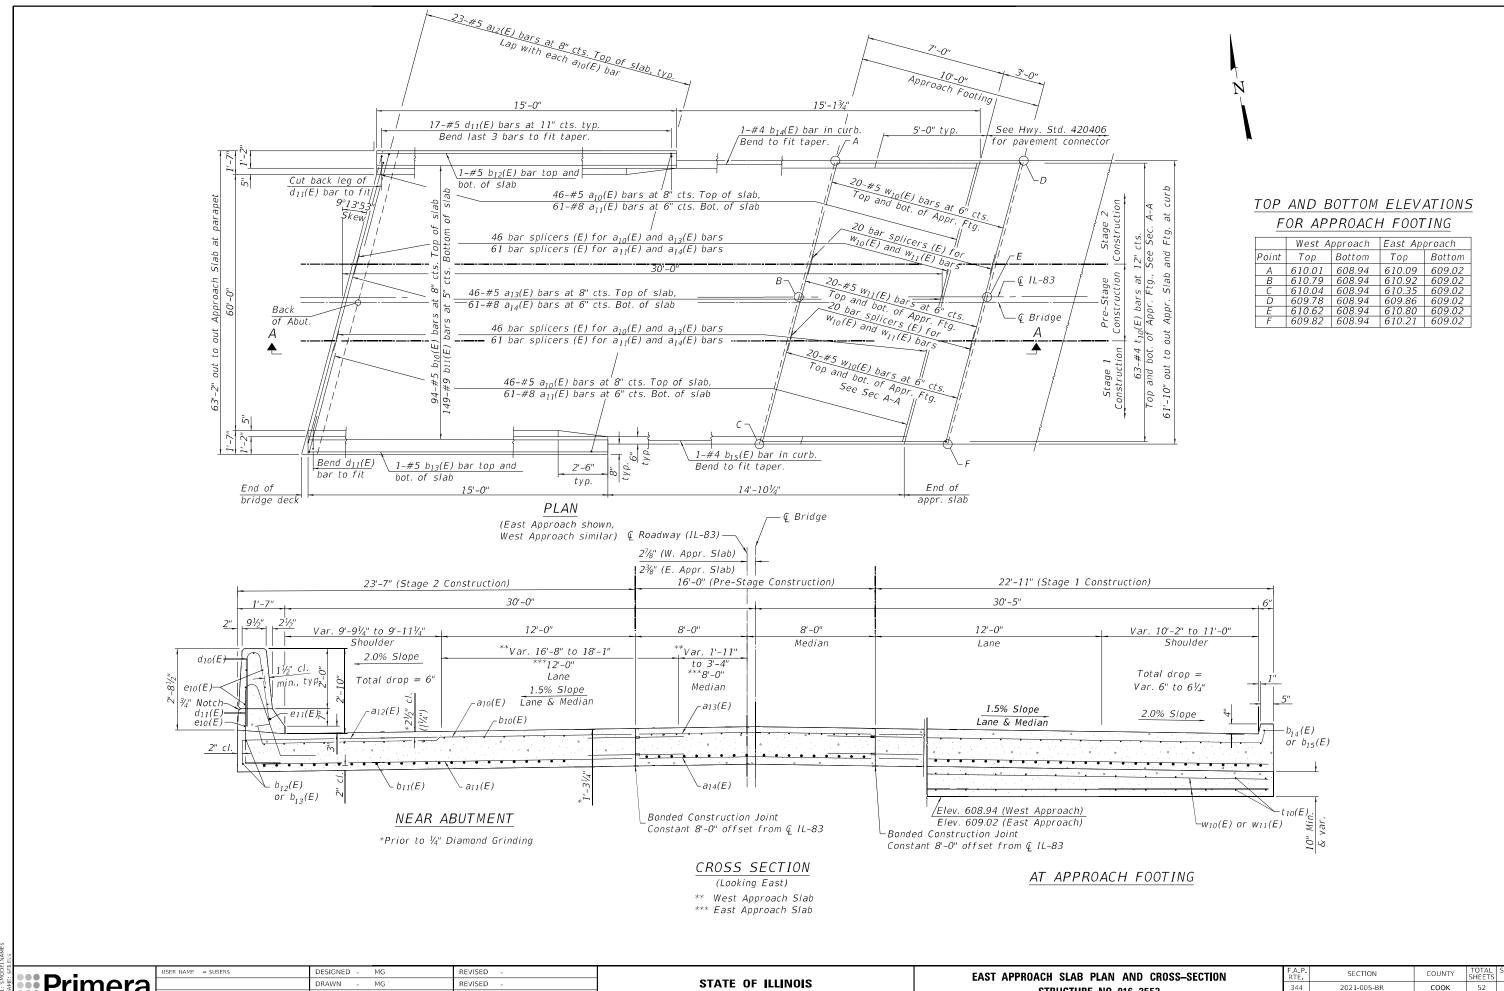


Primera

CHECKED REVISED

DEPARTMENT OF TRANSPORTATION


STRUCTURE NO. 016-2553 SHEET 37 OF 52 SHEETS STA

344 2021-005-BR COOK 52 37 CONTRACT NO. 62N34

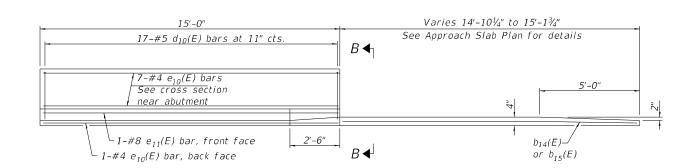



INSIDE ELEVATION OF PARAPET AND CURB


Epoxy Coated.

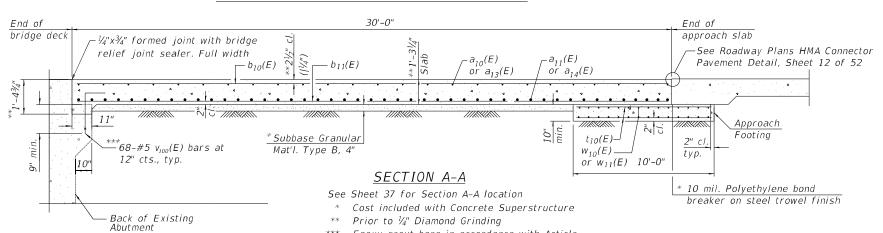

*** Epoxy grout bars in accordance with Article 584 of the Standard Specifications. Cost is included in the cost of Reinforcement Bars,

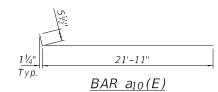

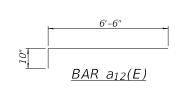


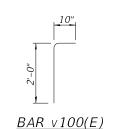


SCALE: N/A

NOTES

- Parapet concrete shall be paid for as Concrete Superstructure.
- Approach slab shall be paid for as Concrete Superstructure (Approach Slab).
- Approach footing concrete shall be paid for as Concrete Structures.
- The approach footing maximum applied service bearing pressure (Qmax) = 2.0 ksf.Cost of excavation for approach footing included with Concrete Structures.
- "Bridge Deck Grooving (Longitudinal)" shall be constructed as directed under Guide Bridge Special Provision 79, and the painted median between travel lanes should be added to the width that is being longitudinally grooved.

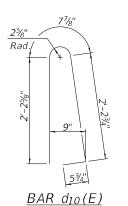

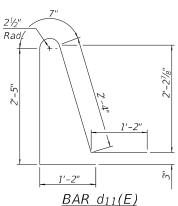

TWO APPROACHES BILL OF MATERIAL


	DILL	UF MAI	ERIAL	
Bar	No.	Size	Length	Shape
a10(E)	184	#5	22'-5" 22'-6"	
a11(E)	244	#8		
a ₁₂ (E)	92	#5	7'-4"	
a13(E)	92	#5	15'-11"	
a14(E)	122	#8	15'-11"	
b10(E)	188	#5	29'-8"	
b ₁₁ (E)	298	#9	29'-8"	
b ₁₂ (E)	4	#5 #5	14'-8"	
b ₁₃ (E)	4	#5	14'-8"	
b ₁₄ (E)	2	#4	14'-10"	
b ₁₅ (E)	2	#4	14'-7"	
d10(E)	68	#5	5'-7"	Λ
d11(E)	68	#5	7'-8"	Ĺ
e ₁₀ (E)	32 4	#4	14'-8"	
e ₁₁ (E)	4	#8	14'-8"	
t10(E)	126	#4	9'-8"	
w10(E)	160	#5 #5	22'-6"	
W11(E)	80	#5	15'-11"	
V 100(E)	128	#5	2'-10"	
Concrete	e Super	structure	Cu. Yd.	6.7
Concrete	e Super	structure		
(Approac			Cu. Yd.	176.9
Concrete			Cu. Yd.	51.3
Reinford	comont	Rarc		
		Dais,	Pound	63,270
Epoxy Coated				
Protective Coat			Sq. Yd.	430
Bridge i	Deck Gr	ooving	G V :	267
(Longitu			Sq. Yd.	267
Diamono	d Grindi	na		
(Bridge		_	Sq. Yd.	628
,		,		

Primera 55 W. AGSSON BURG. BURG. OR GULAGO E. BOBIL P. PORT-GROUPS SPIZ-GRO-SHS	

DRAWN - MG'	REVISED -
PLOT SCALE = \$SCALE\$ CHECKED - SP	REVISED -
PLOT DATE = \$DATE\$ DATE - 10/12/21	REVISED -

<u>VIEW B-B</u>

	APPROACH SLAB DETAILS					F.A.P. SECTION			COUNTY	TOTAL SHEETS	SHEET NO.
STRUCTURE NO. 016-2553					344	44 2021-005-BR			соок	52	38
	31NUCTURE NO. 010-2000								CONTRACT	F NO. 63	2N34
	SHEET 38 OF 52	2 SHEETS	STA.	TO STA.	ILLINOIS FED. AID PROJECT						

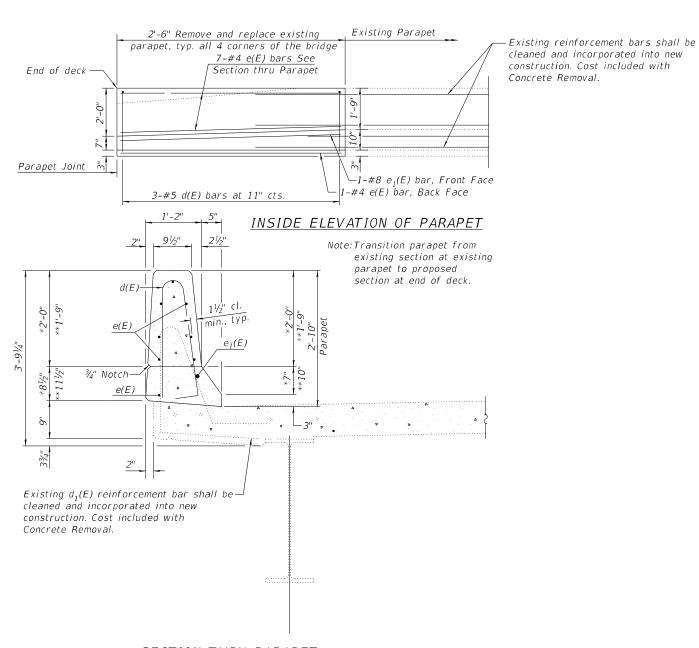

Polyurethane Sealant %" ⊘ Backer Rod ½" Preformed Self-Expanding Cork Joint Filler Const. Jt. (Optional) PARAPET JOINT DETAILS Const. Jt. (Mandatory)


<u>SUPERSTRUCTURE</u> BILL OF MATERIAL

Bar	No.	Size	Length	Shape						
d(E)	12	#5	5'-7"]						
e(E)	32	2'-2"								
$e_1(E)$	4	#8	2'-2"							
Reinfo	rcement	: Bars,	Lbs.	140						
Ероху	Coated		LU3.	140						
Concre	te	Cu. Yd.	1.1							
Supers	structur	Cu. ru.	1.1							
Concre	te Rem	Cu. Yd.	1.1							
			•	-						

SECTION THRU PARAPET

- * At end of deck
- ** At existing parapet

- 1. Removal of existing parapet to be paid for as Concrete Removal.
- 2. The 1/8" Aluminum sheet shall be ASTM B 209 alloy 3003-H14 and coated to minimize reaction with wet concrete. Cost included with Concrete Superstructure.
- The Polyurethane Sealant shall be non-staining gray one component non-sag elastomeric gun grade meeting the requirements of ASTM C-920, Type S, Grade NS, Class 25. Use T with a 1/8" backer rod.
- 4. The 1/2" Preformed Self-Expanding Cork Joint Filler shall be according to Article 1051.07 of the Std. Spec. Cost included with Concrete Superstructure.
- 5. Bend existing reinforcement bars in the field to fit into the proposed construction

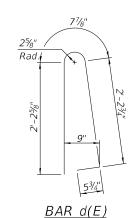


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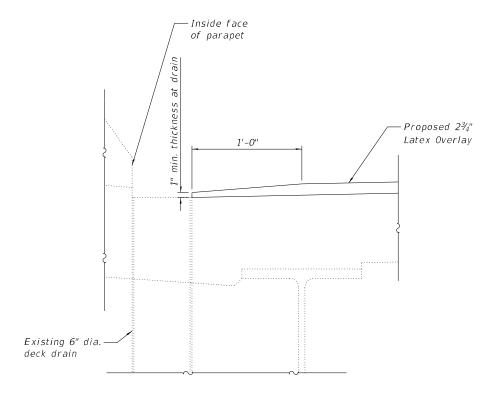
PLOT DATE = \$DATE\$	DATE -	10/12/21	REVISED -
PLOT SCALE = \$SCALE\$	CHECKED -	SP	REVISED -
	DRAWN -	MG '	REVISED -
USER NAME = \$USER\$	DESIGNED -	MG	REVISED -

STATE OF ILLINOIS **DEPARTMENT OF TRANSPORTATION**


SECTION PARAPET REMOVAL AND REPLACEMENT DETAILS 344 2021-005-BR COOK 52 39 STRUCTURE NO. 016-2553 CONTRACT NO. 62N34 SHEET 39 OF 52 SHEETS STA. TO STA.

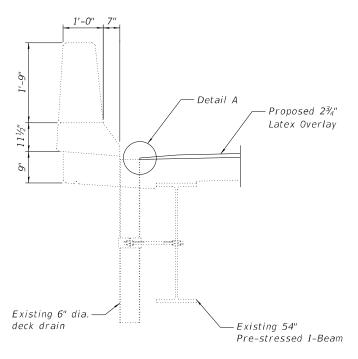

SECTION AT DECK DRAIN



DETAIL A

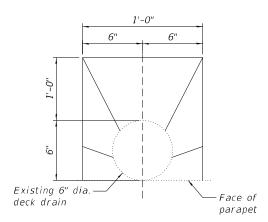

TOP PLAN AT FLOOR DRAIN
(For Drainage Adjustment)

550 W. JACKSOM BLYD, SUITE 600 , CHICAGO IL 40861 , P.312-406-0910 P.312-408-0415


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١		DRAWN -	MG '	REVISED -
ı	PLOT SCALE = \$SCALE\$	CHECKED -	SP	REVISED -
5	PLOT DATE = \$DATE\$	DATE -	10/12/21	REVISED -

STATE OI	F ILLINOIS
DEPARTMENT OF	TRANSPORTATION

SCUPPER DETAILS							SECTION	COUNTY	TOTAL SHEETS			
STRUCTURE NO. 016–2553						344	344 2021-005-BR COOK 52					
31NUCTUNE NU. 010-2333								CONTRACT	NO. 62	2N34		
SCALE: N/A SHEET 40 OF 52 SHEETS STA. TO STA.							ILLINOIS FED. AID PROJECT					

NOTES:

 Quantities and limits shown are estimated for bidding purposes only. The actual areas to be repaired, and the type(s) of repairs to be used, will be determined by the Engineer in the field at the time of construction.

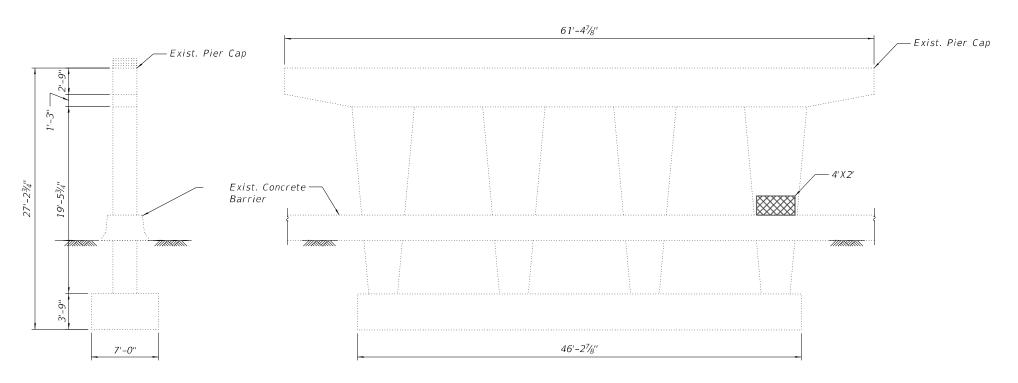

PIER END VIEW
(South Face)

CENTER PIER ELEVATION
(East Face)

SCALE:

<u>LEGEND</u>



BILL OF MATERIAL


ITEM	UNIT	TOTAL
Structural Repair of Concrete (Depth Equal to or Less Than 5 Inches)	Sq. Ft.	8



USER NAME = \$USER\$	DESIGNED - MG	REVISED -
	DRAWN - MG	REVISED -
PLOT SCALE = \$SCALE\$	CHECKED - SP	REVISED -
PLOT DATE = \$DATE\$	DATE - 10/12/21	REVISED -

STATE OF ILLINOIS
DEPARTMENT OF TRANSPORTATION

			F.A.P. RTE				COUNTY	TOTAL SHEETS	SHEET NO.			
STRUCTURE NO. 016-2553				344 2021-005-BR			соок	52	41			
								CONTRAC	T NO. 63	2N34		
HEET	41	OF 52	SHEETS	STA.	TO STA.			ILLINOIS	FED. AI	D PROJECT		

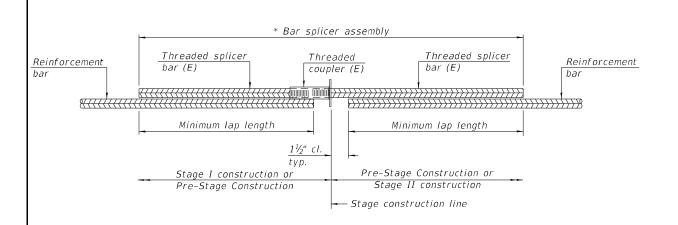


STANDARD BAR SPLICER ASSEMBLY PLAN

(All components shall be provided from one supplier)

Threaded splicer bar length = min. lap length + $1\frac{1}{2}$ " + thread length

* Epoxy not required on Bar Splicer Assembly components used in conjunction with black bars.


Location	Bar	No. assemblies	Minimum
Location	size	required	lap length
W. Approach Slab (Stage 1/Pre-stage)	#5	46	3'-0"
W. Approach Slab (Stage 1/Pre-stage)	#8	61	4'-9"
W. Approach Slab Footing (Stage 1/Pre-stage)	#5	40	3'-0"
W. Approach Slab (Stage 2/Pre-stage)	#5	46	3'-0"
W. Approach Slab (Stage 2/Pre-stage)	#8	61	4'-9"
W. Approach Slab Footing (Stage 2/Pre-stage)	#5	40	3'-0"
E. Approach Slab (Stage 1/Pre-stage)	#5	46	3'-0"
E. Approach Slab (Stage 1/Pre-stage)	#8	61	4'-9"
E. Approach Slab Footing (Stage 1/Pre-stage)	#5	40	3'-0"
E. Approach Slab (Stage 2/Pre-stage)	#5	46	3'-0"
E. Approach Slab (Stage 2/Pre-stage)	#8	61	4'-9"
E. Approach Slab Footing (Stage 2/Pre-stage)	#5	40	3'-0"

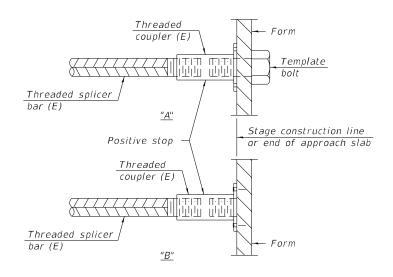

INSTALLATION AND SETTING METHODS

"A": Set bar splicer assembly by means of a template bolt.
"B": Set bar splicer assembly by nailing to wood forms or cementing to steel forms.

(E) : Indicates epoxy coating.

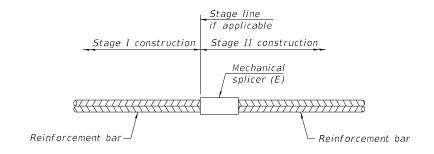

STANDARD MECHANICAL SPLICER

Location	Bar size	No. assemblies required		

BILL OF MATERIAL

ITEM	UNIT	TOTAL
Bar Splicers	Each	588

Notes:

Splicer bars shall be deformed with threaded ends and have a minimum 60 ksi yield strength.

All reinforcement shall be lapped and tied to the splicer bars.

Bar splicer assemblies shall be epoxy coated according to the requirements for reinforcement bars. See Section 508 of the Standard Specifications.

See approved list of bar splicer assemblies and mechanical splicers for alternatives.


BSD-1

1-1-2020

Primera
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USER NAME = \$USER\$	DESIGNED - MG	REVISED -
	DRAWN - MG '	REVISED -
PLOT SCALE = \$SCALE\$	CHECKED - SP	REVISED -
PLOT DATE = \$DATE\$	DATE - 10/12/21	REVISED -


F.A.P. RTE	SECTION	COUNTY	TOTAL SHEETS	SHEET NO.	
344	2021-005-BR		соок	52	42
			CONTRACT	NO. 62	2N34
	ILLINOIS	FED. A	ID PROJECT		



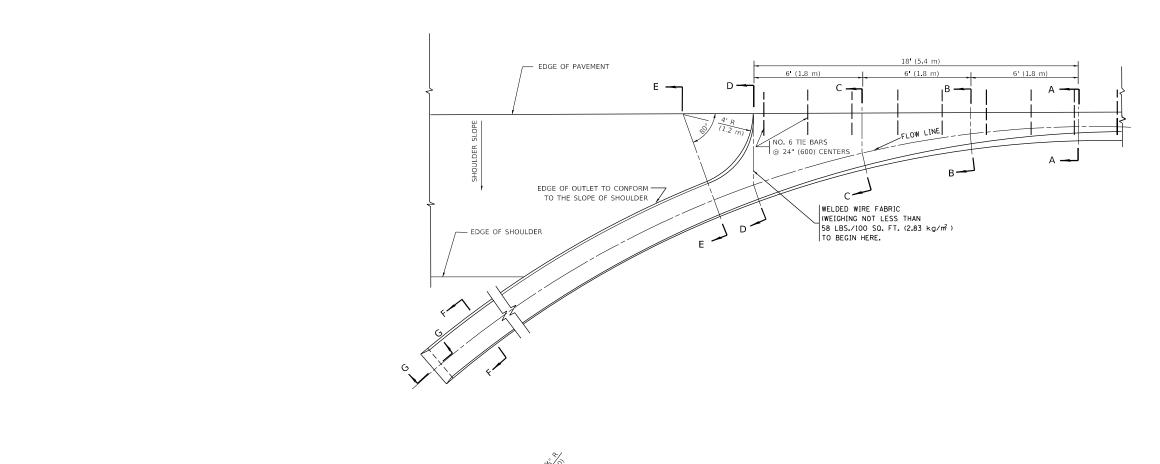


SECTION A-A *


 $\ensuremath{\boldsymbol{\times}}$ DIMENSIONS OF THE CURB & GUTTER AT SECTION A-A ARE SHOWN ON STATE STANDARD 606001. FOR DETAILS OF OUTLET FOR CONCRETE CURB & GUTTER, TYPE B-6.24 (B-15.60) SEE STATE STANDARD 606006.

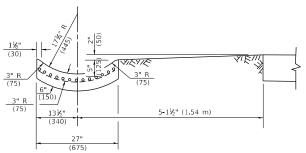




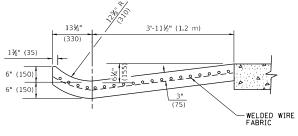

SECTION D-D

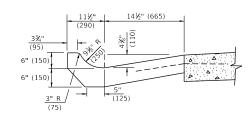

SECTION C-C

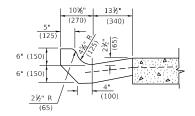

SECTION B-B

GENERAL NOTES


GUTTER OUTLET SHALL BE TIED TO THE PAVEMENT IN ACCORDANCE WITH DETAILS FOR LONGITUDINAL CONSTRUCTION JOINT SHOWN ON STANDARD 420001. TIE BARS SHALL BE NO. 20 (NO.6) AT 24" (600) CENTERS UNLESS OTHERWISE SHOWN. IF THE AVERAGE GRADE OF PAVEMENT FOR THE DISTANCE

FROM SECTION A-A TO D-D EXCEEDS 2%, THIS DISTANCE SHALL BE INCREASED 6' (1.8 m) FOR EACH 1% INCREASE IN GRADE.


QUANTITIES

FOR SECTION A-A TO E-E AND CURTAIN WALL= 1.25 CU. YDS. (0.96³m) CLASS SI CONCRETE (OUTLET) FOR 9" (225) PAV'T. 1.27 CU. YDS. (0.96^3m) CLASS SI CONCRETE (OUTLET) FOR 10" (250) PAV'T. FOR SECTION F-F= 0.045 CU. YDS. (0.03^3m) CLASS SI CONCRETE PER ft. (m).

ALL DIMENSIONS ARE IN INCHES (MILLIMETERS) UNLESS OTHERWISE SHOWN.

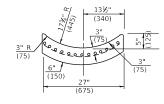


SECTION F-F

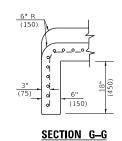

USER NAME = footemj	DESIGNED	-	M. DE YONG	REVISED	-	R. SHAH 09-09-94
	DRAWN	-		REVISED	-	R. SHAH 10-25-94
PLOT SCALE = 50.0000 / in.	CHECKED	-		REVISED	-	E. GOMEZ 12-21-00
PLOT DATE = 3/27/2019	DATE	-	08-04-86	REVISED	-	

STATE OF ILLINOIS	
DEPARTMENT OF TRANSPORTATION	

					F.A. RTE	SEC	TION		COUNTY	TOTAL SHEETS	SHEE NO.		
							2021-0	05-BR		COOK	52	43	
	COND AND GOTTEN					В	D600-01	(BD-03)	CONTRACT	NO. 6	2N34	
	SCALE: NONE	SHEET 1	OF 1	SHEETS	STA.	TO STA.			ILLINOIS	FED. AI	ID PROJECT		

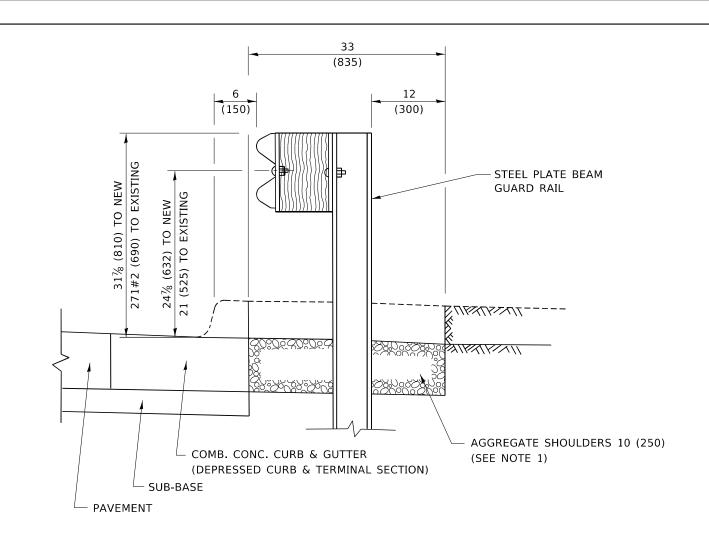

SECTION A-A


NOTES:

- 1. THE AGGREGATE SHOULDER, 10 (250) OR HMA SHOULDER, 6 (150) (IF REQUIRED) SHALL EXTEND UNDER THE TRAFFIC BARRIER TERMINAL.
- 2. "EXISTING" GUARDRAIL REFERS TO CONNECTING TERMINAL SECTION TO GUARD RAILING PRIOR TO THE MIDWEST GUARDRAIL SYSTEM.
- 3. THE CONTRACTOR SHALL VERIFY THE TYPE/HEIGHT OF GUARDRAIL IN-PLACE BEFORE ORDERING THE NEW TERMINAL SECTION. COST INCLUDED WITH THE COST OF THE TERMINAL. THE TERMINAL SECTION HEIGHT TO BE PLACED MUST MATCH THE HEIGHT OF THE IN-PLACE GUARDRAIL.

DETAILS FOR STEEL PLATE BEAM

GUARD RAIL ADJACENT TO CURB AND GUTTER

[FOR ROADWAY SPEED 35 MPH (60 kmh) TO 45 MPH (70 kmh)]

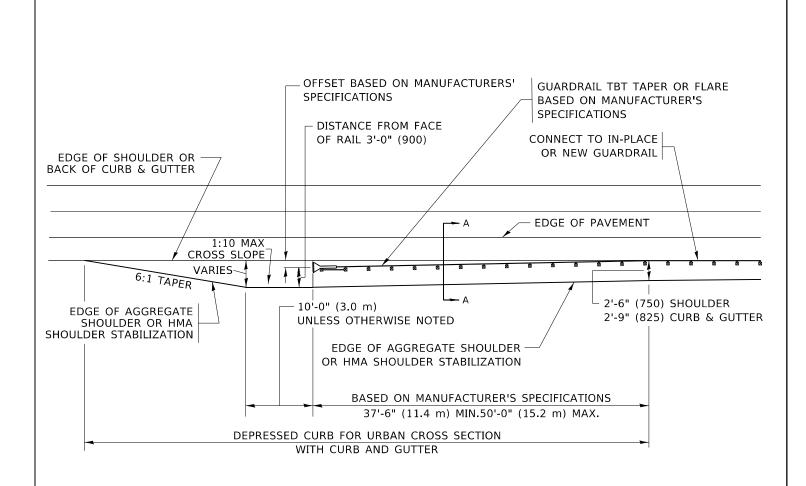

DEPRESSED CURB AND GUTTER AND SHOULDER TREATMENT AT TBT TY. 1 SPL.

AGGREGATE SHOULDER, 10 (250) WILL BE PAID ACCORDING TO SECTION 481.

HMA SHOULDERS 6 (150) (IF REQUIRED) WILL BE PAID ACCORDING TO SECTION 482.

COMB. CONC. C&G, STEEL PLATE BEAM GUARD RAIL AND TRAFFIC BARRIER TERMINAL, OF THE TYPE SPECIFIED WILL BE PAID FOR SEPARATELY.


TBT = TRAFFIC BARRIER TERMINAL
ALL DIMENSIONS ARE IN INCHES (MILLIMETERS)
UNLESS OTHERWISE SHOWN.

USER NAME = rootemj	DESIGNED - M. DE YONG	KEVISED	-	R. BURU 12-08-200
	DRAWN -	REVISED	-	R. BORO 09-14-200
PLOT SCALE = 50.0000 ' / in.	CHECKED -	REVISED	-	R. BORO 08-06-201
PLOT DATE = 3/27/2019	DATE - 09-22-90	REVISED	-	R. BORO 05-08-201

STATE OF ILLINOIS
DEPARTMENT OF TRANSPORTATION

DET		DEPRESSED TREATMEN		GUTTER AND Ty. 1 SPL.
SCALE: NONE	SHEET 1	OF 1 SH	EETS STA.	TO STA.

F.A. RTE	SECTION			COUNTY	TOTAL SHEETS	SHEET NO.
	2021-00	соок	52	44		
	BD600-10 (B	D 34)	CONTRACT	NO. 62	N34	
ILLINOIS FED. A				ID PROJECT		

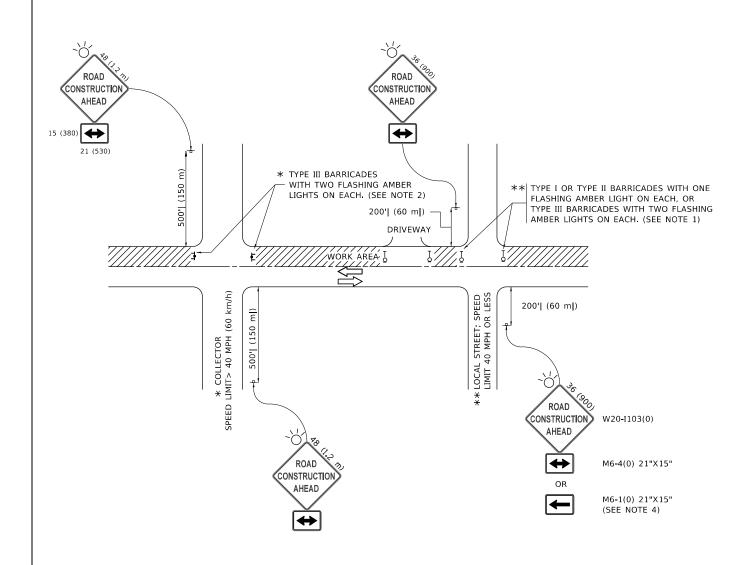

NOTES:

- 1. SIDE ROAD WITH A SPEED LIMIT OF 40 MPH (60 km/h) OR LESS AS SHOWN ON THE DRAWING AND AS DIRECTED BY THE ENGINEER:
- a) ONE "ROAD CONSTRUCTION AHEAD" SIGN 36 x 36 (900x900) WITH A FLASHER MOUNTED ON IT APPROXIMATELY 200' (60 m) IN ADVANCE OF THE MAIN ROUTE.
- b) THE CLOSED PORTION OF THE MAIN ROUTE SHALL BE PROTECTED BY BLOCKING WITH TYPE I, TYPE II OR TYPE III BARRICADES, 1/3 OF THE CROSS SECTION OF THE CLOSED PORTION.
- SIDE ROAD WITH A SPEED LIMIT GREATER THAN 40 MPH (60 km/h) AS SHOWN ON THE DRAWING AND AS DIRECTED BY THE ENGINEER:
- a) ONE "ROAD CONSTRUCTION AHEAD" SIGN 48 x 48 (1.2 m x 1.2 m) WITH A FLASHER MOUNTED ON IT APPROXIMATELY 500' (150 m) IN ADVANCE OF THE MAIN ROUTE.
- THE CLOSED PORTION OF THE MAIN ROUTE SHALL BE PROTECTED BY
 b) BLOCKING WITH TYPE III BARRICADES, 1/2 OF THE CROSS SECTION
 OF THE CLOSED PORTION.
- 3. CONES MAY BE SUBSTITUTED FOR BARRICADES OR DRUMS AT HALF THE SPACING DURING DAY OPERATIONS. CONES SHALL BE A MINIMUM OF 28 (710)
- WHEN THE SIDE ROAD LIES BETWEEN THE BEGINNING OF THE MAINLINE
 4. SIGNING AND THE WORK ZONE, A SINGLE HEADED ARROW (M6-1) SHALL
 BE USED IN LIEU OF THE DOUBLE HEADED ARROW (M6-4).

- WHEN WORK IS BEING PERFORMED ON A SIDE ROAD OR DRIVEWAY, FOLLOW THE APPLICABLE STANDARD(S). THE DIRECTIONAL ARROW (M6-1 OR M6-4) SHALL BE COVERED OR REMOVED WHEN NO LONGER CONSISTENT WITH THE TRAFFIC CONTROL SET-UP.
- 6. ADVANCE WARNING SIGNS ARE TO BE OMITTED ON DRIVEWAYS UNLESS OTHERWISE SPECIFIED IN THE PLANS OR BY THE ENGINEER
- THE TRAFFIC CONTROL AND PROTECTION FOR SIDE ROADS, INTERSECTIONS, AND DRIVEWAYS SHALL BE INCLUDED IN THE COST OF SPECIFIED TRAFFIC CONTROL STANDARDS OR ITEMS.

All dimensions are in inches (millimeters) unless otherwise shown.


USER NAME = footemj	DESIGNED - L.H.A.	REVISED -	A. HOUSEH 10-15-96
	DRAWN -	REVISED -	T. RAMMACHER 01-06-00
PLOT SCALE = 50.0000 / in.	CHECKED -	REVISED -	A. SCHUETZE 07-01-13
PLOT DATE = 3/4/2019	DATE - 06-89	REVISED -	A. SCHUETZE 09-15-16


STATE OF ILLINOIS
DEPARTMENT OF TRANSPORTATION

TRAFFIC CONTROL AND PROTECTION FOR
SIDE ROADS, INTERSECTIONS, AND DRIVEWAYS


SHEET 1 OF 1 SHEETS STA. TO STA.

tc10.den 3/4/2019 10:27:07 AM

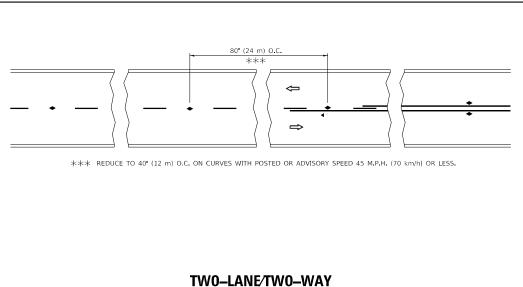

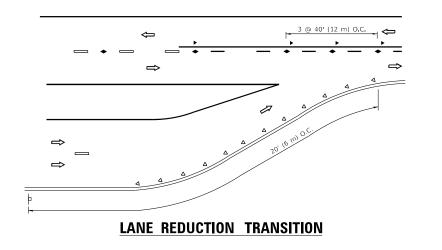

SEE FIGURE 3B-14 MUTCD

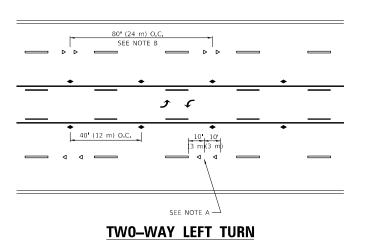

SYMBOLS


ONE-WAY AMBER MARKER


TWO-WAY AMBER MARKER

ONE-WAY CRYSTAL MARKER (W/O)

YELLOW STRIPE


WHITE STRIPE

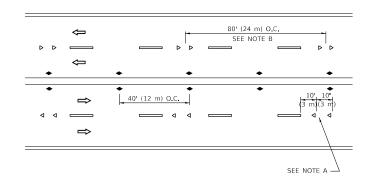


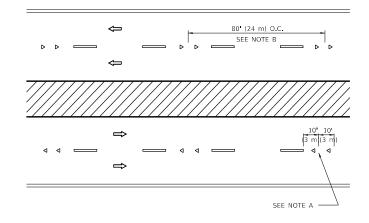

MULTI-LANE/UNDIVIDED



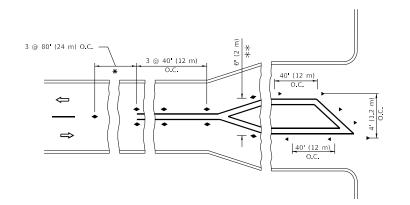

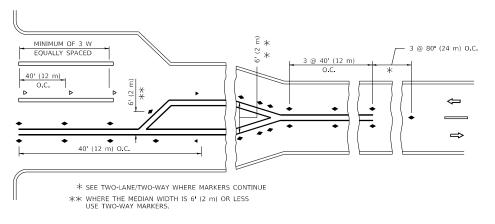

TURN LANES

GENERAL NOTES

- 1. MARKERS USED WITH DASHED LINES SHALL BE CENTERED IN THE GAP BETWEEN SEGMENTS.
- 2. MARKERS USED ADJACENT TO SOLID LINES SHALL BE OFFSET 2 TO 3 (50 TO 75) TOWARD TRAFFIC AS SHOWN.
- 3. MARKERS THROUGH TANGENTS LESS THAN 500' (150 m) IN LENGTH BETWEEN CURVES SHALL BE INSTALLED AT THE LESSER OF THE TWO CURVE SPACINGS.
- 4. MARKERS ARE TO BE USED ADJACENT TO BOTH SOLID WHITE LINES IN DUAL LEFT TURN LANES

LANE MARKER NOTES


- A. USE DOUBLE LANE LINE MARKERS SPACED AS SHOWN.
- B. REDUCE TO 40' (12 m) O.C. ON CURVES WHERE ADVISORY SPEEDS ARE 10 M.P.H (20 km/h) LOWER THAN POSTED SPEEDS.

DESIGN NOTES


- 1. DOUBLE LANE LINE MARKERS SHALL BE USED UNLESS SPECIFIED OTHERWISE.
- 2. EXCEPT AS SHOWN ON THE LANE REDUCTION TRANSITION AND FREEWAY EXIT RAMP DETAIL, MARKERS ARE NOT TO BE SPECIFIED ON RIGHT EDGE LINES.
- 3. THE EXACT MARKER LIMITS, SPACING, AND COLOR SHALL BE INCLUDED IN
- 4. MARKERS SHOULD NOT BE USED ALONGSIDE CURBS EXCEPT FOR EXTREMELY SHORT SECTIONS OF CURBS WHERE NOT MORE THAN TWO MARKERS WOULD BE INVOLVED.


All dimensions are in inches (millimeters) unless otherwise shown.

JSER NAME = footemj DESIGNED -REVISED - T. RAMMACHER 03-12-99 SECTION TYPICAL APPLICATIONS STATE OF ILLINOIS DRAWN REVISED - T. RAMMACHER 01-06-00 COOK 52 46 2021-005-BR RAISED REFLECTIVE PAVEMENT MARKERS (SNOW-PLOW RESISTANT) CHECKED REVISED - C. JUCIUS 09-09-09 **DEPARTMENT OF TRANSPORTATION** CONTRACT NO. 62N34 SHEET 1 OF 1 SHEETS STA. REVISED - C. JUCIUS 07-01-13 PLOT DATE = 3/4/2019 DATE

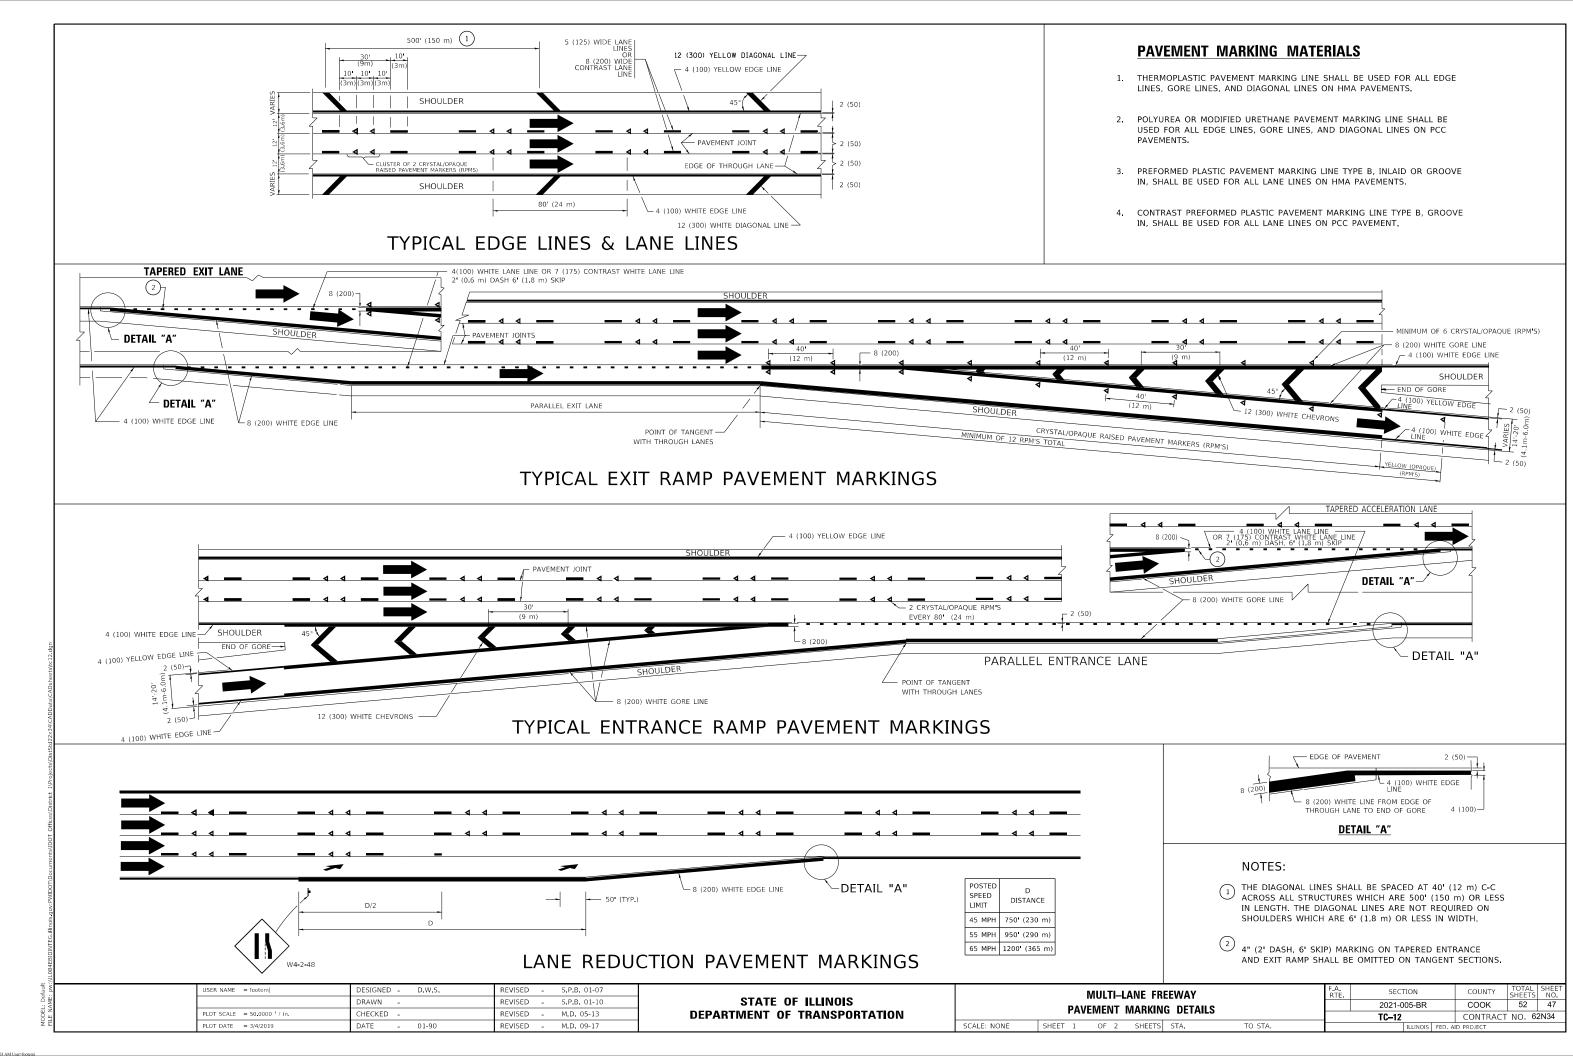

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TYPE OF MARKING	WIDTH OF LINE	PATTERN	COLOR	SPACING / REMARKS
CENTERLINE ON 2 LANE PAVEMENT	4 (100)	SKIP-DASH	YELLOW	10' (3 m) LINE WITH 30' (9 m) SPACE
CENTERLINE ON MULTI-LANE UNDIVIDED PAVEMENT	2 @ 4 (100)	SOLID	YELLOW	11 (280) C-C
NO PASSING ZONE LINES: FOR ONE DIRECTION FOR BOTH DIRECTIONS	4 (100) 2 @ 4 (100)	SOLID SOLID	YELLOW YELLOW	5½ (140) C-C FROM SKIP-DASH CENTERLINE 11 (280) C-C OMIT SKIP-DASH CENTERLINE BETWEEN
LANE LINES	4 (100) 5 (125) ON FREEWAYS	SKIP-DASH SKIP-DASH	WHITE WHITE	10' (3 m) LINE WITH 30' (9 m) SPACE
DOTTED LINES (EXTENSIONS OF CENTER, LANE OR TURN LANE MARKINGS)	SAME AS LINE BEING EXTENDED	SKIP-DASH	SAME AS LINE BEING EXTENDED	2' (600) LINE WITH 6' (1.8 m) SPACE
EDGE LINES	4 (100)	SOLID	YELLOW-LEFT WHITE-RIGHT	OUTLINE MEDIANS IN YELLOW
TURN LANE MARKINGS	6 (150) LINE; FULL SIZE LETTERS & SYMBOLS (8' (2.4m))	SOLID	WHITE	SEE TYPICAL TURN LANE MARKING DETAIL
TWO WAY LEFT TURN MARKING	2 @ 4 (100) EACH DIRECTION 8' (2.4m) LEFT ARROW	SKIP-DASH AND SOLID IN PAIRS	YELLOW	10' (3 m) LINE WITH 30' (9 m) SPACE FOR SKIP-DASH; 5½ (140) C-C BETWEEN SOLID LINE AND SKIP-DASH LINE SEE TYPICAL TWO-WAY LEFT TURN MARKING DETAIL
CROSSWALK LINES (PEDESTRIAN) A. DIAGONALS (BIKE & EQUESTRIAN) B. LONGITUDINAL BARS (SCHOOL)	2 @ 6 (150) 12 (300) @ 45° 12 (300) @ 90°	SOLID SOLID SOLID	WHITE WHITE WHITE	NOT LESS THAN 6' (1.8 m) APART 2' (600) APART 2' (600) APART 2' (600) APART SEE TYPICAL CROSSWALK MARKING DETAILS.
STOP LINES	24 (600)	SOLID	WHITE	PLACE 4 (1.2 m) IN ADVANCE OF AND PARALLEL TO CROSSWALX, IF PRESENT OTHERWISE, PLACE AT DESIRED STOPPING POINT. PARALLEL TO CROSSROAD CENTERLINE, WHERE POSSIBLE
PAINTED MEDIANS	2 @ 4 (100) WITH 12 (300) DIAGONALS @ 45° NO DIAGONALS USED FOR 4' (1.2 m) WIDE MEDIANS	SOLID	YELLOW: TWO WAY TRAFFIC WHITE: ONE WAY TRAFFIC	11 (280) C-C FOR THE DOUBLE LINE SEE TYPICAL PAINTED MEDIAN MARKING.
GORE MARKING AND CHANNELIZING LINES	8 (200) WITH 12 (300) DIAGONALS @ 45°	SOLID	WHITE	DIAGONALS: 15' (4.5 m) C-C (LESS THAN 30MPH (50 km/h)) 20' (6 m) C-C 30MPH (50 km/h) TO 45MPH (70 km/h)) 30' (9 m) C-C (OVER 45MPH (70 km/h))
RAILROAD CROSSING	24 (600) TRANSVERSE LINES; "RR" IS 6' (1.8 m) LETTERS; 16 (400) LINE FOR "X"	SOLID	WHITE	SEE STATE STANDARD 780001 AREA OF: "R"=3.6 SQ. FT. (0.33 m 2 EACH "X"=54.0 SQ. FT. (5.0 m 2
SHOULDER DIAGONALS (REQUIRED FOR SHOULDERS > 8')	12 (300) @ 45°	SOLID	WHITE - RIGHT YELLOW - LEFT	50' (15 m) C-C (LESS THAN 30MPH (50 km/h)) 75' (25 m) C-C (30 MPH (50 km/h) TO 45MPH (70 km/h)) 150' (45 m) C-C (OVER 45MPH (70 km/h))
U TURN ARROW	SEE DETAIL	SOLID	WHITE	16.3 SF
2 ARROW COMBINATION LEFT AND U TURN	SEE DETAIL	SOLID	WHITE	30.4 SF

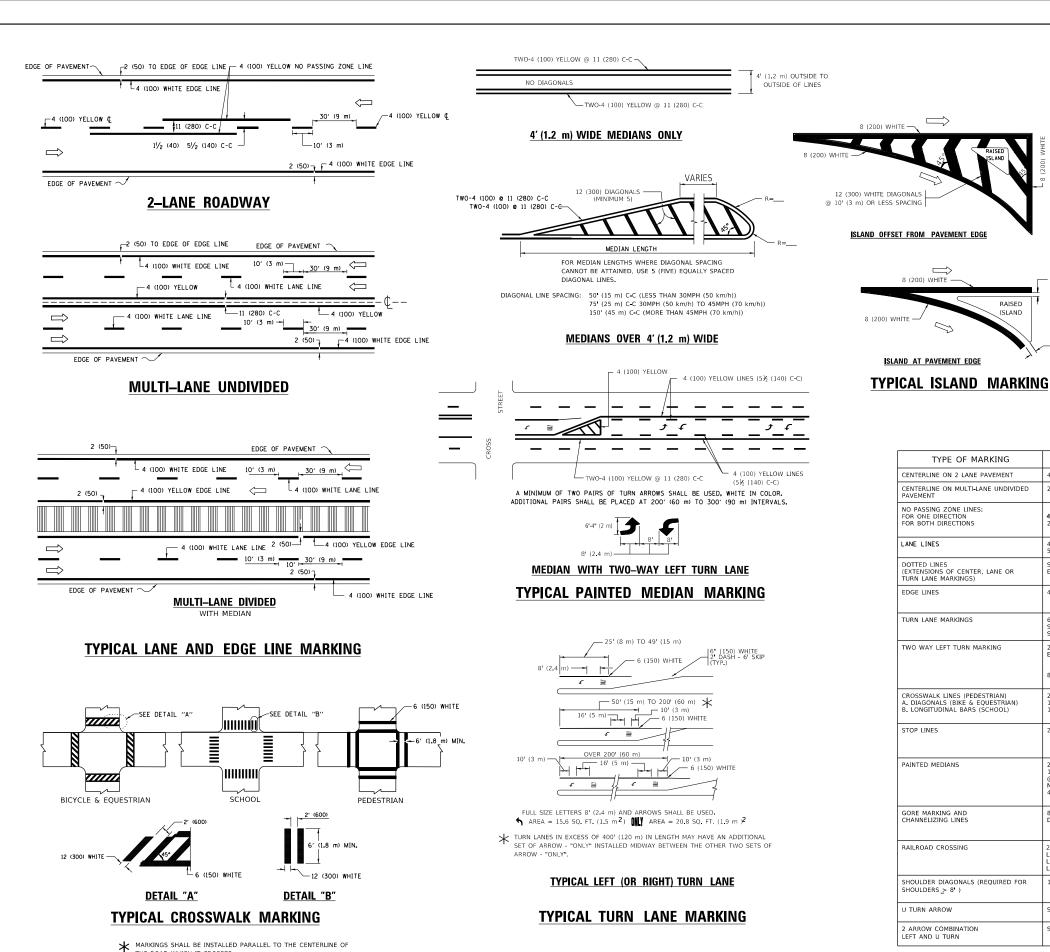FOR FURTHER DETAILS ON PAVEMENT MARKING REFER TO STANDARD SPECIFICATIONS FOR ROAD AND BRIDGE CONSTRUCTION AND STATE STANDARD 780001.

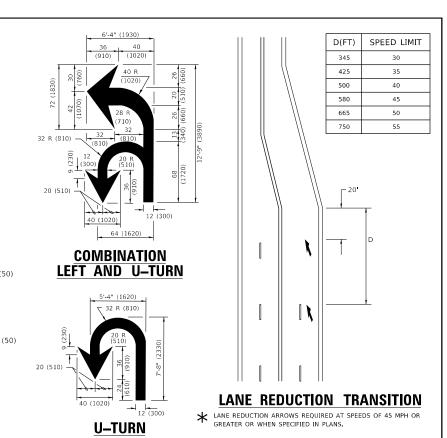SCALE: NONE

RAISED

All dimensions are in inches (millimeters) unless otherwise shown.


JSER NAME = footemj DESIGNED -EVERS C. JUCIUS 09-09-09 DRAWN REVISED -C. JUCIUS 07-01-13 HECKED REVISED -C. JUCIUS 12-21-15 DATE

THE ROAD WHICH IT CROSSES

STATE OF ILLINOIS **DEPARTMENT OF TRANSPORTATION**

SECTION DISTRICT ONE 52 48 2021-005-BR COOK TYPICAL PAVEMENT MARKINGS TC-13 CONTRACT NO.62N34 OF 2 SHEETS STA. TO STA. SHEET 1

TURN BAY ENTRANCE AT START OF LANE CLOSURE TAPER

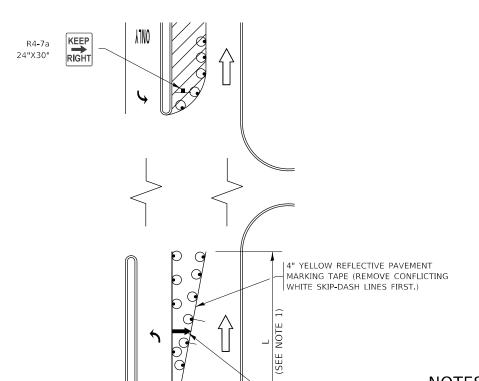


- ARROW BOARD

LEGEND WORK AREA LANE OPEN TO TRAFFIC ARROW BOARD TYPE I OR II BARRICADE OR DRUM WITH STEADY BURN LIGHT DRUM WITH STEADY BURN LIGHT SIGN ASSEMBLY TYPE I OR II CHECK BARRICADE WITH FLASHING LIGHT

NOTES:

- 1. A) WHEN "L" IS ≤ THE STORAGE LENGTH OF THE TURN LANE (AS SHOWN IN FIG. 1), USE FIGURE 1.
 - B) WHEN "L" IS > THE STORAGE LENGTH OF THE TURN LANE OR THE TURN LANE IS WITHIN THE LANE CLOSURE, USE FIGURE 2.
- 2. CONES MAY BE SUBSTITUTED FOR BARRICADES OR DRUMS AT HALF THE SPACING DURING DAY OPERATIONS, CONES SHALL BE A MINIMUM OF 28 (710) IN HEIGHT.
- 3. LIGHTS WILL NOT BE REQUIRED ON BARRICADES OR DRUMS FOR DAY OPERATIONS. ALL LIGHTS SHALL BE MONODIRECTIONAL.
- 4. REFLECTIVE TEMPORARY PAVEMENT MARKINGS SHALL BE PLACED THROUGHOUT THE BARRICADED AREAS OF EACH TURN BAY AS SHOWN WHERE THE CLOSURE TIME IS GREATER THAN FOURTEEN (14) DAYS.
- 5. THIS APPLICATION ALSO APPLIES WHEN WORK IS BEING PERFORMED IN THE RIGHT LANE(S) AND THE RIGHT TURN BAY IS TO REMAIN OPEN. UNDER THIS CONDITION, "RIGHT TURN LANE" R3-I100R 24 x 24 (600 x 600) AND M6-2R 21 x 15 (530 x 380) SHALL BE USED.
- 6. THESE CONTROLS SHALL SUPPLEMENT MAINLINE TRAFFIC CONTROL FOR LANE CLOSURES.
- 7. THE SIGNS SHALL BE MOUNTED ABOVE THE BARRICADES/DRUMS ON SEPARATE SIGN SUPPORTS THAT MEET NCHRP 350 OR MASH PREOUIREMENTS.
- 8. TRAFFIC CONTROL AND PROTECTION AT TURN BAYS (TO REMAIN OPEN TO TRAFFIC) SHALL BE INCLUDED IN THE COST OF SPECIFIED TRAFFIC CONTROL STANDARDS OR ITEMS.

TURN BAY ENTRANCE WITHIN A LANE CLOSURE

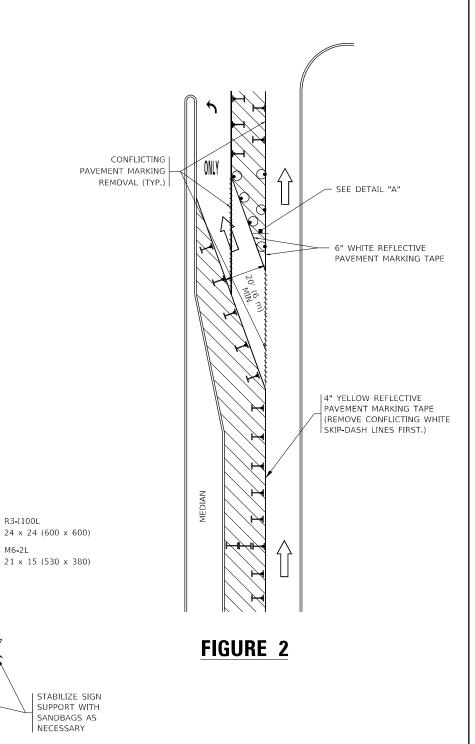

DETAIL A

M6-2L

TURN

LANE

All dimensions are in inches (millimeters) unless otherwise shown

SER NAME = footemj DESIGNED -T. RAMMACHER 09-08-94 REVISED - R. BORO 09-14-09 DRAWN - A. HOUSEH 11-07-95 REVISED - A. SCHUETZE 07-01-13 A. HOUSEH 10-12-96 REVISED - A. SCHUETZE 09-15-16 PLOT DATE = 3/4/2019 DATE - T. RAMMACHER 01-06-00 REVISED


FIGURE 1

STATE OF ILLINOIS **DEPARTMENT OF TRANSPORTATION**

SECTION TRAFFIC CONTROL AND PROTECTION AT TURN BAYS 2021-005-BR (TO REMAIN OPEN TO TRAFFIC) TC-14 SCALE: NONE SHEET 1 OF 1 SHEETS STA.

COOK 52 49 CONTRACT NO. 62N34


SEE DETAIL "A"

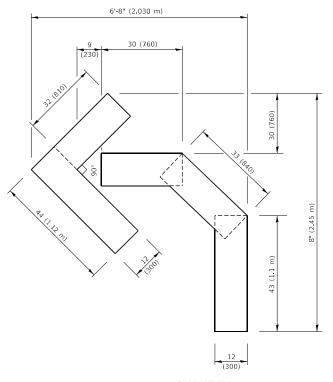


QUANTITY

4 (100) LINE = 45.5 ft. (13.9 m) 15.2 sq. ft. (1.41 sq. m)

6' (2 m)

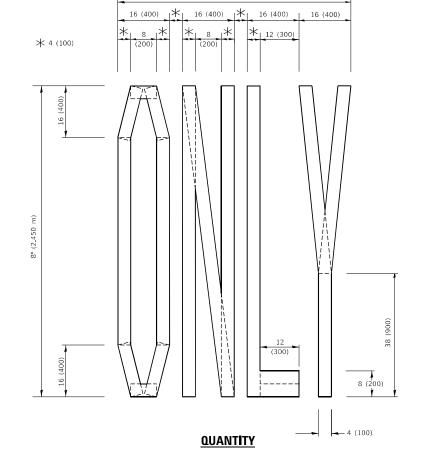

4 (100) LINE = 64.1 ft. (19.5 m)21.4 sq. ft. (1.99 sq. m)

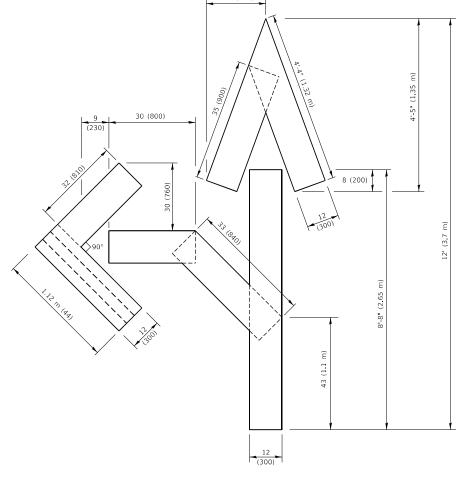


QUANTITY

4 (100) LINE = 82.5 ft. (25.1 m) 27.5 sq. ft. (2.53 sq. m)

NOTE:

ALL QUANTITIES OF PLACEMENT ARE REPRESENTED IN LINEAR FEET OF 4" LINES TO MATCH THE 4" TEMPORARY TAPE PAY ITEM AND REPRESENTS THE TOTAL QUANTITY OF 4" TAPE REQUIRED.

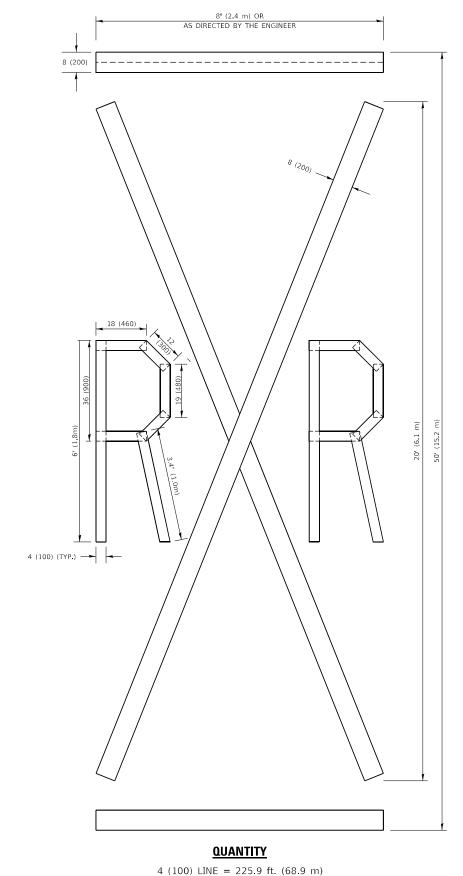

4 (100) LINE = 225.9 ft. (68.9 m) 75.3 sq. ft. (6.99 sq. m)


All dimensions are in inches (millimeters) unless otherwise shown.

USER NAME = footemj	DESIGNED -	REVISED	- T. RAMMACHER 03-02-98
	DRAWN -	REVISED	- E. GOMEZ 08-28-00
PLOT SCALE = 50.0068 / in.	CHECKED -	REVISED	- E. GOMEZ 08-28-00
PLOT DATE = 3/4/2019	DATE - 09-18-94	REVISED	- A. SCHUETZE 09-15-16


STATE OF ILLINOIS
DEPARTMENT OF TRANSPORTATION

	SHORT	TERM	PAV	/EMENT	MARKING	LETTERS	AND S	YMBOLS	
ALE:	NONE	SHEE	T 1	OF 1	SHEETS	STA.	TC	STA.	

F.A. RTE.	SECTION			COUNTY	TOTAL SHEETS	SHEE NO.
	2021-0	соок	52	50		
TC-16				CONTRACT	NO. 62	2N34
		ILLINOIS	FFD. A	ID PROJECT		

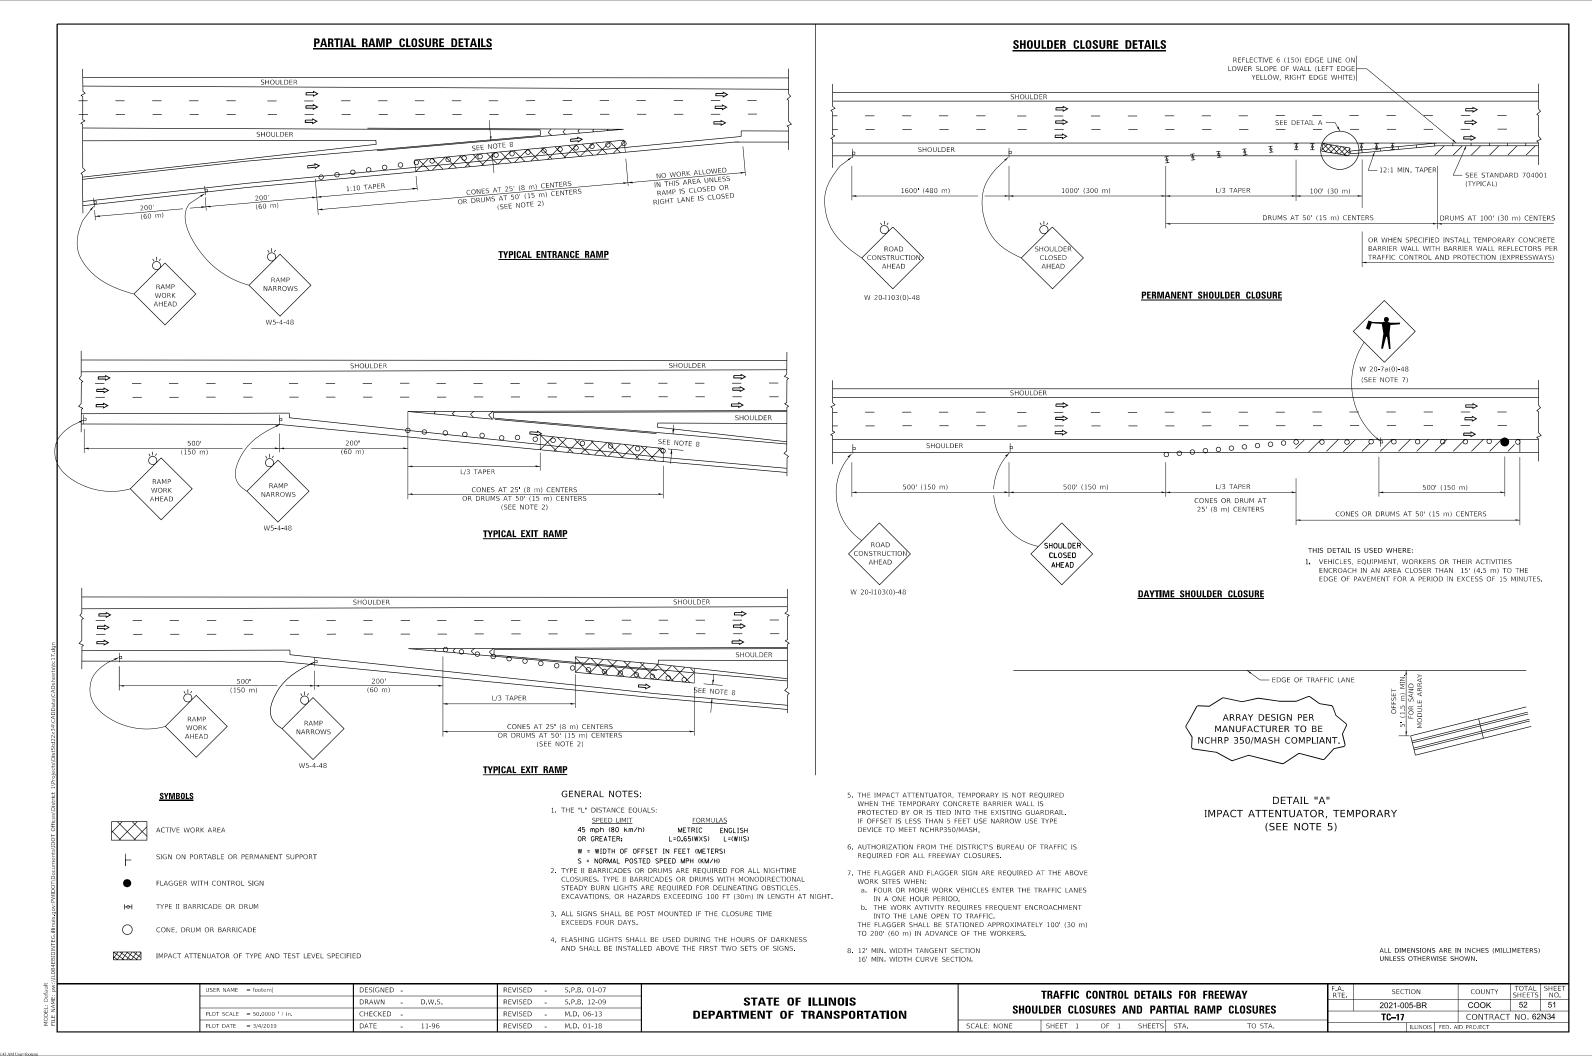

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NOTES:

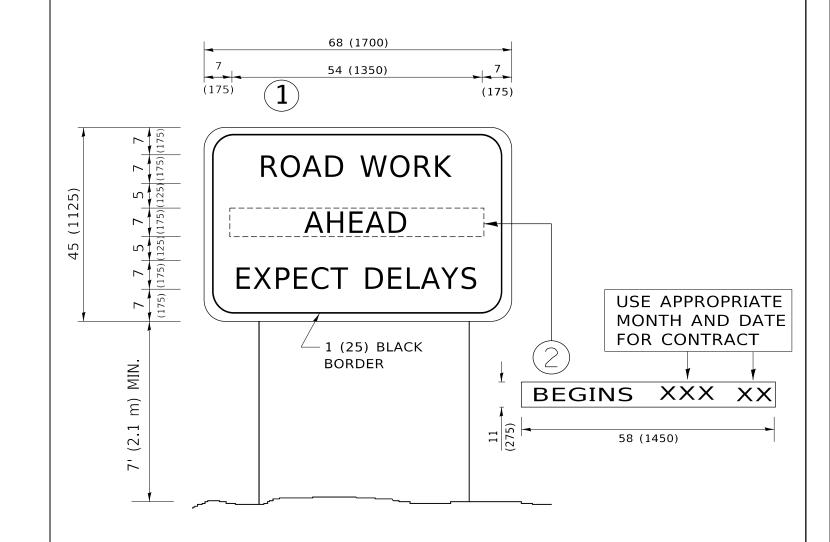- 1. USE BLACK LETTERING ON ORANGE BACKGROUND.
- 2. ERECT SIGNS IN ADVANCE OF THE LOCATION FOR THE "ROAD CONSTRUCTION AHEAD" SIGN AT LOCATIONS AS DIRECTED BY THE ENGINEER.
- 3. ERECT SIGN 1 WITH INSTALLED PANEL 2 ONE WEEK PRIOR TO THE START OF CONSTRUCTION.
- 4. REMOVE PANEL(2)SOON AFTER THE START OF CONSTRUCTION.
- 5. SEE SPECIAL PROVISION FOR "TEMPORARY INFORMATION SIGNING" FOR ADDITIONAL INFORMATION.

SHEET

6. ONE SIGN ASSEMBLY EQUALS 25.70 SQ. FT. (2.3 SQ. M.)

SCALE: NONE

7. SHALL BE PAID FOR AS TEMPORARY INFORMATION SIGNING.

ALL DIMENSIONS ARE IN INCHES (MILLIMETERS) UNLESS OTHERWISE SHOWN.

USER NAME = rootemj	DESIGNED -	KEVISED	- R. MIRS 09-15-97
	DRAWN -	REVISED	- R. MIRS 12-11-97
PLOT SCALE = 50.0000 / in.	CHECKED -	REVISED	-T. RAMMACHER 02-02-99
PLOT DATE = 3/4/2019	DATE -	REVISED	- C. JUCIUS 01-31-07

	ARTERIAL ROAD					SECTION
	INFORMATION SIGN					2021-005-BR
	IIVI OIII	MATION	JIGIN			TC-22
1	OF 1	SHEETS	STA.	TO STA.		ILLINOIS