03-11-2022 LETTING ITEM 004

STATE OF ILLINOIS

DEPARTMENT OF TRANSPORTATION

D-91-511-20

FOR INDEX OF SHEETS, SEE SHEET NO. 2

THIS PROJECT IS LOCATED IN THE VILLAGE OF HAMPSHIRE

PROPOSED HIGHWAY PLANS

FAP ROUTE 525: US 20 / GRANT HWY MCHENRY CO LINE TO 1-90 (JANE ADDAMS MEMORIAL TOLLWAY)

> **SECTION: 2020-112-RS** PROJECT: NHPP-LWCT(653) **SMART OVERLAY, DRAINAGE KANE COUNTY**

> > C-91-309-20

GROSS AND NET LENGTH = 5370 FT. = 1.017 MILES

R 6 E R 7 E **PROJECT ENDS** STA 69 + 35.7 HUNTLEY PROJECT BEGINS MAIN ST. HARMONY STA 15 + 65.4LOCATION MAP (NOT TO SCALE) TOWNSHIP FREEMAN ALLEN HAMPSHIRE ENGINEERING SCALES. REDUCED SIZED PLANS WILL NOT CONFORM TO STANDARD SCALES, IN MAKING MEASUREMENTS HAMPSHIRE ON REDUCED PLANS, THE ABOVE SCALES MAY BE USED. STARKS JOINT UTILITY LOCATION INFORMATION FOR EXCAVATION 1-800-892-0123

LOCATION OF SECTION INDICATED THUS: -STATE OF ILLINOIS

OF THE STATE OF ILLINOIS

CONTRACT NO. 62L90

PROJECT MANAGER: FAWAD AQUEEL

PROJECT ENGINEER: VESELIN VELICHKOV (847) 705-4432

(847) 705-4247

0

0

0

0

US 20:

TRAFFIC DATA:

ADT (2019) = 10400SPEED LIMIT = 45-55 MPH

PRINTED BY THE AUTHORITY

INDEX OF SHEETS

SHEET NO.	DESCRIPTION
1	COVER SHEET
2	INDEX OF SHEETS, STANDARDS AND GENERAL NOTES
3 - 7	SUMMARY OF QUANTITIES
8 - 11	TYPICAL SECTIONS
12 - 13	SCHEDULE OF QUANTITIES
14 - 16	ROADWAY AND PAVEMENT MARKING PLAN
17 - 21	SUGGESTED STAGES OF CONSTRUCTION AND TRAFFIC CONTROL
22 - 23	EROSION CONTROL / LANDSCAPING PLAN
24	DETECTOR LOOP REPLACEMENT PLAN
25 - 26	TRAFFIC SIGNAL PLAN
27	DRIVEAWAY DETAILS - DISTANCE BETWEEN R.O.W AND FACE OF CURB & EDGE OF SHOULDER ≥ 15' (BD-01)
28	DRIVEAWAY DETAILS - DISTANCE BETWEEN R.O.W AND FACE OF CURB & EDGE OF SHOULDER < 15' (BD-02)
29	DETAILS FOR FRAMES AND LIDS ADJACENT WITH MILLING (BD-08)
30	PAVEMENT PATCHING FOR HMA SURFACED PAVEMENT (BD-22)
31	CURB OR CURB AND GUTTER REMOVAL AND REPLACEMENT (BD-24)
32	BUTT-JOINT AND HMA TAPER DETAILS (BD-32)
33	ENTRANCE AND EXIT RAMP CLOSURE DETAILS (TC-08)
34	TRAFFIC CONTROL AND PROTECTION FOR SIDE ROAD, INTERSECTIONS AND DRIVEWAYS (TC-10)
35	TYPICAL APPLICATIONS RAISED REFLECTIVE PAVEMENT MARKERS (SNOW-PLOW RESISTANT) (TC-11)
36	DISTRICT ONE TYPICAL PAVEMENT MARKINGS (TC-13)
37	TRAFFIC CONTROL AND PROTECTION AT TURN BAYS (TO REMAIN OPEN TO TRAFFIC) (TC-14)
38	SHORT TERM PAVEMENT MARKING LETTERS AND SYMBOLS (TC-16)
39	TRAFFIC CONTROL DETAILS FOR FREEWAY SHOULDER CLOSURES AND PARTIAL RAMP CLOSURES (TC-17)
40	ARTERIAL ROAD INFORMATION SIGN (TC-22)
41	DRIVEWAY ENTRANCE SIGNING (TC-26)
42	DISTRICT ONE STANDARD TRAFFIC SIGNAL DESIGN DETAILS (TS-05, SHEET 2 OF 7)
43	DISTRICT ONE DETECTOR LOOP INTALLATION DETAILS FOR ROADWAY RESURFACING (TS-07)
44 - 50	ILLINOIS TOLLWAY DETAILS

STATE STANDARDS

OCCOOL-OR STANDARD SYMBOLS ARRESVIATIONS & DATTERNS

000001-08	STANDARD SYMBOLS, ABBREVIATIONS & PATTERNS
442201-03	CLASS C & D PATCHES
482011-03	HMA SHLD. STRIPS/SHLDS. WITH RESURFACING OR WIDENING AND RESURFACING PROJECTS
604001-05	FRAME AND LIDS TYPE 1
606001-08	CONCRETE CURB TYPE B AND COMBINATION CONCRETE CURB AND GUTTER
606301-04	PC CONCRETE ISLANDS AND MEDIANS
642001-03	SHOULDER RUMBLE STRIPS, 16"
701006-05	OFF-RD OPERATIONS, 2L, 2W, 15' TO 24" FROM PAVEMENT EDGE
701011-04	OFF-RD MOVING OPERATIONS, 2L, 2W, DAY ONLY
701101-05	OFF-RD OPERATIONS, MULTILANE, 15' TO 24" FROM PAVEMENT EDGE
701201-05	LANE CLOSURE, 2L, 2W, DAY ONLY, FOR SPEEDS > 45MPH
701301-04	LANE CLOSURE, 2L, 2W, SHORT TIME OPERATIONS
701306-04	LANE CLOSURE, 2L, 2W, SLOW MOVING OPERATIONS DAY ONLY, FOR SPEEDS > 45 MPH
701311-03	LANE CLOSURE, 2L, 2W, MOVING OPERATIONS - DAY ONLY
701411-09	LANE CLOSURE, MULTILANE, AT ENTRANCE OR EXIT RAMP, FOR SPEEDS > 45 MPH
701501-06	URBAN LANE CLOSURE, 2L, 2W, UNDIVIDED
701502-09	URBAN LANE CLOSURE, 2L, 2W, WITH BIDIRECTIONAL LEFT TURN LANE
701601-09	URBAN LANE CLOSURE, MULTILANE, 1W OR 2W WITH NONTRAVERSABLE MEDIAN
701606-10	URBAN SINGLE LANE CLOSURE, MULTILANE, 2W WITH MOUNTABLE MEDIAN
701701-10	URBAN LANE CLOSURE, MULTILANE INTERSECTION
701901-08	TRAFFIC CONTROL DEVICES
780001-05	TYPICAL PAVEMENT MARKINGS
886001-01	DETECTOR LOOP INSTALLATIONS
GEI	NERAL NOTES

- BEFORE STARTING ANY EXCAVATION, THE CONTRACTOR SHALL CALL "J.U.L.I.E." AT (800) 892-0123 OR 811 FOR FIELD LOCATIONS OF BURIED ELECTRIC, TELEPHONE, AND GAS FACILITIES. (48 HOUR NOTIFICATION IS REQUIRED.)
- 2. THE CONTRACTOR SHALL COORDINATE CONSTRUCTION ACTIVITIES WITH UTILITY COMPANIES, AND THE VILLAGE OF HAMPSHIRE.
- 3. THE CONTRACTOR WILL NOT BE ALLOWED TO SET UP A YARD OR FIELD OFFICE ON STATE (OR TOLLWAY) PROPERTY WITHOUT WRITTEN PERMISSION FROM THE DEPARTMENT.
- 4. BEFORE BEGINNING ANY WORK, THE CONTRACTOR SHALL RETAIN AND RECORD FOR FUTURE REFERENCE, ALL EXISTING PAVEMENT MARKING LINES (AND RAISED REFLECTIVE PAVEMENT MARKERS) IN ORDER THAT THESE LOCATIONS CAN BE RE-ESTABLISHED FOR STRIPING. EXACT LOCATIONS OF ALL PAVEMENT MARKINGS SHALL BE AS SHOWN ON THE PLANS OR AS DIRECTED BY THE ENGINEER.
- 5. IT SHALL BE THE CONTRACTOR'S RESPONSIBILITY TO VERIFY ALL DIMENSIONS AND CONDITIONS EXISTING IN THE FIELD PRIOR TO CONSTRUCTION AND ORDERING OF MATERIALS.
- 6. ANY PAVEMENT MARKINGS AND RAISED REFLECTIVE PAVEMENT MARKERS OBLITERATED BY MILLING AND RESURFACING OPERATIONS ON SIDE STREETS AND ENTRANCES SHALL BE REPLACED AND PAID FOR IN KIND.
- 7. ALL DAMAGE TO EXISTING PAVEMENT MARKINGS OR RAISED REFLECTIVE PAVEMENT MARKERS OUTSIDE THE REMOVAL LINE SHOWN ON THE PLANS SHALL BE REPLACED AT THE CONTRACTOR'S EXPENSE.
- 8. ALL PAVEMENT PATCHING, CURB AND GUTTER REMOVAL AND REPLACEMENT, DRAINAGE ADJUSTMENTS, AND CONCRETE BARRIER MEDIAN REPAIR LOCATIONS WILL BE DETERMINED IN THE FIELD BY THE RESIDENT ENGINEER/TECHNICIAN.
- FRAMES AND GRATES ADJUSTMENT OF PRIVATE UTILITIES WITHIN THE LIMITS OF THE IMPROVEMENTS SHALL BE DONE BY THEIR RESPECTIVE OWNERS AND ARE NOT PART OF THIS CONTRACT.

- 10. THE CONTRACTOR SHALL BE REQUIRED TO PROVIDE ACCESS TO ABUTTING PROPERTY AT ALL TIMES DURING THE CONSTRUCTION OF THIS PROJECT.
- 11. DO NOT SCALE PLANS FOR CONSTRUCTION DIMENSIONS.
- 12. TEN (10) FOOT TRANSITIONS SHALL BE USED TO MATCH PROPOSED CURB AND GUTTER AND MEDIAN ITEMS OF WORK TO EXISTING CURBS AND GUTTER AND MEDIANS IN THE FIELD, UNLESS OTHERWISE SHOWN. THE TRANSITIONS SHALL BE PAID FOR AT THE CONTRACT UNIT PRICE FOR THE PROPOSED ITEMS OF WORK SPECIFIED.
- 13. WHEN THE MILLED PAVEMENT IS OPEN TO TRAFFIC THE MAXIMUM GRADE DIFFERENTIAL BETWEEN PASSES OF THE MILLING MACHINE SHALL NOT EXCEED 11/2 INCHES WHERE THE SPEED LIMIT IS 40 MPH OR LESS AND 1 INCH WHERE THE SPEED LIMIT IS GREATER THAN 40 MPH. WITH WRITTEN APPROVAL OF THE ENGINEER, A MAXIMUM GRADE DIFFERENTIAL OF 3 INCHES MAY BE ALLOWED IF THE EDGE OF THE MILLING IS SLOPED A MINIMUM 1:3 (V:H) OR A NOTCHED LONGITUDINAL WEDGE IS USED.
- 14. THE CONTRACTOR SHALL CONTACT THE DISTRICT ONE ARTERIAL TRAFFIC CONTROL SUPERVISOR AT KALPANA, KANNAN-HOSADURGA@ILLINOIS.GOV, A MINIMUM OF 72 HOURS IN ADVANCE OF BEGINNING WORK.
- 15. THE RESIDENT ENGINEER SHALL CONTACT WALTER CZARNY, AREA TRAFFIC FIELD ENGINEER AT WALTER.CZARNY@ILLINOIS.GOV A MINIMUM OF TWO (2) WEEKS PRIOR TO THE PLACEMENT OF PERMANENT PAVEMENT MARKINGS.
- 16. DOUBLE LANE MARKERS ARE TO BE USED AS SHOWN ON THE DISTRICT ONE DETAIL "TYPICAL APPLICATIONS RAISED REFLECTIVE PAVEMENT MARKERS (SNOW-PLOW RESISTANT)" SHOWN IN THE PLANS.
- 17. TEMPORARY PAVEMENT MARKING LINE 4" TYPE III TAPE SHALL BE USED FOR SHORT TERM PAVEMENT MARKING ON ALL FINAL SURFACES.
- 18. BUTT JOINTS WILL BE INSTALLED AT THE ENDS OF ALL RESURFACING (WHERE RESURFACING MEETS EXISTING PAVEMENT) ACCORDING TO THE "BUTT JOINT AND HOT-MIX ASPHALT TAPER DETAILS" SHEET INCLUDED IN THE PLANS, UNLESS OTHERWISE SPECIFIED.
- 19. EXISTING BROKEN FRAMES AND LIDS SHALL BE REMOVED AND DISPOSED OF BY THE THE CONTRACTOR AND SHALL BE REPLACED AS DIRECTED BY THE ENGINEER. REPLACEMENT FRAMES AND LIDS WILL BE PAID FOR ACCORDING TO ARTICLE 109.04 OF THE STANDARD UNLESS A SEPARATE PAY ITEM HAS BEEN PROVIDED.
- 20. OVERNIGHT LANE CLOSURES SHALL NOT BE ALLOWED FOR REHABILITATION PROJECTS INVOLVING DAYTIME MILLING AND RESURFACING OPERATIONS AND CLASS D PATCHING UNLESS OTHER CONDITIONS WARRANT EXTENDED LANE CLOSURES AS DETERMINED AND APPROVED IN WRITING BY THE ENGINEER OR AS PROVIDED FOR IN THE CONTRACT SPECIFICATIONS.
- 21. THE CONTRACTOR SHALL MAINTAIN PEDESTRIAN ACCESS AT ALL TIMES DURING CONSTRUCTION.
- 22. THE CONTRACTOR SHALL COMPLETE THE SHOULDER WIDENING WORK THAT IS SHOWN IN MAINTENANCE OF TRAFFIC STAGES 1 AND 2 PRIOR TO BEGINNING ANY MILLING, PAVEMENT PATCHING OR CURB AND GUTTER WORK WITHIN STATIONS 53+00 AND 44+00.

F7: F 4:44F -	HOED WAVE - THE -	DECICNED	DEVICED
FILE NAME :	USER NAME = elkhatıbaj	DESIGNED -	REVISED -
pw:\\ildot"pw.bentley.com:PWIDOT\Document	s\IDOT Offices\District 1\Projects\DI51120\CA	IGRaNiNesign\9151120=sht=gennote.dgn	REVISED -
	PLOT SCALE = 100.0000 ' / in.	CHECKED -	REVISED -
Default	PLOT DATE = 12/15/2021	DATE -	REVISED -


	SUMMARY OF QUANTITIES			1	CONSTRUCTI	ON TYPE CODE			SUMMARY OF QUANTITIES				COL	NSTRUCTION	TYPE CODE	
CODE NO		UNIT		BO% FED D% STATE 100% STATE ROADWAY 0005 0005 URBAN URBAN	YY			CODE NO	ITEM	UNIT	TOTAL QUANTITIES	80% FED 20% STATE 1 ROADWAY 0005 URBAN	00% STATE ROADWAY 0005 URBAN			
20200100	EARTH EXCAVATION	CU YD	1025	1025			*	28100105	STONE RIPRAP, CLASS A3	SQ YD	1240	1240				
21101610	TOPSOIL FURNISH AND PLACE, 3"	SO YD	1034	1034				35101800	AGGREGATE BASE COURSE, TYPE B 6"	SO YD	719	719				
21101615	TOPSOIL FURNISH AND PLACE, 4"	SO YD	83	83				40600290	BITUMINOUS MATERIALS (TACK COAT)	POUND	12427	12427				
21400100	GRADING AND SHAPING DITCHES	FOOT	1820	1820				40600370	LONGITUDINAL JOINT SEALANT	FOOT	9323	9323				
25000210	SEEDING, CLASS 2A	ACRE	1	1				40600400	MIXTURE FOR CRACKS, JOINTS, AND	TON	41	41				
									FLANGEWAYS							
25000400	NITROGEN FERTILIZER NUTRIENT	POUND	405	405				40600982	HOT-MIX ASPHALT SURFACE REMOVAL - BUTT	SO YD	134	134				
25000600	POTASSIUM FERTILIZER NUTRIENT	POUND	405	405					JOINT							
25003312	INTERSEEDING, CLASS 4A	ACRE	3. 25	3. 25				40601005	HOT-MIX ASPHALT REPLACEMENT OVER	TON	76	76				
25003314	INTERSEEDING, CLASS 4B	ACRE	0. 25	0. 25					PATCHES							
23003314	INTERSEEDING, CEASS AB	ACILE	0.23	0.23				40604172	POLYMERIZED HOT-MIX ASPHALT SURFACE	TON	2706	2706				
25100630	EROSION CONTROL BLANKET	SO YD	4281	4281					COURSE, IL-9.5, MIX "E", N70							
25200110	SODDING. SALT TOLERANT	SO YD	83	83				42001300	PROTECTIVE COAT	SO YD	688	688				
25200200	SUPPLEMENTAL WATERING	UNIT	1	1				44000100	PAVEMENT REMOVAL	SO YD	103	103				
28000305	TEMPORARY DITCH CHECKS	FOOT	269	269				44000156	HOT-MIX ASPHALT SURFACE REMOVAL, 1	SO YD	27616	27616				
28000400	PERIMETER EROSION BARRIER	FOOT	340	340					<i>5</i> .							
28000500	INLET AND PIPE PROTECTION	EACH	6	6				44000300	CURB REMOVAL	FOOT	2163	2163				
Mary Company (1997)	TEMPORARY EROSION CONTROL BLANKET	SO YD	4281	4281				44002212	HOT-MIX ASPHALT REMOVAL OVER PATCHES, 3"	SO YD	454	454			# = SPECIALTY I △ = NON-PARTICI WORK (100%	PATING
FILE NAME: pw///Idde	USER NAME = elkhatibaj PLOT SCALE = 100.0000 ' / in. PLOT DATE = 12/16/2021	DESIGNED - DRAWN - CHECKED - DATE -	7201	REVISED - REVISED - REVISED - REVISED -			STATE OF IL		TION US 20 (MCHENRY CO LINE TO I— SUMMAR SCALE: NONE SHEET OF	90 (JANE ADD BY OF QUANTITE SHEETS STA.	TES	RIAL TOLLWA	Y)) F.A.P. RTE. 525	SECTIO 2020-112	N COUNTY	TOTAL SHEE SHEETS NO.

	SUMMARY OF QUANTITIES				СО	NSTRUCTION	TYPE CO	DE			SUMN	MARY OF QUANTITIES				CONS	STRUCTION TYPE	CODE	
CODE NO	ITEM	UNIT	TOTAL QUANTITIES	80% FED 20% STATE ROADWAY 0005 URBAN	100% STATE ROADWAY 0005 URBAN	Ξ				CODE NO		ITEM	UNIT	TOTAL QUANTITIES	80% FED 20% STATE II ROADWAY 0005 URBAN	00% STATE ROADWAY 0005 URBAN			
44003100	MEDIAN REMOVAL	SO FT	1985	1985					*	66900530	SOIL DISPOSA	L ANALYSIS	EACH	5	5				
44201761	CLASS D PATCHES, TYPE I, 10 INCH	SO YD	50	50					*	66901001	REGULATED SL	BSTANCES PRE-CONSTRUCTION	LSUM	1	1				
											PLAN								
44201765	CLASS D PATCHES, TYPE II, 10 INCH	SO YD	304	304															
									*	66901003	REGULATED SL	BSTANCES FINAL CONSTRUCTION	LSUM	1	1				
44201769	CLASS D PATCHES, TYPE III, 10 INCH	SO YD	193	193							REPORT								
44201771	CLASS D PATCHES, TYPE IV, 10 INCH	SO YD	55	55					*	66901006	REGULATED SL	BSTANCES MONITORING	CAL DA	15	15				
44201794	CLASS D PATCHES, TYPE III, 12 INCH	SO YD	43	43						67100100	MOBILIZATION		L SUM	1	1				
										70103815	TRAFFIC CONT	ROL SURVEILLANCE	CAL DA	15	15				
44201796	CLASS D PATCHES, TYPE IV. 12 INCH	SO YD	69	69						70107025	CHANGEABLE N	ESSAGE SIGN	CAL DA	15	15				
48102100	AGGREGATE WEDGE SHOULDER, TYPE B	TON	74	74						70300100	SHORT TERM F	AVEMENT MARKING	F00T	16038	16038				
48203029	HOT-MIX ASPHALT SHOULDERS, 8"	SO YD	719	719						70300150	SHORT TERM F	AVEMENT MARKING REMOVAL	SO FT	7463	7463				
60300105	FRAMES AND GRATES TO BE ADJUSTED	EACH	10	10						70300211	TEMPORARY PA	VEMENT MARKING LETTERS AND	SO FT	646	646				
sht-SOQ.dgn			2.44	0.44							SYMBOLS - PA	INT							
60603800	COMBINATION CONCRETE CURB AND GUTTER, TYPE B-6.12	FOOT	2146	2146						70300221	TEMPODADY DAVE	MENT MARKING - LINE 4" - PAINT	FOOT	17152	17152				
DData(Desig	1172 8-0.12									10300221	IEMPORARI PAVE	MENT MARKING - LINE 4 - FAINT	7001	17152	17152				
60618320	CONCRETE MEDIAN SURFACE, 6 INCH	SO FT	725	725						70300241	TEMPORARY PAVE	MENT MARKING - LINE 6" - PAINT	F00T	2226	2226				
espostudit 1/Poje	CONCRETE MEDIAN, TYPE SB-6.12	SO FT	994	994						70300251	TEMPORARY PAVE	MENT MARKING - LINE 8" - PAINT	FOOT	520	520				
Office Control of Cont																			
64200116	SHOULDER RUMBLE STRIPS, 16 INCH	FOOT	3620	3620						70300261	<u> </u>	MENT MARKING - LINE 12" -	FOOT	1340	1340				
100t-pw, bentlew 100t-pw, bentlew 100t-pw, bentlew 100t-pw, pentlew 100t-p	NON-SPECIAL WASTE DISPOSAL	CU YD	1025	1025							PAINT							SPECIALTY NON-PARTIC WORK (100%	IPATING
MME: pw://	USER NAME = elkhatibaj	DESIGNED - DRAWN -	_1	REVISED REVISED	-			S.	TATE OF IL	LINOIS	l	US 20 (MCHENRY CO LINE TO 1–90			RIAL TOLLWAY		SECTION	COUNTY	TOTAL SHEE SHEETS NO.
FILE NA	<u> </u>	CHECKED - DATE -		REVISED REVISED			D		ENT OF TR		ATION		OF QUANTITI		TO STA.	525	2020-112-RS	KANE CONTRACT D. AID PROJECT	NO. 62L90


	SUMMARY OF QUANTITIES		CO	NSTRUCTION	N TYPE CODE		SUMMARY OF QUANTI	TIFS			CONSTRUCTIO	N TYPE CODE	
CODE NO	ITEM	UNIT	TOTAL 80% FED 20% STATE 100% STATE QUANTITIES ROADWAY ROADWAY 0005 0005			CODE NO	ITEM	UNIT	TOTAL QUANTITIES	80% FED 20% STATE 100% ST ROADWAY ROADW 0005 0005	AY		
7070004			URBAN URBAN			7070000	DANESSES AND DESCRIPTION OF THE PROPERTY OF TH		0507	URBAN URBA			
70300281	TEMPORARY PAVEMENT MARKING - LINE 24"	FOOT	170 170			78300202	PAVEMENT MARKING REMOVAL - W.	ATER BLASTING SO FT	9503	9503			
	- PAINT												
						* 81028200	UNDERGROUND CONDUIT, GALVANIZ	ED STEEL, FOOT	265	265			
70306120	TEMPORARY PAVEMENT MARKING - LINE 4" -	FOOT	4010 4010				2" DIA.						
	TYPE III TAPE												
						* 81028240	UNDERGROUND CONDUIT, GALVANIZ	ED STEEL, FOOT	173	173			
* 72400100	REMOVE SIGN PANEL ASSEMBLY - TYPE A	EACH	3 3				4" DIA.						
* 78000100	THERMOPLASTIC PAVEMENT MARKING -	SO FT	646 646			* 81400100	HANDHOLE	EACH	1	1			
	LETTERS AND SYMBOLS												
						* 81400200	HEAVY-DUTY HANDHOLE	EACH	1	1			
* 78000200	THERMOPLASTIC PAVEMENT MARKING - LINE	FOOT	17152 17152										
	4"					* 85000200	MAINTENANCE OF EXISTING TRAFF	IC SIGNAL EACH	1	1			
							INSTALLATION						
* 78000400	THERMOPLASTIC PAVEMENT MARKING - LINE	FOOT	2226 2226										
	6"					* 87301225	ELECTRIC CABLE IN CONDUIT, SI	GNAL NO. FOOT	375	375			
							14 3C						
* 78000500	THERMOPLASTIC PAVEMENT MARKING - LINE	FOOT	520 520										
	8"					** 87301245	ELECTRIC CABLE IN CONDUIT, SI	GNAL NO. FOOT	466	466			
ugp							14 5C						
₹ 78000600	THERMOPLASTIC PAVEMENT MARKING - LINE	FOOT	1340 1340										
18000000		7001	1340			¥ 97701255	ELECTRIC CABLE IN CONDUIT. SI	CNAL NO. FOOT	000	0.00			
ata/Design	12"					* 87301255	<u> </u>	GNAL NO. FOOT	869	869			
120/CADD.							14 7C						
来 78000650	THERMOPLASTIC PAVEMENT MARKING - LINE	FOOT	170 170										
ict 1\Proje	24"					* 87301305	ELECTRIC CABLE IN CONDUIT, LE	AD-IN, NO. FOOT	1101	1101			
fices/Distr							14 1 PAIR						
78100100	RAISED REFLECTIVE PAVEMENT MARKER	EACH	285 285										
Document						* 87301900	ELECTRIC CABLE IN CONDUIT. EO	UIPMENT FOOT	214	214			
78300200	RAISED REFLECTIVE PAVEMENT MARKER	EACH	285 285				GROUNDING CONDUCTOR, NO. 6	1C					
dot-pw.bentley.com	REMOVAL											<pre># = SPECIALTY ITEM</pre>	TING
ILE NAME: pw:WI	PLOT SCALE = 100,0000 ' / in. C	DESIGNED - DRAWN - CHECKED - DATE -	REVISED -			ATE OF ILLINOIS IT OF TRANSPORTA		CO LINE TO 1–90 (JANE AD SUMMARY OF QUANT	ITIES		A.P. SECT FE. 2020-1	ION COUNTY TOT SHEE 12-RS KANE SC CONTRACT NO. ILLINOIS FED. AID PROJECT	TAL SHEE ETS NO. 0 5

	SUMMARY OF QUANTITIES				CONSTRUCTION	ON TYPE COL	DE I		SUMMARY OF QUANTITIES				CONSTRUC	TION TYPE CODE	1
CODE NO	ITEM	UNIT	TOTAL QUANTITIES		100% STATE ROADWAY 0005 URBAN			CODE NO	ITEM	UNIT	TOTAL QUANTITIES	80% FED 20% STATE 100% S ROADWAY ROAD 0005 00 URBAN URB	WAY D5		
87900200	DRILL EXISTING HANDHOLE	EACH	6	6				* ×1400201	RADAR VEHICLE DETECTION SYSTEM, SINGLE	EACH	1	1			
									APPROACH, STOP BAR						
88030100	SIGNAL HEAD, LED, 1-FACE, 5-SECTION,	EACH	2	2											
	BRACKET MOUNTED							X2020110	GRADING AND SHAPING SHOULDERS	UNIT	30	30			
88030110	SIGNAL HEAD, LED, 1-FACE, 5-SECTION,	EACH	2	2				X2503110	MOWING (SPECIAL)	ACRE	3. 25	3. 25			
	MAST-ARM MOUNTED														
								X4400501	COMBINATION CURB AND GUTTER REMOVAL AND	FOOT	250	250			
88200410	TRAFFIC SIGNAL BACKPLATE, LOUVERED,	EACH	2	2					REPLACEMENT LESS THAN OR EQUAL TO 10 FEE	Т					
	FORMED PLASTIC														
								X4402020	CONCRETE MEDIAN SURFACE REMOVAL	SQ FT	725	725			
88600100	DETECTOR LOOP, TYPE I	FOOT	293	293											
								△ x5537800	STORM SEWERS TO BE CLEANED 12"	FOOT	150	1	50		
88600600	DETECTOR LOOP REPLACEMENT	FOOT	442	442											
								X6700407	ENGINEER'S FIELD OFFICE, TYPE A (D1)	CAL MO	12	12			
89502200	MODIFY EXISTING CONTROLLER	EACH	1	1											
								X7010216	TRAFFIC CONTROL AND PROTECTION,	L SUM	1	1			
89502300	REMOVE ELECTRIC CABLE FROM CONDUIT	FOOT	884	884					(SPECIAL)						
89502375	REMOVE EXISTING TRAFFIC SIGNAL	EACH	1	1				* ×7230100	INSTALL SIGN PANEL - TYPE 1	SO FT	27	27			
	EQUIPMENT														
								* x8950205	REBUILD EXISTING HANDHOLE, SPECIAL	EACH	2	2			
89502380	REMOVE EXISTING HANDHOLE	EACH	2	2											
								Z0004562	COMBINATION CONCRETE CURB AND GUTTER	FOOT	250	250			
К0029614	WEED CONTROL. AQUATIC	GALLON	1	1					REMOVAL AND REPLACEMENT						
x0327120	WEED CONTROL. NATIVE LANDSCAPE	ACRE	3. 25	3. 25				△ Z0018500	DRAINAGE STRUCTURES TO BE CLEANED	EACH	15	1	5		
	ENHANCEMENT							1							
								Z0030850	TEMPORARY INFORMATION SIGNING	SO FT	205.6	205. 6			
														¥ = SPECIALT △ = NON-PART WORK (10	ICIPATIN
		DESIGNED -		REVISED		<u> </u>	07177 67		US 20 (MCHENRY CO LINE TO I	–90 (JANE ADI	AMS MEMO	RIAL TOLLWAY))	F.A.P. S	ECTION COUNT	Y TOTAL SHEETS
	PLOT SCALE = 100.0000 / in.	DRAWN - CHECKED - DATE -		REVISED REVISED	-	D	STATE OF EPARTMENT OF 1		AVMINIS	RY OF QUANTI	TIES	TO STA.		0-112-RS KANE CONTRA	


	SUMMARY OF QUANTITIES				CONSTINU	CTION TYPE CO				SUMMARY OF QUANTITIES	l		ONSTRUCTION		<u></u>	_
CODE NO	ITEM	UNIT	TOTAL QUANTITIES	80% FED 20% STATE ROADWAY 0005 URBAN	100% STATE ROADWAY 0005 URBAN				CODE NO	ITEM	TOTAL UNIT QUANTITIE	80% FED 20% STATE 100% STAT S ROADWAY ROADWAY 0005 0005 URBAN URBAN				
Z0064600	SELECTIVE CLEARING	ACRE	1. 75	1. 75												
20076600	TRAINEES	HOURS	500	500												
Z0076604	TRAINEES - TRAINING PROGRAM GRADUATE	HOURS	500	500												
																<u> </u>
																<u> </u>
																L
																$\frac{1}{1}$
																L
																<u> </u>
																<u> </u>
														* = SPE △ = NO' WO	ECIALTY I N-PARTICI RK (100%	TE IPA ST
	USER NAME = elkhatibaj PLOT SCALE = 100.0000 ' / in.	DESIGNED - DRAWN - CHECKED -		REVISED REVISED	-		ST SEPARTME	TATE OF ILL	LINOIS	CIIN	TO 1–90 (JANE ADDAMS MEM IMARY OF QUANTITIES	ORIAL TOLLWAY)) F.A.P RTE. 525	SECTIO 2020-112	2-RS	COUNTY S	TOT/ SHEE

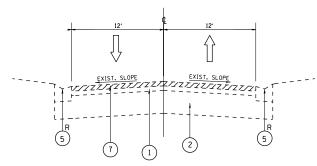


EXISTING TYPICAL CROSS SECTION STA. 15+65 TO 18+92

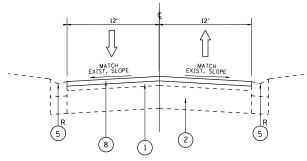


PROPOSED TYPICAL CROSS SECTION STA. 15+65 TO 18+92

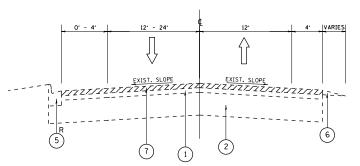


EXISTING TYPICAL CROSS SECTION STA. 18+92 TO 28+00

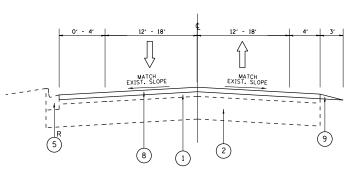

PROPOSED TYPICAL CROSS SECTION STA. 18+92 TO 28+00

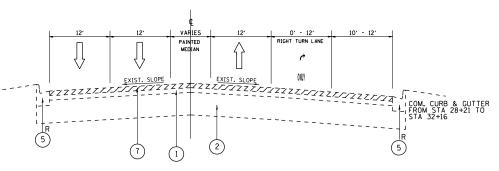

EXISTING TYPICAL CROSS SECTION STA. 28+00 TO 36+00

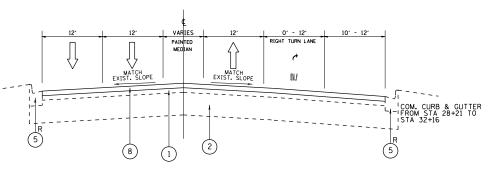

US 20

SCALE:

PROPOSED TYPICAL CROSS SECTION STA. 28+00 TO 36+00

LEGEND:

- (1) EXIST. HOT-MIX ASPHALT, 3"
- (2) EXIST. P.C.C. PAVEMENT, 10"
- (3) EXIST. CORRUGATED MEDIAN
- 4) EXIST. BARRIER MEDIAN
- (5) EXIST. COMB. CONC. CURB AND GUTTER
- (6) EXIST. AGGREGATE SHOULDER
- 7) PROP. HOT-MIX ASPHALT SURFACE REMOVAL, 1.75"
- 8 PROP, POLYMERIZED HOT-MIX ASPHALT SURFACE COURSE, MIX "E", IL-9.5, N70, 1.75 "
- 9 PROP. AGGREGATE WEDGE SHOULDER, TYPE B
- (10) PROP. CLASS D PATCH, 12"
- 11) PROP. FLUSH MEDIAN
- 12) PROP. BARRIER MEDIAN
- (13) PROP. HOT-MIX ASPHALT SHOULDER, 8"
- R CURB AND GUTTER REMOVAL AND REPLACEMENT (LOCATION AS DIRECTED BY THE ENGINEER)

NOTES:

(1) THE CONTRACTOR SHALL PATCH FIRST BEFORE MILLING
(2) THE LONGITUDINAL JOINT SEALANT SHALL BE PLACED OVER THE MILLED SURFACE

HOT-MIX ASPHALT MIXTURE RI	EQUIREMENTS	QUALITY MANAGEMENT
MIXTURE TYPE	AIR VOIDS (%)	PROGRAM (QMP)

RESURFACING MAINLINE:

POLYMERIZED HMA SURFACE COURSE, 4% @ 70 GYR. OCP MIX "E". IL-9.5. N70, 1.75"	OCP
--	-----

HOT-MIX ASPHALT SHOULDERS, 8":

HMA SURFACE COURSE, MIX "D". IL-9.5. N70, 1.75"	4% @ 70 GYR.	OC/QA
HMA BINDER COURSE, IL-19.0, N70, 6.25"	4% @ 70 GYR.	QC/QA

HOT-MIX ASPHALT PATCHING:

CLASS D PATCHES (HMA BINDER IL-19 mm), 10"; 12"	4% @ 70 GYR.	QC/QA
HOT-MIX ASPHALT REPLACEMENT OVER PATCHES (HMA BINDER IL-19 mm), 3"	4% @ 70 GYR.	QC/QA

QMP DESIGNATION: QUALITY CONTROL/QUALITY ASSURANCE (QC/QA); QUALITY CONTROL FOR PERFORMANCE (QCP)

NOTE 1: THE UNIT WEIGHT USED TO CALCULATE ALL HMA SURFACE MIXTURE QUANTITIES IS 112 LBS/SQ YD/IN

NOTE 2: THE "AC TYPE" FOR POLYMERIZED HMA MIXES SHALL BE "SBS/SBR PG 76-22" AND FOR NON-POLYMERIZED HMA.


THE "AC TYPE" SHALL BE "PG 64-22" LINESS MODIFIED BY RECLAIMED.

THE "AC TYPE" SHALL BE "PG 64-22" UNLESS MODIFIED BY RECLAIMED MATERIALS SPECIFICATIONS


USER NAME = elkhatibaj	DESIGNED -	REVISED -	
	DRAWN -	REVISED -	
PLOT SCALE = 100.0000 / in.	CHECKED -	REVISED -	
DLOT DATE - 12/15/2021	DATE	DEVICED	1

STATE OF ILLINOIS
DEPARTMENT OF TRANSPORTATION


(MCHENR	Y CO LINE	TO I-90	(JANES	ADDAM	S MEMORIAL TOLLWAY))	F.A.P. RTE	SECTION		COUNTY	TOTAL SHEETS	SHEET NO.	
•		525	2020-112-RS		KANE	50	8					
	TYPICAL SECTIONS								CONTRACT	Γ NO. 62	2L90	
	SHEET	OF	SHEETS	STA.	TO STA.		ILLINOIS	FED A	ID PROJECT			

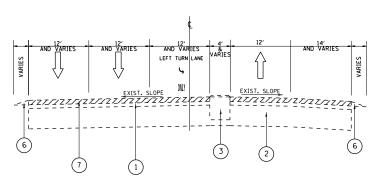



EXISTING TYPICAL CROSS SECTION STA. 36+00 TO 37+47

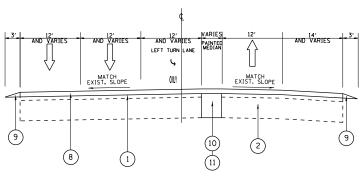


PROPOSED TYPICAL CROSS SECTION STA. 36+00 TO 37+47

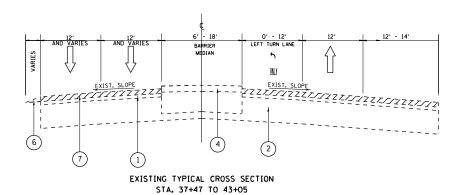

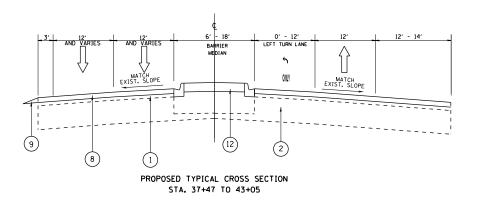

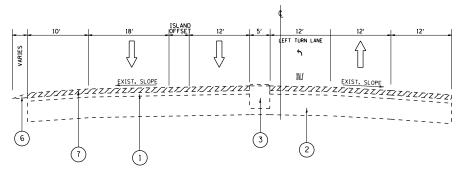

EXISTING TYPICAL CROSS SECTION STA. 43+05 TO 43+83

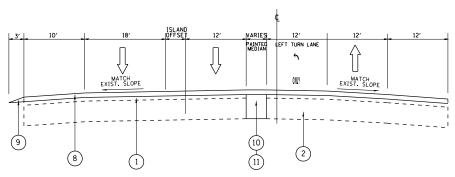

PROPOSED TYPICAL CROSS SECTION STA. 43+05 TO 43+83


JSER NAME = elkhatibaj DESIGNED REVISED DRAWN REVISED CHECKED REVISED PLOT DATE = 1/24/2022 REVISED DATE


STATE OF ILLINOIS **DEPARTMENT OF TRANSPORTATION**

US 20 (MCHENI	RY CO LINE	TO I-90	(JANES	ADDAN	IS MEMORIAL TOLLWAY))	F.A.P. RTE	SECT	ΠΟΝ	COUNTY	TOTAL SHEETS	
,	TYPICAL SECTIONS					525	2020-1	12-RS	KANE	50	9
TIFICAL SECTIONS								CONTRACT	NO. 67	2L90	
SCALE:	SHEET	OF	SHEETS	STA.	TO STA.			ILLINOIS FED.	AID PROJECT		


LEGEND:

- (1) EXIST. HOT-MIX ASPHALT, 3"
- (2) EXIST. P.C.C. PAVEMENT, 10"
- (3) EXIST. CORRUGATED MEDIAN
- 4 EXIST. BARRIER MEDIAN
- (5) EXIST. COMB. CONC. CURB AND GUTTER
- (6) EXIST. AGGREGATE SHOULDER
- PROP. HOT-MIX ASPHALT SURFACE REMOVAL, 1.75"
- PROP. POLYMERIZED HOT-MIX ASPHALT SURFACE COURSE, MIX "E", IL-9.5, N70, 1.75 $^{\prime\prime}$
- 9 PROP. AGGREGATE WEDGE SHOULDER, TYPE B
- (10) PROP. CLASS D PATCH, 12"
- 11) PROP. FLUSH MEDIAN
- 12) PROP. BARRIER MEDIAN
- (13) PROP. HOT-MIX ASPHALT SHOULDER, 8"
- R CURB AND GUTTER REMOVAL AND REPLACEMENT (LOCATION AS DIRECTED BY THE ENGINEER)

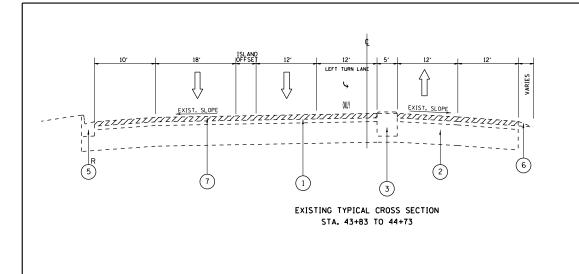


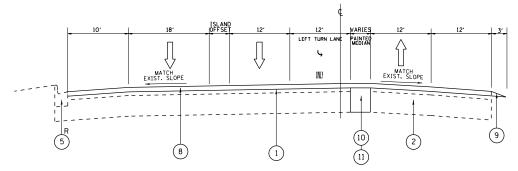

PROPOSED TYPICAL CROSS SECTION STA. 43+83 TO 44+73

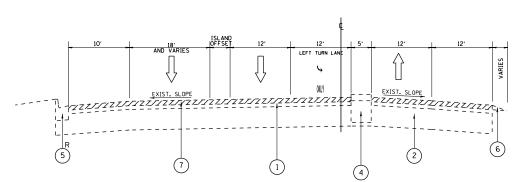


EXISTING TYPICAL CROSS SECTION STA. 44+73 TO 46+00

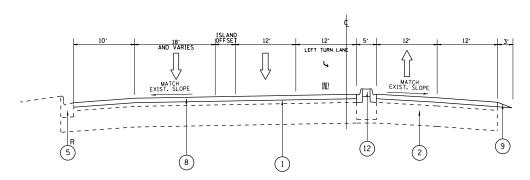

PROPOSED TYPICAL CROSS SECTION STA. 44+73 TO 46+00

EXISTING TYPICAL CROSS SECTION STA. 46+00 to 52+46

EXIST. SLOPE

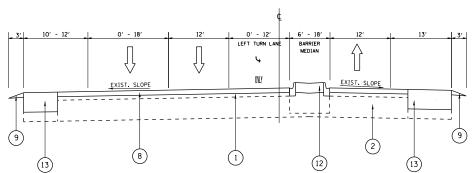

EXISTING TYPICAL CROSS SECTION STA. 46+00 to 52+46

USER NAME = elkhatibaj	DESIGNED -	REVISED -	
	DRAWN -	REVISED -	l
PLOT SCALE = 100.0000 / in.	CHECKED -	REVISED -	l
PLOT DATE = 1/24/2022	DATE -	REVISED -	

STATE OF ILLINOIS **DEPARTMENT OF TRANSPORTATION**

US 20 (MCHENF	Y CO LINE	TO I-9	0 (JANES	ADDAMS	S MEMORIAL TOLLWAY))	I
•			AL SECTION			L
SCALE:	SHEET	OF	SHEETS	STA.	TO STA.	1

LEGEND:

(1) EXIST. HOT-MIX ASPHALT, 3"

(2) EXIST. P.C.C. PAVEMENT, 10"

(3) EXIST. CORRUGATED MEDIAN

EXIST. COMB. CONC. CURB AND GUTTER

9 PROP. AGGREGATE WEDGE SHOULDER, TYPE B

(13) PROP. HOT-MIX ASPHALT SHOULDER, 8"

R CURB AND GUTTER REMOVAL AND REPLACEMENT (LOCATION AS DIRECTED BY THE ENGINEER)

PROP. HOT-MIX ASPHALT SURFACE REMOVAL, 1.75"

PROP. POLYMERIZED HOT-MIX ASPHALT SURFACE COURSE, MIX "E", IL-9.5, N70, 1.75 "

EXIST. AGGREGATE SHOULDER


(4) EXIST. BARRIER MEDIAN

(10) PROP. CLASS D PATCH, 12"


11) PROP. FLUSH MEDIAN

12) PROP. BARRIER MEDIAN


A.P.	SECTION	COUNTY	TOTAL SHEETS	SHEET NO.					
525	2020-112-RS	KANE	50	10					
		CONTRACT	NO. 62	2L90					
	TILLINOIS LEED AID PROJECT								

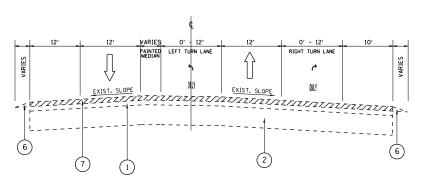


EXISTING TYPICAL CROSS SECTION STA. 52+46 TO 57+44

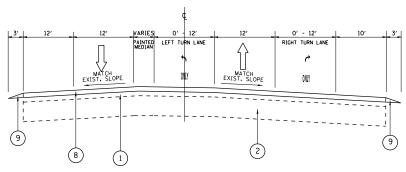


PROPOSED TYPICAL CROSS SECTION STA. 52+46 TO 57+44

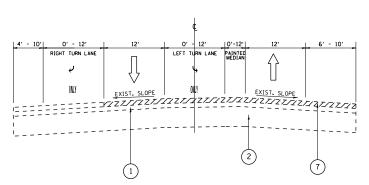


EXISTING TYPICAL CROSS SECTION STA. 57+44 TO 63+81

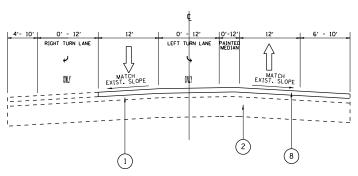

PROPOSED TYPICAL CROSS SECTION STA. 57+44 TO 63+81

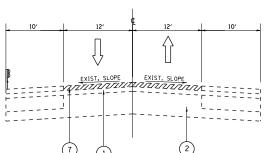

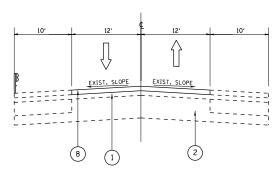

PROPOSED TYPICAL CROSS SECTION STA. 63+81 TO 67+15

USER NAME = elkhatibaj	DESIGNED -	REVISED -	
	DRAWN -	REVISED -	
PLOT SCALE = 100.0000 / in.	CHECKED -	REVISED -	
PLOT DATE = 12/15/2021	DATE -	REVISED -	

STATE OF ILLINOIS **DEPARTMENT OF TRANSPORTATION**

US 20 (MCHENRY CO LINE TO I-90 (JANES ADDAMS MEMORIAL TOLLWAY)) TYPICAL SECTIONS					
SCALE:	SHEET	OF	SHEETS	STA.	TO STA.

F.A.P. RTE.	SECTION	COUNTY	TOTAL SHEETS	SHEET NO.
525	2020-112-RS	KANE	50	11
		CONTRACT	NO. 62	2L90
	TILLINOIS FED	AID PROJECT		

EXISTING TYPICAL CROSS SECTION STA. 63+81 TO 67+15

LEGEND:

(1) EXIST. HOT-MIX ASPHALT, 3"

2 EXIST. P.C.C. PAVEMENT, 10" (3) EXIST. CORRUGATED MEDIAN

4 EXIST. BARRIER MEDIAN

EXIST. COMB. CONC. CURB AND GUTTER

EXIST. AGGREGATE SHOULDER

PROP. HOT-MIX ASPHALT SURFACE REMOVAL, 1.75"

PROP. POLYMERIZED HOT-MIX ASPHALT SURFACE COURSE, MIX "E", IL-9.5, N70, 1.75 "

9 PROP. AGGREGATE WEDGE SHOULDER, TYPE B

(10) PROP. CLASS D PATCH, 12"

11) PROP. FLUSH MEDIAN

12) PROP. BARRIER MEDIAN

(13) PROP. HOT-MIX ASPHALT SHOULDER, 8"

R CURB AND GUTTER REMOVAL AND REPLACEMENT (LOCATION AS DIRECTED BY THE ENGINEER)

LANDSCAPING SCHEDULE OF QUANTITIES

CODE NUMBER

250		

INTERSEEDING, CLASS 4A								
<u>STATION</u>	<u>QUANTITY</u>	<u>UNIT</u>						
17+50 (Offset 250 Ft) to 23+30 (Offset 150 Ft) RT	82,300	SQ FT						
23+70 (Offset 150 Ft) to 27+30 (Offset 50 Ft) RT	21,000	SQ FT						
18+30 (Offset 30 Ft) to 25+00 (Offset 60 Ft) LT	34,300	SQ FT						
TOTAL SQ FT	137,600	SQ FT						
TOTAL ACRE	3.25	ACRE						

25003314

INTERSEEDING, CLASS 4B								
<u>STATION</u>	<u>QUANTITY</u>	<u>UNIT</u>						
19+00 (Offset 50 Ft) to 25+20 (Offset 45 Ft) LT	7,125	SQ FT						
21+60 (Offset 30 FT) to 22+50 (Offset 30 Ft) RT	1,600	SQ FT						
24+00 (Offset 30 Ft) to 25+00 (Offset 30 Ft) RT	720	SQ FT						
TOTAL SQ FT	9,445	SQ FT						
TOTAL ACRE	0.25	ACRE						

к0029614

WEED CONTROL, AQUATIC								
<u>STATION</u>	AREA (SQ FT)	<u>UNIT</u>						
19+00 (Offset 50 Ft) to 25+20 (Offset 45 Ft) LT	7,320	SQ FT						
21+70 (Offset 40 FT) to 22+50 (Offset 65 Ft) RT	2,135	SQ FT						
24+00 (Offset 70 Ft) to 24+75 (Offset 70 Ft) RT	1,760	SQ FT						
TOTAL SQ FT	11,215	SQ FT						
TOTAL GALLON (7.5 Pints Per Acre Used)	1.0	GALLON						

X0327120

WEED CONTROL, NATIVE LANDSCAPE ENHANCEMENT								
<u>STATION</u>	<u>QUANTITY</u>	<u>UNIT</u>						
17+50 (Offset 250 Ft) to 23+30 (Offset 150 Ft) RT	82,300	SQ FT						
23+70 (Offset 150 Ft) to 27+30 (Offset 50 Ft) RT	21,000	SQ FT						
18+30 (Offset 30 Ft) to 25+00 (Offset 60 Ft) LT	35,475	SQ FT						
TOTAL SQ FT	138,775	SQ FT						
TOTAL ACRE	3.25	ACRE						

X2503110

MOWING (SPECIAL)								
<u>STATION</u>	<u>QUANTITY</u>	<u>UNIT</u>						
17+50 (Offset 250 Ft) to 23+30 (Offset 150 Ft) RT	82,300	SQ FT						
23+70 (Offset 150 Ft) to 27+30 (Offset 50 Ft) RT	21,000	SQ FT						
18+30 (Offset 30 Ft) to 25+00 (Offset 60 Ft) LT	34,300	SQ FT						
TOTAL SQ FT	137,600	SQ FT						
TOTAL ACRE	3.25	ACRE						

Z0064600

SELECTIVE CLEARING (ACRE)								
<u>STATION</u>	<u>QUANTITY</u>	<u>UNIT</u>						
19+00 (Offset 100 Ft) to 24+80 (Offset 60 Ft) LT	14,200	SQ FT						
23+70 (Offset 150 Ft) to 25+40 (Offset 120 Ft) RT	6,400	SQ FT						
17+50 (Offset 250 Ft) to 23+30 (Offset 150 Ft) RT	53,700	SQ FT						
TOTAL SQ FT	74,300	SQ FT						
TOTAL ACRE	1.75	ACRE						

Contact the IDOT Roadside Development Unit at 847-705-4171 at least 2 weeks prior to beginning landscape and forestry work for layout.

MODEL: Default

 USER NAME
 = elkhatibaj
 DESIGNED
 REVISED

 DRAWN
 REVISED

 PLOT SCALE
 = 100,0000 ' / in.
 CHECKED
 REVISED

 PLOT DATE
 = 12/15/2021
 DATE
 REVISED

STATE OF ILLINOIS
DEPARTMENT OF TRANSPORTATION

US 20 (MCHENRY CO LINE TO I— 90 (JANE ADDAMS MEMORIAL TOLLWAY))

SCHEDULE OF QUANTITIES

SCALE: SHEET OF SHEETS STA. TO STA.

 F.A. RTE.
 SECTION
 COUNTY
 TOTAL SHEET
 SHEET NO.

 525
 2020-112-RS
 KANE
 50
 12

 CONTRACT NO. 62 L90

	21400100 - GRADING AND SHAPING DITCHES										
LOCATION (APPROX.) LT	LENGTH (FT)	WIDTH (FT)	DEPTH (INCHES)	VOLUME (CU YD)							
19+00		12	4	0							
25+00	600	12	4	89							
27+50	250	12	4	37							
28+35		26	12	0							
28+40	5	26	12	5							
31+50	310	15	9	206							
33+55	205	24	12	130							
34+50		24	12	0							
35+80	130	16	10	88							
37+20	140	18	12	81							
39+00	180	24	12	140							

FOOT

TOTAL VOLUME:

775

CU YD

1820

TOTAL LENGTH:

 USER NAME
 = elknatibaj
 DESIGNED
 REVISED

 DRAWN
 REVISED

 PLOT SCALE
 = 100,0000 '/ in.
 CHECKED
 REVISED

 PLOT DATE
 = 12/15/2021
 DATE
 REVISED

STATE OF ILLINOIS DEPARTMENT OF TRANSPORTATION

US 20 (MCHENRY CO LINE TO I— 90 (JANE ADDAMS MEMORIAL TOLLWAY))


SCHEDULE OF QUANTITIES


SCALE: SHEET OF SHEETS STA. TO STA.


 F.A. RTE.
 SECTION
 COUNTY SHEETS
 NO.

 525
 2020-112-RS
 KANE
 50
 13

 CONTRACT NO. 62L90

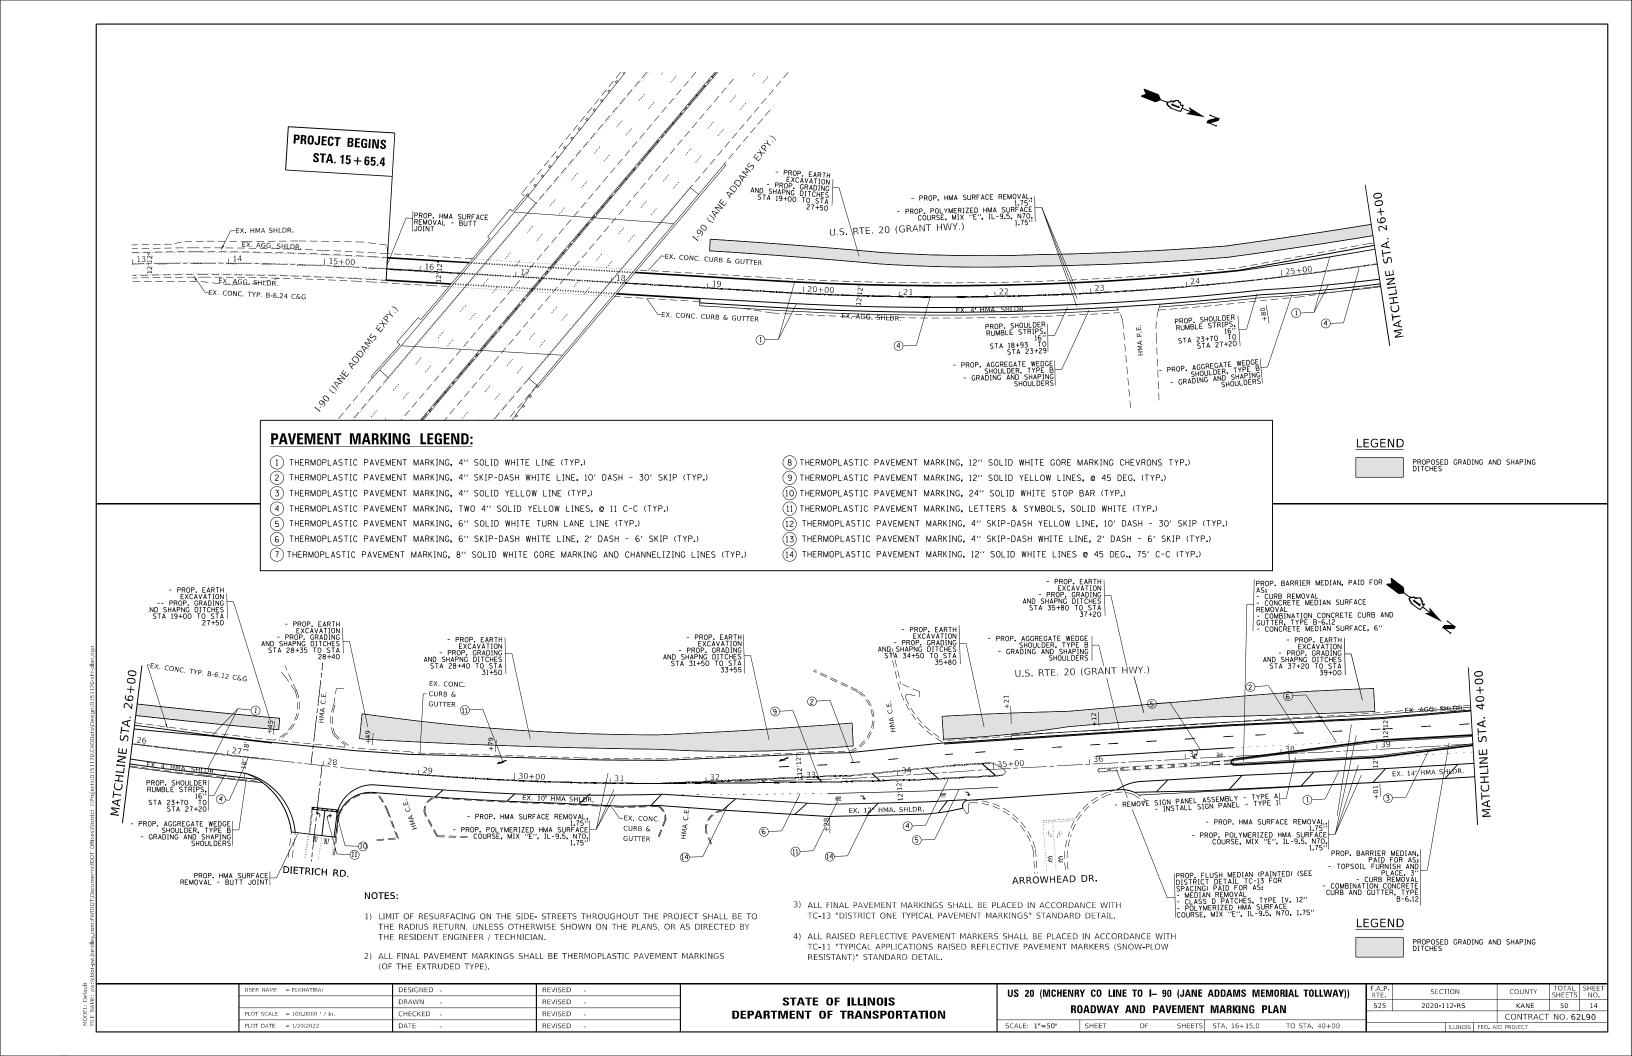

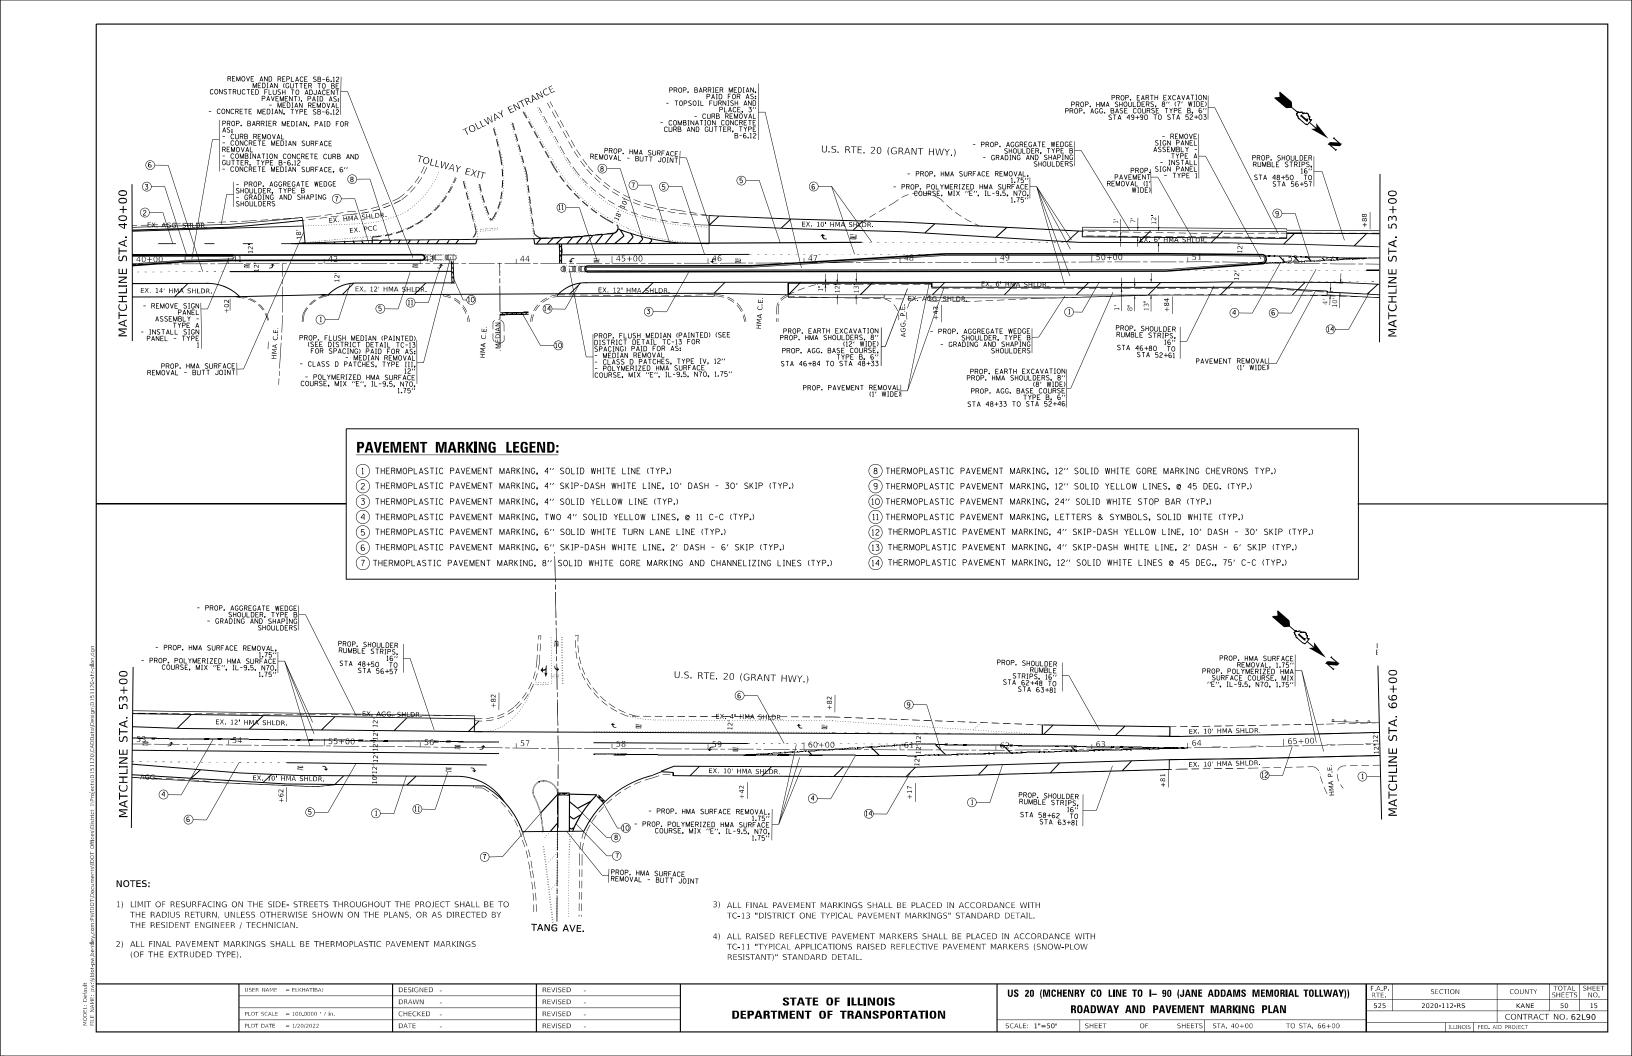

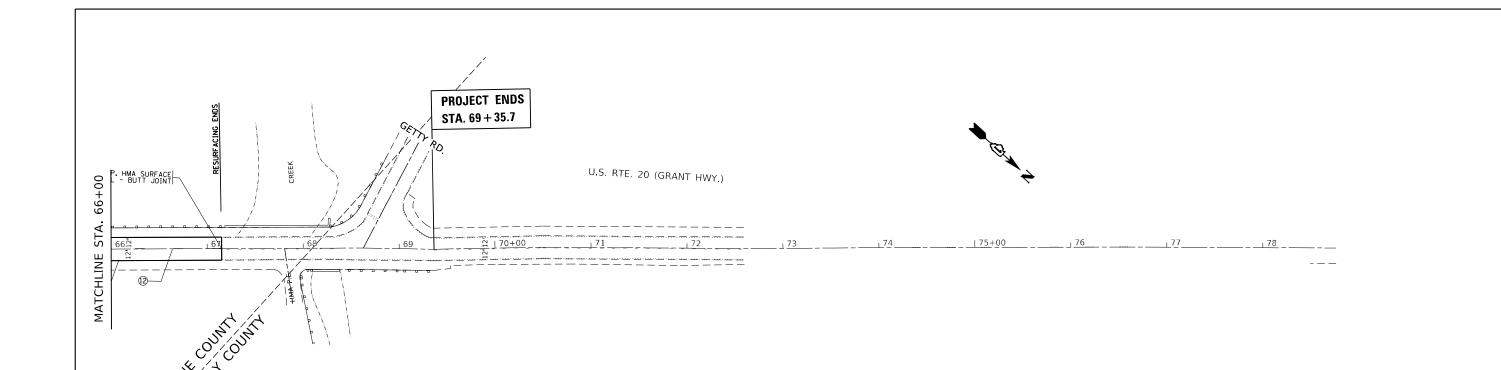

PAVEMENT MARKING LEGEND:

- 1) THERMOPLASTIC PAVEMENT MARKING, 4" SOLID WHITE LINE (TYP.)
- (2) THERMOPLASTIC PAVEMENT MARKING, 4" SKIP-DASH WHITE LINE, 10' DASH 30' SKIP (TYP.)
- (3) THERMOPLASTIC PAVEMENT MARKING, 4" SOLID YELLOW LINE (TYP.)
- (4) THERMOPLASTIC PAVEMENT MARKING, TWO 4" SOLID YELLOW LINES, @ 11 C-C (TYP.)
- (5) THERMOPLASTIC PAVEMENT MARKING, 6" SOLID WHITE TURN LANE LINE (TYP.)
- (6) THERMOPLASTIC PAVEMENT MARKING, 6" SKIP-DASH WHITE LINE, 2' DASH 6' SKIP (TYP.)
- (7) THERMOPLASTIC PAVEMENT MARKING, 8" SOLID WHITE GORE MARKING AND CHANNELIZING LINES (TYP.)
- (8) THERMOPLASTIC PAVEMENT MARKING, 12" SOLID WHITE GORE MARKING CHEVRONS TYP.)
- (9) THERMOPLASTIC PAVEMENT MARKING, 12" SOLID YELLOW LINES, @ 45 DEG. (TYP.)
- (10) THERMOPLASTIC PAVEMENT MARKING, 24" SOLID WHITE STOP BAR (TYP.)
- (11) THERMOPLASTIC PAVEMENT MARKING, LETTERS & SYMBOLS, SOLID WHITE (TYP.)
- (12) THERMOPLASTIC PAVEMENT MARKING, 4" SKIP-DASH YELLOW LINE, 10' DASH 30' SKIP (TYP.)
- (13) THERMOPLASTIC PAVEMENT MARKING, 4" SKIP-DASH WHITE LINE, 2' DASH 6' SKIP (TYP.)
- (14) THERMOPLASTIC PAVEMENT MARKING, 12" SOLID WHITE LINES @ 45 DEG., 75' C-C (TYP.)

NOTES:

- 1) LIMIT OF RESURFACING ON THE SIDE- STREETS THROUGHOUT THE PROJECT SHALL BE TO THE RADIUS RETURN, UNLESS OTHERWISE SHOWN ON THE PLANS, OR AS DIRECTED BY THE RESIDENT ENGINEER / TECHNICIAN.
- 2) ALL FINAL PAVEMENT MARKINGS SHALL BE THERMOPLASTIC PAVEMENT MARKINGS (OF THE EXTRUDED TYPE).

- 3) ALL FINAL PAVEMENT MARKINGS SHALL BE PLACED IN ACCORDANCE WITH TC-13 "DISTRICT ONE TYPICAL PAVEMENT MARKINGS" STANDARD DETAIL.
- 4) ALL RAISED REFLECTIVE PAVEMENT MARKERS SHALL BE PLACED IN ACCORDANCE WITH TC-11 "TYPICAL APPLICATIONS RAISED REFLECTIVE PAVEMENT MARKERS (SNOW-PLOW RESISTANT)" STANDARD DETAIL.

USER NAME = elkhatibaj	DESIGNED -	REVISED -
	DRAWN -	REVISED -
PLOT SCALE = 100.0000 / in.	CHECKED -	REVISED -
PLOT DATE = 12/16/2021	DATE -	REVISED -

STATE OF ILLINOIS DEPARTMENT OF TRANSPORTATION

US 20 (MCHENR	Y CO LINE	TO I- 90 (J	ANE	ADDAMS ME	MORIAL TOLLWAY))	F.A.P. RTE	SEC ⁻	ΓΙΟΝ		COUNTY	TOTAL SHEETS	SHEET NO.
R	ΛΑΝΜΑΥ Α	NID PAVEN	FMT	MARKING I	ΡΙΔΝ	525	2020-1	12 - RS		KANE	50	16
""	UADIVAI A	IND I AVEIN	LIVI	WAINING	LAIV					CONTRAC	T NO. 62	2L90
SCALE: 1"=50'	SHEET	OF SH	EETS	STA. 66+00	TO STA. 69+84.6			ILLINOIS	FED. AI	D PROJECT		

MAINTENANCE OF TRAFFIC NOTES

- THE STAGES OF CONSTRUCTION AND TRAFFIC CONTROL PLANS SHALL SERVE AS A GUIDE FOR THE SAFE DIVERSION OF TRAFFIC DURING THE EXECUTION OF THIS CONTRACT. ANY CHANGES TO THE PLANS SHALL BE SUBMITTED TO THE ENGINEER FOR APPROVAL.
- THE CONTRACTOR SHALL MAINTAIN TRAFFIC IN ACCORDANCE WITH THE SPECIAL PROVISIONS, STATE STANDARDS, STANDARD SPECIFICATIONS AND AS DIRECTED BY THE ENGINEER.
- THE FURNISHING, INSTALLING, AND RELOCATION OF ALL TRAFFIC SIGNS SHALL BE IN ACCORDANCE WITH THE MANUAL ON UNIFORM TRAFFIC CONTROL DEVICES AND THE STANDARD SPECIFICATIONS.
- ACCESS TO PROPERTIES SHALL BE MAINTAINED AT ALL TIMES. PROPERTIES WITH MULTIPLE ENTRANCES SHALL HAVE ONLY ONE ENTRANCE CLOSED AT A TIME.
- THE CONTRACTOR SHALL COMPLETE THE PROPOSED HMA SHOULDER WORK THAT IS SHOWN IN "SUGGESTED STAGES OF CONSTRUCTION AND TRAFFIC CONTROL" STAGES 1 AND 2 PRIOR TO BEGINNING ANY MILLING, PAVEMENT PATCHING OR CURB AND GUTTER WORK WITHIN STATIONS 44+00
- THE CONTRACTOR IS ADVISED THAT TO COMPLETE THE PROPOSED HMA SHOULDER WORK SHOWN IN "SUGGESTED STAGES OF CONSTRUCTION AND TRAFFIC CONTROL" STAGES 1 AND 2, TRAFFIC WILL HAVE TO BE SHIFTED THROUGH THE TRAFFIC SIGNAL LOCATED AT THE US 20 AND I-90 EXIT RAMP AS SHOWN IN MAINTENANCE OF TRAFFIC STAGES 1 AND 2. DURING THIS OPERATION THE CONTRACTOR WILL BE REQUIRED TO TAKE MAINTENANCE OF THE TRAFFIC SIGNAL AND MODIFY THE TRAFFIC SIGNAL PHASING TO A FLASHING CIRCULAR RED PHASE AND FLAG THE SIGNAL AND MODIFY THE TRAFFIC SIGNAL PHASING TO A FLASHING CIRCULAR RED PHASE AND FLAG THE SIGNALIZED INTERSECTION USING A MINIMUM OF 4 CERTIFIED FLAGGERS. PRIOR TO THE PHASE MODIFICATION OF THE TRAFFIC SIGNAL THE CONTRACTOR MUST HAVE PRIOR APPROVAL OF THE ENGINEER. APPROVAL TO MODIFY THE TRAFFIC SIGNAL WILL ONLY BE GRANTED DURING THE PERIOD EXTENDING FROM 10:00 A.M. TO 2:00 P.M. ON WEEKDAYS AND SHALL NOT BE ALLOWED DURING INCLEMENT WEATHER OR HOLIDAY PERIODS. THE TRAFFIC SIGNALS SHALL BE RETURNED TO NORMAL OPERATING CONDITIONS IMMEDIATELY AFTER THE CONTRACTORS WORK OPERATIONS THAT REQUIRE THE SHIFTING OF TRAFFIC THROUGH THE TRAFFIC SIGNAL CONCLUDE. THIS WORK SHALL NOT BE PAID SEPARATELY AND SHALL BE INCLUDED IN THE CONTRACT UNIT PRICE FOR MAINTENANCE OF EXISTING TRAFFIC SIGNAL INSTALLATION.

SUGGESTED CONSTRUCTION SEQUENCE

PRE-STAGE:

APPLICABLE HIGHWAY STANDARDS FOR TRAFFIC CONTROL AND PROTECTION FOR DAY-TIME LANE CLOSURES SHALL BE UTILIZED TO PERFORM THE WORK LISTED BELOW. LANE CLOSURES REQUIRED TO COMPLETE STAGE 1 AND 2 WORK SHALL ONLY BE UTILIZED DURING ALLOWABLE HOURS AS SPECIFIED IN THE MAINTENANCE OF TRAFFIC NOTES.

STAGE I:

TRAFFIC TRAVELING EASTBOUND ON US 20 PAST TANG AVENUE AND WITHIN THE WORK AREA STATIONS SHALL BE TEMPORARILY SHIFTED TO THE WESTBOUND LANES AS GUIDED BY FLAGGER. WESTBOUND LANES SHALL FOLLOW THE EXISTING TRAVEL CONFIGURATION AS GUIDED BY FLAGGER.

ALL PROPOSED WORK SHALL BE EXECUTED WITHIN THE WORK AREA. THIS INCLUDES, BUT IS NOT

- EARTH EXACAVATION, PAVEMENT REMOVAL, HMA SHOULDERS AND ALL INCIDENTAL AND COLLATERAL WORK NECESSARY TO COMPLETE THE SHOULDER WIDENING.

STAGE II:

TRAFFIC TRAVELING WESTBOUND ON US 20 WITHIN THE WORK AREA STATIONS SHALL BE TEMPORARILY SHIFTED TO THE EASTBOUND LANES AS GUIDED BY FLAGGER. EASTBOUND LANES SHALL FOLLOW THE EXISTING TRAVEL CONFIGURATION AS GUIDED BY FLAGGER.

ALL PROPOSED WORK SHALL BE EXECUTED WITHIN THE WORK AREA. THIS INCLUDES, BUT IS NOT

- EARTH EXACAVATION, PAVEMENT REMOVAL, HMA SHOULDERS AND ALL INCIDENTAL AND COLLATERAL WORK NECESSARY TO COMPLETE THE SHOULDER WIDENING.

JSER NAME = elkhatibaj DESIGNED REVISED DRAWN REVISED HECKED REVISED PLOT DATE = 12/15/202 REVISED DATE


STATE OF ILLINOIS **DEPARTMENT OF TRANSPORTATION**


US 20 (MCHENE	RY CO LIN	E TO I-9	0 (JANES	ADDAN	IS MEMORIAL TOLLWAY))	F.A.P. RTE	SECTION	COUNTY	TOTAL SHEETS	SHEET NO.
SUGGESTE	n STAGES	OF CON	ISTRUCTIO	N AND	TRAFFIC CONTROL	525	2020-112-RS	KANE	50	17
OOGGEOTE	D GIAGE	01 0011	011100110	II AIID	THATTO CONTINCE			CONTRACT	NO. 62	2L90
SCALE:	SHEET	OF	SHEETS	STA.	TO STA.		ILLINOIS FED. A	ID PROJECT		-


STAGE III:

ALL REMAINING PROPOSED WORK SHALL BE COMPLETED DURING THIS STAGE. THIS INCLUDES, BUT IS

- MILLING OF EXISTING HMA PAVEMENT WITHIN THE ENTIRE PROJECT LIMITS
- PLACEMENT OF HMA SURFACE COURSE WITHIN THE ENTIRE PROJECT LIMITS
- ALL INCIDENTAL AND COLLATERAL WORK NECESSARY TO COMPLETE THE PROJECT AS SHOWN IN THE PLANS AND AS DESCRIBED HEREIN.

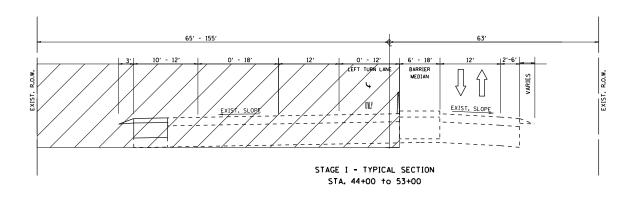

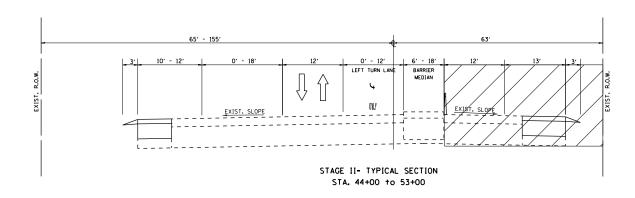

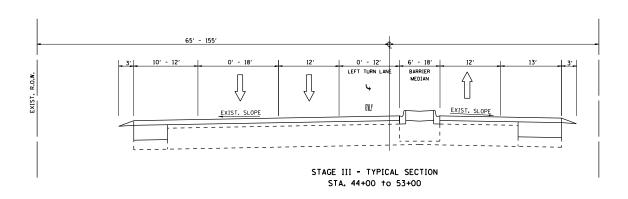

JSER NAME = elkhatibaj DESIGNED -REVISED DRAWN REVISED CHECKED REVISED PLOT DATE = 12/15/2021 DATE REVISED

STATE OF ILLINOIS **DEPARTMENT OF TRANSPORTATION**

US 20 (MC SUGG SCALE:


ICHENE	Y CO LINE	TO I-9	0 (JANES	ADDAM	S MEMORIAL TOLLWAY))	F.A.P. RTE	SEC	TION		COUNTY	TOTAL SHEETS	
GESTE	D STAGES	OF CON	STRUCTIO	м амп	TRAFFIC CONTROL	525	2020-	112-RS		KANE	50	
JULUIL	D GIAGES	01 0010	011100110	II AIID	INALITO CONTINCE					CONTRAC	F NO. 62	2 L S
	SHEET	OF	SHEETS	STA.	TO STA.			ILLINOIS	FED. A	ID PROJECT		


LEGEND

WORK AREA

DIRECTION OF TRAFFIC

CONES AT 25 FT C-C

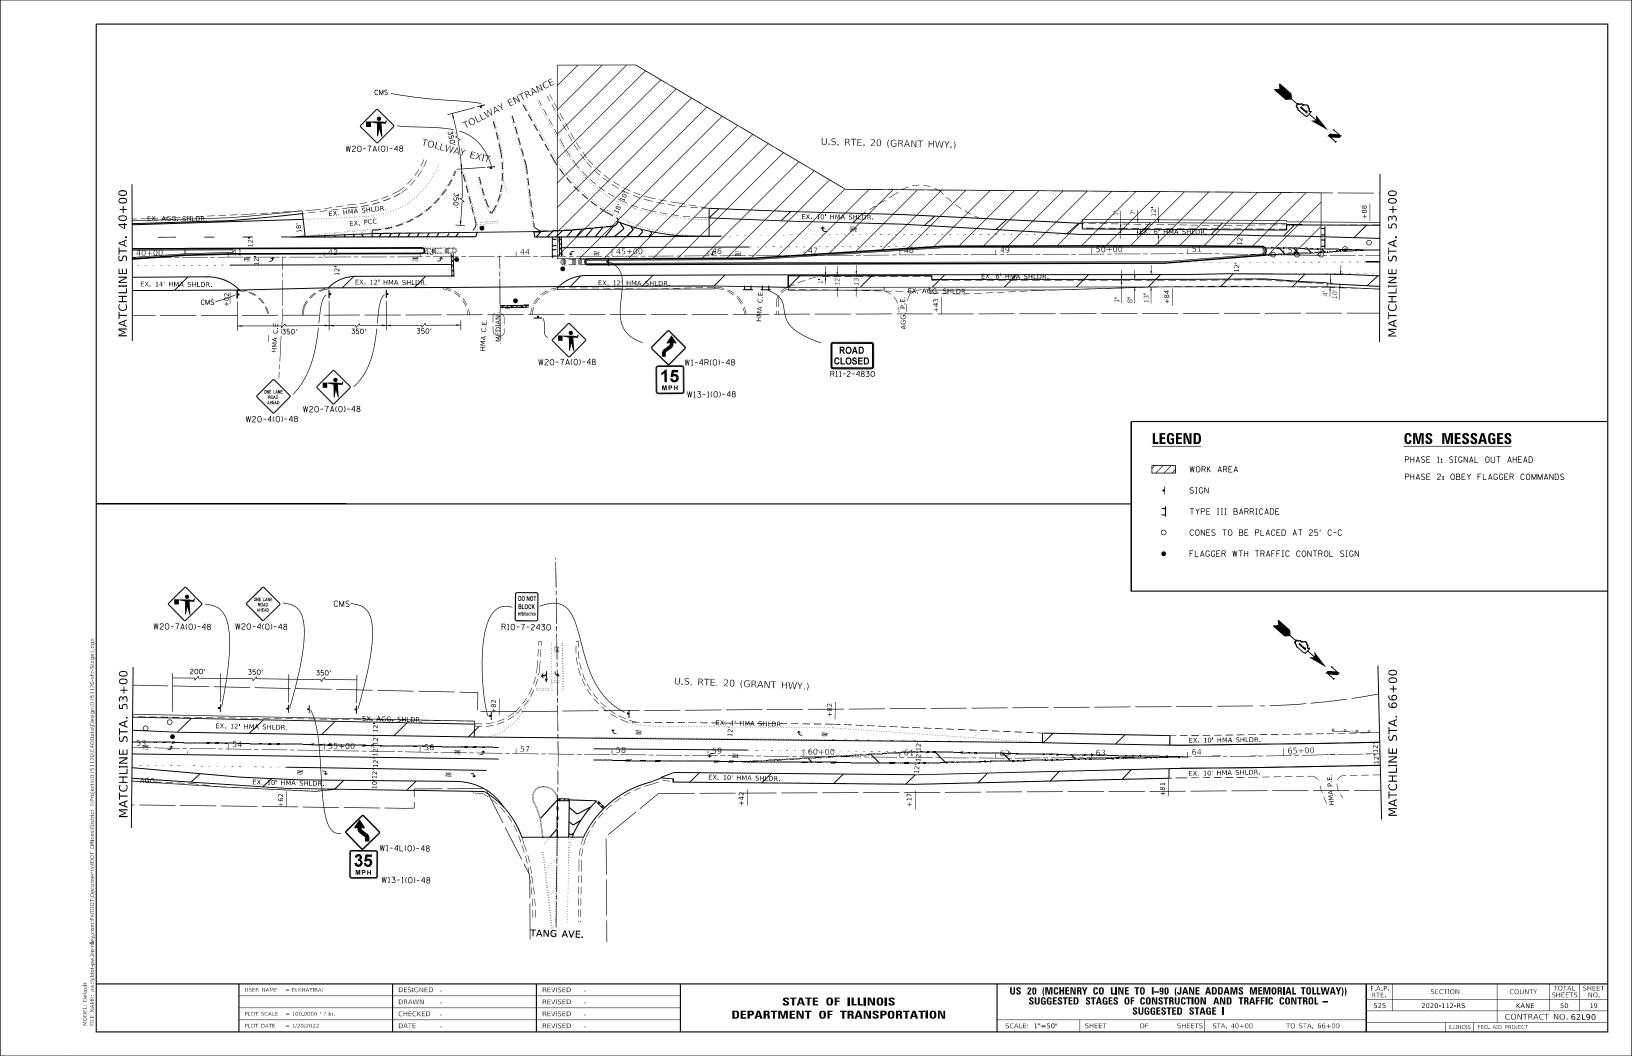

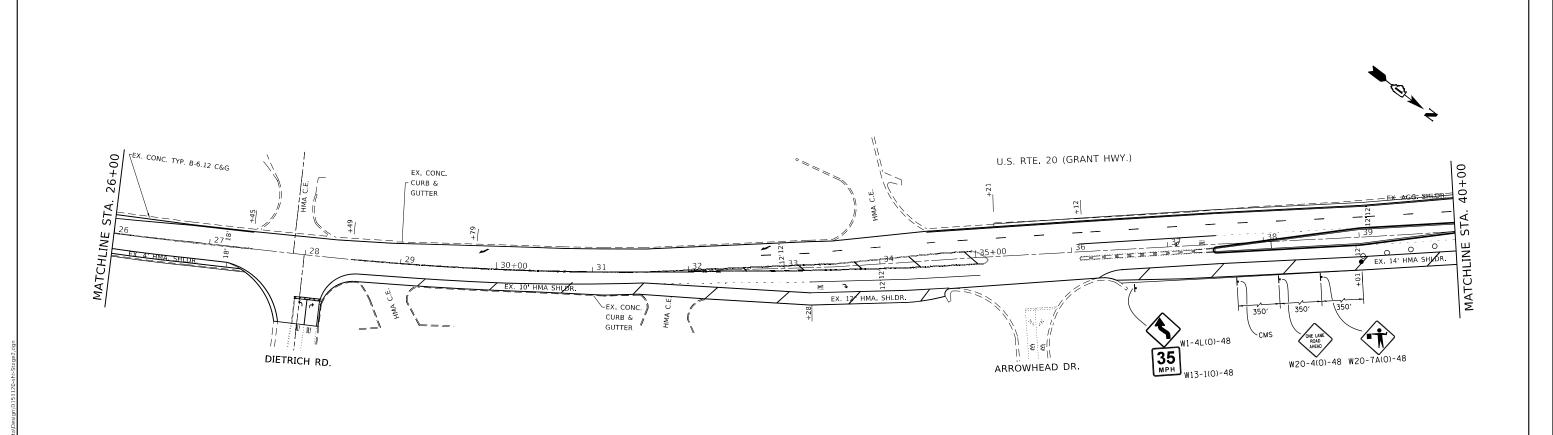

JSER NAME = elkhatibaj DESIGNED -REVISED DRAWN REVISED PLOT SCALE = 100.0000 / in. CHECKED REVISED

STATE OF ILLINOIS **DEPARTMENT OF TRANSPORTATION**

US 20 (MCHENRY CO LINE TO I-90 (JANE ADDAMS MEMORIAL TOLLWAY)) SUGGESTED STAGES OF CONSTRUCTION AND TRAFFIC CONTROL - SUGGESTED STAGE II OF SHEETS STA. 16+15.0 TO STA. 40+00

F.A.P. RTE	SECT	ION		COUNTY	TOTAL SHEETS	SHEET NO.
525	2020-1	12-RS		KANE	50	20
			CONTRACT	NO. 62	2L90	
		ILLINOIS	FFD. A	D PROJECT		

DATE

TYPE III BARRICADE

CONES TO BE PLACED AT 25' C-C FLAGGER WTH TRAFFIC CONTROL SIGN


LEGEND


WORK AREA


∮ SIGN


CMS MESSAGES PHASE 1: SIGNAL OUT AHEAD


PHASE 2: OBEY FLAGGER COMMANDS

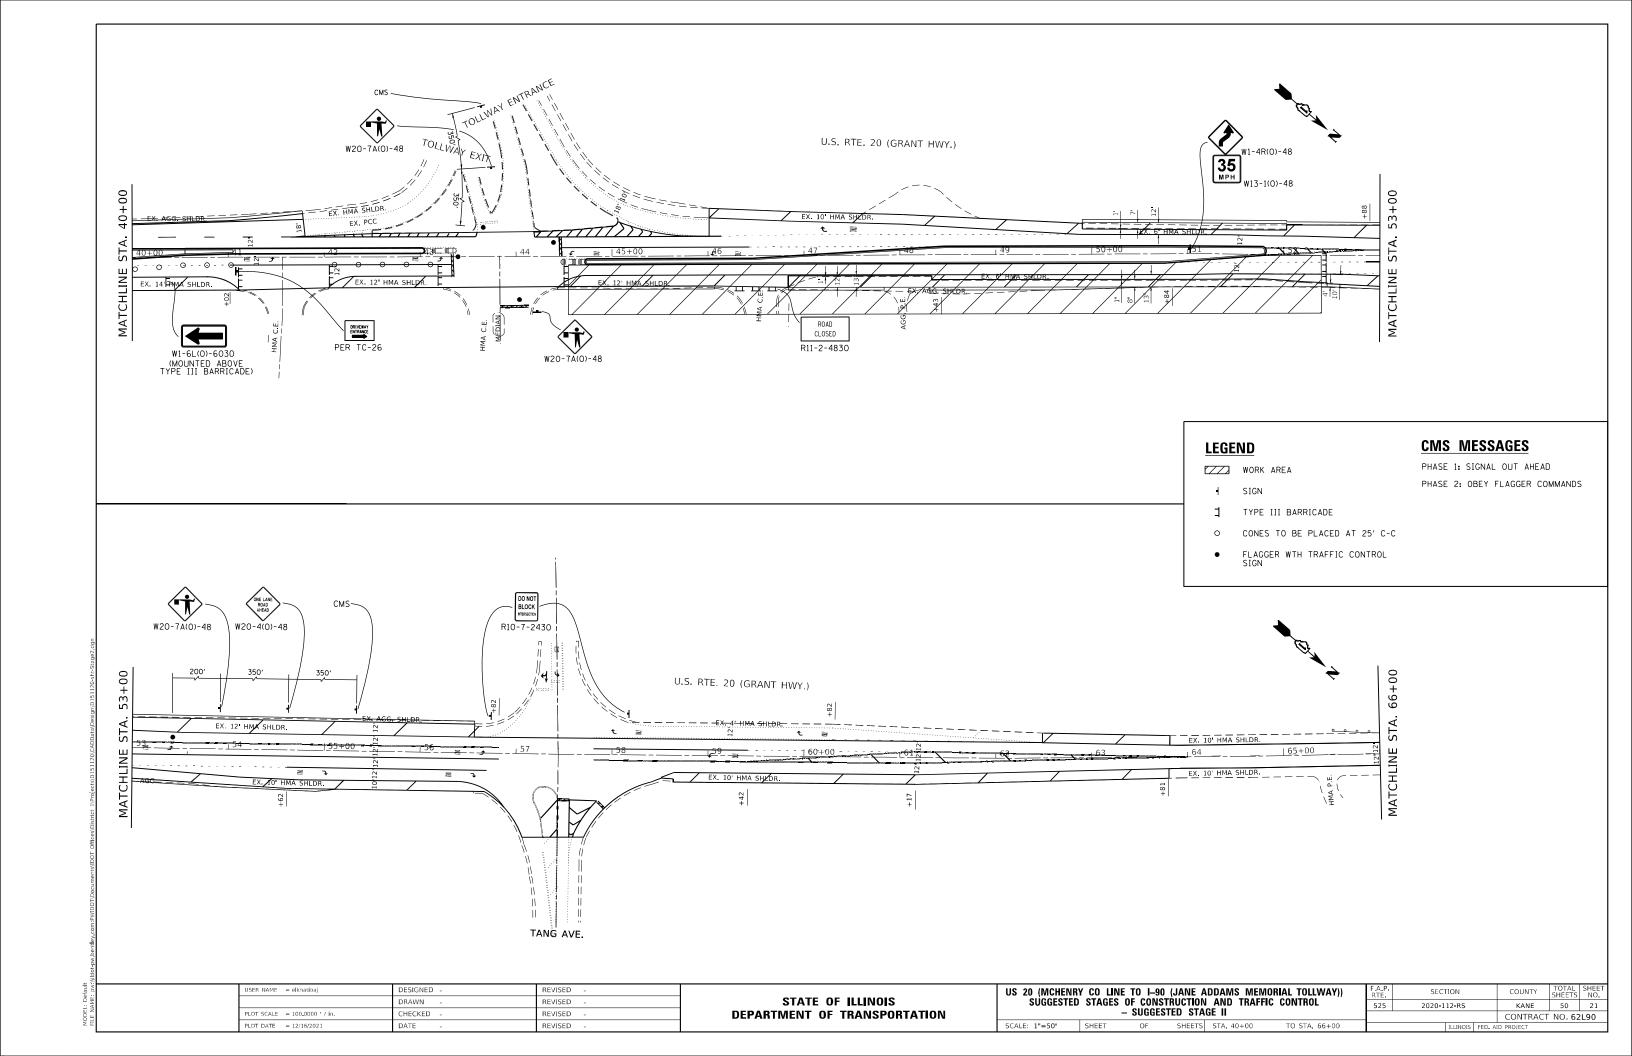


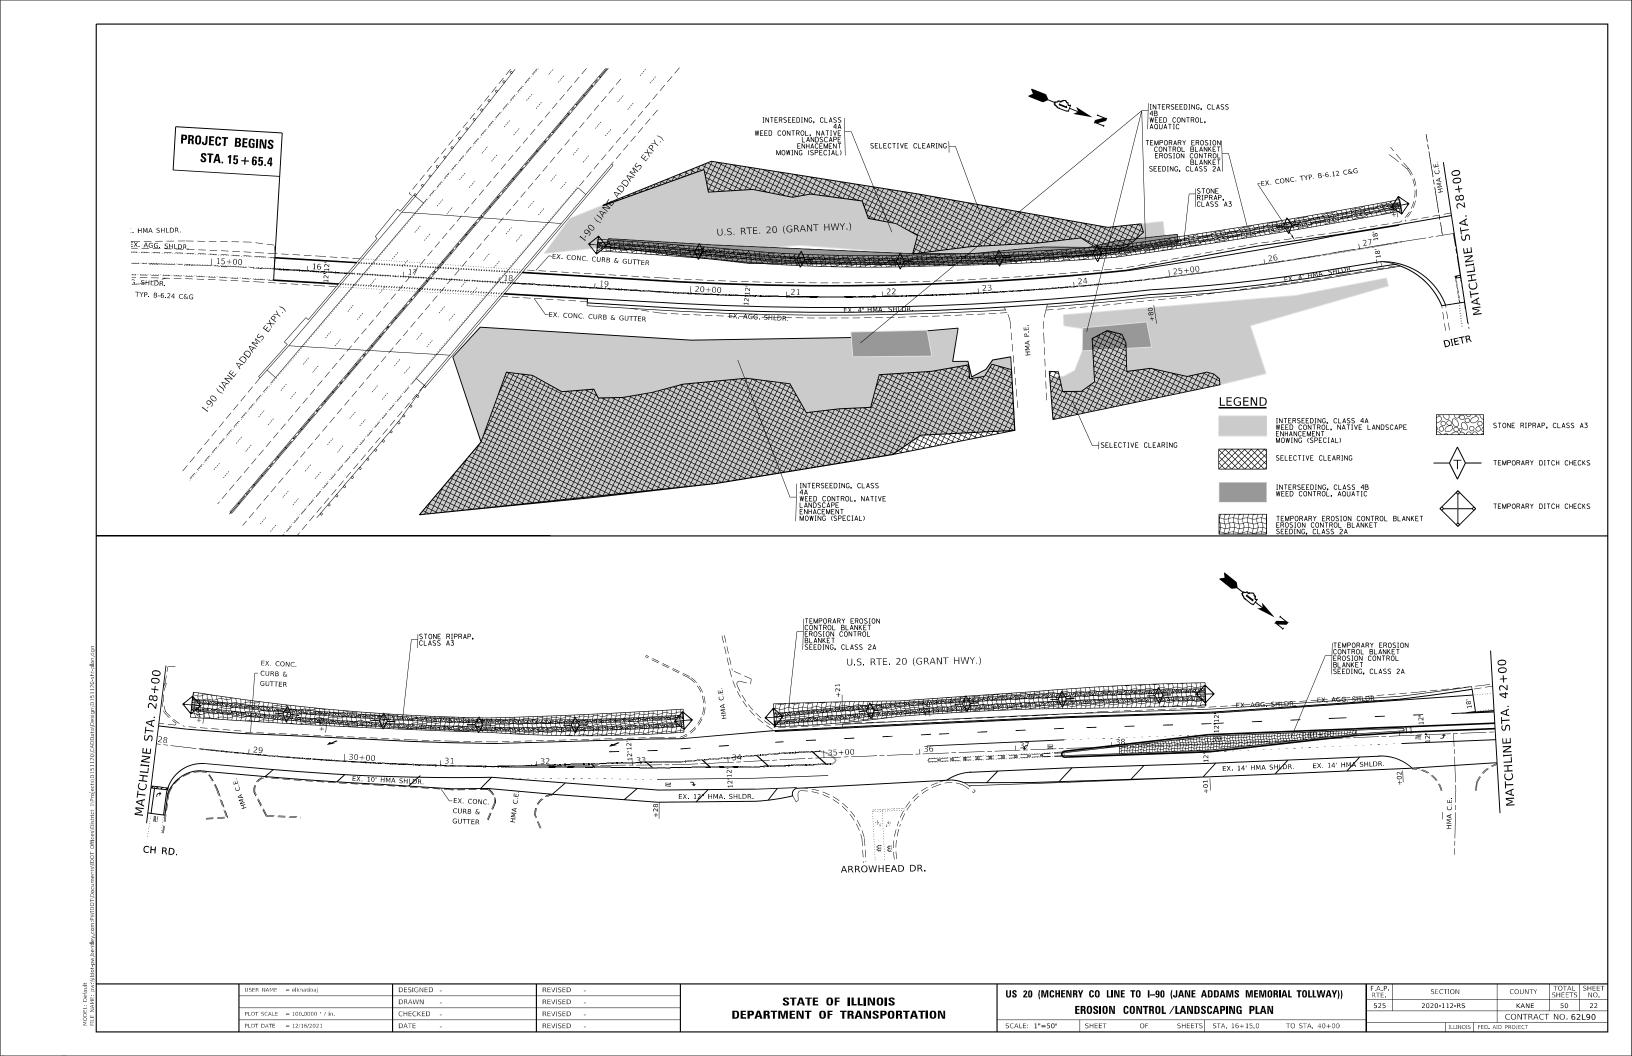

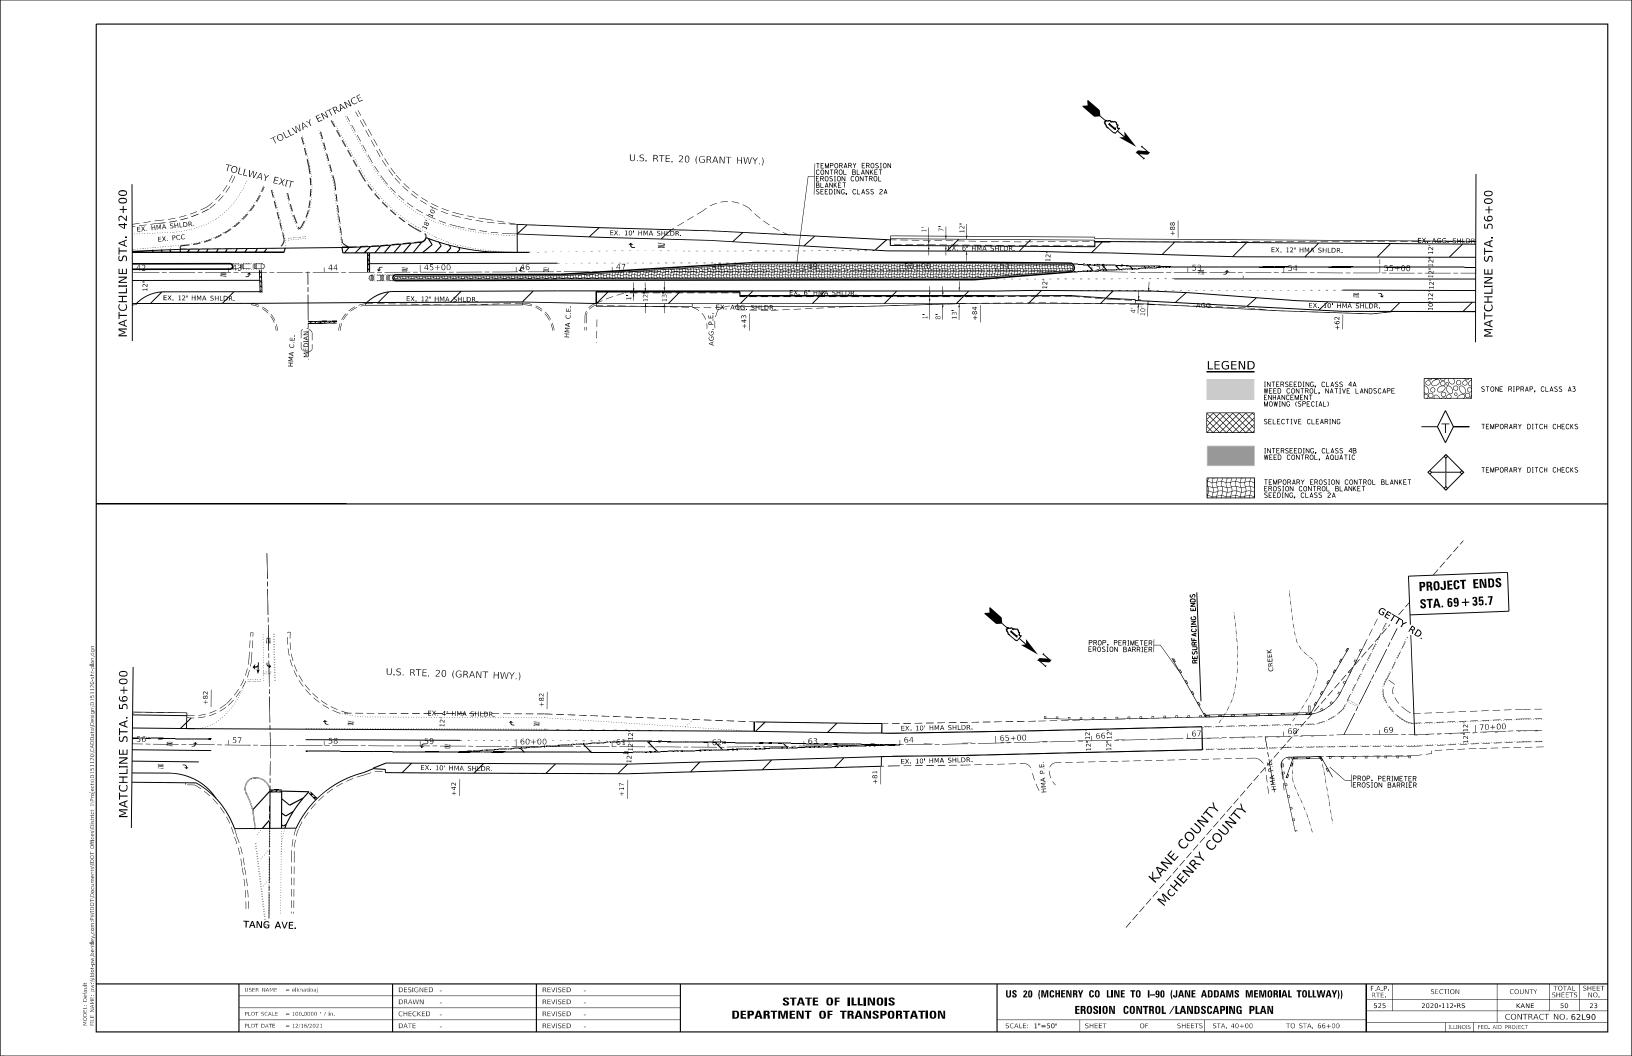

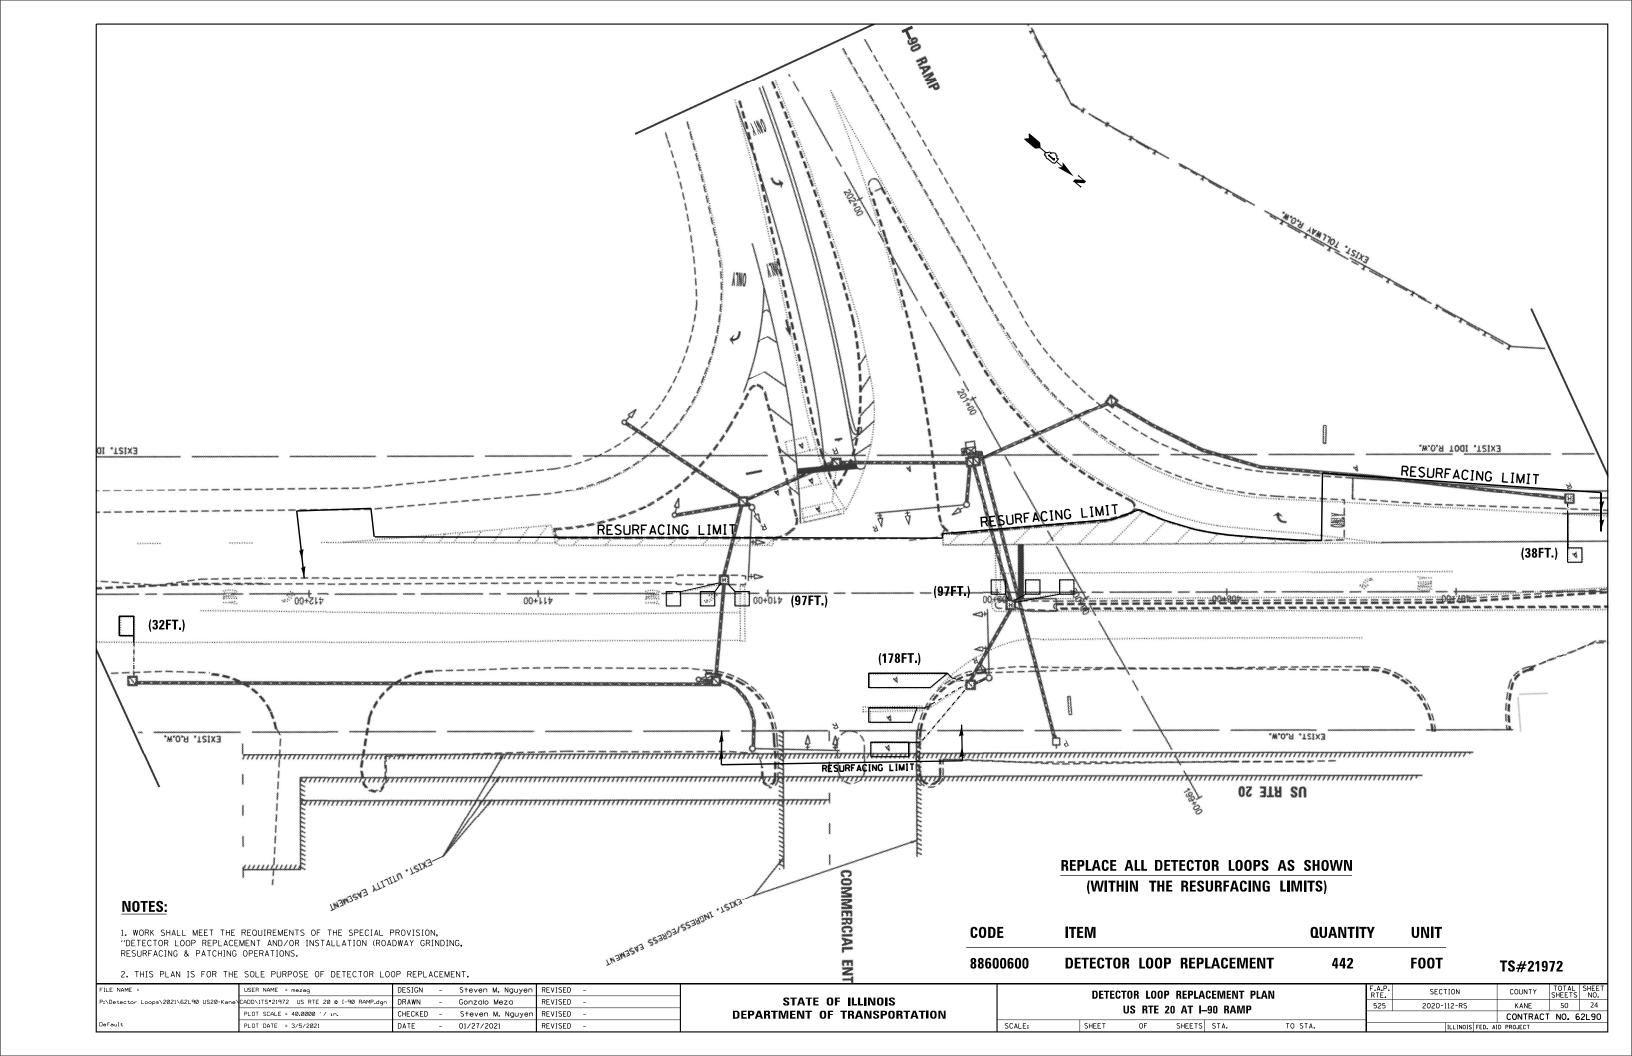

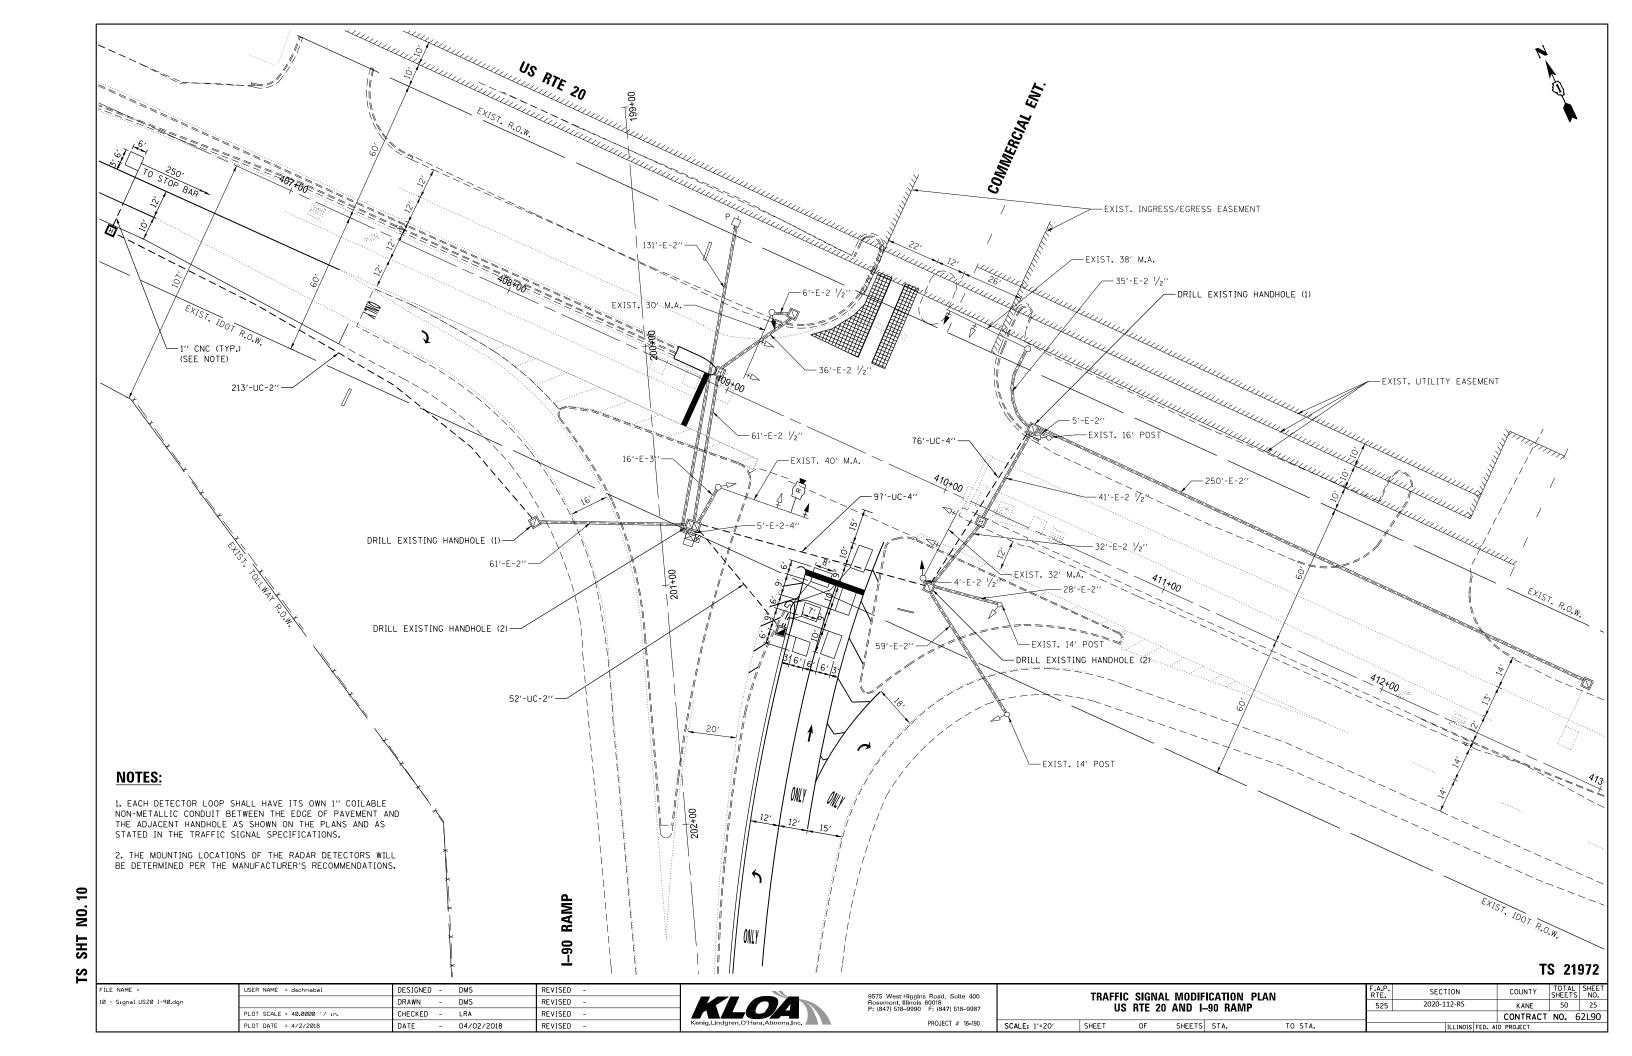


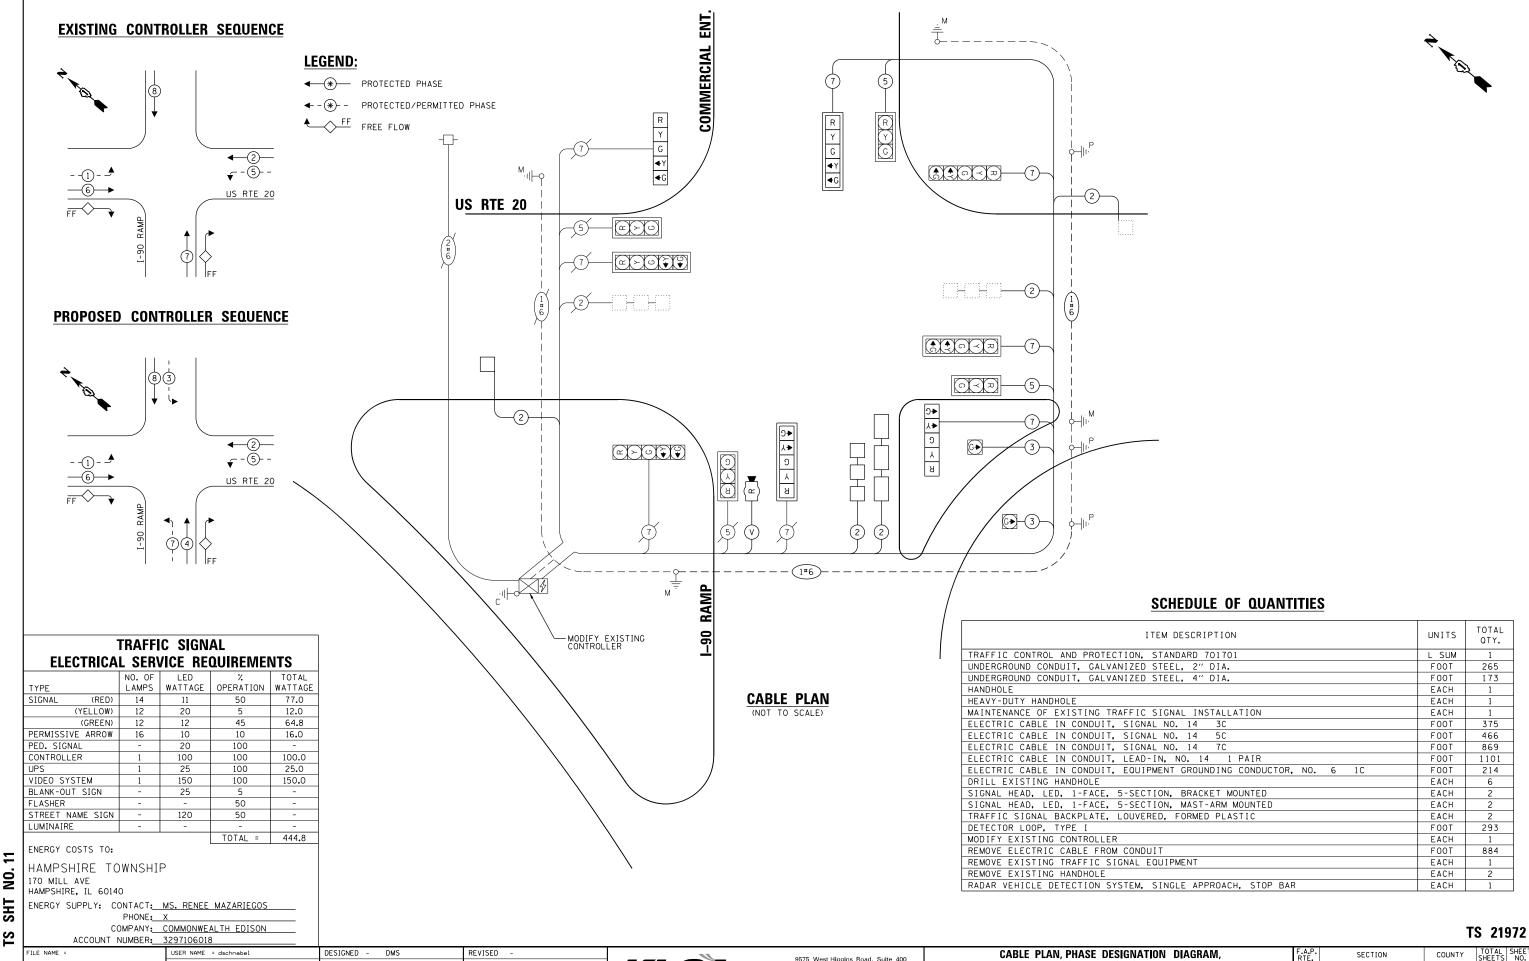



<u>8</u> SHT


9575 West Higgins Road, Suite 400 Rosemont, Illinois 60018 P: (847) 518–9990 F: (847) 518–9987 KANE 50 26 l - Cable US20 I-90.don DRAWN - DMS REVISED AND SCHEDULE OF QUANTITIES 2020-112-RS 525 PLOT SCALE = 40.0000 '/ in. CHECKED -LRA REVISED US RTE 20 AND I-90 RAMP CONTRACT NO. 62L90 PROJECT # 16-190 OF SHEETS STA. TO STA. PLOT DATE = 4/2/2018 DATE 04/02/2018 REVISED

WITH CONCRETE CURB, TYPE B

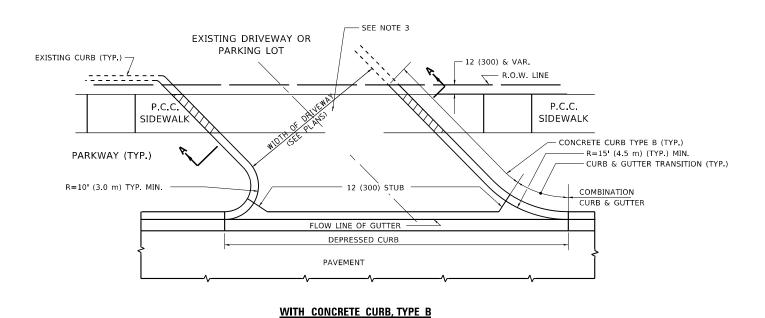

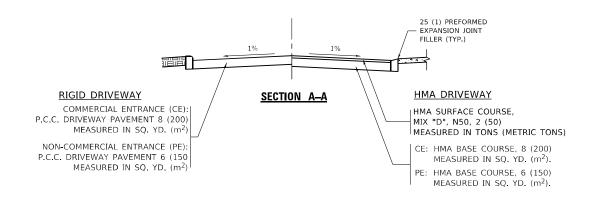

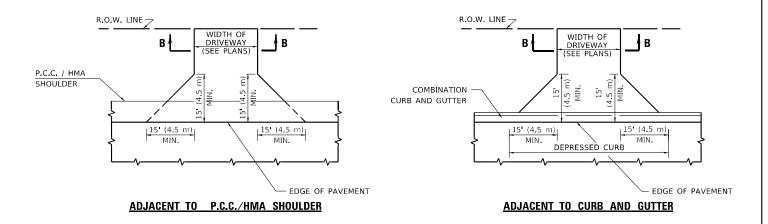

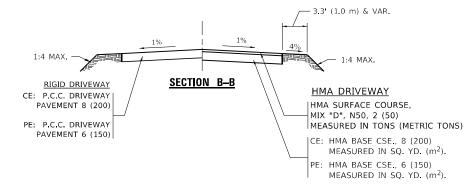

DRIVEWAY SLOPES, LOCATIONS, & GEOMETRIC LAYOUT SHALL BE IN ACCORDANCE WITH THE LATEST EDITION OF THE "HANDBOOK FOR POLICY ON PERMITS FOR ACCESS DRIVEWAYS TO STATE HIGHWAYS". FOR FURTHER LAYOUT REQUIREMENTS, REFER TO ILLUSTRATIONS IN THE PERMIT HANDBOOK. DRIVEWAYS SHALL BE REPLACED IN KIND, UNLESS OTHERWISE NOTED ON THE PLANS.

GENERAL NOTES:

COMMERCIAL DRIVEWAYS SHALL BE CONSTRUCTED WITH CONCRETE CURB, TYPE B RETURNS EXCEPT WHEN THE SIDEWALK EDGE IS 4 FEET (1.2 METERS) OR LESS FROM THE BACK OF CURB, CONSTRUCT A FLARE DRIVEWAY WITHOUT CURB.

THE RESIDENT ENGINEER SHALL CONTACT THE TRAFFIC PERMIT OFFICE AT 847/ 705-4131 FOR ANY QUESTIONS ON DRIVEWAYS SHOWN IN THE PLANS; SPECIFICALLY IN REFERENCE TO ADDITIONAL AND/OR RELOCATION/REMOVAL OF A DRIVEWAY.

COMBINATION CONCRETE CURB & GUTTER SHALL BE MEASURED STRAIGHT ACROSS THE DRIVEWAY. NO ADDITIONAL COMPENSATION WILL BE ALLOWED FOR THE CURB & GUTTER TRANSITION.

1 (25) PREFORMED EXPANSION JOINT FILLER WILL NOT BE PAID SEPARATELY, BUT SHALL BE CONSIDERED INCLUDED IN THE COST OF THE P.C.C. DRIVEWAY PAVEMENT OR P.C.C. SIDEWALK.

WHEN THE P.C.C. SIDEWALK EXTENDS THROUGH THE DRIVEWAY, THE THICKNESS OF THE SIDEWALK IN THE DRIVEWAY AREA SHALL BE THE SAME AS THE DRIVEWAY THICKNESS. SIDEWALK WILL BE PAID FOR AS P.C.C. SIDEWALK OF THE THICKNESS SPECIFIED. SIDEWALK CROSS SLOPE THRU DRIVEWAY AREA TO BE A MAXIMUM OF 1:50.

AND

SCALE: NONE

RURAL FIELD ENTRANCE (FE)


HMA SURFACE COURSE, MIX "D", N50, 2 (50) MEASURED IN TONS (METRIC TONS)


AGGREGATE BASE CSE., TYPE B, 8 (200) MEASURED IN SQ. YD. (m²).


USER NAME = elkhatibaj	DESIGNED -	R. SHAH	REVISED	-	P. LaFLUER 04-15-03
	DRAWN -		REVISED	-	R. BORO 01-01-07
PLOT SCALE = 100.0000 / in.	CHECKED -		REVISED	-	R. BORO 06-11-08
BLOT DATE - 12/15/2021	DATE	11_04_95	DEMICED		P ROPO 09-06-11

						F.A.P RTE	SECT	ION	COUNTY	TOTAL SHEETS	SHEET NO.		
AND E	ACE O	F (CHER	۵.	EDGE OF	SHOULDER	> 15'// 5m\	525	2020-1	12-RS	KANE	50	27
ו שוור	AUL U	' '	COND	Œ	LDGL OI	SHOOLDLII	≥ 13 (4:5III)		3D400-01 (BD-	01)	CONTRACT	NO. 6	2L90
E	SHEET	1	OF	1	SHEETS	STA.	TO STA.			ILLINOIS FED. A	ID PROJECT		

USER NAME = elkhatibaj	DESIGNED - R. SHAH	REVISED - P. LaFLUER 04-1
	DRAWN -	REVISED - R. BORO 01-01-0
PLOT SCALE = 100.0000 / in.	CHECKED -	REVISED - R. BORO 06-11-08
PLOT DATE = 12/15/2021	DATE - 11-04-95	REVISED - R. BORO 09-06-1

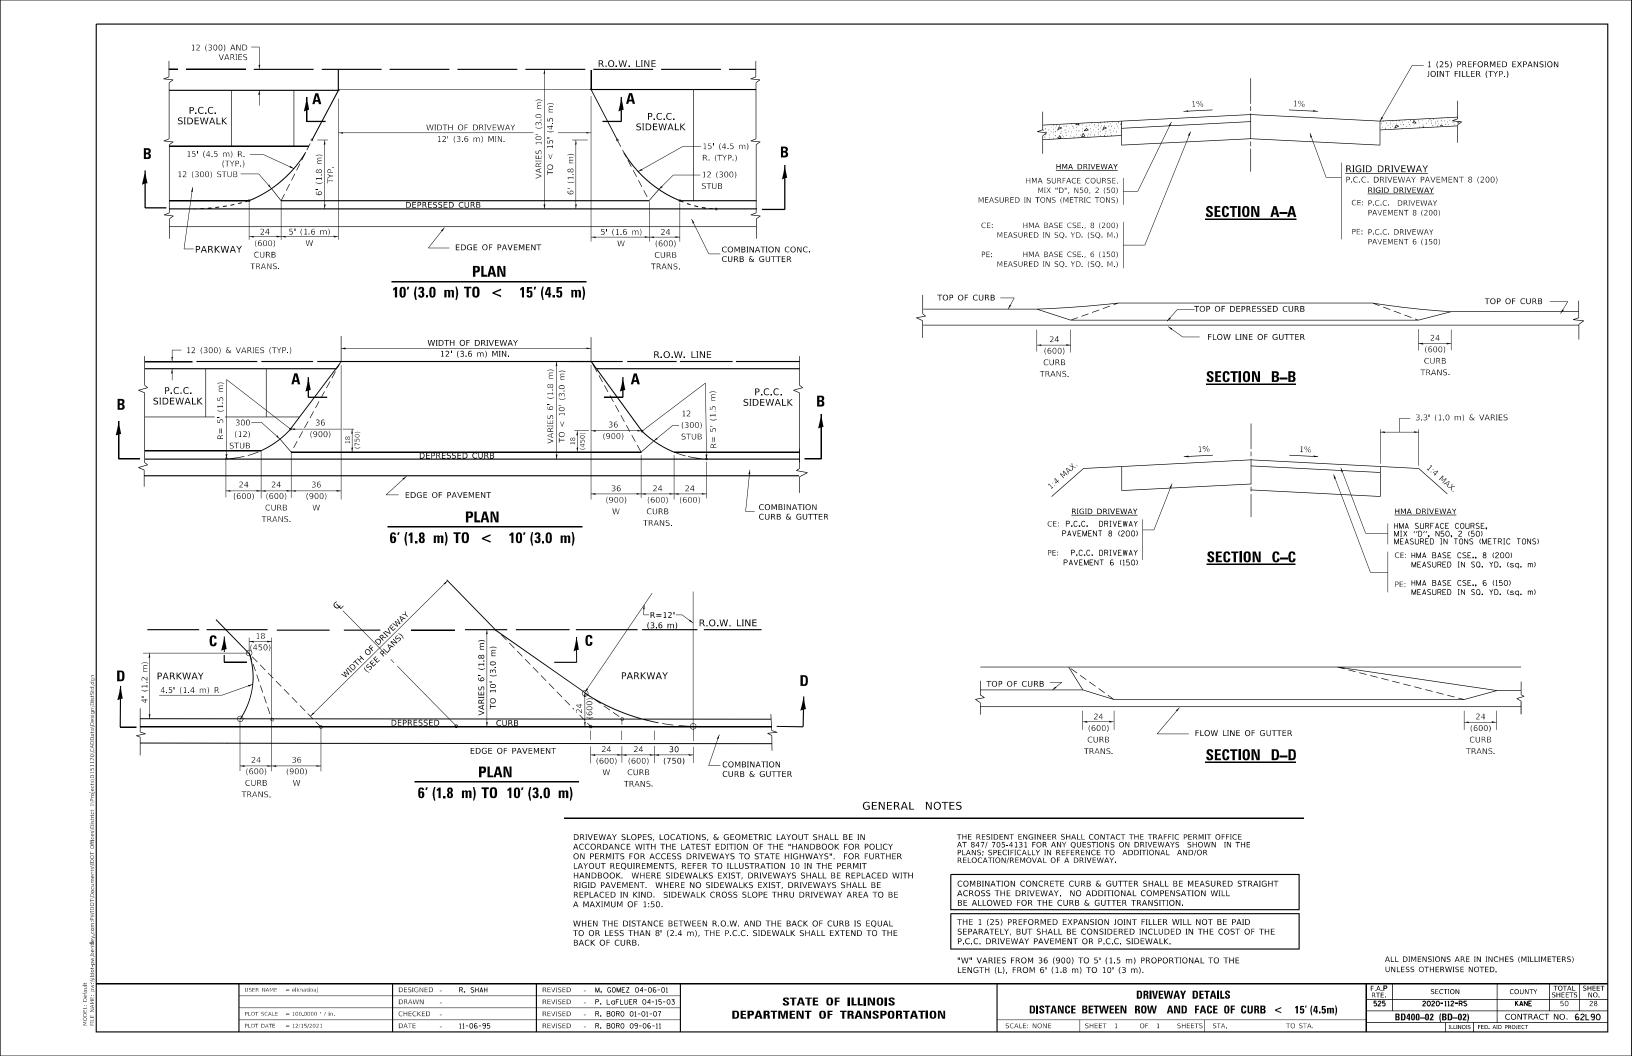

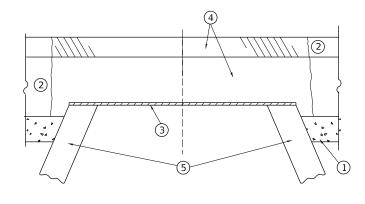

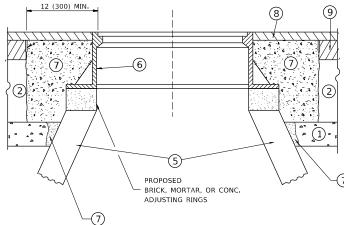

NOTES

EXISTING BROKEN FRAMES AND LIDS SHALL BE REMOVED AND DISPOSED OF BY THE CONTRACTOR AND SHALL BE REPLACED AS DIRECTED BY THE ENGINEER. REPLACEMENT FRAMES AND LIDS WILL BE PAID FOR IN ACCORDANCE WITH ARTICLE 109.04 OF THE STANDARD SPECIFICATIONS UNLESS A SEPARATE PAY ITEM HAS BEEN PROVIDED.

IF THE EXISTING LIDS ARE OPEN, THE FRAME WILL BE ADJUSTED TO THE ELEVATION OF THE MILLED PAVEMENT SURFACE PRIOR TO THE MILLING OPERATION. THE FRAME WILL NOT BE REMOVED AND COVERED BY THE METAL PLATE.

CITY OF CHICAGO CASTINGS ARE THE PROPERTY OF THE CITY AND THE CONTRACTOR SHALL NOTIFY THE CITY FOR REMOVAL AND DISPOSITION OF THE CASTINGS.

THE METAL PLATE USED TO COVER THE STRUCTURE SHALL REMAIN THE PROPERTY OF THE CONTRACTOR.

WHEN STRUCTURES ARE TO BE ADJUSTED OR RECONSTRUCTED, THE LOWERING AND RAISING OF THE FRAMES AND LIDS WILL NOT BE PAID FOR SEPARATELY BUT WILL BE INCLUDED IN THE COST OF THE CORRESPONDING PAY ITEM.

CONSTRUCTION PROCEDURES

STAGE 1 (BEFORE PAVEMENT MILLING)

- A) REMOVE A MINIMUM OF 12 (300) OF THE PAVEMENT FROM AROUND THE STRUCTURE.
- B) REMOVE THE EXISTING FRAME AND LID FROM THE STRUCTURE.
- C) COVER THE STRUCTURE OPENING WITH A 36 (900) DIAMETER METAL PLATE.
- D) BACKFILL WITH CRUSHED STONE AND A MINIMUM 1½ (40)
 THICK HMA SURFACE MIX APPROVED BY THE ENGINEER.

STAGE 2 (AFTER PAVEMENT MILLING)

- A) REMOVE THE HMA SURFACE MIX AND CRUSHED STONE.
- B) INSTALL THE FRAME AND LID; ADJUST THE FRAME TO ITS FINAL SURFACE ELEVATION.
- C) THE SURROUNDING SPACE SHALL BE FILLED WITH CLASS PP-1 *
 CONCRETE TO THE ELEVATION OF THE SURFACE OF THE EXISTING
 BASE COURSE OR THE BINDER COURSE.
- st unless otherwise specified in the plans.

THE PROCEDURE EXPLAINED ABOVE SHALL CONFORM TO THE APPLICABLE PORTIONS OF SECTIONS 353, 406, 602, AND 603 OF THE STANDARD SPECIFICATIONS EXCEPT THAT "THE CONTRACTOR SHALL ADJUST THE STRUCTURES TO THE FINISHED PAVEMENT ELEVATION NO MORE THAN 5 CALENDAR DAYS PRIOR TO PLACEMENT OF THE FINAL LIFT OF SURFACE UNLESS APPROVED BY THE FNGINFER."

LEGEND

- 1 SUB-BASE GRANULAR MATERIAL
- 6 FRAME AND LID (SEE NOTES)
- 2 EXISTING PAVEMENT
- 7 CLASS PP-1 *CONCRETE
- 3 36 (900) DIAMETER METAL PLATE
- 8) PROPOSED HMA SURFACE COURSE
- PROPOSED CRUSHED STONE AND HMA SURFACE MIX

 (5) EXISTING STRUCTURE
- 9 PROPOSED HMA BINDER COURSE

LOCATION OF STRUCTURES

THE CONTRACTOR WILL BE REQUIRED TO KEEP A RECORD OF THE LOCATIONS OF THE BURIED STRUCTURES ACCORDING TO THE STATION AND DISTANCE LEFT OR RIGHT OF THE CENTERLINE OF PAVEMENT. UPON COMPLETION OF THE WORK, THE CONTRACTOR WILL DELIVER THE RECORD TO THE ENGINEER.

BASIS OF PAYMENT

REMOVING FRAMES AND LIDS ON DRAINAGE AND UTILITY STRUCTURES IN THE PAVEMENT PRIOR TO MILLING, AND ADJUSTING TO FINAL GRADE PRIOR TO PLACING THE SURFACE COURSE, WILL BE PAID FOR AT THE CONTRACT UNIT PRICE EACH FOR "FRAMES AND LIDS TO BE ADJUSTED (SPECIAL)."

THIS WORK WILL NOT BE PAID FOR WHEN DRAINAGE AND UTILITY STRUCTURES ARE SPECIFIED FOR PAYMENT AS STRUCTURE RECONSTRUCTION.

NEW FRAMES AND LIDS, WHEN SPECIFIED, WILL BE PAID FOR SEPARATELY.

DETAILS FOR FRAMES AND LIDS ADJUSTMENT WITH MILLING

ALL DIMENSIONS ARE IN INCHES (MILLIMETERS) UNLESS OTHERWISE SHOWN

 USER NAME
 = elkhatibaj
 DESIGNED
 R. SHAH
 REVISED
 R. WEDEMAN 05-14-04

 DRAWN
 REVISED
 R. BORO 01-01-07


 PLOT SCALE
 = 100,0000 ' / in.
 CHECKED
 REVISED
 R. BORO 03-09-11

 PLOT DATE
 = 12/15/2021
 DATE
 10-25-94
 REVISED
 R. BORO 12-06-11

STATE OF ILLINOIS
DEPARTMENT OF TRANSPORTATION

PRAMES AND LIDS ADJUSTMENT WITH MILLING

NE SHEET 1 OF 1 SHEETS STA. TO STA.

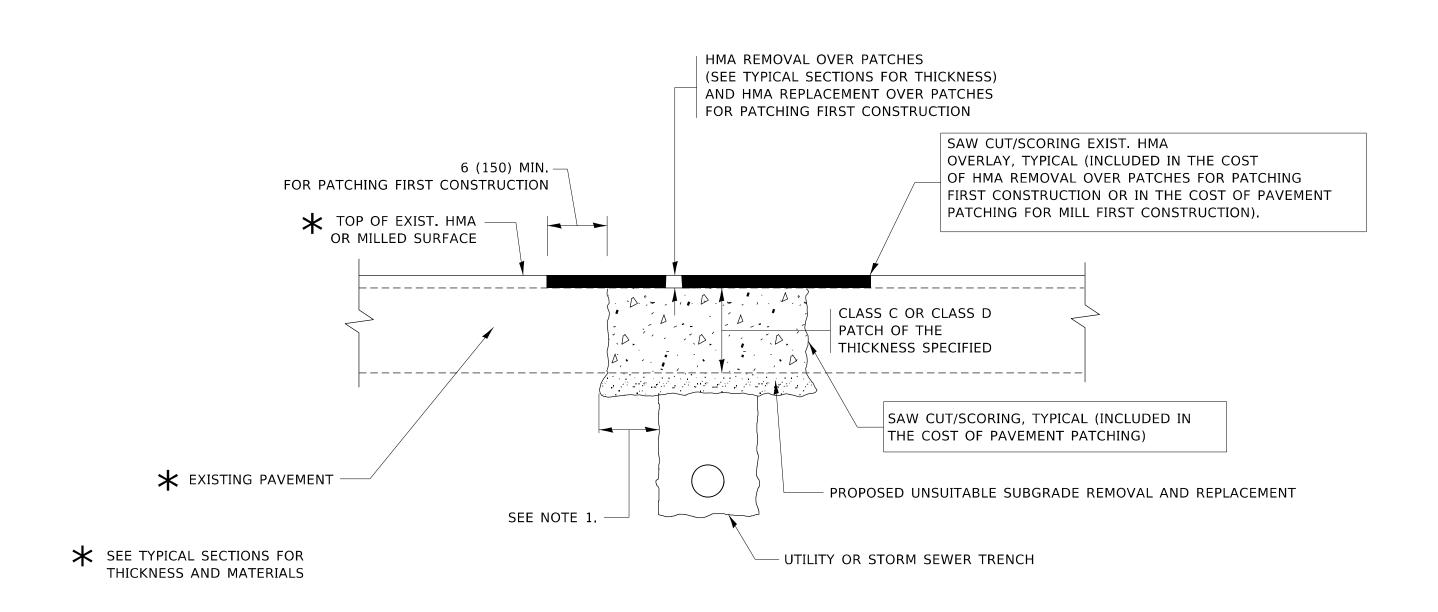

NOTES:

- 1. THE WIDTH OF THE FULL DEPTH PATCH OVER A TRENCH SHALL BE 12 (300) WIDER ON EACH SIDE OF THE TRENCH.
- 2. FOR METHOD OF MEASUREMENT AND BASIS OF PAYMENT, SEE RECURRING SPECIAL PROVISION "PATCHING WITH HOT-MIX ASPHALT OVERLAY REMOVAL".

SEQUENCE OF CONSTRUCTION (PATCHING FIRST)

- 1. REMOVE THE EXISTING HMA MATERIAL OVER THE AREA TO BE PATCHED.
- 2. REMOVE AND REPLACE WITH CLASS C OR D PATCH.
- 3. REPLACE HMA MATERIAL OVER THE AREA TO BE PATCHED.

SEQUENCE OF CONSTRUCTION (MILLING FIRST)

- 1. MILL HMA FIRST IF THERE IS AT LEAST $4\frac{1}{2}$ INCHES OR MORE OF HMA MATERIAL ON TOP OF THE EXISTING PAVEMENT OR IF THE PAVEMENT IS FULL DEPTH HMA. A MINIMUM OF 2 INCHES OF HMA MATERIAL SHALL BE IN PLACE AFTER MILLING.
- 2. REMOVE AND REPLACE WITH FULL DEPTH CLASS D PATCHES TO TOP OF MILLED SURFACE.


ALL DIMENSIONS ARE IN INCHES (MILLIMETERS) UNLESS OTHERWISE SHOWN.

USEK NAME = ejknatioaj	DESIGNED - 1	K. SHAH	KEVISED	-	A. ABBAS 04-27-98	
	DRAWN -		REVISED	-	R. BORO 01-01-07	
PLOT SCALE = 100.0000 / in.	CHECKED -		REVISED	-	R. BORO 09-04-07	
PLOT DATE = 12/15/2021	DATE - :	10-25-94	REVISED	-	K. ENG 10-27-08	

STATE	: OF	ILLINOIS
DEPARTMENT	OF	TRANSPORTATION

SCALE: NONE

	PAVEMENT PATCHING FOR							SEC	TION		COUNTY	TOTAL SHEETS	ETS NO.	
	HMA SURFACED PAVEMENT						525	2020-	112 - RS		KANE 50		30	
TIMA SURFACED PAVEINIENI								BD400-04 (E	3D-22)		CONTRACT	NO. 6	2L90	
SHEET	1	OF	1	SHEETS	STA.	TO STA.			ILLINOIS	FED. AI	D PROJECT			

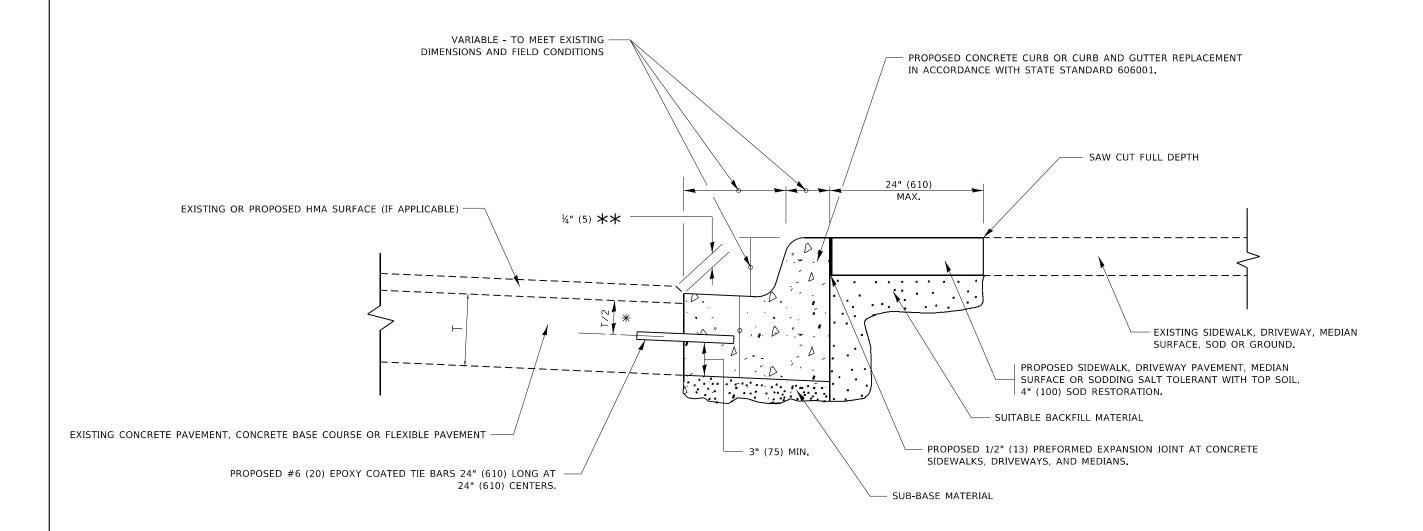

- 💥 3" (75) MINIMUM FROM TOP AND BOTTOM OF THE CONCRETE PAVEMENT OR BASE COURSE.
- $\star\star$ IF THE FINAL SURFACE OF THE PAVEMENT IS CONCRETE, THE GUTTER IS TO BE FLUSH WITH THE PAVEMENT.

CURB OR CURB AND GUTTER REMOVAL AND REPLACEMENT


ALL DIMENSIONS ARE IN INCHES (MILLIMETERS) UNLESS OTHERWISE SHOWN.

USER NAME = elkhatibaj	DESIGNED -	A. HOUSEH	REVISED	-	A. ABBAS 03-21-97
	DRAWN -		REVISED	-	M. GOMEZ 01-22-01
PLOT SCALE = 100.0000 / in.	CHECKED -		REVISED	-	R. BORO 12-15-09
PLOT DATE = 12/15/2021	DATE -	03-11-94	REVISED	-	K. SMITH 07-11-19

STATE OF ILLINOIS
DEPARTMENT OF TRANSPORTATION


CURB OR CURB AND GUTTER
REMOVAL AND REPLACEMENT

SHEET 1 OF 1 SHEETS STA.

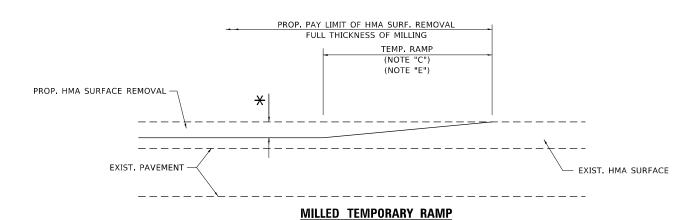

(FOR BUTT JOINT AND HMA TAPER SEE DETAIL BELOW)

OPTION 1

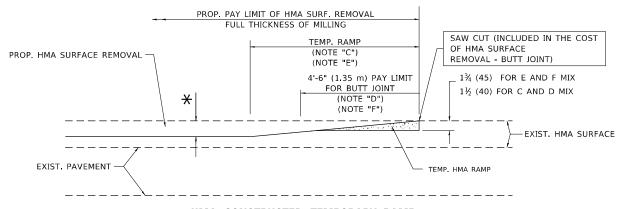


HMA CONSTRUCTED TEMPORARY RAMP

(FOR BUTT JOINT AND HMA TAPER SEE DETAIL BELOW)

OPTION 2

TYPICAL TEMPORARY RAMP

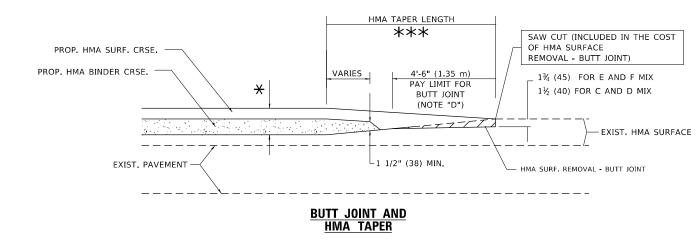


TYPICAL BUTT JOINT AND HMA TAPER FOR MILLING AND RESURFACING

M. DE YONG DESIGNED -DRAWN REVISED -A. ABBAS 03-21-97 HECKED REVISED M. GOMEZ 04-06-01 LOT DATE = 12/15/2021 R.BORO 01-01-07 DATE REVISED -

DEPARTMENT OF TRANSPORTATION

SECTION **BUTT JOINT AND** 2020-112-RS HMA TAPER DETAILS BD400-05 BD32 SHEET 1 OF 1 SHEETS STA. TO STA.

PROP, HMA OR PCC SURFACE REMOVAL - BUTT JOINT SAW CUT (INCLUDED IN THE COST 30'-0" (9.0 m) (NOTE "A") EXIST. HMA OR PCC SURFACE -OF HMA OR P.C.C. SURFACE REMOVAL 15'-0" (4.5 m) (NOTE "B") - BUTT JOINT) (NOTE "D") 1¾ (45) FOR E AND F MIX 1½ (40) FOR C AND D MIX * * EXIST. PAVEMENT **BUTT JOINT DETAIL**

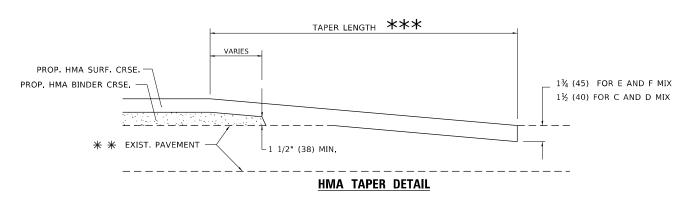

TYPICAL BUTT JOINT AND HMA TAPER FOR RESURFACING ONLY

** PC CONCRETE, HMA OR HMA RESURFACED PAVEMENT.

NOTES

- A. MAINLINE ROADWAYS AND MAJOR SIDE ROADS.
- B. MINOR SIDE ROADS.
- C. THE TEMP, RAMP SHALL BE CONSTRUCTED IMMEDIATELY UPON REMOVAL OF THE EXISTING HMA SURFACE,
- D. THE BUTT JOINT SHALL BE CONSTRUCTED IMMEDIATELY PRIOR TO PLACING THE PROPOSED HMA COURSES.
- E. TAPER THE TEMP. RAMP AT A RATE OF 3'-0" (900 mm) PER 1 INCH (25 mm) OF MILLING THICKNESS.
- F. INSTALLATION AND REMOVAL OF THE 4'-6" (1.35 m) TEMP. RAMP IS INCLUDED IN COST OF HMA SURFACE REMOVAL - BUTT JOINT. * SEE TYPICAL SECTIONS FOR MILLING THICKNESS.
- G. SEE ARTICLE 406.08 AND 406.14 OF THE STANDARD SPECIFICATIONS FOR "HMA AND/OR PCC SURFACE REMOVAL, BUTT JOINT".
- *** 20'-0" (6.1 m) PER 1 (25) RESURFACING (NOTE "A") 10'-0" (3.0 m) PER 1 (25) RESURFACING (NOTE "B")

BASIS OF PAYMENT


THE BUTT JOINT WILL BE PAID FOR AT THE CONTRACT UNIT PRICE FOR "HOT-MIX ASPHALT SURFACE REMOVAL - BUTT JOINT" OR FOR "PORTLAND CEMENT CONCRETE SURFACE REMOVAL - BUTT JOINT" OR


SCALE: NONE

ALL DIMENSIONS ARE IN INCHES (MILLIMETERS) UNLESS OTHERWISE SHOWN.

STATE OF ILLINOIS

CONTRACT NO. 62L90

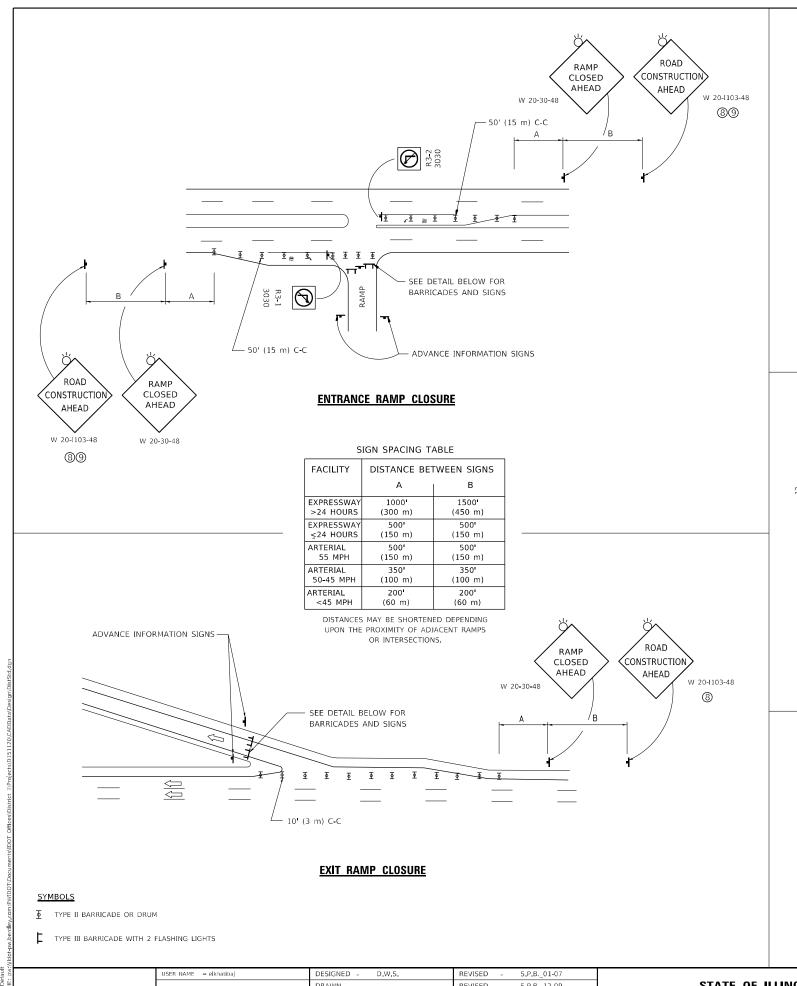

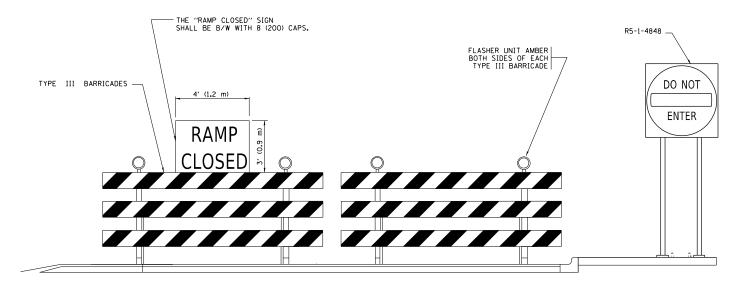

DETAIL FOR REQUIRED BARRICADES & SIGNS

RAMP CLOSURE ADVANCE INFORMATION SIGN



RAMP CLOSURE ADVANCE WARNING SIGN

10' (3 m)

BLACK LEGEND ON ORANGE
BACKGROUND MOUNTED
DIAGONALLY

E MOD FONT
1 (25) BORDER
THESE SIGNS ARE REQUIRED ON ALL THE EXIT
GUIDE SIGNS FOR EXIT RAMPS THAT WILL BE

CLOSED FOR MORE THAN FOUR (4) CONSECUTIVE DAYS.

6 (150) 5 (125) BLACK LEGEND ON WHITE BACKGROUND 6 (150) 5 (125) ½ (12) BORDER **CLOSED** 6 (150) E MOD FONT 5 (125) 6 (150) THESE BLANK AREAS SHALL BE FILLED WITH THE DATES AND THE 5 (125) TIME THAT THE RAMP WILL BE 6 (150) (125)

THESE SIGNS ARE REQUIRED ON BOTH SIDES OF THE RAMP, MINIMUM OF 1 WEEK IN ADVANCE OF THE CLOSURE.

THESE SIGNS SHALL BE FABRICATED AND PAID FOR ACCORDING TO THE TEMPORARY INFORMATION SIGNING SPECIAL PROVISION

GENERAL NOTES:


- ① CONES MAY BE SUBSTITUTED FOR DRUMS OR TYPE II BARRICADES DURING DAY OPERATIONS. CONES SHALL BE A MINIMUM OF 28 (700) HIGH.
- (2) VERTICAL BARRICADES SHALL NOT BE USED FOR RAMP CLOSURES.
- ③ A FLAGGER SHALL BE POSITIONED AT EACH CLOSED RAMP THAT IS OPEN TO CONSTRUCTION VEHICLES, PRECEEDED BY A W20-7 FLAGGER WARNING SIGN.
- ALL ROUTE MARKERS AND TRAILBLAZER ASSEMBLIES WHICH
 DIRECT MOTORISTS TO A CLOSED ENTRANCE RAMP SHALL BE
 COVERED WHEN THE RAMP IS CLOSED FOR MORE THAN FOUR (4) DAYS.
- (3) THE SIGNING AND BARRICADING WHICH IS REQUIRED BY THIS DETAIL SHALL BE INCLUDED IN THE COST OF TRAFFIC CONTROL AND PROTECTION (EXPRESSWAYS).

- 6 AUTHORIZATION FROM THE DISTRICT'S BUREAU OF TRAFFIC IS REQUIRED FOR ALL RAMP CLOSURES.
- THE RAMP CLOSURE ADVANCE INFORMATION SIGNS SHALL BE ERECTED
 IF THE CLOSURE TIME EXCEEDS TWENTY-FOUR (24) HOURS. ADDITIONAL
 ADVANCE WARNING SIGNS ON EXIT GUIDE SIGNING WILL BE
 REQUIRED FOR EXIT RAMP CLOSURES THAT EXCEED FOUR (4) DAYS IN LENGTH
- (8) ROAD CONSTRUCTION AHEAD SIGNS MAY BE OMITTED WHEN THIS DETAIL IS USED IN CONJUNCTION WITH OTHER TRAFFIC CONTROL THAT ALREADY INCLUDES A ROAD CONSTRUCTION AHEAD SIGN.
- ARTERIAL ROAD CONSTRUCTION AHEAD SIGNS SHALL BE INSTALLED ON THE LEFT SIDE OF TRAFFIC IF THE MEDIAN IS MORE THAN 10 FT WIDE.

ALL DIMENSIONS ARE IN INCHES (MILLIMETERS)
UNLESS OTHERWISE SHOWN.

62L90

USER NAME = elkhatibaj	DESIGNED - D.W.S.	REVISED - S.P.B01-07		ENTRANCE AND EXIT RAMP	F.A.P RTF	SECTION	COUNTY	TOTAL
	DRAWN -	REVISED - S.P.B12-09	STATE OF ILLINOIS		525	2020-112-RS	KANE	50
PLOT SCALE = 100.0000 / in	CHECKED -	REVISED - M.D06-13	DEPARTMENT OF TRANSPORTATION	CLOSURE_DETAILS	'	TC-08	CONTRACT	T NO. 6
PLOT DATE = 12/15/2021	DATE - 02-83	REVISED - M.D. 01-18		SCALE: NONE SHEET 1 OF 1 SHEETS STA. TO STA.		ILLINOIS FED. A	ID PROJECT	

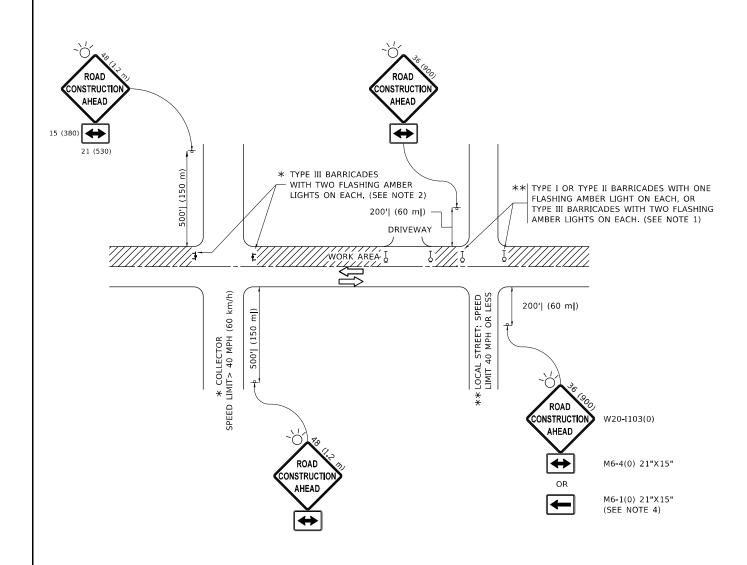

NOTES:

- 1. SIDE ROAD WITH A SPEED LIMIT OF 40 MPH (60 km/h) OR LESS AS SHOWN ON THE DRAWING AND AS DIRECTED BY THE ENGINEER:
- a) ONE "ROAD CONSTRUCTION AHEAD" SIGN 36 x 36 (900x900) WITH A FLASHER MOUNTED ON IT APPROXIMATELY 200' (60 m) IN ADVANCE OF THE MAIN ROUTE.
- b) THE CLOSED PORTION OF THE MAIN ROUTE SHALL BE PROTECTED BY BLOCKING WITH TYPE I, TYPE II OR TYPE III BARRICADES, 1/3 OF THE CROSS SECTION OF THE CLOSED PORTION.
- 2. SIDE ROAD WITH A SPEED LIMIT GREATER THAN 40 MPH (60 km/h) AS SHOWN ON THE DRAWING AND AS DIRECTED BY THE ENGINEER:
- a) ONE "ROAD CONSTRUCTION AHEAD" SIGN 48 x 48 (1.2 m x 1.2 m) WITH A FLASHER MOUNTED ON IT APPROXIMATELY 500' (150 m) IN ADVANCE OF THE MAIN ROUTE.
- THE CLOSED PORTION OF THE MAIN ROUTE SHALL BE PROTECTED BY
 b) BLOCKING WITH TYPE III BARRICADES, 1/2 OF THE CROSS SECTION
 OF THE CLOSED PORTION.
- 3. CONES MAY BE SUBSTITUTED FOR BARRICADES OR DRUMS AT HALF THE SPACING DURING DAY OPERATIONS. CONES SHALL BE A MINIMUM OF 28 (710) IN HEIGHT
- WHEN THE SIDE ROAD LIES BETWEEN THE BEGINNING OF THE MAINLINE
 4. SIGNING AND THE WORK ZONE, A SINGLE HEADED ARROW (M6-1) SHALL
 BE USED IN LIEU OF THE DOUBLE HEADED ARROW (M6-4).

SCALE: NONE

- 5. WHEN WORK IS BEING PERFORMED ON A SIDE ROAD OR DRIVEWAY, FOLLOW THE APPLICABLE STANDARD(S). THE DIRECTIONAL ARROW (M6-1 OR M6-4) SHALL BE COVERED OR REMOVED WHEN NO LONGER CONSISTENT WITH THE TRAFFIC CONTROL SET-UP.
- 6. ADVANCE WARNING SIGNS ARE TO BE OMITTED ON DRIVEWAYS UNLESS OTHERWISE SPECIFIED IN THE PLANS OR BY THE ENGINEER
- 7. THE TRAFFIC CONTROL AND PROTECTION FOR SIDE ROADS, INTERSECTIONS, AND DRIVEWAYS SHALL BE INCLUDED IN THE COST OF SPECIFIED TRAFFIC CONTROL STANDARDS OR ITEMS.


All dimensions are in inches (millimeters) unless otherwise shown.

USER NAME = elkhatibaj	DESIGNED - L.H.A.	REVISED - A. HOUSEH 10-15-96
	DRAWN -	REVISED - T. RAMMACHER 01-06-00
PLOT SCALE = 100.0000 / in.	CHECKED -	REVISED - A. SCHUETZE 07-01-13
PLOT DATE = 12/15/2021	DATE 06-80	REVISED A. SCHUFTZF 09-15-16

STATE	: OI	FILLINOIS
DEPARTMENT	0F	TRANSPORTATION

TRAFFIC CONTROL AND PROTECTION FOR SIDE ROADS, INTERSECTIONS, AND DRIVEWAYS	F.A.P RTE. 525	SECTION 2020-112-RS
OIDE HOADO, HATEHOEOTIONO, AND DINVENTATO		TC-10
CHEET 1 OF 1 CHEETC CTA TO CTA		


| SECTION | COUNTY | SHEET | S

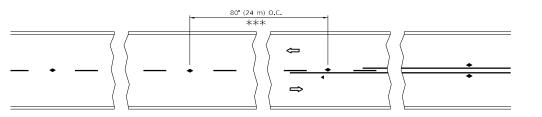


*** REDUCE TO 40' (12 m) O.C. ON CURVES WITH POSTED OR ADVISORY SPEED 45 M.P.H. (70 km/h) OR LESS.


3 @ 40' (12 m) O.C. \Rightarrow LANE REDUCTION TRANSITION

SEE FIGURE 3B-14 MUTCD

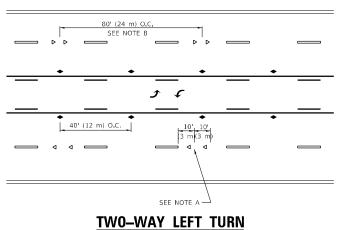


TW0-LANE/TW0-WAY

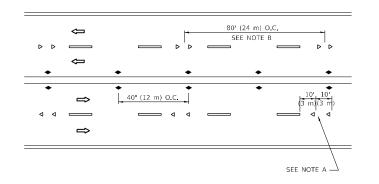


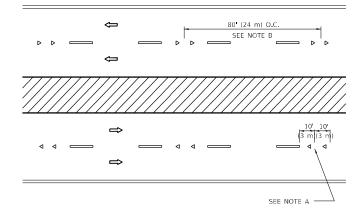

MULTI-LANE/UNDIVIDED



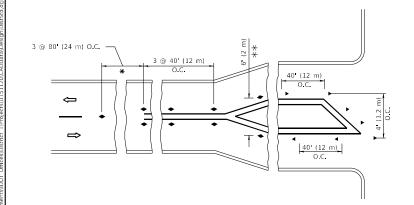

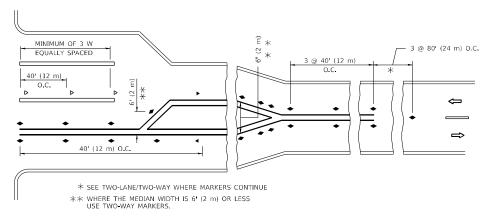

TURN LANES

GENERAL NOTES

- 1. MARKERS USED WITH DASHED LINES SHALL BE CENTERED IN THE GAP BETWEEN SEGMENTS.
- 2. MARKERS USED ADJACENT TO SOLID LINES SHALL BE OFFSET 2 TO 3 (50 TO 75) TOWARD TRAFFIC AS SHOWN.
- 3. MARKERS THROUGH TANGENTS LESS THAN 500' (150 m) IN LENGTH BETWEEN CURVES SHALL BE INSTALLED AT THE LESSER OF THE TWO CURVE SPACINGS.
- 4. MARKERS ARE TO BE USED ADJACENT TO BOTH SOLID WHITE LINES IN DUAL LEFT TURN LANES

LANE MARKER NOTES

- A. USE DOUBLE LANE LINE MARKERS SPACED AS SHOWN.
- B. REDUCE TO 40 (12 m) O.C. ON CURVES WHERE ADVISORY SPEEDS ARE 10 M.P.H (20 km/h) LOWER THAN POSTED SPEEDS.

DESIGN NOTES

- 1. DOUBLE LANE LINE MARKERS SHALL BE USED UNLESS SPECIFIED OTHERWISE.
- 2. EXCEPT AS SHOWN ON THE LANE REDUCTION TRANSITION AND FREEWAY EXIT RAMP DETAIL, MARKERS ARE NOT TO BE SPECIFIED ON RIGHT EDGE LINES.
- 3. THE EXACT MARKER LIMITS, SPACING, AND COLOR SHALL BE INCLUDED IN THE PLANS WHEN STANDARD SPECIFICATIONS ARE NOT BEING USED.
- SHORT SECTIONS OF CURBS WHERE NOT MORE THAN TWO MARKERS WOULD BE INVOLVED.

All dimensions are in inches (millimeters) unless otherwise shown.

DESIGNED REVISED - T. RAMMACHER 03-12-99 JSER NAME = elkhatibaj DRAWN REVISED - T. RAMMACHER 01-06-00 CHECKED REVISED PLOT DATE = 12/15/2021 C. JUCIUS 07-01-13 DATE REVISED -

STATE OF ILLINOIS **DEPARTMENT OF TRANSPORTATION**

TYPICAL APPLICATIONS RAISED REFLECTIVE PAVEMENT MARKERS (SNOW-PLOW RESISTANT) SHEET 1 OF 1 SHEETS STA.

SECTION 2020-112-RS TC-11 CONTRACT NO. 62L90

SYMBOLS

ONE-WAY AMBER MARKER


TWO-WAY AMBER MARKER

ONE-WAY CRYSTAL MARKER (W/O)

YELLOW STRIPE

■ WHITE STRIPE

4. MARKERS SHOULD NOT BE USED ALONGSIDE CURBS EXCEPT FOR EXTREMELY

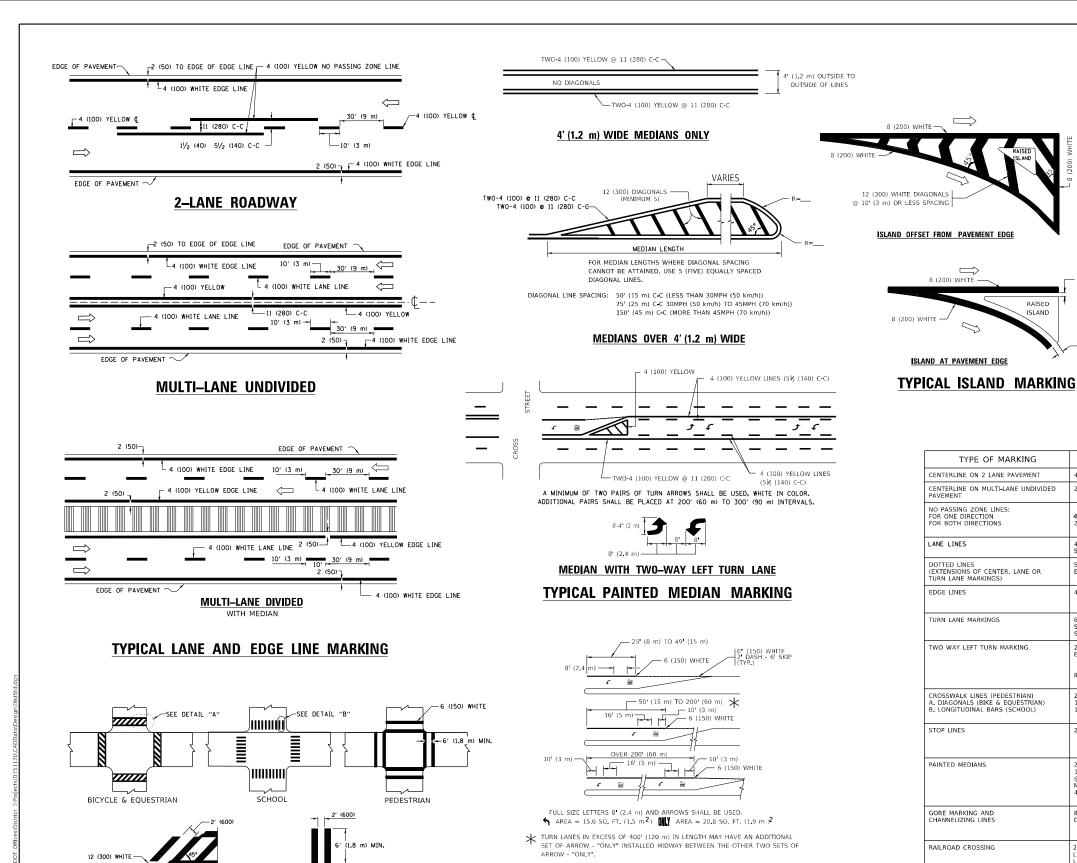

COMBINATION LEFT AND U-TURN — 2 (50) 5'-4" (1620) √ 32 R (810) 2 (50) LANE REDUCTION TRANSITION * LANE REDUCTION ARROWS REQUIRED AT SPEEDS OF 45 MPH OR GREATER OR WHEN SPECIFIED IN PLANS. **U-TURN** WIDTH OF LINE PATTERN COLOR SPACING / REMARKS SKIP-DASH rELLOW 10' (3 m) LINE WITH 30' (9 m) SPACE SOLID YELLOW 11 (280) C-C **4 (100)** 2 @ 4 (100) YELLOW YELLOW 5½ (140) C-C FROM SKIP-DASH CENTERLINE 11 (280) C-C OMIT SKIP-DASH CENTERLINE BETWEEN SKIP-DASH 10' (3 m) LINE WITH 30' (9 m) SPACE 4 (100) 5 (125) ON FREEWAYS SKIP-DASH SAME AS LINE BEING EXTENDED SKIP-DASH SAME AS LINE BEING EXTENDED 2 (600) LINE WITH 6 (1.8 m) SPACE SOLID OUTLINE MEDIANS IN YELLOW 4 (100) YELLOW-LEFT WHITE-RIGHT SEE TYPICAL TURN LANE MARKING DETAIL 10' (3 m) LINE WITH 30' (9 m) SPACE FOR SKIP-DASH; 5½ (140) C-C BETWEEN SOLID LINE AND SKIP-DASH LINE SEE TYPICAL TWO-WAY LEFT TURN MARKING DETAIL 2 @ 4 (100) EACH DIRECTION 8 (2.4m) LEFT ARROW NOT LESS THAN 6 (1.8 m) APART 2 (600) APART (600) APART SEE TYPICAL CROSSWALK MARKING DETAILS. PARALLEL TO CROSSWALK, PRESENT.
OTHERWISE, PLACE AT DESIRED STOPPING
POINT, PARALLEL TO CROSSROAD CENTERLINE, WHERE
POSSIBLE 24 (600) SOLID WHITE 11 (280) C-C FOR THE DOUBLE LINE SEE TYPICAL PAINTED MEDIAN MARKING. 2 @ 4 (100) WITH 12 (300) DIAGONALS @ 45° SOLID YELLOW: TWO WAY TRAFFIC WHITE: ONE WAY TRAFFIC @ 45° NO DIAGONALS USED FO 4' (1.2 m) WIDE MEDIAN! 8 (200) WITH 12 (300) DIAGONALS @ 45° DIAGONALS: 15' (4.5 m) C-C (LESS THAN 30MPH (50 km/h)) 20' (6 m) C-C 30MPH (50 km/h) TO 45MPH (70 km/h)) 30' (9 m) C-C (OVER 45MPH (70 km/h))

D(FT)

580

665

SPEED LIMIT

45

50

55

FOR FURTHER DETAILS ON PAVEMENT MARKING REFER TO STANDARD SPECIFICATIONS FOR ROAD AND BRIDGE CONSTRUCTION AND STATE STANDARD 780001.

SHOULDER DIAGONALS (REQUIRED FOR

SHOULDERS > 8')

2 ARROW COMBINATION

J TURN ARROW

SCALE:

24 (600) TRANSVERSE LINES; "RR" IS 6 (1.8 m) LETTERS; 16 (400) LINE FOR "X"

12 (300) @ 45°

SEE DETAIL

SEE DETAIL

SOLID

SOLID

SOLID

SOLID

WHITE

WHITE

WHITE - RIGHT YELLOW - LEFT

RAISED

All dimensions are in inches (millimeters unless otherwise shown.

50' (15 m) C-C (LESS THAN 30MPH (50 km/h)) 75' (25 m) C-C (30 MPH (50 km/h) TO 45MPH (70 km/h)) 150' (45 m) C-C (OVER 45MPH (70 km/h))

SEE STATE STANDARD 780001 AREA OF:

30.4 SF

"R"=3.6 SQ. FT. (0.33 m)2EACH "X"=54.0 SQ. FT. (5.0 m)2

USER NAME = elkhatibaj	DESIGNED	-	EVERS	REVISED	-	C. JUCIUS 09-09-09
	DRAWN	-		REVISED	-	C. JUCIUS 07-01-13
PLOT SCALE = 100.0000 / in.	CHECKED	-		REVISED	-	C. JUCIUS 12-21-15
PLOT DATE = 12/15/2021	DATE	-	03-19-90	REVISED	-	C. JUCIUS 04-12-16

-12 (300) WHITE

DETAIL "B"

- 6 (150) WHITE

TYPICAL CROSSWALK MARKING

* MARKINGS SHALL BE INSTALLED PARALLEL TO THE CENTERLINE OF

DETAIL "A"

STATE OF ILLINOIS **DEPARTMENT OF TRANSPORTATION**

TYPICAL LEFT (OR RIGHT) TURN LANE

TYPICAL TURN LANE MARKING

DISTRICT ONE									SEC ⁻	TION		COUNTY TOTAL SHEETS		SHEET NO.
	т	VDI	CAL	DΛV	EMENT	MARKIN	G C	525	2020-	112 - RS		KANE	50	36
			UAL	. AV	LIVILIAI	IVIZITINI	<u> </u>		TC-13			CONTRACT	NO. 6	2L90
: NONE	SHEET	1	OF	2	SHEETS	STA.	TO STA.			ILLINOIS	FED. AI	D PROJECT		

TURN BAY ENTRANCE AT START OF LANE CLOSURE TAPER

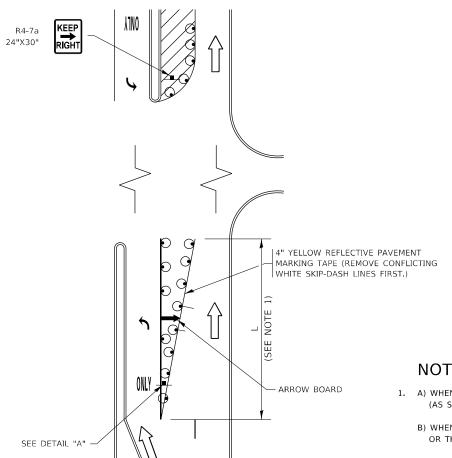



FIGURE 1

LEGEND WORK AREA LANE OPEN TO TRAFFIC ARROW BOARD TYPE I OR II BARRICADE OR DRUM WITH STEADY BURN LIGHT DRUM WITH STEADY BURN LIGHT SIGN ASSEMBLY TYPE I OR II CHECK BARRICADE WITH FLASHING LIGHT

NOTES:

- 1. A) WHEN "L" IS ≤ THE STORAGE LENGTH OF THE TURN LANE (AS SHOWN IN FIG. 1), USE FIGURE 1.
 - B) WHEN "L" IS > THE STORAGE LENGTH OF THE TURN LANE OR THE TURN LANE IS WITHIN THE LANE CLOSURE, USE FIGURE 2.
- 2. CONES MAY BE SUBSTITUTED FOR BARRICADES OR DRUMS AT HALF THE SPACING DURING DAY OPERATIONS. CONES SHALL BE A MINIMUM OF 28 (710) IN HEIGHT.
- 3. LIGHTS WILL NOT BE REQUIRED ON BARRICADES OR DRUMS FOR DAY OPERATIONS. ALL LIGHTS SHALL BE MONODIRECTIONAL.
- 4. REFLECTIVE TEMPORARY PAVEMENT MARKINGS SHALL BE PLACED THROUGHOUT THE BARRICADED AREAS OF EACH TURN BAY AS SHOWN WHERE THE CLOSURE TIME IS GREATER THAN FOURTEEN (14) DAYS.
- 5. THIS APPLICATION ALSO APPLIES WHEN WORK IS BEING PERFORMED IN THE RIGHT LANE(S) AND THE RIGHT TURN BAY IS TO REMAIN OPEN. UNDER THIS CONDITION, "RIGHT TURN LANE" R3-I100R 24 x 24 (600 x 600) AND M6-2R 21 x 15 (530 x 380) SHALL BE USED.
- 6. THESE CONTROLS SHALL SUPPLEMENT MAINLINE TRAFFIC CONTROL FOR LANE CLOSURES.
- 7. THE SIGNS SHALL BE MOUNTED ABOVE THE BARRICADES/DRUMS ON SEPARATE SIGN SUPPORTS THAT MEET NCHRP 350 OR MASH PREOUIREMENTS.
- 8. TRAFFIC CONTROL AND PROTECTION AT TURN BAYS (TO REMAIN OPEN TO TRAFFIC) SHALL BE INCLUDED IN THE COST OF SPECIFIED TRAFFIC CONTROL STANDARDS OR ITEMS.

TURN BAY ENTRANCE WITHIN A LANE CLOSURE

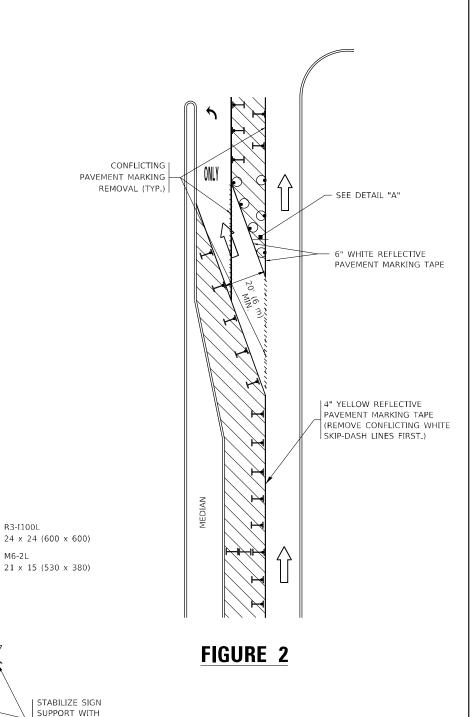

DETAIL A

TURN

All dimensions are in inches (millimeters) unless otherwise shown.


USEK NAME = ejknatioaj	DESIGNED	- 1.	RAMMACHER 09-08-	94 KEVISED	-	R. BURU US	9-14-09
	DRAWN	-	A. HOUSEH 11-07-9	5 REVISED	- A.	. SCHUETZE	07-01-13
PLOT SCALE = 100.0000 / in.	CHECKED	-	A. HOUSEH 10-12-9	6 REVISED	- A.	. SCHUETZE	09-15-16
PLOT DATE = 12/15/2021	DATE	- T.	RAMMACHER 01-06-	00 REVISED	-		

STATE OF ILLINOIS **DEPARTMENT OF TRANSPORTATION**

TRAFF					PROTECT OPEN		T TURN BAYS
SCALE: NONE	SHEET	1	OF	1	SHEETS	STA.	TO STA.


SANDBAGS AS

SECTION 2020-112-RS CONTRACT NO. 62L90 TC-14

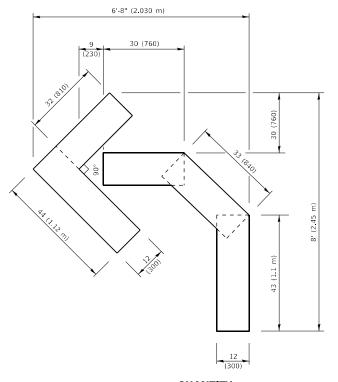


QUANTITY

4 (100) LINE = 45.5 ft. (13.9 m) 15.2 sq. ft. (1.41 sq. m)

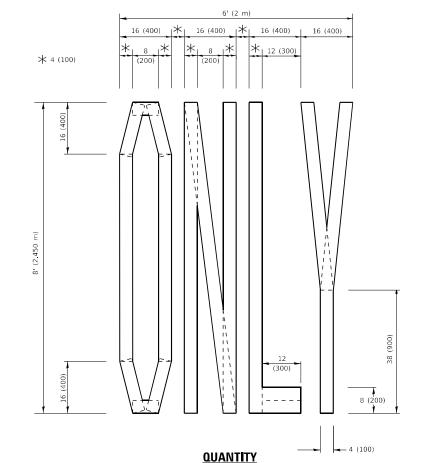

4 (100) LINE = 64.1 ft. (19.5 m) 21.4 sq. ft. (1.99 sq. m)

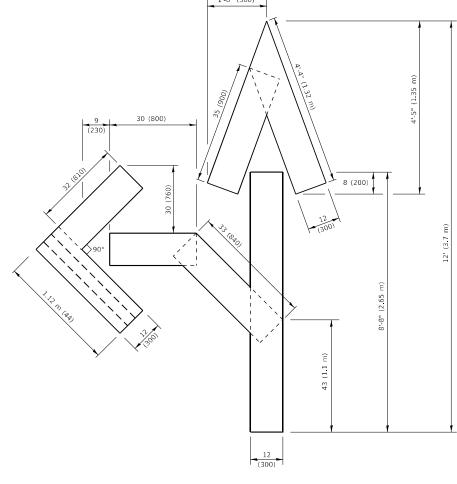


QUANTITY

4 (100) LINE = 82.5 ft. (25.1 m) 27.5 sq. ft. (2.53 sq. m)

NOTE:

ALL QUANTITIES OF PLACEMENT ARE REPRESENTED IN LINEAR FEET OF 4" LINES TO MATCH THE 4" TEMPORARY TAPE PAY ITEM AND REPRESENTS THE TOTAL QUANTITY OF 4" TAPE REQUIRED.

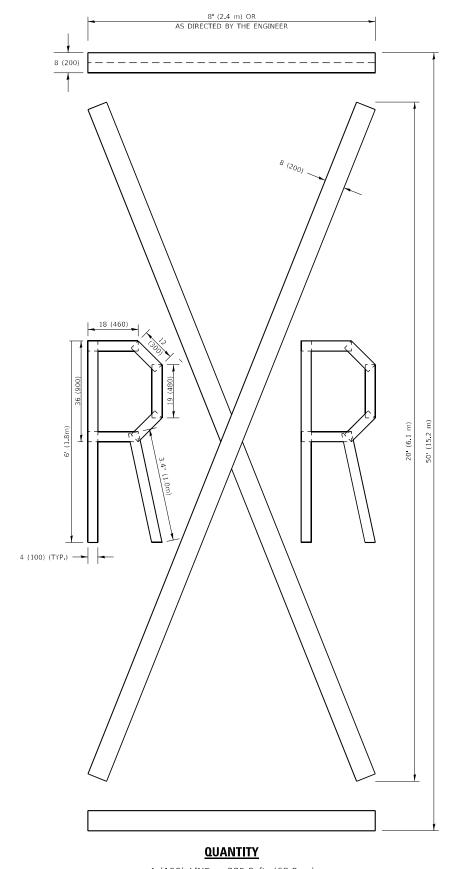

4 (100) LINE = 225.9 ft. (68.9 m) 75.3 sq. ft. (6.99 sq. m)


All dimensions are in inches (millimeters) unless otherwise shown.

USER NAME = elkhatibaj	DESIGNED	-		REVISED	- T. RAMMACHER 03-02-98
	DRAWN	-		REVISED	- E. GOMEZ 08-28-00
PLOT SCALE = 100.0000 / in.	CHECKED	-		REVISED	- E. GOMEZ 08-28-00
PLOT DATE = 12/15/2021	DATE	-	09-18-94	REVISED	- A. SCHUETZE 09-15-16

STATE OF ILLINOIS
DEPARTMENT OF TRANSPORTATION

SHORT TERM PAVEMENT MARKING LETTERS AND SYMBOLS

SCALE: NONE SHEET 1 OF 1 SHEETS STA. TO STA.

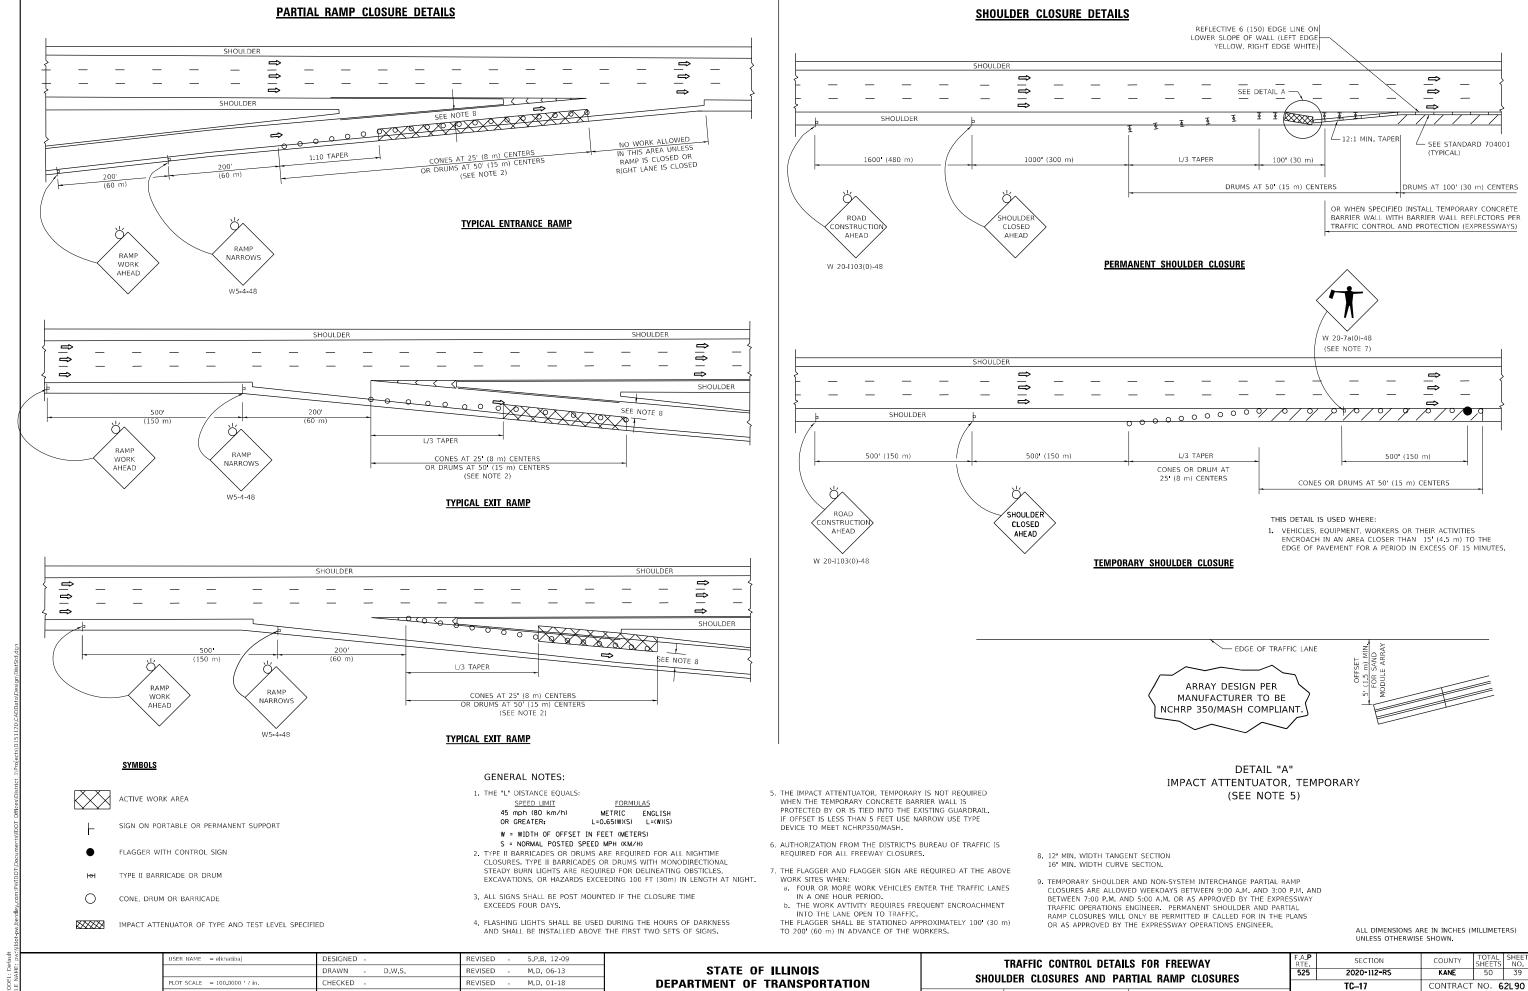


M.D. 10-20

REVISED

DATE

SHEET 1 OF 1 SHEETS STA.

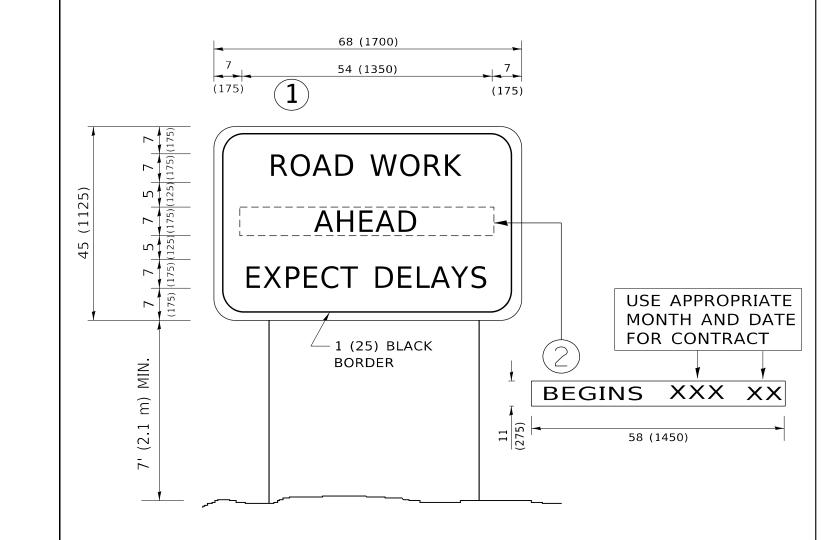

NOTES:

- 1. USE BLACK LETTERING ON ORANGE BACKGROUND.
- 2. ERECT SIGNS IN ADVANCE OF THE LOCATION FOR THE "ROAD CONSTRUCTION AHEAD" SIGN AT LOCATIONS AS DIRECTED BY THE ENGINEER.
- 3. ERECT SIGN 1 WITH INSTALLED PANEL 2 ONE WEEK PRIOR TO THE START OF CONSTRUCTION.
- 4. REMOVE PANEL(2)SOON AFTER THE START OF CONSTRUCTION.
- 5. SEE SPECIAL PROVISION FOR "TEMPORARY INFORMATION SIGNING" FOR ADDITIONAL INFORMATION.
- 6. ONE SIGN ASSEMBLY EQUALS 25.70 SQ. FT. (2.3 SQ. M.)

SCALE: NONE


7. SHALL BE PAID FOR AS TEMPORARY INFORMATION SIGNING.

ALL DIMENSIONS ARE IN INCHES (MILLIMETERS) UNLESS OTHERWISE SHOWN.

USER NAME = elkhatibaj	DESIGNED -	REVISED	- R. MIRS 09-15-97
	DRAWN -	REVISED	- R. MIRS 12-11-97
PLOT SCALE = 100.0000 / in.	CHECKED -	REVISED	-T. RAMMACHER 02-02-99
PLOT DATE = 12/15/2021	DATE -	REVISED	 C. JUCIUS 01-31-07

		Α	RT	ERIAL RO	AD		F.A. P RTE	
		INF	nRI	MATION	SIGN		525	
		1141	UIN	WAIJON	SIGIN			
SHEET	1	OF	1	SHEETS	STA.	TO STA.		

RTE	SEC	TION	COUNTY	NO.			
525	2020-	112-RS	KANE	50	40		
	TC-22			CONTRACT	NO. 6	2L90	
		ILLINOIS	FED. A	ID PROJECT			

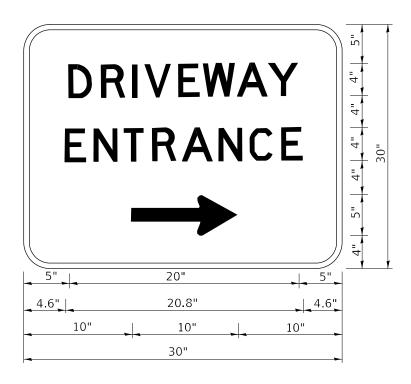

3.0" RADIUS, 0.5" BORDER, WHITE ON GREEN; REFLECTORIZED "DRIVEWAY" D; "ENTRANCE" D; STANDARD ARROW CUSTOM 12.0" x 5.0"

NOTES:

- 1. HALF OF THE SIGNS WILL REQUIRE A LEFT HAND FACING ARROW.
- 2. TWO SIGNS SHALL BE USED AT EACH COMMERCIAL ENTRANCE PLACED BACK-TO-BACK: ONE WITH A RIGHT HAND ARROW (SHOWN) SHALL BE PLACED ON THE NEAR RIGHT SIDE THE DRIVEWAY AND ONE WITH A LEFT HAND ARROW SHALL BE PLACED ON THE FAR LEFT SIDE OF THE DRIVEWAY.
- 3. SIGNS TO BE PAID FOR AS ITEM "TEMPORARY INFORMATION SIGNING".

USER NAME = elkhatibaj	DESIGNED -	REVISED	-	C. JUCIUS 02-15-07
	DRAWN -	REVISED	-	
PLOT SCALE = 100.0000 / in.	CHECKED -	REVISED	-	
PLOT DATE = 12/15/2021	DATE -	REVISED	-	


STATE OF ILLINOIS
DEPARTMENT OF TRANSPORTATION

Ī								F.A. P RTE	SECTION	COUNTY	TOTAL SHEETS	SHEET NO.	
١	DRIVEWAY ENTRANCE SIGNING							525	2020-112 - RS	KANE	50	41	
L									TC-26 CONTRA			CT NO. 62L90	
L	SCALE: NONE	SHEET 1		OF	1 SHEETS	STA.	TO STA.		ILLINOIS FED. A	ID PROJECT			


LOOP DETECTOR NOTES

- 1. EACH PAIR OF LOOP WIRES SHALL BE PLACED IN A SEPARATE EMPTY COILABLE NONMETALLIC CONDUIT FROM THE EDGE OF PAVEMENT TO THE HANDHOLE. SPACING BETWEEN THE HOLES DRILLED IN THE PAVEMENT SHALL NOT BE LESS THAN 6" (150 mm). EMPTY COILABLE NONMETALLIC CONDUIT SHALL BE INCLUDED IN THE COST OF THE LOOP WIRE.
- 2. THE NUMBER OF LOOP TURNS SHALL BE AS RECOMMENDED BY THE AMPLIFIER MANUFACTURER. ALL ADJACENT SIDES OF THE LOOPS SHALL BE INSTALLED IN SUCH A WAY THAT THE CURRENT FLOW IS IN THE SAME DIRECTION TO REINFORCE ITS MAGNETIC FIELDS FOR SMALL VEHICLE DETECTION.
- 3. EACH LOOP LEAD-IN SHALL BE IDENTIFIED AND PERMANENTLY TAGGED IN THE HANDHOLE. EACH LEAD-IN CABLE TAG SHALL INDICATE THE LOCATION OF THE LOOP, LOOP ROTATION (CLOCKWISE/COUNTERCLOCKWISE), LOOP LEAD-IN DIRECTION (IN OR OUT), LOOP CABLE NUMBER AND LOCATION IN CABINET, AND NUMBER OF TURNS IN THE DETECTOR LOOPS IN WATER PROOF INK AS INDICATED ON THE DISTRICT 1 STANDARD TRAFFIC SIGNAL DESIGN DETAIL. THE CONTRACTOR SHALL MARK LOOP LOCATIONS ON RECORD DRAWINGS AND PRESENT TO THE ENGINEER AFTER FINAL INSPECTION. LOOPS SHALL BE MARKED BY LANE AND LOOP NUMBER. SEE DETAIL BELOW.
- 4. ALL LOOP CABLE SHALL BE FASTENED WITH PLASTIC TIE WRAP TO THE HANDHOLE HOOKS.
- 5. IN ASPHALT PAVEMENT, LOOPS SHOULD BE PLACED IN THE BINDER AND DIVEHOLES MARKED AT THE CURB WITH A SAW-CUT. THE SAW-CUT SHALL BE CUT IN ACCORDANCE WITH LOCAL AND E.P.A. DUST CONTROL REQUIREMENTS. DETECTOR LOOP(S) SHALL NOT BE INSTALLED IN WET CONDITIONS AND THE SAW-CUTS MUST BE FREE OF DEBRIS AND RESIDUE SUCH AS DUST AND WATER WHICH IS TO BE ACHIEVED BY THE USE OF COMPRESSED AIR, WIRE BRUSHING AND HEAT DRYING ACCORDING TO SEALANT MANUFACTURER REQUIREMENTS. THE DETECTOR WIRE SHALL BE HELD IN PLACE BY THE USE OF FORM WEDGES. WEDGES SHALL BE SPACED NO MORE THAN 18" (450 mm) APART.
- 6. LOOP SPLICES SHALL BE SOLDERED USING A SOLDERING IRON. BLOW TORCHES OR OTHER DEVICES WHICH OXIDIZE COPPER CABLE SHALL NOT BE ALLOWED FOR SOLDERING OPERATIONS. SEE DETAIL BELOW RIGHT.
- 7. PREFORMED DETECTOR LOOPS SHALL BE USED, AS SHOWN ON THE PLANS, WHERE NEW CONCRETE PAVEMENT IS PROPOSED. THE INSTALLATION OF PREFORMED LOOPS SHALL BE IN ACCORDANCE WITH THE DISTRICT 1 SPECIFICATIONS OR AS DIRECTED BY THE ENGINEER.

LOOP LEAD-IN CABLE TAG

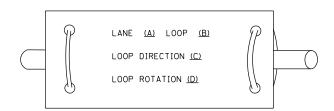



- A. LANE 1 IS THE LANE CLOSEST TO THE CENTERLINE OF THE ROADWAY
- B. LOOP #1 IS THE LOOP IN THE LANE CLOSEST TO THE INTERSECTION.
- C. LABEL LOOP CABLE "IN" OR LOOP CABLE "OUT".
- D. LABEL LOOP CABLE CLOCKWISE OR LOOP CABLE COUNTERCLOCKWISE.

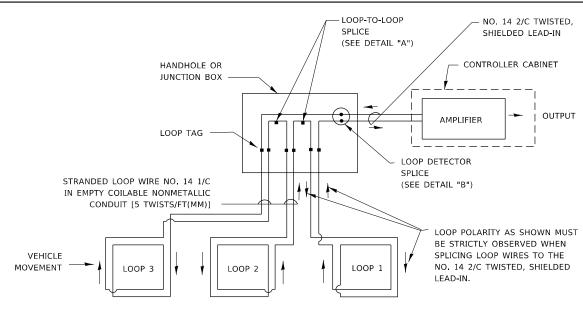

DETECTOR LOOP WIRING SCHEMATIC

- LOOPS SHALL BE SPLICED IN SERIES. SAW-CUTS SHALL BE A MINIMUM WIDTH OF 5/16" (8 mm).
- SAW-CUT DEPTHS SHALL BE 3" (75 mm). IF IN CONCRETE,
- THE SAW-CUT DEPTH SHALL BE TO THE TOP OF THE REINFORCEMENT.
- LOOP CORNERS SHALL BE DRILLED WITH A 2" (50 mm) DIAMETER CORE.

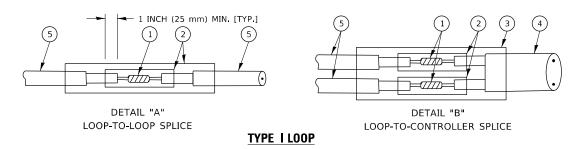

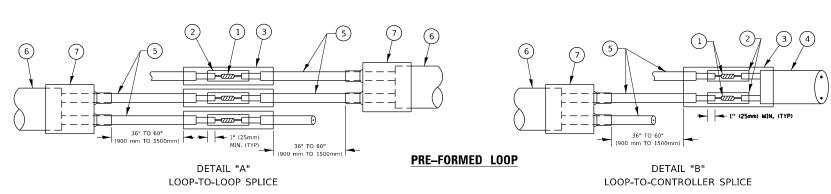

LOOP DETECTOR SPLICE

- (1) WESTERN UNION SPLICE SOLDERED WITH ROSIN CORE FLUX. ALL EXPOSED SURFACES OF THE SOLDER SHALL BE SMOOTH. THE WESTERN UNION SPLICES SHALL BE STAGGERED.
- (2) WCSMW 30/100 HEAT SHRINK TUBE, MINIMUM LENGTH 3" (75 mm), UNDERWATER GRADE.
- (3) WCS 200/750 HEAT SHRINK TUBE, MINIMUM LENGHT 6" (150 mm), UNDERWATER GRADE.
- (4) NO. 14 2/C TWISTED, SHIELDED CABLE.

- 5 LOOP CONDUCTOR WITH FLEXIBLE PLASTIC TUBE. PRE-FORMED LOOP
- (6) XL POLYOLEFIN 2 CONDUCTOR
- (7) BREAKOUT SEALS. TYCO CBR-2 OR APPROVED EQUAL

USER NAME = elkhatibaj	DESIGNED -	REVISED -
	DRAWN -	REVISED -
PLOT SCALE = 100.0000 / in.	CHECKED -	REVISED -
PLOT DATE = 12/15/2021	DATE -	REVISED -

STATE OF ILLINOIS

DISTRICT ONE STANDARD TRAFFIC SIGNAL DESIGN DETAILS SHEET 2 OF 7 SHEETS STA.

525 2020-112-RS CONTRACT NO. 62L90

LOOPS NEXT TO SHOULDERS

* * UNIT DUCT IS TO BE SHOWN ON PLAN SHEETS

BUT SHALL NOT BE INCLUDED IN THE PAY ITEMS


* = (600 mm)

LEFT TURN LANES WITH MEDIANS

VOLUME DENSITY ("FAR OUT" DETECTION) ON SAME APPROACH

(PROTECTED / PERMITTED LEFT TURN PHASING)

HANDHOLE LOCATION MAY VARY DEPENDING ON GEOMETRICS AND DESIGN OF TRAFFIC SIGNALS. HEAVY-DUTY HANDHOLES TO BE USED WHEN THE MEDIAN IS MOUNTABLE. REFER TO STANDARD 814001 TO ENSURE THAT HANDHOLE FITS IN MEDIAN.

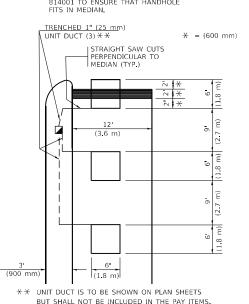


NOTE: DUAL LEFT TURNS NOT SHOWN REFER TO

PLAN SHEET FOR DETECTOR LOOP REPLACEMENT

LEFT TURN LANES WITHOUT MEDIANS

VOLUME DENSITY ("FAR OUT" DETECTION)
ON SAME APPROACH


(PROTECTED / PERMITTED LEFT TURN PHASING)

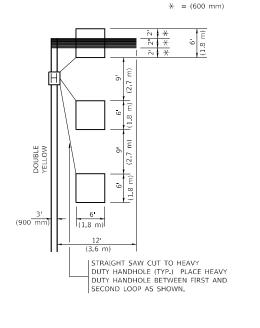

NOTE: DUAL LEFT TURNS NOT SHOWN REFER TO PLAN SHEET FOR DETECTOR LOOP REPLACEMENT


SCALE: NONE

ARTERIAL-VOLUME DENSITY ("FAR OUT" DETECTION) CROSS STREET-NON VOLUME DENSITY ("FAR OUT" DETECTION)

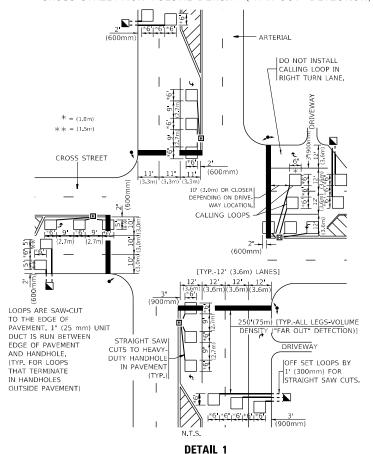

N.T.S.

ARTERIAL-VOLUME DENSITY ("FAR OUT" DETECTION)
CROSS STREET-NON VOLUME DENSITY ("UPTIGHT" PRESENCE DETECTION)

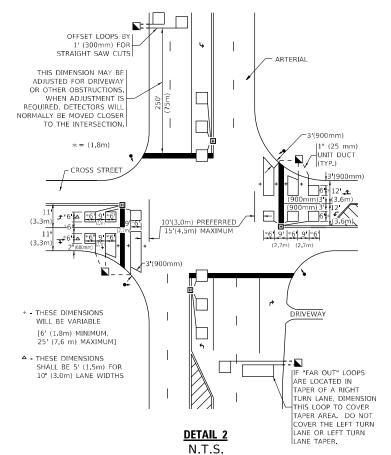

NOTES

VEHICLES LOOP DETECTORS

- * ALL LEAD IN CABLE SHALL BE TWO CONDUCTOR NO. 14 TWISTED, SHIELDED
- * EACH DETECTOR LOOP SHALL HAVE ITS OWN SAW CUT FROM THE LOOP TO THE EDGE OF PAVEMENT OR TO A HANDHOLE IN THE PAVEMENT.
- * EACH DETECTOR LOOP SHALL HAVE ITS OWN ONE INCH (25 mm) UNIT DUCT BETWEEN THE EDGE OF PAVEMENT AND THE FIRST HANDHOLE OR JUNCTION BOX. EACH UNIT DUCT RUN SHALL BE SHOWN ON THE PLANS BY THE DESIGNER, BUT SHALL NOT BE PAID FOR SEPARATLY. THIS ITEM IS INCIDENTAL TO THE PAY ITEM FOR DETECTOR LOOPS.
- * ONE DIMENSION OF \underline{ALL} DETECTOR LOOPS SHALL BE SIX FEET (1.8 m)
- * EACH LANE OF NON-LOCKING, PRESENCE DETECTION AND EACH LANE OF A DOUBLE LEFT TURN LANE REQUIRES A SEPARATE INDUCTIVE LOOP DETECTOR AND LEAD IN CABLE.
- * WHEN NON-LOCKING, PRESENCE DETECTION IS USED, MORE THAN ONE LOOP PER LANE IS REQUIRED BEHIND THE STOP BAR (i.e. 1-1/2, 1-3/4, 2).
- * WHEN SYSTEM LOOPS ARE REQUIRED ON AN APPROACH OF AN INTERSECTION, THE LOOPS USED FOR VOLUME DENSITY AND INTERSECTION TIMING SHALL ALSO BE USED AS SYSTEM DETECTORS. EACH ONE OF THESE TYPE OF LOOPS REQUIRES A SEPARATE TWO CONDUCTOR NO. 14 TWISTED SHIELDED CABLE AND A SEPARATE INDUCTIVE LOOP DETECTOR WHEN NEW CONTROLLERS ARE UTILIZED. THE DESIGNER SHALL LABEL THESE TYPES OF LOOPS AS "INTERSECTION AND SAMPLING (SYSTEM) DETECTORS" ON THE SIGNAL LAYOUT, THE INTERCONNECT PLAN AND THE SYSTEM CABLE PLAN. WHEN AN EXISTING CONTROLLER IS UTILIZED FOR THIS TYPE OF DETECTION, THE PAY ITEM "INDUCTIVE LOOP DETECTOR WITH SYSTEM OUTPUT" SHOULD BE USED.

PLACEMENT OF DETECTORS

THE FOLLOWING FIGURES REPRESENT THE MOST COMMON DETECTOR LOOP LOCATIONS AND SIZES. ADJUSTMENTS WILL BE NECESSARY FOR SPECIFIC GEOMETRIC CONSIDERATIONS.

LOCATIONS AND DEMENSIONS OF DETECTOR LOOPS ARE REQUIRED ON ALL SIGNAL LAYOUT PLAN SHEETS.

"FAR OUT" DETECTION REFERS TO LOCKING, PRESENCE TYPE DETECTION LOCATED IN THRU LANES, RIGHT TURN LANES, AND RIGHT TURN LANE TAPER AREAS (IF APPLICABLE), USUALLY 250' (75 m) IN ADVANCE OF STOP BARS. "UPTIGHT" DETECTION REFERS TO NON-LOCKING PRESENCE TYPE DETECTION LOCATED IN ALL LANES AND 10'-15' (3.0 m-4.5 m) BEHIND THE CROSSING STREET'S EDGE OF PAVEMENT EXTENDED.


NOTE:

ALL DETAILS AND NOTES SHOWN ARE FROM THE I.D.O.T. DISTRICT 1 TRAFFIC SIGNAL DESIGN GUIDELINES DATED JANUARY 1995

THIS DRAWING HAS BEEN PREPARED TO ASSIST THE RESIDENT ENGINEER FOR ALL ROADWAY RESURFACING OR S.M.A.R.T. PROJECTS WHERE THE DIMENSIONS ARE NOT SHOWN ON THE PLANS AND THE FINAL LOCATIONS FOR CROSSWALKS OR STOP BARS ARE NOT DETERMINED.

| DESIGNED - | REVISED - | | DRAWN - | REVISED - | DRAWN - | DRAWN - | REVISED - | DRAWN - | REVISED - | DRAWN - | DRAWN - | REVISED - | REVISED - | DRAWN - | REVISED - | REVIS

STATE OF ILLINOIS DEPARTMENT OF TRANSPORTATION

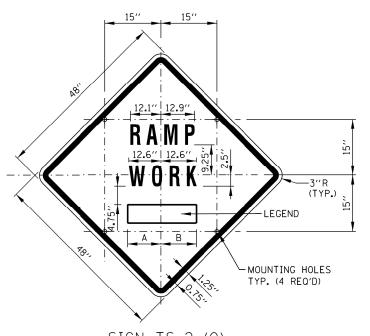

SIGN NO. LEGEND TS-2A AHFAD 15,501 15.50" 500 FT 14.25" 15.13′′ 1000 FT 15**.**75" *L*2 TS-2C 15.75" L2 TS-2D 1500 FT 14.88" L2 15.75" L3 1/2 MILE 15.75" L3 TS-2E TS-2F 1 MILE 13.06" 13.06"

41/2" B 5¾′′ C 121/2' D 73/4" 61/2' 41/2" 61/2′ 6′′ I 12¾′ J 12'' K 45° 55° M 3/4" N1 2" N2 61/2" MOUNTING HOLES TYP. (4 REQ'D)

COLOR: BACKGROUND - FLUCRESCENT ORANGE (O) BORDER AND LETTTERS - BLACK

24"

SUPPLEMENTAL PLATE (O)

SIZE: 24"×18" LETTERING: 4" FEDERAL SERIES D

6.75"

MOUNTING HOLES: 1/16" DIA., 2 HOLES SPACED AS SHOWN

SIGN TS-2 (0)

COLOR: BACKGROUND - FLUORESCENT ORANGE (0)

SIZE: 48"×48"

LETTERING: 7" FEDERAL SERIES D

MOUNTING HOLES: $\frac{1}{6}$ " DIA., 4 HOLES SPACED AS SHOWN

BORDER AND SYMBOL - BLACK


COLOR: BACKGROUND-FLUORESCENT ORANGE (0) TYPE A REFLECTIVE

SIGN W1-4dR (0)

SHEETING PER STANDARD SPECIFICATIONS (*A) BORDER AND LETTERS-BLACK

SIZE: 48"×48"

MOUNTING HOLES: 7/6" DIA., 4 HOLES SPACED AS SHOWN.

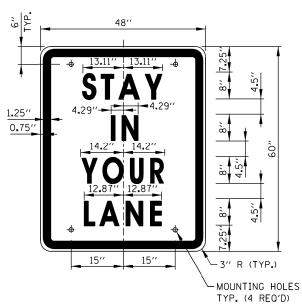

SIGN TS-3

COLOR: BACKGROUND - WHITE (REFLECTORIZED) (*A) BORDER AND LETTERS - BLACK

LETTERING: LEGEND - 8" FEDERAL SERIES D MOUNTING HOLES: 1/6" DIA., 4 HOLES, SPACED AS SHOWN

20.5" 1.25" 0.75 4.5 4.5 4.5 -3" R (TYP.) -MOUNTING HOLES TYP. (4 REQ'D)

SIGN TS-4

BACKGROUND - WHITE (REFLECTORIZED)(* A)

BORDER AND LETTERS - BLACK


SIZE: 48"x60"

LETTERING: LEGEND - 6" FEDERAL SERIES C

MOUNTING HOLES: 1/6" DIA., 4 HOLES, SPACED AS SHOWN

RAMP CLOSURE ADVANCE INFORMATION SIGN

THE VARIABLE MESSAGE WITH DATES FOR THE BOTTOM TWO LINES SHALL BE DETERMINED BY THE ENGINEER AND GIVEN TO THE CONTRACTOR BEFORE THE REQUIRED FIELD ERECTION DATE.

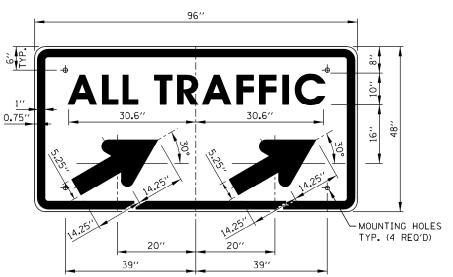

SIGN TS-5a & TS-5b

COLOR: BACKGROUND - WHITE (REFLECTORIZED)(* A) BORDER AND LETTERS - BLACK

ARROW - BLACK

SIZE: 96"x48" LETTERING: 10" FEDERAL SERIES D

INFORMATION ONLY

MOUNTING HOLES: 1/6" DIA., 4 HOLES, SPACED AS SHOWN

NOTE: SIGN TS-5a IS SHOWN, SUBSTITUTE

LEGEND "#" FOR "##" FOR SIGN TS-5b


NOTES:

- ALL LETTERING IS DESIGNATED BY SIZE AND SERIES IN ACCORDANCE WITH THE LATEST EDITION OF "STANDARD ALPHABETS FOR HIGHWAY SIGNS AND PAVEMENT MARKINGS" AS PUBLISHED BY THE U.S. DEPARTMENT OF TRANSPORTATION. LETTERING SPACING SHALL BE IN ACCORDANCE WITH THIS GUIDE EXCEPT WHERE NOTED.
- 2. SYMBOLS AND ARROWS SHALL CONFORM TO THE DETAILS SHOWN IN THE LATEST EDITION OF "STANDARD HIGHWAY SIGNS" AS PUBLISHED BY THE U.S. DEPARTMENT OF TRANSPORTATION.
- SEE THE CONTRACT REQUIREMENTS FOR ADDITIONAL NOTES AND SPECIFICATIONS. FLUORESCENT ORANGE REFLECTIVE SHEETING PER THE STANDARD SPECIFICATIONS.
 - (* A) REFLECTIVE SHEETING PER THE STANDARD SPECIFICATIONS.
- 4. DIMENSIONS INDICATED THUS L ARE BASED ON A REDUCTION IN STANDARD LETTERING SPACING AS SHOWN BELOW:
 - L1 SPACING REDUCED BY 25%
 - L2 SPACING REDUCED BY 40%
 - L3 SPACING REDUCED BY 50%

SHEET 1 OF 2

Illinois *Tollway* DATE REVISIONS SED FINE SIGN NUMBER AND CONSTRUCTION SIGNS D LED SPEED LIMIT DISPLAY
SED NOTES EVISED END WZSL SIGN COLOF EMOVED STANDARD IDOT SIGN: STANDARD E1-07



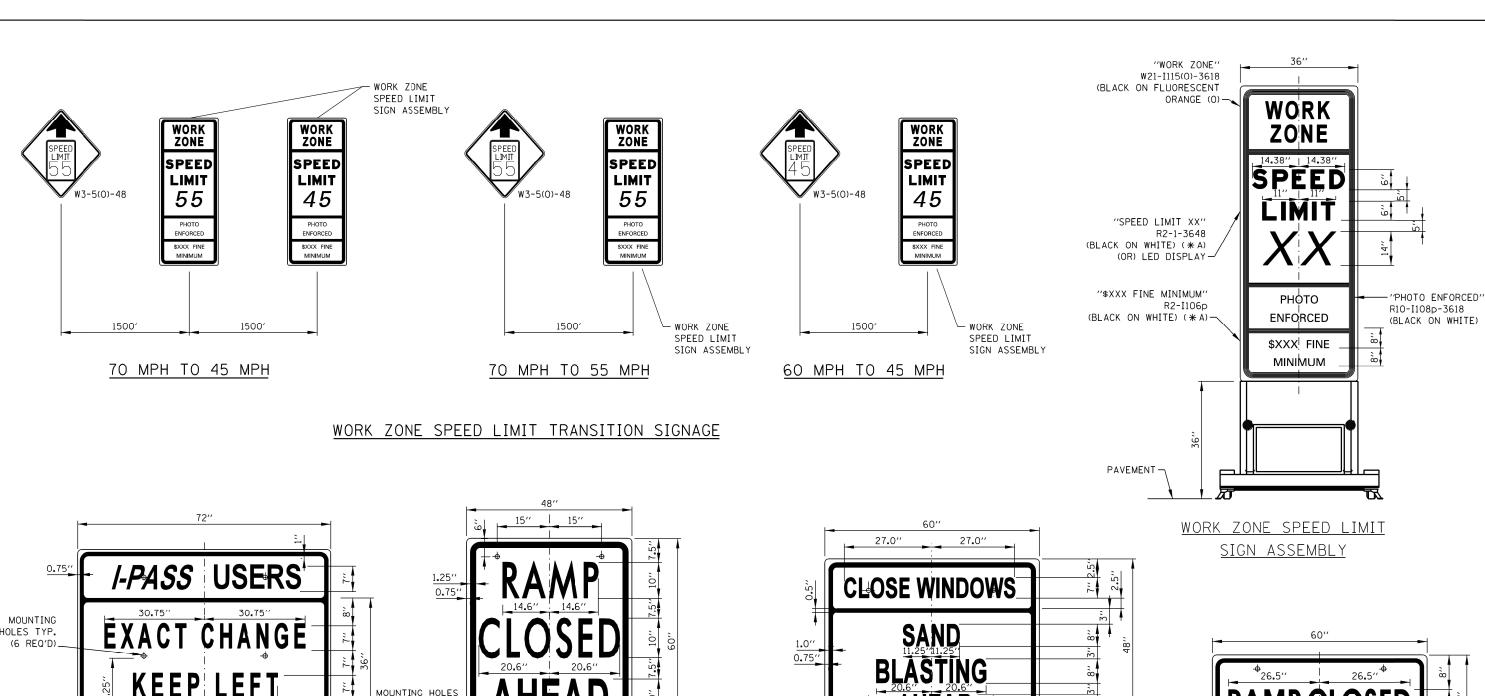

SIGN TS-7

COLOR: BACKGROUND - WHITE (REFLECTORIZED) (* A) BORDER AND LETTTERS - BLACK

21.2"

SIZE: 72"x36"

LETTERING: 7" FEDERAL SERIES C MOUNTING HOLES: $\frac{1}{16}$ " DIA., 4 HOLES SPACED AS SHOWN SIGN TS-9

COLOR: BACKGROUND - WHITE (REFLECTORIZED) (* A) BORDER AND LETTIERS - BLACK SIZE: 48"x60"

TYP. (4 REQ'D).

LETTERING: 10" FEDERAL SERIES C MOUNTING HOLES: $\frac{1}{16}$ " DIA., 4 HOLES SPACED AS SHOWN SIGN TS-10 (0)

AHEAD

14.0" 14.0"

COLOR: BACKGROUND - FLUORESCENT ORANGE (0) BORDER AND LETTTERS - BLACK


28.0"

SIZE: 60"x48"

MOUNTING HOLES

TYP. (4 REQ'D).

LETTERING: 8" FEDERAL SERIES C, 7" FEDERAL SERIES B MOUNTING HOLES: 1/16" DIA., 4 HOLES SPACED AS SHOWN

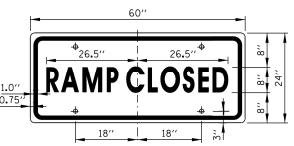

SIGN TS-6

COLOR: BACKGROUND - WHITE (REFLECTORIZED) (* A)

BORDER AND LETTTERS - BLACK

SIZE: 60"x24" LETTERING: 8" FEDERAL SERIES C

MOUNTING HOLES: 1/6" DIA., 4 HOLES SPACED AS SHOWN

SHEET 2 OF 2




SEE SHEET 1 OF THIS SERIES FOR NOTES.



STANDARD E1-07

Paul Koracs CHIEF ENGINEERING OFFICER 5-1-2009

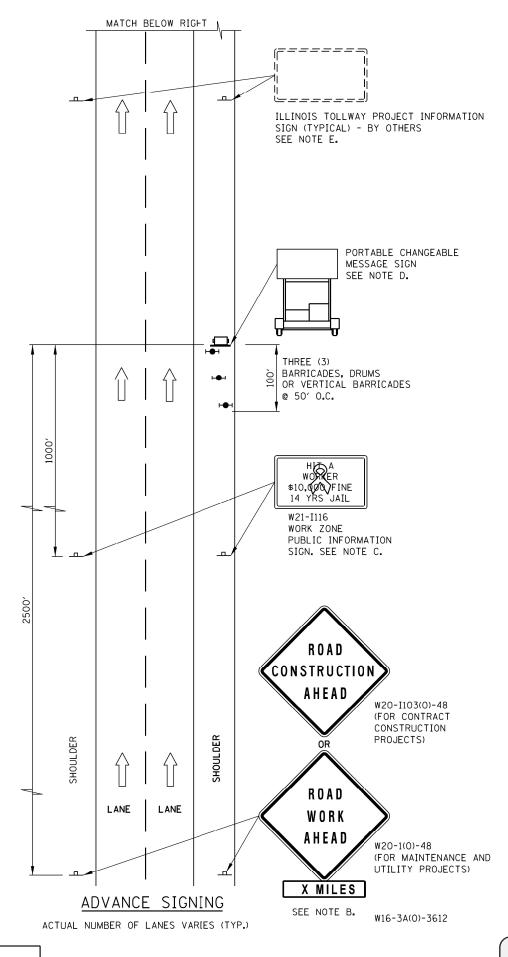

Paul Koracs

CHIEF ENGINEERING OFFICER 5-1-2009

ADVANCE SIGNING NOTES:

- THE ADVANCE SIGNING SHOWN ON THIS STANDARD SHALL APPLY ANY TIME THE CONTRACTOR CLOSES ONE OR WORE LANES, OR IS REQUIRED TO SHIFT THE LANE ALIGNMENT. THE "ROAD WORK AHEAD" OR "ROAD CONSTRUCTION AHEAD" SIGNS, WORK ZONE PUBLIC INFORMATION SIGNS AND PORTABLE CHANGEABLE MESSAGE ARE STATIONARY.
- B. THE ROAD CONSTRUCTION AHEAD SIGN (W20-1A, WITH W16-3a SUPPLEMENTAL PLATE) OR ROAD WORK AHEAD SIGN (W20-1, WITH W16-3a SUPPLEMENTAL PLATE) SHALL BE LOCATED UP TO 5 MILES IN ADVANCE OF THE PROJECT LIMITS, WITH THE LOCATION BEING DETERMINED BY THE ENGINEER.
- THE WORK ZONE PUBLIC INFORMATION SIGN IS 60" WIDE BY 48" HIGH. THE CONTRACTOR SHALL OBTAIN THE CAMERA-READY ARTWORK REQUIRED FOR THE SIGN MESSAGE BY CONTACTING IDOT'S CENTRAL BUREAU
- THE PORTABLE CHANGEABLE MESSAGE SIGN SHALL BE USED TO DISPLAY THE STATUS OF LANE WITHIN THE CONTRACT LIMITS. THE PRIMARY MESSAGES SHALL BE: "RIGHT LANE(S) CLOSED" / "X MILES AHEAD", "LEFT LANE(S) CLOSED" / "X MILES AHEAD", "LANE(S) SHIFT" / "X MILES AHEAD", "ALL LANES OPEN". THE PORTABLE CHANGEABLE MESSAGE SIGN MAY BE MOVED TO THE MEDIAN SHOULDER WHEN THE LANE CLOSURES ARE ON THE LEFT. PROVIDED THE EXISTING SHOULDER WIDTH IS ADEQUATE.
- E. THE ILLINOIS TOLLWAY WILL FURNISH AND INSTALL STATIC PROJECT INFORMATION SIGNS IN ADVANCE, THROUGH AND AT THE END OF THE WORK ZONE. THESE SIGNS WILL BE INSTALLED ALONG THE OUTSIDE SHOULDER WITH THE ADVANCE SIGNS LOCATED BEYOND THE PORTABLE CHANGEABLE MESSAGE SIGN. THE ENGINEER AND CONTRACTOR SHALL COORDINATE WITH THE ILLINOIS TOLLWAY REGARDING THE LOCATION OF THESE SIGNS AND NOTIFY THE ILLINOIS TOLLWAY OF ANY DAMAGE TO THE SIGNS OR SUPPORTS.

LEGEND



ARROW BOARD



WORK AREA



- DIRECTION INDICATOR BARRICADE WITH SEQUENTIAL FLASHING WARNING LIGHT
- TYPE II BARRICADE, DRUM, OR VERTICAL BARRICADE WITH STEADY BURN MONODIRECTIONAL LIGHT
- FLAGGER WITH TRAFFIC CONTROL SIGN



X LANE CLOSED

LAL CHECK BARRICADE

TRUCK MOUNTED ATTENUATOR

3-31-201

REVISIONS

DED TAPER RATE TABLE

ED LANE CLOSURE WITH BARRIER AND ADDED

EQUENTIAL FLASHING WARNING LIGHT.

RE-ARRANGED DETAILS, REVISED NOTE 17, ADDED NOTES 18 & 19, ADDED TMA

SHEET 1 OF 3



LANE CLOSURE DETAILS

STANDARD E2-08

INFORMATION ONLY

