## STATE OF ILLINOIS

## **DEPARTMENT OF TRANSPORTATION**

**DIVISION OF HIGHWAYS** 

FOR INDEX OF SHEETS, SEE SHEET NO. 2

# **PROPOSED** HIGHWAY PLANS

**FAP ROUTE 330: US 45 (LAGRANGE ROAD)** 

**SECTION: 2010-135-I** 

PROJECT: NHF-0330(065)

McGINNIS SLOUGH

END IMPROVEMENT STA. 4227+77.95

RAILROAD TRACK REALIGNMENT

**COOK COUNTY** 


C-91-227-11

DESIGN DESIGNATION:

US 45 (LAGRANGE ROAD): 3800 (20) OTHER PRINCIPAL ARTERIAL AND STRATEGIC REGIONAL ARTERIAL (SRA) -CLASS II TRUCK ROUTE 11.55 (JPCP-20)

DESIGN SPEED:

US 45 (LAGRANGE ROAD) = 45 MPH

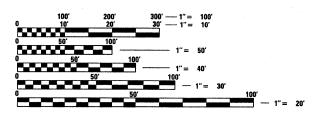

ENGINEERING SCALES. REDUCED SIZED PLANS WILL NOT CONFORM TO STANDARD SCALES. IN MAKING MEASUREMENTS ON REDUCED PLANS, THE ABOVE SCALES MAY BE USED.

JOINT UTILITY LOCATION INFORMATION FOR EXCAVATION 1-800-892-0123

OR 811

PROJECT ENGINEER: MICHELLE AQUINO PROJECT MANAGER: RAJENDRA SHAH

CONTRACT NO. 60N09



EXP. 11/30/2011 DATE:



GROSS LENGTH = 5,854.49 FT. = 1.109 MILE NET LENGTH = 5,854.49 FT. = 1.109 MILE



BEGIN IMPROVEMENT STA. 4169+23.46

W. 143rd ST.

- W. 144th PL.


W. 147th ST.

NAME: JEFFERY R. SPIEKERMANN EXP. 11/30/2011 DATE: 12-20-10 SHT NO.

#### 2010-135-1 COOK CONTRACT NO. 60NO9

#### D-91-569-08



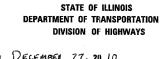

SUBMITTED DECEMBER ZZ, 20 10

Scott E Stitt P.E. | 81

Christeine M. Road Ja

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70	TC-21	TYPICAL MARKING FOR CLOSING STATE HIGHWAYS
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# HIGHWAY STANDARDS

STANDARD NO.	TITLE
000001-06	STANDARD SYMBOLS, ABBREVIATIONS, AND PATTERNS
001001-02	AREAS OF REINFORCEMENT BARS
202001-01	EARTH MEDIAN DITCH CHECK
280001-05	TEMPORARY EROSION CONTROL SYSTEMS
353001-04	PCC BASE COURSE WITH HMA BINDER AND SURFACE COURSES
420001-07	PAVEMENT JOINTS
420501-04	PCC PAVEMENT AND PCC BASE COURSE ADJACENT TO RAILROAD GRADE CROSSING
602001-02	CATCH BASIN, TYPE A
602301-03	INLET, TYPE A
602401-03	MANHOLE, TYPE A
602701-02	MANHOLE STEPS
604001-03	FRAME AND LIDS, TYPE 1
604036-02	GRATE, TYPE 8
604086-02	FRAME AND GRATE, TYPE 23
604091-02	FRAME AND GRATE, TYPE 24
602601-02	PRECAST REINFORCED CONCRETE FLAT SLAB TOP
606001-04	CONCRETE CURB TYPE B AND COMBINATION CONCRETE CURB AND GUTTER
606301-04	PC CONCRETE ISLANDS AND MEDIANS
664001-02	CHAIN LINK FENCE
701901-01	TRAFFIC CONTROL DEVICES
780001-02	TYPICAL PAVEMENT MARKINGS
781001-03	TYPICAL APPLICATIONS RAISED REFLECTIVE PAVEMENT MARKERS

USER NAME = TKluegel	DESIGNED	-	BA	REVISED -
	DRAWN	-	ВА	REVISED -
PLOT SCALE = 1:1	CHECKED	-	MJT	REVISED -
PLOT DATE = 12/29/2010	DATE	-	12/17/10	REVISED -

	INDEX OF SHEETS AND HIGHWAY STANDARDS	F.A.P RTE.	SECTION	COUNTY	TOTAL SHEETS	SHEET NO.
ı	MADEN OF SHEETS MAD HIGHANAL STANDANDS	330	2010-135-I	СООК	101	2
	SCALE: N.T.S. SHEET NO. 1 OF 1 SHEETS STA. TO STA.	<del> </del>	IS-01		NO. 6	ON09

#### **GENERAL NOTES:**

- THE THICKNESS OF HMA SHOWN ON THE PLANS IS THE NOMINAL THICKNESS. DEVIATIONS FROM THE NOMINAL THICKNESS WILL BE PERMITTED WHEN SUCH DEVIATIONS OCCUR DUE TO IRREGULARITIES IN THE EXISTING SURFACE OR BASE ON WHICH THE HMA IS PLACED.
- 2. TEN (10) FOOT TRANSITIONS SHALL BE USED TO MATCH PROPOSED CURB AND GUTTER AND MEDIAN ITEMS OF WORK TO EXISTING CURBS AND GUTTER AND MEDIANS IN THE FIELD, UNLESS OTHERWISE SHOWN. THE TRANSITIONS SHALL BE PAID FOR AT THE CONTRACT UNIT PRICE FOR THE PROPOSED ITEMS OF WORK SPECIFIED.
- 3. BEFORE BEGINNING ANY WORK, THE CONTRACTOR SHALL RETAIN AND RECORD FOR FUTURE REFERENCE, ALL EXISTING PAVEMENT MARKING LINES (AND RAISED REFLECTIVE PAVEMENT MARKERS) IN ORDER THAT THESE LOCATIONS CAN BE RE-ESTABLISHED FOR STRIPING. EXACT LOCATIONS OF ALL PAVEMENT MARKINGS SHALL BE AS DIRECTED BY THE ENGINEER.
- EXCEPT AS NOTED ON THE PLANS, PAVEMENT GRADES SHOWN ARE AT THE TOP OF PAVEMENT SURFACES.
- 5. THE CONTRACTOR WILL NOT BE ALLOWED TO SET UP A YARD OR FIELD OFFICE ON STATE PROPERTY WITHOUT WRITTEN PERMISSION FROM THE DEPARTMENT.
- 6. THE ENGINEER WILL BE THE SOLE JUDGE CONCERNING CURING TIME FOR THE VARIOUS HMA LIFTS.
- SEEDING SHALL NOT BE PERMITTED AT ANY TIME WHEN THE GROUND IS FROZEN, WET, OR IN AN UNTILLABLE CONDITION. LOCATIONS TO BE SEEDED WILL BE DETERMINED BY THE ENGINEER.
- 8. ONLY THOSE TREES DESIGNATED BY THE ENGINEER, LISTED IN THE TREE REMOVAL SCHEDULE, OR SHOWN IN THE PLANS SHALL BE REMOVED. THE CONTRACTOR SHALL PROTECT ALL REMAINING TREES FROM DAMAGE DUE TO HIS OPERATIONS.
- 9. THE LOCATION OF EXISTING DRAINAGE STRUCTURES, STORM SEWERS, WATER MAINS, SANITARY SEWERS, AND ANY OTHER PUBLIC OR PRIVATE UTILITIES AS SHOWN ON THE PLANS IS APPROXIMATE, AND THEIR EXACT LOCATION IS TO BE DETERMINED IN THE FIELD BY THE CONTRACTOR. THIS WORK SHALL BE PAID FOR PER ART. 105.07 OF THE STANDARD SPECIFICATIONS. LOCATING UTILITIES SHALL BE PAID PER ART. 109.04.
- 10. WHEN ARTIFICIAL LIGHTING IS UTILIZED IN NIGHT OPERATIONS, THE CONTRACTOR SHALL EXERCISE THE UTMOST PRECAUTIONS IN PREVENTING ADVERSE VISIBILITY TO THE MOTORING PUBLIC AND ADJOINING RESIDENTIAL AREAS.
- 11. THE WORK REQUIRED TO CONNECT ANY SEWER TO AN EXISTING DRAINAGE STRUCTURE OR PIPE WILL NOT BE PAID FOR SEPARATELY, BUT SHALL BE CONSIDERED AS INCLUDED IN THE CONTRACT UNIT PRICE BID FOR THE SEWER ITEMS.
- 12. IT SHALL BE THE CONTRACTOR \$\frac{1}{32}\$ S RESPONSIBILITY TO VERIFY ALL DIMENSIONS AND CONDITIONS EXISTING IN THE FIELD PRIOR TO CONSTRUCTION AND ORDERING OF MATERIALS.
- 13. THE CONTRACTOR SHALL PROTECT AND CAREFULLY PRESERVE ALL SECTION OR SUBSECTION MONUMENTS, PROPERTY CORNERS, AND REFERENCE MARKERS UNTIL THE OWNER, HIS AGENT, OR ANY AUTHORIZED SURVEYOR HAS WITNESSED OR OTHERWISE REFERENCED THEIR LOCATIONS.
- 14. ABANDONED UNDERGROUND UTILITIES THAT CONFLICT WITH
  CONSTRUCTION SHALL BE DISPOSED OF OUTSIDE THE LIMITS OF THE
  RIGHT OF WAY ACCORDING TO ARTICLE 202.03 OF THE STANDARD
  SPECIFICATIONS AND AS DIRECTED BY THE ENGINEER. THIS WORK WILL
  NOT BE PAID FOR SEPARATELY, BUT SHALL BE INCLUDED IN THE COST OF
- 15. USE \*8 EPOXY-COATED TIE BARS, CONFORMING TO ART. 1006.10 OF THE STANDARD SPECIFICATIONS, FOR ALL TIE BARS. USE THE LONGITUDINAL CONSTRUCTION JOINT (TIE BAR GROUTED IN PLACE) DETAIL SHOWN ON HIGHWAY STANDARD 420001 FOR ALL LONGITUDINAL JOINTS AND FOR TYING PCC PAVEMENT WIDENING TO EXISTING CONCRETE PAVEMENT AS SHOWN ON THE PLANS.
- 16. THE CONTRACTOR SHALL CONTACT THE DISTRICT ONE TRAFFIC CONTROL SUPERVISOR AT (847)705-4470 A MINIMUM OF 72 HOURS IN ADVANCE OF
- 17. DO NOT SCALE PLANS FOR CONSTRUCTION DIMENSIONS.

- 18. ANY REFERENCE TO A STANDARD IN THESE PLANS SHALL BE INTERPRETED TO MEAN THE EDITION AS INDICATED BY THE SUBNUMBER SHOWN IN THE LIST OF STANDARDS OR THE COPY INCLUDED IN THESE PLANS.
- 19. THE FOLLOWING RATES OF APPLICATION HAVE BEEN USED IN CALCULATING PLAN QUANTITIES:

GRANULAR MATERIALS TONS/CU YD 2.05 BITUMINOUS MAT PRIME COAT 0.05 GAL/SQ YD - BETWEEN LIFTS GAL/SQ YD - AGGREGATE GAL/SQ YD - ABOVE PCC BASE AGGREGATE (PRIME COAT) 0.002 TONS/SQ YD HMA RESURFACING 112 LBS/SQ YD/IN LEVEL BINDER (HAND METHOD) 112 LBS/SQ YD/IN GAL/SQ YD/APPLICATION SUPPLEMENTAL WATERING

- 20. ALL DAMAGE TO DEPARTMENT OWNED UNDERGROUND FACILITIES, CAUSED BY THE CONTRACTOR SHALL BE REPAIRED TO THE SATISFACTION OF THE DEPARTMENT AT THE CONTRACTOR'S EXPENSE. THIS SHALL INCLUDE ALL TEMPORARY REPAIRS REQUIRED TO KEEP THE FACILITY OPERATIONAL WHILE MATERIAL IS BEING OBTAINED TO MAKE PERMANENT REPAIRS. SPLICING OF ELECTRIC CABLE SHALL NOT BE ALLOWED. ELECTRIC CABLE SHALL BE REPLACED FROM POLE TO POLE OR CONTROLLER.
- 21. THE CONTRACTOR SHALL CONTACT JULIE AT LEAST 48 HOURS PRIOR TO EXCAVATION TO DETERMINE WHICH UTILITIES ARE IN THE AREA.
- 22. THE CONTRACTOR SHALL MAINTAIN EXISTING STREET ACCESS, EXISTING DRIVEWAY ACCESS, AND PEDESTRIAN ACCESS TO ABUTTING PROPERTY AT ALL TIMES DURING CONSTRUCTION OF THE PROJECT, UNLESS OTHERWISE NOTED IN THE PLANS OR DIRECTED BY THE ENGINEER.
- 23. SAWING OF REMOVAL ITEMS AS NOTED ON THE PLANS, SPECIFIED IN THE STANDARD SPECIFICATIONS, OR AS REQUIRED BY THE ENGINEER SHALL BE INCLUDED IN THE COST OF THE ITEM BEING REMOVED
- 24. IT IS THE CONTRACTOR'S RESPONSIBILITY TO ASCERTAIN EXISTING FIELD CONDITIONS BEFORE BIDDING ON THIS CONTRACT
- 25. DOUBLE LANE MARKERS ARE TO BE USED AS SHOWN ON THE DISTRICT ONE DETAIL 1/32 TYPICAL APPLICATIONS 1/32 RAISED REFLECTIVE PAVEMENT MARKERS (SNOW-PLOW RESISTANT)1/32 SHOWN IN THE PLANS.
- 26. FURNISH AND DELIVER TO METRA THE TRACK MATERIALS AS SPECIFIED IN THE SPECIAL PROVISION "CONSTRUCTION OF TRACK."
- 27. UNDERBRUSH OR DEBRIS AT PLANTING LOCATIONS SHALL BE REMOVED AND DISPOSED OF ACCORDING TO SECTION 201 OF THE STANDARD SPECIFICATIONS. THIS WORK WILL NOT BE PAID FOR SEPARATELY, BUT THE COSTS SHALL BE CONSIDERED AS INCLUDED IN THE CONTRACT UNIT PRICES FOR THE CONSTRUCTION ITEMS INVOLVED, AND NO ADDITIONAL COMPENSATION WILL BE ALLOWED.
- 28. THE CONTRACTOR SHALL TAKE ALL NECESSARY PRECAUTIONS FOR THE PROTECTION OF EXISTING PLANT MATERIAL FOR WHICH THE CONTRACT DOES NOT PROVIDE REMOVAL. THE PROTECTION OF EXISTING PLANT MATERIAL AND THE REPAIR OR REPLACEMENT OF EXISTING PLANT MATERIAL DAMAGED BY THE CONTRACTOR SHALL BE DONE IN ACCORDANCE WITH THE REQUIREMENTS OF SECTION 201 OF THE STANDARD SPECIFICATIONS.

McDonough Associates Inc.
Engineers / Architects
130 East Randolph Street Chicago, Illinois 60601

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STATE OF ILLINOIS
DEPARTMENT OF TRANSPORTATION

SCALE:

										F.A.P RTE.	SECTION	COUNTY	TOTAL	
	GENERAL NOTES						330	2010-135-I	СООК	101	3			
											GN-01	CONTRACT	NO.	60N09
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				ROADWAY US 45/143RD	TRACK RELOCATION	LANDSCAPING	PLATFORM	VILLAGE OF ORLAND PAR
CODE NO.	ITEM	UNIT	TOTAL QUANTITY	80% FED 20% STATE 0003	80% FED 20% STATE 0021	80% FED 20% STATE 4003	80% FED 20% STATE 0003	100% VOP
20100210	TREE REMOVAL (OVER 15 UNITS DIAMETER)	UNIT	62	62	3321			
20100500	TREE REMOVAL, ACRES	ACRE	0.9	0.9				
20200100	EARTH EXCAVATION	CU YD	12, 491		12, 491			
20201200	REMOVAL AND DISPOSAL OF UNSUITABLE MATERIAL	CU YD	3, 527		3, 527			
20400800	FURNISHED EXCAVATION	CU YD	10, 938		10, 938			
20800150	TRENCH BACKFILL	CU YD	173				151	
21001000	GEOTECHNICAL FABRIC FOR GROUND STABILIZATION	SQ YD	12, 990	12, 840				1
21101615	TOPSOIL FURNISH AND PLACE, 4"	SO YD	14,970			14, 970		
25000210	SEEDING, CLASS 2A	ACRE	0.2			0. 2		
25000312	SEEDING, CLASS 4A	ACRE	1.9			1.9		
25000400	NITROGEN FERTILIZER NUTRIENT	POUND	80			80		
25000500	PHOSPHORUS FERTILIZER NUTRIENT	POUND	80			80		
25000600	POTASSIUM FERTILIZER NUTRIENT	POUND	80			80		
25100115	MULCH, METHOD 2	ACRE	3.0			3.0		
25100630	EROSION CONTROL BLANKET	SO YD	6, 910	6, 910				
25200110	SODDING, SALT TOLERANT	SO YD	5, 290	5, 290				
25200200	SUPPLEMENTAL WATERING	UNIT	224	224				
28000250	TEMPORARY EROSION CONTROL SEEDING	POUND	235	235				
28000305	TEMPORARY DITCH CHECKS	FOOT	1,170	1, 170		÷		
28000400	PERIMETER EROSION BARRIER	FOOT	4, 215	4, 215				
28000500	INLET AND PIPE PROTECTION	EACH	7	3				
28000510	INLET FILTERS	EACH	16	16				
35101800	AGGREGATE BASE COURSE, TYPE B 6"	SO YD	190	190				
35102100	AGGREGATE BASE COURSE, TYPE B 9"	SQ YD	150					1
35301200	HIGH-EARLY-STRENGTH PORTLAND CEMENT CONCRETE BASE COURSE 9"	SO YD	635	635				
40600100	BITUMINOUS MATERIALS (PRIME COAT)	GALLON	79	64				
40600300	AGGREGATE (PRIME COAT)	TON	1.4	0.4		, , ,		
40603080	HOT-MIX ASPHALT BINDER COURSE, IL-19.0, N50	TON	187.1	80. 1			88	
40603335	HOT-MIX ASPHALT SURFACE COURSE, MIX "D", N50	TON	175.7	74.7		, .	88	
42001300	PROTECTIVE COAT	SQ YD	355	355				
42400200	PORTLAND CEMENT CONCRETE SIDEWALK 5 INCH	SO FT	8, 143	721			3, 917	3, 9
44000100	PAVEMENT REMOVAL	SQ YD	1,442	1, 185			257	***************************************

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STATE	OF	ILLINOIS
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SCALE:	N.T.S.	SHEET	NO.	1	OF	5	SHEETS	STA.	TO STA.

F.A.P RTE.	SECTION	COUNTY	TOTAL SHEETS	SHEET NO.	
330	2010-135-I	COOK	101	4	
	SQ-01	CONTRACT	NO. 6	ON09	
 	ILLINOIS	FED. AI	D PROJECT		

						CONSTRUCT	TION CODE		
				ROADWAY US 45/143RD	TRACK RELOCATION	LANDSCAPING	. <del></del>	PLATFORM	VILLAGE OF ORLAND PARK
CODE NO.	ITEM	UNIT	TOTAL QUANTITY	80% FED 20% STATE	80% FED 20% STATE	80% FED 20% STATE		80% FED 20% STATE	100% VOF
14000300	CURB REMOVAL	FOOT	180	0003	0021	<b>0</b> 003		0003	0043
14000500	COMBINATION CURB AND GUTTER REMOVAL	FOOT	153	153					
14000600	SIDEWALK REMOVAL	SQ FT	9, 457	104			,	8, 893	46
14003100	MEDIAN REMOVAL	SO FT	1, 215	1,215					
14201741	CLASS D PATCHES, TYPE II, 8 INCH	SQ YD	49						4
0101500	REMOVAL OF EXISTING SUPERSTRUCTURES	EACH	1	1					
0102400	CONCRETE REMOVAL	CU YD	274	274					
0157300	PROTECTIVE SHIELD	SQ YD	387.0	387.0					
0900805	PEDESTRIAN RAILING	FOOT	180					180	
54213657	PRECAST REINFORCED CONCRETE FLARED END SECTIONS 12"	EACH	2	1				`1	
54213675	PRECAST REINFORCED CONCRETE FLARED END SECTIONS 30"	EACH	1					1	
54247150	GRATING FOR CONCRETE FLARED END SECTION 30"	EACH	1					1	
550A0340	STORM SEWERS, CLASS A, TYPE 2 12"	FOOT	637.3	544.3				65.0	2
50A0380	STORM SEWERS, CLASS A, TYPE 2 18"	FOOT	25. 7	25.7					
550A0430	STORM SEWERS, CLASS A, TYPE 2 30"	EACH	667					667	
550A0450	STORM SEWERS, CLASS A, TYPE 2 36"	FOOT	61.7	61.7					
5100500	STORM SEWER REMOVAL 12"	FOOT	24			1			2
55100700	STORM SEWER REMOVAL 15"	FOOT	52. 1	40. 1				12.0	
5100900	STORM SEWER REMOVAL 18"	FOOT	6.0	6.0					
5101400	STORM SEWER REMOVAL 30"	FOOT	954.2	476. 2				478.0	
55101600	STORM SEWER REMOVAL 36"	FOOT	26.0	26.0					
6103300	DUCTILE IRON WATER MAIN 12"	FOOT	223						22
6400820	FIRE HYDRANT WITH AUXILIARY VALVE AND VALVE BOX	EACH	1						
0200805	CATCH BASINS, TYPE A, 4'-DIAMETER, TYPE 8 GRATE	, EACH	2	2					
0201330	CATCH BASINS, TYPE A, 4'-DIAMETER, TYPE 23 FRAME AND GRATE	EACH	1	. 1					
50201340	CATCH BASINS, TYPE A, 4'-DIAMETER, TYPE 24 FRAME AND GRATE	EACH	1	1					
0203805	CATCH BASINS, TYPE A, 5'-DIAMETER, TYPE 1 FRAME, OPEN LID	EACH	1	-				1	
60206905	CATCH BASINS, TYPE C, TYPE 1 FRAME, OPEN LID	EACH	2			7 .			
50218400	MANHOLES, TYPE A, 4'-DIAMETER, TYPE 1 FRAME, CLOSED LID	EACH	4	4					
0221100	MANHOLES, TYPE A, 5'-DIAMETER, TYPE 1 FRAME, CLOSED LID	EACH	2					2	
50221700	MANHOLES, TYPE A, 5'-DIAMETER, TYPE 8 GRATE	EACH	2	2					
60236200	INLETS, TYPE A, TYPE 8 GRATE	EACH	2	2					

FILE NAME	=								
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USER NAME = TKluegel	DESIGNED	-	MJT	REVISED	•
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STATE	OF	ILLINOIS
<b>DEPARTMENT</b>	OF 1	RANSPORTATION

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SCALE:	N.T.S.	SHEET	NO.	2	OF	5	SHEETS	STA.		TO STA.	

RTE.	SECTION	COUNTY	SHEETS	NO.	
330	2010-135-I	соок	5		
	SQ-02	CONTRACT	NO. 6	ON09	
	ILLINOIS FED. AI	D PROJECT			

	ois 60601	
Engineers / Architects	130 East Randolph Street Chicago, Illinois 60601	

						CONSTRUCT	ION CODE		
				ROADWAY US 45/143RD	TRACK RELOCATION	LANDSCAPING		PLATFORM	VILLAGE OF ORLAND PARK
CODE	ITEM	UNIT	TOTAL	80% FED 20% STATE	80% FED 20% STATE	80% FED 20% STATE		80% FED 20% STATE	100% VOP
NO. 60237460	INLETS, TYPE A, TYPE 23 FRAME AND GRATE	EACH	QUANTITY	0003	0021	<b>0</b> 003		0003	0043
60250200	CATCH BASINS TO BE ADJUSTED	EACH	1				,	1	
60255500	MANHOLES TO BE ADJUSTED	EACH	2	1				1	
60500040	REMOVING MANHOLES	EACH	1	1					
60500050	REMOVING CATCH BASINS	EACH	7					2	
60500060								2	
	REMOVING INLETS	EACH	1	1			8		
60600605	CONCRETE CURB, TYPE B	FOOT	226						22
60603800	COMBINATION CONCRETE CURB AND GUTTER, TYPE B-6.12	FOOT	124	124					
60605000	COMBINATION CONCRETE CURB AND GUTTER, TYPE B-6.24	FOOT	125	125					
60618300	CONCRETE MEDIAN SURFACE, 4 INCH	SO FT	1.150	1, 150					
66400105	CHAIN LINK FENCE, 4'	FOOT	305						30
66900200	NON-SPECIAL WASTE DISPOSAL	CU YD	5, 561	5, 561					
66900450	SPECIAL WASTE PLANS AND REPORTS	L SUM	1	1					
66900530	SOIL DISPOSAL ANALYSIS	EACH	3	3			F.		
X6700410	ENGINEER'S FIELD OFFICE, TYPE A (SPECIAL)	CAL MO	12	12					
67100100	MOBILIZATION	L SUM	1	1					
70106800	CHANGEABLE MESSAGE SIGN	CAL MO	7	7					
73700100	REMOVE CROUND MOUNTED SIGN SUPPORT	EACH	1					1	
78000200	THERMOPLASTIC PAVEMENT MARKING - LINE 4"	FOOT	300	300					
78000400	THERMOPLASTIC PAVEMENT MARKING - LINE 6"	FOOT	575	575					
- 78000500	THERMOPLASTIC PAVEMENT MARKING - LINE 8"	FOOT	115	115			· · · · · · · · · · · · · · · · · · ·		
78000600	THERMOPLASTIC PAVEMENT MARKING - LINE 12"	FOOT	99	99					
78000650	THERMOPLASTIC PAVEMENT MARKING - LINE 24"	FOOT	69	69			÷		
78001110	PAINT PAVEMENT MARKING - LINE 4"	FOOT	325			·			32
* 81017515		FOOT	157					157	
	ELECTRIC CABLE IN CONDUIT, 600V (XLP-TYPE USE) 1/C NO. 6	FOOT	885					885	
	TRENCH AND BACKFILL FOR ELECTRICAL WORK	FOOT	157					157	
			· ·						
	LIGHT POLE FOUNDATION, 30" DIAMETER	FOOT	11					11	
84100110	REMOVAL OF TEMPORARY LIGHTING UNIT	EACH	3					3	
* 84200500		EACH	13				. 5	13	
	RELOCATE EXISTING LIGHTING UNIT	EACH	1					1	
88600100	DETECTOR LOOP, TYPE I	FOOT	67	67		-			

FILE NAME = D160N09-SHT-S0003.dgn

USER NAME = TKluegel	DESIGNED	-	MJT	REVISED	-
	DRAWN	-	MJT	REVISED	-
PLOT SCALE = 1:50	CHECKED	-	TRK	REVISED	*
PLOT DATE = 1/7/2011	DATE	-	12/17/10	REVISED	-

STATE	OF	ILLINOIS
DEPARTMENT	0F '	TRANSPORTATION

			SI	JN	IMA	ARY	OF QU	ANTITIES	3
SCALE:	N.T.S.	SHEET	NO.	3	OF	5	SHEETS	STA.	TO STA.

 							•
	ILLINOIS	FED.	AID	PROJECT			
	SQ-03			CONTRACT	NO. 6	0N09	
330 2010-135-I				COOK	101	6	
RTE. SECTION				COUNTY	SHEETS	NO.	

0005			<b></b>	ROADWAY US 45/143RD	TRACK RELOCATION	LANDSCAPING		PLATFORM	VILLAGE O
CODE NO.	ITEM	UNIT	TOTAL QUANTITY	80% FED 20% STATE	80% FED 20% STATE	80% FED 20% STATE		80% FED 20% STATE	100% VOP
89502380	REMOVE EXISTING HANDHOLE	EACH	QUANTITY 8	0003	0021	<b>0</b> 003		0003	0043
XX001244	9 ORNAMENTAL FENCE	FOOT	671						
X0324534		L SUM	1	1					
X2500920	SEEDING, CLASS 1A (SPECIAL)	ACRE	0.1				Α		
X6063401	COMBINATION CONCRETE CURB AND GUTTER, TYPE M-4.12	FOOT	165	165					
X6063600	COMBINATION CONCRETE CURB AND GUTTER, TYPE M-4.24	FOOT	150	150					
X6640300	CHAIN LINK FENCE REMOVAL	FOOT	305						
X7010216	TRAFFIC CONTROL AND PROTECTION, (SPECIAL)	L SUM	. 1	1		* · ·			
X8140115	HANDHOLE TO BE ADJUSTED	EACH	1					1	
XX008438	TRAFFIC CONTROL AND PROTECTION FOR TEMPORARY DETOUR	EACH	2	2					
	AGGREGATE SUBGRADE 12"	SO YD	848	698					
				638					
Z0012455		EACH	10			V		4	* .
Z0013798	CONSTRUCTION LAYOUT	L SUM	1	1				<u> </u>	
Z0018500	DRAINAGE STRUCTURES TO BE CLEANED	EACH	3	3					
Z0030850	TEMPORARY INFORMATION SIGNING	SO FT	70.0	70.0					
Z0048665	RAILROAD PROTECTIVE LIABILITY INSURANCE	L SUM	1	1					
Z0050600	REMOVE AND RESET ORNAMENTAL FENCE	FOOT	475	475					
Z0050900	REMOVE CONCRETE FOUNDATION	EACH	15				*	15	
Z0064560	SEGMENTAL BLOCK RETAINING WALL	SQ FT	950					950	
Z0067900								330	
	S	FOOT	143						
Z0069800		TON	7, 997		7, 997		*.		
Z0075496	CONCRETE RETAINING WALL REMOVAL	FOOT	102	102					
Z0076600	TRAINEES	HOUR							
X0327146	RELOCATE BIKE RACK	EACH	1					1	
X0327147	7 REMOVE RAILROAD PLATFORM	SO FT	9, 235					9, 235	
Z0007126	HANDRAIL <i>REMOVAL</i>	FOOT	221					221	
	3 REMOVE INTERTRACK WIRE FENCE	FOOT	486			,		486	
	STEEL CASINGS 42"								
		FOOT	65				***	65	
	9 RELOCATE BENCH	EACH	5					5	
X0327150	(IN TRENCH	FOOT	11				,	11	
X0327151		FOOT	1,400					1,400	
X0327152		FOOT	375					375	

FILE NAME =
D160N09-SHT-S0004.dgn

USER NAME = TKluegel	DESIGNED	-	MJT	REVISED	-
	DRAWN	- ,	MJT	REVISED	-
PLOT SCALE = 1:50	CHECKED	- '	TRK	REVISED	-
PLOT DATE = 1/7/2011	DATE	-	12/17/10	REVISED	-

STATE	0F	ILLINOIS
DEPARTMENT (	OF T	RANSPORTATION

			S	UN	MMA	RY	OF QU	ANTITIES			
CALE:	N.T.S.	SHEET	ΝO	4	0F	- 5	SHEETS	STA	TO	STA.	
CALL	1441434	SHEET	110.	_	-01		SHEETS	31A.	10	31Ma	

CONSTRUCTION CODE

ı			ILLINOIS	FED. A	ID PROJECT		
4		SQ-04	<u> </u>		CONTRACT	NO.	60N09
	330 2010-135-1				соок	101	7
i	RTE. SECTION				COUNTY	SHEET	S NO.

						CONSTRUC	TION CODE		
				ROADWAY US 45/143RD	TRACK RELOCATION	LANDSCAPING		PLATFORM	VILLAGE OF ORLAND PAR
CODE NO.	I TEM	UNIT	TOTAL QUANTITY	80% FED 20% STATE 0003	80% FED 20% STATE 0021	80% FED 20% STATE <b>0</b> 003		80% FED 20% STATE 0003	100% VOP
K0327153	CONDUIT: 1 1/2" DIA., GALVANIZED STEEL (FURNISH ONLY)	FOOT	1, 350					1, 350	
X0327/54	HANDHOLE, PORTLAND CEMENT CONCRETE (FURNISH ONLY)	EACH	2					2	
X0327155	ELECTRIC CABLE IN CONDUIT, 600V (XLP-TYPE USE) 1/C NO. 10 (FURNISH ONLY)	FOOT	1,700					1, 700	
X0327156	ELECTRIC CABLE IN CONDUIT, 600V (XLP-TYPE USE) 1/C NO. 8 (FURNISH ONLY)	FOOT	5,100					5, 100	
X0327157	AERIAL CABLE, 3-1/C NO. 8 WITH MESSENGER WIRE (FURNISH ONLY)	FOOT	325					325	
X0327150	TRENCH AND BACKFILL FOR ELECTRICAL WORK (FURNISH ONLY)	FOOT	1, 750					1, 750	
X0327159	LIGHT POLE, WOOD, 20 FOOT, CLASS 5 (FURNISH ONLY)	EACH	1					1	
X0327160	LIGHT POLE, WOOD, 40 FOOT, CLASS 3 (FURNISH ONLY)	EACH	2					2	
X0327161	LIGHT POLE FOUNDATION, 30" DIAMETER (FURNISH ONLY)	FOOT	143					143	
X0327162	LIGHT POLE, SPECIAL (DECORATIVE ORNAMENTAL) (FURNISH ONLY)	EACH	12					12	
X0327163	LUMINAIRE (FURNISH ONLY)	EACH	12					12	
X0327164	HOT-MIX ASPHALT RAILROAD STATION PLATFORM (FURNISH ONLY)	SQ FT	12,845					12, 845	
X0327165	CONCRETE RAILROAD STATION PLATFORM (FURNISH ONLY)	SQ FT	4,218					4,218	
X0327166	INTERTRACK WIRE FENCE (FURNISH ONLY)	FOOT	1, 178					1, 178	
X0327167	PEDESTRIAN CROSSWALK (FURNISH ONLY)	SQ FT	300					300	
X0327168	TEMPORARY PEDESTRIAN CROSSWALK (FURNISH ONLY)	SQ FT	300					300	
X0327169	TEMPORARY ISLAND BOARDING PLATFORM (FURNISH ONLY)	SQ FT	1,440			:		1,440	
XX003668	PRECONSTRUCTION VIDEOTAPING	L SUM	1						
								· · · · · · · · · · · · · · · · · · ·	
									· ·
		,							


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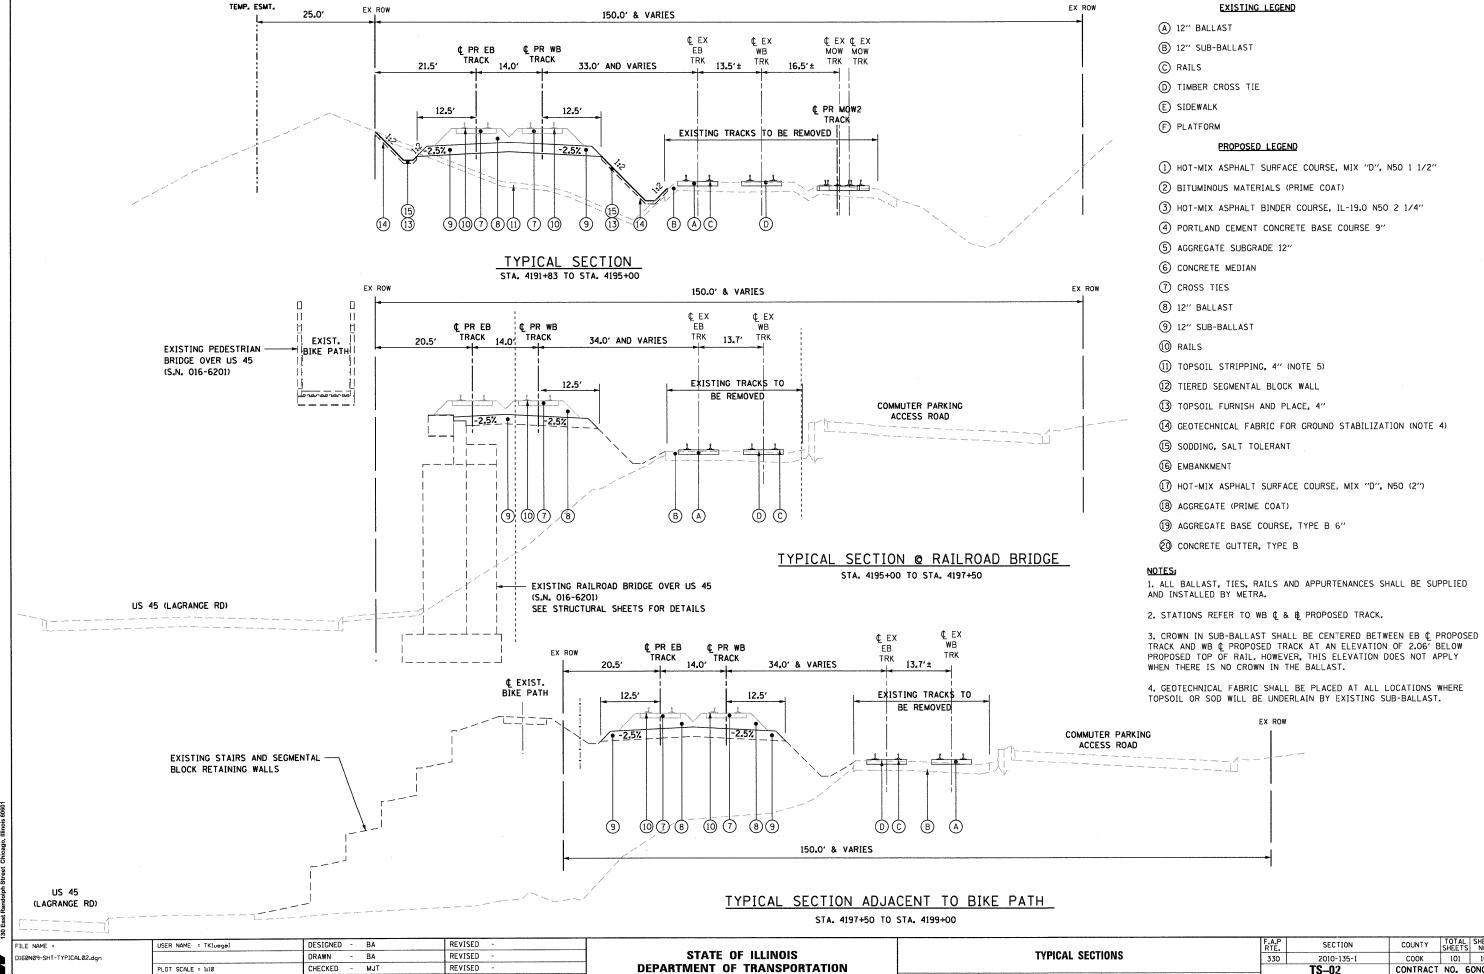
USER NAME = TKluegel	DESIGNED	-	MJT	REVISED	-
	DRAWN	-	MJT	REVISED	-
PLOT SCALE = 1:50	CHECKED	-	TRK	REVISED	-
PLOT DATE = 1/7/2011	DATE	-	12/17/10	REVISED	-

STATE	OF	ILLINOIS
<b>DEPARTMENT</b>	OF 1	<b>TRANSPORTATION</b>

SUMMARY OF QUANTITIES											
ALE: I	N.T.S.	SHEET	N0.	5	OF	5	SHEETS	STA,	TO STA.		
	ALE: 1	ALE: N.T.S.	ALE: N.T.S. SHEET	ALE: N.T.S. SHEET NO.	ALE: N.T.S. SHEET NO. 5	ALE: N.T.S. SHEET NO. 5 OF	ALE: N.T.S. SHEET NO. 5 OF 5	ALE: N.T.S. SHEET NO. 5 OF 5 SHEETS	ALE: N.T.S. SHEET NO. 5 OF 5 SHEETS STA.	ALE: N.T.S. SHEET NO. 5 OF 5 SHEETS STA. TO STA.	

F.A.P RTE.	SECTION	COUNTY	TOTAL SHEETS	SHEET NO.
330	2010-135-1	COOK	101	8
	SQ05	CONTRACT	NO. 6	0N09
	II.LINOIS FED. A	ID PROJECT		



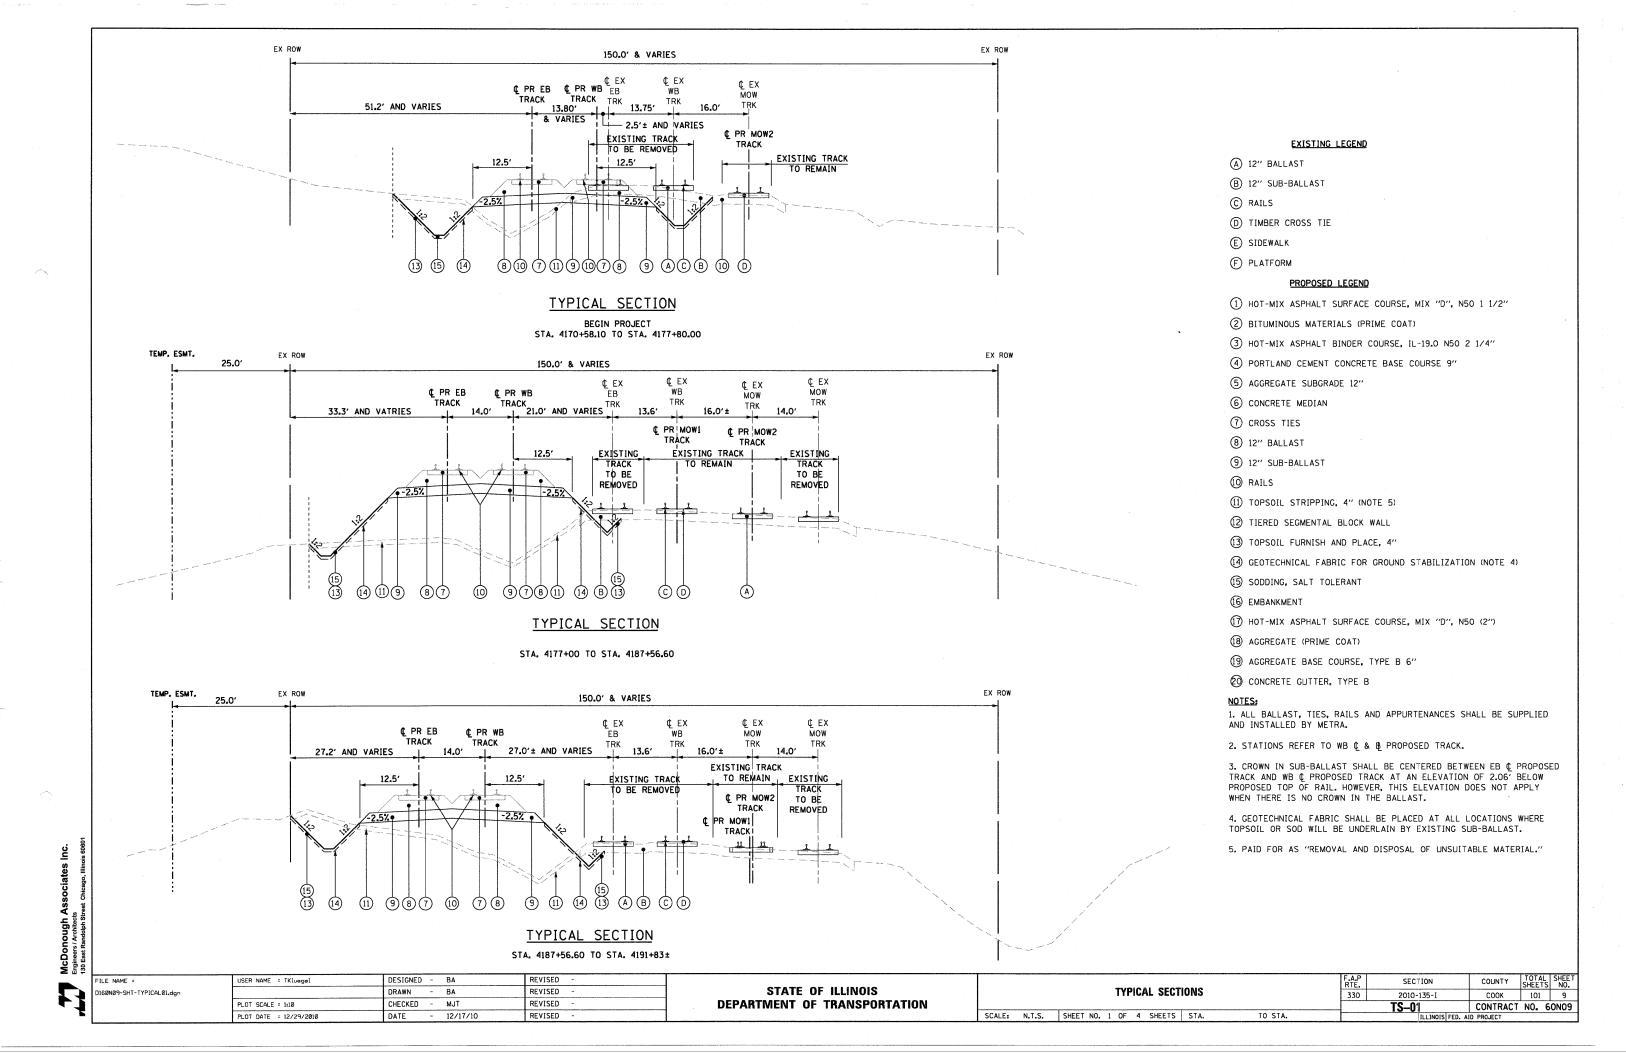


PLOT DATE = 12/29/2010

12/17/10

REVISED

**DEPARTMENT OF TRANSPORTATION** 

COOK 101 10 CONTRACT NO. 60N09 TS-02 SCALE: N.T.S. SHEET NO. 2 OF 4 SHEETS STA. TO STA.

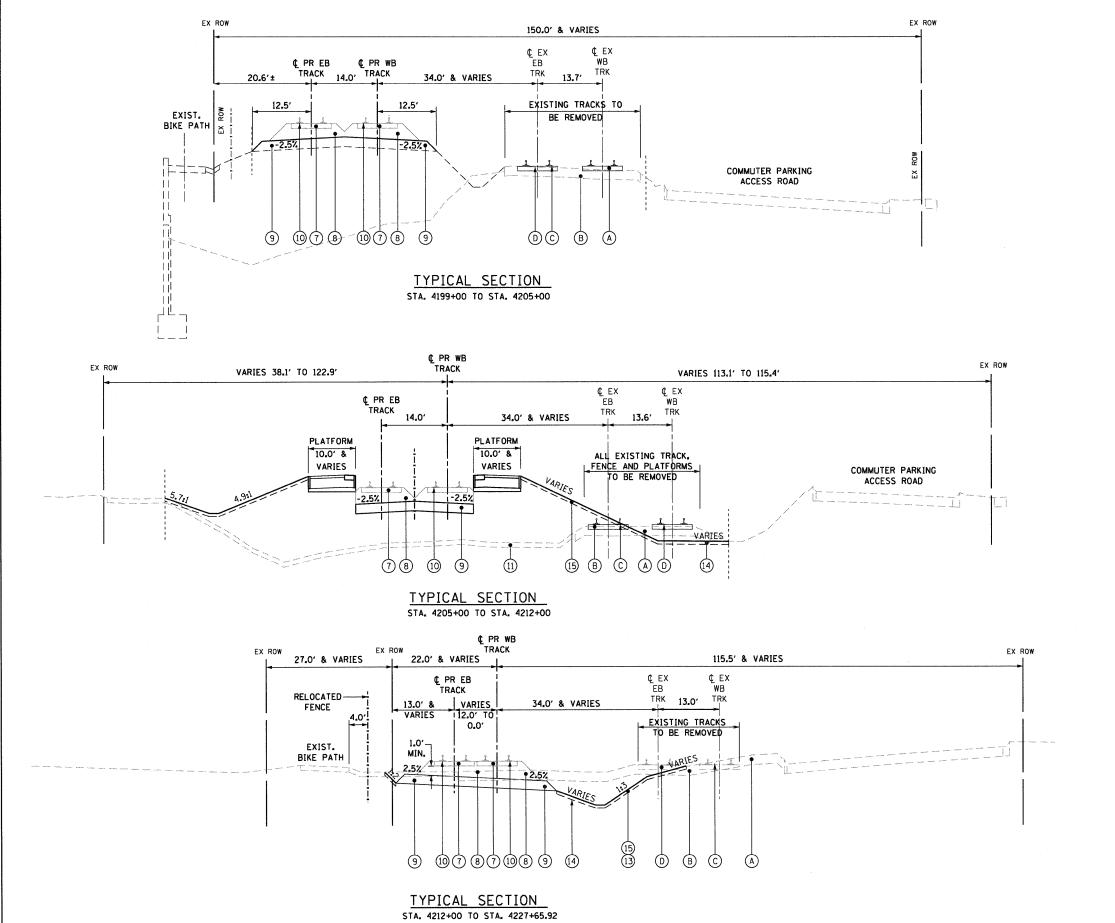

EXISTING LEGEND

- A 12" BALLAST
- B 12" SUB-BALLAST
- C RAILS
- D TIMBER CROSS TIE
- E SIDEWALK
- F PLATFORM

#### PROPOSED LEGEND

- 1 HOT-MIX ASPHALT SURFACE COURSE, MIX "D", N50 1 1/2"
- (2) BITUMINOUS MATERIALS (PRIME COAT)
- 3 HOT-MIX ASPHALT BINDER COURSE, IL-19.0 N50 2 1/4"
- 4 PORTLAND CEMENT CONCRETE BASE COURSE 9"
- (5) AGGREGATE SUBGRADE 12"
- 6 CONCRETE MEDIAN
- 7 CROSS TIES
- 8 12" BALLAST
- 9 12" SUB-BALLAST
- (10) RAILS
- 11) TOPSOIL STRIPPING, 4" (NOTE 5)
- 12 TIERED SEGMENTAL BLOCK WALL
- (3) TOPSOIL FURNISH AND PLACE, 4"
- 4 GEOTECHNICAL FABRIC FOR GROUND STABILIZATION (NOTE 4)
- 15 SODDING, SALT TOLERANT
- (6) EMBANKMENT
- (7) HOT-MIX ASPHALT SURFACE COURSE, MIX "D", N50 (2")
- (18) AGGREGATE (PRIME COAT)
- (19) AGGREGATE BASE COURSE, TYPE B 6"
- ② CONCRETE GUTTER, TYPE B

#### OTFS.

1. ALL BALLAST, TIES, RAILS AND APPURTENANCES SHALL BE SUPPLIED AND INSTALLED BY METRA.

- 2. STATIONS REFER TO WB C & B PROPOSED TRACK.
- 3. CROWN IN SUB-BALLAST SHALL BE CENTERED BETWEEN EB & PROPOSED TRACK AND WB & PROPOSED TRACK AT AN ELEVATION OF 2.06' BELOW PROPOSED TOP OF RAIL. HOWEVER, THIS ELEVATION DOES NOT APPLY WHEN THERE IS NO CROWN IN THE BALLAST.
- 4. GEOTECHNICAL FABRIC SHALL BE PLACED AT ALL LOCATIONS WHERE TOPSOIL OR SOD WILL BE UNDERLAIN BY EXISTING SUB-BALLAST.
- 5. PAID FOR AS "REMOVAL AND DISPOSAL OF UNSUITABLE MATERIAL."


130 East Kandolp


STATE OF ILLINOIS
DEPARTMENT OF TRANSPORTATION

 TYPICAL SECTIONS
 RTE.

 330

 SCALE:
 N.T.S.
 SHEET NO. 3 OF 4 SHEETS STA. TO STA.

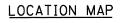


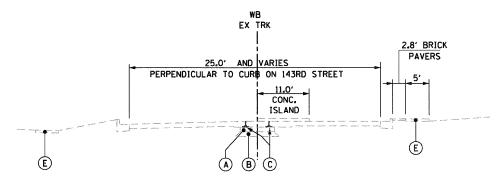

SECTION ACROSS 143RD STREET

AT METRA TRACKS (EXISTING)

(GRADE CROSSING)

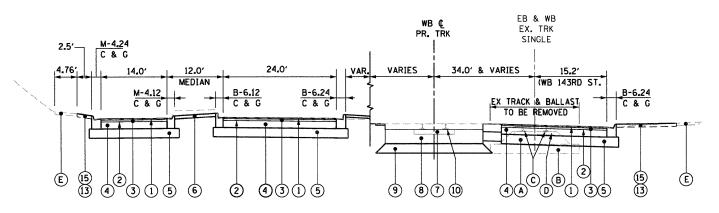

# SECTION A-A ACROSS 143RD STREET AT METRA TRACKS (SEE LOCATION MAP)

HOT-MIX ASPHALT MIXTURE REQUIREMENTS							
MIXTURE TYPE	AIR VOIDS						
COMPOSITE PAVEMENT							
HOT-MIX ASPHALT SURFACE COURSE, MIX "D", N50, 1 1/2"	4% <b>©</b> 50 Gyr.						
HOT-MIX ASPHALT BINDER COURSE, IL-19.0, N50, 2 1/4"	4% <b>©</b> 50 Gyr.						
BIKE PATH							
HOT-MIX ASPHALT SURFACE COURSE, MIX "D", N50, 2"	4% @ 50 Gyr.						

NOTE 1: THE UNIT WEIGHT USED TO CALCULATE ALL HMA SURFACE MIXTURE QUANTITIES IS 112 LBS/SQ YD/IN.
NOTE 2: FOR "AC TYPE" AND "PERCENT RAP" SEE DISTRICT ONE SPECIAL PROVISIONS.

#### 

STATE OF ILLINOIS
DEPARTMENT OF TRANSPORTATION

	TUDICAL CECTIONS						F.A.P RTE.	SECTION	COUNTY	TOTAL SHEET SHEETS NO.		
TYPICAL SECTIONS						330	2010-135-1	COOK	101	12		
							TS-04	CONTRACT	NO.	60N09		
CALE:	N.T.S.	SHEET NO. 4	OF	4	SHEETS	STA.	TO STA.		ILLINOIS FED. A	D PROJECT		

#### EXISTING LEGEND

- (A) 12" BALLAST
- B 12" SUB-BALLAST
- C RAILS
- D TIMBER CROSS TIE
- E) SIDEWALK
- F PLATFORM

#### PROPOSED LEGEND

- 1 HOT-MIX ASPHALT SURFACE COURSE, MIX "D", N50 1 1/2"
- 2 BITUMINOUS MATERIALS (PRIME COAT)
- 3 HOT-MIX ASPHALT BINDER COURSE, IL-19.0 N50 2 1/4"
- 4 PORTLAND CEMENT CONCRETE BASE COURSE 9"
- (5) AGGREGATE SUBGRADE 12"
- 6 CONCRETE MEDIAN
- 7 CROSS TIES
- 8 12" BALLAST
- 9 12" SUB-BALLAST
- (10) RAILS
- (1) TOPSOIL STRIPPING, 4" (NOTE 5)
- 12 TIERED SEGMENTAL BLOCK WALL
- (13) TOPSOIL FURNISH AND PLACE, 4"
- (4) GEOTECHNICAL FABRIC FOR GROUND STABILIZATION (NOTE 4)
- (15) SODDING, SALT TOLERANT
- (6) EMBANKMENT
- (7) HOT-MIX ASPHALT SURFACE COURSE, MIX "D", N50 (2")
- (B) AGGREGATE (PRIME COAT)
- (9) AGGREGATE BASE COURSE, TYPE B 6"
- O CONCRETE GUTTER, TYPE B

#### NOTES:

- 1. ALL BALLAST, TIES, RAILS AND APPURTENANCES SHALL BE SUPPLIED AND INSTALLED BY METRA.
- 2. STATIONS REFER TO WB C & B PROPOSED TRACK.
- 3. CROWN IN SUB-BALLAST SHALL BE CENTERED BETWEEN EB & PROPOSED TRACK AND WB & PROPOSED TRACK AT AN ELEVATION OF 2.06' BELOW PROPOSED TOP OF RAIL. HOWEVER, THIS ELEVATION DOES NOT APPLY WHEN THERE IS NO CROWN IN THE BALLAST.
- 4. GEOTECHNICAL FABRIC SHALL BE PLACED AT ALL LOCATIONS WHERE TOPSOIL OR SOD WILL BE UNDERLAIN BY EXISTING SUB-BALLAST.
- 5. PAID FOR AS "REMOVAL AND DISPOSAL OF UNSUITABLE MATERIAL."

MCDONOUGH ASSOCIATES INC.
Engineers / Architects
130 East Randolph Street Chicago, Illinois 60601

BEGIN STATION	END STATION	EARTH EXCAVATION	REMOVAL AND DISPOSAL OF UNSUITABLE MATERIAL	EXCAVATION TO BE USED IN EMBANKMENT ADJUSTED FOR SHRINKAGE.	EMBANKMENT	EARTHWORK BALANCE WASTE (+) OR SHORTAGE (-)	SUB-BALLAST
		CU. YD.	CU. YD.	CU. YD.	CU. YD.	CU. YD.	CU. YD.
4169+00.00	4175+00.00	496	201	422	85	337	241
4175+00.00	4180+00.00	1,676	410	1,425	771	654	364
4180+00.00	4185+00.00	51	547	43	5,714	-5,671	647
4185+00.00	4190+00.00	348	546	296	4,817	-4,521	705
4190+00.00	4195+00.00	434	552	369	2,981	-2,612	705
4195+00,00	4200+00.00	3,960	52	3,366	354	3,012	387
4200+00.00	4205+00.00	30	0	26	120	-94	705
4205+00.00	4210+00.00	169	627	144	5,209	-5,065	489
4210+00.00	4215+00.00	951	434	808	1,365	-557	537
4215+00.00	4220+00.00	1,276	142	1,085	67	1,018	560
4220+00.00	4225+00.00	2,027	16	1,723	74	1,649	475
4225+00.00	4227+00.00	1,073	0	912	0	912	336
SUB TOTAL		12,491	3,527	10,619	21,557	-10,938	6,151

## EARTHWORK SUMMARY

DESRIPTION	QUANTITY	UNIT
EARTH EXCAVATION	12,491	CU YD
FURNISHED EXCAVATION	10,938	CU YD
REMOVAL AND DISPOSAL OF UNSUITABLE MATERIAL	3,527	CU YD
SUB-BALLAST	6,151	CU YD

NOTE: SUB-BALLAST CALCULATED AT 1.3 TONS PER CUBIC YARD

## EROSION CONTROL SCHEDULE


	28000250	28000305	28000400	28000500	28000510	Z0023202	Z0023206	X0324045	Z0013796	X0324775
	TEMPORARY EROSION	TEMPORARY DITCH	PERIMETER	INLET AND	INLET FILTERS	SEDIMENT CONTROL.	SEDIMENT CONTROL,	SEDIMENT CONTROL,	SEDIMENT CONTROL,	SEDIMENT CONTROL,
	CONTROL SEEDING	CHECKS	EROSION BARRIER	PIPE PROTECTION		DRAINAGE STRUCTURE	SILT FENCE	STABILIZED CONSTRUCTION	STABILIZED CONSTRUCTION	STABILIZED CONSTRUCTION
						INLET FILTER CLEANING	MAINTENANCE	ENTRANCE REMOVAL	ENTRANCE	ENTRANCE MAINTENANCE
	POUND	F00T	F00T	EACH	EACH	EACH	F00T	EACH	SO YD	SQ YD
SHEET										
EC-01 (Top)	28	180	415	-	6	30	125	-	-	-
EC-01 (Bottom)	99	200	385	1	6	30	116	-	-	-
EC-02 (Top)	37	440	2,310	1	-	-	693	1	269	539
EC-02 (Bottom)	43	240	720	-	2	10	216	-	-	-
SUB-TOTAL	210	1,060	3,830	2	14	70	1,150	1	270	540
AT THE ENGINEER'S										
DISCRETION	25	106	385	1	2	7	115	1	30	55
GRAND TOTAL	235	1,170	4,215	3	16	77	1,265	2	300	595

• ASSUME 15% FOR SHRINKAGE

FILE NAME =	USER NAME = TKluegel	DESIGNED -	JCL	REVISED	-
D160N09-SHT-SCHEDULE01.dgn		DRAWN -	JCL	REVISED	-
	PLOT SCALE = 1:50	CHECKED -		REVISED	-
	PLOT DATE = 12/29/2010	DATE -	12/17/10	REVISED	-

STATE OF ILLINOIS
DEPARTMENT OF TRANSPORTATION

COLEDINE OF QUANTITIES								F.A.P RTE.	SECTION	COUNTY	TOTAL SHEETS	SHEET NO.		
	SCHEDULE OF QUANTITIES									330	2010-135-I	соок	101	13
										SC-01 CONTRACT NO.			NO. 6	0N09
SCALE:	SHEET NO	. •	OF	•	SHEETS	STA.	TO	STA.		ILLINOIS FED. AID PROJECT				

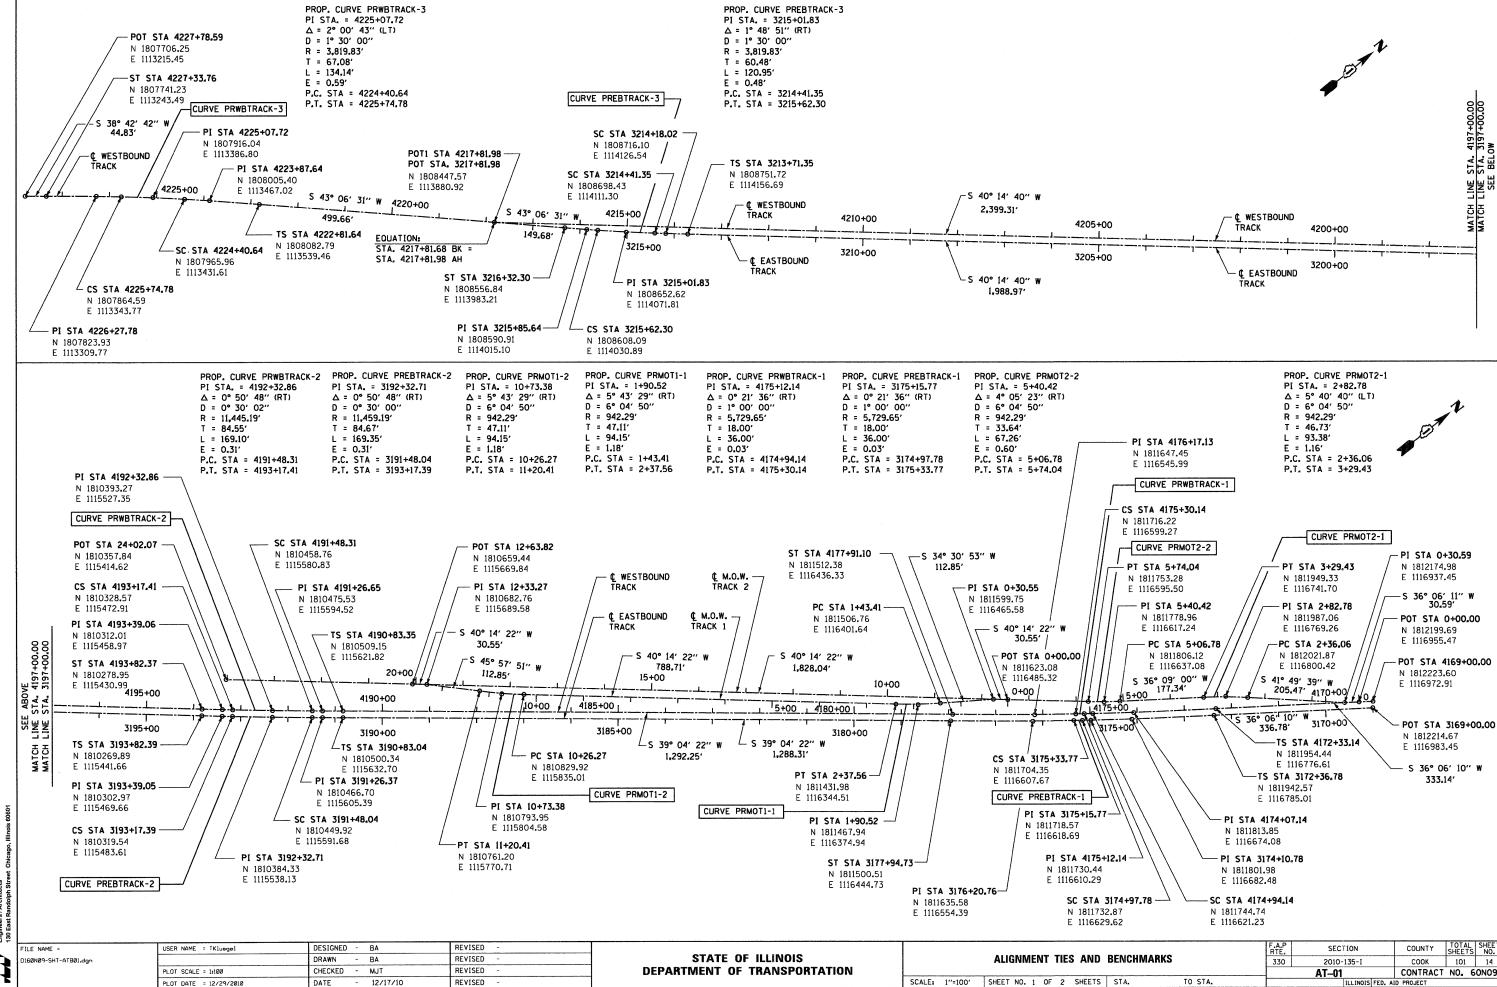


McDonough Associates Inc.

F

LOCATION DESCRIPTION: APPROXIMATE STA. 4346+01.67. 0.47 MILES WEST OF THE WEST EDGE OF METRA STATION BUILDING. 22.87' WEST OF ¢ OF RAILROAD TRACKS.

#### **CONTROL POINT NO. 106**

SCALE: 1" = 20"

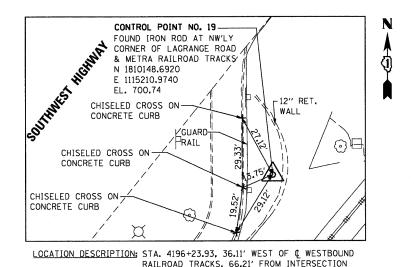

## **CONTROL POINT NO. 19**

SCALE: 1" = 20'

OF LAGRANGE ROAD AND ¢ EASTBOUND RR TRACKS.

- BA

12/17/10

#### TEMPORARY BENCHMARK "E"

CHISELED CROSS ON THE SW'LY ANCHOR BOLT OF THE SE'LY CANTILEVER RAILROAD CROSSING SIGNAL AT 143RD STREET. N 1808297.2710 E 1113732.9280 EL. 702.165

CHISELED CROSS ON THE NE'LY ANCHOR BOLT OF THE ELECTRIC BILLBOARD SIGN, ±50' NW'LY OF SW'LY PLATFORM OF METRA STATION. N 1808925.7770 F 1114323-0220 EL. 699.845

REVISED

REVISED

REVISED


REVISED

### CONTROL POINT NO. 102 PK NAIL ON BIT. PAVEMENT N 1808252.9210 - PK NATI ON THE E 1113701.6130 CONC. ISLAND EL. 701.045 ===== CONC. ISLAND *=======* -CHISELED CROSS ON CONCRETE CURB AND GUTTER -CHISELED CROSS ON CONCRETE WALK

LOCATION DESCRIPTION: STA. 4220+46.13, 22.89' EAST OF C RAILROAD TRACKS. 0.18 MILES SOUTH OF THE WEST EDGE OF METRA STATION BUILDING.

#### **CONTROL POINT NO. 102**

SCALE: 1" = 20'

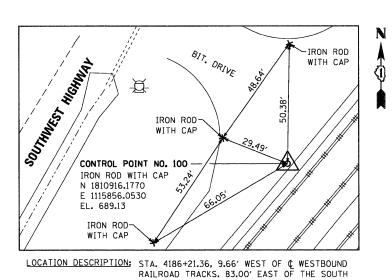

## END OF THE DRAINAGE CULVERT. **CONTROL POINT NO. 100**


SCALE: 1" = 20'

## CONTROL POINT NO. 104 CHISELED CROSS ON CONC. WALK N 1809116.2950 E 1114438.7780 EL. 696.50 23.89 CHISELED CROSS ON CONC. WALK CHISELED CROSS ON CONC. WALK - CHISELED CROSS ON CONC. WALK

LOCATION DESCRIPTION: STA. 4209+10.83, 27.86' EAST OF ¢ EASTBOUND RAILROAD TRACKS. 25.69' NORTH OF EAST EDGE OF METRA STATION BUILDING.

#### **CONTROL POINT NO. 104**

SCALE: 1" = 20

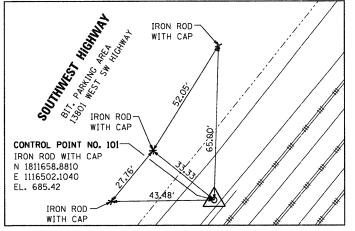

LOCATION DESCRIPTION: STA. 4176+32.96, 10.20' WEST OF ¢ WESTBOUND RAILROAD TRACKS. ±71' SOUTH OF FENCE CORNER LOCATED ON THE WEST OF WESTBOUND RAILROAD TRACKS AT STA. 4175+84.31

#### **CONTROL POINT NO. 101**

SCALE: 1" = 20"

## **TEMPORARY BENCHMARK "2"**

CHISELED CROSS ON THE NE'LY BOLT OF W'LY LIGHT POLE ±60 FT. NORTH OF N'LY EDGE OF SOUTHWEST HIGHWAY BRIDGE. N 1810394,3530 E 1115239.3170 EL. 678.745

#### TEMPORARY BENCHMARK "F"

SET RR SPIKE ON NE SIDE OF POWER POLE LOCATED WEST OF BITUMINOUS/GRAVEL DRIVEWAY. ±900 FT. E. OF LAGRANGE ROAD ±45 FT. SOUTH OF ¢ SOUTHWEST HIGHWAY. N 1810949.7535 E 1115793.8830

#### TEMPORARY BENCHMARK "G"

SQUARE CUT ON SW CORNER OF CONCRETE PAD IN FRONT OF DOOR LOCATED ON THE SW'LY SIDE OF BUILDING ±25' FT. NW'LY OF MOST S'LY CORNER OF BUILDING AT 13801 SOUTHWEST HIGHWAY. N 1811719.7226 E 1116435.5171 EL. 681.07


TO STA.


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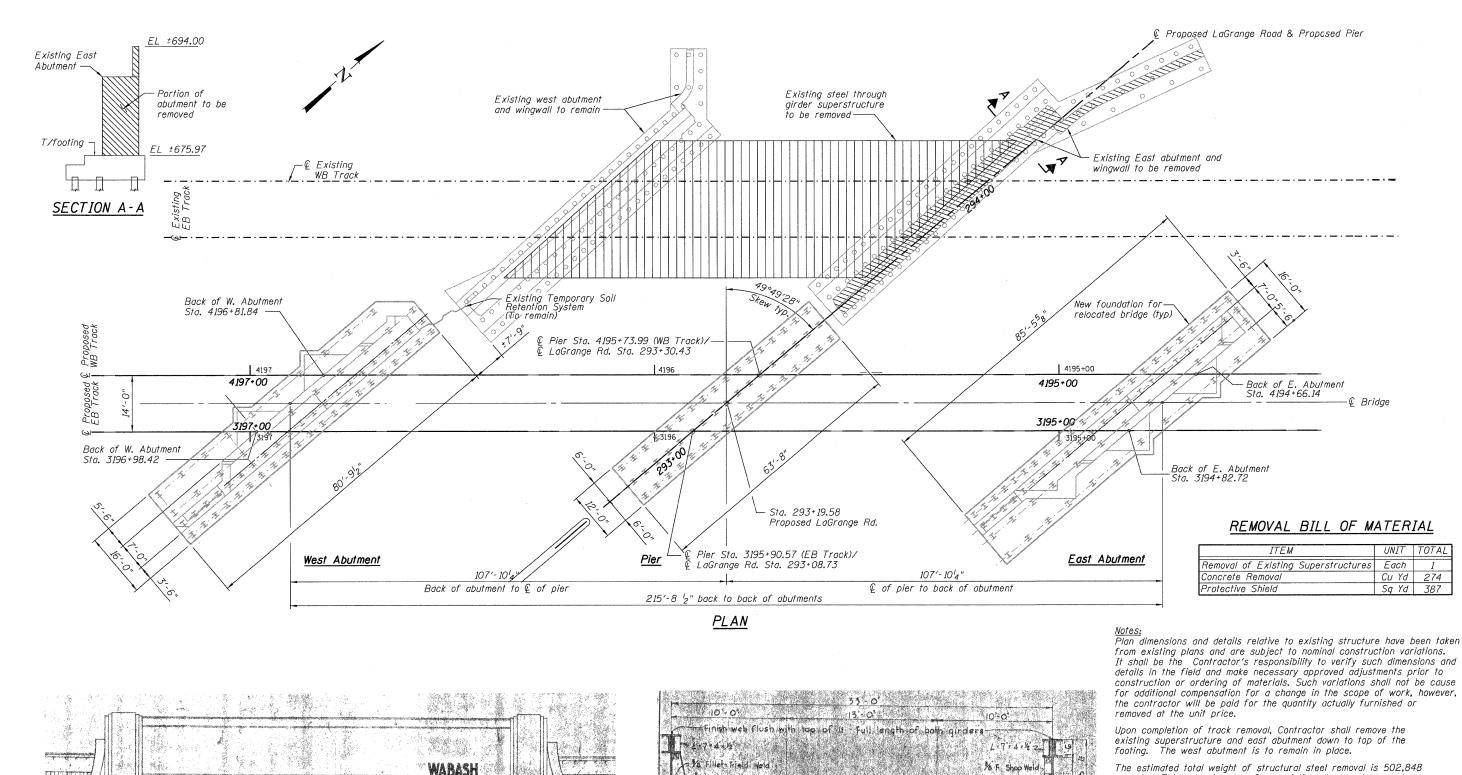
STATE OF ILLINOIS **DEPARTMENT OF TRANSPORTATION** 


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COUNTY TOTAL SHEE SHEETS NO. SECTION 330 2010-135-1 COOK 101 15 CONTRACT NO. 60N09 AT-02






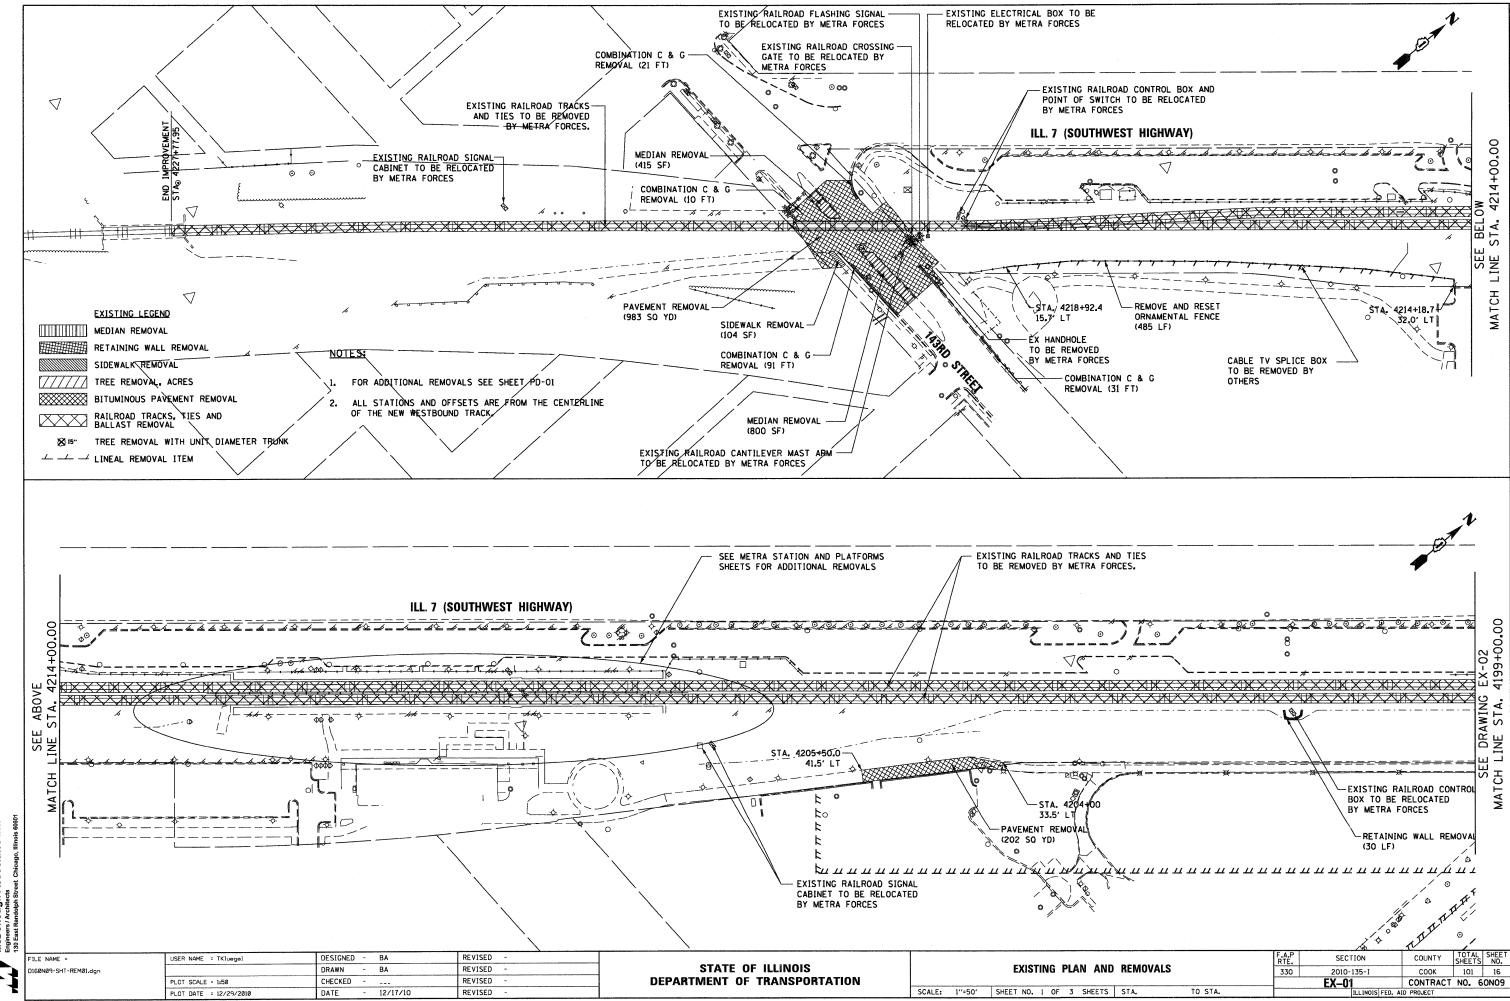

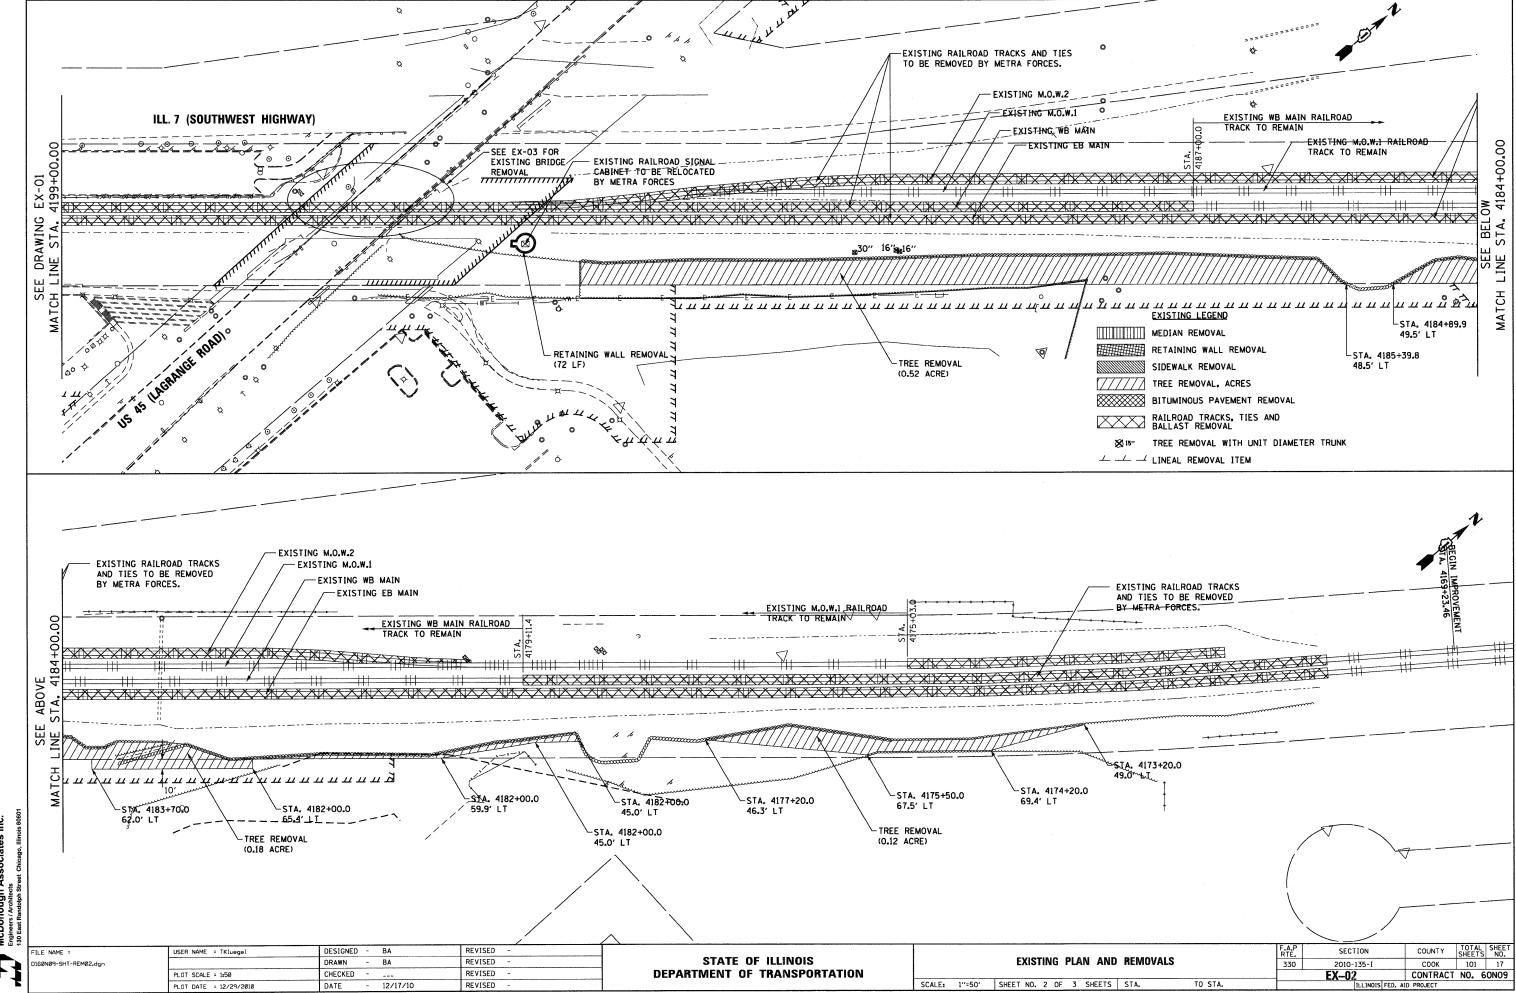

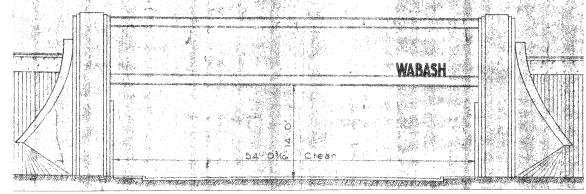EXISTING ELEVATION

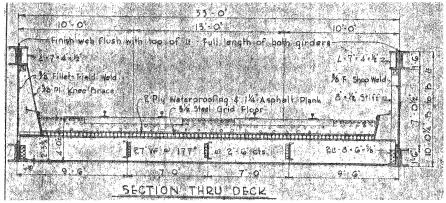

#### EXISTING CROSS SECTION

SCALE:

pounds. This value is taken from existing plans and may not reflect actual conditions. This value should be only be used in aiding the contractor in bidding purposes.

The Protective Shield should extend a minimum of 3 feet outside of the through girders.


Track and ties to be removed by Railroad forces. The Contractor is responsible for the removal of the remainder of the items on the superstructure and will not be paid for separately but included in the cost of Removal of Existing Superstructues.


The full set of existing bridge plans are available by contacting Metra and will be made available to the Contractor upon written


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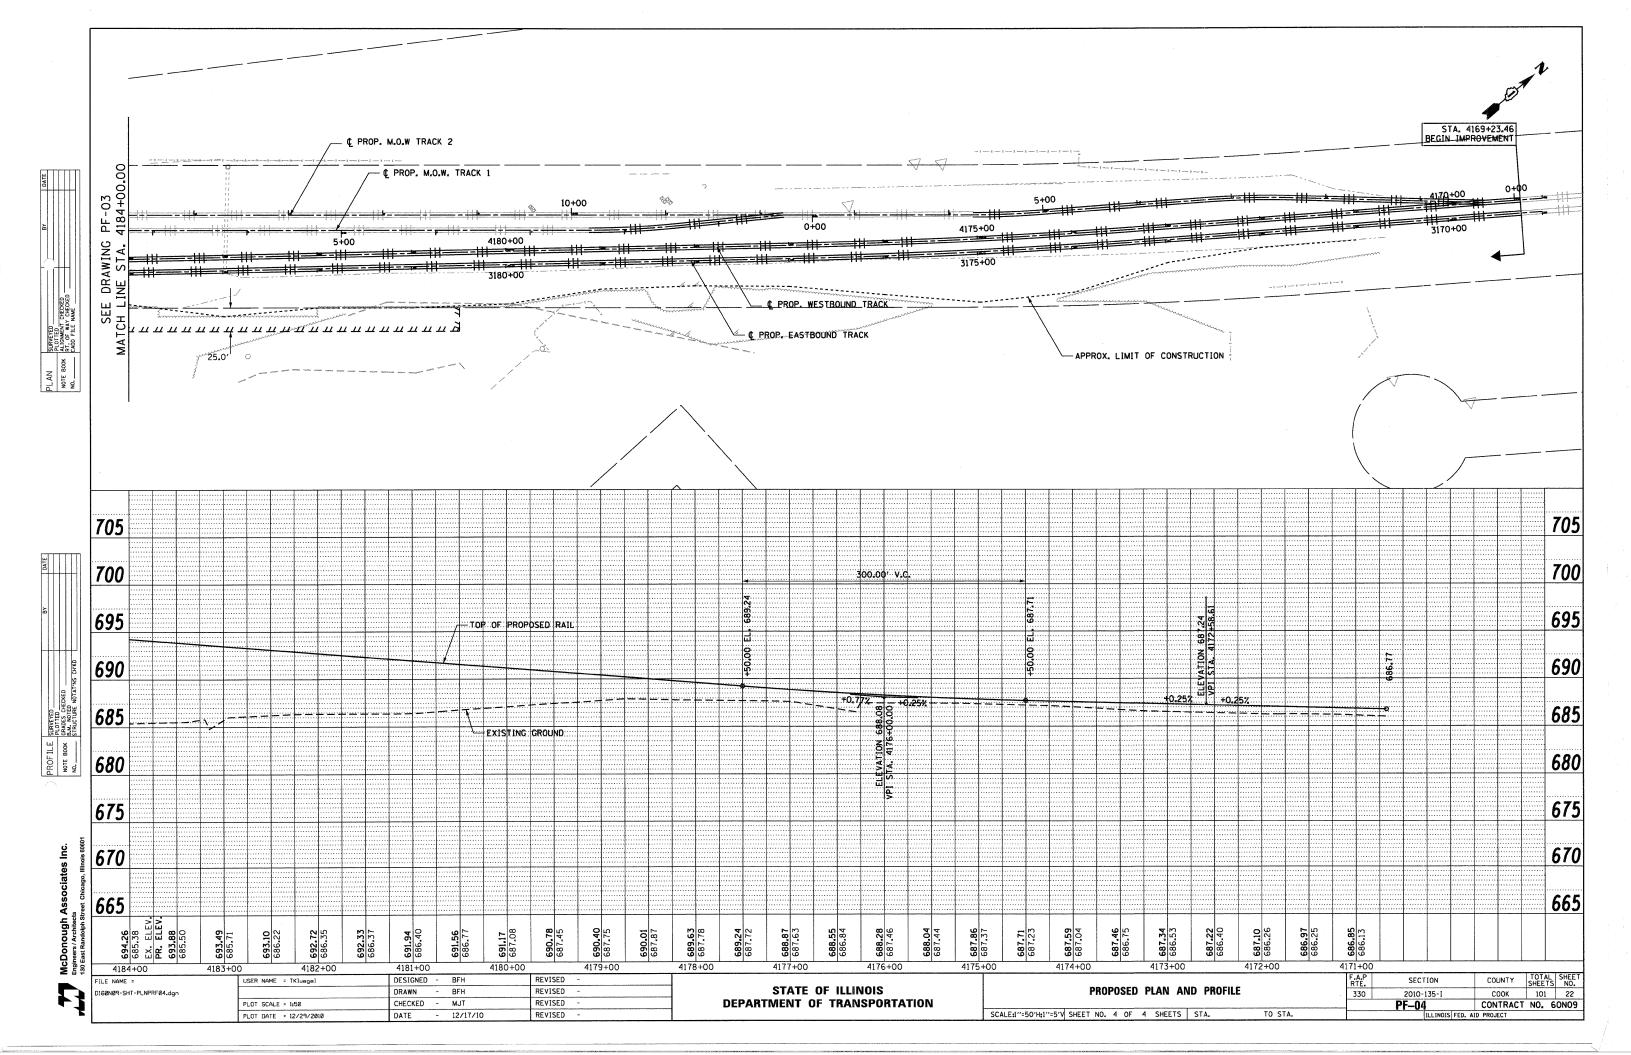
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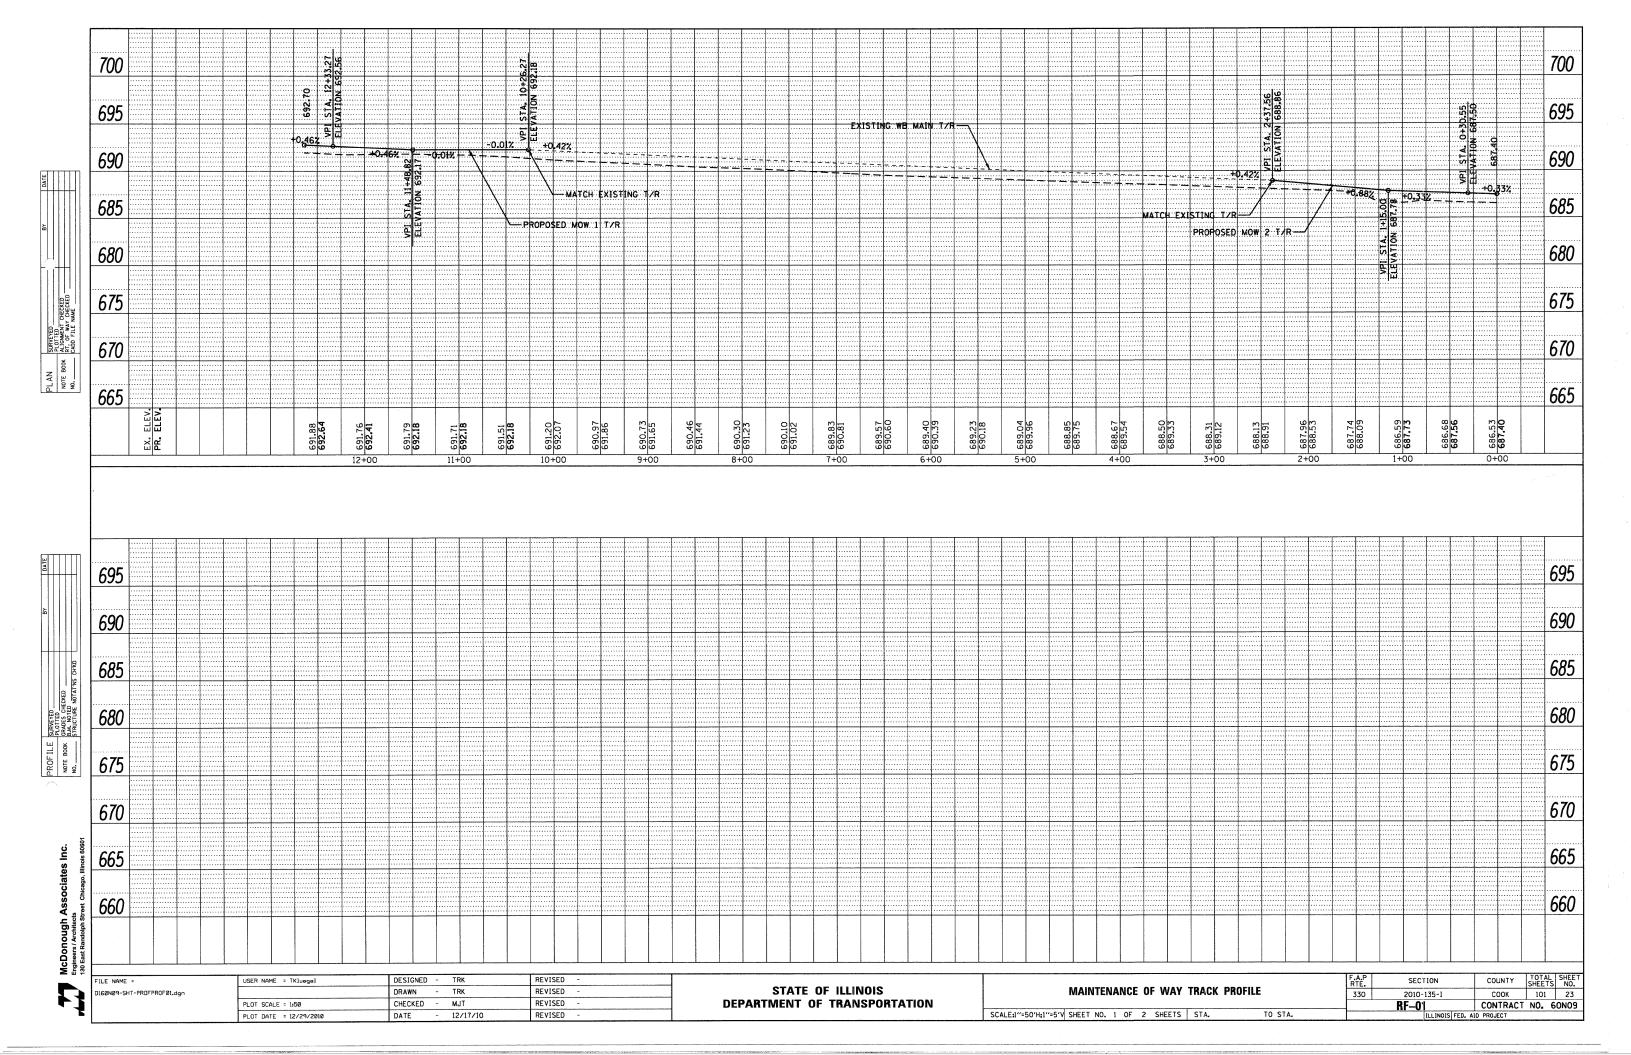
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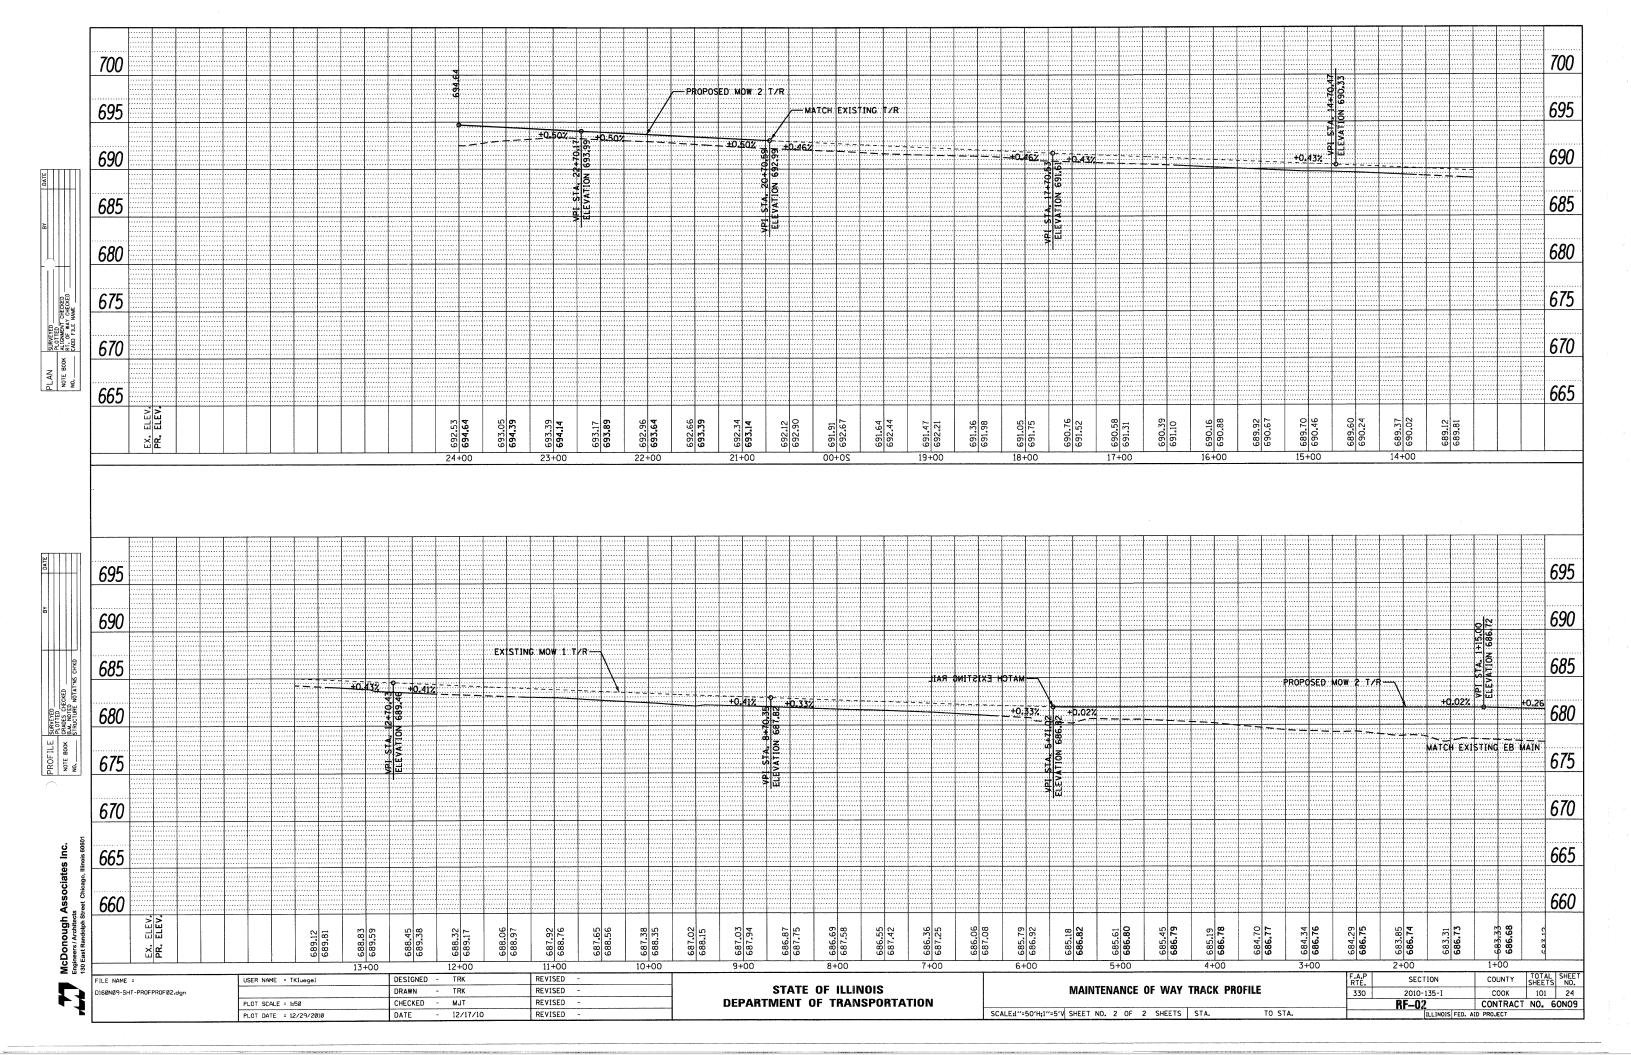








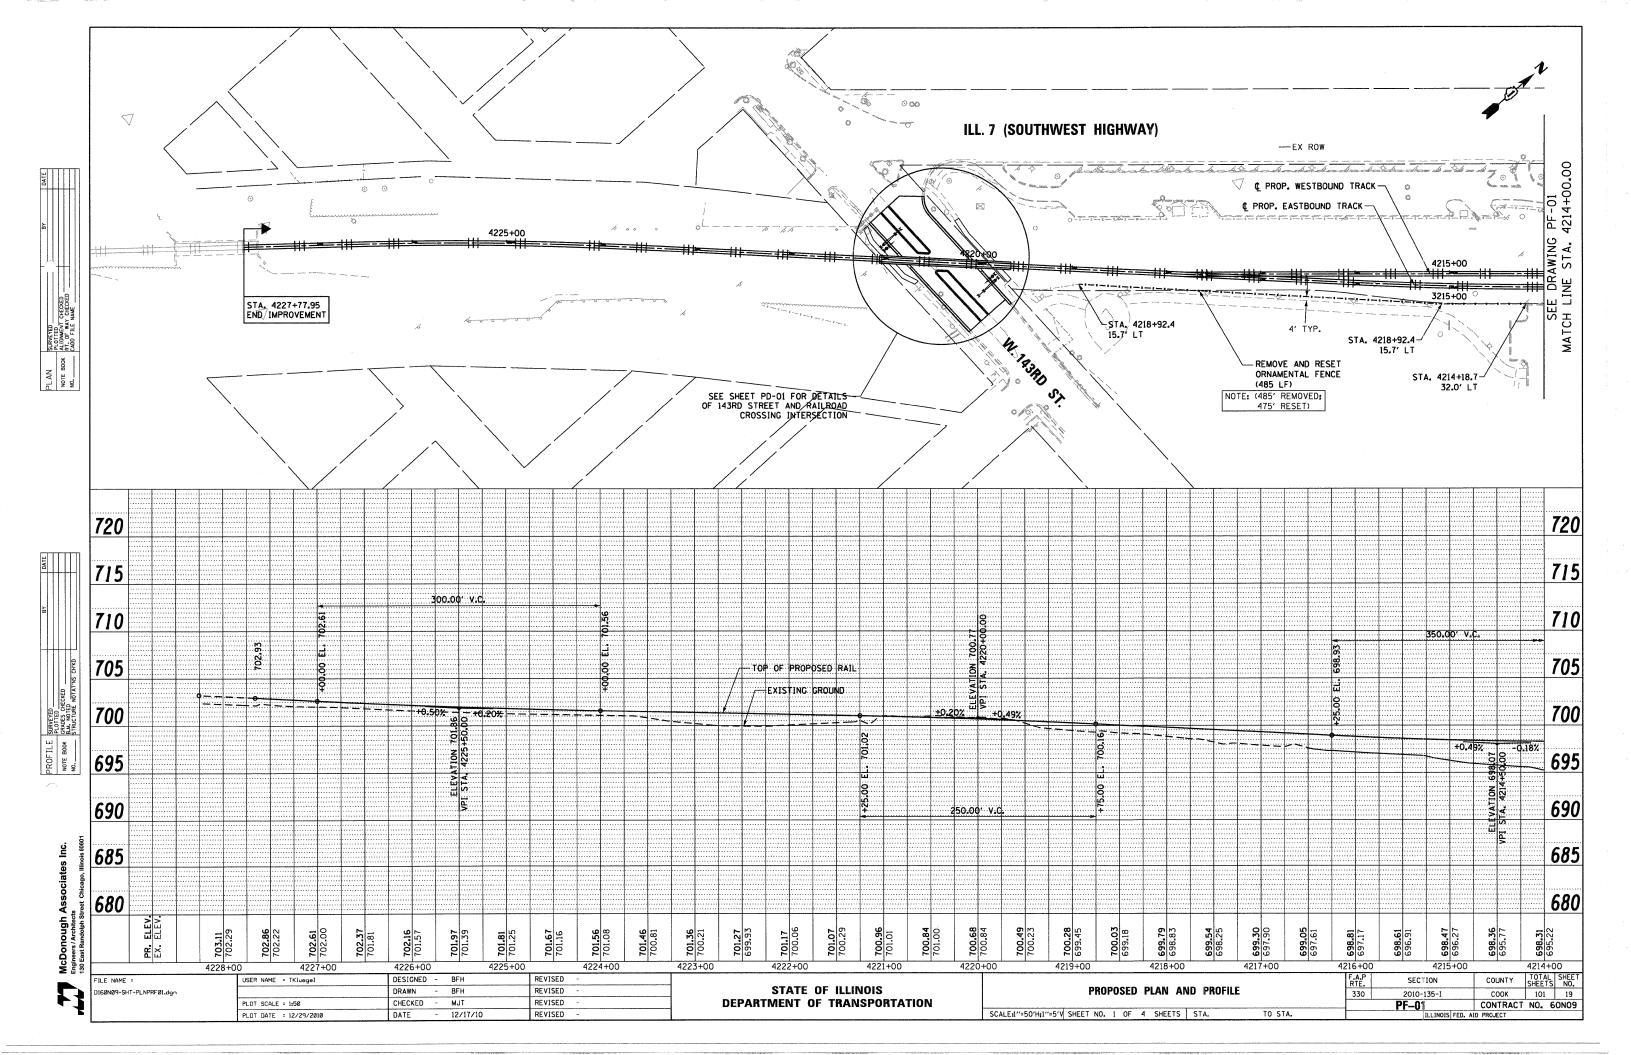

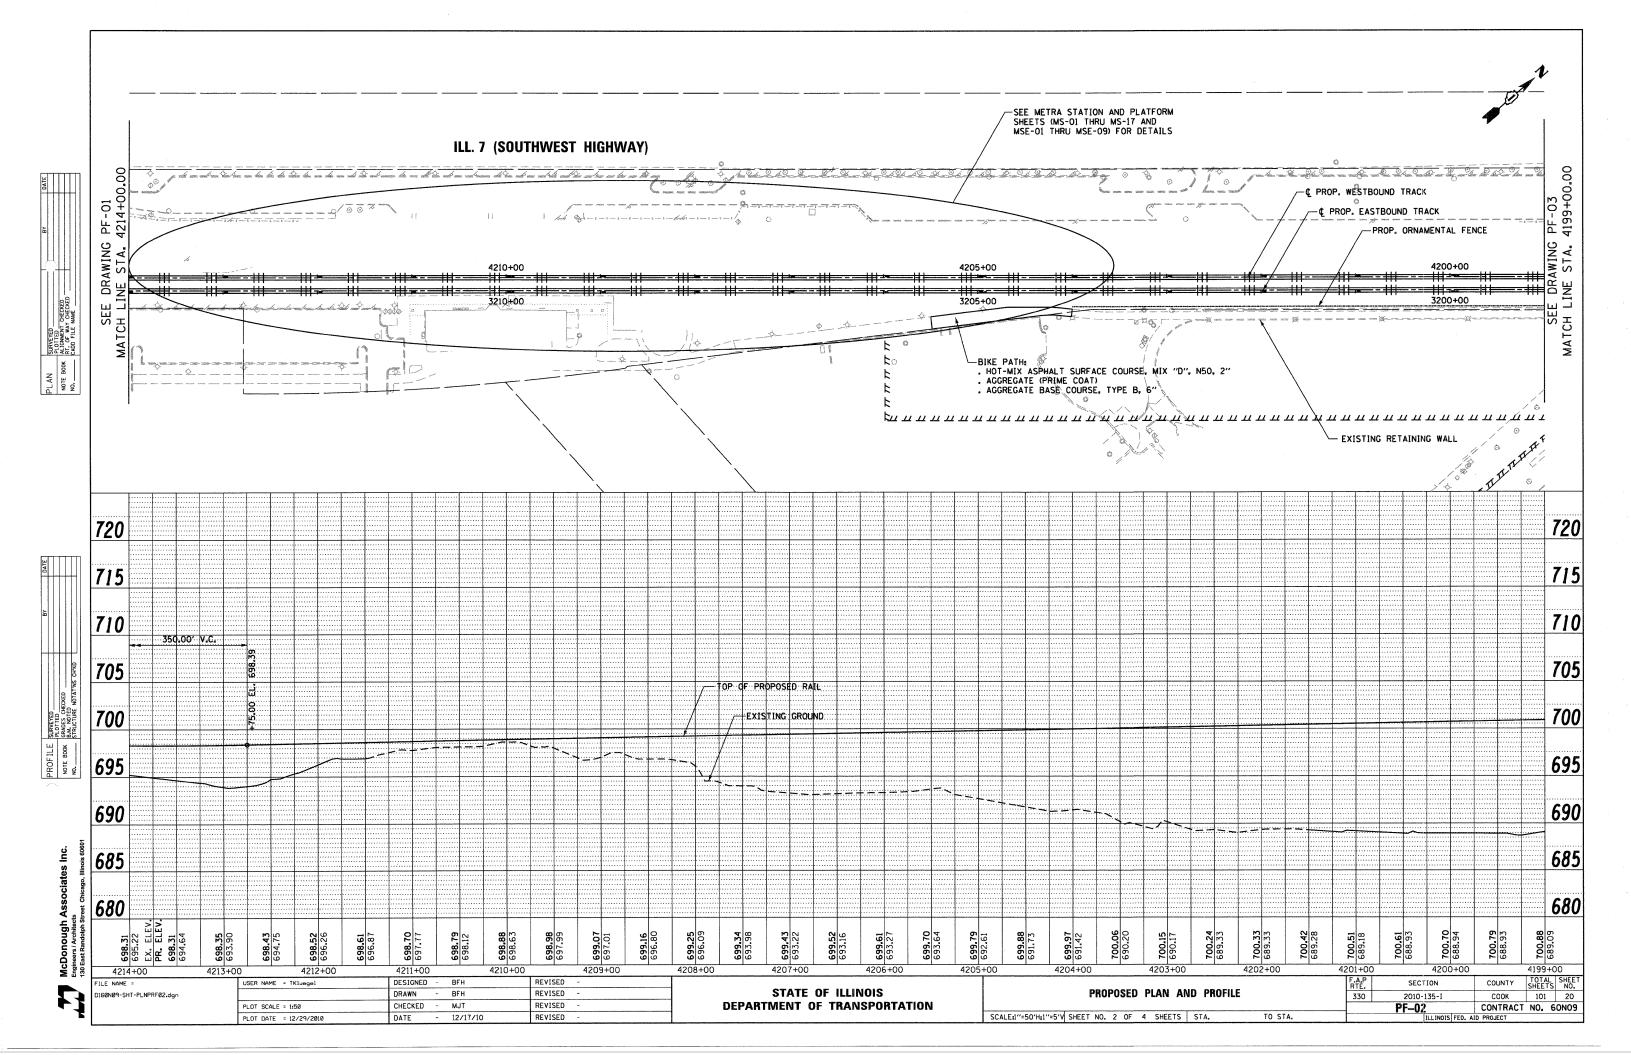

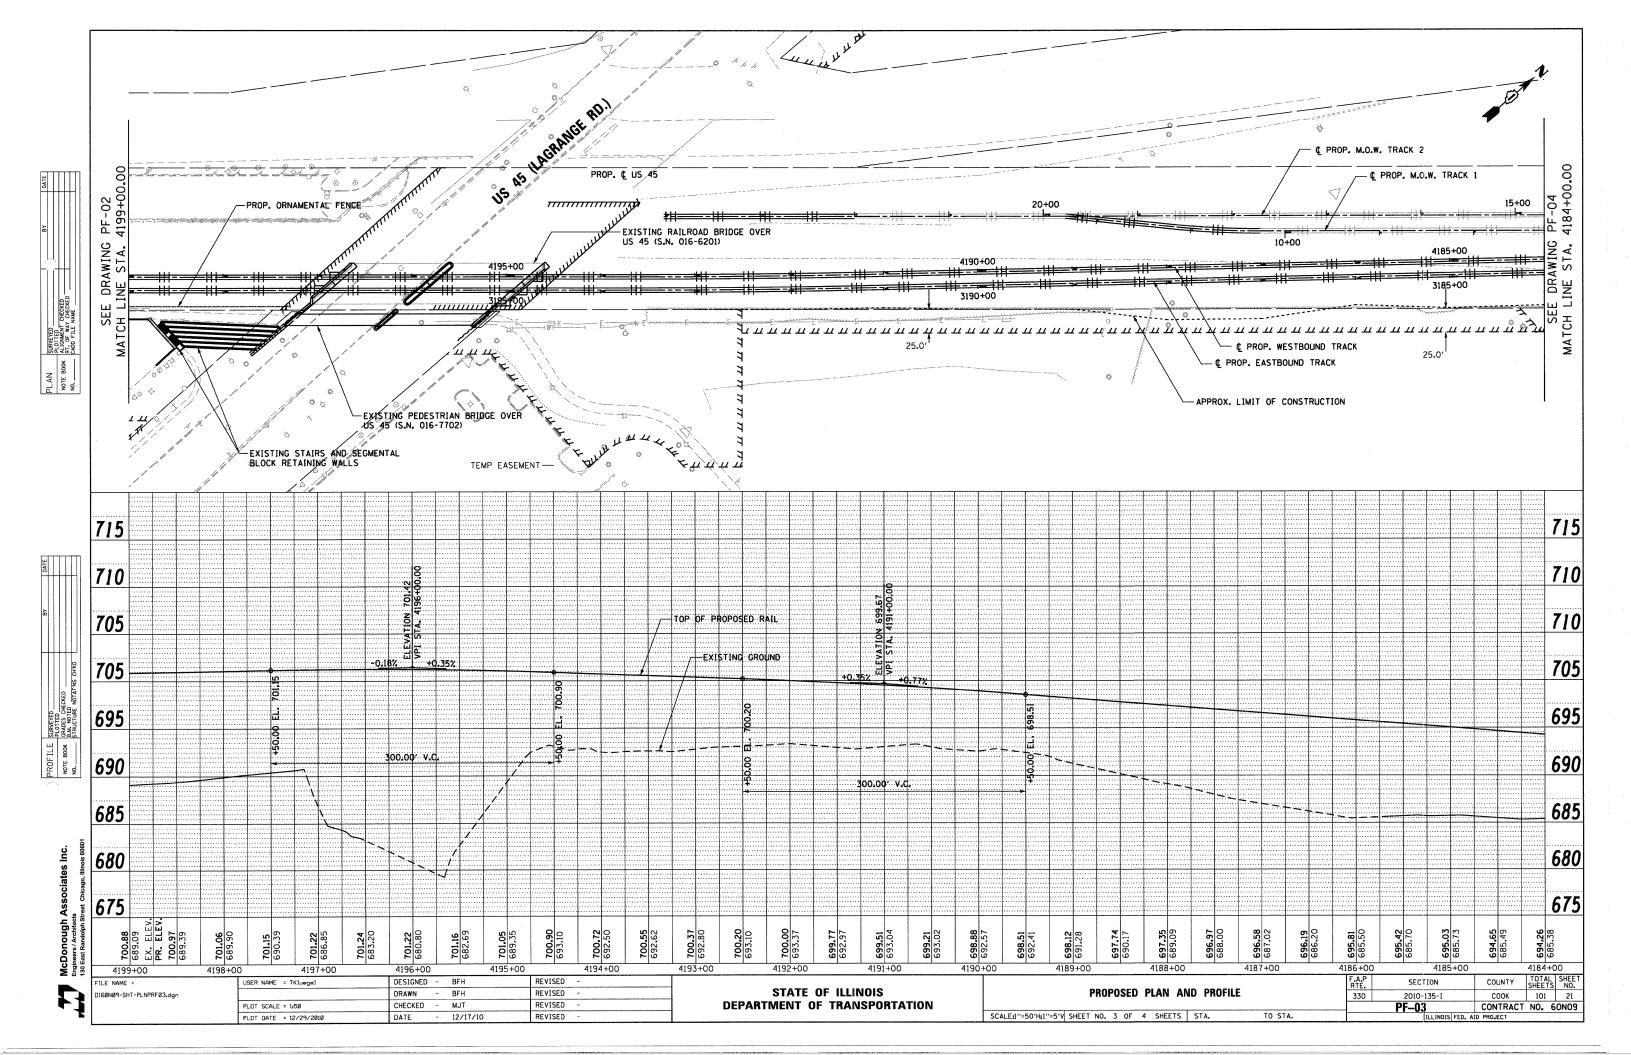

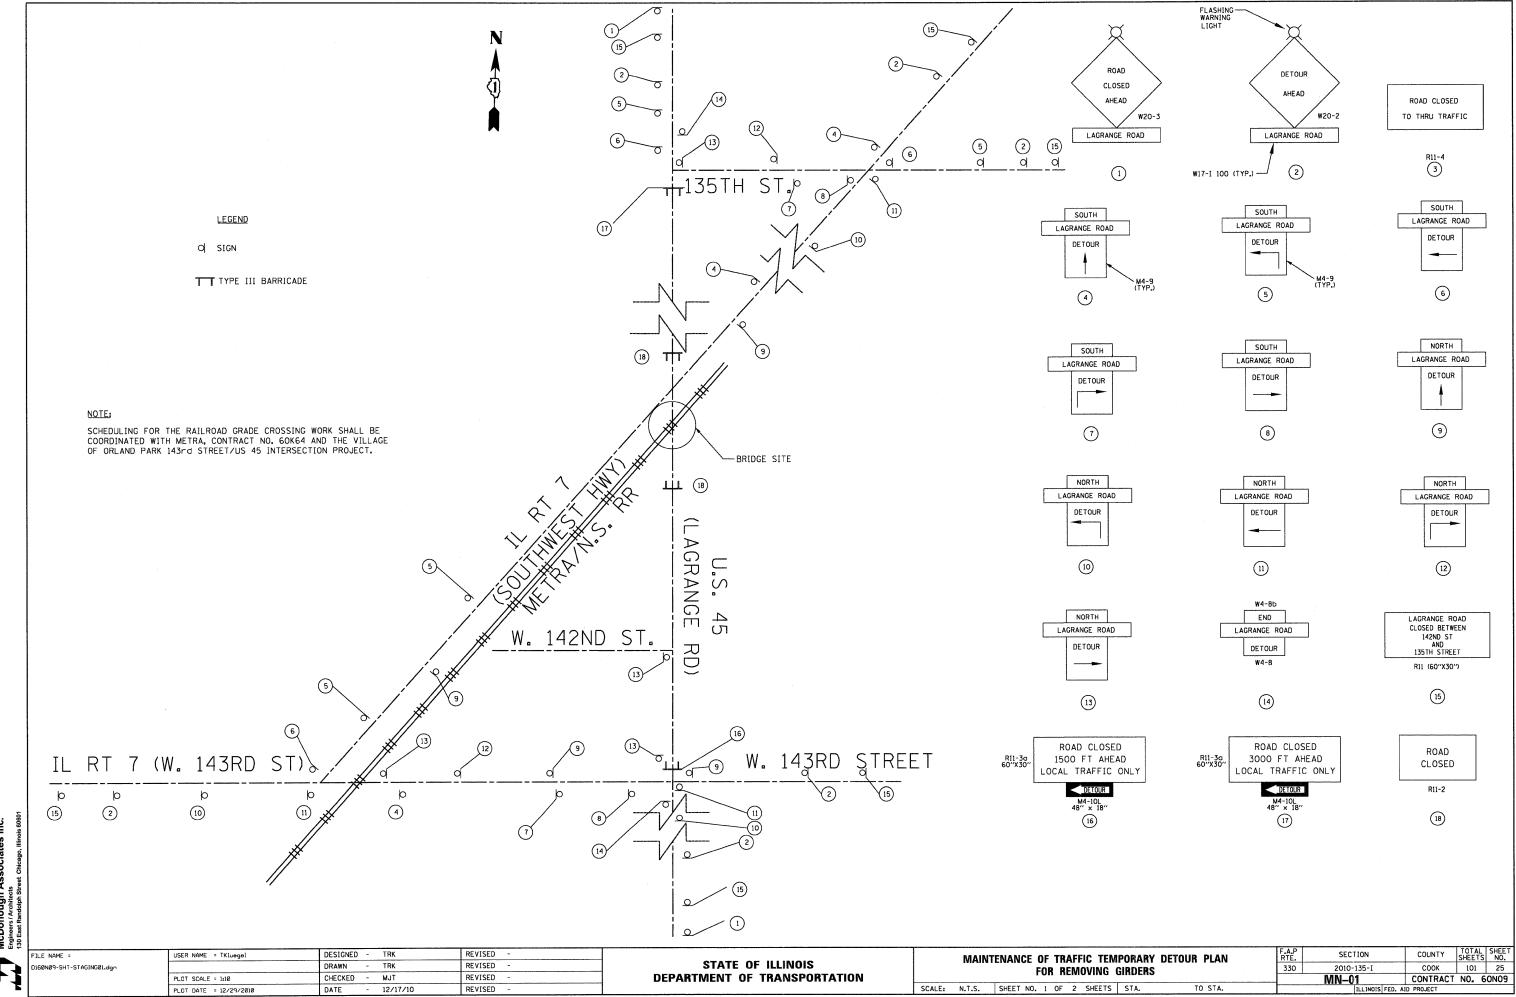

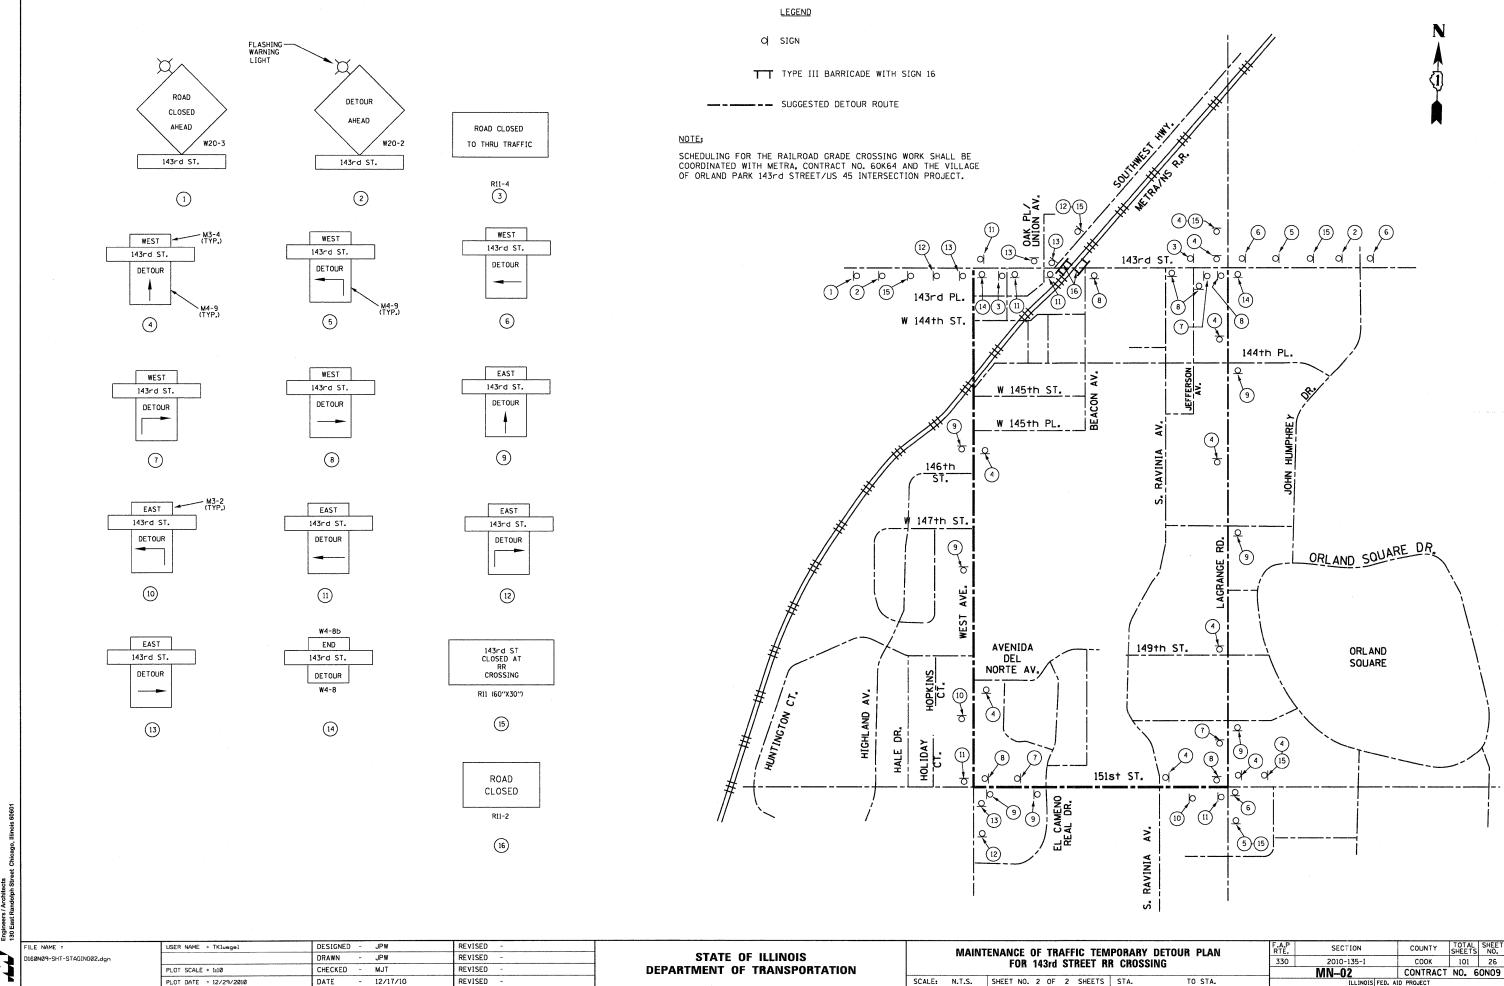

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## EROSION AND SEDIMENT CONTROL GENERAL NOTES

- 1. THE WORK DESCRIBED ON THESE DRAWINGS IS AN INTEGRAL PART OF THE STORM WATER POLLUTION PREVENTION PLAN USED TO OBTAIN A NPDES PERMIT FROM IEPA FOR THE CONSTRUCTION OF THIS PROJECT.
- 2. THE PURPOSE OF THE EROSION AND SEDIMENT CONTROL MEASURES INCLUDED FOR THIS PROJECT IS TO LIMIT THE SEDIMENT POLLUTION IMPACT OF ANY STORM WATER DISCHARGES THAT ORIGINATE ON THIS SITE OR OFF-SITE FLOWS THAT FLOW OVER THE DISTURBED AREAS ON DOWNSTREAM AREAS.
- 3. IT IS THE RESPONSIBILITY OF THE CONTRACTOR TO ENSURE THAT SEDIMENT TRANSPORT OFF THE SITE IS REDUCED BY A COMBINATION OF MINIMIZATION OF EROSION AT THE SOURCE AND INSTALLATION OF SPECIFIC MEASURES TO CONTROL OR REDUCE THE TRANSPORT OF SEDIMENT. A COPY OF THE EROSION AND SEDIMENT CONTROL SCHEDULE BEING IMPLEMENTED BY THE CONTRACTOR WILL BE ON THE CONSTRUCTION SITE AT ALL TIMES.
- 4. TO THE MAXIMUM EXTENT POSSIBLE, ALL FLOWS ORIGINATING OFF THE CONSTRUCTION SITE WILL BE DIVERTED AROUND DISTURBED AREAS OR WILL BE CONVEYED THROUGH THE SITE IN A MANNER THAT UNTREATED ON-SITE RUNOFF DOES NOT MIX WITH THE OFF-SITE RUNOFF.
- ALL RUNOFF ORIGINATING ON DISTURBED AREAS ASSOCIATED WITH THIS PROJECT WILL PASS THROUGH ONE OR MORE MEASURES THAT WILL MINIMIZE THE OFF-SITE SEDIMENT IMPACTS OF THE CONSTRUCTION ACTIVITY.
- ALL PERMANENT SEDIMENT BASINS, PERMANENT STORM WATER CONTROL MEASURES, AND RUNOFF CONTROL MEASURES REQUIRED TO KEEP OFF-SITE RUNOFF FROM FLOWING OVER THE CONSTRUCTION AREA WILL BE INSTALLED BEFORE CLEARING AND STRIPPING OF THE SITE PROCEEDS. PRIOR TO PROCEEDING WITH GENERAL EARTHWORK ON A PROJECT THE CONTRACTOR WILL OBTAIN APPROVAL OF HIS PROPOSED EARTHWORK AND STABILIZATION
- 7. A MAXIMUM OF 10 ACRES MAY BE IN SOME STAGE OF GRADING AT A SINGLE TIME. ADDITIONAL AREAS (UP TO 10 ACRES) MAY BE CLEARED BUT WILL NOT BE STRIPPED OF VEGETATION UNTIL THE GRADED AREAS HAVE BEEN PROTECTED FROM EROSION THROUGH INSTALLATION OF EITHER TEMPORARY OR PERMANENT MEASURES, WHENEVER POSSIBLE, THE GRADING WILL BE COMPLETED TO THE DESIGN GRADE AND THE PERMANENT VEGETATION PLAN IMPLEMENTED PRIOR TO STARTING GRADING ACTIVITIES ON THE NEXT SITE.
  - (A) WHEN BALANCING EARTHWORK (BORROW FROM A CUT USED AS FILL AT A LOCATION DISTANT FROM THE CUT) THE ENGINEER WILL CONSIDER ALLOWING MORE THAN 10 ACRES OF GRADING AT A TIME. THE 10 ACRE LIMITATION DOES NOT INCLUDE HAUL ROADS, BRIDGE CONSTRUCTION WORK AREAS AND STORAGE AREAS.
  - (B) VARIATIONS TO THE ABOVE MAY BE CONSIDERED BY THE ENGINEER UNDER ALL THE FOLLOWING CONDITIONS:
    - . IF THE CONTRACTOR FALLS BEHIND SCHEDULE THROUGH NO FAULT OF HIS OWN.
    - . THE CONTRACTOR MUST PRESENT A SCHEDULE DEMONSTRATING THE NEED FOR SUCH VARIATION IN ORDER TO COMPLETE THE WORK ON TIME.
    - . THE CONTRACTOR MUST COMPLY WITH ALL OTHER CONTRACT REQUIREMENTS.
- 8. DISTURBED AREAS ARE TO BE PROTECTED FROM EROSION IN A TIMELY MANNER. UPON COMPLETION OF GRADING OR CONSTRUCTION, THE AREA WILL BE STABILIZED (USING PERMANENT MEASURES WHEN POSSIBLE) WITHIN 7 CALENDAR DAYS. TEMPORARY STABILIZATION THROUGH USE OF GROUND COVER, MULCHING, OR OTHER APPROVED MEASURES WILL BE INSTALLED WHENEVER SITE DEVELOPMENT WORK, GRADING OR OTHER EARTH DISTURBING ACTIVITIES CEASE TO BE CONTINUOUS FOR A PERIOD EXCEEDING 14 CALENDAR DAYS. THE 7/14 DAY REQUIREMENT IS TAKEN TO MEAN THAT THE STABILIZATION OPERATION IS COMPLETE OR NEARING COMPLETION IN THE DEFINED TIME.
- STABILIZATION OF CUT OR FILL SLOPES WITH TEMPORARY OR PERMANENT EROSION CONTROL MEASURES IS REQUIRED WHENEVER THE CUT OR FILL ACTIVITY REACHES 10 FEET VERTICALLY OR THE FINISHED SLOPE EQUALS 30 FEET, WHICHEVER IS MORE RESTRICTIVE. ONCE THE STABILIZATION MEASURES ARE INSTALLED, THE PLACEMENT OF FILL EXCAVATION ACTIVITIES ARE ALLOWED TO PROCEED.
- 10. THE CONTRACTOR SHALL DESIGNATE ONE OF HIS EMPLOYEES AS RESPONSIBLE FOR IMPLEMENTATION OF THE EROSION AND SEDIMENT CONTROL PLAN ON ALL DISTURBED AREAS. THIS PERSON IS TO BE KNOWLEDGEABLE ABOUT INSTALLATION AND MAINTENANCE OF THE REQUIRED MEASURES AND IS TO HAVE TAKEN AN APPROVED EROSION AND SEDIMENT CONTROL COURSE. THIS EMPLOYEE IS TO HAVE THE AUTHORITY TO CARRY OUT THE IMPLEMENTATION OF ANY INSTRUCTIONS CONCERNING THE EROSION AND SEDIMENT CONTROL PLAN GIVEN BY THE ENGINEER. ALL MEASURES WILL BE INSPECTED BY THIS INDIVIDUAL AND THE ENGINEER ON A REGULAR BASIS (AT LEAST ONCE EVERY 7 DAYS) AND AFTER RAINFALL EVENTS GREATER THAN 0.5 INCH.

## SFF NEXT SHEET FOR CONTINUATION

#### EROSION AND SEDIMENT CONTROL LEGEND

1.\*\*\* SEDIMENT CONTROL, STABILIZED CONSTRUCTION ENTRANCE

PERIMETER EROSION BARRIER

TREE TRUNK PROTECTION DITCH CHECK TEMPORARY

INLET FILTER

TEMPORARY DITCH

DEWATERING BASIN


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DITCH FLOW

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TEMPORARY PIPE SLOPE DRAIN

### EXCAVATION PHASING PLAN-CUT SECTION



NOTES:

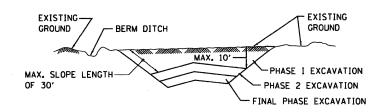- 1. ALL CUT SLOPES SHALL BE EXCAVATED AND STABILIZED (PLACE TOPSOIL, PREPARE SEEDBED, APPLY SEED, PROTECT SLOPE WITH MULCH OR EROSION BLANKET) AS THE WORK PROGRESSES.
- 2. CONSTRUCTION SEQUENCE FOR EXCAVATION:
- (A) EXCAVATE AND STABILIZE BERM, SIDE AND OUTLET DITCHES, PROVIDE SEDIMENT TRAPS FOR DITCHES.
- (B) PERFORM PHASE 1 EXCAVATION AND STABILIZE SLOPES WITH PERMANENT SEEDING.
- (C) PERFORM PHASE 2 EXCAVATION AND STABILIZE SLOPES WITH PERMANENT SEEDING, OVERSEED PHASE 1 SLOPES, IF REQUIRED.
- (D) PERFORM FINAL PHASE EXCAVATION, AND STABILIZE WITH PERMANENT VEGETATIVE PLAN ON THE ENTIRE SLOPE. STABILIZE SURFACE DRAIN DITCHES. OVERSEED PHASE 1 & 2 SLOPES, IF REQUIRED, AS DETERMINED BY THE ENGINEER.
- 3. IF PERMANENT SEEDING CANNOT BE PLACED DUE TO CONTRACT REQUIREMENTS REGARDING PLANTING SEASONS, THE CUT SLOPE IS TO HAVE TOPSOIL PLACED AND SEEDBED PREPARED PRIOR TO USING TEMPORARY STABILIZATION WITH STRAW MULCH OR TEMPORARY SEEDING WITH EROSION BLANKET.
- 4. THE CONTRACTOR HAS THE OPTION OF DELAYING TOPSOIL AND/OR SEEDING BEYOND THE 10 FOOT VERTICAL LIMITATION. (SEE GENERAL NOTE 9) IF SO THE CUT SLOPE MUST BE TEMPORARILY STABILIZED AT NO COST TO THE DEPARTMENT.
- 5. ONCE THE EXCAVATION WITHIN A SPECIFIC AREA HAS BEGUN, THE OPERATION SHALL BE CONTINUOUS FROM STRIPPING THROUGH THE COMPLETION OF THE GRADING AND PLACEMENT OF SLOPE STABILIZATION MEASURES. ANY INTERRUPTIONS IN THE OPERATION 14 DAYS OR MORE MUST BE APPROVED BY THE ENGINEER. ANY VIOLATIONS OF THIS REQUIREMENT WILL RESULT IN THE CONTRACTOR ASSUMING THE RESPONSIBILITY OF PLACING TEMPORARY STABILIZATION AT HIS OWN COST AND EXPENSE AS DIRECTED BY THE ENGINEER.

## INLET AND PIPE PROTECTION


STONE OUTLET STRUCTURE SEDIMENT TRAP

EROSION CONTROL BLANKET WITH TEMPORARY EROSION CONTROL SEEDING



TEMPORARY EROSION CONTROL SEEDING WITH MULCH METHOD 2

#### EMBANKMENT PHASING PLAN-FILL SECTION

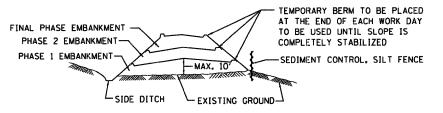

NOTES:

- 1. THE EMBANKMENT WILL BE MADE IN STAGES NOT TO EXCEED 10'. THE EMBANKMENT SLOPES WILL BE STABILIZED USING TEMPORARY MEASURES BEFORE BEGINNING NEXT STAGE.
- 2. AT THE END OF EACH WORK DAY TEMPORARY BERMS (EARTH) AND TEMPORARY PIPE SLOPE DRAINS WILL BE CONSTRUCTED ALONG THE TOP EDGE(S) OF THE EMBANKMENT TO INTERCEPT SURFACE RUNOFF.
- 3. CONSTRUCTION SEQUENCE FOR EMBANKMENT
  - (A) EXCAVATE AND STABILIZE SIDE DITCH AND/OR INSTALL PROPOSED PERIMETER CONTROLS AT THE TOE OF SLOPE.
  - (B) PLACE PHASE 1 EMBANKMENT AND STABILIZE WITH TEMPORARY SEEDING AND MULCH.
- (C) PLACE PHASE 2 EMBANKMENT AND STABILIZE WITH TEMPORARY SEEDING AND MULCH.
- (D) PLACE FINAL PHASE EMBANKMENT AND STABILIZE WITH PERMANENT VEGETATIVE PLAN ON THE ENTIRE SLOPE.

TO STA.

4. ONCE THE PLACEMENT OF FILL WITHIN A SPECIFIC AREA HAS BEGUN, THE OPERATION SHALL BE CONTINUOUS FROM STRIPPING THROUGH THE COMPLETION OF THE GRADING AND PLACEMENT OF PERMANENT VEGETATIVE PLAN. ANY INTERRUPTIONS IN THE OPERATION OF 14 DAYS OR MORE MUST BE APPROVED BY THE ENGINEER. ANY VIOLATION OF THIS REQUIREMENT WILL RESULT IN THE CONTRACTOR ASSUMING THE RESPONSIBILITY OF PLACING TEMPORARY STABILIZATION AT HIS OWN COST AND EXPENSE AS DIRECTED BY THE ENGINEER.

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STATE OF ILLINOIS **DEPARTMENT OF TRANSPORTATION**  **EROSION AND SEDIMENT CONTROL GENERAL NOTES AND LEGEND** 

SECTION 330 2010-135-I COOK 101 27 CONTRACT NO. 60N09 EN-01

SCALE: N.T.S. SHEET NO. 1 OF 2 SHEETS STA.

# EROSION AND SEDIMENT CONTROLS GENERAL NOTES (CONTD.)

- 11. SEDIMENT TRAPS, SEDIMENT BASINS, DITCHES, SEDIMENT CONTROL, SILT FENCE, STONE OUTLET STRUCTURES, EARTH BERMS, ETC. SHALL BE MAINTAINED DURING THE CONSTRUCTION SEASON AS WELL AS THE WINTER MONTHS AND OTHER TIMES WHEN THE PROJECT IS CLOSED DOWN. TRAPS WILL BE CLEANED WHEN THEY ARE 50% FILLED, SILT FENCE & STONE OUTLET STRUCTURES SHALL HAVE SEDIMENT REMOVED WHEN IT REACHES 50%. THE HEIGHT OF THE CONTROL DEVICE. THESE SPOILS WILL BE REMOVED TO AN APPROVED SITE.
- 12. SALVAGED TOPSOIL SHALL BE PLACED ON WELL DRAINED LAND AWAY FROM INTERMITTENT AND LIVE STREAMS OR WETLANDS WITH THE APPROPRIATE RUNOFF CONTROL AND SEDIMENT CONTROL MEASURES INSTALLED AROUND THE STORAGE SITE, AND STABILIZED IMMEDIATELY AFTER FINAL SHAPING OF THE PILE IN ACCORDANCE WITH MULCH, METHOD 2. THE CONTRACTOR WILL PROVIDE AN ADEQUATE QUANTITY OF SILT FENCE TO CONTROL THE PERIMETER OF THE STOCKPILE.
- 13. MATERIALS EXCAVATED FOR THE CONSTRUCTION OR CLEANOUT OF SEDIMENT TRAPS OR SEDIMENT BASINS SHALL NOT BE STOCKPILED IN THE VICINITY OF THE TRAP OR BASIN. IT WILL EITHER BE PLACED IN AN EMBANKMENT OR WASTED AS DIRECTED BY THE ENGINEER.
- 14. EXCAVATION TO BE USED FOR EMBANKMENTS SHALL NOT BE STOCKPILED UNLESS PERIMETER CONTROLS ARE UTILIZED. WHEN THIS MATERIAL IS STOCKPILED FOR THE CONVENIENCE OF THE CONTRACTOR THE COST OF THE CONTROLS ARE BORNE BY THE CONTRACTOR. IF THE MATERIAL IS STOCKPILED AT THE DIRECTION OF THE ENGINEER THE DEPARTMENT WILL ASSUME THE COSTS OF THE CONTROLS.
- 15. SEDIMENT LADEN DEWATERING DISCHARGE MUST BE DIRECTED TO AN APPROVED SEDIMENT TRAPPING MEASURE PRIOR TO RELEASE FROM THE SITE.
- 16. WHEN THE CONTRACTOR REQUESTS A CHANGE TO POSTPONE COMPLETION OF THE EXCAVATION OF A SPECIFIC AREA AS A CONTINUOUS OPERATION AND PLACING THE TOPSOIL AS DEFINED IN THE STANDARD SPECIFICATIONS, THE ENGINEER MAY ALLOW THE CONTRACTOR TO STABILIZE THE AREA USING TEMPORARY STABILIZATION WITH STRAW MULCH PROVIDING THE FOLLOWING CONDITIONS ARE MET:
  - (A) ALL AREAS BEING STABILIZED ARE 3:1 SLOPES OR FLATTER.
  - (B) THE CONTRACTOR BEARS THE COST OF PREPARING THE SEED BED AND STABILIZING THE AREA WITH TEMPORARY STABILIZATION WITH STRAW MULCH.
  - (C) ALL REQUIRED SEDIMENT CONTROL MEASURES FOR THE SECTION OF ROAD IN QUESTION HAVE BEEN INSTALLED AND ARE BEING MAINTAINED.
- 17. SEEDING USAGE
  - CLASS 2A SALT TOLERANT ROADSIDE MIX USED FOR NEW CONSTRUCTION OF LIMITED ACCESS ROUTES INTENDED TO BE MOWED BY IDOT.
  - CLASS 4A LOW PROFILE NATIVE GRASS USED IN THE INACCESSIBLE AREAS AT NORTH AND SOUTH ENDS OF PROJECT.

TEMPORARY EROSION CONTROL SEEDING: USED IN AREAS REQUIRING SHORT TERM TEMPORARY SEEDING DURING CONSTRUCTION.

- 18. TOP SOIL PLACEMENT: TOPSOIL WILL BE PLACED ON FINAL SLOPES WHICH WILL NOT BE DISTURBED BY FUTURE CONSTRUCTION. TOPSOIL WILL NOT BE PLACED ON SURFACES WHICH WILL BE PAVED IN THE FUTURE NOR ON TEMPORARILY STEEP SLOPES.
- 19. IN AREAS WHERE A PERMANENT VEGETATIVE COVER IS PRACTICABLE AND INCLUDED IN THE CONTRACT DOCUMENTS, A SPECIAL EFFORT SHOULD BE MADE TO ESTABLISH A COVER AS SOON AS A DISTURBED AREA IS BROUGHT TO FINAL GRADE.
- 20. EXISTING TRACK DITCHES SHALL BE MAINTAINED AT ALL TIMES THROUGHOUT THE CONSTRUCTION PERIOD. AFTER THE CONSTRUCTION HAS BEEN COMPLETED, ALL EROSION CONTROL DEVICES MUST BE REMOVED, ALL DEPOSITS OF SILT REMOVED, AND THE DITCHES MUST BE RESTORED.



## STATE OF ILLINOIS

**DEPARTMENT OF TRANSPORTATION** 


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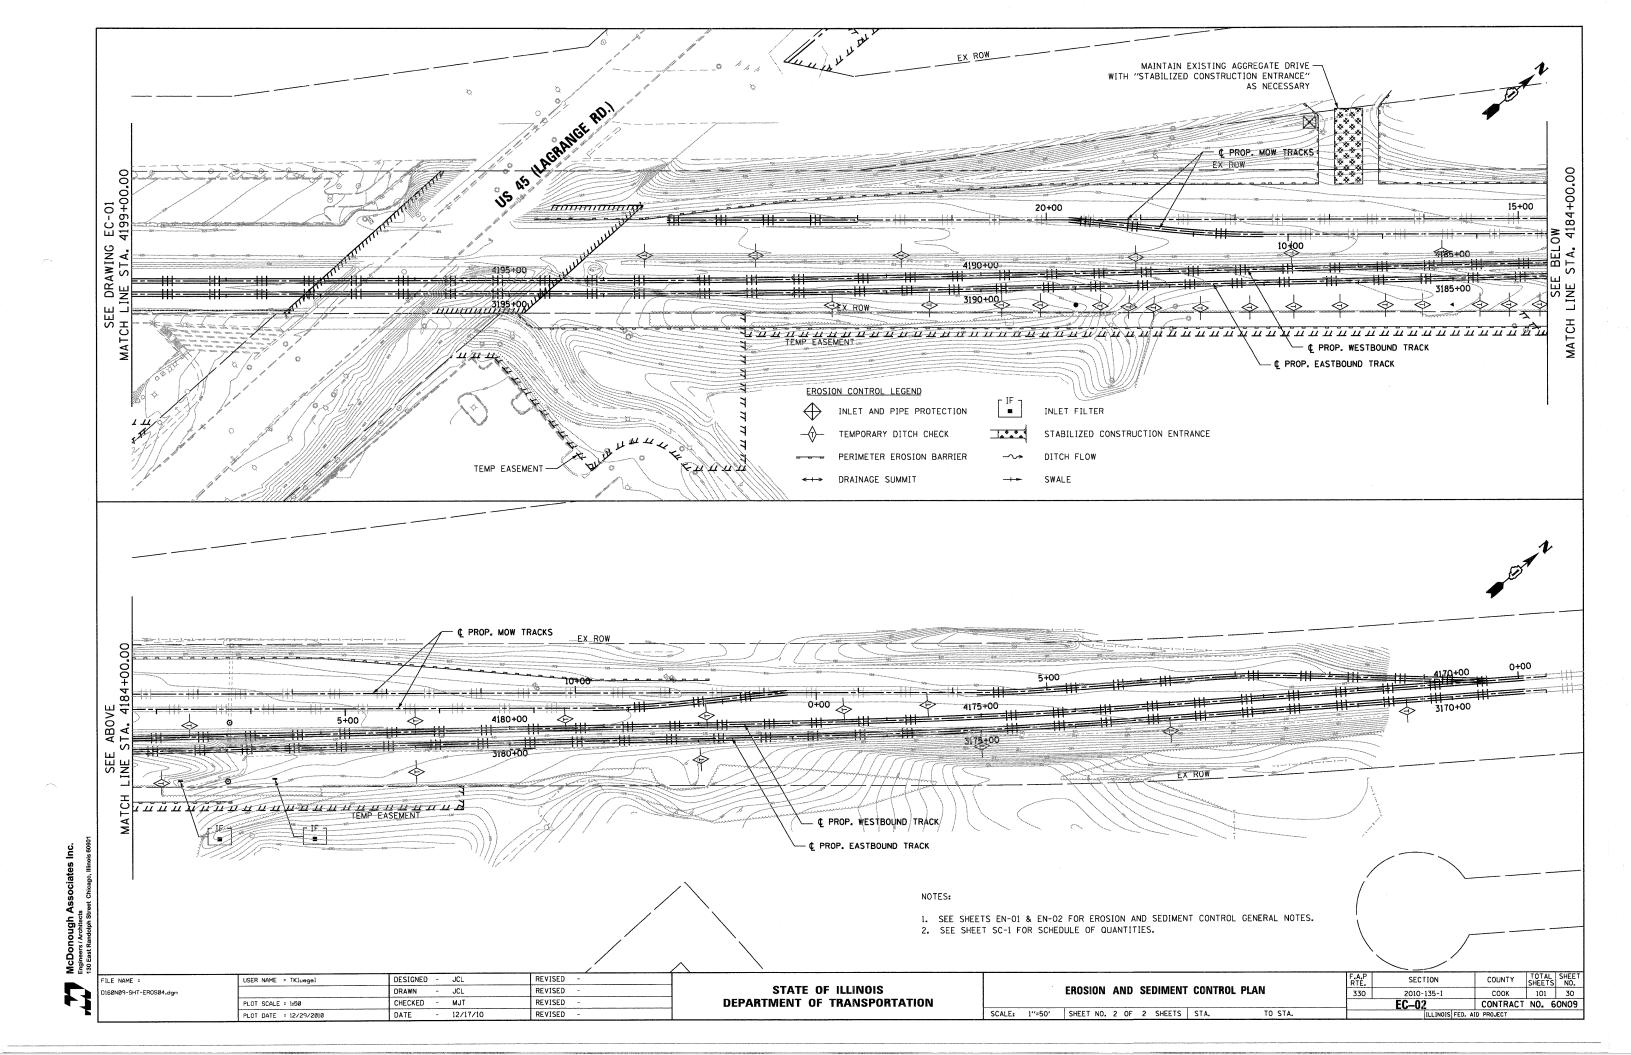
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#### EROSION AND SEDIMENT CONTROL (ESC) STRATEGY


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RECEIVING WATERS: McGinnis Slough

- . ERECT PERIMETER EROSION BARRIER AS SHOWN ON THE PLANS, ESTABLISH STABILIZED CONSTRUCTION ENTRANCES, CLEAR AND GRUB, REMOVE EXISTING TREES AS NECESSARY.
- . INSTALL INLET FILTERS AT EXISTING CATCH BASINS AND OPEN LID MANHOLES. INSTALL INLET & PIPE PROTECTION UPSTREAM OF ALL CULVERTS.
- EXCAVATE AND CONSTRUCT EMBANKMENT FOR PROPOSED TRACKS. ESTABLISH PROPOSED DITCHES, STABILIZE WITH EROSION CONTROL BLANKET AND SEEDING. INSTALL TEMPORARY DITCH CHECKS AT 18" VERTICAL INTERVALS.
- . INSTALL INLET FILTERS AT 143RD STREET STRUCTURES AND AT STRUCTURES ON LAGRANGE ROAD UNDER THE EXISTING AND PROPOSED STRUCTURES.
- . ESTABLISH PERIMETER EROSION BARRIER ADJACENT TO THE EXISTING TRACKS AND PLACE INLET FILTERS AT CATCH BASINS AND OPEN LID MANHOLES NORTH AND WEST OF THE EXISTING TRACKS PRIOR TO DEMO OF EXISTING TRACKS AND BRIDGE. LINE ADJACENT DITCHES WITH TEMPORARY DITCH CHECKS.
- . INSPECT AND MAINTAIN ALL EROSION AND SEDIMENT CONTROL MEASURES FOR THE DURATION OF CONSTRUCTION.
- . WHEN FINAL STABILIZATION IS ESTABLISHED, REMOVE ALL TEMPORARY MEASURES.



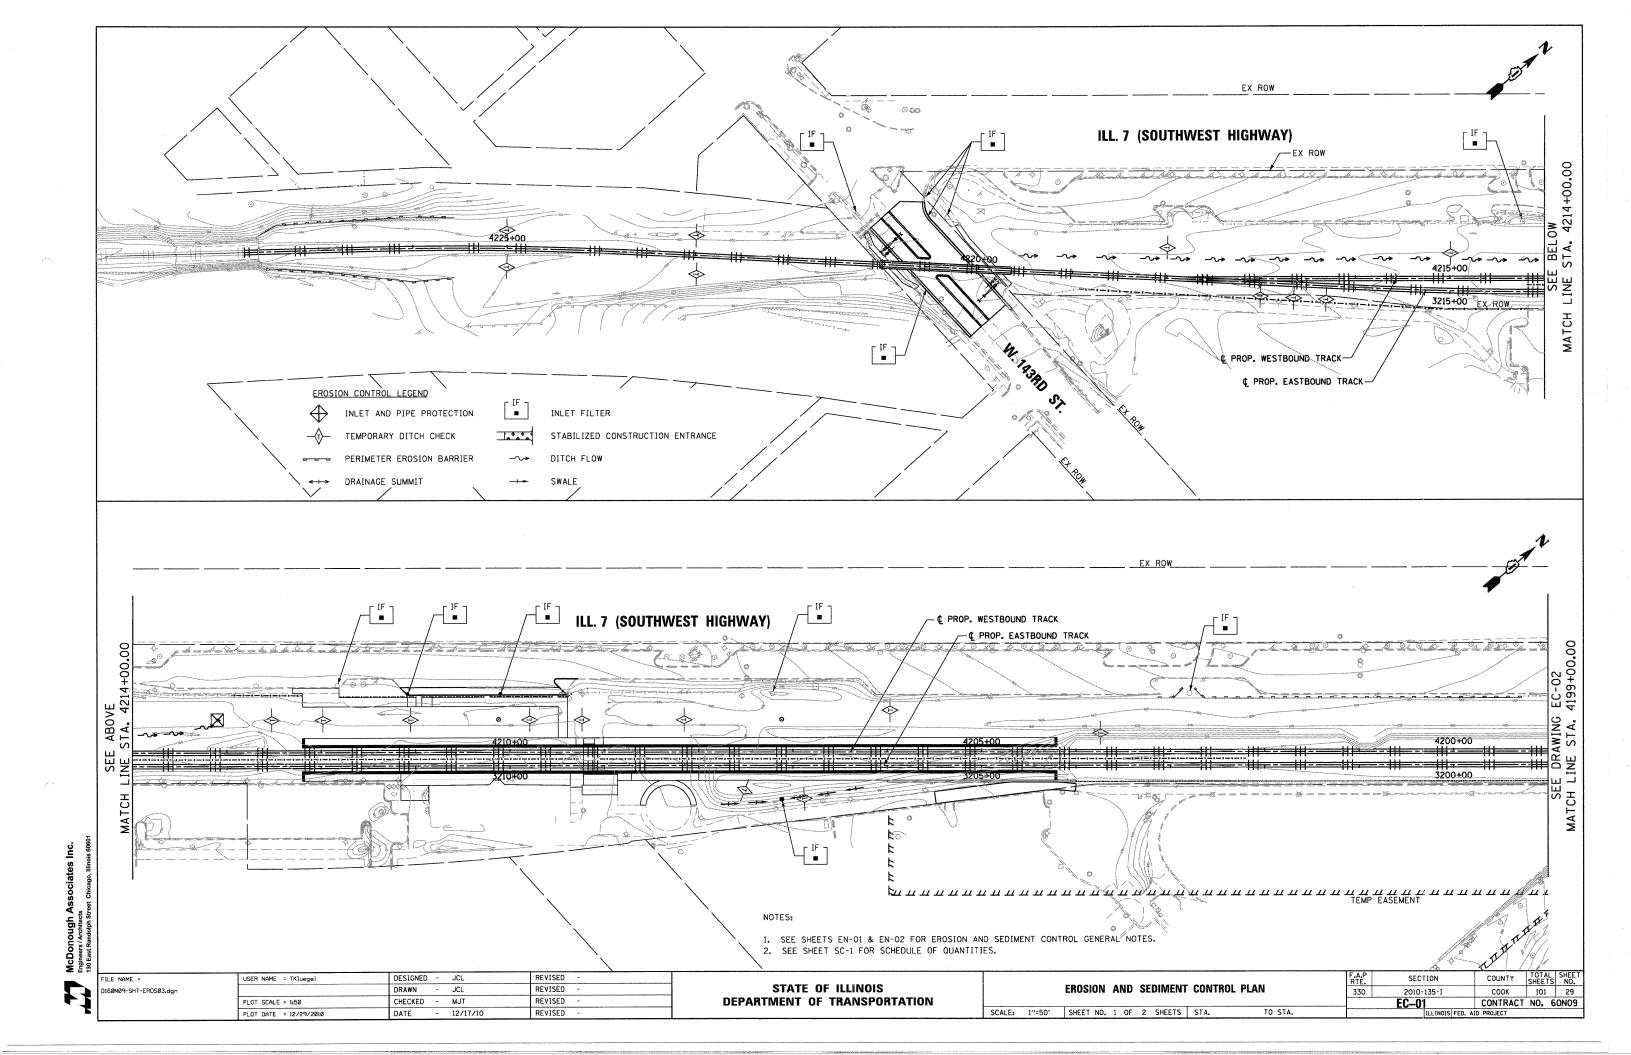

# SECTION A-A

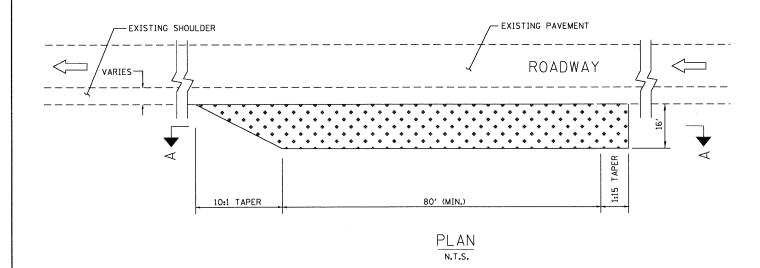

LEGEND

STABILIZED AGGREGATE DRIVEWAY

## CONSTRUCTION SPECIFICATIONS AND NOTES

- STABILIZED CONSTRUCTION ENTRANCE

  A. LENGTH AS REQUIRED, BUT NOT LESS THAN 80 FEET.

  B. THICKNESS NOT LESS THAN 4", ABOVE TOP OF
  - CELLULAR CONFINEMENT GRID.
- EXISTING DITCH DRAINAGE TO BE MAINTAINED.
- GRADE FILL TO 1:10 ON APPROACH SIDE OF ENTRANCE

## STABILIZED CONSTRUCTION ENTRANCE


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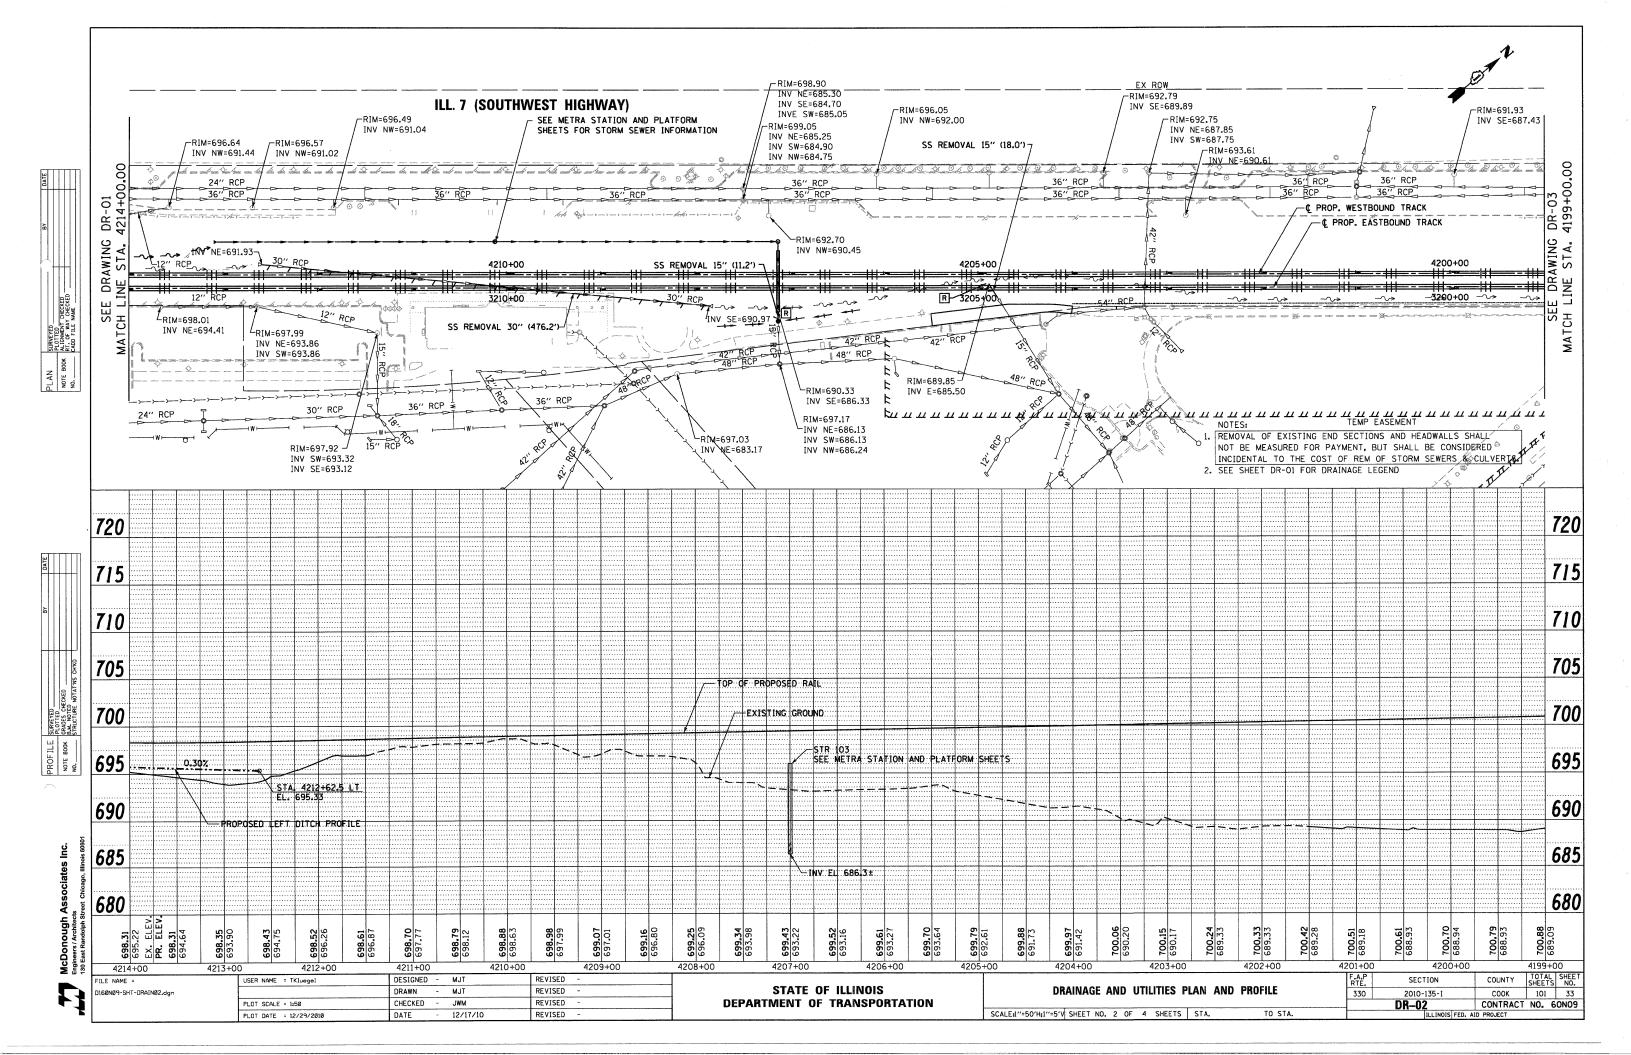
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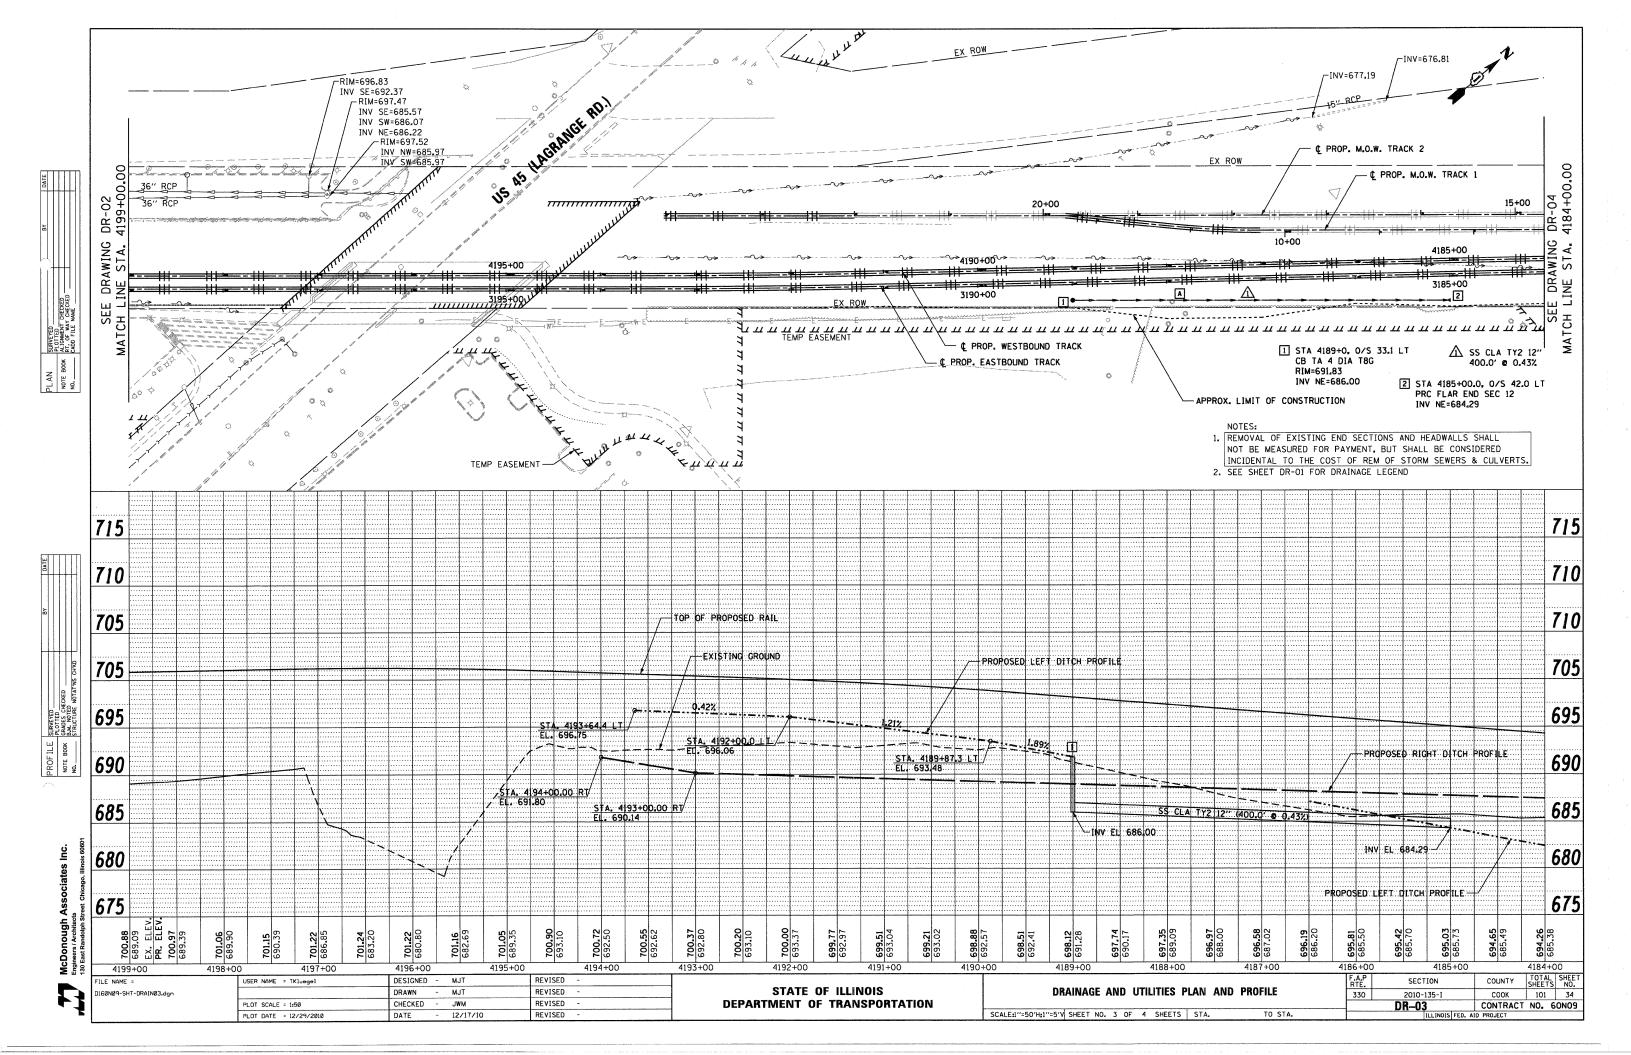
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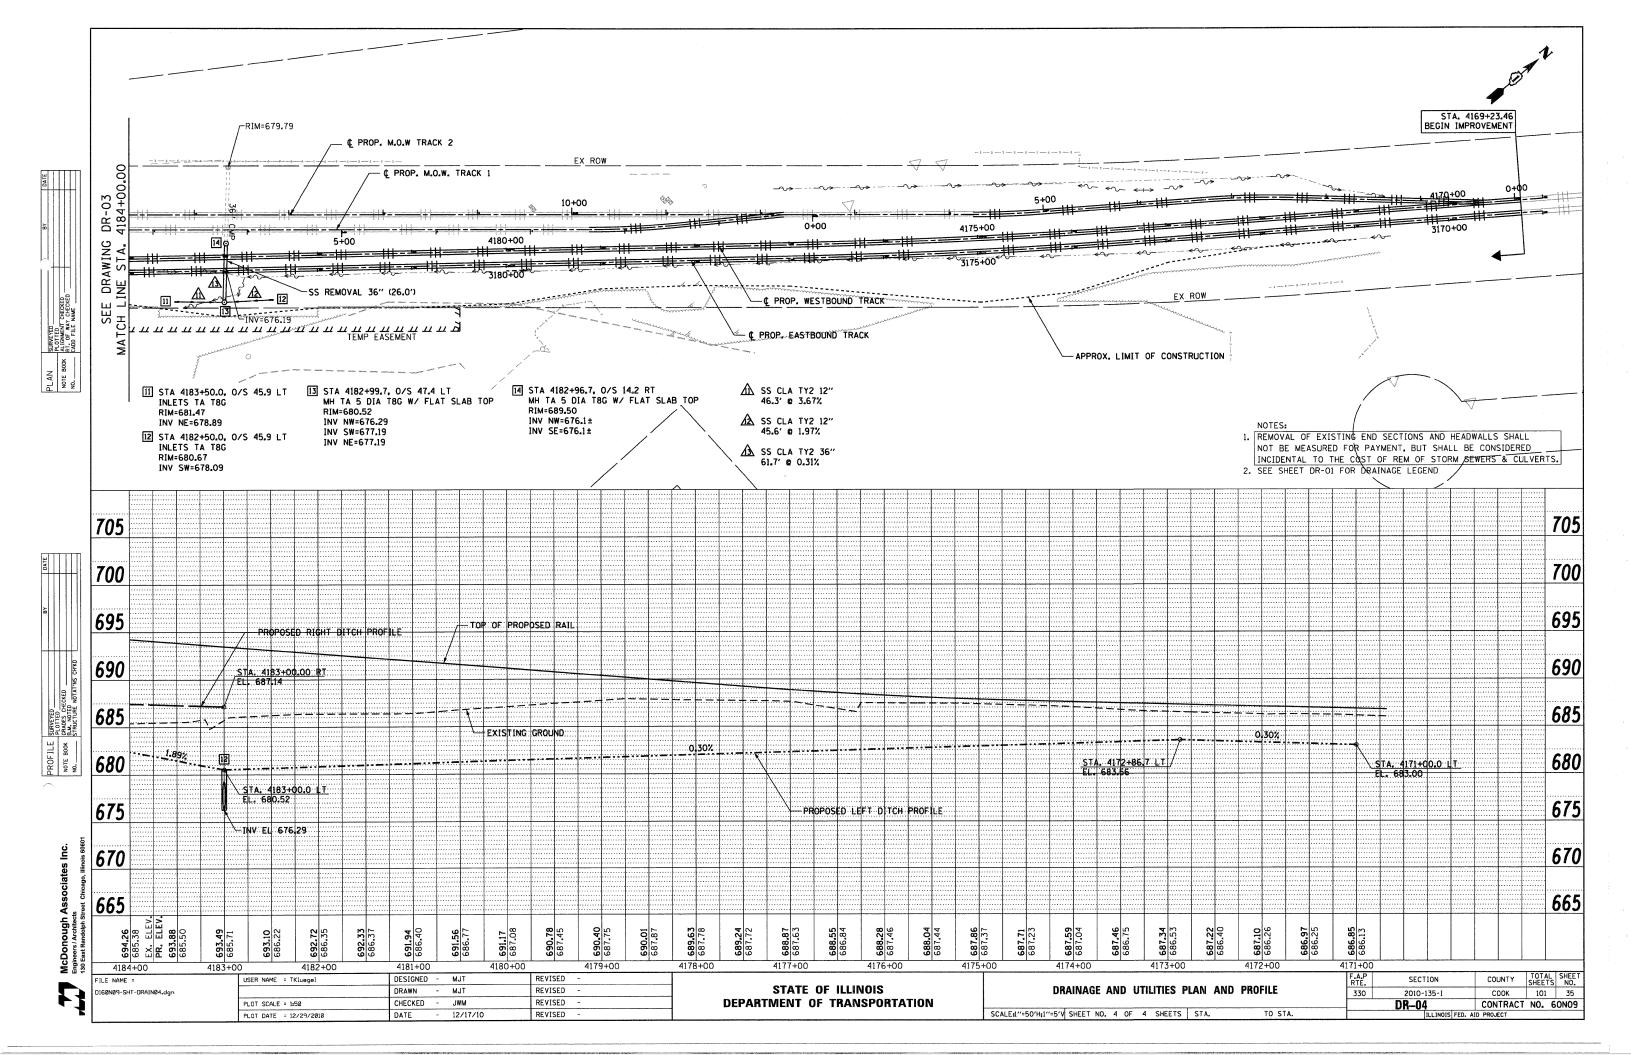
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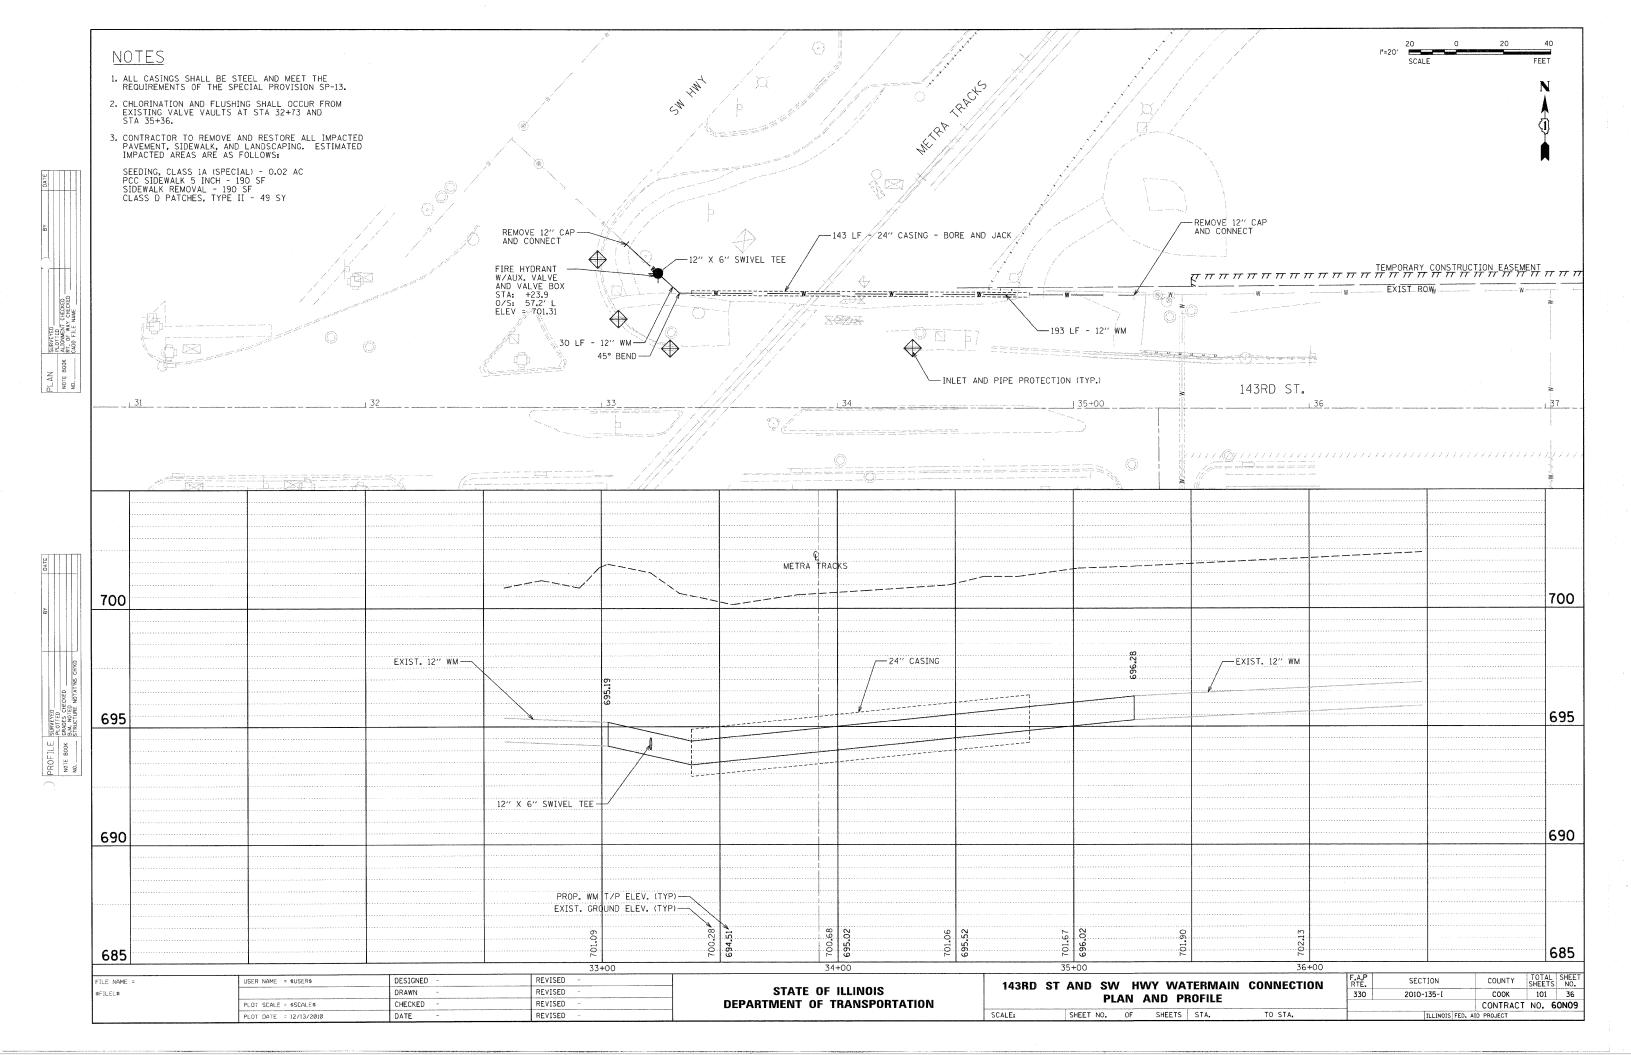
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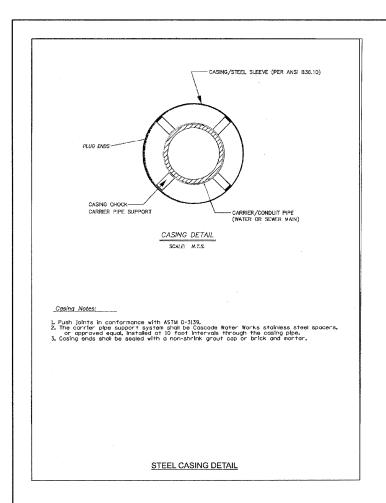














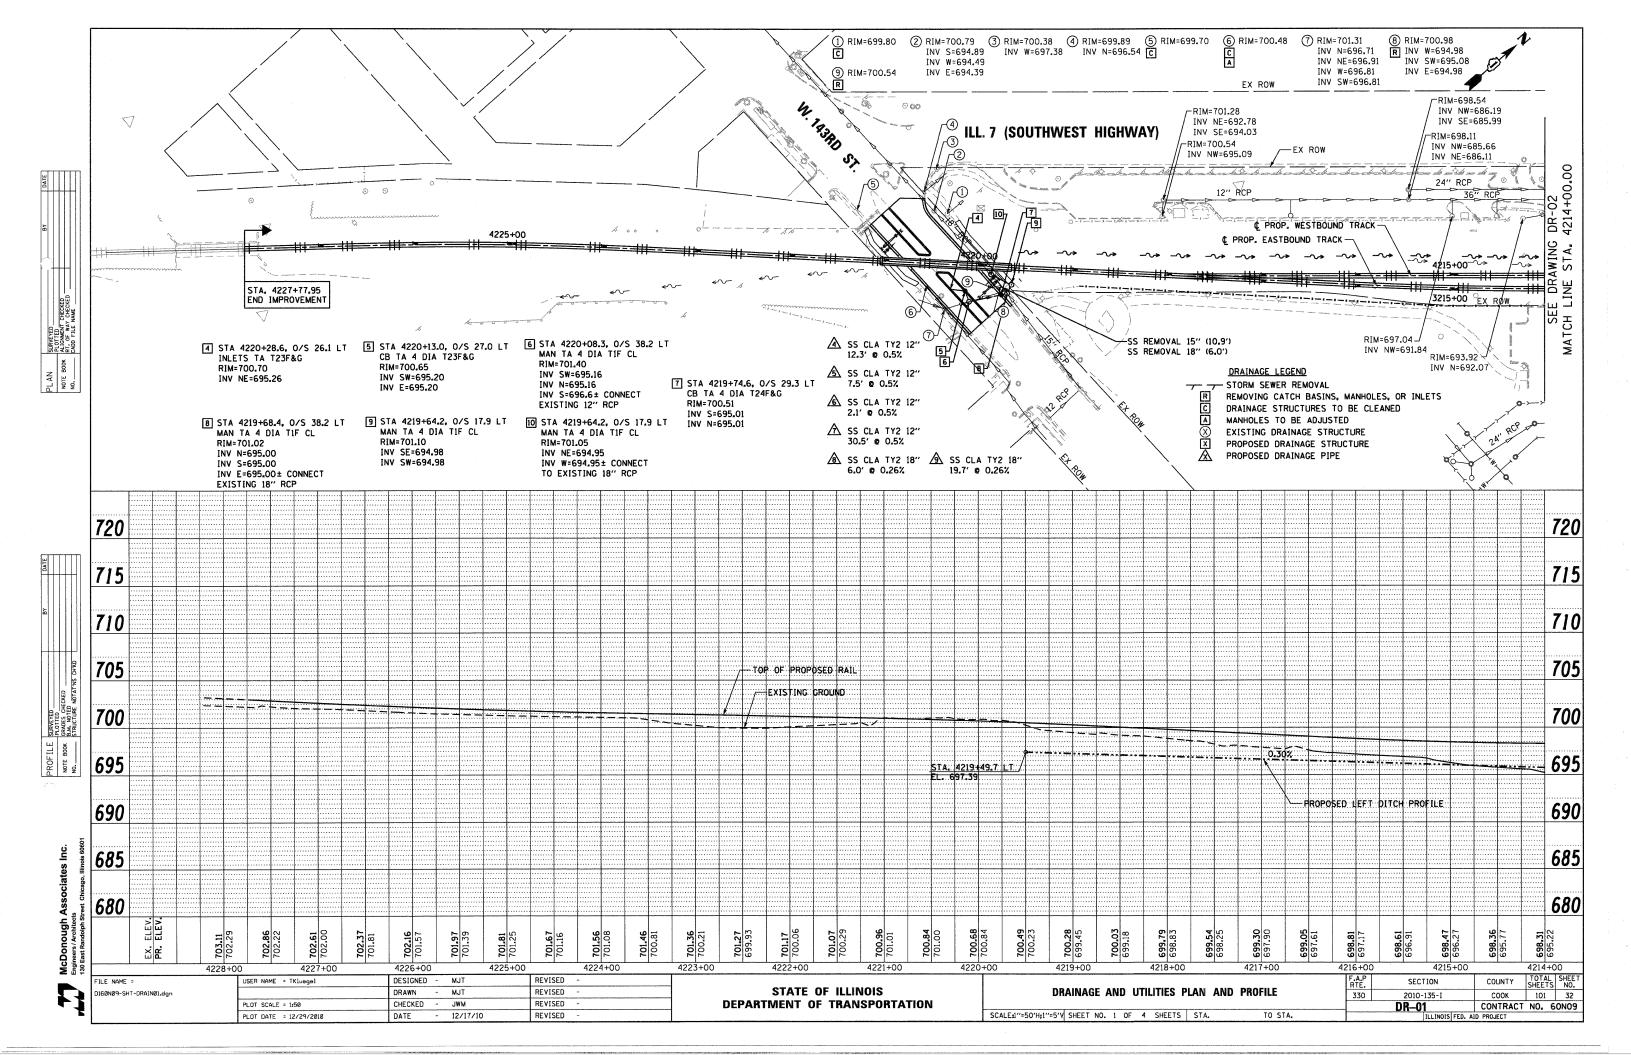


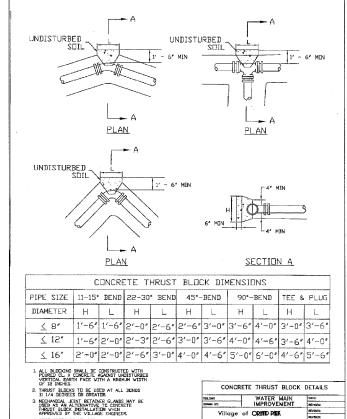


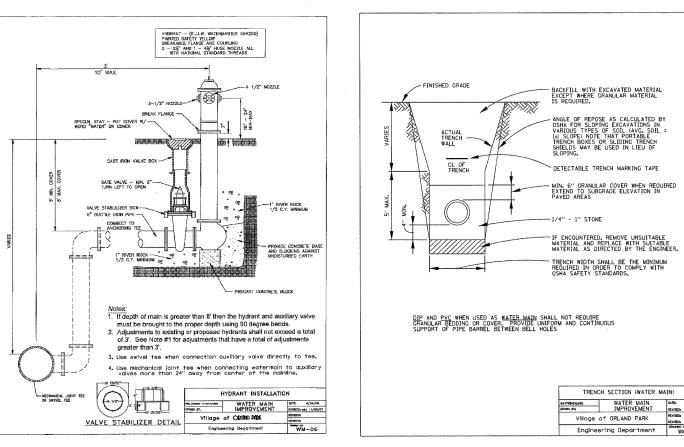

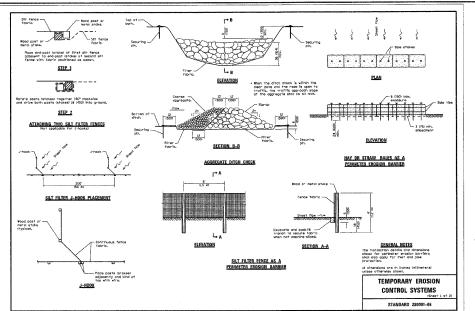

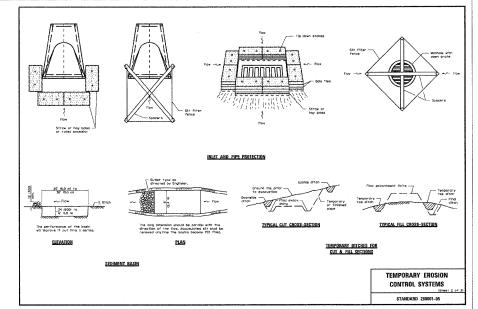

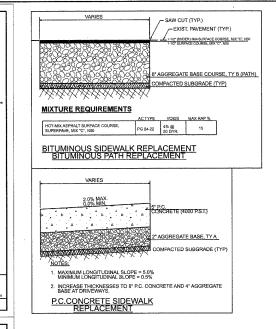


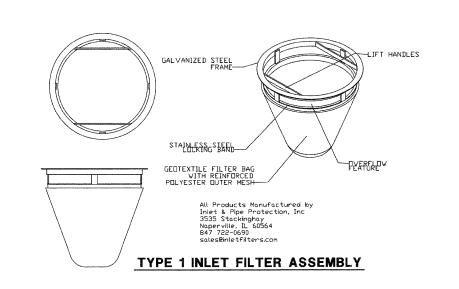



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STATE OF ILLINOIS
DEPARTMENT OF TRANSPORTATION

143RD S	T AND S	N F	IWY WA	TERMAIN	CONNECTION	F.A.P RTE.	SECTION	COUNTY	TOTAL SHEETS	SHEET NO.
				DETAILS		330	2010-135-I	соок	101	37
	COI	40111	OCHON	DLIMILO				CONTRACT	NO. 6	ON09
CALE: NONE	SHEET NO.	OF	SHEETS	STA.	TO STA.		ILLINOIS FED. AI	D PROJECT		



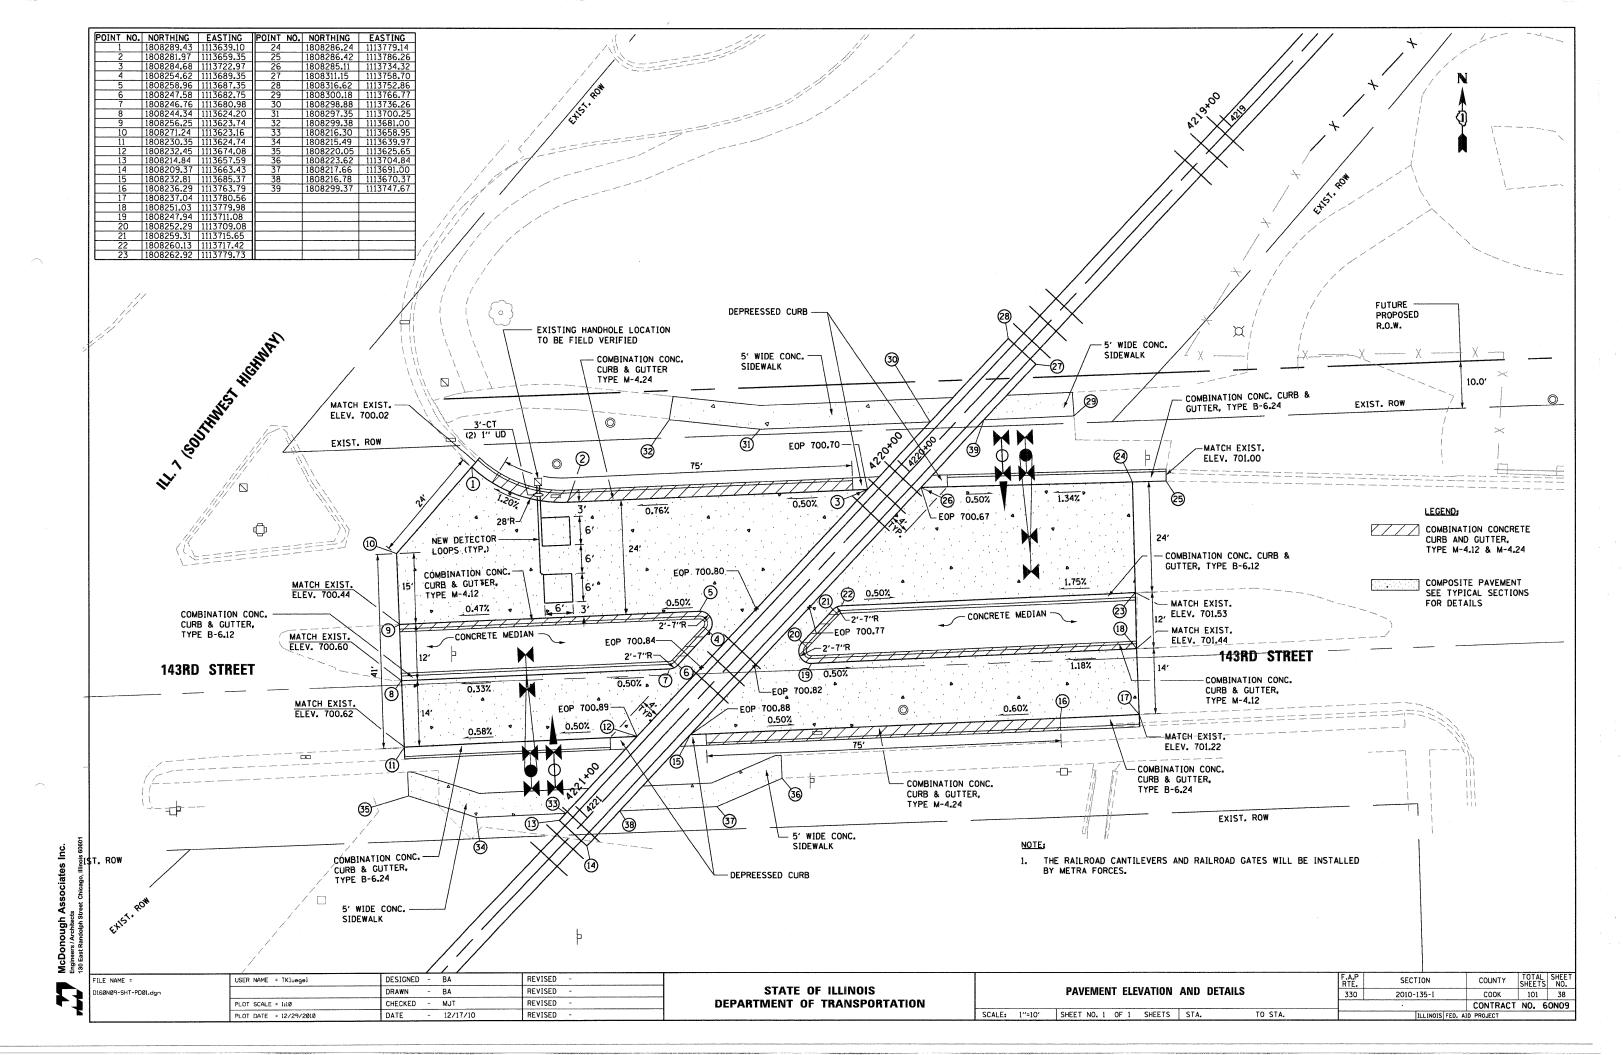

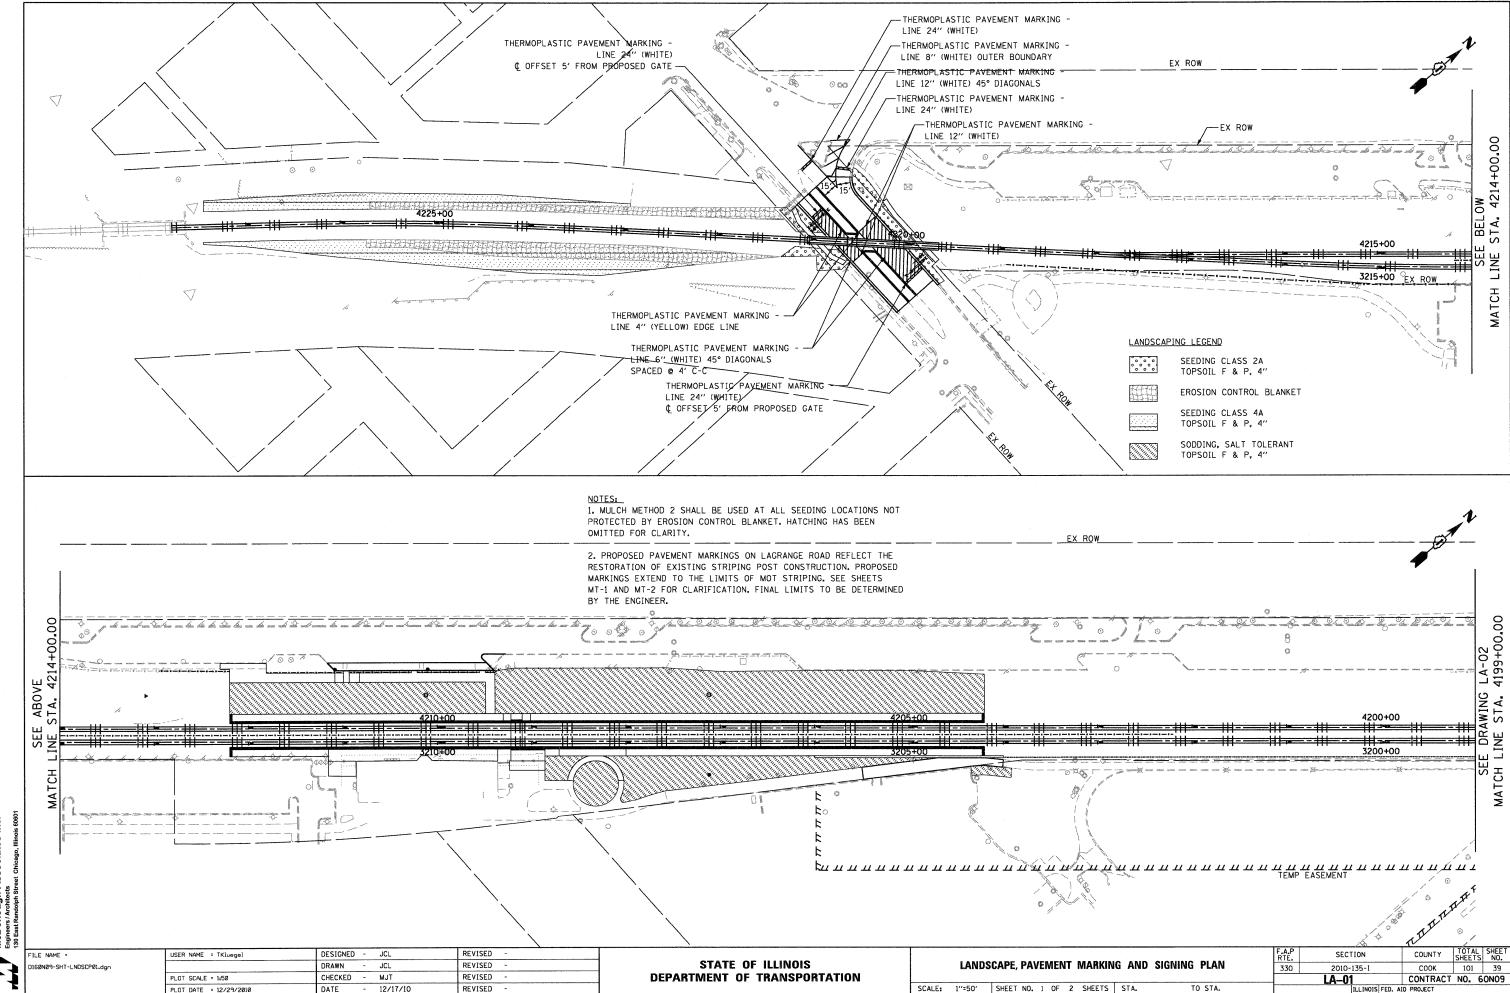
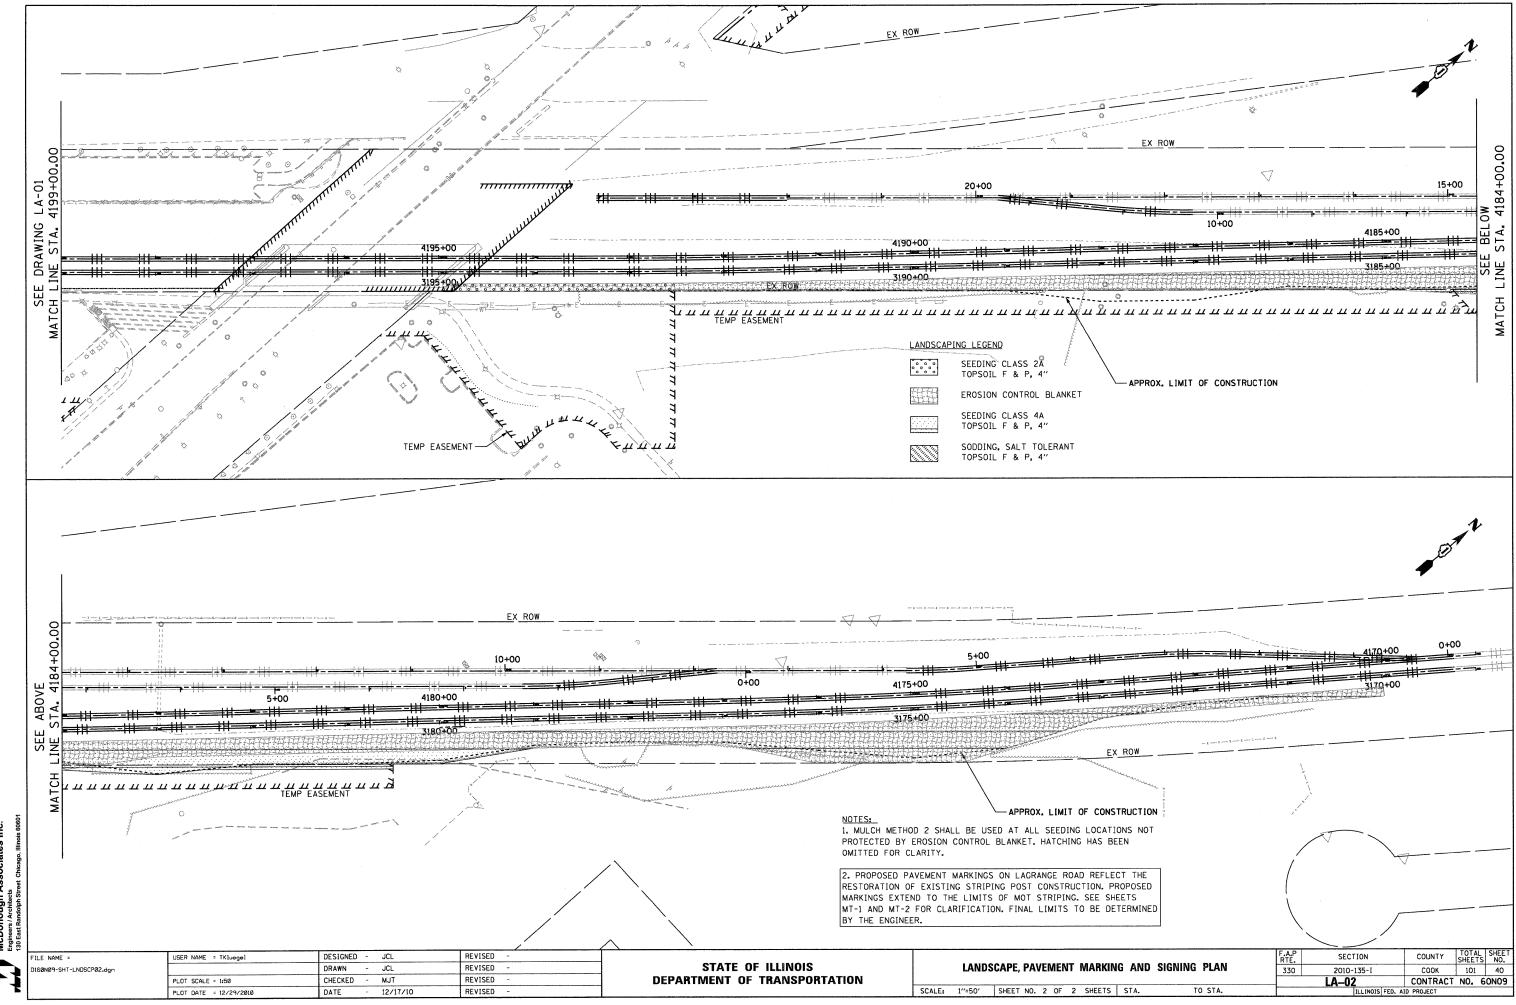
#### NOTES

- THROUGHOUT THE CONSTRUCTION PROCESS, THE CONTRACTOR SHALL STAGE DEMOLITION AND CONSTRUCTION IN ORDER TO MAINTAIN STATION OPERATION.
- 2. THE CONTRACTOR SHALL VISIT THE SITE AND BE KNOWLEDGEABLE OF CONDITIONS THEREOF. HE SHALL INVESTIGATE, VERIFY AND BE RESPONSIBLE FOR ALL CONDITIONS OF THE PROJECT AND SHALL NOTIFY IDOT OF ANY CONDITIONS REQUIRING MODIFICATION BEFORE PROCEEDING WITH THE WORK.
- 3. DURING THE INITIAL SITE VISIT AND THROUGHOUT THE PROJECT, THE CONTRACTOR SHALL NOTIFY IDOT OF DISCREPANCIES IN THE CONTRACT DOCUMENTS OR UPON THE DISCOVERY OF ANY CONDITIONS, APPARENT OR HIDDEN, THAT COULD AFFECT THE CURRENT SCOPE OF THE PROJECT AND THE CONTRACTOR'S WORK.
- 4. THE CONTRACTOR SHALL BE RESPONSIBLE FOR COORDINATION OF ALL WORK OF THE SUBCONTRACTORS, INCLUDING BUT NOT LIMITED TO ALL CIVIL, ARCHITECTURAL, STRUCTURAL, AND ELECTRICAL TRADES.
- 5. THE CONTRACTOR SHALL ENSURE EACH SUBCONTRACTOR IS FAMILIAR WITH THE CONDITIONS OF THE PROJECT, HAS A FULL UNDERSTANDING OF THEIR WORK AND ALL OTHER WORK RELATED TO THEIR WORK.
- 6. CONTRACT DOCUMENTS ARE TO BE ISSUED TO THE SUBCONTRACTORS BY THE CONTRACTOR IN COMPLETE SETS SO THAT THE EXTENT AND COORDINATION OF WORK IS MADE POSSIBLE.
- 7. THE CONTRACTOR SHALL PERFORM ALL WORK IN ACCORDANCE WITH THE CURRENT LOCALLY ADOPTED BUILDING CODES AND ALL APPLICABLE COUNTY, STATE AND FEDERAL LAWS INCLUDING THE OCCUPATIONAL SAFETY AND HEALTH ACT (OSHA) AND REGULATIONS ADOPTED PURSUANT THERETO.
- 8. THE CONTRACT DOCUMENTS DO NOT INCLUDE STANDARDS OR GUIDELINES FOR CONSTRUCTION SAFETY. THE CONTRACTOR SHALL BE RESPONSIBLE FOR THE ADEQUACY AND SAFETY OF ALL CONSTRUCTION METHODS AND THE SAFE PROSECUTION OF THE WORK, INCLUDING BUT NOT LIMITED TO FORMS, FALSE WORK, SCAFFOLDING, PROTECTIVE BARRICADES, PROTECTIVE RAILS AND WARNING LIGHTS. IT IS EXPRESSLY STIPULATED THAT ANY EXAMINATION AND/OR APPROVAL BY THE ENGINEER OF THE CONTRACTOR'S DRAWINGS FOR SUCH ITEMS AS WELL AS FOR ANY OTHER ITEMS NEEDED FOR THE PROSECUTION OF THE WORK WILL COVER ONLY GENERAL CONFORMANCE WITH THE DESIGN CONCEPT OF THE PROJECT AND GENERAL COMPLIANCE WITH THE INFORMATION GIVEN IN THE CONTRACT DOCUMENTS. THE CONTRACTOR SHALL ASSUME FULL AND COMPLETE RESPONSIBILITY FOR SAFE PROSECUTION OF WORK AT ALL TIMES AND FOR OBTAINING SATISFACTORY RESULTS.
- 9. PROTECTION OF PROPERTY, SITE, WORKERS AND THE PUBLIC IS THE SOLE RESPONSIBILITY OF THE CONTRACTOR. ALL WORK SHALL CONFORM WITH APPLICABLE LOCAL, STATE AND FEDERAL CODES AND REGULATIONS. THE USE OF CANOPIES, BARRICADES, SIGNS, ETC. IS THE SOLE RESPONSIBILITY OF THE CONTRACTOR.
- 10. THE CONTRACTOR SHALL PROTECT ALL EXISTING SITE ELEMENTS TO REMAIN FROM DAMAGE DUE TO ALTERATION AND CONSTRUCTION OPERATIONS, AND REPAIR OR REPLACE ELEMENTS DAMAGED DURING THIS PROJECT.
- 11. ANY UTILITY SHUT— OFF AS REQUIRED BY THE SUBCONTRACTORS FOR COMPLETION OF THEIR WORK, SUCH AS ELECTRICAL, GAS, WATER, SEWER, ETC. MUST BE SCHEDULED WITH THE BNSF, METRA AND THE APPROPRIATE UTILITY COMPANIES PRIOR TO COMMENCEMENT.
- 12. THE INDICATIONS OF EXISTING CONDITIONS IN THE CONTRACT DOCUMENTS ARE DIAGRAMMATIC. EXACT LOCATIONS, SIZES, EXTENT AND CONDITIONS OF EXISTING CONSTRUCTION TO BE REMOVED, RELOCATED OR TO REMAIN SHALL BE VERIFIED AT THE SITE BY THE CONTRACTOR.

- 13. ALL DIMENSIONS SHALL BE VERIFIED IN THE FIELD BEFORE PROCEEDING WITH THE WORK. THROUGHOUT THE PROGRESS OF THE PROJECT, EACH SUBCONTRACTOR SHALL FIELD VERIFY CONDITIONS AND DIMENSIONS OF THE SITE AND OF INSTALLED WORK WHICH INTERFACES WITH AND/OR IMPACTS THEIR PORTION OF THE WORK. THE CONTRACTOR SHALL BE RESPONSIBLE FOR ENSURING FIELD VERIFICATION BY THE SUBCONTRACTORS, AND SHALL COORDINATE THE RESOLUTION OF DIMENSION CONFLICTS. THE CONTRACTOR SHALL NOTIFY IDOT BEFORE PROCEEDING WITH THE WORK WHEN A RESOLUTION CANNOT BE DETERMINED OR THE RESOLUTION WOULD CAUSE DESIGN INTENT TO BE ALTERED.
- 14. WHERE SPECIFIC DIMENSIONS, DETAILS AND DESIGN INTENT CANNOT BE DETERMINED, NOTIFY IDOT BEFORE PROCEEDING WITH ANY WORK IN QUESTION:
- 15. DETAILS SHOWN IN THE CONTRACT DOCUMENTS ARE INTENDED TO BE INDICATIVE OF THE PROFILES AND TYPE OF DETAILING REQUIRED FOR THE WORK. ASSUME DETAILS NOT SHOWN ARE SIMILAR IN CONSTRUCTION TO THOSE DETAILED WITH RESPECT TO RELATED ASSEMBLIES. WHERE DESIGN INTENT CANNOT BE DETERMINED, THE CONTRACTOR SHALL CONSULT IDOT BEFORE PROCEEDING WITH THE WORK.
- 16. DIMENSIONS SHALL GOVERN. DO NOT SCALE DRAWINGS. THE CONTRACTOR SHALL NOTIFY IDOT IN WRITING OF ANY DISCREPANCIES, OMISSIONS AND/OR CONFLICTS BEFORE PROCEEDING WITH THE WORK.
- 17. MATERIAL SYMBOLS ARE FOR GENERAL REFERENCE PURPOSES ONLY. REFER TO SPECIFICATIONS FOR ACTUAL MATERIAL DESIGNATIONS.
- 18. THE CONTRACTOR SHALL NOTIFY ALL AGENCIES AND UTILITIES AT LEAST 10 DAYS PRIOR TO ANY CONSTRUCTION IN THE AREA AND SHALL COMPLY WITH ALL RESTRICTIONS FOR EQUIPMENT MOVEMENT AND CLEARANCES WITH REGARD TO THEIR FACILITIES. BEFORE STARTING ANY EXCAVATION, THE CONTRACTOR SHALL CALL "JULIE" AT 800-892-0123 FOR FIELD LOCATIONS OF BURIED UTILITIES; A 48 HOUR NOTIFICATION IS REQUIRED. CONTRACTOR SHALL ALSO CONTACT BNSF RAILROAD AND UP RAILROAD TO LOCATE RAILROAD UTILITIES NOT COVERED BY "JULIE".

#### STRUCTURAL GENERAL NOTES

- 1. COMPRESSIVE STRENGTH FOR ALL CONCRETE SHALL BE 3500 PSI.
- 2. MINIMUM CONCRETE COVER OVER REINFORCING STEEL SHALL BE 3" FOR CONCRETE CAST AGAINST EARTH AND 2" FOR ALL OTHER SURFACES UNLESS NOTED OTHERWISE.
- ALL EXPOSED CONCRETE EDGES SHALL HAVE A 3/4" CHAMFER. CHAMFER ON VERTICAL EDGES SHALL CONTINUE A MINIMUM OF ONE FOOT BELOW FINISHED GROUND LEVEL.
- 4. ALL REINFORCING BARS SHALL BE EPOXY COATED.
- 5. EPOXY COATED REINFORCING STEEL SHALL COMPLY WITH ASTM A775.
- ALL DEFORMED REINFORCING STEEL SHALL COMPLY WITH ASTM A615, GRADE 60.
- 7. CONCRETE SEALANT SHALL BE APPLIED TO ALL EXPOSED CONCRETE SURFACES.

#### WORK BY METRA FORCES

NOTE: ALL MATERIAL FOR WORK BY METRA FORCES SHALL BE FURNISHED BY THE CONTRACTOR.

#### PLATFORM CONSTRUCTION:

ALL PLATFORM CONSTRUCTION, INLCUDING THE INSTALLATION OF THE DETECTABLE WARNING TILES, SHALL BE DONE BY METRA FORCES WITH MATERIALS FURNISHED BY THE CONTRACTOR EXCEPT THE INSTALLATION OF THE PLATFORM SURFACE AND BINDER WHICH SHALL BE INSTALLED BY THE CONTRACTOR.


#### INTERTRACK WORK:


THE INSTALLATION OF TIMBER CROSSWALKS AND INTERTRACK FENCING SHALL BE INSTALLED BY METRA FORCES WITH MATERIALS FURNISHED BY THE CONTRACTOR.

#### PLATFORM LIGHTING:

THE INSTALLATION OF PLATFORM LIGHTING, INCLUDING THE CONCRETE FOUNDATIONS (SONO-TUBES, FORMS, STEEL REINFORCEMENT AND ANCHOR BOLTS), LIGHT POLES, FIXTURES, CABLE AND CONDUIT SHALL BE DONE BY METRA FORCES WITH MATERIALS FURNISHED BY THE CONTRACTOR.

SCALE: NONE

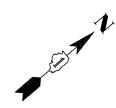

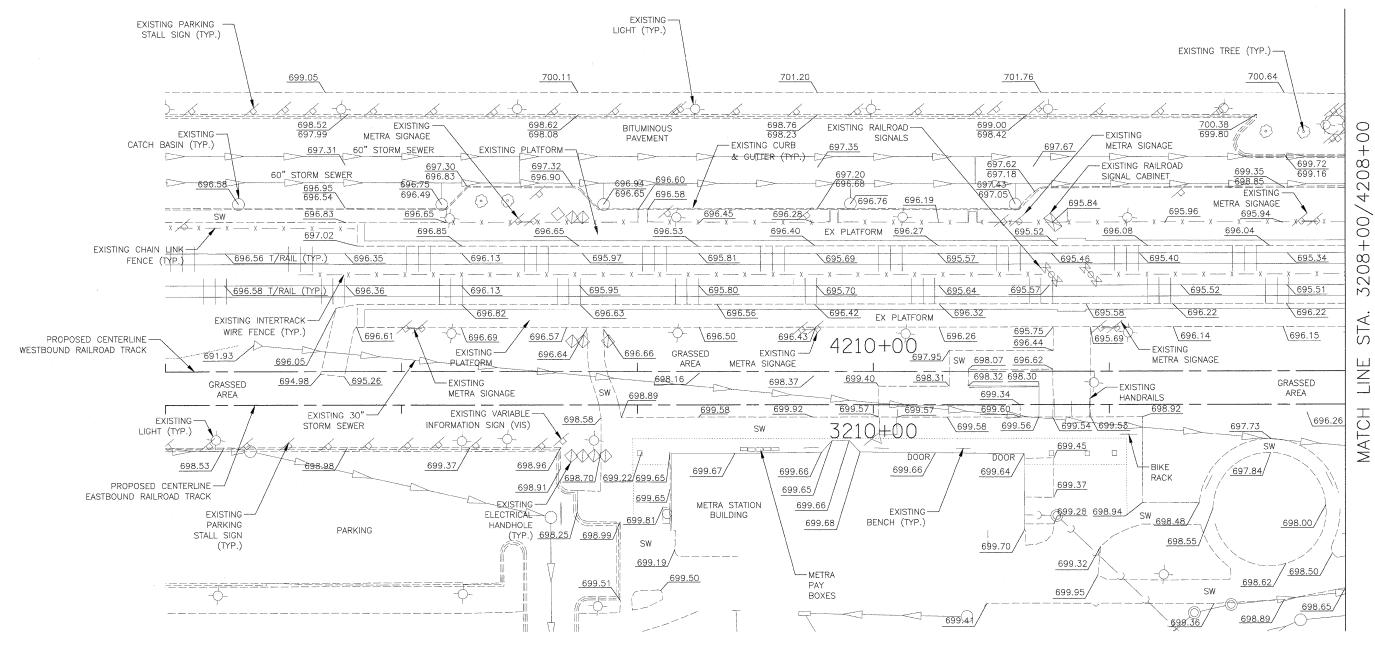



NOTE:

PLATFORM AND SPOT ELEVATION GRID AT 50' INTERVALS.




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	PLOT SCALE = I" = 20'	CHECKED	JRS	REVISED -	DEPARTMENT OF TRANSPORTATION	EXISTING CONDITIONS PLAN	330 1	MS-2	CONTRACT NO. 6	50N09
	PLOT DATE = 08/13/10	DATE	12/27/10	REVISED -		SCALE: 1"=20' SHEET NO. 1 OF 2 SHEETS STA. TO STA.		ILLINOIS FED.	AID PROJECT	

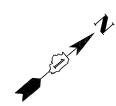


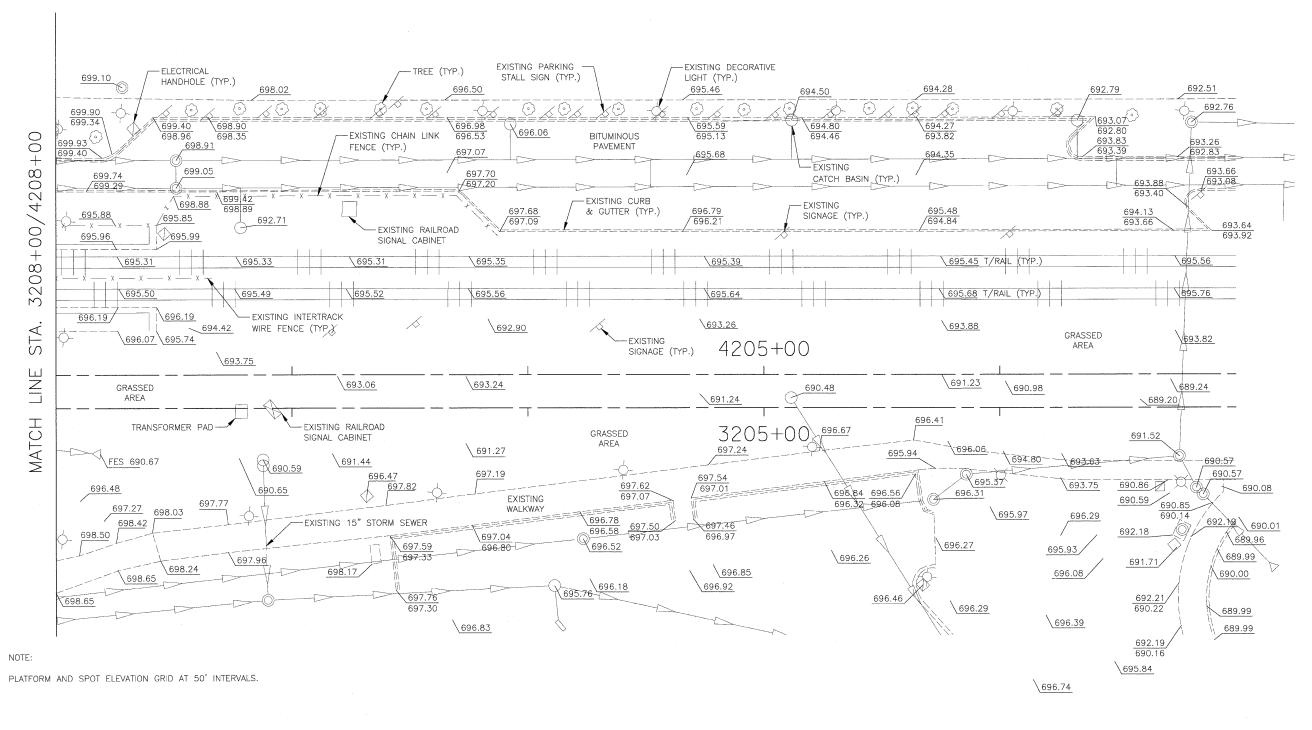


20 0 20 40 SCALE IN FEET

COUNTY TOTAL SHEET NO. DESIGNED REVISED MGS F.A. RTE. SECTION **METRA STATION AND PLATFORMS** STATE OF ILLINOIS DRAWN MGS REVISED COOK **EXISTING CONDITIONS PLAN** 330 2010-135~I MS-3 | Communication | Communi REVISED **DEPARTMENT OF TRANSPORTATION** CHECKED JRS PLOT SCALE = 1" = 20' CONTRACT NO. 60N09 SHEET NO. 2 OF 2 SHEETS STA. SCALE: 1"=20" TO STA. REVISED PLOT DATE = 08/13/10 DATE 12/27/10

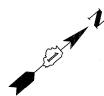


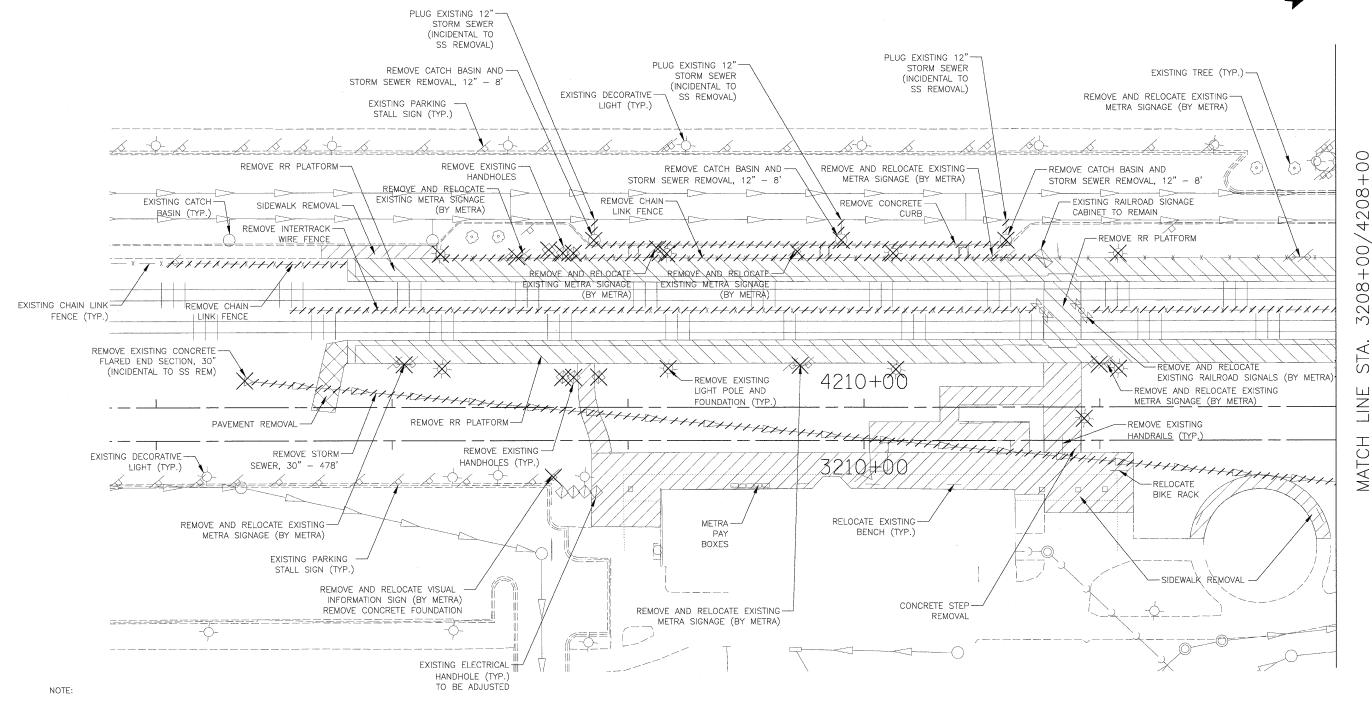


- ALL CONCRETE FOUNDATIONS FOR HANDRAILS, FENCE POSTS, SIGNS, AND OTHER FEATURES TO BE REMOVED ARE TO BE INCLUDED IN THE CONTRACT UNIT PRICE FOR ITEM/FEATURE TO BE REMOVED.
- 2. ALL TEMPORARY AND PERMANENT ALTERATIONS OR RELOCATIONS OF COMMUNICATIONS AND SIGNAL WIRE LINES, SIGNALS AND RAILROAD APPURTENANCES WITHIN METRA ROW WILL BE COMPLETED BY METRA FORCES.

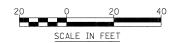


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		DRAWN	MGS	REVISED -	STATE OF ILLINOIS	DEMOLITION PLAN	330	2010-135-I	COOK	101 44
	PLOT SCALE = 1" = 20"	CHECKED	JRS	REVISED -	DEPARTMENT OF TRANSPORTATION	DEMOLITION FEAT		MS-4	CONTRACT	NO. 60N09
	PLOT DATE = 08/13/10	DATE	12/27/10	REVISED -		SCALE: 1"=20" SHEET NO. 1 OF 2 SHEETS STA. TO STA.			AID PROJECT	

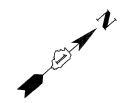


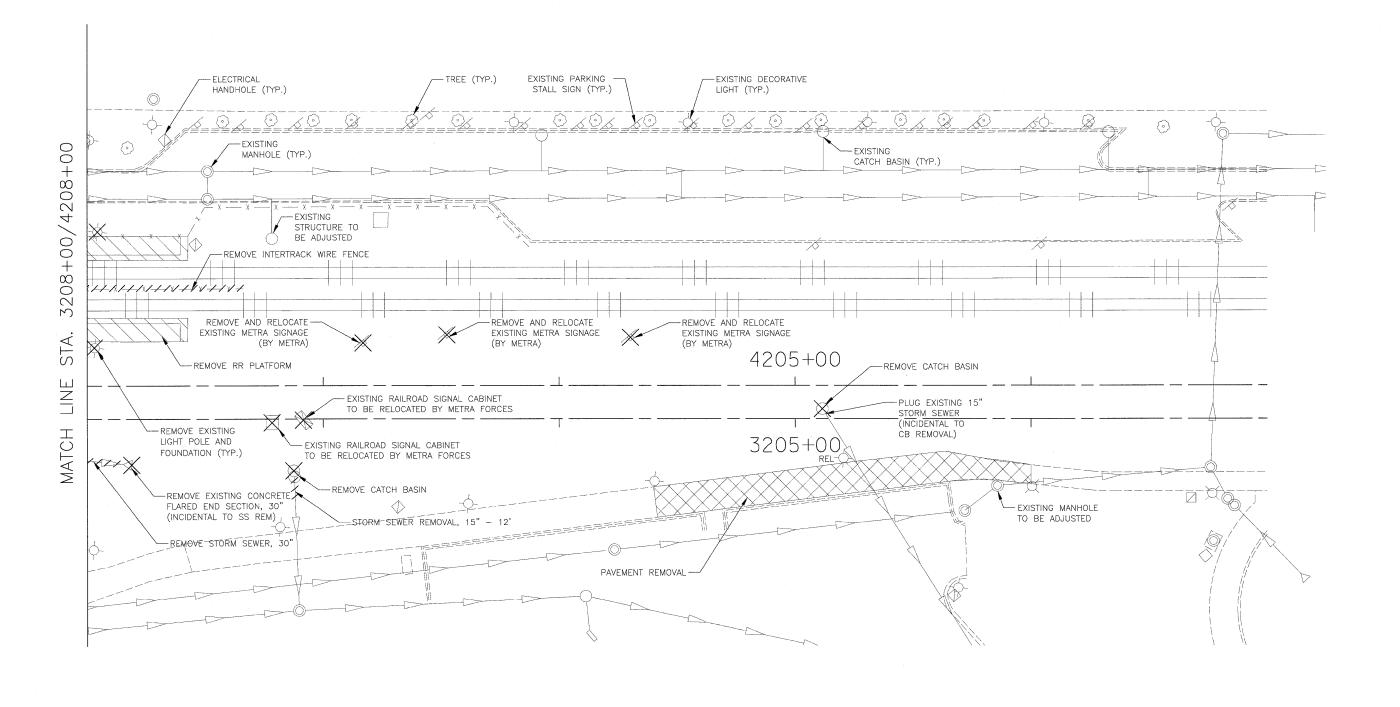




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		DRAWN	MGS	REVISED -	STATE OF ILLINOIS		DEMOLITION PLAN	330	2010-135-I	COOK 101 4
	PLOT SCALE = 1' = 20'	CHECKED	JRS	REVISED -	DEPARTMENT OF TRANSPORTATION		DEMOCITION FLAM		MS-5	CONTRACT NO. 60NO
	PLOT DATE = 08/13/10	DATE	12/27/10	REVISED -		SCALE: 1"=20"	SHEET NO. 2 OF 2 SHEETS STA. TO STA.		ILLINOIS F	FED. AID PROJECT

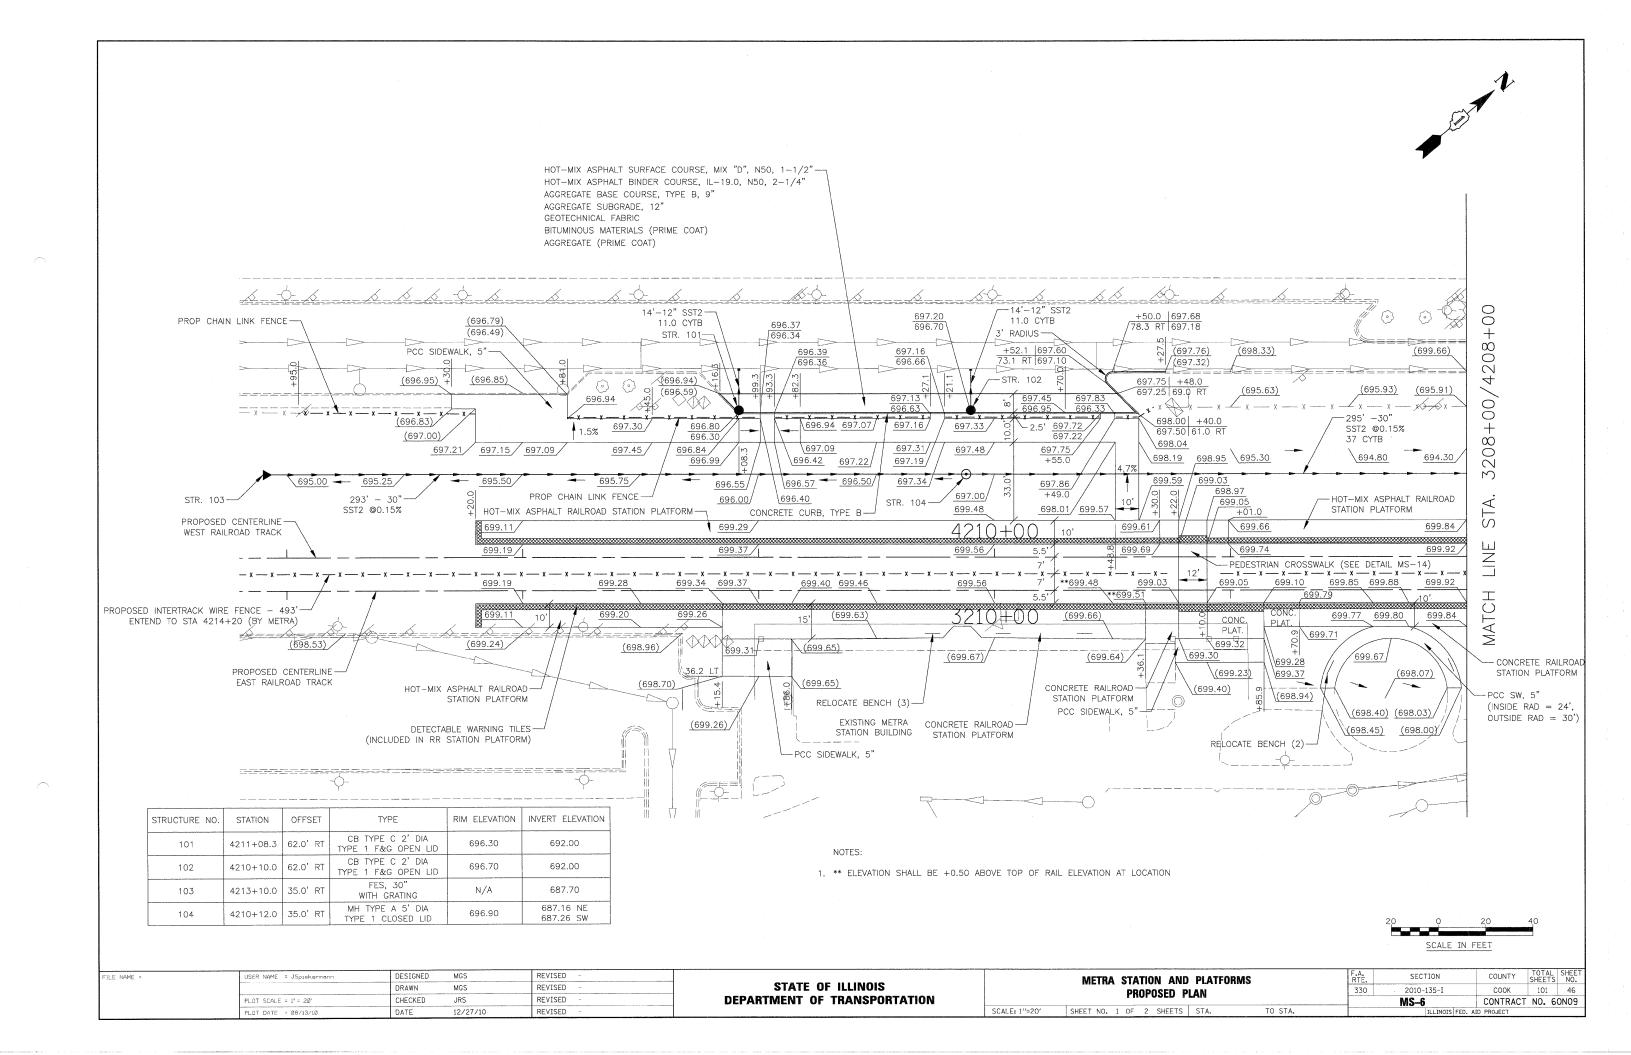

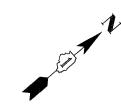


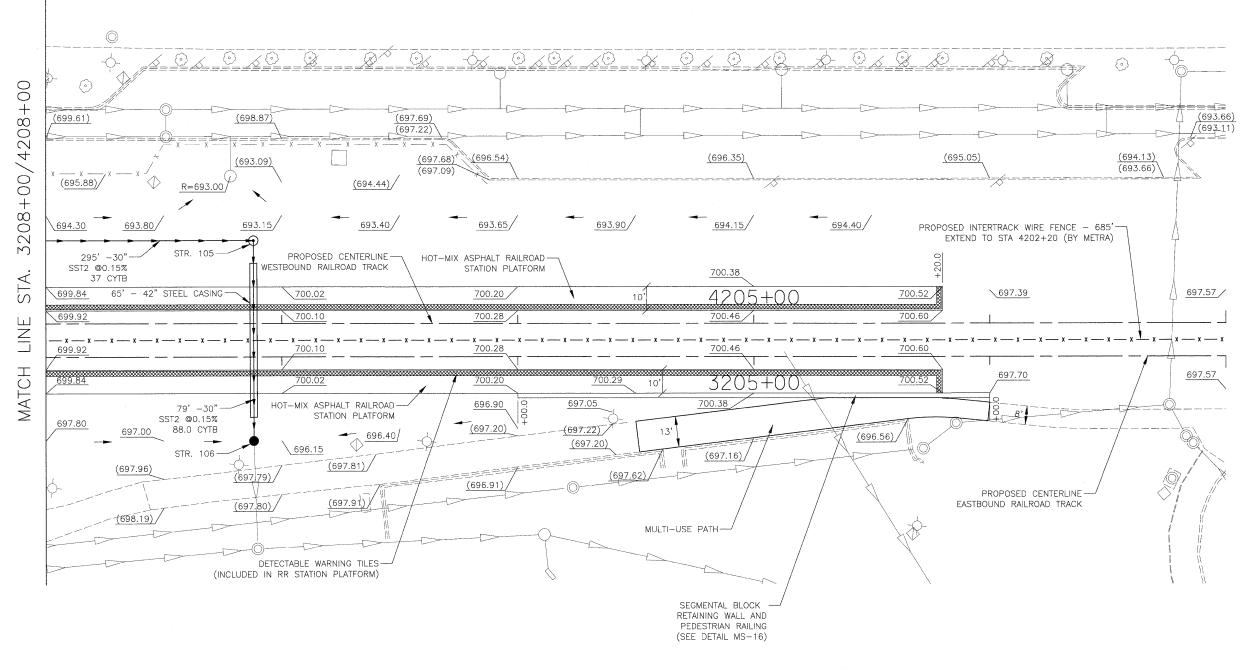

STRUCTURE NO.	STATION	OFFSET	TYPE	RIM ELEVATION	INVERT ELEVATION		
105	4207+12.0	35.0' RT	MH TYPE A 5' DIA TYPE 1 F&G CLOSED LID	695.50	686.62 SE 686.72 SW		
106	4207+11.8	49.5'LT	CB TYPE A 5' DIA TYPE 1 F&G OPEN LID	696.00	(686.31) SE 686.50 NW		

20 0 20 40 SCALE IN FEET

FILE NAME =	USER NAME = JSpiekermann	DESIGNED	MGS	REVISED -			METRA STATION AND PLATFO	RMS	RTE.	SECTION	COUNTY	SHEETS NO.
		DRAWN	MGS	REVISED -	STATE OF ILLINOIS		PROPOSED PLAN		330	2010-135-I	COOK	101 47
	PLOT SCALE = 1" = 20"	CHECKED	JRS	REVISED -	DEPARTMENT OF TRANSPORTATION		FROFUSED FLAM			MS-7	CONTRACT	L NO. 60NO3
	PLOT DATE = 08/13/10	DATE	12/27/10	REVISED -		SCALE: 1"=20"	SHEET NO. 2 OF 2 SHEETS STA.	TO STA.		ILLINOIS F	ED. AID PROJECT	

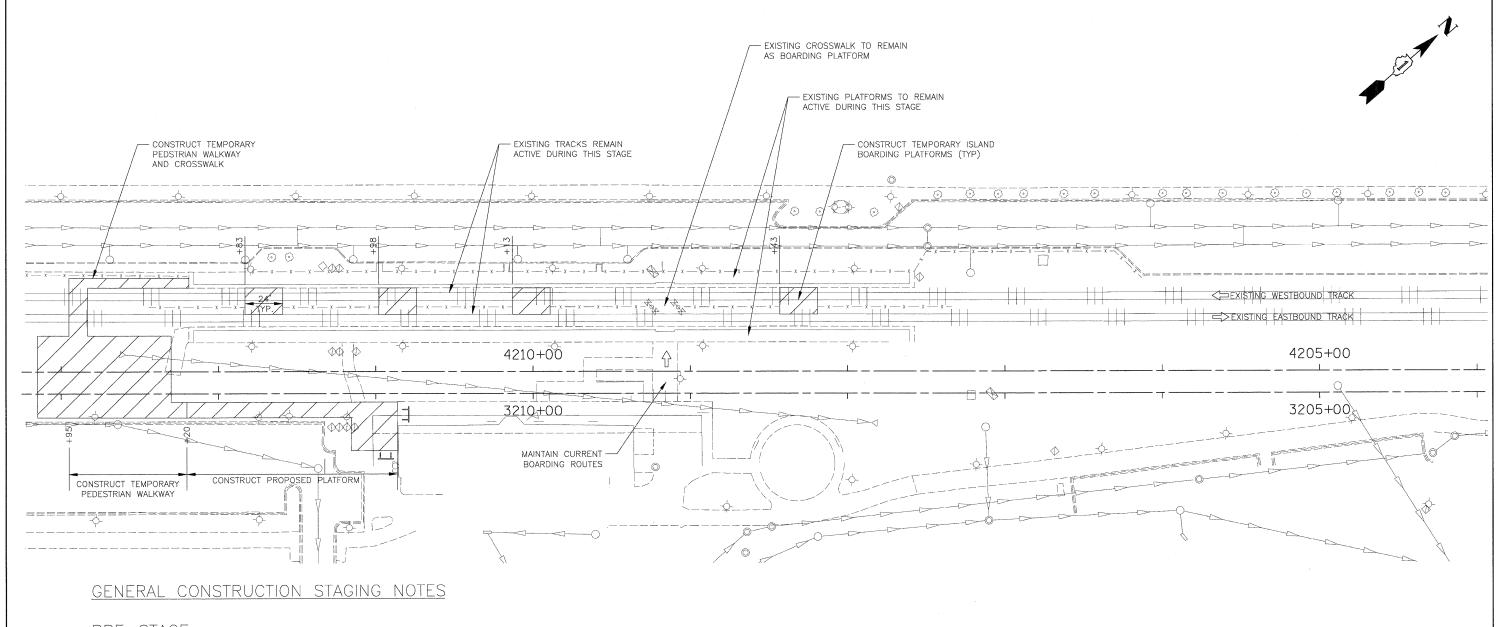

### PRE-STAGE

CONSTRUCT 24' WIDE TEMPORARY ISLAND BOARDING PLATFORMS AT 85' INTERVALS ALONG THE EXISTING TRACKS.

INSTALL TEMPORARY FES AND STORM SEWER AT STATION 4213+05 TO PROVIDE ROOM FOR TEMPORARY PEDESTRIAN WALKWAY.

CONSTRUCT PROPOSED EASTBOUND PLATFORM FROM STATION 4212+20 TO THE WEST END OF THE EXISTING STATION SIDEWALK.

CONSTRUCT ADA ACCESSIBLE TEMPORARY PEDESTRIAN WALKWAY AND CROSSWALK FROM EXISTING WESTBOUND PLATFORM TO NEWLY CONSTRUCTED PROPOSED EASTBOUND PLATFORM.

THE EXISTING BOARDING PLATFORMS WILL REMAIN ACTIVE FOR BOARDING. THROUGHOUT THIS STAGE.


INSTALL ONE PROPOSED PLATFORM LIGHT, TWO TEMPORARY PEDESTRIAN WALKWAY LIGHTS ON WOOD POLES, ONE WOOD LIGHT POLE AND AERIAL CABLE AS SHOWN ON THE TEMPORARY ELECTRICAL PLAN.





WORK ZONE




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- 1		PLOT DATE = 08/13/10	DATE	12/27/10	REVISED -		SCALE: 1"=30"	SHEET NO. 1 OF 4 SHEETS STA. TO STA.		ILLINOIS FE	ED. AID PROJECT		

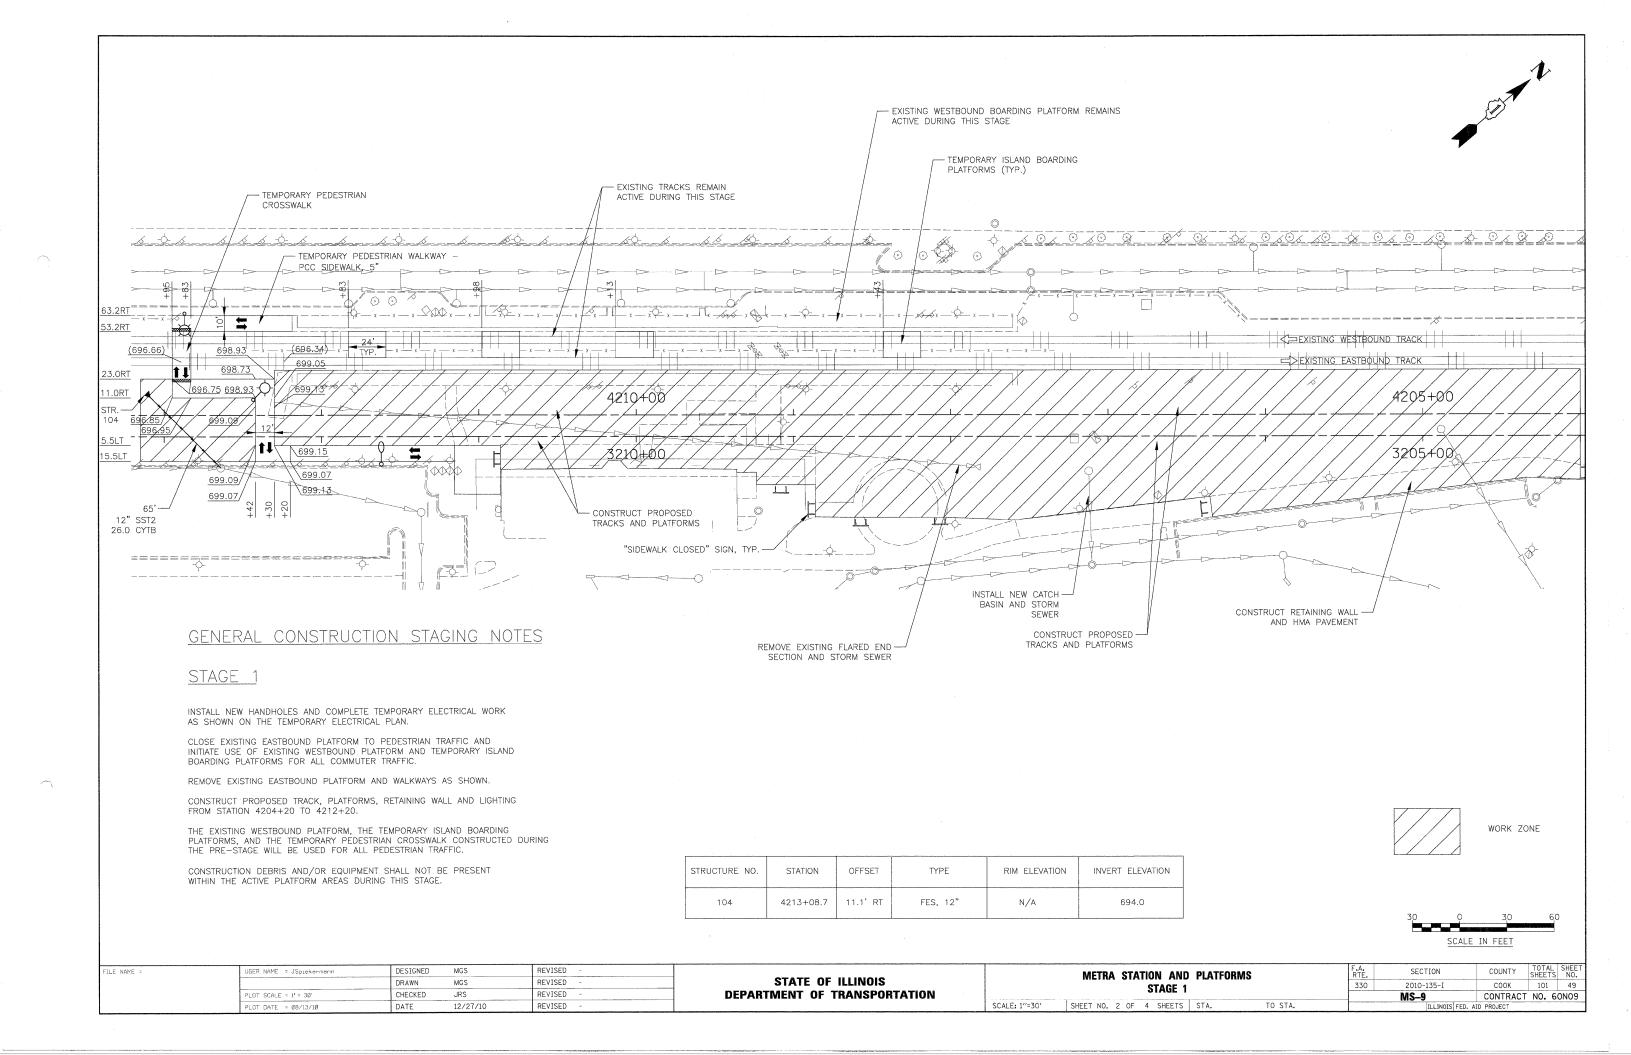

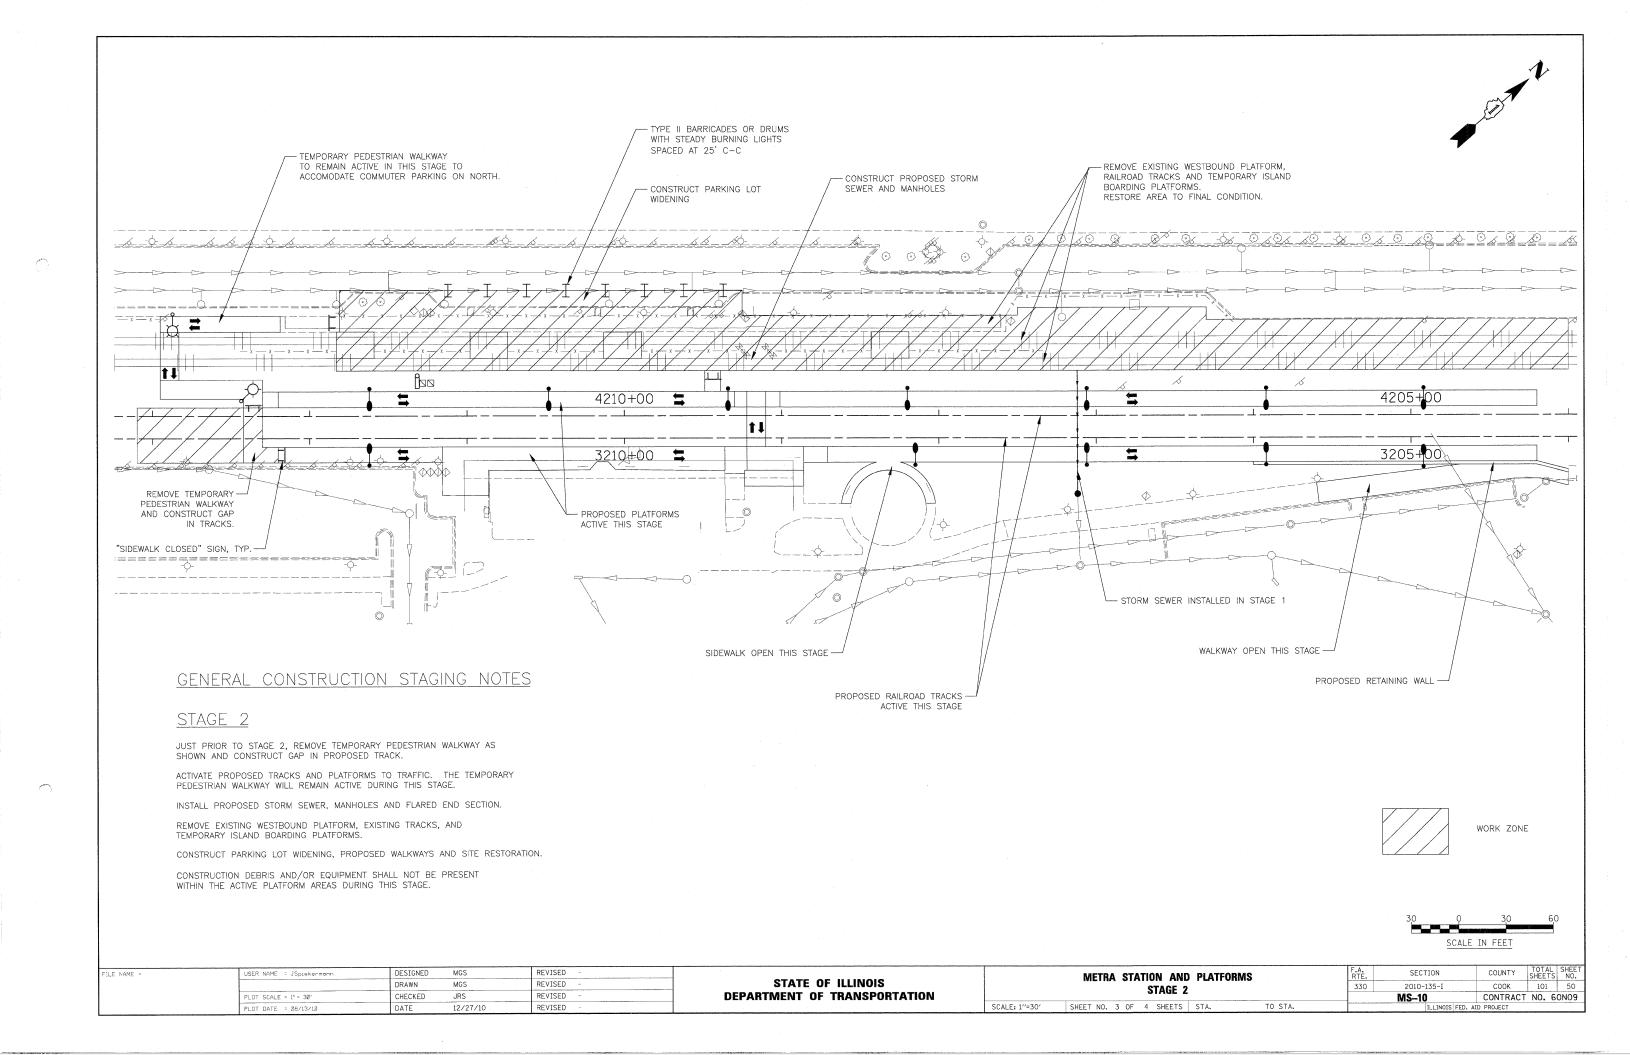

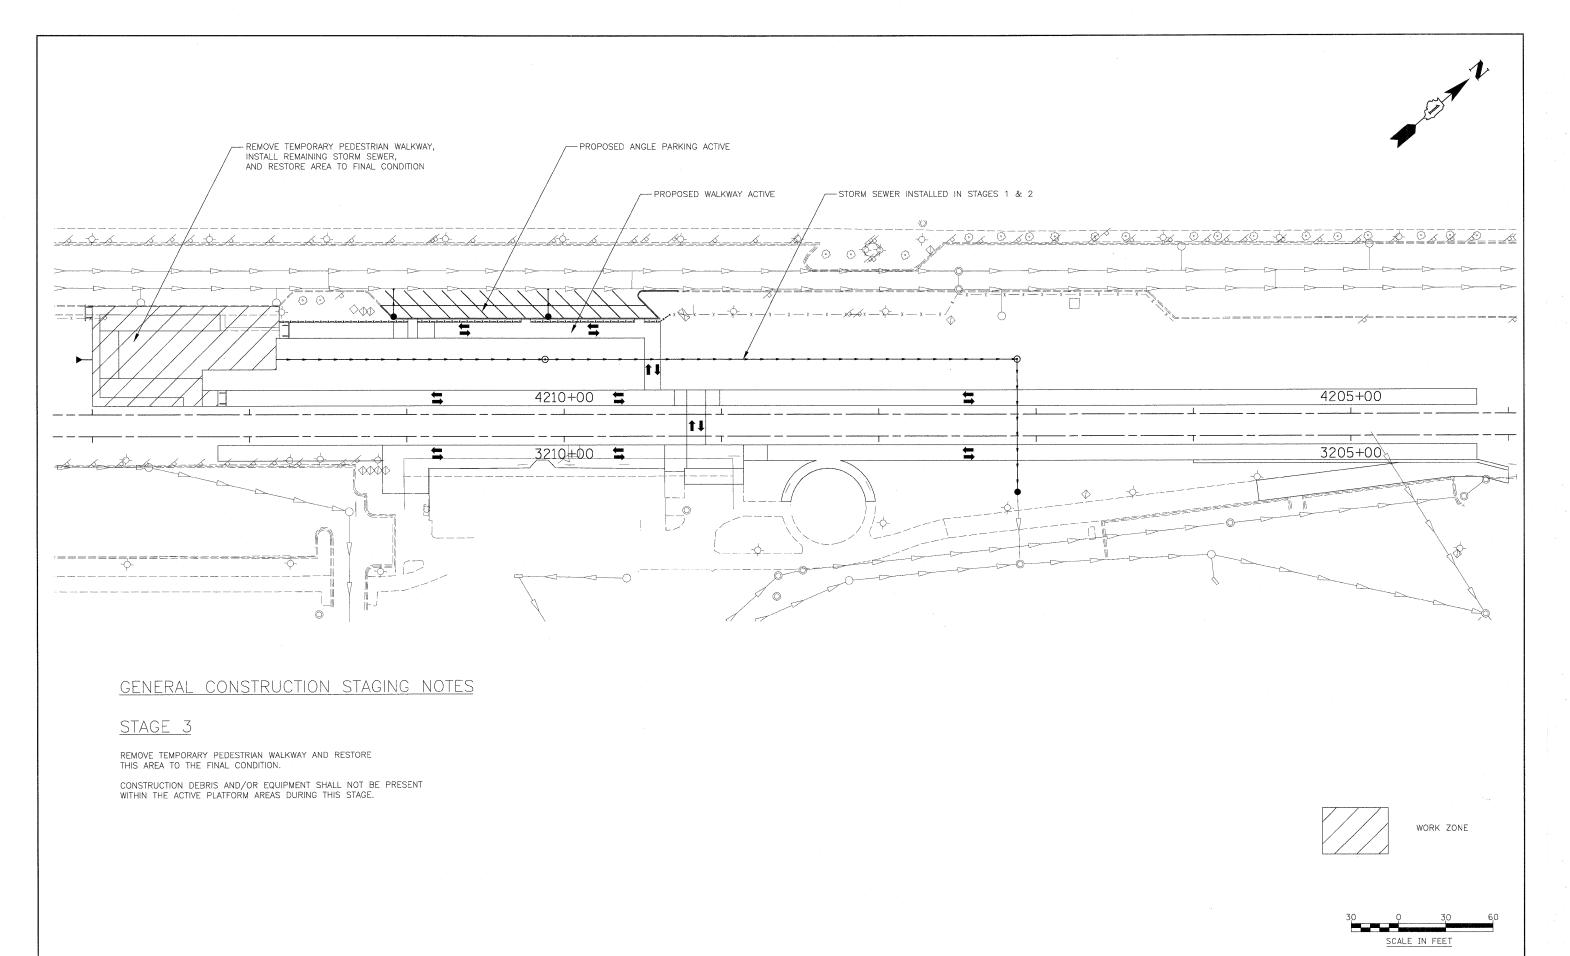

- 1											
FIL	ILE NAME =	USER NAME = JSpiekermann	DESIGNED	MGS	REVISED -		METRA STATION AND PLATFORMS	F.A.	SECTION	COUNTY	TOTAL SHEET
			DRAWN	MGS	REVISED -	STATE OF ILLINOIS	STAGE 3	330	2010-135-I	соок	101 51
		PLOT SCALE = 1' = 30'	CHECKED	JRS	REVISED -	DEPARTMENT OF TRANSPORTATION	STAGE 3		MS-11	CONTRACT	NO. 60N09
		DIOT DATE - 00/12/10	DATE	12/27/10	REVISED -		SCALE: 1"=30" SHEET NO. 4 OF 4 SHEETS STA. TO STA.			AID PROJECT	

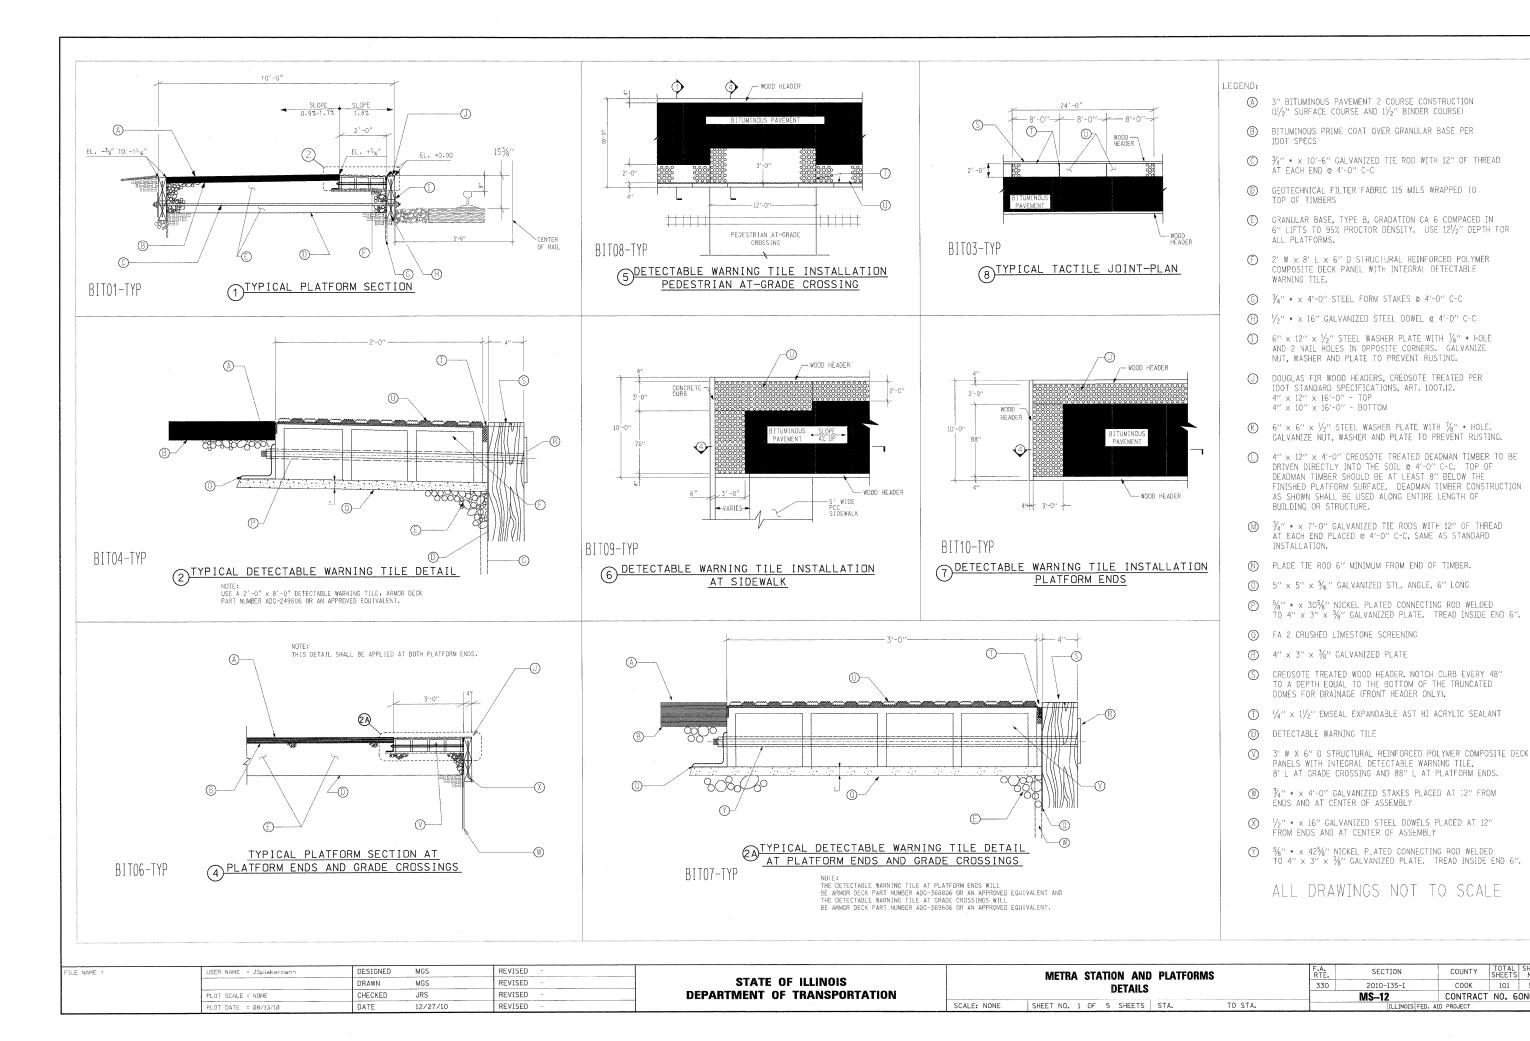



COUNTY TOTAL SHEE

CONTRACT NO. 60N09

101

COOK

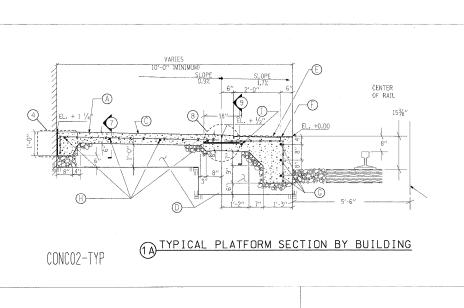

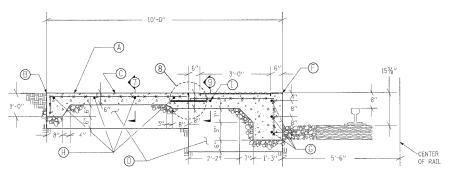

TYPICAL PLATFORM SECTION AT (3) PLATFORM ENDS AND GRADE CROSSINGS CONCO4-TYP

\_\_\_ JOINT SEALANT --- BACKER ROD ---- PREFORMED JOINT FILLER #6 DOWEL - 18" LONG SEE PLATFORM SECTION FOR LOCATIONS

NOTE:
SLAD FOR LOUATIONS
MOTE:
EXPANSION JOINTS SHALL BE PLACED EVERY 24'-0", PERPENDICULAR
TO THE PLATFORM EDGE FOR THE ENTIRE WIDTH OF THE PLATFORM.
CONTRACTION JOINTS (DETAILS 5 AND 6) SHALL BE PLACED EVERY
6'-0", PERPENDICULAR TO THE PLATFORM EDGE FOR THE ENTIRE
WIDTH OF THE PLATFORM. EXPANSION JOINTS AND CONTRACTION
JOINTS ARE TO MATCH THE DETECTABLE WARNING TILE JOINTS.

# (7) TRANSVERSE EXPANSION JOINT


CONCO5-TYP

JOINT SEALANT --- BACKER ROD - PREFORMED JOINT FILLER #8 DOWEL - 18" LONG SEE PLATFORM SECTION CONCRETE WITH GREASE

NOTE:
EXPANSION JOINT SHALL BE PLACED 3'-0" FROM THE EDGE OF
PLATFORM FOR THE ENTIRE LENGTH OF THE PLATFORM. EXCEPT
AT GRADE CROSSINGS (SEE DETECTABLE WARNING TILE
INSTALL ATION-PEDESTRIAN-AT-GRADE CROSSING DETAIL).
INSTALL DOWLE DARS ON 2'-0" CENTERS FOR ENTIRE LENGTH
OF PLATFORM.

# (8) LONGITUDINAL EXPANSION JOINT


CONCO6-TYP

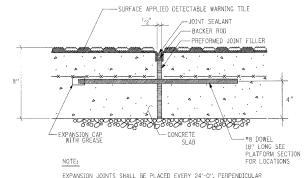

EXPANSION JOINTS SHALL BE PLACED EVERY 24"-0", PERPENDICULAR TO THE PLATFORM EDGE FOR THE ENTIRE WIDTH OF THE CONCRETE SLAB. CONTRACTION JOINTS OBTAILS 5 AND 6) SHALL BE PLACED EVERY 8"-0", PERPENDICULAR TO THE PLATFORM EDGE FOR THE ENTIRE WIDTH OF THE CONCRETE SLAB. EXPANSION JOINTS AND CONTRACTION JOINTS ARE TO MATCH THE DETECTABLE WARNING TILE JOINTS.


### 9 SURFACE APPLIED DETECTABLE WARNING TILE EXPANSION JOINT

CONCO7-TYP

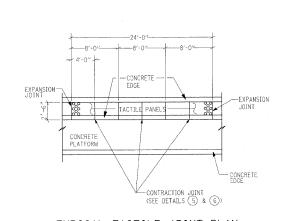


TYPICAL TACTILE JOINT-PLAN

CONCO9-TYP

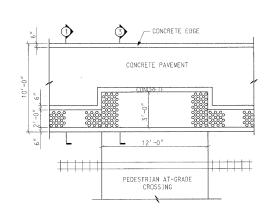

DETECTABLE WARNING TILE INSTALLATION PEDESTRIAN AT-GRADE CROSSING

CONC10-TYP

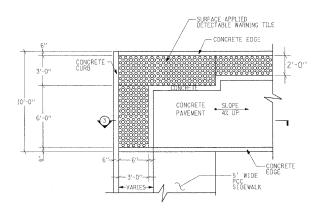


DETECTABLE WARNING TILE INSTALLATION AT SIDEWALK


CONC11-TYP

- CONCRETE SLAB WITH 6" x 6" W2.9 x W2.9 W.W.F.
- REGRADE SOIL TO TOP OF PLATFORM
- APPLY CONCRETE SEALANT
- GRANULAR BASE, TYPE 6, GRADATION CA 6 COMPACTED IN 6" LIFTS TO 95% PROCTOR DENSITY. VARIABLE DEPTH.
- 2'-0" W  $\times$  4'-0" L SURFACE APPLIED DETECTABLE WARNING TILE, FULLY ADHERED AND FASTENED WITH STAINLESS STEEL FASTENERS. TOP OF DOMES SHALL BE FLUSH WITH THE TOP OF THE TIMBER CURB AND TOP OF THE CONCRETE CURB. MILL CONCRETE SURFACE 3/8" TO ACCEPT TACTILE.
- GROOVE CONCRETE EDGE EVERY 2'-C" THE ENTIRE LENGTH OF THE PLATFORM TO A DEPTH EQUAL TO THE BOTTOM OF THE TRUNCATED DOMES FOR DRAINAGE.
- CONTINUOUS #5 BARS FOR THE ENTIRE LENGTH OF THE PLATFORM
- #6 DOWELS 18" LONG AT EXPANSION JOINTS
- (T) #8 DOWELS 18" LONG AT EXPANSION JOINTS


### ALL DRAWINGS NOT TO SCALE

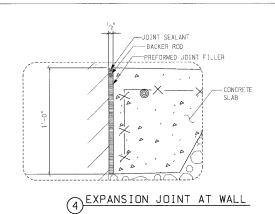

CONCO8-TYP

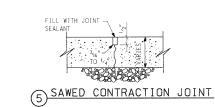

PLAT-01

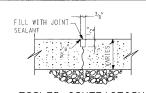

6 TOOLED CONTRACTION JOINT


PLAT-02

ILE NAME =	USER NAME = JSpiekermann	DESIGNED	MGS	REVISED -	
		DRAWN	MGS	REVISED -	1
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	PLOT DATE = 08/13/10	DATE	12/27/10	REVISED -	


STATE OF ILLINOIS **DEPARTMENT OF TRANSPORTATION** 


	METRA	STA	TION	AND	PLATFORMS		
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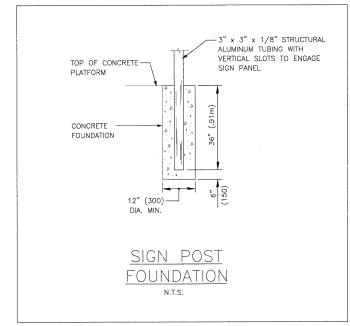
	F.A. RTE.	SECTION	COUNTY	TOTAL SHEETS	SHEET NO.
I	330	2010-135-I	COOK	101	53
		MS-13	CONTRACT	NO. 6	ON09
		TILINOIS FED AT	D PROJECT		

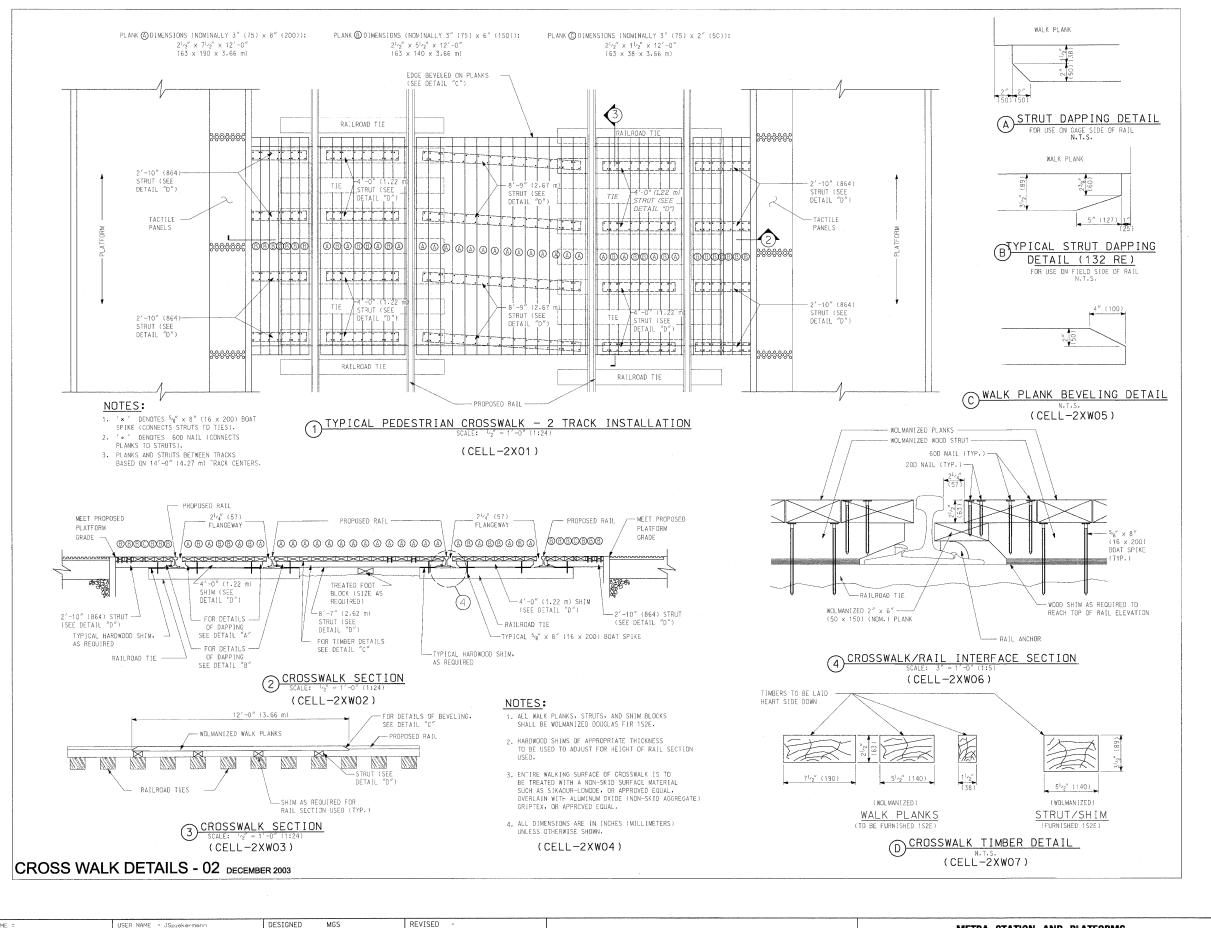



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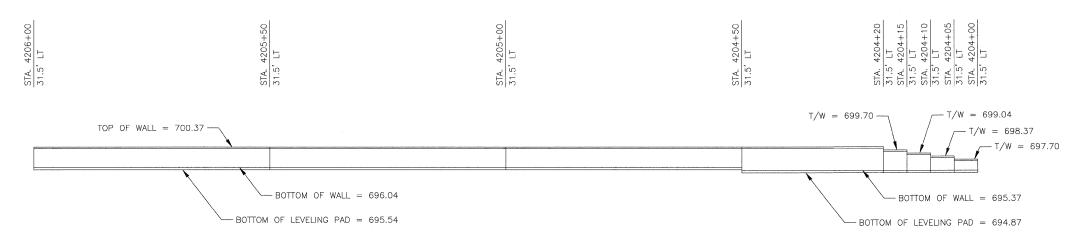




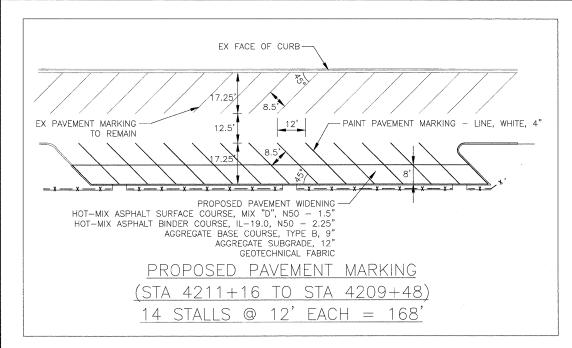

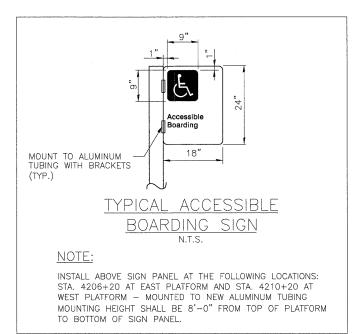
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		DRAWN	MGS	REVISED -	STATE OF ILLINOIS	DETAILS		330	2010-135-I	COOK	101 55
	PLOT SCALE = NONE	CHECKED	JRS	REVISED -	DEPARTMENT OF TRANSPORTATION	DETAILS			MS-15	CONTRACT	T NO. 60NOS
	PLOT DATE = 28/13/10	DATE	12/27/10	REVISED -		SCALE: NONE SHEET NO. 4 OF 5 SHEETS STA.	TO STA.		ILLINOIS FEE	. AID PROJECT	
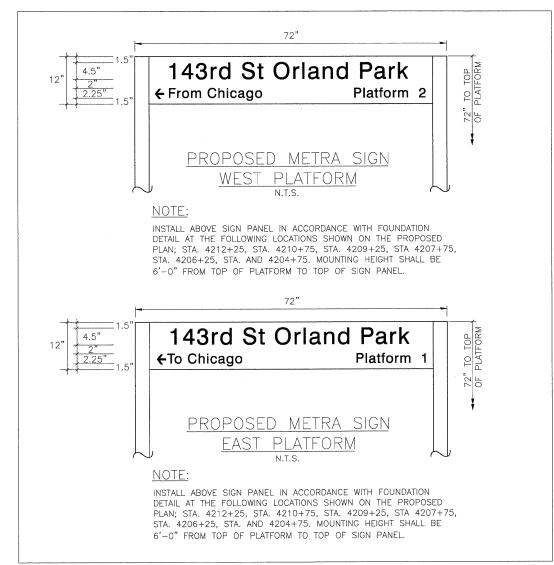
# PLATFORM - SEGMENTAL BLOCK WALL

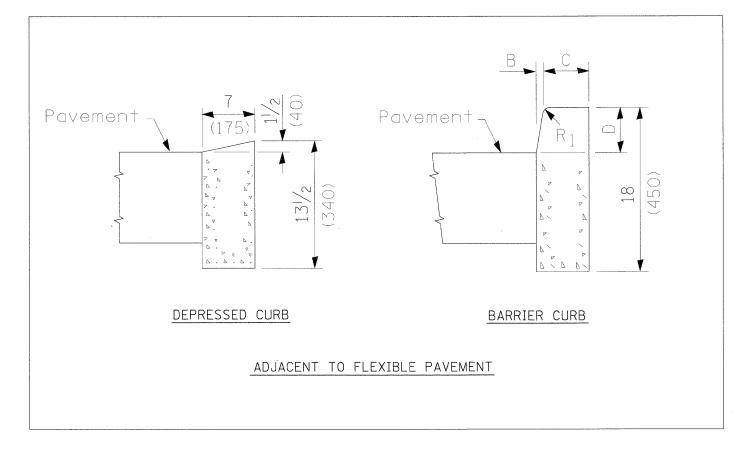

PLATFORM SEGMENTAL BLOCK WALL - ELEVATION

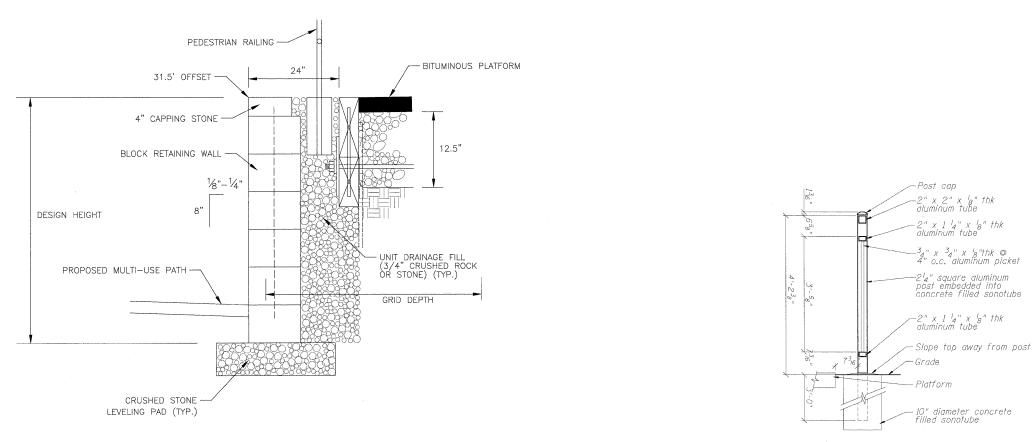

PLATFORM SEGMENTAL BLOCK WALL - TYPICAL SECTION

TYPICAL PEDESTRIAN RAILING DETAIL NEXT TO PLATFORM

FILE NAME =	USER NAME = JSpiekermann	DRAWN .	MGS	REVISED -	STATE OF ILLINOIS		METRA STATION AND PLATFORMS		RTE.	SECTION 2010-135-T	COUNTY SHEETS NO.
	PLOT SCALE = NONE	CHECKED	JRS	REVISED -	DEPARTMENT OF TRANSPORTATION		DETAILS		330	MS-16	CONTRACT NO. 60N09
	PLOT DATE = 08/13/10	DATE	12/27/10	REVISED -		SCALE: NONE	SHEET NO. 5 OF 5 SHEETS STA.	TO STA.		ILLINOIS FEE	D. AID PROJECT

#### **LEGEND**

EXISTING LIGHING UNIT TO REMAIN

-

EXISTING LIGHTING UNIT AND CONCRETE FOUNDATION

PROPOSED 400-WATT METAL HALIDE LUMINAIRE, TYPE 3 DISTRIBUTION, 30' M.H. ON DECORATIVE

PROPOSED ELECTRICAL HANDHOLE

EXISTING ELECTRICAL HANDHOLE TO REMAIN

EXISTING ELECTRICAL HANDHOLE TO BE REMOVED  $\square$ 

EXISTING ELECTRICAL HANDHOLE TO BE ADJUSTED

PROPOSED CONDUIT/WIRING. SIZES AND NUMBERS AS NOTED.

VIS SIGN

LIGHT POLE, WOOD, 40 FOOT, CLASS 3 WITH RELOCATED

400W M.H. LUMINAIRE AND 2 FOOT ARM

----A/C --- AERIAL CABLE, 3-1/C NO.8 WITH MESSENGER WIRE

LIGHT POLE, WOOD, 20 FOOT, CLASS 5

	CONDUIT	& WIRE SCHEDULE	
TAG	CONDUIT SIZE	WIRE QUANTITY AND SIZE	REMARKS
1	1 1/2 "	5#8 & 1#10 GRD	NOTE 2
2	1 1/2 "	3#8 & 1#10 GRD	NOTE 2
3	1′′	2#8 & 1#10 GRD	NOTE 2
4	1 1/2 "	8#8 & 1#10 GRD	NOTE 2
(5)	3/4 "	NOTE 1	NOTE 2
<b>(6</b> )	1′′	NOTE 1	NOTE 2
7	1 1/2 ''	NOTE 1	NOTE 2
<u>(8)</u>	1 1/4"	4#6 & 1#6 GRD	NOTE 2

- 1. PULL STRING IN CONDUIT FOR FUTURE WIRE.
- 2. REFER TO ELECTRICAL PLANS MSE-5, MSE-6 AND MSE-7 FOR CONDUIT

#### **ABBREVIATIONS**

AMPERES AMERICAN WIRE GAUGE BLDG BUILDING CONDUIT CKT CIRCUIT DIA DIAMETER DISC DISCONNECT FDN FOUNDATION FT, (') FFFT GND, GRD GROUND JB JUNCTION BOX KVA KILOVOLT AMPERE METRA METROPOLITAN RAIL MTN MINIMUM MH METAL HALIDE NTS NOT TO SCALE NO.- # NUMBER 0.C. ON CENTER PHASE PVC POLYVINYL CHLORIDE RGS RIGID GALVANIZED STEEL RR RAIL ROAD SQUARE STA. STATION THK THICK TYP TYPICAL UNO UNLESS NOTED OTHERWISE VOLT

WATT

TRANSFORMER

VISUAL INFORMATION SYSTEM

VIS

XFMR


#### ELECTRICAL GENERAL NOTES


- 1. ALL PROPOSED DUCT BANK, CONDUIT, JUNCTION BOXES AND APPURTENANCES ARE ILLUSTRATED DIAGRAMMATICALLY. THE ACTUAL LOCATIONS IN THE FIELD MUST BE APPROVED BY THE ENGINEER.
- THE CONTRACTOR MUST COORDINATE ALL WORK AND MATERIALS WITH SPECIAL ATTENTION PAID TO ALL OTHER CONSTRUCTION CONTRACTS. THIS WORK SHALL BE INCLUDED IN THE COST OF THIS CONTRACT. SEPARATE PAYMENT WILL NOT BE MADE.
- 3. THE ELECTRIC CABLE PHASE AND NEUTRAL CONDUCTORS MUST BE RUN CONTINUOUS WITHOUT ANY UNDERGROUND SPLICES UNLESS NOTED OTHERWISE ON THE DRAWINGS. SPLICING OF ELECTRIC CABLE PHASE AND NEUTRAL CONDUCTORS WILL BE PERMITTED ONLY IN THE BASE OF THE PROPOSED LIGHT POLES AND HANDHOLES WHERE SHOWN, UNLESS NOTED OTHERWISE. THIS WORK SHALL BE INCLUDED IN THE ELECTRIC CABLE PAY ITEM. SEPARATE PAYMENT WILL NOT BE MADE.
- 4. CONTRACTOR SHALL CONTACT ALL UTILITY COMPANIES FOR LOCATION OF THEIR UNDERGROUND EQUIPMENT BEFORE STARTING DIGGING
- 5. THE CONTRACTOR MUST IDENTIFY AND TAG EACH ELECTRIC CABLE ASSEMBLY IN ALL HANDHOLES, MANHOLES, CONTROLLER CABINETS AND LIGHT POLE BASES.
- 6. ALL ELECTRICAL WORK SHALL BE IN ACCORDANCE WITH THE NATIONAL ELECTRICAL CODE (NEC 2009) AND ALL LOCAL CODES AND AMENDMENTS.
- 7. THE CONTRACTOR SHALL REFER TO THE CIVIL DRAWINGS FOR LOCATIONS OF EXISTING EQUIPMENT AND UTILITIES AND FOR LOCATIONS OF PROPOSED OR RELOCATED EQUIPMENT FOUNDATIONS.

IVOI	LO

ILE NAME =

 USER NAME = JSpiekermann	DESIGNED	МВ	REVISED	-
	DRAWN	MB	REVISED	-
PLOT SCALE = NONE	CHECKED	MCP	REVISED	es.
PLOT DATE = 08/13/10	DATE	12/27/10	REVISED	_

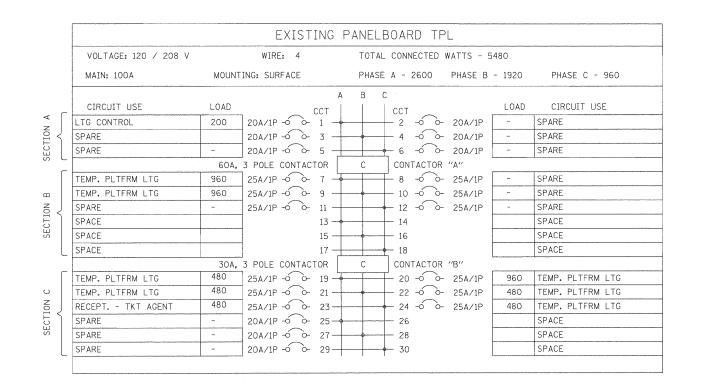

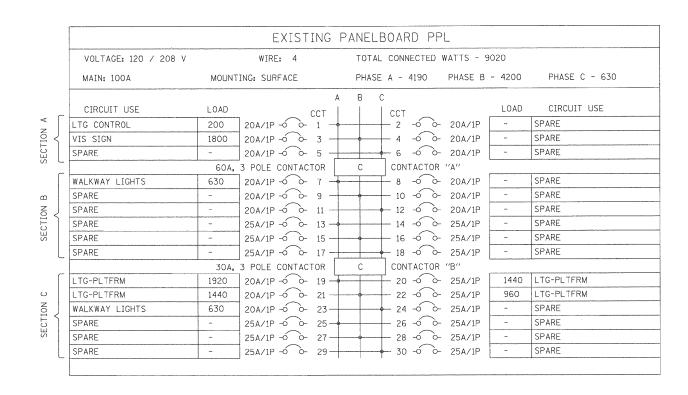

STATE OF ILLINOIS
DEPARTMENT OF TRANSPORTATION


METRA STATION AND PLATFORMS
PANEL SCHEDULES

SHEET NO. 1 OF 1 SHEETS STA. TO STA.

SCALE: NONE


F.A. RTE. SECTION COUNTY TOTAL SHEET NO. 330 2010-135-I COOK 101 58

MSE-2 CONTRACT NO. 60N09

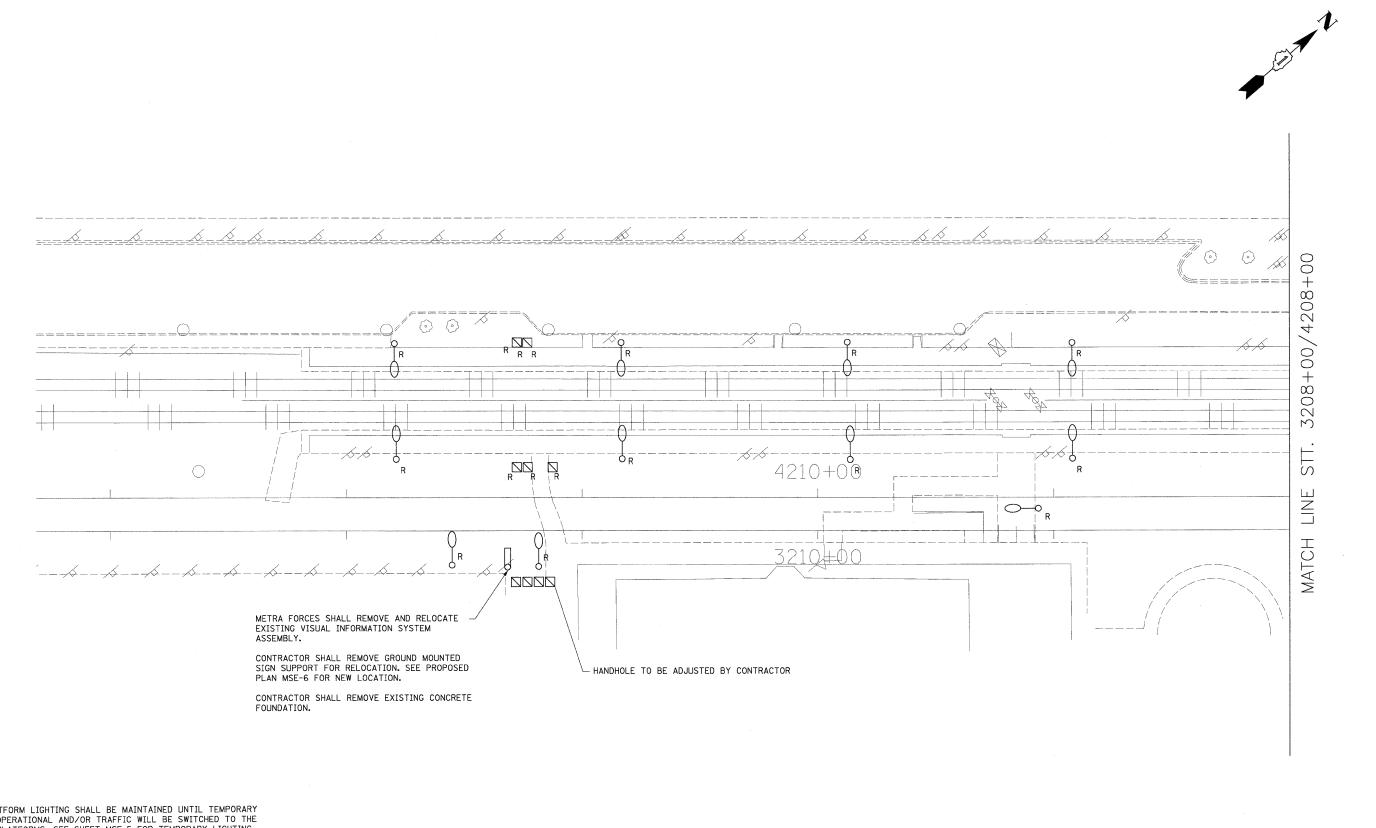



EXISTING PLATFORM LIGHTING SHALL BE MAINTAINED UNTIL TEMPORARY LIGHTING IS OPERATIONAL AND/OR TRAFFIC WILL BE SWITCHED TO THE NEW TRACKS/PLATFORMS. SEE SHEET MSE-5 FOR TEMPORARY LIGHTING.

CONTRACTOR SHALL REMOVE ALL PLATFORM LIGHTING.

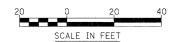

FILE NAME =	USER NAME = JSpiekermann	DESIGNED	МВ	REVISED -			METRA STATION AND PLATFORMS	F.A. RTE.	SECTION	COUNTY TOTAL SHEET NO.
		DRAWN	MB	REVISED -	STATE OF ILLINOIS		ELECTRICAL EXISTING AND DEMOLITION PLAN	330	2010-135-I	COOK 101 59
	PLOT SCALE = 1' = 20'	CHECKED	MCP	REVISED -	DEPARTMENT OF TRANSPORTATION		LECTRICAL EXISTING AND DEMOLITION FLAN		MSE-3	CONTRACT NO. 60N09
	PLOT DATE = 08/13/10	DATE	12/27/10	REVISED -		SCALE: 1"=20"	SHEET NO. 1 OF 2 SHEETS STA. TO STA.		ILLINOIS FED	). AID PROJECT

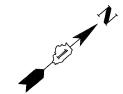

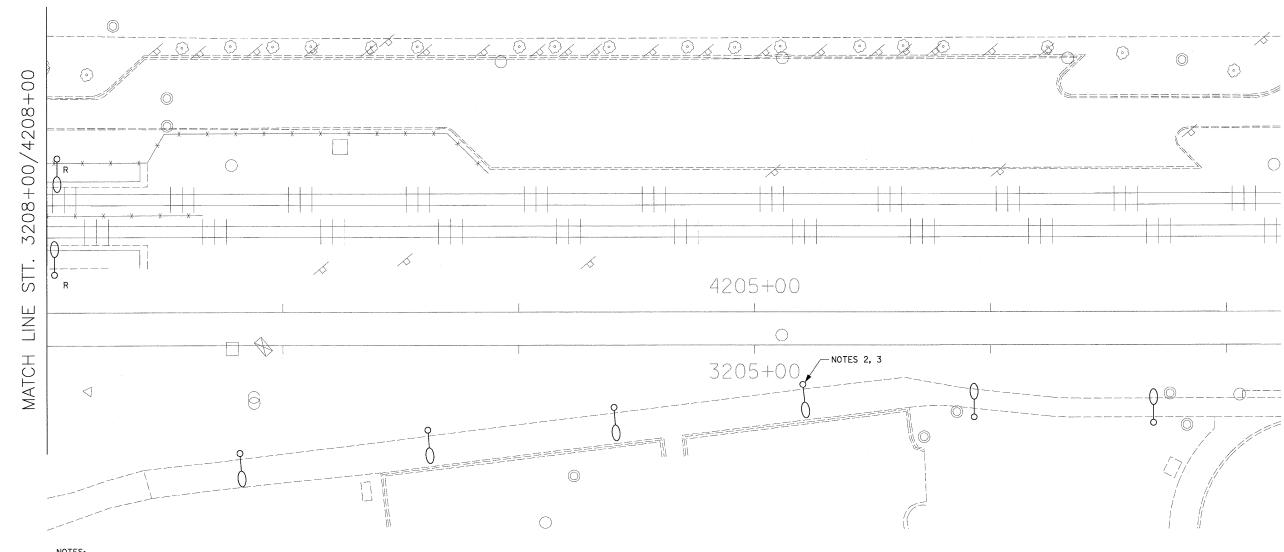



#### NOTES:

- 1. EXISTING PLATFORM LIGHTING SHALL BE MAINTAINED UNTIL TEMPORARY LIGHTING IS OPERATIONAL AND/OR TRAFFIC WILL BE SWITCHED TO THE NEW TRACKS/PLATFORMS. SEE SHEET MSE-5 FOR TEMPORARY LIGHTING.
- REMOVE AND RELOCATE EXISTING LIGHTING UNIT ON NEW LIGHT POLE FOUNDATION. ABANDON THE EXISTING WIRING. SEE PROPOSED PLAN MSE-7 FOR NEW LOCATION.
- 3. REMOVE CONCRETE FOUNDATION.



	FILE NAME =	USER NAME = JSpiekermann	DESIGNED	мв	REVISED -			METRA STATION AND PLATFORMS	F.A. RTE.	SECTION	COUNTY SHEETS NO.
			DRAWN	мВ	REVISED -	STATE OF ILLINOIS		ELECTRICAL EXISTING AND DEMOLITION PLAN	330	2010-135-I	COOK 101 60
- 1		PLOT SCALE = 1" = 20"	CHECKED	MCP	REVISED -	DEPARTMENT OF TRANSPORTATION		ELECTRICAL EXISTING AND DEMOLITION FLAN		MSE-4	CONTRACT NO. 60N09
		PLOT DATE = 08/13/10	DATE	12/27/10	REVISED -		SCALE: 1"=20"	SHEET NO. 2 OF 2 SHEETS STA. TO STA.		ILLINOIS FED.	AID PROJECT

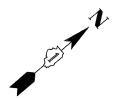

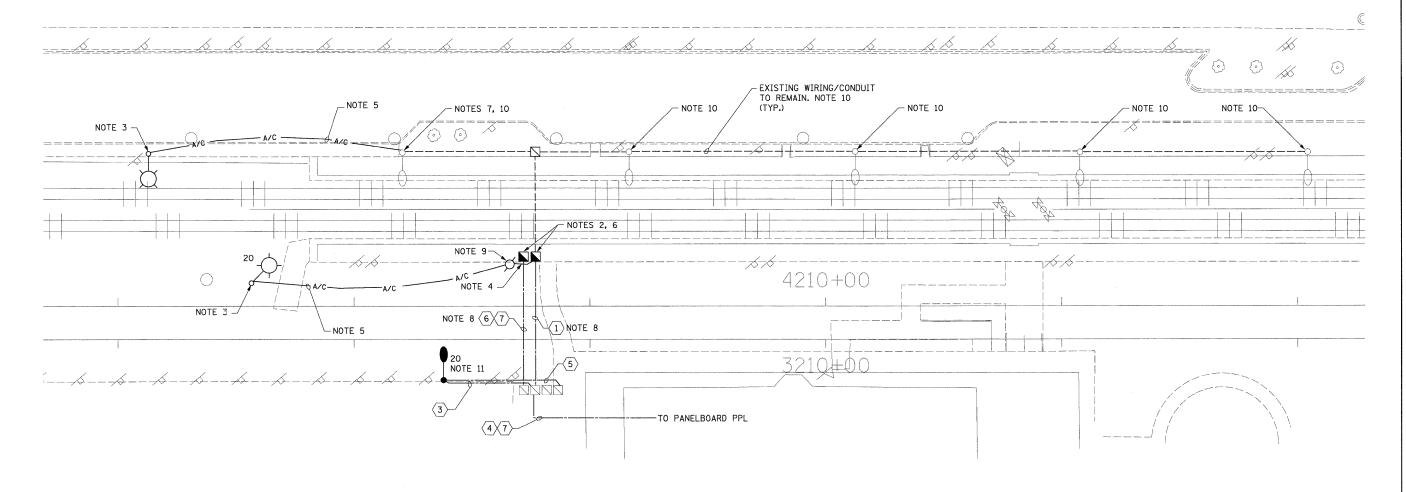

#### NOTES


- 1. CONTRACTOR SHALL FURNISH ALL MATERIALS AND RELATED COMPONENTS FOR TEMPORARY LIGHTING AS SHOWN. METRA FORCES SHALL INSTALL AND WIRE ALL WORK AS SHOWN.
- 2. CONTRACTOR SHALL FURNISH NEW HANDHOLE, PORTLAND CEMENT CONCRETE FOR INSTALLATION BY METRA.
- 3. CONTRACTOR SHALL FURNISH LIGHT POLE, WOOD, 40 FOOT, CLASS 3 FOR INSTALLATION BY METRA FORCES. METRA FORCES SHALL REMOVE FIXTURE AND ARM FROM EXISTING PLATFORM LIGHTING POLES AND INSTALL THEM ON THE WOOD POLE USING PROPER HARDWARE. THE LUMINAIRE SHALL HAVE A 30 FT. MOUNTING HEIGHT FROM THE TEMPORARY SIDEWALK.
- 4. CONTRACTOR SHALL FURNISH 1 1/2" CONDUIT FOR INSTALLATION BY METRA FORCES BETWEEN NEW HANDHOLE AND TEMPORARY 20 FOOT WOOD POLE. METRA FORCES SHALL EXTEND THE CONDUITS 10" UP THE WOOD POLE. METRA FORCES SHALL RUN AERIAL CABLE FROM LIGHTING HANDHOLE TO THE TOP OF THE WOOD POLE.
- 5. CONTRACTOR SHALL FURNISH AERIAL CABLE, 3 1/C NO. 8 WITH MESSENGER WIRE FOR INSTALLATION BY METRA FORCES.
- 6. METRA FORCES SHALL INTERCEPT EXISTING WIRING AT THE NEW HANDHOLE LOCATION AND CONNECT IT TO THE PROPER CIRCUITS COMING FROM THE EXISTING HANDHOLES ON NORTH-EAST SIDE.

- 7. METRA FORCES SHALL CONNECT AERIAL CABLE AT THE LIGHT CIRCUIT IN THE POLE'S HANDHOLE AND RUN IT TO THE TOP OF THE POLE AND TO THE LIGHT POLE, WOOD.
- 8. METRA FORCES SHALL COORDINATE THE INSTALLATION DEPTH OF THE CONDUIT(S) WITH OTHER TRADES.
- 9. CONTRACTOR SHALL FURNISH LIGHT POLE, WOOD, 20 FOOT, CLASS 5 FOR INSTALLATION BY METRA FORCES. INSTALL THE POLE TANGENT TO EXISTING PLATFORM.
- 10.EXISTING AND/OR TEMPORARY PLATFORM LIGHTING SHALL BE MAINTAINED UNTIL TRAFFIC WILL BE SWITCHED TO THE NEW TRACKS/PLATFORMS.
- 11. CONTRACTOR SHALL FURNISH NEW LIGHT POLE, LUMINAIRE AND RELATED COMPONENTS AS SHOWN. FOR DETAILS, SEE SHEET MSE-8. METRA FORCES SHALL INSTALL AND WIRE ALL WORK AS SHOWN.



FILE NAME =	USER NAME = JSpiekermann	DESIGNED	мв	REVISED ~			METRA STATION AND PLA	TEURMS	F.A. RTF.	SECTION	COUNTY	TOTAL SHEET
		DRAWN	MB	REVISED -	STATE OF ILLINOIS		ELECTRICAL TEMPORARY		330	2010-135-I	СООК	101 61
	PLOT SCALE = 1" = 20"	CHECKED	MCP	REVISED -	DEPARTMENT OF TRANSPORTATION		ELECTRICAL TENTONANT	FLAN		MSE-5	CONTRACT	NO. 60N09
	PLOT DATE = 08/13/10	DATE	12/27/10	REVISED -		SCALE: 1"=20"	SHEET NO. 1 OF 1 SHEETS STA	. TO STA.		ILLINOIS FED.	AID PROJECT	



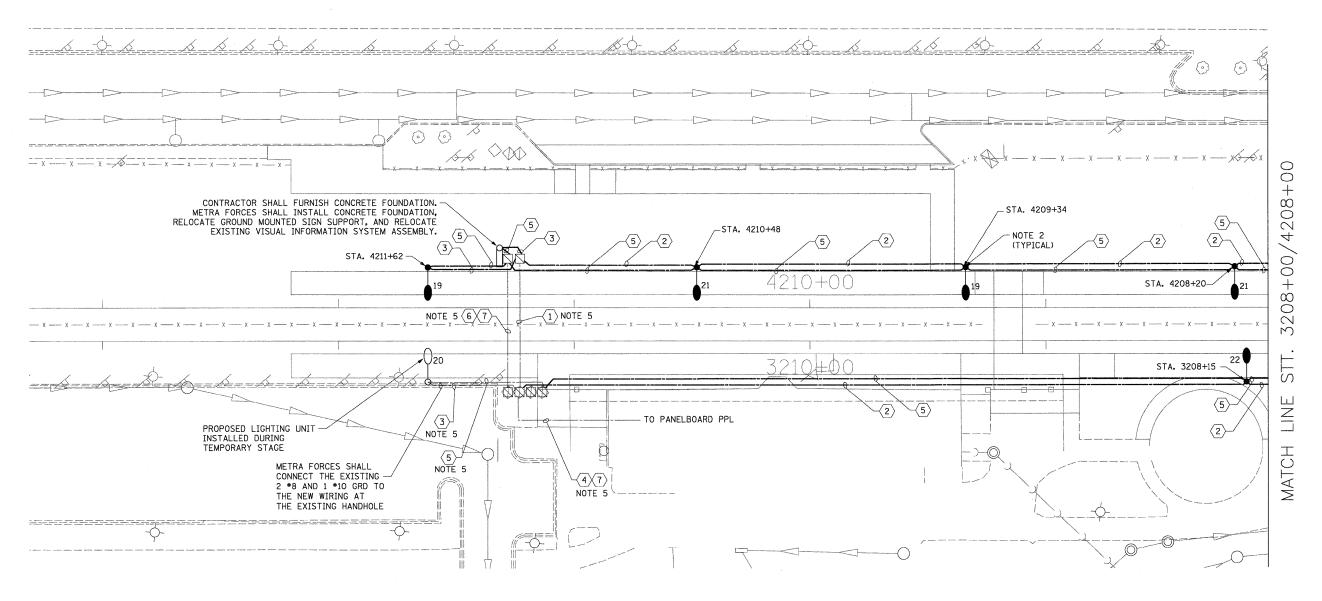



#### NOTES:

- 1. REFER TO SHEET MSE-1 FOR SYMBOLS, ABBREVIATIONS AND GENERAL NOTES.
- CONTRACTOR SHALL FURNISH NEW LIGHT POLE FOUNDATION, CONDUITS, WIRING, LIGHT POLES, LUMINAIRES AND RELATED COMPONENTS AS SHOWN. FOR DETAILS, SEE SHEET MSE-8. METRA FORCES SHALL INSTALL AND WIRE ALL WORK AS SHOWN.
- 3. FOR PANEL SCHEDULE, SEE SHEET MSE-2.
- 4. FOR CONDUIT AND WIRING SCHEDULE, SEE SHEET MSE-1.
- 5. CONDUITS AND WIRES INSTALLED DURING TEMPORARY STAGE, SEE SHEET MSE-5.



- 1	FILE NAME =	USER NAME = JSpiekermann	DESIGNED	MB	REVISED -			METRA STATION AND PLATFORMS	RTE.	SECTION	COUNTY	SHEETS NO.
			DRAWN	MB	REVISED -	STATE OF ILLINOIS		PROPOSED ELECTRICAL PLAN	330	2010-135-I	COOK	101 62
		PLOT SCALE = 1' = 20'	CHECKED	MCP	REVISED -	DEPARTMENT OF TRANSPORTATION		FROFUSED ELECTRICAL FLAN		MSE-6	CONTRACT	NO. 60N09
		PLOT DATE = 08/13/10	DATE	12/27/10	REVISED -		SCALE: 1"=20"	SHEET NO. 1 OF 2 SHEETS STA. TO STA.		ILLINOIS FED.	AID PROJECT	

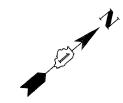


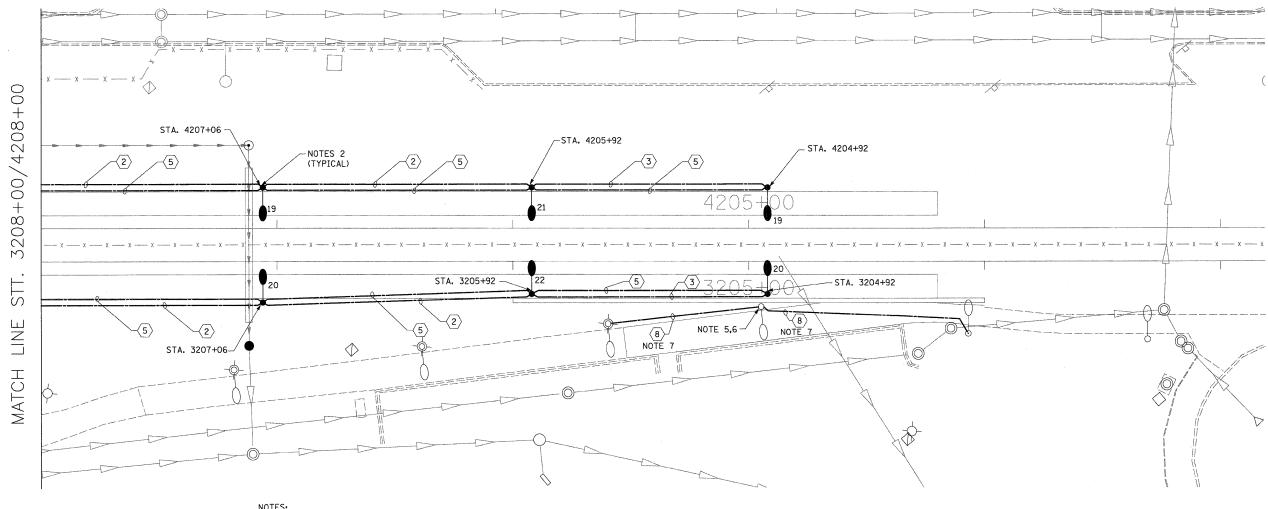

- REFER TO SHEET MSE-1 FOR SYMBOLS, ABBREVIATIONS AND GENERAL NOTES.
- CONTRACTOR SHALL FURNISH NEW LIGHT POLE FOUNDATION, CONDUITS, WIRING, LIGHT POLES, LUMINAIRES AND RELATED COMPONENTS AS SHOWN. FOR DETAILS, SEE SHEET MSE-8. METRA FORCES SHALL INSTALL AND WIRE ALL WORK AS SHOWN.
- 3. FOR PANEL SCHEDULE, SEE SHEET MSE-2.
- 4. FOR CONDUIT AND WIRING SCHEDULE, SEE SHEET MSE-1.
- CONTRACTOR SHALL INSTALL LIGHT POLE FOUNDATION TANGENT TO RETAINING WALL, BETWEEN WALL AND PROPOSED PATH.
- 6. CONTRACTOR SHALL RELOCATE EXISTING LIGHTING UNIT ON NEW FOUNDATION.
- CONTRACTOR SHALL INSTALL NEW CONDUIT AND WIRING FROM RELOCATED POLE TO EXISTING POLES. SPLICE TO EXISTING CIRCUIT IN EXISTING LIGHT POLE HANDHOLE. CHANGE OVER SHALL BE DONE DURING DAYLIGHT HOURS AFTER ALL OTHER WORK IS DONE. MAINTAIN EXISTING LIGHTING DURING HOURS OF DARKNESS. ALL MATERIAL AND LABOR FOR CONNECTING NEW WIRING TO EXISTING LIGHT POLE SHALL BE INCLUDED IN THE "CONDUIT IN TRENCH, 11/4" DIA. COILABLE NONMETALLIC CONDUIT" PAY ITEM. SEPARATE PAYMENT WILL NOT BE MADE.





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	PLOT DATE = 08/13/10	DATE	12/27/10	REVISED -		SCALE: 1"=20" SHEET NO. 2 OF 2 SHEETS STA. TO STA.		ILLINOIS F	ED. AID PROJECT	

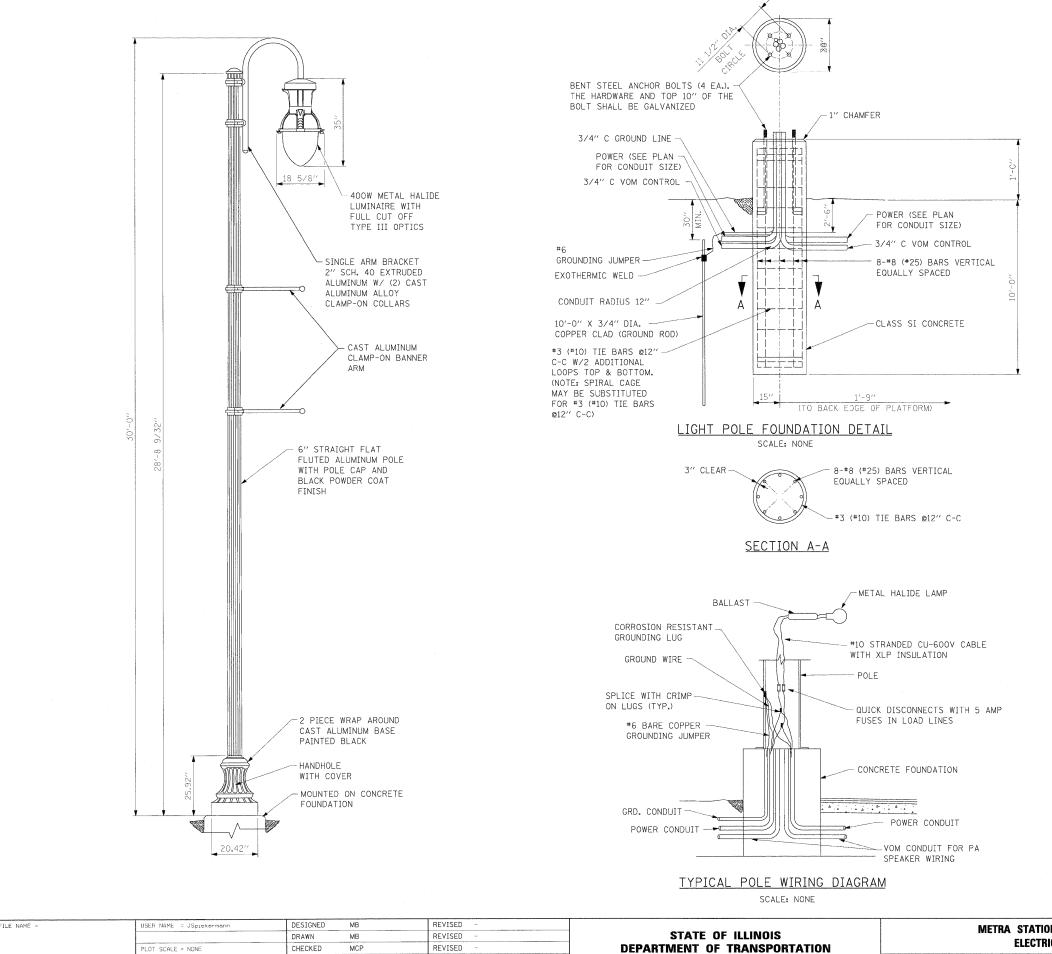

12/27/10

REVISED

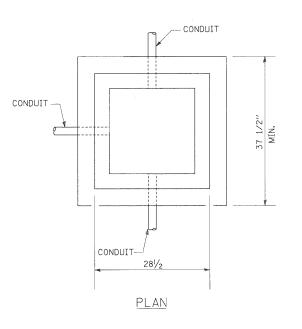

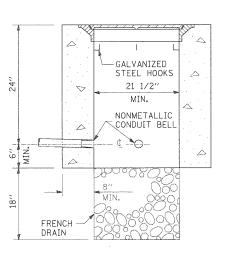

ELEVATION


PORTLAND CEMENT CONCRETE


HANDHOLE

<u>IIIIII TOEC</u>


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ELECTRICAL DETAILS	330	2010-135-I	COOK	101	64
ELECTIONE DETAILS		MSE-8	CONTRACT	NO. 6	0N09
SHEET NO. 1 OF 2 SHEETS STA. TO STA.	ļ	ILLINOIS FED. AI	PROJECT		

SCALE: NONE

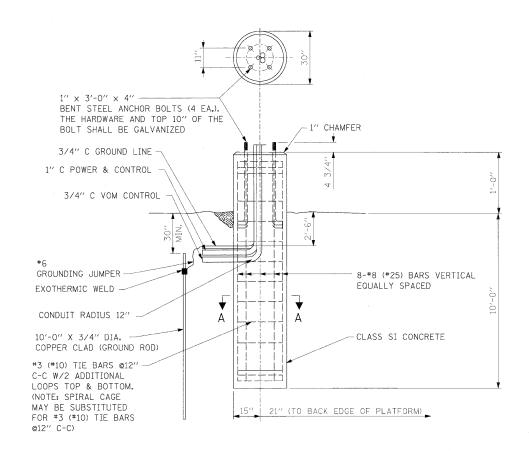


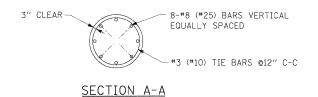

NEW VIS POLE FOUNDATION DETAIL SCALE: NONE

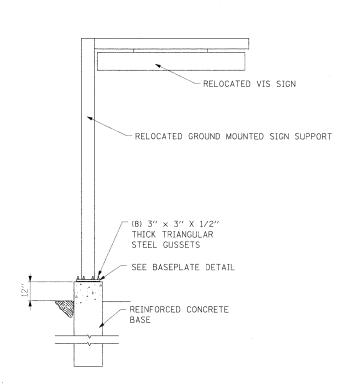

VIS POLE DETAIL
SCALE: NONE

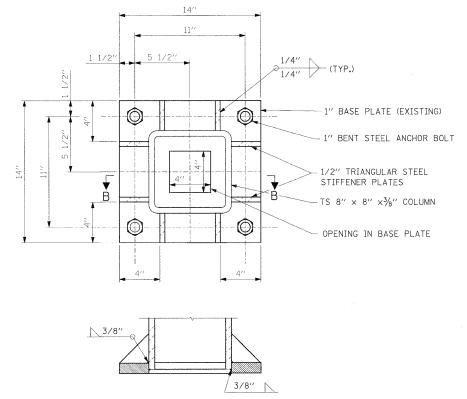


SECTION B-B

RELOCATED BASE PLATE DETAIL


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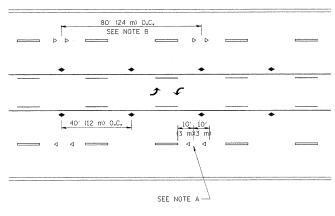
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		DRAWN	МВ	REVISED -	STATE OF ILLINOIS		ELECTRICAL DETAILS	330	2010-135-I	COOK 10	01 65
	PLOT SCALE = NONE	CHECKED	MCP	REVISED -	DEPARTMENT OF TRANSPORTATION	ELECTRICAL DETAILS			MSE-9	CONTRACT NO.	60N09
	PLOT DATE = 08/13/10	DATE	12/27/10	REVISED -		SCALE: NONE	SHEET NO. 2 OF 2 SHEETS STA. TO STA.		ILLINOIS FEE	. AID PROJECT	

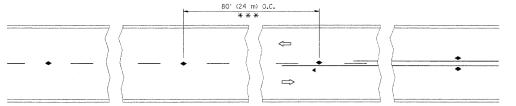


\*\*\* REDUCE TO 40' (12 m) O.C. ON CURVES WITH POSTED OR ADVISORY SPEED 45 M.P.H. (70 km/h) OR LESS.

#### TWO-LANE/TWO-WAY




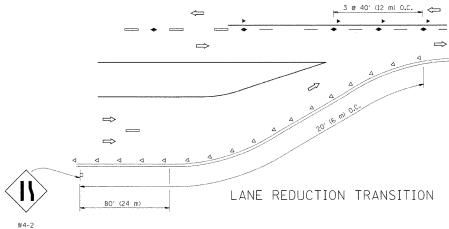

TWO-WAY LEFT TURN

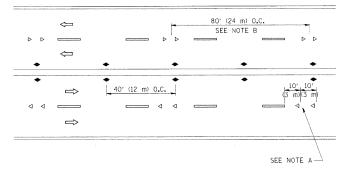

MULTI-LANE/UNDIVIDED

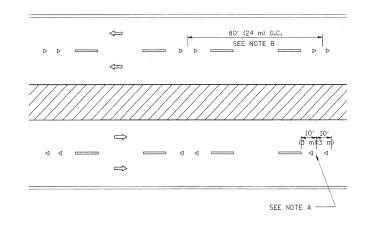

MULTI-LANE/DIVIDED

#### GENERAL NOTES

- MARKERS USED WITH DASHED LINES SHALL BE CENTERED IN THE GAP BETWEEN SEGMENTS.
- 2. MARKERS USED ADJACENT TO SOLID LINES SHALL BE OFFSET 2 TO 3 (50 TO 75) TOWARD TRAFFIC AS SHOWN.
- 3. MARKERS THROUGH TANGENTS LESS THAN 500' (150 m) IN LENGTH BETWEEN CURVES SHALL BE INSTALLED AT THE LESSER OF THE TWO CURVE SPACINGS.

#### LANE MARKER NOTES

A. USE DOUBLE LANE LINE MARKERS SPACED AS SHOWN.

B. REDUCE TO 40' (12 m) O.C. ON CURVES WHERE ADVISORY SPEEDS ARE 10 M.P.H (20 km/h) LOWER THAN POSTED SPEEDS.

#### SYMBOLS

---- YELLOW STRIPE

WHITE STRIPE

■ ONE-WAY AMBER MARKER

- ONE-WAY CRYSTAL MARKER (₩/O)
- ◆ TWO-WAY AMBER MARKER

#### DESIGN NOTES

- 1. DOUBLE LANE LINE MARKERS SHALL BE USED UNLESS SPECIFIED OTHERWISE.
- 2. EXCEPT AS SHOWN ON THE LANE REDUCTION TRANSITION AND FREEWAY EXIT RAMP DETAIL, MARKERS ARE NOT TO BE SPECIFIED ON RIGHT EDGE LINES.
- 3. THE EXACT MARKER LIMITS, SPACING, AND COLOR SHOULD BE INCLUDED IN THE PLANS.
- 4. MARKERS SHOULD NOT BE USED ALONGSIDE CURBS EXCEPT FOR EXTREMELY SHORT SECTIONS OF CURBS WHERE NOT MORE THAN TWO MARKERS WOULD BE INVOLVED.

## 


LEFT TURN


All dimensions are in inches (millimeters) unless otherwise shown.

FILE NAME =	USER NAME = drivakosgn	DESIGNED -		REVISED	T. RAMMACHER	09-19-94
c:\pw.work\pwidot\drivakosgn\d0108315\tc	ll.dgn	DRAWN -		REVISED	-T. RAMMACHER	03-12-99
	PLOT SCALE = 50.000 '/ IN.	CHECKED -		REVISED	-T. RAMMACHER	01-06-00
	PLOT DATE = 9/9/2009	DATE -	12/17/10	REVISED	- C. JUCIUS	09-09-09


STATE OF ILLINOIS DEPARTMENT OF TRANSPORTATION

TYPICAL APPLICATIONS								
RAISED	REFLECTIVE PAVEMENT MARKERS (SNOW-F	PLOW RESISTANT)						
SCALE: NONE	SHEET NO. 1 OF 1 SHEETS STA.	TO STA.						

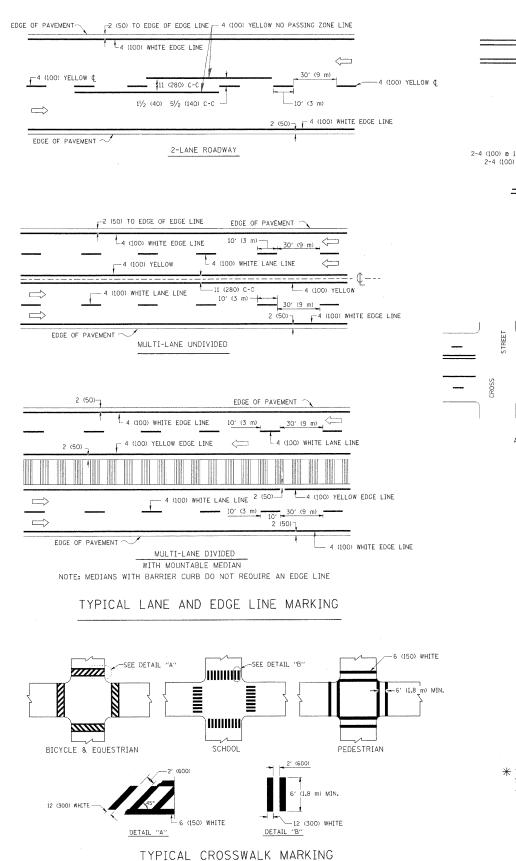

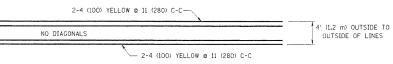


#### 4' (1.2 m) WIDE MEDIANS ONLY

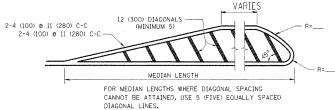


DIAGONAL LINE SPACING: 50' (15 m) C-C (LESS THAN 30MPH (50 km/h))
75' (25 m) C-C (30MPH (50 km/h)) TO 45MPH (70 km/h))
150' (45 m) C-C (MORE THAN 45MPH (70 km/h))

#### MEDIANS OVER 4' (1.2 m) WIDE

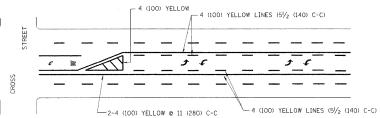


A MINIMUM OF TWO PAIRS OF TURN ARROWS SHALL BE USED, WHITE IN COLOR. ADDITIONAL PAIRS SHALL BE PLACED AT 200' (60 m) TO 300' (90 m) INTERVALS.

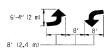

MEDIAN WITH TWO-WAY LEFT TURN LANE

#### TYPICAL PAINTED MEDIAN MARKING

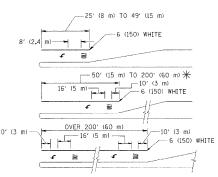


FULL SIZE LETTERS B' (2.4 m) AND ARROWS SHALL BE USED.  $\P_1$  AREA = 15.6 SO. FT. (1.5 m² )  $\Pi$  AREA = 20.8 SO. FT. (1.9 m²)

\* TURN LANES IN EXCESS OF 400' (120 m) IN LENGTH MAY HAVE AN ADDITIONAL SET OF ARROW - "ONLY" INSTALLED MIDWAY BETWEEN THE OTHER TWO SETS OF ARROW - "ONLY".

TYPICAL LEFT (OR RIGHT) TURN LANE

#### TYPICAL TURN LANE MARKING

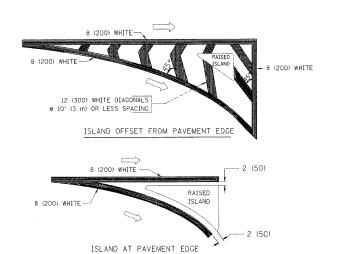

### TYPICAL ISLAND MARKING

TYPE OF MARKING	WIDTH OF LINE	PATTERN	COLOR	SPACING / REMARKS
CENTERLINE ON 2 LANE PAVEMENT	4 (100)	SKIP-DASH	YELLOW	10' (3 m) LINE WITH 30' (9 m) SPACE
CENTERLINE ON MULTI-LANE UNDIVIDED PAVEMENT	2 @ 4 (100)	SOLID	YELLOW	11 (280) C-C
NO PASSING ZONE LINES: FOR ONE DIRECTION FOR BOTH DIRECTIONS	4 (100) 2 @ 4 (100)	SOLID SOLID	YELLOW YELLOW	5½ (140) C-C FROM SKIP-DASH CENTERLINE 11 (280) C-C OMIT SKIP-DASH CENTERLINE BETWEEN
LANE LINES	4 (100) 5 (125) ON FREEWAYS	SKIP-DASH SKIP-DASH	WHITE WHITE	10' (3 m) LINE WITH 30' (9 m) SPACE
DOTTED LINES (EXTENSIONS OF CENTER, LANE OR TURN LANE MARKINGS)	SAME AS LINE BEING EXTENDED	SKIP-DASH	SAME AS LINE BEING EXTENDED	2' (600) LINE WITH 6' (1.8 m) SPACE
EDGE LINES	4 (100)	SOLID	YELLOW-LEFT WHITE-RIGHT	OUTLINE MOUNTABLE MEDIANS IN YELLOW; EDGE LINES ARE NOT USED NEXT TO BARRIER CURB
TURN LANE MARKINGS	6 (150) LINE; FULL SIZE LETTERS & SYMBOLS (8' (2.4m))	SOLID	WHITE	SEE TYPICAL TURN LANE MARKING DETAIL
TWO WAY LEFT TURN MARKING	2 @ 4 (100) EACH DIRECTION	SKIP-DASH AND SOLID	YELLOW	10' (3 m) LINE WITH 30' (9 m) SPACE FOR SKIP-DASH; 5½ (140) C-C BETWEEN SOLID LINE AND SKIP-DASH LINE
	8' (2.4m) LEFT ARROW	IN PAIRS	WHITE	SEE TYPICAL TWO-WAY LEFT TURN MARKING DETAIL
CROSSWALK LINES (PEDESTRIAN) A. DIAGONALS (BIKE & EQUESTRIAN) B. LONGITUDINAL BARS (SCHOOL)	2 @ 6 (150) 12 (300) @ 45° 12 (300) @ 90°	SOLID SOLID SOLID	WHITE WHITE WHITE	NOT LESS THAN 6' (1.8 m) APART 2' (500) APART 2' (500) APART 5' (500) APART SEE TYPICAL CROSSWALK MARKING DETAILS.
STOP LINES	24 (600)	SOLID	WHITE	PLACE 4' (1,2 m) IN ADVANCE OF AND PARALLEL TO CROSSWALK, IF PRESENT. OTHERWISE, PLACE AT DESIRED STOPPING POINT. PARALLEL TO CROSSROAD CENTERLINE, WHERE POSSIBLE
PAINTED MEDIANS	2 @ 4 (100) WITH 12 (300) DIAGONALS	SOLID	YELLOW: TWO WAY TRAFFIC	11 (280) C-C FOR THE DOUBLE LINE
	© 45°  NO DIAGONALS USED FOR 4' (1.2 m) WIDE MEDIANS		WHITE: ONE WAY TRAFFIC	SEE TYPICAL PAINTED MEDIAN MARKING.
GORE MARKING AND CHANNELIZING LINES	8 (200) WITH 12 (300) DIAGONALS @ 45°	SOLID	WHITE	DIAGONALS: 15' (4,5 m) C-C (LESS THAN 30MPH (50 km/h)) 20' (6 m) C-C 30MPH (50 km/h) TO 45MPH (70 km/h)) 30' (9 m) C-C (OVER 45MPH (70 km/h))
RAILROAD CROSSING	24 (600) TRANSVERSE LINES; "RR" IS 6' (1.8 m) LETTERS; 16 (400) LINE FOR "X"	SOLID	WHITE	SEE STATE STANDARD 780001 AREA OF: "R"=3.6 SQ. FT. (0.33 m <sup>2</sup> ) EACH "X"=54.0 SQ. FT. (5.0 m <sup>2</sup> )
SHOULDER DIAGONALS	12 (300) @ 45°	SOLID	WHITE - RIGHT YELLOW - LEFT	50' (15 m) C-C (LESS THAN 30MPH (50 km/h)) 75' (25 m) C-C (30 MPH (50 km/h) TO 45MPH (70 km/h)) 1150' (45 m) C-C (0VER 45MPH (70 km/h))


FOR FURTHER DETAILS ON PAVEMENT MARKING REFER TO STANDARD SPECIFICATIONS FOR ROAD AND BRIDGE CONSTRUCTION AND STATE STANDARD 780001.


All dimensions are in inches (millimeters) unless otherwise shown.


FILE NAME =	USER NAMÉ = drivakosan	DESIGNED -	EVERS	REVISED	-T. RAMMACHER	10-27-94
c:\pw_work\pwidot\drivakosgm\d0108315\tc	l3₊dgn	DRAWN -		REVISED	-C. JUCIUS	09-09-09
	PLOT SCALE = 50.000 '/ IN.	CHECKED -		REVISED	-	
	PLGT DATE = 9/9/2009	DATE -	03-19-90	REVISED	-	

STATE	OF	ILLINOIS
DEPARTMENT	0F	TRANSPORTATION


	DISTRICT ONE						F.A.P. RTE.	SECTION	COUNTY	TOTAL SHEETS	OTAL SHEET HEETS NO.	
	TYPICAL PAVEMENT MARKINGS					330	2010-135-I	COOK	101	67		
							TC-13	CONTRACT	NO. 6	ON09		
	SCALE: NONE	SHEET NO. 1	OF 1	SHEETS	STA.	TO STA.	FED. RO	DAD DIST. NO. 1   ILLINOIS FED. A	ID PROJECT			

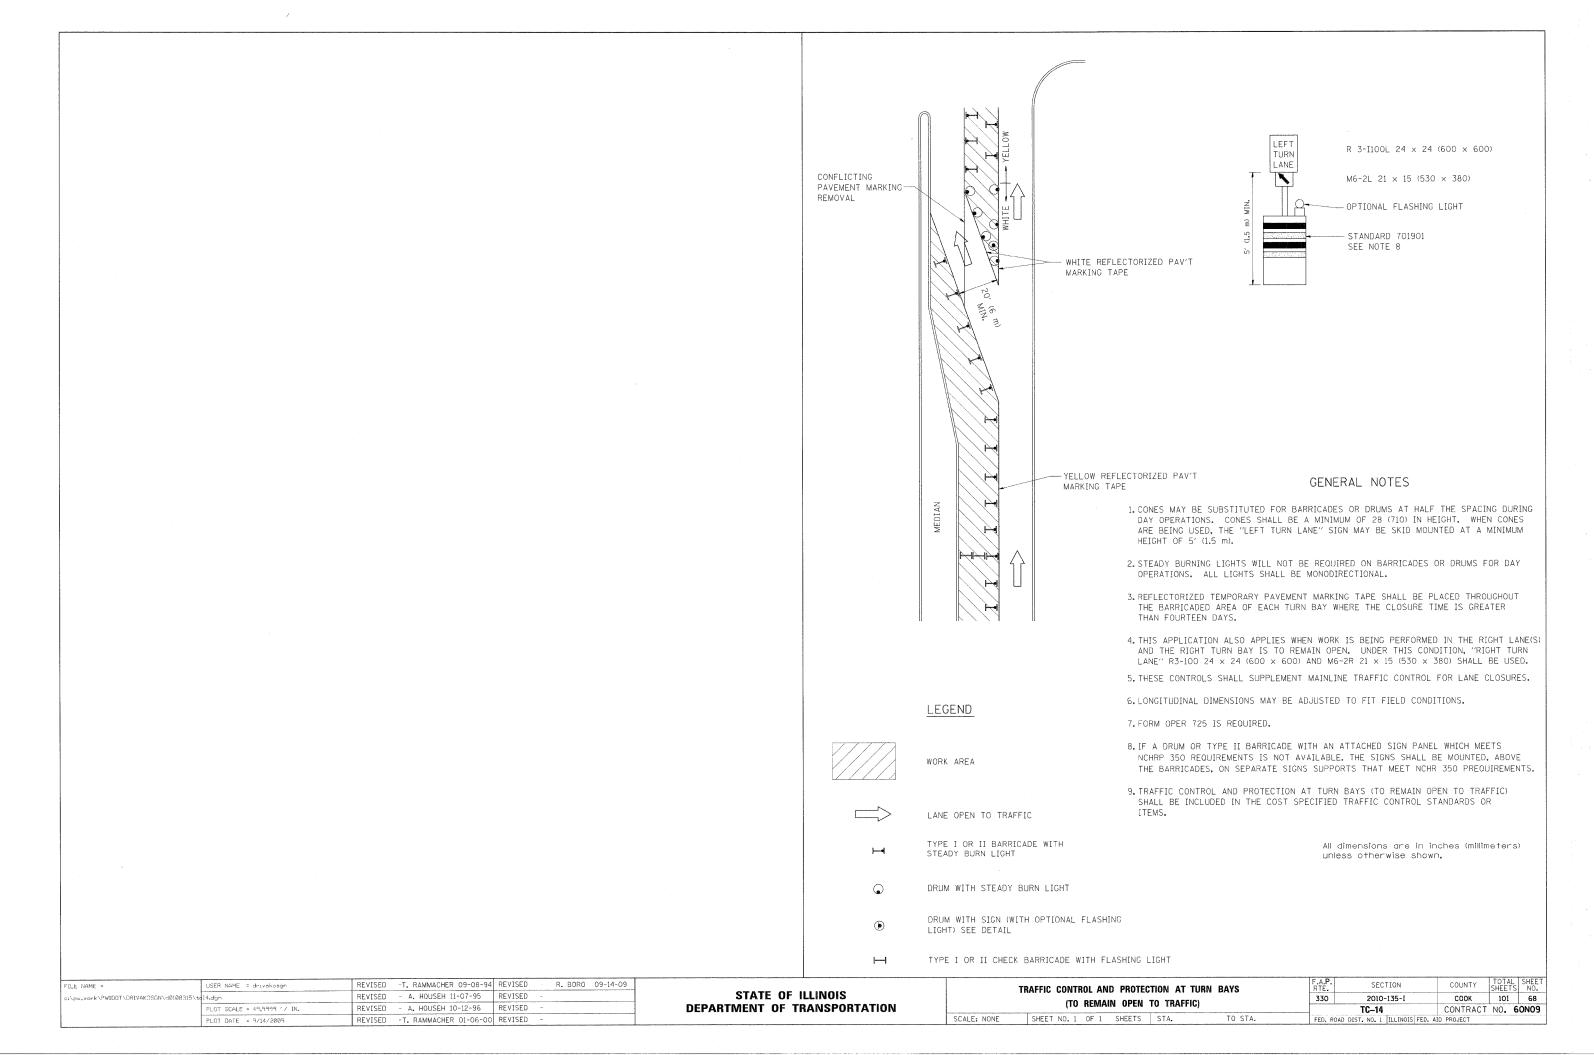

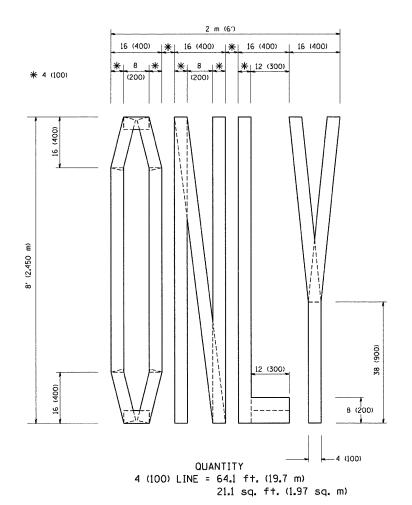

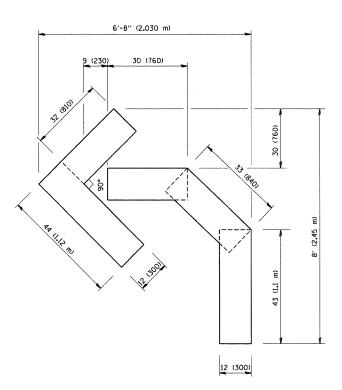

OUANTITY 4 (100) LINE = 45.5 ft. (13.9 m) 15.2 sq. ft. (1.39 sq. m)

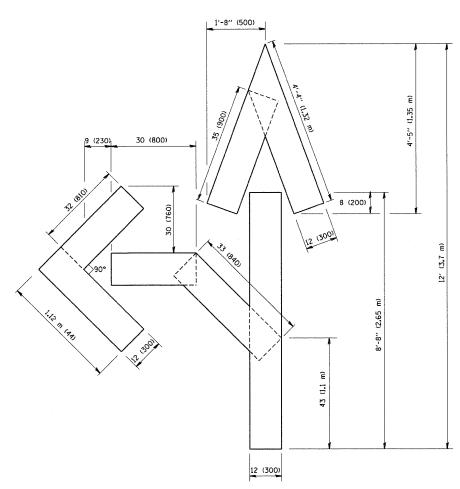


OUANTITY 4 (100) LINE = 82.5 ft. (25.3 m) 27.5 sq. ft. (2.53 sq. m)


All dimensions are in inches (millimeters) unless otherwise shown.

FILE NAME =	USER NAME = gaglianobt	DESIGNED -	REVISED -T. RAMMACHER 06-05-96
W:\diststd\22x34\to16.dgn		DRAWN -	REVISED -T. RAMMACHER 11-04-97
	PLOT SCALE = 50.0000 '/ IN.	CHECKED -	REVISED -T. RAMMACHER 03-02-98
	PLOT DATE = 1/4/2008	DATE - 09-18-94	REVISED - E. GOMEZ 08-28-00

STATE	OF	ILLINOIS	
DEPARTMENT	OF '	TRANSPORTATION	

PAVEMENT MARKING LETTERS AND SYMBOLS					RTE.	SECTION	COUNTY	SHEETS	S SHEE
FOR TRAFFIC STAGING						2010-135-I	соок	101	69
	run Inafric Stading					TC-16	CONTRACT	NO.	60N0
SCALE: NONE	SHEET NO. 1 OF 1	SHEETS	STA.	TO STA.	FED. R	OAD DIST. NO. 1   ILLINOIS FED. A	D PROJECT		

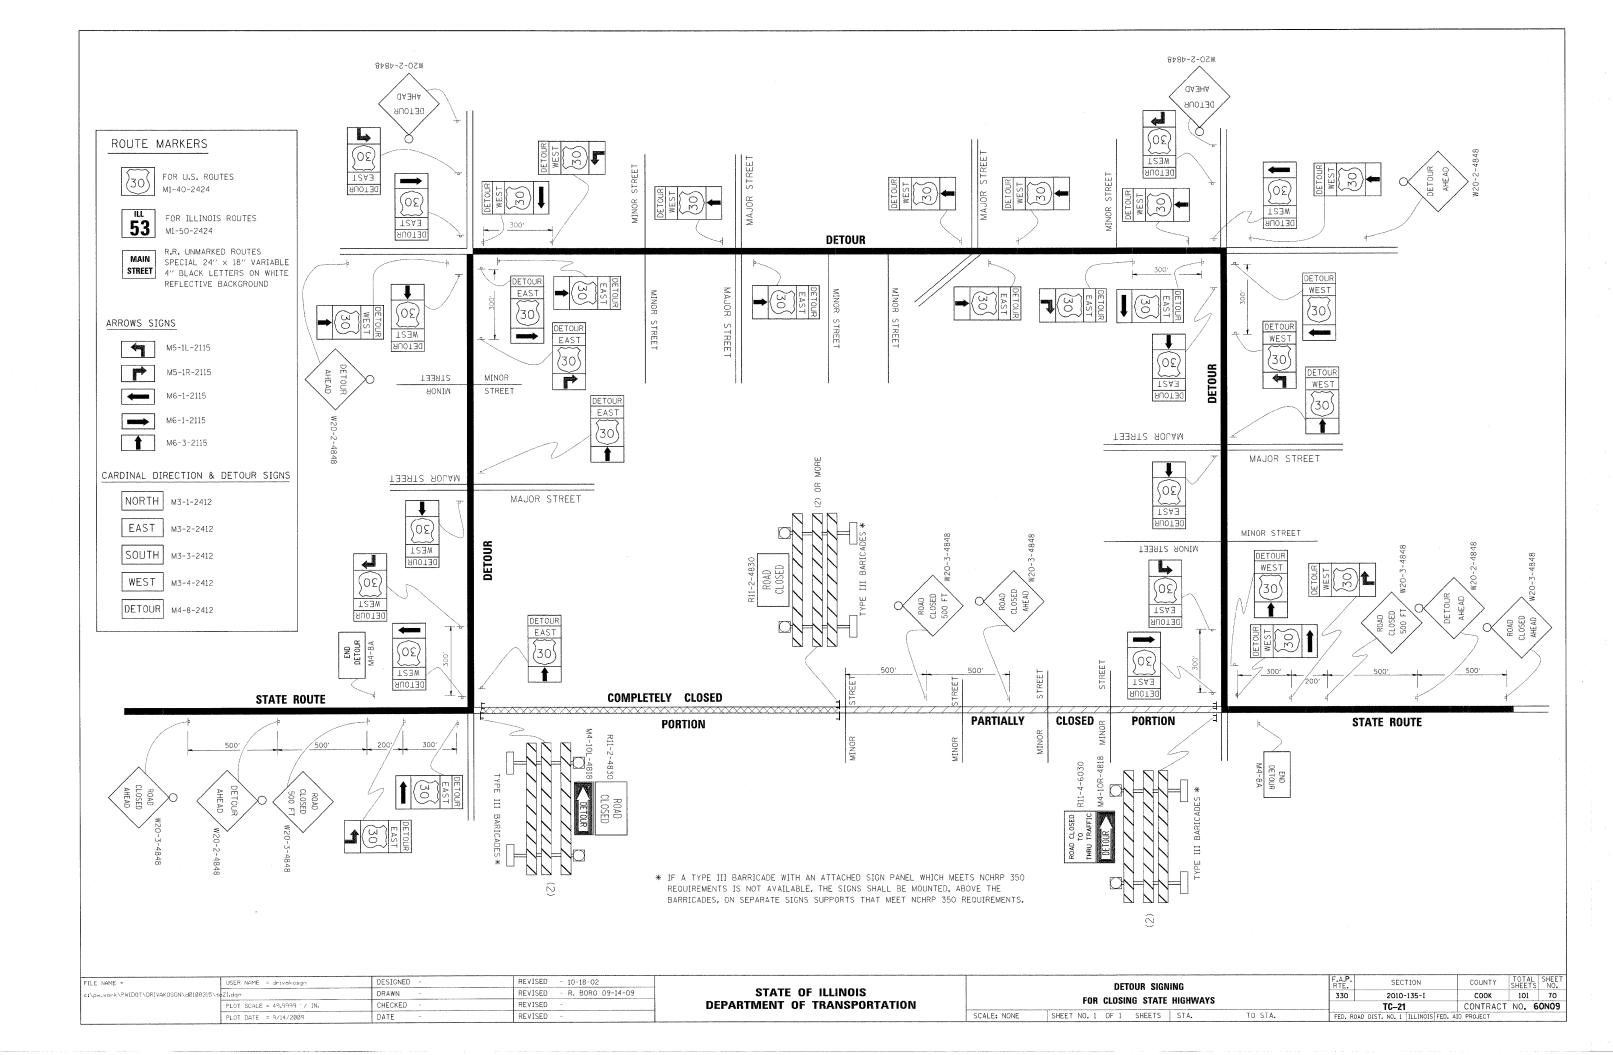

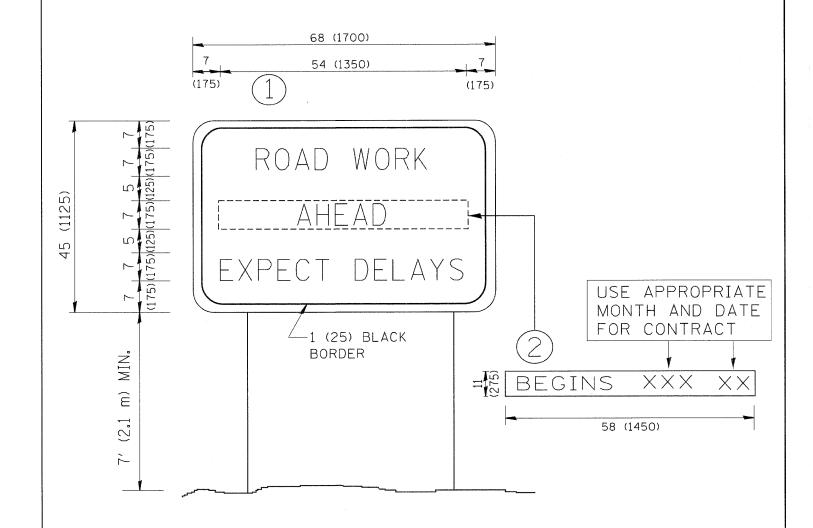

# NOTES:


- 1. USE BLACK LETTERING ON ORANGE BACKGROUND.
- 2. ERECT SIGNS IN ADVANCE OF THE LOCATION FOR THE "ROAD CONSTRUCTION AHEAD" SIGN AT LOCATIONS AS DIRECTED BY THE ENGINEER.
- 3. ERECT SIGN (1) WITH INSTALLED PANEL (2) ONE WEEK PRIOR TO THE START OF CONSTRUCTION.
- 4. REMOVE PANEL (2) SOON AFTER THE START OF CONSTRUCTION.
- 5. SEE SPECIAL PROVISION FOR "TEMPORARY INFORMATION SIGNING" FOR ADDITIONAL INFORMATION.
- 6. ONE SIGN ASSEMBLY EQUALS 25.70 SQ. FT. (2.3 SQ. M.)
- 7. SHALL BE PAID FOR AS TEMPORARY INFORMATION SIGNING.

ALL DIMENSIONS ARE IN INCHES (MILLIMETERS) UNLESS OTHERWISE SHOWN.

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W:\diststd\22x34\tc22.dgn		DRAWN -	REVISED - R. MIRS 12-11-97	STATE OF ILLINOIS	INFORMATION SIGN	330	2010-135-I	СООК	101 71
	PLOT SCALE = 50.000 ' / IN.	CHECKED -	REVISED -T. RAMMACHER 02-02-99	DEPARTMENT OF TRANSPORTATION	INFURIVIATION SIGN		TC-22	CONTRACT N	NO. 60N09
	PLOT DATE = 1/4/2008	DATE ~	REVISED - C. JUCIUS 01-31-07		SCALE: NONE   SHEET NO. 1 OF 1 SHEETS   STA. TO STA.	FED. ROAD	DIST. NO. 1 ILLINOIS FE	D. AID PROJECT	

#### WITH INTERSECTION TRAFFIC SIGNALS

#### WITH NEAR-SIDE TRAFFIC SIGNALS

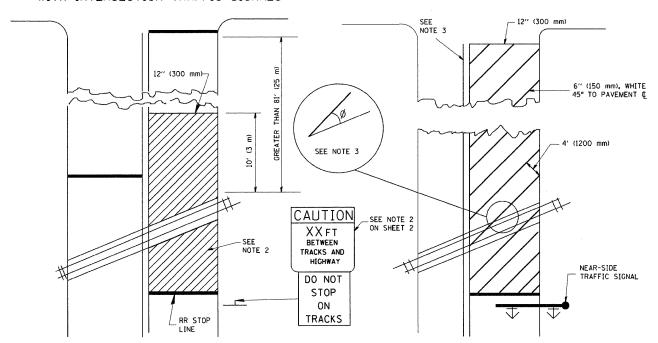


#### NOTES:

- 1. PAVEMENT MARKINGS TO BE INSTALLED ONLY ON APPROACHES TO INTERSECTIONS CONTROLLED BY TRAFFIC SIGNALS WHICH ARE INTERCONNECTED WITH THE RAILROAD WARNING SIGNALS.
- 2. WHERE NEAR-SIDE TRAFFIC SIGNALS ARE USED, THE PAVEMENT MARKINGS EXTENDS TO THE INTERSECTION.
- WHERE THE ANGLE BETWEEN THE DIAGONAL STRIPES AND THE TRACK (Ø) WOULD BE LESS THAN APPROXIMATELY 20°.
  THE STRIPES SHOULD BE SLOPED IN THE OPPOSITE DIRECTION FROM THAT SHOWN.

#### WITH NONSIGNALIZED INTERSECTION

81' (25 m) OR LESS TO CLOSEST RAIL

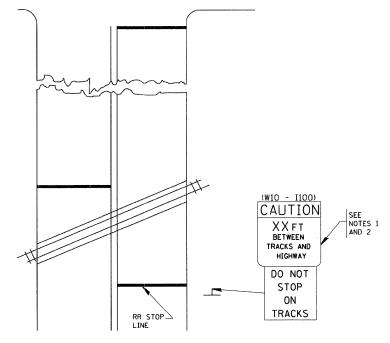

#### NOTE :

- 1. DISTANCE TO BE SHOWN ON SIGN MEASURED FROM A POINT 6 FEET (1.8 m) FROM THE RAIL CLOSEST TO THE INTERSECTION TO THE STOP LINE OR CROSSWALK, WHICHEVER IS CLOSEST, ROUNDED DOWN TO THE NEAREST 5 FEET (1.5 m), WHERE THERE IS NO STOP LINE, MEASURE TO POINT WHERE THE DRIVER HAS A VIEW OF APPROACHING TRAFFIC.
- 2. THE CLEARANCE SIGN IS ALSO TO BE USED AS AN INTERIM MEASURE AT LOCATIONS WITH INTERCONNECTED INTERSECTION TRAFFIC SIGNALS WHERE IT IS PLANNED TO CHANGE THEM TO NEAR-SIDE SIGNALS AT A FUTURE TIME. IN THIS CASE, THE DISTANCE TO BE SHOWN ON THE SIGN IS MEASURED FROM THE EDGE OF THE STRIPED-OUT AREA INSTEAD OF 6-FEET FROM THE RAIL. THE SIGN IS TO BE REMOVED WHEN THE NEAR-SIDE SIGNALS ARE INSTALLED AND THE PAVEMENT MARKINGS EXTEND TO THE INTERSECTION.

ALL DIMENSIONS ARE IN INCHES (MILLIMETERS)
UNLESS OTHERWISE SHOWN.

FILE NAME =	USER NAME = gaglianobt	DESIGNED ~	REVISED - 01-01-07
W:\diststd\22x34\tc23.dgn		DRAWN -	REVISED -
	PLOT SCALE = 50.000 '/ IN.	CHECKED -	REVISED -
	PLOT DATE = 1/4/2008	DATE -	REVISED -

STATE OF ILLINOIS
DEPARTMENT OF TRANSPORTATION

TYPICAL SUPPLEMENTAL SIGNING AND PAVEMENT MARKING				F.A.P. RTÉ.	SECTION	COUNTY	TOTAL	SHEE
				330	2010-135-I	соок	101	72
TREATMENT FOR RAILROAD CROSSINGS					TC-23	CONTRACT	NO. 6	50N09
SCALE: NONE	SHEET NO. 1 OF 1 SHEETS	STA.	TO STA.	FED. R	OAD DIST. NO. 1 ILLINOIS FED. A	ID PROJECT		

