# STATE OF ILLINOIS DEPARTMENT OF TRANSPORTATION

#### SECTION 2020-191-RS COOK | LAKE 29 1 ILLINOIS CONTRACT NO. 62M65

# D-91-589-20

# LOCATION OF SECTION INDICATED THUS: -

# STATE OF ILLINOIS DEPARTMENT OF TRANSPORTATION

SUBMITTED DECEMBER 15 20 27

February 3, 2023

**LOCATION 2:** 

**PROJECT STARTS** 

STA 51 + 55

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# FOR INDEX OF SHEETS, SEE SHEET NO. 2

THE IMPROVEMENT IS LOCATED IN THE VILLAGES OF INVERNESS. BARRINGTON, DEER PARK, SOUTH BARRINGTON, BARRINGTON HILLS

# TRAFFIC DATA:

0

0

0


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# **BARRINGTON RD:**

PROJECT BEGIN TO PROJECT END: ADT (2018) = 15.900SPEED LIMIT = 55 MPH

# LAKE COOK RD:

PROJECT BEGIN TO PROJECT END: ADT (2018) = 13.800SPEED LIMIT = 45 MPH

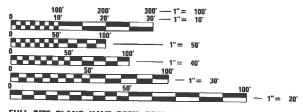

ENGINEERING SCALES. REDUCED SIZED PLANS WILL NOT CONFORM TO STANDARD SCALES. IN MAKING MEASUREMENTS ON REDUCED PLANS, THE ABOVE SCALES MAY BE USED.

JOINT UTILITY LOCATION INFORMATION FOR EXCAVATION 1-800-892-0123

PROJECT ENGINEER: DAN WILGREEN, P.E (847) 705-4240

PROJECT MANAGER: FAWAD AQUEEL, P.E.


CONTRACT NO. 62M65

**PROPOSED** HIGHWAY PLANS

**LOCATION 1: FAU ROUTE 2553: BARRINGTON ROAD** STONE CANYON CIRCLE TO FARMINGTON DRIVE **LOCATION 2: FAU 1270: LAKE COOK ROAD** EAST OF WALLINGFORD LANE **SECTION: 2020-191-RS** 

PROJECT: STP-Q8YE(452) **DESIGNED OVERLAY, DRAINAGE COOK AND LAKE COUNTY** 

C-91-390-20

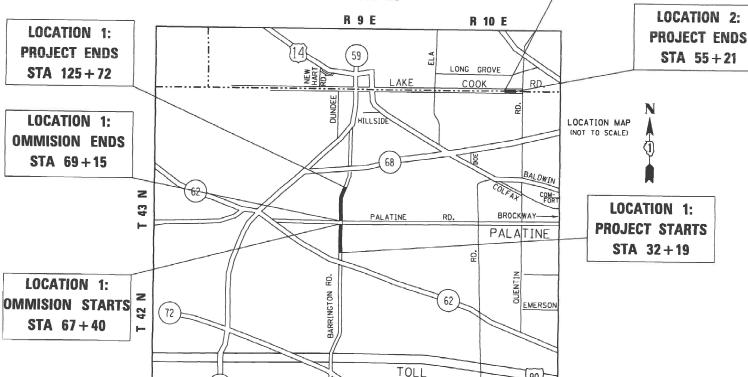

**BARRINGTON TOWNSHIP** 

LOCATION 1: GROSS LENGTH = 9,353 FEET = 1.77 MILES NET LENGTH = 9,178 FEET = 1.74 MILES OMMISION = 175 FEET = .033 MILES

LOCATION 2: GROSS AND NET LENGTH = 366 FT = 0.07 MILES

# **INDEX OF SHEETS**

SHEET NO.	DESCRIPTION
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4-7	SUMMARY OF QUANTITIES
8	BARRINGTON RD: TYPICAL SECTION
9-12	BARRINGTON RD: ROADWAY AND PAVEMENT MARKING PLANS
13	DETECTOR LOOPS
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17	LAKE-COOK ROAD: EARTHWORK SCHEDULE
18	DETAILS FOR FRAMES AND LIDS ADJUSTMENT WITH MILLING (BD-08)
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20	CURB OR CURB AND GUTTER REMOVAL AND REPLACEMENT (BD-24)
21	BUTT JOINT AND HMA TAPER DETAILS (BD-32)
22	TRAFFIC CONTROL AND PROTECTION FOR SIDE ROADS, INTERSECTIONS, AND DRIVEWAYS (TC-10)
23	TYPICAL APPLICATIONS FOR RAISED REFLECTIVE PAVEMENT MARKERS (TC-11)
24	DISTRICT ONE TYPICAL PAVEMENT MARKINGS (TC-13)
25	TRAFFIC CONTROL AND PROTECTION AT TURN BAYS (TC-14)
26	SHORT TERM PAVEMENT MARKING LETTERS AND SYMBOLS (TC-16)
27	ARTERIAL ROAD INFORMATION SIGN (TC-22)
28-29	CROSS SECTIONS FOR LAKE-COOK ROAD

# **HIGHWAY STANDARDS**

STANDARD NO.	DESCRIPTION
000001-08	STANDARD SYMBOLS, ABBREVIATIONS AND PATTERNS
280001-07	TEMPORARY EROSION CONTROL SYSTEMS
420001-10	PAVEMENT JOINTS
420701-03	PAVEMENT WELDED WIRE REINFORCEMENT
442201-03	CLASS C AND D PATCHES
542001-06	CONCRETE END SECTIONS FOR PIPE CULVERTS 15" (375 MM) THRU 84" (2100 MM) DIA
542501-02	INLET BOX TYPE 24 (600) A
602402-03	PRECAST MANHOLE TYPE A 5' (1.52 M) DIAMETER
602601-06	PRECAST REINFORCED CONCRETE FLAT TOP SLAB
602701-02	MANHOLE STEPS
630301-09	SHOULDER WIDENING FOR TYPE 1 (SPECIAL) GUARDRAIL TERMINALS
604001-05	FRAMES AND LIDS TYPE 1
606001-08	CONCRETE CURB TYPE B AND COMBINATION CONCRETE CURB AND GUTTER
701001-02	OFF-ROAD OPERATIONS, 2L, 2W, MORE THAN 15' (4.5 M) AWAY
701006-05	OFF-RD OPERATIONS, 2L, 2W, 15' (4.5 M) TO 24" (600 MM) FROM PAVEMENT EDGE
701011-04	OFF-RD MOVING OPERATIONS 2L, 2W, DAY ONLY
701101-05	OFF-RD MOVING OPERATIONS, MULTILANE 15' TO 24" FROM PAVEMENT
701301-04	LANE CLOSURE, 2L, 2W, SHORT TIME OPERATIONS
701306-04	LANE CLOSURE, 2L, 2W, SLOW MOVING OPERATIONS DAY, FOR SPEEDS >= 45 MPH
701311-03	LANE CLOSURE 2L, 2W MOVING OPERATIONS - DAY ONLY
701336-07	LANE CLOSURE 2L, 2W WORK IN SERIES, FOR SPEEDS >=45 MPH
701426-09	LANE CLOSURE, MULTILANE, INTERMITTENT OR MOVING OPER., FOR SPEEDS >= 45 MPH
701501-06	URBAN LANE CLOSURE 2L, 2W, UNDIVIDED
701502-09	URBAN LANE CLOSURE, 2L, 2W, WITH BIDIRECTIONAL LEFT TURN LANE
701606-10	URBAN SINGLE LANE CLOSURE MULTILANE, 2W WITH MOUNTABLE MEDIAN
701701-10	URBAN LANE CLOSURE, MULTILANE INTERSECTION
701801-06	SIDEWALK, CORNER OR CROSSWALK CLOSURE
701901-08	TRAFFIC CONTROL DEVICES
780001-05	TYPICAL PAVEMENT MARKINGS

# **GENERAL NOTES**

- BEFORE STARTING ANY EXCAVATION, THE CONTRACTOR SHALL CALL "J.U.L.I.E." AT (800) 892-0123 OR 811 FOR FIELD LOCATIONS OF BURIED ELECTRIC, TELEPHONE AND GAS UTILITIES. 48 HOUR NOTIFICATION IS REQUIRED.
- 2. THE CONTRACTOR SHALL COORDINATE CONSTRUCTION ACTIVITIES WITH UTILITY COMPANIES AND THE VILLAGES OF SOUTH BARRINGTON, DEER PARK AND INVERNESS
- THE CONTRACTOR SHALL CONTACT THE DISTRICT ONE TRAFFIC CONTROL SUPERVISOR AT
  KAPLANA,KANNAN-HOSADURGA@ILLINOIS.GOV A MINIMUM OF 72 HOURS IN ADVANCE OF BEGINNING WORK.
- 4. THE RESIDENT ENGINEER SHALL CONTACT THE AREA TRAFFIC FIELD TECHNICIAN PATRICE HARRIS AT PATRICE.HARRIS@ILLINOIS.GOV A MINIMUM OF TWO (2) WEEKS PRIOR TO PLACEMENT OF PERMANENT PAVEMENT MARKINGS
- 5. THE CONTRACTOR WILL NOT BE ALLOWED TO SET UP A YARD OR FIELD OFFICE ON STATE PROPERTY WITHOUT WRITTEN PERMISSION FROM THE DEPARTMENT.
- 6. ANY PAVEMENT MARKINGS AND RAISED REFLECTIVE PAVEMENT MARKERS OBLITERATED BY MILLING AND RESURFACING OPERATIONS ON SIDE STREETS AND ENTRANCES SHALL BE REPLACED AND PAID FOR IN KIND.
- ALL DAMAGE TO EXISTING PAVEMENT MARKINGS OR RAISED REFLECTIVE PAVEMENT MARKERS OUTSIDE THE REMOVAL LINE SHOWN ON THE PLANS SHALL BE REPLACED AT NO ADDITIONAL COST TO THE DEPARTMENT.
- 8. BEFORE BEGINNING ANY WORK, THE CONTRACTOR SHALL RETAIN AND RECORD FOR FUTURE REFERENCE, ALL EXISTING PAVEMENT MARKING LINES (AND RAISED REFLECTIVE PAVEMENT MARKERS) IN ORDER THAT THESE LOCATIONS CAN BE RE-ESTABLISHED FOR STRIPING. EXACT LOCATIONS OF ALL PAVEMENT MARKINGS SHALL BE AS SHOWN ON THE PLANS OR AS DIRECTED BY THE ENGINEER
- 9. ALL FINAL PAVEMENT PATCHING LOCATIONS WILL BE DETERMINED IN THE FIELD BY THE RESIDENT ENGINEER.
- 10. LOCATION OF COMBINATION CONCRETE CURB AND GUTTER REMOVAL AND REPLACEMENT AS WELL AS SEEDING AND PERMIETER EROSION BARRIER WILL BE DETERMINED IN THE FIELD BY THE RESIDENT ENGINEER.
- 11. DRAINAGE ADJUSTMENT OR RECONSTRUCTION LOCATIONS WILL BE DETERMINED IN THE FIELD BY THE RESIDENT ENGINEER.
- 12. IT SHALL BE THE CONTRACTOR'S RESPONSIBILITY TO VERIFY ALL DIMENSIONS AND CONDITIONS EXISTING IN THE FIELD PRIOR TO CONSTRUCTION AND ORDERING OF MATERIALS.
- 13. FRAMES AND GRATES ADJUSTMENT OF PRIVATE UTILITIES WITHIN THE LIMITS OF THE IMPROVEMENTS SHALL BE DONE BY THEIR RESPECTIVE OWNERS AND ARE NOT PART OF THIS CONTRACT.
- 14. THE CONTRACTOR SHALL BE REQUIRED TO PROVIDE ACCESS TO ABUTTING PROPERTY AT ALL TIMES DURING THE CONSTRUCTION OF THIS PROJECT.
- 15. DO NOT SCALE PLANS FOR CONSTRUCTION DIMENSIONS.
- 16. TEMPORARY PAVEMENT MARKING, TYPE III TAPE SHALL BE USED FOR SHORT TERM PAVEMENT MARKINGS ON ALL FINAL SURFACES.
- 17. THE CONTRACTOR SHALL BE REQUIRED TO KEEP A RECORD OF THE LOCATIONS OF PLATED STRUCTURES BY STATION AND OFFSET LEFT OR RIGHT OF THE CENTERLINE OF PAVEMENT.
- 18. THE CONTRACTOR SHALL BE REQUIRED TO KEEP A RECORD OF THE LOCATIONS OF THE BURIED STRUCTURES ACCORDING TO THE STATION AND DISTANCE LEFT OR RIGHT OF THE CENTERLINE OF PAVEMENT. UPON COMPLETION OF THE WORK, THE CONTRACTOR SHALL DELIVER THE RECORD TO THE ENGINEER.
- 19. BUTT JOINTS WILL BE INSTALLED AT THE ENDS OF ALL RESURFACING (WHERE RESURFACING MEETS EXISTING PAVEMENT) ACCORDING TO THE "BUTT JOINT AND HOT-MIX ASPHALT TAPER DETAILS" SHEET INCLUDED IN THE PLANS, UNLESS OTHERWISE SPECIFIED.
- 20. THE RE SHALL NOTIFY THE ROADSIDE DEVELOPMENT UNIT A MINIMUM OF TEN DAYS IN ADVANCE OF TREE REMOVAL OPERATIONS AT (847) 705-4171.
- 21. ALL MILLED SURFACES SHALL BE AT A UNIFORM CROSS SLOPE PER LANE AND FREE OF RIDGES BETWEEN PASSES. ANY DEVIATIONS SHALL BE CORRECTED AT NO COST TO DEPARTMENT.

# **GENERAL NOTES**

- 22. DOUBLE LANE MARKERS ARE TO BE USED AS SHOWN ON THE DISTRICT ONE DETAIL "TYPICAL APPLICATIONS RAISED REFLECTIVE PAVEMENT MARKERS (SNOW-PLOW RESISTANT)" SHOWN IN THE PLANS.
- 23. STORM SEWER CONSTRUCTED UNDER THE ROADWAY SHALL BE BACKFILLED ACCORDING TO METHOD 1 OF ARTICLE 550.07 OF THE STANDARD SPECIFICATIONS.
- 24. TOP OF GRATE OR RIM ELEVATIONS GIVEN ON THE PLANS ARE ONLY TO ASSIST THE CONTRACTOR IN DETERMINING THE APPROXIMATE OVERALL HEIGHT OF EACH STRUCTURE, FRAMES/GRATES/LIDS ON ALL NEW STRUCTURES SHALL BE ADJUSTED TO THE FINAL ELEVATIONS OF THE AREAS IN WHICH THEY ARE LOCATED, AS PART OF THE STRUCTURE COST. PROPOSED SEWER LENGTHS PROVIDED IN THE QUANTITIES ARE FROM THE CENTER OF THE STRUCTURES.
- 25. OVERNIGHT LANE CLOSURES SHALL NOT BE ALLOWED FOR REHABILITATION PROJECTS INVOLVING DAYTIME MILLING AND RESURFACING OPERATIONS AND CLASS D PATCHING UNLESS OTHER CONDITIONS WARRANT EXTENDED LANE CLOSURES AS DETERMINED AND APPROVED IN WRITING BY THE ENGINEER OR AS PROVIDED FOR IN THE CONTRACT SPECIFICATIONS.
- 26. EXISTING BROKEN FRAMES AND LIDS SHALL BE REMOVED AND DISPOSED OF BY THE CONTRACTOR AND SHALL BE REPLACED AS DIRECTED BY THE ENGINEER. REPLACEMENT FRAMES AND LIDS WILL BE PAID FOR ACCORDING TO ARTICLE 109.04 OF THE STANDARD SPECIFICATIONS UNLESS A SEPARATE PAY ITEM HAS BEEN PROVIDED.
- 27. SOIL DISTURBANCE SHALL BE CONDUCTED IN SUCH A MANNER AS TO MINIMIZE EROSION.
- PROPERTIES AND CHANNELS ADJOINING THE SITE SHALL BE PROTECTED FROM EROSION AND SEDIMENTATION.
- 29. SOIL EROSION AND SEDIMENT CONTROL FEATURES SHALL BE CONSTRUCTED PRIOR TO THE COMMENCEMENT OF HYDROLOGIC DISTURBANCE OF UPLAND AREAS.
- 30. DISTURBED AREAS SHALL BE STABILIZED WITH TEMPORARY OR PERMANENT MEASURES WITHIN ONE (1) CALENDAR DAY FOLLOWING THE END OF ACTIVE HYDROLOGIC DISTURBANCE.
- 31. ALL TEMPORARY AND PERMANENT EROSION AND SEDIMENT CONTROL MEASURES SHALL BE MAINTAINED IN IN EFFECTIVE WORKING CONDITION.
- 32. ALL ESC MEASURES WILL BE MAINTAINED IN ACCORDANCE WITH THE IDOT EROSION AND SEDIMENT CONTROL FIELD GUIDE FOR CONSTRUCTION INSPECTION AND IDOT'S BEST MANAGEMENT PRACTICES-MAINTENANCE GUIDE: (HTTP://WWW.IDOT.ILLINOIS.GOV/TRANSPORTATION-SYSTEM/ENVIRONMENT/EROSION-AND-SEDIMENT-CONTROL).
- 33. THE CONTRACTOR SHALL TAKE EXTRA CARE IN GRADING AND EXCAVATING NEAR TREES WHICH ARE NOT MARKED FOR REMOVAL SO AS NOT TO CAUSE INJURY TO THE ROOT SYSTEM OR TRUNKS. ANY DAMAGE DONE TO EXISTING ITEMS BY THE CONTRACTOR SHALL BE REPAIRED BY THE CONTRACTOR AT THE CONTRACTOR'S OWN EXPENSE.
- 34. THIS PROJECT REQUIRES A US ARMY CORPS OF ENGINEERS (USACE) 404 PERMIT THAT WILL BE SECURED BY THE DEPARTMENT. AS A CONDITION OF THIS PERMIT, THE CONTRACTOR WILL NEED TO SUBMIT AN IN-STREAM WORK PLAN (INLCUDING WORK WITHIN WETLANDS) TO THE DEPARTMENT FOR APPROVAL. GUIDELINES ON ACCEPTABLE IN-STREAM WORK TECHNIQUES (INLCUDING WORK WITHIN WETLANDS) CAN BE FOUND ON THE USACE WEBSITE. THE USACE DEFINES AND DETERMINES IN-STREAM WORK. THE COST OF ALL MATERIALS AND LABOR NECESSARY TO COMPLY WITH THE ABOVE PROVISIONS TO PREPARE AND IMPLEMENT AN IN-STREAM WORK PLAN (INLCUDING WORK WITHIN WETLANDS) WILL NOT BE PAID FOR SEPARATELY, BUT SHALL BE CONSIDERED AS INCLUDED IN THE UNIT BID PRICES OF THE CONTRACT AND NO ADDITIONAL COMPENSATION WILL BE ALLOWED WITH THE EXCEPTION OF COFFERDAMS, WHICH WILL BE PAID FOR AS COFFERDAM (TYPE 1) (IN-STREAM/WETLAND WORK) WITH A BASIS OF PAYMENT OF EACH.
- 35. "WETLANDS NO INTRUSION" SIGNAGE SHOULD ALSO BE PROVIDED AT THE BOUNDARY OF ALL UN-IMPACTED WETLANDS AND/OR WOUS. THE CONTRACTOR CAN BORROW THE SIGNS FROM THE BUREAU OF MAINTENANCE. INCLUDE TEMPORARY FENCING AND WETLAND SIGNAGE WITHIN THE EROSION AND SEDIMENT CONTROL STRATEGY.
- 36. TREES (3) INCHES OR GREATER IN DIAMETER AT BREAST HEIGHT WILL NOT BE CLEARED BETWEEN APRIL 1 AND OCTOBER 31.

USER NAME = mohammad.hamwi	DESIGNED -	REVISED -
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PLOT SCALE = 100.0000 / in.	CHECKED -	REVISED -
PLOT DATE = 12/15/2022	DATE -	REVISED -

STATE OF ILLINOIS
DEPARTMENT OF TRANSPORTATION

INDEX OF SHEETS, STATE STANDARDS & GENERAL NOTES

BARRINGTON ROAD AND LAKE—COOK ROAD

SHEET OF SHEETS STA. TO STA.

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	SUMMARY OF QUANTITIES				CO	NSTRUCTIO	N TYPE C	ODE I			SUMMAF	RY OF QUANTITIES				CO	NSTRUCTIO	N TYPE CO	DE
E NO	ITEM	UNIT	TOTAL QUANTITIES URBAN	80% FED 20% STATE BARRINGTON RE 0005	LAKE-COOK RD	LAKE-COOK RD	LOO % STATE COOK BARRINGION R	<u>ε</u>		CODE NO		ITEM	UNIT	TOTAL QUANTITIES URBAN	80% FED 20% STATE BARRINGTON RO	80% FED 20% STATE COOK LAKE-COOK RD	80 % FED 20% STATE LAKE	IOO % STATE COOK BARRINGTON RE	
00110 TF	REE REMOVAL (6-15 UNITS DIAMETER)	UNIT	111	111	0004	0004	0003			28000305	TEMPORARY DI	TCH CHECKS	FOOT	140	0005	0004	140	0003	
00210 TF	REE REMOVAL (OVER 15 UNITS DIAMETER)	UNIT	23	23						28000400	PERIMETER ER	OSION BARRIER	FOOT	727		315	412		
D1000 TE	EMPORARY FENCE	FOOT	142			142				28100105	STONE RIPRAP	. CLASS A3	SO YD	10		5	5		
00100 E	ARTH EXCAVATION	CU YD	29		5	24				31101200	SUBBASE GRAN	ULAR MATERIAL, TYPE B 4"	SO YD	54		27	27		
01200 REM	MOVAL AND DISPOSAL OF UNSUITABLE MATERIAL	CU YD	6		3	3				40600290	BITUMINOUS M	ATERIALS (TACK COAT)	POUND	21, 323	21, 178	72	73		
00800 FI	URNISHED EXCAVATION	CU YD	141		76	65				40600370	LONGITUDINAL	JOINT SEALANT	FOOT	14,000	14,000				
00150 TF	RENCH BACKFILL	CU YD	34. 9		17.4	17.5				40600400	MIXTURE FOR	CRACKS, JOINTS, AND	TON	61	61				
											FLANGEWAYS								
01505 TO	OPSOIL EXCAVATION AND PLACEMENT	CU YD	208		63	145													
										40600982	HOT-MIX ASPHAL	T SURFACE REMOVAL -BUTT JOINT	SO YD	303	273	15	15		
00210 SE	EEDING, CLASS 2A	ACRE	0.07		0.02	0.05													
										40602985	HOT-MIX ASPH	ALT BINDER COURSE, IL-9.5,	TON	3, 514	3, 514				
00312 SE	EEDING, CLASS 4A	ACRE	0. 23		0.07	0.16					N70								
00400 N	ITROGEN FERTILIZER NUTRIENT	POUND	6		2	4				40604172	POLYMERIZED	HOT-MIX ASPHALT SURFACE	TON	3, 103	3, 075	14	14		
											COURSE, IL-9	.5, MIX "E", N70							
00500 PI	HOSPHORUS FERTILIZER NUTRIENT	POUND	2		2														
										44000156	HOT-MIX ASPH	ALT SURFACE REMOVAL, 1	SQ YD	320		158	162		
00600 PC	OTASSIUM FERTILIZER NUTRIENT	POUND	6		2	4					3/4"								
00630 EF	ROSION CONTROL BLANKET	SO YD	1401		425	976				44000164	HOT-MIX ASPH	ALT SURFACE REMOVAL, 3	SQ YD	31, 375	31, 375				
											3/4"								
D0250 TE	EMPORARY EROSION CONTROL SEEDING	POUND	30		9	21													
																		* = : \(\triangle = \)	SPECIALTY ITE
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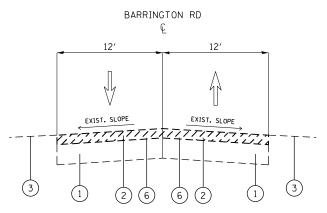
	SUMMARY OF QUANTITIES				CO	NSTRUCTION TYPE (	CODE		SUMMARY OF QUANTITIES				CC	NSTRUCTION	TYPE CODE	
CODE NO	ITEM	UNIT	TOTAL QUANTITIES URBAN	80% FED 20% STATE BARRINGTON RE	LAKE-COOK RD	80 % FED 20% STATE LAKE LAKE-COOK RD BARRINGTON 0004	TE RD	CODE NO	ITEM	UNIT	TOTAL OUANTITIES URBAN	80% FED 20% STATE BARRINGTON RD	80% FED 20% STATE COOK LAKE-COOK RE	80 % FED 20% STATE LAKE LAKE-COOK RDB	DO % STATE COOK ARRINGION RD OOO5	
44201765	CLASS D PATCHES, TYPE II, 10 INCH	SO YD	450	450	0004	0004		60300305	FRAMES AND LIDS TO BE ADJUSTED	EACH	3	3	0004	0004		
14201769	CLASS D PATCHES, TYPE III, 10 INCH	SO YD	300	300				60406000	FRAMES AND LIDS. TYPE 1. OPEN LID	EACH	1	1				
14201771	CLASS D PATCHES, TYPE IV, 10 INCH	SO YD	2000	2000				60406100	FRAMES AND LIDS. TYPE 1. CLOSED LID	EACH	1	1				
44201839	CLASS D PATCHES, TYPE II, 16 INCH	SO YD	18		9	9		60500040	REMOVING MANHOLES	EACH	2		1	1		
14201843	CLASS D PATCHES, TYPE III, 16 INCH	SO YD	36		18	18		60500050	REMOVING CATCH BASINS	EACH	1		1			
48101600	AGGREGATE WEDGE SHOULDER, TYPE B 8"	SO YD	14		7	7		60500060	REMOVING INLETS	EACH	1			1		
48102100	AGGREGATE WEDGE SHOULDER, TYPE B	TON	271.3	260	2.5	8. 8		* 66900200	NON-SPECIAL WASTE DISPOSAL	CU YD	395		151	244		
54261324	CONCRETE END SECTION, STANDARD 542001.	EACH	4		2	2		* 66900530	SOIL DISPOSAL ANALYSIS	EACH	1		0.5	0.5		<u> </u>
	24", 1: 3							* 66901001	REGULATED SUBSTANCES PRE-CONSTRUCTION PLAN	L SUM	1		0.5	0.5		_
54241069	PIPE CULVERTS, CLASS A, TYPE 2 24"	FOOT	128		63. 2	64. 8		* 66901003	REGULATED SUBSTANCES FINAL CONSTRUCTION	L SUM	1		0.5	0.5		
550A0340	STORM SEWERS, CLASS A, TYPE 2 12"	FOOT	92. 7		50	42.7			REPORT							
55100300	STORM SEWER REMOVAL 8"	FOOT	14		6	8		* 66901006	REGULATED SUBSTANCES MONITORING	CAL DA	4		2	2		
55100500	STORM SEWER REMOVAL 12"	FOOT	92		50	42		67100100	MOBILIZATION	L SUM	1	0.8	0. 1	0. 1		
50221100	MANHOLES, TYPE A, 5'-DIAMETER, TYPE 1 FRAME, CLOSED LID	EACH	1		1			70100460	TRAFFIC CONTROL AND PROTECTION, STANDARD	L SUM	1		0.5	0.5		
	THEME, CLOSED LID								701306							
60252800	CATCH BASINS TO BE RECONSTRUCTED	EACH	1	1				70100600	TRAFFIC CONTROL AND PROTECTION, STANDARD 701336	L SUM	1		0.5	0.5		
60300105	FRAMES AND GRATES TO BE ADJUSTED  USER NAME = mohammad.homwi	EACH DESIGNED -	3	3 REVISED	_						# 0021/ = 1		F.A.U. RTE.	SECTIO	<pre># = SPECIALT</pre>	TICIPAT:
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	SUMMARY OF QUANTITIES				CONST	RUCTION TYPE C	ODE			SUMMARY OF QUANTITIE	S			ı	CO	NSTRUCTIO	N TYPE CO	DDE	
CODE NO	ITEM	UNIT		80% FED 20% STATE BARRINGTON RD 0005	LAKE-COOK RD LAKE	% FED STATE LAKE E-COOK RD BARRINGTON R	E C		CODE NO	ITEM		UNIT	TOTAL QUANTITIES URBAN	80% FED 20% STATE BARRINGTON RD 0005	LAKE-COOK RD	LAKE-COOK RD	100 % STATE COOK BARRINGTON RD 0005		
70102620	TRAFFIC CONTROL AND PROTECTION, STANDARD	L SUM	1	1	0004	0004			70300261	TEMPORARY PAVEMENT MARKING -	- LINE 12"	FOOT	450	450	0004	0004			+
	701501									- PAINT									
70102622	TRAFFIC CONTROL AND PROTECTION, STANDARD	L SUM	1	1					70300281	TEMPORARY PAVEMENT MARKING -	- LINE 24"	F00T	100	100					
	701502									- PAINT									-
70102625	TRAFFIC CONTROL AND PROTECTION, STANDARD	L SUM	1	1					70306120	TEMPORARY PAVEMENT MARKING -	- LINE 4" -	FOOT	3, 410	3, 400		10			
	701606									TYPE III TAPE									_
70102635	TRAFFIC CONTROL AND PROTECTION. STANDARD	L SUM	1	1				*	78000100	THERMOPLASTIC PAVEMENT MARKI	NG - LETTERS	SQ FT	300	300					_
	701701									AND SYMBOLS									1
70102640	TRAFFIC CONTROL AND PROTECTION, STANDARD	L SUM	1	1				*	78000200	THERMOPLASTIC PAVEMENT MARKI	ING - LINE	FOOT	34, 230	34, 000	100	1 30			-
	701801									4"									
70300100	SHORT TERM PAVEMENT MARKING	FOOT	10,020	10,000		20		*	78000400	THERMOPLASTIC PAVEMENT MARKI	NG - LINE	FOOT	1,600	1, 600					_
										6"									
70300150	SHORT TERM PAVEMENT MARKING REMOVAL	SO FT	16, 510	16, 500		10			7000500				250	250					<u> </u>
70300211	TEMPORARY PAVEMENT MARKING - LETTERS	SO FT	300	300				*	78000500	THERMOPLASTIC PAVEMENT MARKI	ING - LINE	FOOT	230	230					
	AND SYMBOLS - PAINT																		
70300221	TEMPORARY PAVEMENT MARKING - LINE 4"	FOOT	34, 230	34, 000	100	130		*	78000600	THERMOPLASTIC PAVEMENT MARKI	NG - LINE	FOOT	450	450					<del> </del>
	- PAINT																		
								*	78000650	THERMOPLASTIC PAVEMENT MARKI	NG - LINE	FOOT	100	100					$oxed{oxed}$
70300241	TEMPORARY PAVEMENT MARKING - LINE 6"	FOOT	1,600	1,600						24"									_
	- PAINT							*	78100100	RAISED REFLECTIVE PAVEMENT M	MARKER	EACH	367	365		2			_
70300251	TEMPORARY PAVEMENT MARKING - LINE 8"	FOOT	250	250															
	- PAINT								78300200	RAISED REFLECTIVE PAVEMENT M	MARKER	EACH	367	365		2	* =	SPECIALTY	TITEM
TILE NAME =	USER NAME = mohammod.hamwi DES n-PWIDOT-Documents-VDOT Offices-Olistrict NProjects-O15892O-CADDato-Design-O15892O-sth-S <b>008</b> gi	SIGNED -		REVISED REVISED	<u>-</u>		STA	ATE OF IL	LINOIS	REMOVAL BA	ARRINGTON ROAD			)	F.A.U. RTE.	SECTI	=ON	NON-PART I WORK (100 COUNTY S	ICIPAT D% STA FOTAL SI HEETS
		CKED -		REVISED REVISED	-	D	EPARTMEN			SCALE: SI	SUMMARY SHEET NO. OF S			STA.	VAR	2020-19	C	OOK   LAKE   CONTRACT N PROJECT	

	SUMMARY OF QUANTITIES			C	ONSTRUCTION TYPE C	ODE	SUMMARY OF QUANTITIES				C	NSTRUCTIO	ON TYPE CO	DE	
CODE NO	ITEM	UNIT	TOTAL QUANTITIES URBAN	BARRINGTON RD LAKE-COOK R	80 % FED 20% STATE LAKE D LAKE-COOK RD BARRINGION F 0004		) ITEM	UNIT	TOTAL QUANTITIES URBAN	80% FED 20% STATE BARRINGTON R	80% FED 20% STATE COOK LAKE-COOK R	80 % FED 20% STATE LAKE DLAKE-COOK RD	100 % STATE COOK BARRINGTON RD 0005		
78300202	PAVEMENT MARKING REMOVAL - WATER BLASTING	SO FT	78	34	44	△ Z001850	DRAINAGE STRUCTURES TO BE CLEANED	EACH	12				12		
88600600	D DETECTOR LOOP REPLACEMENT	FOOT	65	65		Z003085	TEMPORARY INFORMATIONS SIGNING	SO FT	102.8	51.4	25. 7	25. 7			
x0900075		EACH	1	1		Z006480	SELECTIVE CLEARING	UNIT	45	45					<u> </u>
	WORK)					Ø 20076600	TRAINEES	HOURS	500	500					
x2010100	TREE. LIMB REMOVAL (4-10 INCHES)	EACH	12	12		Ø 20076604		HOURS	500	500					
X2010200	TREE, LIMB REMOVAL (OVER 10 INCHES)	EACH	5	5											_
	THEE ELING REMOVAL VOVER TO TROPES!														
X2010400	STUMP REMOVAL ONLY	UNIT	54	36	18										
X2020110	GRADING AND SHAPING SHOULDERS	UNIT	168.5	164 1	3. 5										
X4060995	TEMPORARY RAMP, SPECIAL	SO YD	273	273											
X4400503	COMBINATION CURB AND GUTTER REMOVAL AND	FOOT	270	270											
	REPLACEMENT GREATER THAN 10 FEET														
x5537800	STORM SEWERS TO BE CLEANED 12"	FOOT	240		240										
X6023102	MANHOLES, TYPE A, 5'-DIAMETER, TYPE 1	EACH	1		1										
	FRAME CLOSED LID, SPECIAL														
x6030310	FRAMES AND LIDS TO BE ADJUSTED (SPECIAL)	EACH	3	3											
X6700407	ENGINEER'S FIELD OFFICE, TYPE A (D1)	CAL MO	12	6 3	3										
Z0013798	CONSTRUCTION LAYOUT	L SUM	1	0.5	0. 5								* = 9	SPECIAL TY	00
FILE NAME =	USER NAME = motammod.tamwl DE:  (com=PWIDOT\Documents\DOT\Ofticas\District\notation=0.50156320\CADdid\Design\District\District\Ofticas\District\notation=0.50156320\CADdid\Design\District\District\Ofticas\Distri	SIGNED -		REVISED - REVISED -		STATE OF ILLINOIS		ROAD AND LAK		VD	F.A.U. RTE. VAR	SECT1		NON-PARTI WORK (100%	CIPA X ST OTAL HEETS
		CKED -		REVISED -	D	EPARTMENT OF TRANSPOR	Alloi	MARY OF QUANT OF SHEETS   STA		TO STA.		2020-19		ONTRACT N	

- 1. EXISTING PCC BASE COURSE, 10" +/-
- 2. EXISITING HMA SURFACE,  $3\frac{3}{4}$ " +/-
- 3. AGGREGATE SHOULDER

- 4. POLYMERIZED HOT-MIX ASPHALT SURFACE COURSE, IL-9.5, MIX "E", N70, 1¾
- 5. PROPOSED HOT-MIX ASPHALT BINDER COURSE, IL-9.5, N70. 2.0 "
- 6. PROPOSED HMA SURFACE REMOVAL , 33/4"




EXISTING TYPICAL SECTION STA 32+19 - STA 67+40 STA 69+15 - STA 125+72

HOT-MIX ASPHALT MIXTURE REQUIREMENTS		QUALITY MANAGEMENT
MIXTURE TYPE	AIR VOIDS(%) @ Ndes	OUALITY MANAGEMENT PROGRAM (QMP)
PAVEMENT		
POLYMERIZED HOT-MIX ASPHALT SURFACE COURSE, IL-9.5, MIX "E", N70, 13/4"	4.0% @ 70 GYR.	QCP
HMA BINDER COURSE, IL-9.5, N70 2"	4.0% @ 70 GYR.	QCP
PATCHING		
	4.0% @ 70 GYR.	OC/OA
CLASS D PATCHES (HMA BINDER IL-19 MM; 10")	1	
TEMPORARY RAMP (SPECIAL)	<u>I</u>	
	4.0% @ 70 GYR.	QC/QA

4.0% @ 70 GYR.

4.0% @ 70 GYR.

QCP

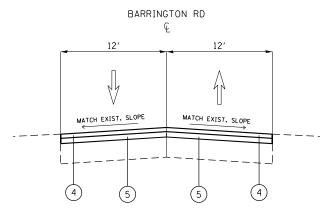

PROPOSED TYPICAL SECTION STA 32+19 - STA 67+40 STA 69+15 - STA 125+72

SCALE:

NOTE 1: THE UNIT WEIGHT USED TO CALCULATE ALL HOT-MIX ASPHALT SURFACE MIXTURE QUANTATIES IS 112 LBS/SQ YD/IN.

NOTE 2: THE "AC TYPE" FOR POLYMERIZED HMA MIXES SHALL BE "SBS/SBR PG 76 -22" AND AND FOR NON-POLYMERIZED HMA THE "AC TYPE" SHALL BE "PG 64 -22" UNLESS MODIFIED BY RECLAIMED MATERIALS SPECIFICATIONS.

NOTE 3: THE CONTRACTOR SHALL MILL BEFORE PATCHING ON BARRINGTON RD NOTE 4: THE LONGITUDINAL JOINT SEALANT SHALL BE PLACE OVER THE HMA BC IL-9.5

USER NAME = mohammad.hamwi	DESIGNED -	REVISED -
	DRAWN -	REVISED -
PLOT SCALE = 100.0002 / in.	CHECKED -	REVISED -
PLOT DATE = 12/15/2022	DATE -	REVISED -

OMP DESIGNATION: QUALITY CONTROL/QUALITY ASSURANCE (QC/QA); QUALITY CONTROL FOR PERFORMANCE (QCP); PAY FOR PERFORMANCE (PFP)

POLYMERIZED HOT-MIX ASPHALT SURFACE COURSE, IL-9.5, MIX "E", N70, 13/4"

CLASS D PATCHES (HMA BINDER IL-19.0 MM; 16")

STATE 0	F ILLINOIS
DEPARTMENT OF	TRANSPORTATION

TYPICAL SECTION	F.A.U. RTE	SECTION	COUNTY	TOTAL SHEETS	SHEET NO.
BARRINGTON ROAD AND LAKE-COOK ROAD	VAR.	2021-191-RS	COOK   LAKE	29	8
DAIIIIINGTON HOAD AND LAKE-COOK HOAD			CONTRACT	NO. 62	2M65
SHEET OF SHEETS STA. TO STA.		ILLINOIS FED. AI	D PROJECT		-

LOCATION

BARRINGTON ROAD

BARRINGTON ROAD


BARRINGTON ROAD


BARRINGTON ROAD


LAKE-COOK ROAD


LAKE-COOK ROAD


PATCHING

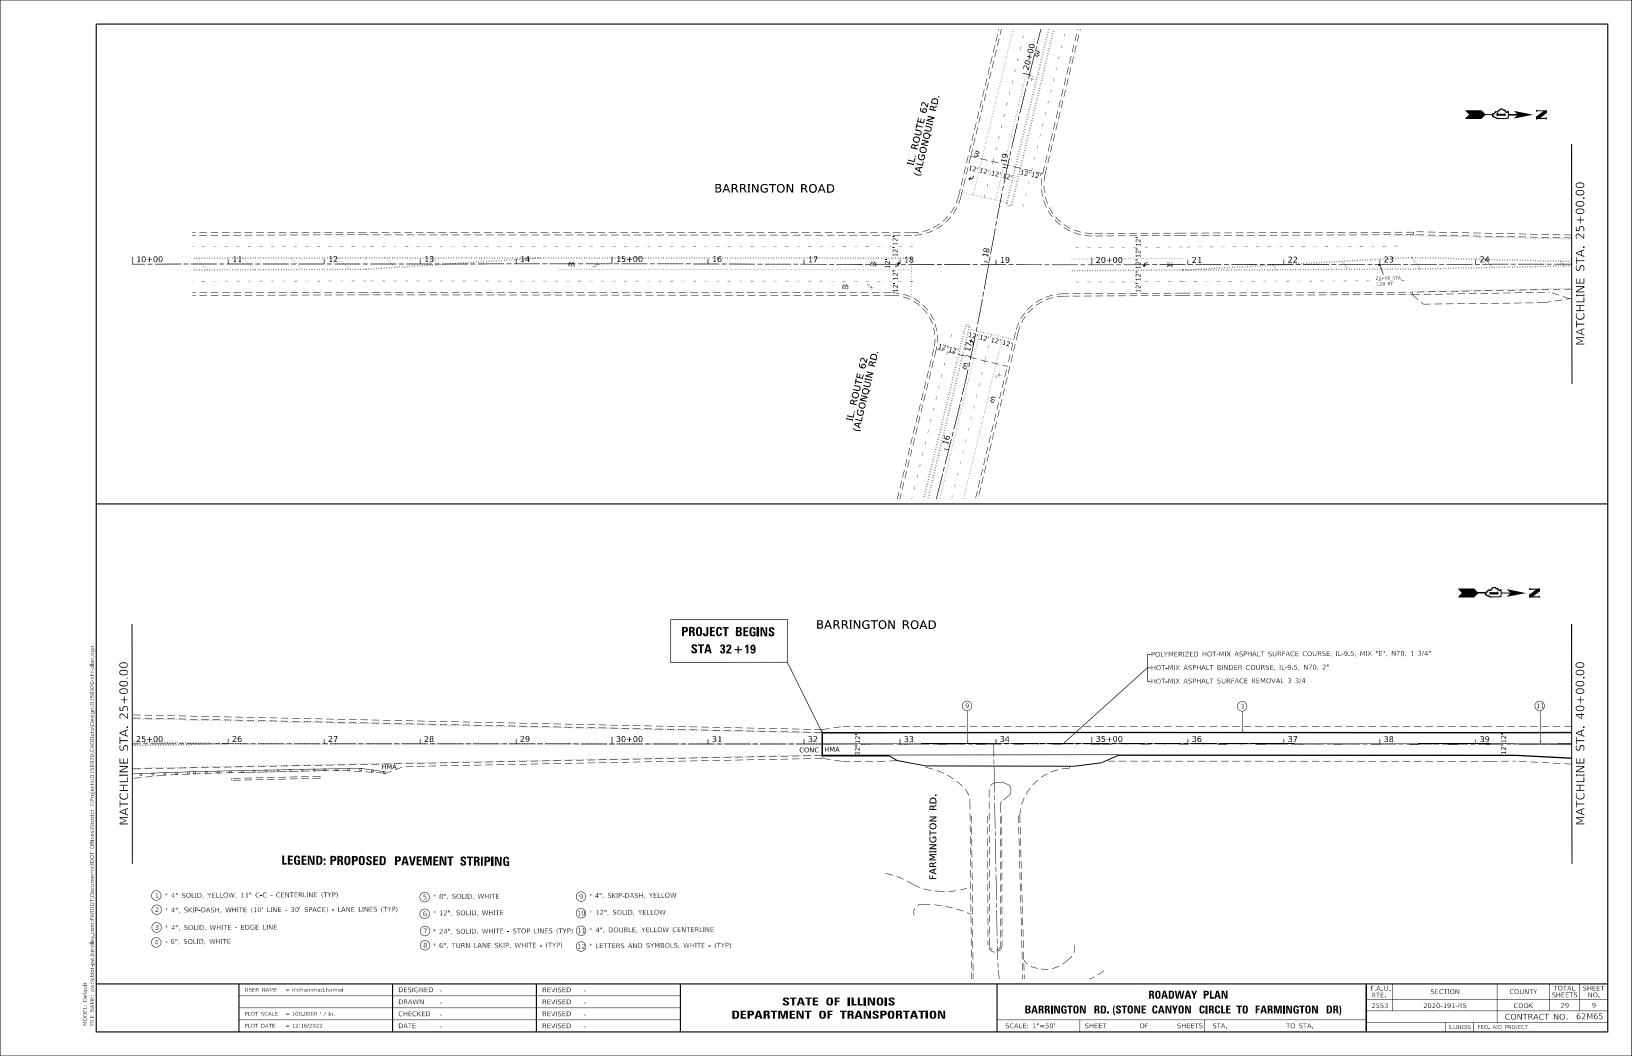

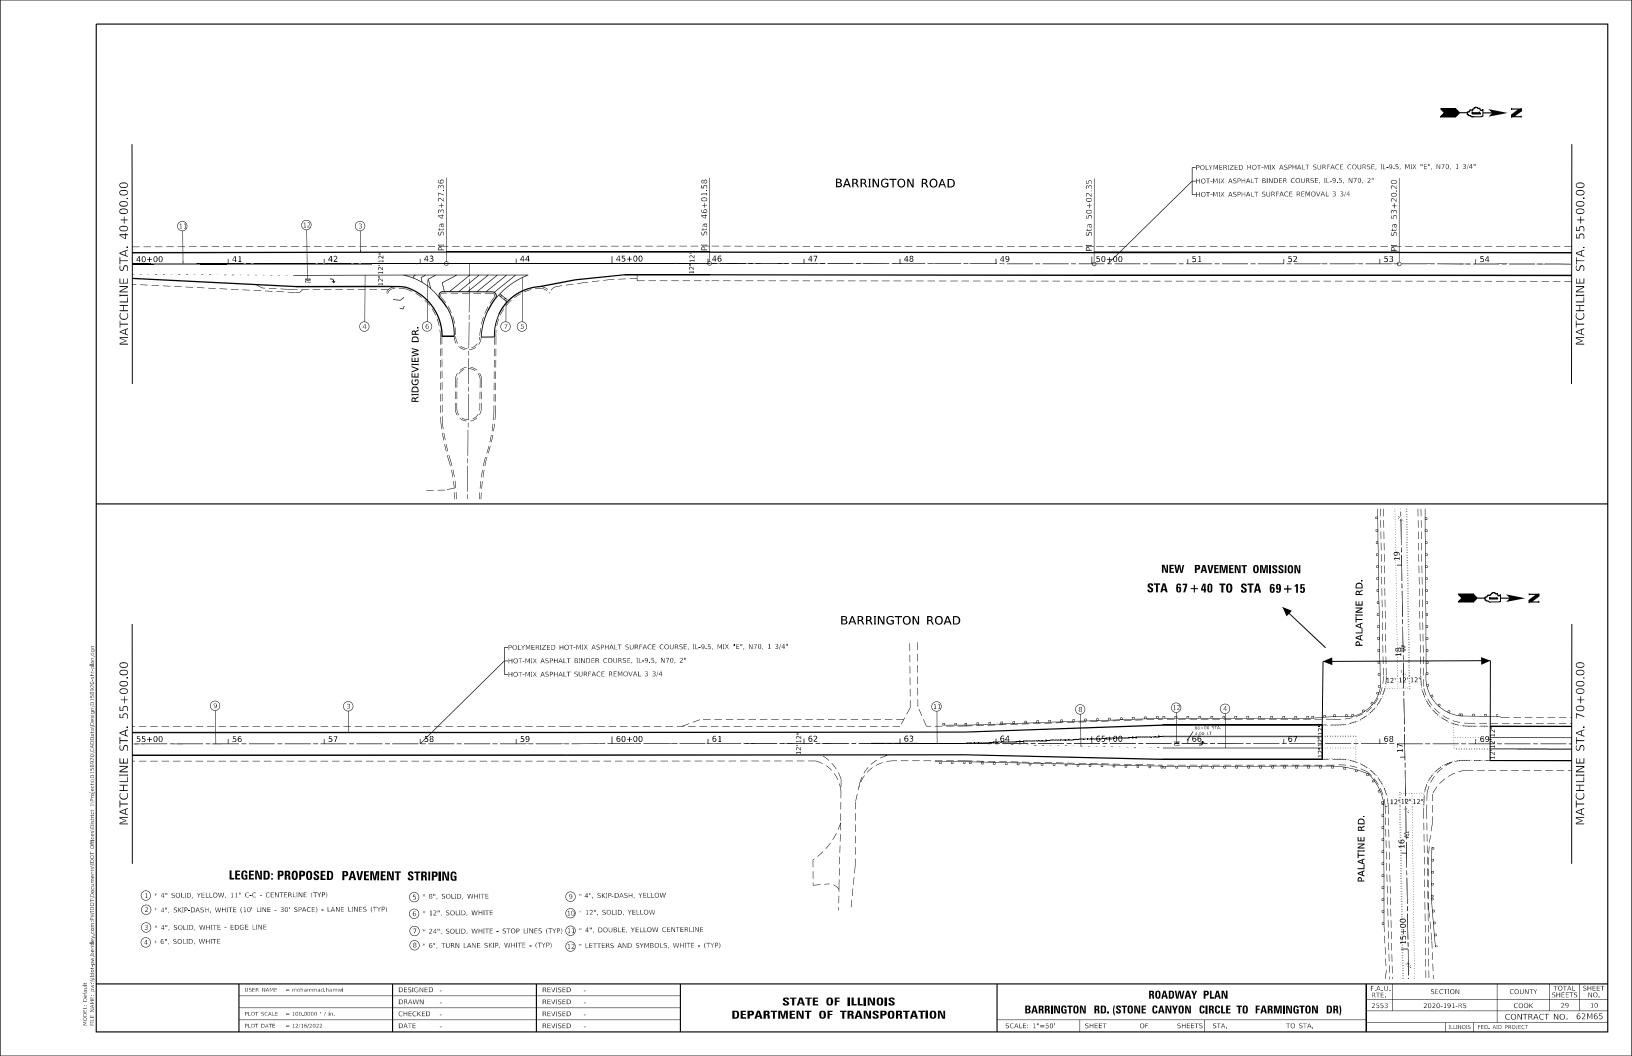

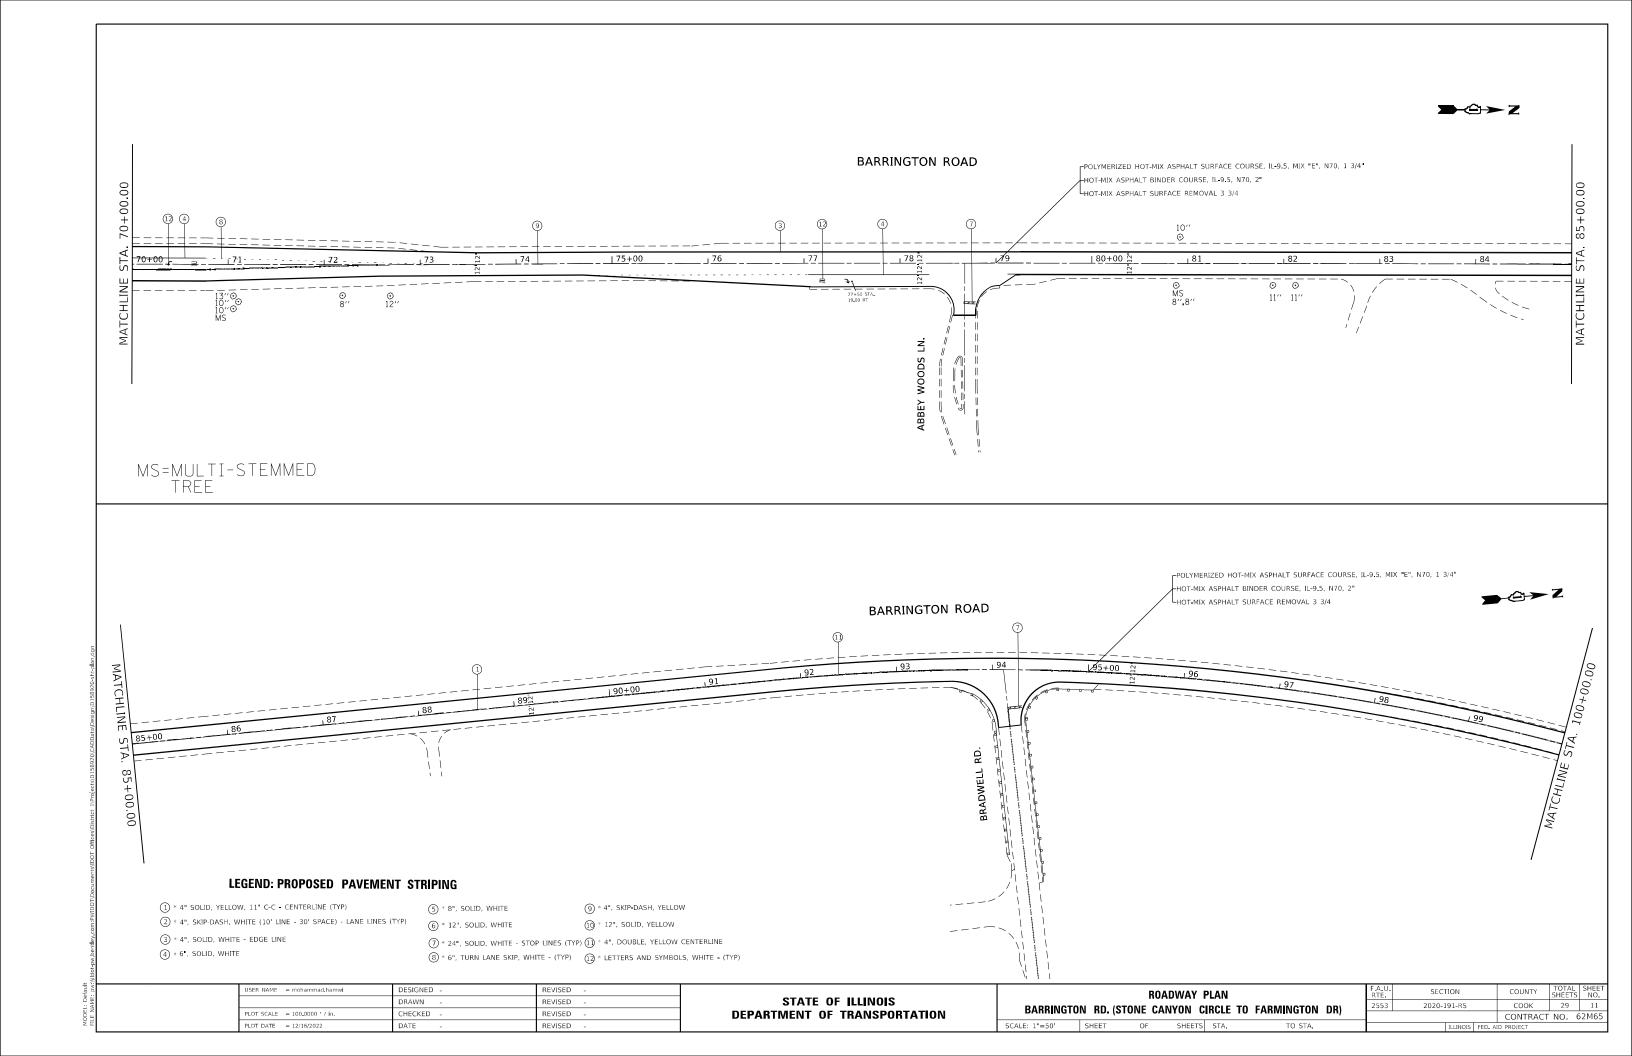


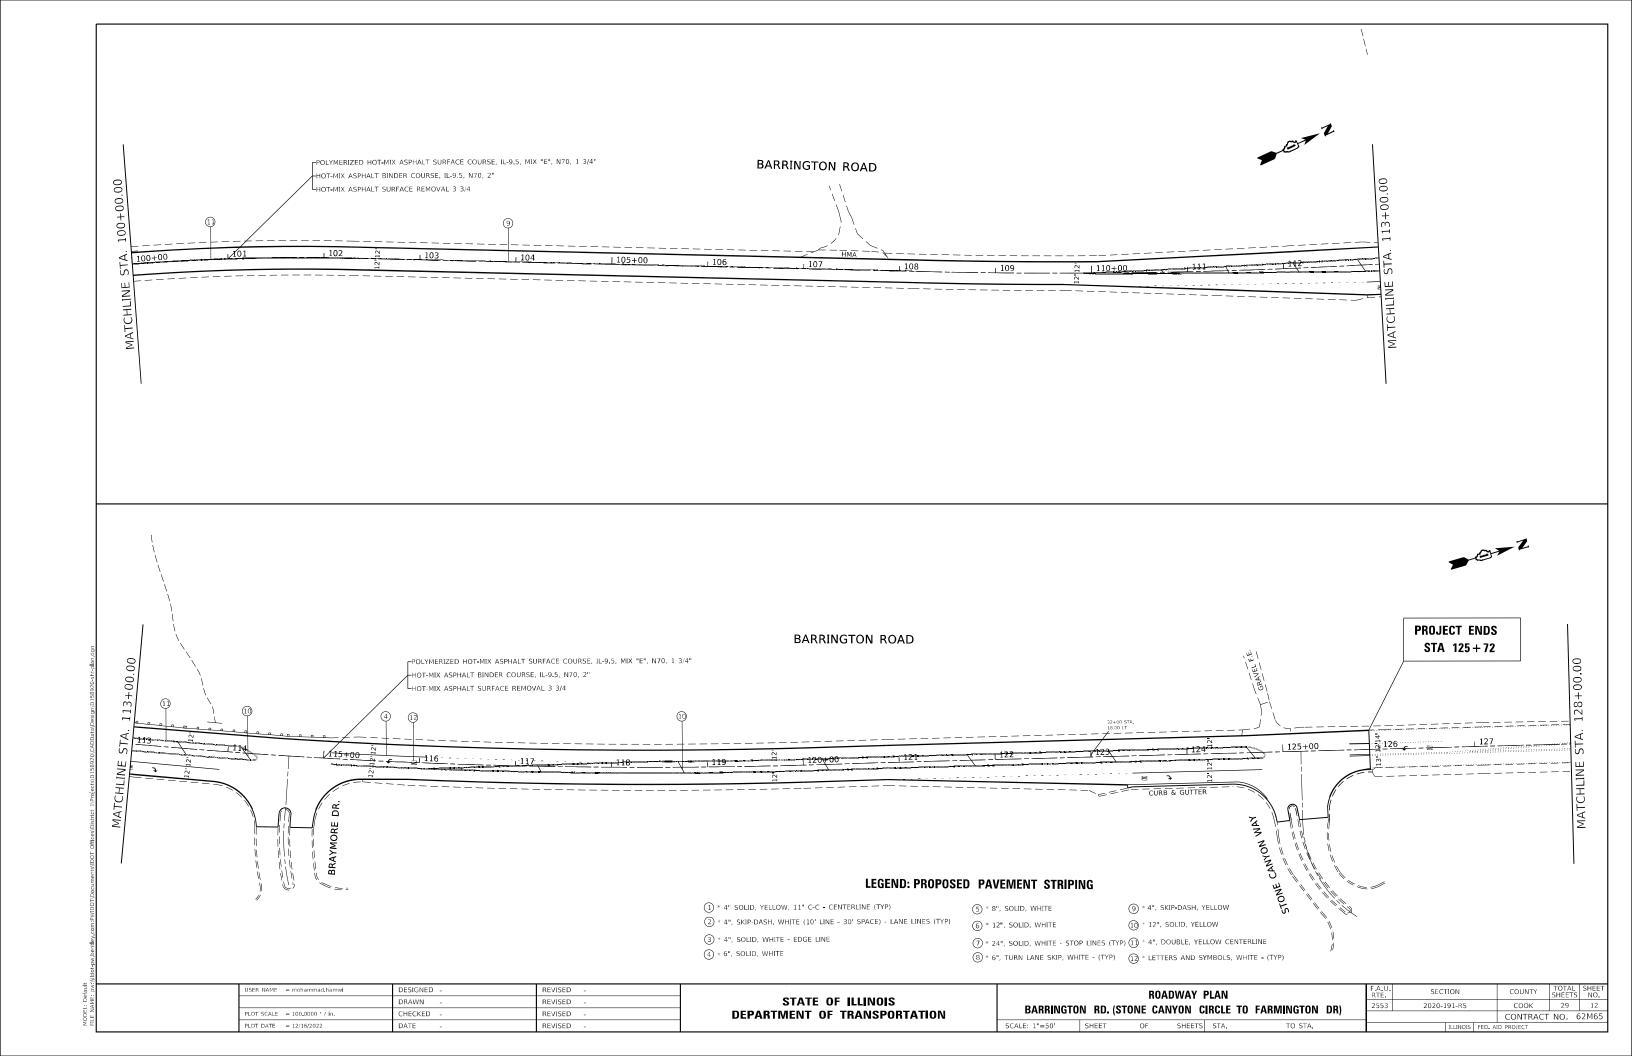

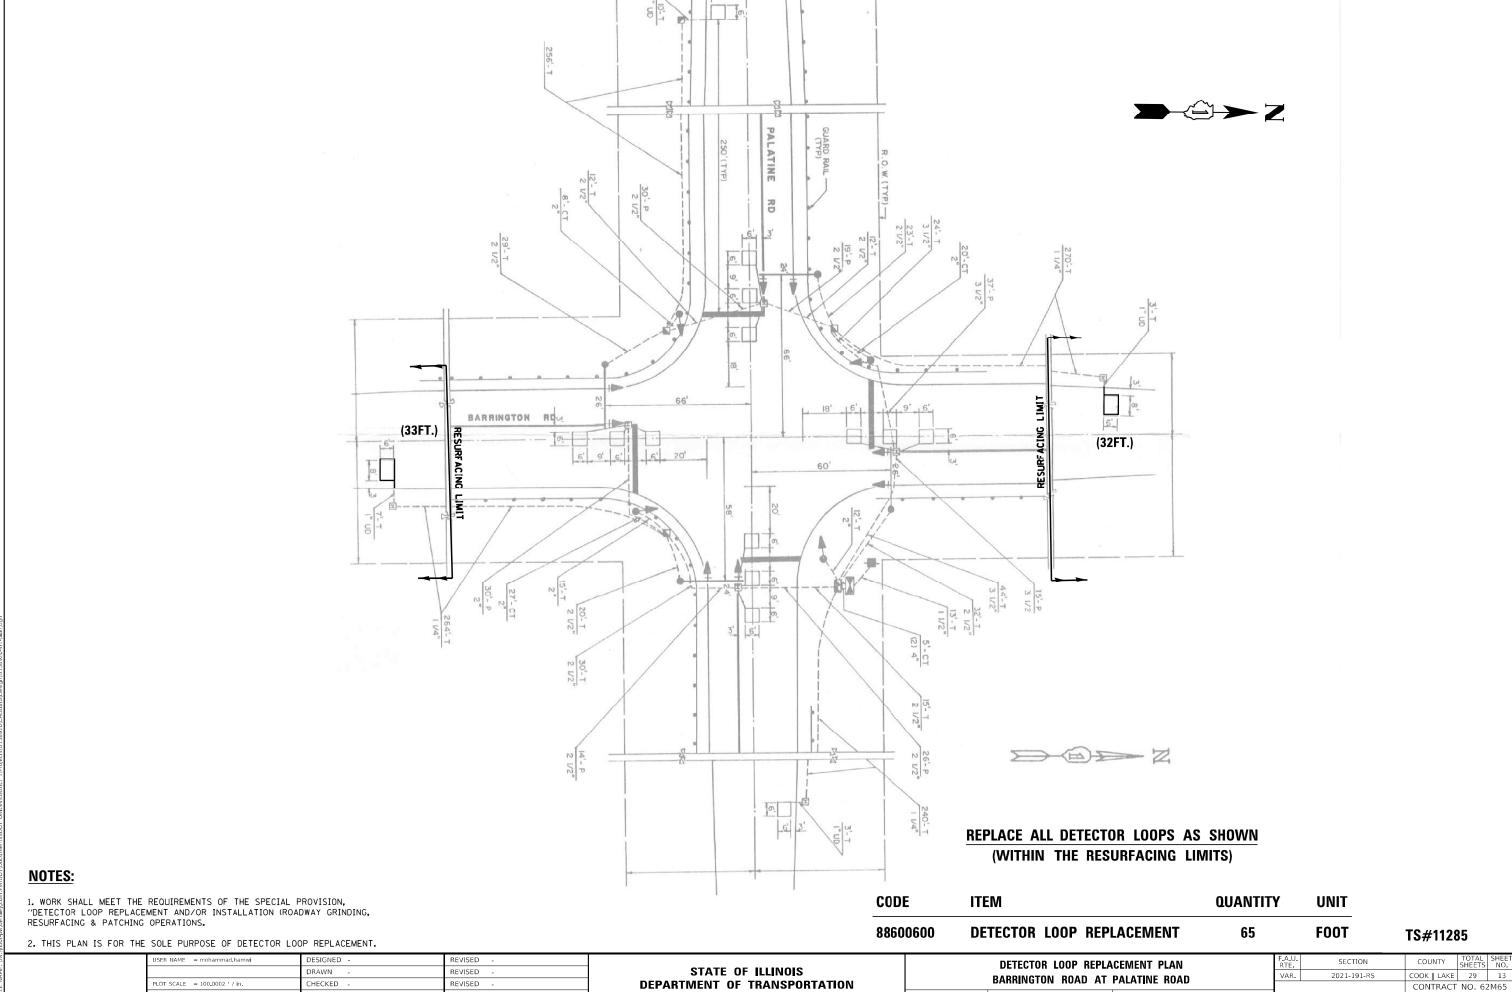

MODEL: Default

DATE

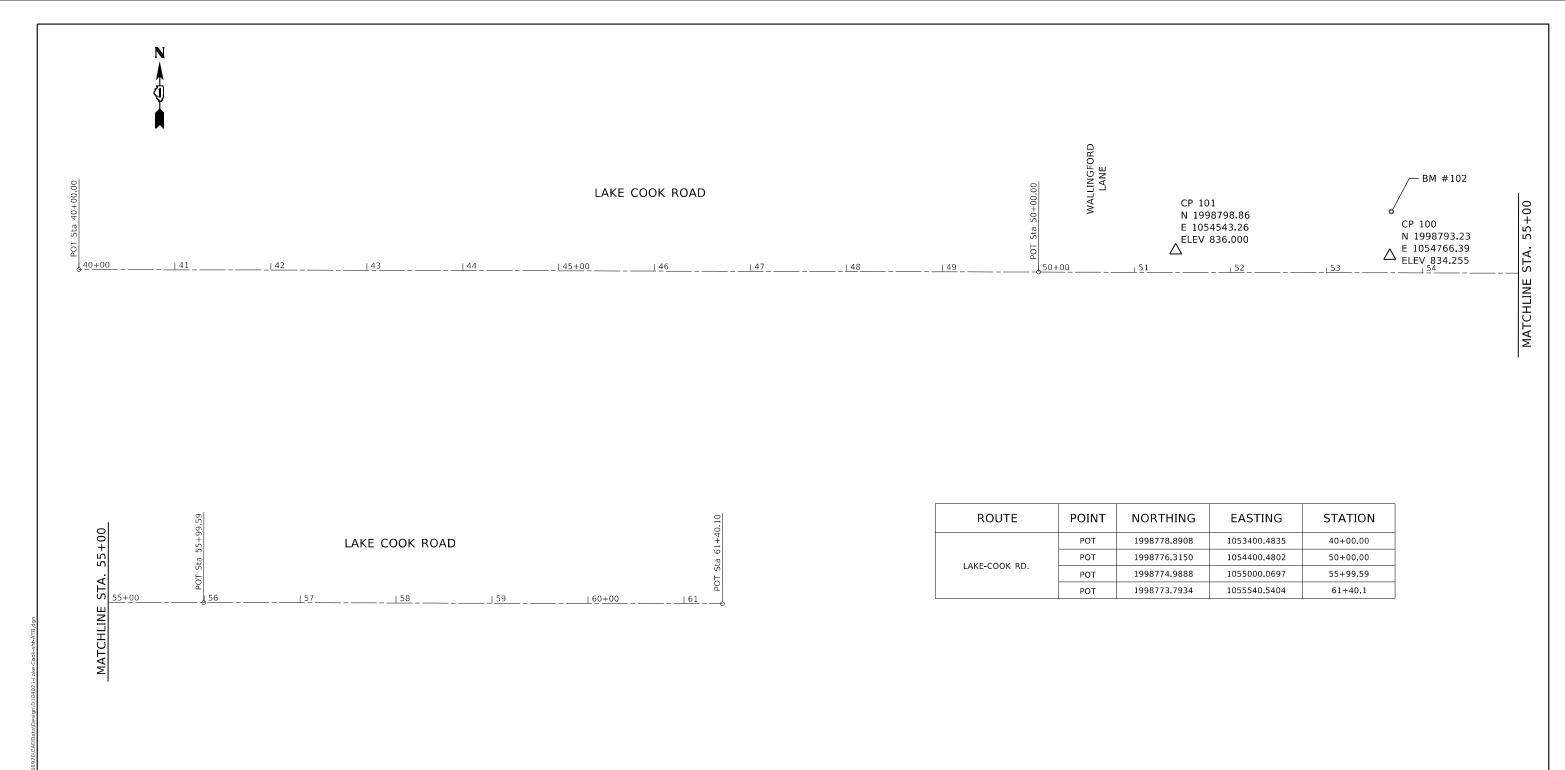

BM #102 - CUT ⊠ ON N. EDGE OF CONC. FLAT TOP OF STR #1002 STA. 53+67.3/ 65.86' LT ELEV. 832.080

 USER NAME
 = mohammad.hamwi
 DESIGNED
 REVISED

 DRAWN
 REVISED

 PLOT SCALE
 = 100.0000 ' / in.
 CHECKED
 REVISED

 PLOT DATE
 = 12/15/2022
 DATE
 REVISED

STATE OF ILLINOIS DEPARTMENT OF TRANSPORTATION


ALIGNMENT, TIES AND BENCHMARK
LAKE COOK ROAD, EAST OF WALLINGFORD LANE


SCALE: 1"=50' SHEET OF SHEETS STA. TO STA.

F.A.U. SECTION COUNTY TOTAL SHEETS NO.

VAR. 2020-191-RS COOK & LAKE 29 14

CONTRACT NO. 62M65

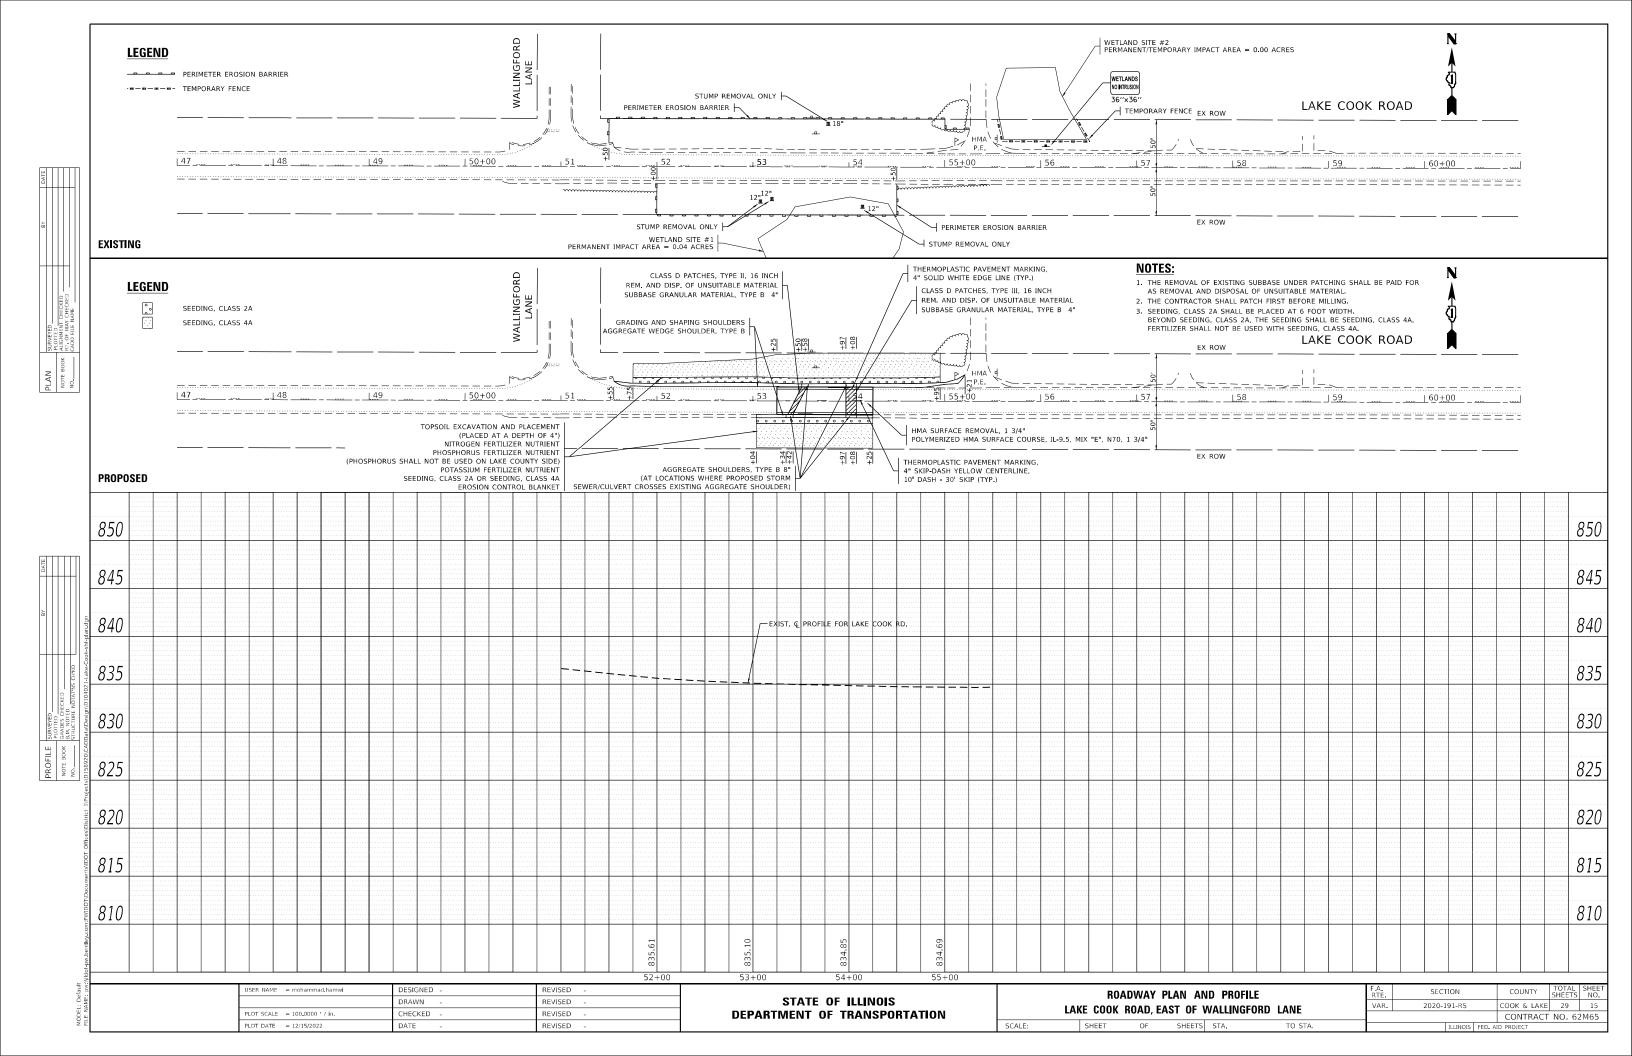

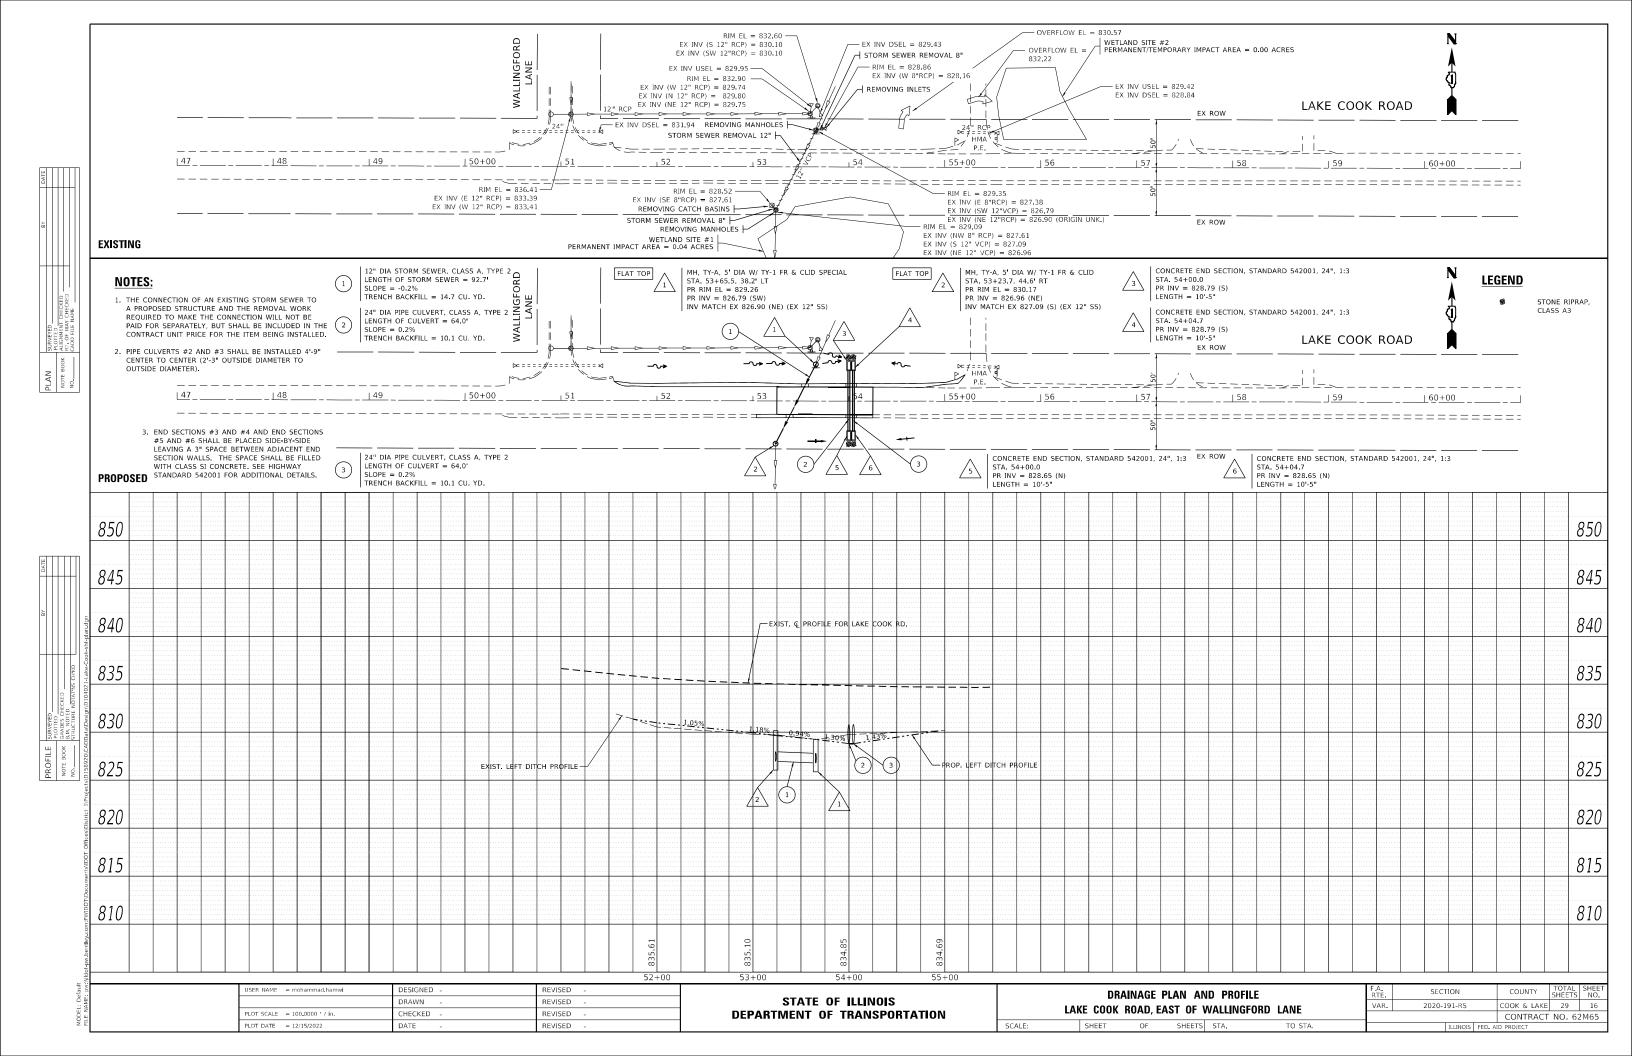

			E/	ARTHWORK SCHED	ULE			
1	2	3	4	_ 5	6	7_	8	9
LAKE COOK ROAD, EAST OF WALLINGFORD LANE	EARTH EXCAVATION (CU. YD.)	EMBANKMENT (CU. YD.)	EARTH EXCAVATION TO BE USED AS EMBANKMENT (ADJUSTED FOR SHRINKAGE AND a(5)) (CU. YD.)	EARTHWORK BALANCE SURPLUS (+) OR SHORTAGE (-) (CU. YD.)	TOPSOIL EXCAVATION (CU. YD.)	TOPSOIL REQUIRED (CU. YD.)	TOPSOIL EXCAVATION  TO BE USED FOR  LANDSCAPING  (ADJUSTED FOR a(5))  (CU. YD.)	TOPSOIL BALANCE SURPLUS (+) OR SHORTAGE (-) (CU. YD.)
LT SIDE	24	85	20	-65	145	109	145	36
RT SIDE	5	80	4	-76	63	48	63	15
TOTAL =	29	165	24	-141	208	157	208	51

COLUMN 1: LOCATION FROM PLANS

COLUMN 2: CUT QUANTITIES FROM CROSS SECTIONS, WHICH DOES NOT INCLUDE UNSUITABLE MATERIAL OR TOPSOIL

COLUMN 3: FILL QUANTITIES FROM CROSS SECTIONS

COLUMN 4: EARTH EXCAVATION THAT IS TO BE USED AS EMBANKMENT, ADJUSTED FOR SHRINKAGE (SHRINKAGE FACTOR = 15%) AND DUE TO PRESENCE OF ARTICLE 669.05(A)(5) CONTAMINATED SITE PER "REMOVAL AND DISPOSAL OF REGULATED SUBSTANCES (PROJECT SPECIFIC)" SPECIAL PROVISION

COLUMN 5: COLUMN 4 - COLUMN 3

POSITIVE QUANTITY = EXTRA EXCAVATION

NEGATIVE QUANTITY = FURNISHED EXCAVATION NEEDED

COLUMN 6: TOPSOIL EXCAVATED TO A DEPTH OF 6" IN AREAS THAT SHALL BE DISTURBED BY PROPOSED WORK

COLUMN 7: TOPSOIL REQUIRED BASED ON AREA OF PROPOSED SEEDING (PLACED AT AREAS OF PROPOSED SEEDING AT A DEPTH OF 4")

COLUMN 8: TOPSOIL EXCAVATION THAT IS TO BE USED FOR LANDSCAPING, ADJUSTED DUE TO PRESENCE OF ARTICLE 669.05(A)(5) CONTAMINATED SITE PER "REMOVAL AND DISPOSAL OF REGULATED SUBSTANCES (PROJECT SPECIFIC)" SPECIAL PROVISION


COLUMN 9: COLUMN 8 - COLUMN 7

POSITIVE QUANTITY = EXTRA TOPSOIL

NEGATIVE QUANTITY = TOPSOIL FURNISH AND PLACE NEEDED

USER NAME = mohammad,hamwi	DESIGNED -	REVISED -
	DRAWN -	REVISED -
PLOT SCALE = 100.0000 / in.	CHECKED -	REVISED -
PLOT DATE = 12/15/2022	DATE -	REVISED -

		EARTHV	VORK SCH	IEDULE		F.A. RTE	SECT	ПОИ		COUN	ITY	TOTAL SHEETS	SHEET NO.
LAK	LAKE COOK ROAD, EAST OF WALLINGFORD LANE						2020-191-RS			соок &	LAKE	29	17
LAI	VE OOOK	HOAD, L	AO1 01 V	VALLIIV	JI OILD EANE					CONT	RACT	NO. 62	2M65
	SHEET	OF	SHEETS	STA.	TO STA.			ILLINOIS	FED. A	ID PROJECT			

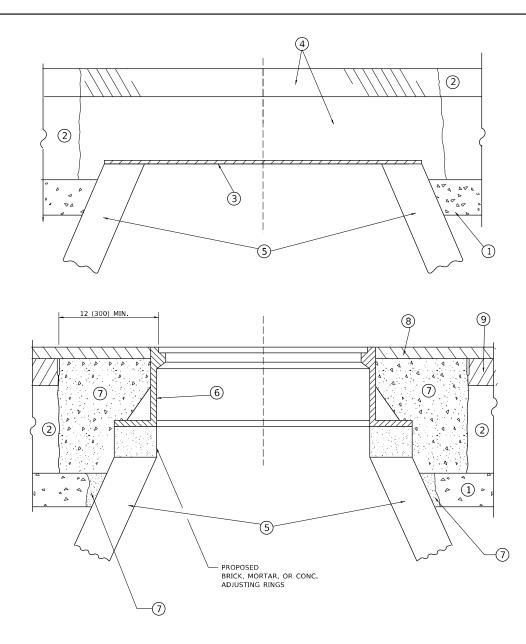

# DETAILS FOR FRAMES AND LIDS ADJUSTMENT WITH MILLING

#### **NOTES**

- 1. EXISTING BROKEN FRAMES AND LIDS SHALL BE REMOVED AND DISPOSED OF BY THE CONTRACTOR AND SHALL BE REPLACED AS DIRECTED BY THE ENGINEER. REPLACEMENT FRAMES AND LIDS WILL BE PAID FOR IN ACCORDANCE WITH ARTICLE 109.04 OF THE STANDARD SPECIFICATIONS UNLESS A SEPARATE PAY ITEM HAS BEEN PROVIDED.
- IF THE EXISTING LIDS ARE OPEN, THE FRAME WILL BE ADJUSTED TO THE ELEVATION OF THE MILLED PAVEMENT SURFACE PRIOR TO THE MILLING OPERATION. THE FRAME WILL NOT BE REMOVED AND COVERED BY THE METAL PLATE.
- 3. CITY OF CHICAGO CASTINGS ARE THE PROPERTY OF THE CITY AND THE CONTRACTOR SHALL NOTIFY THE CITY FOR REMOVAL AND DISPOSITION OF THE CASTINGS.
- 4. THE METAL PLATE USED TO COVER THE STRUCTURE SHALL REMAIN THE PROPERTY OF THE CONTRACTOR.

#### **CONSTRUCTION PROCEDURES**

#### STAGE 1 (BEFORE PAVEMENT MILLING)

- A) REMOVE A MINIMUM OF 12 (300) OF THE PAVEMENT FROM AROUND THE STRUCTURE.
- B) REMOVE THE EXISTING FRAME AND LID FROM THE STRUCTURE.
- C) COVER THE STRUCTURE OPENING WITH A 36 (900) DIAMETER METAL PLATE.
- D) BACKFILL WITH CRUSHED STONE AND HMA SURFACE MIX APPROVED BY THE ENGINEER. (MIN. 1 1/2 (40) HMA TO REMAIN AFTER MILLING).

# STAGE 2 (AFTER PAVEMENT MILLING)

- A) REMOVE THE HMA SURFACE MIX AND CRUSHED STONE.
- B) INSTALL THE FRAME AND LID; ADJUST THE FRAME TO ITS FINAL SURFACE ELEVATION.
- C) THE SURROUNDING SPACE SHALL BE FILLED WITH CLASS\*PP-1 CONCRETE TO THE ELEVATION OF THE SURFACE OF THE EXISTING BASE COURSE OR THE BINDER COURSE.
- \*UNLESS OTHERWISE SPECIFIED IN THE PLANS.

THE PROCEDURE EXPLAINED ABOVE SHALL CONFORM TO THE APPLICABLE PORTIONS OF SECTIONS 353, 406, 602, AND 603 OF THE STANDARD SPECIFICATIONS EXCEPT THAT "THE CONTRACTOR SHALL ADJUST THE STRUCTURES TO THE FINISHED PAVEMENT ELEVATION NO MORE THAN 5 CALENDAR DAYS PRIOR TO PLACEMENT OF THE FINAL LIFT OF SURFACE UNLESS APPROVED BY THE ENGINEER."

### <u>LEGEND</u>

1 SUB-BASE GRANULAR MATERIAL

(5) EXISTING STRUCTURE

- (6) FRAME AND LID (SEE NOTES)
- (2) EXISTING PAVEMENT
- (7) CLASS\*PP-1 CONCRETE
- 3 36 (900) DIAMETER METAL PLATE
- (8) PROPOSED HMA SURFACE COURSE
- 4 PROPOSED CRUSHED STONE AND HMA SURFACE MIX
  - AND
  - (9) PROPOSED HMA BINDER COURSE

# LOCATION OF STRUCTURES

THE CONTRACTOR WILL BE REQUIRED TO KEEP A RECORD OF THE LOCATIONS OF THE BURIED STRUCTURES ACCORDING TO THE STATION AND DISTANCE LEFT OR RIGHT OF THE CENTERLINE OF PAVEMENT. UPON COMPLETION OF THE WORK, THE CONTRACTOR WILL DELIVER THE RECORD TO THE ENGINEER.

# BASIS OF PAYMENT

- 1. REMOVING FRAMES AND LIDS ON DRAINAGE AND UTILITY STRUCTURES IN THE PAVEMENT PRIOR TO MILLING, AND ADJUSTING TO FINAL GRADE PRIOR TO PLACING THE SURFACE COURSE, WILL BE PAID FOR AT THE CONTRACT UNIT PRICE EACH FOR "FRAMES AND LIDS TO BE ADJUSTED (SPECIAL)."
- THIS WORK WILL NOT BE PAID FOR WHEN DRAINAGE AND UTILITY STRUCTURES ARE SPECIFIED FOR PAYMENT AS STRUCTURE RECONSTRUCTION.
- 3. NEW FRAMES AND LIDS, WHEN SPECIFIED, WILL BE PAID FOR SEPARATELY.
- 4. WHEN STRUCTURES ARE TO BE ADJUSTED OR RECONSTRUCTED, THE LOWERING AND RAISING OF THE FRAMES AND LIDS WILL NOT BE PAID FOR SEPARATELY BUT WILL BE INCLUDED IN THE COST OF THE CORRESPONDING PAY ITEM.

ALL DIMENSIONS ARE IN INCHES (MILLIMETERS) UNLESS OTHERWISE SHOWN

STATE OF ILLINOIS
DEPARTMENT OF TRANSPORTATION

DETAILS FOR
FRAMES AND LIDS ADJUSTMENT WITH MILLING

NE SHEET 1 OF 1 SHEETS STA. TO STA.

F.A. U
RTE.
VAR. 20
BD600-0

 RTE.
 SECTION
 COUNTY
 SHEETS
 NO.

 VAR.
 2020-191-RS
 COOK | LAKE
 29
 18

 BD600-03 (BD-08)
 CONTRACT NO.
 62M65


 ILLINOIS
 FED. AID PROJECT

# METHOD OF MEASUREMENT

REFER TO SECTION 442 OF THE STANDARD SPECIFICATIONS FOR ROAD AND BRIDGE CONSTRUCTION AND THE RECURRING SPECIAL PROVISION "PATCHING WITH HOT-MIX ASPHALT OVERLAY REMOVAL."

# **BASIS OF PAYMENT**

- 1. REFER TO SECTION 442 OF THE STANDARD SPECIFICATIONS FOR ROAD AND BRIDGE CONSTRUCTION AND THE RECURRING SPECIAL PROVISION "PATCHING WITH HOT-MIX ASPHALT OVERLAY REMOVAL."
- 2. SAW CUT/SCORING OF EXISTING HMA OVERLAY IS INCLUDED IN THE COST OF PAVEMENT PATCHING.
- 3. SAW CUT/SCORING OF EXISTING PAVEMENT IS INCLUDED IN THE COST OF PAVEMENT PATCHING.

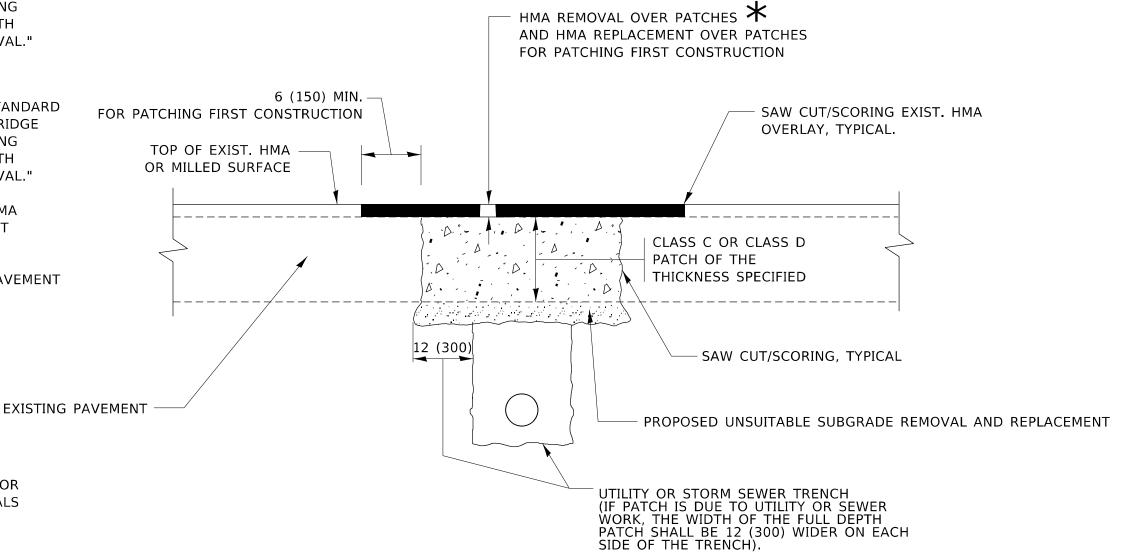

# **SEQUENCE OF CONSTRUCTION (PATCHING FIRST)**

1. REMOVE THE EXISTING HMA MATERIAL OVER THE AREA TO BE PATCHED.

SEE TYPICAL SECTIONS FOR

THICKNESS AND MATERIALS


- 2. REMOVE AND REPLACE WITH CLASS C OR D PATCH.
- 3. REPLACE HMA MATERIAL OVER THE AREA TO BE PATCHED.

# **SEQUENCE OF CONSTRUCTION (MILLING FIRST)**

- 1. MILL HMA FIRST IF THERE IS AT LEAST  $4\frac{1}{2}$  INCHES OR MORE OF HMA MATERIAL ON TOP OF THE EXISTING PAVEMENT OR IF THE PAVEMENT IS FULL DEPTH HMA. A MINIMUM OF 2 INCHES OF HMA MATERIAL SHALL BE IN PLACE AFTER MILLING.
- 2. REMOVE AND REPLACE WITH FULL DEPTH CLASS D PATCHES TO TOP OF MILLED SURFACE.

ALL DIMENSIONS ARE IN INCHES (MILLIMETERS) UNLESS OTHERWISE SHOWN.

USER NAME = mohammad.hamwi	DESIGNED - R. SHAH	REVISED - R. BORO 01-01-07		PAVEMENT PATCHING FOR	F.A.U BTF	SECTION	COUNTY TO	TAL SHEET
	DRAWN -	REVISED - R. BORO 09-04-07	STATE OF ILLINOIS		VAR	2020-191-RS	COOK I LAKE 2	29 19
PLOT SCALE = 100.0000 / in	CHECKED -	REVISED - K. ENG 10-27-08	DEPARTMENT OF TRANSPORTATION	HMA SURFACED PAVEMENT	В	D400-04 (BD-22)	CONTRACT NO	. 62M65
PLOT DATE = 12/15/2022	DATE - 10-25-94	REVISED - K. SMITH 11-18-22		SCALE: NONE SHEET 1 OF 1 SHEETS STA. TO STA.		II LINOIS FED	. AID PROJECT	

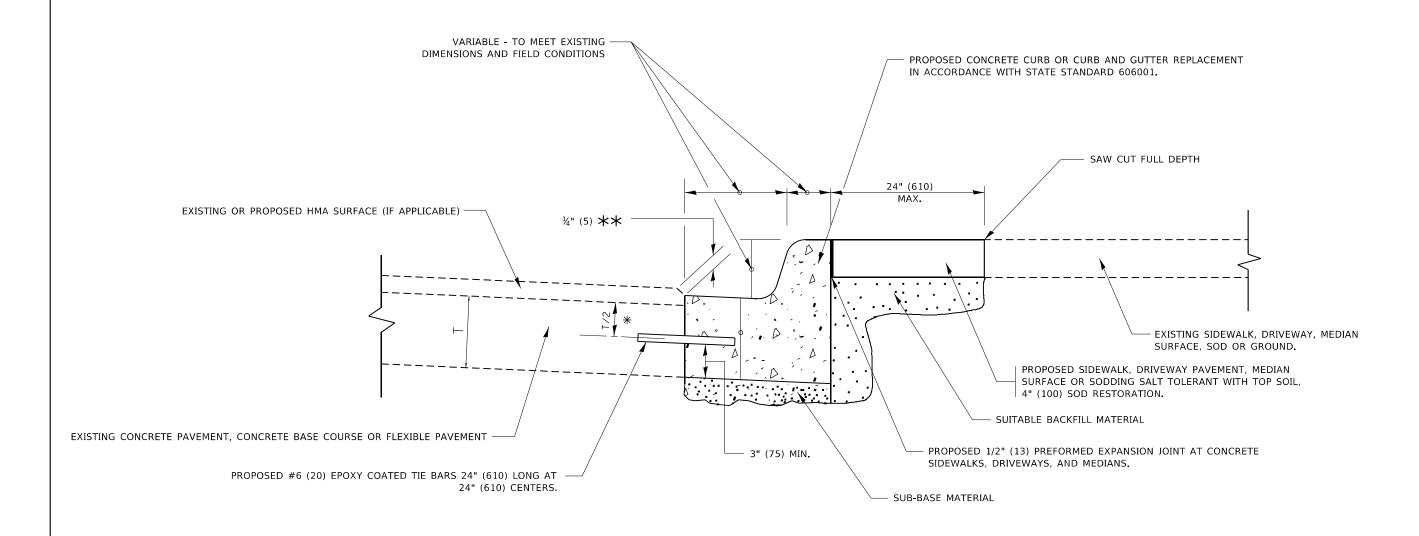


- 💥 3" (75) MINIMUM FROM TOP AND BOTTOM OF THE CONCRETE PAVEMENT OR BASE COURSE.
- $\star\star$  IF THE FINAL SURFACE OF THE PAVEMENT IS CONCRETE, THE GUTTER IS TO BE FLUSH WITH THE PAVEMENT.

# **CURB OR CURB AND GUTTER REMOVAL AND REPLACEMENT**

ALL DIMENSIONS ARE IN INCHES (MILLIMETERS) UNLESS OTHERWISE SHOWN.


USEK NAME = monammad.namwi	DESIGNED - A. HOUSEH	REVISED -	A. ABBAS 03-21-97	
	DRAWN -	REVISED -	M. GOMEZ 01-22-01	STATE OF ILLINOIS
PLOT SCALE = 100.0000 / in.	CHECKED -	REVISED -	R. BORO 12-15-09	DEPARTMENT OF TRANSPORTATION
PLOT DATE = 12/15/2022	DATE - 03-11-94	REVISED -	K. SMITH 07-11-19	

CUR	B OF	i Cl	JRB AN	D GUT	TER		F.A.U RTE	SEC <sup>-</sup>	TION		COUNTY	TOTAL SHEETS	SHEET NO.
DEM	nνΛ		ND REP	LACEMI	FNT		VAR.	2020-1	191-RS		COOK   WILL	29	20
ILIVI	UVA	L A1	VD IILI	LACLIVII	LIVI			BD600-06 (E	3D-24)		CONTRACT	NO. 6	2M65
1	OF	1	SHEETS	STA.		TO STA.			THINOIS	FFD. Al	D PROJECT		

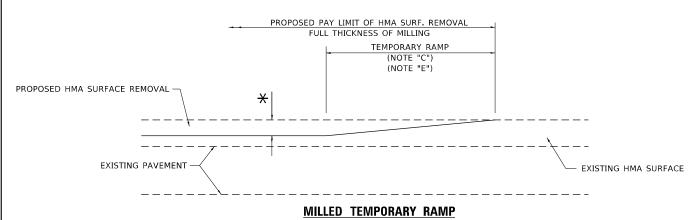

(FOR BUTT JOINT AND HMA TAPER SEE DETAIL BELOW)

# OPTION 1

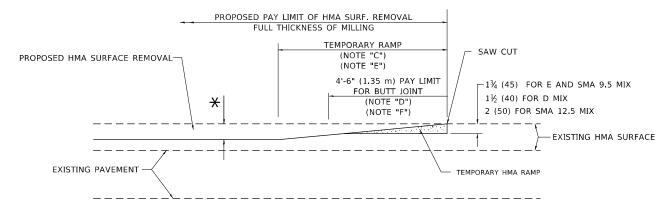


# HMA CONSTRUCTED TEMPORARY RAMP

(FOR BUTT JOINT AND HMA TAPER SEE DETAIL BELOW)


# OPTION 2


# TYPICAL TEMPORARY RAMP

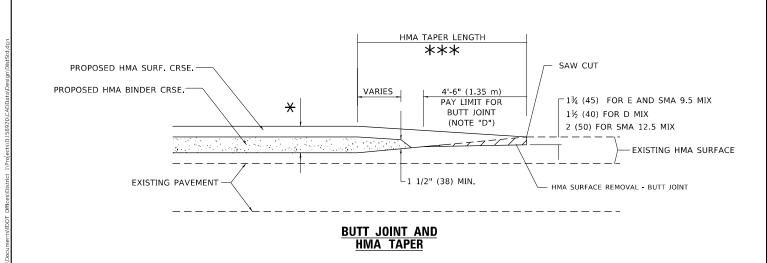

# TYPICAL BUTT JOINT AND HMA TAPER FOR MILLING AND RESURFACING

STATE OF ILLINOIS
DEPARTMENT OF TRANSPORTATION

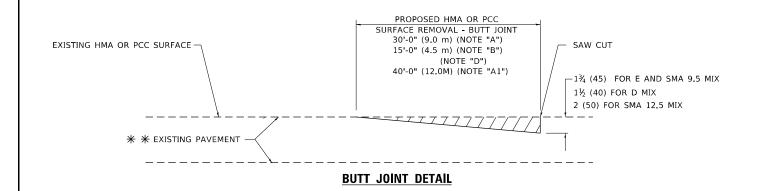

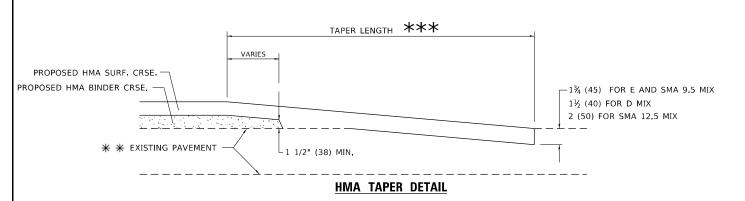

# TYPICAL BUTT JOINT AND HMA TAPER FOR RESURFACING ONLY

\*\* PC CONCRETE, HMA OR HMA RESURFACED PAVEMENT.


# **GENERAL NOTES**

- A. MAINLINE ARTERIAL ROADWAYS AND MAJOR SIDE ROADS.
- A1. INTERSTATES
- B. MINOR SIDE ROADS.
- C. THE TEMP. RAMP SHALL BE CONSTRUCTED IMMEDIATELY UPON REMOVAL OF THE EXISTING HMA SURFACE,
- D. THE BUTT JOINT SHALL BE CONSTRUCTED IMMEDIATELY PRIOR TO PLACING THE PROPOSED HMA COURSES,
- E. TAPER THE TEMP. RAMP AT A RATE OF 3' 4" (1.02m) PER 1 INCH (25 mm) OF MILLING THICKNESS.
  - igstar SEE TYPICAL SECTIONS FOR MILLING THICKNESS.
- F. SEE ARTICLE 406.08 AND 406.14 OF THE STANDARD SPECIFICATIONS FOR "HMA AND/OR PCC SURFACE REMOVAL, BUTT JOINT".
- \*\*\* 20'-0" (6.1 m) PER 1 (25) RESURFACING (NOTE "A") 10'-0" (3.0 m) PER 1 (25) RESURFACING (NOTE "B")

# **BASIS OF PAYMENT**

- THE BUTT JOINT WILL BE PAID FOR AT THE CONTRACT UNIT PRICE PER SQUARE YARD (SQUARE METER) FOR "HOT-MIX ASPHALT SURFACE REMOVAL - BUTT JOINT" OR FOR "PORTLAND CEMENT CONCRETE SURFACE REMOVAL- BUTT JOINT"
- THE TEMPORARY RAMP AND SAW CUT SHALL BE INCLUDED IN THE UNIT COST FOR HMA OR PCC SURFACE REMOVAL-BUTT JOINT.

ALL DIMENSIONS ARE IN INCHES (MILLIMETERS) UNLESS OTHERWISE SHOWN.

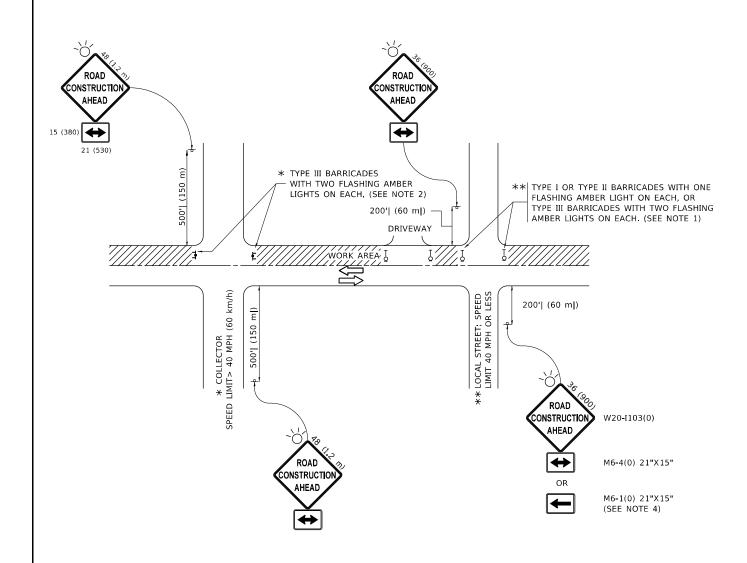

# NOTES:

- 1. SIDE ROAD WITH A SPEED LIMIT OF 40 MPH (60 km/h) OR LESS AS SHOWN ON THE DRAWING AND AS DIRECTED BY THE ENGINEER:
- a) ONE "ROAD CONSTRUCTION AHEAD" SIGN 36 x 36 (900x900) WITH A FLASHER MOUNTED ON IT APPROXIMATELY 200' (60 m) IN ADVANCE OF THE MAIN ROUTE.
- b) THE CLOSED PORTION OF THE MAIN ROUTE SHALL BE PROTECTED BY BLOCKING WITH TYPE I, TYPE II OR TYPE III BARRICADES, 1/3 OF THE CROSS SECTION OF THE CLOSED PORTION.
- SIDE ROAD WITH A SPEED LIMIT GREATER THAN 40 MPH (60 km/h) AS SHOWN ON THE DRAWING AND AS DIRECTED BY THE ENGINEER:
- a) ONE "ROAD CONSTRUCTION AHEAD" SIGN 48 x 48 (1.2 m x 1.2 m) WITH A FLASHER MOUNTED ON IT APPROXIMATELY 500' (150 m) IN ADVANCE OF THE MAIN ROUTE.
- THE CLOSED PORTION OF THE MAIN ROUTE SHALL BE PROTECTED BY
  b) BLOCKING WITH TYPE III BARRICADES, 1/2 OF THE CROSS SECTION
  OF THE CLOSED PORTION.
- 3. CONES MAY BE SUBSTITUTED FOR BARRICADES OR DRUMS AT HALF THE SPACING DURING DAY OPERATIONS. CONES SHALL BE A MINIMUM OF 28 (710) IN HEIGHT
- WHEN THE SIDE ROAD LIES BETWEEN THE BEGINNING OF THE MAINLINE
  4. SIGNING AND THE WORK ZONE, A SINGLE HEADED ARROW (M6-1) SHALL
  BE USED IN LIEU OF THE DOUBLE HEADED ARROW (M6-4).

- 5. WHEN WORK IS BEING PERFORMED ON A SIDE ROAD OR DRIVEWAY, FOLLOW THE APPLICABLE STANDARD(S). THE DIRECTIONAL ARROW (M6-1 OR M6-4) SHALL BE COVERED OR REMOVED WHEN NO LONGER CONSISTENT WITH THE TRAFFIC CONTROL SET-UP.
- 6. ADVANCE WARNING SIGNS ARE TO BE OMITTED ON DRIVEWAYS UNLESS OTHERWISE SPECIFIED IN THE PLANS OR BY THE ENGINEER
- THE TRAFFIC CONTROL AND PROTECTION FOR SIDE ROADS, INTERSECTIONS, AND DRIVEWAYS SHALL BE INCLUDED IN THE COST OF SPECIFIED TRAFFIC CONTROL STANDARDS OR ITEMS.


All dimensions are in inches (millimeters) unless otherwise shown.

USER NAME = mohammad.hamwi	DESIGNED - L.H.A.	REVISED - A. HOUSEH 10-15-96
	DRAWN -	REVISED - T. RAMMACHER 01-06-00
PLOT SCALE = 100.0000 / in.	CHECKED -	REVISED - A. SCHUETZE 07-01-13
PLOT DATE = 12/15/2022	DATE - 06-89	REVISED _ A. SCHUETZE 09-15-16

STATE OF ILLINOIS
DEPARTMENT OF TRANSPORTATION

TRAFFIC CONTROL AND PROTECTION FOR SIDE ROADS, INTERSECTIONS, AND DRIVEWAYS


SHEET 1 OF 1 SHEETS STA. TO ST

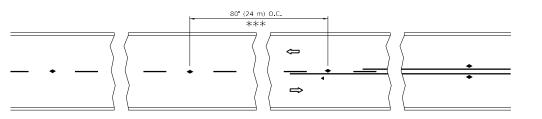


\*\*\* REDUCE TO 40' (12 m) O.C. ON CURVES WITH POSTED OR ADVISORY SPEED 45 M.P.H. (70 km/h) OR LESS.


# LANE REDUCTION TRANSITION

SEE FIGURE 3B-14 MUTCD

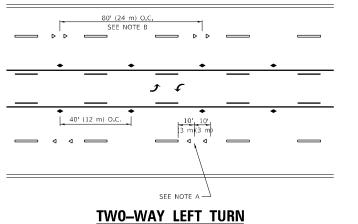


# TWO-LANE/TWO-WAY

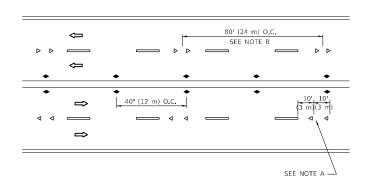


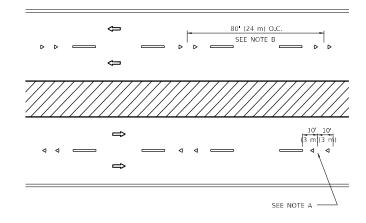

# MULTI-LANE/UNDIVIDED



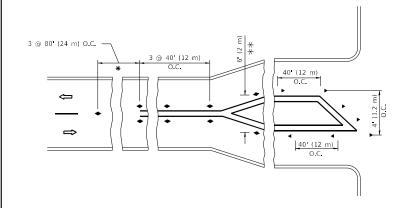

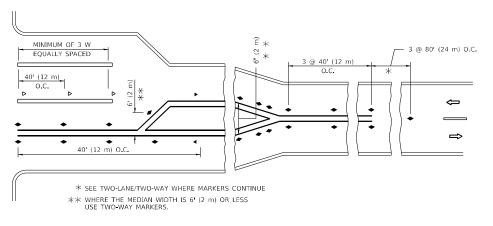

# **TURN LANES**

# **GENERAL NOTES**

- MARKERS USED WITH DASHED LINES SHALL BE CENTERED IN THE GAP BETWEEN SEGMENTS.
- 2. MARKERS USED ADJACENT TO SOLID LINES SHALL BE OFFSET 2 TO 3 (50 TO 75) TOWARD TRAFFIC AS SHOWN.
- MARKERS THROUGH TANGENTS LESS THAN 500' (150 m) IN LENGTH BETWEEN CURVES SHALL BE INSTALLED AT THE LESSER OF THE TWO CURVE SPACINGS.
- 4. MARKERS ARE TO BE USED ADJACENT TO BOTH SOLID WHITE LINES IN DUAL LEFT TURN LANES

# LANE MARKER NOTES

- A. USE DOUBLE LANE LINE MARKERS SPACED AS SHOWN.
- B. REDUCE TO 40' (12 m) O.C. ON CURVES WHERE ADVISORY SPEEDS ARE 10 M.P.H (20 km/h) LOWER THAN POSTED SPEEDS.

# **DESIGN NOTES**

- 1. DOUBLE LANE LINE MARKERS SHALL BE USED UNLESS SPECIFIED OTHERWISE.
- EXCEPT AS SHOWN ON THE LANE REDUCTION TRANSITION AND FREEWAY EXIT RAMP DETAIL, MARKERS ARE NOT TO BE SPECIFIED ON RIGHT EDGE LINES.
- 3. THE EXACT MARKER LIMITS, SPACING, AND COLOR SHALL BE INCLUDED IN THE PLANS WHEN STANDARD SPECIFICATIONS ARE NOT BEING USED.
- MARKERS SHOULD NOT BE USED ALONGSIDE CURBS EXCEPT FOR EXTREMELY SHORT SECTIONS OF CURBS WHERE NOT MORE THAN TWO MARKERS WOULD BE INVOLVED.

All dimensions are in inches (millimeters) unless otherwise shown.

STATE OF ILLINOIS
DEPARTMENT OF TRANSPORTATION

TYPICAL APPLICATIONS

RAISED REFLECTIVE PAVEMENT MARKERS (SNOW-PLOW RESISTANT)

SCALE: NONE SHEET 1 OF 1 SHEETS STA. TO STA.

U SECTION COUNTY TOTAL SHEETS NO.

3. 2020-191-RS COOK | LAKE | 29 | 23

TC-11 CONTRACT NO. 62M65

**SYMBOLS** 


ONE-WAY AMBER MARKER

TWO-WAY AMBER MARKER


ONE-WAY CRYSTAL MARKER (W/O)

YELLOW STRIPE

■ WHITE STRIPE

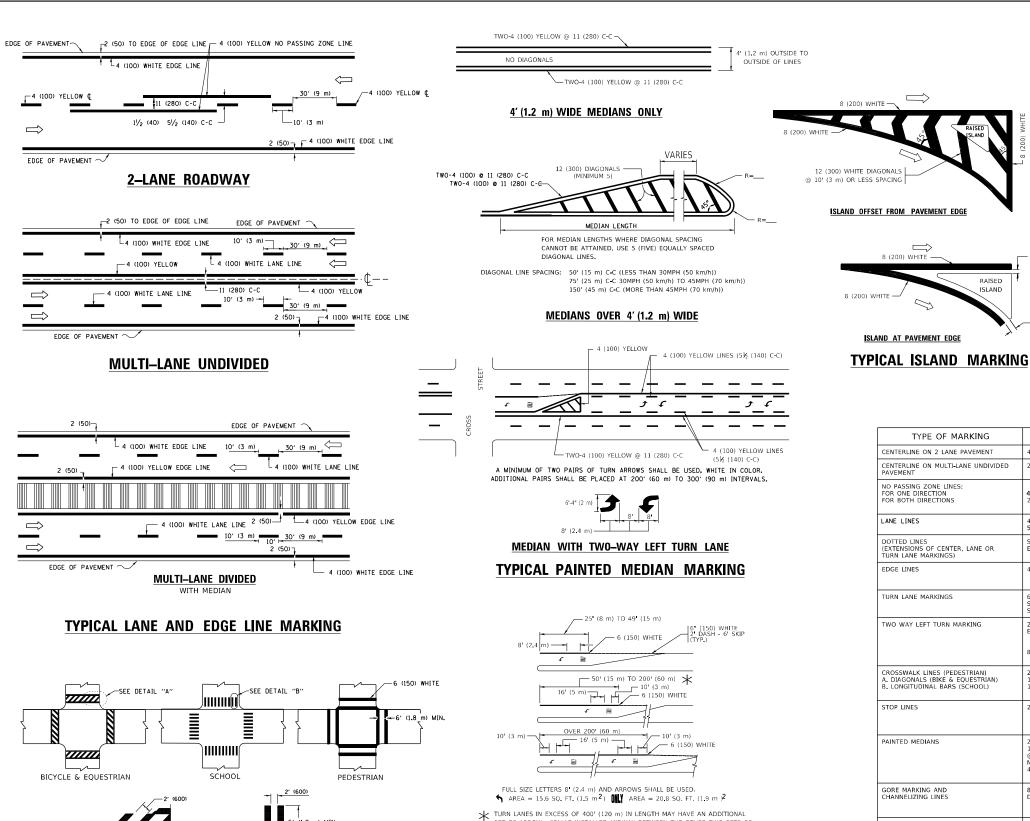

 $\star$  TURN LANES IN EXCESS OF 400' (120 m) IN LENGTH MAY HAVE AN ADDITIONAL SET OF ARROW - "ONLY" INSTALLED MIDWAY BETWEEN THE OTHER TWO SETS OF ARROW - "ONLY". TYPICAL LEFT (OR RIGHT) TURN LANE TYPICAL TURN LANE MARKING

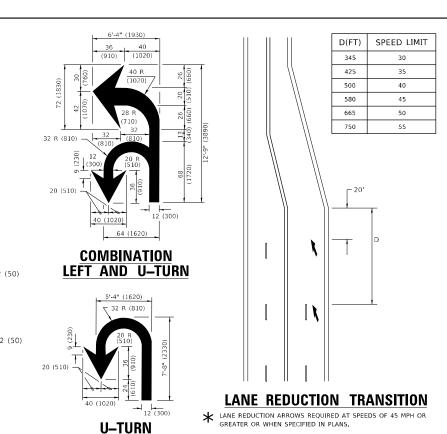

TYPE OF MARKING	WIDTH OF LINE	PATTERN	COLOR	SPACING / REMARKS
CENTERLINE ON 2 LANE PAVEMENT	4 (100)	SKIP-DASH	YELLOW	10' (3 m) LINE WITH 30' (9 m) SPACE
CENTERLINE ON MULTI-LANE UNDIVIDED PAVEMENT	2 @ 4 (100)	SOLID	YELLOW	11 (280) C-C
NO PASSING ZONE LINES: FOR ONE DIRECTION FOR BOTH DIRECTIONS	4 (100) 2 @ 4 (100)	SOLID SOLID	YELLOW YELLOW	5½ (140) C-C FROM SKIP-DASH CENTERLINE 11 (280) C-C OMIT SKIP-DASH CENTERLINE BETWEEN
LANE LINES	4 (100) 5 (125) ON FREEWAYS	SKIP-DASH SKIP-DASH	WHITE WHITE	10' (3 m) LINE WITH 30' (9 m) SPACE
DOTTED LINES (EXTENSIONS OF CENTER, LANE OR TURN LANE MARKINGS)	SAME AS LINE BEING EXTENDED	SKIP-DASH	SAME AS LINE BEING EXTENDED	2' (600) LINE WITH 6' (1.8 m) SPACE
EDGE LINES	4 (100)	SOLID	YELLOW-LEFT WHITE-RIGHT	OUTLINE MEDIANS IN YELLOW
TURN LANE MARKINGS	6 (150) LINE; FULL SIZE LETTERS & SYMBOLS (8' (2.4m))	SOLID	WHITE	SEE TYPICAL TURN LANE MARKING DETAIL
TWO WAY LEFT TURN MARKING	2 @ 4 (100) EACH DIRECTION 8' (2.4m) LEFT ARROW	SKIP-DASH AND SOLID IN PAIRS	YELLOW	10' (3 m) LINE WITH 30' (9 m) SPACE FOR SKIP-DASH; 5½ (140) C-C BETWEEN SOLID LINE AND SKIP-DASH LINE SEE TYPICAL TWO-WAY LEFT TURN MARKING DETAIL
CROSSWALK LINES (PEDESTRIAN) A. DIAGONALS (BIKE & EQUESTRIAN) B. LONGITUDINAL BARS (SCHOOL)	2 @ 6 (150) 12 (300) @ 45° 12 (300) @ 90°	SOLID SOLID SOLID	WHITE WHITE WHITE	NOT LESS THAN 6' (1.8 m) APART 2' (600) APART 2' (500) APART 5EE TYPICAL CROSSWALK MARKING DETAILS.
STOP LINES	24 (600)	SOLID	WHITE	PLACE 4' (1.2 m) IN ADVANCE OF AND PARALLEL TO CROSSWALK, IF PRESENT. OTHERWISE, PLACE AT DESIRED STOPPING POINT. PARALLEL TO CROSSROAD CENTERLINE, WHERE POSSIBLE
PAINTED MEDIANS	2 @ 4 (100) WITH 12 (300) DIAGONALS @ 45° NO DIAGONALS USED FOR 4' (1.2 m) WIDE MEDIANS	SOLID	YELLOW: TWO WAY TRAFFIC WHITE: ONE WAY TRAFFIC	11 (280) C-C FOR THE DOUBLE LINE SEE TYPICAL PAINTED MEDIAN MARKING.
GORE MARKING AND CHANNELIZING LINES	8 (200) WITH 12 (300) DIAGONALS @ 45°	SOLID	WHITE	DIAGONALS: 115' (4.5 m) C-C (LESS THAN 30MPH (50 km/h)) 20' (6 m) C-C 30MPH (50 km/h) TO 45MPH (70 km/h)) 30' (9 m) C-C (OVER 45MPH (70 km/h))
RAILROAD CROSSING	24 (600) TRANSVERSE LINES: "RR" IS 6 (1.8 m) LETTERS; 16 (400) LINE FOR "X"	SOLID	WHITE	SEE STATE STANDARD 780001 AREA OF: "R"=3.6 SQ, FT. (0.33 m PEACH "X"=54.0 SQ, FT. (5.0 m PEACH
SHOULDER DIAGONALS (REQUIRED FOR SHOULDERS > 8')	12 (300) @ 45°	SOLID	WHITE - RIGHT YELLOW - LEFT	50' (15 m) C-C (LESS THAN 30MPH (50 km/h)) 75' (25 m) C-C (30 MPH (50 km/h) TO 45MPH (70 km/h)) 150' (45 m) C-C (OVER 45MPH (70 km/h))
U TURN ARROW	SEE DETAIL	SOLID	WHITE	16.3 SF
2 ARROW COMBINATION LEFT AND U TURN	SEE DETAIL	SOLID	WHITE	30.4 SF
	1	1		1

FOR FURTHER DETAILS ON PAVEMENT MARKING REFER TO STANDARD SPECIFICATIONS FOR ROAD AND BRIDGE CONSTRUCTION AND STATE STANDARD 780001.

8 (200) WHITE -

RAISED

All dimensions are in inches (millimeters) unless otherwise shown.

USER NAME = mohammad.hamwi	DESIGNED	-	EVERS	REVISED	-	C. JUCIUS 09-09-09
	DRAWN	-		REVISED	-	C. JUCIUS 07-01-13
PLOT SCALE = 100.0000 / in.	CHECKED	-		REVISED	-	C. JUCIUS 12-21-15
PLOT DATE = 12/15/2022	DATE	-	03-19-90	REVISED	-	C. JUCIUS 04-12-16

12 (300) WHITE

DETAIL "B"

- 6 (150) WHITE

TYPICAL CROSSWALK MARKING


\* MARKINGS SHALL BE INSTALLED PARALLEL TO THE CENTERLINE OF

DETAIL "A"

STATE OF ILLINOIS **DEPARTMENT OF TRANSPORTATION** 

	DISTI	RICT ON	NE .		F.A.U RTE	SECTION		COUN	TY	TOTAL SHEETS	SHEE NO.
TYPICAL PAVEMENT MARKINGS		VAR.	2020-191-RS	(	соок	LAKE	29	24			
11110	AL IAVI	IVILIAI	INAIININUS			TC-13		CONT	RACT	NO. 6	52M65
HEET 1	OE 2	СПЕЕТС	CTA	TO CTA		numore s	CO 410	DDOLECT			

# TURN BAY ENTRANCE AT START OF LANE CLOSURE TAPER

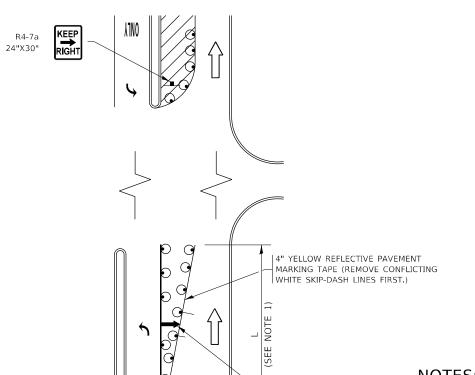



- ARROW BOARD




- 1. A) WHEN "L" IS  $\leq$  THE STORAGE LENGTH OF THE TURN LANE (AS SHOWN IN FIG. 1), USE FIGURE 1.
  - B) WHEN "L" IS > THE STORAGE LENGTH OF THE TURN LANE
    OR THE TURN LANE IS WITHIN THE LANE CLOSURE, USE FIGURE 2.
- CONES MAY BE SUBSTITUTED FOR BARRICADES OR DRUMS AT HALF THE SPACING DURING DAY OPERATIONS. CONES SHALL BE A MINIMUM OF 28 (710) IN HEIGHT.
- LIGHTS WILL NOT BE REQUIRED ON BARRICADES OR DRUMS FOR DAY OPERATIONS. ALL LIGHTS SHALL BE MONODIRECTIONAL.
- 4. REFLECTIVE TEMPORARY PAVEMENT MARKINGS SHALL BE PLACED THROUGHOUT THE BARRICADED AREAS OF EACH TURN BAY AS SHOWN WHERE THE CLOSURE TIME IS GREATER THAN FOURTEEN (14) DAYS.
- 5. THIS APPLICATION ALSO APPLIES WHEN WORK IS BEING PERFORMED IN THE RIGHT LANE(S) AND THE RIGHT TURN BAY IS TO REMAIN OPEN. UNDER THIS CONDITION, "RIGHT TURN LANE" R3-I100R 24 x 24 (600 x 600) AND M6-2R 21 x 15 (530 x 380) SHALL BE USED.
- THESE CONTROLS SHALL SUPPLEMENT MAINLINE TRAFFIC CONTROL FOR LANE CLOSURES,
- THE SIGNS SHALL BE MOUNTED ABOVE THE BARRICADES/DRUMS ON SEPARATE SIGN SUPPORTS THAT MEET NCHRP 350 OR MASH PREOUIREMENTS.
- 8. TRAFFIC CONTROL AND PROTECTION AT TURN BAYS (TO REMAIN OPEN TO TRAFFIC) SHALL BE INCLUDED IN THE COST OF SPECIFIED TRAFFIC CONTROL STANDARDS OR ITEMS.

# TURN BAY ENTRANCE WITHIN A LANE CLOSURE

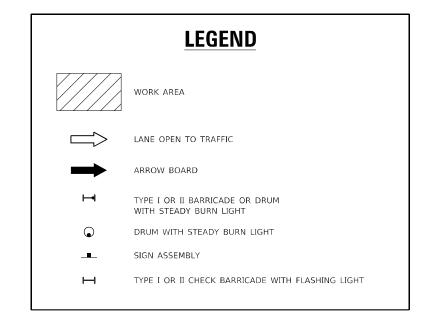

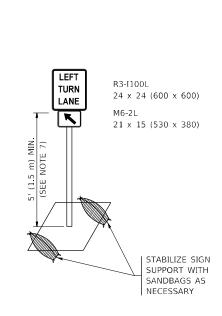

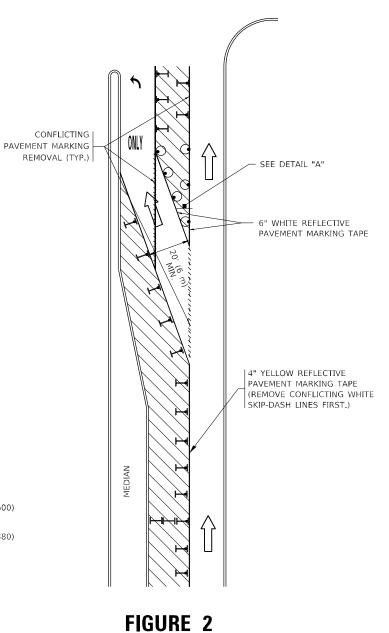

**DETAIL A** 

SCALE: NONE

All dimensions are in inches (millimeters) unless otherwise shown.

#### 

FIGURE 1

STATE OF ILLINOIS
DEPARTMENT OF TRANSPORTATION


TRAFF	IC CONTR	OL AND	PROTEC	CTION AT TURN	BAYS	F.A.U RTE	SECTION	COUNTY	TOTAL SHEETS
	/TO B	EMAIN	OPEN 1	TO TRAFFIC)		VAR.	2020-191-RS	COOK   LAKE	29
	(10 11	LIVIALIA	OI LIV	IO IIIAIIIO/			TC-14	CONTRACT	NO.
NIE	SHEET 1	OF 1	SHEETS	CTA	TO CTA		TURNOTE FED	AID DROIFET	

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SEE DETAIL "A"


:PWIDOT\Documents\IDOT Offices\District 1\Project

40DEL: Default

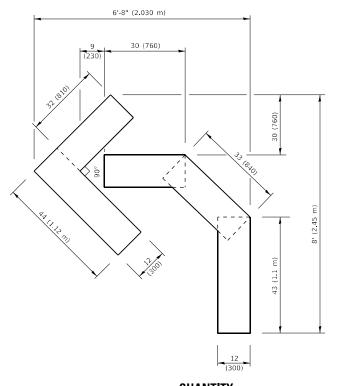

# **QUANTITY**

4 (100) LINE = 45.5 ft. (13.9 m) 15.2 sq. ft. (1.41 sq. m)

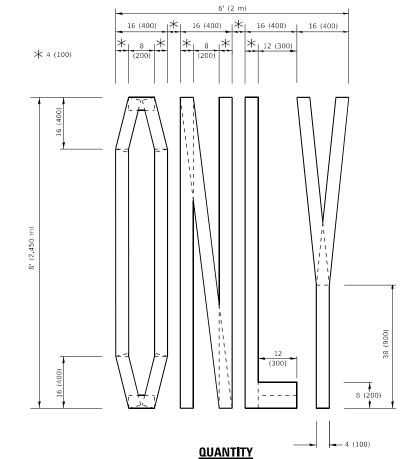

4 (100) LINE = 64.1 ft. (19.5 m) 21.4 sq. ft. (1.99 sq. m)

DESIGNED -

CHECKED


09-18-94

DRAWN

DATE

PLOT SCALE = 100.0000 / in.

PLOT DATE = 12/15/2022

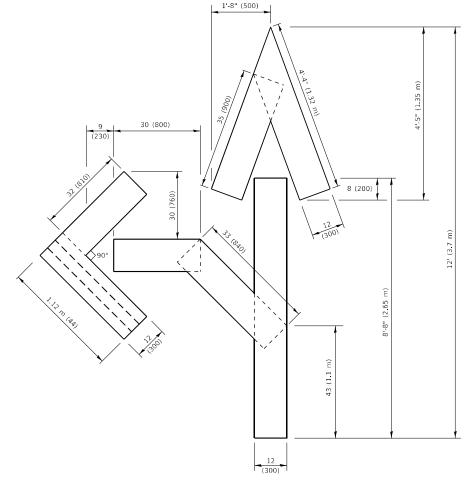


# QUANTITY

4 (100) LINE = 82.5 ft. (25.1 m) 27.5 sq. ft. (2.53 sq. m)

# NOTE:

ALL QUANTITIES OF PLACEMENT ARE REPRESENTED IN LINEAR FEET OF 4" LINES TO MATCH THE 4" TEMPORARY TAPE PAY ITEM AND REPRESENTS THE TOTAL QUANTITY OF 4" TAPE REQUIRED.

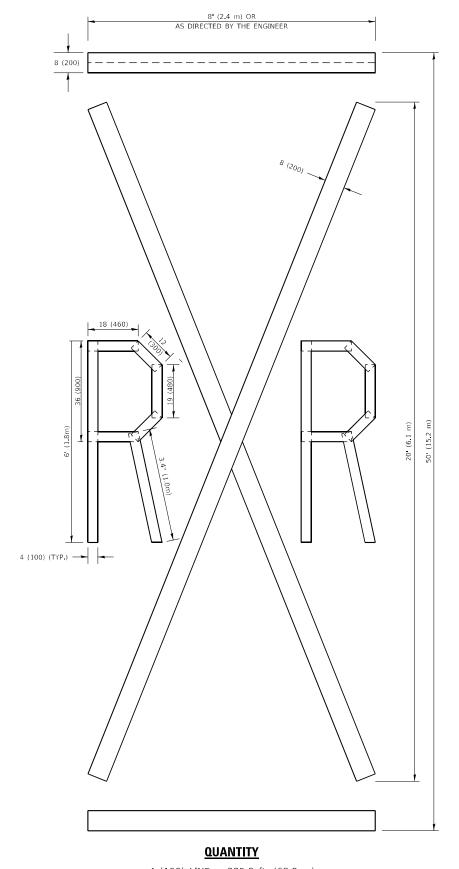

4 (100) LINE = 225.9 ft. (68.9 m) 75.3 sq. ft. (6.99 sq. m)

All dimensions are in inches (millimeters) unless otherwise shown.

REVISED - T. RAMMACHER 03-02-98

REVISED - E. GOMEZ 08-28-00

REVISED - E. GOMEZ 08-28-00

REVISED - A. SCHUETZE 09-15-16

STATE OF ILLINOIS
DEPARTMENT OF TRANSPORTATION


SHORT TERM PAVEMENT MARKING LETTERS AND SYMBOLS

SCALE: NONE SHEET 1 OF 1 SHEETS STA. TO STA.

F.A.U RTE. SECTION COUNTY TOTAL SHEETS NO.

VAR. 2020-191-RS COOK | LAKE 29 26

TC-16 CONTRACT NO. 62M65

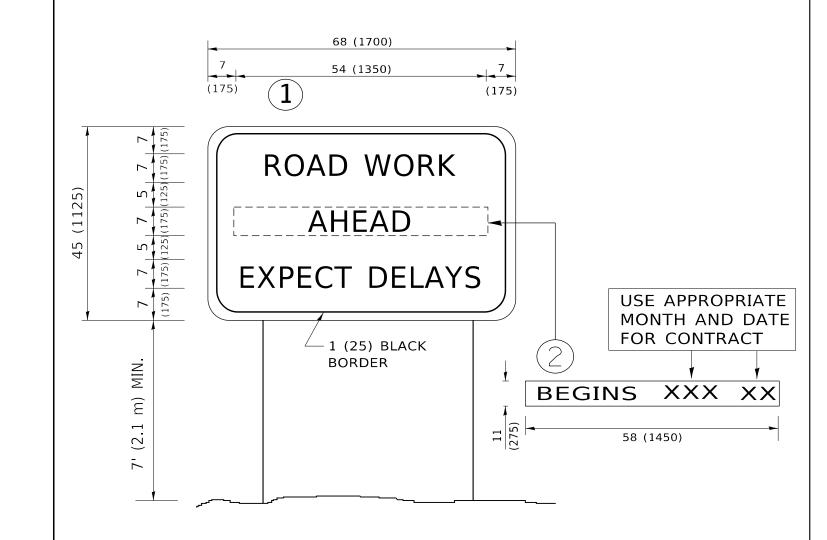

# NOTES:

- 1. USE BLACK LETTERING ON ORANGE BACKGROUND.
- 2. ERECT SIGNS IN ADVANCE OF THE LOCATION FOR THE "ROAD CONSTRUCTION AHEAD" SIGN AT LOCATIONS AS DIRECTED BY THE ENGINEER.
- 3. ERECT SIGN 1 WITH INSTALLED PANEL 2 ONE WEEK PRIOR TO THE START OF CONSTRUCTION.
- 4. REMOVE PANEL(2)SOON AFTER THE START OF CONSTRUCTION.
- 5. SEE SPECIAL PROVISION FOR "TEMPORARY INFORMATION SIGNING" FOR ADDITIONAL INFORMATION.
- 6. ONE SIGN ASSEMBLY EQUALS 25.70 SQ. FT. (2.3 SQ. M.)

SCALE: NONE

7. SHALL BE PAID FOR AS TEMPORARY INFORMATION SIGNING.

ALL DIMENSIONS ARE IN INCHES (MILLIMETERS) UNLESS OTHERWISE SHOWN.

USER NAME = mohammad.hamwi	DESIGNED -	REVISED	-	R. MIRS 09-15-97
	DRAWN -	REVISED	-	R. MIRS 12-11-97
PLOT SCALE = 100.0000 / in.	CHECKED -	REVISED	- T.	RAMMACHER 02-02-99
PLOT DATE = 12/15/2022	DATE -	REVISED	-	C. JUCIUS 01-31-07

STATE (	OF ILLINOIS
DEPARTMENT O	TRANSPORTATION

ARTERIAL ROAD				F.A.U RTE	SECTION		
	INFOR	VIATION SIGN		VAR.	2020-191-RS		
IN OUNTION SIGN					TC-22		
1	OF 1	SHEETS STA.	TO STA.		ILLINOIS F	FED.	

| NO. | NO.

