STATE OF ILLINOIS

DEPARTMENT OF TRANSPORTATION

FOR INDEX OF SHEETS, SEE SHEET NO. 2

TRAFFIC DATA

IL RTE 50:

2019 ADT = 31,200 - 35,900SPEED LIMIT = 35 MPH

MIDLOTHIAN TPKE:

2018 ADT = 14,000 - 14,300SPEED LIMIT = 35-40 MPH

135TH ST:

2018 ADT = 9.550 - 18.200SPEED LIMIT = 35 MPH


CAL SAG RD:

2018 ADT = 12,900SPEED LIMIT = 35 MPH

FUNCTIONAL CLASSIFICATION

IL RTE 50: PRINCIPAL ARTERIAL MIDLOTHIAN TPKE: MINOR ARTERIAL 135TH ST: MAJOR COLLECTOR CAL SAG RD: MINOR ARTERIAL (W OF IL 50) CAL SAG RD: MAJOR COLLECTOR (E OF IL 50)

THE PROJECT IS LOCATED IN THE VILLAGE OF CRESTWOOD

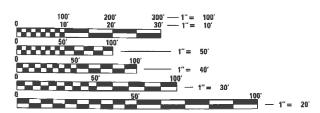

ENGINEERING SCALES. REDUCED SIZED PLANS WILL NOT CONFORM TO STANDARD SCALES. IN MAKING MEASUREMENTS ON REDUCED PLANS, THE ABOVE SCALES MAY BE USED.

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JOINT UTILITY LOCATION INFORMATION FOR EXCAVATORS 1-800-892-0123 OR 811


PROJECT ENGINEER: LUKASZ POCIECHA (847) 705–4255 PROJECT MANAGER: FAWAD AQUEEL (847) 705-4211

CONTRACT NO. 62N85

PROPOSED HIGHWAY PLANS

FAP ROUTE 350: IL 50 /IL 83 (CICERO AVE) AT MIDLOTHIAN TURNPIKE, 135TH STREET, AND CAL SAG ROAD **SECTION: 2021–054–N&SW PROJECT NO: HSIP-GPU8(675)** INTERSECTION IMPROVEMENTS, TRAFFIC SIGNAL **MODERNIZATION, AND ADA IMPROVEMENTS COOK COUNTY**

C-91-158-21

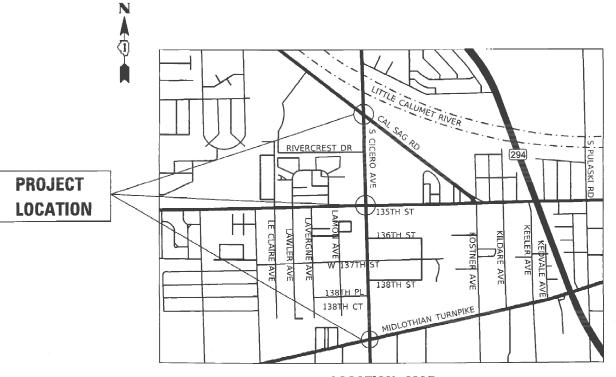

LOCATION MAP NOT TO SCALE

GROSS LENGTH = 5,808.00 FT. = 1.1 MILE NET LENGTH = 5,808.00 FT. = 1.1 MILE





Date: 12/05/2022 License Expires: 11/30/2023 The seal shown above is valid for Sheets 1-55, 62.86 & 153-167.



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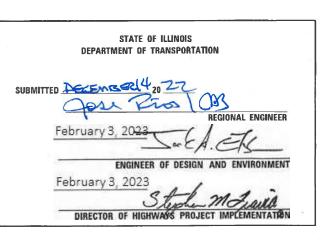
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12/06/2022 License Expires: 11/30/2023 The seal shown above is valid for Sheets 56-61 & 87-115.

D-91-135-21





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SUGGESTED MAINTENANCE OF TRAFFIC TYPICAL SECTIONS

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CROSS SECTIONS

DISTRICT ONE DETAILS

RD-02 DRIV	EWAY DETAIL	- DISTANCE	BTWN ROW	& FACE	OF CURB >= 15'

BD-22	PAVEMENT	PATCHING	FOR	HΜΔ	SURFACED	PAVEMENT

BD-24 CURB OR CURB & GUTTER REMOVAL AND REPLACEMENT

BD-36 FIRE HYDRANT TO BE MOVED

TC-10 TRAFFIC CONTROL & PROTECTION FOR SIDEROADS, INTERSECTIONS & DRIVEWAYS

TC-11 RAISED REFLECTIVE PAVEMENT MARKERS (SNOW PLOW RESISTANT)

TC-13 DISTRICT ONE TYPICAL PAVEMENT MARKINGS

TC-14 TRAFFIC CONTROL & PROTECTION AT TURN BAYS

TC-16 SHORT TERM PAVEMENT MARKING LETTERS AND SYMBOLS

701701-10 URBAN LANE CLOSURE MULTILANE INTERSECTION 701801-06 SIDEWALK, CORNER OR CROSSWALK CLOSURE

TRAFFIC CONTROL DEVICES 720001-01 SIGN PANEL MOUNTING DETAILS

TC-22 ARTERIAL ROAD INFORMATION SIGN

TC-26 DRIVEWAY ENTRANCE SIGNING **HIGHWAY STANDARDS**

000001-08	STANDARD SYMBOLS, ABBREVIATIONS AND PATTERNS
001006	DECIMAL OF AN INCH AND OF A FOOT
280001-07	TEMPORARY EROSION CONTROL SYSTEMS
424001-11	PERPENDICULAR CURB RAMPS FOR SIDEWALKS
424011-04	CORNER PARALLEL CURB RAMPS FOR SIDEWALKS
424031-02	MEDIAN PEDESTRIAN CROSSINGS
442201-03	CLASS C AND D PATCHES
602301-04	INLET - TYPE A
604001-05	FRAME AND LIDS TYPE 1
604091-05	FRAME AND GRATE TYPE 24
606001-08	CONCRETE CURB TYPE B AND COMBINATION CONCRETE CURB & GUTTER
606301-04	PC CONCRETE ISLANDS AND MEDIANS
701101-05	OFF-ROAD OPERATIONS, MULTI-LN, 15 FT. (4.5 m) TO 24 IN. (600 mm)
701427 - 05	LN CLOSURE, MULTI-LN, INTERMITTENT OR MOVING OPER <= 40 MPH
701601-09	URBAN LN CLOSURE, MULTI-LN, 1W OR 2W W/ NON-TRAVERSABLE MEDIAN
701606-10	URBAN SINGLE LN CLOSURE, MULTI-LN, 2W W/ MOUNTABLE MEDIAN

HIGHWAY STANDARDS (CONT'D)

1200	700 - 04	21014 17	WINEL LI	IVECT	ION DE	IAILS			
7200	11-01	METAL	POSTS	FOR	SIGNS,	MARKERS	& D	ELINEA ⁻	TORS

720011-01	METAL POSTS FOR SIGNS, MARKERS & DELINEATORS
729001 01	TELESCODING STEEL SIGN SHIPPORT

/20001-01	TELESCOPING STEEL SIGN SUPPORT
729001-01	APPLICATIONS OF TYPES A & B METAL POSTS (FOR SIGNS & MARKERS)

780001-05 TYPICAL PAVEMENT MARKINGS

720006 04 SIGN DANIEL EDECTION DETAILS

781001-04 TYPICAL APPLICATIONS RAISED REFLECTIVE PAVEMENT MARKERS

GENERAL NOTES

- 1. BEFORE STARTING ANY EXCAVATION, THE CONTRACTOR SHALL CALL "J.U.L.I.E." AT (800) 892-0123 OR 811 FOR FIELD LOCATIONS OF BURIED ELECTRIC, TELEPHONE AND GAS UTILITIES, 48 HOURS NOTIFICATION IS REQUIRED.
- 2. THE CONTRACTOR SHALL COORDINATE CONSTRUCTION ACTIVITIES WITH UTILITY COMPANIES AND WITH LOCAL EMERGENCY SERVICES AND THE VILLAGE OF CRESTWOOD
- 3. THE CONTRACTOR WILL NOT BE ALLOWED TO SET UP A YARD OR FIELD OFFICE ON STATE OR VILLAGE PROPERTY WITHOUT WRITTEN PERMISSION FROM THE DEPARTMENT.
- 4. THE CONTRACTOR SHALL CONTACT THE TRAFFIC CONTROL SUPERVISOR AT KALPANA.KANNAN-HOSADURGA@ILLINOIS.GOV A MINIMUM OF 72 HOURS IN ADVANCE OF BEGINNING ANY WORK.
- 5. THE LOCATIONS OF EXISTING UTILITIES SHOWN ON THE PLANS ARE FOR INFORMATIONAL PURPOSES ONLY AND ARE BASED ON FIELD INVESTIGATIONS AND THE BEST INFORMATION AVAILABLE. IT SHALL BE THE CONTRACTOR'S RESPONSIBILITY TO ASCERTAIN THEIR EXACT LOCATIONS FROM THE UTILITY COMPANIES AND BY FIELD INSPECTION.
- 6. DO NOT SCALE PLANS FOR CONSTRUCTION DIMENSIONS.
- 7. THE DEPARTMENT HAS NOT OBTAINED ANY PERMITS FOR OFFSITE BORROW OR WASTE/USE (BWU) AREAS. PRIOR TO WORKING IN BWU AREAS, IF THE CONTRACTOR CHOOSES TO USE ACTIVITIES REQUIRING PERMITS IT IS THE CONTRACTOR'S RESPONSIBILITY TO SECURE THE PROPER PERMITS. IN ADDITION TO THE BORROW REVIEW (BDE 2289) AND USE/WASTE REVIEW (BDE 2290) SUBMITTALS, THE CONTRACTOR WILL NEED TO SUBMIT AN EROSION AND SEDIMENT CONTROL (ESC) PLAN FOR EVERY BWU SITE TO THE DEPARTMENT FOR ACCEPTANCE. GUIDELINES FOR ACCEPTABLE BWU PRACTICES CAN BE FOUND IN SECTION II.G.1 AND 2 OF THE SWPPP. THE COST OF ALL MATERIALS AND LABOR NECESSARY TO COMPLY WITH THE ABOVE PROVISIONS TO PREPARE AND IMPLEMENT ESC PLANS WILL NOT BE PAID FOR SEPARATELY, BUT SHALL BE CONSIDERED AS INCLUDED IN THE UNIT BID PRICES OF THE CONTRACT AND NO ADDITIONAL COMPENSATION WILL BE ALLOWED.
- 8. THE CONTRACTOR SHALL PROTECT EXISTING AND NEW UTILITIES AND SHALL BRACE AND SUPPORT THE UTILITIES PROPERLY IN ORDER TO PREVENT SETTLEMENT, DISPLACEMENT, OR DAMAGE TO THE UTILITIES. THE PROTECTION OF THE UTILITIES AS SPECIFIED HEREIN WILL NOT BE PAID FOR SEPARATELY, BUT SHALL BE CONSIDERED INCLUDED IN THE CONTRACT
- 9. EXISTING MAILBOXES AFFECTED BY CONSTRUCTION SHALL BE RELOCATED AS DIRECTED BY THE LOCAL POSTAL AUTHORITY AND THE ENGINEER. THIS WORK WILL NOT BE PAID FOR SEPARATELY BUT SHALL BE CONSIDERED INCIDENTAL TO THE CONTRACT.
- 10. THE CONTRACTOR SHALL TAKE CARE IN REMOVING OR EXCAVATING NEAR ALL EXISTING ITEMS WHICH WILL REMAIN. ANY DAMAGE DONE TO EXISTING ITEMS BY THE CONTRACTOR SHALL BE REPAIRED AT THE CONTRACTOR'S EXPENSE.
- 11. THE CONTRACTOR SHALL OBTAIN ALL NECESSARY PERMITS, AS REQUIRED, PRIOR TO COMMENCING WITH CONSTRUCTION. ANY COST ASSOCIATED WITH OBTAINING THESE PERMITS SHALL BE CONSIDERED INCLUDED IN THE CONTRACT UNIT PRICE FOR THE ITEMS
- 12. POLLUTION CONTROL: THE CONTRACTOR SHALL BE REQUIRED TO COMPLY WITH STATE REGULATIONS REGARDING AIR, WATER, AND NOISE POLLUTION. THIS WORK WILL NOT BE PAID FOR SEPARATELY BUT SHALL BE CONSIDERED INCLUDED IN THE COST OF THE
- 13. THE CONTRACTOR IS RESPONSIBLE FOR MAINTAINING DRAINAGE THROUGHOUT THE CONSTRUCTION OF THIS PROJECT. THIS WORK WILL NOT BE PAID FOR SEPARATELY BUT SHALL BE CONSIDERED INCLUDED IN THE COST OF THE CONTRACT.
- 14. NO WORK SHALL COMMENCE UNTIL TRAFFIC CONTROL REQUIREMENTS ARE MET.
- 15. THE COST OF SAW CUTTING, (FULL DEPTH) SHALL BE INCLUDED IN THE UNIT PRICES FOR
- 16. THE CONTRACTOR SHALL DETERMINE WHEN FLAT SLAB TOPS ARE REQUIRED ON INLETS, MANHOLES, AND CATCH BASINS. NO ADDITIONAL COMPENSATION SHALL BE ALLOWED FOR THE USE OF FLAT SLAB TOPS AND IT SHALL BE CONSIDERED INCLUDED IN THE COST OF THE
- 17. ALL ABANDONED SEWER INVERTS SHALL BE PLUGGED WITH BRICK AND CLASS SI CONCRETE TO THE SATISFACTION OF THE ENGINEER. THIS WORK SHALL BE INCLUDED IN THE COST OF
- 18. THE CONNECTION OF EXISTING STORM SEWER INTO PROPOSED DRAINAGE STRUCTURES AND ANY CONCRETE COLLARS SHALL BE INCLUDED IN THE COST OF THE DRAINAGE STRUCTURE. ANY ADDITIONAL STORM SEWER PIPE REQUIRED TO MAKE THE CONNECTION SHALL BE THE SAME SIZE AND MATERIAL TYPE AS THE EXISTING STORM SEWER AND SHALL BE INCLUDED IN THE COST OF THE DRAINAGE STRUCTURE.
- 19. THE CONNECTION OF PROPOSED STORM SEWER TO EXISTING STORM SEWER OR DRAINAGE STRUCTURES SHALL BE INCLUDED THE COST OF THE PROPOSED STORM SEWER BEING
- 20. THE COST OF MAKING UNDERDRAIN CONNECTIONS TO DRAINAGE STRUCTURES SHALL BE INCLUDED IN THE COST OF THE PROPOSED UNDERDRAIN.

- 21. 10 FOOT TRANSITIONS SHALL BE USED TO MATCH PROPOSED CURB & GUTTER AND MEDIANS TO THE EXISTING CURB & GUTTER AND MEDIANS IN THE FIELD UNLESS OTHERWISE SHOWN. THE TRANSITION SHALL BE CONSIDERED INCLUDED IN THE COST OF THE ITEM(S) OF WORK.
- 22. SIDE CURB FOR SIDEWALKS SHALL BE CONSIDERED INCLUDED IN THE COST OF PORTLAND CEMENT CONCRETE SIDEWALK, 5" AND WILL NOT BE PAID FOR SEPARATELY.
- 23. ALL WORK INVOLVING SIGNS SHALL BE GOVERNED BY THE FOLLOWING AND IN ACCORDANCE
 - a. SIGNS SHALL NOT BE MOVED UNTIL PROGRESS OF WORK NECESSITATES IT.
 - b. EVERY SIGN REMOVED MUST BE RE-ERECTED AT A TEMPORARY LOCATION AND BE VISIBLE TO TRAFFIC FOR WHICH IT IS NEEDED. ALL SUCH SIGNS MUST BE MAINTAINED STRAIGHT AND CLEAN FOR THE DURATION OF THE TEMPORARY SETTING.
 - C ALL SIGNS SHALL BE RE-ERECTED IN PERMANENT LOCATIONS AS THE ROADWAY IS COMPLETED. HORIZONTAL LOCATION FROM THE EDGE OF PAVEMENT SHALL BE AS DIRECTED BY THE ENGINEER
 - d. ALL UNUSED SIGNS WILL BE RETURNED TO IDOT.
 - e. LONGER POSTS MAY BE REQUIRED AT SOME TEMPORARY OR PERMANENT SIGN LOCATIONS TO MAINTAIN PROPER SIGN ELEVATIONS. THE COST SHALL BE INCLUDED IN THE UNIT BID PRICES OF THE CONTRACT ACCORDING TO ARTICLE 107.25 OF THE STANDARD SPECIFICATIONS
- 24. WHEN CONSTRUCTING SIDEWALK RAMPS FOR THE HANDICAPPED, STATE STANDARDS LISTED IN THE HIGHWAY STANDARD INDEX SHALL APPLY.
- 25. THE RESIDENT ENGINEER SHALL CONTACT AREA TRAFFIC FIELD TECHNICIAN PATRICE HARRIS AT PATRICE.HARRIS@ILLINOIS.GOV A MINIMUM OF 2 WEEKS PRIOR TO PLACEMENT OF PERMANENT PAVEMENT MARKINGS.
- 26. ALL STORM SEWER CONNECTIONS WITH PIPES 2' DIAMETER AND SMALLER SHALL BE MADE WITH PRECAST "TEE" OR "WYE" PIPES, THIS WORK WILL NOT BE PAID FOR SEPARATELY, BUT SHALL BE INCLUDED IN THE COST FOR PROPOSED STORM SEWERS.
- 27. IF NECESSARY, THE REMOVAL OF TEMPORARY PIPE CULVERTS, TEMPORARY STORM SEWER, AND TEMPORARY STRUCTURES SHALL BE CONSIDERED INCLUDED IN THE COST OF THEIR RESPECTIVE PAY ITEMS.
- 28. EXISTING STORM SEWER LATERALS FOUND DURING CONSTRUCTION AND NOT SHOWN ON THE PLANS SHALL BE CONNECTED TO THE PROPOSED STORM SEWER SYSTEM AT NO ADDITIONAL COST TO THE CONTRACT.
- 29. THE AGGREGATE GRADATION FOR THE AGGREGATE SUBGRADE IMPROVEMENT 12" LOWER LIFT SHALL BE CS 1 OR RR 1.
- 30 ANY AGGREGATE SUBGRADE DAMAGED BY THE CONTRACTOR'S VEHICLE AND/OR FOUIPMENT TO BE REMOVED AND REPLACED AS DIRECTED BY THE ENGINEER AT THE CONTRACTOR'S
- 31. THE SUBGRADE STABILITY SHALL BE VERIFIED BY PROOF ROLLING WITH A FULLY LOADED TANDEM-AXLE TRUCK.
- 32. GEOTECHNICAL FABRIC FOR GROUND STABILIZATION AND/OR AGGREGATE SUBGRADE IMPROVEMENT (CU YD) HAVE BEEN PROVIDED FOR USE AT THE LOCATIONS INDICATED FOR SOILS THAT TEND TO BE UNSTABLE AND/OR UNSUITABLE. THE ACTUAL NEED FOR REMOVAL AND REPLACEMENT WITH ABOVE ITEM(S) WILL BE DETERMINED IN THE FIELD AT THE TIME OF CONSTRUCTION BY THE GEOTECHNICAL ENGINEER. ALL POTENTIALLY UNSTABLE SOILS SHOULD BE TESTED WITH A STATIC OR DYNAMIC CONE PENETROMETER AND TREATED IN ACCORDANCE WITH ARTICLE 301.04 OF THE SSRBC AND IDOT SUBGRADE STABILITY MANUAL. IF UNSTABLE AND/OR UNSUITABLE SOILS ARE NOT ENCOUNTERED, THEN THE QUANTITY SHALL BE DEDUCTED AND NO ADDITIONAL COMPENSATION WILL BE DUE TO THE
- 33. IF ANY EXISTING PAVEMENT MARKING AND/OR SIGNING ALONG COOK COUNTY ROADWAYS IS DAMAGED DUE TO CONSTRUCTION OF PROPOSED IMPROVEMENTS, THE CONTRACTOR SHALL REPLACE THE DAMAGED TRAFFIC CONTROL DEVICES TO THE SATISFACTION OF COOK COUNTY PER IDOT AND IDOT DISTRICT 1 STANDARDS FOR TRAFFIC CONTROL DEVICES, DAMESTIA MARKING AND SIGNACE INCLUDED IN THE BLANK. PAVEMENT MARKING, AND SIGNAGE INCLUDED IN THE PLANS.
- 34. BEFORE BEGINNING ANY WORK, THE CONTRACTOR SHALL RETAIN AND RECORD FOR FUTURE REFERENCE ALL EXISTING PAVEMENT MARKING LINES (AND RAISED REFLECTIVE PAVEMENT MARKERS) IN ORDER THAT THESE LOCATIONS CAN BE RE-ESTABLISHED FOR STRIPING. EXACT LOCATIONS OF ALL PAVEMENT MARKINGS SHALL BE AS SHOWN ON THE PLANS OR AS DIRECTED BY THE ENGINEER.
- 35. THE CONTRACTOR SHALL COORDINATE WITH PACE REGARDING BUS PAD CONSTRUCTION AND SHELTER INSTALLATION. THE CONTRACTOR SHALL ALSO COORDINATE WITH PACE TO ENSURE THERE ARE SAFE PASSAGES TO EXISTING AND/OR TEMPORARY BUS STOP LOCATIONS THROUGHOUT CONSTRUCTION, THE COST OF WHICH SHALL BE INCLUDED IN PAY
- 36. ALL RED LIGHT RUNNING CAMERAS AT LOCATIONS SHOWN ON THE PLANS, AND EQUIPMENT INCLUDING ELECTRICAL AND DATA CONNECTIONS, MUST BE REMOVED BY THE VILLAGE OF CRESTWOOD PRIOR TO THE START OF CONSTRUCTION. THE CONTRACTOR SHALL COORDINATE THIS REMOVAL WITH THE VILLAGE OF CRESTWOOD, 708-371-4800.

DIA Inc
BLA, Inc. ITASCA, ILLINOIS

701901-08

USER NAME = WTeng	DESIGNED - WT	REVISED -
	DRAWN -	REVISED -
PLOT SCALE = 20.0000 / in.	CHECKED - JPO	REVISED -
PLOT DATE = 12/8/2022	DATE - 12/05/2022	REVISED -

SCALE: N.T.S.

SHEET 1

						CONSTRUCTION	CODE		
		URBAN	90% FED 10% STATE	90% FED 10% STATE	90% FED 7.5% STATE 2.5% CRESTWOOD	90% FED 5% STATE 5% CRESTWOOD	90% FED 10% STATE	100% CRESTWOOD	100% CRESTWOOD
CODE NO.	ITEM UNI	TOTAL	ROADWAY 0004	TRAFFIC SIGNALS 0021 IL50 & MIDLOTHIAN	TRAFFIC SIGNALS 0021 IL50 & 135th ST	TRAFFIC SIGNALS 0021 IL50 & CAL SAG RD	INTERCONNECT 0021	EVP 0021	UTILITY RELOCATION 0043
20200100	EARTH EXCAVATION CU \	D 1547	1547						
20201200	REMOVAL AND DISPOSAL OF UNSUITABLE MATERIAL CU	D 310	310						
20800150	TRENCH BACKFILL CU	D 8	6						2
21001000	GEOTECHNICAL FABRIC FOR GROUND STABILIZATION SQ \	D 92	92						
21101505	TOPSOIL EXCAVATION AND PLACEMENT CU	D 38	38						
21101615	TOPSOIL FURNISH AND PLACE, 4" SQ \	D 818	818						
25000400	NITROGEN FERTILIZER NUTRIENT POUL	ID 12	12						
25000500	PHOSPHORUS FERTILIZER NUTRIENT POUL	ID 12	12						
25000600	POTASSIUM FERTILIZER NUTRIENT POUI	ID 12	12						
25200110	SODDING, SALT TOLERANT SQ \	D 1000	1000						
25200200	SUPPLEMENTAL WATERING UNI	50	50						
28000250	TEMPORARY EROSION CONTROL SEEDING POU	ID 63	63						
28000400	PERIMETER EROSION BARRIER FOO	571	571						
28000510	INLET FILTERS EAC	Н 86	86						



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PLOT SCALE = 20.0000 / in.	CHECKED	-	JPO	REVISED	-
PLOT DATE = 12/5/2022	DATE	-	12/05/2022	REVISED	-

	SI	JMMARY	OF QU	ANTITIES	3	F.A.P RTE	SECTION	COUNTY	TOTAL SHEETS	SHEET NO.
		II 50 /	CICERO	AVE)		350	2021-054-N&SW	соок	167	3
		IL 30 (OIOLIIO	AVL				CONTRACT	NO. 62	2N85
SCALE: N.T.S.	SHEET 1	OF 11	SHEETS	STA.	TO STA.		ILLINOIS FED. A	ID PROJECT		

							CONSTRUCTION	CODE			
			URBAN	90% FED 10% STATE	90% FED 10% STATE	90% FED 7.5% STATE 2.5% CRESTWOOD	90% FED 5% STATE 5% CRESTWOOD	90% FED 10% STATE	100% CRESTWOOD	100% CRESTWOOD	
CODE NO.	ITEM	UNIT	TOTAL QUANTITY	ROADWAY 0004	TRAFFIC SIGNALS 0021 IL50 & MIDLOTHIAN	TRAFFIC SIGNALS 0021 IL50 & 135th ST	TRAFFIC SIGNALS 0021 IL50 & CAL SAG RD	INTERCONNECT 0021	EVP 0021	UTILITY RELOCATION 0043	
30300001	AGGREGATE SUBGRADE IMPROVEMENT	CU YD	31	31							
30300112	AGGREGATE SUBGRADE IMPROVEMENT 12"	SQ YD	3242	3242							
31101200	SUBBASE GRANULAR MATERIAL, TYPE B 4"	SQ YD	903	903							
35300500	PORTLAND CEMENT CONCRETE BASE COURSE 10"	SQ YD	964	964							
35400500	PORTLAND CEMENT CONCRETE BASE COURSE WIDENING 10"	SQ YD	36	36							
40600290	BITUMINOUS MATERIALS (TACK COAT)	POUND	450	450							
40604062	HOT-MIX ASPHALT SURFACE COURSE, IL-9.5, MIX "D", N70	TON	168	168							
42000501	PORTLAND CEMENT CONCRETE PAVEMENT 10" (JOINTED)	SQ YD	1016	1016							
42001300	PROTECTIVE COAT	SQ YD	5989	5989							
42300400	PORTLAND CEMENT CONCRETE DRIVEWAY PAVEMENT, 8 INCH	SQ YD	105	105							
42400200	PORTLAND CEMENT CONCRETE SIDEWALK 5 INCH	SQ FT	8129	8129							
42400800	DETECTABLE WARNINGS	SQ FT	305	305							
44000100	PAVEMENT REMOVAL	SQ YD	1251	1251							
44000200	DRIVEWAY PAVEMENT REMOVAL	SQ YD	139	139							



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		su	JMMARY	OF QU	ANTITIES		F.A.P RTE	SEC ⁻	ПОИ		COUNTY	TOTAL SHEETS	SHEET NO.
ı			IL 50 (CICEBO	AVE)		350	2021-05	4-N&SW		СООК	167	4
ı			IF 30 (OIOLNO	AVL)						CONTRACT	NO. 62	2N85
ı	SCALE: N.T.S.	SHEET 2	OF 11	SHEETS	STA.	TO STA.			ILLINOIS	FED. AI	D PROJECT		

							CONSTRUCTION	CODE			
			URBAN	90% FED 10% STATE	90% FED 10% STATE	90% FED 7.5% STATE 2.5% CRESTWOOD	90% FED 5% STATE 5% CRESTWOOD	90% FED 10% STATE	100% CRESTWOOD	100% CRESTWOOD	
				ROADWAY	TRAFFIC SIGNALS	TRAFFIC SIGNALS	TRAFFIC SIGNALS	INTERCONNECT	EVP	UTILITY RELOCATION	
CODE	ITCA	LINIT	TOTAL	0004	0021	0021	0021	0021	0021	0043	
NO.	ITEM	UNIT	QUANTITY		IL50 & MIDLOTHIAN	IL50 & 135th ST	IL50 & CAL SAG RD				
44000500	COMBINATION CURB AND GUTTER REMOVAL	FOOT	1077	1077							
44000600	SIDEWALK REMOVAL	SQ FT	4541	4541							
44007100	MEDIAN DEMOVAL	60.57	17575	17575							
44003100	MEDIAN REMOVAL	SQ FT	17575	17575							
550A0050	STORM SEWERS, CLASS A, TYPE 1 12"	FOOT	16	16							
56400400	FIRE HYDRANTS TO BE RELOCATED	EACH	1							1	
56500600	DOMESTIC WATER SERVICE BOXES TO BE ADJUSTED	EACH	1							1	
60108204	PIPE UNDERDRAINS, TYPE 2, 4"	FOOT	250	250							
00100204	THE ONDERDRANG, THE 2, 4	1001	230	250							
60237470	INLETS, TYPE A, TYPE 24 FRAME AND GRATE	EACH	2	2							
60250500	CATCH BASINS TO BE ADJUSTED WITH NEW TYPE 1 FRAME, CLOSED LID	EACH	4	4							
60260400	INLETS TO BE ADJUSTED WITH NEW TYPE 1 FRAME, CLOSED LID	EACH	4	4							
00200400	INCETS TO BE ADJUSTED WITH NEW TIPE I PRAME, CLOSED LID	LACH	4	4							
60300105	FRAMES AND GRATES TO BE ADJUSTED	EACH	4	4							
		1									
60300305	FRAMES AND LIDS TO BE ADJUSTED	EACH	11	11							
60603800	COMBINATION CONCRETE CURB AND GUTTER, TYPE B-6.12	FOOT	88	88							
00003600	COMBINATION CONCRETE CORD AND GOTTER, TIFE D-0.12	1001	00	00							
60605000	COMBINATION CONCRETE CURB AND GUTTER, TYPE B-6.24	FOOT	740	740							
		1									
		1									
60618300	CONCRETE MEDIAN SURFACE, 4 INCH	SQ FT	97	97							
30010300	CONCRETE MEDIAN SONIACE, 4 INCH	3011	3,	J , ,							



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PLOT SCALE = 20.0000 / in.	CHECKED	-	JPO	REVISED	-
PLOT DATE = 12/9/2022	DATE	-	12/05/2022	REVISED	-

STATI	E 01	F ILLINOIS
DEPARTMENT	0F	TRANSPORTATION

	SI	JMMARY OI	QUA	ANTITIES		F.A.P RTE	SECTION	COUNTY	TOTAL SHEETS	SHEET NO.
		IL 50 (CIC	FR∩	AVE)		350	2021-054-N&SW	соок	167	5
		IL 30 (010	LIIO	AVL,				CONTRACT	T NO. 63	2N85
SCALE: N.T.S.	SHEET 3	OF 11 SH	HEETS	STA.	TO STA.		ILLINOIS FED. A	AID PROJECT		

				CONSTRUCTION CODE							
			URBAN	90% FED 10% STATE	90% FED 10% STATE	90% FED 7.5% STATE 2.5% CRESTWOOD	90% FED 5% STATE 5% CRESTWOOD	90% FED 10% STATE	100% CRESTWOOD	100% CRESTWOOD	
				ROADWAY	TRAFFIC SIGNALS	TRAFFIC SIGNALS	TRAFFIC SIGNALS	INTERCONNECT	EVP	UTILITY RELOCATION	
CODE	TTENA	LINITT	TOTAL	0004	0021	0021	0021	0021	0021	0043	
NO.	ITEM	UNIT	QUANTITY		IL50 & MIDLOTHIAN	IL50 & 135th ST	IL50 & CAL SAG RD				
60618730	CONCRETE MEDIAN, TYPE M-2.06	SQ FT	5763	5763							6.
		6-								1	
60622400	CONCRETE MEDIAN, TYPE SM-6.06	SQ FT	5010	5010							
C.		i-		1				l .			
66900200	NON-SPECIAL WASTE DISPOSAL	CU YD	1065	1065							
66000530	CON DISPOSAL ANALYSIS	FACU						ļ 			
66900530	SOIL DISPOSAL ANALYSIS	EACH	6	6							
66901001	REGULATED SUBSTANCES PRE-CONSTRUCTION PLAN	L SUM	1	1							
00301001	REGOLVED SODSTANCES THE CONSTRUCTION TEXAS	2 3014	1	<u> </u>				<u> </u>	-		
J.											
66901003	REGULATED SUBSTANCES FINAL CONSTRUCTION REPORT	L SUM	1	1							
it.		i i	1					1			
66901005	ENGINEERED BARRIER	SQ YD	340	340							
			Í								
66901006	REGULATED SUBSTANCES MONITORING	CAL DA	30	30							
		N-1									
67100100	MORUTATION	1.61114	1 .					1		<u> </u>	
67100100	MOBILIZATION	L SUM	1	1							
70103815	TRAFFIC CONTROL SURVEILLANCE	CAL DA	40	40							
70103013	The Control Solve Lee and L	CAL BA	1	10					14 0		
			į.								
70107025	CHANGEABLE MESSAGE SIGN	CAL DA	360	360							
				1							
70300150	SHORT TERM PAVEMENT MARKING REMOVAL	SQ FT	2826	2826							
70307100	TEMPORARY PAVEMENT MARKING LETTERS AND SYMBOLS - TYPE IV TAPE	SQ FT	586	586							
70207120	TEMPORARY PAVEMENT MARKING - LINE 4" - TYPE IV TAPE	FOOT	2500	2500							
70307120	ILIVIFORAKI PAVEMENI MAKNING - LINE 4 - ITPE IV TAPE	FOOT	2580	2580							
70307130	TEMPORARY PAVEMENT MARKING - LINE 6" - TYPE IV TAPE	FOOT	2759	2759							
			1								



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0	PLOT DATE = 12/6/2022	DATE 12/05/2022	REVISED =

STATE (OF ILLINOIS
DEPARTMENT O	TRANSPORTATION

	SI	JMMA	RY OF QU	F.A.P RTE.	SECTION	COUNTY TOTAL SHEETS		SHEET NO.		
		11 50	(CICERO	AVE)		350	2021-054-N&SW	соок	167	6
A		IL J	(GIGEIIG	AVL)	f			CONTRACT	NO. 62	2N85
SCALE: N.T.S.	SHEET 4	OF	11 SHEETS	į.	ILLINOIS FED. AI	D PROJECT				

					CONSTRUCTION CODE								
				URBAN	90% FED 10% STATE	90% FED 10% STATE	90% FED 7.5% STATE 2.5% CRESTWOOD	90% FED 5% STATE 5% CRESTWOOD	90% FED 10% STATE	100% CRESTWOOD	100% CRESTWOOD		
					ROADWAY	TRAFFIC SIGNALS	TRAFFIC SIGNALS	TRAFFIC SIGNALS	INTERCONNECT	EVP	UTILITY RELOCATION		
	CODE			TOTAL	0004	0021	0021	0021	0021	0021	0043		
	NO.	ITEM	UNIT	QUANTITY		IL50 & MIDLOTHIAN	IL50 & 135th ST	IL50 & CAL SAG RD					
*	72000100	SIGN PANEL - TYPE 1	SQ FT	50	23		12	15					
*	72000200	SIGN PANEL - TYPE 2	SQ FT	117		52	32.5	32.5					
*	72400200	REMOVE SIGN PANEL ASSEMBLY - TYPE B	EACH	5	5								
	72133233	THE STATE STATE ASSETTING THE D	2,1011										
*	72400310	REMOVE SIGN PANEL - TYPE 1	SQ FT	208	208								
т	72400310	REMOVE SIGN PANEL - TIPE I	SQ F1	206	206								
el.													
*	72400600	RELOCATE SIGN PANEL ASSEMBLY - TYPE B	EACH	5	5								
*	72400710	RELOCATE SIGN PANEL - TYPE 1	SQ FT	68	68								
*	72800100	TELESCOPING STEEL SIGN SUPPORT	FOOT	45	45								
*	72900100	METAL POST - TYPE A	FOOT	54	54								
*	78000100	THERMOPLASTIC PAVEMENT MARKING - LETTERS AND SYMBOLS	SQ FT	767	767								
*	78000200	THERMOPLASTIC PAVEMENT MARKING - LINE 4"	FOOT	12754	12754								
	, 3333200	THE WIST ENDING TWEETERS PARKING - LINE -	1	12/37	12/37								
*	70000400	THEDMODI ACTIC DAVIEMENT MADIZING LINE CIL	FOOT	4500	4502								
	78000400	THERMOPLASTIC PAVEMENT MARKING - LINE 6"	FOOT	4583	4583								
.1.			_	_									
*	78000500	THERMOPLASTIC PAVEMENT MARKING - LINE 8"	FOOT	37	37								
*	78000600	THERMOPLASTIC PAVEMENT MARKING - LINE 12"	FOOT	3284	3284								
*	78000650	THERMOPLASTIC PAVEMENT MARKING - LINE 24"	FOOT	609	609								
			<u></u>						<u></u>				

BLA, Inc. ITASCA, ILLINOIS

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PLOT DATE = 12/5/2022	DATE -	12/05/2022	REVISED	-

	SI	JMMARY	OF QU	F.A.P RTE	SECTION	COUNTY	TOTAL SHEETS	SHEET NO.		
		IL 50 (ricebu	AVE)		350	2021-054-N&SW	соок	167	7
		IL 30 (1	JOLINO	AVL				CONTRACT	NO. 62	2N85
SCALE: N.T.S.	SHEET 5	OF 11	SHEETS		ILLINOIS FED. A	ID PROJECT				

								CONSTRUCTION	CODE			
				URBAN	90% FED 10% STATE	90% FED 10% STATE	90% FED 7.5% STATE 2.5% CRESTWOOD	90% FED 5% STATE 5% CRESTWOOD	90% FED 10% STATE	100% CRESTWOOD	100% CRESTWOOD	
	CODE NO.	ITEM	UNIT	TOTAL QUANTITY	ROADWAY 0004	TRAFFIC SIGNALS 0021 IL50 & MIDLOTHIAN	TRAFFIC SIGNALS 0021 IL50 & 135th ST	TRAFFIC SIGNALS 0021 IL50 & CAL SAG RD	INTERCONNECT 0021	EVP 0021	UTILITY RELOCATION 0043	
*	78009000	MODIFIED URETHANE PAVEMENT MARKING - LETTERS AND SYMBOLS	SQ FT	329	329							
*	78009004	MODIFIED URETHANE PAVEMENT MARKING - LINE 4"	FOOT	8478	8478							
*	78009006	MODIFIED URETHANE PAVEMENT MARKING - LINE 6"	FOOT	3610	3610							
*	78009012	MODIFIED URETHANE PAVEMENT MARKING - LINE 12"	FOOT	220	220							
*	78100100	RAISED REFLECTIVE PAVEMENT MARKER	EACH	701	701							
	78300200	RAISED REFLECTIVE PAVEMENT MARKER REMOVAL	EACH	650	650							
	78300202	PAVEMENT MARKING REMOVAL - WATER BLASTING	SQ FT	17017	17017							
*	81028200	UNDERGROUND CONDUIT, GALVANIZED STEEL, 2" DIA.	FOOT	4683		1019	918	1259	1487			
*	81028220	UNDERGROUND CONDUIT, GALVANIZED STEEL, 3" DIA.	FOOT	560		144	116	300				
*	81028240	UNDERGROUND CONDUIT, GALVANIZED STEEL, 4" DIA.	FOOT	1849		540	586	631			92	
*	81400100	HANDHOLE	EACH	17		5	5	5			2	
*	81400200	HEAVY-DUTY HANDHOLE	EACH	6		2	2	2				
*	81400300	DOUBLE HANDHOLE	EACH	7		2	2	3				
	31,00300		2,1011	,								
*	81603090	UNIT DUCT, 600V, 3-1C NO.4, 1/C NO.6 GROUND, (XLP-TYPE USE), 1 1/4" DIA. POLYETHYLENE	FOOT	770							770	

BLA, Inc. ITASCA, ILLINOIS

STATE OF ILLINOIS
DEPARTMENT OF TRANSPORTATION

SUMMARY OF QUANTITIES IL 50 (CICERO AVE)											
SCALE: N.T.S.	SHEET 6	OF	11	SHEETS	STA.	TO STA.					

					CONSTRUCTION CODE									
				URBAN	90% FED 10% STATE	90% FED 10% STATE	90% FED 7.5% STATE 2.5% CRESTWOOD	90% FED 5% STATE 5% CRESTWOOD	90% FED 10% STATE	100% CRESTWOOD	100% CRESTWOOD			
	CODE NO.	ITEM	UNIT	TOTAL QUANTITY	ROADWAY 0004	TRAFFIC SIGNALS 0021 IL50 & MIDLOTHIAN	TRAFFIC SIGNALS 0021 IL50 & 135th ST	TRAFFIC SIGNALS 0021 IL50 & CAL SAG RD	INTERCONNECT 0021	EVP 0021	UTILITY RELOCATION 0043			
*	83600356	LIGHT POLE FOUNDATION, METAL, 15" BOLT CIRCLE, 8 5/8" X 6'	EACH	2							2			
*	83800205	BREAKAWAY DEVICE, TRANSFORMER BASE, 15 INCH BOLT CIRCLE	EACH	2							2			
*	84200804	REMOVAL OF POLE FOUNDATION	EACH	2							2			
*	84400105	RELOCATE EXISTING LIGHTING UNIT	EACH	2							2			
*	85000200	MAINTENANCE OF EXISTING TRAFFIC SIGNAL INSTALLATION	EACH	3					3					
*	86400100	TRANSCEIVER - FIBER OPTIC	EACH	3					3					
*	87300925	ELECTRIC CABLE IN CONDUIT, TRACER, NO. 14 1C	FOOT	7000					7000					
*	87301215	ELECTRIC CABLE IN CONDUIT, SIGNAL NO. 14 2C	FOOT	5676		1417	1572	2687						
*	87301225	ELECTRIC CABLE IN CONDUIT, SIGNAL NO. 14 3C	FOOT	7013		1860	1972	3181						
*	87301245	ELECTRIC CABLE IN CONDUIT, SIGNAL NO. 14 5C	FOOT	7118		2075	2372	2671						
-														
*	87301255	ELECTRIC CABLE IN CONDUIT, SIGNAL NO. 14 7C	FOOT	6736		2538	2129	2069						
*	87301305	ELECTRIC CABLE IN CONDUIT, LEAD-IN, NO. 14 1 PAIR	FOOT	6382		2123	2113	2146						
*	87301805	ELECTRIC CABLE IN CONDUIT, SERVICE, NO. 6 2 C	FOOT	1004		212	246	546						
*	87301900	ELECTRIC CABLE IN CONDUIT, EQUIPMENT GROUNDING CONDUCTOR, NO. 6 1C	FOOT	3046		791	873	1382						

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PLOT DATE = 12/5/2022	DATE	-	12/05/2022	REVISED	-

SCALE: N.T.S.

SUMMARY OF QUANTITIES	F.A.P RTE	SECTION	COUNTY	TOTAL SHEETS	SHEET NO.
IL 50 (CICERO AVE)	350	2021-054-N&SW	СООК	167	9
IL 30 (OIOLIIO AVL)			CONTRACT	NO. 62	2N85
SHEET 7 OF 11 SHEETS STA. TO STA.		ILLINOIS FED.	AID PROJECT		

				CONSTRUCTION CODE								
				URBAN	90% FED 10% STATE	90% FED 10% STATE	90% FED 7.5% STATE 2.5% CRESTWOOD	90% FED 5% STATE 5% CRESTWOOD	90% FED 10% STATE	100% CRESTWOOD	100% CRESTWOOD	
					ROADWAY	TRAFFIC SIGNALS	TRAFFIC SIGNALS	TRAFFIC SIGNALS	INTERCONNECT	EVP	UTILITY RELOCATION	
	CODE NO.	ITEM	UNIT	TOTAL QUANTITY	0004	0021 IL50 & MIDLOTHIAN	0021 IL50 & 135th ST	0021 IL50 & CAL SAG RD	0021	0021	0043	
	NO.	11 LIVI	ONIT	QUANTITI		ILJO & MIDLOTTIAN	1650 & 15501 51	ILJU & CAL JAG ND				
*	87502500	TRAFFIC SIGNAL POST, GALVANIZED STEEL 16 FT.	EACH	12		3	4	5				
*	87700110	STEEL MAST ARM ASSEMBLY AND POLE, 14 FT.	EACH	1		1						
	07700110	STEEL MAST ANN ASSEMBLY AND FOLE, 14 FT	LACIT	1		1						
*	87700210	STEEL MAST ARM ASSEMBLY AND POLE, 34 FT.	EACH	2		2						
*	87700220	STEEL MAST ARM ASSEMBLY AND POLE, 36 FT.	EACH	2				2				
·	87700220	STEEL MAST ANM ASSEMBLE AND POLE, 30 FT.	EACH	2				2				
*	87700230	STEEL MAST ARM ASSEMBLY AND POLE, 38 FT.	EACH	1		1						
*	07700250	CTEFL MACT ARM ACCEMPLY AND DOLE 42 FT	FACIL			2		1				
Tr.	87700250	STEEL MAST ARM ASSEMBLY AND POLE, 42 FT.	EACH	3		2		1				
*	87700260	STEEL MAST ARM ASSEMBLY AND POLE, 44 FT.	EACH	1			1					
*	07700070		51011									
T	87700270	STEEL MAST ARM ASSEMBLY AND POLE, 46 FT.	EACH	2			2					
*	87700280	STEEL MAST ARM ASSEMBLY AND POLE, 48 FT.	EACH	1				1				
sk				_			_					
*	87700290	STEEL MAST ARM ASSEMBLY AND POLE, 50 FT.	EACH	1			1					
*	87800100	CONCRETE FOUNDATION, TYPE A	FOOT	60		16	20	24				
4	070001-0	CONCESTS FOUNDATION TYPE O		1.5			_					
*	87800150	CONCRETE FOUNDATION, TYPE C	FOOT	12		4	4	4				
*	87800400	CONCRETE FOUNDATION, TYPE E 30-INCH DIAMETER	FOOT	50.5		50.5						
ىلە	070055			45-								
*	87800415	CONCRETE FOUNDATION, TYPE E 36-INCH DIAMETER	FOOT	120		13	54	53				
*	87900200	DRILL EXISTING HANDHOLE	EACH	5					5			
ı												
	* CDECIALTY ITI											



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PLOT DATE = 12/5/2022	DATE -	12/05/2022	REVISED -

	F.A.P RTE				COUNTY	TOTAL SHEETS	SHEET NO.				
	IL 50 (CICERO AVE)								соок	167	10
	IL JU	OICLIIC	AVL)						CONTRACT	NO. 63	2N85
SCALE: N.T.S. SHEET 8 OF 11 SHEETS STA. TO STA.							ILLINOIS	FED. AI	D PROJECT		

					CONSTRUCTION CODE							
				URBAN	90% FED 10% STATE	90% FED 10% STATE	90% FED 7.5% STATE 2.5% CRESTWOOD	90% FED 5% STATE 5% CRESTWOOD	90% FED 10% STATE	100% CRESTWOOD	100% CRESTWOOD	
					ROADWAY	TRAFFIC SIGNALS	TRAFFIC SIGNALS	TRAFFIC SIGNALS	INTERCONNECT	EVP	UTILITY RELOCATION	
	CODE NO.	ITEM	UNIT	TOTAL QUANTITY	0004	0021 IL50 & MIDLOTHIAN	0021 IL50 & 135th ST	0021 IL50 & CAL SAG RD	0021	0021	0043	
	INO.	11 🖂 🗸	UNIT	QUANTITY		IL30 & MIDLOTHIAN	120 & 133(11.31	ILSU & CAL SAG RD				
*	88030020	SIGNAL HEAD, LED, 1-FACE, 3-SECTION, MAST-ARM MOUNTED	EACH	20		7	7	6				
al.												
*	88030050	SIGNAL HEAD, LED, 1-FACE, 3-SECTION, BRACKET MOUNTED	EACH	7		1	3	3				
*	88030100	SIGNAL HEAD, LED, 1-FACE, 5-SECTION, BRACKET MOUNTED	EACH	17		5	5	7				
	00030100	3.01.1.2.1.2.1.3.2.2.3.3.2.2.1.0.1.7.1.1.1.2.2.2.2.2.2.2.2.2.2.2.2.2.2.2	2,7011	1,				,				
*	88030110	SIGNAL HEAD, LED, 1-FACE, 5-SECTION, MAST-ARM MOUNTED	EACH	18		7	5	6				
sk		PEDESTRIAN SIGNAL HEAD, LED, 1-FACE, BRACKET MOUNTED WITH				_	_					
*	88102717	COUNTDOWN TIMER	EACH	28		8	8	12				
*	88200410	TRAFFIC SIGNAL BACKPLATE, LOUVERED, FORMED PLASTIC	EACH	38		14	12	12				
*	88500100	INDUCTIVE LOOP DETECTOR	EACH	18		6	6	6				
*	20522122	DETECTOR LOOP TWO I	5007	10.12		252	220	200				
4	88600100	DETECTOR LOOP, TYPE I	FOOT	1043		353	330	360				
*	88700200	LIGHT DETECTOR	EACH	6						6		
*	88700300	LIGHT DETECTOR AMPLIFIER	EACH	3						3		
*	89000100	TEMPORARY TRAFFIC SIGNAL INSTALLATION	EACH	3		1	1	1				
•	33000100	TENI OWNE TRAITIC SIGNAL INSTALLATION	LACIT	,		1	1	1				
*	89502300	REMOVE ELECTRIC CABLE FROM CONDUIT	FOOT	14000					14000			
şt.				_		_		_				
*	89502375	REMOVE EXISTING TRAFFIC SIGNAL EQUIPMENT	EACH	3		1	1	1				
*	89502376	REBUILD EXISTING HANDHOLE	EACH	1	1							
*	89502380	REMOVE EXISTING HANDHOLE	EACH	28		9	9	8			2	
										I		
	* CDECIALTY ITI											



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	SI	JMMARY	OF QU	F.A.P RTE	SECTION	COUNTY	TOTAL SHEETS	SHEET NO.		
		II 50 /0	CICERO	350	2021-054-N&SW	соок	167	11		
		IL 30 (0	JULITO	AVE)		CONTRACT NO. 62N				
SCALE: N.T.S. SHEET 9 OF 11 SHEETS STA. TO STA.							ILLINOIS FED. A	D PROJECT		

					CONSTRUCTION CODE							
				URBAN	90% FED 10% STATE	90% FED 10% STATE	90% FED 7.5% STATE 2.5% CRESTWOOD	90% FED 5% STATE 5% CRESTWOOD	90% FED 10% STATE	100% CRESTWOOD	100% CRESTWOOD	
					ROADWAY	TRAFFIC SIGNALS	TRAFFIC SIGNALS	TRAFFIC SIGNALS	INTERCONNECT	EVP	UTILITY RELOCATION	
	CODE			TOTAL	0004	0021	0021	0021	0021	0021	0043	
	NO.	ITEM	UNIT	QUANTITY		IL50 & MIDLOTHIAN	IL50 & 135th ST	IL50 & CAL SAG RD				
k	89502382	REMOVE EXISTING DOUBLE HANDHOLE	EACH	4		1	1	2				
k	89502385	REMOVE EXISTING CONCRETE FOUNDATION	EACH	30		9	13	8				
	X6026631	AUXILIARY VALVE AND VALVE BOX	EACH	1							1	
*	X0324085	EMERGENCY VEHICLE PRIORITY SYSTEM LINE SENSOR CABLE, NO. 20 3/C	FOOT	1100						1100		
*	X0324599	ROD AND CLEAN EXISTING CONDUIT	FOOT	5800					5800			
	X0326806	WASHOUT BASIN	L SUM	1	1							
	X0320800	WASHOUT BASIN	L 301VI	1	1							
*	X1400081	FULL-ACTUATED CONTROLLER AND TYPE SUPER P CABINET (SPECIAL)	EACH	2		1		1				
*	X1400108	FULL-ACTUATED CONTROLLER AND TYPE SUPER R CABINET (SPECIAL)	EACH	1			1					
	X1400100	TOLE-ACTORIED CONTROLLER AND THE SOLER R CADINET (SI ECIAL)	LACIT	1			1					
*	X1400150	SERVICE INSTALLATION, GROUND MOUNTED, METERED	EACH	3		1	1	1				
*	X1400201	RADAR VEHICLE DETECTION SYSTEM, SINGLE APPROACH, STOP BAR	EACH	6		2	2	2				
	X1400201	NADAN VEHICLE DETECTION STSTEM, SINGLE ATTROACH, STOT BAN	LACIT			2	2	2		2		
*	X1400367	PEDESTRIAN SIGNAL POST, 10 FT.	EACH	9		5	2	2				
J												
*	X1400378	PEDESTRIAN SIGNAL POST, 5 FT.	EACH	2		į.	1	1				
	X4022000	TEMPORARY ACCESS (COMMERCIAL ENTRANCE)	EACH	2	2							
	V4240000	DETECTABLE WARNINGS (CRESTAL)	50.57	120	120							
	X4240800	DETECTABLE WARNINGS (SPECIAL)	SQ FT	120	120							
	X4400503	COMBINATION CURB AND GUTTER REMOVAL AND REPLACEMENT GREATER THAN 10 FEET	FOOT	387	387							



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STATE OF ILLINOIS
DEPARTMENT OF TRANSPORTATION

1	SUMMARY OF QUANTITIES	F.A.P RTE.				COUNTY	TOTAL	SHEET NO.
	IL 50 (CICERO AVE)	350	2021-054-N&SW			COOK	167	12
	IL 30 (SIDENO APE)		- 10			CONTRACT	NO. 62	2N85
	SCALE: N.T.S. SHEET 10 OF 11 SHEETS STA. TO STA.		[iu	LINOIS F	ED. AII	PROJECT		

				CONSTRUCTION CODE							
			URBAN	90% FED 10% STATE	90% FED 10% STATE	90% FED 7.5% STATE 2.5% CRESTWOOD	90% FED 5% STATE 5% CRESTWOOD	90% FED 10% STATE	100% CRESTWOOD	100% CRESTWOOD	
				ROADWAY	TRAFFIC SIGNALS	TRAFFIC SIGNALS	TRAFFIC SIGNALS	INTERCONNECT	EVP	UTILITY RELOCATION	
CODE NO.	ITEM	UNIT	TOTAL QUANTITY	0004	0021 IL50 & MIDLOTHIAN	0021 IL50 & 135th ST	0021 IL50 & CAL SAG RD	0021	0021	0043	
NO.	I I EIVI	UNIT	QUANTITY		ILSU & MIDLOTHIAN	1120 & 133(11.31	ILSU & CAL SAG RD				
X4403800	MEDIAN SURFACE REMOVAL	SQ FT	958	958							
		12 E									
2											
X6700407	ENGINEER'S FIELD OFFICE, TYPE A (D1)	CAL MO	12	12							
X7010216	TRAFFIC CONTROL AND PROTECTION, (SPECIAL)	L SUM	1	1							
X7010210	THAITIC CONTROL AND TROTECTION, (STECIAL)	E 30141	1	1							
X8620200	UNINTERRUPTABLE POWER SUPPLY, SPECIAL	EACH	3		1	1	1				
		2									
X8710024	FIBER OPTIC CABLE IN CONDUIT, NO. 62.5/125, MM12F SM24F	FOOT	7000					7000			
V0760000	ACCECCIDE DEDECTRIAN CIONALC	FACU	30				12				
X8760200	ACCESSIBLE PEDESTRIAN SIGNALS	EACH	28		8	8	12				
X8780012	CONCRETE FOUNDATION, TYPE A 12-INCH DIAMETER	FOOT	44		20	12	12				
	·		-								
X8950100	RELOCATE EXISTING MASTER CONTROLLER	EACH	1					1			
							8				
			_								
Z0013798	CONSTRUCTION LAYOUT	L SUM	1	1							
Z0030850	TEMPORARY INFORMATION SIGNING	SQ FT	206	206)
	8			6							7
Z0033046	RE-OPTIMIZE TRAFFIC SIGNAL SYSTEM LEVEL 2	EACH	6					6			
e.											
Z0073510	TEMPORARY TRAFFIC SIGNAL TIMING	EACH	3		1	1	1				
Z0076600	TRAINEES	HOUR	500	500							
		110011	300	300							
Z0076604	TRAINEES - TRAINING PROGRAM GRADUATE	HOUR	500	500							
4											
								1			
X7810101	LIGHTWEIGHT RAISED REFLECTIVE PAVEMENT MARKER (PCC)	EACH	165	165							


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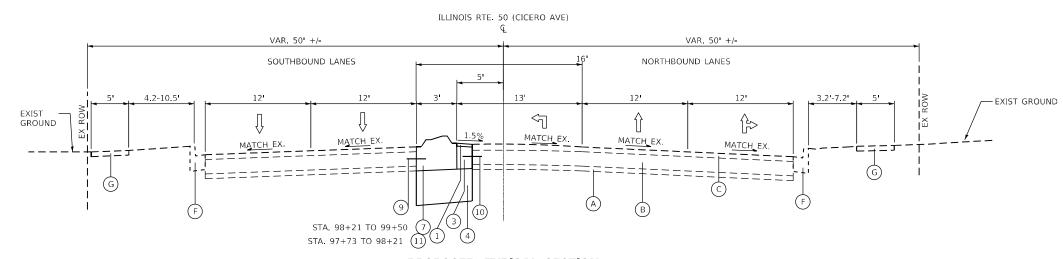
1	USER NAME = WTeng	DESIGNED WT	REVISED =
T		DRAWN	REVISED =
Γ	PLOT SCALE = 20.0000 ' / in.	CHECKED JPO	REVISED -
I	PLOT DATE = 12/8/2022	DATE 12/05/2022	REVISED =

STATE OF ILLINOIS DEPARTMENT OF TRANSPORTATION

					φ	1042
7.0	SUMMARY OF QUANTITIES	F.A.P RTE.	SECTION	COUNTY	TOTAL	
	IL 50 (CICERO AVE)	350	2021-054-N&SW	COOK	167	13
	IL 30 (GIOLIIO AVL)			CONTRAC	T NO. 6	2N85
	SCALE: N.T.S. SHEET 11 OF 11 SHEETS STA. TO STA.		ILLINOIS FED. /	AID PROJECT		



(LOOKING NORTH)
IL. RTE. 50 AT MIDLOTHIAN TURNPIKE - SOUTH LEG
STA. 97+73.00 TO STA. 99+50.00

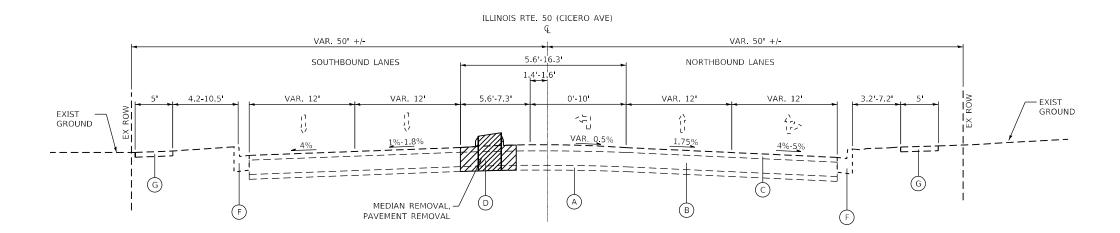

PROPOSED TYPICAL SECTION

(LOOKING NORTH)
IL. RTE. 50 AT MIDLOTHIAN TURNPIKE - SOUTH LEG
STA. 97+73.00 TO STA. 99+50.00

HOT-MIX ASPHALT MIXTURE REQUIREMENTS CHART

MIXTURE TYPE	AIR VOIDS @ N DES	QMP
COMPOSITE PAVEMENT RECONSTRUCTION		
HMA SURFACE COURSE, IL-9.5, MIX "D" N70; 3" (IN TWO LIFTS)	4% @ 70 GYR.	QC/QA
PAVEMENT WIDENING		
HMA SURFACE COURSE, IL-9.5, MIX "D" N70; 3" (IN TWO LIFTS)	4% @ 70 GYR.	QC/QA
QMP DESIGNATION: QUALITY CONTROL/QUALITY ASSURANCE (QC/QA)		

NOTES:

- 1. THE UNIT WEIGHT USED TO CALCULATE ALL HOT-MIX ASPHALT SURFACE MIXTURE QUANTITIES IS $112\ \text{LBS/SQ YD/IN}.$
- THE AC TYPE FOR POLYMERIZED HMA MIXES SHALL BE SBS/SBR PG 76-22 AND FOR NON-POLYMERIZED HMA THE AC TYPE SHALL BE PG 64-22 UNLESS MODIFIED BY RECLAIMED MATERIALS SPECIFICATIONS.

EXISTING LEGEND

- (A) EX. SUB-BASE GRANULAR MATERIAL, TYPE-A, 6"
- B) EX. PCC PAVEMENT, 10"
- (C) EX. HMA SURFACE, 2 3/4"
- D EX. CONCRETE MEDIAN, TYPE SB
- E EX. CORRUGATED MEDIAN
- (F) EX. COMBINATION CONC. CURB & GUTTER, TYPE B-6.24
- G EX. PCC SIDEWALK. 5"

PROPOSED LEGEND

- 1 PR. HMA SURFACE COURSE, IL-9.5, MIX "D", N70 (3")
- 2) SUBBASE GRANULAR MATERIAL TYPE B 4"
- (3) PR. PCC BASE COURSE (OR BASE COURSE WIDENING) 10"
- 4) PR. AGGREGATE SUBGRADE IMPROVEMENT 12"
- 5) PR. COMBINATION CONCRETE CURB & GUTTER, B-6.24
- (6) PR. PCC SIDEWALK 5"
- (7) PR. 3-FT CONC. MEDIANS, TYPE SM-6.06
- 8 PR. PCC PAVEMENT 10" (JOINTED)
- 9 PROPOSED LONGITUDINAL CONSTRUCTION JOINT WITH NO. 6 x 24" EPOXY COATED DEFORMED TIE BARS AT 24" CENTERS
- PROPOSED SAWED LONGITUDINAL JOINT WITH NO. 6 x 30" EPOXY COATED DEFORMED TIE BARS AT 30" CENTERS
- (11) PR. CONC. MEDIANS, TYPE M-2.06

BL	BLA, Inc.
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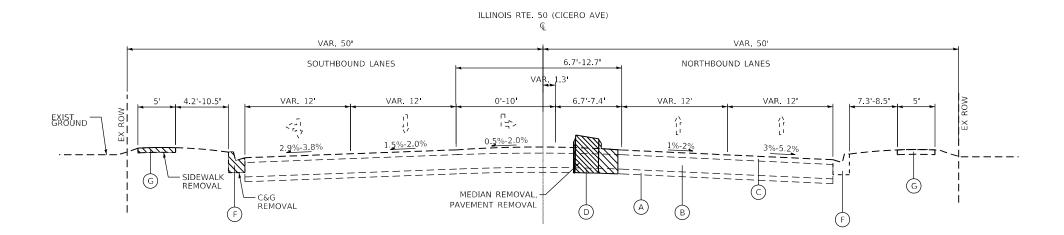
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PLOT DATE = 12/5/2022	DATE - 12/05/2022	REVISED -

STATE OF ILLINOIS
DEPARTMENT OF TRANSPORTATION


TYPICAL SECTIONS					
	IL 50 (CICERO	AVE) AT IV	IIDLOTHIAN	TURNPIKE	
SCALE: N.T.S.	SHEET 1	OF 14 SHE	ETS STA.	TO STA.	

F.A.P RTE	SECTION			COUNTY	TOTAL SHEETS	SHEE NO.
350	2021-054-N&SW			соок	167	14
				CONTRACT	NO. 62	2N85
		ILLINOIS	FED. A	ID PROJECT		

MODEL: Default FILE NAME: W:\195-000 EFK Moen [



(LOOKING NORTH) IL. RTE. 50 AT MIDLOTHIAN TURNPIKE - NORTH LEG STA. 100+50.00 TO STA. 103+96.00

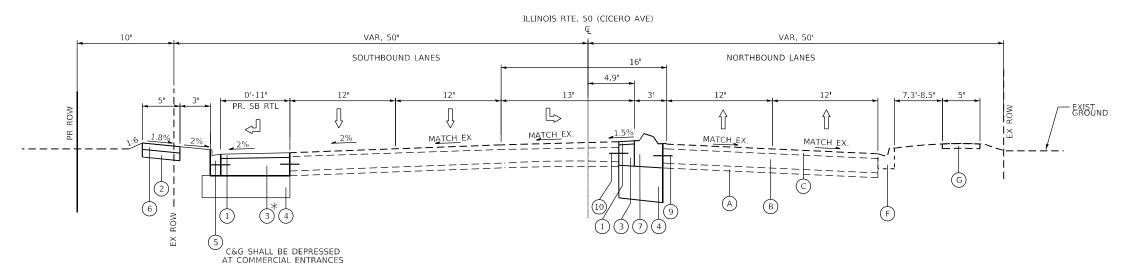

 $*$ BASE COURSE AT PROP. SB RTL SHALL BE PAID FOR AS: PCC BASE COURSE WIDENING, 10" - FOR WIDENING 6 FT OR LESS PCC BASE COURSE, 10" - FOR WIDENING GREATER THAN 6 FT

PROPOSED TYPICAL SECTION

(LOOKING NORTH) IL. RTE. 50 AT MIDLOTHIAN TURNPIKE - NORTH LEG STA. 100+50.00 TO STA. 103+96.00

- A EX. SUB-BASE GRANULAR MATERIAL, TYPE-A, 6"
- (B) EX. PCC PAVEMENT, 10"
- (C) EX. HMA SURFACE, 2 3/4"
- (D) EX. CONCRETE MEDIAN, TYPE SB
- (E) EX. CORRUGATED MEDIAN
- (F) EX. COMBINATION CONC. CURB & GUTTER, TYPE B-6.24
- G EX. PCC SIDEWALK. 5"

PROPOSED LEGEND

- 1) PR. HMA SURFACE COURSE, IL-9.5, MIX "D", N70 (3")
- 2) SUBBASE GRANULAR MATERIAL TYPE B 4"
- PR. PCC BASE COURSE (OR BASE COURSE WIDENING) 10"
- 4) PR. AGGREGATE SUBGRADE IMPROVEMENT 12"
- 5 PR. COMBINATION CONCRETE CURB & GUTTER, B-6.24
- (6) PR. PCC SIDEWALK 5"
- 7) PR. 3-FT CONC. MEDIANS, TYPE SM-6.06
- (8) PR. PCC PAVEMENT 10" (JOINTED)
- PROPOSED LONGITUDINAL CONSTRUCTION JOINT WITH NO. 6 \times 24" EPOXY COATED DEFORMED TIE BARS AT 24" CENTERS

COOK 167 15

CONTRACT NO. 62N85


- PROPOSED SAWED LONGITUDINAL JOINT WITH NO. 6 x 30" EPOXY COATED DEFORMED TIE BARS AT 30" CENTERS

(11	PR.	CONC.	MEDIANS,	TYPE	M-2.06
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BL	BLA, Inc.
	ITASCA, ILLINOIS


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PLOT DATE = 12/5/2022	DATE - 12/05/2022	REVISED -

TYPICAL SECTIONS	F.A.P RTE	SECTION	_
IL 50 (CICERO AVE) AT MIDLOTHIAN TURNPIKE	350	2021-054-N&SW	_
ie de (electio Ave/A) infectiniana femaline			
SCALE: N.T.S. SHEET 2 OF 14 SHEETS STA. TO STA.		ILLINOIS FED. AI	Б

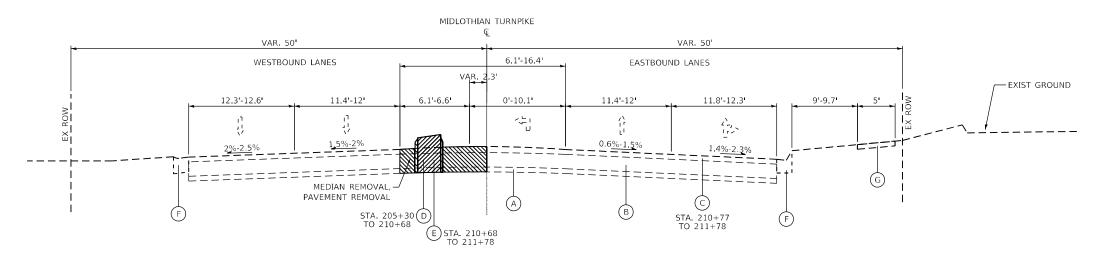

(LOOKING EAST)

IL. RTE. 50 AT MIDLOTHIAN TURNPIKE - WEST LEG STA. 205+44.00 TO STA. 206+45.00 STA. 207+88.00 TO STA. 211+28.00

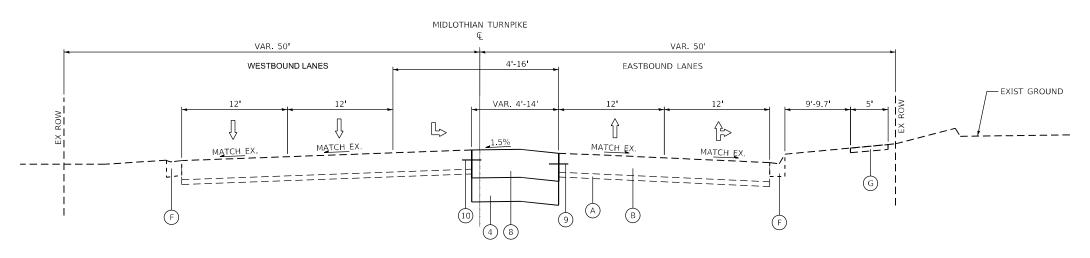

PROPOSED TYPICAL SECTION

(LOOKING EAST) IL. RTE. 50 AT MIDLOTHIAN TURNPIKE - WEST LEG STA. 205+44.00 TO STA. 206+45.00

- A EX. SUB-BASE GRANULAR MATERIAL, TYPE-A, 6"
- B) EX. PCC PAVEMENT, 10"
- (C) EX. HMA SURFACE, 2 3/4"
- (D) EX. CONCRETE MEDIAN, TYPE SB
- E EX. CORRUGATED MEDIAN
- F EX. COMBINATION CONC. CURB & GUTTER, TYPE B-6.24
- G EX. PCC SIDEWALK. 5"

PROPOSED LEGEND

- 1) PR. HMA SURFACE COURSE, IL-9.5, MIX "D", N70 (3")
- 2) SUBBASE GRANULAR MATERIAL TYPE B 4"
- PR. PCC BASE COURSE (OR BASE COURSE WIDENING) 10"
- 4) PR. AGGREGATE SUBGRADE IMPROVEMENT 12"
- 5 PR. COMBINATION CONCRETE CURB & GUTTER, B-6.24
- (6) PR. PCC SIDEWALK 5"
- 7) PR. 3-FT CONC. MEDIANS, TYPE SM-6.06
- (8) PR. PCC PAVEMENT 10" (JOINTED)
- PROPOSED LONGITUDINAL CONSTRUCTION JOINT WITH NO. 6 \times 24" EPOXY COATED DEFORMED TIE BARS AT 24" CENTERS
- PROPOSED SAWED LONGITUDINAL JOINT WITH NO. 6 x 30" EPOXY COATED DEFORMED TIE BARS AT 30" CENTERS
- (11) PR. CONC. MEDIANS, TYPE M-2.06


BL	BLA, Inc.
	ITASCA, ILLINOIS

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PLOT DATE = 12/5/2022	DATE - 12/05/2022	REVISED -


STATE	0F	ILLINOIS
DEPARTMENT	0F	TRANSPORTATION

TYPICAL SECTIONS							
l	I 50 (CICERO) AVE	AT MIN	ПТНІЛЬ	I THRNDIKE	350	
IL 50 (CICERO AVE) AT MIDLOTHIAN TURNPIKE							
SCALE: N.T.S.	SHEET 3	OF 14	SHEETS	STA.	TO STA.		

SECTION 2021-054-N&SW COOK 167 16 CONTRACT NO. 62N85

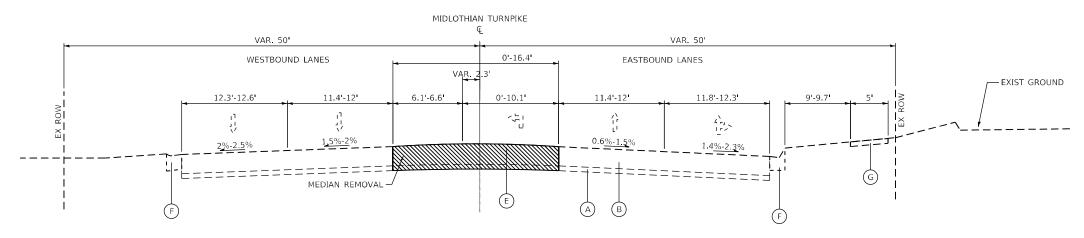


(LOOKING EAST) IL. RTE. 50 AT MIDLOTHIAN TURNPIKE - WEST LEG STA. 206+45.00 TO STA. 207+88.00

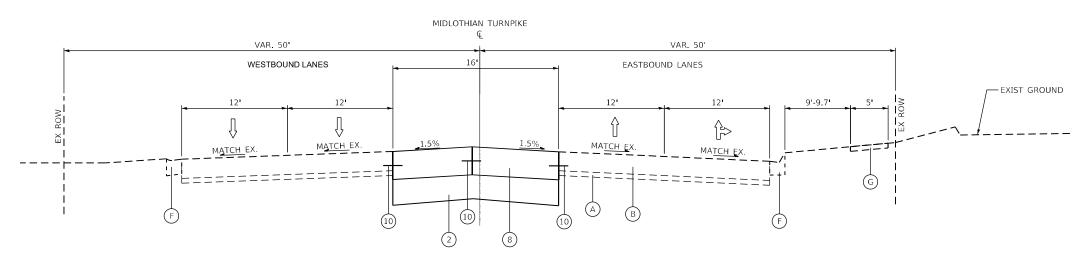

PROPOSED TYPICAL SECTION

(LOOKING EAST) IL. RTE. 50 AT MIDLOTHIAN TURNPIKE - WEST LEG STA. 206+45.00 TO STA. 207+88.00

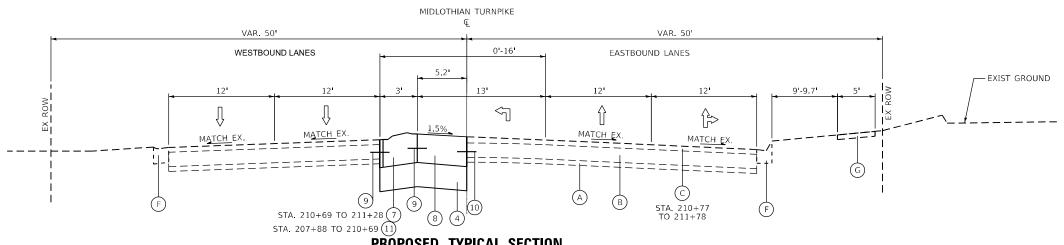

PROPOSED TYPICAL SECTION

(LOOKING EAST) IL. RTE. 50 AT MIDLOTHIAN TURNPIKE - WEST LEG STA. 207+88.00 TO STA. 211+28.00

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(١	EV	CLID DACE	CDANIHAD	MATERIAL	TVDE A	61

- B) EX. PCC PAVEMENT, 10"
- (C) EX. HMA SURFACE, 2 3/4"
- D EX. CONCRETE MEDIAN, TYPE SB
- E EX. CORRUGATED MEDIAN
- F EX. COMBINATION CONC. CURB & GUTTER, TYPE B-6.24
- G EX. PCC SIDEWALK. 5"

PROPOSED LEGEND

- 1) PR. HMA SURFACE COURSE, IL-9.5, MIX "D", N70 (3")
- 2) SUBBASE GRANULAR MATERIAL TYPE B 4"
- 3) PR. PCC BASE COURSE (OR BASE COURSE WIDENING) 10"
- 4) PR. AGGREGATE SUBGRADE IMPROVEMENT 12"
- 5 PR. COMBINATION CONCRETE CURB & GUTTER, B-6.24
- (6) PR. PCC SIDEWALK 5"
- PR. 3-FT CONC. MEDIANS, TYPE SM-6.06
- (8) PR. PCC PAVEMENT 10" (JOINTED)
- PROPOSED LONGITUDINAL CONSTRUCTION JOINT WITH NO. 6 x 24" EPOXY COATED DEFORMED TIE BARS AT 24" CENTERS
- PROPOSED SAWED LONGITUDINAL JOINT WITH NO. 6 x 30" EPOXY COATED DEFORMED TIE BARS AT 30" CENTERS
- (11) PR. CONC. MEDIANS, TYPE M-2.06

	A, Inc.
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STATE OF ILLINOIS **DEPARTMENT OF TRANSPORTATION**


TYPICAL SECTIONS									
IL	50	(CICERO	AVE) AT	MIDLOTHIAN	TURNPIKE				

SECTION 2021-054-N&SW COOK 167 17 CONTRACT NO. 62N85

TO STA.


SCALE: N.T.S.

SHEET 4 OF 14 SHEETS STA.

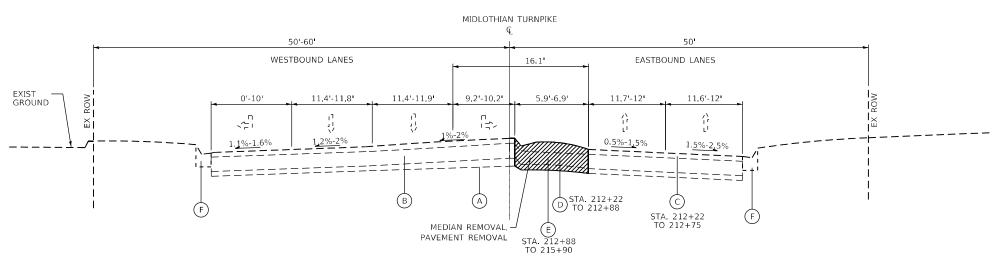

(LOOKING EAST)

IL. RTE. 50 AT MIDLOTHIAN TURNPIKE - EAST LEG STA. 212+22.00 TO STA. 215+90.00

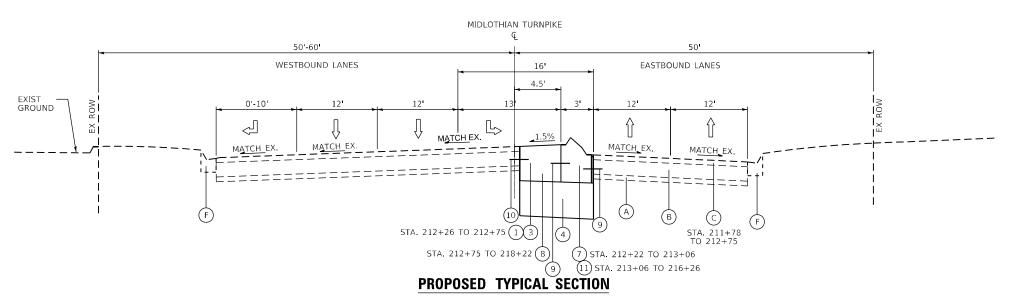

(LOOKING EAST)
IL. RTE. 50 AT MIDLOTHIAN TURNPIKE - EAST LEG
STA. 212+22.00 TO STA. 216+26.00

- A EX. SUB-BASE GRANULAR MATERIAL, TYPE-A, 6"
- B) EX. PCC PAVEMENT, 10"
- (C) EX. HMA SURFACE, 2 3/4"
- D EX. CONCRETE MEDIAN, TYPE SB
- E EX. CORRUGATED MEDIAN
- F EX. COMBINATION CONC. CURB & GUTTER, TYPE B-6.24
- G EX. PCC SIDEWALK. 5"

PROPOSED LEGEND

- 1) PR. HMA SURFACE COURSE, IL-9.5, MIX "D", N70 (3")
- 2) SUBBASE GRANULAR MATERIAL TYPE B 4"
- (3) PR. PCC BASE COURSE (OR BASE COURSE WIDENING) 10"
- 4) PR. AGGREGATE SUBGRADE IMPROVEMENT 12"
- 5 PR. COMBINATION CONCRETE CURB & GUTTER, B-6.24
- 6 PR. PCC SIDEWALK 5"
- 7) PR. 3-FT CONC. MEDIANS, TYPE SM-6.06
- 8 PR. PCC PAVEMENT 10" (JOINTED)
- 9 PROPOSED LONGITUDINAL CONSTRUCTION JOINT WITH NO. 6 x 24" EPOXY COATED DEFORMED TIE BARS AT 24" CENTERS
- proposed sawed longitudinal joint with No. 6 x 30" epoxy coated deformed tie bars at 30" centers
- (11) PR. CONC. MEDIANS, TYPE M-2.06

BL	BLA, Inc.
	HASCA, ILLINOIS


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PLOT DATE = 12/5/2022	DATE - 12/05/2022	REVISED -

STATE OF ILLINOIS
DEPARTMENT OF TRANSPORTATION


SCALE: N.T.S.

		F.A.P RTE			COUNTY	TOTAL SHEETS	S					
		350	2021-05	4-N&SW		соок	167					
						CONTRAC	T NO. 6:	2 N				
	SHEET 5	OF 14	SHEETS	STA.	TO STA.			ILLINOIS	EED Δ	ID PROJECT		

THE NAME: WILLST-000 EFA

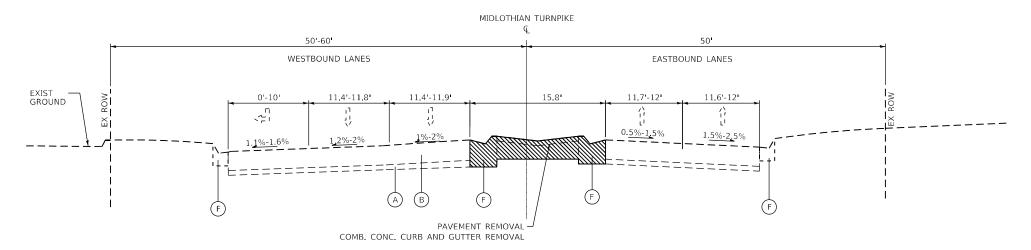

(LOOKING EAST)
IL. RTE. 50 AT MIDLOTHIAN TURNPIKE - EAST LEG
STA. 215+90.00 TO STA. 218+22.00

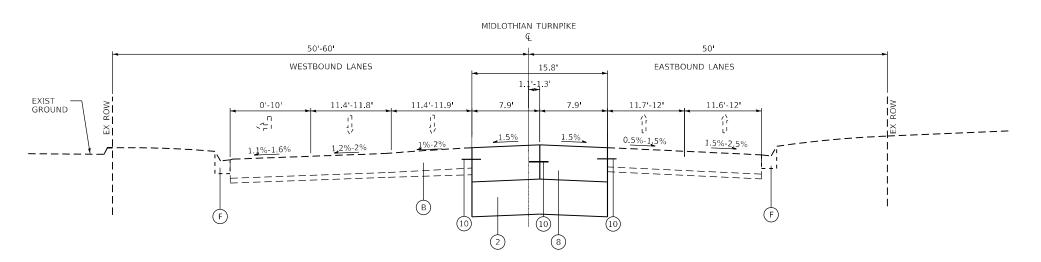

PROPOSED TYPICAL SECTION

(LOOKING EAST)
IL. RTE. 50 AT MIDLOTHIAN TURNPIKE - EAST LEG
STA. 216+26.00 TO STA. 218+22.00

- A EX. SUB-BASE GRANULAR MATERIAL, TYPE-A, 6"
- B) EX. PCC PAVEMENT, 10"
- C EX. HMA SURFACE, 2 3/4"
- D EX. CONCRETE MEDIAN, TYPE SB
- E EX. CORRUGATED MEDIAN
- F EX. COMBINATION CONC. CURB & GUTTER, TYPE B-6.24
- G EX. PCC SIDEWALK. 5"

PROPOSED LEGEND

- 1) PR. HMA SURFACE COURSE, IL-9.5, MIX "D", N70 (3")
- 2) SUBBASE GRANULAR MATERIAL TYPE B 4"
- 3) PR. PCC BASE COURSE (OR BASE COURSE WIDENING) 10"
- 4) PR. AGGREGATE SUBGRADE IMPROVEMENT 12"
- 5) PR. COMBINATION CONCRETE CURB & GUTTER, B-6.24
- (6) PR. PCC SIDEWALK 5"
- 7) PR. 3-FT CONC. MEDIANS, TYPE SM-6.06
- 8 PR. PCC PAVEMENT 10" (JOINTED)
- PROPOSED LONGITUDINAL CONSTRUCTION JOINT WITH NO. 6 x 24" EPOXY COATED DEFORMED TIE BARS AT 24" CENTERS

COOK 167 19


CONTRACT NO. 62N85

- PROPOSED SAWED LONGITUDINAL JOINT WITH NO. 6 x 30" EPOXY COATED DEFORMED TIE BARS AT 30" CENTERS
- (11) PR. CONC. MEDIANS, TYPE M-2.06


R.	BLA, Inc.
	ITASCA, ILLINOIS

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PLOT DATE = 12/5/2022	DATE - 12/05/2022	REVISED -

TYPICAL SECTIONS	F.A.P RTE SECTION			
IL 50 (CICERO AVE) AT MIDLOTHIAN TURNPIKE	350	2021-054-N	N&SW	
ie 30 (dioeno Ave) Al milocofficia fondi ne				
SCALE: N.T.S. SHEET 6 OF 14 SHEETS STA. TO STA.		ILI	LINOIS	FED. AII

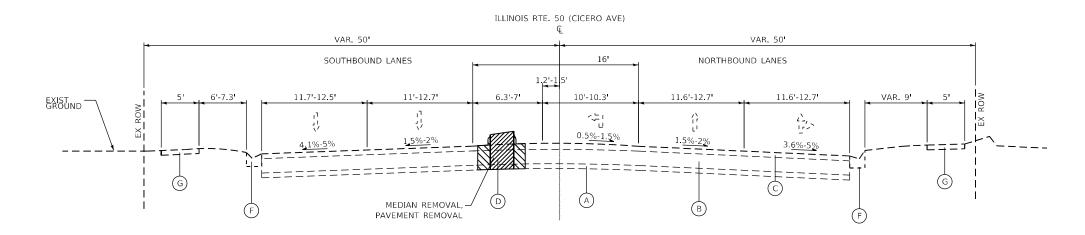

(LOOKING NORTH) IL. RTE. 50 AT 135TH STREET - SOUTH LEG STA. 129+44.00 TO STA. 131+54.00

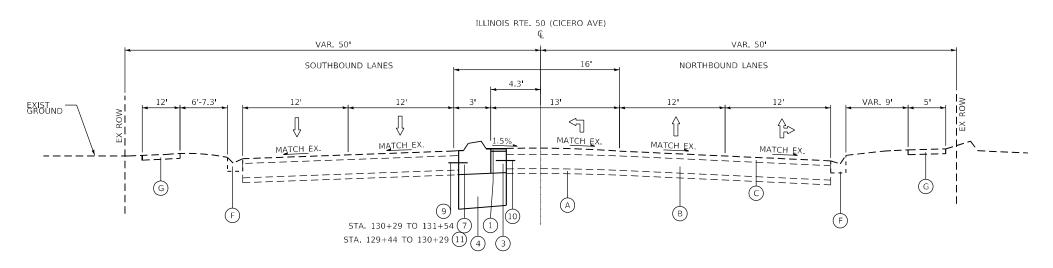

PROPOSED TYPICAL SECTION

(LOOKING NORTH) IL. RTE. 50 AT 135TH STREET - SOUTH LEG STA. 129+44.00 TO STA. 131+54.00

- A EX. SUB-BASE GRANULAR MATERIAL, TYPE-A, 6"
- (B) EX. PCC PAVEMENT, 10"
- (C) EX. HMA SURFACE, 2 3/4"
- D EX. CONCRETE MEDIAN, TYPE SB
- E EX. CORRUGATED MEDIAN
- F EX. COMBINATION CONC. CURB & GUTTER, TYPE B-6.24
- G EX. PCC SIDEWALK. 5"

PROPOSED LEGEND

- 1) PR. HMA SURFACE COURSE, IL-9.5, MIX "D", N70 (3")
- 2) SUBBASE GRANULAR MATERIAL TYPE B 4"
- 3) PR. PCC BASE COURSE (OR BASE COURSE WIDENING) 10"
- PR. AGGREGATE SUBGRADE IMPROVEMENT 12"
- 5 PR. COMBINATION CONCRETE CURB & GUTTER, B-6.24
- (6) PR. PCC SIDEWALK 5"
- 7) PR. 3-FT CONC. MEDIANS, TYPE SM-6.06
- 8 PR. PCC PAVEMENT 10" (JOINTED)
- PROPOSED LONGITUDINAL CONSTRUCTION JOINT WITH NO. 6 \times 24" EPOXY COATED DEFORMED TIE BARS AT 24" CENTERS

COOK 167 20 CONTRACT NO. 62N85

- PROPOSED SAWED LONGITUDINAL JOINT WITH NO. 6 x 30" EPOXY COATED DEFORMED TIE BARS AT 30" CENTERS
- (11) PR. CONC. MEDIANS, TYPE M-2.06


B	BLA, Inc.
	ITAGUA, ILLINOIS

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	DRAWN -	REVISED -
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PLOT DATE = 12/5/2022	DATE - 12/05/2022	REVISED -

STATE	0F	ILLINOIS
DEPARTMENT C)F T	RANSPORTATION


				F.A.P RTE	SECTION	
IL 50 (CICERO AVE) AT 135th STREET				350	2021-054-N&SW	
IL 30 (010E110	AVE/ AI	100111	OTHELL			
SHEET 7 OF 1/	SHEETS	STA		TO STA		TURNOIC

SCALE: N.T.S.

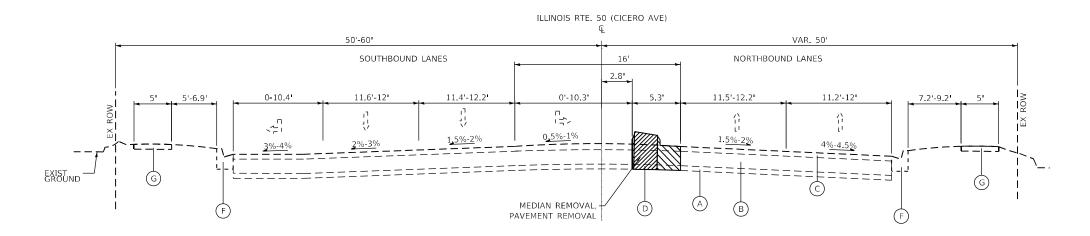

(LOOKING NORTH)

IL. RTE. 50 AT 135TH STREET - NORTH LEG
STA. 132+53.00 TO STA. 134+48.00

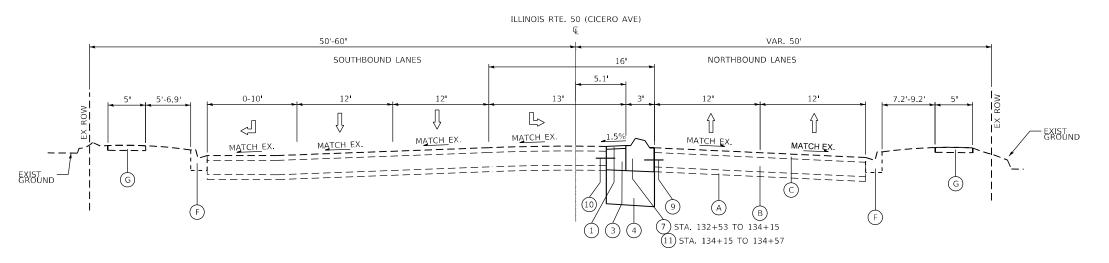

PROPOSED TYPICAL SECTION

(LOOKING NORTH)

IL. RTE. 50 AT 135TH STREET - NORTH LEG
STA. 132+53.00 TO STA. 134+57.00

- A EX. SUB-BASE GRANULAR MATERIAL, TYPE-A, 6"
- B) EX. PCC PAVEMENT, 10"
- C EX. HMA SURFACE, 2 3/4"
- D EX. CONCRETE MEDIAN, TYPE SB
- E EX. CORRUGATED MEDIAN
- F EX. COMBINATION CONC. CURB & GUTTER, TYPE B-6.24
- G EX. PCC SIDEWALK. 5"

PROPOSED LEGEND


- 1) PR. HMA SURFACE COURSE, IL-9.5, MIX "D", N70 (3")
- 2) SUBBASE GRANULAR MATERIAL TYPE B 4"
- (3) PR. PCC BASE COURSE (OR BASE COURSE WIDENING) 10"
- 4) PR. AGGREGATE SUBGRADE IMPROVEMENT 12"
- 5) PR. COMBINATION CONCRETE CURB & GUTTER, B-6.24
- 6 PR. PCC SIDEWALK 5"
- 7) PR. 3-FT CONC. MEDIANS, TYPE SM-6.06
- 8 PR. PCC PAVEMENT 10" (JOINTED)
- 9 PROPOSED LONGITUDINAL CONSTRUCTION JOINT WITH NO. 6 x 24" EPOXY COATED DEFORMED TIE BARS AT 24" CENTERS
- PROPOSED SAWED LONGITUDINAL JOINT WITH NO. 6 x 30" EPOXY COATED DEFORMED TIE BARS AT 30" CENTERS
- 11) PR. CONC. MEDIANS, TYPE M-2.06

D L BLA, Inc.	BL	BLA, Inc.
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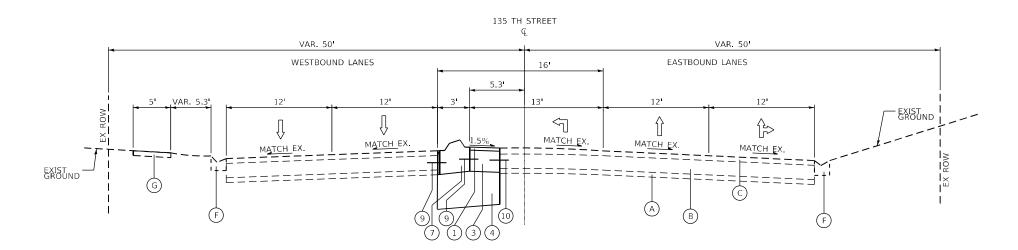
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	DRAWN -	REVISED -
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PLOT DATE = 12/5/2022	DATE - 12/05/2022	REVISED -

F.A.P RTE	RTE SECTION			COUNTY	SHEETS	SHEE NO.
350 2021-054-N&SW			COOK	167	21	
·			CONTRACT	NO. 62	2N85	
		ILLINOIS	FED. A	D PROJECT		

MODEL: Default FILE NAME: W:\195-000 EFK Moen D1 V\

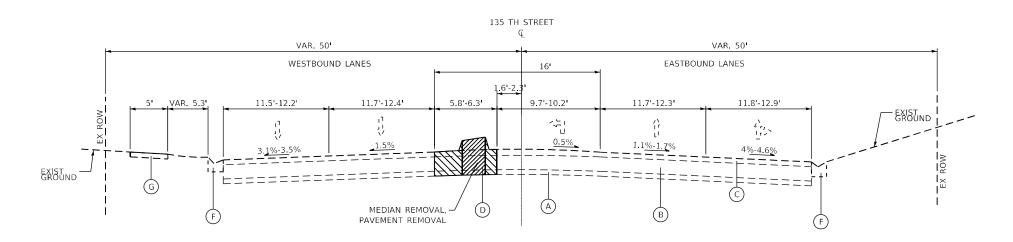

(LOOKING EAST)
IL. RTE. 50 AT 135TH STREET - WEST LEG
STA. 307+07.00 TO STA. 310+25.00



PROPOSED TYPICAL SECTION

(LOOKING EAST)
IL. RTE. 50 AT 135TH STREET - WEST LEG
STA. 307+07.00 TO STA. 310+25.00

- A EX. SUB-BASE GRANULAR MATERIAL, TYPE-A, 6"
- B EX. PCC PAVEMENT, 10"
- C EX. HMA SURFACE, 2 3/4"
- D EX. CONCRETE MEDIAN, TYPE SB
- E EX. CORRUGATED MEDIAN
- F EX. COMBINATION CONC. CURB & GUTTER, TYPE B-6.24
- G EX. PCC SIDEWALK. 5"

PROPOSED LEGEND

- 1 PR. HMA SURFACE COURSE, IL-9.5, MIX "D", N70 (3")
- 2) SUBBASE GRANULAR MATERIAL TYPE B 4"
- (3) PR. PCC BASE COURSE (OR BASE COURSE WIDENING) 10"
- 4) PR. AGGREGATE SUBGRADE IMPROVEMENT 12"
- 5) PR. COMBINATION CONCRETE CURB & GUTTER, B-6.24
- 6 PR. PCC SIDEWALK 5"
- 7) PR. 3-FT CONC. MEDIANS, TYPE SM-6.06
- 8 PR. PCC PAVEMENT 10" (JOINTED)
- 9 PROPOSED LONGITUDINAL CONSTRUCTION JOINT WITH NO. 6 \times 24" EPOXY COATED DEFORMED TIE BARS AT 24" CENTERS
- PROPOSED SAWED LONGITUDINAL JOINT WITH NO. 6 \times 30" EPOXY COATED DEFORMED TIE BARS AT 30" CENTERS
- (11) PR. CONC. MEDIANS, TYPE M-2.06


BL	BLA, Inc.
	ITASCA, ILLINOIS

USER NAME = wteng	DESIGNED - WT	REVISED -
	DRAWN -	REVISED -
PLOT SCALE = 20.0000 / in	CHECKED - JPO	REVISED -
PLOT DATE = 12/5/2022	DATE - 12/05/2022	REVISED -


STATE OF ILLINOIS
DEPARTMENT OF TRANSPORTATION

TYPICAL SECTIONS						
	IL 50	(CICERO	AVE) AT	135th	STREET	
SCALE: N.T.S.	SHEET 9	OF 14	SHEETS	STA.		TO STA.

MODEL: Default FILE NAME: W:\195-000 EFK Mod

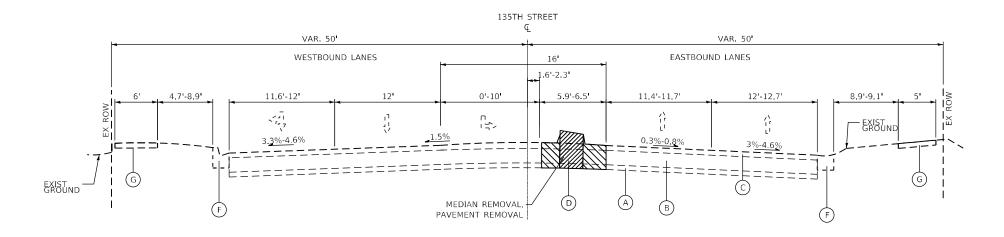

(LOOKING EAST) IL. RTE. 50 AT 135TH STREET - EAST LEG STA. 311+23.00 TO STA. 314+41.00

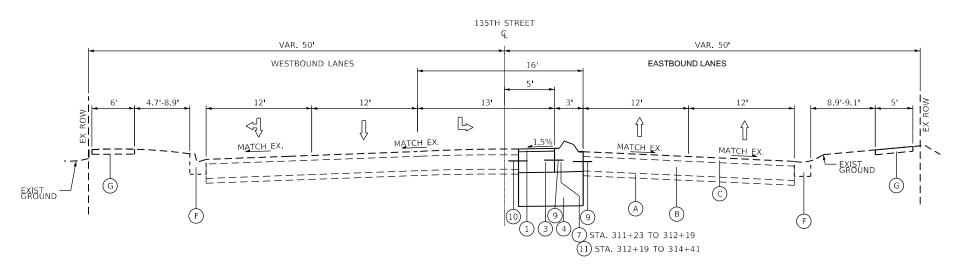

PROPOSED TYPICAL SECTION

(LOOKING EAST) IL. RTE. 50 AT 135TH STREET - EAST LEG STA. 311+23.00 TO STA. 314+41.00

- A EX. SUB-BASE GRANULAR MATERIAL, TYPE-A, 6"
- B) EX. PCC PAVEMENT, 10"
- C EX. HMA SURFACE, 2 3/4"
- D EX. CONCRETE MEDIAN, TYPE SB
- E EX. CORRUGATED MEDIAN
- F EX. COMBINATION CONC. CURB & GUTTER, TYPE B-6.24
- G EX. PCC SIDEWALK. 5"

PROPOSED LEGEND

- 1 PR. HMA SURFACE COURSE, IL-9.5, MIX "D", N70 (3")
- 2) SUBBASE GRANULAR MATERIAL TYPE B 4"
- 3) PR. PCC BASE COURSE (OR BASE COURSE WIDENING) 10"
- PR. AGGREGATE SUBGRADE IMPROVEMENT 12"
- 5) PR. COMBINATION CONCRETE CURB & GUTTER, B-6.24
- 6 PR. PCC SIDEWALK 5"
- 7) PR. 3-FT CONC. MEDIANS, TYPE SM-6.06
- 8 PR. PCC PAVEMENT 10" (JOINTED)
- PROPOSED LONGITUDINAL CONSTRUCTION JOINT WITH NO. 6 \times 24" EPOXY COATED DEFORMED TIE BARS AT 24" CENTERS
- PROPOSED SAWED LONGITUDINAL JOINT WITH NO. 6 x 30" EPOXY COATED DEFORMED TIE BARS AT 30" CENTERS
- (11) PR. CONC. MEDIANS, TYPE M-2.06


D'	BLA, Inc.
	ITASCA ILLINOIS

USER NAME = wteng	DESIGNED - WT	REVISED -
	DRAWN -	REVISED -
PLOT SCALE = 20.0000 / in.	CHECKED - JPO	REVISED -
PLOT DATE = 12/5/2022	DATE - 12/05/2022	REVISED -


STATE OF ILLINOIS	
DEPARTMENT OF TRANSPORTATIO	N

TYPICAL SECTIONS							
	IL 50 (CICERO	AVE) AT	135th	STREET		
SCALE: N.T.S.	SHEET 10	OF 14	SHEETS	STA.		TO STA	٨.

2021-054-N&SW COOK 167 23 CONTRACT NO. 62N85

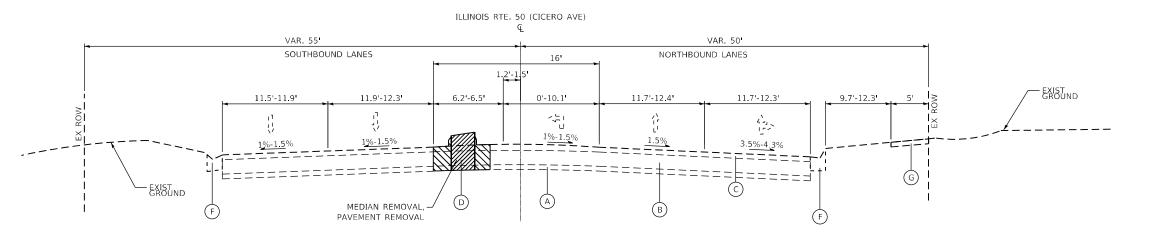

(LOOKING NORTH)
IL. RTE. 50 AT CAL SAG ROAD - SOUTH LEG
STA. 149+18.00 TO STA. 153+28.00

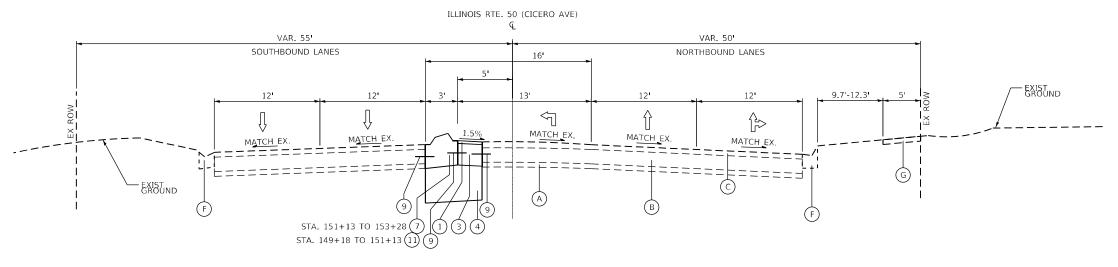

PROPOSED TYPICAL SECTION

(LOOKING NORTH)

IL. RTE. 50 AT CAL SAG ROAD - SOUTH LEG
STA. 149+18.00 TO STA. 153+28.00

- A EX. SUB-BASE GRANULAR MATERIAL, TYPE-A, 6"
- B EX. PCC PAVEMENT, 10"
- C EX. HMA SURFACE, 2 3/4"
- D EX. CONCRETE MEDIAN, TYPE SB
- E EX. CORRUGATED MEDIAN
- F EX. COMBINATION CONC. CURB & GUTTER, TYPE B-6.24
- G EX. PCC SIDEWALK. 5"

PROPOSED LEGEND

- 1 PR. HMA SURFACE COURSE, IL-9.5, MIX "D", N70 (3")
- 2) SUBBASE GRANULAR MATERIAL TYPE B 4"
- 3) PR. PCC BASE COURSE (OR BASE COURSE WIDENING) 10"
- 4) PR. AGGREGATE SUBGRADE IMPROVEMENT 12"
- 5) PR. COMBINATION CONCRETE CURB & GUTTER, B-6.24
- (6) PR. PCC SIDEWALK 5"
- 7) PR. 3-FT CONC. MEDIANS, TYPE SM-6.06
- 8 PR. PCC PAVEMENT 10" (JOINTED)
- 9 PROPOSED LONGITUDINAL CONSTRUCTION JOINT WITH NO. 6 x 24" EPOXY COATED DEFORMED TIE BARS AT 24" CENTERS
- PROPOSED SAWED LONGITUDINAL JOINT WITH NO. 6 \times 30" EPOXY COATED DEFORMED TIE BARS AT 30" CENTERS
- (11) PR. CONC. MEDIANS, TYPE M-2.06


BL	BLA, Inc.

USER NAME = wteng	DESIGNED - WT	REVISED -
	DRAWN -	REVISED -
PLOT SCALE = 20.0000 / in.	CHECKED - JPO	REVISED -
PLOT DATE = 12/5/2022	DATE - 12/05/2022	REVISED -

	IL 50 (CIC		L SECT /E) AT (IONS Cal sag road)
SCALE: N.T.S.	SHEET 11	OF 14	SHEETS	STA.	TO STA.


F.A.P RTE			COUNTY	TOTAL SHEETS	SHEE NO.
350	2021-054-N&SW		соок	167	24
			CONTRACT	NO. 62	2N85
	ILLINOIS	FED. A	D PROJECT		

MODEL: Default

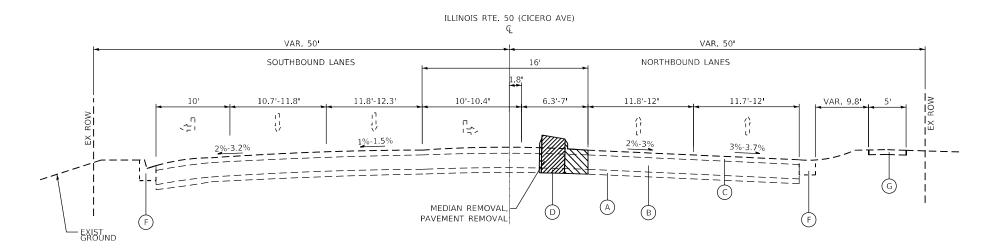

(LOOKING NORTH)

IL. RTE. 50 AT CAL SAG ROAD - NORTH LEG
STA. 154+56.00 TO STA. 157+00.00

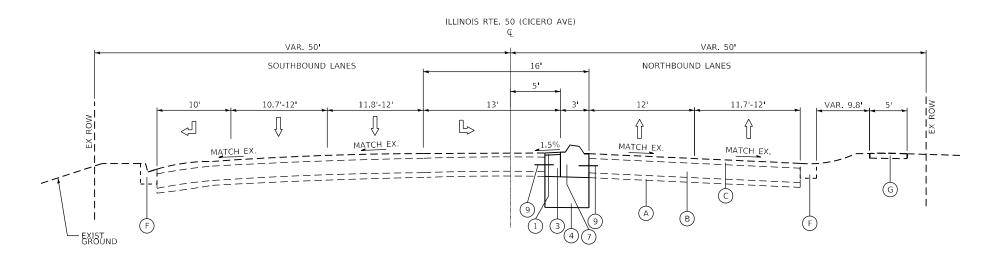

PROPOSED TYPICAL SECTION

(LOOKING NORTH)
IL. RTE. 50 AT CAL SAG ROAD - NORTH LEG
STA. 154+56.00 TO STA. 157+00.00

- A EX. SUB-BASE GRANULAR MATERIAL, TYPE-A, 6"
- B EX. PCC PAVEMENT, 10"
- C EX. HMA SURFACE, 2 3/4"
- D EX. CONCRETE MEDIAN, TYPE SB
- E EX. CORRUGATED MEDIAN
- F EX. COMBINATION CONC. CURB & GUTTER, TYPE B-6.24
- G EX. PCC SIDEWALK. 5"


PROPOSED LEGEND

- 1 PR. HMA SURFACE COURSE, IL-9.5, MIX "D", N70 (3")
- 2) SUBBASE GRANULAR MATERIAL TYPE B 4"
- 3) PR. PCC BASE COURSE (OR BASE COURSE WIDENING) 10"
- 4) PR. AGGREGATE SUBGRADE IMPROVEMENT 12"
- 5) PR. COMBINATION CONCRETE CURB & GUTTER, B-6.24
- 6 PR. PCC SIDEWALK 5"
- 7) PR. 3-FT CONC. MEDIANS, TYPE SM-6.06
- 8 PR. PCC PAVEMENT 10" (JOINTED)
- 9 PROPOSED LONGITUDINAL CONSTRUCTION JOINT WITH NO. 6 x 24" EPOXY COATED DEFORMED TIE BARS AT 24" CENTERS
- PROPOSED SAWED LONGITUDINAL JOINT WITH NO. 6 x 30" EPOXY COATED DEFORMED TIE BARS AT 30" CENTERS
- 11) PR. CONC. MEDIANS, TYPE M-2.06


BLA, Inc.
ITASCA, ILLINOIS

USER NAME = wteng	DESIGNED - WT	REVISED -
	DRAWN -	REVISED -
PLOT SCALE = 20.0000 / in.	CHECKED - JPO	REVISED -
PLOT DATE = 12/5/2022	DATE - 12/05/2022	REVISED -

MODEL: Default FILE NAME: W:\195-000 EFK M

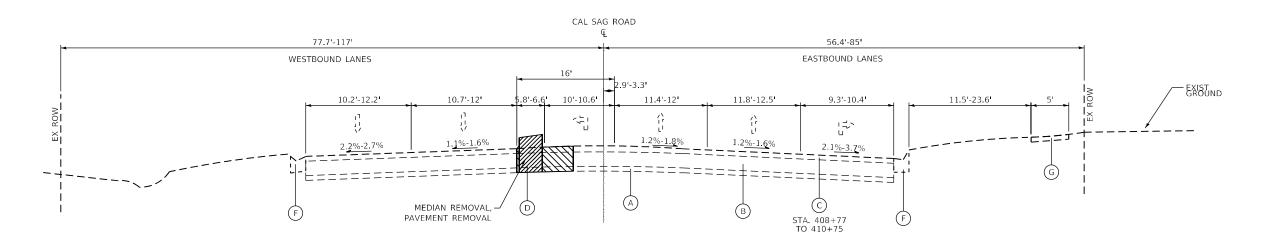

(LOOKING EAST) IL. RTE. 50 AT CAL SAG ROAD - WEST LEG STA. 400+46 TO 401+60.00 STA. 405+32 TO 410+14.00

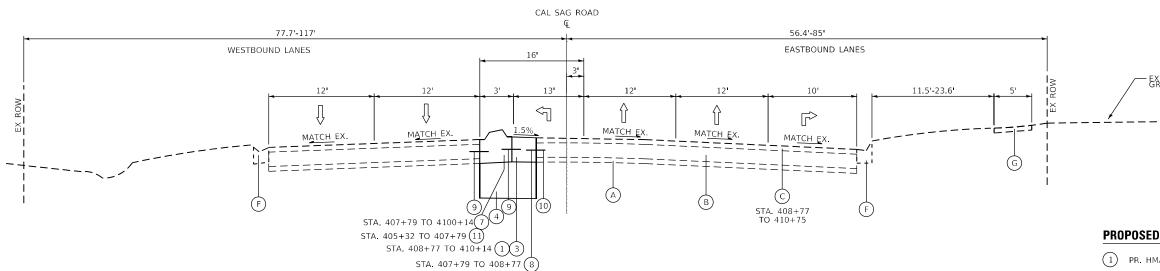

PROPOSED TYPICAL SECTION

(LOOKING EAST) IL. RTE. 50 AT CAL SAG ROAD - WEST LEG STA. 400+46 TO 401+60.00 STA. 405+32 TO 410+14.00

EXISTING LEGEND

- (A) EX. SUB-BASE GRANULAR MATERIAL, TYPE-A, 6"
- (B) EX. PCC PAVEMENT, 10"
- C EX. HMA SURFACE, 2 3/4"
- D EX. CONCRETE MEDIAN, TYPE SB
- (E) EX. CORRUGATED MEDIAN
- (F) EX. COMBINATION CONC. CURB & GUTTER, TYPE B-6.24
- G EX. PCC SIDEWALK. 5"

PROPOSED LEGEND

- 1) PR. HMA SURFACE COURSE, IL-9.5, MIX "D", N70 (3")
- 2) SUBBASE GRANULAR MATERIAL TYPE B 4"
- 3) PR. PCC BASE COURSE (OR BASE COURSE WIDENING) 10"
- PR. AGGREGATE SUBGRADE IMPROVEMENT 12"
- 5) PR. COMBINATION CONCRETE CURB & GUTTER, B-6.24
- (6) PR. PCC SIDEWALK 5"
- PR. 3-FT CONC. MEDIANS, TYPE SM-6.06
- 8 PR. PCC PAVEMENT 10" (JOINTED)
- PROPOSED LONGITUDINAL CONSTRUCTION JOINT WITH NO. 6 x 24" EPOXY COATED DEFORMED TIE BARS AT 24" CENTERS
- PROPOSED SAWED LONGITUDINAL JOINT WITH NO. 6 x 30" EPOXY COATED DEFORMED TIE BARS AT 30" CENTERS
- (11) PR. CONC. MEDIANS, TYPE M-2.06


	BLA, Inc.
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USER NAME = wteng	DESIGNED - WT	REVISED -
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PLOT DATE = 12/5/2022	DATE - 12/05/2022	REVISED -


STATE OF ILLINOIS **DEPARTMENT OF TRANSPORTATION**

	IL 50 (CIC		L SECT /E) AT (IONS Cal sag roa	D
SCALE: N.T.S.	SHEET 13	OF 14	SHEETS	STA.	TO STA.

SECTION 2021-054-N&SW COOK 167 26 CONTRACT NO. 62N85

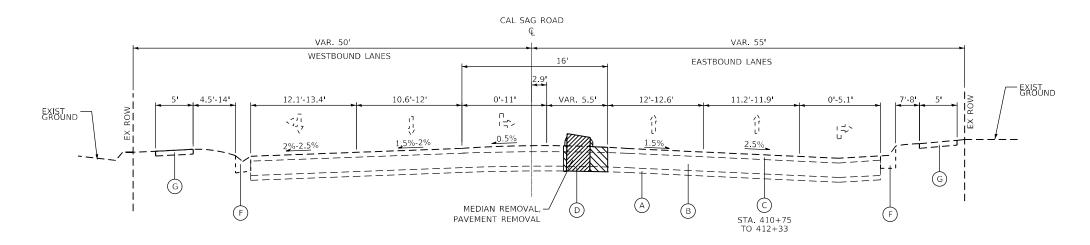

(LOOKING EAST) IL. RTE. 50 AT CAL SAG ROAD - EAST LEG STA. 411+30.00 TO STA. 414+51.00

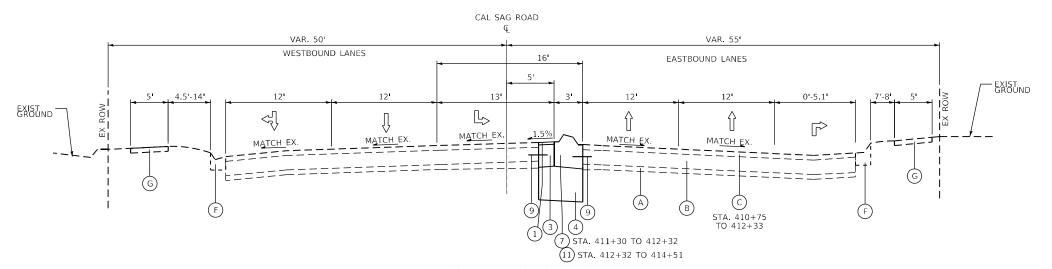

PROPOSED TYPICAL SECTION

(LOOKING EAST) IL. RTE. 50 AT CAL SAG ROAD - EAST LEG STA. 411+30.00 TO STA. 414+51.00

- A EX. SUB-BASE GRANULAR MATERIAL, TYPE-A, 6"
- B EX. PCC PAVEMENT, 10"
- C EX. HMA SURFACE, 2 3/4"
- D EX. CONCRETE MEDIAN, TYPE SB
- E EX. CORRUGATED MEDIAN
- F EX. COMBINATION CONC. CURB & GUTTER, TYPE B-6.24
- G EX. PCC SIDEWALK. 5"

PROPOSED LEGEND

- 1 PR. HMA SURFACE COURSE, IL-9.5, MIX "D", N70 (3")
- 2) SUBBASE GRANULAR MATERIAL TYPE B 4"
- 3) PR. PCC BASE COURSE (OR BASE COURSE WIDENING) 10"
- 4) PR. AGGREGATE SUBGRADE IMPROVEMENT 12"
- 5) PR. COMBINATION CONCRETE CURB & GUTTER, B-6.24
- 6 PR. PCC SIDEWALK 5"
- 7) PR. 3-FT CONC. MEDIANS, TYPE SM-6.06
- 8 PR. PCC PAVEMENT 10" (JOINTED)
- PROPOSED LONGITUDINAL CONSTRUCTION JOINT WITH NO. 6 x 24" EPOXY COATED DEFORMED TIE BARS AT 24" CENTERS
- PROPOSED SAWED LONGITUDINAL JOINT WITH NO. 6 \times 30" EPOXY COATED DEFORMED TIE BARS AT 30" CENTERS
- (11) PR. CONC. MEDIANS, TYPE M-2.06

	A, Inc.
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USER NAME = wteng	DESIGNED - WT	REVISED -
	DRAWN -	REVISED -
PLOT SCALE = 20.0000 / in.	CHECKED - JPO	REVISED -
PLOT DATE = 12/5/2022	DATE - 12/05/2022	REVISED -

STATE OF ILLINOIS **DEPARTMENT OF TRANSPORTATION**

TYPICAL SECTIONS IL 50 (CICERO AVE) AT CAL SAG ROAD							
SCALE: N.T.S.	SHEET 14	OF 14	SHEETS	STA.	TO STA.		

SECTION 2021-054-N&SW COOK 167 27 CONTRACT NO. 62N85

PAVEMENT SCHEDULE

LOCATION STATION-STATION	PAVEMENT REMOVAL (SQ YD)	MEDIAN REMOVAL (SQ FT)	AGGREGATE SUBGRADE IMPROV. 12" (SQ YD)	CONCRETE MEDIAN TYPE M-2.06 (SQ FT)	CONCRETE MEDIAN TYPE SM-6.06 (SQ FT)	HMA SURFACE CSE IL-9.5 MIX "D" N70 (TON)	PCC BASE COURSE 10" (SQ YD)
CICERO AVE AT MIDLO	OTHIAN TPKE						
S LEG STA 94 - 100	24	361	93	147	375	5	36
N LEG STA 100 - 106	333	761	500	0	576	73	400
W LEG STA 205 - 212	13	4411	525	843	136	3	19
E LEG STA 212 - 219	298	6998	811	960	222	4	24
CICERO AVE AT 135th	ST						
S LEG STA 126 - 132	29	366	98	255	342	5	32
N LEG STA 132 - 138	19	478	110	126	474	8	44
W LEG STA 305 - 311	50	615	160	435	485	10	58
E LEG STA 311 - 317	79	328	139	666	225	7	40
CICERO AVE AT CAL S	AG RD						
S LEG STA 148 - 154	70	846	189	585	639	9	53
N LEG STA 154 - 160	121	744	235	0	651	31	185
W LEG STA 400 - 411	140	1212	256	1089	612	9	50
E LEG STA 411 - 417	75	455	126	657	273	4	23
TOTAL	1251	17575	3242	5763	5010	168	964

SIDEWALK, CURB & GUTTER SCHEDULE

LOCATION STATION-STATION	COMB. C&G REMOVAL (FOOT)	COMB. C&G REM & REP >10 FT. (FOOT)	SIDEWALK REMOVAL (SQ FT)	SUBBASE GRAN MAT, TY B 4" (SQ YD)	COMB. CONC. C&G, TY B-6.12 (FOOT)	COMB. CONC. C&G, TY B-6.24 (FOOT)	PCC SIDEWALK 5" (SQ FT)
CICERO AVE AT MIDLO	OTHIAN TPKE						
S LEG STA 94 - 100		42	765	152			1365
N LEG STA 100 - 106	484	54	1543	262		473	2363
W LEG STA 205 - 212							
E LEG STA 212 - 219	460						
CICERO AVE AT 135th	ST						
S LEG STA 126 - 132		132	675	117			1056
N LEG STA 132 - 138		61	783	83			744
W LEG STA 305 - 311							
E LEG STA 311 - 317			207	47			425
CICERO AVE AT CAL S	SAG RD						
S LEG STA 148 - 154	56	63	200	51		59	458
N LEG STA 154 - 160	77		294	73	88	208	656
W LEG STA 400 - 411		35	74	118			1062
E LEG STA 411 - 417							
TOTAL	1077	387	4541	903	88	740	8129

STRUCTURE ADJUSTMENT SCHEDULE

CATCH BASIN ADJ. W. NEW TY. 1 FRAME CL				
STATION	OFFSET			
101+74	34' LT 34' LT			
103+25				
215+94	1' LT			
217+75	0' RT			
TOTAL (EA)	4			

INLET ADJ. W/ NEW TY. 1 FRAME CL					
STATION	OFFSET				
97+90	4' LT				
129+94	3' LT				
150+35	4' LT				
308+13	4' LT				
TOTAL (EA)	4				

FRAMES & GRATES TO BE ADJUSTED					
STATION	OFFSET				
211+05	34' LT				
154+33	34' RT				
155+65	44' LT				
409+03	43' LT				
TOTAL (EA)	4				

FRAMES & LIDS TO BE ADJUSTED						
STATION	OFFSET					
99+17	49' LT					
100+70	49' LT					
101+39	43' RT					
132+51	45' RT					
154+27	55' RT					
154+29	43' RT					
210+97	46' RT					
211+08	45' LT					
212+53	60' LT					

310+14 45' RT

311+25 TOTAL (EA)

47' RT

EARTHWORK SCHEDULE (WIDENING)

LOCATION	CUT	FILL	TS EXC *
STA - STA	(CU YD)	(CU YD)	(CU YD)
100+50 - 101+00	60.5	2.0	8.8
101+00 - 101+50	51.8	1.4	6.2
101+50 - 102+00	54.2	1.4	7.2
102+00 - 102+50	56.5	2.0	7.6
102+50 - 103+00	40.7	1.3	4.4
103+00 - 103+50	24.2	1.4	2.4
103+50 - 104+00	9.0	1.0	1.2
TOTAL	297	10	38

^{*} BASED ON TOPSOIL STRIP DEPTH OF 6" & VAR.


EARTHWORK SCHEDULE


LOCATION STATION-STATION	EARTH EXCAVATION (CU YD)
CICERO AVE AT MIDLO	THIAN TPKE
S LEG STA 94 - 100	52
N LEG STA 100 - 106	521*
W LEG STA 205 - 212	170
E LEG STA 212 - 219	271
CICERO AVE AT 135th	ST
S LEG STA 126 - 132	55
N LEG STA 132 - 138	58
W LEG STA 305 - 311	54
E LEG STA 311 - 317	48
CICERO AVE AT CAL S	AG RD
S LEG STA 148 - 154	76
N LEG STA 154 - 160	70
W LEG STA 400 - 411	130
E LEG STA 411 - 417	42
TOTAL	1547
INCL 297 CH VD WIDE	WING EARTH EY


^{*} INCL. 297 CU YD WIDENING EARTH EX.


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	DRAWN -	REVISED -
PLOT SCALE = 40.0000 / in.	CHECKED - JPO	REVISED -
PLOT DATE = 12/5/2022	DATE - 12/05/2022	REVISED -

			F.A.P RTE. SECTION		COUNTY	TOTAL SHEETS	SHEE NO.			
	SCHEDULE OF QUANTITIES			350	2021-054-N&SW			COOK	167	28
								CONTRAC	T NO. 62	2N85
	SCALE: N.T.S.	SHEET 1 OF 1 SHEETS STA. N/A	TO STA. N/A			ILLINOIS	FED. AI	D PROJECT		

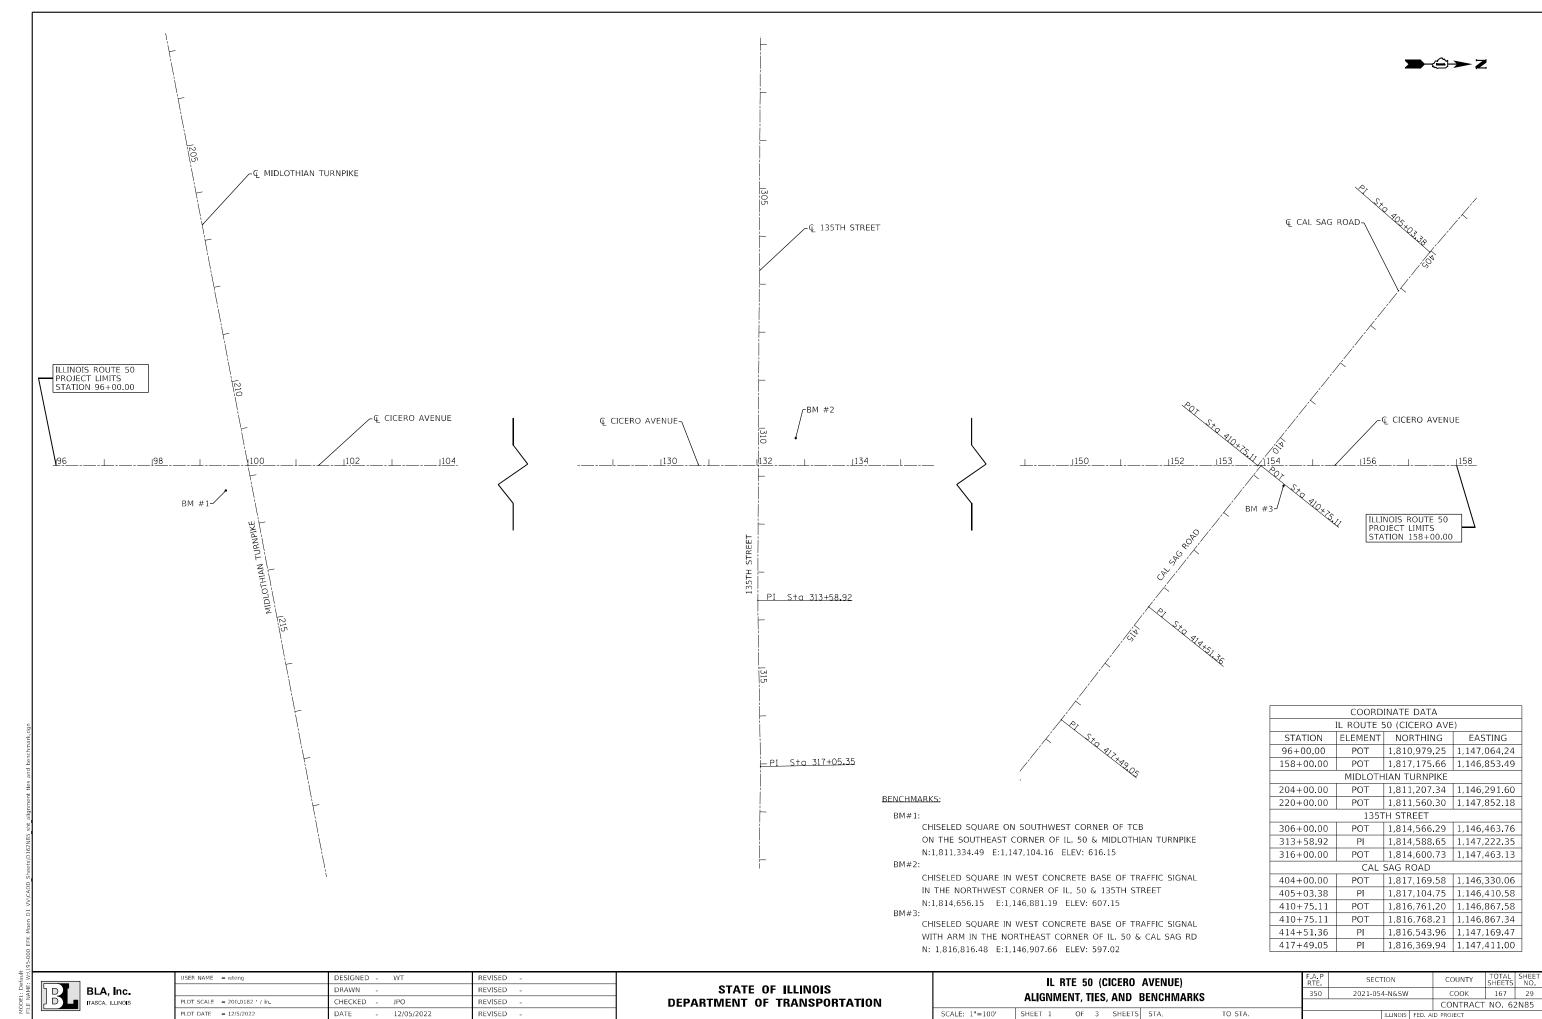

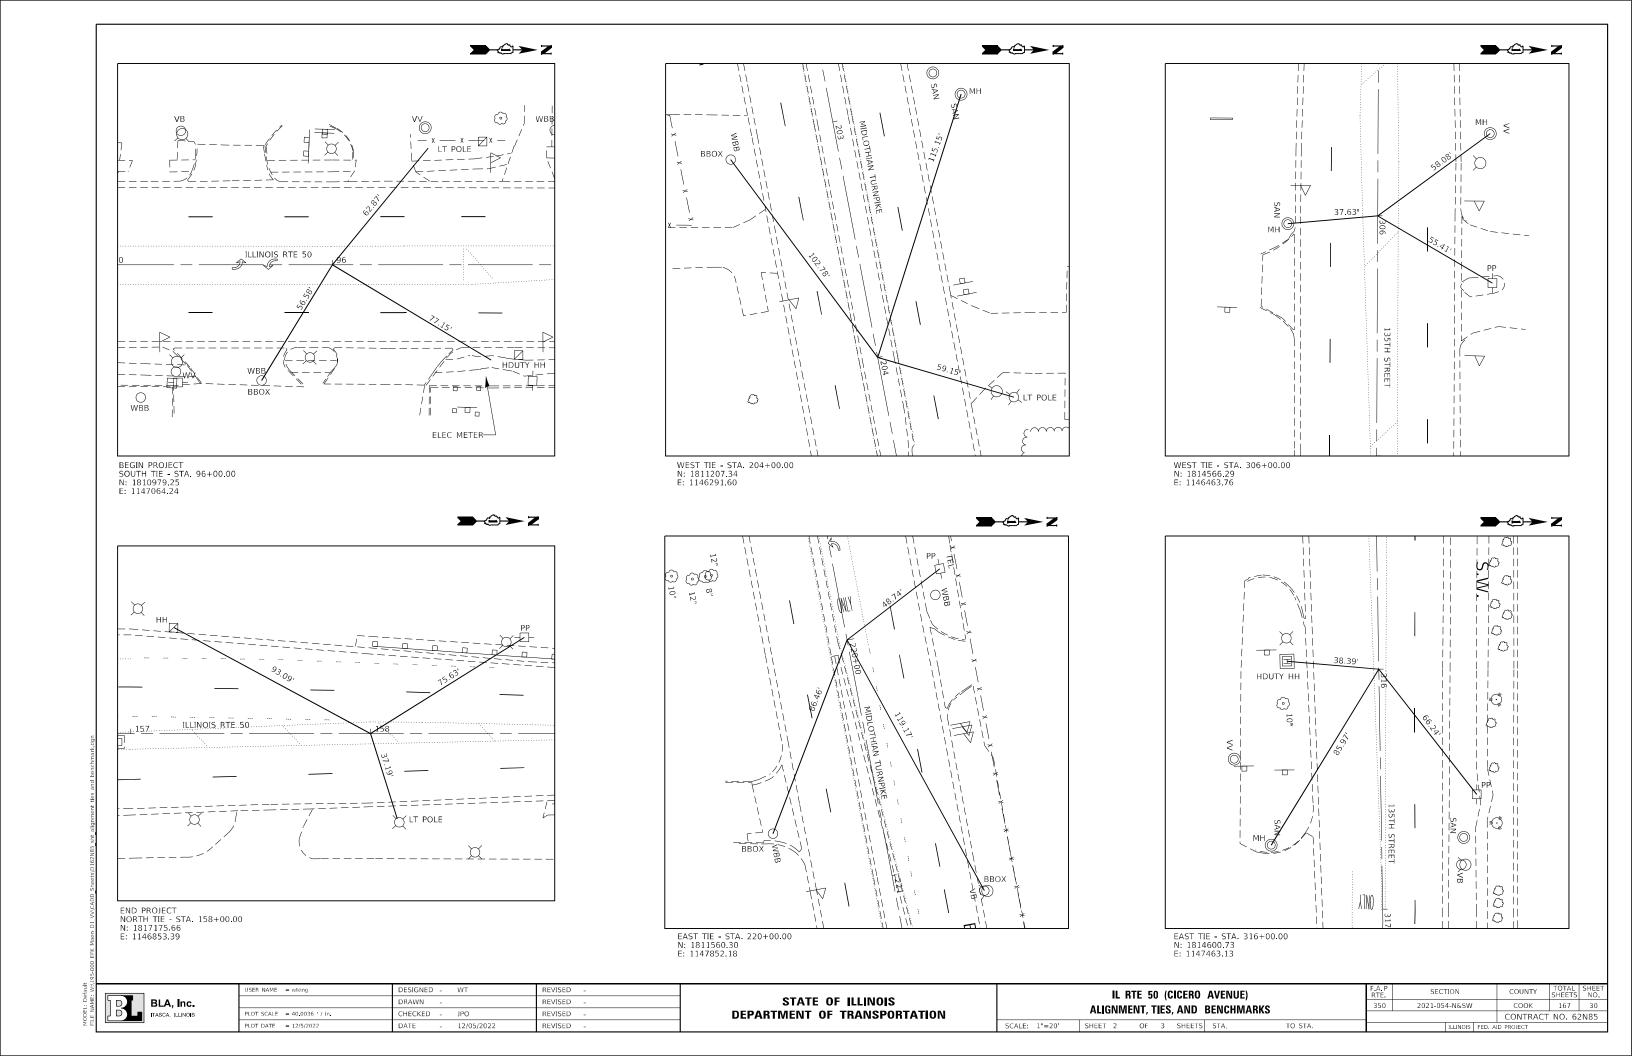

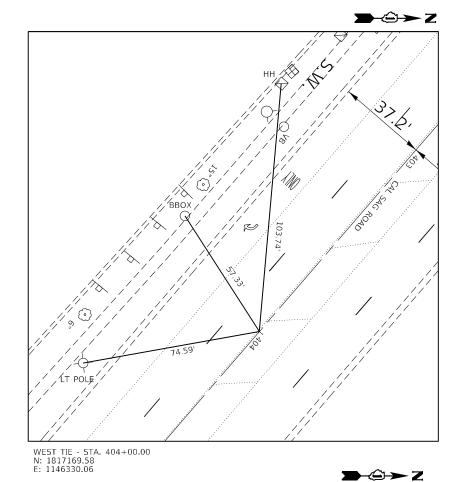

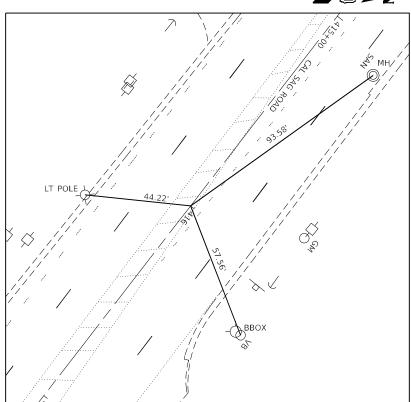

EAST TIE - STA. 416+00.00 N: 1816457.07 E: 1147290.07

	USER NAME = wteng	DESIGNED	-	WT	REVISED -	
		DRAWN	-		REVISED -	
ı	PLOT SCALE = 40.0036 / in	CHECKED	-	JPO	REVISED -	
	PLOT DATE = 12/5/2022	DATE	-	12/05/2022	REVISED -	

DEPARTMENT OF TRANSPORTATION


IL RTE 50 (CICERO AVENUE) ALIGNMENT, TIES, AND BENCHMARKS SCALE: 1"=20" SHEET 3 OF 3 SHEETS STA. TO STA.

SECTION 2021-054-N&SW COOK 167 31 CONTRACT NO. 62N85

ILLINOIS RTE 50

→©→ Z


NORTH TIE #1 CAL SAG ROAD STA. 410+75.11 ILLINOIS RTE 50 STA. 153+85.61 N: 1816761.20 E: 1146867.58

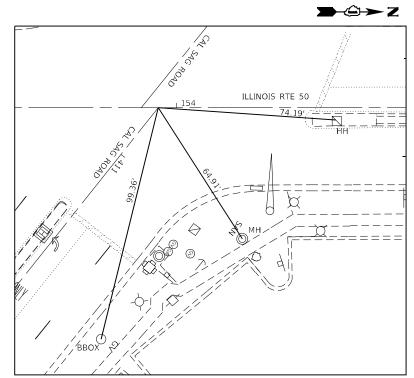



NORTH TIE #2 CAL SAG ROAD STA. 410+75.11 ILLINOIS RTE 50 STA. 153+92.31 N: 1816768.21 E: 1146867.34


BLA, Inc.


STATE OF ILLINOIS

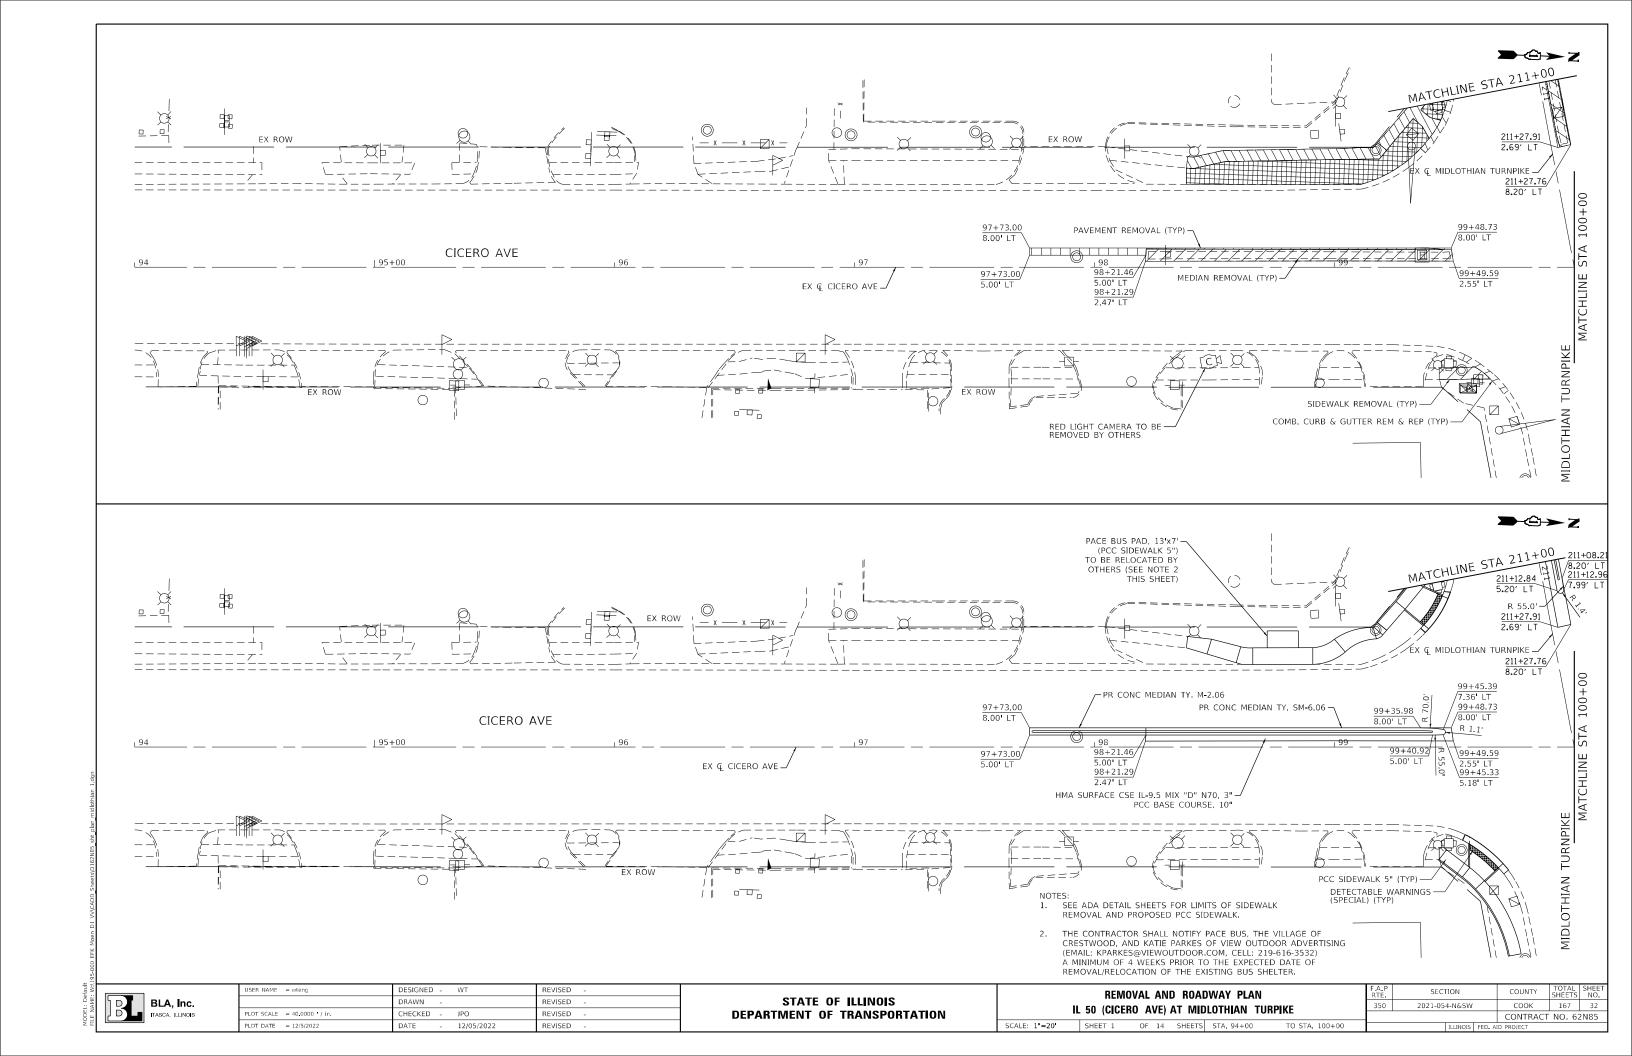


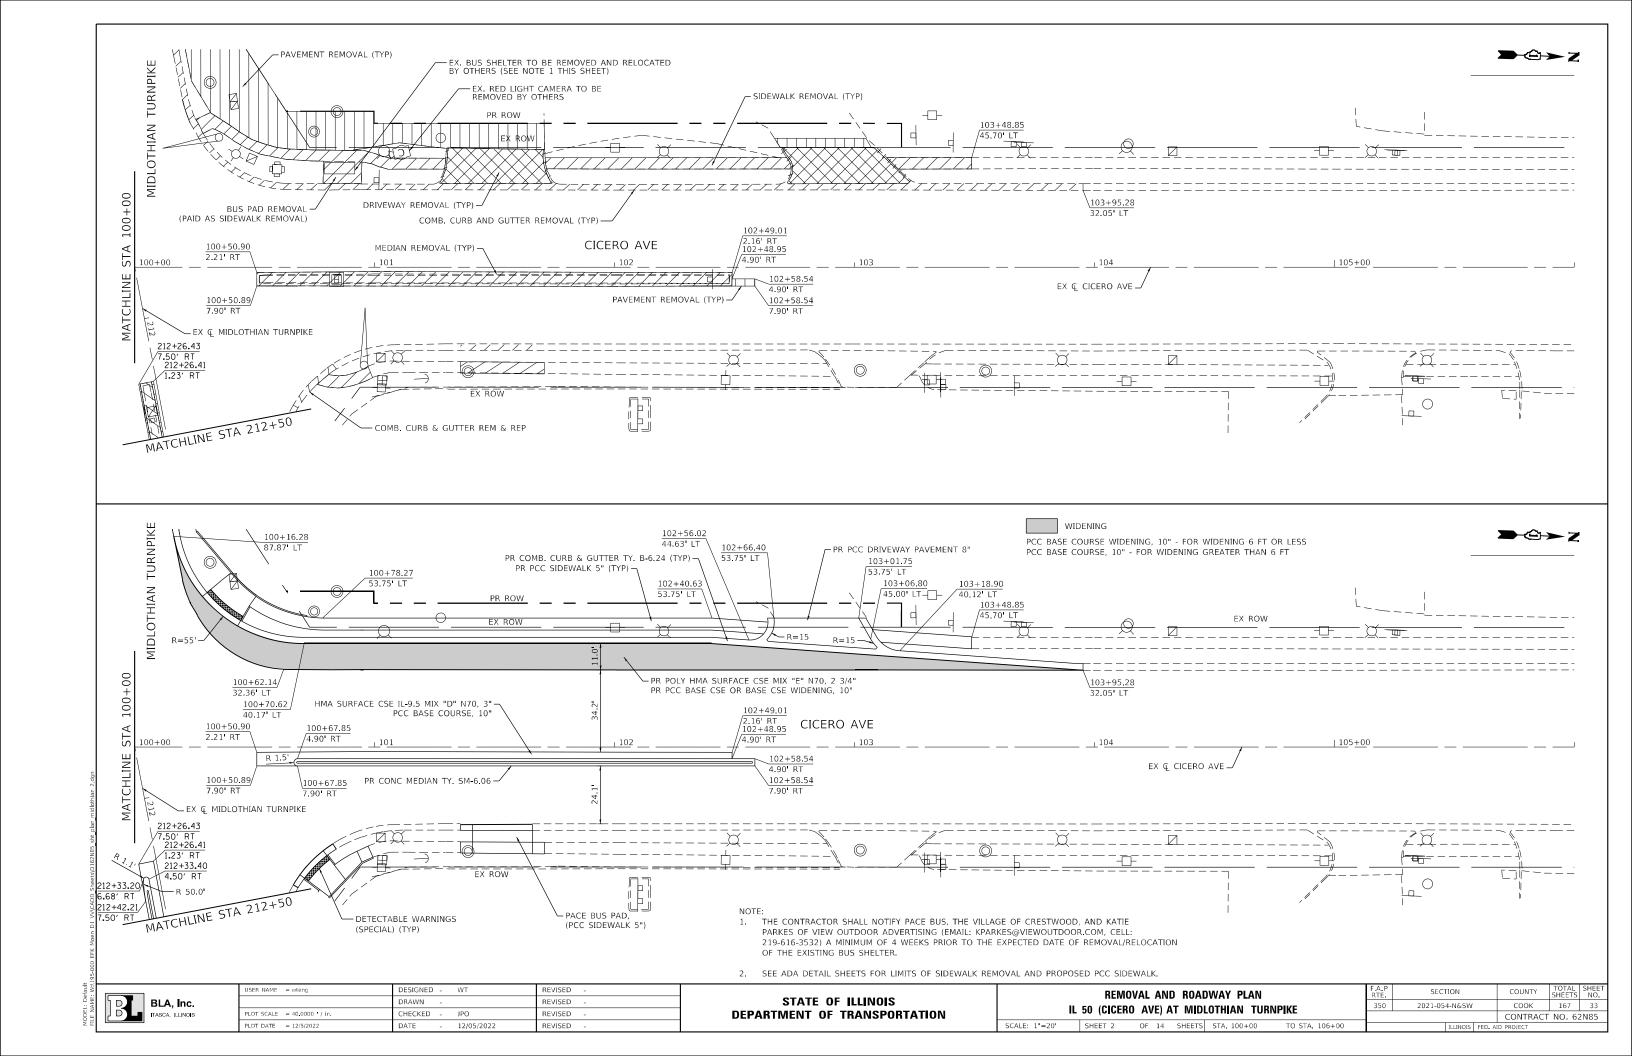


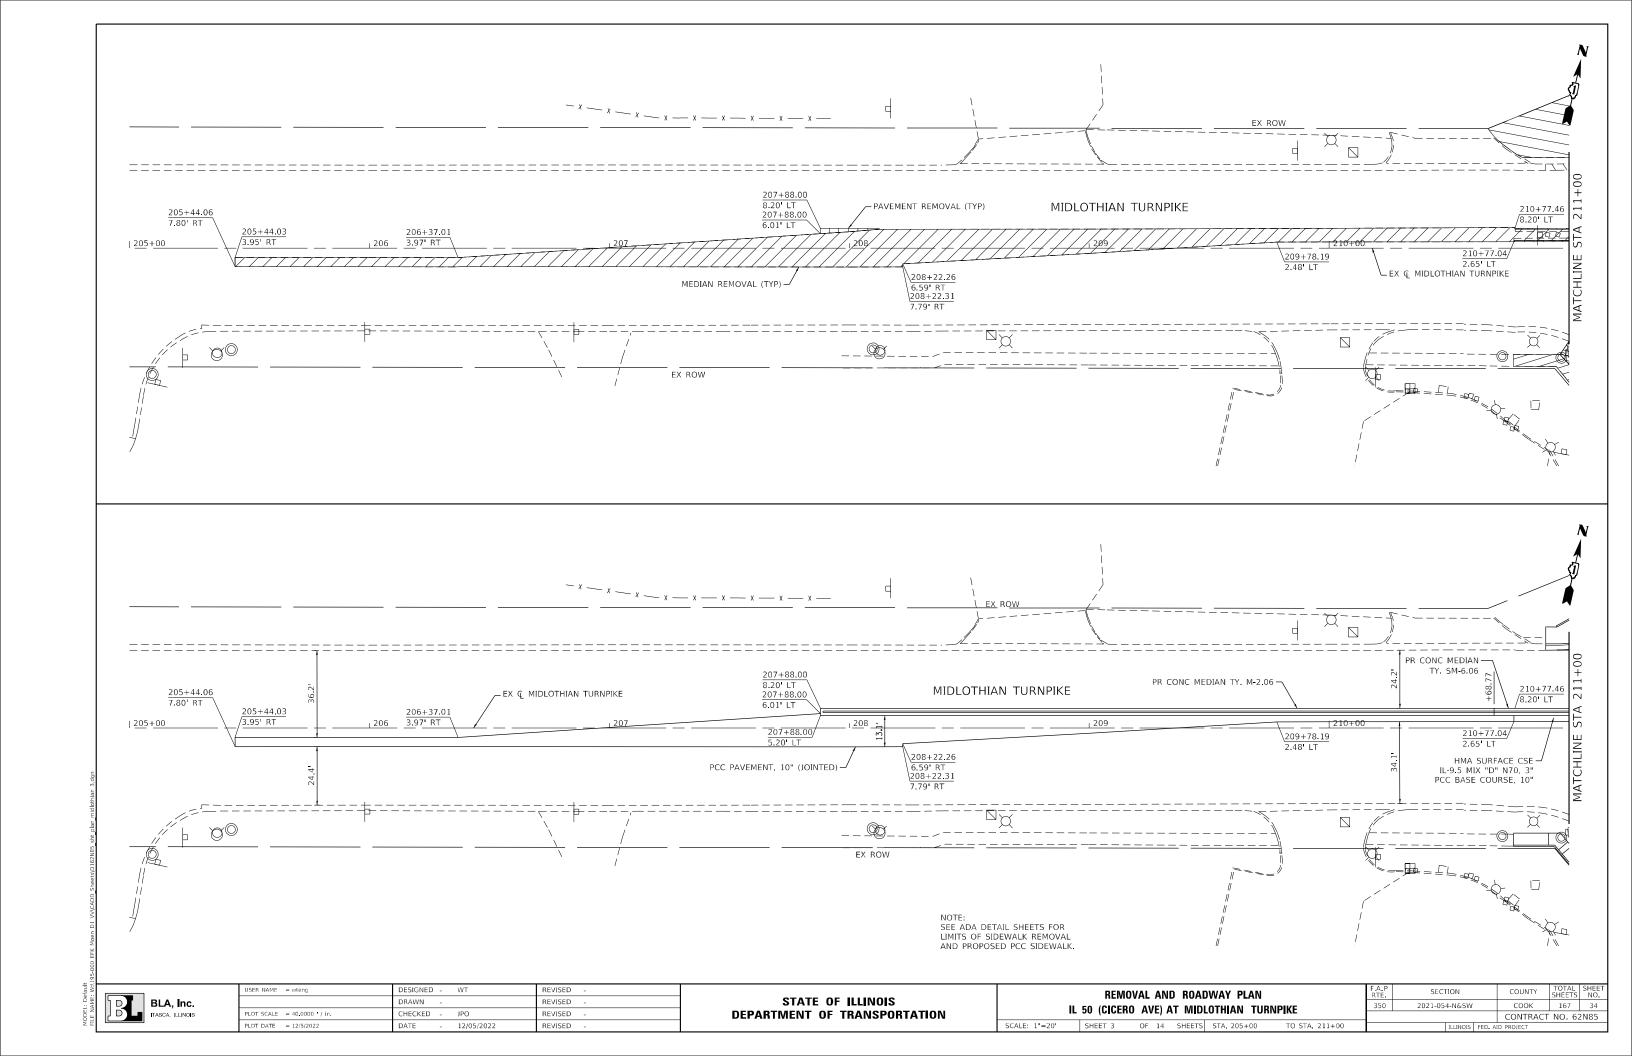


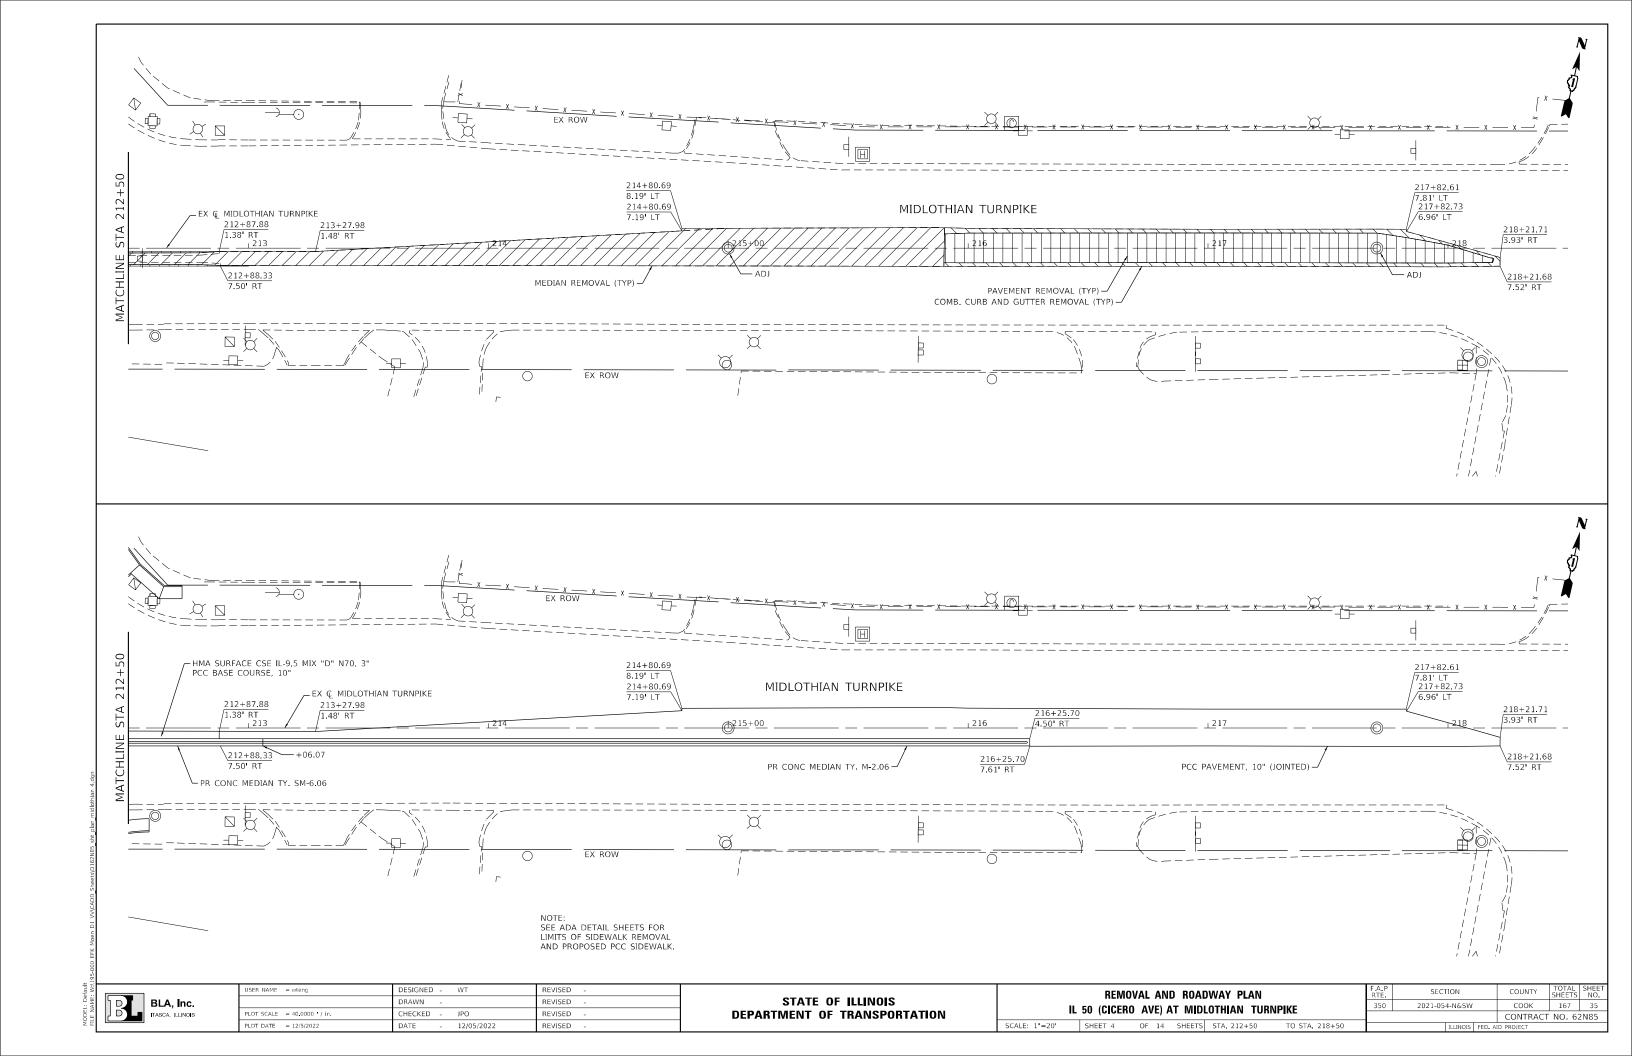


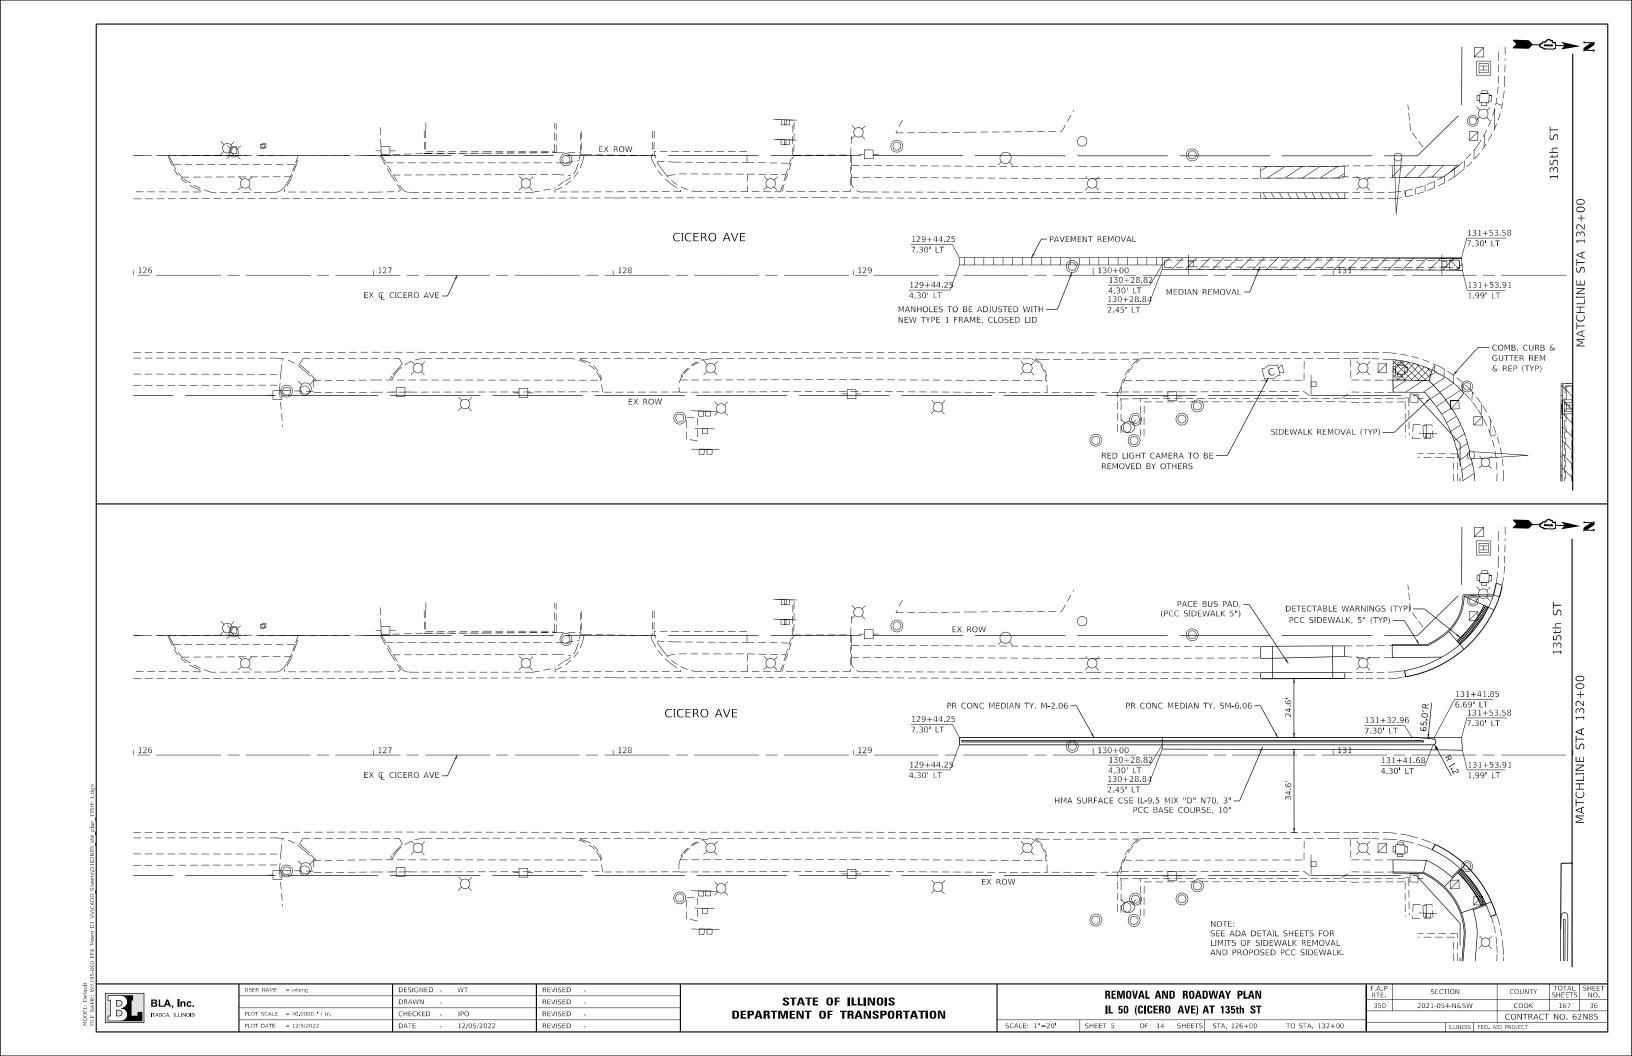


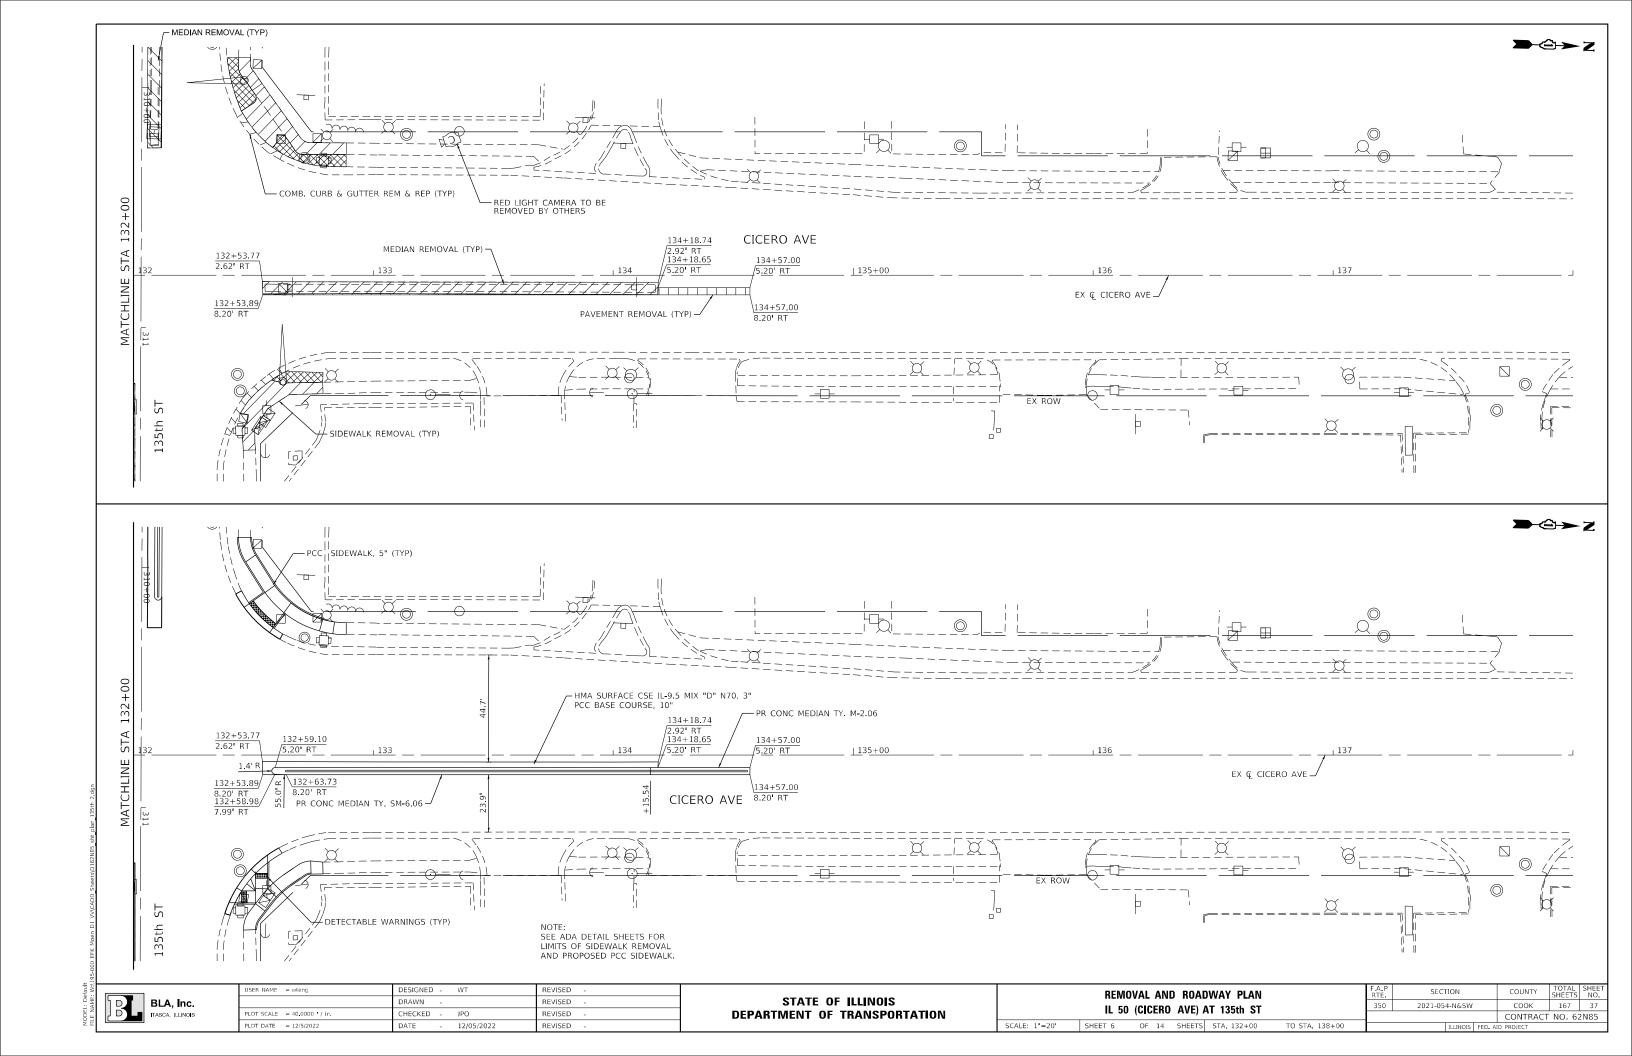


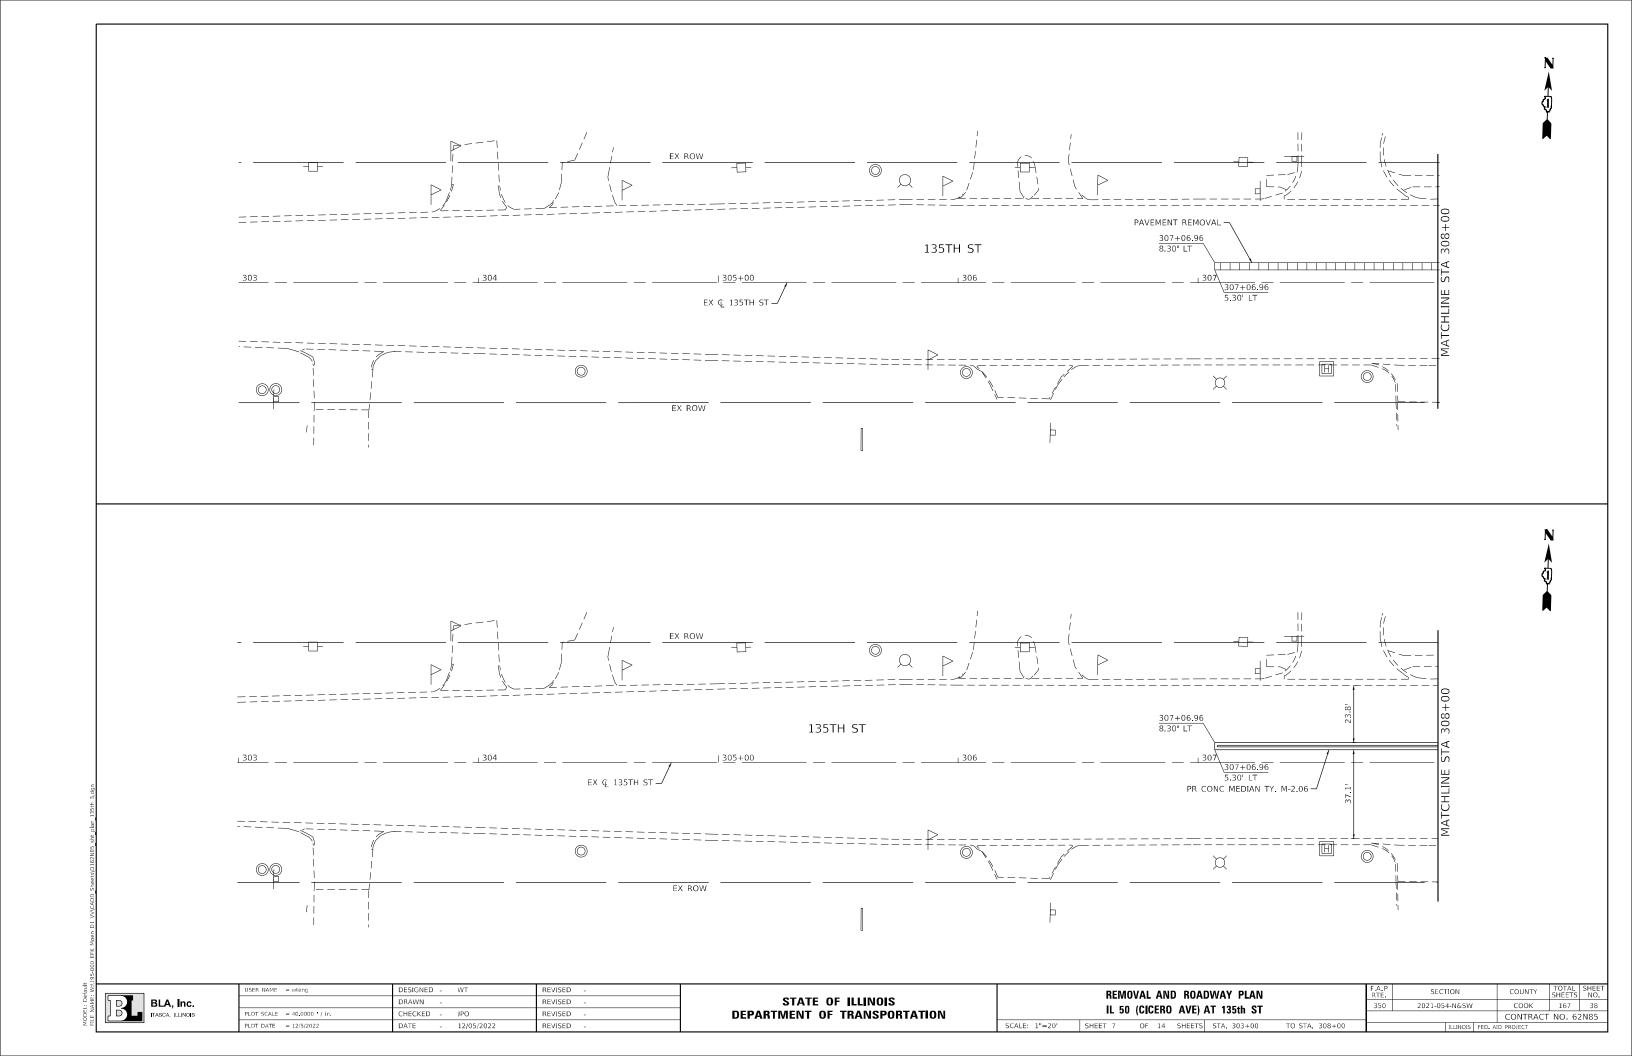


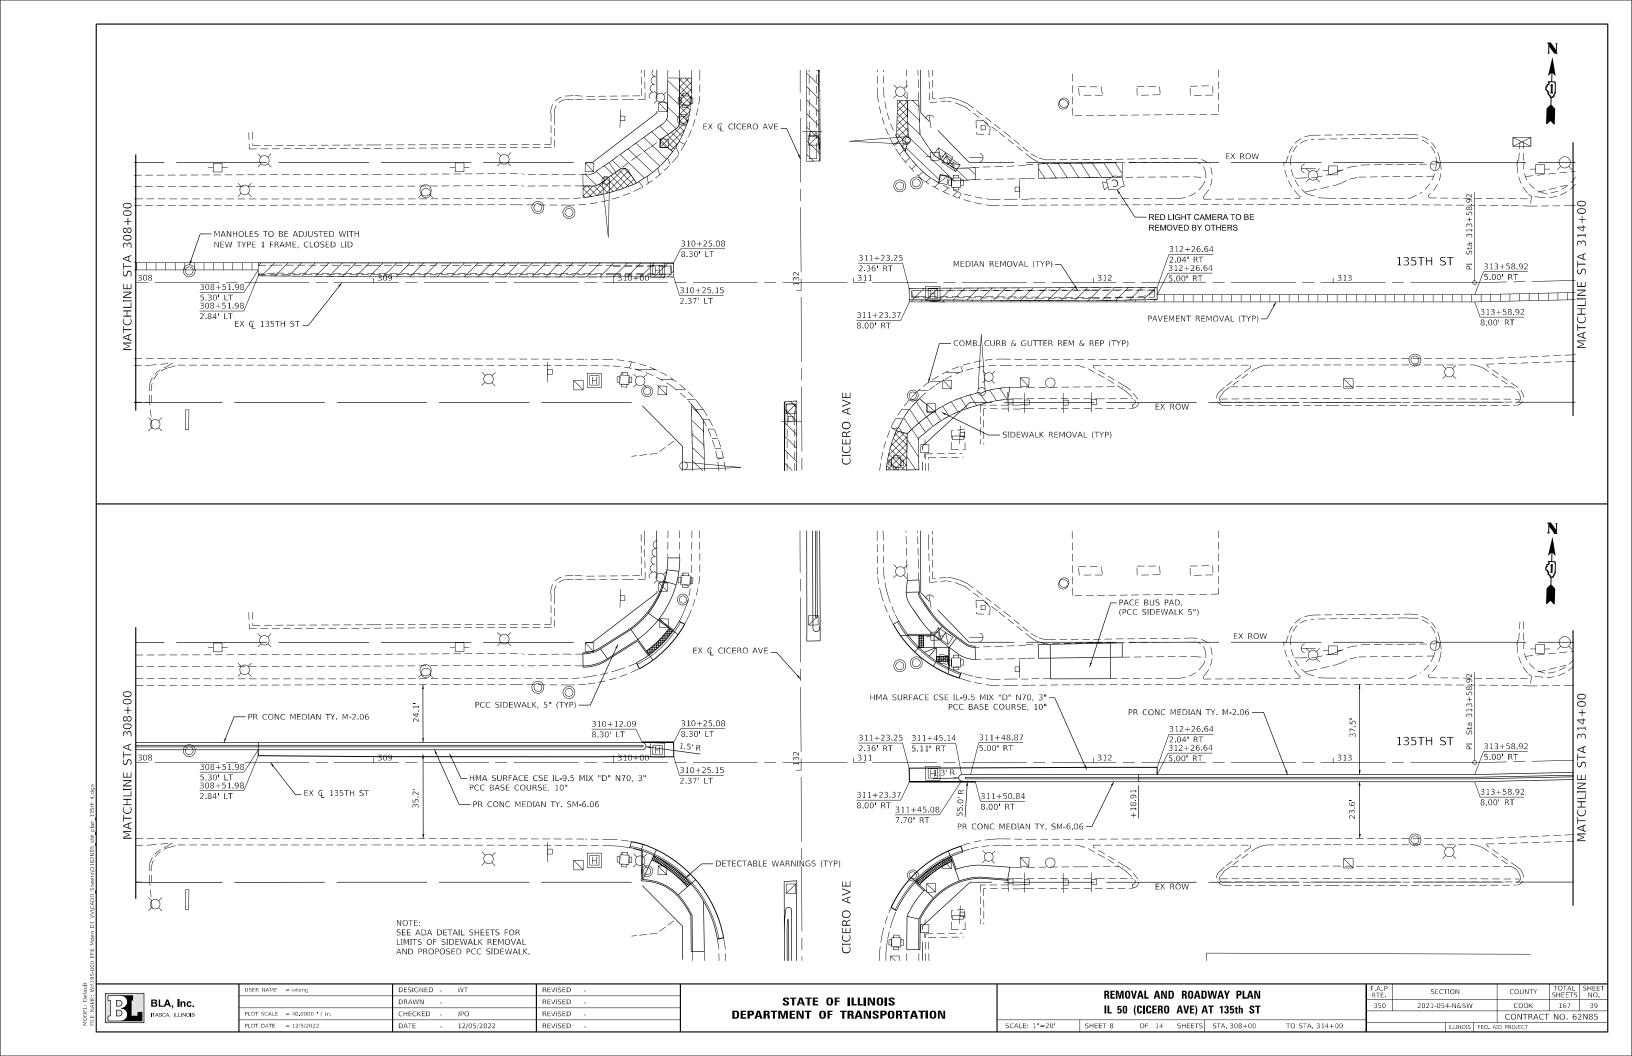


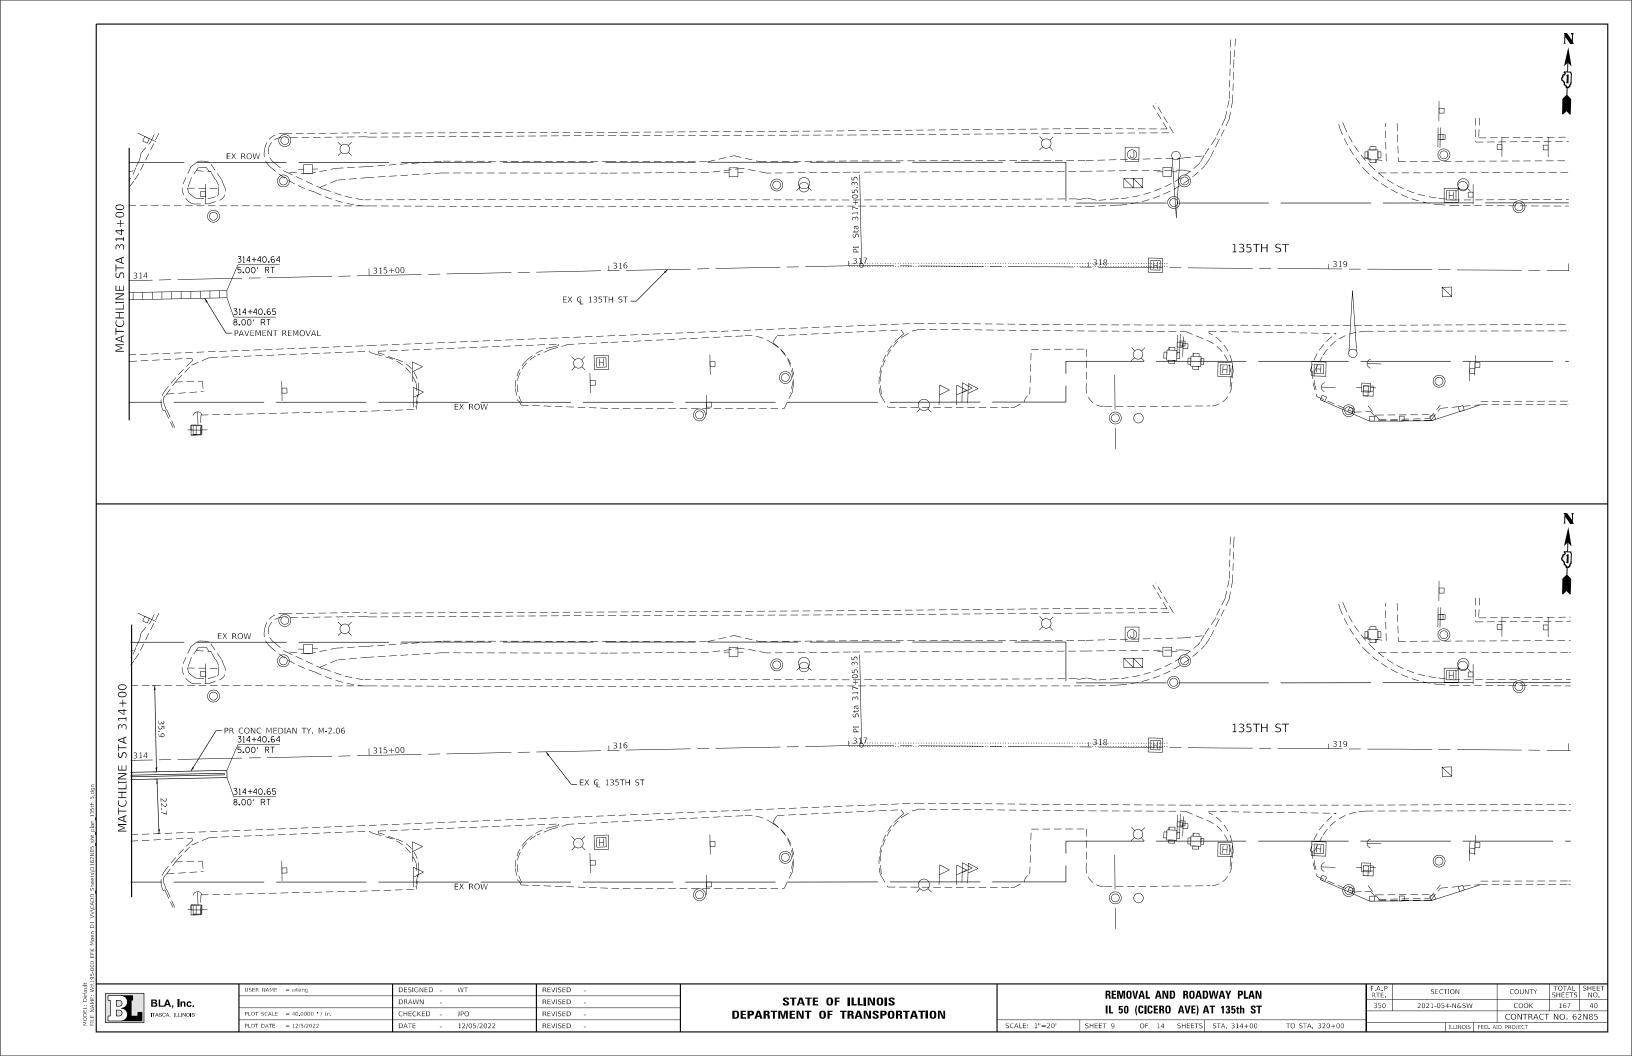


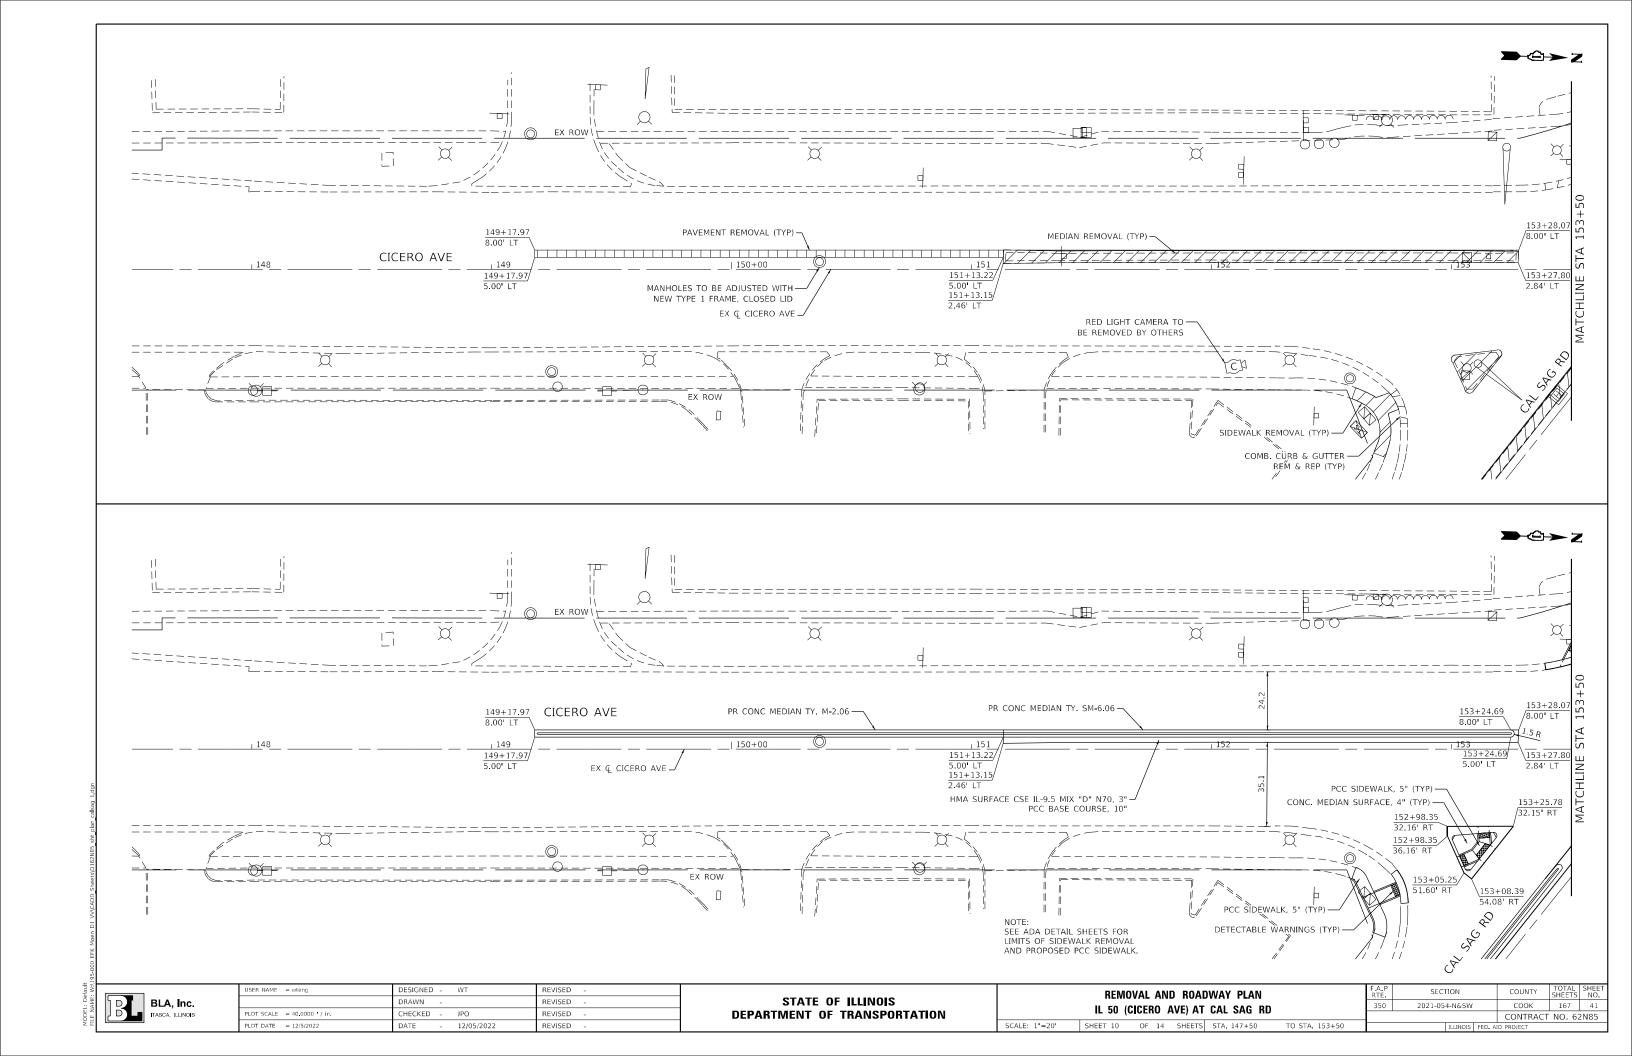

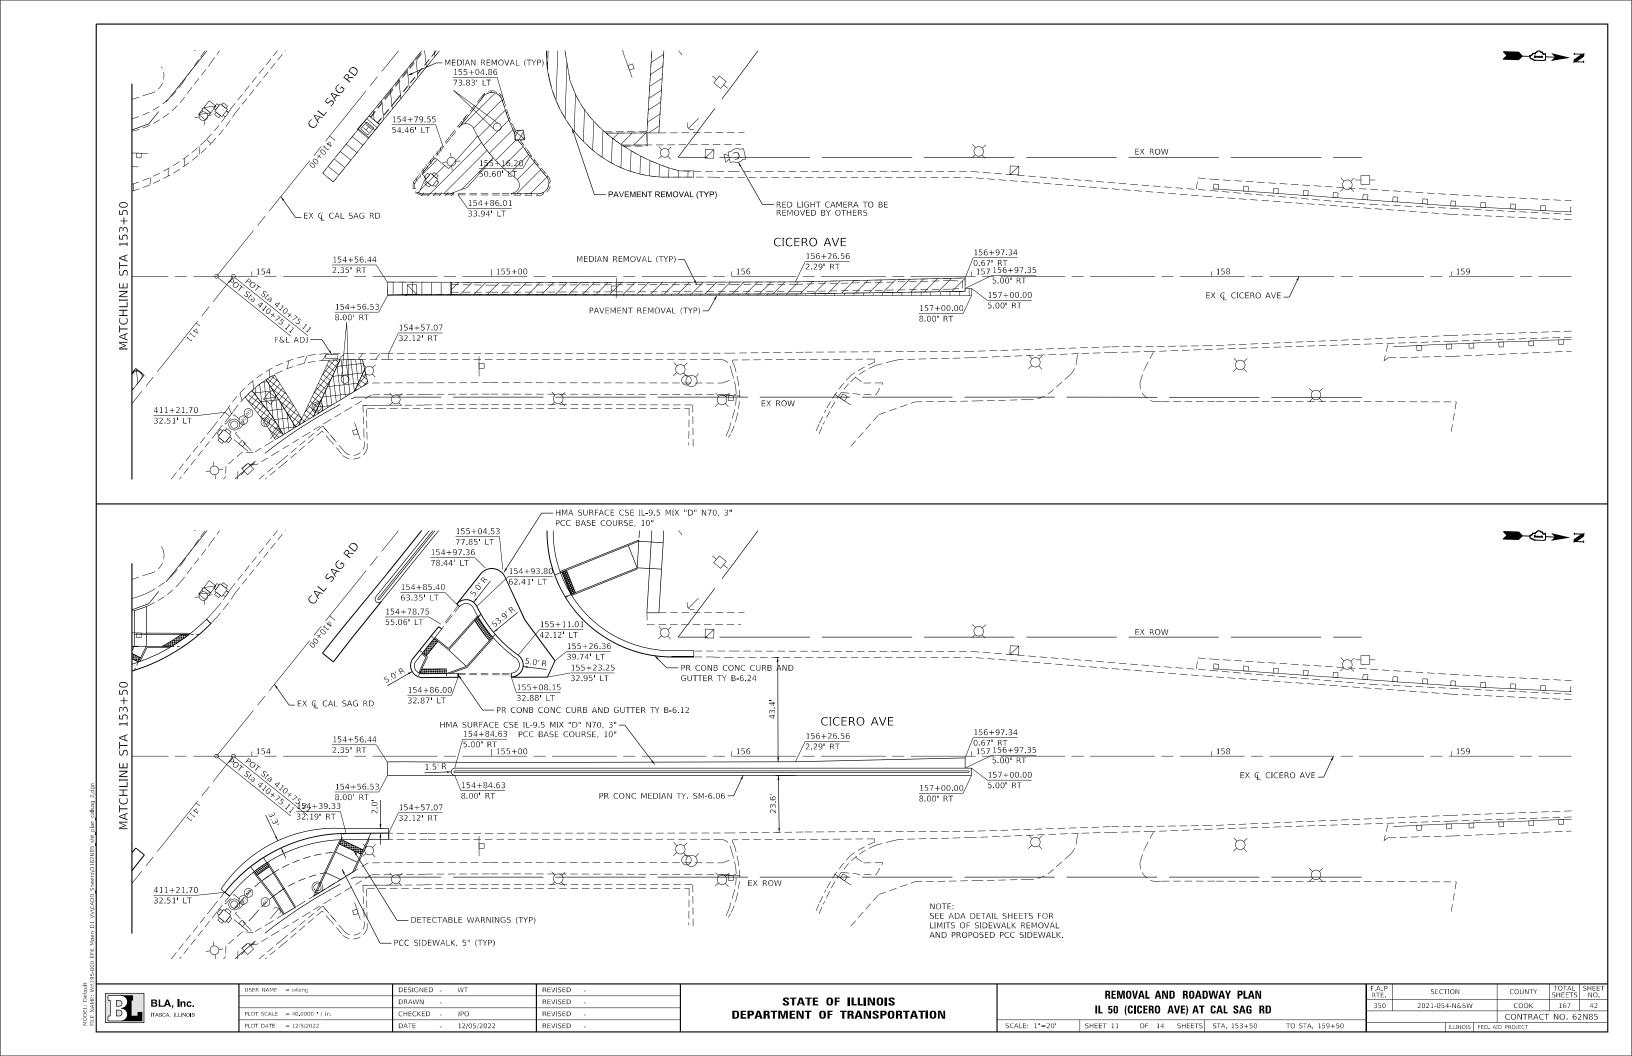

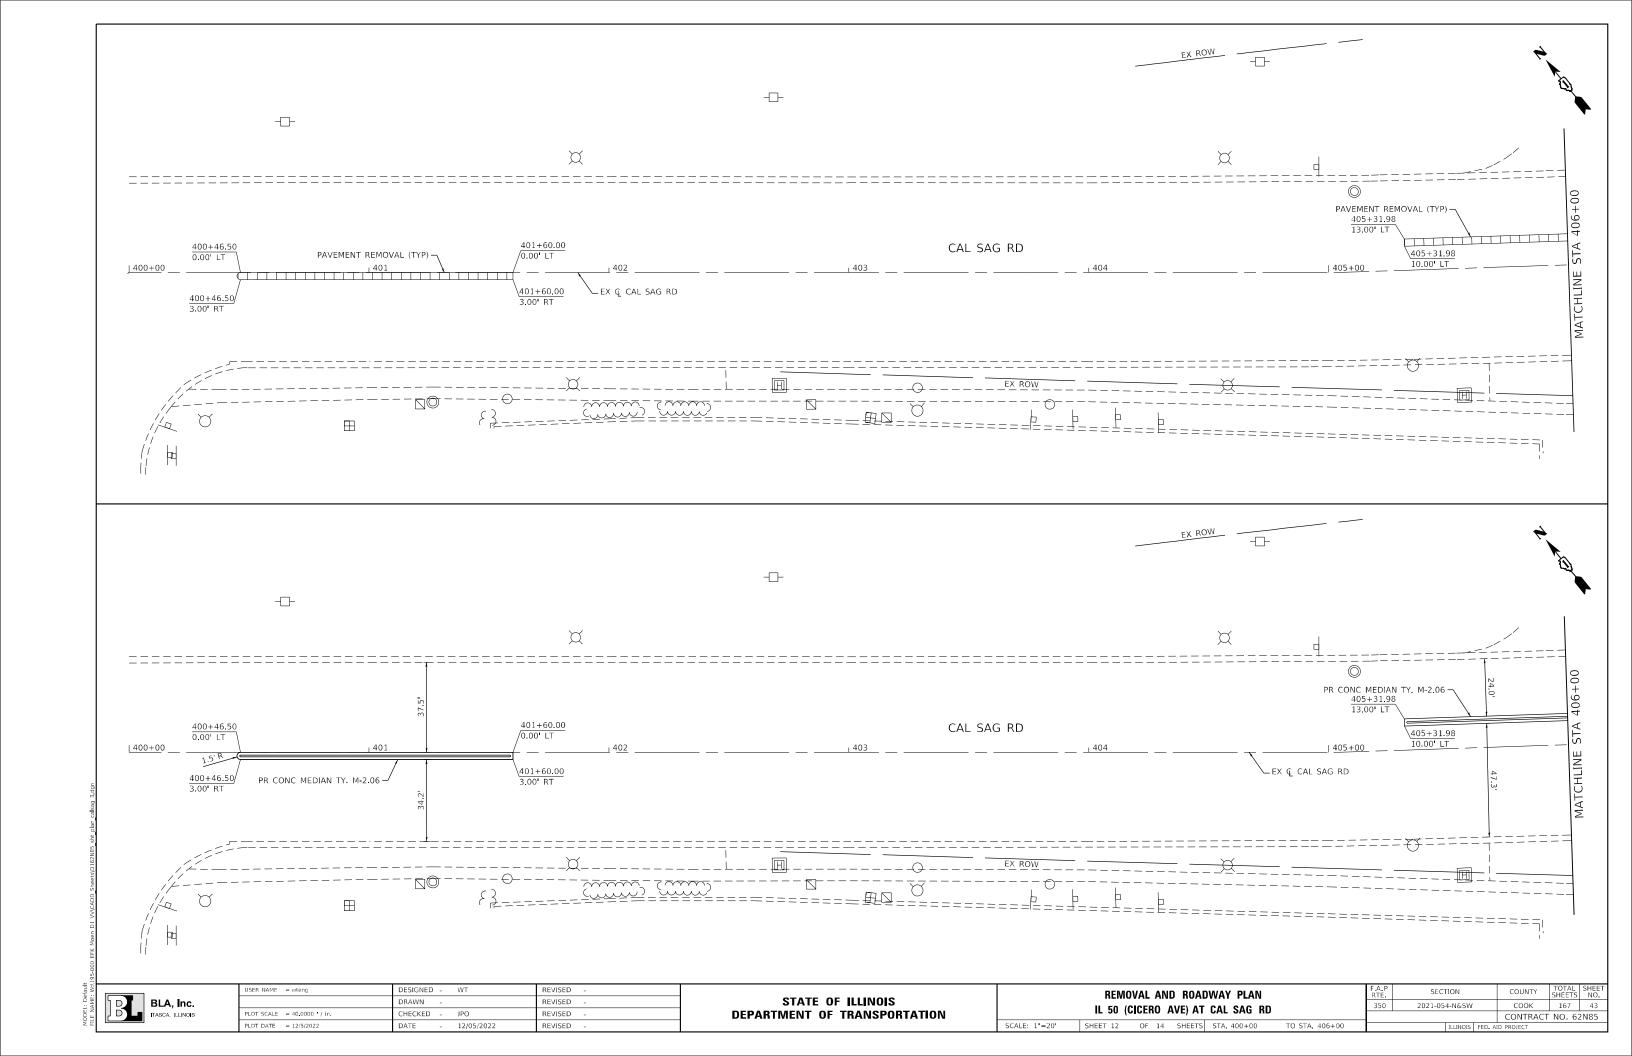

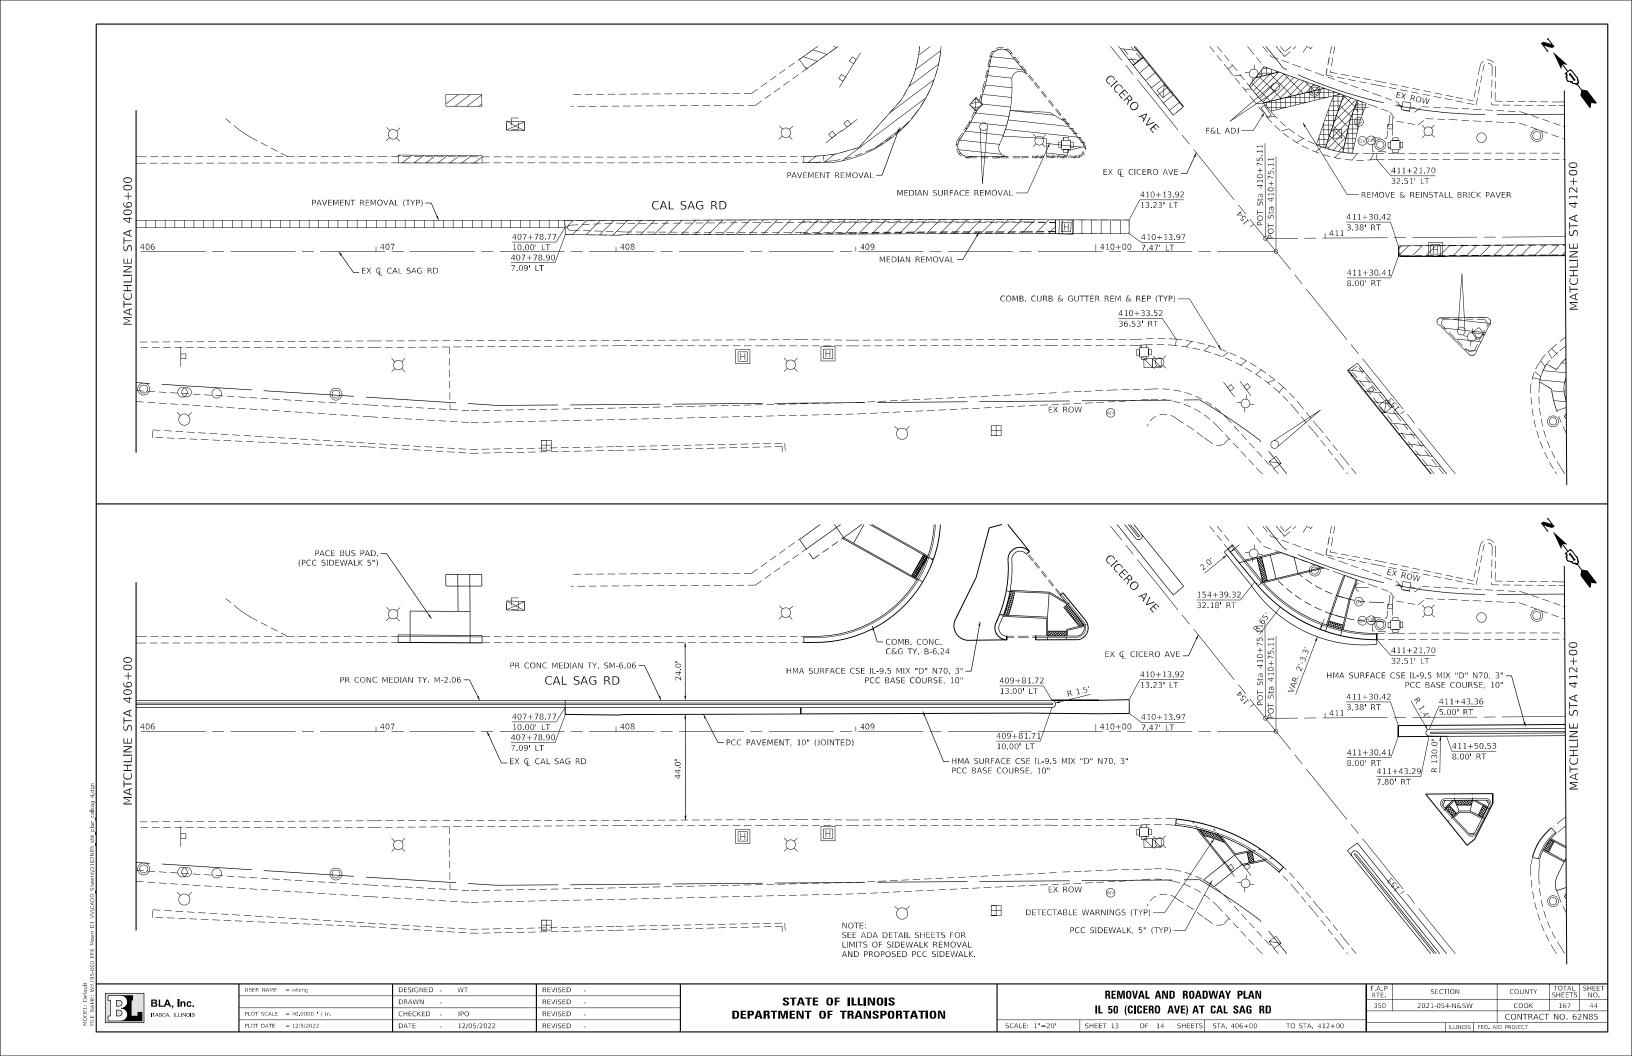

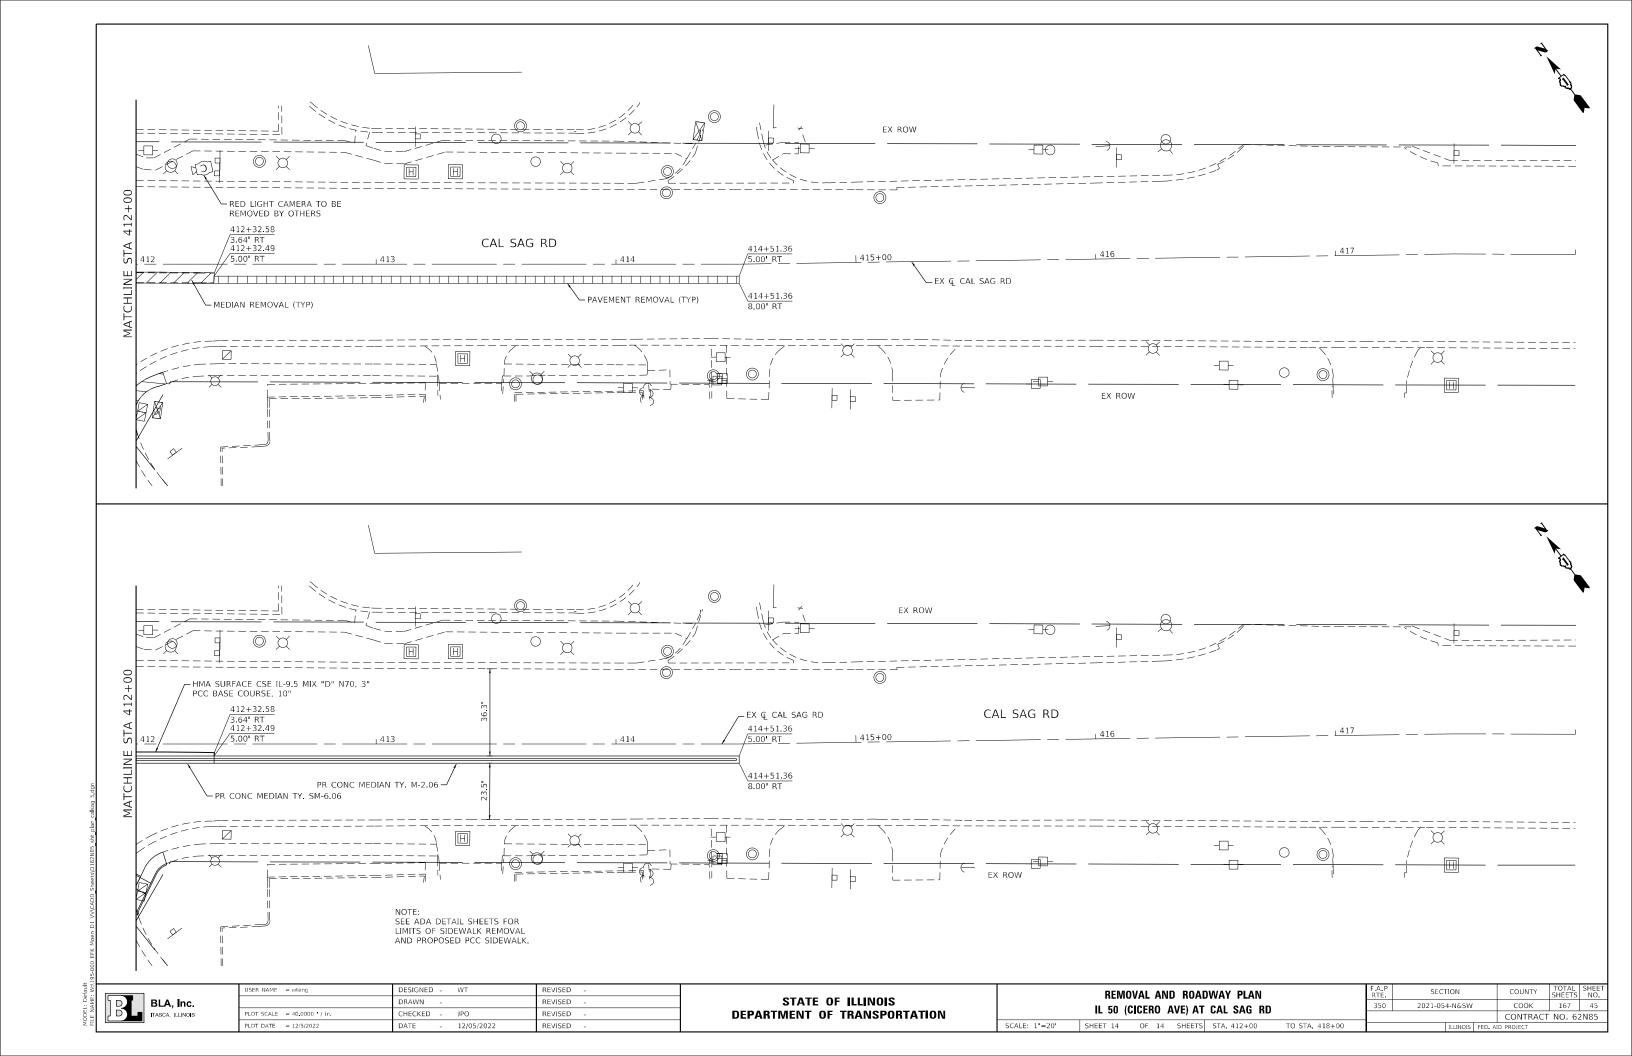

MAINTENANCE OF TRAFFIC GENERAL NOTES

- 1. ALL OF THE TRAFFIC CONTROL DEVICES SHALL BE IN PLACE BEFORE CONSTRUCTION IS STARTED. TEMPORARY TRAFFIC SIGNALS SHALL BE CONSTRUCTED AT THE INTERSECTIONS NOTED IN THE PLANS. TEMPORARY INTERSECTION SIGNALIZATION SHALL BE ADJUSTED TO ACCOMMODATE THE VARIOUS STAGES OF CONSTRUCTION SHOWN. THE TRAFFIC CONTROL PLANS SHALL SERVE AS A GUIDE FOR THE SAFE DIVERSION OF TRAFFIC DURING EXECUTION OF THIS CONTRACT.
- 2. IT WILL BE THE CONTRACTOR'S RESPONSIBILITY TO PROVIDE INFORMATIONAL SIGNS ON TEMPORARY SUPPORTS FOR DRIVEWAYS. THESE SIGNS SHALL BE WHITE ON GREEN IN ACCORDANCE WITH THE MANUAL FOR UNIFORM TRAFFIC CONTROL DEVICES. ALSO, "CAUTION NEW LANES OPEN STOP HERE" SIGNS WILL BE THE CONTRACTOR'S RESPONSIBILITY TO PROVIDE AT THE APPROPRIATE LOCATIONS. THIS WORK WILL BE PER DISTRICT DETAIL TC-26 INCLUDED IN THE VARIOUS ITEMS FOR "TEMPORARY INFORMATION SIGNAGE".
- 3. PORTABLE CHANGEABLE MESSAGE SIGN SHALL BE PLACED BEYOND THE NORTH AND SOUTH PROJECT LIMITS ON ILLINOIS RTE 50, ALL SIDE ROADS WITHIN THE PROJECT LIMITS, AND AS DIRECTED BY THE ENGINEER. IT SHALL BE PAID FOR AS "CHANGEABLE
- 4. THE CONTRACTOR WILL GIVE THE ENGINEER AT LEAST 10 DAYS NOTICE PRIOR TO ANY TRAFFIC STAGING CHANGES.
- PEDESTRIAN AND BICYCLE ACCESS MUST BE MAINTAINED ON ALL EXISTING FACILITIES AND ON NEW FACILITIES AS THEY BECOME AVAILABLE FOR PEDESTRIAN AND BICYCLE
- 6. THE CONTRACTOR SHALL CONTACT THE TRAFFIC CONTROL SUPERVISOR AT KALPANA.KANNAN-HOSADURGA@ILLINOIS.GOV A MINIMUM OF 72 HOURS IN ADVANCE OF BEGINNING WORK
- 7. ARROW BOARDS SHALL HAVE SOLAR POWER CAPABILITY.
- 8. STOP SIGNS AND STOP BARS ARE TO BE MAINTAINED FOR UNSIGNALIZED SIDE STREETS AND DRIVEWAYS THROUGH ALL CONSTRUCTION STAGES IN WHICH THEY ARE TO BE
- 9. POSITIVE DRAINAGE WITHIN THE WORK ZONE MUST BE MAINTAINED AT ALL TIMES TO THE SATISFACTION OF THE RESIDENT ENGINEER. WHEN EXISTING DRAINAGE FACILITIES ARE DISTURBED, THE CONTRACTOR SHALL PROVIDE AND MAINTAIN TEMPORARY INLETS OUTLETS. AND CONNECTIONS FOR ALL EXISTING AND PROPOSED FACILITIES INCLUDING TEMPORARY PUMPING IF NECESSARY, TEMPORARY ACCOMMODATIONS SHALL BE MAINTAINED UNTIL SUCH TIME AS THE PERMANENT CONNECTIONS WITH SEWERS ARE BUILT AND IN SERVICE AND THE FINAL SHAPING AND GRADING OF DITCHES IS PERFORMED. THE COST OF ALL LABOR, EQUIPMENT, AND MATERIALS (TEMPORARY OR PERMANENT USED AS TEMPORARY) TO COMPLY WITH THIS REQUIREMENT WILL NOT BE PAID FOR DIRECTLY, BUT THE COST SHALL BE CONSIDERED INCLUDED IN THE PROPOSED ITEMS OF WORK IN THE CONTRACT.
- 10. THE CONTRACTOR SHALL NOTE LOCATIONS OF ALL PAVEMENT MARKINGS OUTSIDE OF THE PROJECT LIMITS FOR RESTORATION PURPOSES.
- 11. THE CONTRACTOR SHALL MAINTAIN ACCESS TO ALL SIDE STREETS AND DRIVEWAYS BY UTILIZING STAGED CONSTRUCTION, FLAGGERS, TEMPORARY ACCESSES, OR OTHER METHODS APPROVED BY THE ENGINEER. THIS WORK SHALL NOT BE CONSIDERED FOR ADDITIONAL PAYMENT, BUT SHALL BE CONSIDERED INCLUDED IN THE COST OF THE ITEMS OF WORK
- 12 THE CONTRACTOR SHALL PROVIDE AT LEAST 48 HOURS PRIOR NOTICE TO THE RESIDENT ENGINEER, VILLAGE OF CRESTWOOD EMERGENCY SERVICES, SCHOOLS, AND POST OFFICE PRIOR TO IMPLEMENTING LANE CLOSURES OR MAJOR TRAFFIC CONTROL CHANGES.
- 13. IF THE CONTRACTOR MUST FULLY CLOSE AN EXISTING DRIVEWAY OR SIDE STREET, THE CONTRACTOR MUST MAINTAIN A TEMPORARY ACCESS. THE CONTRACTOR SHALL GIVE AT LEAST ONE WEEK PRIOR WRITTEN NOTICE OF DRIVEWAY OR SIDE STREET CLOSURES TO THE ENGINEER, THE VILLAGE, EMERGENCY SERVICES, SCHOOLS, AND THE LOCAL POST OFFICE. DIRECTIONAL SIGNAGE SHALL BE PROVIDED TO REDIRECT DRIVERS AND PATRONS OF AFFECTED BUSINESSES TO ACCESS PROPERTIES BY ALTERNATE ROUTES. THIS WORK SHALL BE COORDINATED BY THE RESIDENT ENGINEER. ANY REDIRECTING SIGNAGE SHALL BE PAID FOR AS "TEMPORARY INFORMATION SIGNAGE" AND SHALL BE PAID FOR AT THE CONTRACT UNIT PRICE. ANY ITEMS FOR CLOSURE OF THE DRIVES INCLUDING TYPE III BARRICADES SHALL NOT BE PAID FOR SEPARATELY BUT SHALL BE
- 14. THE CONTRACTOR SHALL REMOVE OR COVER ALL W21-1 (WORKERS PRESENT) AND W20-7 (FLAGGER) SIGNS, WITHIN AN HOUR, WHEN WORKERS ARE NOT PRESENT OR IF THE SIGN IS NOT APPLICABLE.
- 15. THE CONTRACTOR SHALL BE REQUIRED TO PLACE AGGREGATE SUBGRADE AT ALL DROP-OFFS GREATER THAN 12-IN BY THE END OF THE SAME WORKING DAY DURING WHICH THE DROP-OFFS WERE CREATED. ANY OTHER OPENINGS GREATER THAN 12-IN DEPTH WITHIN THE CLEAR ZONE SHALL BE PROTECTED WITH A TRAVERSABLE COVER BY THE END OF THE WORKING DAY.

SUGGESTED SEQUENCE OF CONSTRUCTION

SET UP WORK ZONES USING DAYTIME CLOSURES OF THE INNER TRAVEL LANES AT THE SOUTH AND WEST APPROACHES OF EACH INTERSECTION, REDUCING INBOUND TRAFFIC TO ONE LANE IN EACH DIRECTION DURING OFF-PEAK HOURS ONLY. CONSTRUCT CONCRETE MEDIAN AND PAVED MEDIAN (WHERE APPLICABLE). CONSTRUCT CURB RAMPS AND PACE BUS PADS AT THE NORTHEAST AND SOUTHEAST CORNERS OF EACH INTERSECTION. DURING PEAK AND NIGHTTIME HOURS, MAINTAIN ONE LEFT TURN LANE AND TWO THROUGH LANES OF MINIMUM 10-FT. WIDTH AT EACH APPROACH AS SHOWN ON THE PLANS.

SET UP WORK ZONES USING DAYTIME CLOSURES OF THE INNER TRAVEL LANES AT THE NORTH AND EAST APPROACHES OF EACH INTERSECTION, REDUCING INBOUND TRAFFIC TO ONE LANE IN EACH DIRECTION DURING OFF-PEAK HOURS ONLY. CONSTRUCT CONCRETE MEDIAN AND PAVED MEDIAN (WHERE APPLICABLE). CONSTRUCT CURB RAMPS AND PACE BUS PADS AT THE NORTHWEST AND SOUTHWEST CORNERS OF EACH INTERSECTION. DURING PEAK AND NIGHTTIME HOURS, MAINTAIN ONE LEFT TURN LANE AND TWO THROUGH LANES OF MINIMUM 10-FT. WIDTH AT EACH APPROACH AS SHOWN ON THE PLANS.


STAGE III

AT THE NORTH APPROACH OF IL RTE 50 AND MIDLOTHIAN TURNPIKE, SET UP WORK ZONE USING DAYTIME CLOSURE OF THE OUTER SOUTHBOUND LANE DURING OFF-PEAK HOURS ONLY. CONSTRUCT SOUTHBOUND WIDENING, DRIVEWAYS, SIDEWALK AND DRAINAGE IMPROVEMENTS. DURING PEAK AND NIGHTTIME HOURS, MAINTAIN ONE LEFT TURN LANE AND TWO THROUGH LANES OF MINIMUM 10-FT. WIDTH AT EACH APPROACH AS SHOWN ON THE PLANS.

AT THE NORTHEAST CORNER OF IL RTE 50 AND CAL SAG ROAD, SET UP WORK ZONE USING DAYTIME CLOSURE OF THE OUTER NORTHBOUND AND WESTBOUND LANES. CONSTRUCT CORNER-RADIUS PAVEMENT WIDENING AND SIDEWALK. AT THE NORTHWEST AND SOUTHEAST CORNERS OF THIS INTERSECTION, SET UP WORK ZONES USING DAYTIME LANE CLOSURES, AND CONSTRUCT THE CORNER ISLANDS. DURING PEAK AND NIGHTTIME HOURS, MAINTAIN ONE LEFT TURN LANE AND TWO THROUGH LANES OF MINIMUM 10-FT. WIDTH AT ALL APPROACHES AS SHOWN ON THE PLANS

ADVANCE WIDTH RESTRICTION SIGNING MAP

NOT TO SCALE

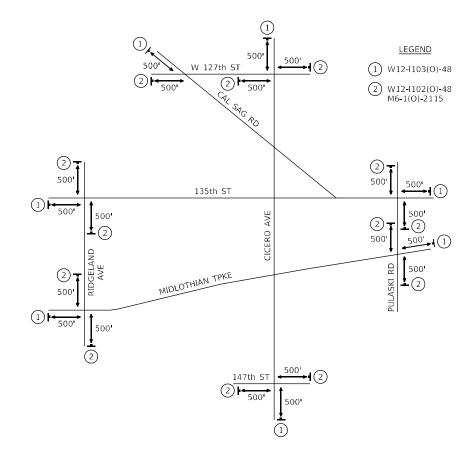

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PLOT DATE = 12/5/2022	DATE - 12/05/2022	REVISED -

STATE OF ILLINOIS **DEPARTMENT OF TRANSPORTATION**

SCALE: N.T.S.

SECTION IL 50 (CICERO AVENUE) 2021-054-N&SW STAGING GENERAL NOTES & SEQUENCING OF 10 SHEETS STA. N/A TO STA. N/A

COUNTY COOK 167 46 CONTRACT NO. 62N85


THE FOLLOWING TEMPORARY PAVEMENT MARKINGS SHALL BE PROVIDED IN ACCORDANCE WITH SECTION 703 "WORK ZONE PAVEMENT MARKINGS" OF STANDARD SPECIFICATIONS AT ALL THE FOLLOWING LOCATIONS IN EACH OF THE VARIOUS STAGES OF CONSTRUCTION:


4 IN. WHITE LINE (10 FT. DASH, 30 FT. SKIP) - BETWEEN THRU LANES

6 IN. WHITE LINE (SOLID) - TURN LANE STORAGE BAY

6 IN. WHITE LINE (2 FT. DASH, 6 FT. SKIP) - TURN LANE TAPER

WHITE LETTERS AND SYMBOLS - TURN LANES

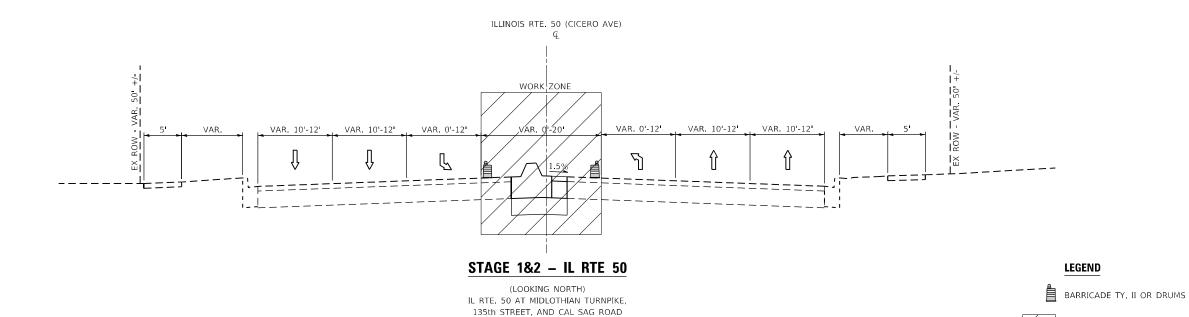

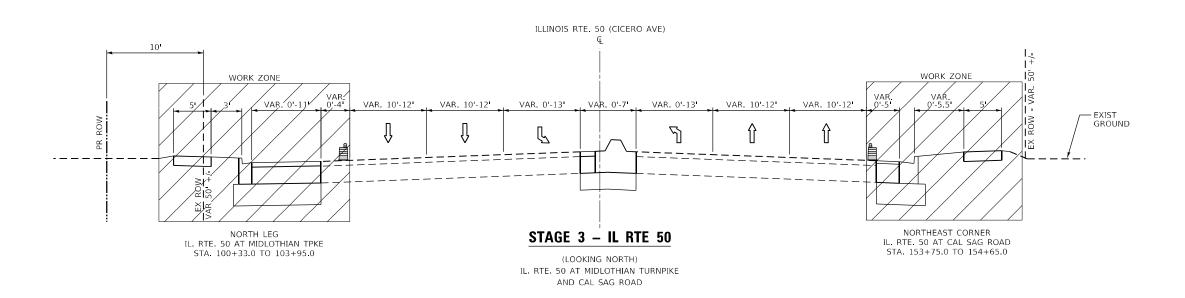

BLA, Inc.


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		IL RTE	50 (CICERO	AVEN	IUE)		
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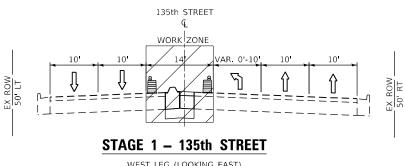
SECTION 2021-054-N&SW COOK 167 47 CONTRACT NO. 62N85

WORK ZONE


STATE OF ILLINOIS		IL	KIE 50	(CII
DEPARTMENT OF TRANSPORTATION	SUGGES	TED MAIN	TENANCE	E 0
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WEST LEG (LOOKING EAST)



WEST LEG (LOOKING EAST)

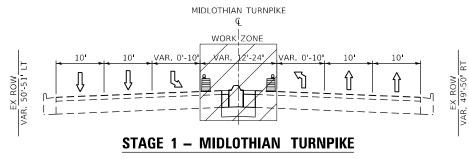




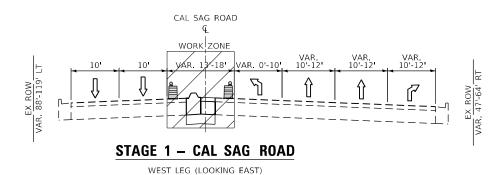


BARRICADE TY. II OR DRUMS




WORK ZONE

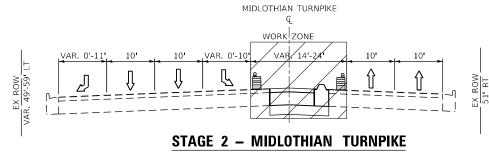


EAST LEG (LOOKING EAST)

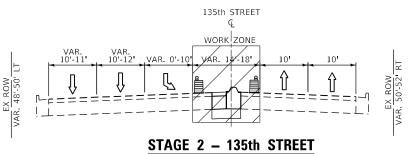

EAST LEG (LOOKING EAST)

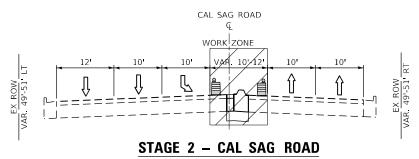

EAST LEG (LOOKING EAST)

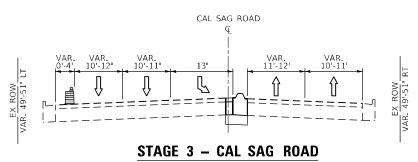

EAST LEG (LOOKING EAST)


BLA, Inc.


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STATE OF ILLINOIS **DEPARTMENT OF TRANSPORTATION**

	IL	RTE 50 (CICERO	AVENUE)			F
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SECTION 2021-054-N&SW COOK 167 48 CONTRACT NO. 62N85



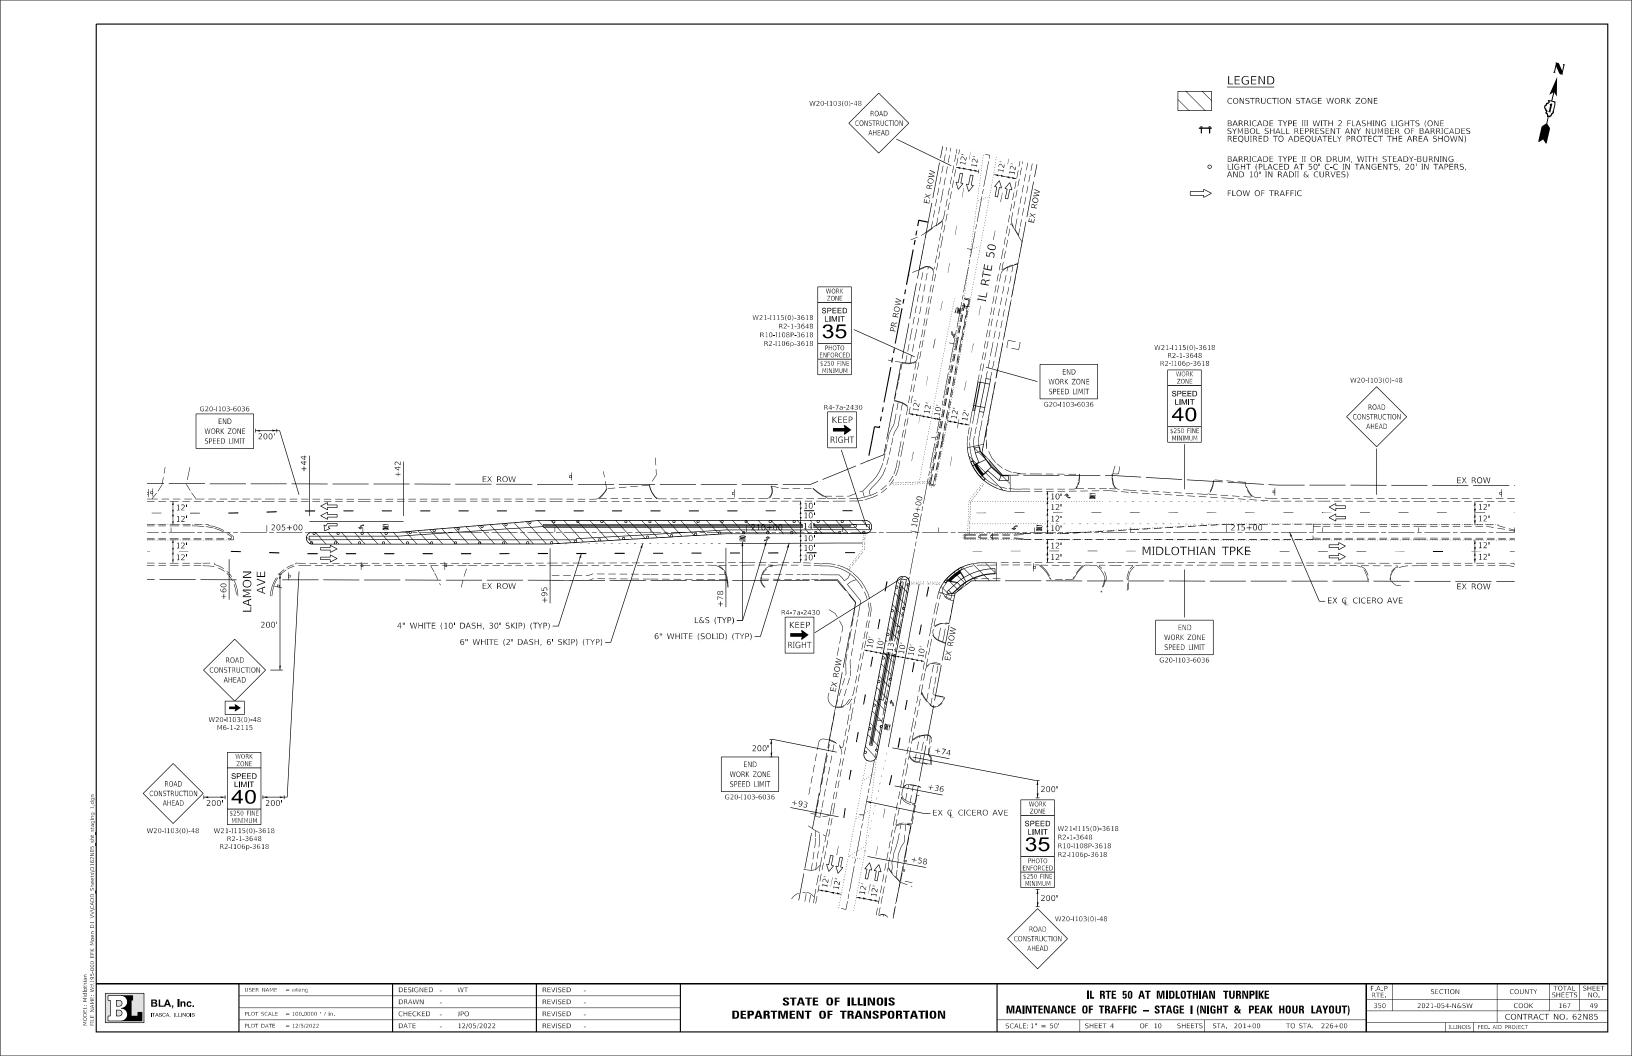


BLA, Inc.
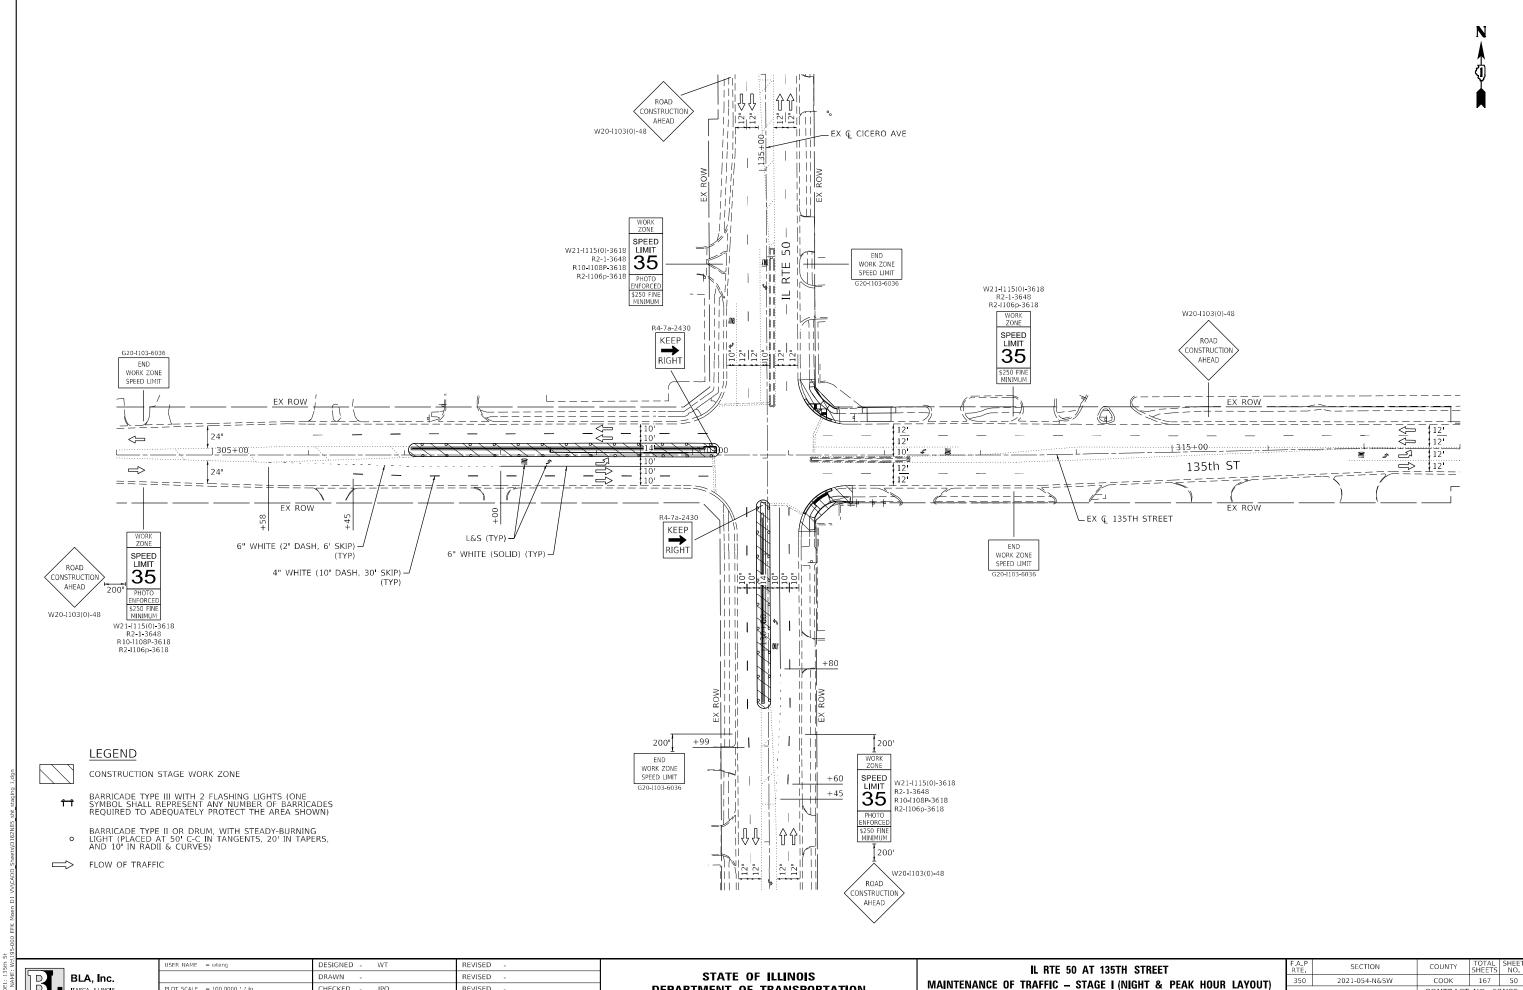
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DEPARTMENT OF TRANSPORTATION

MAINTENANCE OF TRAFFIC - STAGE I (NIGHT & PEAK HOUR LAYOUT) SCALE: 1" = 50' SHEET 5 OF 10 SHEETS STA. 307+00 TO STA. 322+00

CONTRACT NO. 62N85

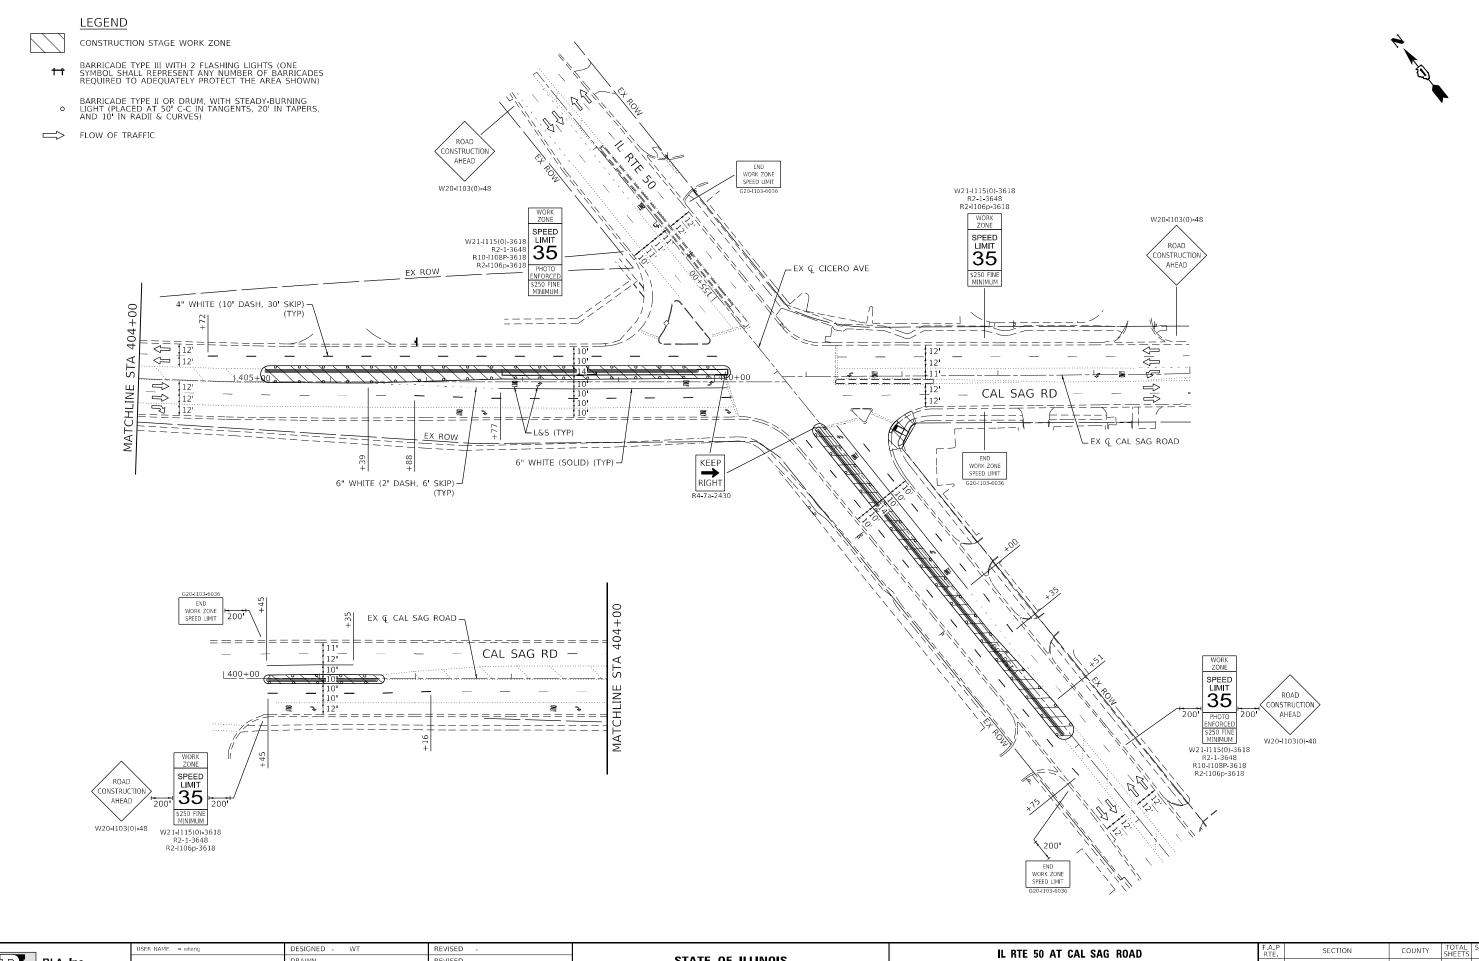


BLA, Inc. ITASCA, ILLINOIS

STATE OF ILLINOIS
DEPARTMENT OF TRANSPORTATION

	IL RTE	50 AT	CAL SA	AG R	OAD			F
// AINTENANCE	OF TRAFFIC	– STA	GE I (NI	IGHT	& PEAK	HOUR LA	AYOUT)	_
CALE: 1" = 50"	SHEET 6	OF 10	SHEETS	STA	404+00	TO STA.	423+00	_

F.A.P RTE	SECTI	ION		COUNTY	TOTAL SHEETS	SHEET NO.
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			CONTRACT	NO. 62	2N85	
	1	ILLINOIS	FED. A	D PROJECT		

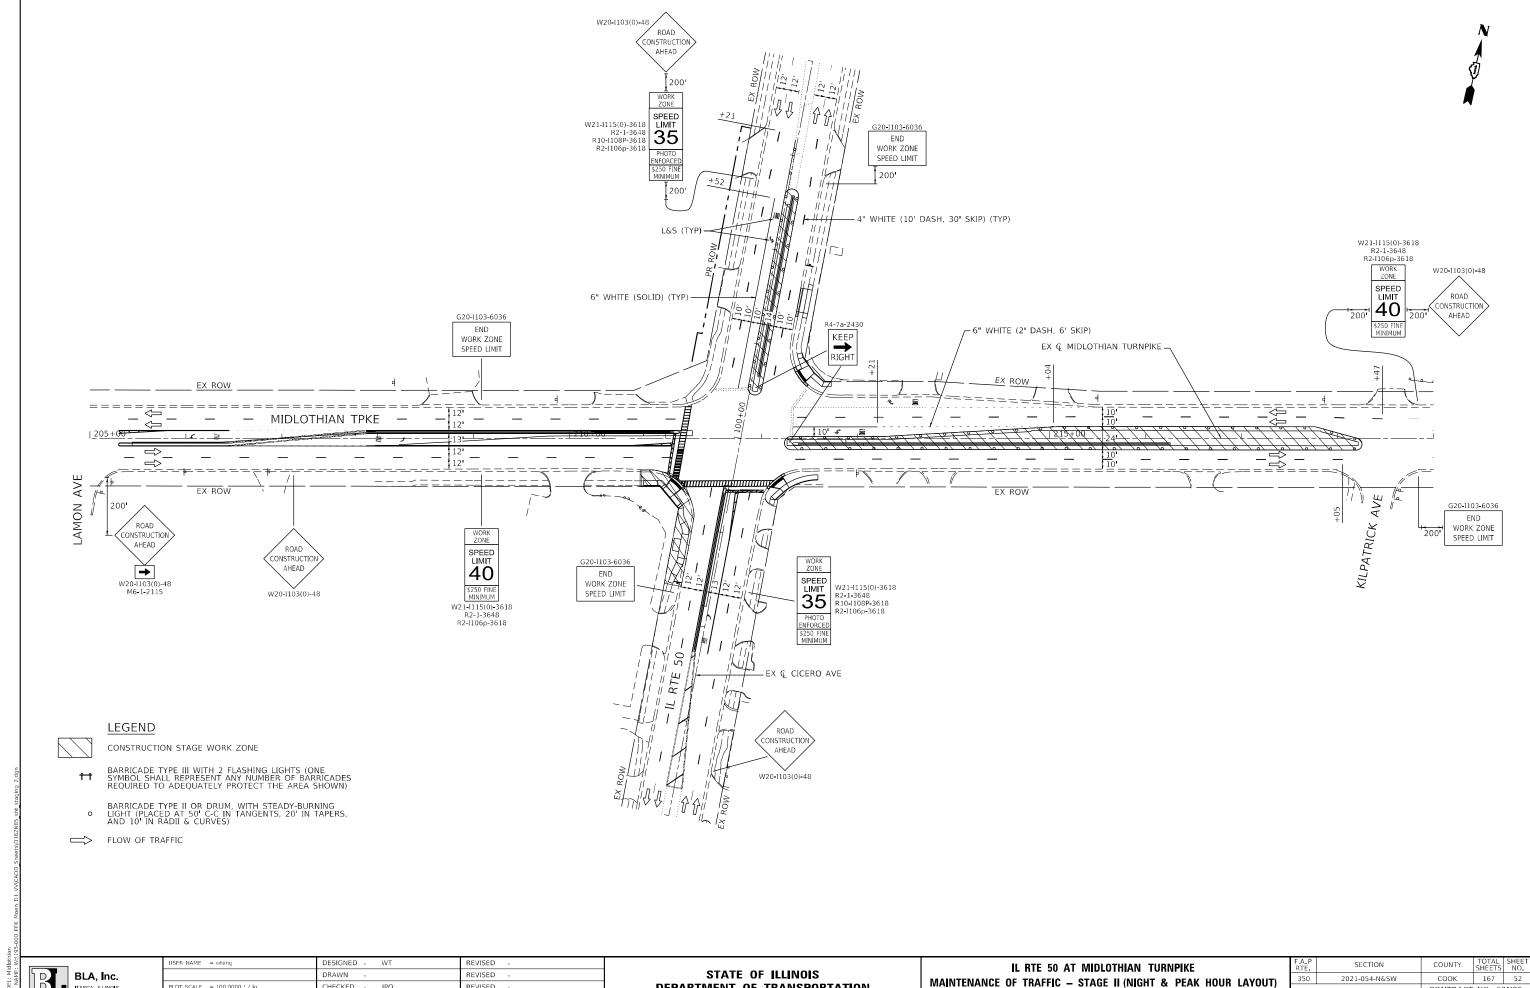


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DEPARTMENT OF TRANSPORTATION

	IL RTE 50 AT MIDLOTHIAN TURNPIKE							
IAINTENANCE	OF TRAFFI	C _ ST/	AGE II (N	IIGHT	& PFAK	HOUR	ΔΥΟΠΤ)	350
	01 1111	0 017		.,	Q I LAIN			
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CONTRACT NO. 62N85




BLA, Inc. ITASCA, ILLINOIS

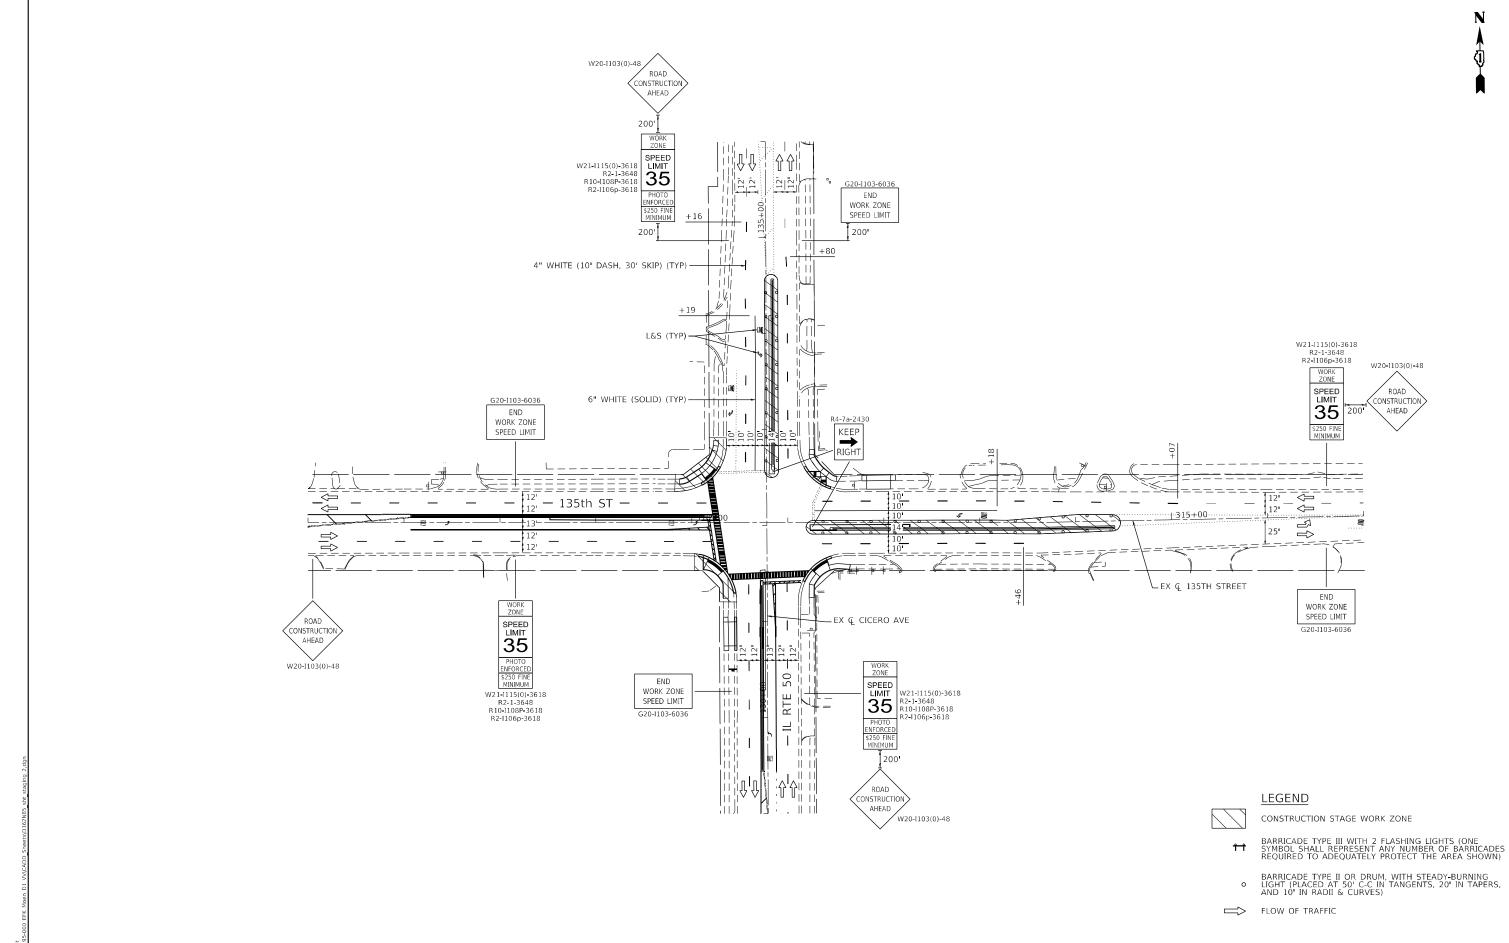STATE OF ILLINOIS DEPARTMENT OF TRANSPORTATION

F.A.P. RTE. SECTION COUNTY TOTAL SHEETS NO. 350 2021-054-N&SW COOK 167 53

CONTRACT NO. 62N85


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IL RTE 50 AT CAL SAG ROAD								
MAINTENANCE	OF TRAFFIC	– STA	GE II (N	IIGHT	& PEAK	HOUR LAYOUT)	3.	
SCALE: 1" = 50'	SHEET 9	OF 10	SHEETS	STA.	401+00	TO STA. 418+00		

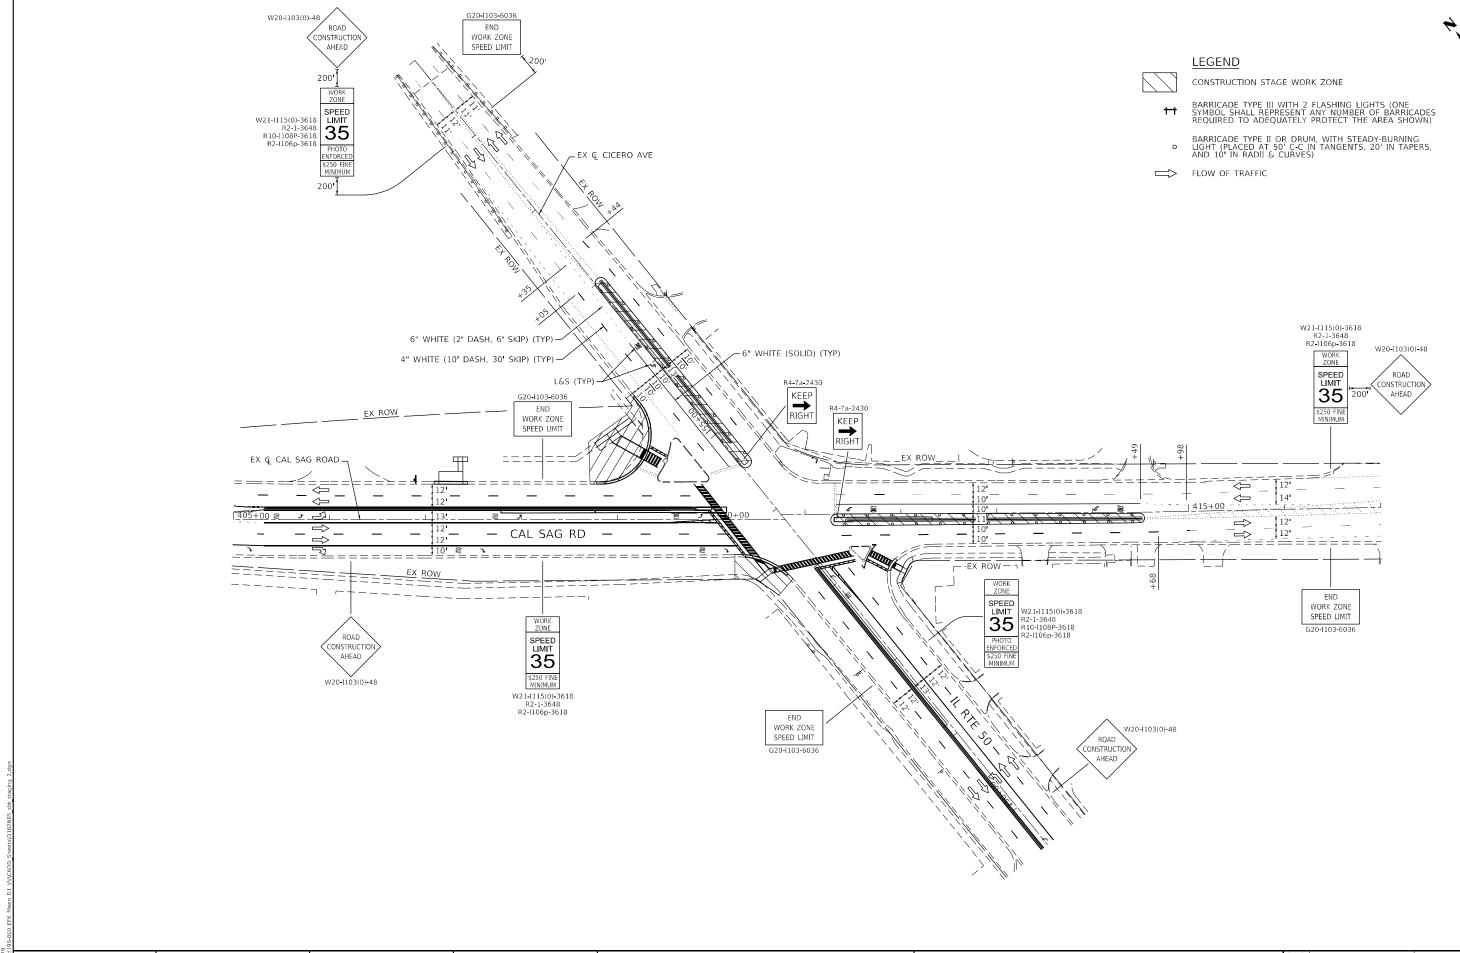F.A.P RTE	SECT	ПОИ		COUNTY	TOTAL SHEETS	SHEET NO.
350	2021-05	4-N&SW		соок	167	54
				CONTRACT	NO. 62	2N85
		ILLINOIS	FED. A	ID PROJECT		



EROSION CONTROL AND LANDSCAPING GENERAL NOTES


- DIRECT OR INDIRECT PUMPING OF SEDIMENT-LADEN WATER INTO A STORMWATER FACILITY WITHOUT FILTRATION IS PROHIBITED.
- RUNOFF FROM EXCAVATED AREAS SHALL LEAVE THE SITE THROUGH SEDIMENT CONTROL DEVICES SHOWN IN IDOT STD. 280001-07, AND/OR NRCS DETAILS FROM THE MOST RECENT VERSION OF THE ILLINOIS URBAN MANUAL
- 3. THE CONTRACTOR SHALL SURROUND ANY NECESSARY EARTH STOCKPILES WITH PERIMETER EROSION BARRIER.
- ALL ESC MEASURES SHOULD BE CHECKED WEEKLY AND AFTER EACH RAINFALL, 0.5 INCHES OR GREATER. ADDITIONALLY DURING WINTER MONTHS, ALL MEASURES SHOULD BE CHECKED AFTER
- STABILIZATION OF DISTURBED AREAS MUST BE INITIATED WITHIN ONE (1) WORKING DAY OF THE TEMPORARY OR PERMANENT CESSATION OF EARTH DISTURBING ACTIVITIES AND SHALL BE COMPLETED AS SOON AS POSSIBLE BUT NO LATER THAN 14 DAYS FROM THE INITIATION OF STABILIZATION OF WORK IN AN AREA.
- 6. ALL WASTE GENERATED AS A RESULT OF THE PROJECT INCLUDING DISCARDED BUILDING MATERIALS, CONCRETE TRUCK WASHOUT, CHEMICALS, LITTER, SANITARY WASTE, OR ANY OTHER WASTE SHALL BE PROPERLY DISPOSED OF AND BE PREVENTED FROM BEING CARRIED OFF THE SITE BY EITHER WIND OR WATER.
- 7. ALL EXPOSED IDLE EARTH, INCLUDING EARTH STOCKPILES, WILL BE SEEDED WITH TEMPORARY EROSION CONTROL SEEDING. THE APPLICATION RATE FOR TEMPORARY EROSION CONTROL SEEDING IS 100 POUNDS PER ACRE FOR THREE APPLICATIONS.
- 8. ALL TEMPORARY EROSION AND SEDIMENT CONTROL MEASURES SHALL BE REMOVED WITHIN 30 DAYS OF ACHIEVING PERMANENT SOIL STABILIZATION. TRAPPED SEDIMENT AND OTHER DISTURBED SOILS RESULTING FROM TEMPORARY MEASURES SHALL BE PROPERLY DISPOSED OF AND THE AREA PERMANENTLY STABILIZED.
- 9. ANY LOOSE MATERIAL DEPOSITION IN THE FLOW LINE OF DRAINAGE STRUCTURES, WHICH OBSTRUCTS THE NATURAL FLOW OF WATER, SHALL BE REMOVED AT THE CLOSE OF EACH WORKING DAY. PRIOR TO ACCEPTANCE OF THE IMPROVEMENT, ALL DRAINAGE STRUCTURES SHALL BE FREE OF DIRT AND DEBRIS. THIS WORK WILL NOT BE PAID FOR SEPARATELY BUT SHALL BE CONSIDERED AS INCIDENTAL.
- 10. ALL ESC MEASURES WILL BE MAINTAINED IN ACCORDANCE WITH THE IDOT EROSION AND SEDIMENT CONTROL FIELD GUIDE FOR CONSTRUCTION INSPECTION FOUND ON THE CONSTRUCTION TAB AT (HTTP://WWW.IDOT.ILLINOIS.GOV/TRANSPORTATION-SYSTEM/ENVIRONMENT/EROSION-AND-SEDIMENT-
- 11. THE CONTRACTOR WILL ASSUME RESPONSIBILITY FOR MAINTENANCE OF ALL SOIL EROSION CONTROL DURING CONSTRUCTION.
- 12. THE CONTRACTOR SHOULD PROVIDE TO THE RE A PLAN TO ENSURE THAT A STABILIZED FLOW LINE WILL BE PROVIDED DURING STORM SEWER CONSTRUCTION. THE USE OF A STABILIZED FLOW LINE BETWEEN THE INSTALLED STORM SEWER AND OPEN DISTURBANCE WILL REDUCE THE POTENTIAL FOR THE OFFSITE DISCHARGE OF SEDIMENT BEARING WATERS, ESPECIALLY WHEN RAIN IS FORCASTED, SO THAT FLOW WILL NOT ERODE, LACK OF AN APPROVED PLAN OR FAILURE TO COMPLY WILL RESULT IN AN ESC DEFICIENCY DEDUCTION.
- 13. UNDER NO CIRCUMSTANCES SHALL THE CONTRACTOR PROLONG FINAL GRADING AND SHAPING SO THAT THE ENTIRE PROJECT CAN BE PERMANENTLY SEEDED AT ONE TIME.

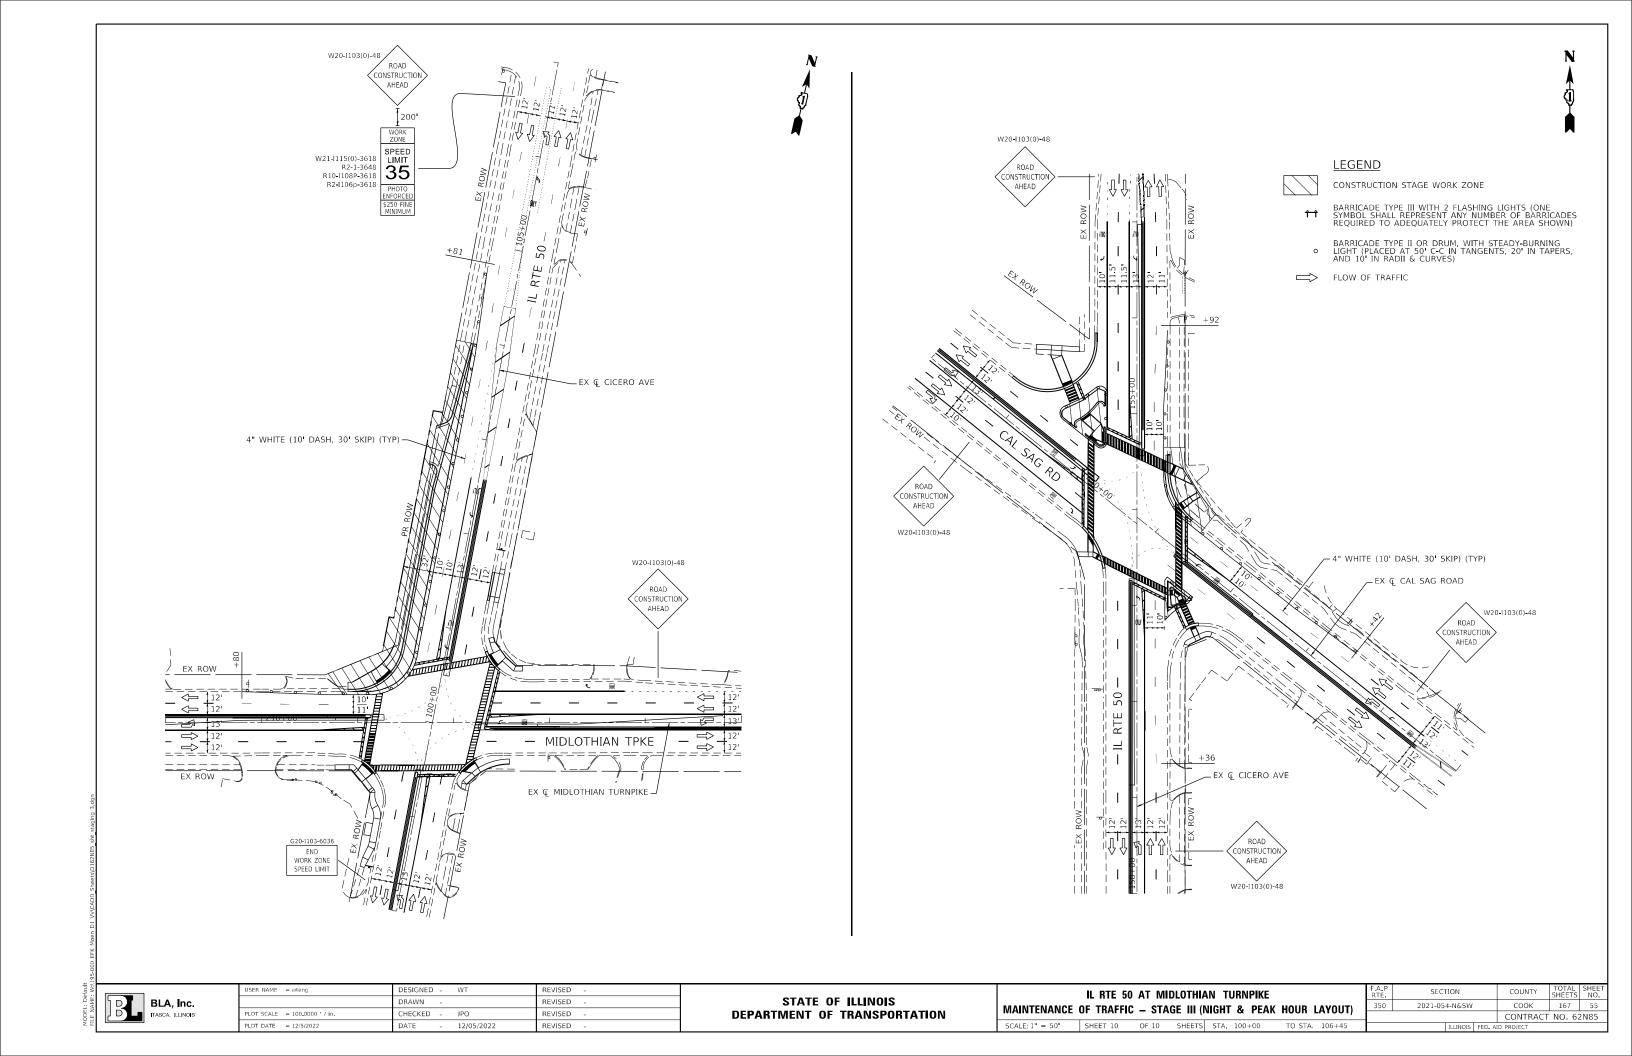
EFK•Moen
Civil Engineering Design


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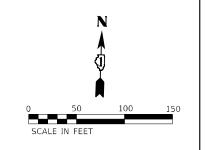
IL ROUTE 50 (CICERO AVE) EROSION CONTROL GENERAL NOTES									
	SHEET	OF	SHEETS	STA.	TO STA				


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			CONTRACT	NO. 62	2N85
	ILLINOIS	FED. A	D PROJECT		




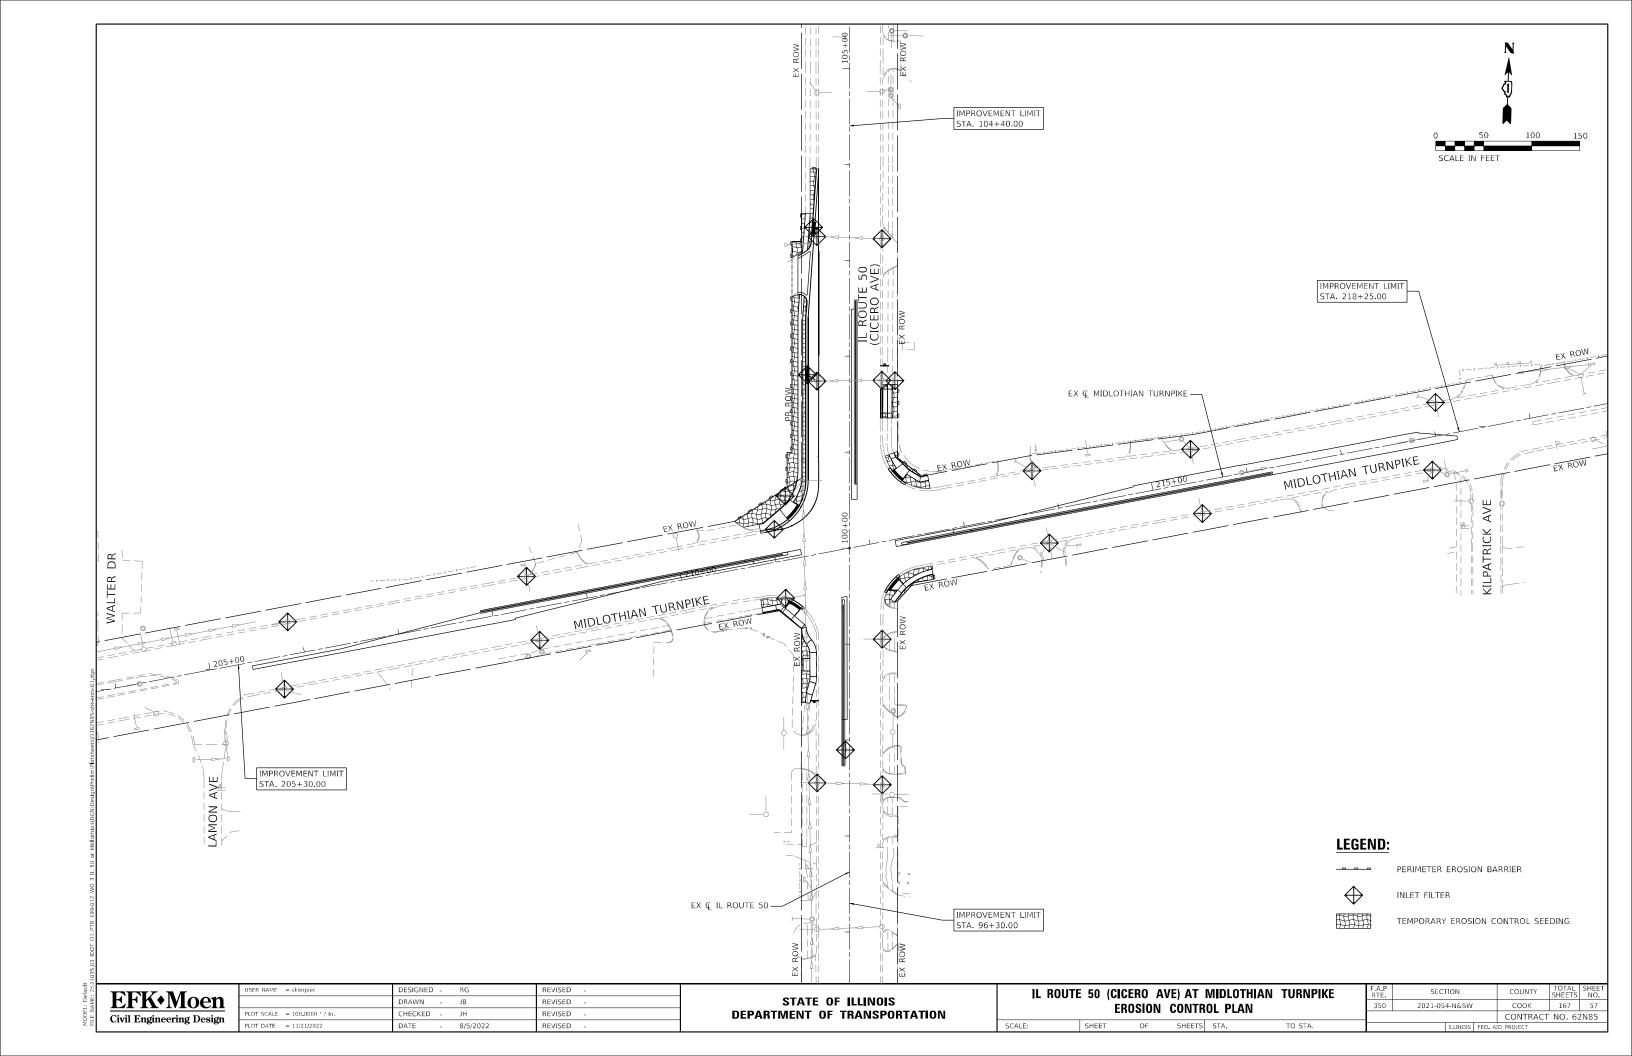

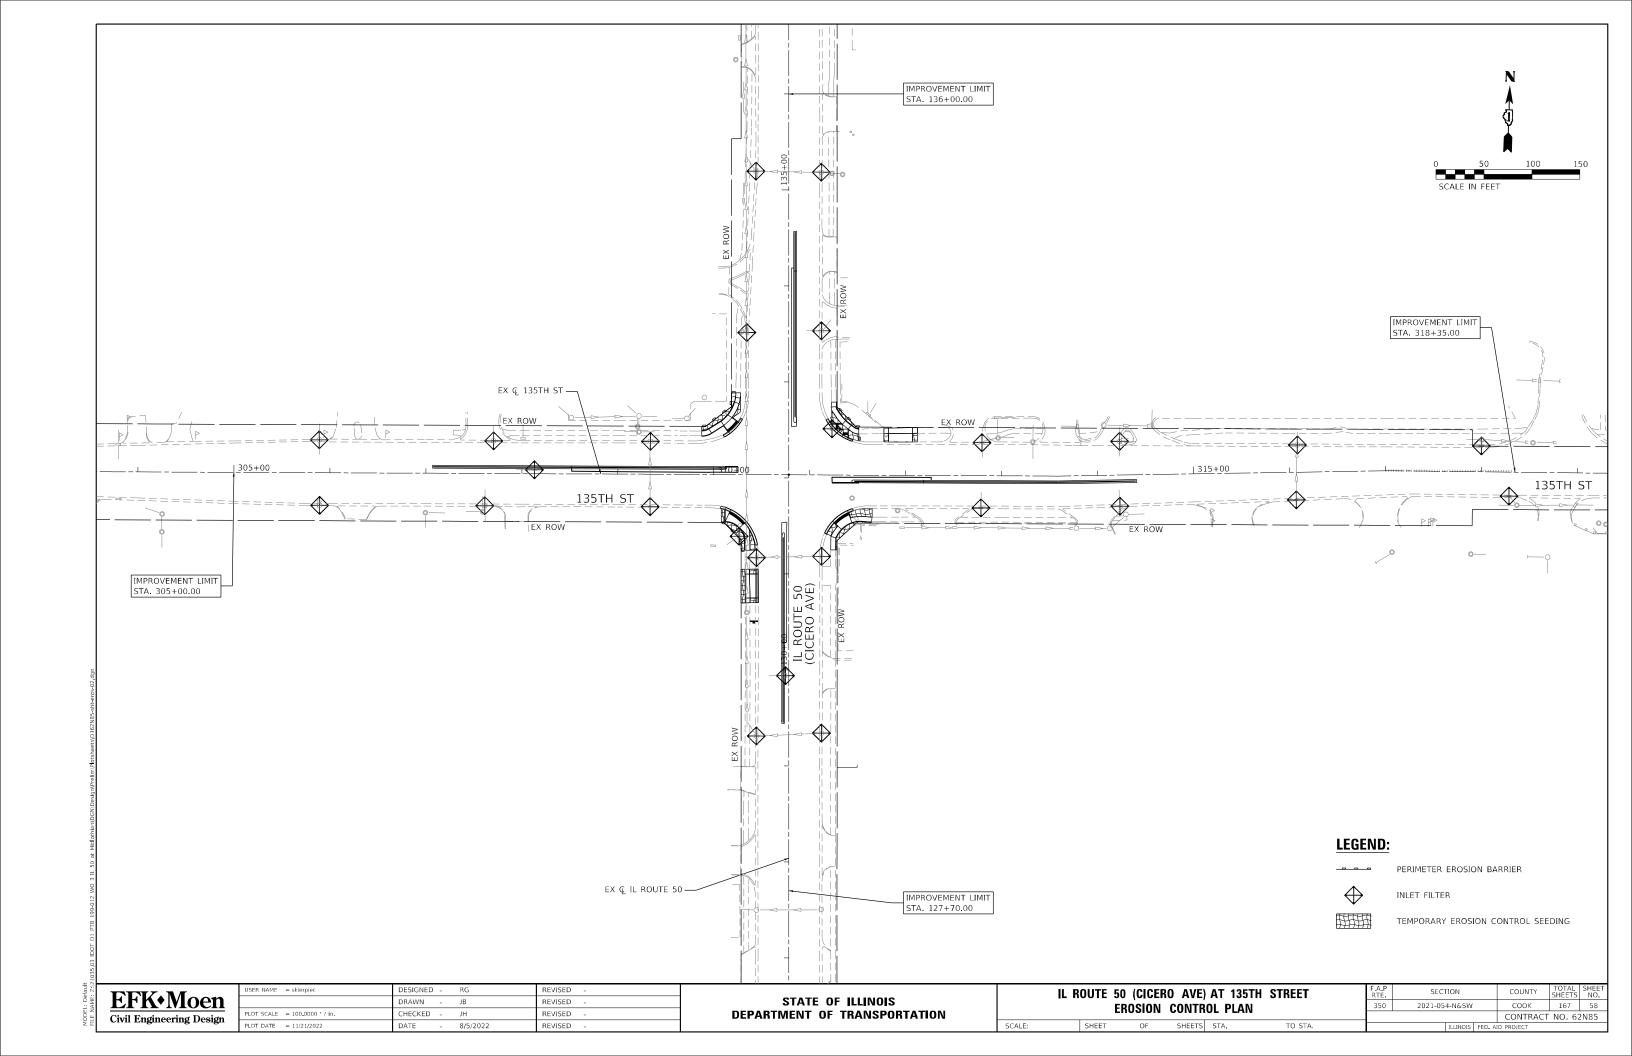

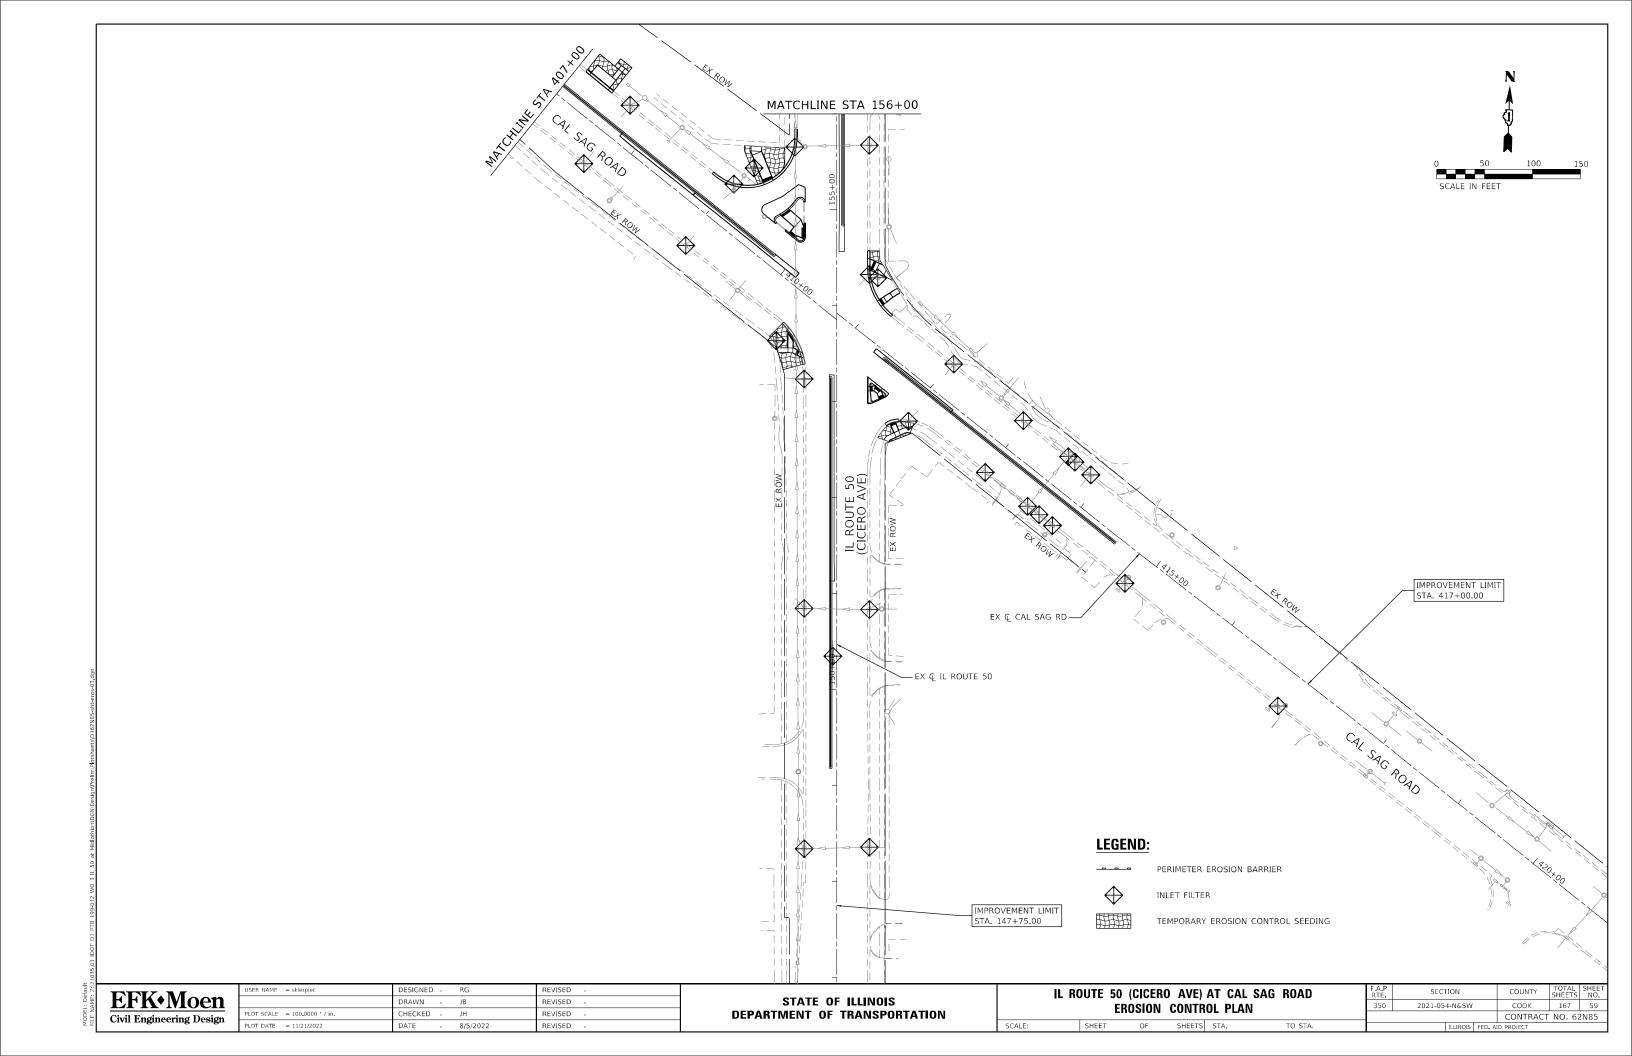

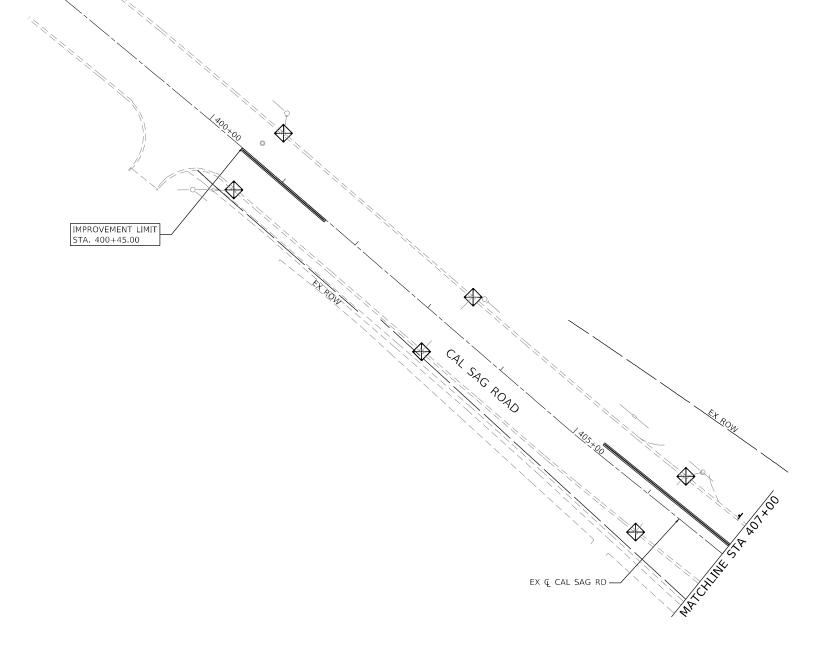

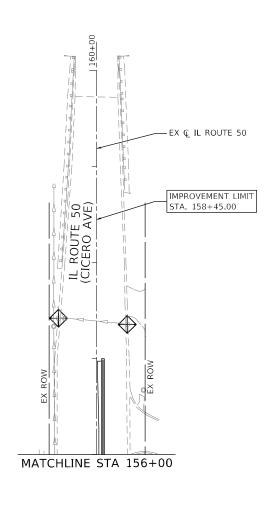

LEGEND:

PERIMETER EROSION BARRIER



INLET FILTER

TEMPORARY EROSION CONTROL SEEDING

EFK Moen
Civil Engineering Design


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STATE OF ILLINOIS
DEPARTMENT OF TRANSPORTATION


IL ROUTE 50 (CICERO AVE) AT CAL SAG ROAI EROSION CONTROL PLAN							
	SHEET	OF	SHEETS	STA.	TO STA.		

SCALE:

F.A.P RTE	SECTION	COUNTY	TOTAL SHEETS	SHEE NO.	
350	2021-054-N&SW	соок	167	60	
			CONTRACT	NO. 62	2N85
	ILLINOIS	FED. A	ID PROJECT		

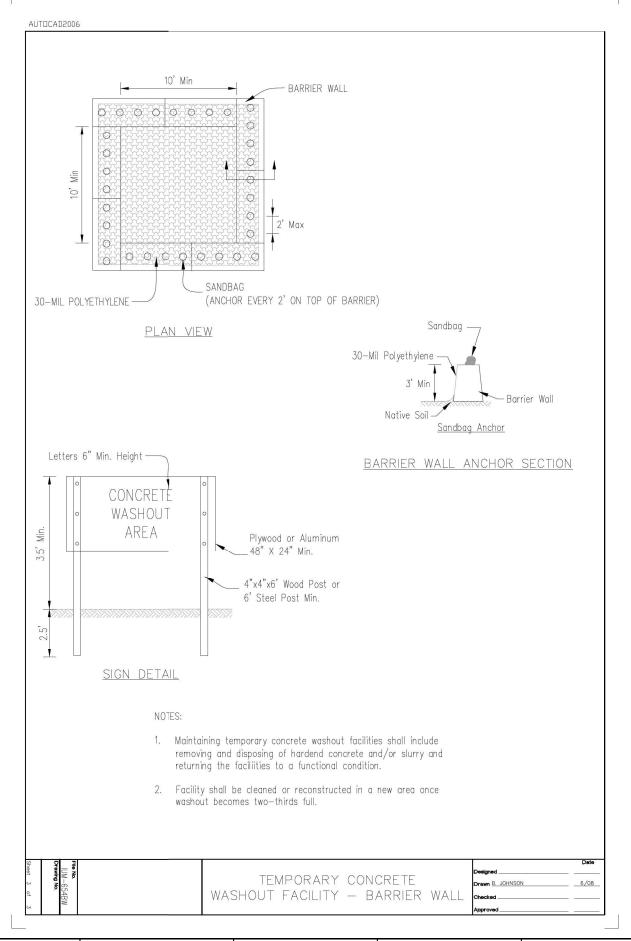


INLET PROTECTION - PAVED AREAS DROP-IN PROTECTION

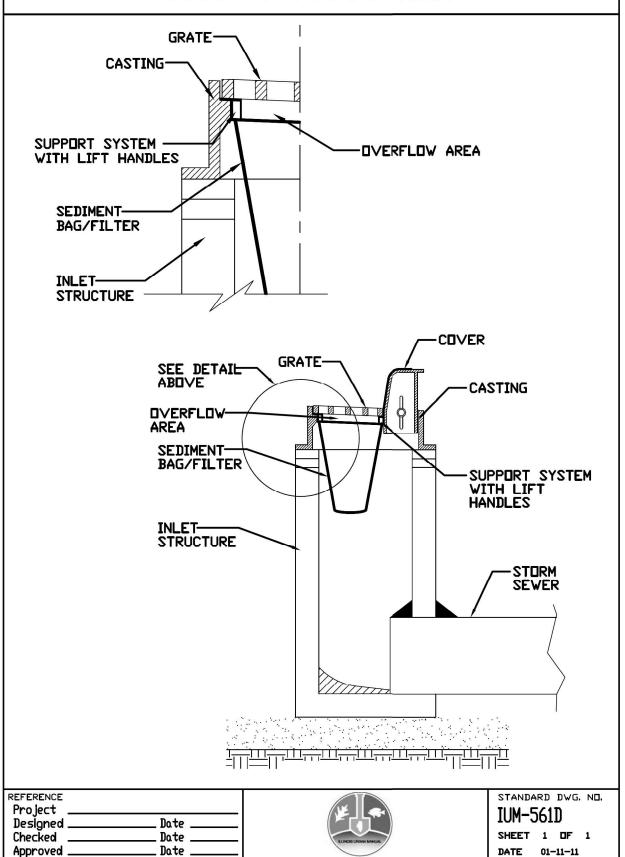


EFK Moen
Civil Engineering Design

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PLOT DATE = 11/21/2022	DATE	-	8/5/2022	REVISED	-

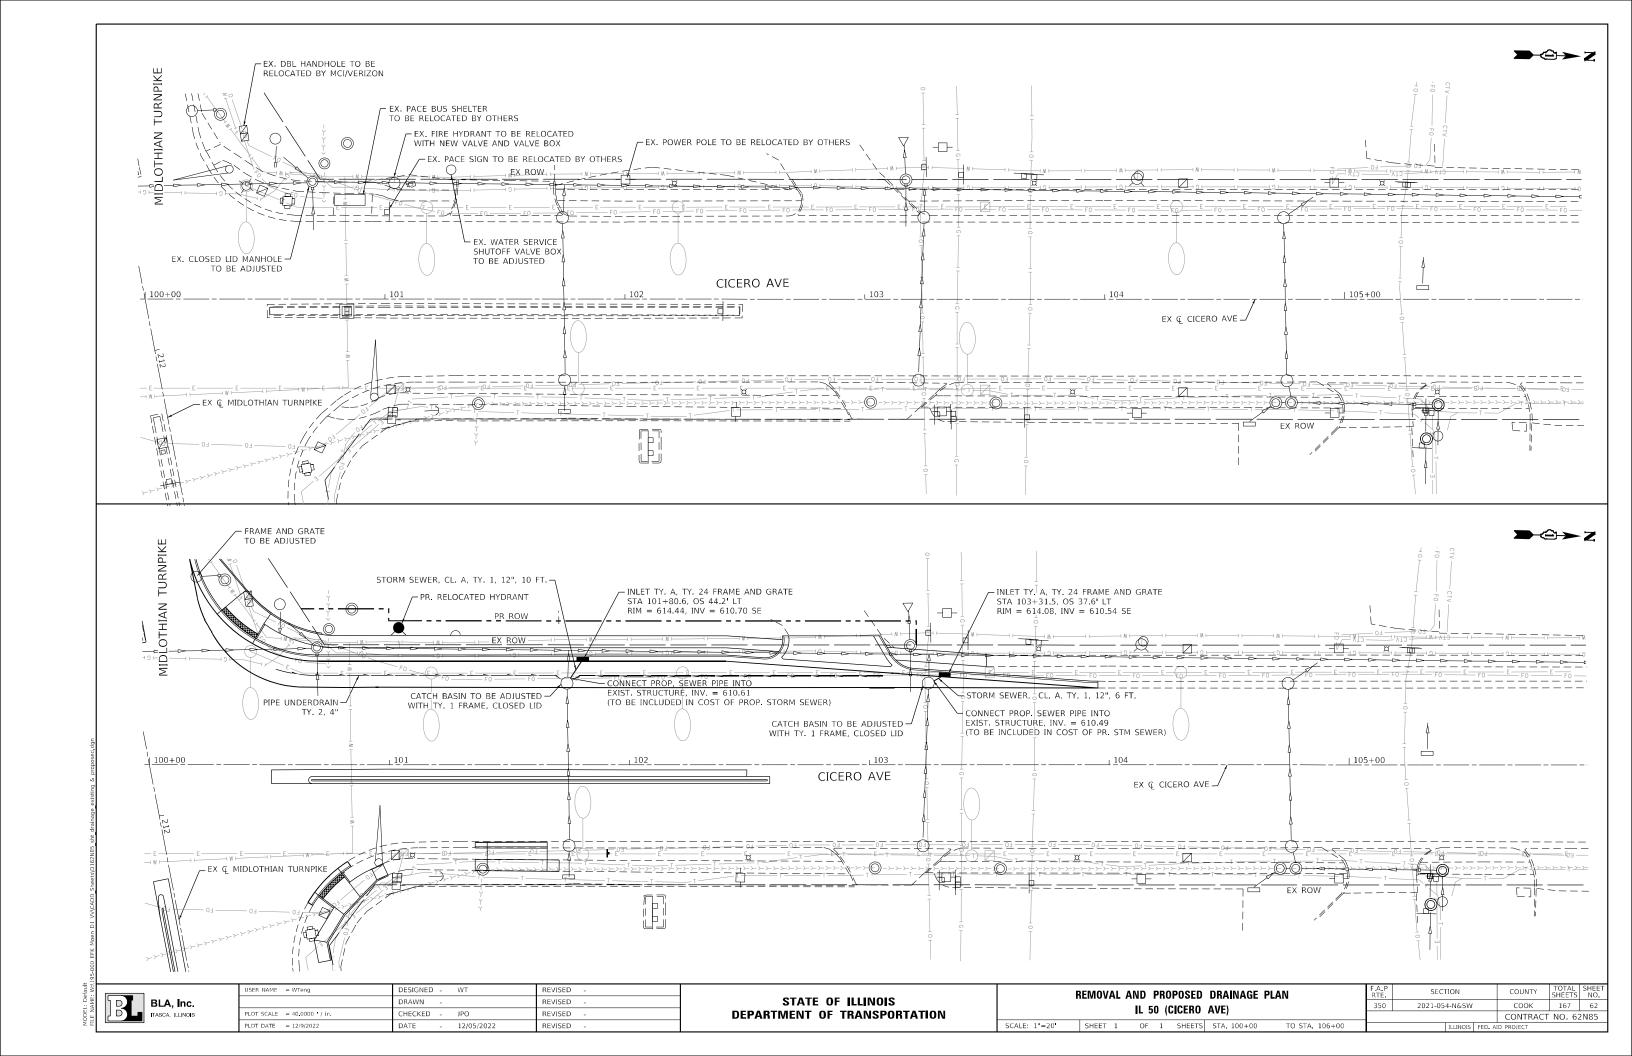



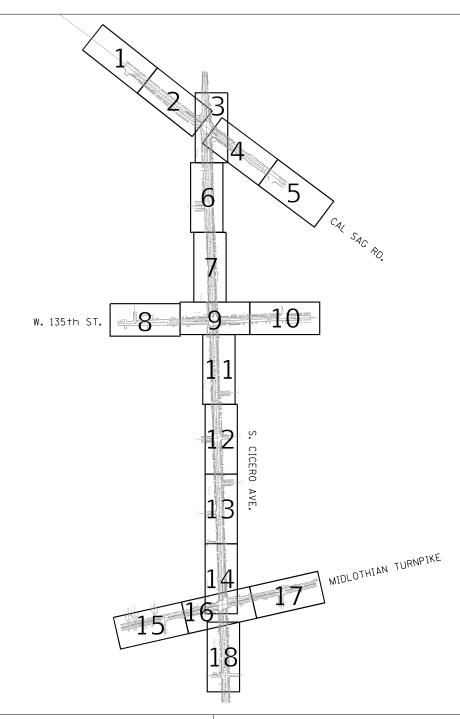

ASCE STANDARDS OF DEPICTION OF SUBSURFACE UTILITIES QUALITY LEVEL A (QLA) PRECISE HORIZONTAL AND VERTICAL LOCATION OF UTILITIES OBTAINED BY THE ACTUAL EXPOSURE (OR VERIFICATION OF PREVIOUSLY EXPOSED AND SURVEYED UTILITIES) USING MINIMALLY INTRUSIVE EXCAVATION EQUIPMENT TO MINIMIZE POTENTIAL FOR UTILITY DAMAGE, AND SUBSEQUENT MEASURMENT OF THE SUBSURFACE UTILITIES WITH OTHER UTILITY ATTRIBUTES SUCH AS TYPE, SIZE & MATERIAL OF UTILITY. QUALITY LEVEL B (QLB) INFORMATION OBTAINED THROUGH THE APPLICATION OF APPROPRIATE SURFACE GEOPHYSICAL METHODS TO DETERMINE THE EXISTENCE AND APPROXIMATE HORIZONTAL POSITION OF SUBSURFACE UTILTIES. QUALITY LEVEL B DATA SHOULD BE REPRODUCIBLE BY SURFACE GEOPHYSICS AT ANY POINT OF THEIR DEPICTION. THIS INFORMATION IS SURVEYED TO

QUALITY LEVEL C (QLC) INFORMATION OBTAINED BY SURVEYING AND PLOTTING VISIBLE ABOVE-GROUND UTLITY FEATURES AND BY USING PROFESSIONAL JUDGEMENT IN CORRELATING THIS INFORMATION TO QUALITY LEVEL D INFORMATION.

APPLICABLE TOLERANCES DEFINED BY THE PROJECT AND REDUCED ONTO PLAN DOCUMENTS

INFORMATION DERIVED FROM EXISITNG RECORDS OR ORAL RECOLLECTIONS.

GENERAL NOTES:

WGI INC. HAS EXERCISED ITS BEST PROFESSIONAL EXPERTISE AND GEOPHYSICALPROSPECTING TECHNIQUES TO DEVELOP THIS MAPPING OF SUBSURFACE UTILITIES WITHIN THE PROJECT LIMITS.

WGI INC. DOES NOT GUARANTEE THAT UTILITIES SHOWN COMPRISE ALL UTILITIES WITHIN THE PROJECT AREA.

 $WGI's \ \textit{FIELD INVESTIGATION WAS PERFORMED } 06/02/2020 \ \textit{THROUGH } 07/15/2020.$ CHANGES TO UTILITIES AFTER 07/15/2020 MAY HAVE BEEN MADE AND THEREFORE MAY RESULT IN VARIANCES FROM THIS PLAN IF DEEMED ADVISABLE PRIOR TO FINAL


FIELD LOCATED UTILITIES MEET THE FEDERAL HIGHWAY ADMINISTRATION DEFINITION FOR "QUALITY LEVEL B" (QLB) STANDARDS.

UTILITY SIZE AND INFORMATION IS BASED ON BEST AVAILABLE FIELD AND

ALL UTILITIES SHOWN ARE QUALITY LEVEL B (QLB) UNLESS NOTED OTHERWISE.

ALL ELECTRONIC DEPTHS PROVIDED ARE ESTIMATED APPROXIMATELY TO THE CENTER OF THE UTILITY UNLESS NOTED OTHERWISE AND SHOULD BE USED FOR INFORMATIONAL PURPOSES ONLY.

UTILITY LEGEND:

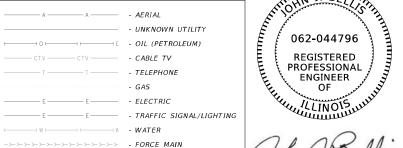

- FIBER OPTIC

SCALE:

SEOI - END OF INFORMATION - ELECTRONIC DEPTH

license expires 11/30/2021

08/27/2020

-044796 **AMERICAN**

American Surveying & Engineering, P.C. 30 N. LaSalle St., Suite 3440 Chicago, IL 60605 Phone No. (312) 277-2000





Downers Grove, IL 60515


USER NAME = Erick Maleza	DESIGNED -	REVISED -
	DRAWN - EM	REVISED -
PLOT SCALE = 50.0000 / in.	CHECKED - EG	REVISED -
PLOT DATE = 8/27/2020	DATE -	REVISED -

STATE OF ILLINOIS **DEPARTMENT OF TRANSPORTATION**

	IL. RT. 50 AT MIDLOTHIAN — CAL SAG RD Crestwood. Illinois				F.A. RTE	SECTION		COUNTY	TOTAL SHEETS		
					350	2021-054-N&SW		COOK	167	63	
	CILGI WOOD, ILLINOIS						CONTRACT NO	P-109	313		
	SHEET	OF	SHEETS	STA.	TO STA.		TLUNOIS	EED ΔI	D PROJECT		

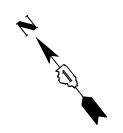

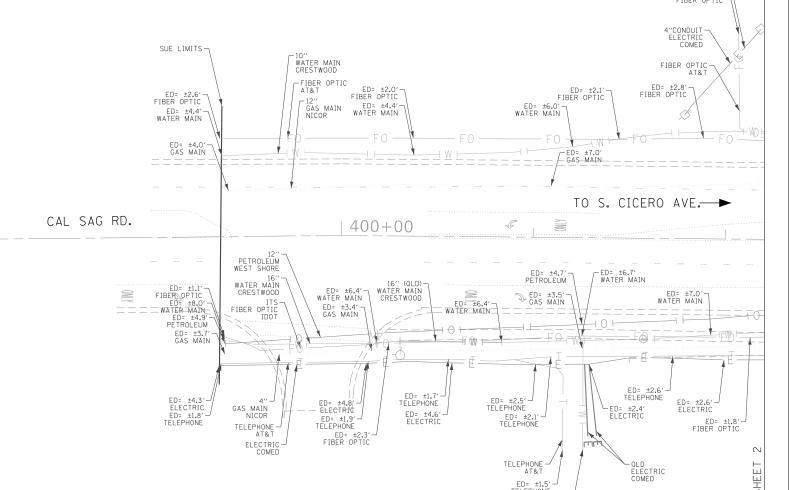

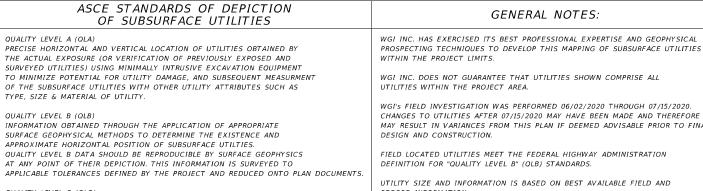

QUALITY LEVEL C (QLC) INFORMATION OBTAINED BY SURVEYING AND PLOTTING VISIBLE ABOVE-GROUND UTLITY FEATURES AND BY USING PROFESSIONAL JUDGEMENT IN CORRELATING THIS INFORMATION TO QUALITY LEVEL D INFORMATION.

INFORMATION DERIVED FROM EXISITNG RECORDS OR ORAL RECOLLECTIONS.

WGI INC. DOES NOT GUARANTEE THAT UTILITIES SHOWN COMPRISE ALL CABLE TV TELEPHONE WGI'S FIELD INVESTIGATION WAS PERFORMED 06/02/2020 THROUGH 07/15/2020. CHANGES TO UTILITIES AFTER 07/15/2020 MAY HAVE BEEN MADE AND THEREFORE MAY RESULT IN VARIANCES FROM THIS PLAN IF DEEMED ADVISABLE PRIOR TO FINAL - GAS - ELECTRIC - TRAFFIC SIGNAL/LIGHTING FIELD LOCATED UTILITIES MEET THE FEDERAL HIGHWAY ADMINISTRATION - WATER FORCE MAIN UTILITY SIZE AND INFORMATION IS BASED ON BEST AVAILABLE FIELD AND FIBER OPTIC

ALL UTILITIES SHOWN ARE QUALITY LEVEL B (QLB) UNLESS NOTED OTHERWISE.

ALL ELECTRONIC DEPTHS PROVIDED ARE ESTIMATED APPROXIMATELY TO THE

INFORMATIONAL PURPOSES ONLY.

TEST HOLE SEOI - END OF INFORMATION - ELECTRONIC DEPTH CENTER OF THE UTILITY UNLESS NOTED OTHERWISE AND SHOULD BE USED FOR

UTILITY LEGEND:

AERIAL



08/27/2020

license expires 11/30/2021



American Surveying & Engineering, P.C. 30 N. LaSalle St., Suite 3440 Chicago, IL 60605 Phone No. (312) 277-2000



ED= ±8.0' WATER MAIN


2001 Butterfield Road, Suite 410 Downers Grove, IL 60515 Phone No. (630) 307-3800

USER NAME = Erick Maleza	DESIGNED -	REVISED -
	DRAWN - EM	REVISED -
PLOT SCALE = 50.0000 / in.	CHECKED - EG	REVISED -
PLOT DATE = 8/20/2020	DATE -	REVISED -

STATE OF ILLINOIS **DEPARTMENT OF TRANSPORTATION**

IL. RT. 50 AT MIDLOTHIAN - CAL SAG RD								
CRESTWOOD, ILLINOIS								
SHEET 1	OF 18	SHEETS	STA.	TO STA.				

F.A. RTE	SECTION		COUNTY	TOTAL SHEETS	SHEE NO.
350	2021-054-N&SW		соок	167	64
			CONTRACT NO	P-109	313

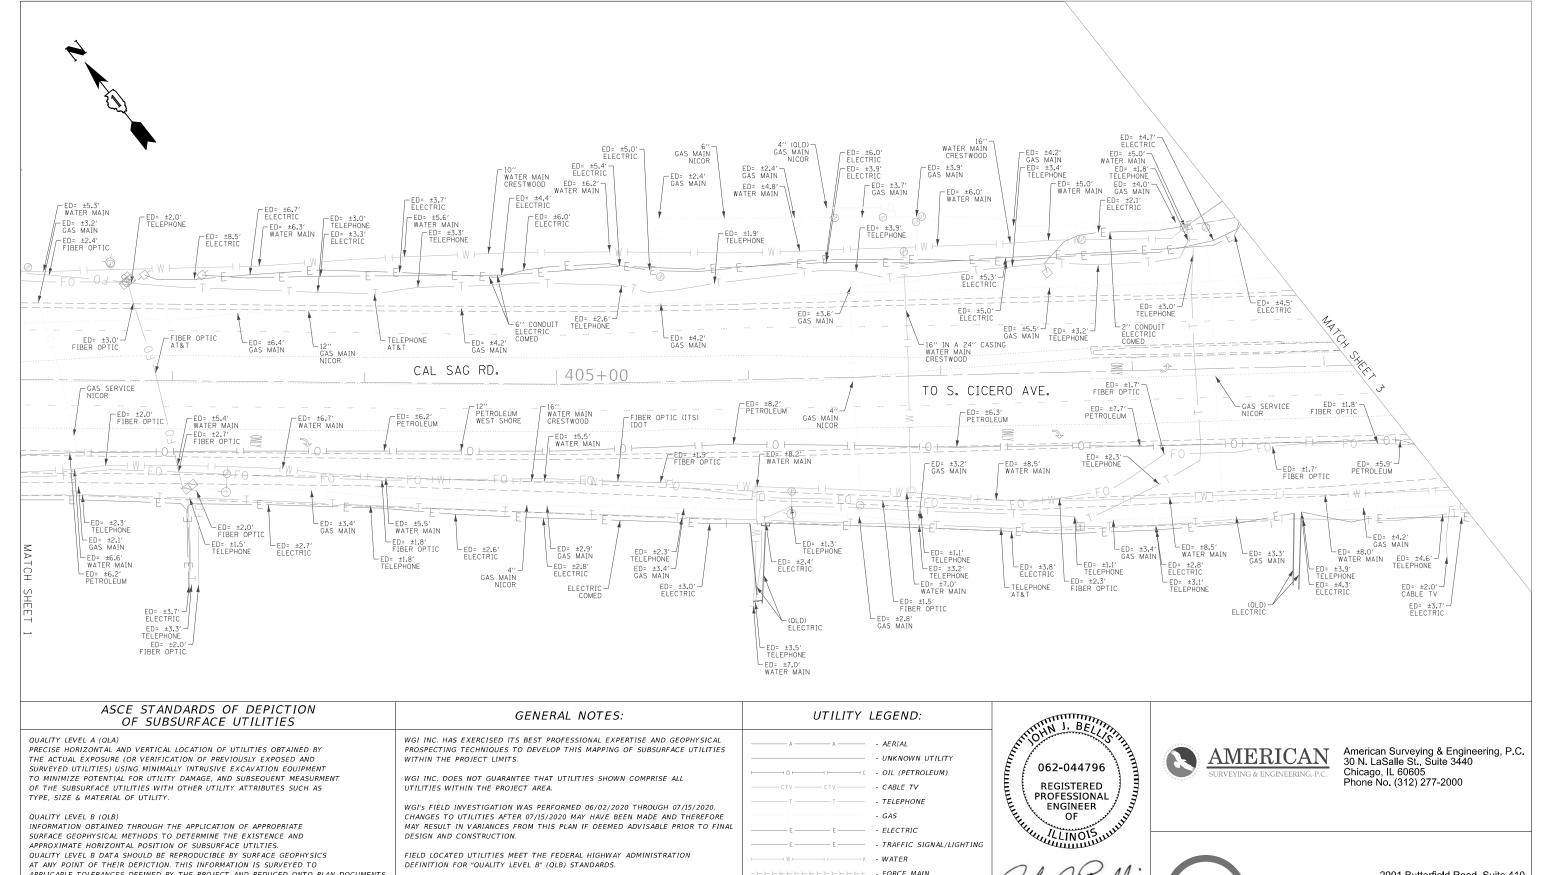

APPROXIMATE HORIZONTAL POSITION OF SUBSURFACE UTILTIES. QUALITY LEVEL B DATA SHOULD BE REPRODUCIBLE BY SURFACE GEOPHYSICS AT ANY POINT OF THEIR DEPICTION. THIS INFORMATION IS SURVEYED TO APPLICABLE TOLERANCES DEFINED BY THE PROJECT AND REDUCED ONTO PLAN DOCUMENTS

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INFORMATION DERIVED FROM EXISITNG RECORDS OR ORAL RECOLLECTIONS.

FIELD LOCATED UTILITIES MEET THE FEDERAL HIGHWAY ADMINISTRATION DEFINITION FOR "QUALITY LEVEL B" (QLB) STANDARDS.

UTILITY SIZE AND INFORMATION IS BASED ON BEST AVAILABLE FIELD AND


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WATER FORCE MAIN

> FIBER OPTIC TEST HOLE ςEOI - END OF INFORMATION

ΕD - ELECTRONIC DEPTH



2001 Butterfield Road, Suite 410 Downers Grove, IL 60515 Phone No. (630) 307-3800 Fax No. (630) 307-7030

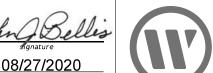
USER NAME = Erick.Maleza DESIGNED -REVISED DRAWN -EM REVISED PLOT SCALE = 50.0000 / in. CHECKED -REVISED PLOT DATE = 8/20/2020 REVISED


STATE OF ILLINOIS **DEPARTMENT OF TRANSPORTATION**


IL. RT. 50 AT MIDLOTHIAN - CAL SAG RD **CRESTWOOD, ILLINOIS** OF 18 SHEETS STA. SHEET 2


license expires 11/30/2021

F.A. RTE	SECTION		COUNTY	TOTAL SHEETS	SHEE NO
350	2021-054-N&SW		соок	167	65
		CONTRACT NO. P-109313			

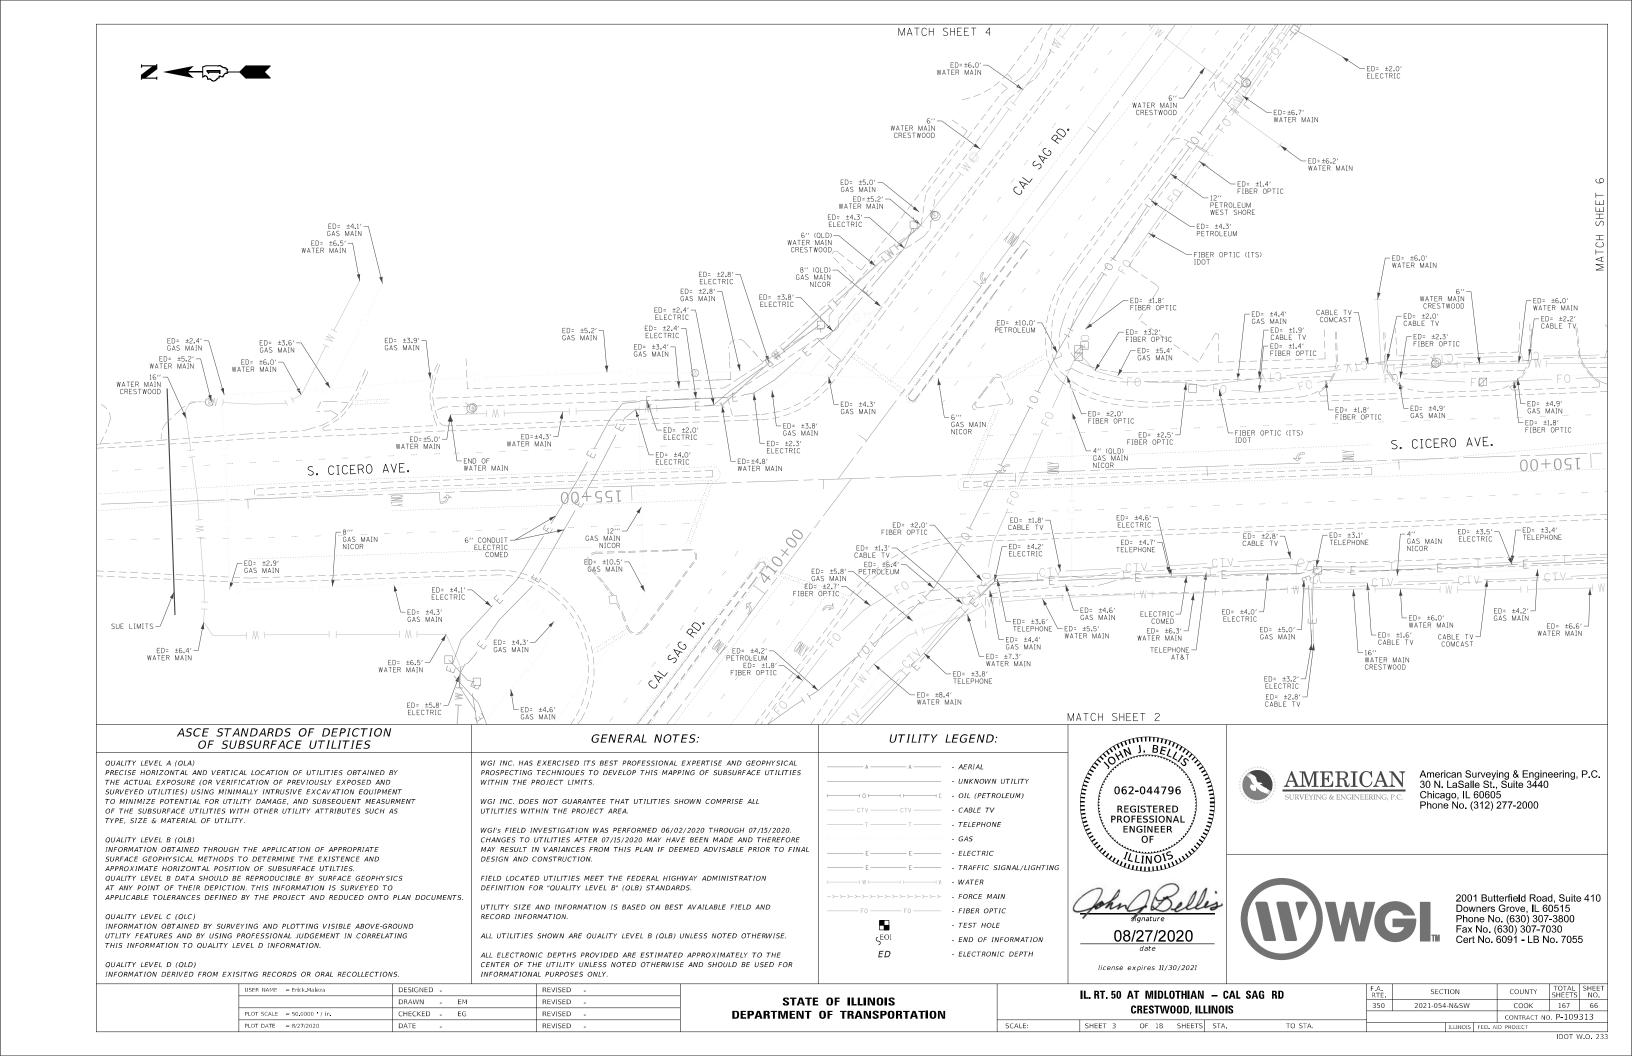

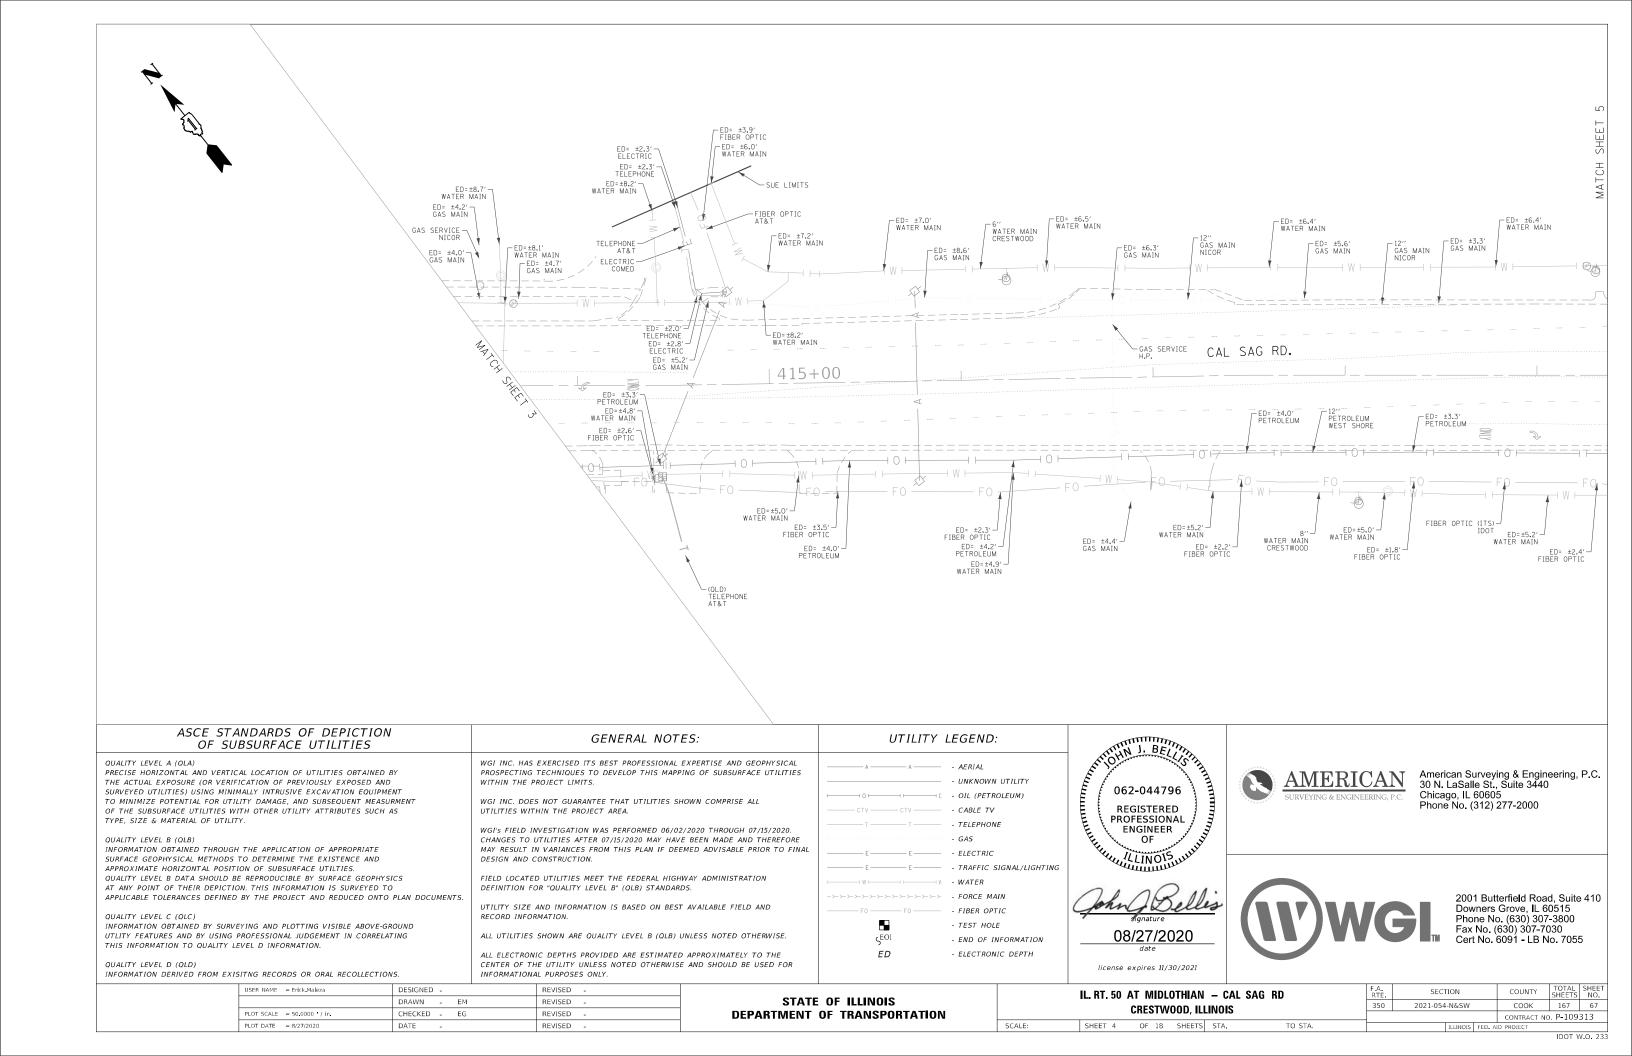

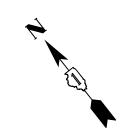

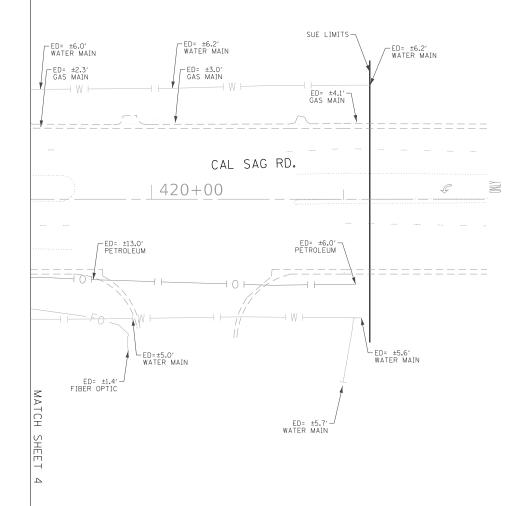

ASCE STANDARDS OF DEPICTION OF SUBSURFACE UTILITIES QUALITY LEVEL A (QLA) PRECISE HORIZONTAL AND VERTICAL LOCATION OF UTILITIES OBTAINED BY THE ACTUAL EXPOSURE (OR VERIFICATION OF PREVIOUSLY EXPOSED AND SURVEYED UTILITIES) USING MINIMALLY INTRUSIVE EXCAVATION EQUIPMENT TO MINIMIZE POTENTIAL FOR UTILITY DAMAGE, AND SUBSEQUENT MEASURMENT OF THE SUBSURFACE UTILITIES WITH OTHER UTILITY ATTRIBUTES SUCH AS TYPE, SIZE & MATERIAL OF UTILITY. QUALITY LEVEL B (QLB) INFORMATION OBTAINED THROUGH THE APPLICATION OF APPROPRIATE SURFACE GEOPHYSICS AL METHODS TO DETERMINE THE EXISTENCE AND APPROXIMATE HORIZONTAL POSITION OF SUBSURFACE UTILITIES. QUALITY LEVEL B DATA SHOULD BE REPRODUCIBLE BY SURFACE GEOPHYSICS AT ANY POINT OF THEIR DEPICTION. THIS INFORMATION IS SURVEYED TO APPLICABLE TOLERANCES DEFINED BY THE PROJECT AND REDUCED ONTO PLAN DOCUMENTS

QUALITY LEVEL C (QLC)
INFORMATION OBTAINED BY SURVEYING AND PLOTTING VISIBLE ABOVE-GROUND
UTLITY FEATURES AND BY USING PROFESSIONAL JUDGEMENT IN CORRELATING
THIS INFORMATION TO QUALITY LEVEL D INFORMATION.

QUALITY LEVEL D (OLD)
INFORMATION DERIVED FROM EXISITNG RECORDS OR ORAL RECOLLECTIONS.

GENERAL NOTES:

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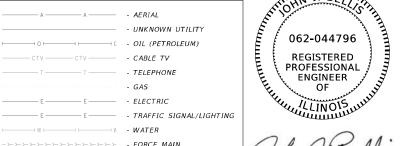
FIELD LOCATED UTILITIES MEET THE FEDERAL HIGHWAY ADMINISTRATION DEFINITION FOR "OUALITY LEVEL B" (OLB) STANDARDS.

UTILITY SIZE AND INFORMATION IS BASED ON BEST AVAILABLE FIELD AND RECORD INFORMATION.

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ALL ELECTRONIC DEPTHS PROVIDED ARE ESTIMATED APPROXIMATELY TO THE CENTER OF THE UTILITY UNLESS NOTED OTHERWISE AND SHOULD BE USED FOR INFORMATIONAL PURPOSES ONLY.

UTILITY LEGEND:



FO — FIBER OPTIC

TEST HOLE

- WATER

- WATER

- FORCE MAIN

- FOBER OPTIC

- TEST HOLE

- TEST HOLE
- END OF INFORMATION
- ELECTRONIC DEPTH

- TEST HOLE
- 89gnature

08/27/2020

SCALE:

license expires 11/30/2021

SHEET 5

062-044796 REGISTERED PROFESSIONAL ENGINEER OF

American Surveying & Engineering, P.C. 30 N. LaSalle St., Suite 3440 Chicago, IL 60605 Phone No. (312) 277-2000



2001 Butterfield Road, Suite 410 Downers Grove, IL 60515 Phone No. (630) 307-3800 Fax No. (630) 307-7030 Cert No. 6091 - LB No. 7055

USER NAME = Erick Maleza	DESIGNED -	REVISED -
	DRAWN - EM	REVISED -
PLOT SCALE = 50.0000 / in.	CHECKED - EG	REVISED -
PLOT DATE = 8/27/2020	DATE -	REVISED -

STATE OF ILLINOIS
DEPARTMENT OF TRANSPORTATION


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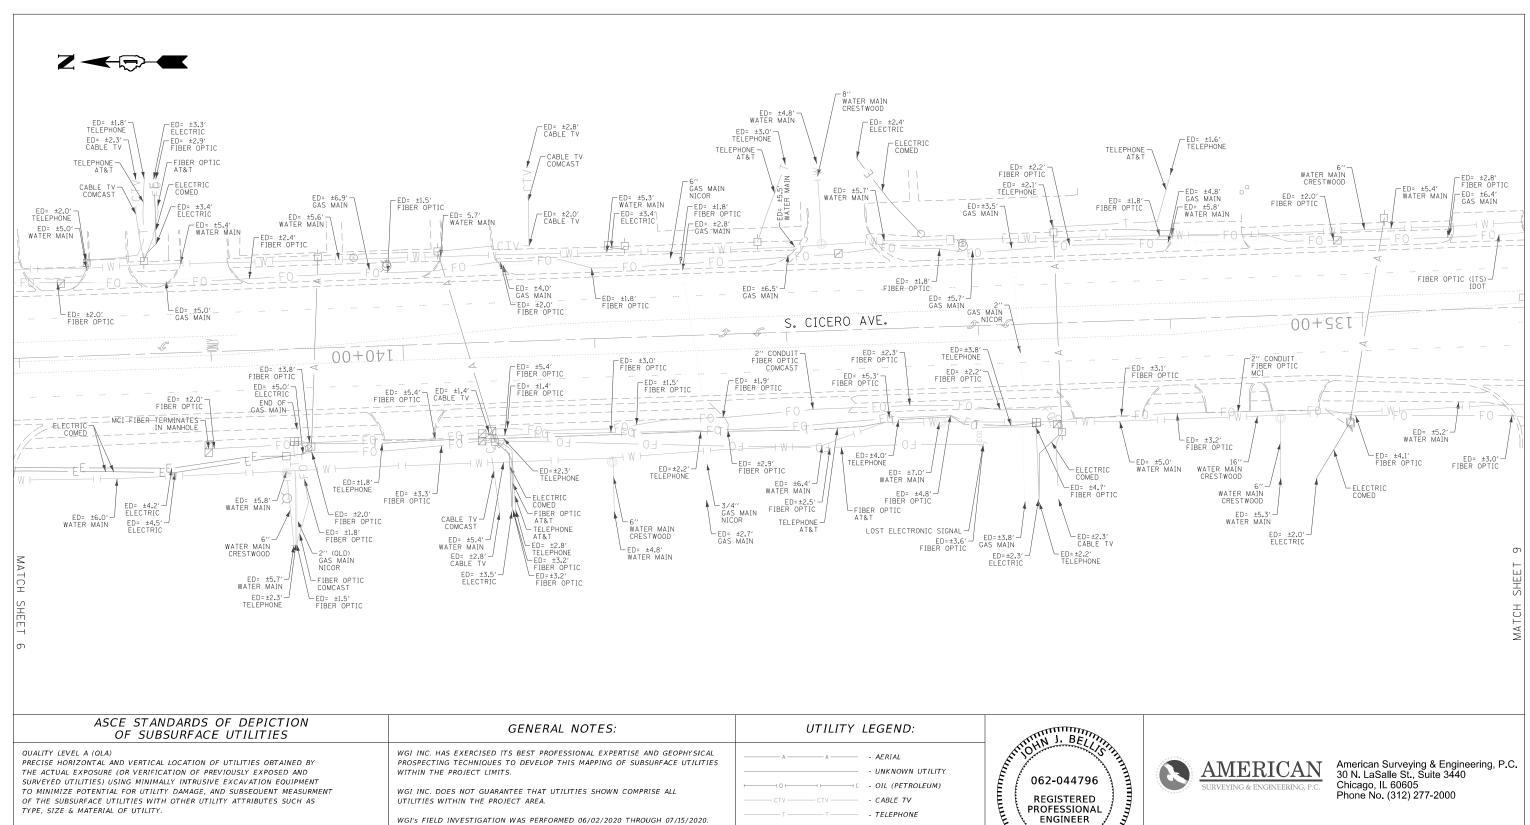
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IL. RT. 50 AT MIDLOTHIAN — CAL SAG RD CRESTWOOD, ILLINOIS

OF 18 SHEETS STA.

F.A. RTE	SECTION	COUNTY	TOTAL SHEETS	SHEET NO.		
350	2021-054-N&SW	соок	167	68		
		CONTRACT NO	CONTRACT NO. P-109313			



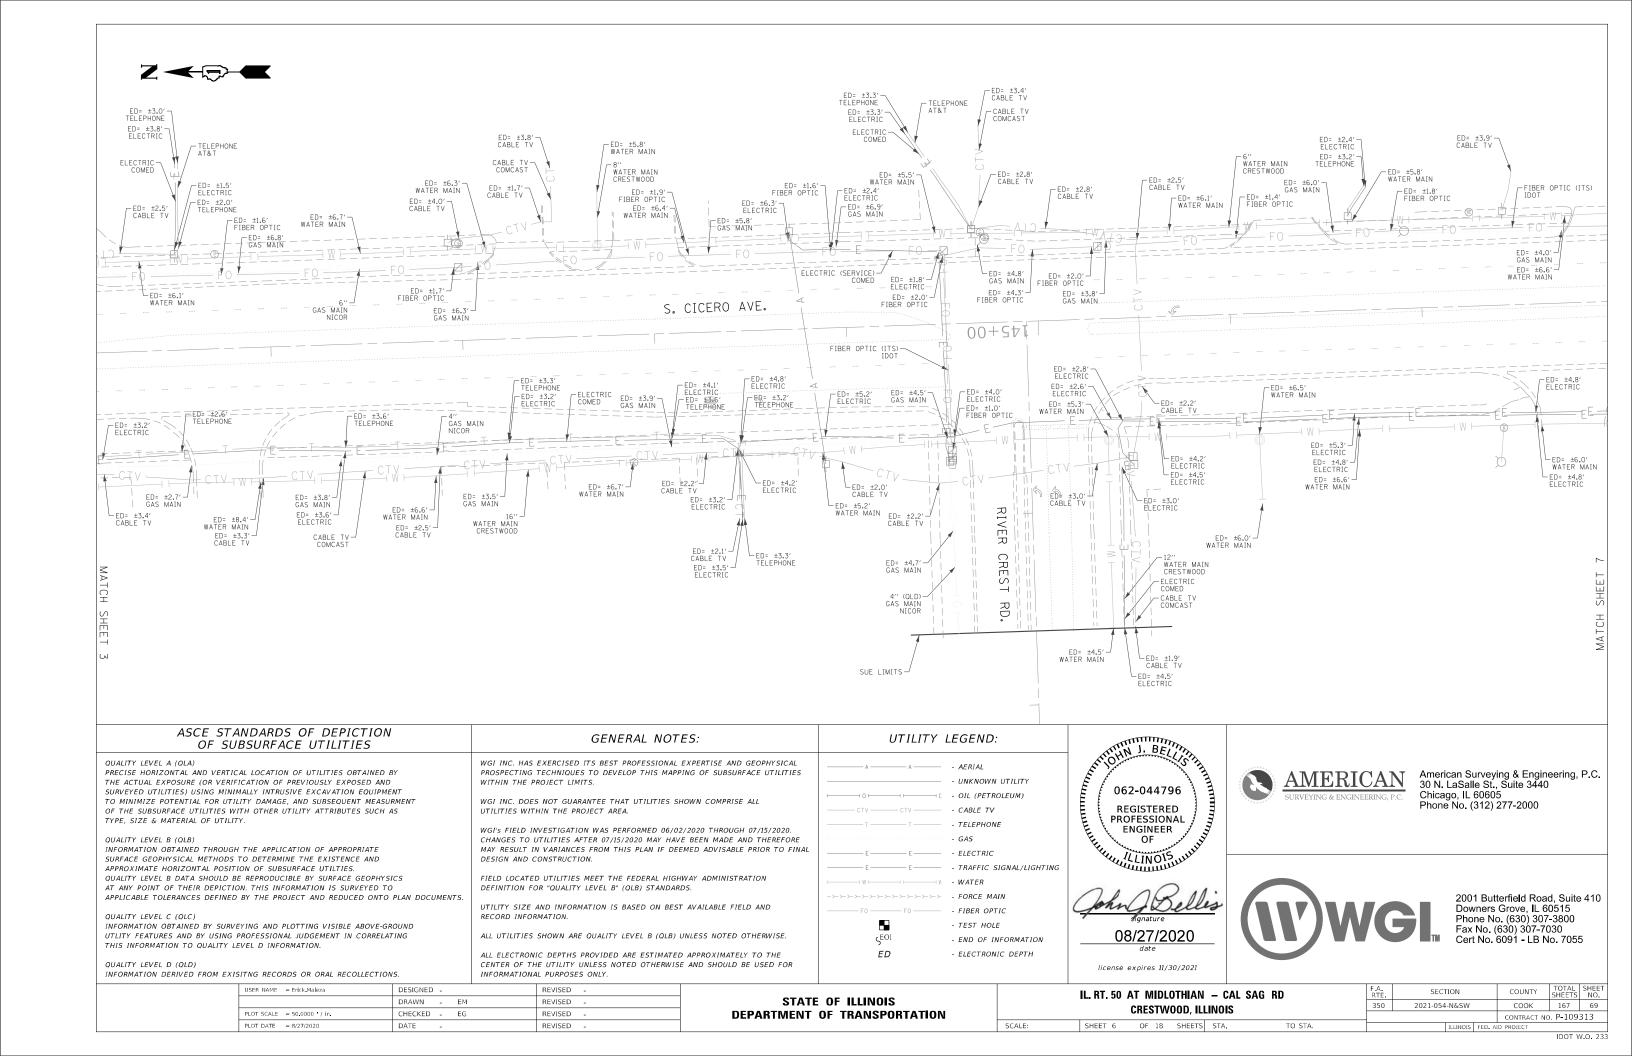

OF SUBSURFACE UTILITIES QUALITY LEVEL A (QLA) PRECISE HORIZONTAL AND VERTICAL LOCATION OF UTILITIES OBTAINED BY THE ACTUAL EXPOSURE (OR VERIFICATION OF PREVIOUSLY EXPOSED AND SURVEYED UTILITIES) USING MINIMALLY INTRUSIVE EXCAVATION EQUIPMENT TO MINIMIZE POTENTIAL FOR UTILITY DAMAGE, AND SUBSEQUENT MEASURMENT OF THE SUBSURFACE UTILITIES WITH OTHER UTILITY ATTRIBUTES SUCH AS TYPE, SIZE & MATERIAL OF UTILITY. QUALITY LEVEL B (QLB) INFORMATION OBTAINED THROUGH THE APPLICATION OF APPROPRIATE SURFACE GEOPHYSICAL METHODS TO DETERMINE THE EXISTENCE AND APPROXIMATE HORIZONTAL POSITION OF SUBSURFACE UTILTIES. QUALITY LEVEL B DATA SHOULD BE REPRODUCIBLE BY SURFACE GEOPHYSICS AT ANY POINT OF THEIR DEPICTION. THIS INFORMATION IS SURVEYED TO APPLICABLE TOLERANCES DEFINED BY THE PROJECT AND REDUCED ONTO PLAN DOCUMENTS

QUALITY LEVEL C (QLC) INFORMATION OBTAINED BY SURVEYING AND PLOTTING VISIBLE ABOVE-GROUND UTLITY FEATURES AND BY USING PROFESSIONAL JUDGEMENT IN CORRELATING THIS INFORMATION TO QUALITY LEVEL D INFORMATION.

INFORMATION DERIVED FROM EXISITNG RECORDS OR ORAL RECOLLECTIONS.

USER NAME = Erick.Maleza

PLOT DATE = 8/27/2020

DESIGNED -

DRAWN -

CHECKED -

DATE

EM

GENERAL NOTES:

WGI INC. HAS EXERCISED ITS BEST PROFESSIONAL EXPERTISE AND GEOPHYSICAL PROSPECTING TECHNIQUES TO DEVELOP THIS MAPPING OF SUBSURFACE UTILITIES WITHIN THE PROJECT LIMITS.

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FIELD LOCATED LITUITIES MEET THE FEDERAL HIGHWAY ADMINISTRATION DEFINITION FOR "QUALITY LEVEL B" (QLB) STANDARDS.

UTILITY SIZE AND INFORMATION IS BASED ON BEST AVAILABLE FIELD AND RECORD INFORMATION.

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ALL ELECTRONIC DEPTHS PROVIDED ARE ESTIMATED APPROXIMATELY TO THE CENTER OF THE UTILITY UNLESS NOTED OTHERWISE AND SHOULD BE USED FOR INFORMATIONAL PURPOSES ONLY.

REVISED

REVISED

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UTILITY LEGEND:

AERIAL CABLE TV TELEPHONE - GAS - ELECTRIC

TRAFFIC SIGNAL/LIGHTING WATER FORCE MAIN

TEST HOLE ζEOI - END OF INFORMATION ED - ELECTRONIC DEPTH

FIBER OPTIC

SCALE:

REGISTE, PROFESSION. ENGINEER OF 08/27/2020

license expires 11/30/2021

SHEET 7

AMERICAN

TO STA.

American Surveying & Engineering, P.C. 30 N. LaSalle St., Suite 3440 Chicago, IL 60605 Phone No. (312) 277-2000




2001 Butterfield Road, Suite 410 Downers Grove, IL 60515 Phone No. (630) 307-3800 Fax No. (630) 307-7030

STATE OF ILLINOIS **DEPARTMENT OF TRANSPORTATION**

IL. RT. 50	ΑT	MIDLOTHIAN -	. (CAL	SAG	RD	
	CR	ESTWOOD, ILLIN	0	IS			

OF 18 SHEETS STA.

F.A. RTE	SECTION	COUNTY	TOTAL SHEETS	SHEE NO	
350	2021-054-N&9	SW	соок	167	70
		CONTRACT NO. P-109313			
			•		

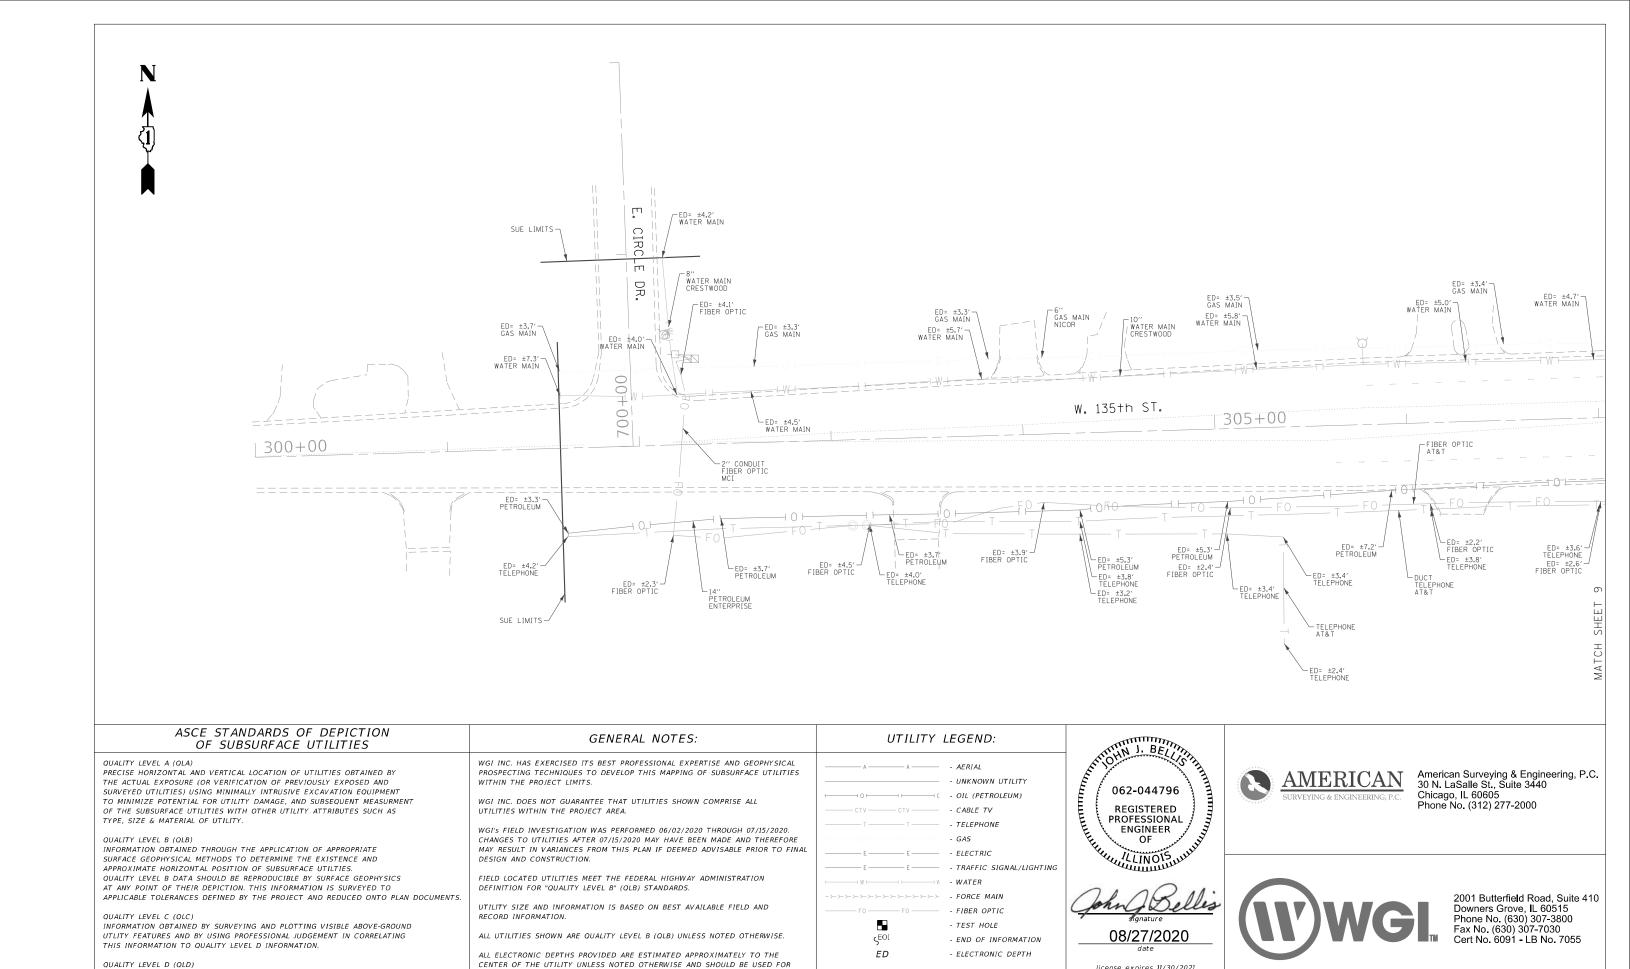

CONTRACT NO. P-109313

STATE OF ILLINOIS **DEPARTMENT OF TRANSPORTATION**

INFORMATION DERIVED FROM EXISITNG RECORDS OR ORAL RECOLLECTIONS.

USER NAME = Erick.Maleza

PLOT SCALE = 50.0000 / in.

PLOT DATE = 8/20/2020

INFORMATIONAL PURPOSES ONLY.

REVISED

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DESIGNED -

DATE

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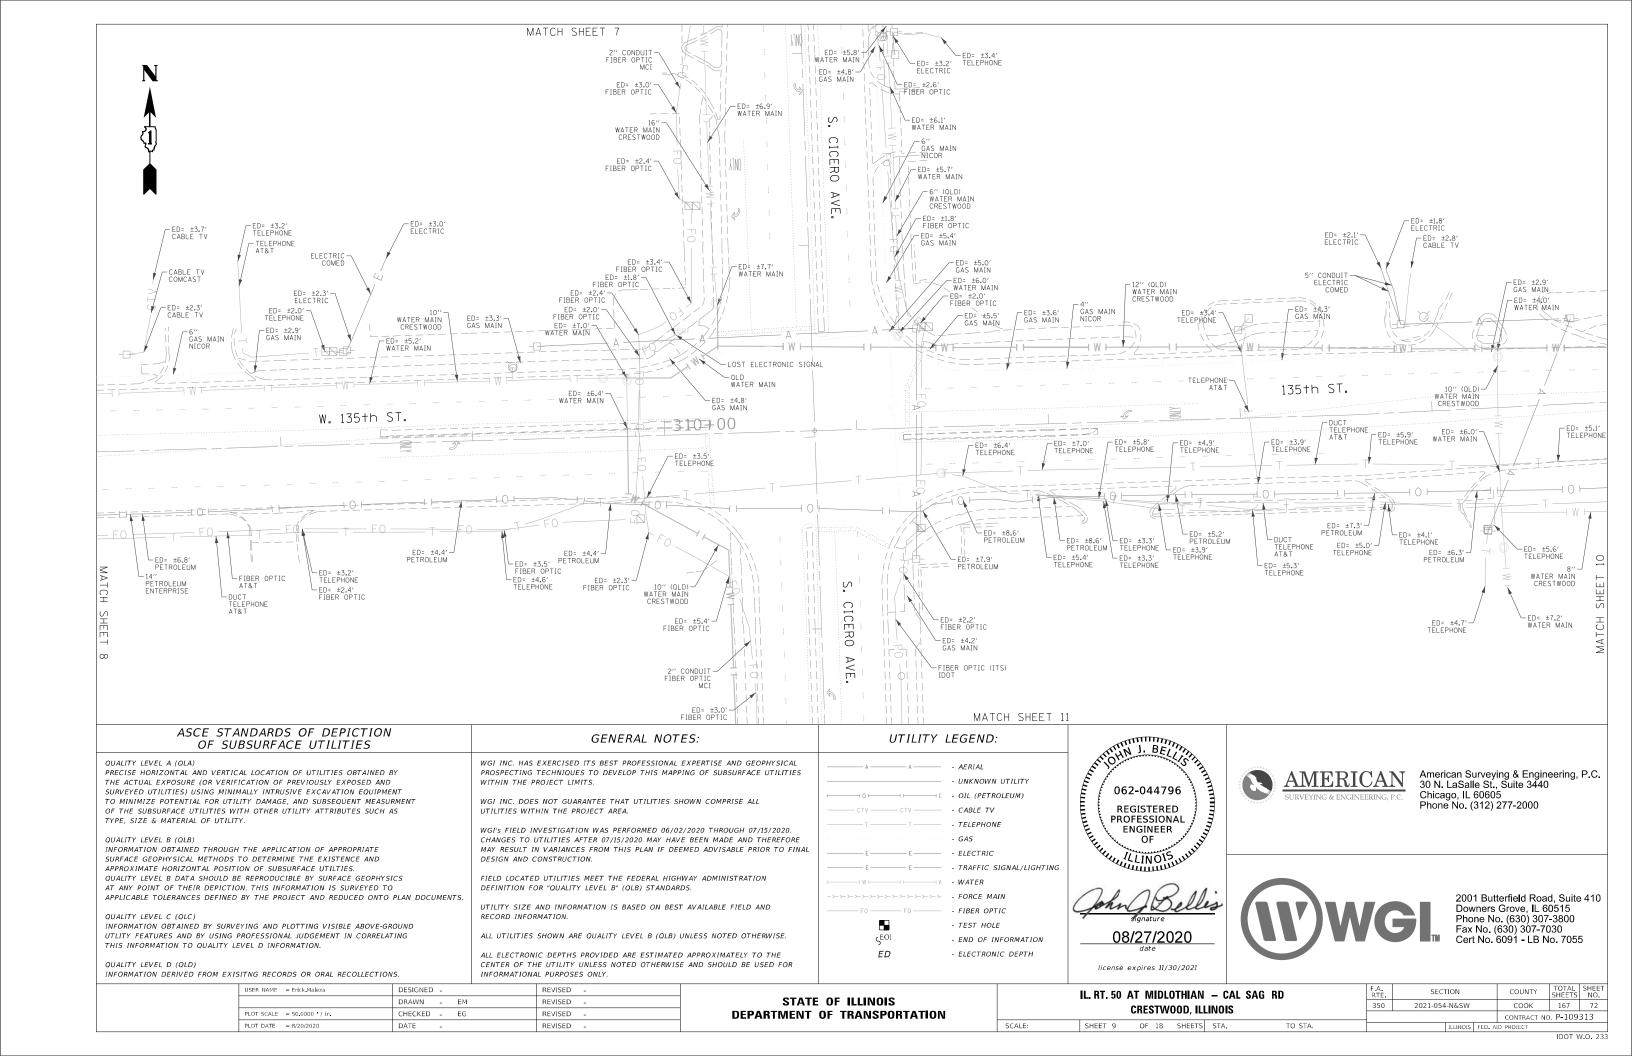
IL. RT. 50 AT MIDLOTHIAN - CAL SAG RD **CRESTWOOD, ILLINOIS** OF 18 SHEETS STA.


TO STA.

license expires 11/30/2021

SHEET 8

SECTION COUNTY 350 2021-054-N&SW соок 167 71



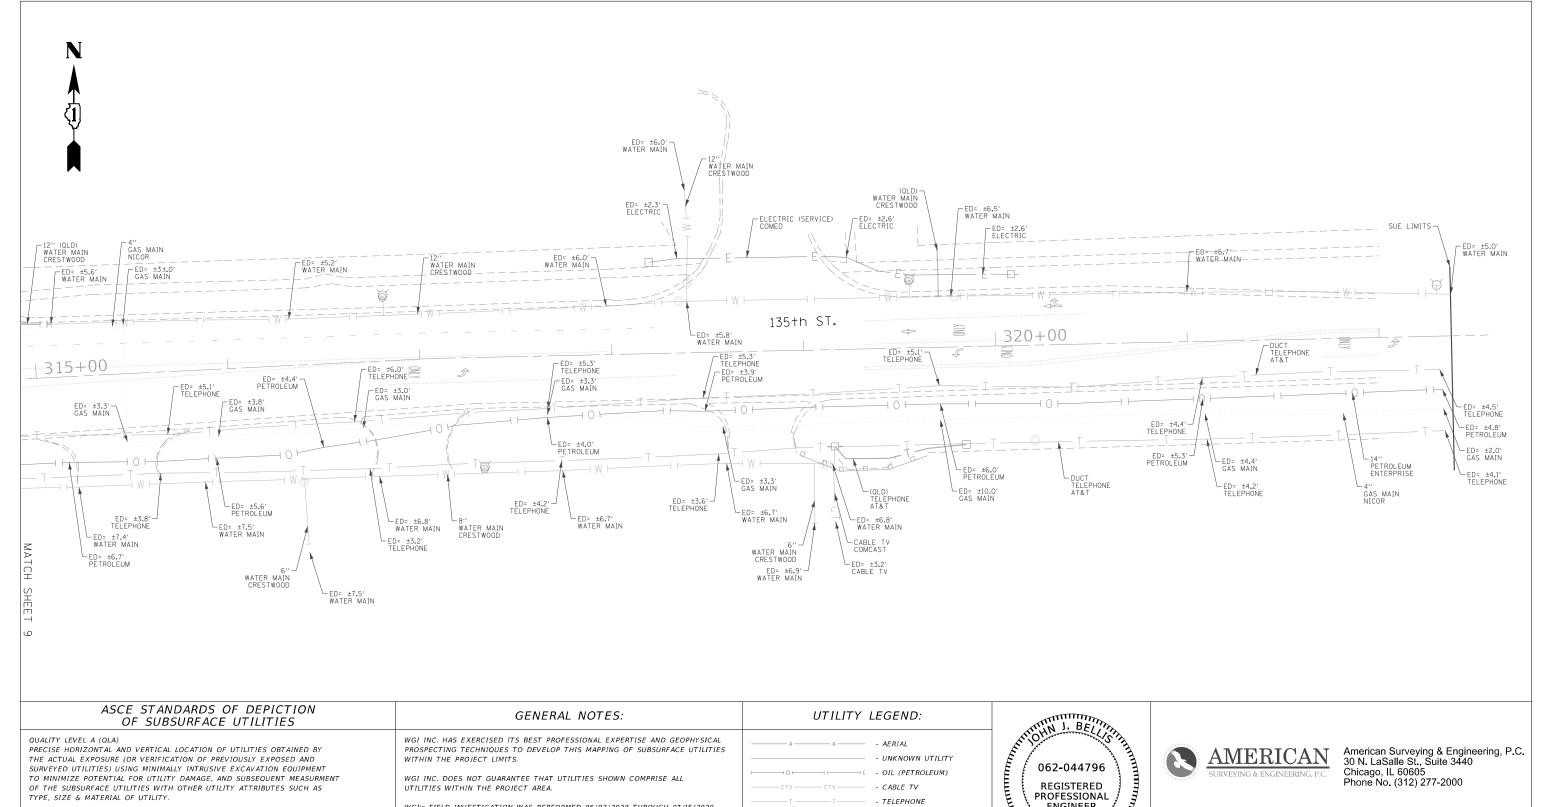

QUALITY LEVEL A (QLA) PRECISE HORIZONTAL AND VERTICAL LOCATION OF UTILITIES OBTAINED BY THE ACTUAL EXPOSURE (OR VERIFICATION OF PREVIOUSLY EXPOSED AND SURVEYED UTILITIES) USING MINIMALLY INTRUSIVE EXCAVATION EQUIPMENT TO MINIMIZE POTENTIAL FOR UTILITY DAMAGE, AND SUBSEQUENT MEASURMENT OF THE SUBSURFACE UTILITIES WITH OTHER UTILITY ATTRIBUTES SUCH AS TYPE, SIZE & MATERIAL OF UTILITY QUALITY LEVEL B (QLB) INFORMATION OBTAINED THROUGH THE APPLICATION OF APPROPRIATE SURFACE GEOPHYSICAL METHODS TO DETERMINE THE EXISTENCE AND APPROXIMATE HORIZONTAL POSITION OF SUBSURFACE UTILTIES. QUALITY LEVEL B DATA SHOULD BE REPRODUCIBLE BY SURFACE GEOPHYSICS AT ANY POINT OF THEIR DEPICTION. THIS INFORMATION IS SURVEYED TO

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AERIAL CABLE TV

REGISI.
PROFESSIC
ENGINEER
OF

ALLINOIS TELEPHONE GAS - ELECTRIC TRAFFIC SIGNAL/LIGHTING

WATER FORCE MAIN FIBER OPTIC

> TEST HOLE ςEOI - END OF INFORMATION ED - ELECTRONIC DEPTH

08/27/2020

license expires 11/30/2021

SHEET 10 OF 18 SHEETS STA.

AMERICAN

American Surveying & Engineering, P.C. 30 N. LaSalle St., Suite 3440 Chicago, IL 60605 Phone No. (312) 277-2000





2001 Butterfield Road, Suite 410 Downers Grove, IL 60515 Phone No. (630) 307-3800 Fax No. (630) 307-7030


USER NAME = Erick.Maleza DESIGNED -REVISED DRAWN -EM REVISED PLOT SCALE = 50.0000 / in. CHECKED -REVISED PLOT DATE = 8/27/2020 REVISED

STATE OF ILLINOIS **DEPARTMENT OF TRANSPORTATION** IL. RT. 50 AT MIDLOTHIAN - CAL SAG RD CRESTWOOD, ILLINOIS


F.A. RTE	SECTION	COUNTY	TOTAL SHEETS	SHEI
350	2021-054-N&SW	соок	167	73
		CONTRACT NO	P-109	313
		•		

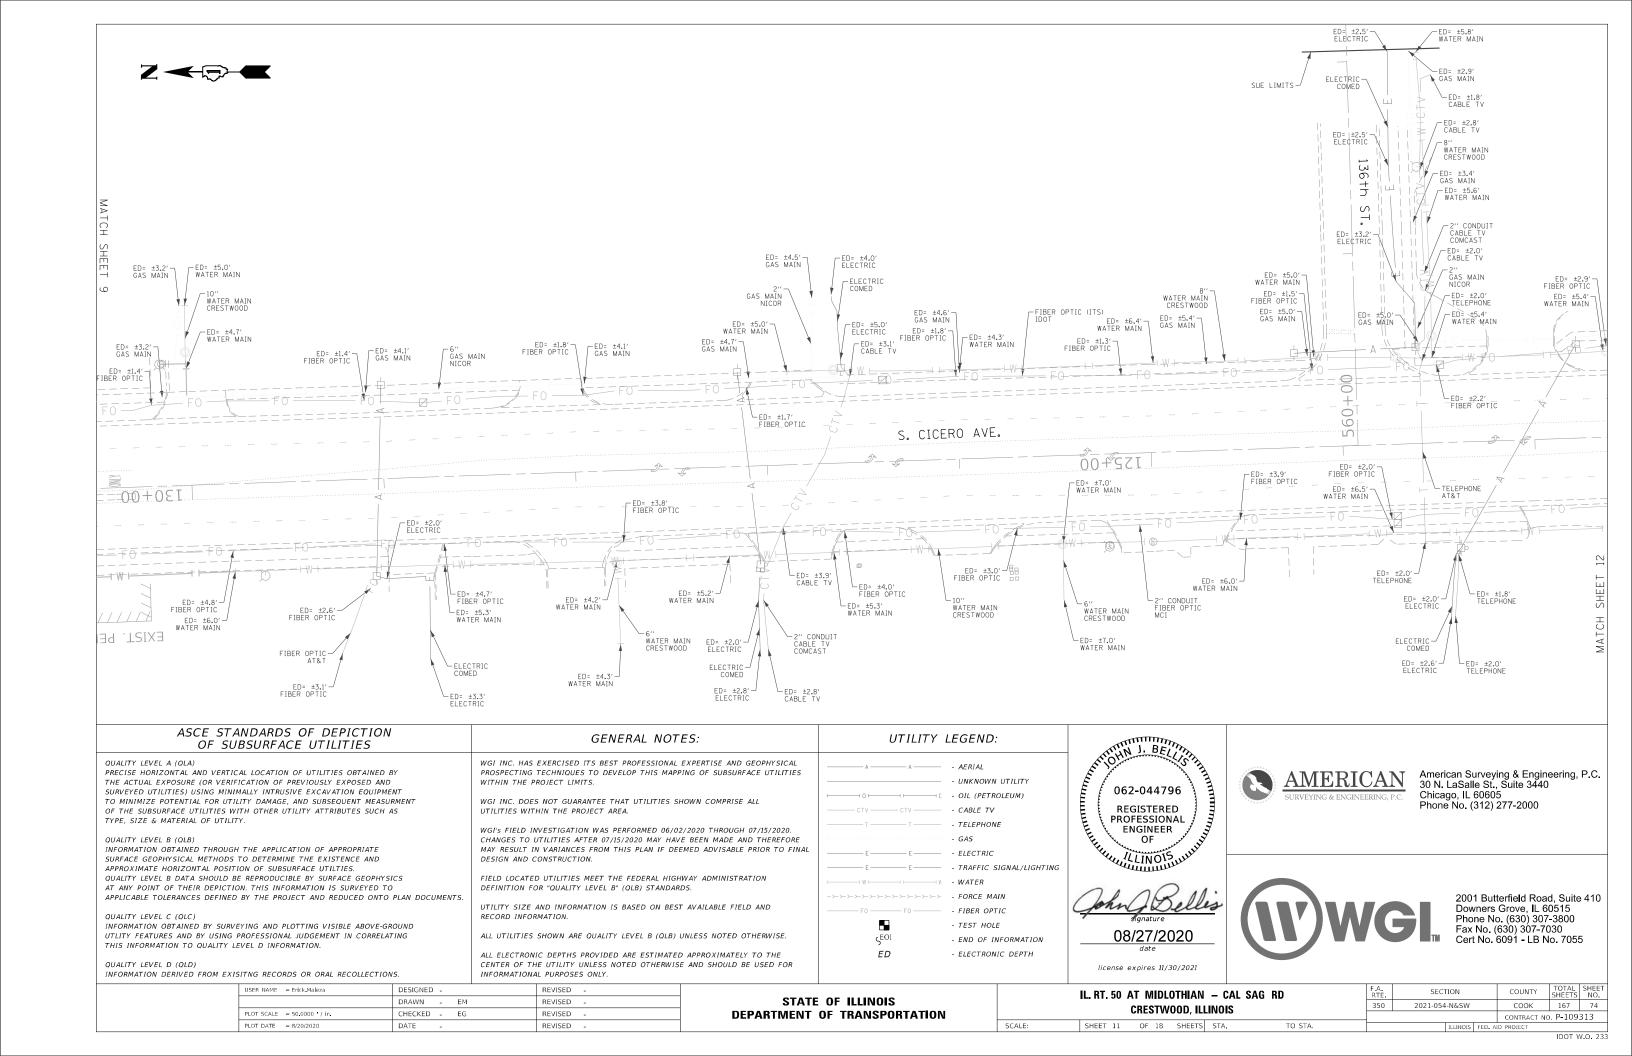

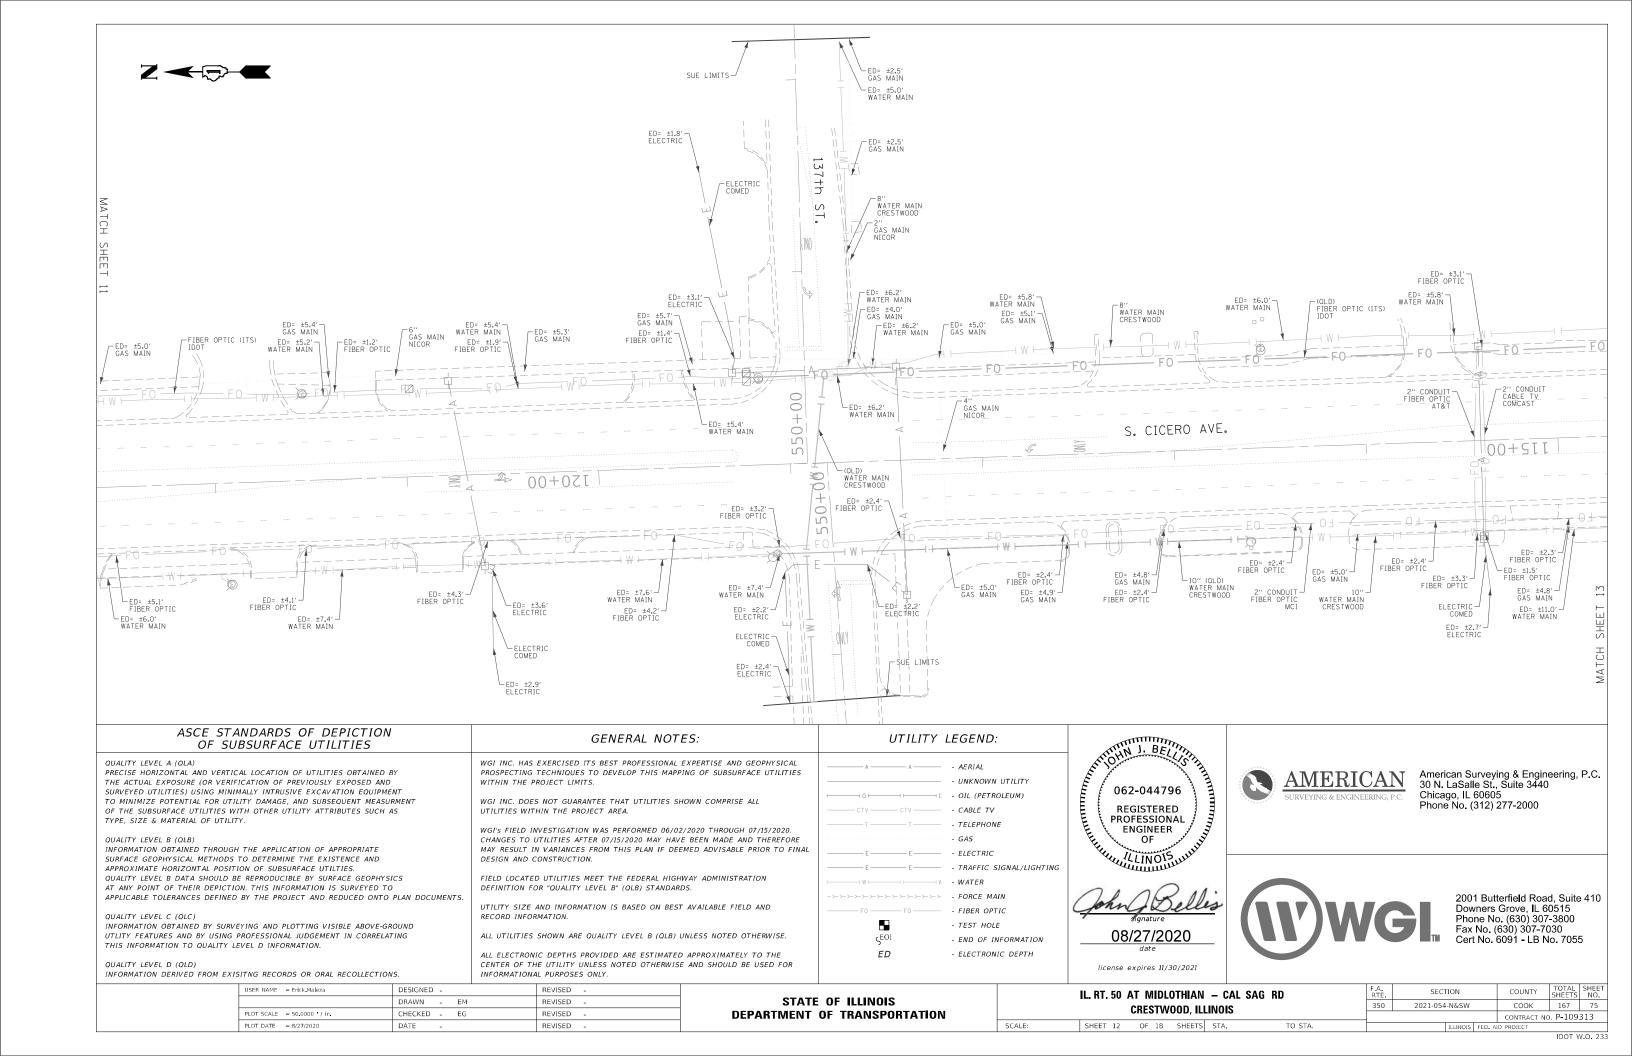

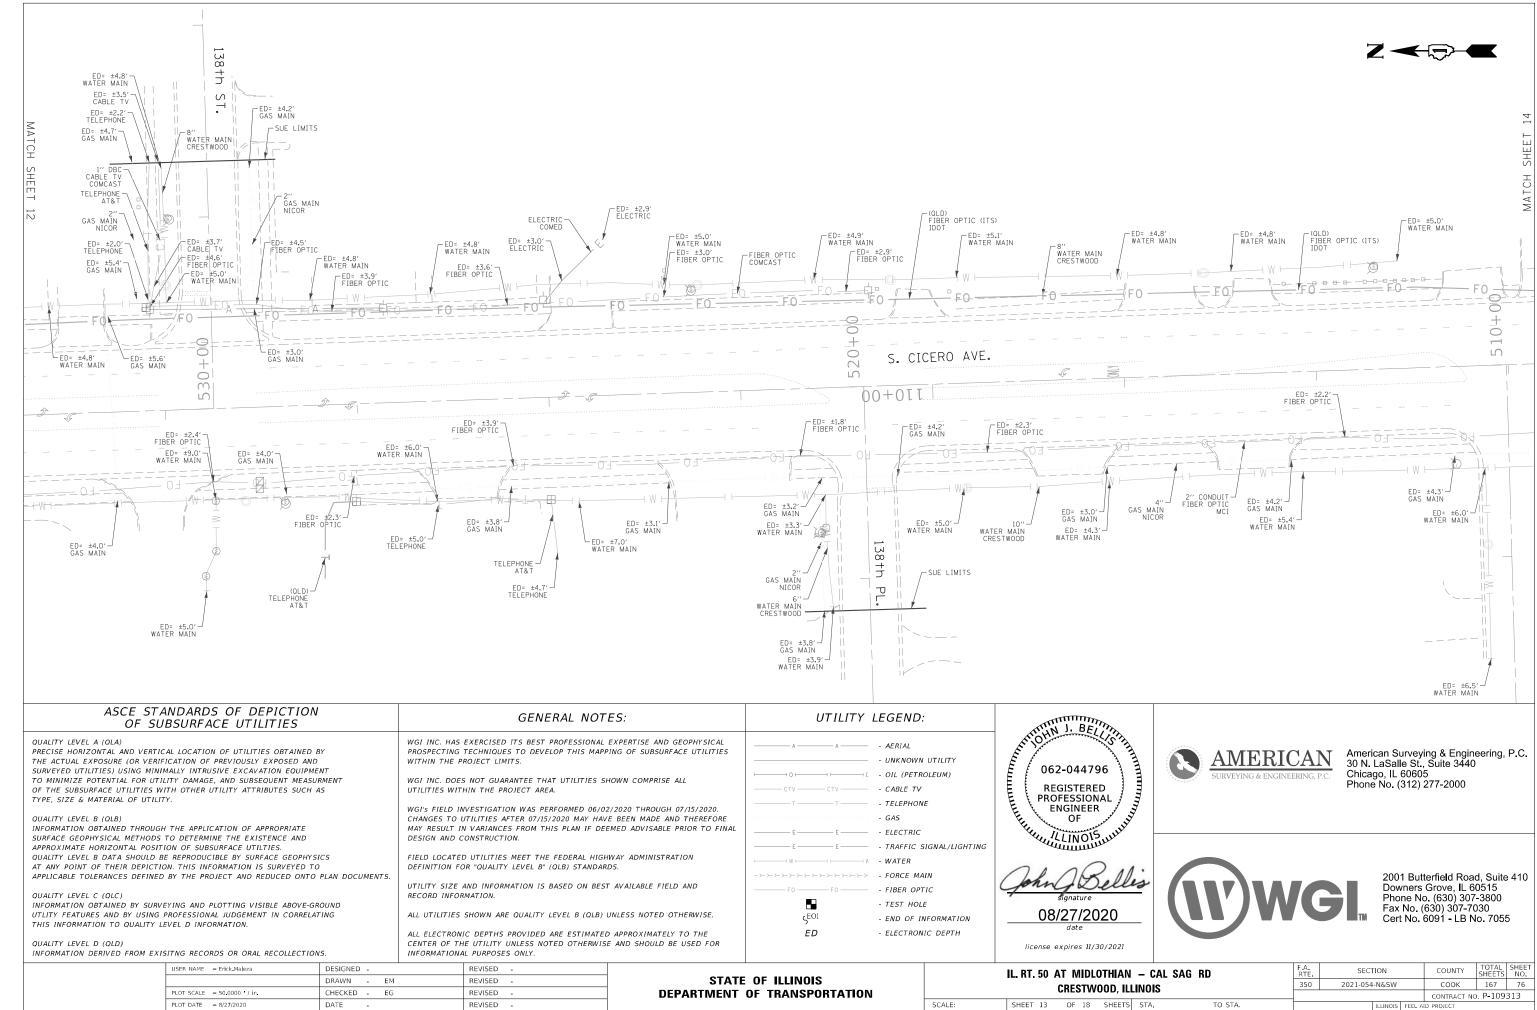

IDOT W.O. 233

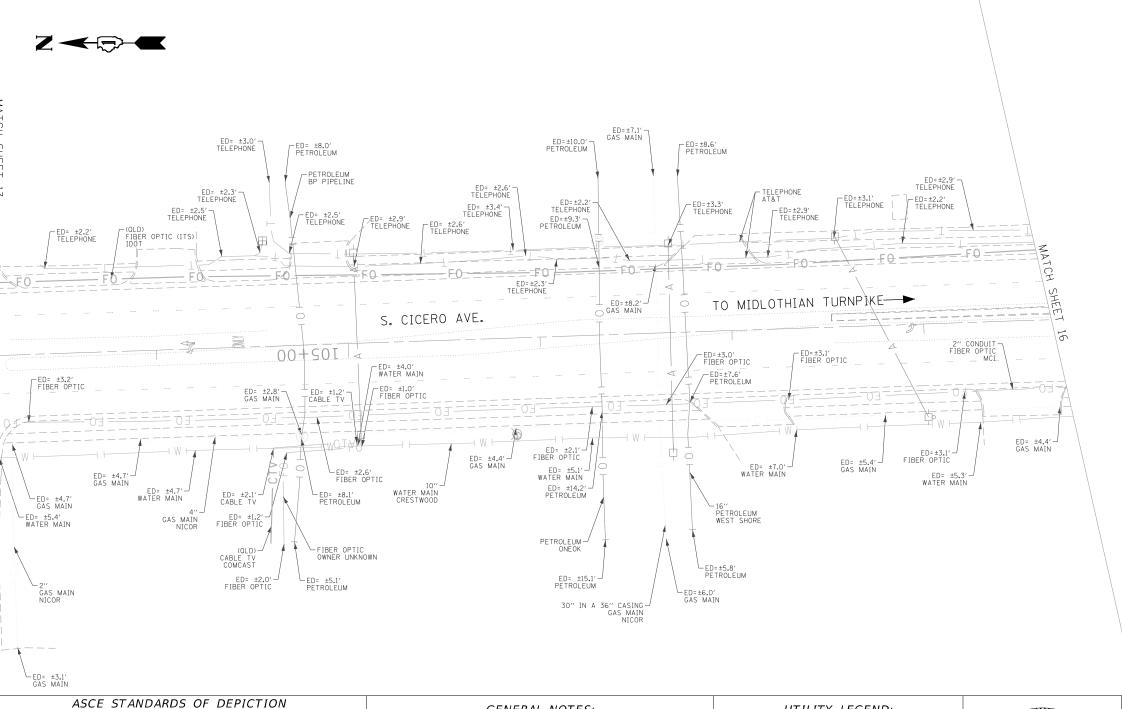

OF SUBSURFACE UTILITIES QUALITY LEVEL A (QLA) PRECISE HORIZONTAL AND VERTICAL LOCATION OF UTILITIES OBTAINED BY THE ACTUAL EXPOSURE (OR VERIFICATION OF PREVIOUSLY EXPOSED AND SURVEYED UTILITIES) USING MINIMALLY INTRUSIVE EXCAVATION EQUIPMENT TO MINIMIZE POTENTIAL FOR UTILITY DAMAGE, AND SUBSEQUENT MEASURMENT OF THE SUBSURFACE UTILITIES WITH OTHER UTILITY ATTRIBUTES SUCH AS TYPE, SIZE & MATERIAL OF UTILITY QUALITY LEVEL B (QLB) INFORMATION OBTAINED THROUGH THE APPLICATION OF APPROPRIATE SURFACE GEOPHYSICAL METHODS TO DETERMINE THE EXISTENCE AND APPROXIMATE HORIZONTAL POSITION OF SUBSURFACE UTILTIES. QUALITY LEVEL B DATA SHOULD BE REPRODUCIBLE BY SURFACE GEOPHYSICS AT ANY POINT OF THEIR DEPICTION. THIS INFORMATION IS SURVEYED TO

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APPLICABLE TOLERANCES DEFINED BY THE PROJECT AND REDUCED ONTO PLAN DOCUMENTS

INFORMATION DERIVED FROM EXISITNG RECORDS OR ORAL RECOLLECTIONS

GENERAL NOTES:

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UTILITY LEGEND:

AERIAL CABLE TV TELEPHONE - GAS - ELECTRIC

TRAFFIC SIGNAL/LIGHTING WATER FORCE MAIN

FIBER OPTIC TEST HOLE ςEOI - END OF INFORMATION

ED - ELECTRONIC DEPTH

SCALE:

-044796 REGISI. PROFESSIC ENGINEER OF ALLINOIS

license expires 11/30/2021

SHEET 14 OF 18 SHEETS STA.



American Surveying & Engineering, P.C. 30 N. LaSalle St., Suite 3440 **AMERICAN** Chicago, IL 60605 Phone No. (312) 277-2000



08/27/2020

TO STA.

2001 Butterfield Road, Suite 410 Downers Grove, IL 60515 Phone No. (630) 307-3800


USER NAME = Erick Maleza	DESIGNED -	REVISED -
	DRAWN - EM	REVISED -
PLOT SCALE = 50.0000 / in.	CHECKED - EG	REVISED -
PLOT DATE = 8/27/2020	DATE -	REVISED -

STATE OF ILLINOIS **DEPARTMENT OF TRANSPORTATION**

IL. RT. 50	AT MIDLOTHIAN - CAL	SAG RD
	CRESTWOOD, ILLINOIS	

F.A. RTE	SECTION	COUNTY	TOTAL SHEETS	SHEE	
350	2021-054-N&SW	соок	167	77	
		CONTRACT NO. P-109313			
		•			

IDOT W.O. 233

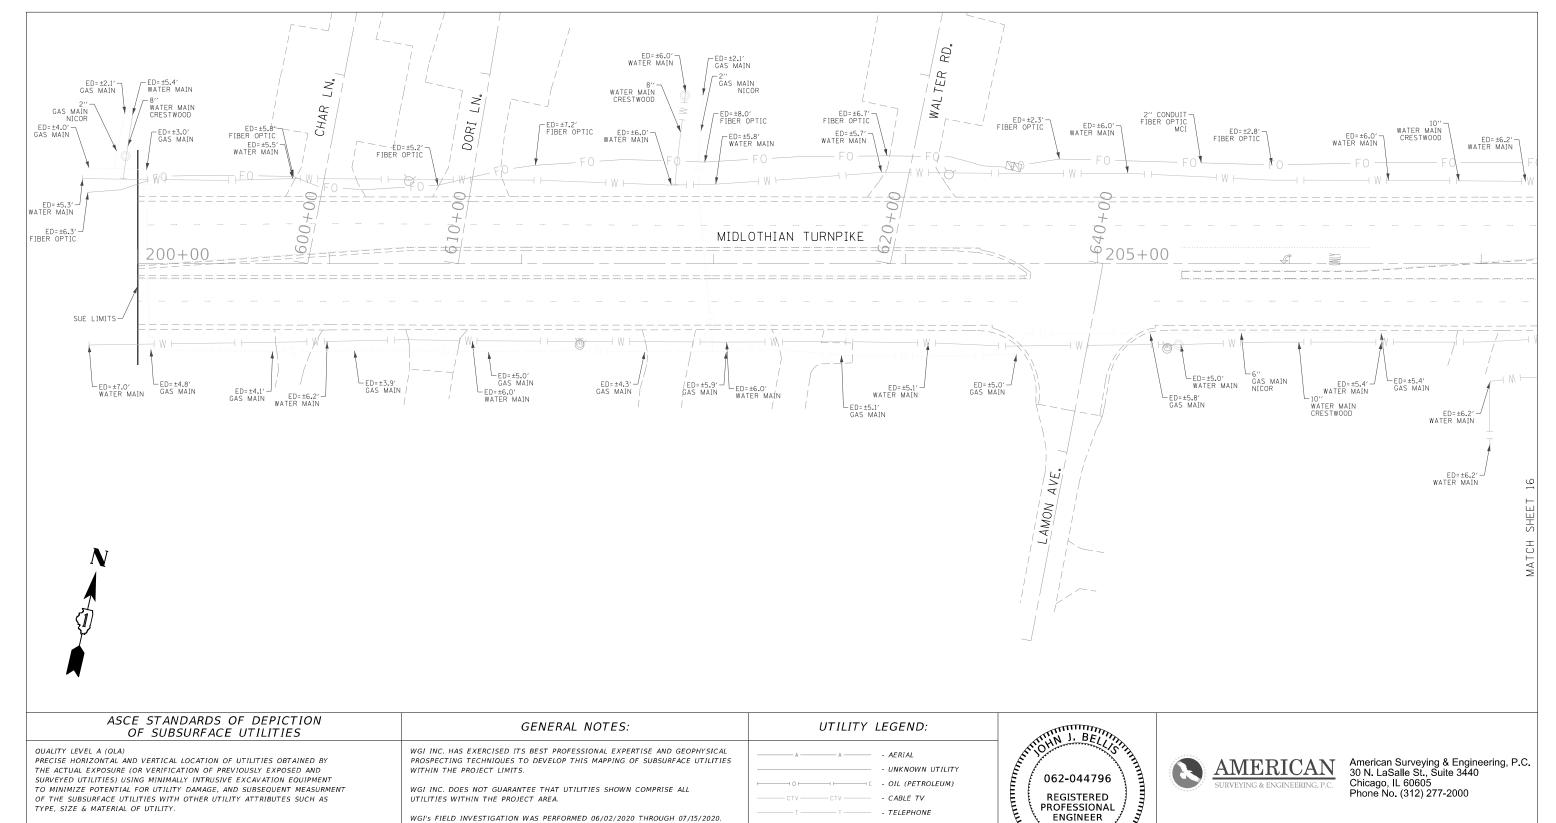

SURVEYED UTILITIES) USING MINIMALLY INTRUSIVE EXCAVATION EQUIPMENT TO MINIMIZE POTENTIAL FOR UTILITY DAMAGE, AND SUBSEQUENT MEASURMENT OF THE SUBSURFACE UTILITIES WITH OTHER UTILITY ATTRIBUTES SUCH AS TYPE, SIZE & MATERIAL OF UTILITY. QUALITY LEVEL B (QLB) INFORMATION OBTAINED THROUGH THE APPLICATION OF APPROPRIATE SURFACE GEOPHYSICAL METHODS TO DETERMINE THE EXISTENCE AND APPROXIMATE HORIZONTAL POSITION OF SUBSURFACE UTILTIES. QUALITY LEVEL B DATA SHOULD BE REPRODUCIBLE BY SURFACE GEOPHYSICS AT ANY POINT OF THEIR DEPICTION. THIS INFORMATION IS SURVEYED TO APPLICABLE TOLERANCES DEFINED BY THE PROJECT AND REDUCED ONTO PLAN DOCUMENTS QUALITY LEVEL C (QLC)

INFORMATION OBTAINED BY SURVEYING AND PLOTTING VISIBLE ABOVE-GROUND UTLITY FEATURES AND BY USING PROFESSIONAL JUDGEMENT IN CORRELATING THIS INFORMATION TO QUALITY LEVEL D INFORMATION.

INFORMATION DERIVED FROM EXISITNG RECORDS OR ORAL RECOLLECTIONS.

USER NAME = Erick.Maleza

WGI INC. DOES NOT GUARANTEE THAT UTILITIES SHOWN COMPRISE ALL UTILITIES WITHIN THE PROJECT AREA.

WGI'S FIELD INVESTIGATION WAS PERFORMED 06/02/2020 THROUGH 07/15/2020. CHANGES TO UTILITIES AFTER 07/15/2020 MAY HAVE BEEN MADE AND THEREFORE MAY RESULT IN VARIANCES FROM THIS PLAN IF DEEMED ADVISABLE PRIOR TO FINAL

FIELD LOCATED UTILITIES MEET THE FEDERAL HIGHWAY ADMINISTRATION DEFINITION FOR "QUALITY LEVEL B" (QLB) STANDARDS.

UTILITY SIZE AND INFORMATION IS BASED ON BEST AVAILABLE FIELD AND RECORD INFORMATION.

ALL UTILITIES SHOWN ARE QUALITY LEVEL B (QLB) UNLESS NOTED OTHERWISE.

ALL ELECTRONIC DEPTHS PROVIDED ARE ESTIMATED APPROXIMATELY TO THE CENTER OF THE UTILITY UNLESS NOTED OTHERWISE AND SHOULD BE USED FOR INFORMATIONAL PURPOSES ONLY.

REVISED

CABLE TV TELEPHONE - GAS

- ELECTRIC TRAFFIC SIGNAL/LIGHTING WATER

FORCE MAIN FIBER OPTIC

ςEOI - END OF INFORMATION ED - ELECTRONIC DEPTH

TEST HOLE

SCALE:

REGISI. PROFESSIC ENGINEER OF ALLINOIS

CRESTWOOD, ILLINOIS

SHEET 15 OF 18 SHEETS STA

Chicago, IL 60605 Phone No. (312) 277-2000



2001 Butterfield Road, Suite 410 Downers Grove, IL 60515 Phone No. (630) 307-3800

license expires 11/30/2021 IL. RT. 50 AT MIDLOTHIAN - CAL SAG RD

TO STA.


F.A. RTE	SECTION	COUNTY	TOTAL SHEETS	SHEE NO.
350	2021-054-N&SW	соок	167	78
		CONTRACT NO	P-109	313
	TURNOTE SER A	ID DOOLEGE		


DRAWN -EM REVISED PLOT SCALE = 50.0000 / in. CHECKED -EG REVISED PLOT DATE = 8/20/2020 DATE REVISED

DESIGNED -

STATE OF ILLINOIS **DEPARTMENT OF TRANSPORTATION**

IDOT W.O. 233

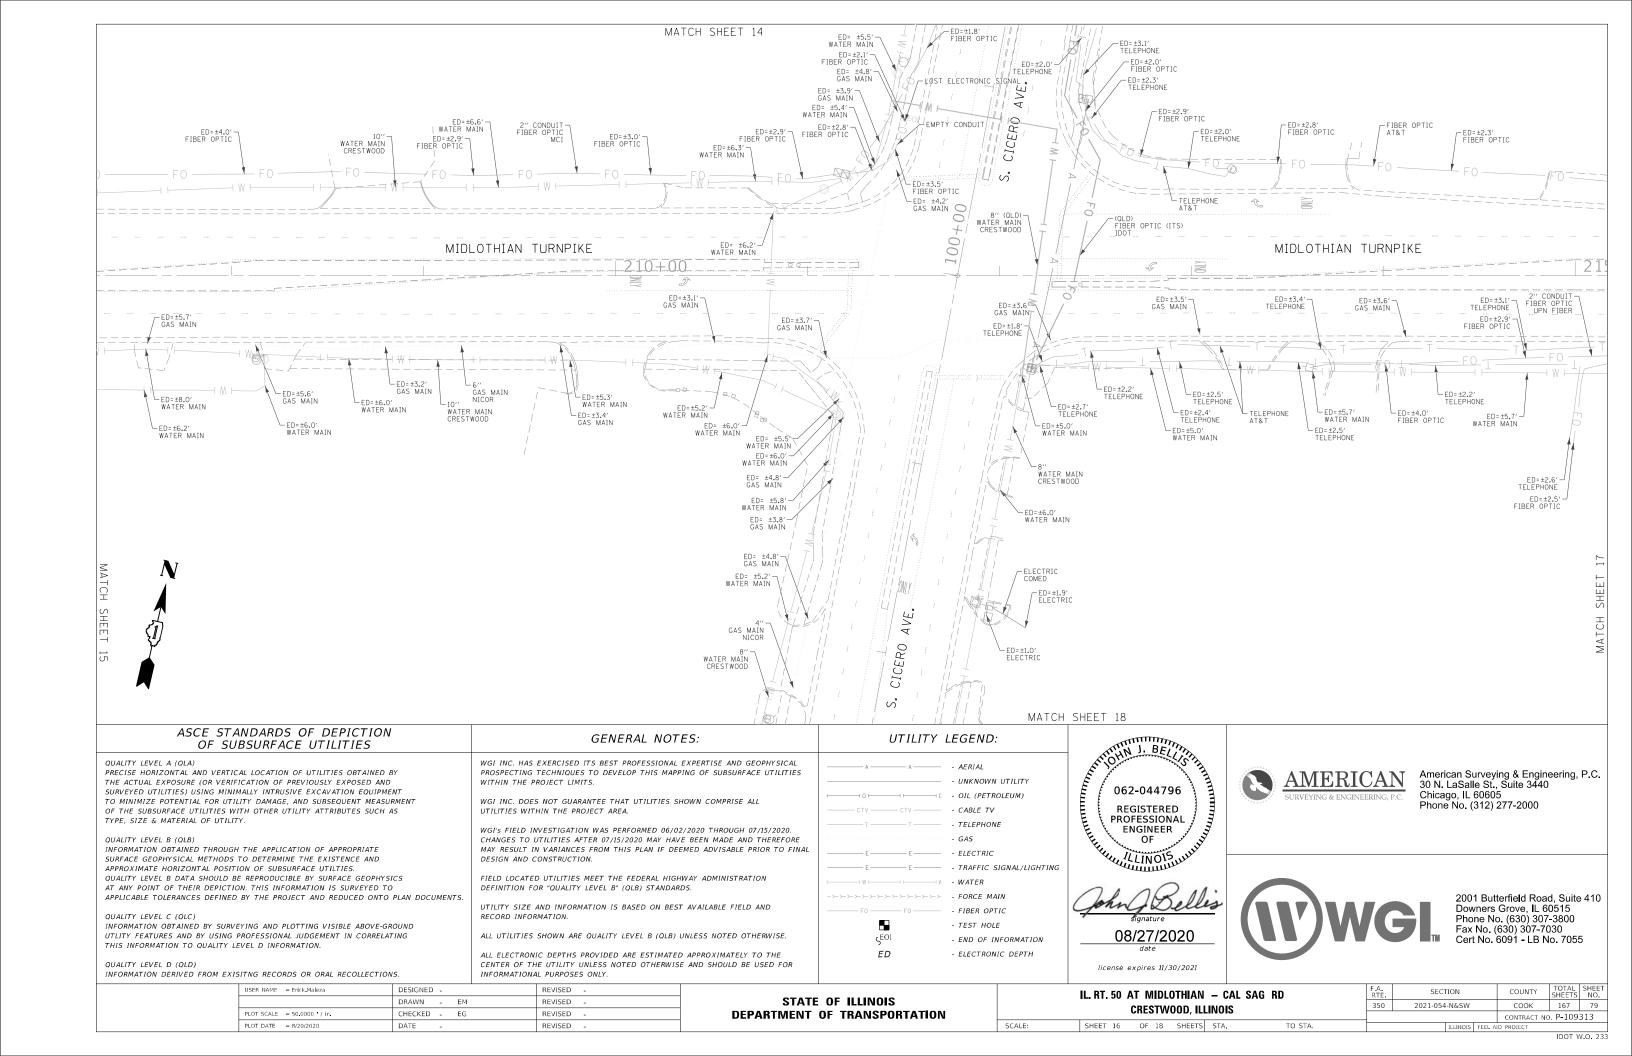

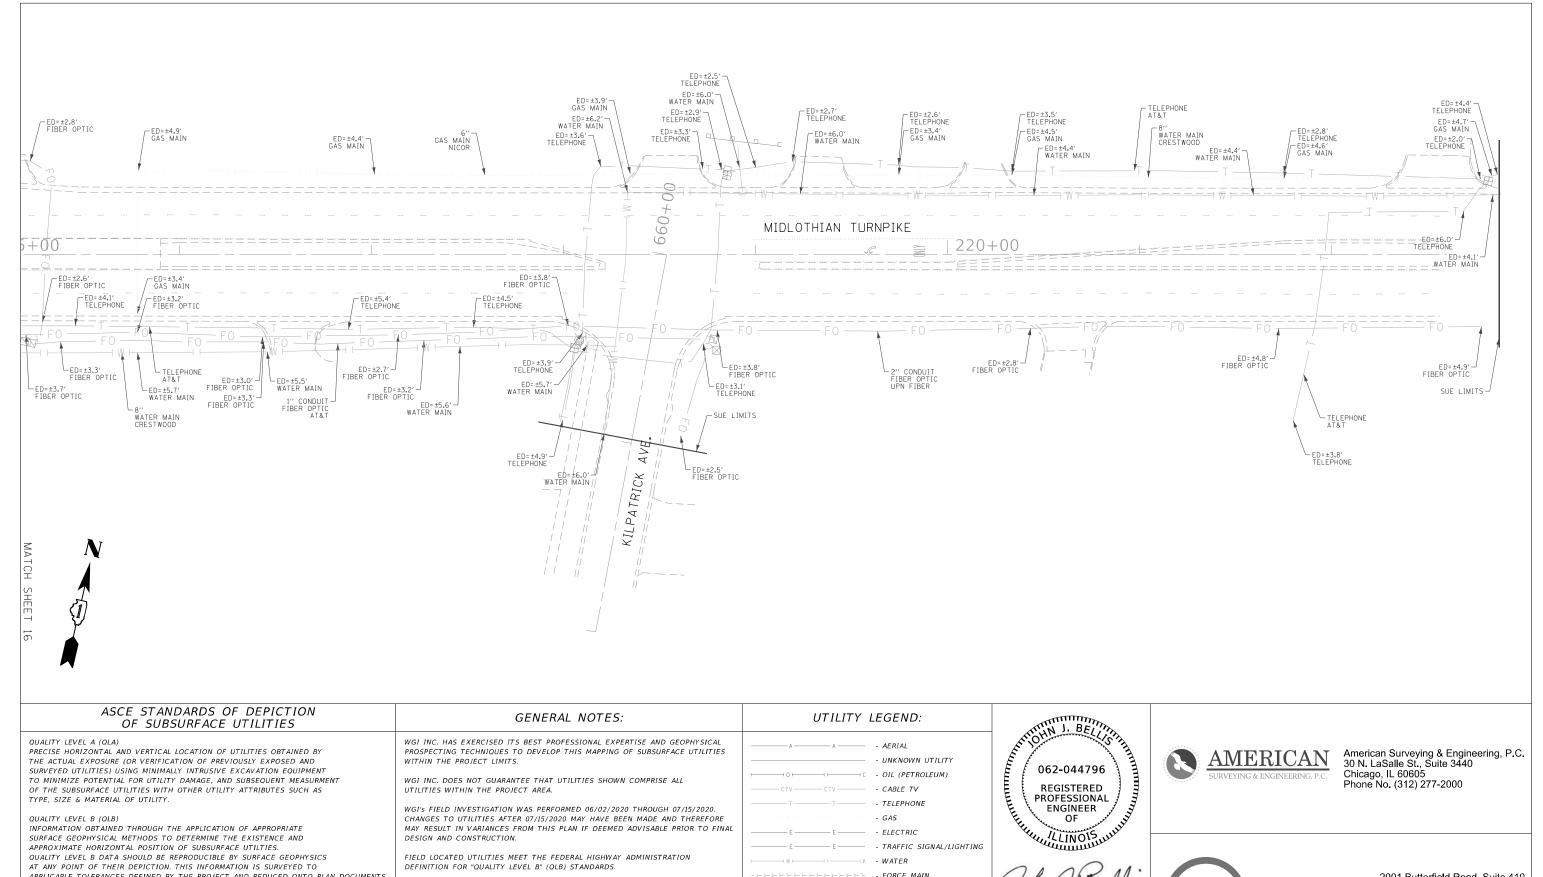

THE ACTUAL EXPOSURE (OR VERIFICATION OF PREVIOUSLY EXPOSED AND SURVEYED UTILITIES) USING MINIMALLY INTRUSIVE EXCAVATION EQUIPMENT TO MINIMIZE POTENTIAL FOR UTILITY DAMAGE. AND SUBSEQUENT MEASURMENT OF THE SUBSURFACE UTILITIES WITH OTHER UTILITY ATTRIBUTES SUCH AS TYPE, SIZE & MATERIAL OF UTILITY QUALITY LEVEL B (QLB) INFORMATION OBTAINED THROUGH THE APPLICATION OF APPROPRIATE SURFACE GEOPHYSICAL METHODS TO DETERMINE THE EXISTENCE AND APPROXIMATE HORIZONTAL POSITION OF SUBSURFACE UTILTIES. QUALITY LEVEL B DATA SHOULD BE REPRODUCIBLE BY SURFACE GEOPHYSICS AT ANY POINT OF THEIR DEPICTION. THIS INFORMATION IS SURVEYED TO APPLICABLE TOLERANCES DEFINED BY THE PROJECT AND REDUCED ONTO PLAN DOCUMENTS

QUALITY LEVEL C (QLC) INFORMATION OBTAINED BY SURVEYING AND PLOTTING VISIBLE ABOVE-GROUND UTLITY FEATURES AND BY USING PROFESSIONAL JUDGEMENT IN CORRELATING THIS INFORMATION TO QUALITY LEVEL D INFORMATION.

INFORMATION DERIVED FROM EXISITNG RECORDS OR ORAL RECOLLECTIONS.

WITHIN THE PROJECT LIMITS.

WGI INC. DOES NOT GUARANTEE THAT UTILITIES SHOWN COMPRISE ALL UTILITIES WITHIN THE PROJECT AREA.


WGI'S FIELD INVESTIGATION WAS PERFORMED 06/02/2020 THROUGH 07/15/2020. CHANGES TO UTILITIES AFTER 07/15/2020 MAY HAVE BEEN MADE AND THEREFORE MAY RESULT IN VARIANCES FROM THIS PLAN IF DEEMED ADVISABLE PRIOR TO FINAL

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FIBER OPTIC - TEST HOLE

- END OF INFORMATION

SCALE:

- ELECTRONIC DEPTH

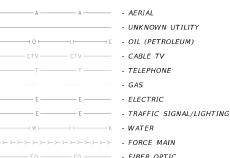08/27/2020

license expires 11/30/2021

	AMERICAN
	SURVEYING & ENGINEERING, P.C.

American Surveying & Engineering, P.C. 30 N. LaSalle St., Suite 3440 Chicago, IL 60605 Phone No. (312) 277-2000



2001 Butterfield Road, Suite 410 Downers Grove, IL 60515 Phone No. (630) 307-3800


USER NAME = Erick Maleza	DESIGNED -	REVISED -	
	DRAWN - EM	REVISED -	
PLOT SCALE = 50.0000 / in.	CHECKED - EG	REVISED -	
PLOT DATE = 8/20/2020	DATE -	REVISED -	

STATE OF ILLINOIS **DEPARTMENT OF TRANSPORTATION**

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IL. RT. 50 AT MIDLOTHIAN - CAL SAG RD				F.A. RTE	SECTION	COUNTY	TOTAL SHEETS	SHEET NO.		
CRESTWOOD, ILLINOIS			350	2021-054-N&SW	соок	167	80			
GREST WOOD, ILLINOIS						CONTRACT N	P-109	313		
	SHEET 17	OF 18	SHEETS	STA.	TO STA.		ILLINOIS FED.	AID PROJECT		



STATE OF ILLINOIS

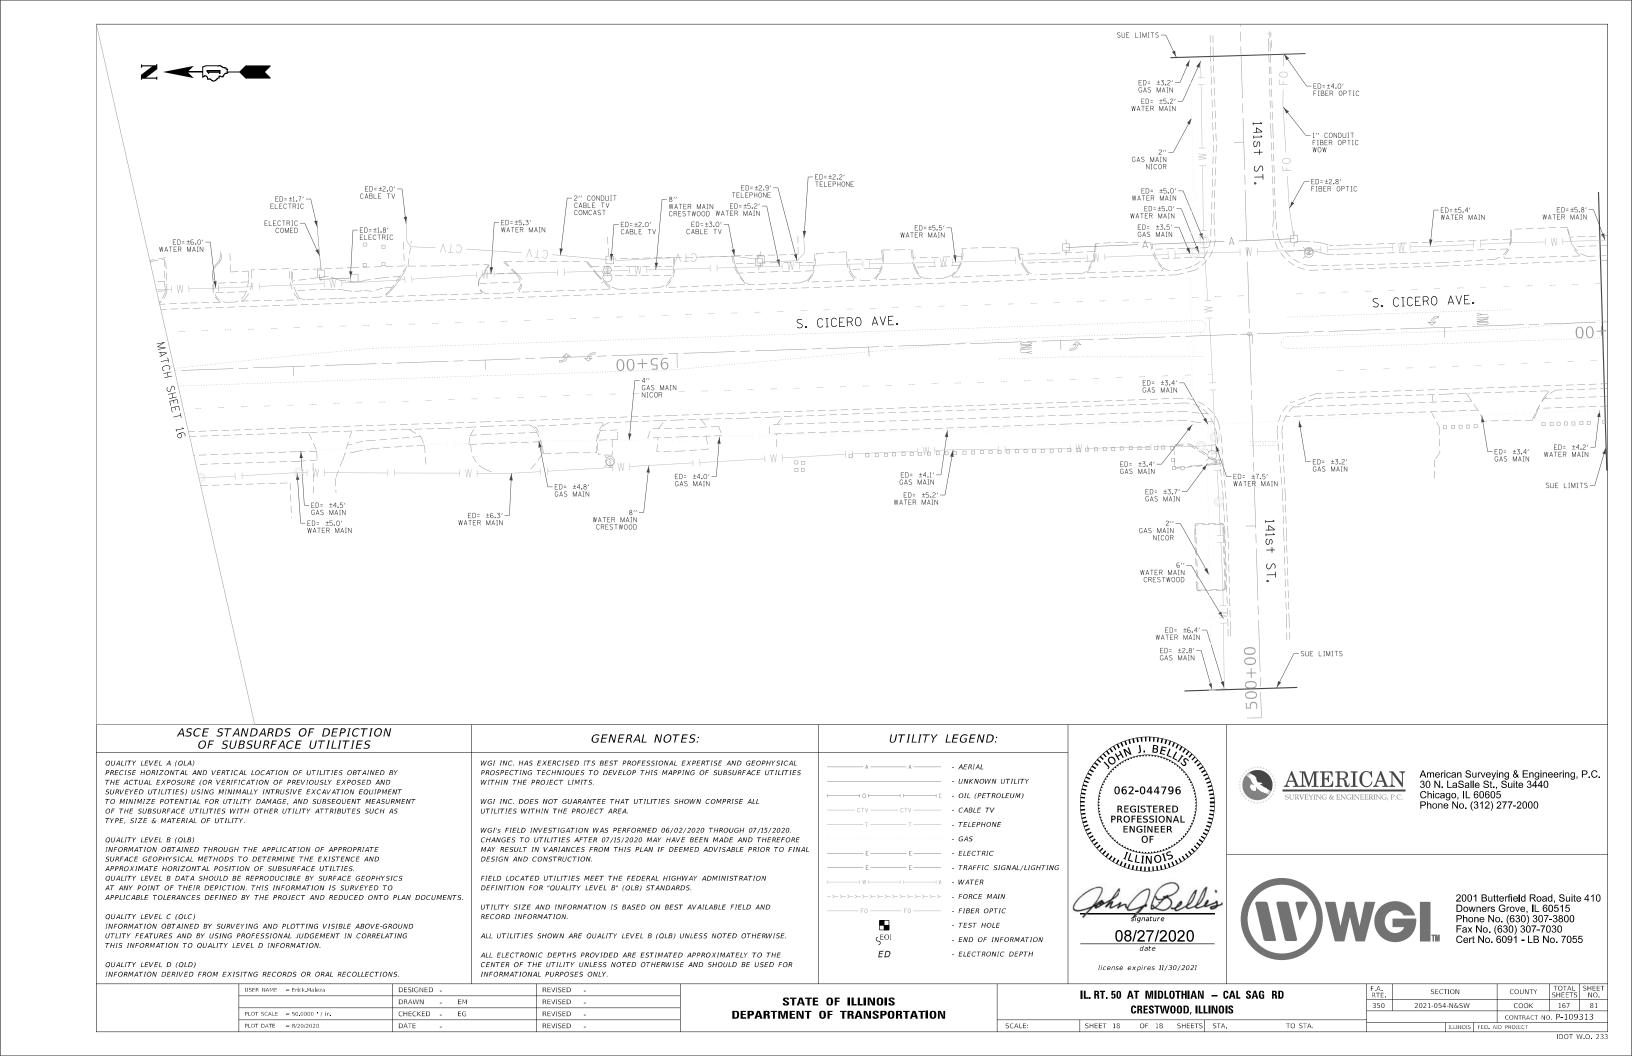DEPARTMENT OF TRANSPORTATION DIVISION OF HIGHWAYS

PLAT OF HIGHWAYS


ROUTE: ILLINOIS ROUTE 50(CICERO AVENUE) SECTION: MIDLOTHIAN TURNPIKE

TO CALUMET SAG ROAD


COUNTY: COOK

LIMITS: 96 + 30.00 TO 158 + 45.00

JOB NO: R-90-015-13

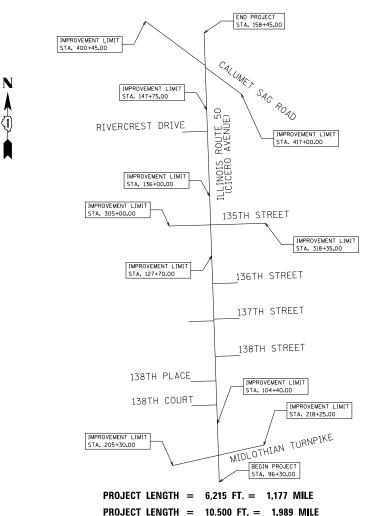

LOCATION MAP

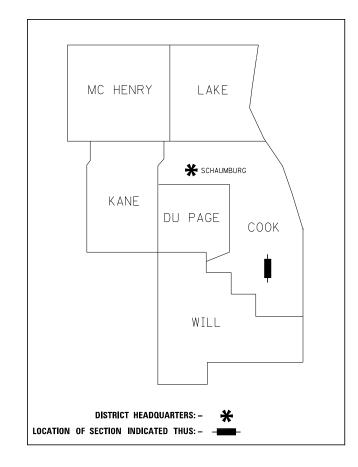

PRINTED BY THE AUTHORITY OF THE STATE OF ILLINOIS


PARCEI

OMT0001

OWNER

THE VILLAGE OF CRESTWOOD, AN ILLINOIS MUNICIPAL CORPORATION PROPERTY

ACQUIRED BY

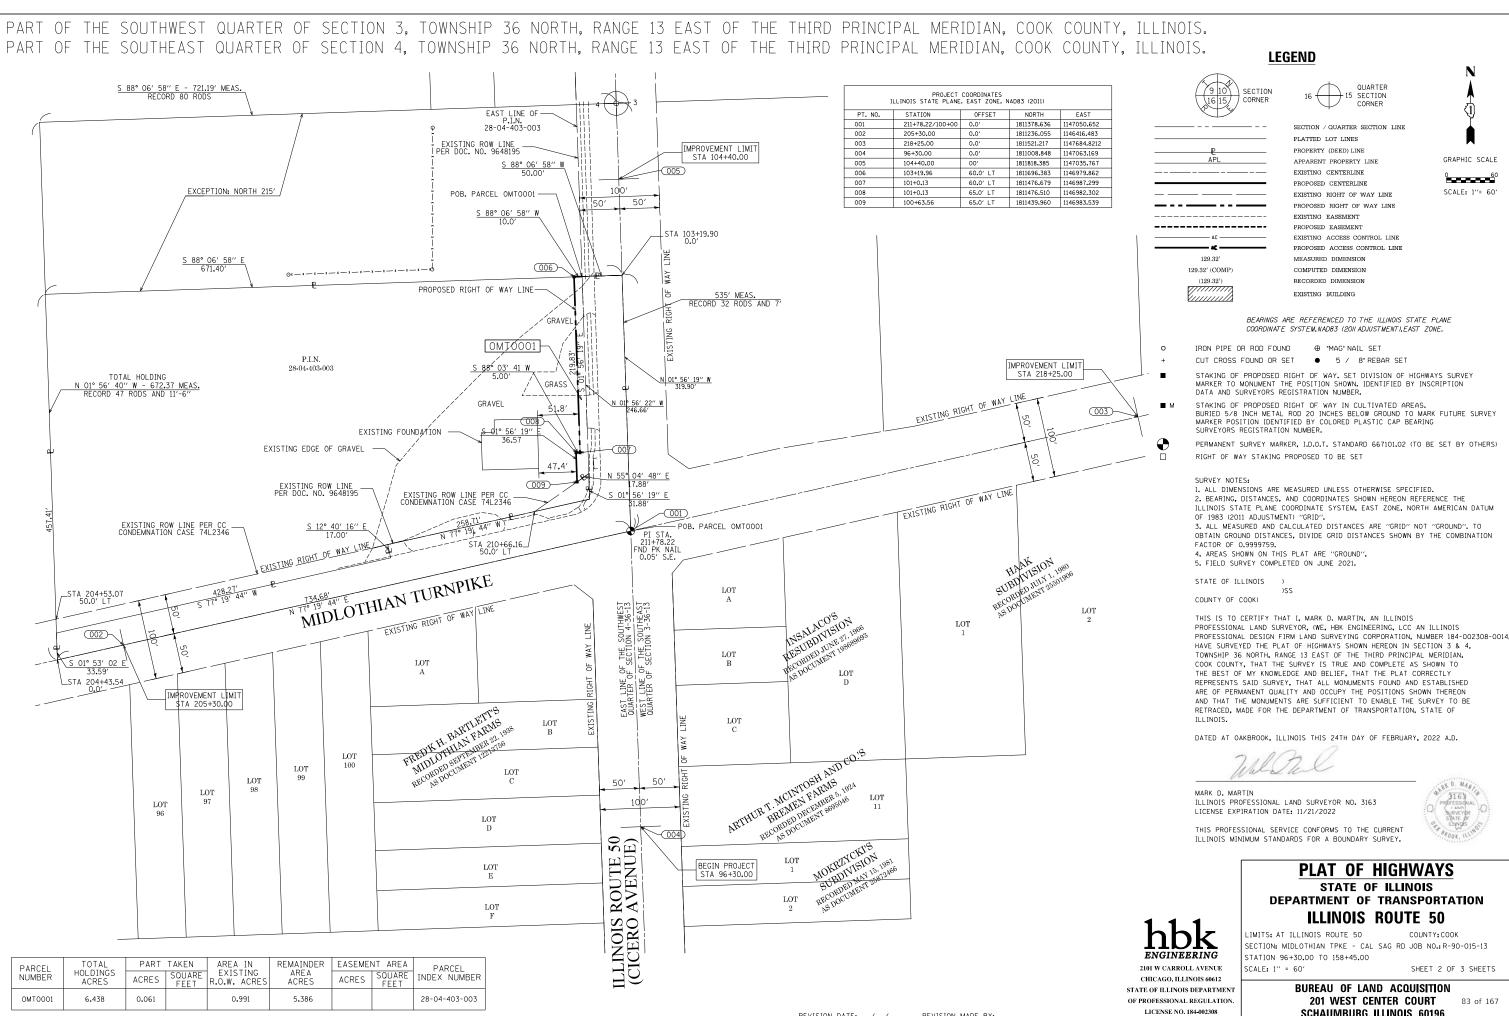


REVISION DATE: / /


REVISION MADE BY:


DEPARTMENT OF TRANSPORTATION


83 of 167 SCHAUMBURG, ILLINOIS 60196

PART OF THE SOUTHWEST QUARTER OF SECTION 3, TOWNSHIP 36 NORTH, RANGE 13 EAST OF THE THIRD PRINCIPAL MERIDIAN, COOK COUNTY, ILLINOIS. PART OF THE SOUTHEAST QUARTER OF SECTION 4, TOWNSHIP 36 NORTH, RANGE 13 EAST OF THE THIRD PRINCIPAL MERIDIAN, COOK COUNTY, ILLINOIS.

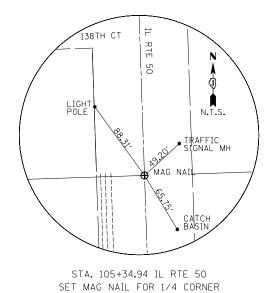


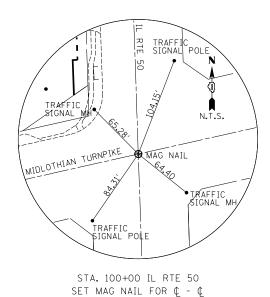


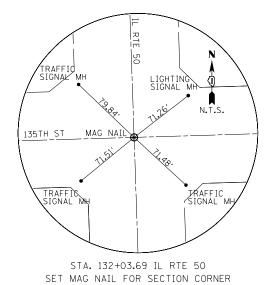


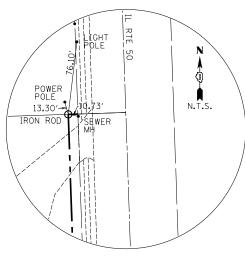

STA. 103+19.96, OFF. 60.0' LT IL RTE 50 SET IRON ROD WITH MONUMENT CAP

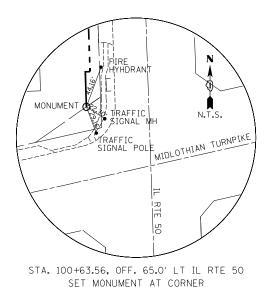

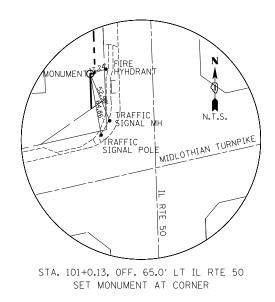

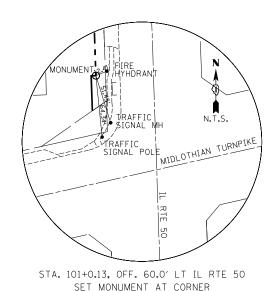

STATE OF ILLINOIS

THIS IS TO CERTIFY THAT I, MARK D. MARTIN, AN ILLINOIS PROFESSIONAL LAND SURVEYOR, (WE, HBK ENGINEERING, LCC AN ILLINOIS PROFESSIONAL DESIGN FIRM LAND SURVEYING CORPORATION, NUMBER 184-002308-0014, HAVE SURVEYED THE PLAT OF HIGHWAYS SHOWN HEREON IN SECTION 3 & 4. TOWNSHIP 36 NORTH, RANGE 13 EAST OF THE THIRD PRINCIPAL MERIDIAN, COOK COUNTY, THAT THE SURVEY IS TRUE AND COMPLETE AS SHOWN TO THE BEST OF MY KNOWLEDGE AND BELIEF, THAT THE PLAT CORRECTLY REPRESENTS SAID SURVEY, THAT ALL MONUMENTS FOUND AND ESTABLISHED ARE OF PERMANENT QUALITY AND OCCUPY THE POSITIONS SHOWN THEREON AND THAT THE MONUMENTS ARE SUFFICIENT TO ENABLE THE SURVEY TO BE RETRACED, MADE FOR THE DEPARTMENT OF TRANSPORTATION, STATE OF

DATED AT OAKBROOK, ILLINOIS THIS 24TH DAY OF FEBRUARY, 2022 A.D.

ILLINOIS PROFESSIONAL LAND SURVEYOR NO. 3163 LICENSE EXPIRATION DATE: 11/21/2022

THIS PROFESSIONAL SERVICE CONFORMS TO THE CURRENT



2101 W CARROLL AVENUE

CHICAGO, ILLINOIS 60612 STATE OF ILLINOIS DEPARTMENT OF PROFESSIONAL REGULATION. LICENSE NO. 184-002308

PLAT OF HIGHWAYS STATE OF ILLINOIS **DEPARTMENT OF TRANSPORTATION ILLINOIS ROUTE 50**

LIMITS: AT ILLINOIS ROUTE 50 COUNTY: COOK SECTION: MIDLOTHIAN TPKE - CAL SAG RD JOB NO.: R-90-015-13 STATION 96+30.00 TO 158+45.00 SCALE: N.T.S. SHEET 3 OF 3 SHEETS

> **BUREAU OF LAND ACQUISITION** 201 WEST CENTER COURT 84 of 167 SCHAUMBURG, ILLINOIS 60196

REVISION DATE: __/__/_ REVISION MADE BY:

