FOR INDEX OF SHEETS, SEE SHEET NO. 2

MU = 10.2%

0

0

0

0

STATE OF ILLINOIS DEPARTMENT OF TRANSPORTATION

D-98-091-22

CARDINI WYNA BABS 9000

CARDINI WOLE AS STARK MARSHALL

STARK MARSHALL

STARK MARSHALL

FAI 64 ADT IL 159 TO WEST HWY 50 2023 = 79,700 (ESTIMATED) SU = 2.4% MU = 11.3%

FAI 64 ADT IL 157 TO IL 159 2023 = 89.000 (ESTIMATED)

SU = 2.4%

FAI 64 ADT
WEST HWY 50 TO GREENMOUNT RD

2023 = 64,900 (ESTIMATED)
SU = 2.4% MU = 13.6%

FAI 64 ADT
GREENMOUNT RD TO IL 158

2023 = 58,200 (ESTIMATED)
SU = 2.5% MU = 15.1%

FUNCTIONAL CLASSIFICATION: INTERSTATE

PROPOSED HIGHWAY PLANS

FAI ROUTE 64 (I-64)
SECTION 82-(5,6,7)PP-1
PROJECT
PAVEMENT PATCHING
ST. CLAIR COUNTY

BRIDGE OMISSION

SN 082-0308 (EB) & SN 082-0309 (WB) STA 589+97 TO

STA 591+49

BEGIN PROJECT

0.5 MILES WEST OF IL 159

LAT: 38.59998° N LONG: 89.99418° W

STA, 510 + 00

C-98-123-22 STATION EQUATION STA. 618 + 20.65 (BK) = STA. 643 + 85.18 (AH)

R8W

R7W

R8W

R7W

Salitation of the state of the state

LOCATION MAP

GROSS LENGTH = 24,662 FT. = 4,671 MILE NET LENGTH = 24,662 FT. = 4.671 MILE END PROJECT

0.5 MILES EAST OF GREENMOUNT RD STA. 782 + 27
LAT: 38.57478° N LONG: 89.92013° W

STATE OF ILLINOIS
DEPARTMENT OF TRANSPORTATION

JBMITTED 20 CO REGIONA

ENGINEER OF DESIGN AND ENVIRONMENT

February 3, 2023

LOCATION OF SECTION INDICATED THUS: - -

DIRECTOR OF HIGHWAYS PROJECT IMPLEMENTATION

PRINTED BY THE AUTHORITY OF THE STATE OF ILLINOIS

0 100' 280' 300' — 1" = 100'
0 10' 20' 30' — 1" = 10'
0 50' 100' — 1" = 50'
0 50' 100' — 1" = 30'
0 50' 100' — 1" = 30'

FULL SIZE PLANS HAVE BEEN PREPARED USING STANDARD ENGINEERING SCALES. REDUCED SIZED PLANS WILL NOT CONFORM TO STANDARD SCALES. IN MAKING MEASUREMENTS ON REDUCED PLANS, THE ABOVE SCALES MAY BE USED.

J.U.L.I.E. JOINT UTILITY LOCATION INFORMATION FOR EXCAVATORS 1–800–892–0123 OR 811

PROJECT ENGINEER: BILLIE OWEN
PROJECT MANAGER: BRANDON HUMPHREYS

CONTRACT NO. 76R48

INDEX OF SHEETS

- COVER SHEET
- 2. INDEX OF SHEETS, HIGHWAY STANDARDS, GENERAL NOTES, & COMMITMENTS
- 3. SUMMARY OF QUANTITIES
- 4-11. TYPICAL SECTIONS
- 12. LOCATION MAP SHEET
- 13-14. CLASS A PATCHES, SPECIAL

HIGHWAY STANDARDS

000001-08	STANDARD SYMBOLS, ABBREVIATIONS AND PATTERNS
001001-02	AREAS OF REINFORCEMENT BARS
001006	DECIMAL OF AN INCH AND OF A FOOT
420001-10	PAVEMENT JOINTS
442001-04	CLASS A PATCHES
701400-11	APPROACH TO LANE CLOSURE, FREEWAY/EXPRESSWAY
701401-13	LANE CLOSURE, FREEWAY/EXPRESSWAY
701411-09	LANE CLOSURE, MULTILANE, AT ENTRANCE OR EXIT RAMP, FOR
	SPEEDS ≥ 45 MPH
701426-09	LANE CLOSURE, MULTILANE, INTERMITTENT OR MOVING OPER.,
	FOR SPEEDS ≥ 45 MPH
701428-01	TRAFFIC CONTROL SETUP AND REMOVAL FREEWAY/EXPRESSWAY
701446-11	TWO LANE CLOSURE, FREEWAY/EXPRESSWAY
701901-08	TRAFFIC CONTROL DEVICES
780001-05	TYPICAL PAVEMENT MARKINGS
781001-04	TYPICAL APPLICATIONS RAISED REFLECTIVE PAVEMENT
	MARKERS

GENERAL NOTES

COMMITMENTS

NONE

1. THE UTILITIES KNOWN TO HAVE FACILITIES WITHIN THE PROJECT AREA ARE AS FOLLOWS:

- AMEREN ILLINOIS

- AT&T ILLINOIS
- BUCKEYE PARTNERS L.P. -- WOOD RIVER PIPELINE
- VILLAGE OF CASEYVILLE
- CHARTER COMMUNICATIONS, INC.
- CLEARWAVE FIBER LLC
- EVERSTREAM GLC HOLDING COMPANY LLC
- EXTENET SYSTEMS, INC.
- CITY OF FAIRVIEW HEIGHTS
- FIDELITY COMMUNICATIONS III, INC.
- VERIZON BUSINESS
- CITY OF O'FALLON
- VILLAGE OF SHILOH
- ST. CLAIR COUNTY
- WINDSTREAM KDL, INC.
- 2. NO SURVEY WAS PERFORMED FOR THIS PROJECT AND THE PLANS WERE CREATED USING MICROFILM AND FIELD MEASUREMENTS.
- 3. THE RESIDENT ENGINEER SHALL VERIFY THE EXISTENCE OF HIGHWAY LIGHTING, INTELLIGENT TRANSPORTATION SYSTEMS (I.T.S.) UTILITIES, AND/OR ELECTRICAL CABLES ASSOCIATED WITH TRAFFIC SIGNALS WITHIN THE PROJECT LIMITS. IF ANY OF THESE EXIST WITHIN THE PROJECT LIMITS, AND IF THESE ITEMS REQUIRE LOCATING, THE CONTRACTOR SHALL BE DIRECTED TO DO SO ACCORDING TO SECTION 803 OF THE STANDARD SPECIFICATIONS. THIS WORK SHALL BE PAID FOR ACCORDING TO ARTICLE 109.04 OF THE STANDARD SPECIFICATIONS.
- 4. EIGHT CHANGEABLE MESSAGE SIGNS SHALL BE REQUIRED FOR THIS PROJECT. THEY WILL BE REQUIRED TWO WEEKS PRIOR TO ANY LANE CLOSURE. LOCATIONS SHALL BE AT THE DIRECTION OF THE RESIDENT ENGINEER.
- 5. THE DEPARTMENT STRONGLY ENCOURAGES THE PRIME CONTRACTOR AND THEIR APPROVED SUB-CONTRACTORS TO HIRE MINORITY, WOMEN AND DISADVANTAGED INDIVIDUALS FROM ITS FEDERALLY FUNDED HIGHWAY CONSTRUCTION CAREERS TRAINING PROGRAM (HCCTP) TO HELP MEET WORKFORCE AND TRAINEE GOALS. THIS PROGRAM IS TRAINING MINORITIES, WOMEN AND DISADVANTAGED INDIVIDUALS IN HIGHWAY CONSTRUCTION-RELATED SKILLS, E.G., MATH FOR THE TRADES, JOB READINESS, TECHNICAL SKILLS COURSEWORK (CARPENTRY, CONCRETE FLATWORK, BLUEPRINT READING, SITE PLANS, SITE WORK, TOOLS USE, ETC.) AND OSHA 10 HOUR CERTIFICATION, TO PREPARE THEM FOR A CAREER IN THE HIGHWAY CONSTRUCTION TRADES. GRADUATES ARE WELL-TRAINED AND READY TO BECOME PRODUCTIVE ENTRY-LEVEL CONSTRUCTION WORKERS. CONTACT THE DISTRICT 8 EEO OFFICE AT 618-346-3360 AND/OR THE HCCTP COORDINATOR AT 618-874-6528 TO LEARN MORE ABOUT THE PROGRAM AND ASSISTANCE IN MEETING WORKFORCE AND TRAINEE GOALS.
- 6. THE FOLLOWING MIXTURE REQUIREMENTS ARE APPLICABLE FOR THIS PROJECT:

MIXTURE USE	PARTIAL DEPTH
	PATCH
AC/PG	PG 64-22
DESIGN AIR VOIDS	4.0% @ Ndes=90
MIX COMPOSITION	IL 9.5
(GRADATION)	
FRICTION AGG	MIXTURE "E"
QUALITY MGMT	QC/QA
PROGRAM	
MATERIAL TRANSFER	NO
DEVICE REQUIRED	

PLAN QUANTITIES FOR HOT-MIX ASPHALT ITEMS ARE CALCULATED USING A UNIT WEIGHT OF 112 LBS/SQ YD/IN

SCALE:

REV. - MS

STATE OF ILLINOIS
DEPARTMENT OF TRANSPORTATION

INDEX OF SHEETS, HIGHWAY STANDARDS,
GENERAL NOTES, AND COMMITMENTS

SHEET OF SHEETS STA. TO STA.

 F.A.I. RTE.
 SECTION
 COUNTY
 TOTAL SHEETS
 SHEET NO.

 64
 82-(5,6,7)PP-1
 ST. CLAIR
 14
 2

 CONTRACT NO.
 76R48

				CONCINI CODE
				100% STATE
Ö-	T			
0005				ROADWAY
CODE			TOTAL	0006
NO.	ITEM	UNIT	QUANTITY	URBAN
44213000	PATCHING REINFORCEMENT	SQ YD	760	760
44213200	SAW CUTS	FOOT	2384	2384
-				
44213204	TIE BARS 3/4"	EACH	140	140
67100100	MOBILIZATION	L SUM	1	1
		2 33.7	-	-
70100420	TRAFFIC CONTROL AND PROTECTION, STANDARD 701411	EACH	14	14
70100420	The control was more and a second of the control of	Exem		
70100800	TRAFFIC CONTROL AND PROTECTION, STANDARD 701401	L SUM	1	1
70100815	TRAFFIC CONTROL AND PROTECTION, STANDARD 701446	L SUM	1	1
	· ·			
70107025	CHANGEABLE MESSAGE SIGN	CAL DA	336	336
70200100	NIGHTTIME WORK ZONE LIGHTING	L SUM	1	1
				-
70300100	SHORT TERM PAVEMENT MARKING	FOOT	4656	4656
7				
70300150	SHORT TERM PAVEMENT MARKING REMOVAL	SQ FT	1552	1552
			1	
78001130	PAINT PAVEMENT MARKING - LINE 6"	FOOT	12800	12800
_				
78100100	RAISED REFLECTIVE PAVEMENT MARKER	EACH	1280	1280
78300200	RAISED REFLECTIVE PAVEMENT MARKER REMOVAL	EACH	1280	1280
Z0076604	TRAINEES TRAINING PROGRAM GRADUATE	HOUR	500	500
	<u> </u>		- 30	- 30

				CONSTR. CODE
				100% 57475
				100% STATE ROADWAY
CODE			TOTAL	0006
NO.	ITEM	UNIT	QUANTITY	URBAN
X1700051	CLASS A PATCHES, TYPE IV, 15 INCH (SPECIAL)	SQ YD	120	120
X1700052	CLASS A PATCHES, TYPE II, 12 INCH (SPECIAL)	SQ YD	22	22
X1700055	CLASS A PATCHES, TYPE II, 13 INCH (SPECIAL)	SQ YD	22	22
X1700056	CLASS A PATCHES, TYPE III, 13 INCH (SPECIAL)	SQ YD	48	48
X1700057	CLASS A PATCHES, TYPE IV, 13 INCH (SPECIAL)	SQ YD	120	120
X1700079	CLASS A PATCHES, TYPE III, 12 INCH (SPECIAL)	SQ YD	48	48
X4405020	LONGITUDINAL PARTIAL DEPTH REMOVAL 2"	FOOT	50630	50630
X4420579	CLASS A PATCHES, TYPE IV, 12 INCH (SPECIAL)	SQ YD	120	120
X4420621	CLASS A PATCHES, TYPE II, 14 INCH (SPEC IAL)	SQ YD	22	22
X4420624	CLASS A PATCHES, TYPE III, 14 INCH (SPEC IAL)	SQ YD	48	48
X4420628	CLASS A PATCHES, TYPE IV, 14 INCH (SPEC IAL)	SQ YD	120	120
X4420630	CLASS A PATCHES, TYPE II, 15 INCH (SPECIAL)	SQ YD	22	22
X4420632	CLASS A PATCHES, TYPE III, 15 INCH (SPECIAL)	SQ YD	48	48
X4420900	LONGITUDINAL PARTIAL DEPTH PATCHING	TON	1261	1261

* SPECIALTY ITEM

Ø 0042

REV. - MS


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	3	DRAWN	REVISED _
	PLOT SCALE = 40.0000 ' / in.	CHECKED	REVISED -
- 1	PLOT DATE = 12/21/2022	DATE	REVISED +

STATE OF ILLINOIS								
DEPARTMENT	0F	TRANSPORTATION						


SCALE:

CONSTR. CODE

					F.A.I. RTE.	SECTION	COUNTY TOT		SHEET NO.	
	SUMMAR	Y OF QU	ANTITIE	S	64	82-(5,6,7)PP-1		ST. CLAIR	14	3
								CONTRACT	NO. 70	5R48
SHEET 1	OF 1	SHEETS	STA.	TO STA.		ILLINOIS	FED. A	ID PROJECT		

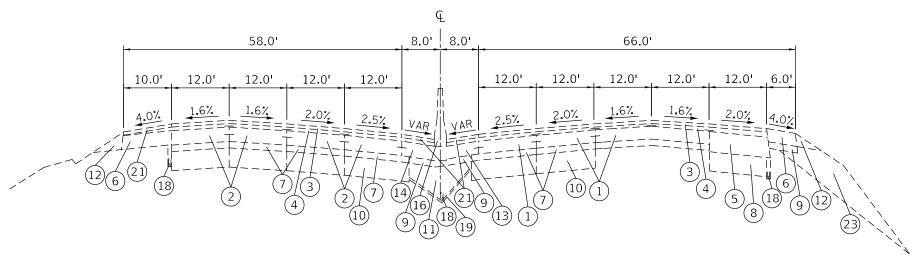

STA 510+00.00 TO STA 510+34.00 (WB) STA 510+00.00 TO STA 521+38.92 (EB)

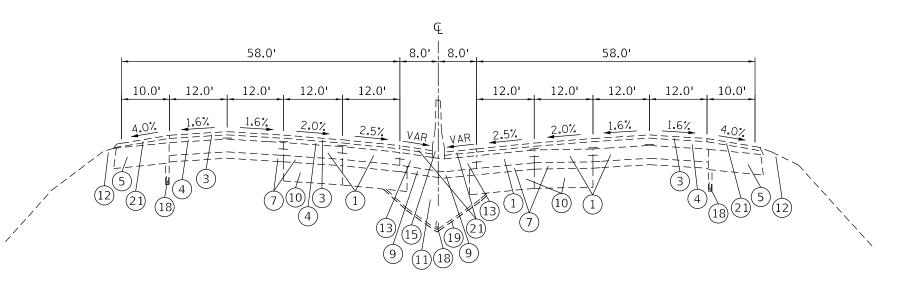

EXISTING TYPICAL SECTION FAI 64 (I-64)

STA 510+34.00 TO STA 547+70.40 (WB) STA 521+38.92 TO STA 548+60.20 (EB)

LEGEND


- (1) CONTINUOUSLY REINFORCED P.C.C. PAVEMENT, 8"
- (2) CONTINUOUSLY REINFORCED P.C.C. PAVEMENT, 9"
- 3) POLYMERIZED BITUMINOUS SURFACE COURSE, STONE MATRIX ASPHALT, CLASS I, VARIES 1 1/2" TO 2"
- 4 POLYMERIZED BITUMINOUS BINDER COURSE, SUPERPAVE, VARIES 2" TO 2 1/2"
- (5) HOT-MIX ASPHALT SHOULDER, 13"

- (6) HOT-MIX ASPHALT SHOULDER, 8"
- (7) STABILIZED SUB-BASE, 4"
- (8) GRANULAR MATERIAL, TYPE B, 12"
- (9) GRANULAR MATERIAL, TYPE A, 4"
- (10) AGGREGATE SUBGRADE, 12"
- (11) POROUS GRANULAR EMBANKMENT, SUBGRADE
- (12) AGGREGATE SHOULDER, TYPE B
- (13) P.C.C. SHOULDER, 8"
- (14) P.C.C. SHOULDER, 9"
- (15) CONCRETE BARRIER
- (16) STEEL PLATE BEAM GUARDRAIL
- (17) BITUMINOUS SHOULDER CURB


- (18) PIPE UNDERDRAINS, 6"
- (19) FILTER FABRIC
- (20) NOISE ABATEMENT WALL
- (21) BITUMINOUS SURFACE COURSE, SUPERPAVE, 2"
- (22) BITUMINOUS SHOULDER, SUPERPAVE, 3 3/4"
- (23) EMBANKMENT

USER NAME = Brandon.Humphreys	DESIGNED -	REVISED -	
	DRAWN -	REVISED -	
PLOT SCALE = 40.0000 / in.	CHECKED -	REVISED -	
BLOT DATE - 12/21/2022	DATE	DEVICED	

	=>/1						F.A.I. RTE	SEC.	TION		COUNTY	TOTAL SHEETS	SHEET NO.
EXISTING TYPICAL SECTIONS		64	82-(5,6	,7)PP-1		ST. CLAIR	14	4					
											CONTRACT	NO. 76	5R48
NI/A	CUEET 1	OF	0	SHEETS	CTA	TO STA			TI I TI LOTE	EED AL	D DDG IEGT		

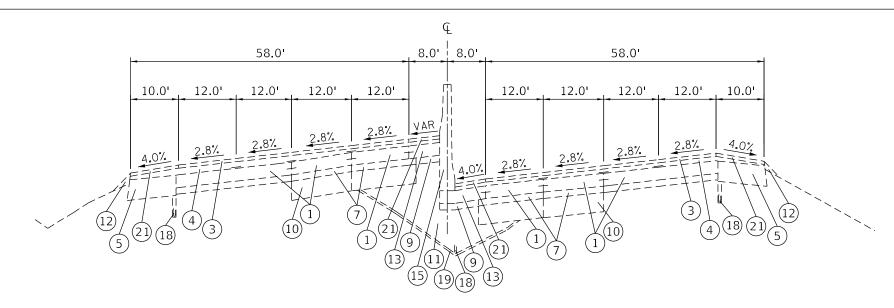

STA 547+70.40 TO STA 560+38.12 (WB) STA 548+60.20 TO STA 559+48.32 (EB)

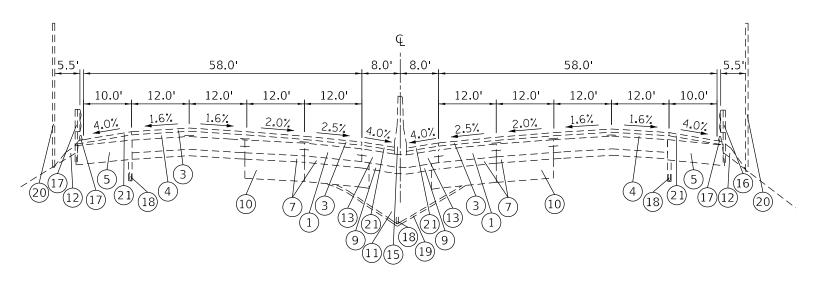

EXISTING TYPICAL SECTION FAI 64 (I-64)

STA 560+38.12 TO STA 586+21.18 (WB) STA 559+48.32 TO STA 585+31.38 (EB)


LEGEND

- (1) CONTINUOUSLY REINFORCED P.C.C. PAVEMENT, 8"
- 2) CONTINUOUSLY REINFORCED P.C.C. PAVEMENT, 9"
- 3) POLYMERIZED BITUMINOUS SURFACE COURSE, STONE MATRIX ASPHALT, CLASS I, VARIES 1 1/2" TO 2"
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- (6) HOT-MIX ASPHALT SHOULDER, 8"
- (7) STABILIZED SUB-BASE, 4"
- (8) GRANULAR MATERIAL, TYPE B, 12"
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- (23) EMBANKMENT

USER NAME = Brandon.Humphreys	DESIGNED -	REVISED -								F.A.I. BTF	SECTION	COUNTY	TOTAL	SHEET
	DRAWN -	REVISED -	STATE OF ILLINOIS					SECTIONS		64	82-(5.6.7)PP-1	ST. CLAIR	14	5
PLOT SCALE = 40.0000 / in.	CHECKED -	REVISED -	DEPARTMENT OF TRANSPORTATION								. (12/2)	CONTRACT	Г NO. 7	6R48
PLOT DATE = 12/21/2022	DATE -	REVISED -		SCALE: N/A	SHEET 2	OF 8	SHEETS	STA.	TO STA.		ILLINOIS FED.	AID PROJECT		


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EXISTING TYPICAL SECTION

FAI 64 (I-64)

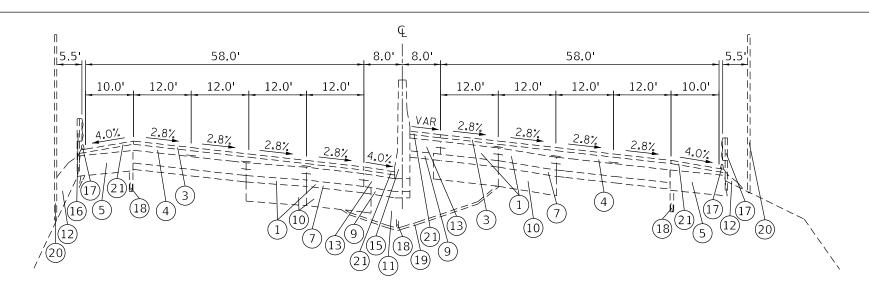STA 586+21.18 TO STA 606+93.98 (WB) STA 585+31.38 TO STA 607+83.78 (EB) BRIDGE OMISSION: STA 589+97 TO 591+49 (SN 082-0309 WB & SN 082-0308 EB)



EXISTING TYPICAL SECTION FAI 64 (I-64)

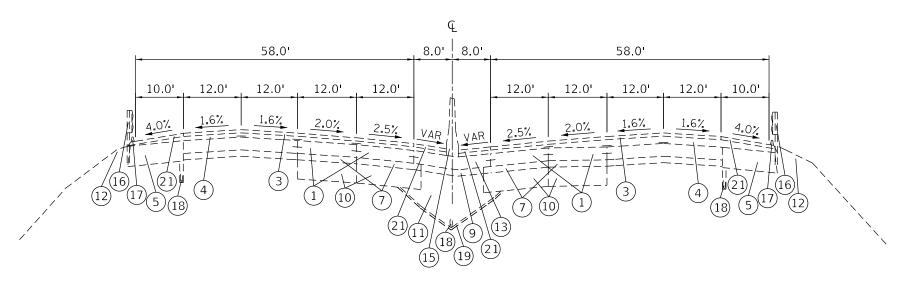STA 606+93.98 TO STA 613+80.02 (WB) STA 607+83.78 TO STA 613+80.02 (EB) STA 692+18.71 TO STA 730+77.89 (WB) STA 693+92.51 TO STA 732+09.69 (EB)

LEGEND

- (1) CONTINUOUSLY REINFORCED P.C.C. PAVEMENT, 8"
- 2) CONTINUOUSLY REINFORCED P.C.C. PAVEMENT, 9"
- 3) POLYMERIZED BITUMINOUS SURFACE COURSE, STONE MATRIX ASPHALT, CLASS I, VARIES 1 1/2" TO 2"
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- (5) HOT-MIX ASPHALT SHOULDER, 13"


- (6) HOT-MIX ASPHALT SHOULDER, 8"
- $\overline{(7)}$ STABILIZED SUB-BASE, 4"
- (8) GRANULAR MATERIAL, TYPE B, 12"
- 9 GRANULAR MATERIAL, TYPE A, 4"
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- (12) AGGREGATE SHOULDER, TYPE B
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- (15) CONCRETE BARRIER
- (16) STEEL PLATE BEAM GUARDRAIL
- (17) BITUMINOUS SHOULDER CURB

SCALE: N/A


- (18) PIPE UNDERDRAINS, 6"
- (19) FILTER FABRIC
- (20) NOISE ABATEMENT WALL
- (21) BITUMINOUS SURFACE COURSE, SUPERPAVE, 2"
- (22) BITUMINOUS SHOULDER, SUPERPAVE, 3 3/4"
- (23) EMBANKMENT

USER NAME = Brandon.Humphreys	DESIGNED -	REVISED -
	DRAWN -	REVISED -
PLOT SCALE = 40.0000 / in.	CHECKED -	REVISED -
PLOT DATE = 12/21/2022	DATE -	REVISED -

=3/14			050510110		F.A.I. RTE	SECT	10N	COUNTY	TOTAL SHEETS	SHEET NO.
EXIS	STING	IYPICAL	SECTIONS		64	82-(5,6,	,7)PP-1	ST. CLAIR	14	6
								CONTRACT	NO. 76	5R48
HEET 3	OF 8	SHEETS	STA	TO STA.			TILINOIS EED /	UD DROIECT		

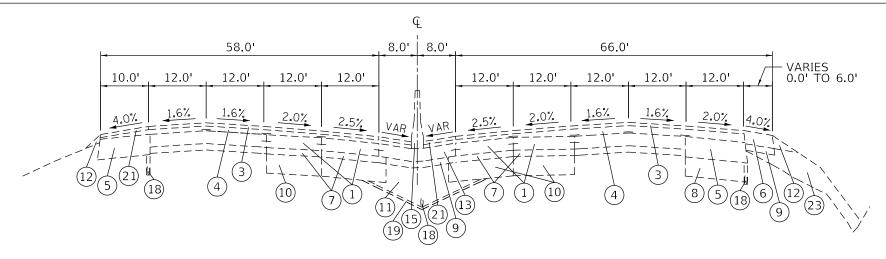

STA 613+80.02 TO STA 652+43.94 (WB) STA 613+80.02 TO STA 657+24.79 (EB)

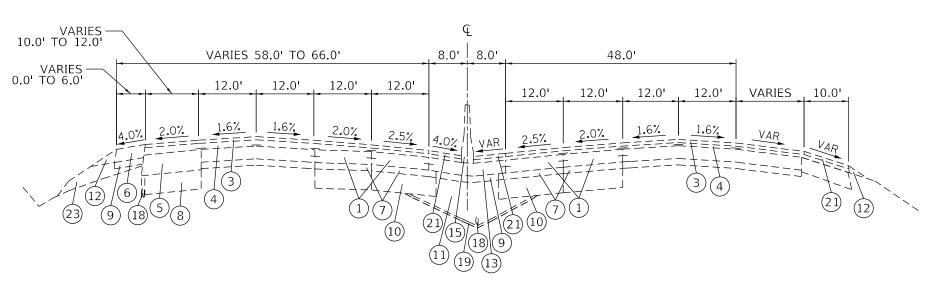

EXISTING TYPICAL SECTION FAI 64 (I-64)

STA 652+43.94 TO STA 658+54.90 (WB) STA 657+24.79 TO STA 658+69.57 (EB)

LEGEND


- (1) CONTINUOUSLY REINFORCED P.C.C. PAVEMENT, 8"
- 2) CONTINUOUSLY REINFORCED P.C.C. PAVEMENT, 9"
- 3) POLYMERIZED BITUMINOUS SURFACE COURSE, STONE MATRIX ASPHALT, CLASS I, VARIES 1 1/2" TO 2"
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- (5) HOT-MIX ASPHALT SHOULDER, 13"

- (6) HOT-MIX ASPHALT SHOULDER, 8"
- (7) STABILIZED SUB-BASE, 4"
- (8) GRANULAR MATERIAL, TYPE B, 12"
- 9 GRANULAR MATERIAL, TYPE A, 4"


(10) AGGREGATE SUBGRADE, 12"

- (11) POROUS GRANULAR EMBANKMENT, SUBGRADE
- (12) AGGREGATE SHOULDER, TYPE B
- (13) P.C.C. SHOULDER, 8"
- 14) P.C.C. SHOULDER, 9"
- (15) CONCRETE BARRIER
- (16) STEEL PLATE BEAM GUARDRAIL
- (17) BITUMINOUS SHOULDER CURB
- (18) PIPE UNDERDRAINS, 6"
- (19) FILTER FABRIC
- (20) NOISE ABATEMENT WALL
- (21) BITUMINOUS SURFACE COURSE, SUPERPAVE, 2"
- (22) BITUMINOUS SHOULDER, SUPERPAVE, 3 3/4"
- (23) EMBANKMENT

USER NAME = Brandon.Humphreys	DESIGNED -	REVISED -				F.A.I. RTF	SECTION	COUNTY	TOTAL SHEET	
	DRAWN -	REVISED -	STATE OF ILLINOIS	EXISTING TYPICAL SECTIONS				82-(5,6,7)PP-1	ST. CLAIR	14 7
PLOT SCALE = 40.0000 / in.	CHECKED -	REVISED -	DEPARTMENT OF TRANSPORTATION						CONTRACT	NO. 76R48
PLOT DATE = 12/21/2022	DATE -	REVISED -		SCALE: N/A	SHEET 4 OF 8 SHEETS STA.	TO STA.		ILLINOIS FE	D. AID PROJECT	

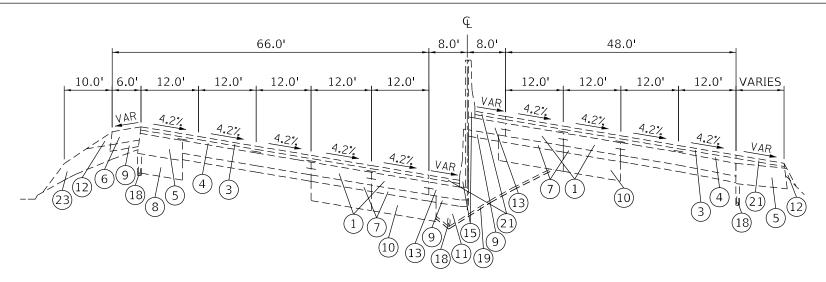

STA 658+54.90 TO STA 661+10.04 (WB) STA 658+69.57 TO STA 661+10.04 (EB) STA 662+84.20 TO STA 672+93.94

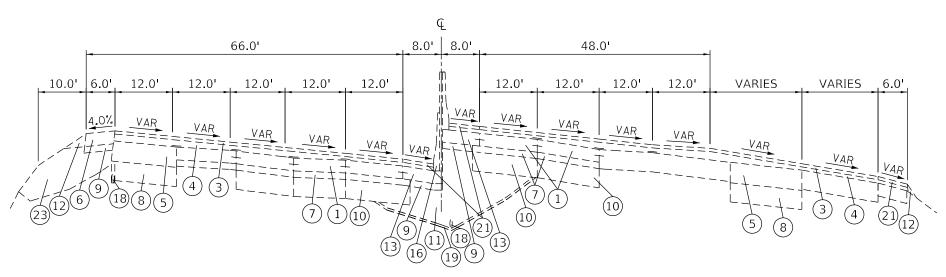

EXISTING TYPICAL SECTION FAI 64 (I-64)


STA 661+10.04 TO STA 662+23.36

- (1) CONTINUOUSLY REINFORCED P.C.C. PAVEMENT, 8"
- (2) CONTINUOUSLY REINFORCED P.C.C. PAVEMENT, 9"
- 3) POLYMERIZED BITUMINOUS SURFACE COURSE, STONE MATRIX ASPHALT, CLASS I, VARIES 1 1/2" TO 2"
- 4 POLYMERIZED BITUMINOUS BINDER COURSE, SUPERPAVE, VARIES 2" TO 2 1/2"
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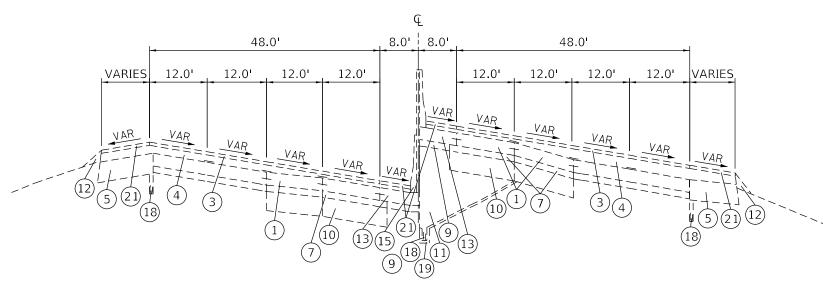
- (6) HOT-MIX ASPHALT SHOULDER, 8"
- (7) STABILIZED SUB-BASE, 4"
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- (20) NOISE ABATEMENT WALL
- (21) BITUMINOUS SURFACE COURSE, SUPERPAVE, 2"
- (22) BITUMINOUS SHOULDER, SUPERPAVE, 3 3/4"
- (23) EMBANKMENT

USER NAME = Brandon.Humphreys	DESIGNED -	REVISED -					F.A.I. RTE	SECTION	COUNTY	TOTAL SHEET SHEETS NO.		
	DRAWN -	REVISED -	STATE OF ILLINOIS	EXISTING TYPICAL SECTIONS				64	82-(5,6,7)PP-1	ST. CLAIR	14 8	٦
PLOT SCALE = 40.0000 / in	CHECKED -	REVISED -	DEPARTMENT OF TRANSPORTATION						· ·	CONTRACT	NO. 76R48	1
PLOT DATE = 12/21/2022	DATE -	REVISED -		SCALE: N/A	SHEET 5 OF	8 SHEETS STA.	TO STA.		ILLINOIS FED. A	AID PROJECT		1



STA 662+23.36 TO STA 662+84.20

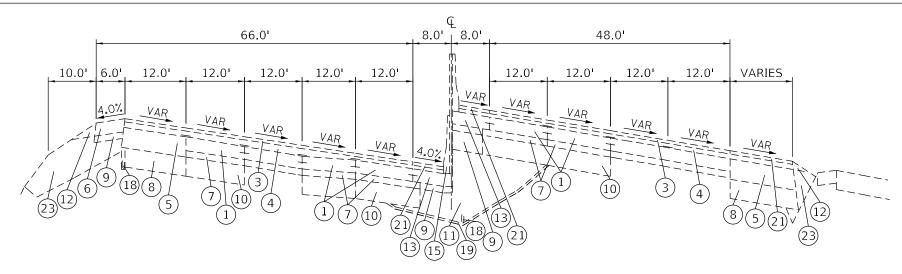

EXISTING TYPICAL SECTION FAI 64 (I-64)


STA 672+93.94 TO STA 681+00.00 STA 689+15.00 TO STA 692+18.71 (WB) STA 689+15.00 TO STA 693+92.51 (EB)

- (1) CONTINUOUSLY REINFORCED P.C.C. PAVEMENT, 8"
- 2) CONTINUOUSLY REINFORCED P.C.C. PAVEMENT, 9"
- 3) POLYMERIZED BITUMINOUS SURFACE COURSE, STONE MATRIX ASPHALT, CLASS I, VARIES 1 1/2" TO 2"
- 4 POLYMERIZED BITUMINOUS BINDER COURSE, SUPERPAVE, VARIES 2" TO 2 1/2"
- (5) HOT-MIX ASPHALT SHOULDER, 13"


- (6) HOT-MIX ASPHALT SHOULDER, 8"
- (7) STABILIZED SUB-BASE, 4"
- (8) GRANULAR MATERIAL, TYPE B, 12"
- (9) GRANULAR MATERIAL, TYPE A, 4"
- (10) AGGREGATE SUBGRADE, 12"
- (11) POROUS GRANULAR EMBANKMENT, SUBGRADE
- (12) AGGREGATE SHOULDER, TYPE B
- (13) P.C.C. SHOULDER, 8"
- (14) P.C.C. SHOULDER, 9"
- (15) CONCRETE BARRIER
- (16) STEEL PLATE BEAM GUARDRAIL
- (17) BITUMINOUS SHOULDER CURB

- (18) PIPE UNDERDRAINS, 6"
- (19) FILTER FABRIC
- (20) NOISE ABATEMENT WALL
- (21) BITUMINOUS SURFACE COURSE, SUPERPAVE, 2"
- (22) BITUMINOUS SHOULDER, SUPERPAVE, 3 3/4"
- (23) EMBANKMENT

USER NAME = Brandon.Humphreys	DESIGNED -	REVISED -				F.A.I. RTE.	SECTION	COUNTY	TOTAL SHEET SHEETS NO.	
	DRAWN -	REVISED -	STATE OF ILLINOIS	EXISTING TYPICAL SECTIONS				82-(5,6,7)PP-1	ST. CLAIR	14 9
PLOT SCALE = 40.0000 / in.	CHECKED -	REVISED -	DEPARTMENT OF TRANSPORTATION					<u> </u>	CONTRACT	NO. 76R48
PLOT DATE = 12/21/2022	DATE -	REVISED -		SCALE: N/A	SHEET 6 OF 8 SHEETS STA.	TO STA.		ILLINOIS FED.	AID PROJECT	

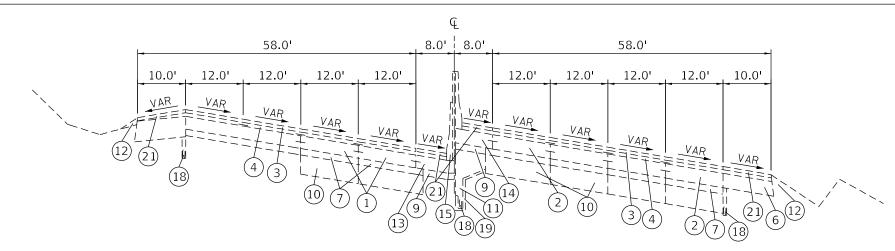

STA 681+00.00 TO STA 689+15.00

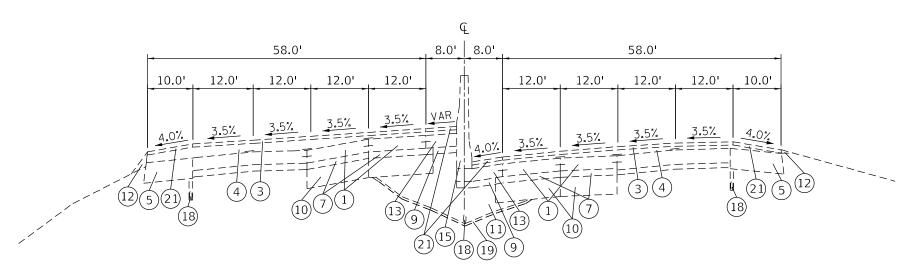

EXISTING TYPICAL SECTION FAI 64 (I-64)


STA 730+77.89 TO STA 735+74.76 (WB) STA 732+09.69 TO STA 735+74.76 (EB)

- (1) CONTINUOUSLY REINFORCED P.C.C. PAVEMENT, 8"
- ig(2ig) CONTINUOUSLY REINFORCED P.C.C. PAVEMENT, 9"
- 3) POLYMERIZED BITUMINOUS SURFACE COURSE, STONE MATRIX ASPHALT, CLASS I, VARIES 1 1/2" TO 2"
- 4 POLYMERIZED BITUMINOUS BINDER COURSE, SUPERPAVE, VARIES 2" TO 2 1/2"
- (5) HOT-MIX ASPHALT SHOULDER, 13"


- (6) HOT-MIX ASPHALT SHOULDER, 8"
- (7) STABILIZED SUB-BASE, 4"
- (8) GRANULAR MATERIAL, TYPE B, 12"
- (9) GRANULAR MATERIAL, TYPE A, 4"
- (10) AGGREGATE SUBGRADE, 12"
- (11) POROUS GRANULAR EMBANKMENT, SUBGRADE
- (12) AGGREGATE SHOULDER, TYPE B
- (13) P.C.C. SHOULDER, 8"
- (14) P.C.C. SHOULDER, 9"
- (15) CONCRETE BARRIER
- (16) STEEL PLATE BEAM GUARDRAIL
- (17) BITUMINOUS SHOULDER CURB

- (18) PIPE UNDERDRAINS, 6"
- (19) FILTER FABRIC
- (20) NOISE ABATEMENT WALL
- (21) BITUMINOUS SURFACE COURSE, SUPERPAVE, 2"
- (22) BITUMINOUS SHOULDER, SUPERPAVE, 3 3/4"
- (23) EMBANKMENT

USER NAME = Brandon, Humphreys	DESIGNED -	REVISED -		EXISTING TYPICAL SECTIONS						F.A.I.	SECTION	
	DRAWN -	REVISED -	STATE OF ILLINOIS							64	82-(5.6.7)PP-1	+
PLOT SCALE = 40.0000 / in.	CHECKED -	REVISED -	DEPARTMENT OF TRANSPORTATION								(-/-/-/	+
PLOT DATE = 12/21/2022	DATE -	REVISED -		SCALE: N/A	SHEET 7	OF 8	SHEETS	STA.	TO STA.		ILLINOIS FED.	AID P

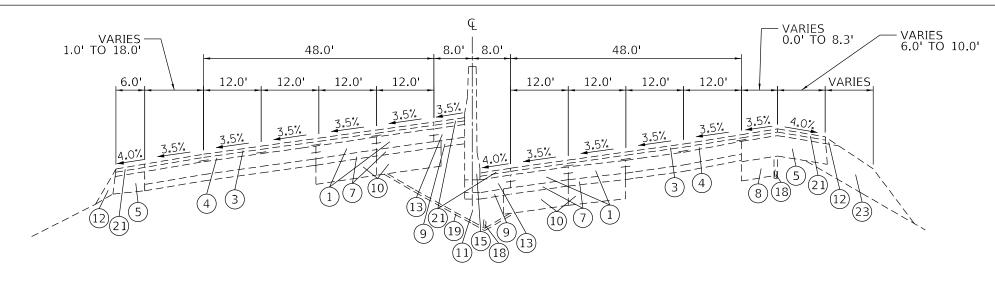

STA 735+74.76 TO STA 744+15.00

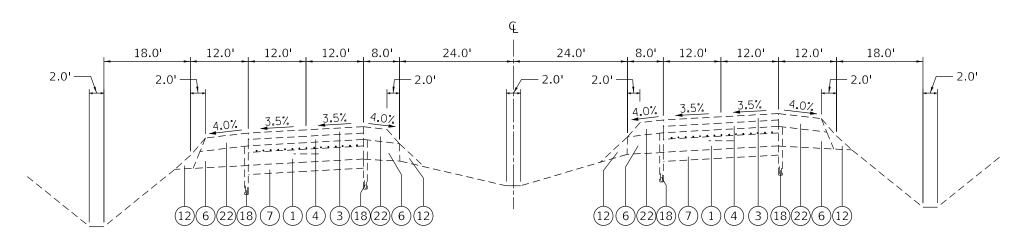

EXISTING TYPICAL SECTION FAI 64 (I–64)


STA 744+15.00 TO STA 782+26.74


- (1) CONTINUOUSLY REINFORCED P.C.C. PAVEMENT, 8"
- (2) CONTINUOUSLY REINFORCED P.C.C. PAVEMENT, 9"
- 3 POLYMERIZED BITUMINOUS SURFACE COURSE, STONE MATRIX ASPHALT, CLASS I, VARIES 1 1/2" TO 2"
- 4 POLYMERIZED BITUMINOUS BINDER COURSE, SUPERPAVE, VARIES 2" TO 2 1/2"
- (5) HOT-MIX ASPHALT SHOULDER, 13"

- (6) HOT-MIX ASPHALT SHOULDER, 8"
- (7) STABILIZED SUB-BASE, 4"
- (8) GRANULAR MATERIAL, TYPE B, 12"
- (9) GRANULAR MATERIAL, TYPE A, 4"
- (10) AGGREGATE SUBGRADE, 12"
- (11) POROUS GRANULAR EMBANKMENT, SUBGRADE
- (12) AGGREGATE SHOULDER, TYPE B
- (13) P.C.C. SHOULDER, 8"
- (14) P.C.C. SHOULDER, 9"
- (15) CONCRETE BARRIER
- (16) STEEL PLATE BEAM GUARDRAIL
- (17) BITUMINOUS SHOULDER CURB

- (18) PIPE UNDERDRAINS, 6"
- (19) FILTER FABRIC
- (20) NOISE ABATEMENT WALL
- (21) BITUMINOUS SURFACE COURSE, SUPERPAVE, 2"
- (22) BITUMINOUS SHOULDER, SUPERPAVE, 3 3/4"
- (23) EMBANKMENT

USER NAME = Brandon, Humphreys	DESIGNED -	REVISED -								F.A.I.	SECTION	COUNTY	TOTAL	SHEET
	DRAWN -	REVISED -	STATE OF ILLINOIS	EXISTING TYPICAL SECTIONS		64	82-(5.6.7)PP-1	ST. CLAIR	14	11				
PLOT SCALE = 40.0000 / in.	CHECKED -	REVISED -	DEPARTMENT OF TRANSPORTATION								. (-77	CONTRACT	- NO. 76	5R48
PLOT DATE = 12/21/2022	DATE -	REVISED -		SCALE: N/A	SHEET 8	OF 8	SHEETS	STA.	TO STA.		ILLINOIS FED. A	D PROJECT		

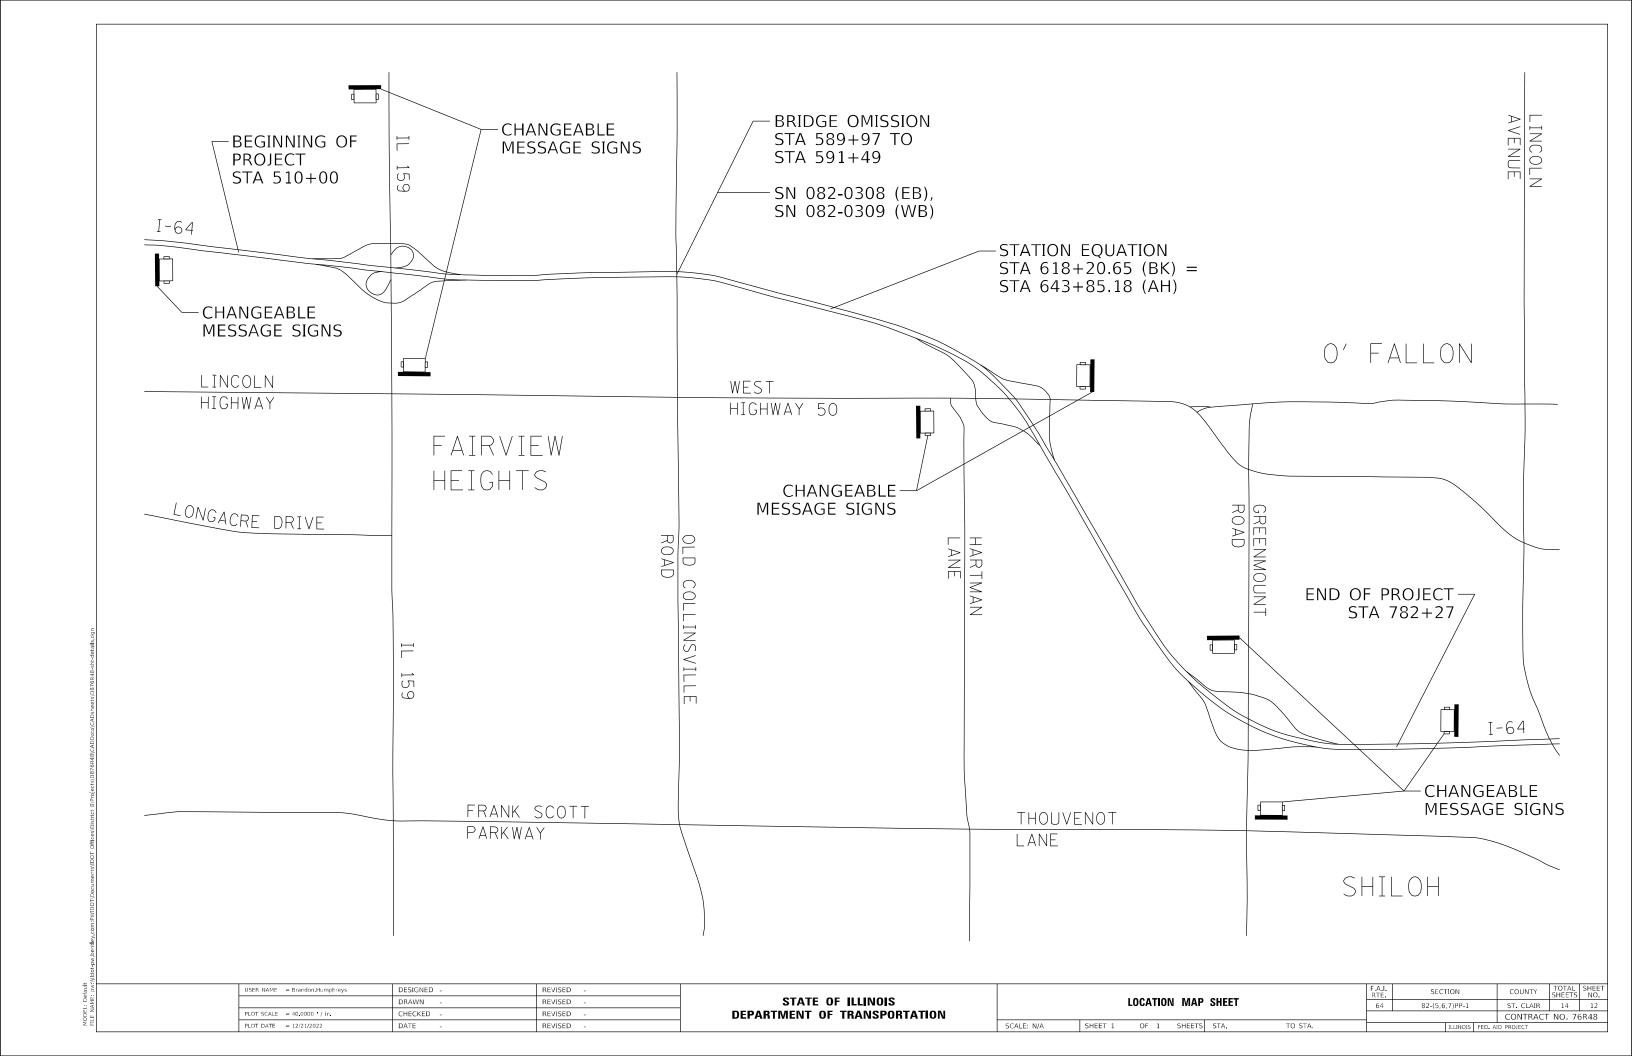


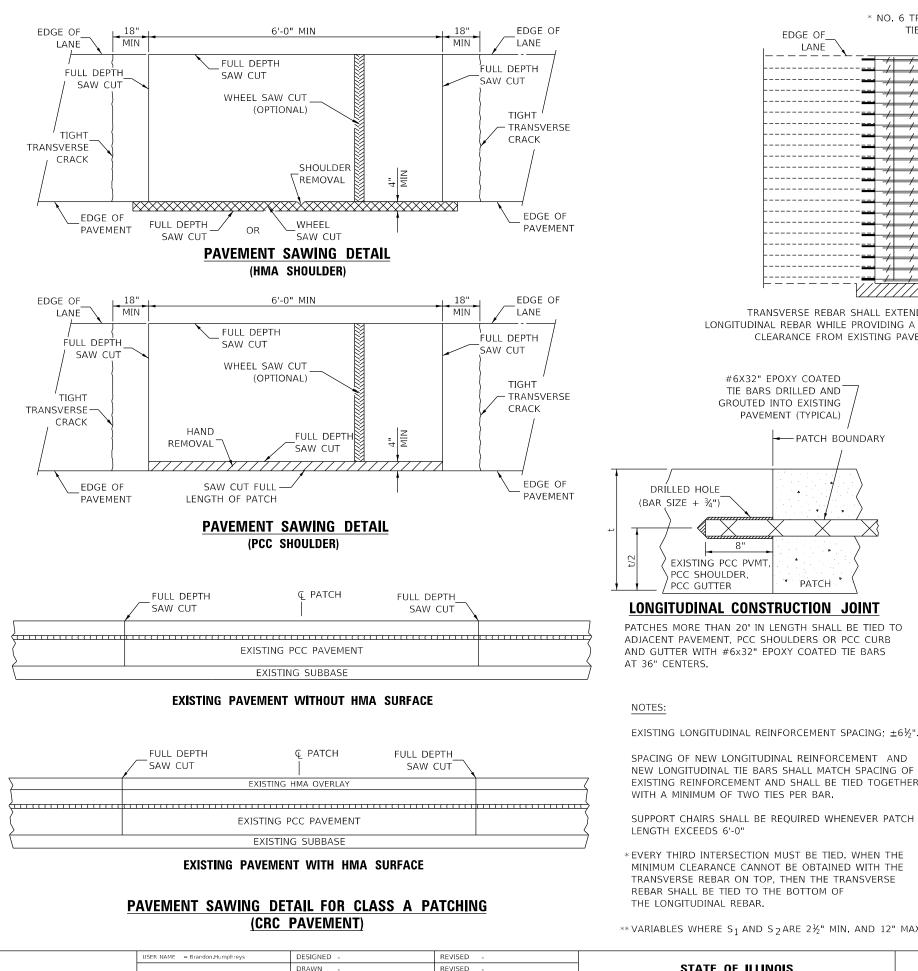


CHECKED


REVISED

PLOT SCALE = 40.0000 / in.

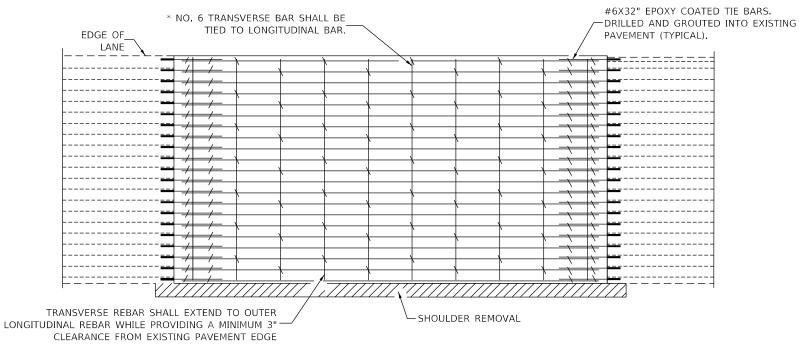

PAVEMENT REINFORCEMENT DETAIL

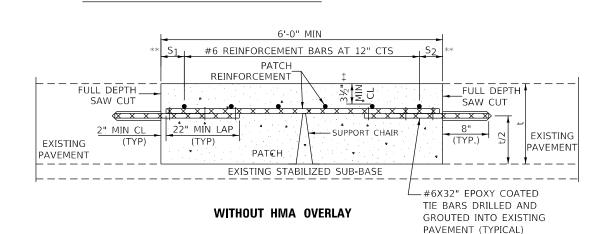

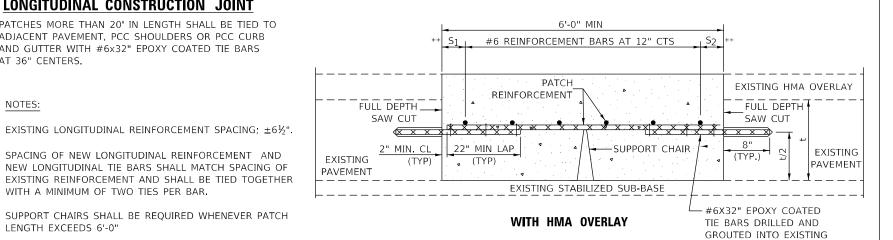

PATCHING DETAIL FOR CLASS A PATCHING (CRC PAVEMENT)

PAVEMENT (TYPICAL)

** VARIABLES WHERE S $_1$ AND S $_2$ ARE $2\frac{1}{2}$ " MIN. AND 12" MAX.

#6X32" EPOXY COATED

TIE BARS DRILLED AND

PAVEMENT (TYPICAL)

* PATCH

- PATCH BOUNDARY

GROUTED INTO EXISTING

DRÍLLED HOLE


EXISTING PCC PVMT,

PCC SHOULDER,


PCC GUTTER

(BAR SIZE + $\frac{3}{4}$ ")

CLASS A PATCHING (SPECIAL) 82-(5,6,7)PP-1 14 CONTRACT NO. 76R48 SCALE: N/A SHEET 1 OF 2 SHEETS STA.

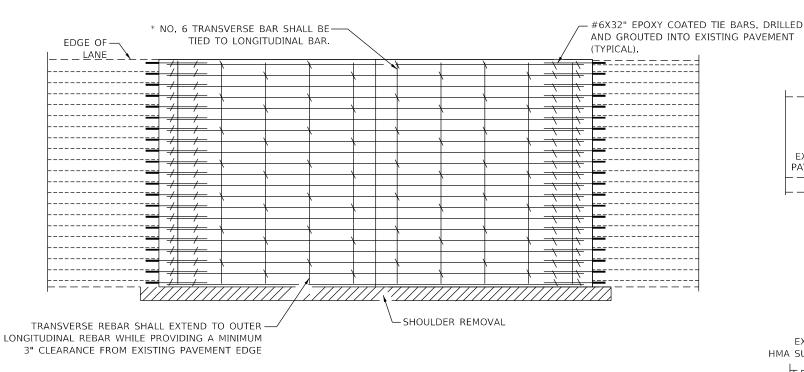


PAVEMENT REINFORCEMENT DETAIL

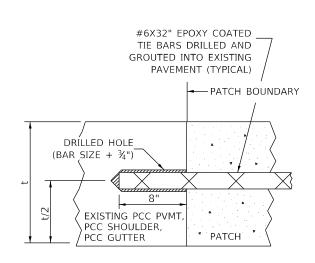

LONGITUDINAL CONSTRUCTION JOINT


PATCHES MORE THAN 20' IN LENGTH SHALL BE TIED TO ADJACENT PAVEMENT, PCC SHOULDERS OR PCC CURB AND GUTTER WITH #6x32" EPOXY COATED TIE BARS AT 36" CENTERS.

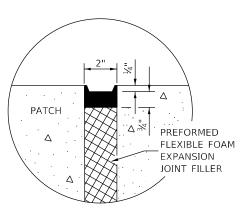

12'-0" MIN 6'-0" MIN 6'-0" MIN SEE SEALING DETAILS-PATCH REINFORCEMENT FULL DEPTH — FULL DEPTH SAW CUT SAW CUT SUPPORT 8" 22" MIN LAP CHAIR **EXISTING** 4 (TYP) **EXISTING** PAVEMENT **PAVEMENT** EXISTING STABILIZED SUB-BASE -#6X32" EPOXY COATED


WITHOUT HMA OVERLAY

TIE BARS DRILLED AND GROUTED INTO EXISTING PAVEMENT (TYPICAL)

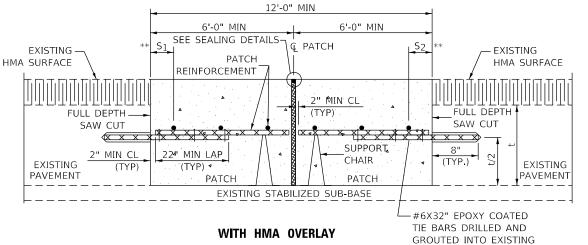

CLASS A PATCH WITH EXPANSION JOINT

SEALING DETAIL

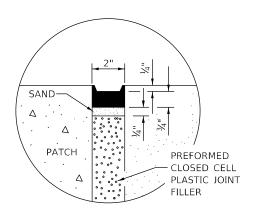

SEALING DETAIL

SCALE: N/A

NOTES:

EXISTING LONGITUDINAL REINFORCEMENT SPACING; ±6½".

PAVEMENT (TYPICAL)

SPACING OF NEW LONGITUDINAL REINFORCEMENT AND NEW LONGITUDINAL TIE BARS SHALL MATCH SPACING OF EXISTING REINFORCEMENT AND SHALL BE TIED TOGETHER WITH A MINIMUM OF TWO TIES PER BAR.

SUPPORT CHAIRS SHALL BE REQUIRED WHENEVER PATCH LENGTH EXCEEDS 6'-0"

* EVERY THIRD INTERSECTION MUST BE TIED, WHEN THE MINIMUM CLEARANCE CANNOT BE OBTAINED WITH THE TRANSVERSE REBAR ON TOP, THEN THE TRANSVERSE REBAR SHALL BE TIED TO THE BOTTOM OF THE LONGITUDINAL REBAR.

** VARIABLES WHERE S $_1$ AND S $_2$ ARE $2\frac{1}{2}$ " MIN. AND 12" MAX.

USER NAME = Brandon.Humphreys	DESIGNED -	REVISED -
	DRAWN -	REVISED -
PLOT SCALE = 40.0000 / in.	CHECKED -	REVISED -
PLOT DATE = 12/21/2022	DATE -	REVISED -

0.1			(0050111)		F.A.I. RTE	SECTION	COUNTY	TOTAL SHEETS	SHEET NO.
CLASS A PATCHING (SPECIAL)					64	82-(5,6,7)PP-1	ST. CLAIR	14	14
,							CONTRACT	NO. 76	5R48
SHEET 2	OF 2	SHEETS	STA.	TO STA.		TILLINOIS FED A	ID PROJECT		