STATE OF ILLINOIS DEPARTMENT OF TRANSPORTATION DIVISION OF HIGHWAYS

PLANS FOR PROPOSED SIDEWALK IMPROVEMENT

FOR INDEX OF SHEETS, SEE SHEET NO. 2

CONGESTION MITIGATION AND AIR QUALITY (CMAQ)

FAP 348 (HARLEM AVE / IL 43) 79TH STREET TO 91st STREET SECTION 03-00047-00-SW PROJECT NO. CMF-0348 (024) COOK COUNTY

> C-91-107-03 Village of Bridgeview

BEGIN PROJECT STA. 2+76.95 V-86tir P

END PROJECT

STA. 73+55.93

Bridgeview | 6 W 78th St W 85th St W 88m P W 89th PI Hickory Hills

> LOCATION MAP (N.T.S.)

TOTAL LENGTH OF IMPROVEMENT = 1.34 MILES

ED PROFESSIONAL DAVID A. ZIESEMER 062-034376 SATE OF ILLINO

DATE

12 / 1 / 05

LICENSE EXPIRES 11-30-2007

SECTION CONTRACT NO. 83830



VILLAGE OF BRIDGEVIEW APPROVED JANARAY 4 20 06

STATE OF ILLINOIS DEPARTMENT OF TRANSPORTATION APPROVED Jag. 9 Diane M. O'Kegge on DEPUTY DIRECTOR OF HIGHWAYS, REGION ENGINEER



Globetrotters®

PRINTED BY THE AUTHORITY OF THE STATE OF ILLINOIS

CONTRACT NO. 83830

1-800-892-0123

FULL SIZE PLANS HAVE BEEN PREPARED USING STANDARD ENGINEERING SCALES. REDUCED SIZED PLANS WILL NOT

ON REDUCED PLANS. THE ABOVE SCALE MAY BE USED.

CONFORM TO STANDARD SCALES. IN MAKING MEASUREMENTS

JOINT UTILITY LOCATION INFORMATION FOR EXCAVATION

2649003 C01.dgn 12/29/2005 03:46:38 PM

INDEX OF SHEETS

- 1 COVER SHEET
- 2 INDEX OF SHEETS & GENERAL NOTES
- 3 SUMMARY OF QUANTITIES
- 4 SCHEDULE OF QUANTITIES
- 5 TIES
- 6 PROPOSED TYPICAL SECTIONS
- 7 DETAIL SECTIONS
- 8 20 SIDEWALK IMPROVEMENT PLANS

LIST OF ILLINOIS DOT HIGHWAY STANDARDS

000001-64 STANDARD SYMBOLS, ABBREVIATIONS AND PATTERNS

424001-04 CURB RAMPS FOR SIDEWALKS

606001 -OZ CONCRETE CURB TYPE B AND COMBINATION CONCRETE CURB

701606-04 URBAN LANE CLOSURE, MULTILANE, 2W WITH MOUNTABLE MEDIAN

701701 - 04 URBAN LANE CLOSURE, MULTILANE INTERSECTION

701801 - 5 LANE CLOSURE, MULTILANE, 1W OR 2W CROSSWALK OR SIDEWALK CLOSURE

702001 - STRAFFIC CONTROL DEVICES 814001 CONCRETE HANDHOLES

GENERAL NOTES

- 1. ALL CONSTRUCTION SHALL BE DONE IN ACCORDANCE WITH THE STATE OF ILLINOIS "STANDARD SPECIFICATIONS FOR ROAD AND BRIDGE CONSTRUCTION" ADOPTED JAN. 1, 2002, AND THE LATEST EDITION OF THE "SUPPLEMENT SPECIFICATIONS AND SPECIAL PROVISIONS" AS NOTED ON THE CHECK SHEET AND THE SPECIAL PROVISIONS INCLUDED IN THE CONTRACT DOCUMENTS.
- 2. WHERE SECTION OR SUBSECTION MONUMENTS ARE ENCOUNTERED, THE ENGINEER SHALL BE NOTIFIED BEFORE THE MONUMENTS ARE REMOVED. THE CONTRACTOR SHALL CAREFULLY PRESERVE ALL PROPERTY MARKS AND MONUMENTS UNTIL THE OWNER, AUTHORIZED SURVEYOR OR AGENT HAS WITNESSED OR OTHERWISE REFERENCED THEIR LOCATION.
- 3. SIGNS
 - A) THE CONTRACTOR WILL BE REQUIRED TO RELOCATE OR REMOVE AND REPLACE SIGNS WHICH INTERFERE WITH HIS CONSTRUCTION OPERATIONS THIS WORK WILL BE CONSIDERED AS INCIDENTAL TO THE CONTRACT.
 - B) SIGNS SHALL NOT BE MOVED UNTIL PROGRESS OF WORK NECESSITATES IT.
 - C) EVERY SIGN REMOVED MUST BE RE-ERECTED AT A TEMPORARY LOCATION IN A WORKMANLIKE MANNER AND BE VISIBLE TO TRAFFIC FOR WHICH IT IS INTENDED. ALL SUCH SIGNS MUST BE MAINTAINED STRAIGHT AND CLEAN FOR THE DURATION OF THE TEMPORARY SETTING.
 - D) ALL SIGNS SHALL BE RE-ERECTED IN PERMANENT LOCATIONS AS THE SIDEWALK IS COMPLETED, HORIZONTAL LOCATION FROM THE EDGE OF PAVEMENT SHALL BE AS DESIGNATED BY THE ENGINEER.
 - E) ALL UNUSED SIGNS WILL BE RETURNED TO THE STATE OR VILLAGE.
 - F) LONGER POSTS MAY BE REQUIRED AT SOME TEMPORARY OR PERMANENT SIGN LOCATIONS TO MAINTAIN PROPER SIGN ELEVATIONS.
- 4. PUBLIC AND PRIVATE UTILITIES: THE CONTRACTOR WILL BE REQUIRED TO ASCERTAIN THE EXACT LOCATIONS OF UTILITIES AND EXERCISE CARE DURING HIS CONSTRUCTION OPERATIONS SO AS NOT TO DAMAGE THEM.
- 5. EARTH EXCAVATION
 - A) THE REMOVAL OF EXISTING BITUMINOUS PAVEMENT AND AGGREGATE BASE COURSE SHALL BE CONSIDERED AS EARTH EXCAVATION.
- 6. DRIVEWAYS OR ENTRANCES
 - A) EXISTING BITUMINOUS, CONCRETE, AND GRAVEL DRIVEWAYS AND ENTRANCES SHALL BE SURFACED TO THE RIGHT-OF-WAY WITH BITUMINOUS CONCRETE SURFACE COURSE AS SCHEDULED IN THE PLANS.
- 7. ALL ELEVATIONS SHOWN ON THESE PLANS ARE ON U.S.G.S. DATUM.

- 8. ANY REFERENCE TO STANDARDS IN THE PLANS OR SPECIAL PROVISIONS SHALL BE INTERPRETED TO BE LATEST STANDARDS OF THE DEPARTMENT.
- 9. THE CONTRACTOR'S ATTENTION IS CALLED TO THE FACT THAT SOME QUANTITIES ARE GIVEN IN BOTH SUMMARY FORM AND SCHEDULE ON THE PLAN SHEETS. CARE SHOULD BE TAKEN TO AVOID DUPLICATION OF QUANTITIES.
- 10. THE CONTRACTOR IS REQUIRED TO TEMPORARILY RESET MAILBOXES THAT INTERFERE WITH CONSTRUCTION. THE COST IS INCIDENTAL TO THE CONTRACT.
- 11. SEDIMENTATION AND EROSION CONTROL
- A) SOIL DISTURBANCE SHALL BE CONDUCTED IN SUCH A MANNER AS TO MINIMIZE EROSION. SOIL STABILIZATION MEASURES SHALL CONSIDER THE TIME OF YEAR, SITE CONDITIONS AND THE USE OF TEMPORARY OR PERMANENT MEASURES.
- B) SOIL EROSION AND SEDIMENT CONTROL FEATURES SHALL BE CONSTRUCTED PRIOR TO THE COMMENCEMENT OF HYDROLOGIC DISTURBANCE OF UPLAND AREAS.
- C) DISTURBED AREAS SHALL BE STABILIZED WITH TEMPORARY OR PERMANENT MEASURES WITHIN 14 CALENDAR DAYS OF THE END OF ACTIVE HYDROLOGIC DISTURBANCE OR REDISTURBANCE.
- 12. TYPICAL CONSTRUCTION SEQUENCING:
 - A) INSTALLATION OF SOIL EROSION AND SEDIMENT CONTROL SE/SC MEASURES:
 - 1) SELECTIVE VEGETATION REMOVAL FOR SILT FENCE INSTALLATION.
 - 2) STLT FENCE INSTALLATION
 - 3) CONSTRUCTION FENCING AROUND AREAS NOT TO BE DISTURBED.
 - 4) STABILIZED CONSTRUCTION ENTRANCE.
- B) WHERE NECESSARY CLEAR AND GRUB (SHRUBS AND SMALL TREES).
- C) CONSTRUCT SEDIMENT TRAPPING DEVICES (SEDIMENT TRAPS, BASINS...).
- D) STRIP TOPSOIL, STOCKPILE TOPSOIL AND GRADE SITE.
- E) TEMPORARILY STABILIZE TOPSOIL STOCKPILES (SEED AND SILT FENCES AROUND TOE OF SLOPE).
- F) TEMPORARILY STABILIZE ALL AREAS INCLUDING LOTS THAT HAVE REACHED TEMPORARY GRADE.
- G) REMOVE AND RELOCATE ANY EXISTING APPURTENANCES.
- H) ADJUST APPURTENANCES TO REMAIN IN PLACE WITHIN PROPOSED SIDEWALK.
- I) INSTALL SIDEWALKS.
- J) INSTALL ANY REQUIRED DRIVEWAY OR PARKING LOT CURB & GUTTER.
- K) PERMANENTLY STABILIZE ALL OUTLET AREAS.
- L) INSTALL STRUCTURES AND GRADE INDIVIDUAL LOTS.
- M) PERMANENTLY STABILIZE LOTS.
- N) REMOVE ALL TEMPORARY SE/SC MEASURES AFTER THE SITE IS STABILIZED WITH VEGETATION.
- 13. IN ORDER TO AVOID SIDEWALK ENCROACHMENT ONTO PRIVATE PROPERTY, THE CONTRACTOR SHALL DELINATE THE R.O.W. LINE ALONG THE WEST FRONTAGE OF HARLEM AVENUE.
- 14. AT LOCATIONS WHERE ASPHALT PAVEMENT IS TO BE REMOVED FROM ENCROACHING PARKING AREAS, A SAW CUT SHALL BE MADE ALONG THE R.O.W. LINE AND FULL DEPTH OF PAVEMENT SHALL BE REMOVED BETWEEN THE SAW CUT AND THE STREET. THE SAW CUT IS INCIDENTAL TO THE BITUMINOUS CONCRETE PAVEMENT REMOVAL (FULL DEPTH).
- 15. AT LOCATIONS WHERE TREES, LIGHT POLES, FIRE HYDRANTS AND OTHER APPURTENANCES ARE LOCATED ALONG THE GENERAL PATH OF THE PROPOSED SIDEWALK, THE ALIGNMENT SHALL BE ADJUSTED TO MINIMIZE REMOVAL OR RELOCATION.

CONTRACT NO. 83830

- 16. AT SOME LOCATIONS THERE IS EXISTING STONE RUBBLE MATERIAL ALONG THE CURB, THIS MATERIAL CAN BE REUSED FOR CONSTRUCTION OF THE NEW STONE RUBBLE EDGE.
- 17. HANDICAP RAMPS SHALL BE PAIDED FOR IN ACCORDANCE WITH BUREAU OF DESIGN & ENVIRONMENT SPECIAL PROVISION.
- 18. SIDEWALKS SHALL BE IN ACCORDANCE WITH A.D.A. REQUIREMENTS.
- 19. CURB REMOVAL WILL BE 15FT. THE REMOVAL WILL BE 7.5FT (OR LESS) IN EACH DIRECTION FROM THE CENTER OF THE SIDEWALK OR DRIVEWAY.
- 20. REMOVAL OF THE EXISTING DECORATIVE STONE FROM APPROXIMATE STA. 17+00.00 TO STA. 22+00.00 IS INCIDENTAL TO THE SIDEWALK REMOVAL

PROJECT NOTES

 FIRE HYDRANT RELOCATION, WATER VALVE (BUFFALO BOXES) ADJUSTMENTS, AND TREE REMOVAL TO BE PERFORMED BY THE VILLAGE.

VILLAGE CONTACT:

WILLIAM CRONCH DIRECTOR OF PUBLIC WORKS VILLAGE OF BRIDGEVIEW 7500 S. OKETO AVE BRIDGEVIEW, IL 60455 (708) 924-8051

2. TELEPHONE RELOCATION CONTACT IS SBC/AMERITECH.

CONTACT

MICHAEL WATTERS SBC/AMERITECH 2427 UNION FLOOR 2 BLUE ISLAND, IL 60406 (708) 396-7614

GENERAL NOTES SURROUNDED BY A BOX DENOTE WORK THAT IS INCIDENTAL TO THE CONTRACT.



GlobetrottersEngineering Corporation

ENGINEERS

ARCHITECTS

300 South Wacker Drive Chicago, Illinois 60606



Village of Bridgeview

Illinois

Steven M. Landek, Mayor

ILLINOIS DEPARTMENT OF TRANSPORTATION
SIDEWALK IMPROVEMENT
INDEX OF SHEETS & GENERAL NOTES

SCALE: VERT. N.T.S. HORIZ. N.T.S. DATE: 11 / 17 / 05

DRAWN BY: C.G. CHECKED BY: D.Z.

SUMMARY OF QUANTITIES

		IDOT CODE	THE OF CONDITION		TOTAL	80% FEDERAL 20% BRIDGEVIEW
		IBOT COBE	ITEM DESCRIPTION	UNIT		CONSTRUCTION TYPE CODE SFTY-1B
	1	20200100	EARTH EXCAVATION	CU YD	771	771
*	2	21101615	TOPSOIL, FURNISH AND PLACE, 4 IN	SQ YD	4207	4207
*	3	25000400	NITROGEN FURTILIZER NUTRIENT	POUND	52	52
*	4	25000500	PHOSPHORUS FERTILIZER NUTRIENT	POUND	52	52
*	5	25000600	POTASIUM FERTILIZER NUTRIENT	POUND	52	52
•	6	25200110	SODDING, SALT TOLERANT	SQ YD	4207	4207
*	7	25200200	SUPPLEMENTAL WATERING	UNIT	63	63
	8	28000400	PERIMETER EROSION BARRIER	FOOT	60	60
	9	31101000	SUB-BASE GRANULAR MATERIAL, TYPE B	TON	10	10
	10	42400200	PORTLAND CEMENT CONCRETE SIDEWALK, 5 IN	SQ FT	20297	20297
į	11	42400800	DETECTABLE WARNINGS	SQ FT	1010	1010
	12	44000300	CURB REMOVAL	FOOT	935	935
	13	44000500	COMBINATION CURB AND GUTTER REMOVAL	FOOT	308	308
Ī	14	44000600	SIDEWALK REMOVAL	SQ FT	3842	3842
	15	60250200	CATCH BASINS TO BE ADJUSTED	EACH	4	4
Ī	16	60255500	MANHOLES TO BE ADJUSTED	EACH	5	5
	17	60265700	VALVE VAULT TO BE ADJUSTED	EACH	1	1
Ī	18	60600605	CONCRETE CURB, TYPE B	FOOT	1633	1633
	19	60605000	COMBINATION CONCRETE CURB AND GUTTER, TYPE B-6.24	FOOT	270	270
	20	63200310	GUARDRAIL REMOVAL	F00T	14	14
Ì	21	67100100	MOBILIZATION	L SUM	1	1
	22	70102625	TRAFFIC CONTROL AND PROTECTION, STANDARD 701606	L SUM	1	1
	23	70102635	TRAFFIC CONTROL AND PROTECTION, STANDARD 701701	L SUM	1	1
	24	70102640	TRAFFIC CONTROL AND PROTECTION, STANDARD 701801	L SUM	1	1
Ī	25	72400710	RELOCATE SIGN PANEL - TYPE 1	SQ FT	35	35
*	26	78000400	THERMOPLASTIC PAVEMENT MARKING - LINE 6"	F00T	3186	3186
*	27	78000650	THERMOPLASTIC PAVEMENT MARKING - LINE 24"	FOOT	939	939
	28	X4066414	BITUMINOUS CONCRETE SURFACE COURSE, SUPERPAVE, MIX "C", N50	TON	49.6	49.6
Ī	29	X4066614	BITUMINOUS CONCRETE BINDER COURSE, SUPERPAVE, IL-19, N50	TON	99.1	99.1
	30	X4066735	LEVELING BINDER (HAND METHOD), SUPERPAVE N50	TON	10	10
	31	X8950200	REBUILD EXISTING HANDHOLE	EACH	2	2
	32	X8950210	REBUILD EXISTING HANDHOLE TO HEAVY-DUTY HANDHOLE	EACH	1	1
	33	XX006461	BITUMINOUS CONCRETE PAVEMENT REMOVAL (FULL DEPTH)	SQ YD	1095	1095

DENOTES SPECIALTY ITEM



Globetrotters* Engineering Corporation ENGINEERS ARCHITECTS

300 South Wacker Drive Chicago, Illinois 60606



Village of Bridgeview Illinois

Steven M. Landek, Mayor

REVISIO	NS I	ILLINOIS DECARTAGUE OF TRANSPORTATION						
NAME	DATE	ILLINOIS DEPARTMENT OF TRANSPORTATIO SIDEWALK IMPROVEMENT						
		SUMMARY OF QUANTITIES						

SCALE: VERT. N.T.S. HORIZ. N.T.S. DATE: 11 / 17 / 05

DRAWN BY: B.C. CHECKED BY: L.S. / D.Z.

CONTRACT NO. 83830

FED. ROAD DIST. NO. _ ILLINOIS FED. AID PROJECT

F.A.	SECTION	COUNTY	SHEETS	SHEET NO.	
IL 43	03-00047-00-SW	COOK	20	4	
STA.	TO	STA.		**********	
FED. RO	AD DIST. NO ILLINOIS	FED. AID	PROJECT		
	CC	NTRACT N	0. 83830		

SCHEDULE OF QUANTITIES

	IDOT CODE	ITEM DESCRIPTION	UNIT	TOTAL QUANTITY	STA 2+76.95 TO STA 14+86.01	STA 16+94.08 TO STA 24+89.24	STA 26+80.00 TO STA 33+42.61	STA 34+04.73 TO STA 45+45.39	STA 47+32.12 TO STA 51+51.82	STA 53+06.50 TO STA 56+85.44	STA 60+77.22 TO STA 63+31.00	STA 65+23.17 TO STA 73+55.93
1	20200100	EARTH EXCAVATION	CU YD	771	94	207	97	147	70	33	0	123
2	21101615	TOPSOIL, FURNISH AND PLACE, 4 IN	SQ YD	4207	278	649	645	1238	458	291	0	648
3	25000400	NITROGEN FURTILIZER NUTRIENT	POUND	52	3 -	8	8	15	6	4	0	8
4	25000500	PHOSPHORUS FERTILIZER NUTRIENT	POUND	52	3	8	8	15	6	4	0	8
5	25000600	POTASIUM FERTILIZER NUTRIENT	POUND	52	3	8	8	15	6	4	0	8
6	25200110	SODDING, SALT TOLERANT	SQ YD	4207	278	649	645	1238	458	291	0	648
7	25200200	SUPPLEMENTAL WATERING	UNIT	63	4	10	10	18	7	4 .	0	10
8	28000400	PERIMETER EROSION BARRIER	FOOT	60	60	0	0	0	0	0	0	0
9	31101000	SUB-BASE GRANULAR MATERIAL, TYPE B	TON	10	0.5	0	0	0	0.5	0	0	9.0
10	42400200	PORTLAND CEMENT CONCRETE SIDEWALK, 5 IN	SQ FT	2029.7	4003	3340	2502	4080	1883	1090	75	3324
11	42400800	DETECTABLE, WARNINGS	SQ FT	1010	130	140	120	300	60	80	0	180
12	44000300	CURB REMOVAL	FOOT	935	75	210	176	156	80	0	0	238
13	44000500	COMBINATION CURB AND GUTTER REMOVAL	FOOT	308	118	0	0	0	60	110	0	20
14	44000600	SIDEWALK REMOVAL	SQ FT	3842	280	2462	847	78	100	0	75	0
15	60250200	CATCH BASINS TO BE ADJUSTED	EACH	4	0	0	1	2	1	0	0	0
16	60255500	MANHOLES TO BE ADJUSTED	EACH	5	0	1	2	2	0	0	0	0
17	60265700	VALVE VAULT TO BE ADJUSTED	EACH	1	0	0	0	0	0	0	0 .	1
18	60600605	CONCRETE CURB, TYPE B	FOOT	1633	75	210	220	660	30	0	0	438
19	60605000	COMBINATION CONCRETE CURB AND GUTTER, TYPE B-6.24	FOOT	270	140	0	0	0	0	110	0	20
20	63200310	GUARDRAIL REMOVAL	FOOT	14	0	0	0	0	0	0	0	14
21	67100100	MOBILIZATION	L SUM	1	0	0	0	0	0	0	0	0
22	70102625	TRAFFIC CONTROL AND PROTECTION, STANDARD 701606	L SUM	1	0	0	0	0	0	0	0	0 .
23	70102635	TRAFFIC CONTROL AND PROTECTION, STANDARD 701701	L SUM	1	0	0	0	0	0	0	0	0
24	70102640	TRAFFIC CONTROL AND PROTECTION, STANDARD 701801	L SUM	1	0	0	0	0	0	0	0	0
25	72400710	RELOCATE SIGN PANEL - TYPE 1	SQ FT	3 5	0	0	0	0	35	0	0	0
26	78000400	THERMOPLASTIC PAVEMENT MARKING - LINE 6"	FOOT	3186	1020	0	258	462	60	752	170	464
27	78000650	THERMOPLASTIC PAVEMENT MARKING - LINE 24"	FOOT	939	276	0	52	123	15	206	131	136
28	X4066414	BITUMINOUS CONCRETE SURFACE COURSE, SUPERPAVE, MIX "C", N50	TON	49.6	2	0	0	28	0.4	0	0	19.2
29	X4066614	BITUMINOUS CONCRETE BINDER COURSE, SUPERPAVE, IL-19, N50	TON	99.1	2	0	0	58	0.7	0	0	38.4
30	X4066735	LEVELING BINDER (HAND METHOD), SUPERPAVE N50	TON	10	0	0	0	0	0	. 0 .	0	10
31	X8950200	REBUILD EXISTING HANDHOLE	EACH	2	О	0	1	0	0	0	0	1
32	X8950210	REBUILD EXISTING HANDHOLE TO HEAVY-DUTY HANDHOLE	EACH	1	1	0	0	0	0	0	0	0
33	XXOOLAHOI	BITUMINOUS CONCRETE PAVEMENT REMOVAL (FULL DEPTH)	SQ YD	1095	0	0	0	133	0	0	0	962

* - DENOTES SPECIALTY ITEM



Globetrotters®
Engineering Corporation
ENGINEERS ARCHITECTS

300 South Wacker Drive Chicago, Illinois 60606



Village of Bridgeview


Illinois Steven M. Landek, Mayor


NAME	DATE


ILLINOIS DEPARTMENT OF TRANSPORTATION
SIDEWALK IMPROVEMENT
SCHEDULE OF QUANTITIES

SCALE: VERT. N.T.S.
HORIZ. N.T.S.
DATE: 11 / 17 / 05


DRAWN BY: B.C. CHECKED BY: L.S. / D.Z.

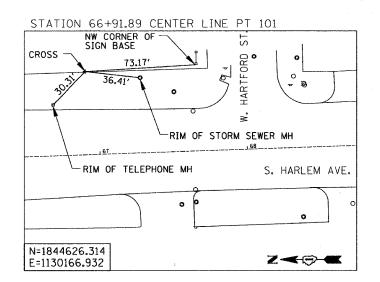

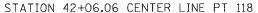


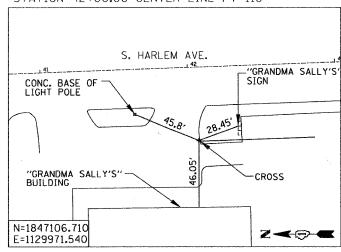


STATION 7+57.13 CENTER LINE PT 115

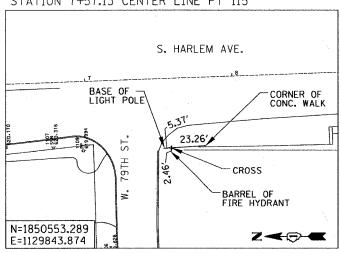


STATION 59+43.46 CENTER LINE PT 119

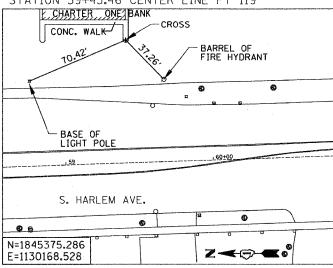

STATION 28+18.56 CENTER LINE PT 117

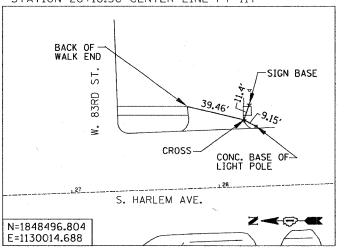


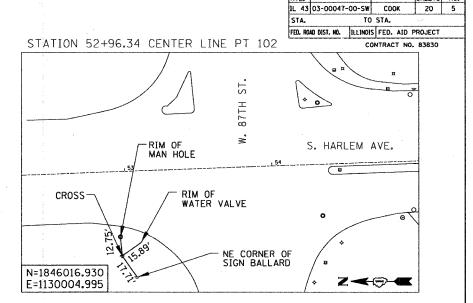

SECTION

COUNTY

STATION 17+83.36 CENTER LINE PT 116

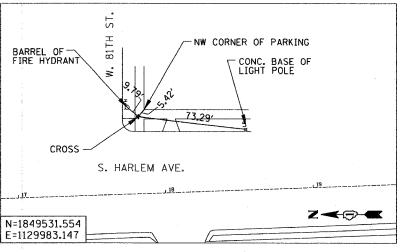



Globetrotters® Engineering Corporation

300 South Wacker Drive Chicago, Illinois 60606

ARCHITECTS





Village of **Bridgeview** Illinois

Steven M. Landek, Mayor

ILLINOIS DEPARTMENT OF TRANSPORTATION SIDEWALK IMPROVEMENT STATIONING TIES

SCALE: VERT. N.T.S. HORIZ. N.T.S. DATE: 11 / 17 / 05

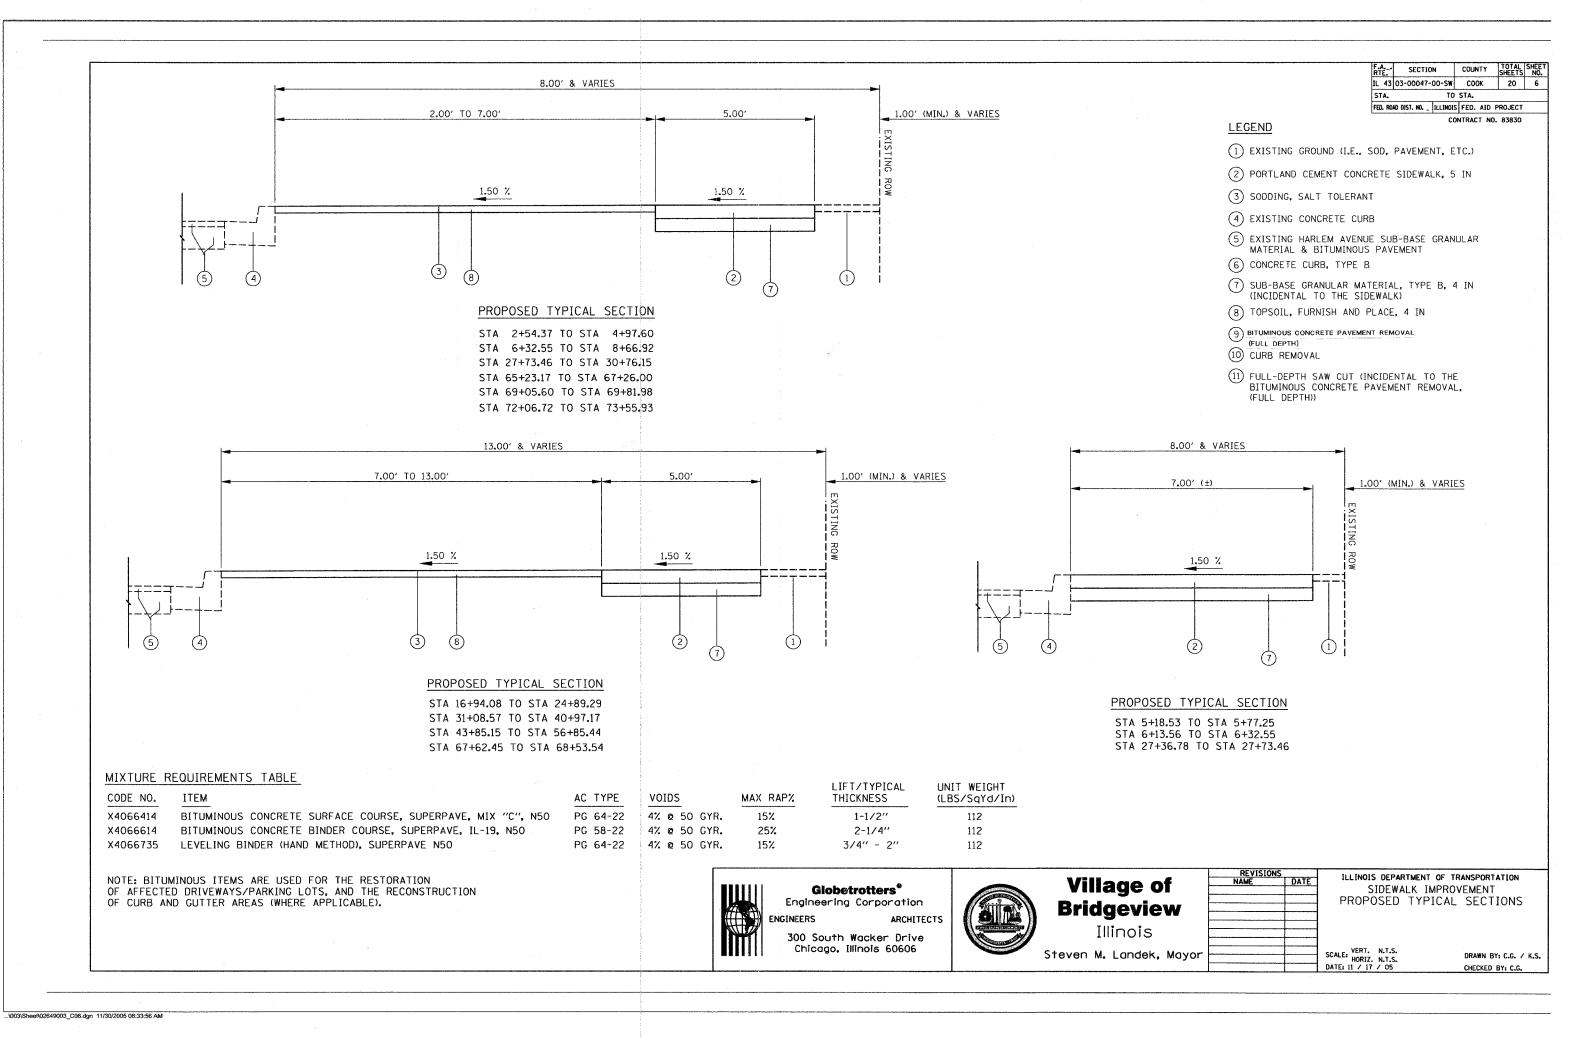

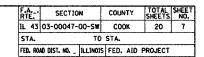

1) EXISTING GROUND (I.E., SOD, PAVEMENT, ETC.)

(2) PORTLAND CEMENT CONCRETE SIDEWALK, 5 IN

(5) EXISTING HARLEM AVENUE SUB-BASE GRANULAR MATERIAL & BITUMINOUS PAVEMENT

7 SUB-BASE GRANULAR MATERIAL, TYPE B, 4 IN (INCIDENTAL TO THE SIDEWALK)

11) FULL-DEPTH SAW CUT (INCIDENTAL TO THE BITUMINOUS CONCRETE PAVEMENT REMOVAL,

8 TOPSOIL, FURNISH AND PLACE, 4 IN
9 BITUMINOUS CONCRETE PAVEMENT REMOVAL

3 SODDING, SALT TOLERANT4 EXISTING CONCRETE CURB


(6) CONCRETE CURB, TYPE B

(FULL DEPTH)

(10) CURB REMOVAL

(FULL DEPTH))

CONTRACT NO. 83830

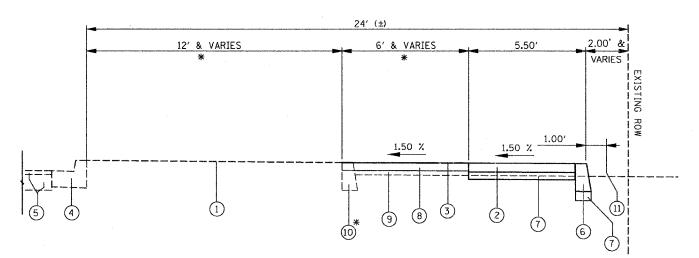

SECTION A-A

HARLEM AVENUE

*STA 41+29.93 TO STA 41+78.11 STA 42+06.29 TO STA 43+85.15 STA 69+97.84 TO STA 72+06.72

E

GlobetrottersEngineering Corporation

ENGINEERS

ARCHITECTS

300 South Wacker Drive Chicago, Illinois 60606



Village of Bridgeview

Illinois

Steven M. Landek, Mayor

REVISIONS					
REVISIONS NAME	DATE				
	1				


LEGEND

ILLINOIS DEPARTMENT OF TRANSPORTATION
SIDEWALK IMPROVEMENT
DETAIL SECTIONS

SCALE: VERT. N.T.S. HORIZ. N.T.S. DATE: 11 / 17 / 05 DRAWN BY: C.W. / K.S. CHECKED BY: C.G.

F.A RTE.	SECTIO	N	COUNTY	TOTAL	SHEET NO.
IL 43	03-00047-00-SW		COOK	20	8
STA.	2+54.37	TO	STA. 4+00	.00	•
FEB. RO	AD DIST. NO	ILLINOIS	FED. AID	PROJECT	

CONTRACT NO. 83830

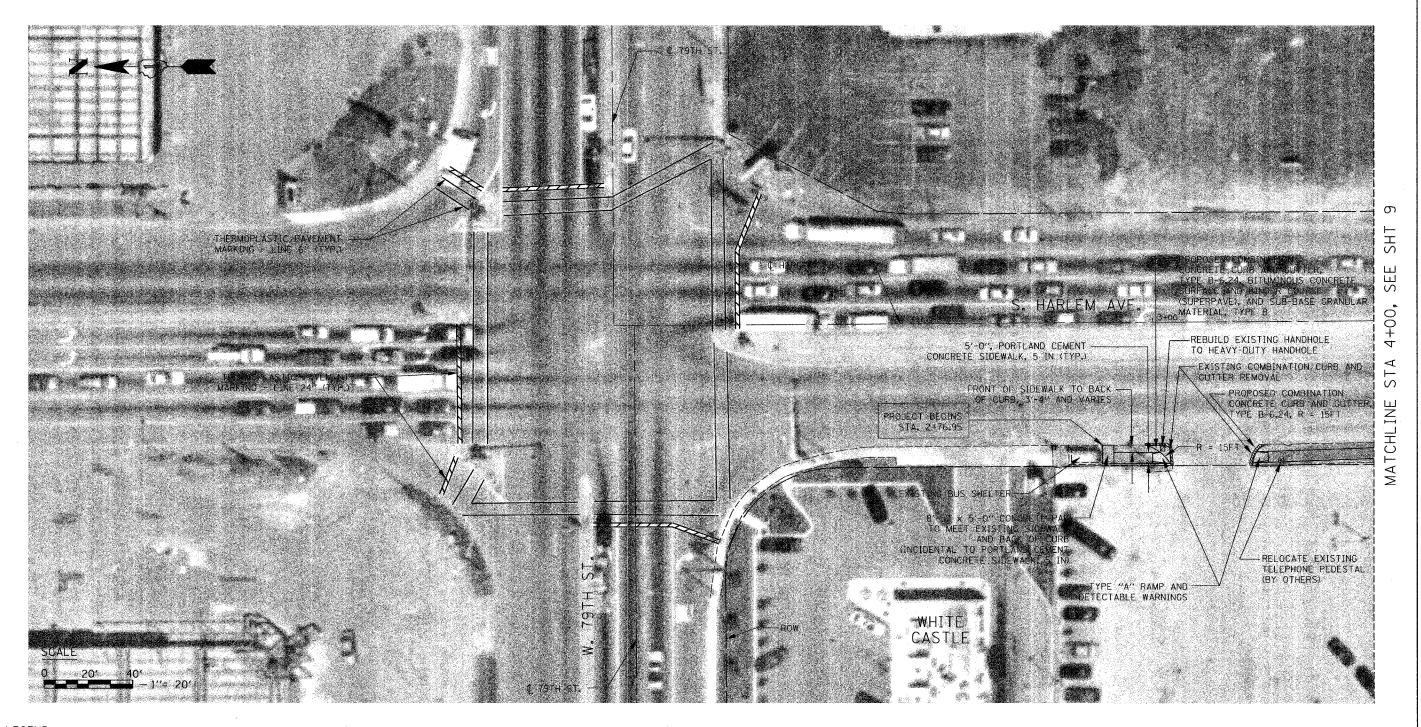

LEGEND



CURB REMOVAL, COMBINATION CURB AND GUTTER REMOVAL, OR SIDEWALK REMOVAL



Globetrotters®Engineering Corporation ARCHITECTS

300 South Wacker Drive Chicago, Illinois 60606



Village of Bridgeview

Illinois


Steven M. Landek, Mayor

REVISIO	NS
NAME	DATE
	


ILLINOIS DEPARTMENT OF TRANSPORTATION
SIDEWALK IMPROVEMENT

PLAN STA 2+54.37 TO STA 4+00.00

SCALE: VERT. 1"= 20' HORIZ. 1"= 20' DATE: 11 / 17 / 05

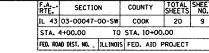



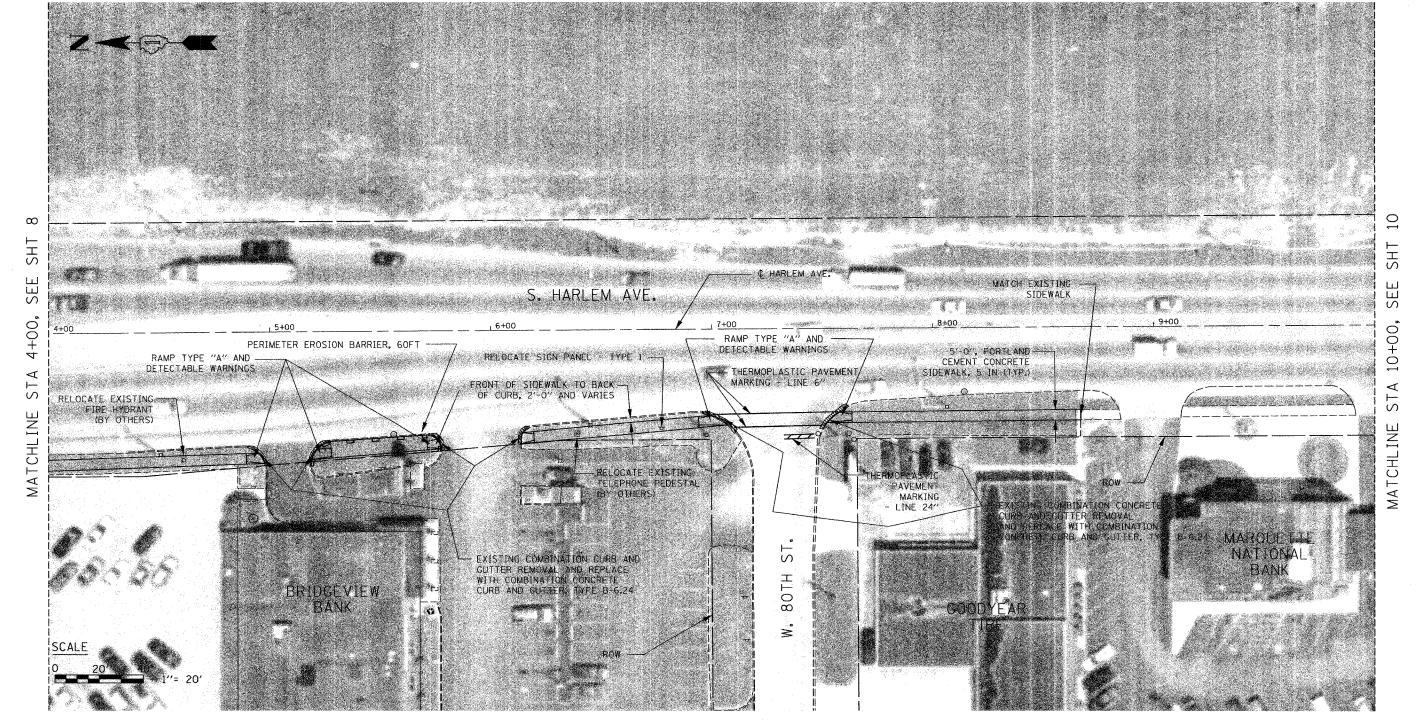

LEGEND



CURB REMOVAL, COMBINATION CURB AND GUTTER REMOVAL, OR SIDEWALK REMOVAL



Globetrotters*

Engineering Corporation ARCHITECTS

ENGINEERS

300 South Wacker Drive Chicago, Illinois 60606



Village of **Bridgeview**

Illinois

Steven M. Landek, Mayor


REVISIONS NAME	,	
NAME	DATE	ĺ
		1
~	1	1
		1
	 	1
	-	ĺ
	1	1
	+	ı
	+	l
		1 9

ILLINOIS DEPARTMENT OF TRANSPORTATION SIDEWALK IMPROVEMENT STA 4+00.00 TO STA 10+00.00

SCALE: VERT. 1"= 20' HORIZ. 1"= 20' DATE: 11 / 17 / 05

STA. 10+00.00 TO STA. 16+00.00 FED. ROAD DIST. NO. _ ILLINOIS FED. AID PROJECT

CONTRACT NO. 83830

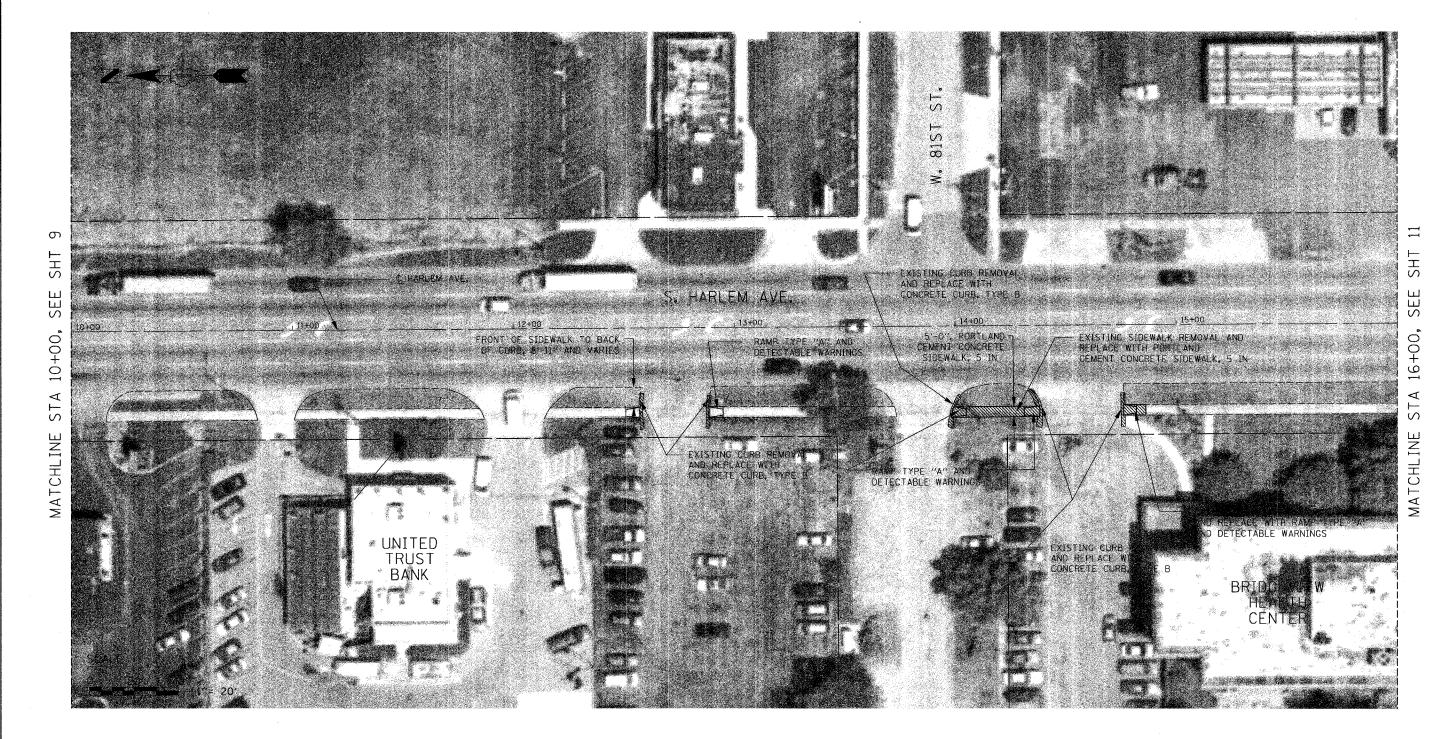

LEGEND

CURB REMOVAL, COMBINATION CURB AND GUTTER REMOVAL, OR SIDEWALK REMOVAL



Globetrotters*

Engineering Corporation

300 South Wacker Drive Chicago, Illinois 60606



Village of **Bridgeview**

Illinois Steven M. Landek, Mayor

REVISIONS NAME DATE					
NAME	DATE				
······································	<u> </u>				
·····					
		١.			


ILLINOIS DEPARTMENT OF TRANSPORTATION SIDEWALK IMPROVEMENT PLAN STA 10+00.00 TO STA 16+00.00

SCALE: VERT. 1"= 20' HORIZ. 1"= 20' DATE: 11 / 17 / 05

F.A. - SECTION COUNTY TOTAL SHEETS NO.

IL 43 03-00047-00-SW COOK 20 11 STA. 16+00.00 TO STA. 22+00.00 FED. ROAD DIST. NO. _ ILLINOIS FED. AID PROJECT

CONTRACT NO. 83830

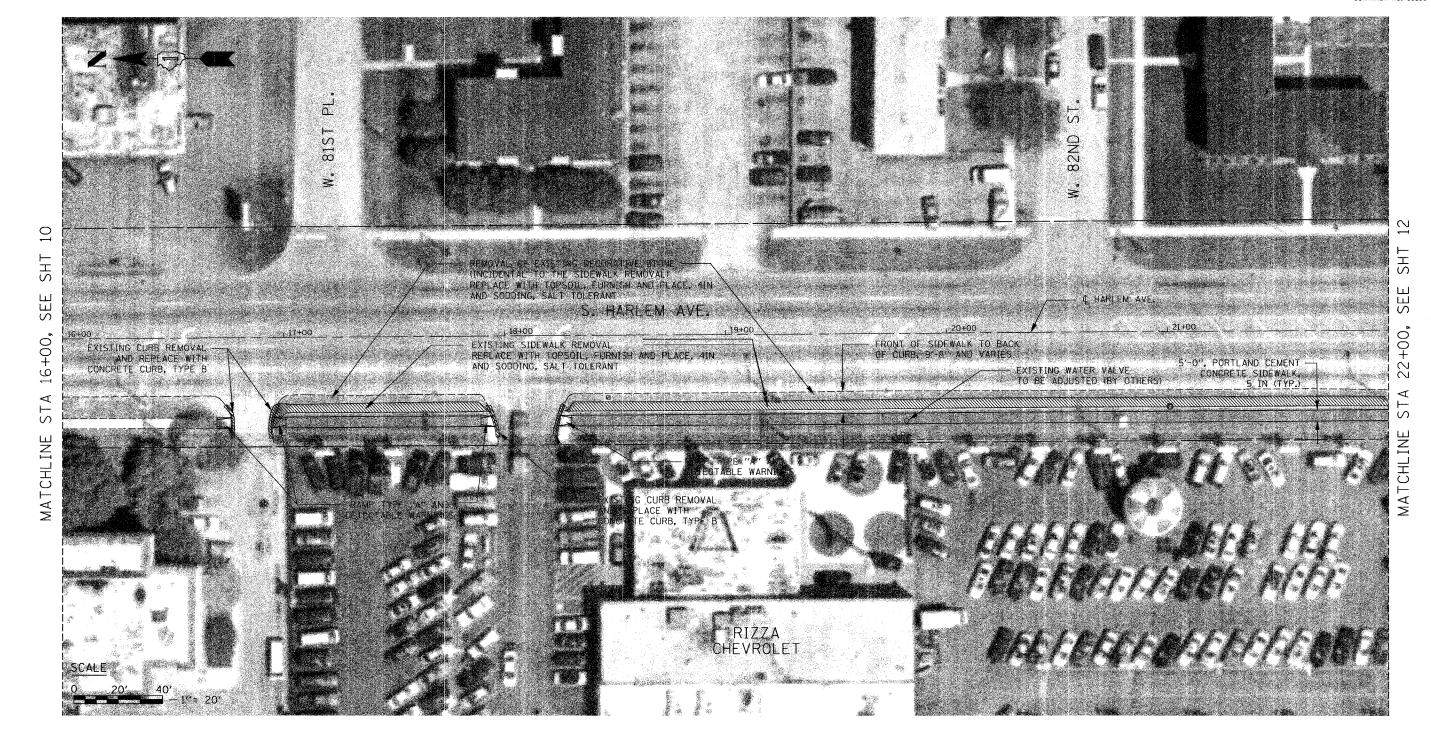

LEGEND

CURB REMOVAL, COMBINATION CURB AND GUTTER REMOVAL, OR SIDEWALK REMOVAL



Globetrotters^e

Engineering Corporation ARCHITECTS

300 South Wacker Drive Chicago, Illinois 60606



Village of Bridgeview


Illinois

Steven M. Landek, Mayor

REVISIONS NAME DATE			
NAME	DATE		


ILLINOIS DEPARTMENT OF TRANSPORTATION SIDEWALK IMPROVEMENT PLAN STA 16+00.00 TO STA 22+00.00

SCALE: VERT. 1"= 20' HORIZ. 1"= 20' DATE: 11 / 17 / 05

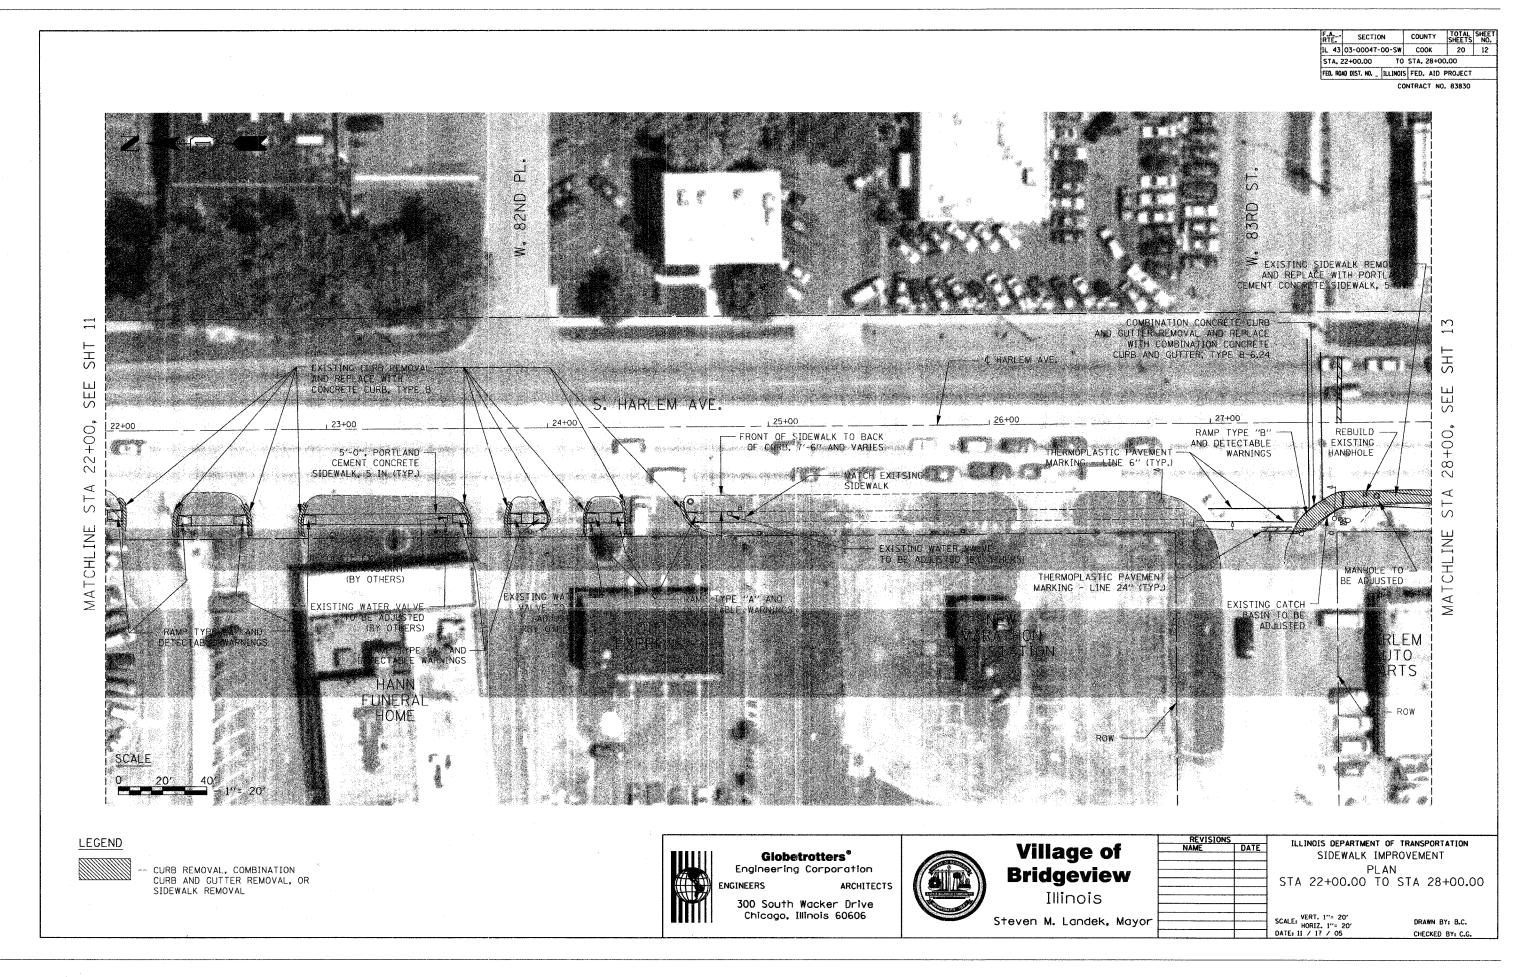

STA. 28+00.00 TO STA. 34+00.00 FED. ROAD DIST. ND. _ ILLINOIS FED. AID PROJECT

CONTRACT NO. 83830

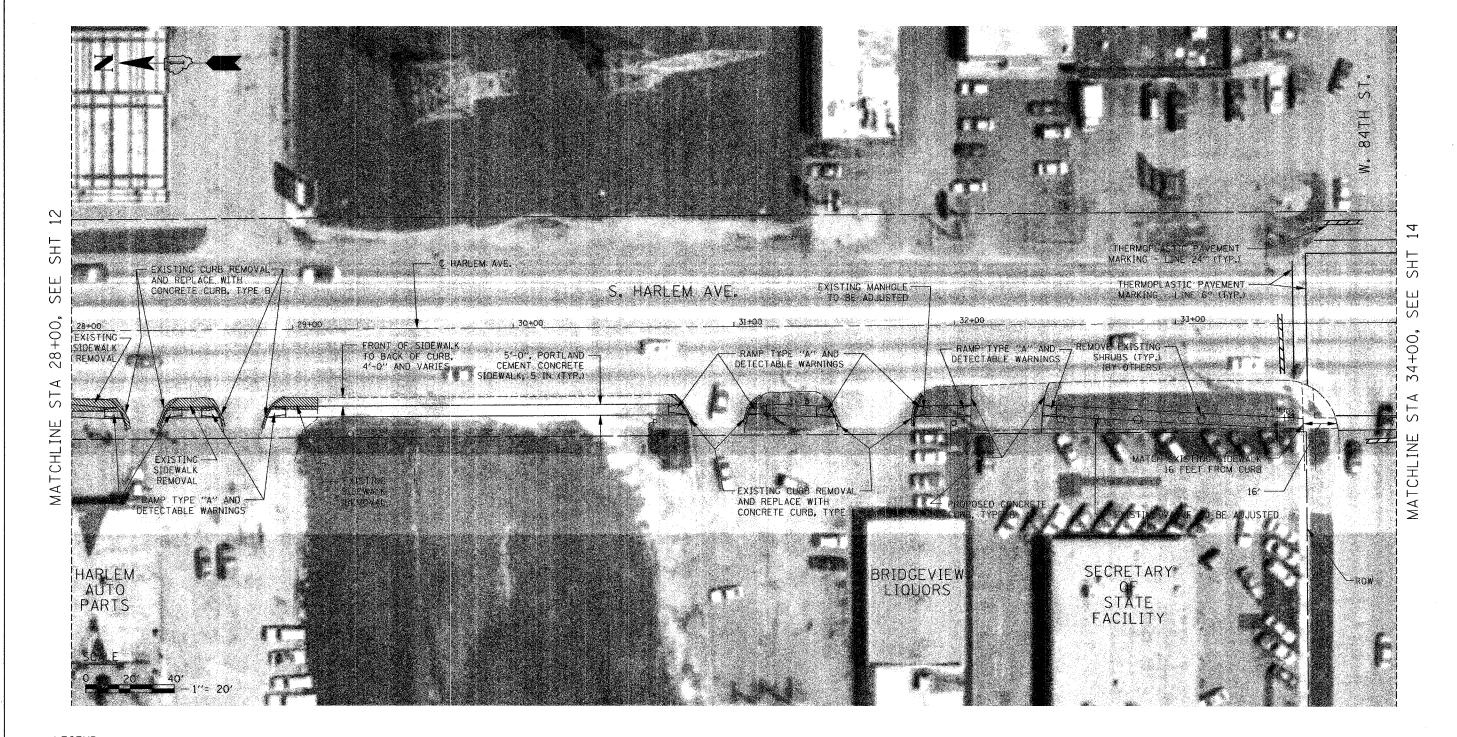

LEGEND



CURB REMOVAL, COMBINATION CURB AND GUTTER REMOVAL, OR SIDEWALK REMOVAL



Globetrotters*

Engineering Corporation ARCHITECTS

ENGINEERS

300 South Wacker Drive Chicago, Illinois 60606



Village of **Bridgeview**

Illinois

Steven M. Landek, Mayor


REVISIONS					
REVISIONS NAME	DATE				
·····					
·· · · · · · · · · · · · · · · · · · ·		ĺ			
					
		5			
	3				

ILLINOIS DEPARTMENT OF TRANSPORTATION SIDEWALK IMPROVEMENT PLAN STA 28+00.00 TO STA 34+00.00

SCALE: VERT. 1"= 20' HORIZ. 1"= 20' DATE: 11 / 17 / 05

RTE. SECTION COOK
IL 43 03-00047-00-SW COOK
TO STA, 40+C 20 14 STA. 34+00.00 TO STA. 40+00.00 FED. ROAD DIST. NO. _ ILLINOIS FED. AID PROJECT

CONTRACT NO. 83830

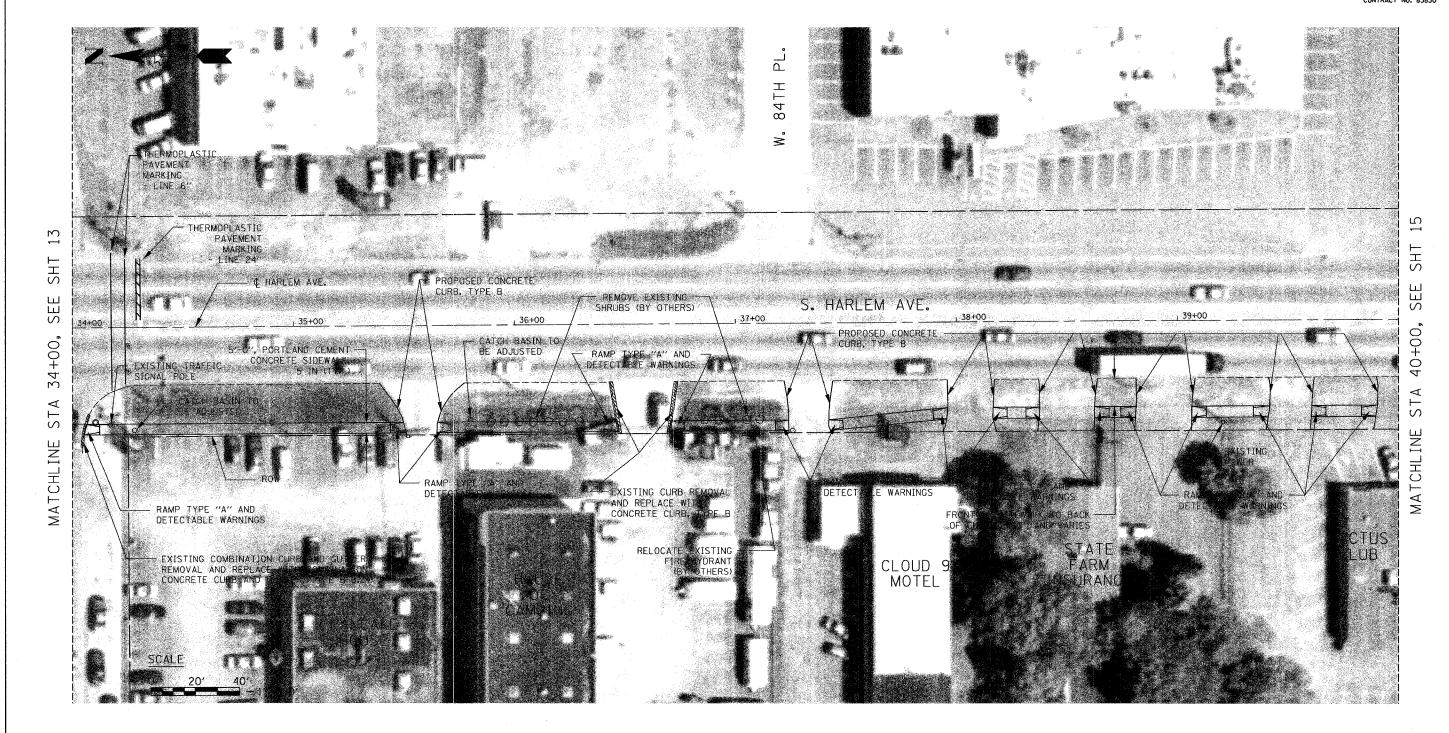

LEGEND



CURB REMOVAL, COMBINATION CURB AND GUTTER REMOVAL, OR SIDEWALK REMOVAL



Globetrotters⁶

Engineering Corporation

ARCHITECTS

300 South Wacker Drive Chicago, Illinois 60606



Village of Bridgeview

Illinois

Steven M. Landek, Mayor


REVISIONS NAME DATE	
NAME	DATE

ILLINOIS DEPARTMENT OF TRANSPORTATION SIDEWALK IMPROVEMENT

PLAN STA 34+00.00 TO STA 40+00.00

SCALE: VERT. 1"= 20' HORIZ. 1"= 20' DATE: 11 / 17 / 05

CONTRACT NO. 83830

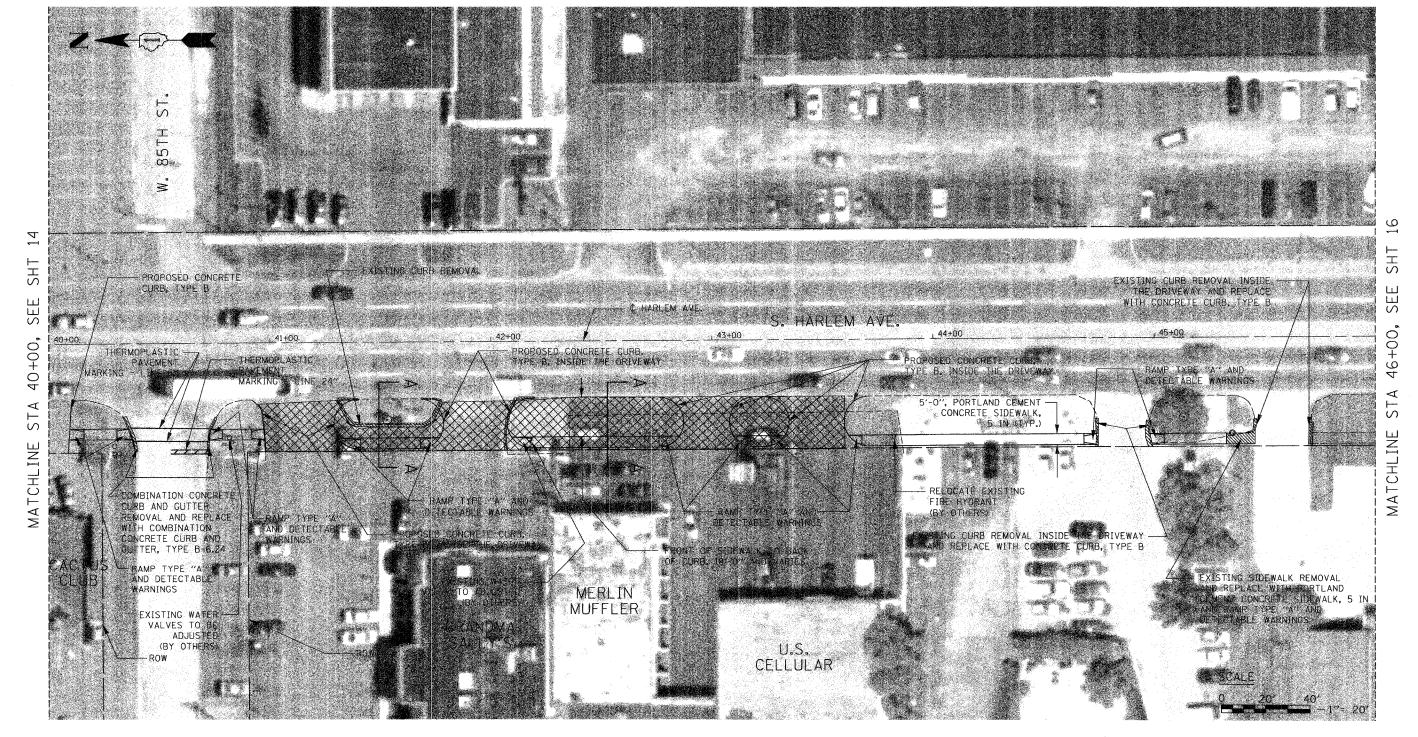

NOTES

1. FOR SECTION A-A, SEE SHEET 7.

2. ALL PROPOSED DRIVEWAY CONCRETE CURB. TYPE B
RADII TO BE HALF THE DISTANCE FROM BACK OF
HARLEM AVE. EXISTING CURB TO BACK OF PROPOSED
PORTLAND CEMENT CONCRETE SIDEWALK, 5 IN

LEGEND



- PROPOSED BITUMINOUS CONCRETE PAVEMENT REMOVAL (FULL-DEPTH) (SAW CUTS INCIDENTAL)



-- CURB REMOVAL, COMBINATION CURB AND GUTTER REMOVAL, OR SIDEWALK REMOVAL



Globetrotters®Engineering Corporation

ARCHITECTS

ENGINEERS

300 South Wacker Drive Chicago. Illinois 60606



Village of Bridgeview


Illinois

Steven M. Landek, Mayor


REVISIONS NAME DATE		-
NAME	DATE	
	1	

ILLINOIS DEPARTMENT OF TRANSPORTATION
SIDEWALK IMPROVEMENT
PLAN
STA 40+00.00 TO STA 46+00.00

SCALE: VERT. 1"= 20' HORIZ. 1"= 20' DATE: 11 / 17 / 05

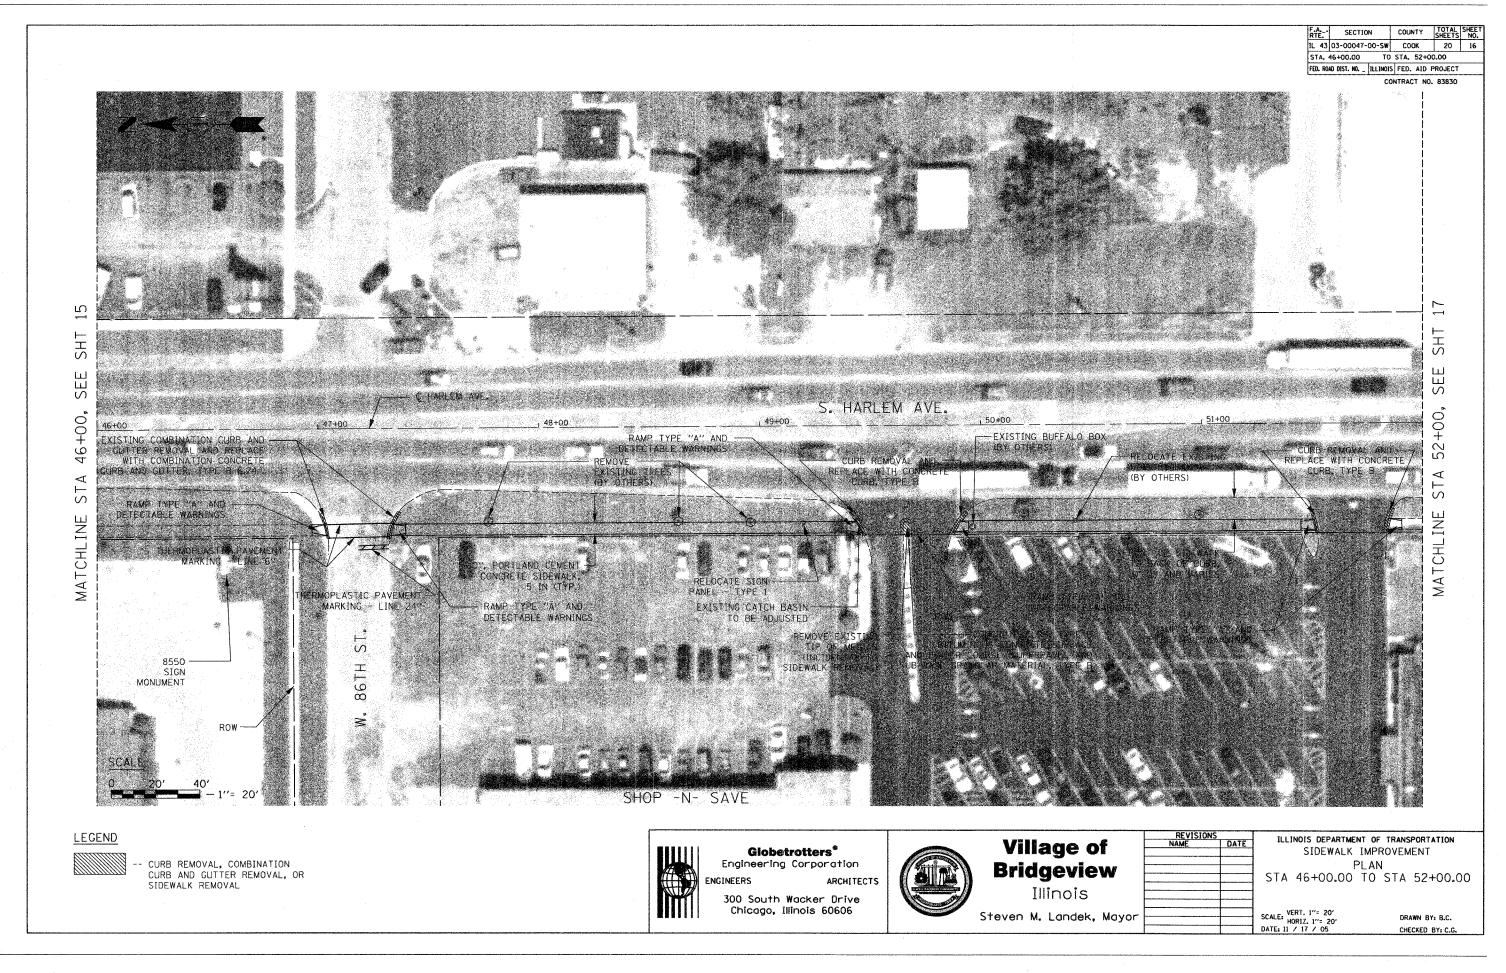

CONTRACT NO. 83830

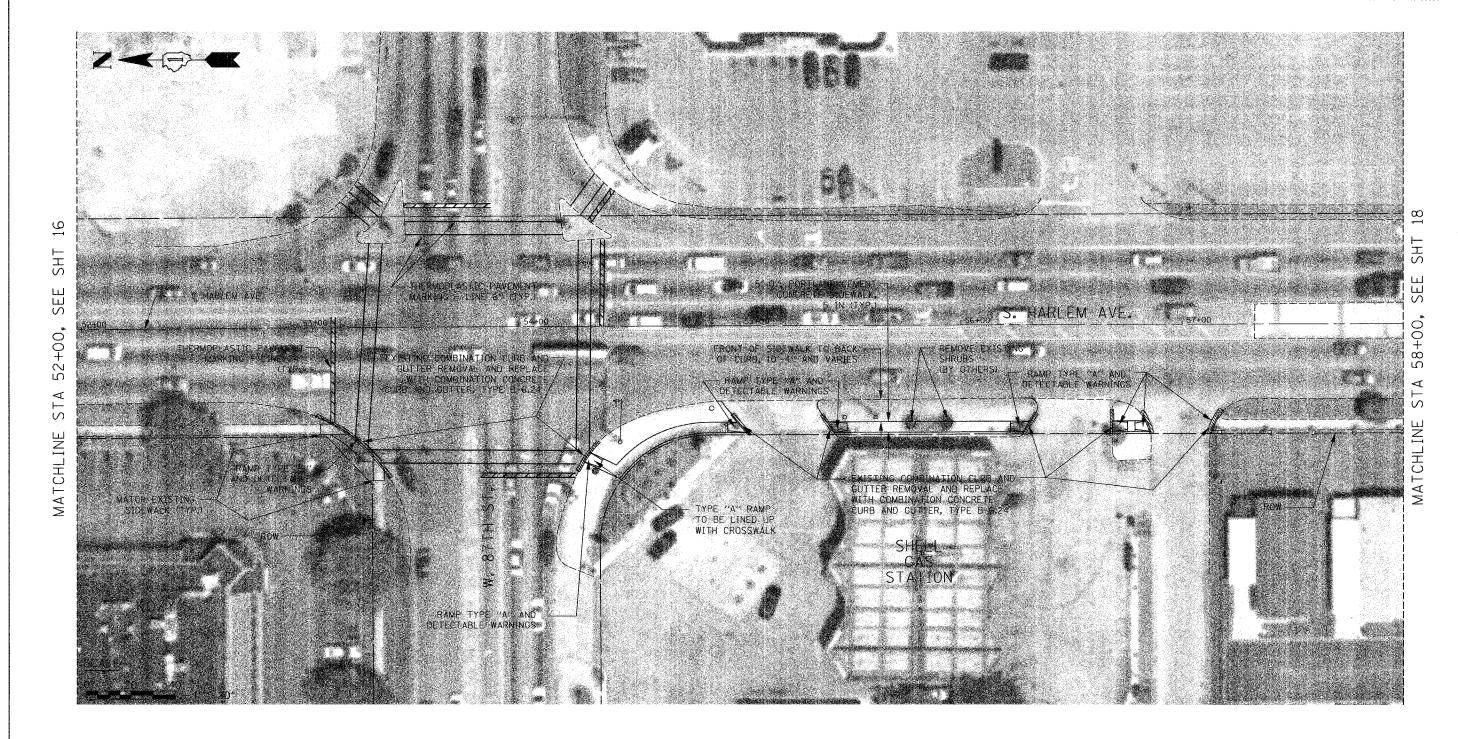

LEGEND



CURB REMOVAL, COMBINATION CURB AND GUTTER REMOVAL, OR SIDEWALK REMOVAL



Globetrotters®Engineering Corporation

Engineering Corporation
GINEERS ARCHITECTS

300 South Wacker Drive Chicago, Illinois 60606



Village of Bridgeview

Illinois

Steven M. Landek, Mayor


DEVISIONS		
REVISIONS NAME	DATE	
		١
		i i
		l
	1	

ILLINOIS DEPARTMENT OF TRANSPORTATION
SIDEWALK IMPROVEMENT
PLAN
STA 52+00.00 TO STA 58+00.00

SCALE: VERT. 1"= 20' HORIZ. 1"= 20' DATE: 11 / 17 / 05

STA. 58+00.00 TO STA. 64+00.00
FED. ROAD DIST. NO. _ ILLINOIS FED. AID PROJECT

CONTRACT NO. 83830

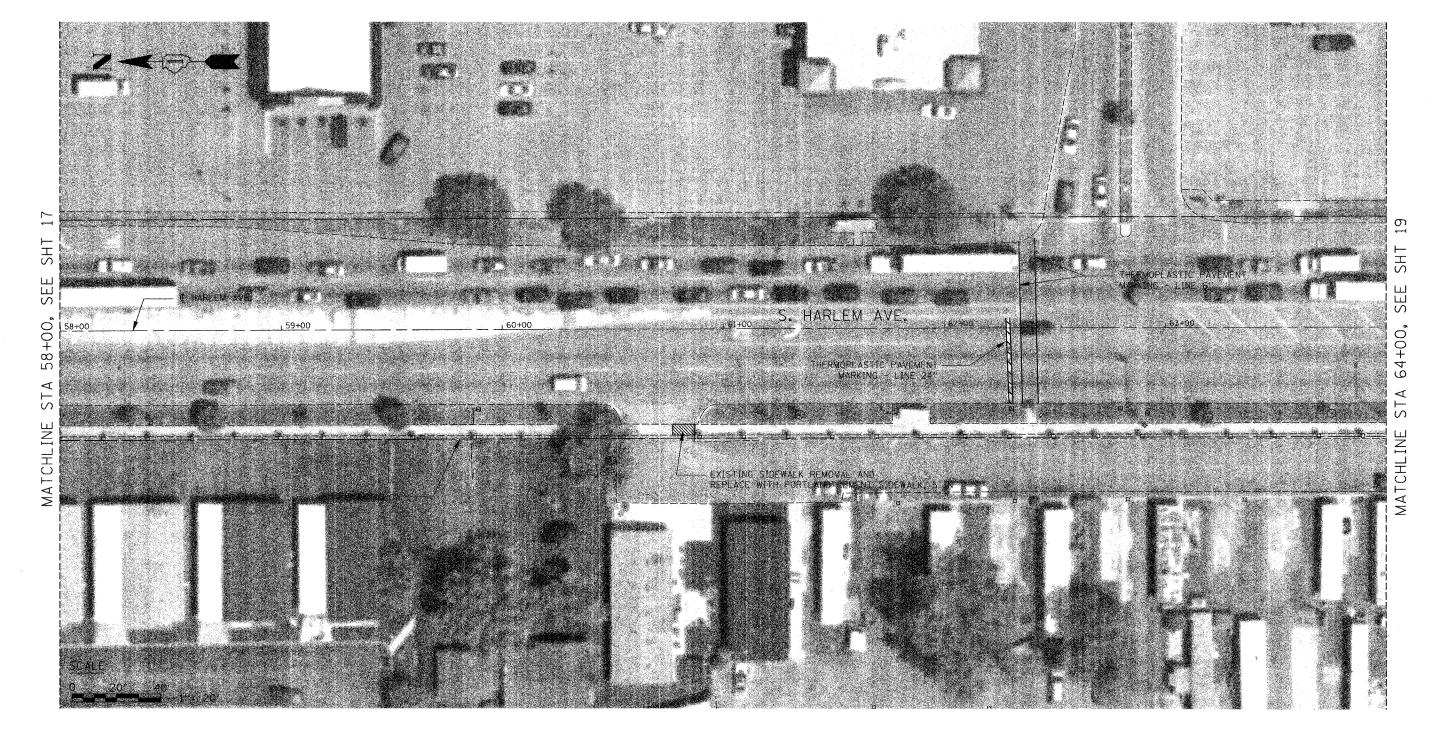

LEGEND

CURB REMOVAL, COMBINATION CURB AND GUTTER REMOVAL, OR SIDEWALK REMOVAL



Globetrotters°

Engineering Corporation ARCHITECTS

300 South Wacker Drive Chicago, Illinois 60606



Village of **Bridgeview**

Illinois

Steven M. Landek, Mayor

REVISIONS NAME DATE	
NAME	DATE

ILLINOIS DEPARTMENT OF TRANSPORTATION SIDEWALK IMPROVEMENT PLAN STA 58+00.00 TO STA 64+00.00

SCALE: VERT. 1"= 20' HORIZ. 1"= 20' DATE: 11 / 17 / 05

CONTRACT NO. 83830 HARTFORD 18 SHT SHT SEE SEE 64+00, 70+00, EXISTING WATER VALVE -TO BE ADJUSTED VBY OTHERS) RAMP TYPE 'A' AND DETECTABLE WARNINGS STA STA MATCHLINE MATCHLINE CURB REMOVAL AND REPLACE. WITH CONCRETE CURB, TYPE:

LEGEND



- CURB REMOVAL, COMBINATION CURB AND GUTTER REMOVAL, OR SIDEWALK REMOVAL



Globetrotters®Engineering Corporation

ENGINEERS ARCHITECTS

300 South Wacker Drive Chicago, Illinois 60606



Village of Bridgeview

Illinois

Steven M. Landek, Mayor


REVISIONS	,	
REVISIONS NAME	DATE	1
	1	1
	1	
		1
	+	
		ĺ
	-	l
		ı
		ء ا

ILLINOIS DEPARTMENT OF TRANSPORTATION
SIDEWALK IMPROVEMENT
PLAN
STA 64+00.00 TO STA 70+00.00

SCALE: VERT. 1"= 20' HORIZ. 1"= 20' DATE: 11 / 17 / 05

SECTION COUNTY 43 03-00047-00-SW COOK 20 20 STA. 70+00.00 TO STA. 73+55.93 FED. ROAD DIST. NO. _ ILLINOIS FED. AID PROJECT

CONTRACT NO. 83830

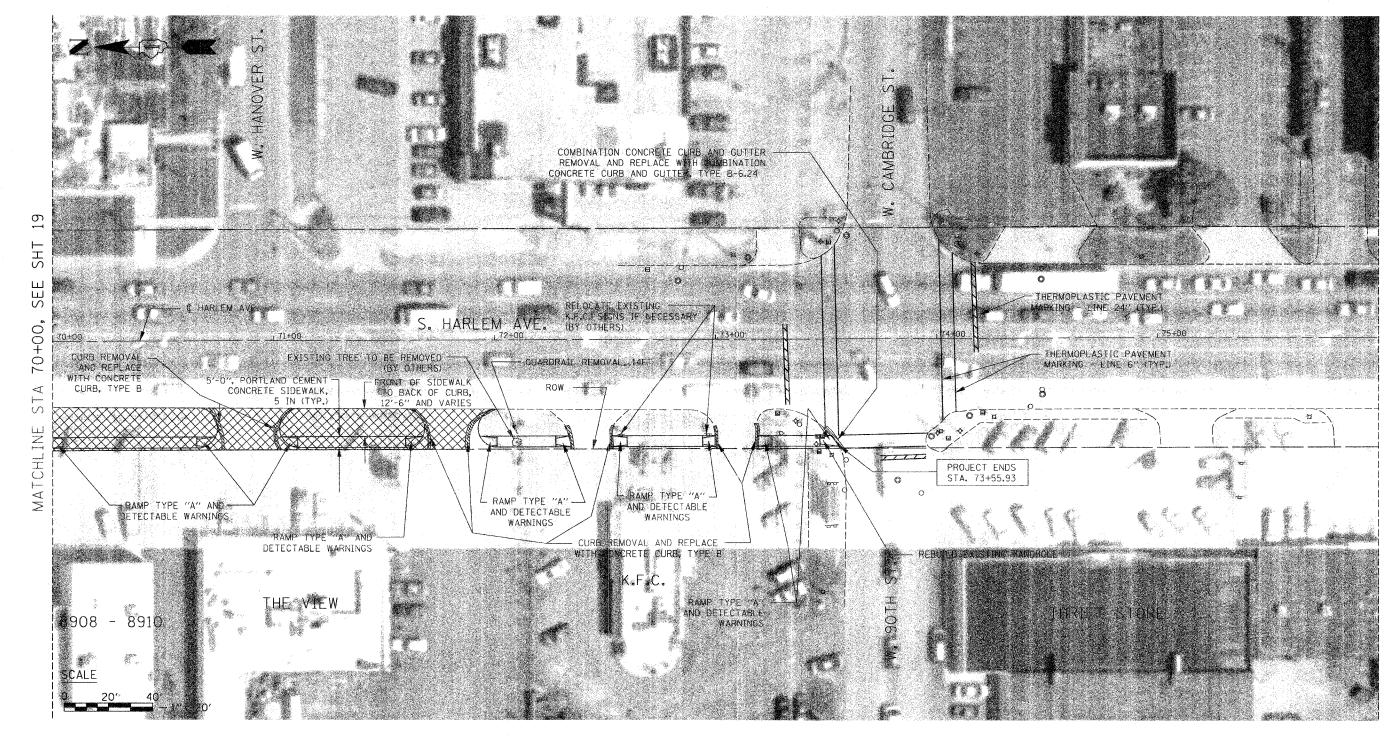

1. ALL PROPOSED DRIVEWAY CONCRETE CURB, TYPE B RADII TO BE HALF THE DISTANCE FROM BACK OF HARLEM AVE. EXISTING CURB TO BACK OF PROPOSED PORTLAND CEMENT CONCRETE SIDEWALK, 5 IN

LEGEND



PROPOSED BITUMINOUS CONCRETE PAVEMENT REMOVAL (FULL-DEPTH) (SAW CUTS INCIDENTAL)



- CURB REMOVAL, COMBINATION CURB AND GUTTER REMOVAL, OR SIDEWALK REMOVAL



Globetrotters° Engineering Corporation

ARCHITECTS

ENGINEERS

300 South Wacker Drive Chicago, Illinois 60606



Village of **Bridgeview**

Illinois

Steven M. Landek, Mayor

REVISIO	NS .	
NAME	DATE	

ILLINOIS DEPARTMENT OF TRANSPORTATION SIDEWALK IMPROVEMENT PLAN

STA 70+00.00 TO STA 73+55.93

SCALE: VERT. 1"= 20' HORIZ. 1"= 20' DATE: 11 / 17 / 05