


F.A.U. RTE.	SECTION	COUNTY	TOTAL SHEETS	SHEET NO.
5952	G-BR-1	GRUNDY	50	19
STA.		TO STA.		
FED. ROAD DIST. NO. 7		ILLINOIS	FED. AID PROJECT	

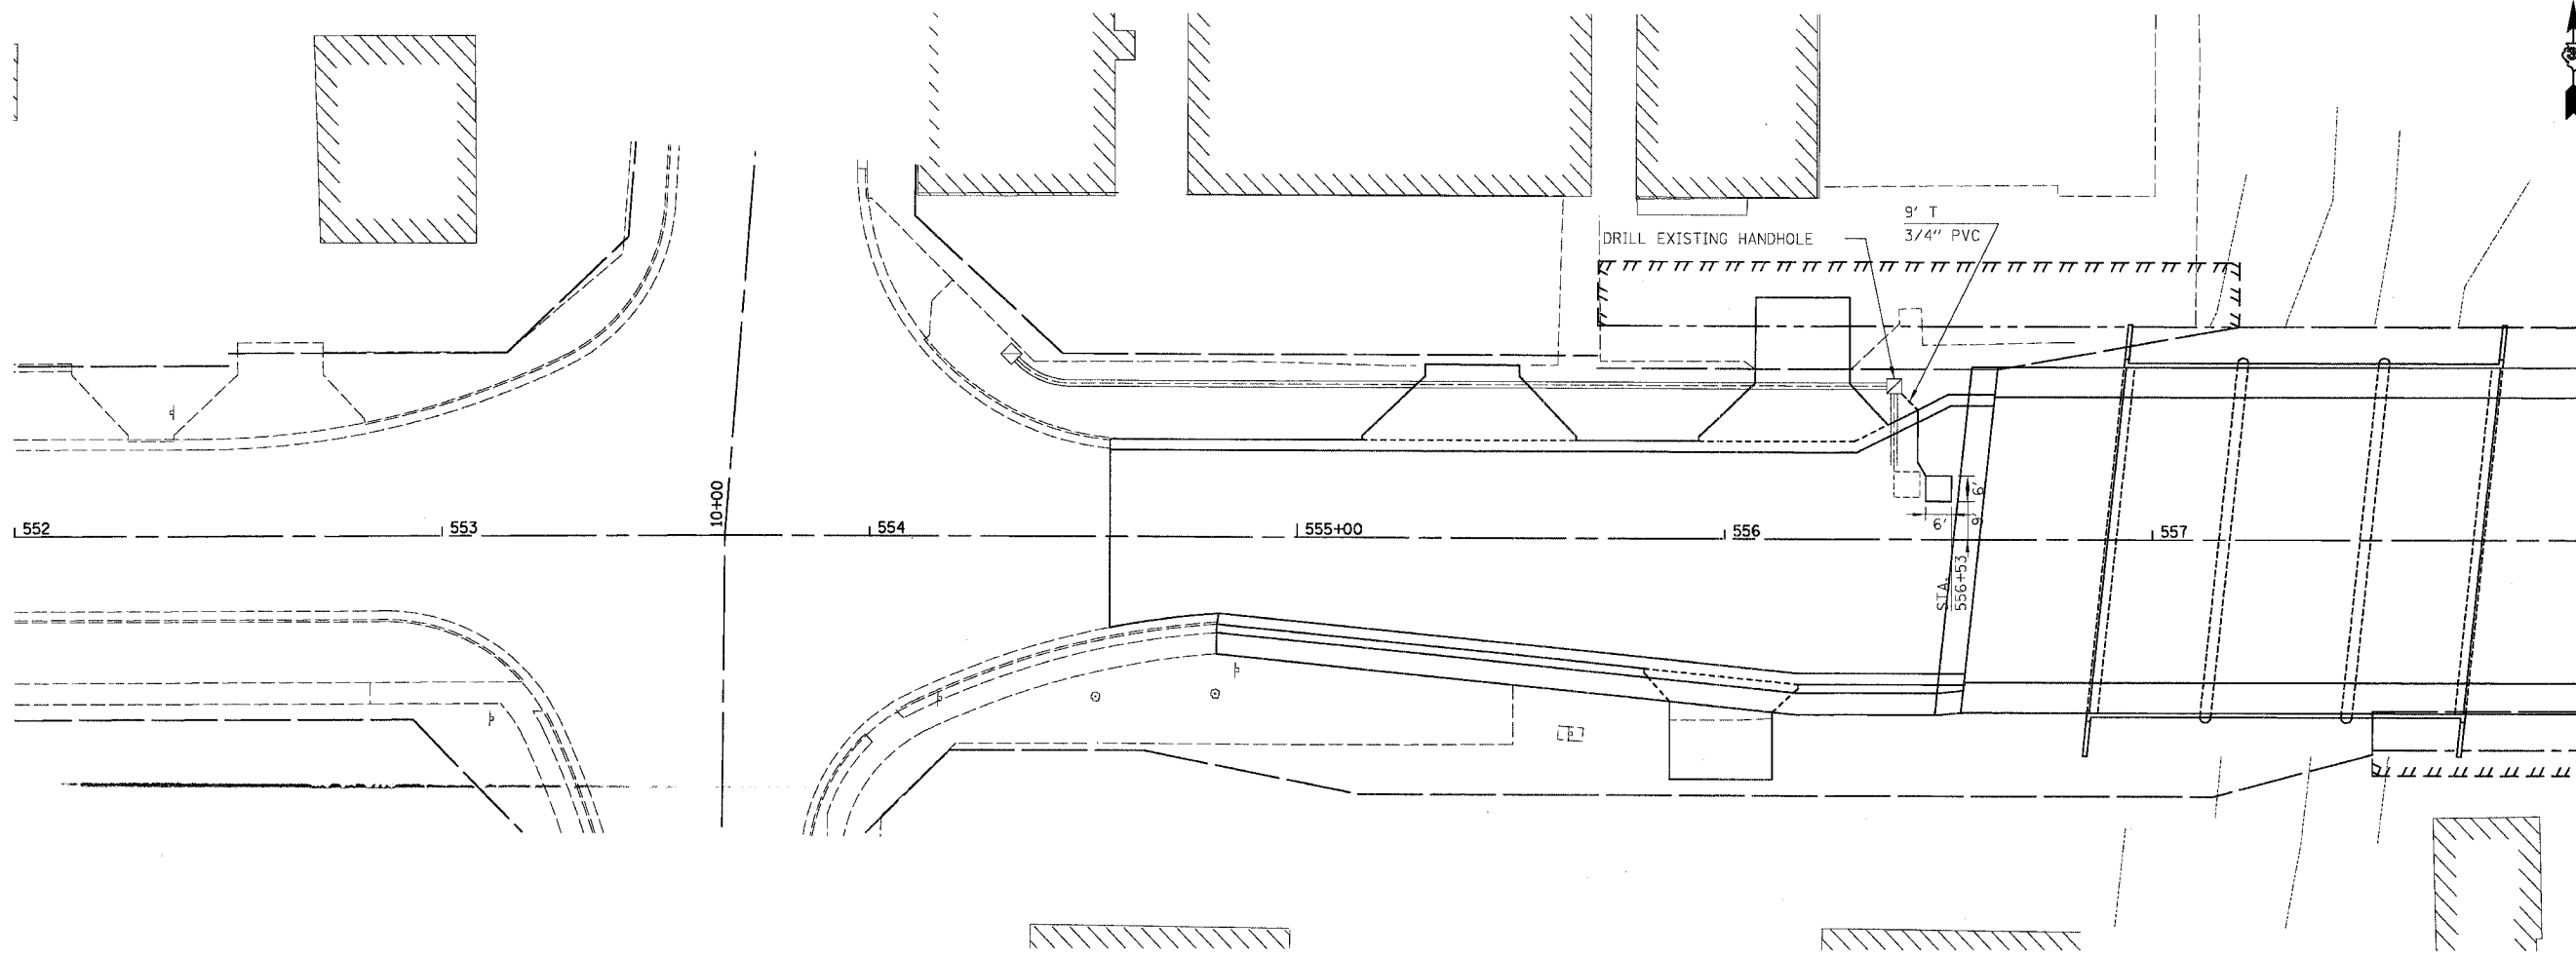

SCHEDULE OF SIGNAL QUANTITIES

- 9 FOOT CONDUIT IN TRENCH, 3/4" DIA., PVC
- 9 FOOT TRENCH AND BACKFILL FOR ELECTRICAL WORK
- 1 EACH DRILL EXISTING HANDHOLE
- 44 FOOT DETECTOR LOOP, TYPE 1
- 1 EACH MODIFY EXISTING CONTROLLER

NOTE: DISCONNECT THE EXISTING LOOP DETECTOR FROM THE EXISTING LEAD-IN WIRE AT HANDHOLE TO BE DRILLED AND CONNECT TO THE NEW LOOP DETECTORS.

MODIFY EXISTING CONTROLLER CONSISTS OF SEQUENCE OF OPERATION CHANGES AND LOOP DETECTOR INPUT CHANGES AS NOTED ON THE PLANS.

REVISIONS	
NAME	DATE

ILLINOIS DEPARTMENT OF TRANSPORTATION

U.S. ROUTE 6
SIGNAL INSTALLATION
STAGE 2A

SCALE: VERT. NTS
HORIZ. 1" = 50'
DATE 10/25/05

DRAWN BY PK
CHECKED BY JM

EJM **EJM ENGINEERING, INC**
41 South Wells Street Suite 800
Chicago, Illinois 60607

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