

F.A.P. RTE.	SECTION	COUNTY	TOTAL SHEETS	SHEET NO.
856	14-00170-42-RP	WILL	34389	1
		ILLINOIS	CONTRACT NO. 61D47	

STATE OF ILLINOIS
DEPARTMENT OF TRANSPORTATION

PLANS FOR PROPOSED
FEDERAL AID PROJECT

F.A.P. 856 (WEBER ROAD)
135TH STREET TO NORMANTOWN ROAD
WIDENING AND RECONSTRUCTION
SECTION 14-00170-42-RP
PROJECT JMYR(660)
WILL COUNTY
C-91-246-16

D-91-010-14



LOCATION OF SECTION INDICATED THUS: - [black box] -

FUNCTIONAL CLASSIFICATION
URBAN SRA
ADT = 39,200
P.V. = 97% S.U. = 3%

STATE OF ILLINOIS
AGENCY RESPONSIBLE FOR LETTING
DEPARTMENT OF TRANSPORTATION

APPROVED: NOVEMBER 22ND, 2016
[Signature]
DIRECTOR OF TRANSPORTATION, COUNTY ENGINEER, WILL COUNTY

PASSED: MAY 16, 2017
[Signature]
DISTRICT 1 ENGINEER OF LOCAL ROADS & STREETS

RELEASING FOR BID BASED ON LIMITED REVIEW: MAY 24, 2017
[Signature]
REGIONAL ENGINEER

PRINTED BY THE AUTHORITY
OF THE STATE OF ILLINOIS

thomas
engineering group
service of the highest grade

thomas engineering group, llc
55 w. 22nd street
suite 300
lombard, il 60148
phone: 855-533-1700

PROGRAM AND OFFICE ENGINEER: CHARLES F. RIDDLE, P.E. (847) 705-4406 SCHAUMBURG, IL


FOR INDEX OF SHEETS AND LISTING OF
HIGHWAY STANDARDS, SEE SHEET NO. 2

IMPROVEMENTS LOCATED IN THE
VILLAGE OF ROMEOVILLE

WEBER ROAD (CH 88)
URBAN SRA
EXISTING ADT (2010) 36,300 TO 39,200
PROPOSED ADT (2040) 50,000 TO 57,000
DESIGN SPEED = 45 MPH
POSTED SPEED = 45 MPH


135TH STREET/ROMEO ROAD
MINOR ARTERIAL/LOCAL
EXISTING ADT (2010) 5,000 TO 12,900
PROPOSED ADT (2040) 7,200 TO 17,000
DESIGN SPEED = 35 MPH
POSTED SPEED = 30 MPH

GRAND BOULEVARD/N. CARILLON DRIVE
LOCAL
EXISTING ADT (2010) 3,000 TO 4,300
PROPOSED ADT (2040) 5,500 TO 7,900
DESIGN SPEED = 35 MPH
POSTED SPEED = 30 MPH

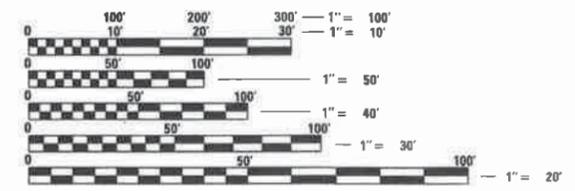

FULL SIZE PLANS HAVE BEEN PREPARED USING STANDARD
ENGINEERING SCALES. REDUCED SIZED PLANS WILL NOT
CONFORM TO STANDARD SCALES. IN MAKING MEASUREMENTS
ON REDUCED PLANS, THE ABOVE SCALES MAY BE USED.

J.U.L.I.E.
JOINT UTILITY LOCATION INFORMATION FOR EXCAVATION
1-800-892-0123
OR 811

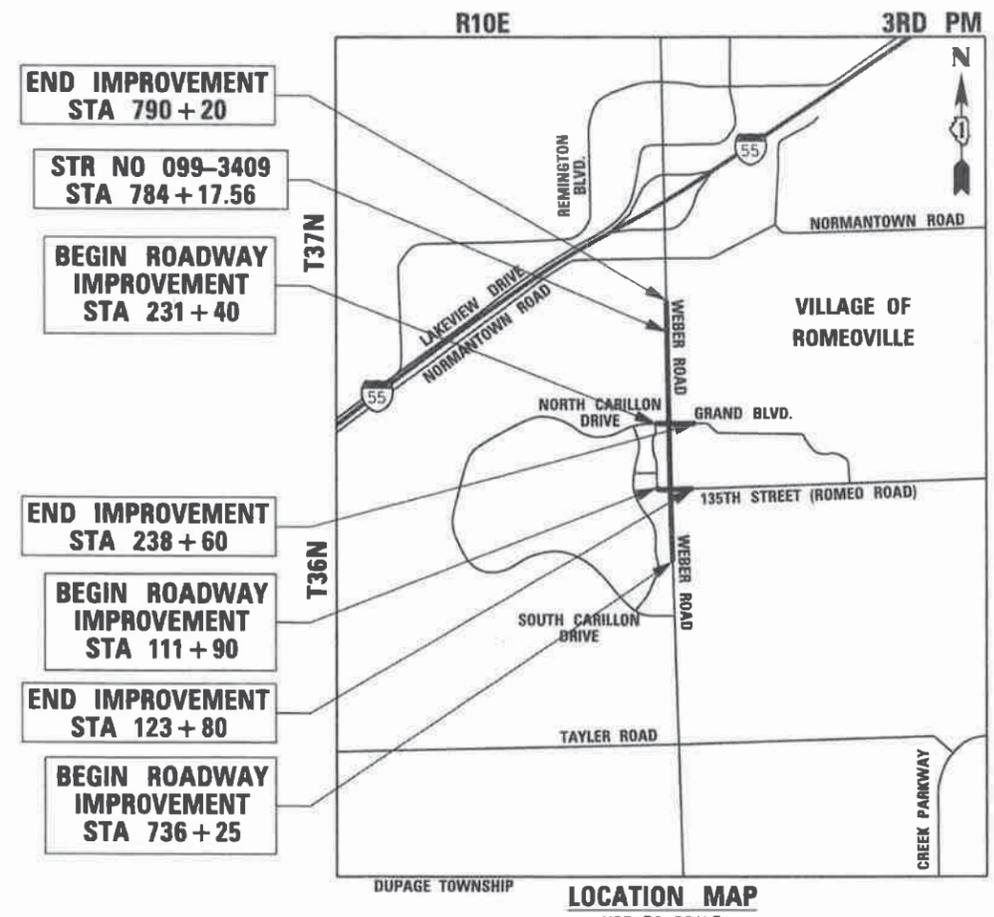

LOCATION MAP
NOT TO SCALE

GROSS LENGTH = 8,153 FT. = 1.544 MILE
NET LENGTH = 8,153 FT. = 1.544 MILE

CONTRACT NO. 61D47

	<p>THOMAS ENGINEERING GROUP DATE: <u>NOVEMBER 20, 2016</u> [Signature] CURTIS R. CORNWELL EXPIRES: <u>11/30/19</u> SHEET NO.: <u>1-122, 133-200, 253-255, 260-394</u></p>
	<p>MILLENNIA PROFESSIONAL SERVICES DATE: <u>11/20/2016</u> [Signature] THOMAS V. NGO EXPIRES: <u>11/30/19</u> SHEET NO.: <u>123-132, 201-228</u></p>
	<p>AMES ENGINEERING, INC DATE: <u>NOVEMBER 20, 2016</u> [Signature] BRENDA D. LONERT EXPIRES: <u>11/30/19</u> SHEET NO.: <u>229-241</u></p>

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**STATE OF ILLINOIS
DEPARTMENT OF TRANSPORTATION**

INDEX OF SHEETS


SCALE: NTS SHEET 1 OF 1 SHEETS STA. TO STA.

F.A.P. RTE.	SECTION	COUNTY	TOTAL SHEETS	SHEET NO.
856	14-00170-42-RP	WILL	394	2
				CONTRACT NO. 61D47
ILLINOIS FED. AID PROJECT				

GENERAL NOTES

1. BEFORE STARTING ANY EXCAVATION, THE CONTRACTOR SHALL CALL "J.U.L.I.E." AT 800-892-0123 OR 811 FOR FIELD LOCATIONS, BURIED ELECTRIC LINES, TELEPHONE AND GAS FACILITIES. (48 HOUR NOTIFICATION IS REQUIRED)
2. THE CONTRACTOR SHALL COORDINATE CONSTRUCTION ACTIVITIES WITH UTILITY COMPANIES, THE VILLAGE OF ROMEOVILLE, AND WILL COUNTY DIVISION OF TRANSPORTATION (WCDOT).
3. THE CONTRACTOR WILL NOT BE ALLOWED TO SET UP A YARD OF FIELD OFFICE ON WCDOT PROPERTY WITHOUT WRITTEN PERMISSION FROM WCDOT.
4. THE CONTRACTOR SHOULD BE AWARE THAT CONTRACT 60X10 IS DIRECTLY ADJACENT TO THE NORTH OF THIS CONTRACT AND WILL START SIMULTANEOUSLY TO THIS PROJECT. THE CONTRACTOR SHALL COORDINATE ALL CONSTRUCTION ACTIVITIES WITH ADJACENT CONTRACT.
5. THE LOCATIONS OF EXISTING UTILITIES SHOWN ON THE PLANS ARE BASED ON THE SUBSURFACE UTILITY ENGINEERING (SUE) AND THE BEST INFORMATION AVAILABLE, BUT THEY ARE NOT GUARANTEED. IT SHALL BE THE CONTRACTOR'S RESPONSIBILITY TO ASCERTAIN THEIR EXACT LOCATIONS FROM THE UTILITY COMPANIES AND BY FIELD INSPECTION.
6. THE CONTRACTOR SHALL TAKE CARE IN REMOVING OR EXCAVATING NEAR ALL EXISTING ITEMS WHICH WILL REMAIN INCLUDING, BUT NOT LIMITED TO, TREES WHICH ARE NOT MARKED FOR REMOVAL SO AS NOT TO CAUSE INJURY TO THE ROOT SYSTEM OR TRUNKS. MAJOR ROOTS OF A TREE THAT ARE TO REMAIN IN PLACE EXTENDING INTO THE EXCAVATION AREAS AT AN ELEVATION THAT WOULD INTERFERE WITH ANY PORTION OF THE PLANNED CONSTRUCTION SHALL BE SEVERED AT A POINT IMMEDIATELY OUTSIDE OF THE EXCAVATION AREA IN A MANNER THAT WILL CAUSE THE LEAST AMOUNT OF SYSTEM DAMAGE TO THE REMAINING TREE STRUCTURE. ANY DAMAGE DONE TO EXISTING ITEMS BY THE CONTRACTOR SHALL BE REPAIRED BY THE CONTRACTOR AT THE CONTRACTOR'S OWN EXPENSE.
7. ALL REFERENCES IN THE HIGHWAY STANDARDS AND THE STANDARD SPECIFICATIONS FOR REINFORCEMENT, DOWEL BARS AND TIE BARS IN PAVEMENT, SHOULDERS, CURB, GUTTER, COMBINATION CURB AND GUTTER AND MEDIAN, AND CHAIR SUPPORTS FOR JPCP PAVEMENT, SHALL BE EPOXY COATED, UNLESS NOTED ON THE PLAN.
8. FOR STORM SEWER CONSTRUCTED UNDER THE ROADWAY, BACKFILLING METHODS TWO AND THREE SPECIFIED UNDER THE PROVISIONS OF ARTICLE 550.07 OF THE STANDARD SPECIFICATIONS WILL NOT BE ALLOWED.
9. NO WORK SHALL COMMENCE UNTIL TRAFFIC CONTROL REQUIREMENTS ARE MET.
10. DURING CONSTRUCTION OPERATIONS, WHENEVER LOOSE MATERIAL IS DEPOSITED IN THE FLOW LINE OF GUTTER, DRAINAGE STRUCTURES, DITCHES, ETC., SUCH THAT THE NATURAL FLOW LINE OF WATER IS OBSTRUCTED, THE LOOSE MATERIAL SHALL BE REMOVED AT THE CLOSE OF EACH WORKING DAY. AT THE CONCLUSION OF THE CONSTRUCTION OPERATIONS, ALL DRAINAGE STRUCTURES AND FLOW LINES SHALL BE FREE FROM DIRT AND DEBRIS. THE CONTRACTOR'S FAILURE TO PROVIDE THE ABOVE WILL PRECLUDE ANY POSSIBLE ADDED COMPENSATION REQUESTED DUE TO DELAYS OR UNSUITABLE MATERIAL CREATED AS A RESULT THERE OF.
11. ITEMS OCCUPYING NEWLY ACQUIRED PARCELS SHALL BE CLEARED BY OTHERS EXCEPT FOR THE COMPENSATORY STORAGE SITE. THESE ITEMS ARE NOT SHOWN ON THE PLANS. THE CONTRACTOR IS TO CONFIRM WITH THE ENGINEER THAT THIS WORK HAS BEEN COMPLETED PRIOR TO STARTING ANY OPERATION ON THE NEWLY ACQUIRED PARCEL.
12. PRESERVATION OF EXISTING TREES IS OF UTMOST IMPORTANCE TO THE VILLAGE OF ROMEOVILLE. ALL TREE PROTECTION, TREE REMOVAL, PRUNING AND ROOT PRUNING SHALL BE COMPLETED BEFORE CONSTRUCTION OPERATIONS COMMENCE IN ALL AREAS. AT NO TIME SHALL THE CONTRACTOR PRUNE OR REMOVE TREES UNLESS SPECIFICALLY DIRECTED BY THE ENGINEER.
13. THE CONTRACTOR SHALL ERECT A TEMPORARY FENCE AROUND ALL TREES WITHIN THE CONSTRUCTION AREA TO ESTABLISH A TREE PROTECTION ZONE AND AROUND EXISTING WETLANDS TO ESTABLISH A WETLAND PROTECTION ZONE BEFORE ANY WORK BEGINS OR ANY MATERIAL IS DELIVERED TO THE JOB SITE. NO WORK IS TO BE PERFORMED WITHIN THE TREE PROTECTION ZONE AND WETLAND PROTECTION ZONE. REMOVE PROTECTIVE TEMPORARY FENCE ONLY AFTER ALL CONSTRUCTION WORK HAS BEEN COMPLETED.
14. THIS PROJECT REQUIRES A US ARMY CORPS OF ENGINEERS 404 PERMIT. THE PERMIT ISSUED TO THE COUNTY DOES NOT COVER THE IN STREAM WORK BY THE CONTRACTOR. THEREFORE AFTER AWARD, THE CONTRACTOR WILL NEED TO SUBMIT THE WORK PLAN TO THE US ARMY CORPS OF ENGINEERS. THE CORPS WILL NOT BE PROVIDING AN APPROVAL UNLESS STATED OTHERWISE IN THE PERMIT AND IN STREAM WORK CAN COMMENCE AT THE CONTRACTOR'S DISCRETION. GUIDELINES ON ACCEPTABLE IN STREAM WORK TECHNIQUES CAN BE FOUND ON THE CORPS WEBSITE: [HTTP://WWW.LRC.USACE.ARMY.MIL/](http://www.lrc.usace.army.mil/)
15. STATE 401 WATER QUALITY CERTIFICATION - WATER QUALITY CERTIFICATION UNDER SECTION 401 OF THE CLEAN WATER ACT IS REQUIRED FROM THE ILLINOIS ENVIRONMENTAL PROTECTION AGENCY (IEPA). THE DISTRICT MAY CONSIDER WATER QUALITY, AMONG OTHER FACTORS, IN DETERMINING WHETHER TO EXERCISE DISCRETIONARY AUTHORITY AND REQUIRE AN INDIVIDUAL PERMIT. PLEASE NOTE THAT SECTION 401 WATER QUALITY CERTIFICATION IS A REQUIREMENT FOR PROJECTS ISSUED UNDER SECTION 404 OF THE CLEAN WATER ACT. PROJECTS ISSUED UNDER SECTION 10 OF THE RIVERS AND HARBORS ACT OF 1899 DO NOT REQUIRE SECTION 401 WATER QUALITY CERTIFICATION.
16. THE CONTRACTOR SHALL CONTRACT THE IDOT ARTERIAL TRAFFIC CONTROL SUPERVISOR AT 847-705-4470 A MINIMUM OF 72 HOURS IN ADVANCE OF BEGINNING WORK.
17. THE CONTRACTOR SHALL COORDINATE WITH LOCAL AUTHORITIES AND OBSERVE LOCAL NOISE ORDINANCES FOR ALL CONSTRUCTION ACTIVITIES.
18. CONTRACTOR IS TO REFER TO CONTRACTOR DESIGNED GROUND IMPROVEMENT SHEETS FOR THE REQUIRED SOIL IMPROVEMENT MEASURES REQUIRED FROM STA 780+00 TO STA 792+20.
19. CONTRACTOR IS TO REFER TO PROPOSED UTILITY RELOCATION PLANS (BY OTHERS) WHILE DESIGNING CONTRACTOR DESIGNED GROUND IMPROVEMENT. CONTRACTOR SHALL CONSIDER AND VERIFY RELOCATED UTILITIES FOR THE COLUMN SPACING REQUIREMENTS FROM STA 781+00 TO STA 790+20.

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PLOT DATE = 11/14/2017	DATE - 11/15/17	REVISED -

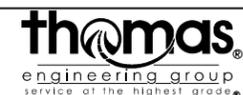**STATE OF ILLINOIS
DEPARTMENT OF TRANSPORTATION**

GENERAL NOTES

SCALE: NTS SHEET 1 OF 1 SHEETS STA. TO STA.

F.A.P. RTE.	SECTION	COUNTY	TOTAL SHEETS	SHEET NO.
856	14-00170-42-RP	WILL	394	4
CONTRACT NO. 61D47				
ILLINOIS FED. AID PROJECT				

SUMMARY OF QUANTITIES

SI	CODE NO.	ITEM DESCRIPTION	UNIT	TOTAL QUANTITY	ROADWAY	ROADWAY	TRAFFIC SIGNALS	TRAFFIC SIGNALS	INTER CONNECT	EMERGENCY	EMERGENCY	SIDEWALK	SHARED USE PATH	LANDSCAPING	BOX CULVERT	NOISE BARRIER	TRAINEES
					0003	LIGHTING	(135th/WEBER)	(GRAND/WEBER)	0021	VEHICLE	VEHICLE	0021	0028	0031	SN 099-3409	WALL	0042
					80/20%	80/20%	100%	100%	100%	80/20%	80/20%	80/20%	80/20%	100%	100%	100%	80/20%
					WILL COUNTY	ROMEDEVILLE STP	WILL COUNTY	WILL COUNTY	WILL COUNTY	ROMEDEVILLE STP	ROMEDEVILLE STP	ROMEDEVILLE STP	ROMEDEVILLE STP	WILL COUNTY	WILL COUNTY	WILL COUNTY	STP
X	20100110	TREE REMOVAL (6 TO 15 UNITS DIAMETER)	UNIT	1,382	1,382												
X	20100210	TREE REMOVAL (OVER 15 UNITS DIAMETER)	UNIT	36	36												
	20101000	TEMPORARY FENCE	FOOT	2,514	2,514												
	20101100	TREE TRUNK PROTECTION	EACH	120	120												
X	20101200	TREE ROOT PRUNING	EACH	120	120												
X	20101300	TREE PRUNING (1 TO 10 INCH DIAMETER)	EACH	40	40												
X	20101350	TREE PRUNING (OVER 10 INCH DIAMETER)	EACH	80	80												
	20200100	EARTH EXCAVATION	CU YD	46,698	46,698												
	20201200	REMOVAL AND DISPOSAL OF UNSUITABLE MATERIAL	CU YD	16,026	16,026												
	20400800	FURNISHED EXCAVATION	CU YD	25,845	25,845												
	20800150	TRENCH BACKFILL	CU YD	1,850	1,850												
	21001000	GEO TECHNICAL FABRIC FOR GROUND STABILIZATION	SQ YD	950	950												
	21101505	TOPSOIL EXCAVATION AND PLACEMENT	CU YD	12,784	12,784												
X	25000210	SEEDING, CLASS 2A	ACRE	5.06										5.06			
X	25000310	SEEDING, CLASS 4	ACRE	4.89										4.89			
X	25000314	SEEDING, CLASS 4B	ACRE	1.84										1.84			
X	25000400	NITROGEN FERTILIZER NUTRIENT	POUND	607										607			
X	25000600	POTASSIUM FERTILIZER NUTRIENT	POUND	607										607			
X	25100115	MULCH, METHOD 2	ACRE	5.70	5.70												
X	25200110	SODDING, SALT TOLERANT	SQ YD	12,098										12,098			
	28000250	TEMPORARY EROSION CONTROL SEEDING	POUND	1,865	1,865												
	28000305	TEMPORARY DITCH CHECKS	FOOT	836	836												
	28000400	PERIMETER EROSION BARRIER	FOOT	11,403	11,403												
	28000510	INLET FILTERS	EACH	102	102												
	28001100	TEMPORARY EROSION CONTROL BLANKET	SQ YD	82,557	82,557												
	28100105	STONE RIPRAP, CLASS A3	SQ YD	839	839												
	28100107	STONE RIPRAP, CLASS A4	SQ YD	267	197										70		
	28100111	STONE RIPRAP, CLASS A6	SQ YD	179	179												
	28200200	FILTER FABRIC	SQ YD	1,285	1,215										70		
	30300001	AGGREGATE SUBGRADE IMPROVEMENT	CU YD	691	691												
	30300112	AGGREGATE SUBGRADE IMPROVEMENT 12"	SQ YD	69,458	69,458												
	31101200	SUBBASE GRANULAR MATERIAL, TYPE B 4"	SQ YD	42,843	39,283							3,560					

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SI - SPECIALTY ITEM



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**STATE OF ILLINOIS
DEPARTMENT OF TRANSPORTATION**

SUMMARY OF QUANTITIES

SCALE: NTS SHEET 1 OF 11 SHEETS STA. TO STA.

F.A.P. RTE.	SECTION	COUNTY	TOTAL SHEETS	SHEET NO.
856	14-00170-42-RP	WILL	394	5
CONTRACT NO. 61D47			ILLINOIS FED. AID PROJECT	

SUMMARY OF QUANTITIES

SI	CODE NO.	ITEM DESCRIPTION	UNIT	TOTAL QUANTITY	ROADWAY	ROADWAY	TRAFFIC SIGNALS	TRAFFIC SIGNALS	INTER CONNECT	EMERGENCY	EMERGENCY	SIDEWALK	SHARED USE PATH	LANDSCAPING	BOX CULVERT	NOISE BARRIER	TRAINEES
					0003	0021	(135th/WEBER)	(GRAND/WEBER)	0021	0021	0021	0021	0021	0021	0021	0021	0021
					80/20% WILL COUNTY	80/20% ROMEDEVILLE STP	100% WILL COUNTY	100% WILL COUNTY	100% WILL COUNTY	80/20% ROMEDEVILLE STP	80/20% ROMEDEVILLE STP	80/20% ROMEDEVILLE STP	80/20% ROMEDEVILLE STP	100% WILL COUNTY	100% WILL COUNTY	100% WILL COUNTY	80/20% STP
	35101800	AGGREGATE BASE COURSE, TYPE B 6"	SQ YD	3,454	322								3,132				
	35501305	HOT-MIX ASPHALT BASE COURSE, 5 1/4"	SQ YD	2,816	2,816												
	35501316	HOT-MIX ASPHALT BASE COURSE, 8"	SQ YD	608	608												
	35501317	HOT-MIX ASPHALT BASE COURSE, 8 1/4"	SQ YD	4,484	4,484												
	40600290	BITUMINOUS MATERIALS (TACK COAT)	POUND	219	219												
	40600982	HOT-MIX ASPHALT SURFACE REMOVAL - BUTT JOINT	SQ YD	166	166												
	40600990	TEMPORARY RAMP	SQ YD	748	748												
	40603335	HOT-MIX ASPHALT SURFACE COURSE, MIX "D", N50	TON	598	69								529				
	40603340	HOT-MIX ASPHALT SURFACE COURSE, MIX "D", N70	TON	989	989												
	40700100	BITUMINOUS MATERIALS (TACK COAT)	POUND	4,665	4,665												
	42000501	PORTLAND CEMENT CONCRETE PAVEMENT 10" (JOINTED)	SQ YD	53,538	53,538												
	42001300	PROTECTIVE COAT	SQ YD	66,520	63,105							3,415					
	42300400	PORTLAND CEMENT CONCRETE DRIVEWAY PAVEMENT, 8 INCH	SQ YD	451	451												
	42400200	PORTLAND CEMENT CONCRETE SIDEWALK 5 INCH	SQ FT	30,708								30,708					
	42400410	PORTLAND CEMENT CONCRETE SIDEWALK 8 INCH	SQ FT	1,257								1,257					
	42400800	DETECTABLE WARNINGS	SQ FT	434								237	197				
	44000100	PAVEMENT REMOVAL	SQ YD	86,893	86,893												
	44000157	HOT-MIX ASPHALT SURFACE REMOVAL, 2"	SQ YD	1,348	1,348												
	44000200	DRIVEWAY PAVEMENT REMOVAL	SQ YD	2,081	2,081												
	44000500	COMBINATION CURB AND GUTTER REMOVAL	FOOT	18,538	18,538												
	44000600	SIDEWALK REMOVAL	SQ FT	16,191	16,191												
	44003100	MEDIAN REMOVAL	SQ FT	8,305	8,305												
	44201807	CLASS D PATCHES, TYPE III, 13 INCH	SQ YD	826	826												
	50100100	REMOVAL OF EXISTING STRUCTURES	EACH	1	1												
	50104400	CONCRETE HEADWALL REMOVAL	EACH	1	1												
	50105220	PIPE CULVERT REMOVAL	FOOT	218	218												
	50200100	STRUCTURE EXCAVATION	CU YD	215	215												
	50200450	REMOVAL AND DISPOSAL OF UNSUITABLE MATERIAL FOR STRUCTURES	CU YD	125											125		
	50800105	REINFORCEMENT BARS	POUND	2,210	2,210												
	50800205	REINFORCEMENT BARS, EPOXY COATED	POUND	48,630	2,310										46,320		
	50800515	BAR SPLICERS	EACH	107											107		
X	50901720	BICYCLE RAILING	FOOT	115								115					
	51500100	NAME PLATES	EACH	1											1		

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					0003	LIGHTING	(135th/WEBER)	(GRAND/WEBER)	0021	VEHICLE	VEHICLE	0021	0021	0021	0021	0021	0028
					80/20%	80/20%	100%	100%	100%	80/20%	80/20%	80/20%	80/20%	100%	100%	100%	80/20%
					WILL COUNTY	ROMEDEVILLE STP	WILL COUNTY	WILL COUNTY	WILL COUNTY	ROMEDEVILLE STP	ROMEDEVILLE STP	ROMEDEVILLE STP	ROMEDEVILLE STP	WILL COUNTY	WILL COUNTY	WILL COUNTY	STP
X	56105300	WATER VALVES 16"	EACH	1	1												
X	56400300	FIRE HYDRANTS TO BE ADJUSTED	EACH	1	1												
X	56400500	FIRE HYDRANTS TO BE REMOVED	EACH	5	5												
X	56400825	FIRE HYDRANT WITH AUXILIARY VALVE, VALVE BOX AND TEE	EACH	4	4												
	59100100	GEOCOMPOSITE WALL DRAIN	SQ YD	46	46												
	60108206	PIPE UNDERDRAINS, TYPE 2, 6"	FOOT	2,693	2,693												
	60200105	CATCH BASINS, TYPE A, 4'-DIAMETER, TYPE 1 FRAME, OPEN LID	EACH	2	2												
	60200805	CATCH BASINS, TYPE A, 4'-DIAMETER, TYPE 8 GRATE	EACH	2	2												
	60201105	CATCH BASINS, TYPE A, 4'-DIAMETER, TYPE 11 FRAME AND GRATE	EACH	1	1												
	60201110	CATCH BASINS, TYPE A, 4'-DIAMETER, TYPE 11V FRAME AND GRATE	EACH	4	4												
	60201330	CATCH BASINS, TYPE A, 4'-DIAMETER, TYPE 23 FRAME AND GRATE	EACH	2	2												
	60201340	CATCH BASINS, TYPE A, 4'-DIAMETER, TYPE 24 FRAME AND GRATE	EACH	40	40												
	60219540	MANHOLES, TYPE A, 4'-DIAMETER, TYPE 24 FRAME AND GRATE	EACH	8	8												
	60221100	MANHOLES, TYPE A, 5'-DIAMETER, TYPE 1 FRAME, CLOSED LID	EACH	1	1												
	60222000	MANHOLES, TYPE A, 5'-DIAMETER, TYPE 11 FRAME AND GRATE	EACH	3	3												
	60222240	MANHOLES, TYPE A, 5'-DIAMETER, TYPE 24 FRAME AND GRATE	EACH	26	26												
	60224005	MANHOLES, TYPE A, 6'-DIAMETER, TYPE 8 GRATE	EACH	1	1												
	60224039	MANHOLES, TYPE A, 6'-DIAMETER, TYPE 24 FRAME AND GRATE	EACH	9	9												
	60224446	MANHOLES, TYPE A, 7'-DIAMETER, TYPE 1 FRAME, CLOSED LID	EACH	2	2												
	60224448	MANHOLES, TYPE A, 7'-DIAMETER, TYPE 8 GRATE	EACH	2	2												
	60224469	MANHOLES, TYPE A, 9'-DIAMETER, TYPE 1 FRAME, CLOSED LID	EACH	1	1												
	60224476	MANHOLES, TYPE A, 9'-DIAMETER, TYPE 24 FRAME AND GRATE	EACH	1	1												
	60236200	INLETS, TYPE A, TYPE 8 GRATE	EACH	2	2												
	60236800	INLETS, TYPE A, TYPE 11 FRAME AND GRATE	EACH	2	2												
	60236825	INLETS, TYPE A, TYPE 11V FRAME AND GRATE	EACH	1	1												
	60237460	INLETS, TYPE A, TYPE 23 FRAME AND GRATE	EACH	3	3												
	60237470	INLETS, TYPE A, TYPE 24 FRAME AND GRATE	EACH	50	50												
	60248900	VALVE VAULTS, TYPE A, 5'-DIAMETER, TYPE 1 FRAME, CLOSED LID	EACH	5	5												
	60255500	MANHOLES TO BE ADJUSTED	EACH	2	2												
	60265700	VALVE VAULTS TO BE ADJUSTED	EACH	2	2												
	60600605	CONCRETE CURB, TYPE B	FOOT	586	586												
	60603800	COMBINATION CONCRETE CURB AND GUTTER, TYPE B-6.12	FOOT	2,813	2,813												
	60604400	COMBINATION CONCRETE CURB AND GUTTER, TYPE B-6.18	FOOT	1,235	1,235												

SI - SPECIALTY ITEM

FILE NAME = D:\68211-141-500.dgn



USER NAME = TEG
 PLOT SCALE = 2.0000' / 1in.
 PLOT DATE = 12/29/2017

DESIGNED - CRC
 DRAWN - BLP
 CHECKED - EER
 DATE - 11/15/17

REVISED - 3/3/2015
 REVISED - 6/19/2015
 REVISED - 9/21/2016
 REVISED -

**STATE OF ILLINOIS
 DEPARTMENT OF TRANSPORTATION**

SUMMARY OF QUANTITIES

SCALE: NTS SHEET 4 OF 11 SHEETS STA. TO STA.

F.A.P. RTE.	SECTION	COUNTY	TOTAL SHEETS	SHEET NO.
856	14-00170-42-RP	WILL	394	8
CONTRACT NO. 61D47			[ILLINOIS] FED. AID PROJECT	

SUMMARY OF QUANTITIES

SI	CODE NO.	ITEM DESCRIPTION	UNIT	TOTAL QUANTITY	ROADWAY	ROADWAY	TRAFFIC SIGNALS	TRAFFIC SIGNALS	INTER CONNECT	EMERGENCY	EMERGENCY	SIDEWALK	SHARED USE PATH	LANDSCAPING	BOX CULVERT	NOISE BARRIER	TRAINEES
					0003	0021	(135th/WEBER)	(GRAND/WEBER)	0021	0021	0021	0021	0021	0021	0021	0021	0021
					80/20% WILL COUNTY	80/20% ROMEDEVILLE STP	100% WILL COUNTY	100% WILL COUNTY	100% WILL COUNTY	80/20% ROMEDEVILLE STP	80/20% ROMEDEVILLE STP	80/20% ROMEDEVILLE STP	80/20% ROMEDEVILLE STP	100% WILL COUNTY	100% WILL COUNTY	100% WILL COUNTY	80/20% STP
	60605000	COMBINATION CONCRETE CURB AND GUTTER, TYPE B-6.24	FOOT	20,259	20,259												
	60620000	CONCRETE MEDIAN, TYPE SB-6.24	SQ FT	8,312	8,312												
	60623800	CONCRETE BARRIER MEDIAN	SQ FT	4,072	4,072												
	60624600	CORRUGATED MEDIAN	SQ FT	1,702	1,702												
X	66900200	NON-SPECIAL WASTE DISPOSAL	CU YD	18,830	18,830.0												
X	66900400	SPECIAL WASTE GROUNDWATER DISPOSAL	GALLON	300	300												
X	66900450	SPECIAL WASTE PLANS AND REPORTS	LSUM	1	1												
X	66900530	SOIL DISPOSAL ANALYSIS	EACH	10	10												
X	66901000	BACKFILL PLUGS	CU YD	200	200												
	67100100	MOBILIZATION	LSUM	1	1												
	70103815	TRAFFIC CONTROL SURVEILLANCE	CAL DA	1,080	1,080												
	70300210	TEMPORARY PAVEMENT MARKING LETTERS AND SYMBOLS	SQ FT	762	762												
	70300220	TEMPORARY PAVEMENT MARKING - LINE 4"	FOOT	32,105	32,105												
	70300240	TEMPORARY PAVEMENT MARKING - LINE 6"	FOOT	1,151	1,151												
	70300260	TEMPORARY PAVEMENT MARKING - LINE 12"	FOOT	105	105												
	70300280	TEMPORARY PAVEMENT MARKING - LINE 24"	FOOT	351	351												
	70300900	PAVEMENT MARKING TAPE, TYPE IV - LETTERS AND SYMBOLS	SQ FT	2,135	2,135												
	70300904	PAVEMENT MARKING TAPE, TYPE IV 4"	FOOT	94,810	94,810												
	70300906	PAVEMENT MARKING TAPE, TYPE IV 6"	FOOT	8,542	8,542												
	70300912	PAVEMENT MARKING TAPE, TYPE IV 12"	FOOT	890	890												
	70300924	PAVEMENT MARKING TAPE, TYPE IV 24"	FOOT	1,761	1,761												
	70400100	TEMPORARY CONCRETE BARRIER	FOOT	4,050	4,050												
	70400200	RELOCATE TEMPORARY CONCRETE BARRIER	FOOT	1,787.5	1,787.5												
	70600260	IMPACT ATTENUATORS, TEMPORARY (FULLY REDIRECTIVE, NARROW), TEST LEVEL 3	EACH	11	11												
	70600332	IMPACT ATTENUATORS, RELOCATE (FULLY REDIRECTIVE, NARROW), TEST LEVEL 3	EACH	1	1												
X	72400100	REMOVE SIGN PANEL ASSEMBLY - TYPE A	EACH	7	7												
X	72400200	REMOVE SIGN PANEL ASSEMBLY - TYPE B	EACH	5	5												
X	72400310	REMOVE SIGN PANEL - TYPE 1	SQ FT	304	304												
X	72400710	RELOCATE SIGN PANEL - TYPE 1	SQ FT	14	14												
X	72400720	RELOCATE SIGN PANEL - TYPE 2	SQ FT	40	40												
X	72800100	TELESCOPING STEEL SIGN SUPPORT	FOOT	1,361	1,361												

SI - SPECIALTY ITEM



USER NAME = TEG
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DESIGNED - CRC
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 DATE - 11/15/17

REVISED - 3/3/2015
 REVISED - 6/19/2015
 REVISED - 9/27/2016
 REVISED -

**STATE OF ILLINOIS
 DEPARTMENT OF TRANSPORTATION**

SUMMARY OF QUANTITIES

SCALE: NTS SHEET 5 OF 11 SHEETS STA. TO STA.

F.A.P. RTE.	SECTION	COUNTY	TOTAL SHEETS	SHEET NO.
856	14-00170-42-RP	WILL	394	9
CONTRACT NO. 61D47			ILLINOIS FED. AID PROJECT	

SUMMARY OF QUANTITIES

SI	CODE NO.	ITEM DESCRIPTION	UNIT	TOTAL QUANTITY	ROADWAY 0003		ROADWAY LIGHTING 0021		TRAFFIC SIGNALS (135th/WEBER) 0021		TRAFFIC SIGNALS (GRANDWEBER) 0021		INTER CONNECT 0021		EMERGENCY VEHICLE PREEMPTION (135th/WEBER) 0021		EMERGENCY VEHICLE PREEMPTION (GRANDWEBER) 0021		SIDEWALK 0021		SHARED USE PATH 0028		LANDSCAPING 0031		BOX CULVERT SN 099-3409 0008		NOISE BARRIER WALL 0020		TRAINEES 0042	
					80/20% WILL COUNTY	80/20% ROMEOVILLE STP	100% WILL COUNTY	100% WILL COUNTY	100% WILL COUNTY	100% WILL COUNTY	80/20% ROMEOVILLE STP	80/20% ROMEOVILLE STP	80/20% ROMEOVILLE STP	80/20% ROMEOVILLE STP	100% WILL COUNTY	100% WILL COUNTY	100% WILL COUNTY	100% WILL COUNTY	100% WILL COUNTY	100% WILL COUNTY	80/20% STP									
X	78000100	THERMOPLASTIC PAVEMENT MARKING - LETTERS AND SYMBOLS	SQ FT	874	874																									
X	78000200	THERMOPLASTIC PAVEMENT MARKING - LINE 4"	FOOT	11,915	11,915																									
X	78000400	THERMOPLASTIC PAVEMENT MARKING - LINE 6"	FOOT	3,379	3,379																									
X	78000600	THERMOPLASTIC PAVEMENT MARKING - LINE 12"	FOOT	870	870																									
X	78000650	THERMOPLASTIC PAVEMENT MARKING - LINE 24"	FOOT	177	177																									
X	78007100	PERMANENT PAVEMENT MARKING - LETTERS AND SYMBOLS	SQ FT	795	795																									
X	78007110	PERMANENT PAVEMENT MARKING - LINE 4"	FOOT	41,553	41,553																									
X	78007130	PERMANENT PAVEMENT MARKING - LINE 6"	FOOT	1,440	1,440																									
X	78007150	PERMANENT PAVEMENT MARKING - LINE 12"	FOOT	320	320																									
X	78007180	PERMANENT PAVEMENT MARKING - LINE 24"	FOOT	422	422																									
X	78008200	POLYUREA PAVEMENT MARKING TYPE I - LETTERS AND SYMBOLS	SQ FT	1,752	1,752																									
X	78008210	POLYUREA PAVEMENT MARKING TYPE I - LINE 4"	FOOT	21,410	21,410																									
X	78008230	POLYUREA PAVEMENT MARKING TYPE I - LINE 6"	FOOT	5,616	5,616																									
X	78008250	POLYUREA PAVEMENT MARKING TYPE I - LINE 12"	FOOT	2,315	2,315																									
X	78008270	POLYUREA PAVEMENT MARKING TYPE I - LINE 24"	FOOT	512	512																									
X	78100100	RAISED REFLECTIVE PAVEMENT MARKER	EACH	755	755																									
X	78200011	BARRIER WALL REFLECTORS, TYPE C	EACH	235	235																									
X	78300200	RAISED REFLECTIVE PAVEMENT MARKER REMOVAL	EACH	521	521																									
X	80500010	SERVICE INSTALLATION - GROUND MOUNTED	EACH	2				1	1																					
X	81028200	UNDERGROUND CONDUIT, GALVANIZED STEEL, 2" DIA.	FOOT	5,398				1,009	840	3,549																				
X	81028220	UNDERGROUND CONDUIT, GALVANIZED STEEL, 3" DIA.	FOOT	243				101	142																					
X	81028240	UNDERGROUND CONDUIT, GALVANIZED STEEL, 4" DIA.	FOOT	1,853			554	622	677																					
X	81400100	HANDHOLE	EACH	16				5	5	6																				
X	81400200	HEAVY-DUTY HANDHOLE	EACH	8				4	4																					
X	81400300	DOUBLE HANDHOLE	EACH	4				2	2																					
X	81603090	UNITDUCT, 600V, 3-1C NO. 4, 1/C NO. 6 GROUND, (XLP-TYPE USE), 1 1/4" DIA. POLYETHYLENE	FOOT	1,782			1,782																							
X	81800300	AERIAL CABLE, 3-1/C NO. 2 WITH MESSENGER WIRE	FOOT	1,074			1,074																							
X	82102250	LUMINAIRE, SODIUM VAPOR, HORIZONTAL MOUNT, 250 WATT	EACH	7			7																							
X	82102400	LUMINAIRE, SODIUM VAPOR, HORIZONTAL MOUNT, 400 WATT	EACH	8			8																							
X	83008600	LIGHT POLE, ALUMINUM, 40 FT. M.H. 15 FT. MAST ARM	EACH	7			7																							
X	83057345	LIGHT POLE, WOOD, 60 FOOT, CLASS 3, WITH 15FT MAST ARM	EACH	9			9																							
X	83600200	LIGHT POLE FOUNDATION, 24" DIAMETER	FOOT	70			70																							
X	83800205	BREAKAWAY DEVICE, TRANSFORMER BASE, 15 INCH BOLT CIRCLE	EACH	7			7																							

FILE NAME = D:\B\X11-ant-500.dgn

SI - SPECIALTY ITEM



USER NAME = TEG
 PLOT SCALE = 2.0000 ' / in.
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DESIGNED - CRC
 DRAWN - BLP
 CHECKED - EER
 DATE - 11/15/17

REVISED - 3/3/2015
 REVISED - 6/19/2015
 REVISED - 9/27/2016
 REVISED -

**STATE OF ILLINOIS
 DEPARTMENT OF TRANSPORTATION**

SUMMARY OF QUANTITIES

SCALE: NTS SHEET 6 OF 11 SHEETS STA. TO STA.

F.A.P. RTE.	SECTION	COUNTY	TOTAL SHEETS	SHEET NO.
856	14-00170-42-RP	WILL	394	10
CONTRACT NO. 61047			ILLINOIS FED. AID PROJECT	

SUMMARY OF QUANTITIES

SI	CODE NO.	ITEM DESCRIPTION	UNIT	TOTAL QUANTITY	ROADWAY 0003		TRAFFIC SIGNALS (135th/WEBER) 0021		INTER CONNECT 0021	EMERGENCY VEHICLE PREEMPTION (135th/WEBER) 0021		EMERGENCY VEHICLE PREEMPTION (GRAND/WEBER) 0021		SIDEWALK 0021	SHARED USE PATH 0028	LANDSCAPING 0031	BOX CULVERT SN 099-3409 0008	NOISE BARRIER WALL 0020	TRAINEES 0042
					80/20% WILL COUNTY	80/20% ROMEOVILLE STP	100% WILL COUNTY	100% WILL COUNTY		80/20% ROMEOVILLE STP	80/20% ROMEOVILLE STP	80/20% ROMEOVILLE STP	80/20% ROMEOVILLE STP						
X	84100110	REMOVAL OF TEMPORARY LIGHTING UNIT	EACH	9		9													
X	84200500	REMOVAL OF LIGHTING UNIT, SALVAGE	EACH	15		15													
X	84200804	REMOVAL OF POLE FOUNDATION	EACH	19		19													
X	84400105	RELOCATE EXISTING LIGHTING UNIT	EACH	4		4													
X	85000200	MAINTENANCE OF EXISTING TRAFFIC SIGNAL INSTALLATION	EACH	1					1										
X	86400100	TRANSCEIVER - FIBER OPTIC	EACH	1					1										
X	87300925	ELECTRIC CABLE IN CONDUIT, TRACER, NO. 14 1C	FOOT	9,720					9,720										
X	87301215	ELECTRIC CABLE IN CONDUIT, SIGNAL NO. 14 2C	FOOT	2,008			1,096	912											
X	87301225	ELECTRIC CABLE IN CONDUIT, SIGNAL NO. 14 3C	FOOT	5,699			2,645	3,054											
X	87301245	ELECTRIC CABLE IN CONDUIT, SIGNAL NO. 14 5C	FOOT	5,554			2,672	2,882											
X	87301255	ELECTRIC CABLE IN CONDUIT, SIGNAL NO. 14 7C	FOOT	5,651			2,866	2,785											
X	87301305	ELECTRIC CABLE IN CONDUIT, LEAD-IN, NO. 14 1 PAIR	FOOT	6,641			2,964	3,677											
X	87301805	ELECTRIC CABLE IN CONDUIT, SERVICE, NO. 6 2 C	FOOT	378			222	156											
X	87301900	ELECTRIC CABLE IN CONDUIT, EQUIPMENT GROUNDING CONDUCTOR, NO. 6 1C	FOOT	1,452			666	786											
X	87502500	TRAFFIC SIGNAL POST, GALVANIZED STEEL 16 FT.	EACH	3			1	2											
X	87700210	STEEL MAST ARM ASSEMBLY AND POLE, 34 FT.	EACH	1			1												
X	87700310	STEEL MAST ARM ASSEMBLY AND POLE, 54 FT.	EACH	1				1											
X	87700424	STEEL MAST ARM ASSEMBLY AND POLE, 72 FT.	EACH	1			1												
X	87702880	STEEL COMBINATION MAST ARM ASSEMBLY AND POLE 30 FT.	EACH	2			1	1											
X	87702890	STEEL COMBINATION MAST ARM ASSEMBLY AND POLE 32 FT.	EACH	1			1												
X	87703040	STEEL COMBINATION MAST ARM ASSEMBLY AND POLE 62 FT.	EACH	1			1												
X	87703070	STEEL COMBINATION MAST ARM ASSEMBLY AND POLE 66 FT.	EACH	1				1											
X	87703090	STEEL COMBINATION MAST ARM ASSEMBLY AND POLE 70 FT.	EACH	1				1											
X	87703120	STEEL COMBINATION MAST ARM ASSEMBLY AND POLE 75 FT.	EACH	1			1												
X	87704341	STEEL COMBINATION MAST ARM ASSEMBLY AND POLE WITH DUAL MAST ARMS, 28 FT. AND 50 FT.	EACH	1				1											
X	87800100	CONCRETE FOUNDATION, TYPE A	FOOT	40			24	16											
X	87800150	CONCRETE FOUNDATION, TYPE C	FOOT	8			4	4											
X	87800400	CONCRETE FOUNDATION, TYPE E 30-INCH DIAMETER	FOOT	14			14												
X	87800415	CONCRETE FOUNDATION, TYPE E 36-INCH DIAMETER	FOOT	66			22	44											
X	87800420	CONCRETE FOUNDATION, TYPE E 42-INCH DIAMETER	FOOT	121			71	50											
X	87900200	DRILL EXISTING HANDHOLE	EACH	1					1										
X	88030020	SIGNAL HEAD, LED, 1-FACE, 3-SECTION, MAST-ARM MOUNTED	EACH	20			10	10											

SI - SPECIALTY ITEM

FILE NAME = D:\B0011-ahc-500.dgn



USER NAME = TEG	DESIGNED - CRC	REVISED - 3/3/2015
PLOT SCALE = 2.0000' / 1"	DRAWN - BLP	REVISED - 6/19/2015
PLOT DATE = 12/29/2017	CHECKED - EER	REVISED - 9/27/2016
	DATE - 11/15/17	REVISED -

**STATE OF ILLINOIS
DEPARTMENT OF TRANSPORTATION**

SUMMARY OF QUANTITIES			
SCALE: NTS	SHEET 7 OF 11 SHEETS	STA. TO STA.	

F.A.P. RTE. 856	SECTION 14-00170-42-RP	COUNTY WILL	TOTAL SHEETS 394	SHEET NO. 11
CONTRACT NO. 61D47				ILLINOIS FED. AID PROJECT

SUMMARY OF QUANTITIES

SI	CODE NO.	ITEM DESCRIPTION	UNIT	TOTAL QUANTITY	ROADWAY 0003		TRAFFIC SIGNALS (135th/WEBER) 0021		INTER CONNECT 0021	EMERGENCY VEHICLE PREEMPTION (135th/WEBER) 0021		SIDEWALK 0021	SHARED USE PATH 0028		LANDSCAPING 0031	BOX CULVERT SN 099-3409 0008	NOISE BARRIER WALL 0020	TRAINEES 0042
					80/20% WILL COUNTY	80/20% ROMEOVILLE STP	100% WILL COUNTY	100% WILL COUNTY		80/20% ROMEOVILLE STP	80/20% ROMEOVILLE STP		80/20% ROMEOVILLE STP	80/20% ROMEOVILLE STP				
X	88030050	SIGNAL HEAD, LED, 1-FACE, 3-SECTION, BRACKET MOUNTED	EACH	1				1										
X	88030070	SIGNAL HEAD, LED, 1-FACE, 4-SECTION, BRACKET MOUNTED	EACH	2			2											
X	88030080	SIGNAL HEAD, LED, 1-FACE, 4-SECTION, MAST ARM MOUNTED	EACH	2			2											
X	88030100	SIGNAL HEAD, LED, 1-FACE, 5-SECTION, BRACKET MOUNTED	EACH	6			3	3										
X	88030110	SIGNAL HEAD, LED, 1-FACE, 5-SECTION, MAST-ARM MOUNTED	EACH	12			5	7										
X	88102717	PEDESTRIAN SIGNAL HEAD, LED, 1-FACE, BRACKET MOUNTED WITH COUNTDOWN TIMER	EACH	10			6	4										
X	88200210	TRAFFIC SIGNAL BACKPLATE, LOUVERED, ALUMINUM	EACH	34			17	17										
X	88500100	INDUCTIVE LOOP DETECTOR	EACH	24			12	12										
X	88600700	PREFORMED DETECTOR LOOP	FOOT	3,078			1,607	1,471										
X	88700200	LIGHT DETECTOR	EACH	8						4	4							
X	88700300	LIGHT DETECTOR AMPLIFIER	EACH	2						1	1							
X	88800100	PEDESTRIAN PUSH-BUTTON	EACH	10			6	4										
X	89000100	TEMPORARY TRAFFIC SIGNAL INSTALLATION	EACH	2			1	1										
X	89502300	REMOVE ELECTRIC CABLE FROM CONDUIT	FOOT	3,672					3,672									
X	89502375	REMOVE EXISTING TRAFFIC SIGNAL EQUIPMENT	EACH	2			1	1										
X	89502380	REMOVE EXISTING HANDHOLE	EACH	18			8	10										
X	89502382	REMOVE EXISTING DOUBLE HANDHOLE	EACH	2			1	1										
X	89502385	REMOVE EXISTING CONCRETE FOUNDATION	EACH	16			8	8										
	Z0007430	TEMPORARY SIDEWALK	SQ FT	1,305	1,305													
	Z0013798	CONSTRUCTION LAYOUT	LSUM	1	1													
	Z0018700	DRAINAGE STRUCTURE TO BE REMOVED	EACH	135	135													
	Z0022800	FENCE REMOVAL	FOOT	103	103													
	Z0030850	TEMPORARY INFORMATION SIGNING	SQ FT	695	695													
X	Z0033020	LUMINAIRE SAFETY CABLE ASSEMBLY	EACH	7		7												
X	Z0033028	MAINTENANCE OF LIGHTING SYSTEM	CAL MO	24		24												
X	Z0033046	RE-OPTIMIZE TRAFFIC SIGNAL SYSTEM LEVEL 2	EACH	1					1									
	Z0046304	PIPE UNDERDRAINS FOR STRUCTURES 4"	FOOT	127	127													
	Z0056608	STORM SEWER (WATER MAIN REQUIREMENTS) 12 INCH	FOOT	263	263													
	Z0056612	STORM SEWER (WATER MAIN REQUIREMENTS) 18 INCH	FOOT	20	20													
	Z0056616	STORM SEWER (WATER MAIN REQUIREMENTS) 24 INCH	FOOT	43	43													
	Z0056626	STORM SEWER (WATER MAIN REQUIREMENTS) 48 INCH	FOOT	36	36													
	Z0056637	STORM SEWER (WATER MAIN REQUIREMENTS) EQUIVALENT ROUND-SIZE 36 INCH	FOOT	53	53													

SI - SPECIALTY ITEM



USER NAME = TEG	DESIGNED - CRC	REVISED - 3/3/2015
PLOT SCALE = 2.0000' / 1"	DRAWN - BLP	REVISED - 6/19/2015
PLOT DATE = 12/29/2017	CHECKED - EER	REVISED - 9/27/2016
	DATE - 11/15/17	REVISED -

**STATE OF ILLINOIS
DEPARTMENT OF TRANSPORTATION**

SUMMARY OF QUANTITIES

SCALE: NTS SHEET 8 OF 11 SHEETS STA. TO STA.

F.A.P. RTE. 856	SECTION 14-00170-42-RP	COUNTY WILL	TOTAL SHEETS 394	SHEET NO. 12
CONTRACT NO. 61D47			[ILLINOIS] FED. AID PROJECT	

FILE NAME = D:\68X11-nt-500.dgn

SUMMARY OF QUANTITIES

SI	CODE NO.	ITEM DESCRIPTION	UNIT	TOTAL QUANTITY	ROADWAY	ROADWAY	TRAFFIC SIGNALS	TRAFFIC SIGNALS	INTER CONNECT	EMERGENCY	EMERGENCY	SIDEWALK	SHARED USE PATH	LANDSCAPING	BOX CULVERT	NOISE BARRIER	TRAINEES
					0003	0021	(135th/WEBER)	(GRANDWEBER)	0021	VEHICLE	VEHICLE	0021	0028	0031	SN 099-3409	WALL	0042
					80/20%	80/20%	100%	100%	100%	80/20%	80/20%	80/20%	80/20%	100%	100%	100%	80/20%
					WILL COUNTY	ROMEDEVILLE STP	WILL COUNTY	WILL COUNTY	WILL COUNTY	ROMEDEVILLE STP	ROMEDEVILLE STP	ROMEDEVILLE STP	ROMEDEVILLE STP	WILL COUNTY	WILL COUNTY	WILL COUNTY	STP
X	Z0057300	SANITARY SEWER 18"	FOOT	1,122	1,122												
X	Z0058000	SANITARY SEWER, SPECIAL	FOOT	94	94												
	Z0062456	TEMPORARY PAVEMENT	SQ YD	38,111	38,111												
	Z0064505	SECTION CORNER MARKERS	EACH	3	3												
X	Z0067900	STEEL CASINGS 24"	FOOT	520	520												
X	Z0068200	STEEL CASINGS 30"	FOOT	240	240												
	Z0073345	SLEEPER SLAB	FOOT	700	700												
X	Z0073510	TEMPORARY TRAFFIC SIGNAL TIMING	EACH	2			1	1									
	Z0076600	TRAINEES	HOUR	1,500													1,500
	Z0076604	TRAINEES TRAINING PROGRAM GRADUATE	HOUR	1,500													1,500
X	A2000174	TREE, ACER X FREEMANII AUTUMN BLAZE (AUTUMN BLAZE FREEMAN MAPLE), 10' HEIGHT CLUMP FORM, BALLED AND BURLAPPED	EACH	3										3			
X	A2000220	TREE, ACER X FREEMANII MARMO (MARMO FREEMAN MAPLE), 2-1/2" CALIPER, BALLED AND BURLAPPED	EACH	5										5			
X	A2002474	TREE, BETULA NIGRA HERITAGE (HERITAGE RIVER BIRCH), 10' HEIGHT, CLUMP FORM, BALLED AND BURLAPPED	EACH	2										2			
X	A2002920	TREE, CELTIS OCCIDENTALIS (COMMON HACKBERRY), 2-1/2" CALIPER, BALLED AND BURLAPPED	EACH	7										7			
X	A2004512	TREE, GINKGO BILOBA AUTUMN GOLD (AUTUMN GOLD GINKGO), 2" CALIPER, BALLED AND BURLAPPED	EACH	4										4			
X	A2004820	TREE, GLEDITSIA TRIACANTHOS INERMIS SKYLINE (SKYLINE THORNLESS COMMON HONEYLOCUST), 2-1/2" CALIPER, BALLED AND BURLAPPED	EACH	16										16			
X	A2005020	TREE, GYMNOCLADUS DIOICUS (KENTUCKY COFFEETREE), 2-1/2" CALIPER, BALLED AND BURLAPPED	EACH	15										15			
X	A2005420	TREE, LIRIODENDRON TULIPIFERA (TULIP TREE), 2-1/2" CALIPER, BALLED AND BURLAPPED	EACH	12										12			
X	A2006516	TREE, QUERCUS BICOLOR (SWAMP WHITE OAK), 2" CALIPER, BALLED AND BURLAPPED	EACH	4										4			
X	A2006816	TREE, QUERCUS MUEHLENBERGII (CHINKAPIN OAK), 2" CALIPER, BALLED AND BURLAPPED	EACH	9										9			
X	A2007624	TREE, TAXODIUM DISTICHUM (COMMON BALD CYPRESS), 3" CALIPER, BALLED AND BURLAPPED	EACH	19										19			
X	A2007818	TREE, TILIA AMERICANA MCKSENTRY (SENTRY AMERICAN LINDEN/BASSWOOD), 2" CALIPER, BALLED AND BURLAPPED	EACH	1										1			
X	B2000666	TREE, AMELANCHIER X GRANDIFLORA (APPLE SERVICEBERRY), 6' HEIGHT, SHRUB FORM, BALLED AND BURLAPPED	EACH	15										15			
X	D2002460	EVERGREEN, PINUS FLEXILIS VANDERWOLF'S PYRAMID (VANDERWOLF'S PYRAMID LIMBER PINE), 5' HEIGHT, BALLED AND BURLAPPED	EACH	14										14			
X	D2002772	EVERGREEN, PINUS NIGRA (AUSTRIAN PINE), 6' HEIGHT, BALLED AND BURLAPPED	EACH	9										9			
X	E20210G1	VINE-PARTHENOCISSUS QUINQUEFOLIA ENGEL MANNII (ENGELMANNII VIRGINIA CREEPER), 1-GALLON POT	EACH	860										860			

SI - SPECIALTY ITEM



USER NAME = TEG	DESIGNED - CRC	REVISED - 3/3/2015
PLOT SCALE = 2.0000' / in.	DRAWN - BLP	REVISED - 6/19/2015
PLOT DATE = 12/29/2017	CHECKED - EER	REVISED - 9/27/2016
	DATE - 11/15/17	REVISED -

**STATE OF ILLINOIS
DEPARTMENT OF TRANSPORTATION**

SUMMARY OF QUANTITIES

SCALE: NTS SHEET 9 OF 11 SHEETS STA. TO STA.

F.A.P. RTE. 856	SECTION 14-00170-42-RP	COUNTY WILL	TOTAL SHEETS 394	SHEET NO. 13
CONTRACT NO. 61D47			ILLINOIS FED. AID PROJECT	

FILE NAME = D:\B2017-18\14-00170-42-RP.dgn

SUMMARY OF QUANTITIES

SI	CODE NO.	ITEM DESCRIPTION	UNIT	TOTAL QUANTITY	ROADWAY	ROADWAY	TRAFFIC SIGNALS	TRAFFIC SIGNALS	INTER CONNECT	EMERGENCY VEHICLE	EMERGENCY VEHICLE	SIDEWALK	SHARED USE PATH	LANDSCAPING	BOX CULVERT	NOISE BARRIER	TRAINEES
					0003	0021	(135th/WEBER)	(GRAND/WEBER)	0021	PREEMPTION	PREEMPTION	0021	0028	0031	SN 099-3409	WALL	0042
					80/20% WILL COUNTY	80/20% ROMEOVILLE STP	100% WILL COUNTY	100% WILL COUNTY	100% WILL COUNTY	80/20% ROMEOVILLE STP	80/20% ROMEOVILLE STP	80/20% ROMEOVILLE STP	80/20% ROMEOVILLE STP	100% WILL COUNTY	100% WILL COUNTY	100% WILL COUNTY	80/20% STP
X	K0029634	WEED CONTROL, PRE-EMERGENT GRANULAR HERBICIDE	POUND	35										35			
	X0301423	NOISE ABATEMENT WALL, GROUND MOUNTED	SQ FT	16,550												16,550	
	X0320037	TEMPORARY PUMPING SYSTEM	LSUM	1	1												
	X0323265	REMOVE EXISTING RIPRAP	SQ YD	671	671												
X	X0323577	SANITARY SEWER TELEVISION INSPECTION, VIDEOTAPING AND RECORDING	FOOT	1,216	1,216												
X	X0323814	SANITARY SEWER REMOVAL, 18"	FOOT	1,182	1,182												
X	X0324085	EMERGENCY VEHICLE PRIORITY SYSTEM LINE SENSOR CABLE, NO. 20 3/C	FOOT	1,936						1,082	854						
X	X0324599	ROD AND CLEAN EXISTING CONDUIT	FOOT	500					500								
X	X0325003	REMOVE EXISTING VALVE AND VAULT	EACH	4	4												
X	X0326713	SANITARY SEWER CONNECTION	EACH	2	2												
	X0326936	CONTRACTOR DESIGNED GROUND IMPROVEMENT	LSUM	1	1												
X	X0327698	LED INTERNALLY ILLUMINATED STREET NAME SIGN	EACH	8			4	4									
	X0327979	PAVEMENT MARKING REMOVAL - GRINDING	SQ FT	17,525	17,525												
	X0327980	PAVEMENT MARKING REMOVAL - WATER BLASTING	SQ FT	21,145	21,145												
	X0426200	DEWATERING	LSUM	1	1												
X	X1400081	FULL-ACTUATED CONTROLLER AND TYPE SUPER P CABINET (SPECIAL)	EACH	2			1	1									
	X2130010	EXPLORATION TRENCH, SPECIAL	FOOT	400	400												
	X4021000	TEMPORARY ACCESS (PRIVATE ENTRANCE)	EACH	1	1												
	X4022000	TEMPORARY ACCESS (COMMERCIAL ENTRANCE)	EACH	9	9												
	X4024100	TEMPORARY ACCESS (WINTERIZE)	SQ YD	1,595	1,595.0												
	X5401005	PRECAST CONCRETE BOX CULVERTS 10' X 4' (SPECIAL)	FOOT	42											42.0		
X	X5610004	DUCTILE IRON WATER MAIN FITTINGS	POUND	4,228	4,228												
X	X5610708	WATER MAIN REMOVAL, 8"	FOOT	95	95												
X	X5610712	WATER MAIN REMOVAL, 12"	FOOT	708	708												
X	X5610716	WATER MAIN REMOVAL, 16"	FOOT	131	131												
	X5860110	GRANULAR BACKFILL FOR STRUCTURES	CU YD	185	60										125		
	X5930100	CONTROLLED LOW-STRENGTH MATERIAL, SPECIAL	CU YD	8,350	8,350												
	X6020096	MANHOLES, TYPE A, 6'-DIAMETER, WITH 2 TYPE 1 FRAME, CLOSED LID, RESTRICTOR PLATE	EACH	1	1												
	X6022858	MANHOLES, TYPE A, SANITARY, 4'-DIAMETER, TYPE 1 FRAME, CLOSED LID	EACH	7	7												
X	X6026050	SANITARY MANHOLES TO BE ADJUSTED	EACH	5	5												
X	X6026051	SANITARY MANHOLES TO BE RECONSTRUCTED	EACH	2	2												
X	X6026054	SANITARY MANHOLES TO BE REMOVED	EACH	3	3												

SI - SPECIALTY ITEM



USER NAME = TEG	DESIGNED - CRC	REVISED - 3/3/2015
PLOT SCALE = 2.0000' / 1"	DRAWN - BLP	REVISED - 6/19/2015
PLOT DATE = 12/29/2017	CHECKED - EER	REVISED - 9/27/2016
	DATE - 11/15/17	REVISED -

**STATE OF ILLINOIS
DEPARTMENT OF TRANSPORTATION**

SUMMARY OF QUANTITIES

SCALE: NTS SHEET 10 OF 11 SHEETS STA. TO STA.

F.A.P. RTE.	SECTION	COUNTY	TOTAL SHEETS	SHEET NO.
856	14-00170-42-RP	WILL	394	14
CONTRACT NO. 61D47			ILLINOIS FED. AID PROJECT	

FILE NAME = D:\B011-14-10-500.dgn

SUMMARY OF QUANTITIES

SI	CODE NO.	ITEM DESCRIPTION	UNIT	TOTAL QUANTITY	ROADWAY	ROADWAY	TRAFFIC SIGNALS	TRAFFIC SIGNALS	INTER CONNECT	EMERGENCY	EMERGENCY	SIDEWALK	SHARED USE PATH	LANDSCAPING	BOX CULVERT	NOISE BARRIER	TRAINEES
					0003	LIGHTING	(135th/WEBER)	(GRAND/WEBER)	0021	VEHICLE	VEHICLE	0021	PREEMPTION	PREEMPTION	0021	0028	0031
					80/20%	80/20%	100%	100%	100%	80/20%	80/20%	80/20%	80/20%	100%	100%	100%	80/20%
					WILL COUNTY	ROMEDEVILLE STP	WILL COUNTY	WILL COUNTY	WILL COUNTY	ROMEDEVILLE STP	ROMEDEVILLE STP	ROMEDEVILLE STP	ROMEDEVILLE STP	WILL COUNTY	WILL COUNTY	WILL COUNTY	STP
	X6064500	COMBINATION CONCRETE CURB AND GUTTER, TYPE B-6.24 (TEMPORARY)	FOOT	360	360												
	X6700410	ENGINEER'S FIELD OFFICE, TYPE A (SPECIAL)	CAL MO	36	36												
	X7010216	TRAFFIC CONTROL AND PROTECTION, (SPECIAL)	LSUM	1	1												
	X7015005	CHANGEABLE MESSAGE SIGN	CAL DA	5,400	5,400												
	X7030005	TEMPORARY PAVEMENT MARKING REMOVAL	SQ FT	42,276	42,276												
	X7040125	PINNING TEMPORARY CONCRETE BARRIER	EACH	1,440	1,440												
X	X7200105	SIGN PANEL - TYPE 1 (SPECIAL)	SQ FT	606	546			30	30								
X	X7200205	SIGN PANEL - TYPE 2 (SPECIAL)	SQ FT	135	135												
X	X8210040	TEMPORARY LUMINAIRE, HIGH PRESSURE SODIUM VAPOR, HORIZONTAL MOUNT, 400 WATT	EACH	9			9										
X	X8620200	UNINTERRUPTABLE POWER SUPPLY, SPECIAL	EACH	2				1	1								
X	X8710024	FIBER OPTIC CABLE IN CONDUIT, NO. 62.5/125, MM12F SM24F	FOOT	9,720					9,720								
X	X8760055	PEDESTRIAN PUSH-BUTTONPOST, TYPE A	EACH	6				4	2								
X	X8950077	REMOVE AND RELOCATE EXISTING LIGHTING CONTROLLER	EACH	1			1										
	XX000717	STORMSEWER CONNECTION, SPECIAL	EACH	20	20												

FILE NAME = D:\60X11-shr-SDD.dgn

SI - SPECIALTY ITEM



USER NAME = TEG	DESIGNED -	REVISED - 3/3/2015
PLOT SCALE = 2.0000' / 1in.	DRAWN -	REVISED - 6/19/2015
PLOT DATE = 12/29/2017	CHECKED -	REVISED - 9/27/2016
	DATE - 11/15/17	REVISED -

**STATE OF ILLINOIS
DEPARTMENT OF TRANSPORTATION**

SUMMARY OF QUANTITIES

SCALE: NTS SHEET 11 OF 11 SHEETS STA. TO STA.

F.A.P. RTE.	SECTION	COUNTY	TOTAL SHEETS	SHEET NO.
856	14-00170-42-RP	WILL	394	15
CONTRACT NO. 61D47			ILLINOIS FED. AID PROJECT	


NOTES

- REFER TO THE REMOVAL PLANS AND SCHEDULES FOR MORE INFORMATION




EXISTING LEGEND:

- A 1 3/4" HMA SURFACE COURSE
- B 2" HMA SURFACE COURSE
- C 2" HMA BINDER COURSE
- D 2 1/4" HMA BINDER COURSE
- E 9" HMA BASE COURSE
- F 11" HMA PAVEMENT
- G 12" HMA PAVEMENT
- H 4" GRANULAR SUB-BASE MATERIAL
- I COMB CONC CURB & GUTTER, TYPE B-6.12
- J COMB CONC CURB & GUTTER, TYPE B-6.18
- K COMB CONC CURB & GUTTER, TYPE B-6.24
- L PCC SIDEWALK
- M SODDING & TOPSOIL

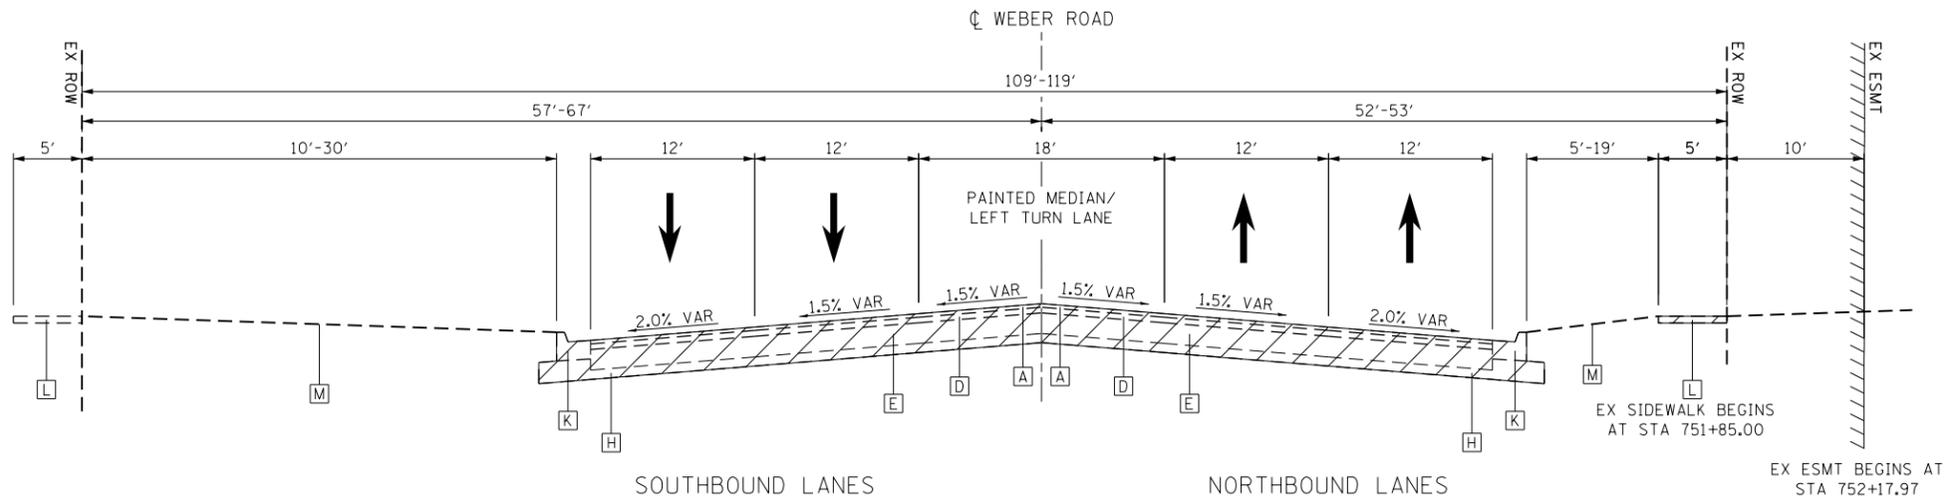

EXISTING TYPICAL SECTION 1


STA 736+25.00 TO STA 765+20.51, WEBER ROAD

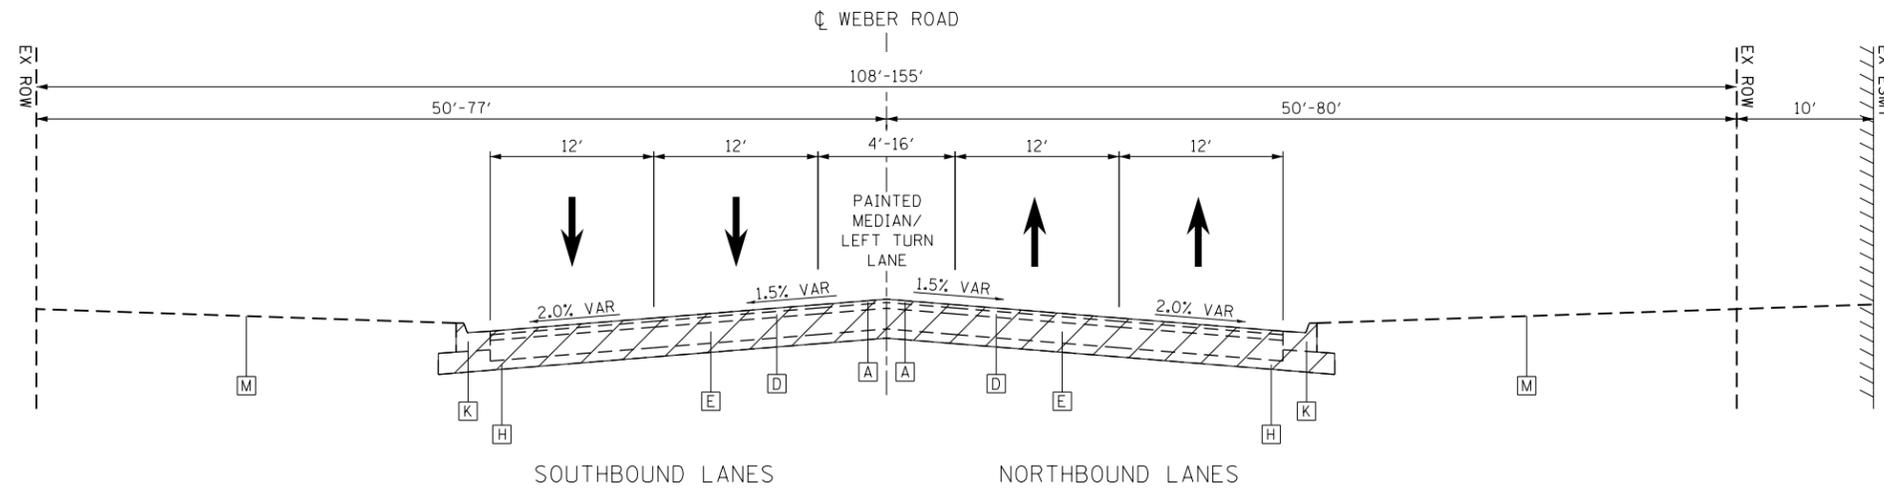

EXISTING TYPICAL SECTION 2

STA 765+20.51 TO STA 790+20.00, WEBER ROAD

FILE NAME = D:\B\11-sh-typical.dgn

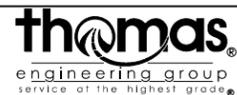

USER NAME = TEG	DESIGNED - VJM	REVISED - 3/3/2015
	DRAWN - VJM	REVISED - 6/19/2015
PLOT SCALE = 13.3332' / 1"	CHECKED - RO	REVISED - 9/27/2016
PLOT DATE = 11/14/2017	DATE - 11/15/17	REVISED -

**STATE OF ILLINOIS
DEPARTMENT OF TRANSPORTATION**

**TYPICAL SECTIONS
EXISTING WEBER ROAD**

SCALE: NTS SHEET 1 OF 13 SHEETS STA. TO STA.

F.A.P. RTE.	SECTION	COUNTY	TOTAL SHEETS	SHEET NO.
856	14-00170-42-RP	WILL	394	16
CONTRACT NO. 61D47				
ILLINOIS FED. AID PROJECT				


NOTES

- REFER TO THE REMOVAL PLANS AND SCHEDULES FOR MORE INFORMATION




EXISTING LEGEND:

- A 1 3/4" HMA SURFACE COURSE
- B 2" HMA SURFACE COURSE
- C 2" HMA BINDER COURSE
- D 2 1/4" HMA BINDER COURSE
- E 9" HMA BASE COURSE
- F 11" HMA PAVEMENT
- G 12" HMA PAVEMENT
- H 4" GRANULAR SUB-BASE MATERIAL
- I COMB CONC CURB & GUTTER, TYPE B-6.12
- J COMB CONC CURB & GUTTER, TYPE B-6.18
- K COMB CONC CURB & GUTTER, TYPE B-6.24
- L PCC SIDEWALK
- M SODDING & TOPSOIL

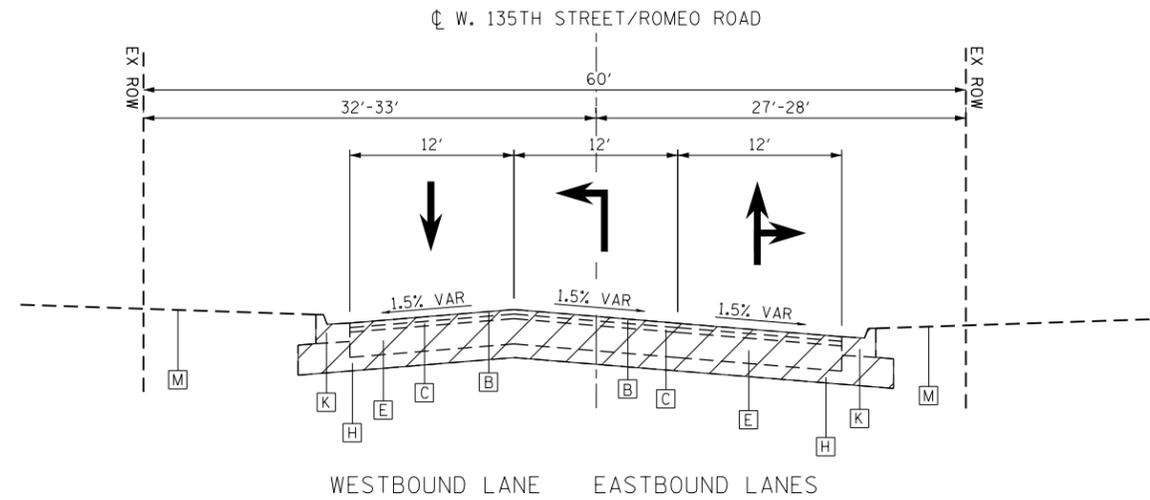

EXISTING TYPICAL SECTION 3


STA 113+34.00 TO STA 115+36.58, W 135TH STREET/ROMEO ROAD

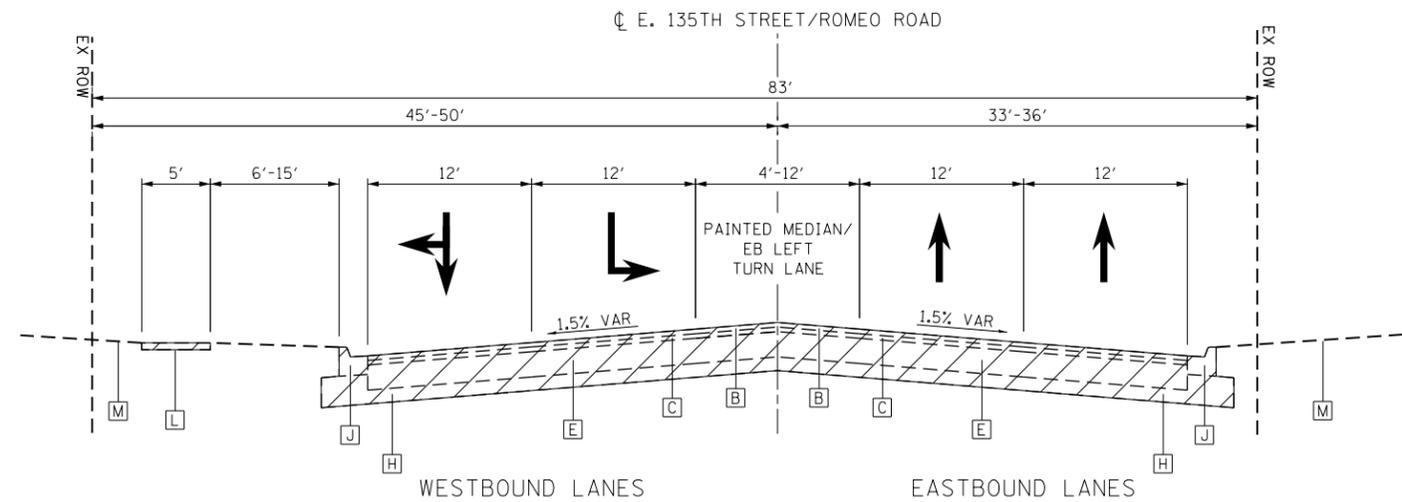

EXISTING TYPICAL SECTION 4

STA 115+36.58 TO STA 123+80.00, E 135TH STREET/ROMEO ROAD

FILE NAME = D:\B\11-sh-typical.dgn

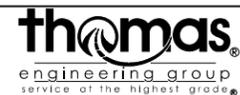

USER NAME = TEG	DESIGNED - VJM	REVISED - 3/3/2015
	DRAWN - VJM	REVISED - 6/19/2015
PLOT SCALE = 13.3332' / 1"	CHECKED - RO	REVISED - 9/27/2016
PLOT DATE = 11/14/2017	DATE - 11/15/17	REVISED -

**STATE OF ILLINOIS
DEPARTMENT OF TRANSPORTATION**

**TYPICAL SECTIONS
EXISTING 135TH STREET / ROMEO ROAD**

SCALE: NTS SHEET 2 OF 13 SHEETS STA. TO STA.

F.A.P. RTE.	SECTION	COUNTY	TOTAL SHEETS	SHEET NO.
856	14-00170-42-RP	WILL	394	17
CONTRACT NO. 61D47			ILLINOIS FED. AID PROJECT	


NOTES

- REFER TO THE REMOVAL PLANS AND SCHEDULES FOR MORE INFORMATION




EXISTING LEGEND:

- A 1 3/4" HMA SURFACE COURSE
- B 2" HMA SURFACE COURSE
- C 2" HMA BINDER COURSE
- D 2 1/4" HMA BINDER COURSE
- E 9" HMA BASE COURSE
- F 11" HMA PAVEMENT
- G 12" HMA PAVEMENT
- H 4" GRANULAR SUB-BASE MATERIAL
- I COMB CONC CURB & GUTTER, TYPE B-6.12
- J COMB CONC CURB & GUTTER, TYPE B-6.18
- K COMB CONC CURB & GUTTER, TYPE B-6.24
- L PCC SIDEWALK
- M SODDING & TOPSOIL

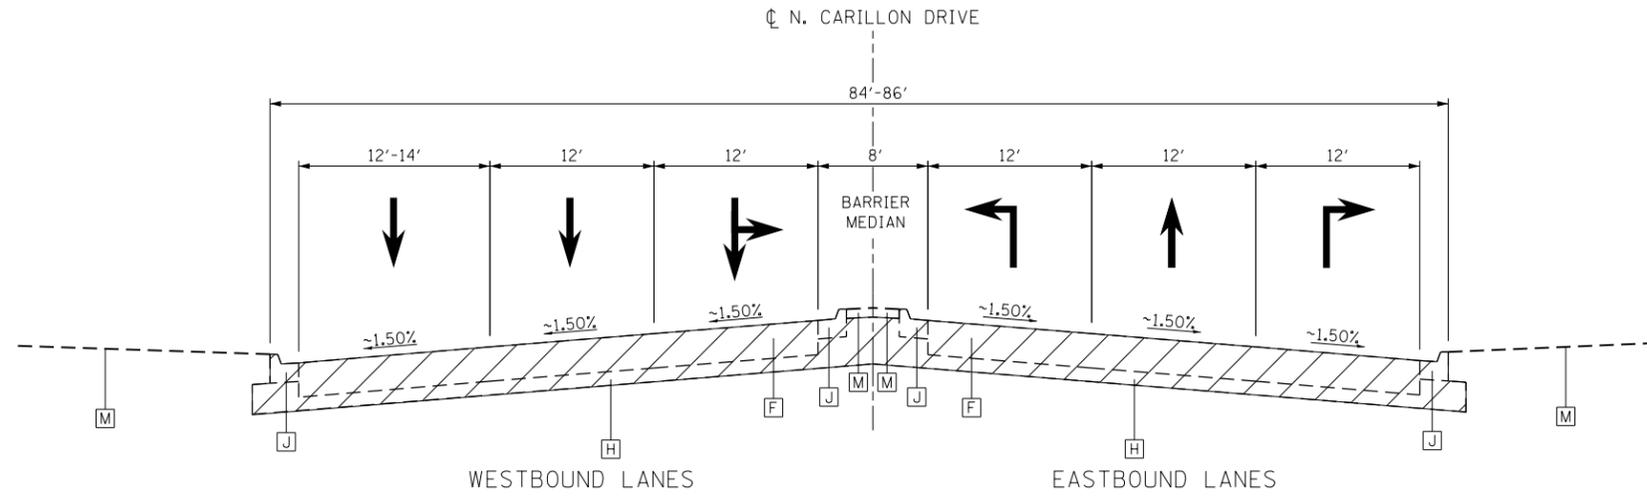

EXISTING TYPICAL SECTION 5


STA 231+40.00 TO STA 235+92.00, N CARILLON DRIVE

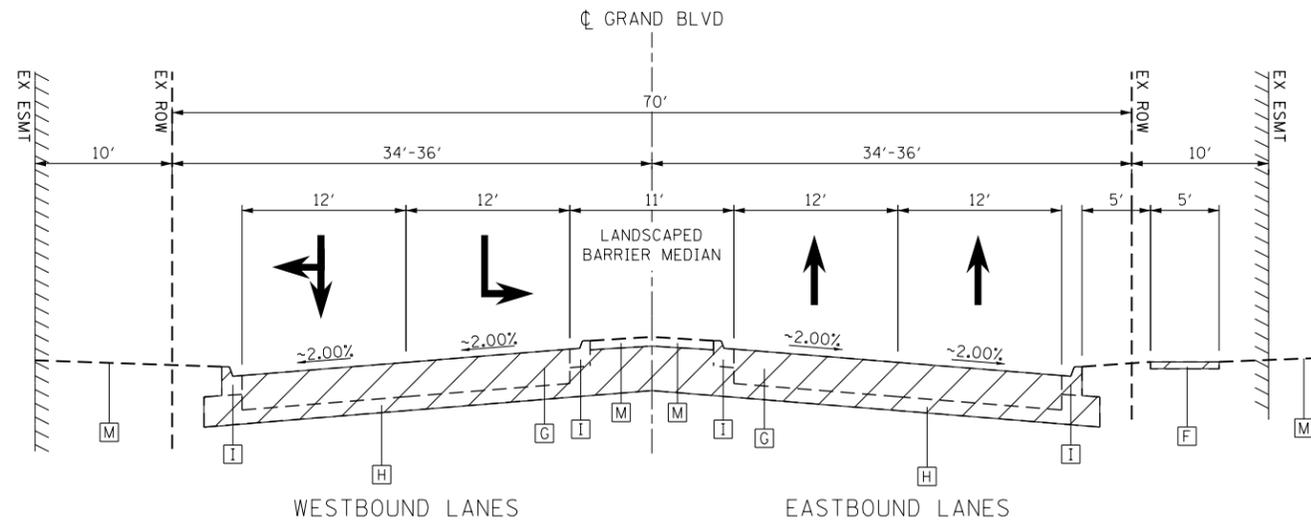

EXISTING TYPICAL SECTION 6

STA 235+92.00 TO STA 238+48.00, GRAND BOULEVARD

FILE NAME = D:\B\11-shr-typical.dgn

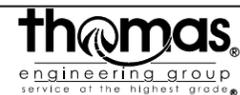

USER NAME = TEG	DESIGNED - VJM	REVISED - 3/3/2015
	DRAWN - VJM	REVISED - 6/19/2015
PLOT SCALE = 13.3332' / in.	CHECKED - RO	REVISED - 9/27/2016
PLOT DATE = 11/14/2017	DATE - 11/15/17	REVISED -

**STATE OF ILLINOIS
DEPARTMENT OF TRANSPORTATION**

**TYPICAL SECTIONS
EXISTING N. CARILLON DRIVE / GRAND BOULEVARD**

SCALE: NTS SHEET 3 OF 13 SHEETS STA. TO STA.

F.A.P. RTE.	SECTION	COUNTY	TOTAL SHEETS	SHEET NO.
856	14-00170-42-RP	WILL	394	18
CONTRACT NO. 61D47				
ILLINOIS FED. AID PROJECT				

HOT-MIX ASPHALT MIXTURE REQUIREMENTS		
	MIXTURE TYPE	AIR VOIDS @ N _{as}
HOT-MIX ASPHALT PAVEMENT, 7½" 135TH STREET (WEST LEG) NORTH CARILLON DRIVE GRAND BOULEVARD	HOT-MIX ASPHALT SURFACE COURSE, MIX "D", N70, (IL-9.5mm); 2"	4% @ 70 Gyr.
	HOT-MIX ASPHALT BASE COURSE, IL-19.0, N70, 5¼"	4% @ 70 Gyr.
HOT-MIX ASPHALT PAVEMENT, 10¼" 135TH STREET (EAST LEG)	HOT-MIX ASPHALT SURFACE COURSE, MIX "D", N70, (IL-9.5mm); 2"	4% @ 70 Gyr.
	HOT-MIX ASPHALT BASE COURSE, IL-19.0, N70, 8¼"	4% @ 70 Gyr.
TEMPORARY PAVEMENT WEBER ROAD	HOT-MIX ASPHALT SURFACE COURSE, MIX "D", N50, (IL-9.5mm); 2"	4% @ 50 Gyr.
	HOT-MIX ASPHALT BASE COURSE (HOT-MIX ASPHALT BINDER), IL-19.0, N50, 8"	4% @ 50 Gyr.
TEMPORARY PAVEMENT 135TH STREET N. CARILLON DRIVE GRAND BOULEVARD	HOT-MIX ASPHALT SURFACE COURSE, MIX "D", N50, (IL-9.5mm); 2"	4% @ 50 Gyr.
	HOT-MIX ASPHALT BASE COURSE (HOT-MIX ASPHALT BINDER), IL-19.0, N50, 6"	4% @ 50 Gyr.
HOT-MIX ASPHALT DRIVEWAY PAVEMENT, 10" PRIVATE ENTRANCES COMMERCIAL ENTRANCES	HOT-MIX ASPHALT SURFACE COURSE, MIX "D", N50, (IL-9.5mm); 2"	4% @ 50 Gyr.
	HOT-MIX ASPHALT BASE COURSE (HOT-MIX ASPHALT BINDER), IL-19.0, N50, 8"	4% @ 50 Gyr.
HMA PAVEMENT RESURFACING, 2"	HOT-MIX ASPHALT SURFACE COURSE, MIX "D", N70, (IL-9.5mm); 2"	4% @ 70 Gyr.
HOT-MIX ASPHALT SHARED-USE PATH, 3"	HOT-MIX ASPHALT SURFACE COURSE, MIX "D", N50, (IL-9.5mm); 3"	4% @ 50 Gyr.
TEMPORARY ACCESS (WINTERIZE)	HOT-MIX ASPHALT SURFACE COURSE, MIX "D", N50, (IL-9.5mm); 2"	4% @ 50 Gyr.
CLASS D PATCHES, TYPE IV, 13 INCH	HOT-MIX ASPHALT SURFACE COURSE, MIX "D", N70, (IL-9.5mm); 2"	4% @ 70 Gyr.
	HOT-MIX ASPHALT BINDER, IL-19.0, N70, 10"	4% @ 70 Gyr.

NOTES


THE UNIT WEIGHT USED TO CALCULATE ALL HOT-MIX ASPHALT MIXTURES IS 112 LBS/SQ YD/IN.

FOR USE OF RECYCLED MATERIALS SEE DISTRICT ONE SPECIAL PROVISIONS.

ALTERNATE TEMPORARY PAVEMENT:
PC CONCRETE TEMPORARY PAVEMENT SHALL CONSIST OF PV CONCRETE MEETING THE REQUIREMENTS OF ARTICLE 1020 OF THE STANDARD SPECIFICATIONS, 8" THICK. TEMPORARY PCC PAVEMENT DOES NOT REQUIRE DOWEL BARS.

THE AC TYPE FOR NON-POLYMERIZED HMA SHALL BE PG 64-22" UNLESS MODIFIED BY DISTRICT ONE SPECIAL PROVISIONS.

FILE NAME = D:\B\11-shr-typical.dgn

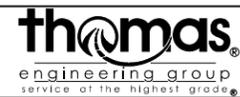


USER NAME = TEG	DESIGNED - VJM	REVISED - 3/3/2015
	DRAWN - VJM	REVISED - 6/19/2015
PLOT SCALE = 13.3332 1/1 in.	CHECKED - RO	REVISED - 9/27/2016
PLOT DATE = 11/14/2017	DATE - 11/15/17	REVISED -

STATE OF ILLINOIS
DEPARTMENT OF TRANSPORTATION


TYPICAL SECTIONS
HOT-MIX ASPHALT MIXTURE REQUIREMENTS

SCALE: NTS SHEET 4 OF 13 SHEETS STA. TO STA.

F.A.P. RTE.	SECTION	COUNTY	TOTAL SHEETS	SHEET NO.
856	14-00170-42-RP	WILL	394	19
			CONTRACT NO. 61D47	
ILLINOIS FED. AID PROJECT				

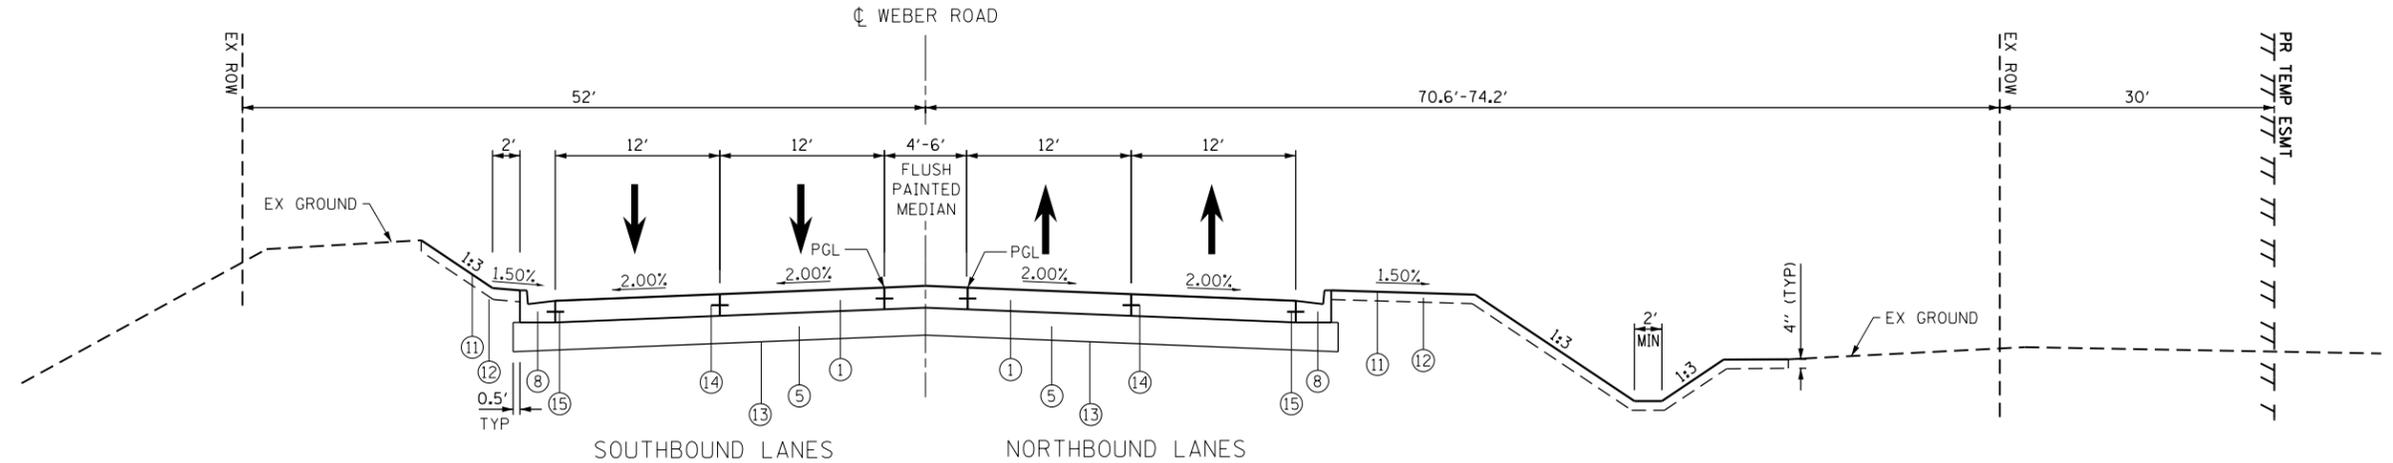

PROPOSED TYPICAL SECTION 1
 STA 736+25.00 TO STA 736+90.28, WEBER ROAD

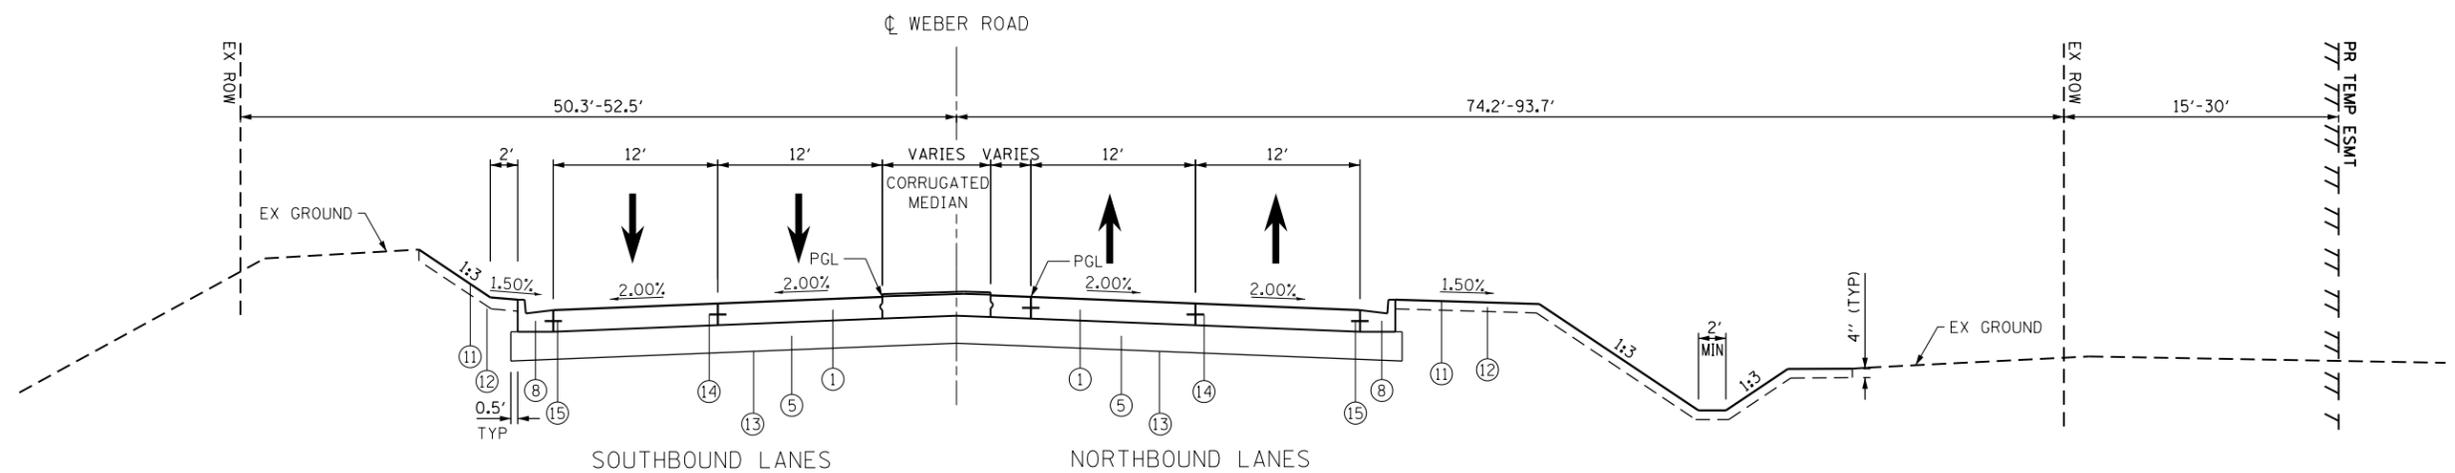

PROPOSED TYPICAL SECTION 2
 STA 736+90.28 TO STA 739+85.96, WEBER ROAD

PROPOSED LEGEND:

- ① PORTLAND CEMENT CONCRETE PAVEMENT (JOINTED), 10"
- ② HOT-MIX ASPHALT SURFACE COURSE, MIX "D", N70, 2"
- ③ HOT-MIX ASPHALT BASE COURSE, IL-19.0, N70, 5 1/4"
- ④ HOT-MIX ASPHALT BASE COURSE, IL-19.0, N70, 8 1/4"
- ⑤ AGGREGATE SUBGRADE IMPROVEMENT, 12"
- ⑥ COMBINATION CONCRETE CURB & GUTTER, TYPE B-6.12
- ⑦ COMBINATION CONCRETE CURB & GUTTER, TYPE B-6.18
- ⑧ COMBINATION CONCRETE CURB & GUTTER, TYPE B-6.24
- ⑨ PCC SIDEWALK
 - (A) PORTLAND CEMENT CONCRETE SIDEWALK, 5"
 - (B) SUBBASE GRANULAR MATERIAL, TYPE B 4"
- ⑩ SHARED-USE PATH
 - (A) HOT-MIX ASPHALT SURFACE COURSE, MIX "D", N50, 3"
 - (B) AGGREGATE BASE COURSE TYPE B, 6"
- ⑪ SEEDING OR SODDING, FERTILIZER, AND EROSION CONTROL BLANKET
- ⑫ TOPSOIL EXCAVATION AND PLACEMENT
- ⑬ GEOTECHNICAL FABRIC FOR GROUND STABILIZATION - SEE NOTE 1
- ⑭ LONGITUDINAL CONSTRUCTION JOINT, NO. 6 TIE BAR, DEFORMED (EPOXY COATED) REFER TO STANDARD 420001-08 FOR DETAILS (TO BE INCLUDED IN THE COST OF PROPOSED PAVEMENT)
- ⑮ NO. 6 TIE BAR, DEFORMED (EPOXY COATED) REFER TO STANDARD 606001-06 FOR DETAILS (TO BE INCLUDED IN THE COST OF CURB AND GUTTER)
- ⑯ NOISE ABATEMENT WALL, GROUND MOUNTED
- ⑰ CONCRETE RETAINING WALL
- ⑱ BICYCLE RAILING
- ⑲ PIPE UNDERDRAINS, TYPE 2, 6"
- ⑳ BITUMINOUS TACK COAT BETWEEN LIFTS
- ㉑ CONCRETE BARRIER MEDIAN

- NOTES**
1. GEOTECHNICAL FABRIC FOR GROUND STABILIZATION IS PLACED BENEATH THE AGGREGATE SUBGRADE IMPROVEMENT AND THE EXISTING SUBGRADE AT THE UNDERCUT AREAS. REFER TO CROSS SECTIONS AND P&P FOR UNDERCUT AREAS AND ADDITIONAL INFO.
 2. GUTTER FLAG THICKNESS SHALL MATCH THE ADJACENT PAVEMENT THICKNESS AT ALL LOCATIONS.
 3. SEE CROSS SECTIONS FOR GRADING INFORMATION.
 4. REFER TO DRAINAGE PLAN AND PROFILES FOR LOCATIONS OF REVERSE PITCHED GUTTER.
 5. SEE LANDSCAPING PLANS FOR SEEDING AND SODDING INFORMATION.
 6. SEE PLAT OF HIGHWAYS FOR RIGHT-OF-WAY INFORMATION.

STRUCTURAL DESIGN TRAFFIC	YEAR: 2030
PV = 47,160 SU = 2,535 MU = 1,015	
ROAD STREET CLASSIFICATION:	CLASS I
PERCENT OF STRUCTURAL DESIGN TRAFFIC IN DESIGN LANE:	
PV = 8% SU = 37% MU = 37%	
TRAFFIC FACTOR:	ACTUAL TF 7.94 AC TYPE =
	MINIMUM TF 4.13
AC GRADE: BINDER =	SURFACE =
SUBGRADE SUPPORT RATING:	
SSR =	STA. TO STA.

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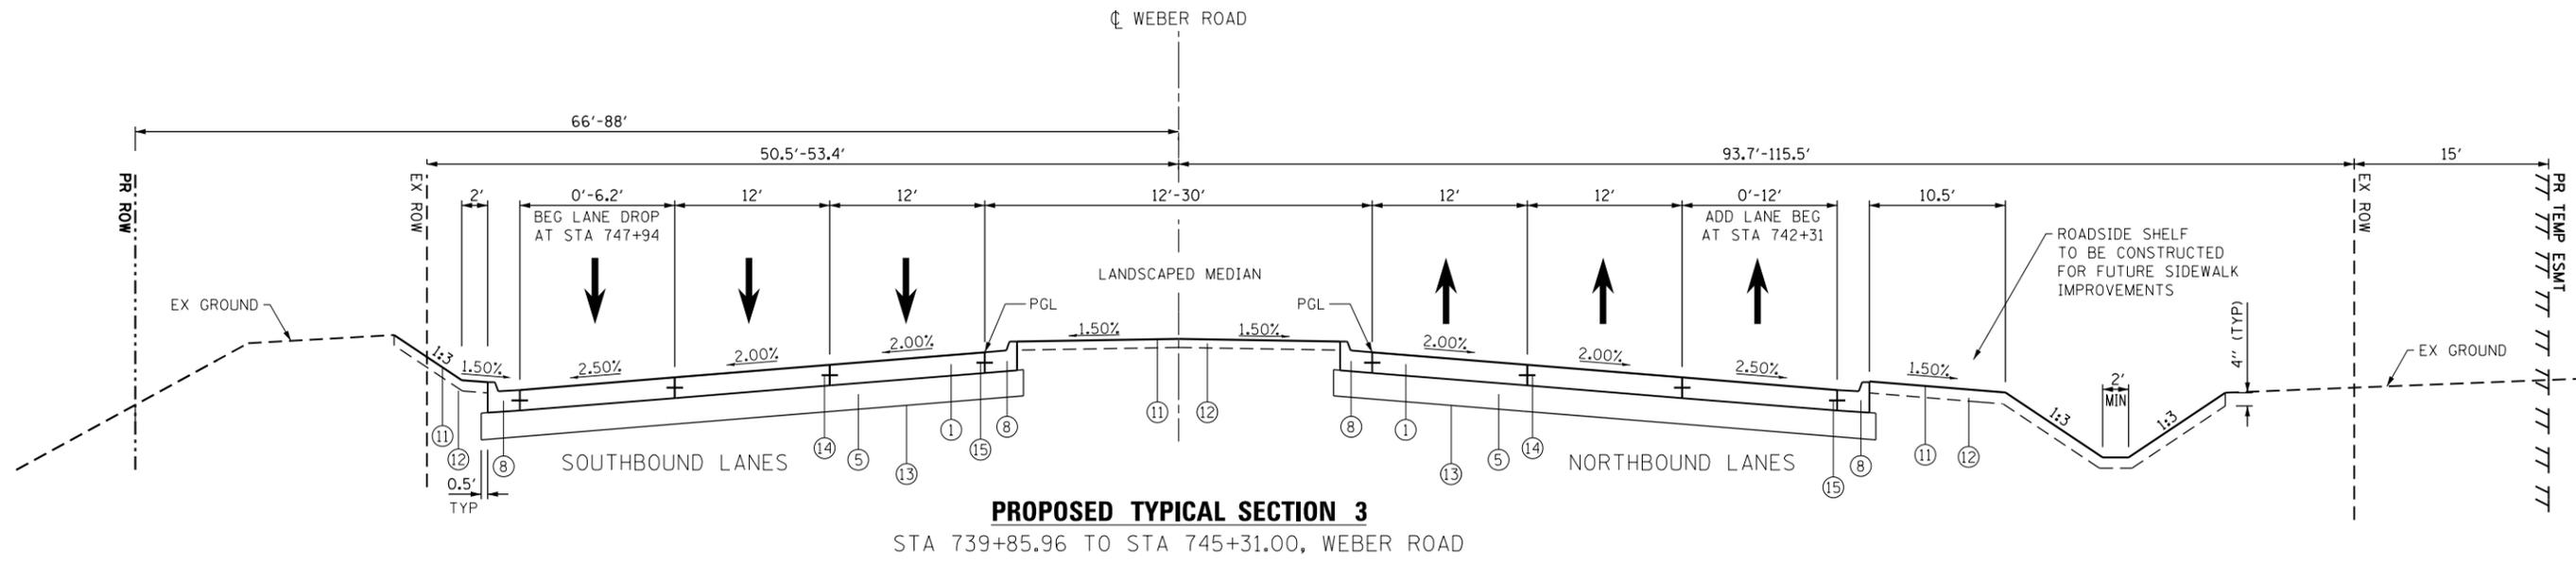


USER NAME = TEG	DESIGNED - VJM	REVISED - 3/3/2015
	DRAWN - VJM	REVISED - 6/19/2015
PLOT SCALE = 13.3332' / 1"	CHECKED - RO	REVISED - 9/27/2016
PLOT DATE = 11/14/2017	DATE - 11/15/17	REVISED -


**STATE OF ILLINOIS
 DEPARTMENT OF TRANSPORTATION**

TYPICAL SECTIONS PROPOSED WEBER ROAD	
SCALE: NTS	SHEET 5 OF 13 SHEETS STA. TO STA.

F.A.P. RTE.	SECTION	COUNTY	TOTAL SHEETS	SHEET NO.
856	14-00170-42-RP	WILL	394	20
CONTRACT NO. 61D47				
ILLINOIS FED. AID PROJECT				



PROPOSED TYPICAL SECTION 3
STA 739+85.96 TO STA 745+31.00, WEBER ROAD

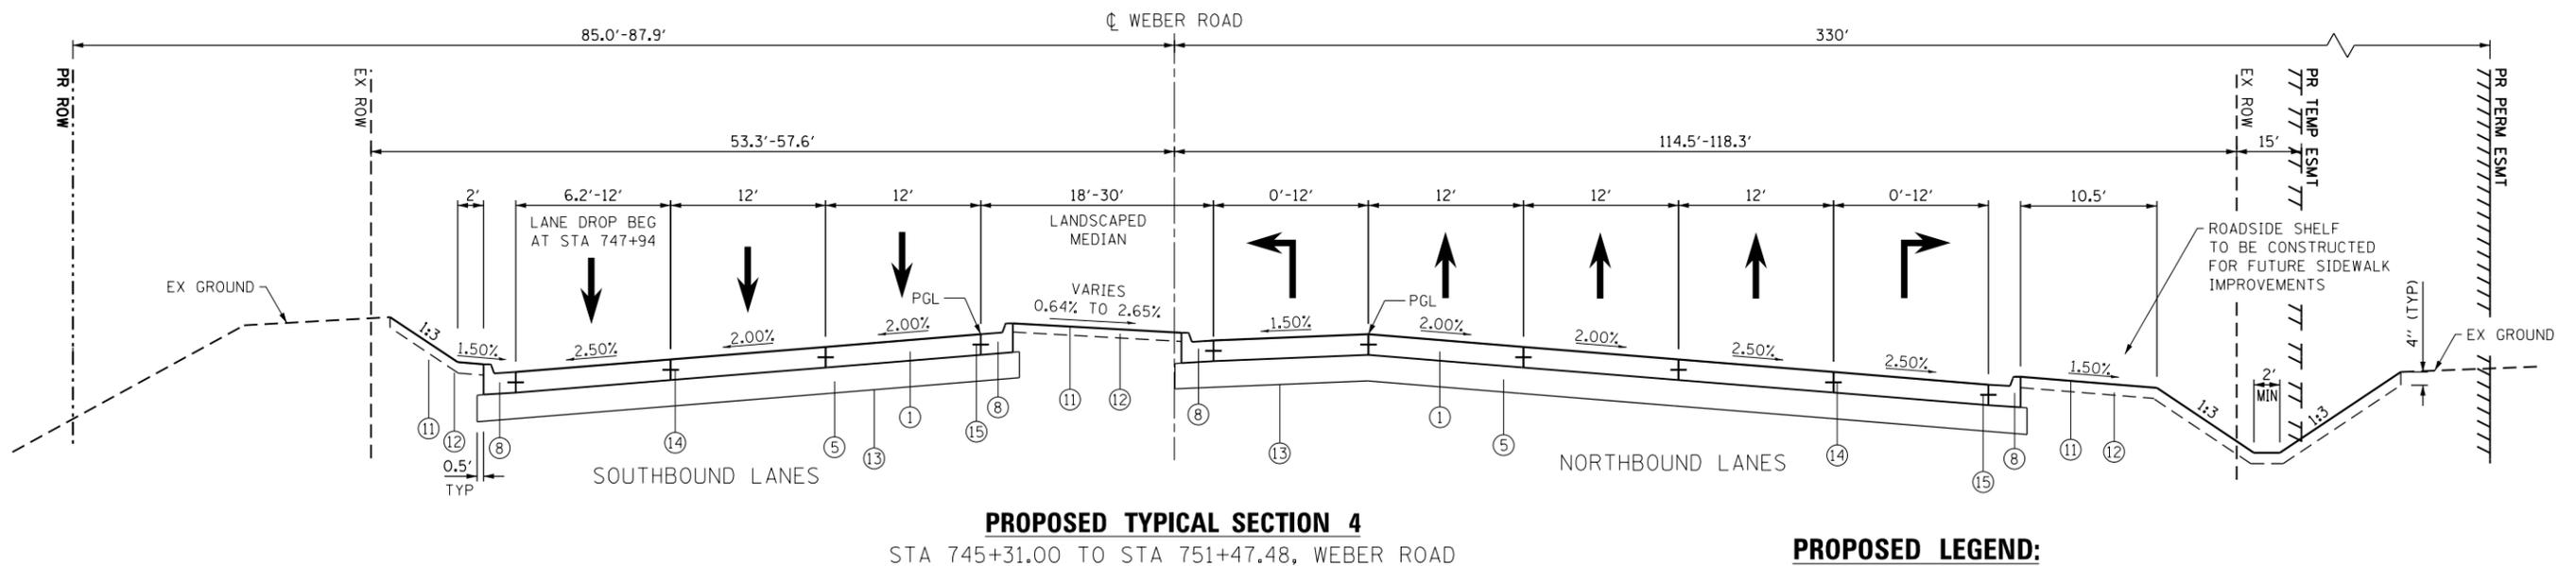

PROPOSED TYPICAL SECTION 4
STA 745+31.00 TO STA 751+47.48, WEBER ROAD

PROPOSED LEGEND:


- ① PORTLAND CEMENT CONCRETE PAVEMENT (JOINTED), 10"
- ② HOT-MIX ASPHALT SURFACE COURSE, MIX "D", N70, 2"
- ③ HOT-MIX ASPHALT BASE COURSE, IL-19.0, N70, 5 1/4"
- ④ HOT-MIX ASPHALT BASE COURSE, IL-19.0, N70, 8 1/4"
- ⑤ AGGREGATE SUBGRADE IMPROVEMENT, 12"
- ⑥ COMBINATION CONCRETE CURB & GUTTER, TYPE B-6.12
- ⑦ COMBINATION CONCRETE CURB & GUTTER, TYPE B-6.18
- ⑧ COMBINATION CONCRETE CURB & GUTTER, TYPE B-6.24
- ⑨ PCC SIDEWALK
 - (A) PORTLAND CEMENT CONCRETE SIDEWALK, 5"
 - (B) SUBBASE GRANULAR MATERIAL, TYPE B 4"
- ⑩ SHARED-USE PATH
 - (A) HOT-MIX ASPHALT SURFACE COURSE, MIX "D", N50, 3"
 - (B) AGGREGATE BASE COURSE TYPE B, 6"
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- ⑫ TOPSOIL EXCAVATION AND PLACEMENT
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- ⑭ LONGITUDINAL CONSTRUCTION JOINT, NO. 6 TIE BAR, DEFORMED (EPOXY COATED) REFER TO STANDARD 420001-08 FOR DETAILS (TO BE INCLUDED IN THE COST OF PROPOSED PAVEMENT)
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- ⑯ NOISE ABATEMENT WALL, GROUND MOUNTED
- ⑰ CONCRETE RETAINING WALL
- ⑱ BICYCLE RAILING
- ⑲ PIPE UNDERDRAINS, TYPE 2, 6"
- ⑳ BITUMINOUS TACK COAT BETWEEN LIFTS
- ㉑ CONCRETE BARRIER MEDIAN

NOTES

1. GEOTECHNICAL FABRIC FOR GROUND STABILIZATION IS PLACED BENEATH THE AGGREGATE SUBGRADE IMPROVEMENT AND THE EXISTING SUBGRADE AT THE UNDERCUT AREAS. REFER TO CROSS SECTIONS AND P&P FOR UNDERCUT AREAS AND ADDITIONAL INFO.
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3. SEE CROSS SECTIONS FOR GRADING INFORMATION.
4. REFER TO DRAINAGE PLAN AND PROFILES FOR LOCATIONS OF REVERSE PITCHED GUTTER.
5. SEE LANDSCAPING PLANS FOR SEEDING AND SODDING INFORMATION.
6. SEE PLAT OF HIGHWAYS FOR RIGHT-OF-WAY INFORMATION.

STRUCTURAL DESIGN TRAFFIC	YEAR: 2030
PV = 47,160 SU = 2,535 MU = 1,015	
ROAD STREET CLASSIFICATION: CLASS I	
PERCENT OF STRUCTURAL DESIGN TRAFFIC IN DESIGN LANE:	
PV = 8% SU = 37% MU = 37%	
TRAFFIC FACTOR: ACTUAL TF 7.94 AC TYPE =	
MINIMUM TF 4.13	
AC GRADE: BINDER = SURFACE =	
SUBGRADE SUPPORT RATING: SSR = STA. TO STA.	


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** COMBINATION CONCRETE CURB AND GUTTER B-6.12 IS FROM STA 752+24.00 TO STA 755+54.00
 COMBINATION CONCRETE CURB AND GUTTER B-6.24 IS FROM STA 755+54.00 TO STA 760+59.00

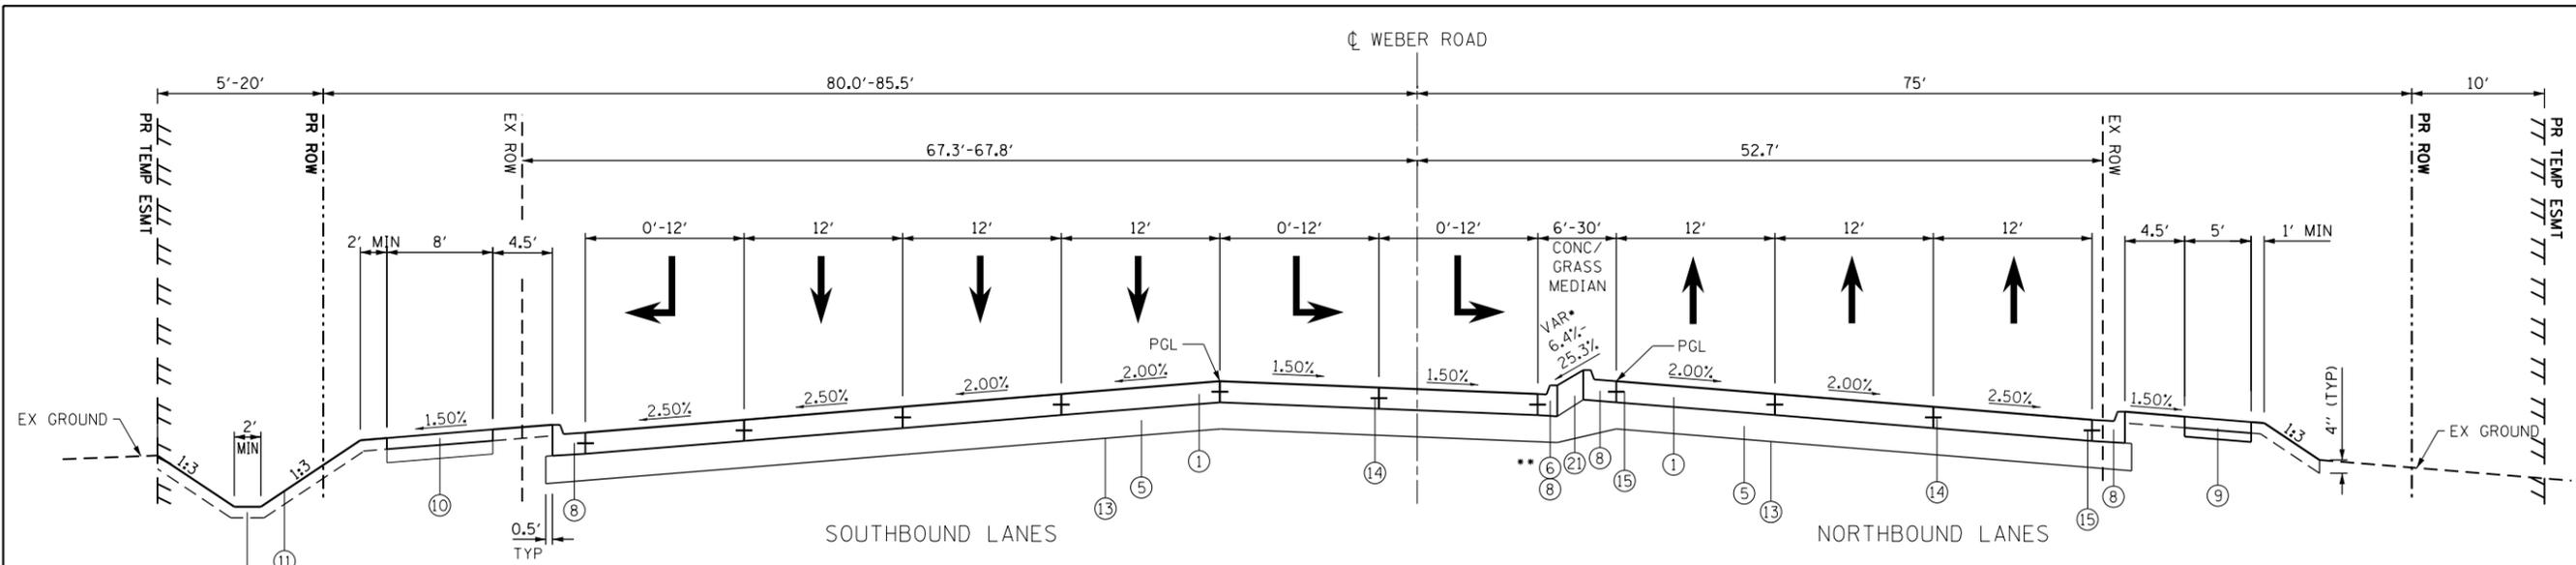PROPOSED TYPICAL SECTION 5
 STA 751+47.48 TO STA 760+59.00, WEBER ROAD

*RANGE OF CROSS SLOPES IS FOR THE CONCRETE MEDIAN PORTION ONLY
 REFER TO CROSS SECTIONS FOR DETAILS



PROPOSED TYPICAL SECTION 6
 STA 760+59.00 TO STA 765+20.51, WEBER ROAD

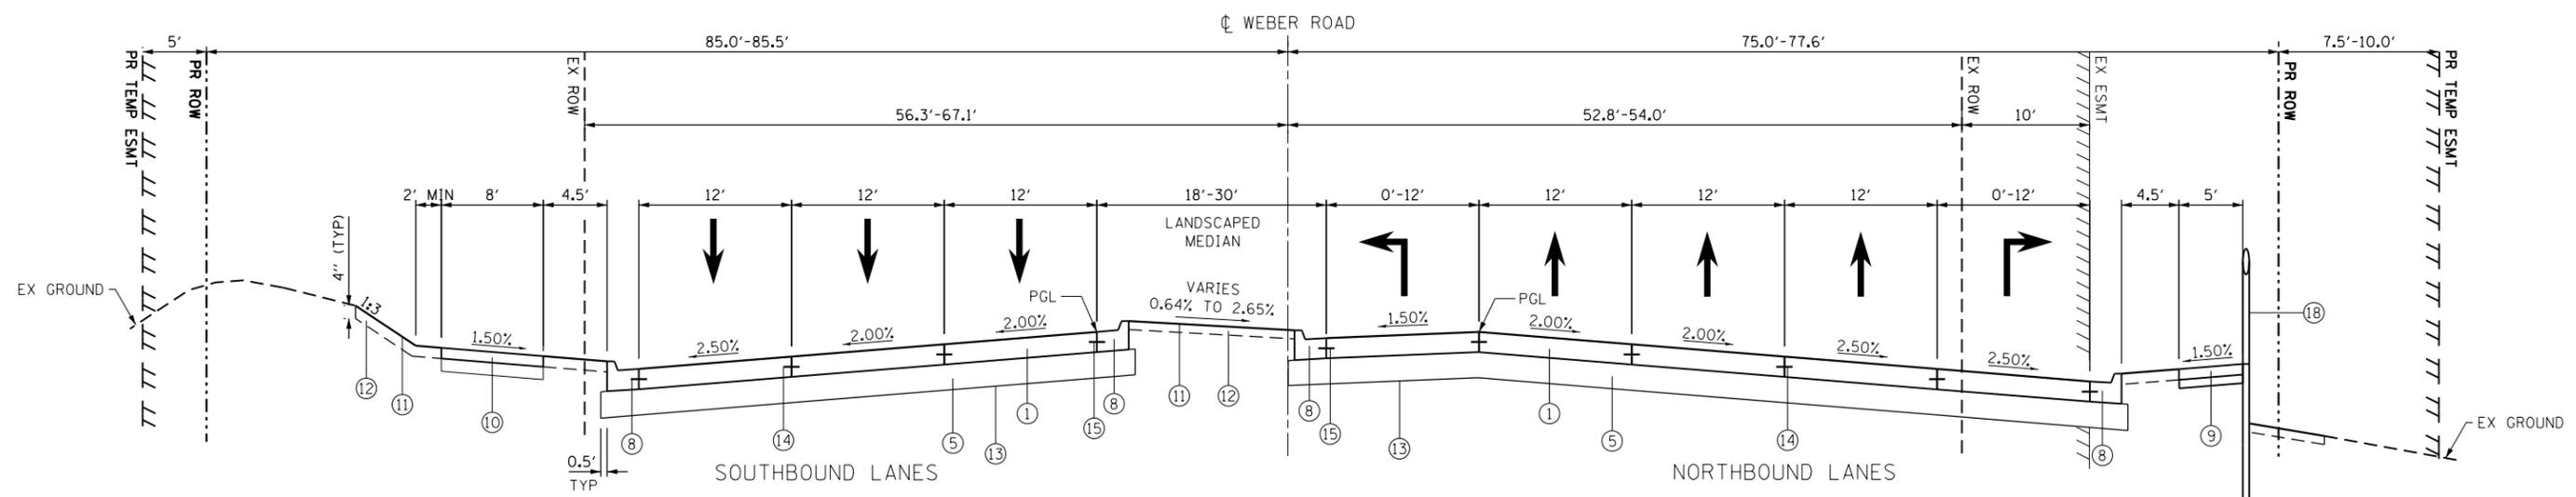PROPOSED LEGEND:

*CONCRETE RETAINING WALL AND BICYCLE RAILING FROM STA 763+15.00 TO STA 764+30.00
 SEE RETAINING WALL DETAIL

- NOTES**
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 5. SEE LANDSCAPING PLANS FOR SEEDING AND SODDING INFORMATION.
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STRUCTURAL DESIGN TRAFFIC	YEAR: 2030
PV = 47,160 SU = 2,535 MU = 1,015	
ROAD STREET CLASSIFICATION: CLASS I	
PERCENT OF STRUCTURAL DESIGN TRAFFIC IN DESIGN LANE:	
PV = 8% SU = 37% MU = 37%	
TRAFFIC FACTOR: ACTUAL TF 7.94 AC TYPE =	
MINIMUM TF 4.13	
AC GRADE: BINDER = SURFACE =	
SUBGRADE SUPPORT RATING: SSR = STA. TO STA.	

- ① PORTLAND CEMENT CONCRETE PAVEMENT (JOINTED), 10"
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- ④ HOT-MIX ASPHALT BASE COURSE, IL-19.0, N70, 8/4"
- ⑤ AGGREGATE SUBGRADE IMPROVEMENT, 12"
- ⑥ COMBINATION CONCRETE CURB & GUTTER, TYPE B-6.12
- ⑦ COMBINATION CONCRETE CURB & GUTTER, TYPE B-6.18
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- ⑨ PCC SIDEWALK
 - (A) PORTLAND CEMENT CONCRETE SIDEWALK, 5"
 - (B) SUBBASE GRANULAR MATERIAL, TYPE B 4"
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 - (A) HOT-MIX ASPHALT SURFACE COURSE, MIX "D", N50, 3"
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- ⑰ CONCRETE RETAINING WALL
- ⑱ BICYCLE RAILING
- ⑲ PIPE UNDERDRAINS, TYPE 2, 6"
- ⑳ BITUMINOUS TACK COAT BETWEEN LIFTS
- ㉑ CONCRETE BARRIER MEDIAN

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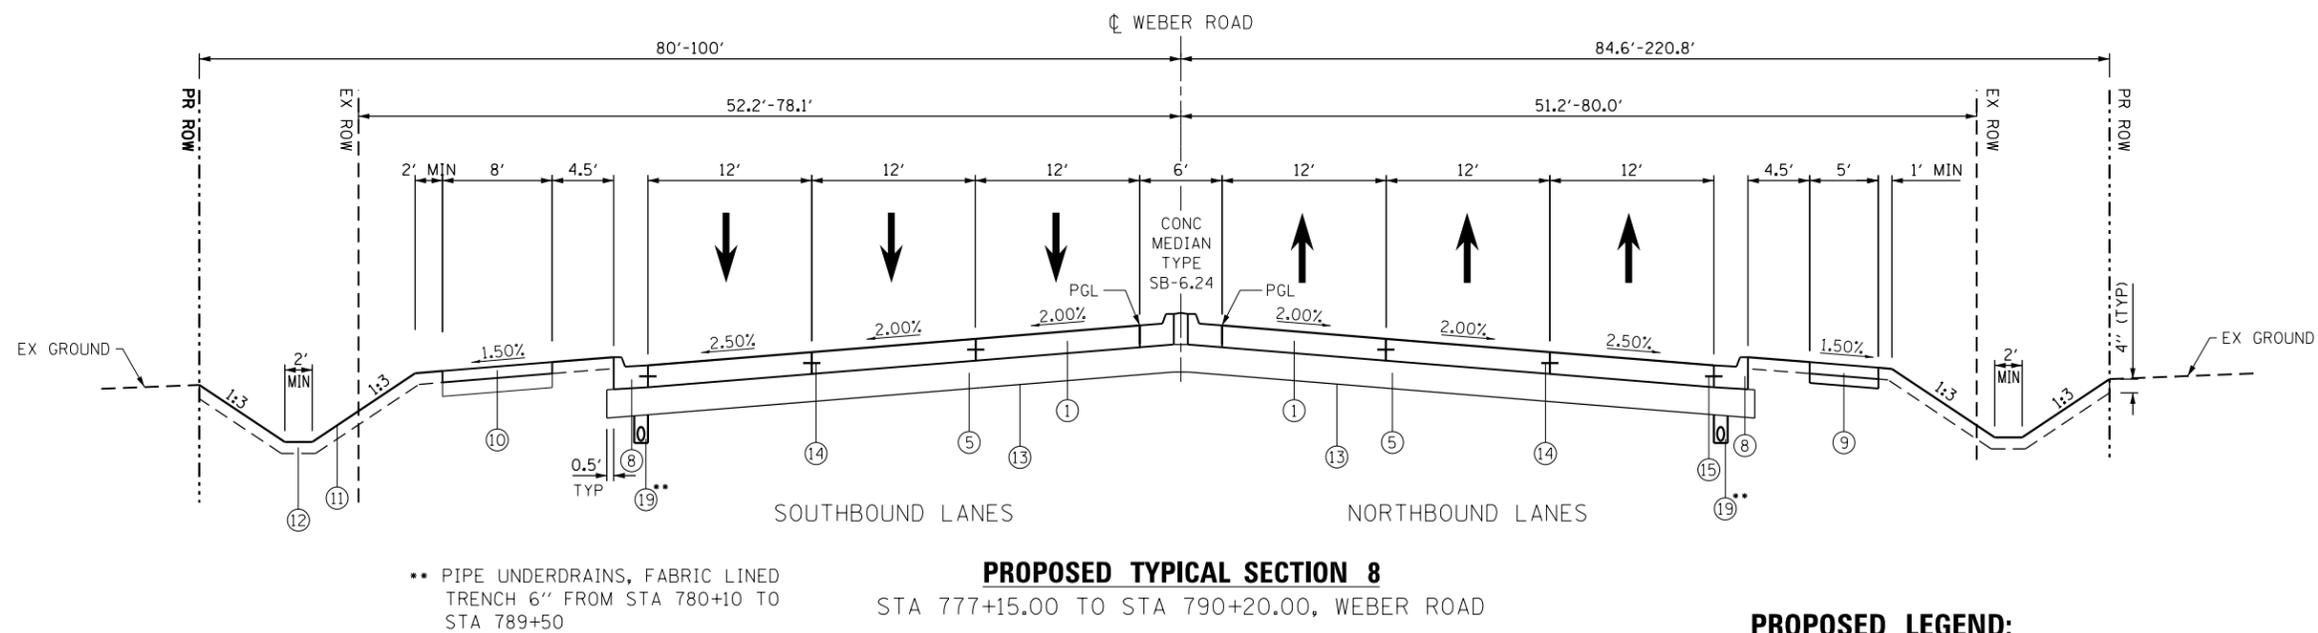
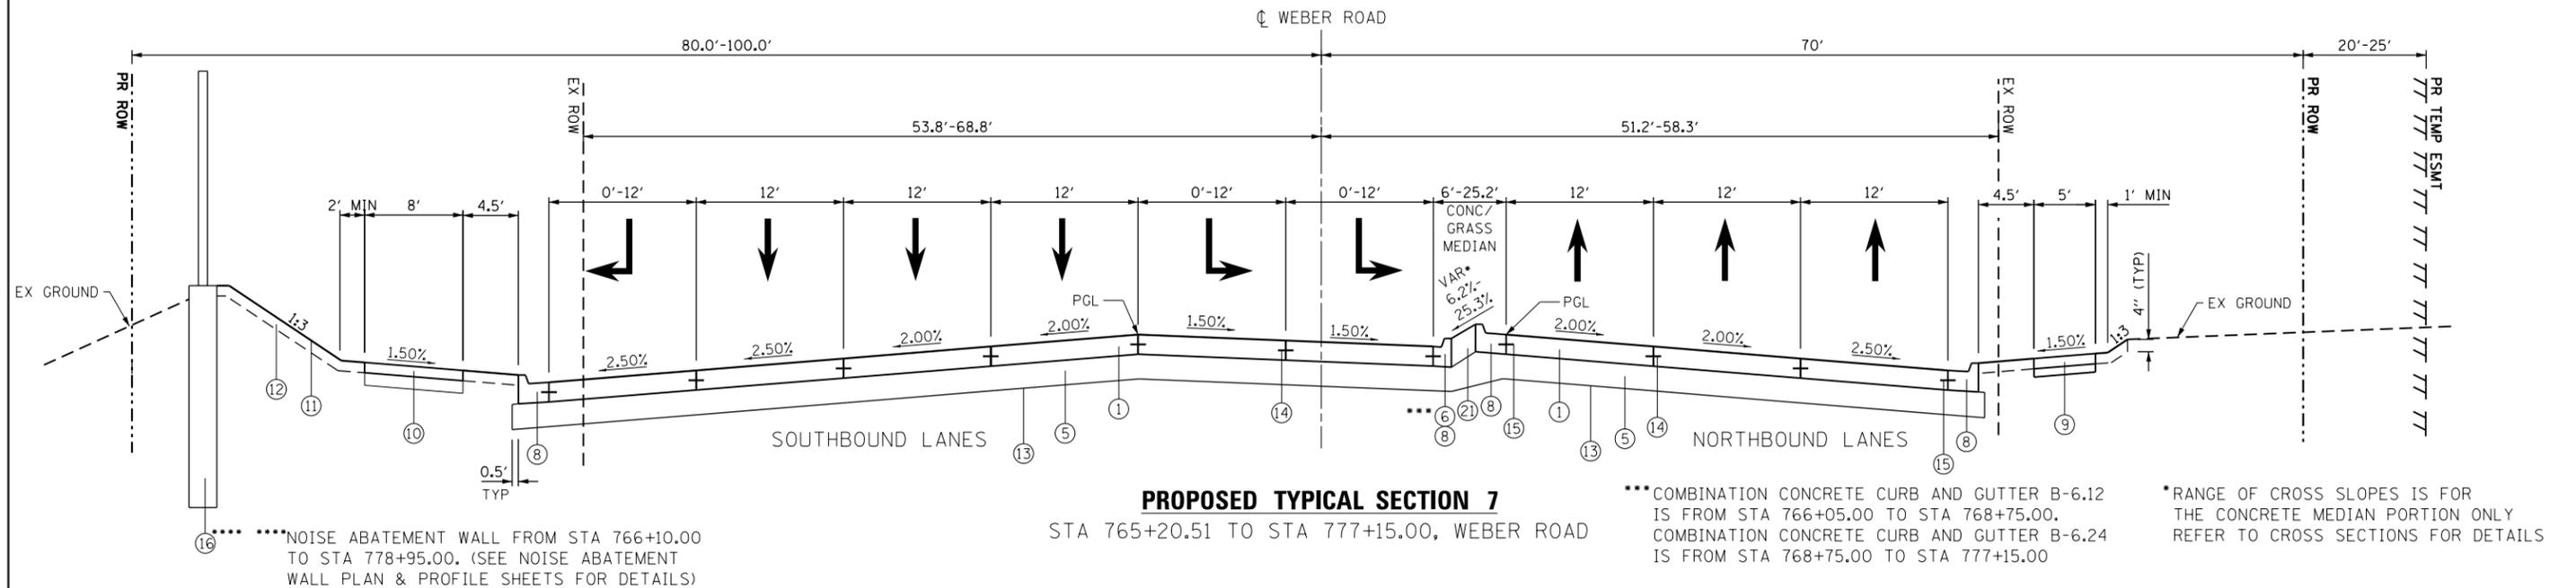


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	DRAWN - VJM	REVISED - 6/19/2015
PLOT SCALE = 13.3332 1/16"	CHECKED - RO	REVISED - 9/27/2016
PLOT DATE = 11/14/2017	DATE - 11/15/17	REVISED -

STATE OF ILLINOIS
 DEPARTMENT OF TRANSPORTATION

TYPICAL SECTIONS	
PROPOSED WEBER ROAD	
SCALE: NTS	SHEET 7 OF 13 SHEETS STA. TO STA.

F.A.P. RTE.	SECTION	COUNTY	TOTAL SHEETS	SHEET NO.
856	14-00170-42-RP	WILL	394	22
CONTRACT NO. 61D47				
ILLINOIS FED. AID PROJECT				



PROPOSED LEGEND:


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- ㉑ CONCRETE BARRIER MEDIAN

NOTES

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5. SEE LANDSCAPING PLANS FOR SEEDING AND SODDING INFORMATION.
6. SEE PLAT OF HIGHWAYS FOR RIGHT-OF-WAY INFORMATION.

STRUCTURAL DESIGN TRAFFIC	YEAR: 2030	
PV = 47,160	SU = 2,535	MU = 1,015
ROAD STREET CLASSIFICATION: CLASS I		
PERCENT OF STRUCTURAL DESIGN TRAFFIC IN DESIGN LANE:		
PV = 8%	SU = 37%	MU = 37%
TRAFFIC FACTOR:	ACTUAL TF 7.94	AC TYPE =
	MINIMUM TF 4.13	
AC GRADE:	BINDER =	SURFACE =
SUBGRADE SUPPORT RATING:	SSR =	STA. TO STA

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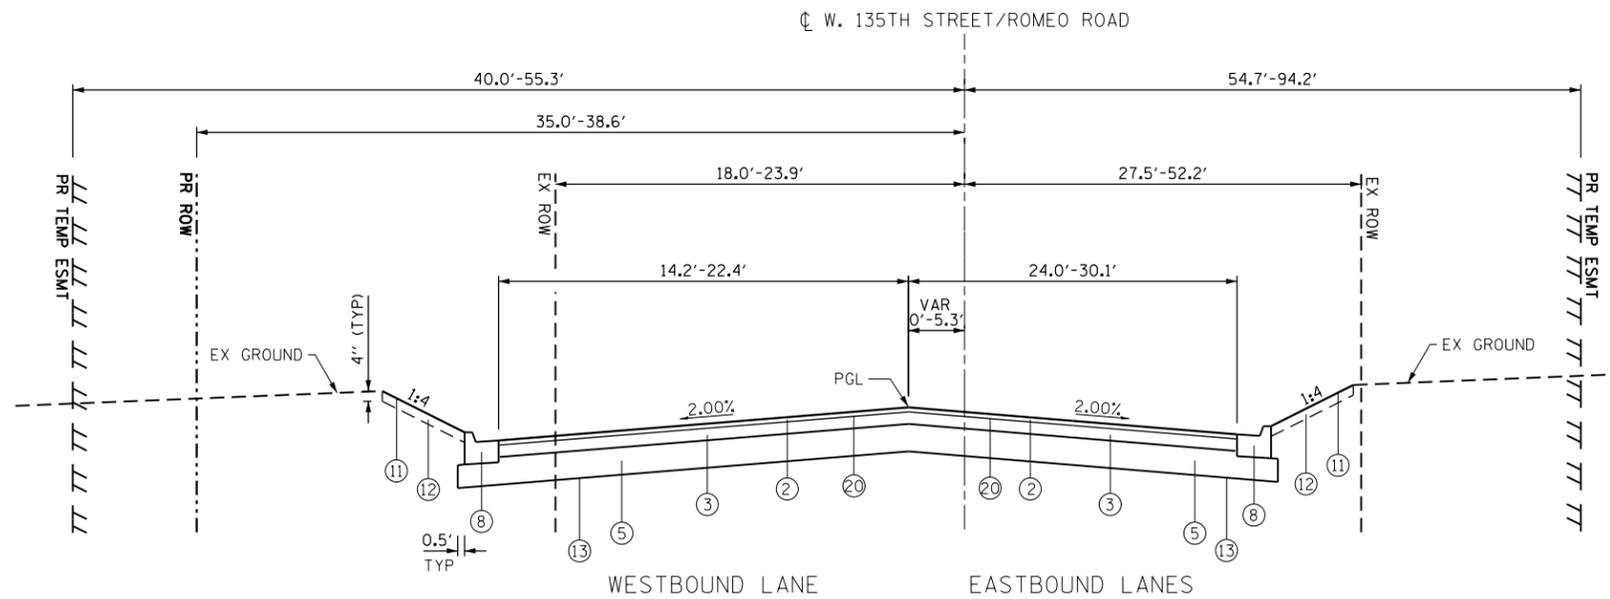
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	DRAWN - VJM	REVISED - 6/19/2015
PLOT SCALE = 13.3332 "/>	CHECKED - RO	REVISED - 9/27/2016
PLOT DATE = 11/14/2017	DATE - 11/15/17	REVISED -

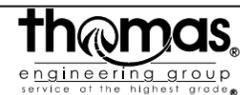STATE OF ILLINOIS
 DEPARTMENT OF TRANSPORTATION

TYPICAL SECTIONS
 PROPOSED WEBER ROAD


SCALE: NTS SHEET 8 OF 13 SHEETS STA. TO STA.

F.A.P. RTE.	SECTION	COUNTY	TOTAL SHEETS	SHEET NO.
856	14-00170-42-RP	WILL	394	23
CONTRACT NO. 61D47				
ILLINOIS FED. AID PROJECT				



PROPOSED TYPICAL SECTION 9

STA 111+90.00 TO STA 112+90.00, W 135TH STREET/ROMEO ROAD

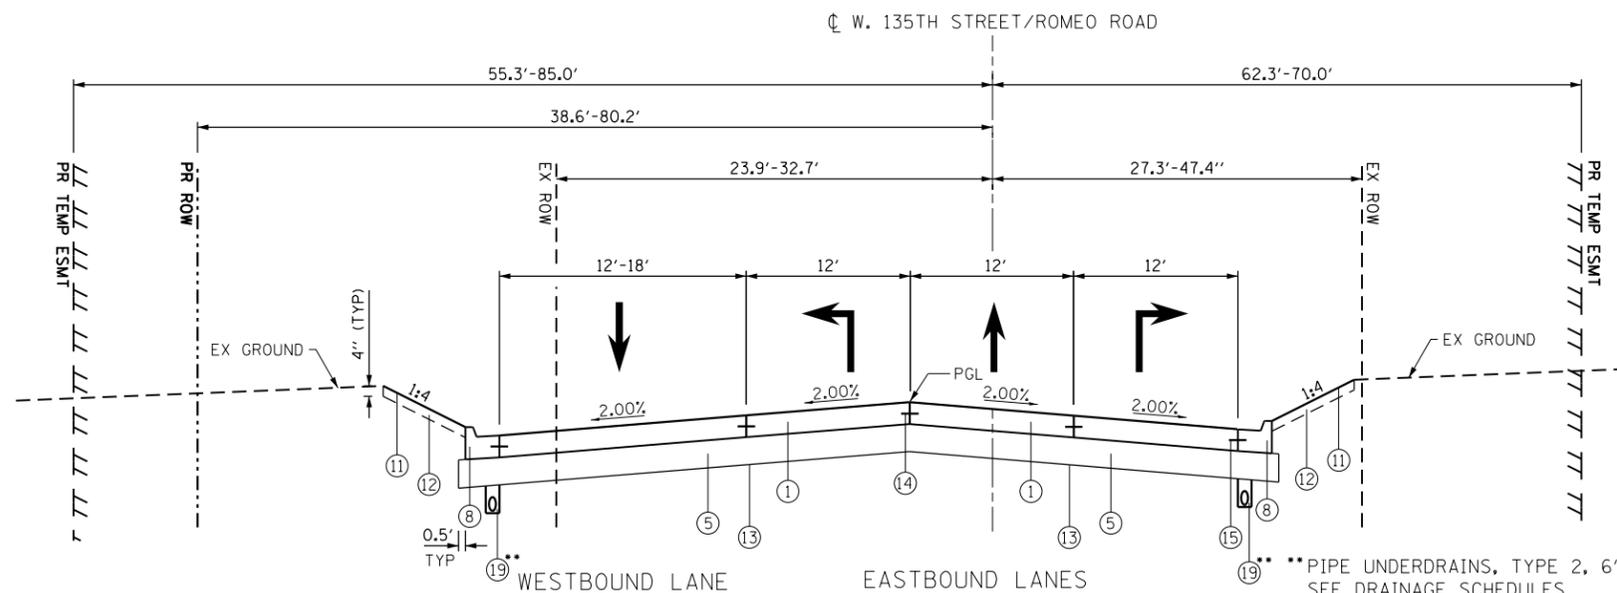

PROPOSED TYPICAL SECTION 10

STA 112+90.00 TO STA 115+36.58, W 135TH STREET/ROMEO ROAD

***PIPE UNDERDRAINS, TYPE 2, 6"
SEE DRAINAGE SCHEDULES
FOR STATIONS AND LOCATIONS.

PROPOSED LEGEND:


NOTES

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6. SEE PLAT OF HIGHWAYS FOR RIGHT-OF-WAY INFORMATION.

STRUCTURAL DESIGN TRAFFIC	YEAR: 2030
PV = 47,160 SU = 2,535 MU = 1,015	
ROAD STREET CLASSIFICATION: CLASS I	
PERCENT OF STRUCTURAL DESIGN TRAFFIC IN DESIGN LANE:	
PV = 8% SU = 37% MU = 37%	
TRAFFIC FACTOR: ACTUAL TF 7.94 AC TYPE =	
MINIMUM TF 4.13	
AC GRADE: BINDER = SURFACE =	
SUBGRADE SUPPORT RATING: SSR = STA. TO STA.	

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- ⑨ PCC SIDEWALK
 - (A) PORTLAND CEMENT CONCRETE SIDEWALK, 5"
 - (B) SUBBASE GRANULAR MATERIAL, TYPE B 4"
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 - (A) HOT-MIX ASPHALT SURFACE COURSE, MIX "D", N50, 3"
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- ⑱ BICYCLE RAILING
- ⑲ PIPE UNDERDRAINS, TYPE 2, 6"
- ⑳ BITUMINOUS TACK COAT BETWEEN LIFTS
- ㉑ CONCRETE BARRIER MEDIAN

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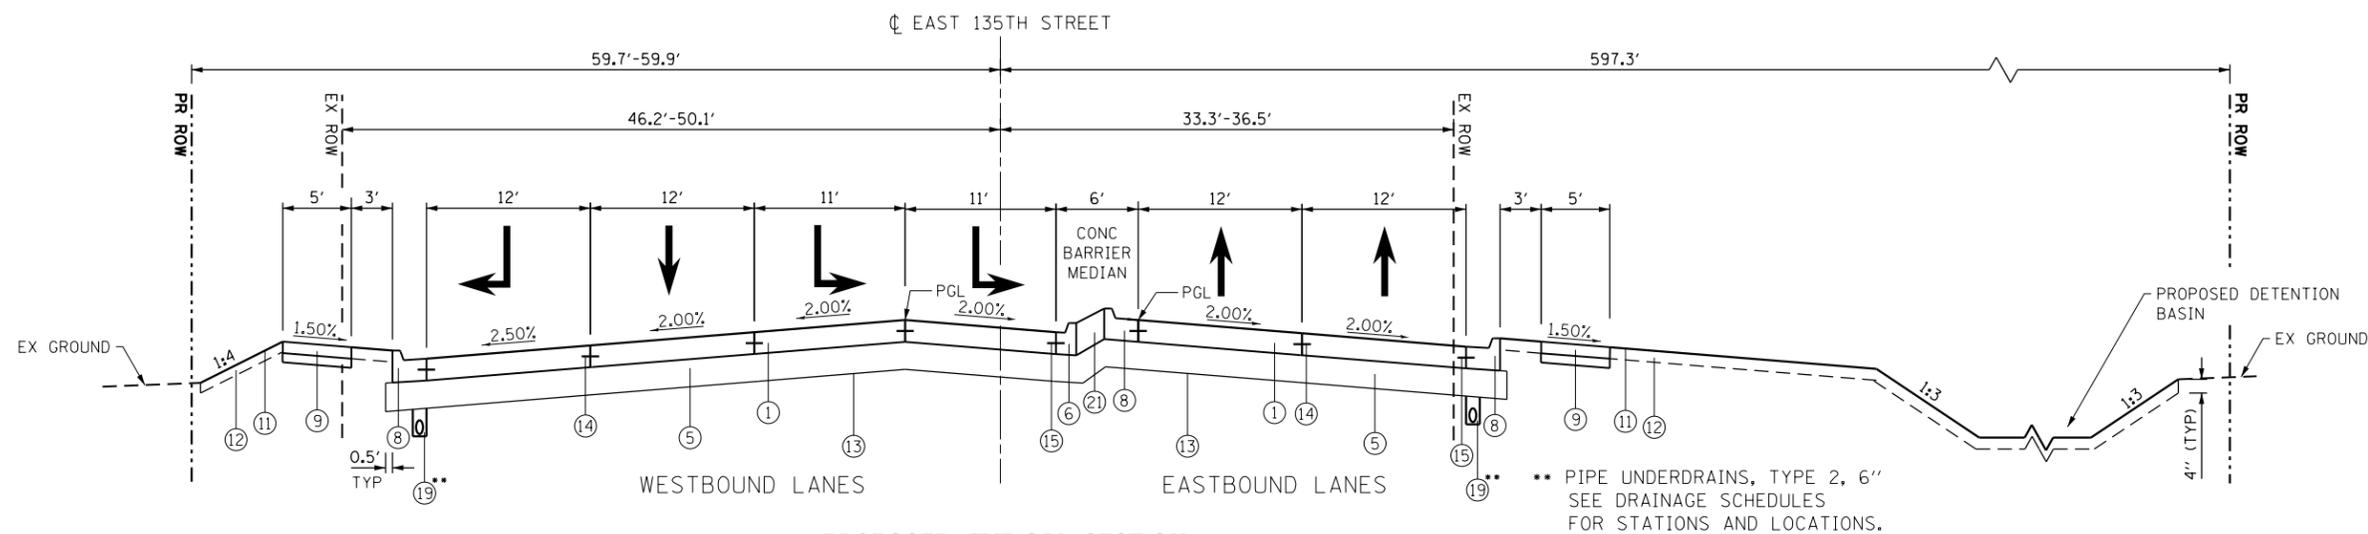

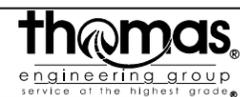
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	DRAWN - VJM	REVISED - 6/19/2015
PLOT SCALE = 13.3332' / 1"	CHECKED - RO	REVISED - 9/27/2016
PLOT DATE = 11/14/2017	DATE - 11/15/17	REVISED -

STATE OF ILLINOIS
DEPARTMENT OF TRANSPORTATION

TYPICAL SECTIONS	
PROPOSED 135TH STREET /ROMEO ROAD	
SCALE: NTS	SHEET 9 OF 13 SHEETS STA. TO STA.

F.A.P. RTE.	SECTION	COUNTY	TOTAL SHEETS	SHEET NO.
856	14-00170-42-RP	WILL	394	24
CONTRACT NO. 61D47				
ILLINOIS FED. AID PROJECT				



PROPOSED TYPICAL SECTION 11
 STA 115+36.58 TO STA 117+60.00, E 135TH STREET/ROMEO ROAD

** PIPE UNDERDRAINS, TYPE 2, 6"
 SEE DRAINAGE SCHEDULES
 FOR STATIONS AND LOCATIONS.

PROPOSED LEGEND:

NOTES

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STRUCTURAL DESIGN TRAFFIC	YEAR: 2030
PV = 47,160 SU = 2,535 MU = 1,015	
ROAD STREET CLASSIFICATION: CLASS I	
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MINIMUM TF 4.13	
AC GRADE: BINDER = SURFACE =	
SUBGRADE SUPPORT RATING: SSR = STA. TO STA.	

- | | |
|--------------------------------------------------------------------------------------------------------------------------------------------------------------------------------------------------------------------------------------------------------------------------------------------------------------------------------------------------------------------------------------------------------------------------------------------------------------------------------------------------------------------------------------------------------------------------------------------------------------------------------------------------------------------------------------------------------------------------------------------------------------------------------------------------------------------------------------------------------------------------------------------------------------------|------------------------------------------------------------------------------------------------------------------------------------------------------------------------------------------------------------------------------------------------------------------------------------------------------------------------------------------------------------------------------------------------------------------------------------------------------------------------------------------------------------------------------------------------------------------------------------------------------------------------------------------------------------------------------------------------------------------------------------------------------------------------------------------------|
| <ul style="list-style-type: none"> ① PORTLAND CEMENT CONCRETE PAVEMENT (JOINTED), 10" ② HOT-MIX ASPHALT SURFACE COURSE, MIX "D", N70, 2" ③ HOT-MIX ASPHALT BASE COURSE, IL-19.0, N70, 5 1/4" ④ HOT-MIX ASPHALT BASE COURSE, IL-19.0, N70, 8 1/4" ⑤ AGGREGATE SUBGRADE IMPROVEMENT, 12" ⑥ COMBINATION CONCRETE CURB & GUTTER, TYPE B-6.12 ⑦ COMBINATION CONCRETE CURB & GUTTER, TYPE B-6.18 ⑧ COMBINATION CONCRETE CURB & GUTTER, TYPE B-6.24 ⑨ PCC SIDEWALK <ul style="list-style-type: none"> (A) PORTLAND CEMENT CONCRETE SIDEWALK, 5" (B) SUBBASE GRANULAR MATERIAL, TYPE B 4" ⑩ SHARED-USE PATH <ul style="list-style-type: none"> (A) HOT-MIX ASPHALT SURFACE COURSE, MIX "D", N50, 3" (B) AGGREGATE BASE COURSE TYPE B, 6" | <ul style="list-style-type: none"> ⑪ SEEDING OR SODDING, FERTILIZER, AND EROSION CONTROL BLANKET ⑫ TOPSOIL EXCAVATION AND PLACEMENT ⑬ GEOTECHNICAL FABRIC FOR GROUND STABILIZATION - SEE NOTE 1 ⑭ LONGITUDINAL CONSTRUCTION JOINT, NO. 6 TIE BAR, DEFORMED (EPOXY COATED) REFER TO STANDARD 420001-08 FOR DETAILS (TO BE INCLUDED IN THE COST OF PROPOSED PAVEMENT) ⑮ NO. 6 TIE BAR, DEFORMED (EPOXY COATED) REFER TO STANDARD 606001-06 FOR DETAILS (TO BE INCLUDED IN THE COST OF CURB AND GUTTER) ⑯ NOISE ABATEMENT WALL, GROUND MOUNTED ⑰ CONCRETE RETAINING WALL ⑱ BICYCLE RAILING ⑲ PIPE UNDERDRAINS, TYPE 2, 6" ⑳ BITUMINOUS TACK COAT BETWEEN LIFTS ㉑ CONCRETE BARRIER MEDIAN |
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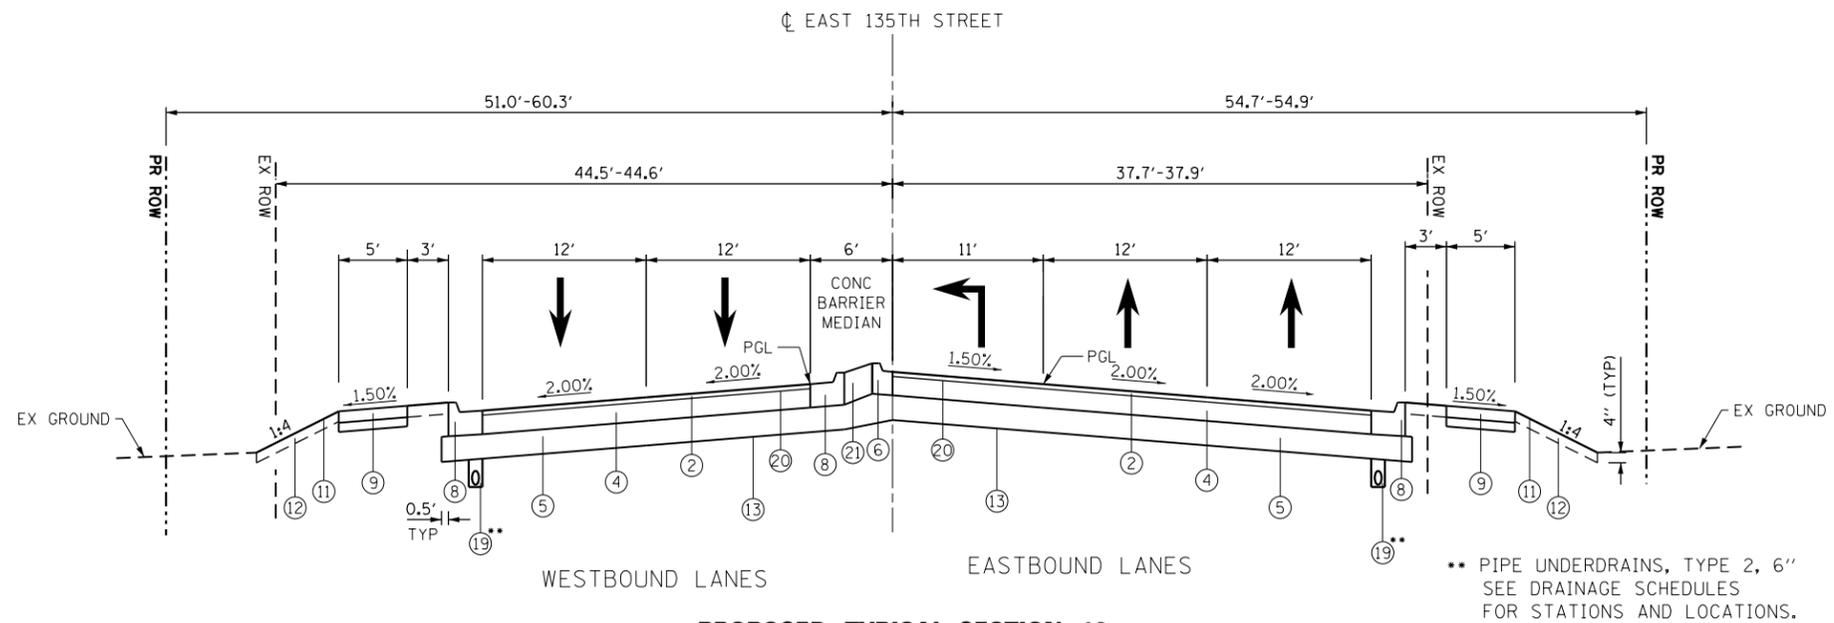


USER NAME = TEG	DESIGNED - VJM	REVISED - 3/3/2015
	DRAWN - VJM	REVISED - 6/19/2015
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PLOT DATE = 11/14/2017	DATE - 11/15/17	REVISED -

**STATE OF ILLINOIS
 DEPARTMENT OF TRANSPORTATION**


TYPICAL SECTIONS	
PROPOSED 135TH STREET /ROMEO ROAD	
SCALE: NTS	SHEET 10 OF 13 SHEETS STA. TO STA.

F.A.P. RTE.	SECTION	COUNTY	TOTAL SHEETS	SHEET NO.
856	14-00170-42-RP	WILL	394	25
CONTRACT NO. 61D47				
ILLINOIS FED. AID PROJECT				



PROPOSED TYPICAL SECTION 12
 STA 117+60.00 TO STA 121+83.00, E 135TH STREET/ROMEO ROAD

** PIPE UNDERDRAINS, TYPE 2, 6"
 SEE DRAINAGE SCHEDULES
 FOR STATIONS AND LOCATIONS.

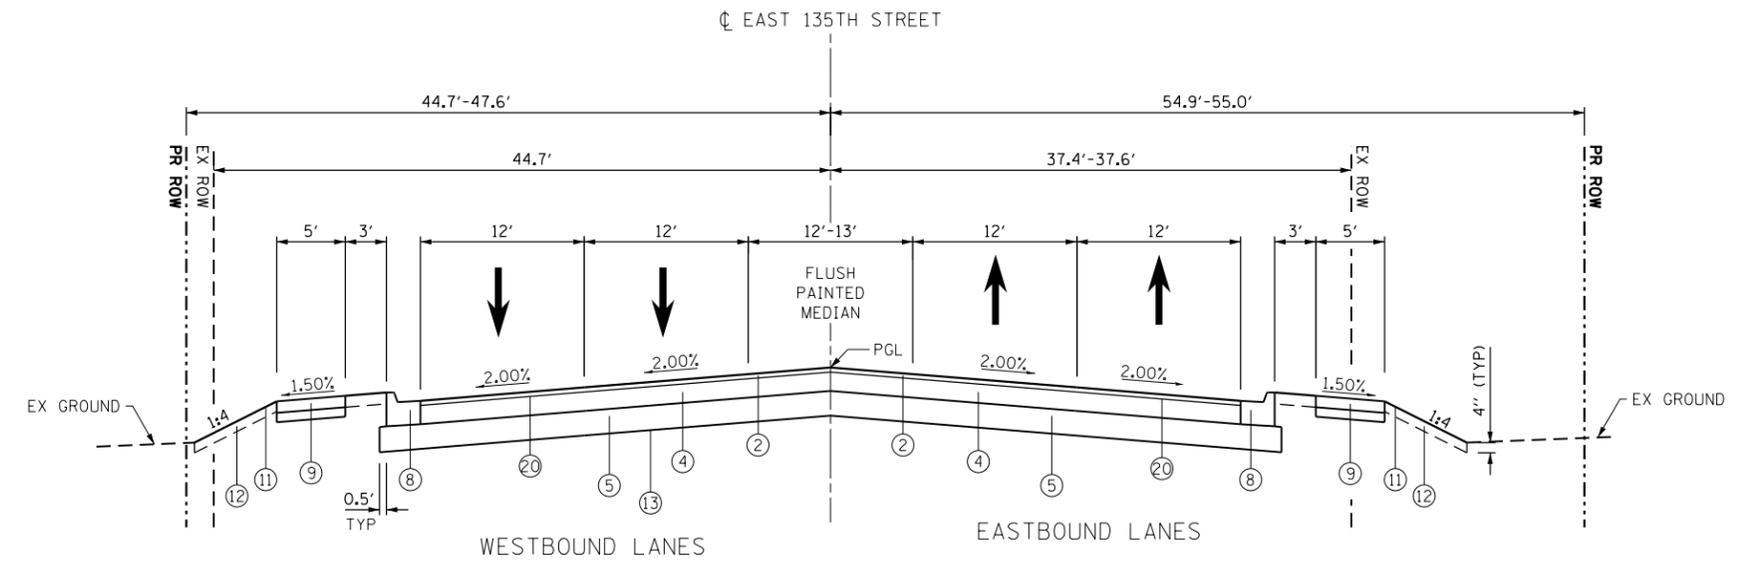

PROPOSED TYPICAL SECTION 13
 STA 121+83.00 TO STA 123+80.00, E 135TH STREET/ROMEO ROAD

PROPOSED LEGEND:


- ① PORTLAND CEMENT CONCRETE PAVEMENT (JOINTED), 10"
- ② HOT-MIX ASPHALT SURFACE COURSE, MIX "D", N70, 2"
- ③ HOT-MIX ASPHALT BASE COURSE, IL-19.0, N70, 5 1/4"
- ④ HOT-MIX ASPHALT BASE COURSE, IL-19.0, N70, 8 1/4"
- ⑤ AGGREGATE SUBGRADE IMPROVEMENT, 12"
- ⑥ COMBINATION CONCRETE CURB & GUTTER, TYPE B-6.12
- ⑦ COMBINATION CONCRETE CURB & GUTTER, TYPE B-6.18
- ⑧ COMBINATION CONCRETE CURB & GUTTER, TYPE B-6.24
- ⑨ PCC SIDEWALK
 - (A) PORTLAND CEMENT CONCRETE SIDEWALK, 5"
 - (B) SUBBASE GRANULAR MATERIAL, TYPE B 4"
- ⑩ SHARED-USE PATH
 - (A) HOT-MIX ASPHALT SURFACE COURSE, MIX "D", N50, 3"
 - (B) AGGREGATE BASE COURSE TYPE B, 6"
- ⑪ SEEDING OR SODDING, FERTILIZER, AND EROSION CONTROL BLANKET
- ⑫ TOPSOIL EXCAVATION AND PLACEMENT
- ⑬ GEOTECHNICAL FABRIC FOR GROUND STABILIZATION - SEE NOTE 1
- ⑭ LONGITUDINAL CONSTRUCTION JOINT, NO. 6 TIE BAR, DEFORMED (EPOXY COATED) REFER TO STANDARD 420001-08 FOR DETAILS (TO BE INCLUDED IN THE COST OF PROPOSED PAVEMENT)
- ⑮ NO. 6 TIE BAR, DEFORMED (EPOXY COATED) REFER TO STANDARD 606001-06 FOR DETAILS (TO BE INCLUDED IN THE COST OF CURB AND GUTTER)
- ⑯ NOISE ABATEMENT WALL, GROUND MOUNTED
- ⑰ CONCRETE RETAINING WALL
- ⑱ BICYCLE RAILING
- ⑲ PIPE UNDERDRAINS, TYPE 2, 6"
- ⑳ BITUMINOUS TACK COAT BETWEEN LIFTS
- ㉑ CONCRETE BARRIER MEDIAN

NOTES

1. GEOTECHNICAL FABRIC FOR GROUND STABILIZATION IS PLACED BENEATH THE AGGREGATE SUBGRADE IMPROVEMENT AND THE EXISTING SUBGRADE AT THE UNDERCUT AREAS. REFER TO CROSS SECTIONS AND P&P FOR UNDERCUT AREAS AND ADDITIONAL INFO.
2. GUTTER FLAG THICKNESS SHALL MATCH THE ADJACENT PAVEMENT THICKNESS AT ALL LOCATIONS.
3. SEE CROSS SECTIONS FOR GRADING INFORMATION.
4. REFER TO DRAINAGE PLAN AND PROFILES FOR LOCATIONS OF REVERSE PITCHED GUTTER.
5. SEE LANDSCAPING PLANS FOR SEEDING AND SODDING INFORMATION.
6. SEE PLAT OF HIGHWAYS FOR RIGHT-OF-WAY INFORMATION.

STRUCTURAL DESIGN TRAFFIC		YEAR: 2030
PV = 47,160	SU = 2,535	MU = 1,015
ROAD STREET CLASSIFICATION: CLASS I		
PERCENT OF STRUCTURAL DESIGN TRAFFIC IN DESIGN LANE:		
PV = 8%	SU = 37%	MU = 37%
TRAFFIC FACTOR:	ACTUAL TF 7.94	AC TYPE =
	MINIMUM TF 4.13	
AC GRADE:	BINDER =	SURFACE =
SUBGRADE SUPPORT RATING:	SSR =	STA. TO STA.

FILE NAME = DIBX11-shc-typical.dgn

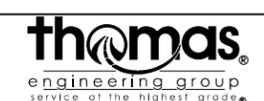


USER NAME = TEG	DESIGNED - VJM	REVISED - 3/3/2015
	DRAWN - VJM	REVISED - 6/19/2015
PLOT SCALE = 13.3332' / 1"	CHECKED - RO	REVISED - 9/27/2016
PLOT DATE = 11/14/2017	DATE - 11/15/17	REVISED -


**STATE OF ILLINOIS
 DEPARTMENT OF TRANSPORTATION**

TYPICAL SECTIONS	
PROPOSED 135TH STREET /ROMEO ROAD	
SCALE: NTS	SHEET 11 OF 13 SHEETS STA. TO STA.

F.A.P. RTE.	SECTION	COUNTY	TOTAL SHEETS	SHEET NO.
856	14-00170-42-RP	WILL	394	26
CONTRACT NO. 61D47				
ILLINOIS FED. AID PROJECT				

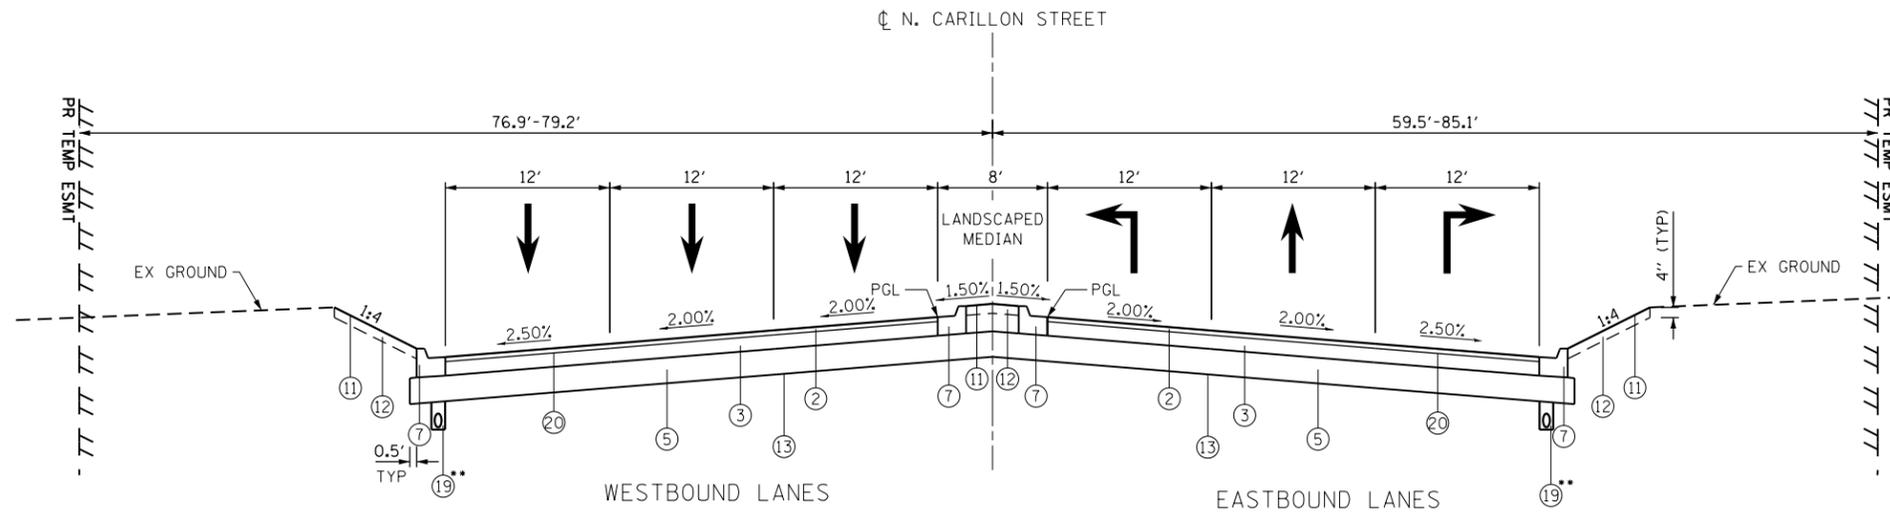

PROPOSED TYPICAL SECTION 14
 STA 231+40.00 TO STA 232+95.00, N CARILLON DRIVE

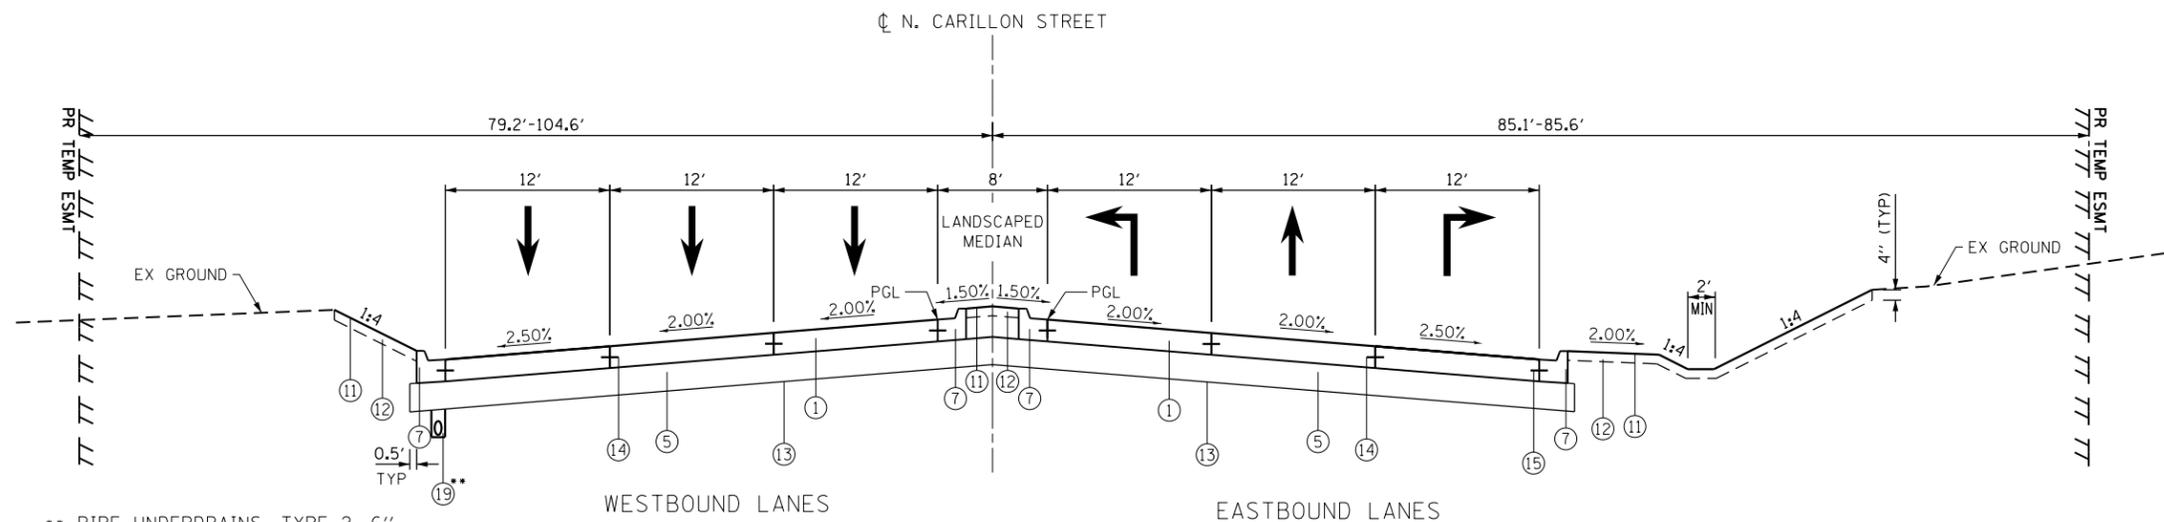

** PIPE UNDERDRAINS, TYPE 2, 6"
 SEE DRAINAGE SCHEDULES
 FOR STATIONS AND LOCATIONS.

PROPOSED TYPICAL SECTION 15
 STA 232+95.00 TO STA 234+24.00, N CARILLON DRIVE

PROPOSED LEGEND:


- ① PORTLAND CEMENT CONCRETE PAVEMENT (JOINTED), 10"
- ② HOT-MIX ASPHALT SURFACE COURSE, MIX "D", N70, 2"
- ③ HOT-MIX ASPHALT BASE COURSE, IL-19.0, N70, 5/4"
- ④ HOT-MIX ASPHALT BASE COURSE, IL-19.0, N70, 8/4"
- ⑤ AGGREGATE SUBGRADE IMPROVEMENT, 12"
- ⑥ COMBINATION CONCRETE CURB & GUTTER, TYPE B-6.12
- ⑦ COMBINATION CONCRETE CURB & GUTTER, TYPE B-6.18
- ⑧ COMBINATION CONCRETE CURB & GUTTER, TYPE B-6.24
- ⑨ PCC SIDEWALK
 - (A) PORTLAND CEMENT CONCRETE SIDEWALK, 5"
 - (B) SUBBASE GRANULAR MATERIAL, TYPE B 4"
- ⑩ SHARED-USE PATH
 - (A) HOT-MIX ASPHALT SURFACE COURSE, MIX "D", N50, 3"
 - (B) AGGREGATE BASE COURSE TYPE B, 6"
- ⑪ SEEDING OR SODDING, FERTILIZER, AND EROSION CONTROL BLANKET
- ⑫ TOPSOIL EXCAVATION AND PLACEMENT
- ⑬ GEOTECHNICAL FABRIC FOR GROUND STABILIZATION - SEE NOTE 1
- ⑭ LONGITUDINAL CONSTRUCTION JOINT, NO. 6 TIE BAR, DEFORMED (EPOXY COATED) REFER TO STANDARD 420001-08 FOR DETAILS (TO BE INCLUDED IN THE COST OF PROPOSED PAVEMENT)
- ⑮ NO. 6 TIE BAR, DEFORMED (EPOXY COATED) REFER TO STANDARD 606001-06 FOR DETAILS (TO BE INCLUDED IN THE COST OF CURB AND GUTTER)
- ⑯ NOISE ABATEMENT WALL, GROUND MOUNTED
- ⑰ CONCRETE RETAINING WALL
- ⑱ BICYCLE RAILING
- ⑲ PIPE UNDERDRAINS, TYPE 2, 6"
- ⑳ BITUMINOUS TACK COAT BETWEEN LIFTS
- ㉑ CONCRETE BARRIER MEDIAN

NOTES

1. GEOTECHNICAL FABRIC FOR GROUND STABILIZATION IS PLACED BENEATH THE AGGREGATE SUBGRADE IMPROVEMENT AND THE EXISTING SUBGRADE AT THE UNDERCUT AREAS. REFER TO CROSS SECTIONS AND P&P FOR UNDERCUT AREAS AND ADDITIONAL INFO.
2. GUTTER FLAG THICKNESS SHALL MATCH THE ADJACENT PAVEMENT THICKNESS AT ALL LOCATIONS.
3. SEE CROSS SECTIONS FOR GRADING INFORMATION.
4. REFER TO DRAINAGE PLAN AND PROFILES FOR LOCATIONS OF REVERSE PITCHED GUTTER.
5. SEE LANDSCAPING PLANS FOR SEEDING AND SODDING INFORMATION.
6. SEE PLAT OF HIGHWAYS FOR RIGHT-OF-WAY INFORMATION.

STRUCTURAL DESIGN TRAFFIC	YEAR: 2030
PV = 47,160 SU = 2,535 MU = 1,015	
ROAD STREET CLASSIFICATION:	CLASS I
PERCENT OF STRUCTURAL DESIGN TRAFFIC IN DESIGN LANE:	
PV = 8% SU = 37% MU = 37%	
TRAFFIC FACTOR:	ACTUAL TF 7.94 AC TYPE =
	MINIMUM TF 4.13
AC GRADE:	BINDER = SURFACE =
SUBGRADE SUPPORT RATING:	
SSR =	STA. TO STA.

FILE NAME = D:\B\11-shc-typical.dgn

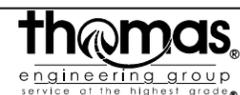


USER NAME = TEG	DESIGNED - VJM	REVISED - 3/3/2015
	DRAWN - VJM	REVISED - 6/19/2015
PLOT SCALE = 13.3332' / in.	CHECKED - RO	REVISED - 9/27/2016
PLOT DATE = 11/14/2017	DATE - 11/15/17	REVISED -

**STATE OF ILLINOIS
 DEPARTMENT OF TRANSPORTATION**


TYPICAL SECTIONS	
PROPOSED N. CARILLON DRIVE	
SCALE: NTS	SHEET 12 OF 13 SHEETS STA. TO STA.

F.A.P. RTE.	SECTION	COUNTY	TOTAL SHEETS	SHEET NO.
856	14-00170-42-RP	WILL	394	27
CONTRACT NO. 61D47				
ILLINOIS FED. AID PROJECT				

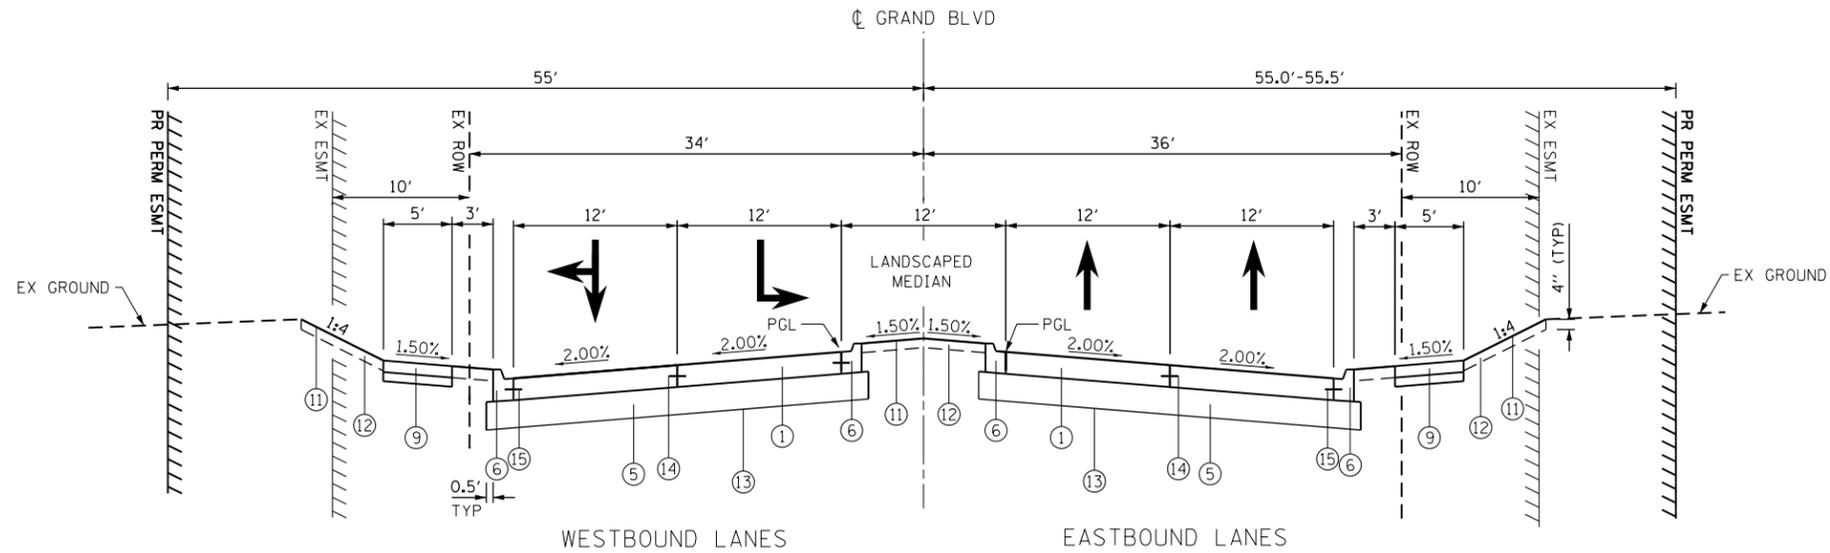

PROPOSED TYPICAL SECTION 16

STA 235+93.00 TO STA 237+00.00, GRAND BOULEVARD

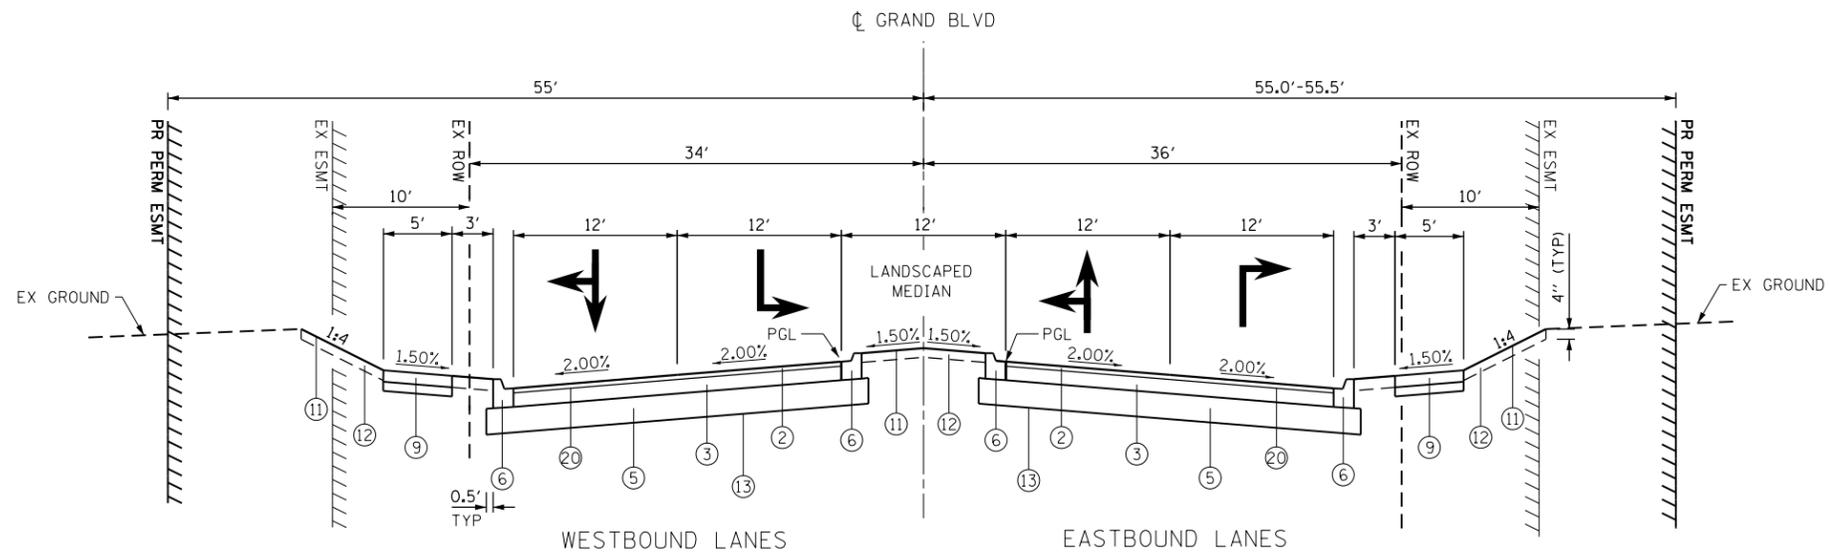

PROPOSED TYPICAL SECTION 17

STA 237+00.00 TO STA 238+38.00, GRAND BOULEVARD

PROPOSED LEGEND:


NOTES

1. GEOTECHNICAL FABRIC FOR GROUND STABILIZATION IS PLACED BENEATH THE AGGREGATE SUBGRADE IMPROVEMENT AND THE EXISTING SUBGRADE AT THE UNDERCUT AREAS. REFER TO CROSS SECTIONS AND P&P FOR UNDERCUT AREAS AND ADDITIONAL INFO.
2. GUTTER FLAG THICKNESS SHALL MATCH THE ADJACENT PAVEMENT THICKNESS AT ALL LOCATIONS.
3. SEE CROSS SECTIONS FOR GRADING INFORMATION.
4. REFER TO DRAINAGE PLAN AND PROFILES FOR LOCATIONS OF REVERSE PITCHED GUTTER.
5. SEE LANDSCAPING PLANS FOR SEEDING AND SODDING INFORMATION.
6. SEE PLAT OF HIGHWAYS FOR RIGHT-OF-WAY INFORMATION.

STRUCTURAL DESIGN TRAFFIC	YEAR: 2030
PV = 47,160 SU = 2,535 MU = 1,015	
ROAD STREET CLASSIFICATION: CLASS I	
PERCENT OF STRUCTURAL DESIGN TRAFFIC IN DESIGN LANE:	
PV = 8% SU = 37% MU = 37%	
TRAFFIC FACTOR: ACTUAL TF 7.94 AC TYPE =	
MINIMUM TF 4.13	
AC GRADE: BINDER = SURFACE =	
SUBGRADE SUPPORT RATING: SSR = STA. TO STA.	

- | | |
|------------------------------------------------------------------------------------------------------------------------------------------------------------------------------------------------------------------------------------------------------------------------------------------------------------------------------------------------------------------------------------------------------------------------------------------------------------------------------------------------------------------------------------------------------------------------------------------------------------------------------------------------------------------------------------------------------------------------------------------------------------------------------------------------------------------------------------------------------------------------------------------------|------------------------------------------------------------------------------------------------------------------------------------------------------------------------------------------------------------------------------------------------------------------------------------------------------------------------------------------------------------------------------------------------------------------------------------------------------------------------------------------------------------------------------------------------------------------------------------------------------------------------------------------------------------------------------------------------------------------------------------------------------------------------------------------------|
| <ul style="list-style-type: none"> ① PORTLAND CEMENT CONCRETE PAVEMENT (JOINTED), 10" ② HOT-MIX ASPHALT SURFACE COURSE, MIX "D", N70, 2" ③ HOT-MIX ASPHALT BASE COURSE, IL-19.0, N70, 5 1/4" ④ HOT-MIX ASPHALT BASE COURSE, IL-19.0, N70, 8 1/4" ⑤ AGGREGATE SUBGRADE IMPROVEMENT, 12" ⑥ COMBINATION CONCRETE CURB & GUTTER, TYPE B-6.12 ⑦ COMBINATION CONCRETE CURB & GUTTER, TYPE B-6.18 ⑧ COMBINATION CONCRETE CURB & GUTTER, TYPE B-6.24 ⑨ PCC SIDEWALK <ul style="list-style-type: none"> (A) PORTLAND CEMENT CONCRETE SIDEWALK, 5" (B) SUBBASE GRANULAR MATERIAL, TYPE B 4" ⑩ SHARED-USE PATH <ul style="list-style-type: none"> (A) HOT-MIX ASPHALT SURFACE COURSE, MIX "D", N50, 3" (B) AGGREGATE BASE COURSE TYPE B, 6" | <ul style="list-style-type: none"> ⑪ SEEDING OR SODDING, FERTILIZER, AND EROSION CONTROL BLANKET ⑫ TOPSOIL EXCAVATION AND PLACEMENT ⑬ GEOTECHNICAL FABRIC FOR GROUND STABILIZATION - SEE NOTE 1 ⑭ LONGITUDINAL CONSTRUCTION JOINT, NO. 6 TIE BAR, DEFORMED (EPOXY COATED) REFER TO STANDARD 420001-08 FOR DETAILS (TO BE INCLUDED IN THE COST OF PROPOSED PAVEMENT) ⑮ NO. 6 TIE BAR, DEFORMED (EPOXY COATED) REFER TO STANDARD 606001-06 FOR DETAILS (TO BE INCLUDED IN THE COST OF CURB AND GUTTER) ⑯ NOISE ABATEMENT WALL, GROUND MOUNTED ⑰ CONCRETE RETAINING WALL ⑱ BICYCLE RAILING ⑲ PIPE UNDERDRAINS, TYPE 2, 6" ⑳ BITUMINOUS TACK COAT BETWEEN LIFTS ㉑ CONCRETE BARRIER MEDIAN |
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FILE NAME = DIBX11-shc-typical.dgn

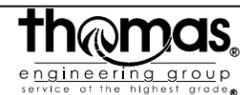

USER NAME = TEG	DESIGNED - VJM	REVISED - 3/3/2015
	DRAWN - VJM	REVISED - 6/19/2015
PLOT SCALE = 13.3332 1/16"	CHECKED - RO	REVISED - 9/27/2016
PLOT DATE = 11/14/2017	DATE - 11/15/17	REVISED -

STATE OF ILLINOIS
DEPARTMENT OF TRANSPORTATION

TYPICAL SECTIONS
PROPOSED GRAND BLVD

SCALE: NTS SHEET 13 OF 13 SHEETS STA. TO STA.

F.A.P. RTE.	SECTION	COUNTY	TOTAL SHEETS	SHEET NO.
856	14-00170-42-RP	WILL	394	28
CONTRACT NO. 61D47				
ILLINOIS FED. AID PROJECT				

WEBER ROAD

PRE-STAGE CUT					
STATION	CUT (SF)	AVERAGE	LENGTH	TOTAL	TOTAL (CY)
726+00	0.0	0.4	100.0	36.7	1.4
727+00	0.7	1.2	100.0	116.2	4.3
728+00	1.6	5.5	100.0	552.6	20.5
729+00	9.5	6.6	100.0	656.0	24.3
730+00	3.7	3.7	100.0	365.8	13.5
731+00	3.7	4.0	100.0	400.5	14.8
732+00	4.4	4.3	100.0	434.8	16.1
733+00	4.3	4.2	100.0	423.0	15.7
734+00	4.1	3.5	100.0	350.3	13.0
735+00	2.9	2.0	100.0	203.0	7.5
736+00	1.2	0.6	100.0	61.0	2.3
737+00	0.1	0.0	100.0	2.5	0.1
738+00	0.0	4.9	100.0	487.3	18.0
739+00	9.7	21.8	100.0	2,175.6	80.6
740+00	33.8	35.5	100.0	3,548.1	131.4
741+00	37.2	41.1	100.0	4,109.3	152.2
742+00	45.0	53.0	100.0	5,295.6	196.1
743+00	60.9	62.6	100.0	6,261.8	231.9
744+00	64.3	55.4	100.0	5,544.6	205.4
745+00	46.6	41.9	100.0	4,185.8	155.0
746+00	37.1	41.2	100.0	4,118.1	152.5
747+00	45.2	418.1	100.0	41,811.9	1,548.6
748+00	791.0	865.2	100.0	86,515.8	3,204.3
749+00	939.3	931.6	100.0	93,156.0	3,450.2
750+00	923.8	496.6	100.0	49,661.8	1,839.3
751+00	69.4	59.1	100.0	5,910.0	218.9
752+00	48.8	54.3	100.0	5,434.1	201.3
753+00	59.9	56.4	100.0	5,636.5	208.8
754+00	52.8	57.2	100.0	5,717.3	211.8
755+00	61.5	64.0	5.9	377.6	14.0
755+05.90	66.5	68.6	94.1	6,451.5	238.9
756+00	70.6	70.5	100.0	7,046.3	261.0
757+00	70.3	82.6	100.0	8,259.2	305.9
758+00	94.9	82.0	100.0	8,200.5	303.7

WEBER ROAD

PRE-STAGE CUT					
STATION	CUT (SF)	AVERAGE	LENGTH	TOTAL	TOTAL (CY)
759+00	69.1	72.2	100.0	7,218.9	267.4
760+00	75.3	55.5	59.0	3,275.4	121.3
760+58.97	35.8	29.3	41.0	1,202.8	44.5
761+00	22.8	31.2	100.0	3,124.3	115.7
762+00	39.7	38.9	100.0	3,886.3	143.9
763+00	38.0	33.5	100.0	3,350.8	124.1
764+00	29.0	14.5	100.0	1,448.5	53.6
765+00	0.0	28.1	100.0	2,813.3	104.2
766+00	56.3	55.6	100.0	5,561.8	206.0
767+00	55.0	38.3	100.0	3,825.4	141.7
768+00	21.5	23.4	100.0	2,338.5	86.6
769+00	25.2	36.1	100.0	3,614.8	133.9
770+00	47.1	49.8	100.0	4,982.9	184.6
771+00	52.6	48.4	100.0	4,837.9	179.2
772+00	44.2	52.0	100.0	5,201.2	192.6
773+00	59.9	58.6	100.0	5,863.7	217.2
774+00	57.4	56.7	100.0	5,665.9	209.8
775+00	55.9	53.4	100.0	5,337.2	197.7
776+00	50.8	58.1	100.0	5,814.8	215.4
777+00	65.5	41.8	100.0	4,178.9	154.8
778+00	18.1	469.8	100.0	46,976.5	1,739.9
779+00	921.4	920.0	100.0	92,003.5	3,407.5
780+00	918.7	459.3	100.0	45,933.1	1,701.2
781+00	0.0	0.0	100.0	0.0	0.0
782+00	0.0	0.0	100.0	0.0	0.0
783+00	0.0	0.0	100.0	0.0	0.0
784+00	0.0	0.0	17.6	0.0	0.0
784+17.56	0.0	0.0	82.4	0.0	0.0
785+00	0.0	0.0	100.0	0.0	0.0
786+00	0.0	0.0	100.0	0.0	0.0
787+00	0.0	0.0	100.0	0.0	0.0
788+00	0.0	0.0	100.0	0.0	0.0
789+00	0.0	0.0	100.0	0.0	0.0
790+00	0.0	0.0	20.0	0.0	0.0
790+20	0.0				
TOTAL					23,407


WEBER ROAD

PRE-STAGE FILL					
STATION	FILL (SF)	AVERAGE	LENGTH	TOTAL	TOTAL (CY)
726+00	0.0	5.2	100.0	521.7	19.3
727+00	10.4	12.8	100.0	1,281.8	47.5
728+00	15.2	18.3	100.0	1,829.7	67.8
729+00	21.4	23.2	100.0	2,323.4	86.1
730+00	25.1	31.5	100.0	3,149.7	116.7
731+00	37.9	37.1	100.0	3,712.0	137.5
732+00	36.3	32.0	100.0	3,200.0	118.5
733+00	27.7	36.7	100.0	3,673.4	136.1
734+00	45.8	60.1	100.0	6,007.9	222.5
735+00	74.4	100.5	100.0	10,050.0	372.2
736+00	126.6	128.6	100.0	12,859.2	476.3
737+00	130.6	93.1	100.0	9,306.5	344.7
738+00	55.6	44.7	100.0	4,469.7	165.5
739+00	33.8	34.6	100.0	3,457.5	128.1
740+00	35.3	32.1	100.0	3,206.8	118.8
741+00	28.8	26.9	100.0	2,692.8	99.7
742+00	25.1	24.5	100.0	2,449.8	90.7
743+00	23.9	25.6	100.0	2,559.8	94.8
744+00	27.3	29.9	100.0	2,993.1	110.9
745+00	32.6	34.6	100.0	3,457.3	128.0
746+00	36.5	30.3	100.0	3,029.0	112.2
747+00	24.0	37.9	100.0	3,790.5	140.4
748+00	51.8	52.0	100.0	5,196.5	192.5
749+00	52.2	44.3	100.0	4,431.4	164.1
750+00	36.5	19.3	100.0	1,932.8	71.6
751+00	2.2	1.9	100.0	191.4	7.1
752+00	1.6	2.3	100.0	225.5	8.4
753+00	2.9	3.1	100.0	308.9	11.4
754+00	3.3	9.2	100.0	916.3	33.9
755+00	15.0	15.1	5.9	88.9	3.3
755+05.90	15.1	25.5	94.1	2,401.5	88.9
756+00	35.9	30.9	100.0	3,091.1	114.5
757+00	25.9	20.3	100.0	2,025.8	75.0
758+00	14.6	12.7	100.0	1,267.8	47.0

WEBER ROAD

PRE-STAGE FILL					
STATION	FILL (SF)	AVERAGE	LENGTH	TOTAL	TOTAL (CY)
759+00	10.7	11.0	100.0	1,098.3	40.7
760+00	11.2	7.7	59.0	454.5	16.8
760+59	4.2	9.1	41.0	371.9	13.8
761+00	13.9	13.4	100.0	1,336.8	49.5
762+00	12.8	13.3	100.0	1,333.7	49.4
763+00	13.9	13.6	100.0	1,355.8	50.2
764+00	13.2	6.6	100.0	661.5	24.5
765+00	0.0	1.5	100.0	145.9	5.4
766+00	2.9	2.8	100.0	279.3	10.3
767+00	2.7	3.5	100.0	349.2	12.9
768+00	4.3	4.6	100.0	459.9	17.0
769+00	4.9	4.0	100.0	403.4	14.9
770+00	3.2	2.9	100.0	285.3	10.6
771+00	2.5	2.6	100.0	258.7	9.6
772+00	2.7	3.5	100.0	352.8	13.1
773+00	4.4	4.3	100.0	433.0	16.0
774+00	4.3	4.3	100.0	434.0	16.1
775+00	4.4	5.1	100.0	507.9	18.8
776+00	5.7	5.9	100.0	587.9	21.8
777+00	6.0	24.9	100.0	2,494.4	92.4
778+00	43.9	40.4	100.0	4,040.4	149.6
779+00	36.9	19.2	100.0	1,919.5	71.1
780+00	1.4	93.1	100.0	9,307.3	344.7
781+00	184.7	192.5	100.0	19,247.5	712.9
782+00	200.3	189.5	100.0	18,950.0	701.9
783+00	178.8	165.3	100.0	16,532.5	612.3
784+00	151.9	144.0	17.6	2,529.1	93.7
784+18	136.2	131.8	82.4	10,861.5	402.3
785+00	127.4	124.3	100.0	12,432.5	460.5
786+00	121.3	126.4	100.0	12,635.0	468.0
787+00	131.4	140.7	100.0	14,067.5	521.0
788+00	150.0	157.7	100.0	15,772.5	584.2
789+00	165.5	176.2	100.0	17,617.5	652.5
790+00	186.9	93.4	20.0	1,868.5	69.2
790+20	0.0				
TOTAL					10,500

FILE NAME = D:\BX11-ant-schedule.dgn

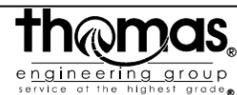

USER NAME = TEG
 PLOT SCALE = 2.0000' / 1" / 1" / 1"
 PLOT DATE = 11/14/2017

DESIGNED -
 DRAWN -
 CHECKED -
 DATE - 11/15/17

REVISED - 3/3/2015
 REVISED - 6/19/2015
 REVISED - 9/27/2016
 REVISED -

**STATE OF ILLINOIS
 DEPARTMENT OF TRANSPORTATION**

SCHEDULE OF QUANTITIES

SCALE: NTS SHEET 1 OF 22 SHEETS STA. TO STA.

F.A.P. RTE.	SECTION	COUNTY	TOTAL SHEETS	SHEET NO.
856	14-00170-42-RP	WILL	394	29
CONTRACT NO. 61D47				
ILLINOIS FED. AID PROJECT				

WEBER ROAD

PRE-STAGE TOPSOIL REMOVAL					
STATION	TOPSOIL (SF)	AVERAGE	LENGTH	TOTAL	TOTAL (CY)
726+00	0.0	3.8	100.0	384.1	14.2
727+00	7.7	8.1	100.0	808.0	29.9
728+00	8.5	11.7	100.0	1,169.0	43.3
729+00	14.9	15.4	100.0	1,535.8	56.9
730+00	15.8	15.9	100.0	1,587.1	58.8
731+00	15.9	16.7	100.0	1,667.9	61.8
732+00	17.4	18.2	100.0	1,823.5	67.5
733+00	19.0	21.0	100.0	2,097.2	77.7
734+00	22.9	25.1	100.0	2,514.1	93.1
735+00	27.4	30.0	100.0	3,000.0	111.1
736+00	32.6	33.5	100.0	3,346.7	124.0
737+00	34.3	32.9	100.0	3,293.6	122.0
738+00	31.6	34.5	100.0	3,449.6	127.8
739+00	37.4	39.2	100.0	3,915.2	145.0
740+00	40.9	40.7	100.0	4,069.2	150.7
741+00	40.5	40.4	100.0	4,036.7	149.5
742+00	40.2	40.1	100.0	4,006.6	148.4
743+00	39.9	39.3	100.0	3,930.6	145.6
744+00	38.7	37.7	100.0	3,769.0	139.6
745+00	36.7	36.0	100.0	3,604.3	133.5
746+00	35.4	35.2	100.0	3,523.7	130.5
747+00	35.1	84.0	100.0	8,395.5	310.9
748+00	132.8	131.6	100.0	13,164.3	487.6
749+00	130.4	130.0	100.0	12,998.8	481.4
750+00	129.5	78.6	100.0	7,862.3	291.2
751+00	27.7	32.6	100.0	3,257.4	120.6
752+00	37.4	38.1	100.0	3,808.3	141.0
753+00	38.7	36.2	100.0	3,624.2	134.2
754+00	33.8	40.6	100.0	4,060.5	150.4
755+00	47.5	47.4	5.9	279.6	10.4
755+05.90	47.3	45.4	94.1	4,273.2	158.3
756+00	43.5	44.1	100.0	4,409.7	163.3
757+00	44.7	45.0	100.0	4,501.2	166.7
758+00	45.3	44.5	100.0	4,454.2	165.0

WEBER ROAD

PRE-STAGE TOPSOIL REMOVAL					
STATION	TOPSOIL (SF)	AVERAGE	LENGTH	TOTAL	TOTAL (CY)
759+00	43.7	43.1	100.0	4,308.6	159.6
760+00	42.4	33.5	59.0	1,978.2	73.3
760+59	24.7	27.1	41.0	1,110.3	41.1
761+00	29.5	31.5	100.0	3,154.5	116.8
762+00	33.6	35.2	100.0	3,522.0	130.4
763+00	36.8	35.7	100.0	3,565.0	132.0
764+00	34.5	17.2	100.0	1,724.9	63.9
765+00	0.0	14.5	100.0	1,447.7	53.6
766+00	29.0	28.8	100.0	2,882.1	106.7
767+00	28.7	25.5	100.0	2,549.7	94.4
768+00	22.3	22.9	100.0	2,291.7	84.9
769+00	23.5	23.3	100.0	2,329.3	86.3
770+00	23.1	23.2	100.0	2,321.3	86.0
771+00	23.4	22.5	100.0	2,250.5	83.4
772+00	21.6	23.5	100.0	2,347.8	87.0
773+00	25.3	26.4	100.0	2,638.1	97.7
774+00	27.4	27.8	100.0	2,777.4	102.9
775+00	28.1	28.6	100.0	2,863.0	106.0
776+00	29.2	28.0	100.0	2,796.5	103.6
777+00	26.8	28.9	100.0	2,885.2	106.9
778+00	30.9	72.9	100.0	7,289.0	270.0
779+00	114.8	105.9	100.0	10,592.9	392.3
780+00	97.0	68.7	100.0	6,868.1	254.4
781+00	40.4	40.1	100.0	4,006.3	148.4
782+00	39.8	39.7	100.0	3,970.4	147.1
783+00	39.6	39.1	100.0	3,912.1	144.9
784+00	38.6	40.5	17.6	710.6	26.3
784+18	42.3	33.0	82.4	2,717.9	100.7
785+00	23.6	24.1	100.0	2,413.5	89.4
786+00	24.7	25.4	100.0	2,539.1	94.0
787+00	26.1	26.9	100.0	2,687.3	99.5
788+00	27.6	27.6	100.0	2,762.3	102.3
789+00	27.6	26.7	100.0	2,672.4	99.0
790+00	25.8	12.9	20.0	258.3	9.6
790+20	0.0				
TOTAL				8,807	

WEBER ROAD

PRE-STAGE TOPSOIL PLACEMENT					
STATION	TOPSOIL (SF)	AVERAGE	LENGTH	TOTAL	TOTAL (CY)
726+00	0.0	0.0	100.0	0.0	0.0
727+00	0.0	0.0	100.0	0.0	0.0
728+00	0.0	0.0	100.0	0.0	0.0
729+00	0.0	0.0	100.0	0.0	0.0
730+00	0.0	0.0	100.0	0.0	0.0
731+00	0.0	0.0	100.0	0.0	0.0
732+00	0.0	0.0	100.0	0.0	0.0
733+00	0.0	0.0	100.0	0.0	0.0
734+00	0.0	0.0	100.0	0.0	0.0
735+00	0.0	0.0	100.0	0.0	0.0
736+00	0.0	0.0	100.0	0.0	0.0
737+00	0.0	0.0	100.0	0.0	0.0
738+00	0.0	0.0	100.0	0.0	0.0
739+00	0.0	0.0	100.0	0.0	0.0
740+00	0.0	0.0	100.0	0.0	0.0
741+00	0.0	0.0	100.0	0.0	0.0
742+00	0.0	0.0	100.0	0.0	0.0
743+00	0.0	0.0	100.0	0.0	0.0
744+00	0.0	0.0	100.0	0.0	0.0
745+00	0.0	4.2	100.0	416.6	15.4
746+00	8.3	8.2	100.0	817.8	30.3
747+00	8.0	35.4	100.0	3,538.5	131.1
748+00	62.7	62.3	100.0	6,234.6	230.9
749+00	61.9	61.6	100.0	6,164.2	228.3
750+00	61.3	30.7	100.0	3,066.8	113.6
751+00	0.0	0.0	100.0	0.0	0.0
752+00	0.0	0.0	100.0	0.0	0.0
753+00	0.0	0.0	100.0	0.0	0.0
754+00	0.0	0.0	100.0	0.0	0.0
755+00	0.0	0.0	5.9	0.0	0.0
755+05.90	0.0	0.0	94.1	0.0	0.0
756+00	0.0	0.0	100.0	0.0	0.0
757+00	0.0	0.0	100.0	0.0	0.0
758+00	0.0	0.0	100.0	0.0	0.0

WEBER ROAD

PRE-STAGE TOPSOIL PLACEMENT					
STATION	TOPSOIL (SF)	AVERAGE	LENGTH	TOTAL	TOTAL (CY)
759+00	0.0	0.0	100.0	0.0	0.0
760+00	0.0	0.0	59.0	0.0	0.0
760+59	0.0	0.0	41.0	0.0	0.0
761+00	0.0	0.0	100.0	0.0	0.0
762+00	0.0	0.0	100.0	0.0	0.0
763+00	0.0	0.0	100.0	0.0	0.0
764+00	0.0	0.0	100.0	0.0	0.0
765+00	0.0	0.0	100.0	0.0	0.0
766+00	0.0	0.0	100.0	0.0	0.0
767+00	0.0	0.0	100.0	0.0	0.0
768+00	0.0	0.0	100.0	0.0	0.0
769+00	0.0	0.0	100.0	0.0	0.0
770+00	0.0	0.0	100.0	0.0	0.0
771+00	0.0	0.0	100.0	0.0	0.0
772+00	0.0	0.0	100.0	0.0	0.0
773+00	0.0	0.0	100.0	0.0	0.0
774+00	0.0	0.0	100.0	0.0	0.0
775+00	0.0	0.0	100.0	0.0	0.0
776+00	0.0	0.0	100.0	0.0	0.0
777+00	0.0	0.0	100.0	0.0	0.0
778+00	0.0	28.2	100.0	2,818.2	104.4
779+00	56.4	51.0	100.0	5,095.3	188.7
780+00	45.5	26.5	100.0	2,647.3	98.0
781+00	7.4	7.5	100.0	750.9	27.8
782+00	7.6	7.7	100.0	771.0	28.6
783+00	7.8	8.0	100.0	796.6	29.5
784+00	8.1	8.6	17.6	150.9	5.6
784+18	9.1	7.0	82.4	579.0	21.4
785+00	5.0	5.2	100.0	524.2	19.4
786+00	5.5	5.8	100.0	583.6	21.6
787+00	6.2	6.7	100.0	666.1	24.7
788+00	7.1	7.0	100.0	698.6	25.9
789+00	6.8	6.2	100.0	622.8	23.1
790+00	5.6	2.8	20.0	56.3	2.1
790+20	0.0				
TOTAL				1,371	

FILE NAME = D:\BX11-ant-schedule.dgn



USER NAME = TEG	DESIGNED -	REVISED - 3/3/2015
	DRAWN -	REVISED - 6/19/2015
PLOT SCALE = 2.0000' / 1"	CHECKED -	REVISED - 9/27/2016
PLOT DATE = 11/14/2017	DATE - 11/15/17	REVISED -

**STATE OF ILLINOIS
DEPARTMENT OF TRANSPORTATION**

SCHEDULE OF QUANTITIES

SCALE: NTS SHEET 2 OF 22 SHEETS STA. TO STA.

F.A.P. RTE.	SECTION	COUNTY	TOTAL SHEETS	SHEET NO.
856	14-00170-42-RP	WILL	394	30
CONTRACT NO. 61D47				
ILLINOIS FED. AID PROJECT				

N. CARILLON DRIVE / GRAND BOULEVARD

PRE-STAGE					
CUT					
STATION	CUT (SF)	AVERAGE	LENGTH	TOTAL	TOTAL (CY)
230+00	35.6				
		23.4	100.0	2,338.8	86.6
231+00	11.2				
		5.6	100.0	559.5	20.7
232+00	0.0				
		0.0	29.7	0.0	0.0
232+29.70	0.0				
		0.0	70.3	0.0	0.0
233+00	0.0				
		0.0	100.0	0.0	0.0
234+00.	0.0				
		0.0	100.0	0.0	0.0
235+00.	0.0				
		8.3	100.0	826.3	30.6
236+00	16.5				
		12.9	100.0	1,286.3	47.6
237+00.	9.2				
		6.8	100.0	682.3	25.3
238+00	4.4				
				TOTAL	211

N. CARILLON DRIVE / GRAND BOULEVARD

PRE-STAGE					
FILL					
STATION	FILL (SF)	AVERAGE	LENGTH	TOTAL	TOTAL (CY)
230+00	1.6				
		1.6	100.0	158.8	5.9
231+00	1.6				
		0.8	100.0	79.4	2.9
232+00	0.0				
		0.0	29.7	0.0	0.0
232+29.70	0.0				
		0.0	70.3	0.0	0.0
233+00	0.0				
		0.0	100.0	0.0	0.0
234+00.	0.0				
		0.0	100.0	0.0	0.0
235+00.	0.0				
		3.1	100.0	314.1	11.6
236+00	6.3				
		4.3	100.0	426.3	15.8
237+00.	2.2				
		3.0	100.0	300.2	11.1
238+00	3.8				
				TOTAL	48

N. CARILLON DRIVE / GRAND BOULEVARD

PRE-STAGE					
TOPSOIL REMOVAL					
STATION	TOPSOIL (SF)	AVERAGE	LENGTH	TOTAL	TOTAL (CY)
230+00	0.0				
		0.0	100.0	0.0	0.0
231+00	0.0				
		0.0	100.0	0.0	0.0
232+00	0.0				
		0.0	29.7	0.0	0.0
232+29.70	0.0				
		0.0	70.3	0.0	0.0
233+00	0.0				
		0.0	100.0	0.0	0.0
234+00.	0.0				
		0.0	100.0	0.0	0.0
235+00.	0.0				
		6.9	100.0	694.5	25.7
236+00	13.9				
		11.3	100.0	1,132.8	42.0
237+00.	8.8				
		9.7	100.0	970.3	35.9
238+00	10.6				
				TOTAL	104

N. CARILLON DRIVE / GRAND BOULEVARD

PRE-STAGE					
TOPSOIL PLACEMENT					
STATION	TOPSOIL (SF)	AVERAGE	LENGTH	TOTAL	TOTAL (CY)
230+00	0.0				
		0.0	100.0	0.0	0.0
231+00	0.0				
		0.0	100.0	0.0	0.0
232+00	0.0				
		0.0	29.7	0.0	0.0
232+29.70	0.0				
		0.0	70.3	0.0	0.0
233+00	0.0				
		0.0	100.0	0.0	0.0
234+00.	0.0				
		0.0	100.0	0.0	0.0
235+00.	0.0				
		0.0	100.0	0.0	0.0
236+00	0.0				
		0.0	100.0	0.0	0.0
237+00.	0.0				
		0.0	100.0	0.0	0.0
238+00	0.0				
				TOTAL	0

FILE NAME = D:\B\11-ent-schedule.dgn



USER NAME = TEG	DESIGNED -	REVISED - 3/3/2015
	DRAWN -	REVISED - 6/19/2015
PLOT SCALE = 2.0000' / 1" =	CHECKED -	REVISED - 9/27/2016
PLOT DATE = 11/14/2017	DATE - 11/15/17	REVISED -

**STATE OF ILLINOIS
DEPARTMENT OF TRANSPORTATION**

SCHEDULE OF QUANTITIES

SCALE: NTS SHEET 4 OF 22 SHEETS STA. TO STA.

F.A.P. RTE.	SECTION	COUNTY	TOTAL SHEETS	SHEET NO.
856	14-00170-42-RP	WILL	394	32
CONTRACT NO. 61D47			ILLINOIS FED. AID PROJECT	

WEBER ROAD

STAGE 1					
TOPSOIL REMOVAL					
STATION	TOPSOIL (SF)	AVERAGE	LENGTH	TOTAL	TOTAL (CY)
726+00	0.0				
		0.0	100.0	0.0	0.0
727+00	0.0				
		0.0	100.0	0.0	0.0
728+00	0.0				
		0.0	100.0	0.0	0.0
729+00	0.0				
		0.0	100.0	0.0	0.0
730+00	0.0				
		0.0	100.0	0.0	0.0
731+00	0.0				
		0.0	100.0	0.0	0.0
732+00	0.0				
		0.0	100.0	0.0	0.0
733+00	0.0				
		0.0	100.0	0.0	0.0
734+00	0.0				
		0.0	100.0	0.0	0.0
735+00	0.0				
		0.0	100.0	0.0	0.0
736+00	0.0				
		0.7	100.0	66.5	2.5
737+00	1.3				
		2.6	100.0	264.1	9.8
738+00	4.0				
		4.1	100.0	410.5	15.2
739+00	4.3				
		6.1	100.0	612.6	22.7
740+00	8.0				
		9.2	100.0	916.8	34.0
741+00	10.3				
		10.2	100.0	1,016.5	37.6
742+00	10.0				
		10.0	100.0	997.2	36.9
743+00	10.0				
		10.6	100.0	1,057.6	39.2
744+00	11.2				
		11.6	100.0	1,155.4	42.8
745+00	11.9				
		14.5	100.0	1,445.9	53.6
746+00	17.0				
		13.4	100.0	1,344.6	49.8
747+00	9.9				
		9.7	100.0	968.3	35.9
748+00	9.5				
		8.9	100.0	886.0	32.8
749+00	8.2				
		11.7	100.0	1,169.9	43.3
750+00	15.2				
		7.6	100.0	757.9	28.1
751+00	0.0				
		12.1	100.0	1,210.1	44.8
752+00	24.2				
		12.1	100.0	1,210.1	44.8
753+00	0.0				
		0.0	100.0	0.0	0.0
754+00	0.0				
		0.0	100.0	0.0	0.0
755+00	0.0				
		0.0	5.9	0.0	0.0
755+05.90	0.0				
		0.0	94.1	0.0	0.0
756+00	0.0				
		0.0	100.0	0.0	0.0
757+00	0.0				
		0.0	100.0	0.0	0.0
758+00	0.0				
		0.0	100.0	0.0	0.0
				TOTAL	2,743

WEBER ROAD

STAGE 1					
TOPSOIL REMOVAL					
STATION	TOPSOIL (SF)	AVERAGE	LENGTH	TOTAL	TOTAL (CY)
759+00	0.0				
		0.0	100.0	0.0	0.0
760+00	0.0				
		0.0	59.0	0.0	0.0
760+58.97	0.0				
		0.0	41.0	0.0	0.0
761+00	0.0				
		0.0	100.0	0.0	0.0
762+00	0.0				
		0.0	100.0	0.0	0.0
763+00	0.0				
		0.0	100.0	0.0	0.0
764+00	0.0				
		0.0	100.0	0.0	0.0
765+00	0.0				
		7.8	100.0	778.7	28.8
766+00	15.6				
		17.1	100.0	1,711.4	63.4
767+00	18.7				
		20.7	100.0	2,065.6	76.5
768+00	22.7				
		22.6	100.0	2,262.0	83.8
769+00	22.6				
		24.3	100.0	2,429.8	90.0
770+00	26.0				
		27.9	100.0	2,792.3	103.4
771+00	29.8				
		30.0	100.0	3,003.8	111.3
772+00	30.2				
		28.7	100.0	2,872.7	106.4
773+00	27.2				
		25.9	100.0	2,593.8	96.1
774+00	24.7				
		24.6	100.0	2,455.7	91.0
775+00	24.4				
		24.0	100.0	2,396.3	88.8
776+00	23.5				
		23.0	100.0	2,298.0	85.1
777+00	22.5				
		22.3	100.0	2,234.7	82.8
778+00	22.2				
		20.6	100.0	2,062.8	76.4
779+00	19.0				
		19.9	100.0	1,986.5	73.6
780+00	20.7				
		20.2	100.0	2,019.5	74.8
781+00	19.7				
		19.5	100.0	1,946.6	72.1
782+00	19.2				
		19.7	100.0	1,971.6	73.0
783+00	20.2				
		20.5	100.0	2,046.3	75.8
784+00	20.7				
		23.7	17.6	415.9	15.4
784+17.56	26.6				
		27.0	82.4	2,228.0	82.5
785+00	27.4				
		27.5	100.0	2,752.4	101.9
786+00	27.6				
		26.9	100.0	2,693.3	99.8
787+00	26.2				
		26.7	100.0	2,670.4	98.9
788+00	27.2				
		27.2	100.0	2,721.8	100.8
789+00	27.3				
		28.4	100.0	2,843.3	105.3
790+00	29.6				
		14.8	20.0	296.1	11.0
790+20	0.0				
				TOTAL	2,743

WEBER ROAD

STAGE 1					
TOPSOIL PLACEMENT					
STATION	TOPSOIL (SF)	AVERAGE	LENGTH	TOTAL	TOTAL (CY)
726+00	0.0				
		0.0	100.0	0.0	0.0
727+00	0.0				
		0.0	100.0	0.0	0.0
728+00	0.0				
		0.0	100.0	0.0	0.0
729+00	0.0				
		0.0	100.0	0.0	0.0
730+00	0.0				
		0.0	100.0	0.0	0.0
731+00	0.0				
		0.0	100.0	0.0	0.0
732+00	0.0				
		0.0	100.0	0.0	0.0
733+00	0.0				
		0.0	100.0	0.0	0.0
734+00	0.0				
		0.0	100.0	0.0	0.0
735+00	0.0				
		0.0	100.0	0.0	0.0
736+00	0.0				
		0.7	100.0	66.5	2.5
737+00	1.3				
		2.6	100.0	264.1	9.8
738+00	4.0				
		4.1	100.0	410.5	15.2
739+00	4.3				
		6.1	100.0	612.6	22.7
740+00	8.0				
		9.2	100.0	916.8	34.0
741+00	10.3				
		10.2	100.0	1,016.5	37.6
742+00	10.0				
		10.0	100.0	997.2	36.9
743+00	10.0				
		10.6	100.0	1,057.6	39.2
744+00	11.2				
		11.6	100.0	1,155.4	42.8
745+00	11.9				
		14.5	100.0	1,445.9	53.6
746+00	17.0				
		13.4	100.0	1,344.6	49.8
747+00	9.9				
		9.7	100.0	968.3	35.9
748+00	9.5				
		8.9	100.0	886.0	32.8
749+00	8.2				
		11.7	100.0	1,169.9	43.3
750+00	15.2				
		7.6	100.0	757.9	28.1
751+00	0.0				
		12.1	100.0	1,210.1	44.8
752+00	24.2				
		12.1	100.0	1,210.1	44.8
753+00	0.0				
		0.0	100.0	0.0	0.0
754+00	0.0				
		0.0	100.0	0.0	0.0
755+00	0.0				
		0.0	5.9	0.0	0.0
755+05.90	0.0				
		0.0	94.1	0.0	0.0
756+00	0.0				
		0.0	100.0	0.0	0.0
757+00	0.0				
		0.0	100.0	0.0	0.0
758+00	0.0				
		0.0	100.0	0.0	0.0
				TOTAL	2,743

WEBER ROAD

STAGE 1					
TOPSOIL PLACEMENT					
STATION	TOPSOIL (SF)	AVERAGE	LENGTH	TOTAL	TOTAL (CY)
759+00	0.0				
		0.0	100.0	0.0	0.0
760+00	0.0				
		0.0	59.0	0.0	0.0
760+58.97	0.0				
		0.0	41.0	0.0	0.0
761+00	0.0				
		0.0	100.0	0.0	0.0
762+00	0.0				
		0.0	100.0	0.0	0.0
763+00	0.0				
		0.0	100.0	0.0	0.0
764+00	0.0				
		0.0	100.0	0.0	0.0
765+00	0.0				
		7.8	100.0	778.7	28.8
766+00	15.6				
		17.1	100.0	1,711.4	63.4
767+00	18.7				
		20.7	100.0	2,065.6	76.5
768+00	22.7				
		22.6	100.0	2,262.0	83.8
769+00	22.6				
		24.3	100.0	2,429.8	90.0
770+00	26.0				
		27.9	100.0	2,792.3	103.4
771+00	29.8				
		30.0	100.0	3,003.8	111.3
772+00	30.2				
		28.7	100.0	2,872.7	106.4
773+00	27.2				
		25.9	100.0	2,593.8	96.1
774+00	24.7				
		24.6	100.0	2,455.7	91.0
775+00	24.4				
		24.0	100.0	2,396.3	88.8
776+00	23.5				
		23.0	100.0	2,298.0	85.1
777+00	22.5				
		22.3	100.0	2,234.7	82.8
778+00	22.2				
		20.6	100.0	2,062.8	76.4
779+00	19.0				
		19.9	100.0	1,986.5	73.6
780+00	20.7				
		20.2	100.0	2,019.5	74.8
781+00	19.7				
		19.5	100.0	1,946.6	72.1
782+00	19				

WEBER ROAD

STAGE 1					
UNSUITABLE MATERIAL					
STATION	UNSUIT (SF)	AVERAGE	LENGTH	TOTAL	TOTAL (CY)
779+00	0.0				
		32.2	100.0	3,223.3	119.4
780+00	64.5				
		160.4	100.0	16,038.3	594.0
781+00	256.3				
		271.2	100.0	27,122.5	1,004.5
782+00	286.2				
		262.0	100.0	26,202.5	970.5
783+00	237.9				
		221.0	100.0	22,100.0	818.5
784+00	204.1				
		208.3	17.6	3,658.2	135.5
784+17.56	212.6				
		232.9	82.4	19,198.2	711.0
785+00	253.2				
		247.6	100.0	24,760.0	917.0
786+00	242.0				
		245.7	100.0	24,572.5	910.1
787+00	249.5				
		263.4	100.0	26,337.5	975.5
788+00	277.3				
		305.2	100.0	30,522.5	1,130.5
789+00	333.2				
		339.8	100.0	33,980.0	1,258.5
790+00	346.5				
		173.2	20.0	3,464.5	128.3
790+20	0.0				
TOTAL				9,674	

WEBER ROAD

STAGE 1					
AGGREGATE SUBGRADE IMPROVEMENT					
STATION	ASI (SF)	AVERAGE	LENGTH	TOTAL	TOTAL (CY)
779+00	0.0				
		46.6	100.0	4,657.5	172.5
780+00	93.2				
		46.6	100.0	4,657.5	172.5
781+00	0.0				
		0.0	100.0	0.0	0.0
782+00	0.0				
		0.0	100.0	0.0	0.0
783+00	0.0				
		0.0	100.0	0.0	0.0
784+00	0.0				
		0.0	17.6	0.0	0.0
784+17.56	0.0				
		0.0	82.4	0.0	0.0
785+00	0.0				
		0.0	100.0	0.0	0.0
786+00	0.0				
		0.0	100.0	0.0	0.0
787+00	0.0				
		0.0	100.0	0.0	0.0
788+00	0.0				
		0.0	100.0	0.0	0.0
789+00	0.0				
		0.0	100.0	0.0	0.0
790+00	0.0				
		0.0	20.0	0.0	0.0
790+20	0.0				
TOTAL				345	


ROMEO ROAD / 135TH STREET

STAGE 1					
CUT					
STATION	CUT (SF)	AVERAGE	LENGTH	TOTAL	TOTAL (CY)
110+00	0.0				
		0.0	100.0	0.0	0.0
111+00	0.0				
		10.1	100.0	1,007.5	37.3
112+00	20.2				
		22.3	37.5	835.7	31.0
112+37.53	24.4				
		42.0	62.5	2,624.1	97.2
113+00	59.6				
		67.2	25.2	1,696.0	62.8
113+25.24	74.8				
		93.3	64.4	6,009.3	222.6
113+89.66	111.8				
		107.3	10.3	1,109.7	41.1
114+00	102.8				
		99.6	7.0	699.4	25.9
114+07.02	96.4				
		48.2	93.0	4,482.3	166.0
115+00	0.0				
		0.0	100.0	0.0	0.0
116+00	0.0				
		21.5	100.0	2,148.0	79.6
117+00	43.0				
		31.4	100.0	3,139.5	116.3
118+00	19.8				
		16.4	100.0	1,638.6	60.7
119+00	12.9				
		11.5	44.3	510.4	18.9
119+44.27	10.1				
		10.4	55.7	578.0	21.4
120+00	10.6				
		6.3	100.0	629.2	23.3
121+00	2.0				
		3.7	100.0	373.6	13.8
122+00	5.5				
		6.5	7.4	47.8	1.8
122+07.38	7.4				
		14.4	92.6	1,333.0	49.4
123+00	21.4				
		10.7	100.0	1,067.7	39.5
124+00	0.0				
TOTAL				1,069	

ROMEO ROAD / 135TH STREET

STAGE 1					
FILL					
STATION	FILL (SF)	AVERAGE	LENGTH	TOTAL	TOTAL (CY)
110+00	0.0				
		0.0	100.0	0.0	0.0
111+00	0.0				
		0.2	100.0	17.7	0.7
112+00	0.4				
		0.4	37.5	16.0	0.6
112+37.53	0.5				
		0.4	62.5	28.0	1.0
113+00	0.4				
		0.4	25.2	10.4	0.4
113+25.24	0.4				
		0.2	64.4	13.8	0.5
113+89.66	0.0				
		0.0	10.3	0.0	0.0
114+00	0.0				
		0.0	7.0	0.0	0.0
114+07.02	0.0				
		0.0	93.0	0.0	0.0
115+00	0.0				
		0.0	100.0	0.0	0.0
116+00	0.0				
		0.0	100.0	1.6	0.1
117+00	0.0				
		2.3	100.0	225.6	8.4
118+00	4.5				
		10.4	100.0	1,042.0	38.6
119+00	16.4				
		15.9	44.3	705.0	26.1
119+44.27	15.5				
		15.9	55.7	885.8	32.8
120+00	16.3				
		13.5	100.0	1,347.2	49.9
121+00	10.6				
		8.6	100.0	859.0	31.8
122+00	6.5				
		4.7	7.4	34.9	1.3
122+07.38	2.9				
		1.7	92.6	157.1	5.8
123+00	0.5				
		0.2	100.0	23.3	0.9
124+00	0.0				
TOTAL				198	

FILE NAME = D:\B\11-11-17\11-17-17\11-17-17.dgn

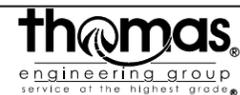

USER NAME = TEG	DESIGNED -	REVISED - 3/3/2015
	DRAWN -	REVISED - 6/19/2015
PLOT SCALE = 2.0000' / 1" =	CHECKED -	REVISED - 9/27/2016
PLOT DATE = 11/14/2017	DATE - 11/15/17	REVISED -

**STATE OF ILLINOIS
DEPARTMENT OF TRANSPORTATION**

SCHEDULE OF QUANTITIES

SCALE: NTS SHEET 7 OF 22 SHEETS STA. TO STA.

F.A.P. RTE.	SECTION	COUNTY	TOTAL SHEETS	SHEET NO.
856	14-00170-42-RP	WILL	394	35
CONTRACT NO. 61D47			ILLINOIS FED. AID PROJECT	

WEBER ROAD

STAGE 2					
CUT					
STATION	CUT (SF)	AVERAGE	LENGTH	TOTAL	TOTAL (CY)
726+00	0.0				
		3.1	100.0	312.3	11.6
727+00	6.2				
		8.8	100.0	884.5	32.8
728+00	11.4				
		13.8	100.0	1,383.7	51.2
729+00	16.2				
		18.0	100.0	1,801.6	66.7
730+00	19.8				
		26.3	100.0	2,629.7	97.4
731+00	32.8				
		31.7	100.0	3,168.8	117.4
732+00	30.6				
		25.9	100.0	2,589.8	95.9
733+00	21.2				
		29.6	100.0	2,960.0	109.6
734+00	38.0				
		51.4	100.0	5,141.5	190.4
735+00	64.8				
		88.3	100.0	8,832.0	327.1
736+00	111.8				
		107.3	100.0	10,734.8	397.6
737+00	102.9				
		71.4	100.0	7,142.8	264.5
738+00	40.0				
		32.3	100.0	3,231.8	119.7
739+00	24.7				
		29.0	100.0	2,904.3	107.6
740+00	33.4				
		33.1	100.0	3,306.0	122.4
741+00	32.7				
		30.9	100.0	3,086.0	114.3
742+00	29.0				
		29.0	100.0	2,904.3	107.6
743+00	29.1				
		29.4	100.0	2,939.3	108.9
744+00	29.7				
		27.5	100.0	2,746.9	101.7
745+00	25.2				
		15.9	100.0	1,585.3	58.7
746+00	6.5				
		11.3	100.0	1,131.9	41.9
747+00	16.2				
		19.4	100.0	1,944.2	72.0
748+00	22.7				
		22.4	100.0	2,237.1	82.9
749+00	22.0				
		22.1	100.0	2,207.7	81.8
750+00	22.1				
		11.1	100.0	1,106.8	41.0
751+00	0.0				
		19.3	100.0	1,933.3	71.6
752+00	38.7				
		19.3	100.0	1,933.3	71.6
753+00	0.0				
		0.1	100.0	6.5	0.2
754+00	0.1				
		0.7	100.0	67.8	2.5
755+00	1.2				
		1.1	5.9	6.6	0.2
755+05.90	1.0				
		0.6	94.1	53.4	2.0
756+00	0.1				
		0.1	100.0	10.9	0.4
757+00	0.1				
		0.1	100.0	10.9	0.4
758+00	0.1				
		0.1	100.0	10.8	0.4
TOTAL				8,576	

WEBER ROAD

STAGE 2					
CUT					
STATION	CUT (SF)	AVERAGE	LENGTH	TOTAL	TOTAL (CY)
759+00	0.1				
		0.1	100.0	5.4	0.2
760+00	0.0				
		0.0	59.0	0.0	0.0
760+58.97	0.0				
		0.3	41.0	12.4	0.5
761+00	0.6				
		8.0	100.0	795.4	29.5
762+00	15.3				
		39.4	100.0	3,944.0	146.1
763+00	63.6				
		67.3	100.0	6,730.5	249.3
764+00	71.0				
		35.5	100.0	3,551.8	131.5
765+00	0.0				
		19.2	100.0	1,920.7	71.1
766+00	38.4				
		33.8	100.0	3,380.4	125.2
767+00	29.2				
		29.1	100.0	2,910.0	107.8
768+00	29.0				
		29.0	100.0	2,898.0	107.3
769+00	29.0				
		27.3	100.0	2,728.0	101.0
770+00	25.6				
		25.9	100.0	2,593.4	96.1
771+00	26.3				
		23.1	100.0	2,314.2	85.7
772+00	20.0				
		15.7	100.0	1,565.2	58.0
773+00	11.3				
		9.3	100.0	932.0	34.5
774+00	7.4				
		5.7	100.0	571.4	21.2
775+00	4.1				
		4.1	100.0	413.4	15.3
776+00	4.2				
		4.3	100.0	434.0	16.1
777+00	4.5				
		3.2	100.0	320.8	11.9
778+00	1.9				
		1.7	100.0	173.9	6.4
779+00	1.5				
		1.6	100.0	158.0	5.9
780+00	1.6				
		64.8	100.0	6,478.3	239.9
781+00	128.0				
		134.5	100.0	13,450.0	498.1
782+00	141.1				
		133.3	100.0	13,325.0	493.5
783+00	125.5				
		119.0	100.0	11,900.0	440.7
784+00	112.6				
		104.7	17.6	1,838.5	68.1
784+17.56	96.9				
		96.2	82.4	7,932.8	293.8
785+00	95.6				
		93.9	100.0	9,387.5	347.7
786+00	92.2				
		95.2	100.0	9,522.5	352.7
787+00	98.3				
		104.5	100.0	10,447.5	386.9
788+00	110.7				
		115.7	100.0	11,570.0	428.5
789+00	120.8				
		129.9	100.0	12,985.0	480.9
790+00	139.0				
		69.5	20.0	1,389.5	51.5
790+20	0.0				
TOTAL				8,576	

WEBER ROAD

STAGE 2					
FILL					
STATION	FILL (SF)	AVERAGE	LENGTH	TOTAL	TOTAL (CY)
726+00	0.0				
		0.9	100.0	94.8	3.5
727+00	1.9				
		2.5	100.0	250.5	9.3
728+00	3.1				
		8.2	100.0	823.0	30.5
729+00	13.3				
		9.9	100.0	987.3	36.6
730+00	6.4				
		6.1	100.0	609.5	22.6
731+00	5.8				
		6.2	100.0	624.3	23.1
732+00	6.7				
		6.6	100.0	664.3	24.6
733+00	6.6				
		6.4	100.0	642.8	23.8
734+00	6.3				
		5.6	100.0	557.5	20.6
735+00	4.9				
		3.3	100.0	330.8	12.3
736+00	1.7				
		7.6	100.0	764.8	28.3
737+00	13.6				
		14.3	100.0	1,432.0	53.0
738+00	15.1				
		22.3	100.0	2,228.8	82.5
739+00	29.5				
		41.8	100.0	4,175.0	154.6
740+00	54.0				
		56.8	100.0	5,681.6	210.4
741+00	59.6				
		62.3	100.0	6,234.6	230.9
742+00	65.1				
		69.1	100.0	6,913.8	256.1
743+00	73.2				
		72.2	100.0	7,218.8	267.4
744+00	71.2				
		59.0	100.0	5,901.8	218.6
745+00	46.9				
		35.5	100.0	3,546.0	131.3
746+00	24.0				
		21.6	100.0	2,157.3	79.9
747+00	19.1				
		36.8	100.0	3,680.0	136.3
748+00	54.5				
		65.6	100.0	6,557.5	242.9
749+00	76.7				
		86.0	100.0	8,603.0	318.6
750+00	95.4				
		47.7	100.0	4,770.5	176.7
751+00	0.0				
		5.3	100.0	530.8	19.7
752+00	10.6				
		43.9	100.0	4,389.5	162.6
753+00	77.2				
		73.6	100.0	7,359.0	272.6
754+00	70.0				
		63.9	100.0	6,387.3	236.6
755+00	57.7				
		58.2	5.9	343.2	12.7
755+05.90	58.6				
		78.0	94.1	7,340.5	271.9
756+00	97.4				
		98.1	100.0	9,810.8	363.4
757+00	98.8				
		101.8	100.0	10,184.3	377.2
758+00	104.9				
		101.9	100.0	10,193.5	377.5
TOTAL				17,865	

WEBER ROAD

STAGE 2					
FILL					
STATION	FILL (SF)	AVERAGE	LENGTH	TOTAL	TOTAL (CY)
759+00	99.0				
		90.3	100.0	9,032.3	334.5
760+00	81.7				
		69.3	59.0	4,083.7	151.2
760+58.97	56.8				
		43.4	41.0	1,780.4	65.9
761+00	30.0				
		22.3	100.0	2,228.8	82.5
762+00	14.6				
		8.7	100.0	866.3	32.1
763+00	2.7				
		2.1	100.0	213.0	7.9
764+00	1.6				
		0.8	100.0	77.5	2.9
765+00	0.0				
		6.3	100.0	627.4	23.2
766+00	12.5				
		25.0	100.0	2,495.4	92.4
767+00	37.4				
		24.5	100.0	2,453.6	90.9
768+00	11.7				
		12.6	100.0	1,259.0	46.6
769+00	13.5				
		16.1	100.0	1,613.6	59.8
770+00	18.8				
		20.4	100.0	2,044.3	75.7
771+00	22.1				
		20.6	100.0	2,064.5	76.5
772+00	19.2				
		26.5	100.0	2,649.2	98.1
773+00	33.8				
		42.7	100.0	4,268.8	158.1
774+00	51.6				
		51.1	100.0	5,112.0	189.3
775+00	50.6				
		55.7	100.0	5,565.1	206.1
776+00	60.7				
		61.7	100.0	6,174.8	228.7
777+00	62.8				
		64.9	100.0	6,491.5	240.4
778+00	67.0				
		79.4	100.0	7,935.3	293.9

WEBER ROAD

STAGE 2 TOPSOIL PLACEMENT					
STATION	TOPSOIL (SF)	AVERAGE	LENGTH	TOTAL	TOTAL (CY)
726+00	0.0	2.5	100.0	254.8	9.4
727+00	5.1	5.3	100.0	533.3	19.8
728+00	5.6	7.7	100.0	767.5	28.4
729+00	9.8	10.1	100.0	1,009.0	37.4
730+00	10.4	10.4	100.0	1,042.5	38.6
731+00	10.5	11.0	100.0	1,096.8	40.6
732+00	11.5	12.0	100.0	1,200.5	44.5
733+00	12.5	13.8	100.0	1,375.8	51.0
734+00	15.0	16.5	100.0	1,647.8	61.0
735+00	18.0	19.7	100.0	1,972.3	73.0
736+00	21.5	21.8	100.0	2,179.8	80.7
737+00	22.1	21.2	100.0	2,122.3	78.6
738+00	20.3	22.0	100.0	2,198.8	81.4
739+00	23.6	24.3	100.0	2,432.3	90.1
740+00	25.0	24.5	100.0	2,447.3	90.6
741+00	23.9	23.5	100.0	2,346.0	86.9
742+00	23.0	22.2	100.0	2,221.0	82.3
743+00	21.4	20.3	100.0	2,025.5	75.0
744+00	19.1	17.6	100.0	1,763.3	65.3
745+00	16.2	15.0	100.0	1,498.8	55.5
746+00	13.8	9.3	100.0	932.3	34.5
747+00	4.9	11.0	100.0	1,099.0	40.7
748+00	17.1	17.0	100.0	1,700.8	63.0
749+00	16.9	17.2	100.0	1,722.5	63.8
750+00	17.5	8.8	100.0	877.3	32.5
751+00	0.0	1.3	100.0	127.5	4.7
752+00	2.6	3.9	100.0	392.3	14.5
753+00	5.3	5.4	100.0	537.5	19.9
754+00	5.5	2.7	100.0	272.8	10.1
755+00	0.0	0.0	5.9	0.0	0.0
755+05.90	0.0	3.0	94.1	279.2	10.3
756+00	5.9	6.0	100.0	598.5	22.2
757+00	6.0	6.1	100.0	608.0	22.5
758+00	6.1	6.0	100.0	603.3	22.3

WEBER ROAD

STAGE 2 TOPSOIL PLACEMENT					
STATION	TOPSOIL (SF)	AVERAGE	LENGTH	TOTAL	TOTAL (CY)
759+00	5.9	6.2	100.0	618.8	22.9
760+00	6.4	6.5	59.0	380.9	14.1
760+58.97	6.5	5.0	41.0	204.3	7.6
761+00	3.5	3.2	100.0	322.8	12.0
762+00	3.0	3.5	100.0	354.0	13.1
763+00	4.1	3.0	100.0	304.9	11.3
764+00	2.0	1.0	100.0	99.9	3.7
765+00	0.0	3.0	100.0	301.0	11.1
766+00	6.0	7.9	100.0	790.0	29.3
767+00	9.8	7.8	100.0	779.8	28.9
768+00	5.8	6.4	100.0	642.5	23.8
769+00	7.0	7.0	100.0	701.3	26.0
770+00	7.0	7.4	100.0	744.0	27.6
771+00	7.9	7.4	100.0	744.0	27.6
772+00	7.0	8.2	100.0	821.0	30.4
773+00	9.4	10.0	100.0	1,002.3	37.1
774+00	10.6	11.1	100.0	1,105.5	40.9
775+00	11.5	11.6	100.0	1,155.8	42.8
776+00	11.6	10.4	100.0	1,043.0	38.6
777+00	9.2	9.2	100.0	923.3	34.2
778+00	9.2	11.1	100.0	1,106.0	41.0
779+00	12.9	12.9	100.0	1,291.5	47.8
780+00	12.9	12.5	100.0	1,245.0	46.1
781+00	12.0	11.8	100.0	1,181.5	43.8
782+00	11.7	11.5	100.0	1,148.5	42.5
783+00	11.3	11.2	100.0	1,115.0	41.3
784+00	11.0	10.5	17.6	184.8	6.8
784+17.56	10.1	7.2	82.4	591.5	21.9
785+00	4.3	4.6	100.0	464.5	17.2
786+00	5.0	5.2	100.0	517.5	19.2
787+00	5.4	5.4	100.0	537.3	19.9
788+00	5.4	5.5	100.0	549.3	20.3
789+00	5.6	5.5	100.0	552.8	20.5
790+00	5.5	2.7	20.0	54.6	2.0
790+20	0.0				
TOTAL				2,425	

WEBER ROAD

STAGE 2 UNSUITABLE MATERIAL					
STATION	UNSUIT (SF)	AVERAGE	LENGTH	TOTAL	TOTAL (CY)
779+00	0.0	35.6	100.0	3,562.5	131.9
780+00	71.3	67.0	100.0	6,702.5	248.2
781+00	62.8	71.0	100.0	7,097.5	262.9
782+00	79.2	76.9	100.0	7,690.0	284.8
783+00	74.7	73.2	100.0	7,315.0	270.9
784+00	71.7	71.6	17.6	1,256.4	46.5
784+17.56	71.5	78.6	82.4	6,481.8	240.1
785+00	85.8	85.5	100.0	8,552.5	316.8
786+00	85.3	87.3	100.0	8,732.5	323.4
787+00	89.4	95.0	100.0	9,502.5	351.9
788+00	100.7	103.9	100.0	10,385.0	384.6
789+00	107.1	116.4	100.0	11,640.0	431.1
790+00	125.8	62.9	20.0	1,257.5	46.6
790+20	0.0				
TOTAL				3,340	

WEBER ROAD

STAGE 2 AGGREGATE SUBGRADE IMPROVEMENT					
STATION	ASI (SF)	AVERAGE	LENGTH	TOTAL	TOTAL (CY)
779+00	0.0	46.6	100.0	4,658.0	172.5
780+00	93.2	46.6	100.0	4,658.0	172.5
781+00	0.0	0.0	100.0	0.0	0.0
782+00	0.0	0.0	100.0	0.0	0.0
783+00	0.0	0.0	100.0	0.0	0.0
784+00	0.0	0.0	17.6	0.0	0.0
784+17.56	0.0	0.0	82.4	0.0	0.0
785+00	0.0	0.0	100.0	0.0	0.0
786+00	0.0	0.0	100.0	0.0	0.0
787+00	0.0	0.0	100.0	0.0	0.0
788+00	0.0	0.0	100.0	0.0	0.0
789+00	0.0	0.0	100.0	0.0	0.0
790+00	0.0	0.0	20.0	0.0	0.0
790+20	0.0				
TOTAL				346	

FILE NAME = D:\B\11-ant-schedule.dgn



USER NAME = TEG	DESIGNED -	REVISED - 3/3/2015
	DRAWN -	REVISED - 6/19/2015
PLOT SCALE = 2.0000' / in.	CHECKED -	REVISED - 9/27/2016
PLOT DATE = 11/14/2017	DATE - 11/15/17	REVISED -

**STATE OF ILLINOIS
DEPARTMENT OF TRANSPORTATION**

SCHEDULE OF QUANTITIES

SCALE: NTS SHEET 10 OF 22 SHEETS STA. TO STA.

F.A.P. RTE.	SECTION	COUNTY	TOTAL SHEETS	SHEET NO.
856	14-00170-42-RP	WILL	394	38
			CONTRACT NO. 61D47	
ILLINOIS FED. AID PROJECT				

ROMEO ROAD / 135TH STREET

STAGE 2					
CUT					
STATION	CUT (SF)	AVERAGE	LENGTH	TOTAL	TOTAL (CY)
110+00	0.0				
		0.0	100.0	0.0	0.0
111+00	0.0				
		3.8	100.0	382.0	14.1
112+00	7.6				
		15.8	37.5	591.7	21.9
112+37.53	23.9				
		22.3	62.5	1,391.2	51.5
113+00	20.7				
		51.4	25.2	1,297.1	48.0
113+25.24	82.1				
		56.7	64.4	3,652.6	135.3
113+89.66	31.3				
		39.2	10.3	405.2	15.0
114+00	47.1				
		45.0	7.0	316.2	11.7
114+07.02	43.0				
		28.9	93.0	2,687.1	99.5
115+00	14.8				
		7.4	100.0	741.5	27.5
116+00	0.0				
		6.1	100.0	612.3	22.7
117+00	12.2				
		8.8	100.0	876.8	32.5
118+00	5.3				
		3.6	100.0	359.0	13.3
119+00	1.9				
		2.4	44.3	108.0	4.0
119+44.27	3.0				
		2.5	55.7	138.2	5.1
120+00	2.0				
		2.8	100.0	276.5	10.2
121+00	3.6				
		5.4	100.0	539.3	20.0
122+00	7.2				
		10.3	7.4	76.0	2.8
122+07.38	13.4				
		17.9	92.6	1,653.7	61.2
123+00	22.3				
		11.5	100.0	1,147.5	42.5
124+00	0.6				
TOTAL				639	

ROMEO ROAD / 135TH STREET

STAGE 2					
FILL					
STATION	FILL (SF)	AVERAGE	LENGTH	TOTAL	TOTAL (CY)
110+00	0.0				
		0.0	100.0	0.0	0.0
111+00	0.0				
		0.0	100.0	0.0	0.0
112+00	0.0				
		0.2	37.5	9.0	0.3
112+37.53	0.5				
		2.8	62.5	175.5	6.5
113+00	5.1				
		2.6	25.2	64.9	2.4
113+25.24	0.0				
		8.5	64.4	545.3	20.2
113+89.66	16.9				
		8.5	10.3	87.5	3.2
114+00	0.0				
		0.0	7.0	0.0	0.0
114+07.02	0.0				
		0.0	93.0	0.0	0.0
115+00	0.0				
		0.0	100.0	0.0	0.0
116+00	0.0				
		9.1	100.0	909.3	33.7
117+00	18.2				
		18.4	100.0	1,837.5	68.1
118+00	18.6				
		12.0	100.0	1,201.3	44.5
119+00	5.5				
		5.2	44.3	228.8	8.5
119+44.27	4.9				
		4.8	55.7	267.4	9.9
120+00	4.7				
		7.9	100.0	791.7	29.3
121+00	11.1				
		8.7	100.0	869.5	32.2
122+00	6.3				
		3.5	7.4	25.7	1.0
122+07.38	0.7				
		1.0	92.6	95.0	3.5
123+00	1.4				
		1.5	100.0	152.8	5.7
124+00	1.7				
TOTAL				269	

ROMEO ROAD / 135TH STREET

STAGE 2					
TOPSOIL PLACEMENT					
STATION	TOPSOIL (SF)	AVERAGE	LENGTH	TOTAL	TOTAL (CY)
110+00	0.0				
		0.0	100.0	0.0	0.0
111+00	0.0				
		0.0	100.0	0.0	0.0
112+00	0.0				
		0.0	37.5	0.0	0.0
112+37.53	0.0				
		2.8	62.5	176.5	6.5
113+00	5.7				
		2.8	25.2	71.3	2.6
113+25.24	0.0				
		6.1	64.4	396.0	14.7
113+89.66	12.3				
		6.1	10.3	63.6	2.4
114+00	0.0				
		0.0	7.0	0.0	0.0
114+07.02	0.0				
		0.0	93.0	0.0	0.0
115+00	0.0				
		0.0	100.0	0.0	0.0
116+00	0.0				
		5.1	100.0	514.0	19.0
117+00	10.3				
		9.4	100.0	937.8	34.7
118+00	8.5				
		5.5	100.0	552.8	20.5
119+00	2.6				
		2.6	44.3	114.5	4.2
119+44.27	2.6				
		2.3	55.7	129.6	4.8
120+00	2.1				
		3.2	100.0	318.0	11.8
121+00	4.3				
		4.4	100.0	442.5	16.4
122+00	4.5				
		2.3	7.4	16.8	0.6
122+07.38	0.0				
		1.4	92.6	129.2	4.8
123+00	2.8				
		2.3	100.0	228.0	8.4
124+00	1.8				
TOTAL				152	

FILE NAME = D:\B\11-ent-schedule.dgn



USER NAME = TEG	DESIGNED -	REVISED - 3/3/2015
	DRAWN -	REVISED - 6/19/2015
PLOT SCALE = 2.0000' / 1" =	CHECKED -	REVISED - 9/27/2016
PLOT DATE = 11/14/2017	DATE - 11/15/17	REVISED -

**STATE OF ILLINOIS
DEPARTMENT OF TRANSPORTATION**

SCHEDULE OF QUANTITIES

SCALE: NTS SHEET 11 OF 22 SHEETS STA. TO STA.

F.A.P. RTE.	SECTION	COUNTY	TOTAL SHEETS	SHEET NO.
856	14-00170-42-RP	WILL	394	39
CONTRACT NO. 61D47				
ILLINOIS FED. AID PROJECT				

N. CARILLON DRIVE / GRAND BOULEVARD

STAGE 2					
CUT					
STATION	CUT (SF)	AVERAGE	LENGTH	TOTAL	TOTAL (CY)
230+00	0.0				
		0.0	100.0	0.0	0.0
231+00	0.0				
		19.7	100.0	1,967.3	72.9
232+00	39.3				
		41.6	29.7	1,235.1	45.7
232+29.70	43.8				
		64.3	70.3	4,520.7	167.4
233+00	84.8				
		58.9	100.0	5,887.6	218.1
234+00.	33.0				
		16.5	100.0	1,648.3	61.0
235+00.	0.0				
		41.7	100.0	4,174.0	154.6
236+00	83.5				
		56.5	100.0	5,649.3	209.2
237+00.	29.5				
		22.0	100.0	2,203.8	81.6
238+00	14.6				
TOTAL					1,011

N. CARILLON DRIVE / GRAND BOULEVARD

STAGE 2					
FILL					
STATION	FILL (SF)	AVERAGE	LENGTH	TOTAL	TOTAL (CY)
230+00	0.0				
		0.0	100.0	0.0	0.0
231+00	0.0				
		0.0	100.0	0.0	0.0
232+00	0.0				
		0.0	29.7	0.0	0.0
232+29.70	0.0				
		0.5	70.3	33.5	1.2
233+00	1.0				
		5.5	100.0	554.5	20.5
234+00.	10.1				
		5.1	100.0	506.8	18.8
235+00.	0.0				
		0.3	100.0	32.0	1.2
236+00	0.6				
		2.7	100.0	272.0	10.1
237+00.	4.8				
		4.7	100.0	469.3	17.4
238+00	4.6				
TOTAL					70

N. CARILLON DRIVE / GRAND BOULEVARD

STAGE 2					
TOPSOIL REMOVAL					
STATION	TOPSOIL (SF)	AVERAGE	LENGTH	TOTAL	TOTAL (CY)
230+00	0.0				
		0.0	100.0	0.0	0.0
231+00	0.0				
		0.0	100.0	0.0	0.0
232+00	0.0				
		0.0	29.7	0.0	0.0
232+29.70	0.0				
		7.7	70.3	541.7	20.1
233+00	15.4				
		12.0	100.0	1,200.8	44.5
234+00.	8.6				
		4.3	100.0	430.2	15.9
235+00.	0.0				
		0.0	100.0	0.0	0.0
236+00	0.0				
		0.0	100.0	0.0	0.0
237+00.	0.0				
		0.0	100.0	0.0	0.0
238+00	0.0				
TOTAL					81

N. CARILLON DRIVE / GRAND BOULEVARD

STAGE 2					
TOPSOIL PLACEMENT					
STATION	TOPSOIL (SF)	AVERAGE	LENGTH	TOTAL	TOTAL (CY)
230+00	0.0				
		0.0	100.0	0.0	0.0
231+00	0.0				
		0.0	100.0	0.0	0.0
232+00	0.0				
		0.0	29.7	0.0	0.0
232+29.70	0.0				
		5.4	70.3	382.8	14.2
233+00	10.9				
		9.2	100.0	919.4	34.1
234+00.	7.5				
		3.7	100.0	374.9	13.9
235+00.	0.0				
		0.9	100.0	87.5	3.2
236+00	1.8				
		3.2	100.0	317.8	11.8
237+00.	4.6				
		5.2	100.0	518.3	19.2
238+00	5.8				
TOTAL					97

FILE NAME = D:\B\11-11-17-schedule.dgn



USER NAME = TEG	DESIGNED -	REVISED - 3/3/2015
	DRAWN -	REVISED - 6/19/2015
PLOT SCALE = 2.0000' / 1" =	CHECKED -	REVISED - 9/27/2016
PLOT DATE = 11/14/2017	DATE - 11/15/17	REVISED -

**STATE OF ILLINOIS
DEPARTMENT OF TRANSPORTATION**

SCHEDULE OF QUANTITIES

SCALE: NTS SHEET 12 OF 22 SHEETS STA. TO STA.

F.A.P. RTE.	SECTION	COUNTY	TOTAL SHEETS	SHEET NO.
856	14-00170-42-RP	WILL	394	40
			CONTRACT NO. 61D47	
ILLINOIS FED. AID PROJECT				

WEBER ROAD

STAGE 3					
CUT					
STATION	CUT (SF)	AVERAGE	LENGTH	TOTAL	TOTAL (CY)
726+00	0.0	0.0	100.0	0.0	0.0
727+00	0.0	0.0	100.0	0.0	0.0
728+00	0.0	0.0	100.0	0.0	0.0
729+00	0.0	0.0	100.0	0.0	0.0
730+00	0.0	0.0	100.0	0.0	0.0
731+00	0.0	0.0	100.0	0.0	0.0
732+00	0.0	0.0	100.0	0.0	0.0
733+00	0.0	0.0	100.0	0.0	0.0
734+00	0.0	0.0	100.0	0.0	0.0
735+00	0.0	0.0	100.0	0.0	0.0
736+00	0.0	2.4	100.0	244.3	9.0
737+00	4.9	6.5	100.0	646.5	23.9
738+00	8.0	9.5	100.0	952.5	35.3
739+00	11.0	12.4	100.0	1,238.5	45.9
740+00	13.8	9.4	100.0	937.3	34.7
741+00	5.0	5.0	100.0	498.0	18.4
742+00	5.0	5.3	100.0	531.8	19.7
743+00	5.7	6.0	100.0	595.0	22.0
744+00	6.2	6.2	100.0	624.5	23.1
745+00	6.2	6.2	100.0	624.8	23.1
746+00	6.3	6.3	100.0	633.0	23.4
747+00	6.4	6.4	100.0	641.0	23.7
748+00	6.4	6.4	100.0	640.8	23.7
749+00	6.4	6.4	100.0	640.8	23.7
750+00	6.4	3.2	100.0	320.5	11.9
751+00	0.0	0.0	100.0	0.0	0.0
752+00	0.0	16.6	100.0	1,660.5	61.5
753+00	33.2	33.2	100.0	3,323.8	123.1
754+00	33.3	33.3	100.0	3,328.0	123.3
755+00	33.3	33.3	5.9	196.4	7.3
755+05.90	33.3	32.9	94.1	3,092.6	114.5
756+00	32.4	23.8	100.0	2,378.3	88.1
757+00	15.1	10.6	100.0	1,058.5	39.2
758+00	6.0	4.3	100.0	432.8	16.0

WEBER ROAD

STAGE 3					
CUT					
STATION	CUT (SF)	AVERAGE	LENGTH	TOTAL	TOTAL (CY)
759+00	2.6	2.6	100.0	261.5	9.7
760+00	2.6	2.6	59.0	152.6	5.7
760+58.97	2.6	3.4	41.0	138.1	5.1
761+00	4.2	5.6	100.0	558.8	20.7
762+00	7.0	6.7	100.0	670.8	24.8
763+00	6.4	6.4	100.0	636.0	23.6
764+00	6.3	3.2	100.0	315.5	11.7
765+00	0.0	0.0	100.0	0.0	0.0
766+00	0.0	19.5	100.0	1,950.5	72.2
767+00	39.0	38.8	100.0	3,881.3	143.8
768+00	38.6	38.8	100.0	3,880.8	143.7
769+00	39.0	31.4	100.0	3,143.0	116.4
770+00	23.9	18.9	100.0	1,887.0	69.9
771+00	13.9	9.8	100.0	979.8	36.3
772+00	5.7	5.6	100.0	564.0	20.9
773+00	5.6	6.8	100.0	679.0	25.1
774+00	8.0	8.9	100.0	886.0	32.8
775+00	9.7	10.9	100.0	1,093.5	40.5
776+00	12.2	11.0	100.0	1,100.0	40.7
777+00	9.8	9.4	100.0	935.5	34.6
778+00	8.9	8.9	100.0	886.0	32.8
779+00	8.8	10.8	100.0	1,076.5	39.9
780+00	12.7	9.4	100.0	937.5	34.7
781+00	6.1	6.1	100.0	606.4	22.5
782+00	6.1	6.1	100.0	606.4	22.5
783+00	6.1	6.1	100.0	606.4	22.5
784+00	6.1	6.1	17.6	106.5	3.9
784+17.56	6.1	6.1	82.4	499.2	18.5
785+00	6.0	6.0	100.0	604.7	22.4
786+00	6.0	6.1	100.0	605.5	22.4
787+00	6.1	6.1	100.0	606.3	22.5
788+00	6.1	6.1	100.0	606.3	22.5
789+00	6.1	6.1	100.0	608.2	22.5
790+00	6.1	3.1	20.0	61.0	2.3
790+20	0.0				
TOTAL				2,125	


WEBER ROAD

STAGE 3					
FILL					
STATION	FILL (SF)	AVERAGE	LENGTH	TOTAL	TOTAL (CY)
726+00	0.0	0.0	100.0	0.0	0.0
727+00	0.0	0.0	100.0	0.0	0.0
728+00	0.0	0.0	100.0	0.0	0.0
729+00	0.0	0.0	100.0	0.0	0.0
730+00	0.0	0.0	100.0	0.0	0.0
731+00	0.0	0.0	100.0	0.0	0.0
732+00	0.0	0.0	100.0	0.0	0.0
733+00	0.0	0.0	100.0	0.0	0.0
734+00	0.0	0.0	100.0	0.0	0.0
735+00	0.0	0.0	100.0	0.0	0.0
736+00	0.0	0.0	100.0	0.0	0.0
737+00	0.0	0.0	100.0	0.0	0.0
738+00	0.0	0.0	100.0	0.0	0.0
739+00	0.0	0.0	100.0	0.0	0.0
740+00	0.0	12.0	100.0	1,204.0	44.6
741+00	24.1	27.1	100.0	2,711.3	100.4
742+00	30.1	29.8	100.0	2,975.8	110.2
743+00	29.4	28.0	100.0	2,798.3	103.6
744+00	26.6	26.6	100.0	2,659.5	98.5
745+00	26.6	26.6	100.0	2,659.3	98.5
746+00	26.6	21.8	100.0	2,177.0	80.6
747+00	17.0	14.2	100.0	1,424.8	52.8
748+00	11.5	11.5	100.0	1,151.8	42.7
749+00	11.5	11.5	100.0	1,149.0	42.6
750+00	11.5	5.7	100.0	574.5	21.3
751+00	0.0	0.0	100.0	0.0	0.0
752+00	0.0	1.8	100.0	181.3	6.7
753+00	3.6	3.7	100.0	366.0	13.6
754+00	3.7	3.7	100.0	368.3	13.6
755+00	3.7	3.7	5.9	21.7	0.8
755+05.90	3.7	3.6	94.1	341.8	12.7
756+00	3.6	8.8	100.0	875.8	32.4
757+00	13.9	18.5	100.0	1,848.5	68.5
758+00	23.1	26.7	100.0	2,666.8	98.8

WEBER ROAD

STAGE 3					
FILL					
STATION	FILL (SF)	AVERAGE	LENGTH	TOTAL	TOTAL (CY)
759+00	30.3	30.4	100.0	3,036.5	112.5
760+00	30.4	30.4	59.0	1,791.1	66.3
760+58.97	30.3	26.1	41.0	1,069.1	39.6
761+00	21.8	18.2	100.0	1,824.8	67.6
762+00	14.7	13.1	100.0	1,308.5	48.5
763+00	11.5	11.4	100.0	1,143.5	42.4
764+00	11.4	5.7	100.0	569.0	21.1
765+00	0.0	0.0	100.0	0.0	0.0
766+00	0.0	0.0	100.0	0.0	0.0
767+00	0.0	0.0	100.0	0.0	0.0
768+00	0.0	0.0	100.0	0.0	0.0
769+00	0.0	2.2	100.0	219.3	8.1
770+00	4.4	7.3	100.0	732.5	27.1
771+00	10.3	14.3	100.0	1,430.8	53.0
772+00	18.4	18.9	100.0	1,894.5	70.2
773+00	19.5	17.0	100.0	1,700.4	63.0
774+00	14.5	13.3	100.0	1,326.6	49.1
775+00	12.1	8.6	100.0	862.9	32.0
776+00	5.2	4.4	100.0	437.3	16.2
777+00	3.6	5.4	100.0	543.5	20.1
778+00	7.3	8.1	100.0	805.7	29.8
779+00	8.8	8.4	100.0	837.3	31.0
780+00	8.0	8.2	100.0	820.0	30.4
781+00	8.5	8.5	100.0	845.0	31.3
782+00	8.5	8.5	100.0	845.0	31.3
783+00	8.5	8.5	100.0	845.0	31.3
784+00	8.5	8.5	17.6	148.4	5.5
784+17.56	8.5	8.5	82.4	696.6	25.8
785+00	8.5	8.5	100.0	845.0	31.3
786+00	8.5	8.5	100.0	845.0	31.3
787+00	8.5	8.5	100.0	845.0	31.3
788+00	8.5	8.5	100.0	845.0	31.3
789+00	8.5	8.5	100.0	845.0	31.3
790+00	8.5	4.2	20.0	84.5	3.1
790+20	0.0				
TOTAL				2,156	

FILE NAME = D:\BX11-ant-schedule.dgn

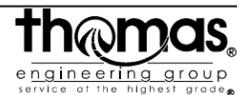

USER NAME = TEG
 DESIGNED -
 DRAWN -
 PLOT SCALE = 2.0000' / 1" =
 PLOT DATE = 11/14/2017

DESIGNED -
 DRAWN -
 CHECKED -
 DATE = 11/15/17

REVISED - 3/3/2015
 REVISED - 6/19/2015
 REVISED - 9/27/2016
 REVISED -

**STATE OF ILLINOIS
 DEPARTMENT OF TRANSPORTATION**

SCHEDULE OF QUANTITIES

SCALE: NTS SHEET 13 OF 22 SHEETS STA. TO STA.

F.A.P. RTE.	SECTION	COUNTY	TOTAL SHEETS	SHEET NO.
856	14-00170-42-RP	WILL	394	41
CONTRACT NO. 61D47				
ILLINOIS FED. AID PROJECT				

ROMEO ROAD / 135TH STREET

STAGE 3					
TOPSOIL PLACEMENT					
STATION	TOPSOIL (SF)	AVERAGE	LENGTH	TOTAL	TOTAL (CY)
110+00	0.0				
		0.0	100.0	0.0	0.0
111+00	0.0				
		0.6	100.0	57.0	2.1
112+00	1.1				
		3.2	37.5	121.1	4.5
112+37.53	5.3				
		4.9	62.5	306.4	11.3
113+00	4.5				
		4.1	25.2	104.3	3.9
113+25.24	3.8				
		1.9	64.4	121.4	4.5
113+89.66	0.0				
		0.0	10.3	0.0	0.0
114+00	0.0				
		0.0	7.0	0.0	0.0
114+07.02	0.0				
		0.0	93.0	0.0	0.0
115+00	0.0				
		0.0	100.0	0.0	0.0
116+00	0.0				
		0.0	100.0	0.0	0.0
117+00	0.0				
		0.0	100.0	0.0	0.0
118+00	0.0				
		0.0	100.0	0.0	0.0
119+00	0.0				
		0.0	44.3	0.0	0.0
119+44.27	0.0				
		0.0	55.7	0.0	0.0
120+00	0.0				
		0.0	100.0	0.0	0.0
121+00	0.0				
		0.0	100.0	0.0	0.0
122+00	0.0				
		0.0	7.4	0.0	0.0
122+07.38	0.0				
		0.0	92.6	0.0	0.0
123+00	0.0				
		0.0	100.0	0.0	0.0
124+00	0.0				
TOTAL				27	

N. CARILLON DRIVE / GRAND BOULEVARD

STAGE 3					
CUT					
STATION	CUT (SF)	AVERAGE	LENGTH	TOTAL	TOTAL (CY)
230+00	1.3				
		1.3	100.0	130.8	4.8
231+00	1.3				
		0.7	100.0	65.3	2.4
232+00	0.0				
		0.0	29.7	0.0	0.0
232+29.70	0.0				
		5.6	70.3	396.8	14.7
233+00	11.3				
		11.1	100.0	1,112.5	41.2
234+00	11.0				
		5.5	100.0	548.0	20.3
235+00	0.0				
		7.1	100.0	705.8	26.1
236+00	14.1				
		9.5	100.0	950.0	35.2
237+00	4.9				
		3.3	100.0	331.5	12.3
238+00	1.7				
TOTAL				158	

N. CARILLON DRIVE / GRAND BOULEVARD

STAGE 3					
FILL					
STATION	FILL (SF)	AVERAGE	LENGTH	TOTAL	TOTAL (CY)
230+00	20.0				
		14.1	100.0	1,410.3	52.2
231+00	8.2				
		4.1	100.0	410.3	15.2
232+00	0.0				
		0.0	29.7	0.0	0.0
232+29.70	0.0				
		0.0	70.3	0.0	0.0
233+00	0.0				
		0.0	100.0	0.0	0.0
234+00	0.0				
		0.0	100.0	0.0	0.0
235+00	0.0				
		0.0	100.0	0.0	0.0
236+00	0.0				
		2.3	100.0	229.3	8.5
237+00	4.6				
		7.9	100.0	788.0	29.2
238+00	11.2				
TOTAL				106	

N. CARILLON DRIVE / GRAND BOULEVARD

STAGE 3					
TOPSOIL PLACEMENT					
STATION	TOPSOIL (SF)	AVERAGE	LENGTH	TOTAL	TOTAL (CY)
230+00	5.9				
		4.2	100.0	417.5	15.5
231+00	2.5				
		1.2	100.0	124.0	4.6
232+00	0.0				
		0.0	29.7	0.0	0.0
232+29.70	0.0				
		0.6	70.3	45.0	1.7
233+00	1.3				
		1.3	100.0	127.0	4.7
234+00	1.3				
		0.6	100.0	63.0	2.3
235+00	0.0				
		0.0	100.0	0.0	0.0
236+00	0.0				
		1.5	100.0	145.8	5.4
237+00	2.9				
		2.9	100.0	291.5	10.8
238+00	2.9				
TOTAL				45	

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USER NAME = TEG	DESIGNED -	REVISED - 3/3/2015
	DRAWN -	REVISED - 6/19/2015
PLOT SCALE = 2.0000' / 1" =	CHECKED -	REVISED - 9/27/2016
PLOT DATE = 11/14/2017	DATE - 11/15/17	REVISED -

**STATE OF ILLINOIS
DEPARTMENT OF TRANSPORTATION**

SCHEDULE OF QUANTITIES

SCALE: NTS SHEET 15 OF 22 SHEETS STA. TO STA.

F.A.P. RTE.	SECTION	COUNTY	TOTAL SHEETS	SHEET NO.
856	14-00170-42-RP	WILL	394	43
			CONTRACT NO. 61D47	
ILLINOIS FED. AID PROJECT				

EARTHWORK SUMMARY

ROADWAY & STAGE		EARTHWORK								
		EARTH EXCAVATION	ADJ. EARTH EXCAVATION (15%)	EMBANKMENT	EARTHWORK BALANCE WASTE (+) OR SHORTAGE (-)	STAGE TOPSOIL EXCAVATION	STAGE TOPSOIL PLACEMENT	TOPSOIL BALANCE WASTE (+) OR SHORTAGE (-)	REMOVAL OF UNSUITABLE MATERIALS	AGG. SUBGRADE IMPROVEMENT AT UNDERCUT AREAS
		(CU YD)	(CU YD)	(CU YD)	(CU YD)	(CU YD)	(CU YD)	(CU YD)	(CU YD)	(CU YD)
PRE-STAGE	WEBER ROAD	23,407	19,896	10,500	9,396	8,807	1,371	7,436	3,012	0
	135TH STREET / ROMEO ROAD	3,420	2,907	207	2,700	672	215	457	0	0
	N. CARILLON DR / GRAND BLVD	211	180	48	132	104	0	104	0	0
STAGE 1	WEBER ROAD	4,832	4,108	25,836	-21,728	2,743	1,034	1,709	9,674	345
	135TH STREET / ROMEO ROAD	1,069	909	198	711	242	36	206	0	0
	N. CARILLON DR / GRAND BLVD	1,219	1,037	23	1,014	135	49	86	0	0
STAGE 2	WEBER ROAD	8,576	7,290	17,865	-10,575	0	2,425	-2,425	3,340	346
	135TH STREET / ROMEO ROAD	639	544	269	275	0	152	-152	0	0
	N. CARILLON DR / GRAND BLVD	1,011	860	70	790	81	97	-16	0	0
STAGE 3	WEBER ROAD	2,125	1,807	2,156	-349	0	750	-750	0	0
	135TH STREET / ROMEO ROAD	31	27	58	-31	0	27	-27	0	0
	N. CARILLON DR / GRAND BLVD	158	135	106	29	0	45	-45	0	0
TOTAL VOLUMES		46,698	39,700	57,336	-17,636*	12,784*	6,201	6,583	16,026	691

*SEE NOTE 2 *SEE NOTE 1

EARTHWORK QUANTITY SUMMARY		
ITEM CODE	PAY ITEMS	CU YD
20200100	EARTH EXCAVATION	46,698
20201200	REMOVAL AND DISPOSAL OF UNSUITABLE MATERIAL	16,026
20400800	FURNISHED EXCAVATION	25,845
21101505	TOPSOIL EXCAVATION AND PLACEMENT	12,784
30300001	AGGREGATE SUBGRADE IMPROVEMENT	691

PAY ITEM NO. 20400800 "FURNISHED EXCAVATION" QUANTITY WILL BE INCREASED BY A PORTION OF THE QUANTITY FOR PAY ITEM NO. 66900200 "NON-SPECIAL WASTE DISPOSAL" WHICH IS 18,830 CY. A DEDUCTION OF 10,621 CY OF NON-SPECIAL WASTE DISPOSAL FROM THE TOTAL 18,830 CY HAS BEEN INCLUDED IN THE CALCULATIONS. THIS 10,621 CY DEDUCTION IS THE AMOUNT OF EARTH EXCAVATION FROM THE PSI THROUGH THE LILY CACHE SLOUGH, WHICH ASSUMES THE EXCAVATION IS NOT UNSUITABLE MATERIAL. THE BELOW CALCULATION BREAKS DOWN THE TOTAL QUANTITY FOR "FURNISHED EXCAVATION."

17,636 CY OF "FURNISHED EXCAVATION"
 + 18,830 CY OF "NON-SPECIAL WASTE DISPOSAL"
 - 10,621 CY OF "NON-SPECIAL WASTE DISPOSAL" (QUANTIFIED AS UNSUITABLE MATERIAL)
 = 25,845 CY OF "FURNISHED EXCAVATION"

NOTES

- "TOPSOIL EXCAVATION AND PLACEMENT" WILL BE MEASURED FOR PAYMENT BASED ON THE TOTAL VOLUME OF TOPSOIL EXCAVATED. THE CONTRACTOR IS RESPONSIBLE FOR THE REMOVAL AND PROPER DISPOSAL OF THE WASTE TOPSOIL FROM THE PROJECT SITE. THIS WORK AND ALL ASSOCIATED COSTS, IN ACCORDANCE WITH STANDARD SPECIFICATIONS, ARE INCLUDED IN THE PAY ITEM "TOPSOIL EXCAVATION AND PLACEMENT."
- THE QUANTITY OF PAY ITEM 66900200: "NON-SPECIAL WASTE DISPOSAL" WILL REDUCE THE AMOUNT OF AVAILABLE EMBANKMENT MATERIALS. THE QUANTITY OF FURNISHED EXCAVATION HAS BEEN ADJUSTED TO REFLECT THIS.

FILE NAME = D:\B\11-ent-schedule.dgn



USER NAME = TEG	DESIGNED -	REVISED - 3/3/2015
	DRAWN -	REVISED - 6/19/2015
PLOT SCALE = 2.0000' / in.	CHECKED -	REVISED - 9/27/2016
PLOT DATE = 11/14/2017	DATE - 11/15/17	REVISED -

**STATE OF ILLINOIS
DEPARTMENT OF TRANSPORTATION**

SCHEDULE OF QUANTITIES			
SCALE: NTS	SHEET 16	OF 22 SHEETS	STA. TO STA.

F.A.P. RTE.	SECTION	COUNTY	TOTAL SHEETS	SHEET NO.
856	14-00170-42-RP	WILL	394	44
CONTRACT NO. 61D47				
ILLINOIS FED. AID PROJECT				

DRAINAGE STRUCTURE AND STORM SEWER REMOVAL SCHEDULE

DRAINAGE STRUCTURE TO BE REMOVED (Z0018700)			
STATION	OFFSET	STRUCTURE	EACH
WEBER ROAD			
737+02.17	46.5 RT	Flared End Section	1
737+02.22	26.4 RT	Inlet	1
737+04.57	27.5 LT	Inlet	1
739+79.74	27.61 LT	Inlet	1
739+79.86	26.53 RT	Inlet	1
739+79.83	39.65 RT	Flared End Section	1
742+63.52	28.87 LT	Inlet	1
742+63.44	25.01 RT	Inlet	1
742+63.18	42.42 RT	Flared End Section	1
745+43.02	31.78 LT	Inlet	1
745+44.07	24.07 RT	Inlet	1
745+43.08	37.36 RT	Flared End Section	1
748+02.80	37.71 LT	Inlet	1
748+03.75	46.26 RT	Flared End Section	1
748+04.50	34.35 RT	Inlet	1
748+04.43	49.83 LT	Manhole	1
750+49.86	52.85 LT	Manhole	1
750+49.58	40.48 LT	Inlet	1
750+50.68	37.62 RT	Inlet	1
750+49.68	52.71 RT	Flared End Section	1
750+76.84	85.82 RT	Flared End Section	1
750+89.20	94.0 LT	Catch Basin	1
750+89.69	52.9 LT	Manhole	1
751+84.39	65.9 LT	Catch Basin	1
751+97.56	53.0 LT	Manhole	1
752+17.69	28.00 RT	Inlet	1
752+26.95	34.1 RT	Manhole	1
752+31.35	77.33 LT	Catch Basin	1
754+47.36	81.8 LT	Catch Basin	1
754+59.90	41.39 RT	Inlet	1
754+78.22	34.58 RT	Manhole	1
754+75.24	40.59 LT	Inlet	1
754+76.62	46.42 LT	Catch Basin	1
756+04.46	46.84 LT	Catch Basin	1
756+97.33	36.69 RT	Catch Basin	1
757+56.14	25.41 RT	Inlet	1
757+54.90	40.56 LT	Inlet	1
757+60.36	50.90 LT	Catch Basin	1
759+99.60	46.40 LT	Manhole	1
760+15.94	61.39 LT	Manhole	1
760+26.69	40.18 LT	Catch Basin	1
760+28.32	61.16 LT	Inlet	1
760+26.00	27.07 RT	Inlet	1
762+79.89	61.32 LT	Catch Basin	1
763+00.64	39.76 LT	Inlet/Catch Basin	1
763+01.65	46.53 LT	Manhole	1
763+00.41	39.12 RT	Inlet	1
763+77.48	45.51 LT	Manhole	1
765+61.28	47.3 RT	Inlet	1
766+60.80	50.01 LT	Inlet	1
766+61.53	56.81 LT	Manhole	1
768+00.21	29.9 RT	Inlet	1
768+29.27	122.43 RT	Flared End Section	1
768+58.03	48.10 LT	Inlet	1
768+59.69	58.61 LT	Manhole	1
770+45.12	111.22 RT	Flared End Section	1
770+52.87	45.67 LT	Manhole	1
770+51.25	37 LT	Inlet	1
770+50.33	31.56 RT	Inlet	1
771+32.89	46.08 RT	Flared End Section	1
772+83.94	70.52 LT	Manhole	1
772+99.86	34.30 LT	Inlet	1
772+99.98	46.94 LT	Flared End Section	1
773+00.77	26.62 RT	Inlet	1
773+00.28	51.13 RT	Manhole	1
775+49.97	48.95 LT	Flared End Section	1
775+50.58	33.28 LT	Inlet	1
775+50.76	20.86 RT	Inlet	1
775+52.78	48.86 RT	Manhole	1

DRAINAGE STRUCTURE TO BE REMOVED (Z0018700)			
STATION	OFFSET	STRUCTURE	EACH
776+83.12	34.79 RT	Flared End Section	1
777+16.61	35.27 RT	Flared End Section	1
777+47.09	47.34 RT	Catch Basin	1
777+75.18	60.61 RT	Manhole	1
778+00.01	32.04 RT	Flared End Section	1
778+00.66	18.37 RT	Inlet	1
778+00.17	35.83 LT	Inlet	1
778+00.54	51.49 LT	Flared End Section	1
778+19.63	35.07 RT	Flared End Section	1
778+88.95	35.94 RT	Flared End Section	1
779+77.13	37.78 RT	Flared End Section	1
780+21.87	38.21 RT	Flared End Section	1
780+49.63	56.67 LT	Flared End Section	1
780+49.27	36.51 LT	Inlet	1
780+50.88	17.65 RT	Inlet	1
780+50.12	33.83 RT	Flared End Section	1
783+39.69	54.04 LT	Flared End Section	1
783+39.28	32.88 LT	Inlet	1
783+40.40	21.35 RT	Inlet	1
783+39.82	40.40 RT	Flared End Section	1
785+94.82	48.25 LT	Flared End Section	1
785+95.39	29.24 LT	Inlet	1
785+96.00	25.41 RT	Inlet	1
785+95.52	43.47 RT	Flared End Section	1
786+00.98	44.81 LT	Flared End Section	1
786+00.42	39.70 RT	Flared End Section	1
786+05.28	48.33 LT	Flared End Section	1
786+05.03	29.34 LT	Inlet	1
786+05.14	25.51 RT	Inlet	1
786+05.00	43.56 RT	Flared End Section	1
789+00.66	49.07 LT	Flared End Section	1
789+08.67	29.56 LT	Inlet	1
789+00.66	25.10 RT	Inlet	1
788+99.90	46.95 RT	Flared End Section	1
ROMEO ROAD / 135TH ST			
111+99.02	25.68 LT	Manhole	1
114+41.32	56.22 RT	Catch Basin	1
114+64.50	39.47 RT	Manhole	1
114+71.78	26.2 RT	Inlet	1
114.71.41	28.29 LT	Inlet	1
115+99.12	31.57 LT	Inlet	1
115+98.85	45.91 RT	Inlet	1
116+17.75	35.39 LT	Manhole	1
116+18.32	42.9 RT	Manhole	1
116+23.71	27.36 LT	Inlet	1
116+23.55	32.30 RT	Inlet	1
117+57.85	32.74 LT	Inlet	1
117+59.04	29.58 RT	Inlet	1
118+39.15	34.60 LT	Inlet	1
118+39.11	29.00 RT	Inlet	1
120+91.85	37.93 LT	Manhole	1
121+17.67	49.2 LT	Catch Basin	1
121+27.79	31.79 LT	Inlet	1
121+25.66	31.09 RT	Inlet	1
121+39.73	31.66 LT	Inlet	1
121+40.55	31.97 RT	Inlet	1
N. CARILLON DR / GRAND BLVD			
233+32.97	40.99 LT	Inlet	1
233+32.45	41.71 RT	Inlet	1
233+33.76	50.54 RT	Manhole	1
235+44.20	32.96 LT	Manhole	1
236+90.71	40.18 LT	Manhole	1
237+07.14	40.35 LT	Manhole	1
237+07.40	29.19 LT	Inlet	1
237+07.90	31.76 RT	Inlet	1
238+36.60	40.22 LT	Manhole	1
238+38.62	29.39 LT	Inlet	1
238+38.66	32.05 RT	Inlet	1
PROJECT TOTAL			135

STORM SEWER REMOVAL, 12" (55100500)				
STATION	OFFSET (FT)	STATION	OFFSET (FT)	QUANTITY (FT)
WEBER ROAD				
739+79.74	27.6 LT	739+79.86	26.5 RT	54
739+79.86	26.5 RT	739+79.84	40.8 RT	14
742+63.52	28.9 LT	742+63.35	24.8 RT	54
742+63.35	24.8 RT	742+63.30	40.0 RT	15
745+41.12	84.9 LT	745+43.02	31.8 LT	50
745+44.07	24.1 RT	745+43.04	38.6 RT	15
748+04.43	34.4 RT	748+03.74	45.3 RT	11
748+02.80	37.7 LT	748+04.43	49.8 LT	12
748+04.43	49.8 LT	750+49.86	52.9 LT	246
750+49.64	40.4 LT	750+49.86	52.9 LT	13
750+49.86	52.9 LT	750+89.69	52.9 LT	40
750+89.20	94.0 LT	750+89.69	52.9 LT	41
750+89.69	52.9 LT	751+97.56	53.0 LT	108
751+19.91	64.3 LT	751+84.39	65.9 LT	65
751+84.39	65.9 LT	751+97.56	53.0 LT	18
752+17.64	28.0 RT	752+26.95	34.1 RT	11
754+75.22	40.7 LT	754+76.63	46.5 LT	6
757+56.19	25.4 RT	757+57.96	40.6 LT	66
760+26.06	27.0 RT	760+26.69	40.2 LT	67
760+26.69	40.2 LT	760+15.91	61.4 LT	24
763+00.47	39.1 RT	763+00.70	39.8 LT	79
763+00.70	39.8 LT	763+01.65	46.5 LT	7
762+97.39	40.1 LT	763+00.70	39.8 LT	3
765+61.28	47.3 RT	765+53.52	36.0 RT	14
765+53.52	36.0 RT	766+61.53	56.8 LT	143
766+60.79	50.0 LT	766+61.53	56.8 LT	7
768+00.15	29.9 RT	768+29.27	122.4 RT	97
770+50.38	31.6 RT	770+45.12	111.2 RT	80
770+51.30	37.0 LT	770+52.73	45.5 LT	9
772+99.92	34.3 LT	772+99.98	44.6 LT	10
773+00.82	26.6 RT	773+00.28	51.1 RT	25
773+00.28	51.1 RT	775+52.78	48.9 RT	253
775+50.81	20.9 RT	775+52.78	48.9 RT	28
775+50.63	33.3 LT	775+50.19	46.6 LT	13
778+00.22	35.8 LT	778+00.49	49.1 LT	13
778+00.71	18.4 RT	778+00.02	29.7 RT	11
780+49.27	36.5 LT	780+49.56	54.3 LT	18
780+50.94	17.7 RT	780+50.19	31.4 RT	14
783+39.33	32.9 LT	783+39.58	51.6 LT	19
783+40.35	21.3 RT	783+39.83	38.0 RT	17
785+95.33	29.3 LT	785+94.92	45.9 LT	17
785+96.05	25.4 RT	785+95.52	41.1 RT	16
786+05.07	29.4 LT	786+05.39	46.0 LT	17
786+05.19	25.5 RT	786+05.01	41.2 RT	16
789+08.72	29.6 LT	789+09.14	45.2 LT	16
789+00.66	25.1 RT	788+99.93	44.6 RT	20
ROMEO ROAD / 135TH ST				
115+98.89	45.9 RT	116+18.32	42.9 RT	20
116+23.60	32.3 RT	116+18.32	42.9 RT	12
116+23.71	27.4 LT	116+17.75	35.4 LT	10
117+59.09	29.6 RT	117+57.90	32.7 LT	62
118+39.16	29.0 RT	118+39.21	34.6 LT	64
118+39.21	34.6 LT	117+57.90	32.7 LT	81
121+15.90	39.5 RT	120+91.85	37.9 LT	81
120+91.85	37.9 LT	121+17.67	49.2 LT	28
121+40.55	32.0 RT	121+25.66	31.1 RT	15
121+25.66	31.1 RT	121+27.84	31.7 LT	63
121+39.73	31.7 LT	121+27.84	31.7 LT	12
121+27.84	31.7 LT	121+17.67	49.2 LT	20
N. CARILLON DR / GRAND BLVD				
233+10.00	51.8 RT	233+33.76	50.5 RT	24
233+32.97	41.0 LT	233+33.76	50.5 RT	83
237+07.92	32.1 RT	237+07.46	28.9 LT	61
237+07.46	28.9 LT	237+07.10	40.3 LT	12
238+38.66	32.0 RT	238+38.54	29.7 LT	62
238+38.54	29.7 LT	238+36.60	40.2 LT	11
PROJECT TOTAL			2,613	

STORM SEWER REMOVAL, 15" (55100700)				
STATION	OFFSET (FT)	STATION	OFFSET (FT)	QUANTITY (FT)
WEBER ROAD				
751+97.56	53.0 LT	754+76.62	46.4 LT	279
754+76.62	46.4 LT	756+04.46	46.8 LT	128
756+04.46	46.8 LT	757+57.58	46.0 LT	153
775+52.78	48.9 RT	777+47.16	47.4 RT	194
777+47.16	47.4 RT	777+75.22	60.6 RT	31
ROMEO ROAD / 135TH ST				
115+99.10	31.6 LT	116+17.75	35.4 LT	19
116+17.75	35.4 LT	117+57.90	32.7 LT	140
PROJECT TOTAL			944	

STORM SEWER REMOVAL, 24" (55101200)				
STATION	OFFSET (FT)	STATION	OFFSET (FT)	QUANTITY (FT)
WEBER ROAD				
737+04.52	28.4 LT	737+02.18	27.2 RT	56
737+02.18	27.2 RT	737+02.33	44.1 RT	17
750+76.84	85.8 RT	751+06.42	82.6 RT	30
751+06.42	82.6 RT	751+84.63	80.4 RT	78
751+84.63	80.4 RT	752+26.95	34.1 RT	63
752+26.95	34.1 RT	754+78.22	34.6 RT	253
754+78.22	34.6 RT	756+67.33	36.7 RT	219
756+67.33	36.7 RT	757+54.96	40.6 LT	96
757+54.96	40.6 LT	757+57.58	46.0 LT	6
789+00.60	45.5 LT	790+20.00	41.8 LT	120
PROJECT TOTAL			938	

STORM SEWER REMOVAL, 30" (55101400)				
STATION	OFFSET (FT)	STATION	OFFSET (FT)	QUANTITY (FT)
WEBER ROAD				
737+04.35	37.3 LT	737+04.52	28.4 LT	9
757+57.58	46.0 LT	759+99.60	46.4 LT	242
759+99.60	46.4 LT	760+15.94	61.4 LT	22
760+15.94	61.4 LT	792+79.89	61.3 LT	264
792+79.89	61.3 LT	763+01.65	46.5 LT	26
763+01.65	46.5 LT	763+77.48	45.5 LT	76
763+77.48	45.5 LT	766+61.53	56.8 LT	284
766+61.53	56.8 LT	768+59.69	58.6 LT	198</

TREE REMOVALS SCHEDULE

TREE REMOVAL (6 TO 15 UNITS DIAMETER) (20100110)		
STATION	OFFSET	UNITS DIAMETER
WEBER ROAD		
740+31.08	48.88 LT	6
741+69.18	52.61 LT	10
742+17.40	52.27 LT	11
743+20.99	42.79 LT	14
743+47.06	44.58 LT	14
743+89.53	49.69 LT	10
743+99.37	55.89 LT	10
744+05.11	52.17 LT	11
745+08.39	56.91 LT	11
745+15.18	58.68 LT	11
745+57.25	62.64 LT	7
745+58.40	61.89 LT	10
745+89.47	64.22 LT	10
745+91.82	65.38 LT	12
746+13.65	66.51 LT	6
752+22.09	68.89 LT	8
752+64.26	70.10 LT	10
753+00.58	70.08 LT	10
753+30.91	64.41 RT	10
753+38.58	70.14 LT	10
753+77.40	70.45 LT	6
754+09.05	64.27 RT	8
754+15.18	70.77 LT	6
754+63.32	71.33 LT	6
754+96.66	80.39 LT	15
755+00.75	53.76 LT	6
755+38.23	54.01 LT	-
755+76.21	53.56 LT	6
755+94.94	67.08 RT	10
756+01.52	63.78 RT	10
756+15.17	53.98 LT	-
756+69.37	63.29 RT	8
756+88.81	81.62 LT	8
756+89.85	80.69 LT	8
756+90.95	83.57 LT	8
757+09.58	83.39 LT	8
757+17.45	82.11 LT	8
757+15.03	62.58 RT	9
757+36.00	81.49 LT	8
757+56.92	65.31 RT	13
758+17.85	72.01 LT	-
758+23.80	64.84 RT	12
758+45.17	72.07 LT	-
758+58.62	59.78 RT	15
758+85.52	61.40 RT	10
759+07.95	64.47 RT	8
759+17.54	60.91 RT	7
759+35.34	69.77 LT	-
759+36.39	62.56 RT	8
759+54.50	59.36 RT	6
759+56.13	63.68 RT	6
759+58.47	57.23 RT	6
759+73.54	57.37 RT	6
759+79.61	58.85 RT	6
759+79.79	59.33 RT	-
759+83.02	61.52 RT	6
759+86.49	57.81 RT	6
759+86.57	58.23 RT	-
759+85.33	64.33 RT	-
759+89.56	61.67 RT	-
759+89.04	64.13 RT	-
759+92.92	68.46 LT	-

TREE REMOVAL (6 TO 15 UNITS DIAMETER) (20100110)		
STATION	OFFSET	UNITS DIAMETER
760+12.49	61.41 RT	12
760+40.42	59.80 RT	24
760+53.28	65.20 RT	6
760+63.13	59.80 RT	6
760+92.10	67.01 RT	6
761+09.02	68.22 RT	6
761+18.10	79.44 LT	8
761+27.59	69.45 RT	6
761+33.15	77.80 LT	8
761+41.34	60.57 RT	6
761+52.82	79.41 LT	10
761+53.91	67.07 RT	6
761+70.68	70.12 RT	6
761+88.19	65.05 RT	6
761+81.01	82.79 LT	6
761+89.73	79.89 LT	6
761+97.65	79.51 LT	6
762+03.87	67.42 RT	6
762+25.17	68.60 RT	10
762+64.46	74.31 RT	6
762+67.06	64.02 RT	6
762+92.6	77.86' RT	6
763+07.9	78.03' RT	6
763+11.92	68.83 RT	9
763+19.52	69.86 RT	9
763+31.17	66.24 RT	6
763+36.98	72.25 RT	6
763+48.69	69.15 RT	8
763+86.03	73.31 RT	12
764+18.31	72.51 RT	8
764+38.14	74.85 RT	6
764+49.65	80.43 RT	-
764+58.37	82.53 RT	-
764+62.51	87.66 RT	-
764+62.86	96.57 RT	12
764+68.27	98.13 RT	7
766+96.53	77.94 LT	6
767+27.92	92.08 LT	10
767+49.40	88.02 LT	6
767+70.51	90.19 LT	6
767+94.98	93.88 LT	6
768+20.00	88.91 RT	12
768+28.96	83.02 LT	6
768+46.73	86.10 LT	6
768+99.71	81.53 RT	8
769+13.47	89.89 LT	10
769+28.18	76.47 RT	12
769+43.81	78.98 LT	10
769+56.63	77.26 RT	8
769+61.94	70.77 LT	10
769+83.01	70.01 LT	-
769+91.84	79.27 LT	-
769+93.32	82.40 RT	6
769+99.60	67.90 LT	6
770+04.12	77.31 RT	-
770+11.82	79.42 RT	-
770+18.01	78.08 LT	12
770+22.29	76.28 RT	12
770+32.29	77.19 LT	12
770+34.36	81.00 RT	12
770+44.08	89.97 LT	12
770+44.10	83.53 RT	12
770+53.97	77.58 LT	12

TREE REMOVAL (6 TO 15 UNITS DIAMETER) (20100110)		
STATION	OFFSET	UNITS DIAMETER
770+57.77	75.89 RT	12
770+91.71	70.41 RT	15
771+10.19	89.62 LT	10
771+10.52	71.68 LT	-
771+13.64	73.62 RT	15
771+19.75	79.23 RT	6
771+33.53	73.83 LT	12
771+37.47	72.59 RT	12
771+50.21	84.32 LT	12
771+54.06	70.30 LT	8
771+66.63	74.25 LT	-
771+74.48	69.88 LT	6
771+86.06	74.92 LT	10
772+19.28	82.64 LT	-
772+34.33	75.03 RT	-
772+38.80	78.66 LT	8
772+50.27	69.39 LT	12
772+52.04	84.83 LT	8
772+70.69	69.81 LT	10
772+72.09	82.00 LT	8
772+87.23	77.10 LT	6
773+05.35	67.51 LT	-
773+26.61	76.14 LT	6
773+38.73	78.04 LT	8
773+43.60	75.33 RT	-
773+58.98	67.60 LT	6
773+70.40	78.72 LT	6
773+73.94	69.47 LT	12
774+29.35	69.16 LT	15
774+43.44	65.69 LT	12
774+46.79	77.10 RT	12
774+57.39	75.32 LT	6
774+62.42	67.49 LT	-
774+63.49	75.40 RT	12
775+02.94	70.64 LT	15
775+48.90	68.63 LT	12
775+50.35	68.87 LT	12
776+14.31	72.82 LT	8
776+67.07	77.94 LT	12
776+98.41	72.82 LT	8
777+14.09	73.07 LT	10
777+29.87	78.40 LT	8
ROMEO ROAD / 135TH ST		
112+74.13	28.64 LT	12
113+36.26	39.46 LT	8
113+54.88	30.87' LT	14
118+05.01	56.22 LT	6
118+70.32	59.24 LT	6
118+86.11	55.25 LT	6
N. CARILLON DR / GRAND BLVD		
236+04.75	1.20 RT	6
236+36.55	1.68 RT	-
236+66.95	1.09 RT	-
237+04.17	45.93 LT	8
237+29.31	1.64 RT	7
237+27.80	39.41 LT	8
237+69.54	40.26 LT	8
237+97.26	1.97 RT	6
238+19.40	1.42 RT	6
238+22.68	39.60 LT	8
PROJECT TOTAL		1,382

TREE REMOVAL (OVER 15 UNITS DIAMETER) (20100210)		
STATION	OFFSET	UNITS DIAMETER
WEBER ROAD		
750+99.78	86.53 LT	18
757+88.37	60.01 RT	18
PROJECT TOTAL		36

NOTES

- SCHEDULED TREES LISTED WITH A UNIT DIAMETER OF "--" HAVE A UNIT DIAMETER OF LESS THAN 6 INCHES AT A POINT 4.5 FEET ABOVE THE HIGHEST GROUND LEVEL AT THE BASE OF THE TREE.
- ACCORDING TO SECTION 201.02 OF THE STANDARD SPECIFICATIONS, TREES HAVING A DIAMETER LESS THAN 6 INCHES WILL BE CONSIDERED SAPPLINGS.
- ACCORDING TO SECTION 201.01(A) OF THE STANDARD SPECIFICATIONS, REMOVAL OF SAPPLINGS WILL BE CONSIDERED CLEARING.
- ACCORDING TO SECTION 201.10 OF THE STANDARD SPECIFICATIONS, CLEARING WILL NOT BE MEASURED FOR PAYMENT.

FILE NAME = D:\BX11-sht-schedule3.dgn



USER NAME = TEG	DESIGNED - MAS	REVISED - 3/3/2015
	DRAWN - ADF	REVISED - 6/19/2015
PLOT SCALE = 2.0000' / in.	CHECKED - CRC	REVISED - 9/27/2016
PLOT DATE = 11/14/2017	DATE - 11/15/17	REVISED -

**STATE OF ILLINOIS
DEPARTMENT OF TRANSPORTATION**

SCHEDULE OF QUANTITIES

SCALE: NTS SHEET 18 OF 22 SHEETS STA. TO STA.

F.A.P. RTE.	SECTION	COUNTY	TOTAL SHEETS	SHEET NO.
856	14-00170-42-RP	WILL	394	46
			CONTRACT NO. 61D47	
ILLINOIS FED. AID PROJECT				

ROADWAY REMOVAL

PAVEMENT REMOVAL (44000100)			
STATION	STATION	EXISTING PAVEMENT QUANTITY (SQ YD)	TEMPORARY PAVEMENT QUANTITY (SQ YD)
WEBER ROAD			
736+25	746+00	5,644	-
746+00	774+00	24,068	-
774+00	790+92	9,434	-
726+46	751+25	-	11,038
736+25	750+90	-	3,067
751+75	764+90	-	5,762
752+24	764+40	-	2,985
754+87.50	755+22.50	-	57
760+43.50	760+75	-	99
765+49.50	790+20	-	9,596
766+05	790+20	-	2,354
772+20	790+20	-	1,937
ROMEO ROAD / 135TH ST			
111+87	113+40	-	114
111+90	114+50	1,190	-
116+50	123+80	4,815	-
112+50	113+96	-	157
114+17	114+83	-	100
114+17	114+58	-	52
120+00	121+81	-	121
N. CARILLON DR / GRAND BLVD			
231+40	234+00	2,177	-
236+00	238+60	1,418	-
229+97	231+40	-	237
234+33	234+70	-	80
235+73	238+48	-	172
239+35	240+25	36	183
SUBTOTAL		48,782	38,111
TOTAL		86,893	

CURB AND GUTTER REMOVAL (44000500)				
STATION	STATION	OFFSET	NOTE	QUANTITY (FT)
WEBER ROAD				
726+45	736+25	RT	PRE-STAGE	982
736+25	751+21	RT	-	1,526
736+25	751+12	LT	-	1,492
751+89	760+42	LT	-	884
760+35	760+88	LT	ISLAND	146
760+76	764+54	LT	-	408
751+85	754+90	RT	-	338
752+25	754+53	LT	BP GAS STATION	235
752+40	754+39	RT	DOMINICK'S	200
754+80	755+24	RT	ISLAND	129
755+22	764+77	RT	-	997
765+85	790+20	LT	-	2,442
765+61	790+20	RT	-	2464
778+19	778+46	RT	DRIVEWAY	109
780+07	780+35	RT	DRIVEWAY	100
ROMEO ROAD / 135TH ST				
111+90	114+80	RT	-	375
111+90	114+86	LT	-	399
115+90	123+80	LT	-	1067
116+37	124+40	RT	-	804
N. CARILLON DR / GRAND BLVD				
230+20	231+88	LT/RT	MEDIAN	340
232+40	234+16	LT/RT	MEDIAN	363
234+41	234+71	LT	ISLAND	109
234+34	234+70	RT	ISLAND	116
231+39	234+41	RT		353
231+40	234+32	LT		299
235+73	238+48	RT/LT	MEDIAN	558
239+36	240+24	RT/LT	MEDIAN	198
235+67	238+67	RT		310
235+55	238+73	LT		340
239+07	239+39	RT		37
239+03	239+40	LT		58
CONC C&G, TYPE B-6.24 (TEMPORARY)				360
TOTAL				18,538

DRIVEWAY PAVEMENT REMOVAL (44000200)		
CE STATION	OFFSET	QUANTITY (SQ YD)
WEBER ROAD		
BP Gas Station Pavement		288
Old Dominick's Pavement		101
755+03.43	43.6 RT	217
760+56.87	66.2 LT	165
778+51.42	35.0 RT	70
780+01.86	37.5 RT	63
789+45.00	31.0 LT	37
ROMEO ROAD / 135TH ST		
112+36.96	35.0 RT	67
113+22.98	34.7 RT	291
113+89.87	37.7 LT	217
114+07.09	34.5 RT	77
117+23.24	37.5 LT	73
119+44.12	47.5 LT	183
122+07.51	46.9 LT	110
N. CARILLON DR / GRAND BLVD		
232+16.82	47.6 RT	122
TOTAL		2,081

SIDEWALK REMOVAL (44000600)			
STATION	STATION	OFFSET	QUANTITY (SQ FT)
WEBER ROAD			
751+85.62	754+78	RT	1,427
755+29.55	764+69.11	RT	4,646
756+40.53	760+34.22	LT	2,017
760+82.93	764+61.87	LT	1,859
ROMEO ROAD / 135TH ST			
115+95.33	117+10.34	LT	562
117+25.28	119+24.41	LT	953
119+63.65	121+88.82	LT	1,091
122+26.27	122+70	LT	203
N. CARILLON DR / GRAND BLVD			
235+60.25	238+63.09	RT	1,488
239+10	239+59	RT	225
238+64	238+69	LT	101
239+07	239+52	LT	314
TEMPORARY SIDEWALK			1,305
PROJECT TOTAL			16,191

HMA SURFACE REMOVAL - BUTT JOINT (40600982)			
STATION	STATION	OFFSET	QUANTITY (SQ YD)
WEBER ROAD			
736+05	736+09.50	LT/RT	26
ROMEO ROAD / 135TH ST			
111+80	111+84.50	LT/RT	15
111+91.91	112+16.61	RT	17
123+95.50	124+00	LT/RT	30
N. CARILLON DR / GRAND BLVD			
231+30	231+34.50	LT	21
231+30	231+34.50	RT	18
238+65.50	238+70	LT/RT	39
PROJECT TOTAL			166

HMA SURFACE REMOVAL, 2" (44000157)			
STATION	STATION	OFFSET	QUANTITY (SQ YD)
WEBER ROAD			
736+05	736+09.50	LT/RT	90
ROMEO ROAD / 135TH ST			
111+84.50	111+90	LT/RT	20
111+94.66	112+19.72	RT	21
123+80	123+95.50	LT/RT	103
N. CARILLON DR / GRAND BLVD			
231+34.50	231+40	LT	22
231+34.50	231+40	RT	25
238+60	240+21	LT/RT	1,027
240+21	240+25	LT/RT	40
PROJECT TOTAL			1,348

MEDIAN REMOVAL (44003100)			
STATION	STATION	OFFSET (FT)	QUANTITY (SQ FT)
WEBER ROAD			
755+03	-	39.0' RT	890
760+59	-	58.8' LT	823
764+79.50	-	51.7' LT	483
765+72	-	49.4' LT	415
N. CARILLON DR / GRAND BLVD			
230+20	231+89.88	LT/RT	1,337
232+19	-	56.2' RT	179
232+40	234+18.85	LT/RT	695
235+73.39	238+47.86	LT/RT	2,147
239+36	240+25.42	LT/RT	1,336
PROJECT TOTAL			8,305

CONCRETE HEADWALL REMOVAL (50104400)		
STATION	OFFSET (FT)	QUANTITY (EACH)
WEBER ROAD		
777+95.70	48.5' RT	1
PROJECT TOTAL		1

RIPRAP REMOVAL (X0323265)			
STATION	STATION	OFFSET (FT)	QUANTITY (SQ YD)
WEBER ROAD			
771+29	781+31	LT	671
PROJECT TOTAL			671

FILE NAME = D:\B\11-ah-t-schedule\1e64.dgn



USER NAME = TEG	DESIGNED -	REVISED - 3/3/2015
	DRAWN -	REVISED - 6/19/2015
PLOT SCALE = 2.0000' / in.	CHECKED -	REVISED - 9/27/2016
PLOT DATE = 12/29/2017	DATE - 11/15/17	REVISED -

**STATE OF ILLINOIS
DEPARTMENT OF TRANSPORTATION**

SCHEDULE OF QUANTITIES

SCALE: NTS SHEET 19 OF 22 SHEETS STA. TO STA.

F.A.P. RTE.	SECTION	COUNTY	TOTAL SHEETS	SHEET NO.
856	14-00170-42-RP	WILL	394	47
CONTRACT NO. 61D47				
ILLINOIS FED. AID PROJECT				

WATER MAIN AND SANITARY SEWER SCHEDULES

DUCTILE IRON WATER MAIN 6" (56103000)				
STATION	OFFSET (FT)	STATION	OFFSET (FT)	QUANTITY (FT)
ROMEO ROAD / 135TH ST				
117+00.00	55.6 LT	118+07.50	53.0 LT	107.6
PROJECT TOTAL				108

DUCTILE IRON WATER MAIN 8" (56103100)				
STATION	OFFSET (FT)	STATION	OFFSET (FT)	QUANTITY (FT)
ROMEO ROAD / 135TH ST				
119+00.00	50.7 LT	119+04.90	59.7 LT	15.0
PROJECT TOTAL				15

DUCTILE IRON WATER MAIN 12" (56103300)				
STATION	OFFSET (FT)	STATION	OFFSET (FT)	QUANTITY (FT)
ROMEO ROAD / 135TH ST				
114+20.00	29.5 RT	114+34.50	29.9 RT	14.5
114+34.50	29.9 RT	114+43.00	38.8 RT	12.3
114+43.00	38.8 RT	114+55.60	52.0 RT	18.3
114+55.60	52.0 RT	116+72.40	57.3 RT	216.8
116+72.40	57.3 RT	117+07.50	51.2 RT	35.6
117+07.50	51.2 RT	118+05.00	51.6 RT	97.5
118+05.00	51.6 RT	118+25.00	51.6 RT	20.0
118+05.00	51.6 RT	118+07.50	53.0 LT	104.7
118+07.50	53.0 LT	119+00.00	50.7 LT	92.5
119+00.00	50.7 LT	120+33.00	46.9 LT	133.7
120+33.00	46.9 LT	120+76.40	38.2 LT	44.3
120+76.40	38.2 LT	120+85.00	38.2 LT	8.6
N. CARILLON DR / GRAND BLVD				
233+51.10	44.5 RT	233+51.40	64.5 RT	20.0
233+51.30	54.5 RT	233+10.00	45.8 RT	358.8
PROJECT TOTAL				1,178

DUCTILE IRON WATER MAIN 16" (5610400)				
STATION	OFFSET (FT)	STATION	OFFSET (FT)	QUANTITY (FT)
WEBER ROAD				
778+05.00	75.5 RT	779+20.00	78.1 RT	115.4
779+20.00	78.1 RT	779+35.00	78.1 RT	15.3
PROJECT TOTAL				131

WATER VALVES				
STATION	OFFSET (FT)	WATER VALVES 8" (56105000) (EACH)	WATER VALVES 12" (56105200) (EACH)	WATER VALVES 16" (56105300) (EACH)
WEBER ROAD				
779+20.00	78.1 RT	-	-	1
ROMEO ROAD / 135TH ST				
114+43.00	38.8 RT	-	1	-
118+05.00	54.6 RT	-	1	-
119+00.00	50.7 LT	1	-	-
N. CARILLON DR / GRAND BLVD				
233+51.25	54.5 RT	-	1	-
PROJECT TOTAL				1

FIRE HYDRANTS TO BE ADJUSTED (56400300)		
STATION	OFFSET (FT)	QUANTITY (EACH)
WEBER ROAD		
774+88.25	59.3 RT	1
PROJECT TOTAL		1

FIRE HYDRANT WITH AUXILIARY VALVE, VALVE BOX AND TEE (56400825)		
STATION	OFFSET (FT)	QUANTITY (EACH)
ROMEO ROAD / 135TH ST		
114+45.20	47.2 RT	1
117+00.00	55.6 LT	1
N. CARILLON DR / GRAND BLVD		
236+65.00	52.0 RT	1
239+38.00	46.0 RT	1
PROJECT TOTAL		4

VALVE VAULTS TO BE ADJUSTED (60265700)		
STATION	OFFSET (FT)	QUANTITY (EACH)
ROMEO ROAD / 135TH ST		
121+08.25	37.0 LT	1
N. CARILLON DR / GRAND BLVD		
239+21.00	40.3 RT	1
PROJECT TOTAL		2

MANHOLES TO BE ADJUSTED (60255500)		
STATION	OFFSET (FT)	QUANTITY (EACH)
ROMEO ROAD / 135TH ST		
112+24.19	24.9 RT	1
112+82.23	29.5 RT	1
PROJECT TOTAL		2

VALVE VAULTS, TYPE 1, 5' DIAMETER, TYPE 1 FRAME, CLOSED LID (60248900)			
STATION	OFFSET (FT)	RIM ELEV	QUANTITY (EACH)
WEBER ROAD			
779+20.00	78.1 RT	621.85	1
ROMEO ROAD / 135TH ST			
114+43.00	38.8 RT	654.90	1
118+05.00	51.6 RT	656.35	1
119+00.00	50.7 LT	658.38	1
N. CARILLON DR / GRAND BLVD			
233+51.25	54.5 RT	640.50	1
PROJECT TOTAL			5

DUCTILE IRON WATER MAIN FITTINGS (X5610004)			
STATION	OFFSET (FT)	DESCRIPTION	QUANTITY (POUND)
WEBER ROAD			
778+05.00	75.5 RT	16" - SLEEVE	174
778+20.00	79.4 RT	16" - 11.25 DEGREE BEND (HORIZONTAL)	161
778+08.00	79.3 RT	16" - 45 DEGREE BEND (VERTICAL)	290
778+10.00	79.3 RT	16" - 45 DEGREE BEND (VERTICAL)	290
778+85.00	78.2 RT	16" - 45 DEGREE BEND (VERTICAL)	290
778+87.00	78.2 RT	16" - 45 DEGREE BEND (VERTICAL)	290
779+35.00	78.1 RT	16" - SLEEVE	174
ROMEO ROAD / 135TH ST			
114+20.00	29.5 RT	12" - 45 DEGREE BEND (VERTICAL)	159
114+22.00	29.5 RT	12" - 45 DEGREE BEND (VERTICAL)	159
114+34.50	29.9 RT	12" - 45 DEGREE BEND (HORIZONTAL)	159
114+55.60	52.0 RT	12" - 45 DEGREE BEND (HORIZONTAL)	159
116+72.40	57.3 RT	12" - 11.25 DEGREE BEND (HORIZONTAL)	82
117+07.50	51.2 RT	12" - 11.25 DEGREE BEND (HORIZONTAL)	82
118+05.00	51.6 RT	12" X 12" TEE IN VAULT	144
118+25.00	51.6 RT	12" - PLUG	47
119+00.00	50.7 LT	12" X 8" TEE IN VAULT	149
119+00.00	54.2 LT	8" - 45 DEGREE BEND (HORI/VERT)	56
119+04.80	58.7 LT	8" - 45 DEGREE BEND (HORI/VERT)	56
119+04.90	59.9 LT	8" - SLEEVE	55
120+33.00	46.9 LT	12" - 11.25 DEGREE BEND (HORIZONTAL)	82
120+76.40	38.2 LT	12" - 11.25 DEGREE BEND (HORIZONTAL)	82
120+85.00	38.2 LT	12" - SLEEVE	81
N. CARILLON DR / GRAND BLVD			
233+51.10	44.5 RT	12" - SLEEVE	81
233+51.20	50.0 RT	12" - 45 DEGREE BEND (VERTICAL)	159
233+51.20	52.0 RT	12" - 45 DEGREE BEND (VERTICAL)	159
233+51.25	54.5 RT	12" X 12" TEE IN VAULT	144
233+51.40	64.5 RT	12" - SLEEVE	81
236+60.00	48.3 RT	12" - 45 DEGREE BEND (VERTICAL)	159
236+62.00	48.3 RT	12" - 45 DEGREE BEND (VERTICAL)	159
237+10.00	46.8 RT	12" X 8" - REDUCER	65
PROJECT TOTAL			4,228

STEEL CASINGS 24" (Z0067900)				
STATION	OFFSET (FT)	STATION	OFFSET (FT)	QUANTITY (FT)
ROMEO ROAD / 135TH ST				
114+58.00	52.0 RT	116+58.00	57.0 RT	200.0
118+05.00	46.6 RT	118+07.50	49.6 LT	100.0
N. CARILLON DR / GRAND BLVD				
234+00.00	53.5 RT	236+20.00	48.7 RT	220.0
PROJECT TOTAL				520

STEEL CASINGS 30" (Z0068200)				
STATION	OFFSET (FT)	STATION	OFFSET (FT)	QUANTITY (FT)
N. CARILLON DR / GRAND BLVD				
233+86.00	37.0 RT	237+25.80	27.9 RT	240.0
PROJECT TOTAL				240

MANHOLES, TYPE A, SANITARY, 4'-DIAMETER, TYPE 1 FRAME, CLOSED LID (X6022858)			
STATION	OFFSET (FT)	RIM ELEV	QUANTITY (EACH)
WEBER ROAD			
780+10	63 RT	621.68	1
783+65	54 RT	620.30	1
783+97	90 RT	618.20	1
784+37	90 RT	618.20	1
784+65	54 RT	619.95	1
786+96	54 RT	620.80	1
790+00	54 RT	622.23	1
PROJECT TOTAL			7

WATER MAIN REMOVAL, 8" (X5610708)				
STATION	OFFSET (FT)	STATION	OFFSET (FT)	QUANTITY (FT)
ROMEO ROAD / 135TH ST				
119+04.00	40.2 LT	119+04.90	59.9 LT	25.0
N. CARILLON / GRAND BLVD				
236+40.00	48.4 RT	237+10.00	46.8 RT	70.0
PROJECT TOTAL				95

WATER MAIN REMOVAL, 12" (X5610712)				
STATION	OFFSET (FT)	STATION	OFFSET (FT)	QUANTITY (FT)
ROMEO ROAD / 135TH ST				
114+20.00	29.5 RT	114+68.50	30.7 RT	48.5
114+68.50	30.7 RT	115+91.70	45.1 LT	144.6
115+91.70	45.1 LT	119+04.00	40.2 LT	312.4
119+04.00	40.2 LT	120+85.00	38.2 LT	181.6
N. CARILLON / GRAND BLVD				
233+51.10	44.5 RT	233+51.40	64.5 RT	20.0
PROJECT TOTAL				708

WATER MAIN REMOVAL, 16" (X5610716)				
STATION	OFFSET (FT)	STATION	OFFSET (FT)	QUANTITY (FT)
WEBER ROAD				
778+05.00	75.5 RT	779+35.00	78.1 RT	130.7
PROJECT TOTAL				131

SANITARY SEWER REMOVAL, 18" (X0323814)				
STATION	OFFSET (FT)	STATION	OFFSET (FT)	QUANTITY (FT)
WEBER ROAD				
778+19.37	63.58 RT	781+94.77	63.29 RT	375.4
781+94.77	63.29 RT	785+67.89	58.68 RT	373.1
785+67.89	58.68 RT	789+42.20	52.94 RT	374.9
789+42.20	52.94 RT	790+00	53.65 RT	58.0
PROJECT TOTAL				1,182

SANITARY SEWER 18" (Z0057300)				
STATION	OFFSET (FT)	STATION	OFFSET (FT)	QUANTITY (FOOT)
WEBER ROAD				
778+19.40	63.6 RT	780+10	63.6 RT	190.6
780+10	63.6 RT	783+65	54 RT	355.1
783+97	90 RT	784+37	90 RT	40.0
784+65	54 RT	786+96	54 RT	231.0
786+96	54 RT	790+00	54 RT	304.6
PROJECT TOTAL				1,122

SANITARY SEWER, SPECIAL (Z0058000)				
STATION	OFFSET (FT)	STATION	OFFSET (FT)	QUANTITY (FOOT)
WEBER ROAD				
783+65	54 RT	783+97	90 RT	48.2
784+37	90 RT	784+65	54 RT	45.6
PROJECT TOTAL				94

FIRE HYDRANTS TO BE REMOVED (56400500)		
STATION	OFFSET (FT)	QUANTITY (EACH)
WEBER ROAD		
774+88.25	59.3 RT	1
ROMEO ROAD / 135TH ST		
114+39.00	32.4 RT	1
115+96.50	44.1 LT	1
N. CARILLON DR / GRAND BLVD		
236+32.00	36.8 RT	1
239+31.25	36.7 RT	1
PROJECT TOTAL		5

REMOVE EXISTING VALVE AND VAULT (X0325003)		
STATION	OFFSET (FT)	QUANTITY (EACH)
WEBER ROAD		
778+57.30	75.7 RT	1
ROMEO ROAD / 135TH ST		
114+48.50	29.5 RT	1
116+15.20	43.8 LT	1
119+03.90	38.7 LT	1
PROJECT TOTAL		4

SANITARY MANHOLES TO BE REMOVED (X6026054)		
STATION	OFFSET (FT)	QUANTITY (EACH)
WEBER ROAD		
781+94.77	62.3 RT	1
785+67.89	58.7 RT	1
789+42.20	52.9 RT	1
PROJECT TOTAL		3

SANITARY MANHOLES TO BE ADJUSTED (X6026050)		
STATION	OFFSET (FT)	QUANTITY (EACH)
WEBER ROAD		
764+51.84	63.8 LT	1
767+52.82	71 LT	1
770+18.49	70 LT	1
774+53.88	58.6 LT	1
N. CARILLON DR / GRAND BLVD		
238+60.77	33.7 LT	1
PROJECT TOTAL		5

SANITARY MANHOLES TO BE RECONSTRUCTED (X6026051)		
STATION	OFFSET (FT)	QUANTITY (EACH)
WEBER ROAD		
772+83.94	70.5 LT	1
778+16.60	58.8 LT	1
PROJECT TOTAL		2

SANITARY SEWER CONNECTION (X0326713)		
STATION	OFFSET (FT)	QUANTITY (EACH)
WEBER ROAD		
778+19.40	63.6 RT	1
790+00	53.7 RT	1
PROJECT TOTAL		2

FILE NAME = DIBX11-ah-t-schedule4.dgn



MAINTENANCE OF TRAFFIC AND PAVEMENT PATCHING

TEMPORARY PAVEMENT MARKINGS				TEMPORARY PAVEMENT MARKING LETTERS AND SYMBOLS	TEMPORARY PAVEMENT MARKING - LINE 4"	TEMPORARY PAVEMENT MARKING - LINE 6"	TEMPORARY PAVEMENT MARKING - LINE 12"	TEMPORARY PAVEMENT MARKING - LINE 24"	PAVEMENT MARKING TAPE, TYPE IV	PAVEMENT MARKING TAPE, TYPE IV - 4"	PAVEMENT MARKING TAPE, TYPE IV - 6"	PAVEMENT MARKING TAPE, TYPE IV - 12"	PAVEMENT MARKING TAPE, TYPE IV - 24"	PAVEMENT MARKING REMOVAL - GRINDING	PAVEMENT MARKING REMOVAL - WATER BLASTING	TEMPORARY PAVEMENT MARKING REMOVAL
STAGE	ROADWAY	FROM STATION	TO STATION	SQ FT	FOOT	FOOT	FOOT	FOOT	SQ FT	FOOT	FOOT	FOOT	FOOT	SQ FT	SQ FT	SQ FT
STAGE 1	WEBER ROAD	726+00	751+50	125	7,155	165	40	38	33	6,733	289	215	-	4,035	2,805	2,621
		751+50	765+00	235	6,885	139	40	73	-	43	-	-	-	4,040	-	-
		765+00	790+20	97	11,260	150	-	35	-	-	-	-	-	6,245	-	-
SUB-STAGE 1	WEBER ROAD	726+00	751+50	-	-	-	-	-	-	453	45	15	38	-	-	265
		751+50	765+00	-	-	-	-	-	-	365	-	-	36	-	-	194
		765+00	790+20	-	-	-	-	-	-	130	-	-	36	-	-	116
PRE-STAGE 2	WEBER ROAD	726+00	751+50	-	-	-	-	-	134	12,055	459	150	35	-	-	4,602
		751+50	765+00	-	-	-	-	-	171	6,265	665	150	125	-	-	2,992
		765+00	790+20	-	-	-	-	-	74	11,720	580	30	45	-	-	4,391
STAGE 2	WEBER ROAD	726+00	751+50	-	-	-	-	-	92	6,335	204	-	181	-	-	2,668
		751+50	765+00	-	-	-	-	-	156	4,115	320	35	106	-	-	1,935
		765+00	790+20	-	-	-	-	-	305	50	-	33	-	-	193	
STAGE 3	WEBER ROAD	726+00	751+50	-	-	-	-	-	97	520	70	-	44	-	-	394
		751+50	765+00	-	-	-	-	-	-	-	-	45	-	-	90	
		765+00	790+20	-	-	-	-	-	165	5,948	465	-	101	-	-	2,583
SUB-STAGE 1	WEBER ROAD	726+00	751+50	-	-	-	-	-	110	8,245	1,070	150	75	-	-	3,694
		751+50	765+00	-	-	-	-	-	147	3,218	1,020	-	151	-	-	2,032
		765+00	790+20	-	-	-	-	-	74	8,135	500	-	64	-	-	3,164
TOTAL:				762	32,105	1,151	105	351	2,135	94,810	8,542	890	1,761	17,525	5,155	42,276

STAGE	FROM STATION	TO STATION	TEMPORARY CONCRETE BARRIER	RELOCATE TEMPORARY CONCRETE BARRIER	IMPACT ATTENUATOR, TEMPORARY	IMPACT ATTENUATOR, RELOCATE	BARRIER WALL REFLECTORS, TYPE C	PINNING TEMPORARY CONCRETE BARRIER
			FOOT	FOOT	EACH	EACH	EACH	EACH
PRE-STAGE	752+52.50	754+65	213	-	2	-	9	57
	755+50	764+25	875	-	2	-	35	216
STAGE 1	749+45	750+45	100	-	2	-	4	30
	751+95	753+95	200	-	2	-	8	54
	765+70	790+20	2450	-	1	-	98	594
PRE-STAGE 2	772+32.50	790+20	-	1787.5	-	1	72	432
TOTAL:			4,050	1,787.5	11	1	235	1,440

STAGE	FROM STATION	TO STATION	TEMPORARY PAVEMENT	SUBBASE GRANULAR MATERIAL, TYPE B 4"
			SQ YD	SQ YD
PRE-STAGE	726+46	749+53.55	20062456	31101200
	751+75.63	764+41.65	5,762	5,762
	754+89.56	755+22	57	57
	760+43.53	760+74.41	99	99
	765+49.50	790+20	9,596	9,596
	112+50	113+95.60	157	157
	114+17.70	114+82.39	100	100
	115+70.48	124+40	1,345	1,345
	229+97.38	231+40	237	237
	234+33	234+70	80	80
STAGE 1	235+73.41	238+47.85	172	172
	239+36	240+25	183	183
	736+25	750+90	3,067	3,067
	752+24	764+40	2,985	2,985
	766+05	790+20	2,354	2,354
	772+20	790+20	1,937	1,937
SUB-STAGE 1	111+87.	113+40.	114	114
	120+00	121+81	121	121
	114+17	114+58	52	52
TOTAL:			38,111	38,111

CLASS D PATCHES, TYPE III, 13 INCH (44201807)				
STATION	OFFSET (FT)	STATION	OFFSET (FT)	QUANTITY (FT)
WEBER ROAD				
750+70	39.76 LT	750+70	42.24 RT	92
772+15.29	67.40 LT	751+91.28	50.19 RT	156
754+00	41.80 LT	754+00	38.20 RT	89
760+06.95	51 LT	762+32.69	46.11 LT	52
ROMEO ROAD / 135TH ST				
114+23	18.15 RT	114+23	21.85 LT	45
N. CARILLON DR / GRAND BLVD				
233+75.00	35.5 RT	233+90.00	36.6 RT	25
234+19.72	53.03 RT	234+25.67	61.81 LT	128
236+15.00	24.9 RT	236+35.00	25.0 RT	25
GRAND BLVD AT FAIR MEADOW DR (ADA & MEDIUM)				
238+60	34.05 LT	238+77.11	59.22 LT	14
238+99	49.45 LT	239+39.94	11.85 LT	15
239+00	47 RT	239+39	26.95 RT	11
239+33	6 RT	240+35	6 RT	174
PROJECT TOTAL				826

WINTER PAVEMENT MARKINGS				PERMANENT PAVEMENT MARKING LETTERS AND SYMBOLS	PERMANENT PAVEMENT MARKING - LINE 4"	PERMANENT PAVEMENT MARKING - LINE 6"	PERMANENT PAVEMENT MARKING - LINE 12"	PERMANENT PAVEMENT MARKING - LINE 24"	PAVEMENT MARKING REMOVAL - WATER BLASTING
STAGE	ROADWAY	FROM STATION	TO STATION	SQ FT	FOOT	FOOT	FOOT	FOOT	SQ FT
STAGE 1	WEBER ROAD	726+00	751+50	158	13,838	454	255	38	5,325
		751+50	765+00	235	6,885	139	40	73	2,300
		765+00	790+20	97	11,260	150	-	35	3,995
		110+00	123+00	156	6,150	242	-	173	2,675
	N. CARILLON DR / GRAND BLVD	228+00	241+00	149	3,420	455	25	103	1,695
TOTAL:				795	41,553	1,440	320	422	15,990

NOTE:
 THE CONTRACTOR SHALL USE, DURING ALL WINTER STAGING MONTHS, PERMANENT PAVEMENT MARKINGS. FOR QUANTITY PURPOSES, STAGE 1 TRAFFIC CONFIGURATION WAS USED. REMOVAL OF PERMANENT PAVEMENT MARKINGS SHALL BE PAID FOR AS PAVEMENT MARKING REMOVAL - WATER BLASTING. PLEASE NOTE, PAVEMENT MARKING REMOVAL - WATER BLASTING SHALL ALSO BE USED WHEN EXISTING PAVEMENT MARKINGS ARE TO BE REMOVED ON EXISTING PAVEMENT TO REMAIN (SEE TEMPORARY PAVEMENT MARKINGS SCHEDULE).

FILE NAME = D:\B\11-ah-t-schedule4.dgn



USER NAME = TEG	DESIGNED -	REVISED - 3/3/2015
PLOT SCALE = 2.0000' / in.	DRAWN -	REVISED - 6/19/2015
PLOT DATE = 12/29/2017	CHECKED -	REVISED - 9/27/2016
	DATE - 11/15/17	REVISED -

**STATE OF ILLINOIS
DEPARTMENT OF TRANSPORTATION**

SCHEDULE OF QUANTITIES

SCALE: NTS SHEET 21 OF 22 SHEETS STA. TO STA.

F.A.P. RTE.	SECTION	COUNTY	TOTAL SHEETS	SHEET NO.
856	14-00170-42-RP	WILL	394	49
CONTRACT NO. 61D47				
ILLINOIS FED. AID PROJECT				

PROPOSED ROADWAY ITEMS

PROPOSED SIDEWALK					
STATION	STATION	OFFSET	PORTLAND CEMENT CONCRETE SIDEWALK 5 INCH (SQ FT) (42400200)	PORTLAND CEMENT CONCRETE SIDEWALK 8 INCH (SQ FT) (42400410)	SUBBASE GRANULAR MATERIAL, TYPE B 4" (SQ YD) (31101200)
WEBER ROAD					
751+96	752+35	LT	340	-	38
752+07	754+84	RT	1,430	-	159
755+27	764+62	RT	5,659	-	629
765+70	790+20	RT	12,304	-	1,368
750+70	751+15	LT	365	-	41
750+80	Curb Ramp	Median	70	-	8
754+80	755+32	RT	-	226	25
758+01	758+06	LT	107	-	12
760+20	Curb Ramp	LT	150	-	17
760+20	760+95	LT	-	478	53
761+00	Curb Ramp	LT	150	-	17
762+72	762+77	LT	48	-	6
764+42	764+65	LT	263	-	30
765+94	766+12	LT	179	-	20
ROMEO ROAD / 135TH ST					
116+08	121+94	RT	3,029	-	337
121+94	122+20	RT	-	123	14
122+20	122+70	RT	258	-	29
116+27	119+23	LT	1,476	-	164
119+21	119+65	LT	-	224	25
119+67	121+85	LT	1,104	-	123
121+87	122+27	LT	-	206	23
122+29	122+70	LT	208	-	24
N. CARILLON DR / GRAND BLVD					
235+93	238+65	RT	1,424	-	159
235+90	238+69	LT	1,485	-	165
239+10	239+59	RT	299	-	34
239+05	239+52	LT	360	-	40
TOTAL			30,708	1,257	3,560

DETECTABLE WARNINGS (42400800)		
STATION	OFFSET	QUANTITY (SQ FT)
WEBER ROAD		
750+75	MEDIAN	16.0
750+75	MEDIAN	16.0
750+77	RT	18.8
750+79	LT	16.0
754+78	RT	15.3
755+33	RT	15.3
760+21	LT	27.5
760+93	LT	26.0
764+61	LT	21.4
764+61	RT	16.5
765+74	RT	18.7
766+01	LT	28.0
ROMEO ROAD / 135TH ST		
114+54	RT	22.0
114+54	LT	24.0
116+23	RT	13.7
116+23	LT	15.9
119+18	LT	17.2
119+70	LT	10.0
121+84	LT	10.0
122+31	LT	10.0
N. CARILLON DR / GRAND BLVD		
238+60	RT	15.8
238+67	LT	12.7
239+06	LT	10.9
239+14	RT	15.6
239+33	LT	10.0
239+33	RT	10.0
PROJECT TOTAL		434

PROPOSED DRIVEWAYS						
STATION CENTER ENTRANCE	SUBBASE GRANULAR MATERIAL, TYPE B 4" (SQ YD) (31101200)	AGGREGATE BASE COURSE, TYPE B 6" (SQ YD) (35101800)	HOT-MIX ASPHALT BASE COURSE, 8" (SQ YD) (35501316)	HOT-MIX ASPHALT SURFACE COURSE, MIX "D", N50 (TON) (40603335)	PORTLAND CEMENT CONCRETE PAVEMENT 10" (JOINTED) (SQ YD) (42000501)	PORTLAND CEMENT CONCRETE DRIVEWAY PAVEMENT, 8 INCH (SQ YD) (42300400)
WEBER ROAD						
755+05.90	104	-	65	7.3	-	29
760+58.97	168	-	111	12.5	-	39
776+91.04	-	41	-	-	-	-
WEBER ROAD (ROMEO ROAD NW & NE QUADRANT PCC PAVEMENT REPLACEMENT)						
NW	112	-	-	-	-	99
NE	100	-	-	-	-	88
ROMEO ROAD / 135TH ST						
112+37.53	70	-	67	7.6	-	-
113+25.24	-	281	-	-	276	-
113+89.36	139	-	-	-	-	134
114+07.02	84	-	74	8.4	-	-
119+44.27	140	-	107	12	-	19
122+07.38	29	-	19	2.2	-	10
122+07.38	104	-	61	6.9	-	33
N. CARILLON DR / GRAND BLVD						
232+17.42	122	-	104	11.7	-	-
TOTAL		1,172	322	608	69	451

RIPRAP AND FILTER FABRIC								
STATION	STATION/OFFSET	RIPRAP, CLASS A3 (SQ YD) (28100105)	RIPRAP, CLASS A4 (SQ YD) (28100107)	RIPRAP, CLASS A6 (SQ YD) (28100111)	FILTER FABRIC (SQ YD) (28200200)	W1 (FEET)	W2 (FEET)	LA (FEET)
WEBER ROAD								
766+00	778+80	783	-	-	783	-	-	-
780+10	75.0 LT	8	-	-	8	3	11	10
782+90	70.2 LT	16	-	-	16	4.5	15.5	14
784+81	68.3 LT	8	-	-	8	3	11	10
786+50	66.3 LT	8	-	-	8	3	11	10
788+00	69.4 LT	8	-	-	8	3	11	10
789+50	70.4 LT	8	-	-	8	3	11	10
786+00	78.0 LT	-	24	-	24	20.5	20.5	10
784+17	69.0 LT	-	33	-	33	24	31	10
784+17	65.0 RT	-	210	-	210	24	68	41
778+50	80.0 RT	-	-	179	179	51	62	30
TOTAL		839	267	179	1,285	-	-	-

PROPOSED SHARED-USE PATH			
STATION	STATION	HOT-MIX ASPHALT SURFACE COURSE, MIX "D", N50 (TON) (40603335)	AGGREGATE BASE COURSE, TYPE B 6" (SQ YD) (35101800)
WEBER ROAD			
752+30	760+10	117	694
761+05	764+42	51	298
766+15	790+20	361	2,140
TOTAL		529	3,132

PROTECTIVE COAT (42001300)		
LOCATION	QUANTITY (SQ YD)	
PCC SIDEWALK, 5 INCH	3,415	
PCC SIDEWALK, 8 INCH	140	
PCC DRIVEWAY PVMT, 8 INCH	55	
CURB TYPE B	70	
COMB C&G TYPE B.6-12	630	
COMB C&G TYPE B.6-18	345	
COMB C&G TYPE B.6-24	6,755	
CORRUGATED MEDIAN	190	
CONCRETE BARRIER MEDIAN	455	
CONCRETE MEDIAN TYPE SB-6.24	925	
PCC PAVEMENT 10" (JOINTED)	53,540	
PROJECT TOTAL		66,520

SUBBASE GRANULAR MATERIAL, TYPE B 4" (31101200)		
LOCATION	QUANTITY (SQ YD)	
PCC SIDEWALK, 5 INCH	3,420	
PCC SIDEWALK, 8 INCH	140	
DRIVEWAY ENTRANCES	1,172	
TEMPORARY PAVEMENT	38,111	
PROJECT TOTAL		42,843

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USER NAME = TEG	DESIGNED -	REVISED - 3/3/2015
PLOT SCALE = 2.0000' / in.	DRAWN -	REVISED - 6/19/2015
PLOT DATE = 12/29/2017	CHECKED -	REVISED - 9/27/2016
	DATE - 11/15/17	REVISED -

**STATE OF ILLINOIS
DEPARTMENT OF TRANSPORTATION**

SCHEDULE OF QUANTITIES


SCALE: NTS SHEET 22 OF 22 SHEETS STA. TO STA.

F.A.P. RTE.	SECTION	COUNTY	TOTAL SHEETS	SHEET NO.
856	14-00170-42-RP	WILL	394	50
CONTRACT NO. 61D47				
ILLINOIS FED. AID PROJECT				


PR CURVE P-WEBER-1
 PI STA. = 729+39.48
 $\Delta = 1^\circ 46' 38''$ (LT)
 $D = 0^\circ 12' 53''$
 $R = 26,700.00'$
 $T = 414.15'$
 $L = 828.23'$
 $E = 3.21'$
 P.C. STA = 725+25.33
 P.T. STA = 733+53.56

PR CURVE P-WEBER-2
 PI STA. = 736+05.22
 $\Delta = 1^\circ 47' 28''$ (LT)
 $D = 0^\circ 21' 21''$
 $R = 16,100.00'$
 $T = 251.66'$
 $L = 503.29'$
 $E = 1.97'$
 P.C. STA = 733+53.56
 P.T. STA = 738+56.85


PR CURVE P-WEBER-3
 PI STA. = 743+77.47
 $\Delta = 3^\circ 52' 08''$ (RT)
 $D = 0^\circ 22' 18''$
 $R = 15,414.51'$
 $T = 520.63'$
 $L = 1,040.86'$
 $E = 8.79'$
 P.C. STA = 738+56.85
 P.T. STA = 748+97.70

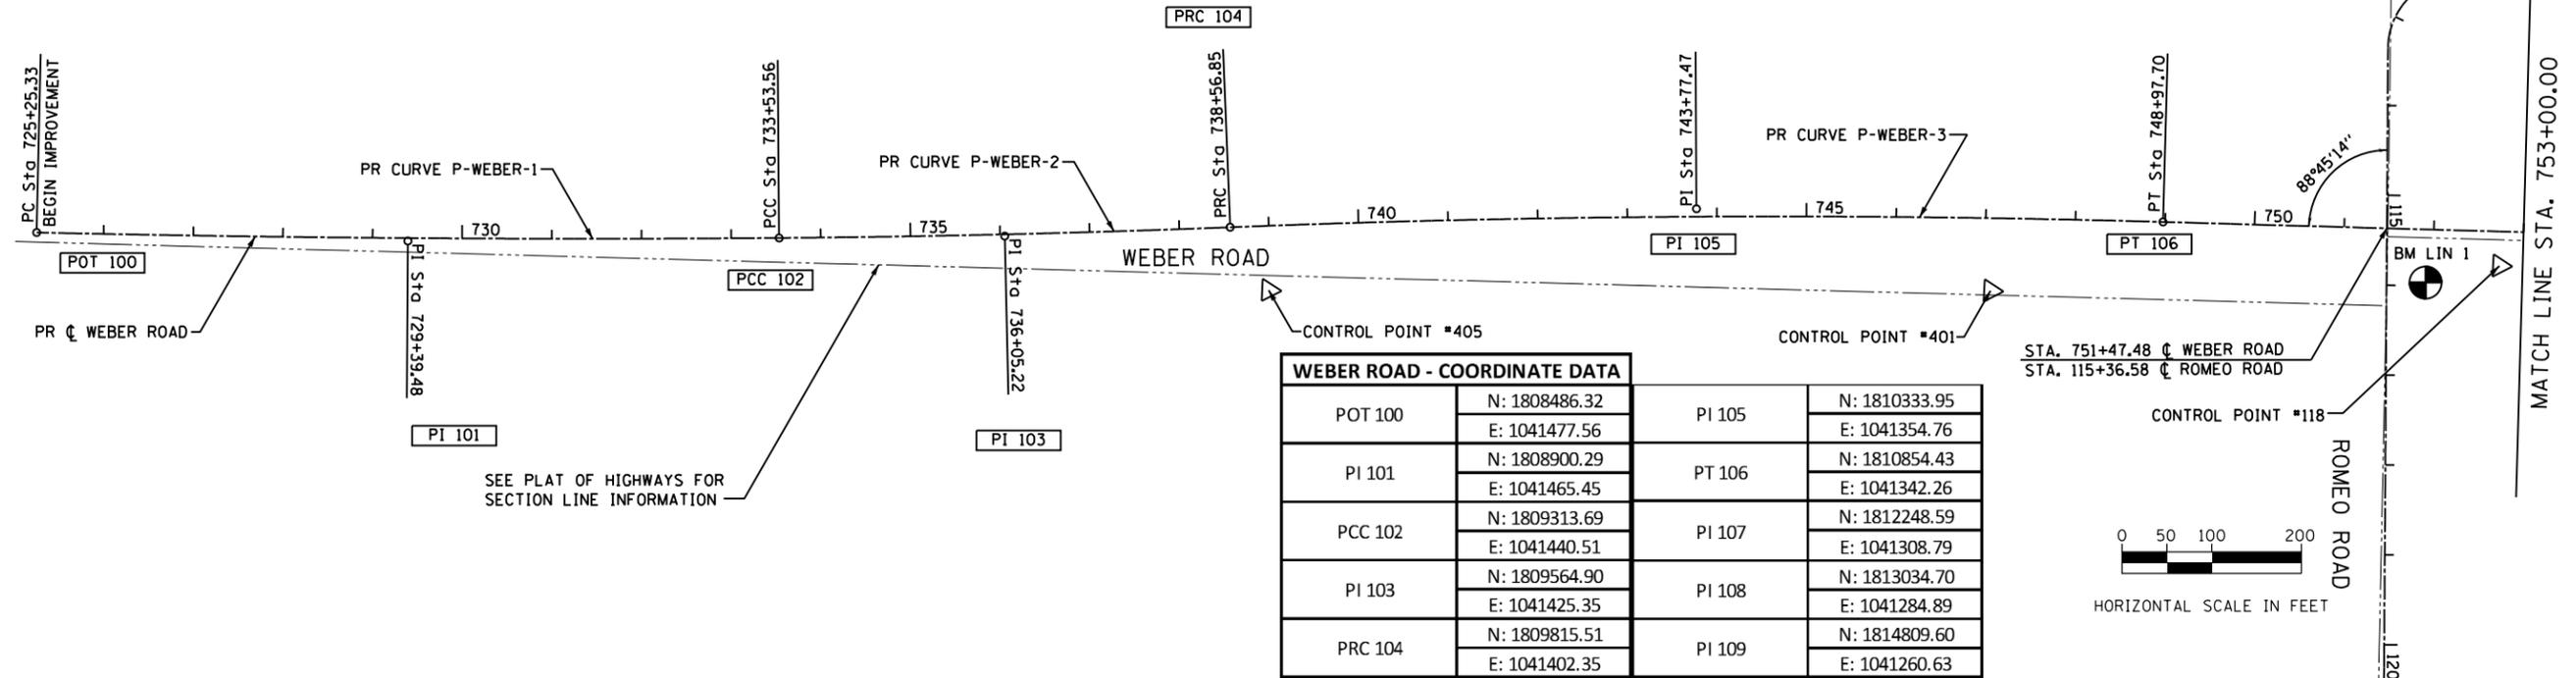

WEBER ROAD - COORDINATE DATA			
POT 100	N: 1808486.32 E: 1041477.56	PI 105	N: 1810333.95 E: 1041354.76
PI 101	N: 1808900.29 E: 1041465.45	PT 106	N: 1810854.43 E: 1041342.26
PCC 102	N: 1809313.69 E: 1041440.51	PI 107	N: 1812248.59 E: 1041308.79
PI 103	N: 1809564.90 E: 1041425.35	PI 108	N: 1813034.70 E: 1041284.89
PRC 104	N: 1809815.51 E: 1041402.35	PI 109	N: 1814809.60 E: 1041260.63

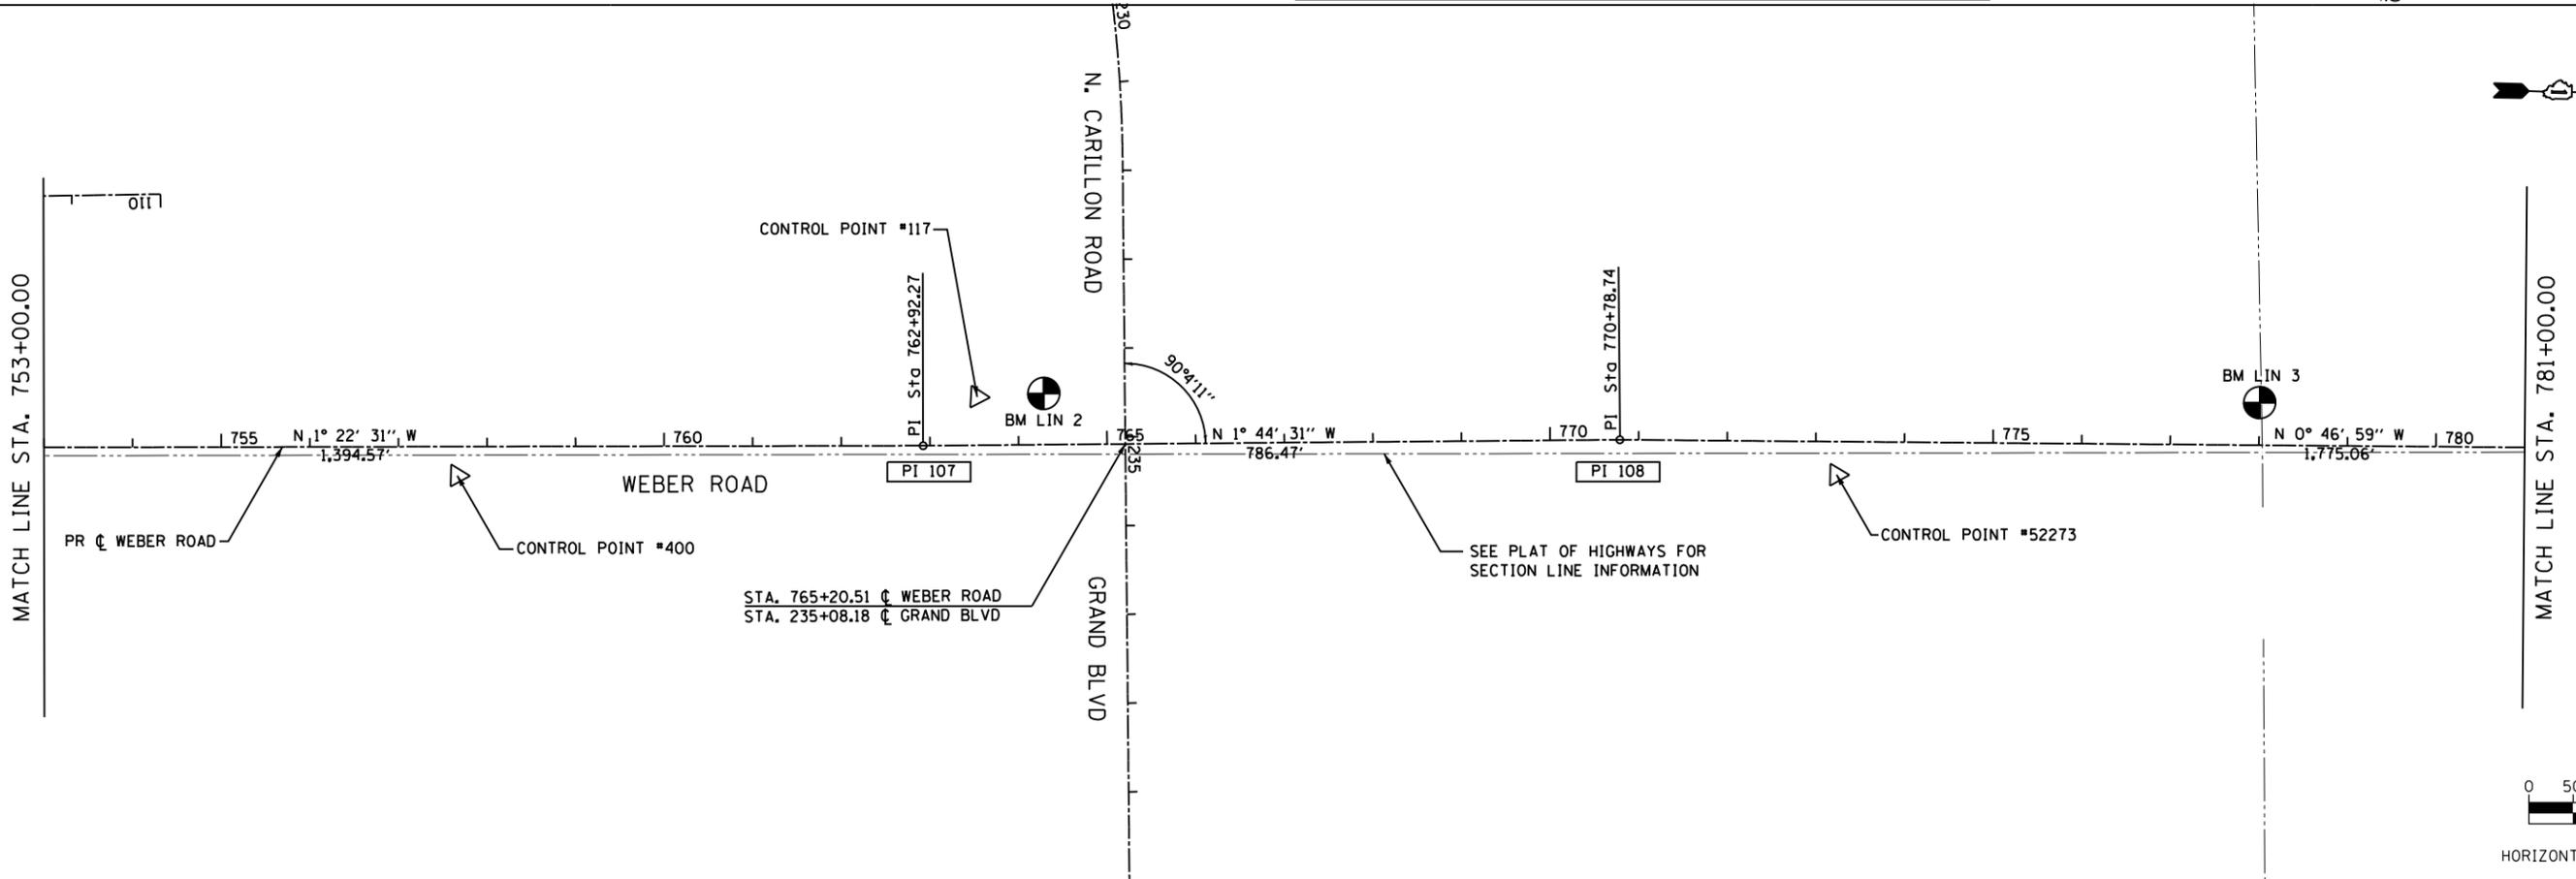

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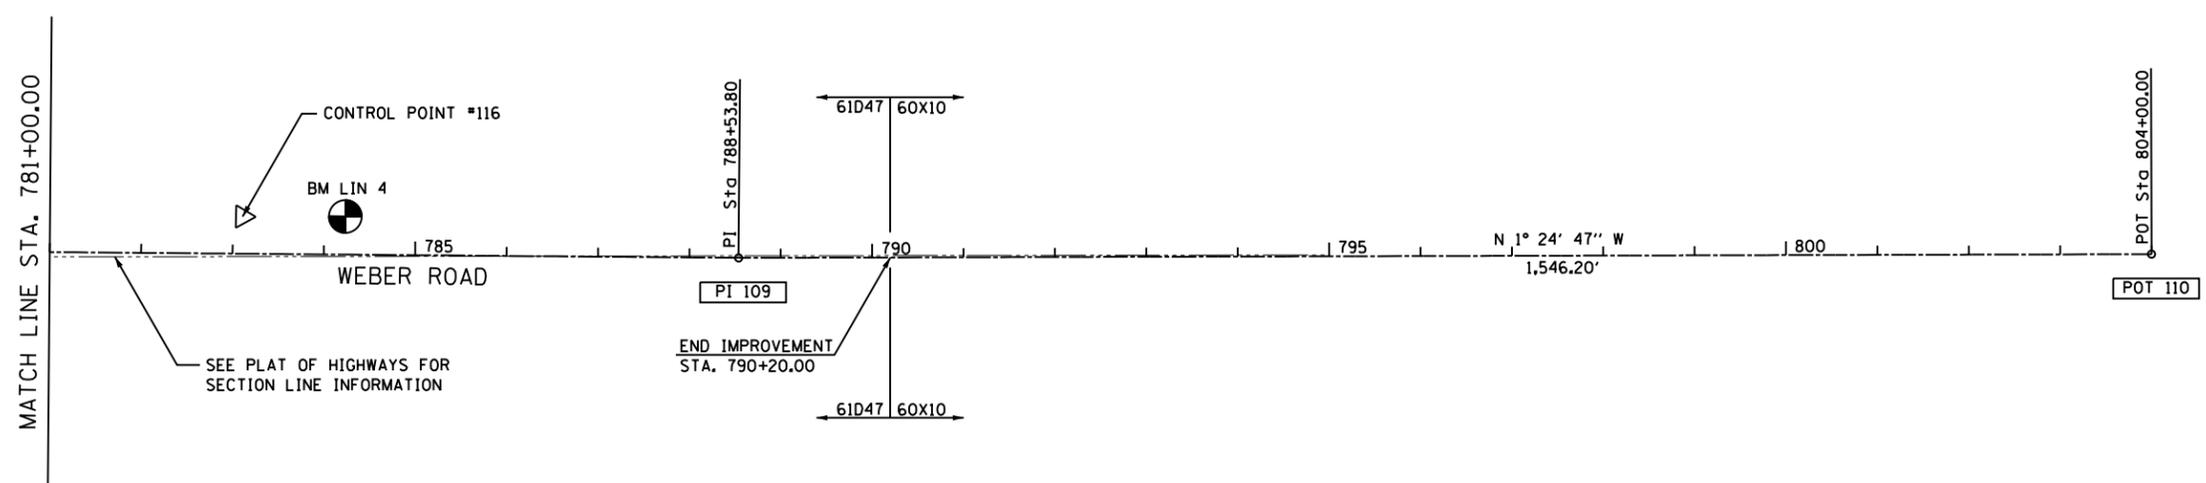
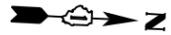
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	DRAWN - ADF	REVISED - 6/19/2015
PLOT SCALE = 200.0000' / in.	CHECKED - CRC	REVISED - 9/27/2016
PLOT DATE = 11/14/2017	DATE - 11/15/17	REVISED -

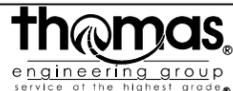STATE OF ILLINOIS
 DEPARTMENT OF TRANSPORTATION


ALIGNMENT, TIES, AND BENCHMARKS

SCALE: 1"=100' SHEET 1 OF 4 SHEETS STA. TO STA.

F.A.P. RTE.	SECTION	COUNTY	TOTAL SHEETS	SHEET NO.
856	14-00170-42-RP	WILL	394	51
CONTRACT NO. 61D47				
ILLINOIS FED. AID PROJECT				




WEBER ROAD - COORDINATE DATA	
POT 100	N: 1808486.32 E: 1041477.56
PI 101	N: 1808900.29 E: 1041465.45
PCC 102	N: 1809313.69 E: 1041440.51
PI 103	N: 1809564.90 E: 1041425.35
PRC 104	N: 1809815.51 E: 1041402.35
PI 105	N: 1810333.95 E: 1041354.76
PT 106	N: 1810854.43 E: 1041342.26
PI 107	N: 1812248.59 E: 1041308.79
PI 108	N: 1813034.70 E: 1041284.89
PI 109	N: 1814809.60 E: 1041260.63
POT 110	N: 1816355.33 E: 1041222.50

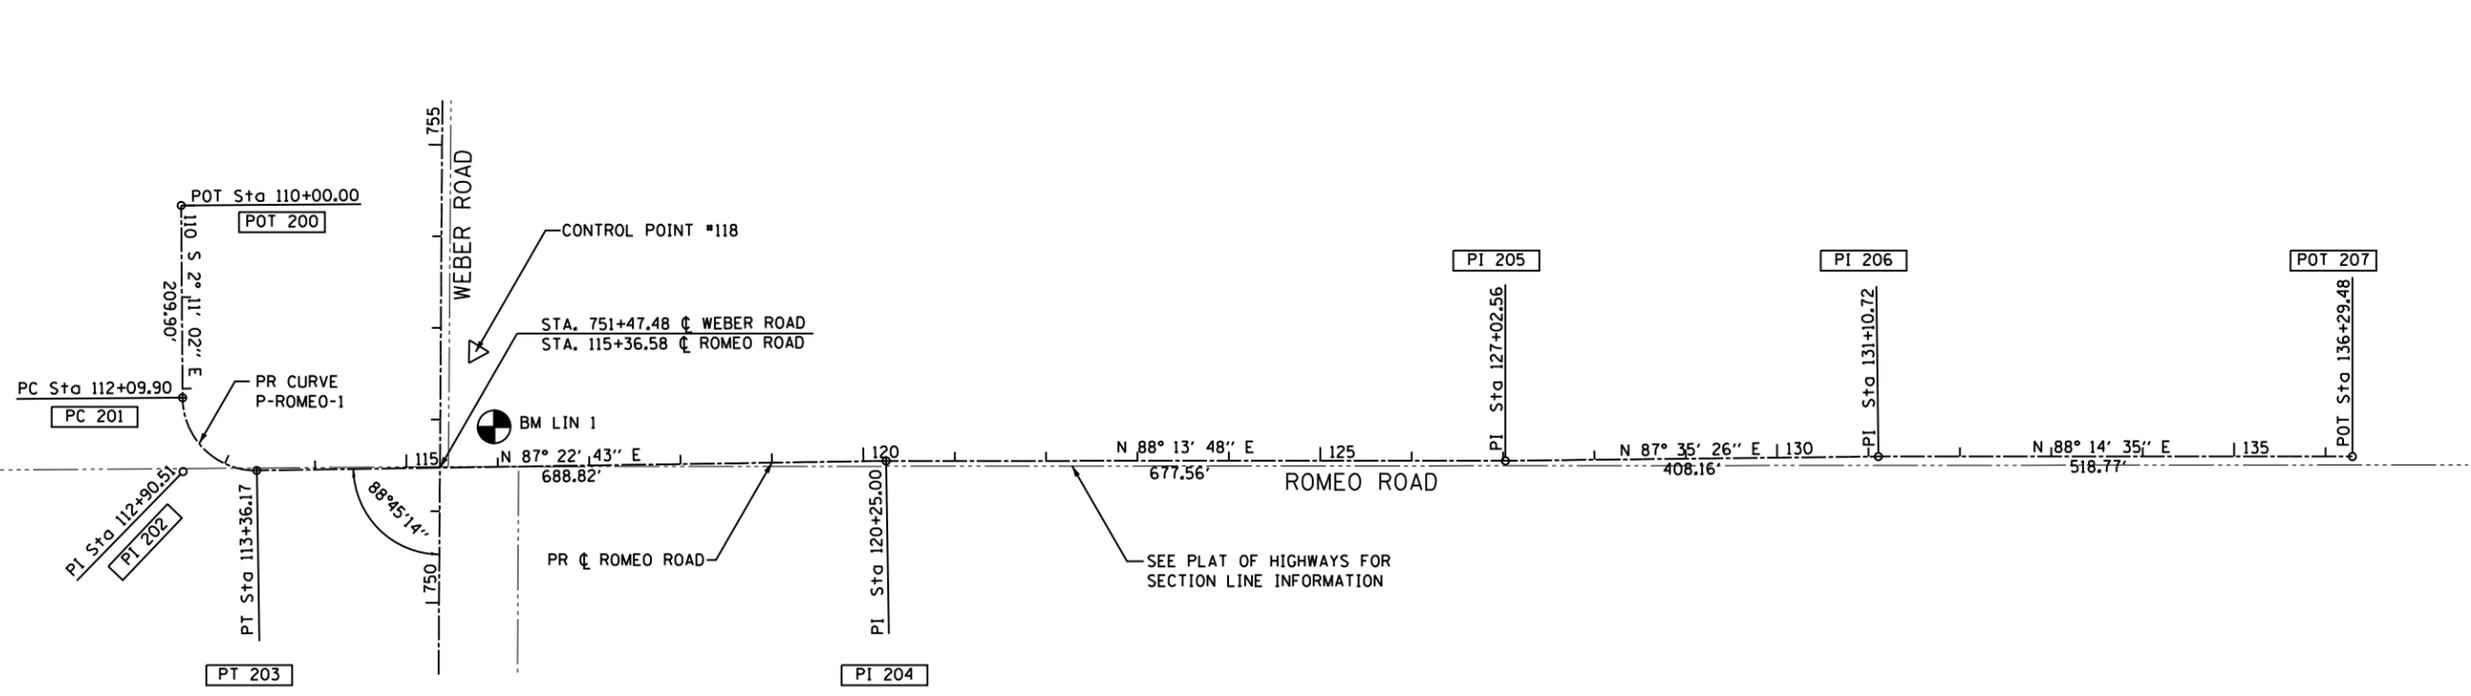


PR CURVE P-ROMEO-1
 $\Delta = 90^\circ 26' 15''$ (LT)
 $D = 71^\circ 37' 11''$
 $R = 80.00'$
 $T = 80.61'$
 $L = 126.27'$
 $E = 33.57'$
 P.C. STA = 112+09.90
 P.T. STA = 113+36.17



ROMEO ROAD - COORDINATE DATA	
POT 200	N: 1811381.59 E: 1041044.47
PC 201	N: 1811171.84 E: 1041052.47
PI 202	N: 1811091.29 E: 1041055.54
PT 203	N: 1811094.97 E: 1041136.07
PI 204	N: 1811126.48 E: 1041824.17
PI 205	N: 1811147.40 E: 1042501.41
PI 206	N: 1811164.56 E: 1042909.21
POT 207	N: 1811180.47 E: 1043427.73

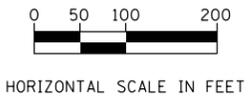

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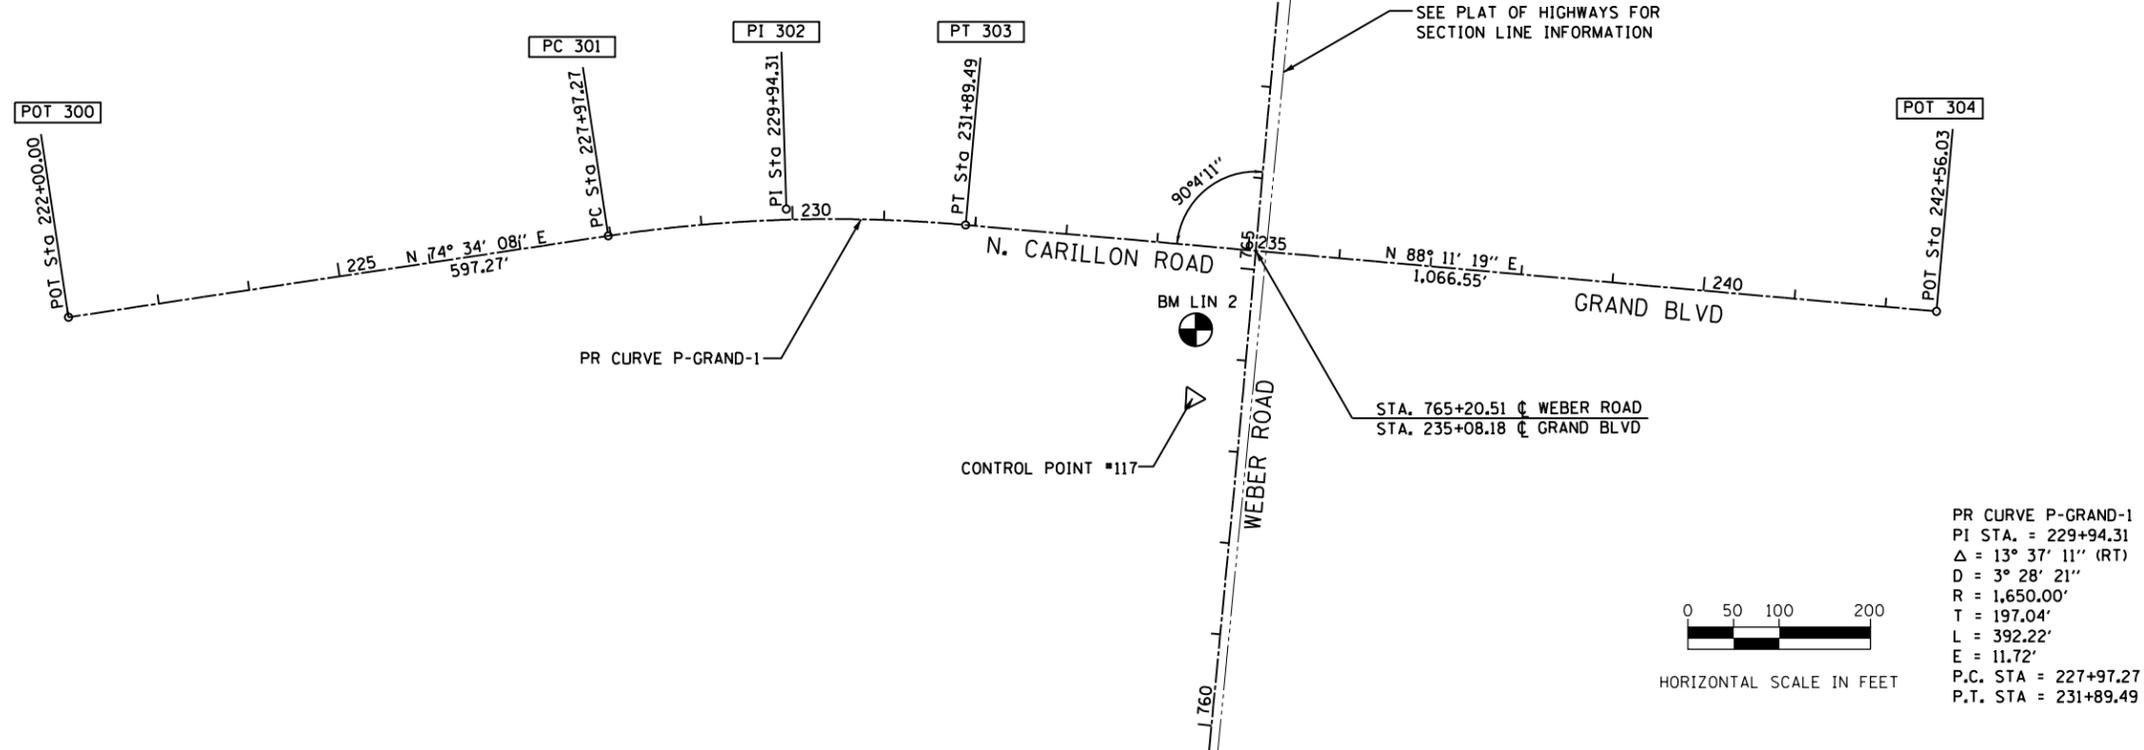
USER NAME = TEG	DESIGNED - JBH	REVISED - 3/3/2015
	DRAWN - ADF	REVISED - 6/19/2015
PLOT SCALE = 200.0000' / in.	CHECKED - CRC	REVISED - 9/27/2016
PLOT DATE = 11/14/2017	DATE - 11/15/17	REVISED -

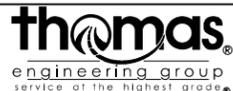STATE OF ILLINOIS
DEPARTMENT OF TRANSPORTATION

ALIGNMENT, TIES, AND BENCHMARKS

SCALE: 1"=100' SHEET 2 OF 4 SHEETS STA. TO STA.

F.A.P. RTE.	SECTION	COUNTY	TOTAL SHEETS	SHEET NO.
856	14-00170-42-RP	WILL	394	52
CONTRACT NO. 61D47				
ILLINOIS FED. AID PROJECT				



GRAND BLVD - COORDINATE DATA	
POT 300	N: 1812249.08 E: 1040020.71
PC 301	N: 1812408.00 E: 1040596.45
PI 302	N: 1812460.43 E: 1040786.38
PT 303	N: 1812466.66 E: 1040983.32
POT 304	N: 1812500.37 E: 1042049.34

PR CURVE P-GRAND-1
 PI STA. = 229+94.31
 Δ = 13° 37' 11" (RT)
 D = 3° 28' 21"
 R = 1,650.00'
 T = 197.04'
 L = 392.22'
 E = 11.72'
 P.C. STA = 227+97.27
 P.T. STA = 231+89.49

0 50 100 200
 HORIZONTAL SCALE IN FEET

BENCHMARKS

VERTICAL DATUM IS NAVD88

BM LIN 1	CHISELED "X" IN NORTHWEST BOLT ON RED FIRE HYDRANT IN NORTHEAST QUAD OF WEBER ROAD AND 135TH STREET ELEV. 655.57	BM LIN 8	CHISELED SQUARE IN WEST SIDE OF CONCRETE LIGHT POLE FOUNDATION EAST OF WEBER ROAD 3RD LIGHT POLE NORTH OF LAKEVIEW DRIVE (LAKEVIEW DRIVE IS EAST WEST ROAD NORTH OF SHELL STATION) ELEV. 658.95
BM LIN 2	CHISELED SQUARE IN EAST SIDE OF FOUNDATION FOR MAST ARM WITH LIGHT IN SOUTHWEST QUAD OF WEBER ROAD AND NORTH CARILLON DRIVE AND GRAND BOULEVARD ELEV. 644.84	BM LIN 9	CHISELED SQUARE IN WEST SIDE OF FOUNDATION FOR MAST ARM IN SOUTHEAST QUAD OF WEBER ROAD AND WINDHAM PARKWAY AND REMINGTON BOULEVARD ELEV. 652.89
BM LIN 3	CHISELED SQUARE IN TOP OF FLARED END SECTION OF 12" CONCRETE CULVERT RUNNING UNDER WEBER ROAD ON WEST SIDE OF ROAD, ±1280' NORTH OF GRAND BOULEVARD AND EAST OF POND ELEV. 619.69	BM LIN 10	CHISELED SQUARE IN TOP OF 53"x34" ELLIPTICAL PIPE FARTHEST SOUTH OF 2 PIPES EAST OF WEBER ROAD ±90' SOUTH OF INTERSECTION OF NORTH CARILLON ROAD AND WEBER ROAD ELEV. 651.37
BM LIN 4	CHISELED SQUARE IN NORTHWEST CORNER OF HEADWALL WEST END OF BOX CULVERT RUNNING UNDER WEBER ROAD DRAINING LILY CACHE SLOUGH, ±1900' NORTH OF GRAND BOULEVARD ELEV. 617.46	BM LIN 11	CHISELED SQUARE IN WEST SIDE OF FOUNDATION OF TRAFFIC LIGHT MAST ARM IN ISLAND AT SOUTH EAST QUAD OF WEBER ROAD AND REMINGTON BOULEVARD AND RODEO DRIVE ELEV. 654.09
BM LIN 5	CHISELED SQUARE IN EAST SIDE OF LIGHT POLE FOUNDATION WEST OF WEBER ROAD 4TH POLE SOUTH OF WEBER ROAD AND NORMANTOWN ROAD JUST NORTH OF "DISCOUNT TIRE CO." ELEV. 624.62	BM LIN 12	CHISELED SQUARE IN BACK OF CURB AT EAST SIDE OF DI ALONG WEBER ROAD ±105' SOUTH OF CENTER OF ENTRANCE TO HIGHLAND CORPORATE CENTER ±1000' SOUTH OF WEBER ROAD AND 115TH STREET INTERSECTION ELEV. 656.97
BM LIN 6	CHISELED SQUARE IN SOUTHWEST SIDE OF CONCRETE TRAFFIC SIGNAL FOUNDATION NORTHEAST QUAD OF WEBER ROAD AND I-55 NORTH BOUND RAMP (DIRECTS TRAFFIC FROM I-55 EXIT RAMP) ELEV. 660.06	BM LIN 13	CHISELED "X" CUT IN SOUTH EAST BOLT ON YELLOW FIRE HYDRANT IN NORTHWEST QUAD OF WEBER ROAD AND 115TH STREET ELEV. 660.53
BM LIN 7	CHISELED SQUARE IN WEST SIDE OF CONCRETE TRAFFIC SIGNAL FOUNDATION SOUTHEAST QUAD OF WEBER ROAD AND I-55 SOUTH BOUND RAMP FARTHEST SOUTH SIGNAL (DIRECTS NORTH BOUND WEBER ROAD TRAFFIC) ELEV. 666.06	BM LIN 14	CHISELED "X" CUT IN WESTERLY BOLT OF FIRE HYDRANT IN NORTHWEST QUAD OF WEBER ROAD AND REMINGTON BOULEVARD AND RODEO DRIVE ELEV. 655.57

FILE NAME = D:\B\11-11803.dgn



USER NAME = TEG	DESIGNED - JBH	REVISED - 3/3/2015
	DRAWN - ADF	REVISED - 6/19/2015
PLOT SCALE = 200.0000' / in.	CHECKED - CRC	REVISED - 9/27/2016
PLOT DATE = 11/14/2017	DATE - 11/15/17	REVISED -

STATE OF ILLINOIS
 DEPARTMENT OF TRANSPORTATION

ALIGNMENT, TIES, AND BENCHMARKS

SCALE: 1"=100' SHEET 3 OF 4 SHEETS STA. TO STA.


F.A.P. RTE.	SECTION	COUNTY	TOTAL SHEETS	SHEET NO.
856	14-00170-42-RP	WILL	394	53
CONTRACT NO. 61D47				
ILLINOIS FED. AID PROJECT				

CONTROL POINT #116

5/8" I-PIN WITH RED CAP
 NORTHING: 1,814,265.9380
 EASTING: 1,041,227.5360
 STA. 783+10.65, 40.52' LT

LILY CACHE SLOUGH

WEBER ROAD

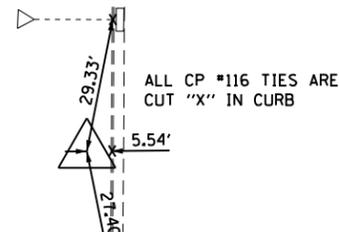

CONTROL POINT #52273

SET IRON ROD 5/8"
 NORTHING: 1,813,280.1340
 EASTING: 1,041,318.8160
 STA. 773+23.68, 37.33' RT

SW CORNER OF
 ELECTRIC CONT. BOX

NE CORNER OF
 INLET STRUCTURE

CATCH BASIN

SIGN

CONTROL POINT #117

5/8" I-PIN WITH RED CAP
 NORTHING: 1,812,308.4660
 EASTING: 1,041,252.5400
 STA. 763+53.82, 54.41' LT

N. CARILLON DRIVE

WEBER ROAD

HMA

CHISELED "X" IN MANHOLE LID

CHISELED "X" ON SIDEWALK

CHISELED "X" IN TOP OF CURB

CONTROL POINT #118

5/8" T-PIN WITH RED CAP
 NORTHING: 1,811,231.7940
 EASTING: 1,041,371.5250
 STA. 752+74.26, 38.31' RT

WEBER ROAD

CHISELED "X" IN TOP OF CURB

CHISELED "X" IN LIGHT POLE FOUNDATION

ROMEO ROAD


CONTROL POINT #400

SET 5/8" IR W/ YELLOW CAP
 NORTHING: 1,811,723.6710
 EASTING: 1,041,354.1180
 STA. 757+66.41, 32.71' RT

WEBER ROAD

NE CORNER OF INLET STRUCTURE

NE CORNER OF HANDHOLE STRUCTURE

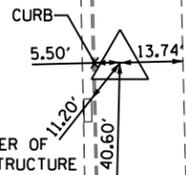

CONTROL POINT #401

5/8" SET IR W/YELLOW CAP
 NORTHING: 1,810,666.4040
 EASTING: 1,041,428.6950
 STA. 747+06.65, 80.71' RT

WEBER ROAD

BACK OF CURB

NO RIGHT TURN SIGN

CUT "X" IN SW CORNER OF HAND HOLE

CONTROL POINT #404

SET MAG NAIL IN PAVEMENT ENTRANCE FOR HIGH TENSION POWER LINES
 NORTHING: 1,808,352.9050
 EASTING: 1,041,515.1830
 STA. 725+25.33, 33.70' RT

S. CARILLON DRIVE

WEBER ROAD

BACK OF CURB 5.90'

MAG NAIL IN NORTH FACE OF POWER POLE


CONTROL POINT #405

FOUND IRON ROD W/CAP MARKED LWA CORP 184-00439
 NORTHING: 1,809,862.0450
 EASTING: 1,041,470.0190
 STA. 738+97.19, 71.59' RT

FOUND MAG NAIL WEST FACE OF PP

BACK OF CURB

FOUND MAG NAIL WEST FACE OF PP

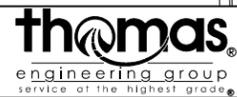

USER NAME = TEG	DESIGNED - JBH	REVISED - 3/3/2015
DRAWN - ADF	REVISED - 6/19/2015	
CHECKED - CRC	REVISED - 9/27/2016	
DATE - 11/15/17	REVISED -	



STATE OF ILLINOIS
 DEPARTMENT OF TRANSPORTATION

ALIGNMENT, TIES, AND BENCHMARKS

SCALE: NTS SHEET 4 OF 4 SHEETS STA. TO STA.



F.A.P. RTE.	SECTION	COUNTY	TOTAL SHEETS	SHEET NO.
856	14-00170-42-RP	WILL	394	54
CONTRACT NO. 61D47				
ILLINOIS FED. AID PROJECT				

FILE NAME = DIBX11-ATB04.dgn

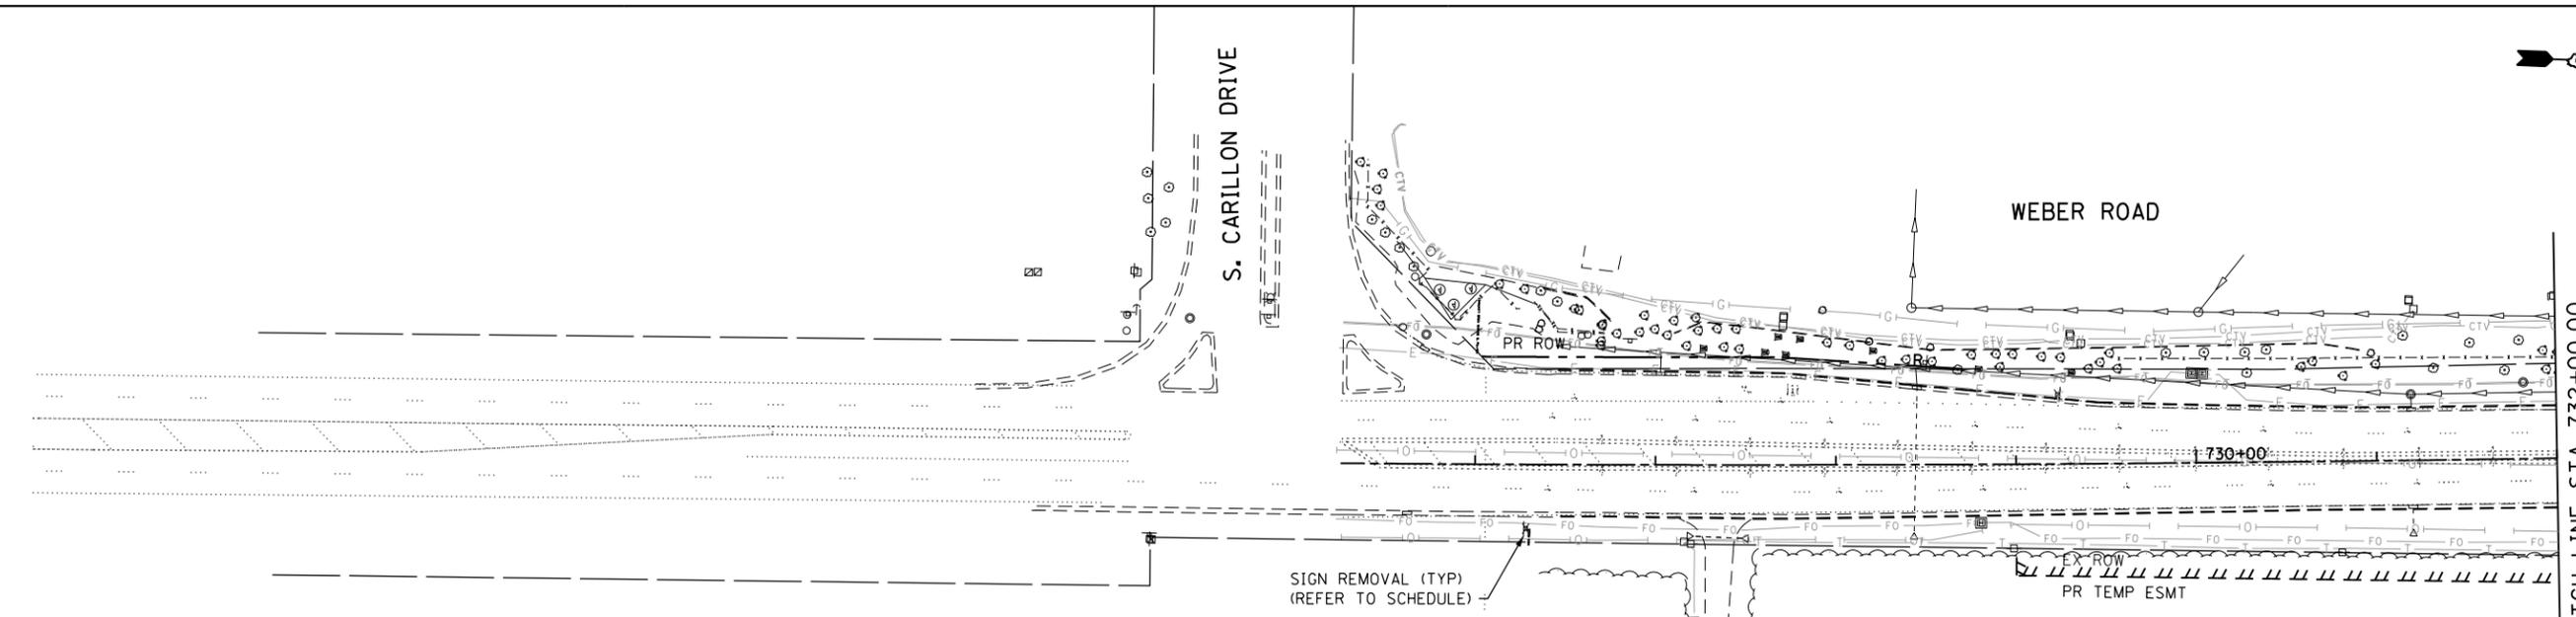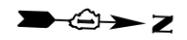

REMOVAL PLAN LEGEND			
	SIDEWALK REMOVAL		DRAINAGE STRUCTURE TO BE REMOVED (INLET)
	PAVEMENT REMOVAL		DRAINAGE STRUCTURE TO BE REMOVED (FES)
	HMA SURFACE REMOVAL		DRAINAGE STRUCTURE TO BE REMOVED (MH)
	DRIVEWAY PVMT REMOVAL		DRAINAGE STRUCTURE TO BE REMOVED (CB)
	MEDIAN REMOVAL		TREE REMOVAL
	COMB C&G REMOVAL		SIGN REMOVAL OR REL (SEE SCHEDULES)
	LINEAR ITEM REMOVAL		SIGN REMOVAL (BY OTHERS)
	ITEM TO BE REMOVED BY CONTRACTOR		
	ITEM TO BE RELOCATED BY OTHERS		

- NOTES**
- COORDINATE EXISTING SIGN REMOVAL WITH STAGED CONSTRUCTION ACTIVITIES.
 - REFER TO TREE REMOVAL SCHEDULE FOR LOCATION DETAIL AND DIMENSIONS.
 - REFER TO SIGN REMOVAL SCHEDULE FOR SIGN REMOVAL AND RELOCATION DETAIL. ADVERTISING AND PRIVATELY OWNED SIGNS ARE TO BE REMOVED (BY OTHERS).
 - REFER TO DRAINAGE STRUCTURE REMOVAL SCHEDULE FOR STATION AND OFFSET DETAILS.
 - REFER TO STORM SEWER REMOVAL SCHEDULES FOR LOCATIONS AND SIZES.
 - REFER TO TEMPORARY TRAFFIC SIGNAL PLANS FOR MORE INFORMATION ON THE REMOVAL OF EXISTING TRAFFIC SIGNAL EQUIPMENT.
 - REFER TO LIGHTING PLANS FOR MORE INFORMATION ON THE REMOVAL OF EXISTING LIGHTING EQUIPMENT.
 - THE COST OF SAW CUTTING, (FULL DEPTH) SHALL BE INCLUDED IN THE UNIT PRICES FOR THE VARIOUS REMOVAL PAY ITEMS.
 - REMOVAL OR RELOCATION OF ANY EXISTING SPRINKLER SYSTEM SHALL BE COORDINATED BY THE CONTRACTOR WITH THE PROPERTY OWNER.

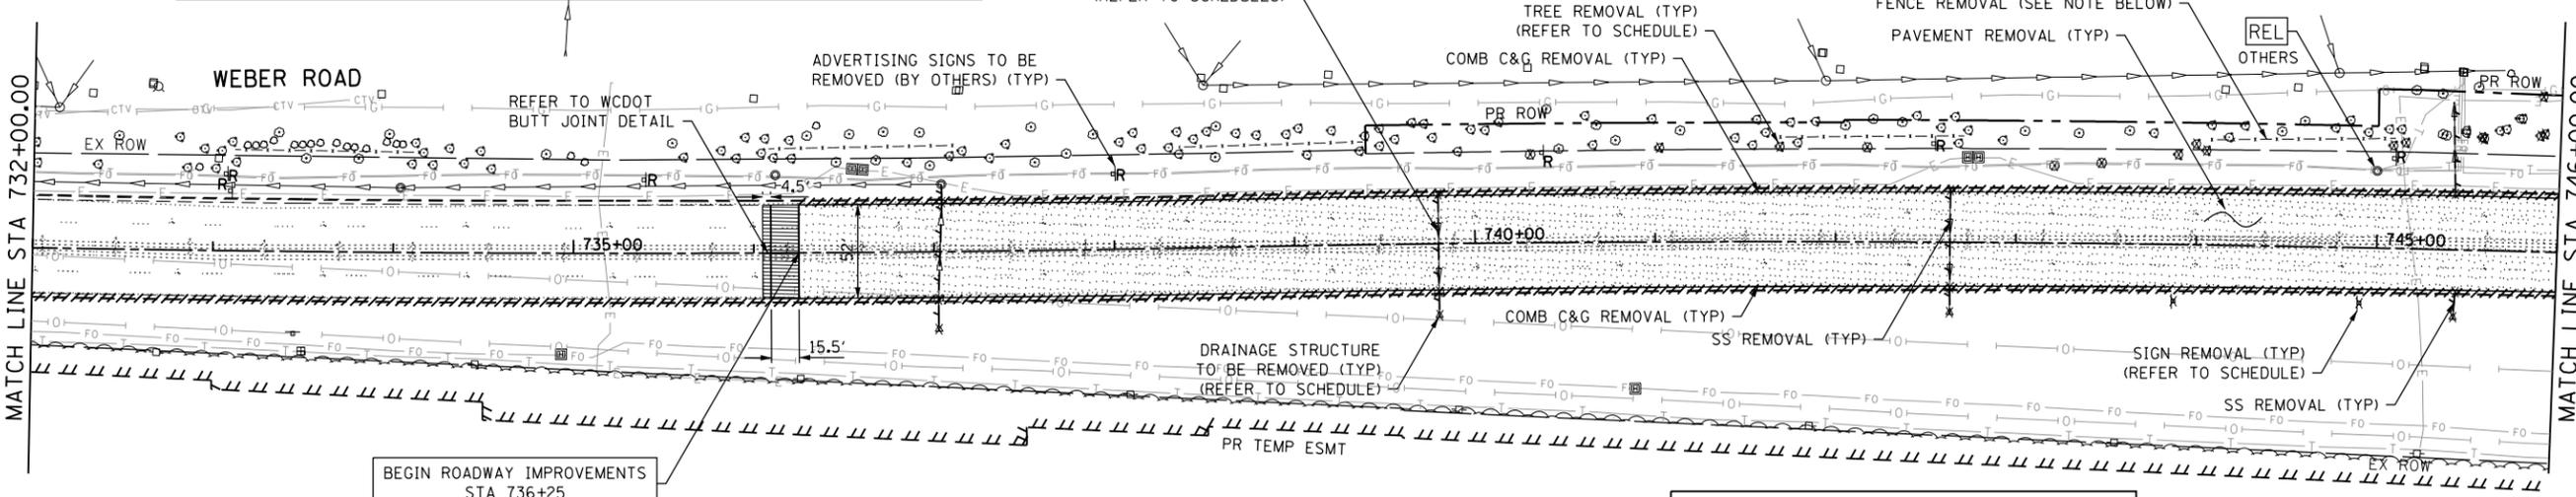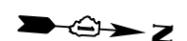


NOTE
 FENCE REMOVAL OR PRESERVATION SHALL BE DETERMINED BASED ON FIELD CONDITIONS BY THE FIELD ENGINEER. A QUANTITY AND SPECIAL PROVISION HAVE BEEN INCORPORATED IF THE FIELD ENGINEER DEEMS REMOVAL IS NECESSARY.



HORIZONTAL SCALE IN FEET

FILE NAME = D:\B\11-ahtr-removal\01.dgn

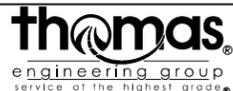



USER NAME = TEG	DESIGNED - RO	REVISED - 3/3/2015
	DRAWN - VJM	REVISED - 6/19/2015
PLOT SCALE = 100.0000' / in.	CHECKED - CRC	REVISED - 9/27/2016
PLOT DATE = 11/14/2017	DATE - 11/15/17	REVISED -

**STATE OF ILLINOIS
 DEPARTMENT OF TRANSPORTATION**


**REMOVAL PLAN
 WEBER ROAD**

SCALE: 1"=50' SHEET 1 OF 5 SHEETS STA. TO STA.


F.A.P. RTE.	SECTION	COUNTY	TOTAL SHEETS	SHEET NO.
856	14-00170-42-RP	WILL	394	55
CONTRACT NO. 61D47				
ILLINOIS FED. AID PROJECT				

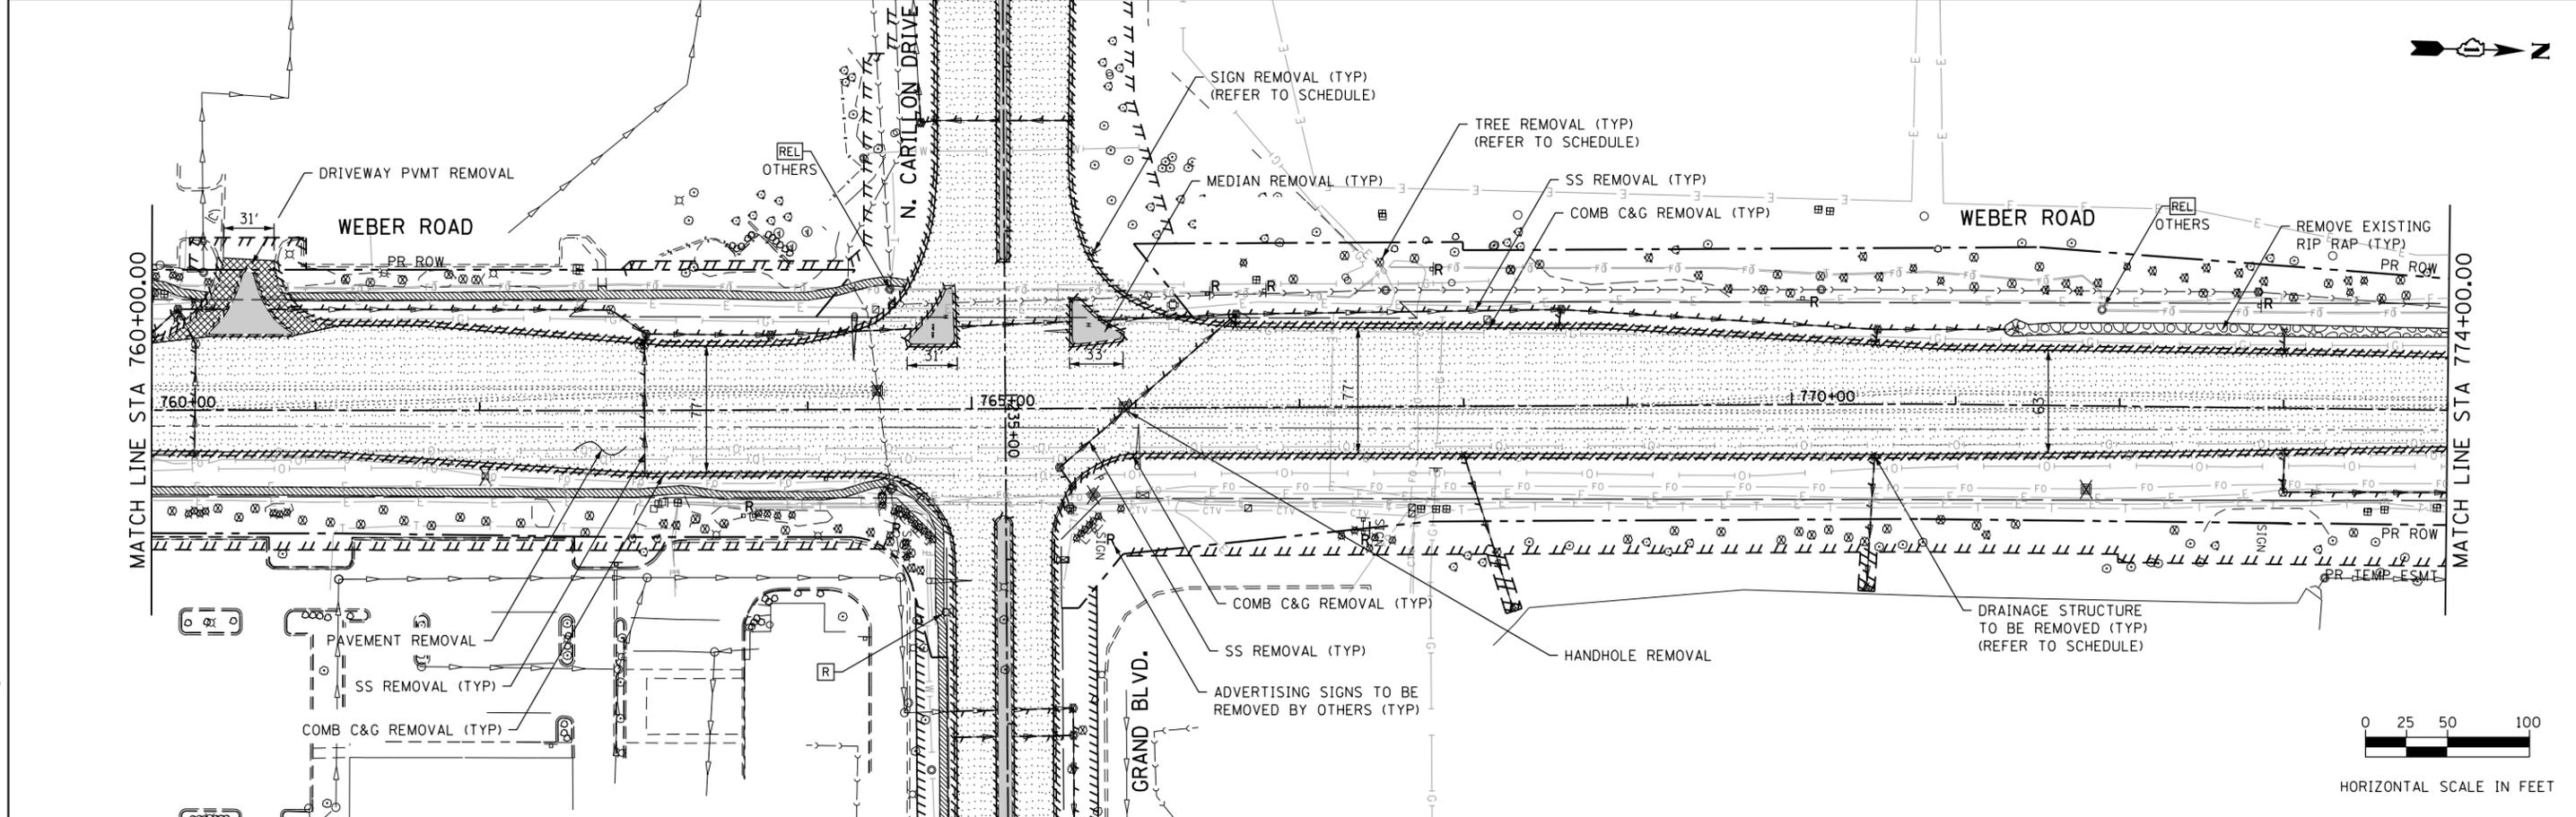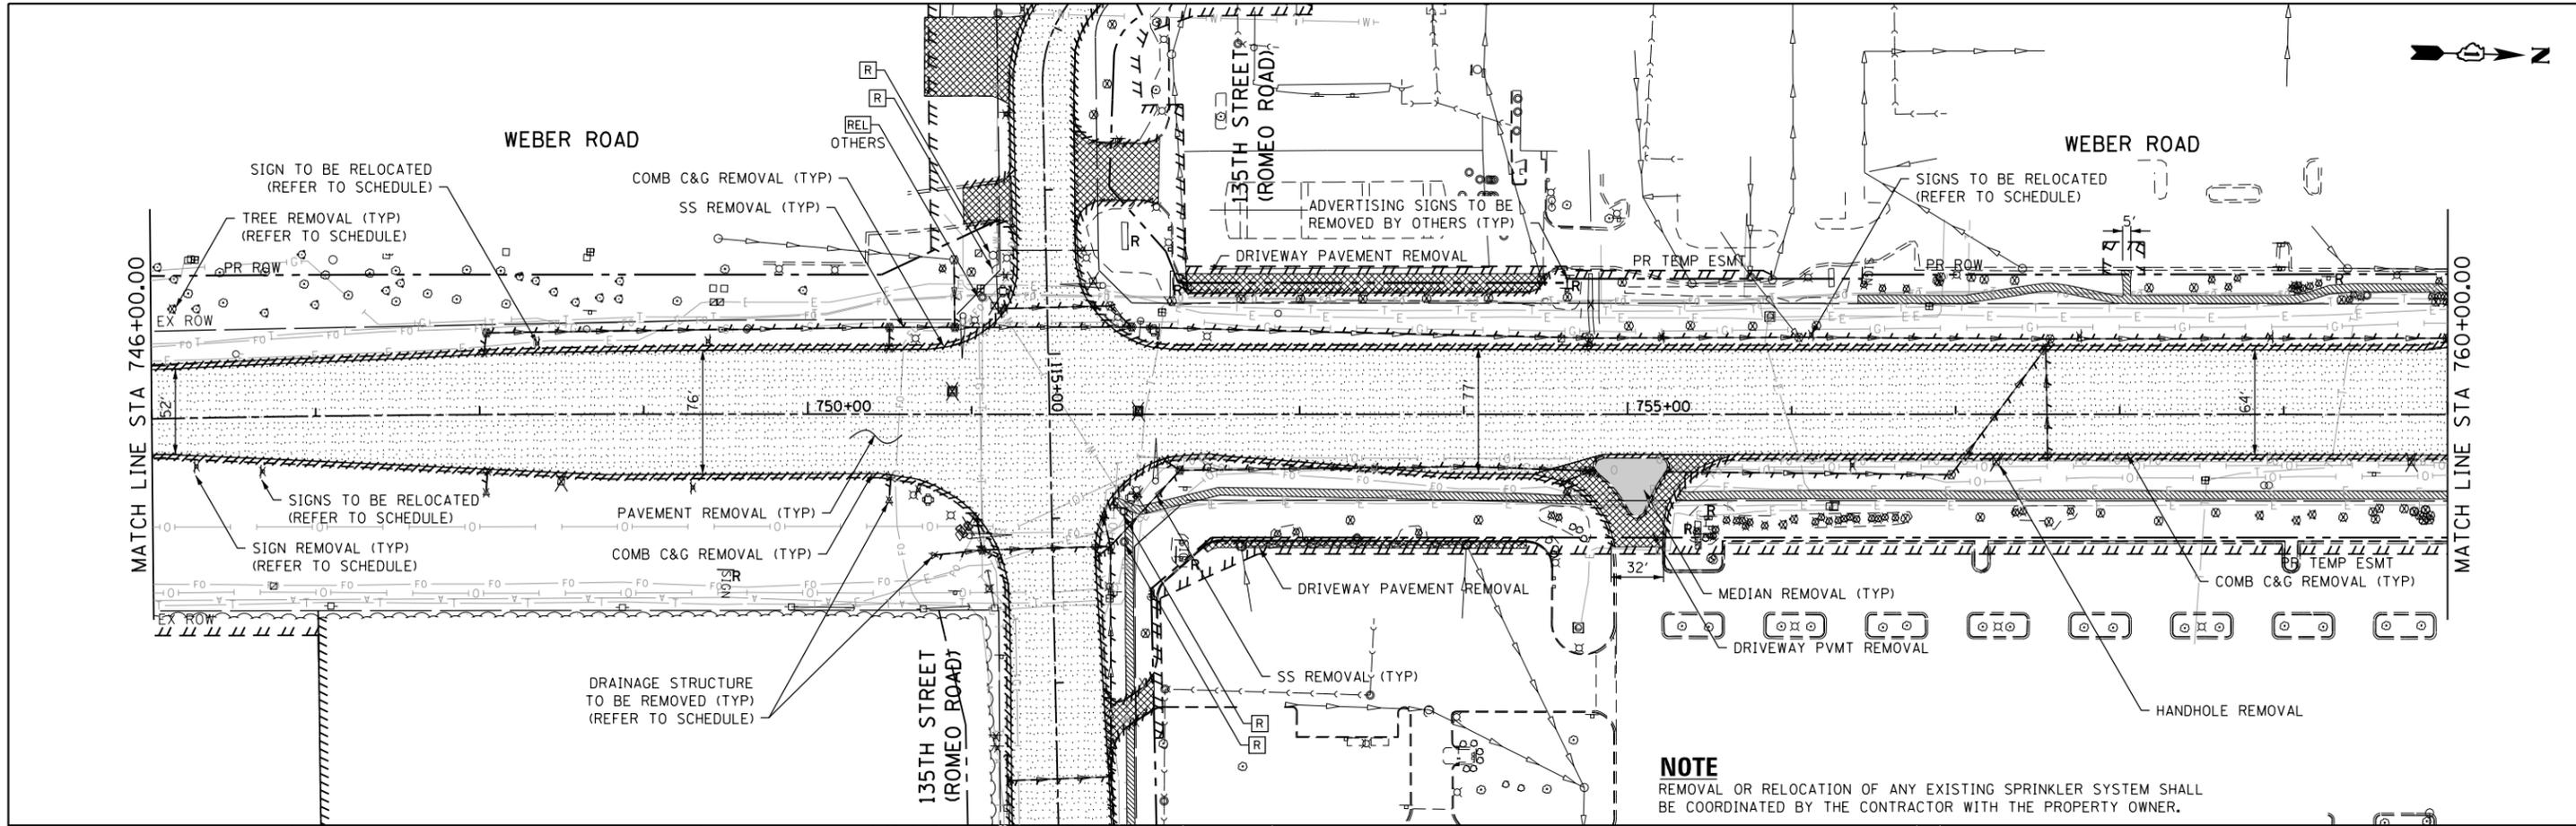

NOTE
REMOVAL OR RELOCATION OF ANY EXISTING SPRINKLER SYSTEM SHALL BE COORDINATED BY THE CONTRACTOR WITH THE PROPERTY OWNER.

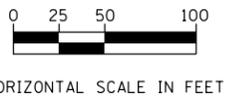

FILE NAME = D:\BX11-ahc-removal\02.dgn

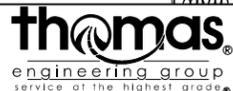



USER NAME = TEG	DESIGNED - RO	REVISED - 3/3/2015
	DRAWN - VJM	REVISED - 6/19/2015
PLOT SCALE = 100.0000' / in.	CHECKED - CRC	REVISED - 9/27/2016
PLOT DATE = 11/14/2017	DATE - 11/15/17	REVISED -

STATE OF ILLINOIS
DEPARTMENT OF TRANSPORTATION




REMOVAL PLAN
WEBER ROAD

SCALE: 1"=50' SHEET 2 OF 5 SHEETS STA. TO STA.


F.A.P. RTE.	SECTION	COUNTY	TOTAL SHEETS	SHEET NO.
856	14-00170-42-RP	WILL	394	56
CONTRACT NO. 61D47				
ILLINOIS FED. AID PROJECT				

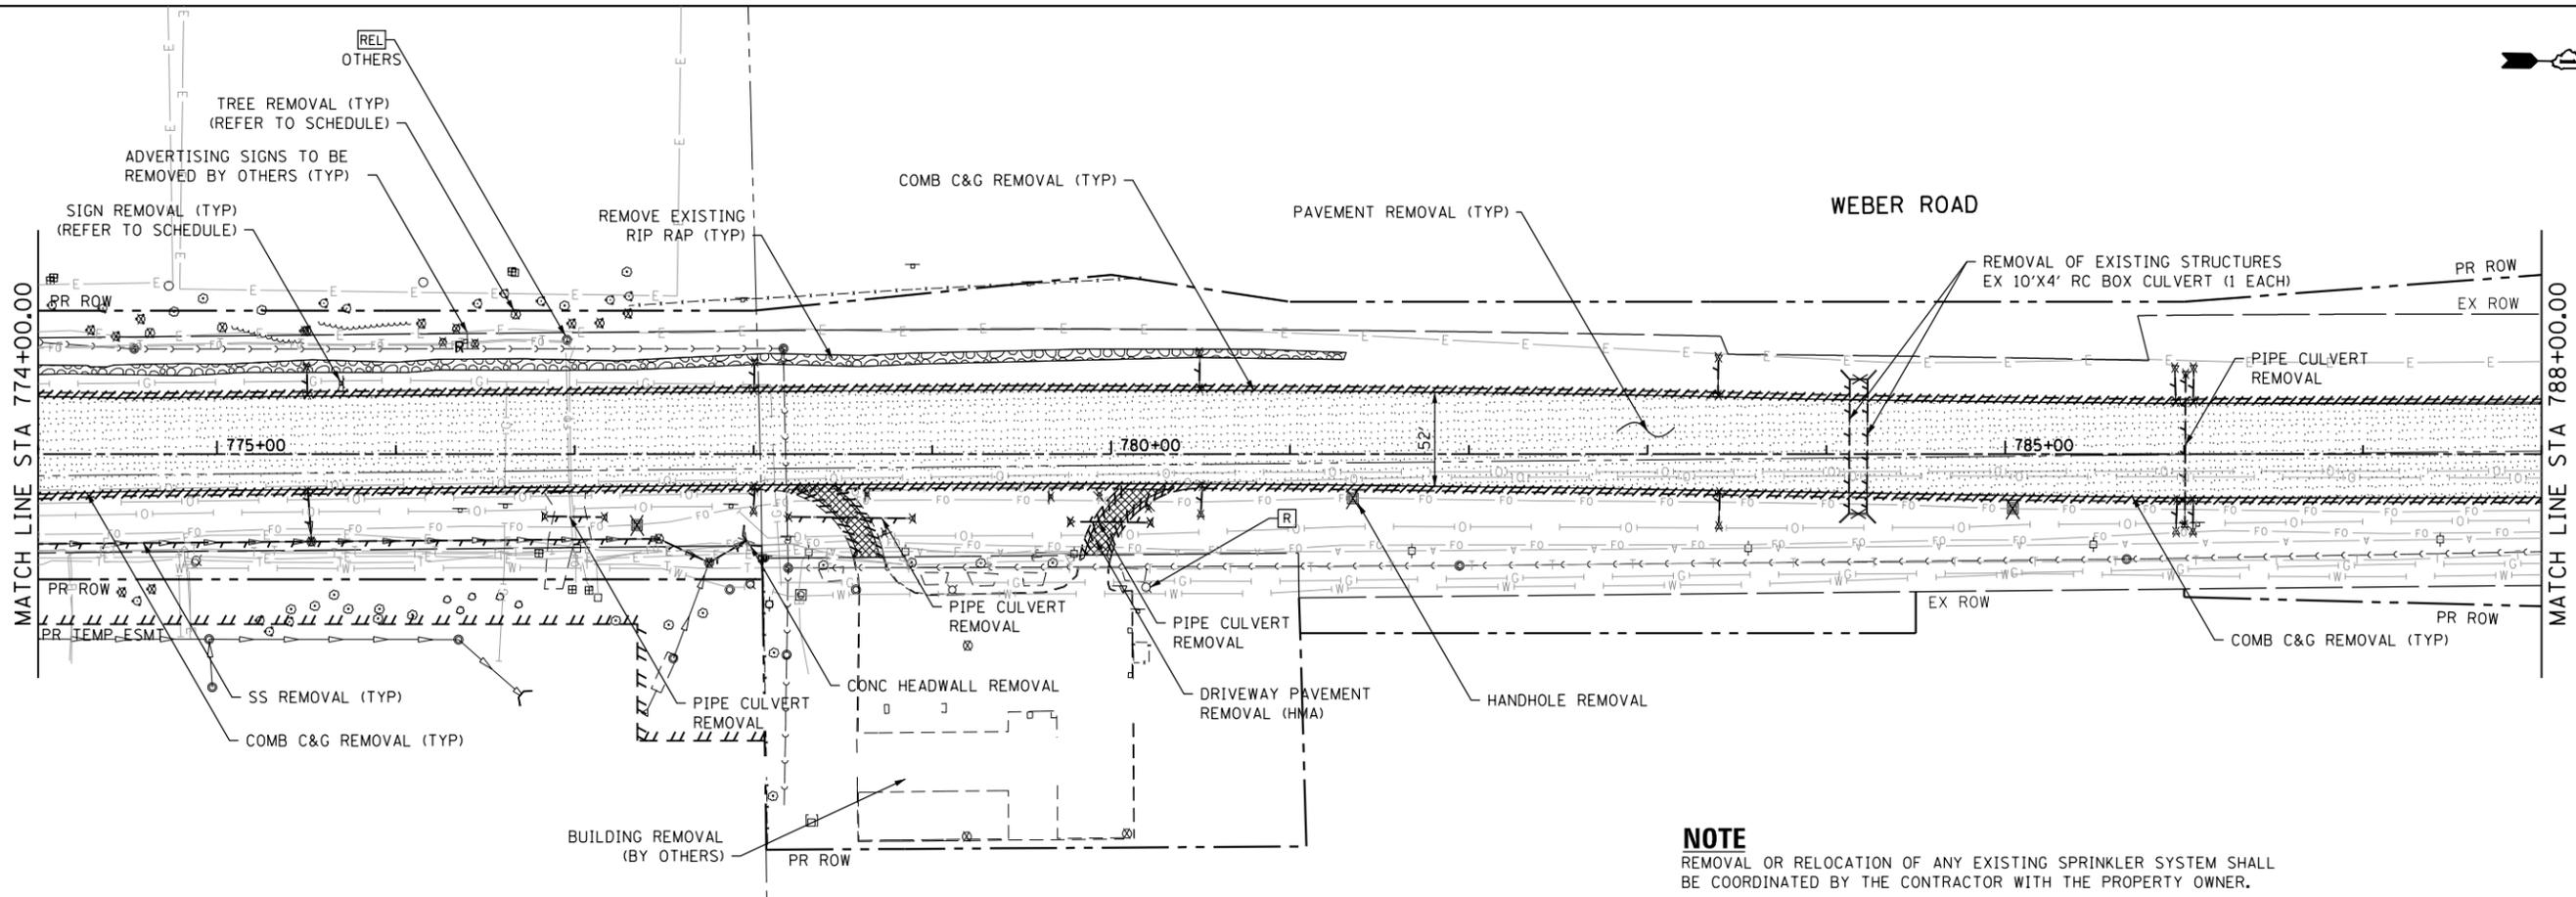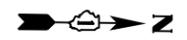

NOTE
 REMOVAL OR RELOCATION OF ANY EXISTING SPRINKLER SYSTEM SHALL BE COORDINATED BY THE CONTRACTOR WITH THE PROPERTY OWNER.

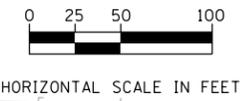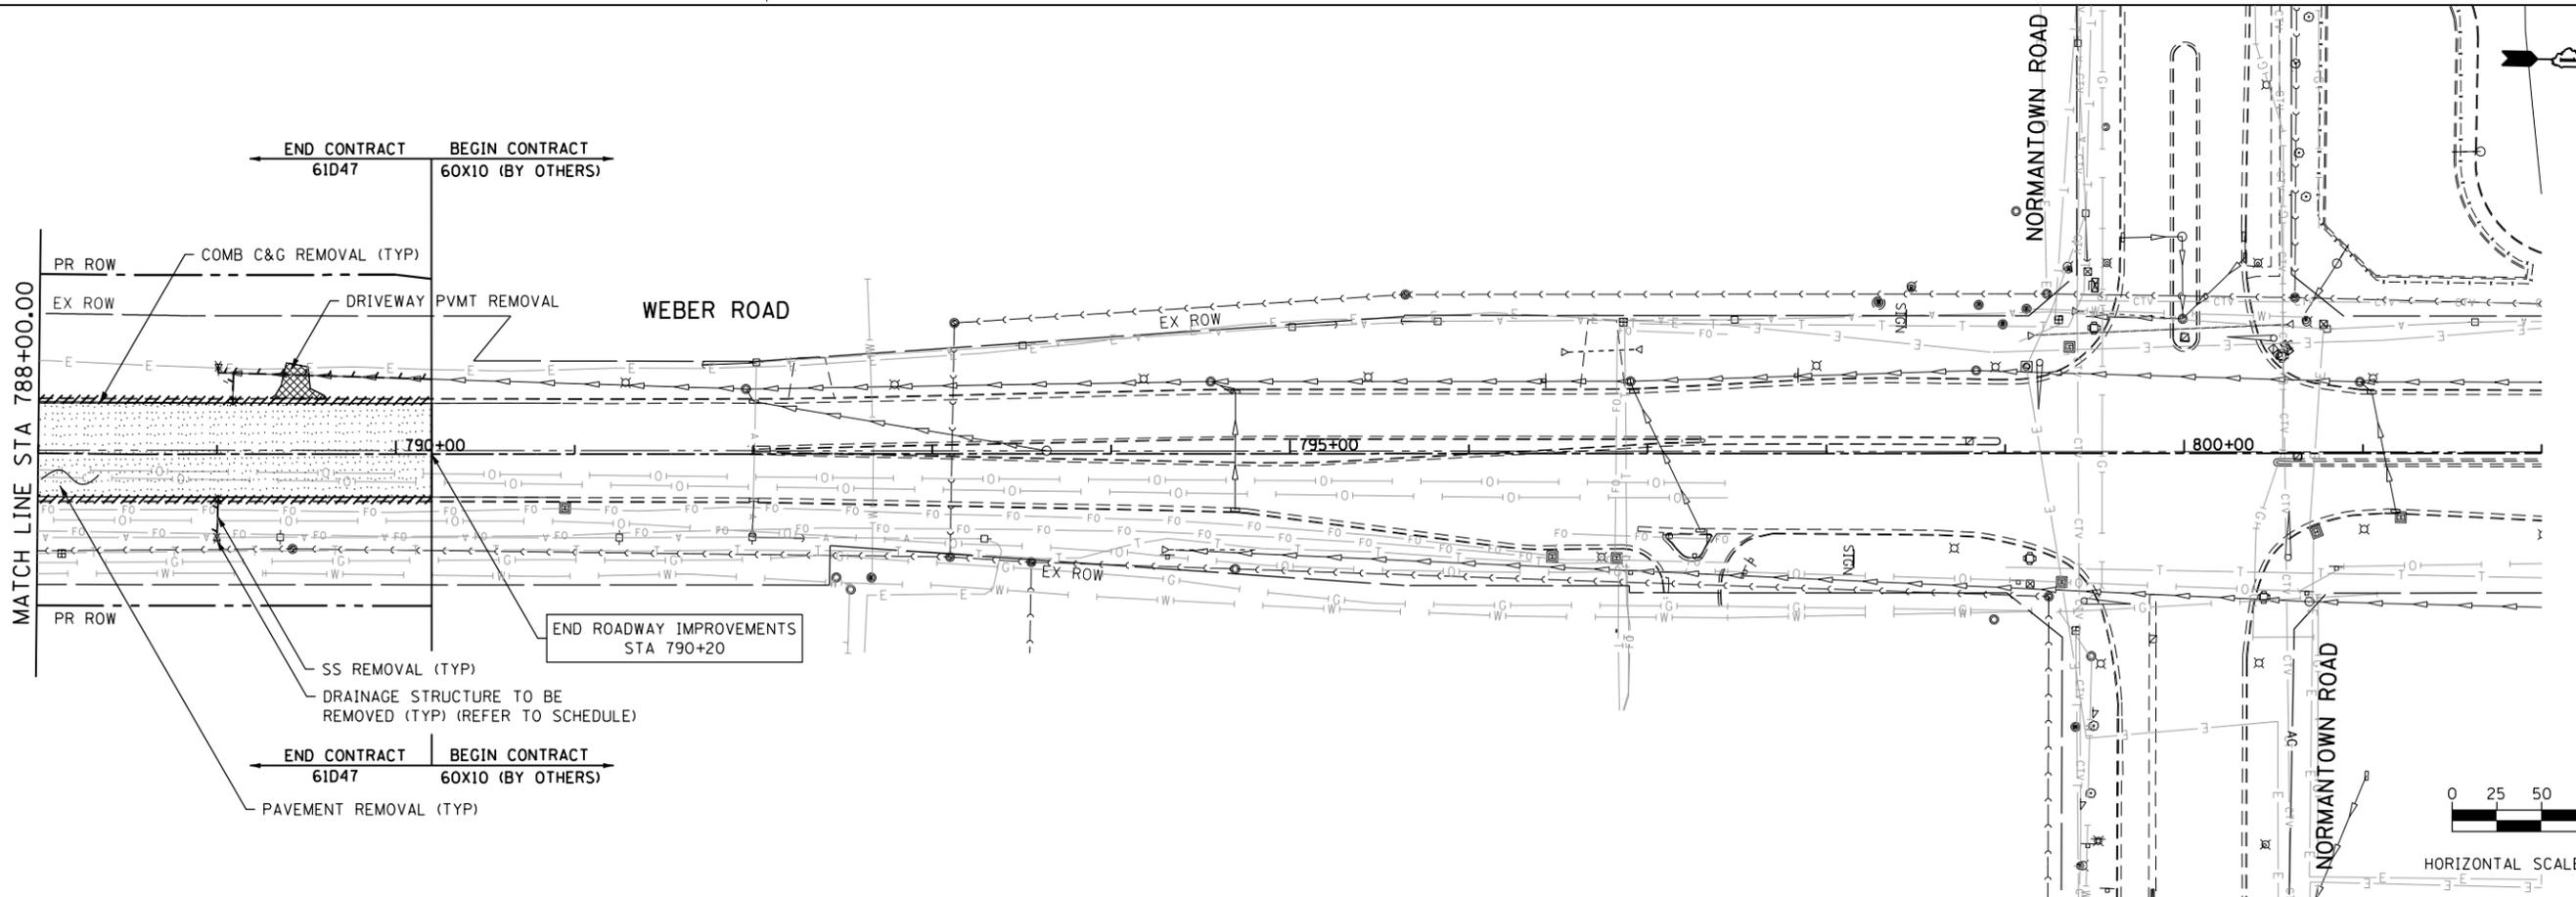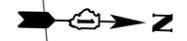

FILE NAME = D:\B\11-shr-removal\03.dgn

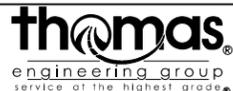

USER NAME = TEG	DESIGNED - RO	REVISED - 3/3/2015
PLOT SCALE = 100.0000' / in.	DRAWN - VJM	REVISED - 6/19/2015
PLOT DATE = 11/14/2017	CHECKED - CRC	REVISED - 9/27/2016
	DATE - 11/15/17	REVISED -


**STATE OF ILLINOIS
 DEPARTMENT OF TRANSPORTATION**

**REMOVAL PLAN
 WEBER ROAD**

SCALE: 1"=50' SHEET 3 OF 5 SHEETS STA. TO STA.

F.A.P. RTE.	SECTION	COUNTY	TOTAL SHEETS	SHEET NO.
856	14-00170-42-RP	WILL	394	57
CONTRACT NO. 61D47				

ILLINOIS FED. AID PROJECT

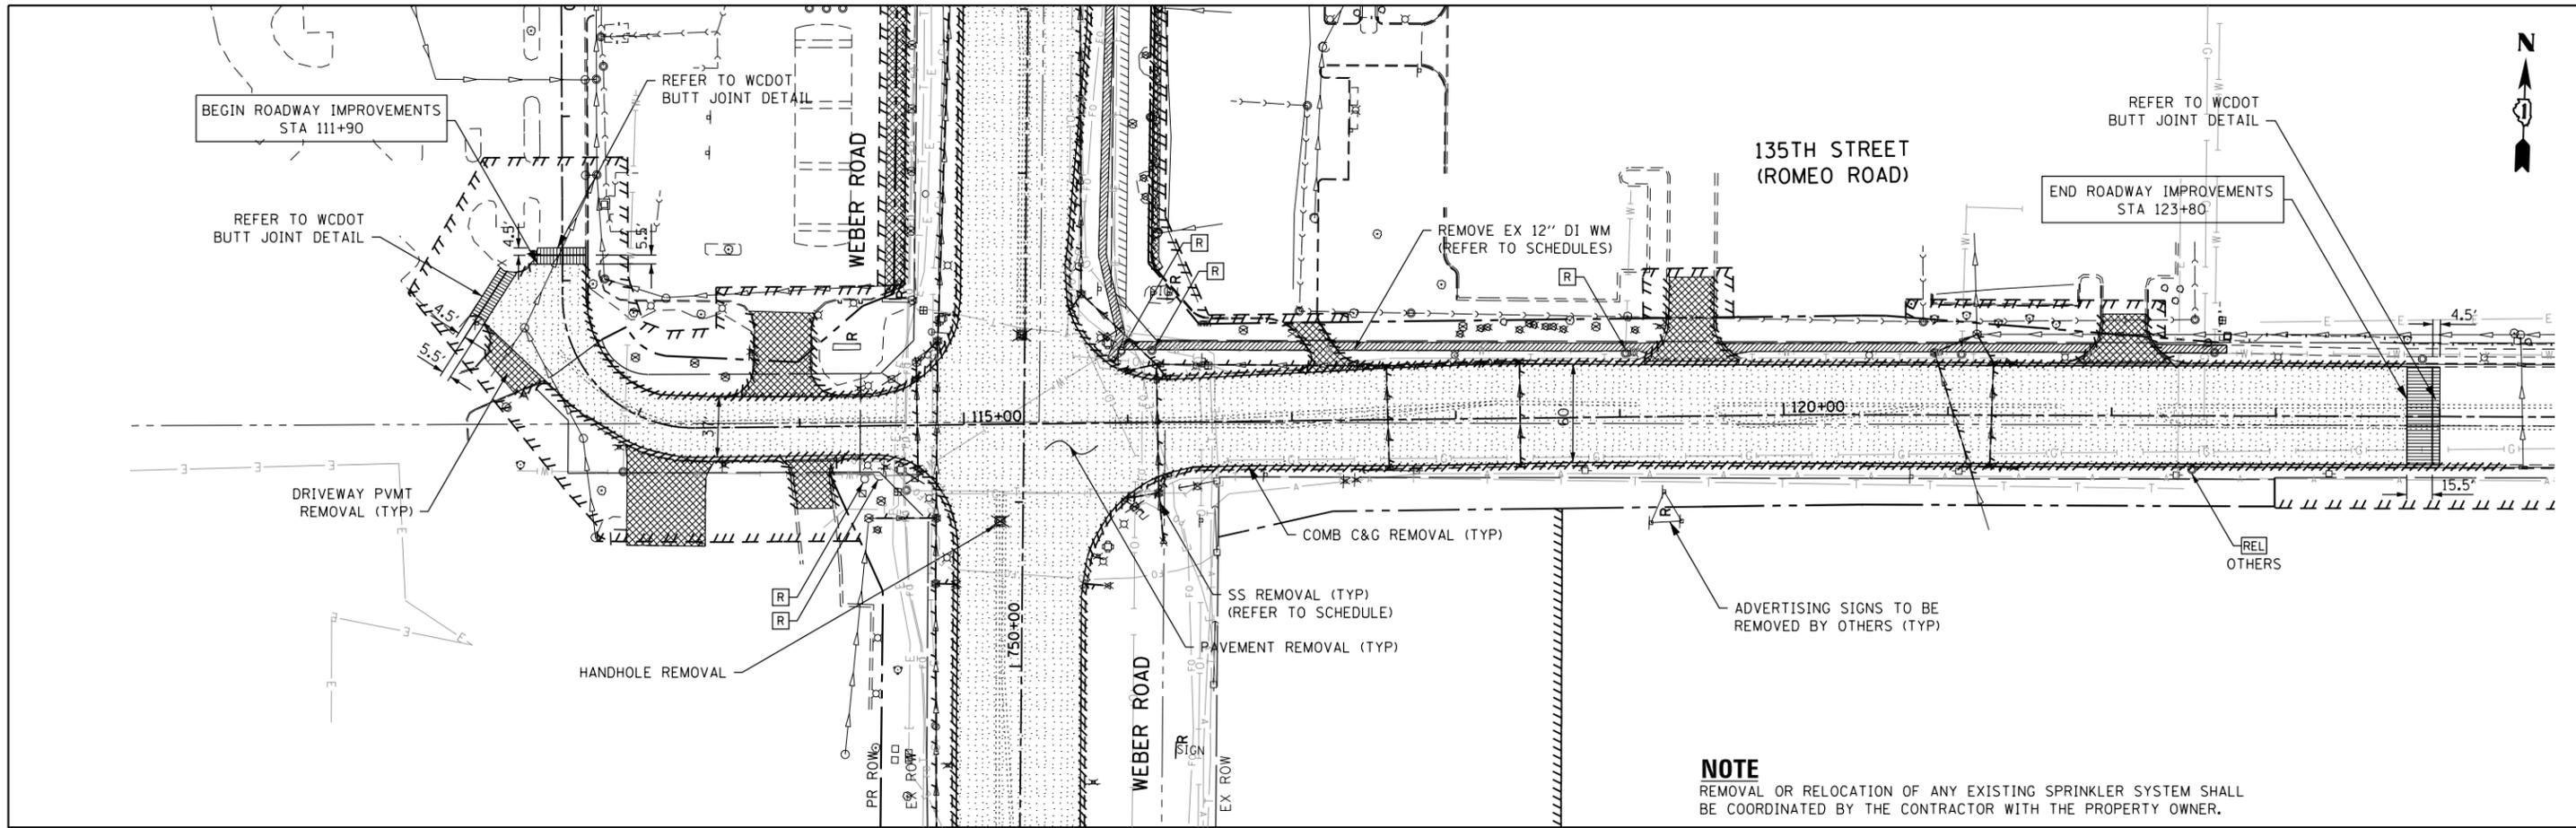


NOTE
 REMOVAL OR RELOCATION OF ANY EXISTING SPRINKLER SYSTEM SHALL BE COORDINATED BY THE CONTRACTOR WITH THE PROPERTY OWNER.

REMOVAL PLAN LEGEND	
	SIDEWALK REMOVAL
	PAVEMENT REMOVAL
	HMA SURFACE REMOVAL
	DRIVEWAY PVMT REMOVAL
	MEDIAN REMOVAL
	COMB C&G REMOVAL
	LINEAR ITEM REMOVAL
	ITEM TO BE REMOVED BY CONTRACTOR
	ITEM TO BE RELOCATED BY OTHERS
	DRAINAGE STRUCTURE TO BE REMOVED (INLET)
	DRAINAGE STRUCTURE TO BE REMOVED (FES)
	DRAINAGE STRUCTURE TO BE REMOVED (MH)
	DRAINAGE STRUCTURE TO BE REMOVED (CB)
	TREE REMOVAL
	SIGN REMOVAL OR REL (SEE SCHEDULES)
	SIGN REMOVAL (BY OTHERS)



FILE NAME = D:\B\11-11-17\11-17-17\11-17-17.dgn

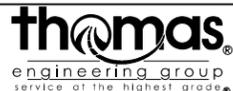


USER NAME = TEG	DESIGNED - RO	REVISED - 3/3/2015
	DRAWN - VJM	REVISED - 6/19/2015
PLOT SCALE = 100.0000' / 1"	CHECKED - CRC	REVISED - 9/27/2016
PLOT DATE = 11/14/2017	DATE - 11/15/17	REVISED -

**STATE OF ILLINOIS
 DEPARTMENT OF TRANSPORTATION**

REMOVAL SHEET	
135TH STREET/ROMEO ROAD	
SCALE: 1"=50'	SHEET 4 OF 5 SHEETS STA. TO STA.

F.A.P. RTE. 856	SECTION 14-00170-42-RP	COUNTY WILL	TOTAL SHEETS 394	SHEET NO. 58
CONTRACT NO. 61D47				
ILLINOIS FED. AID PROJECT				

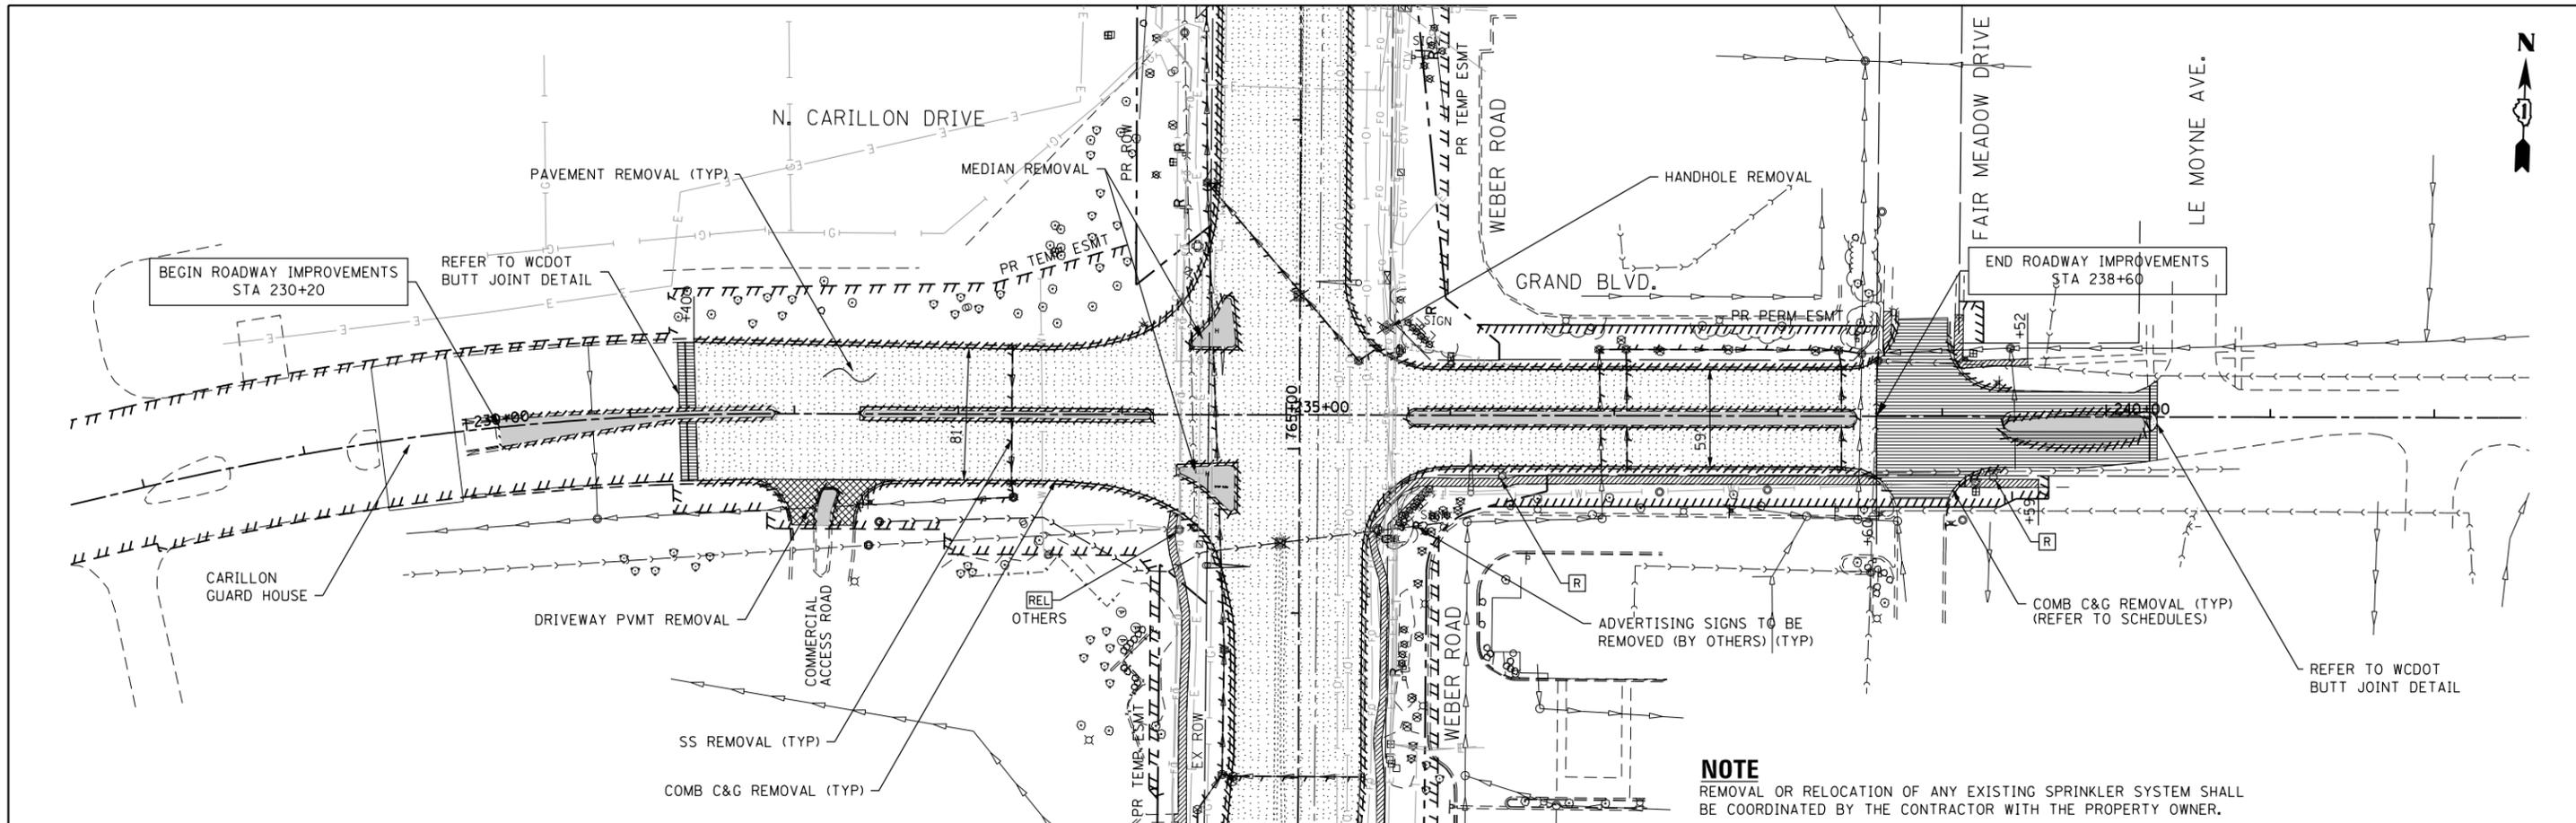

NOTE
 REMOVAL OR RELOCATION OF ANY EXISTING SPRINKLER SYSTEM SHALL BE COORDINATED BY THE CONTRACTOR WITH THE PROPERTY OWNER.

REMOVAL PLAN LEGEND

	SIDEWALK REMOVAL		DRAINAGE STRUCTURE TO BE REMOVED (INLET)
	PAVEMENT REMOVAL		DRAINAGE STRUCTURE TO BE REMOVED (FES)
	HMA SURFACE REMOVAL		DRAINAGE STRUCTURE TO BE REMOVED (MH)
	DRIVEWAY PVMT REMOVAL		DRAINAGE STRUCTURE TO BE REMOVED (CB)
	MEDIAN REMOVAL		TREE REMOVAL
	COMB C&G REMOVAL		SIGN REMOVAL OR REL (SEE SCHEDULES)
	LINEAR ITEM REMOVAL		SIGN REMOVAL (BY OTHERS)
	ITEM TO BE REMOVED BY CONTRACTOR		
	ITEM TO BE RELOCATED BY OTHERS		



HORIZONTAL SCALE IN FEET

FILE NAME = D:\B\11-shr-removal\05.dgn



USER NAME = TEG	DESIGNED - RO	REVISED - 3/3/2015
	DRAWN - VJM	REVISED - 6/19/2015
PLOT SCALE = 100.0000' / in.	CHECKED - CRC	REVISED - 9/27/2016
PLOT DATE = 11/14/2017	DATE - 11/15/17	REVISED -

**STATE OF ILLINOIS
 DEPARTMENT OF TRANSPORTATION**


**REMOVAL SHEETS
 N. CARILLON DRIVE/GRAND BLVD.**

SCALE: 1"=50' SHEET 5 OF 5 SHEETS STA. TO STA.

F.A.P. RTE.	SECTION	COUNTY	TOTAL SHEETS	SHEET NO.
856	14-00170-42-RP	WILL	394	59
CONTRACT NO. 61D47				
ILLINOIS FED. AID PROJECT				

LOCKPORT TOWNSHIP
FIRE AND AMBULANCE
PROTECTION DISTRICT
STATION NO. 3

FOR CONTINUATION OF IMPROVEMENT
ALONG 135TH ST/ROMEO ROAD, REFER
TO SHEET NO. 6 OF THE PLAN/PROFILE

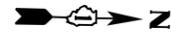

PLAN	SURVEYED	DATE
	PLOTTED	
	ALIGNED	
	CHECKED	
	FILED	
	NO.	

PROFILE	SURVEYED	DATE
	PLOTTED	
	GRADES	
	CHECKED	
	STRUCTURE	
	NOTATIONS	
	CHKD	
	NO.	



WEBER ROAD
MATCH LINE STA 746+00.00
PR WEBER ROAD
EX ROW
540' @ 45:1 TAPER
747+94 51' LT
748+97.70 51' LT
748+97.70 15' LT
748+97.70 15' LT
200' @ 16.7:1 TAPER
746+01 15' RT
747+31 63' RT
748+01 3' RT
748+97.70 63' RT
LANDSCAPED MEDIAN
COMBINATION CONCRETE CURB AND GUTTER, TYPE B-24 (60605000)
PROP. CURVE P-WEBER-3
PI STA. = 743+77.47
Δ = 3° 52' 08" (RT)
D = 0° 22' 18"
R = 15,414.51'
T = 520.63'
L = 1,040.86'
E = 8.79'
e = ----
T.R. = ----
S.E. RUN = ----
P.C. STA. = 738+56.85
P.T. STA. = 748+97.70

135TH STREET (ROMEO ROAD)
DETECTABLE WARNINGS (TYP)
TWO-CENTERED CURVE 55' - 250'R; 10' OFFSET
PGL
750+00
750+511'
88:42:14.1"
TWO-CENTERED CURVE 55'R - 350'R; 15' OFFSET
PT Sta 748+97.70
748+97.70 63' RT
748+97.70 63' RT
56'

BP GAS STATION
STA 751+47.48 WEBER ROAD
STA 115+36.58 135TH ST/ROMEO RD
CONC DRIVEWAY PAVEMENT, 8"
CONCRETE CURB, TYPE B'
TWO-CENTERED CURVE 85'R - 55'R; 15' OFFSET
PR TEMP EASEMENT
754+09 63' LT
755+54 9' RT
756+09 51' LT
758+54 15' LT
CONC CURB, TYPE B
PCC DRIVEWAY PAVEMENT, 8"
754+65 51' RT
755+46 51' RT
FORMER DOMINICK'S GAS STATION
+05.90 (CE)

WEBER ROAD
MATCH LINE STA 760+00.00
PR WEBER ROAD
PR 8' SHARED-USE PATH (TYP)
CONCRETE BARRIER MEDIAN
PR 5' SIDEWALK
PR 5' SIDEWALK (TYP)
300' @ 12.5:1 TAPER
755+00
755+46 51' RT
754+65 51' RT
COMB C&G, TYPE B-6.12 (TYP FOR DUAL LTL'S)
COMB C&G, TYPE B-6.24
LANDSCAPED MEDIAN
PR TEMP EASEMENT

NOTE
1. SEE INTERSECTION DETAIL SHEETS FOR INTERSECTION GRADING INFORMATION.
2. PR ROADWAY AND SHARED-USE PATH PAVEMENT STRUCTURE IDENTIFIED IN TYPICAL SECTIONS.

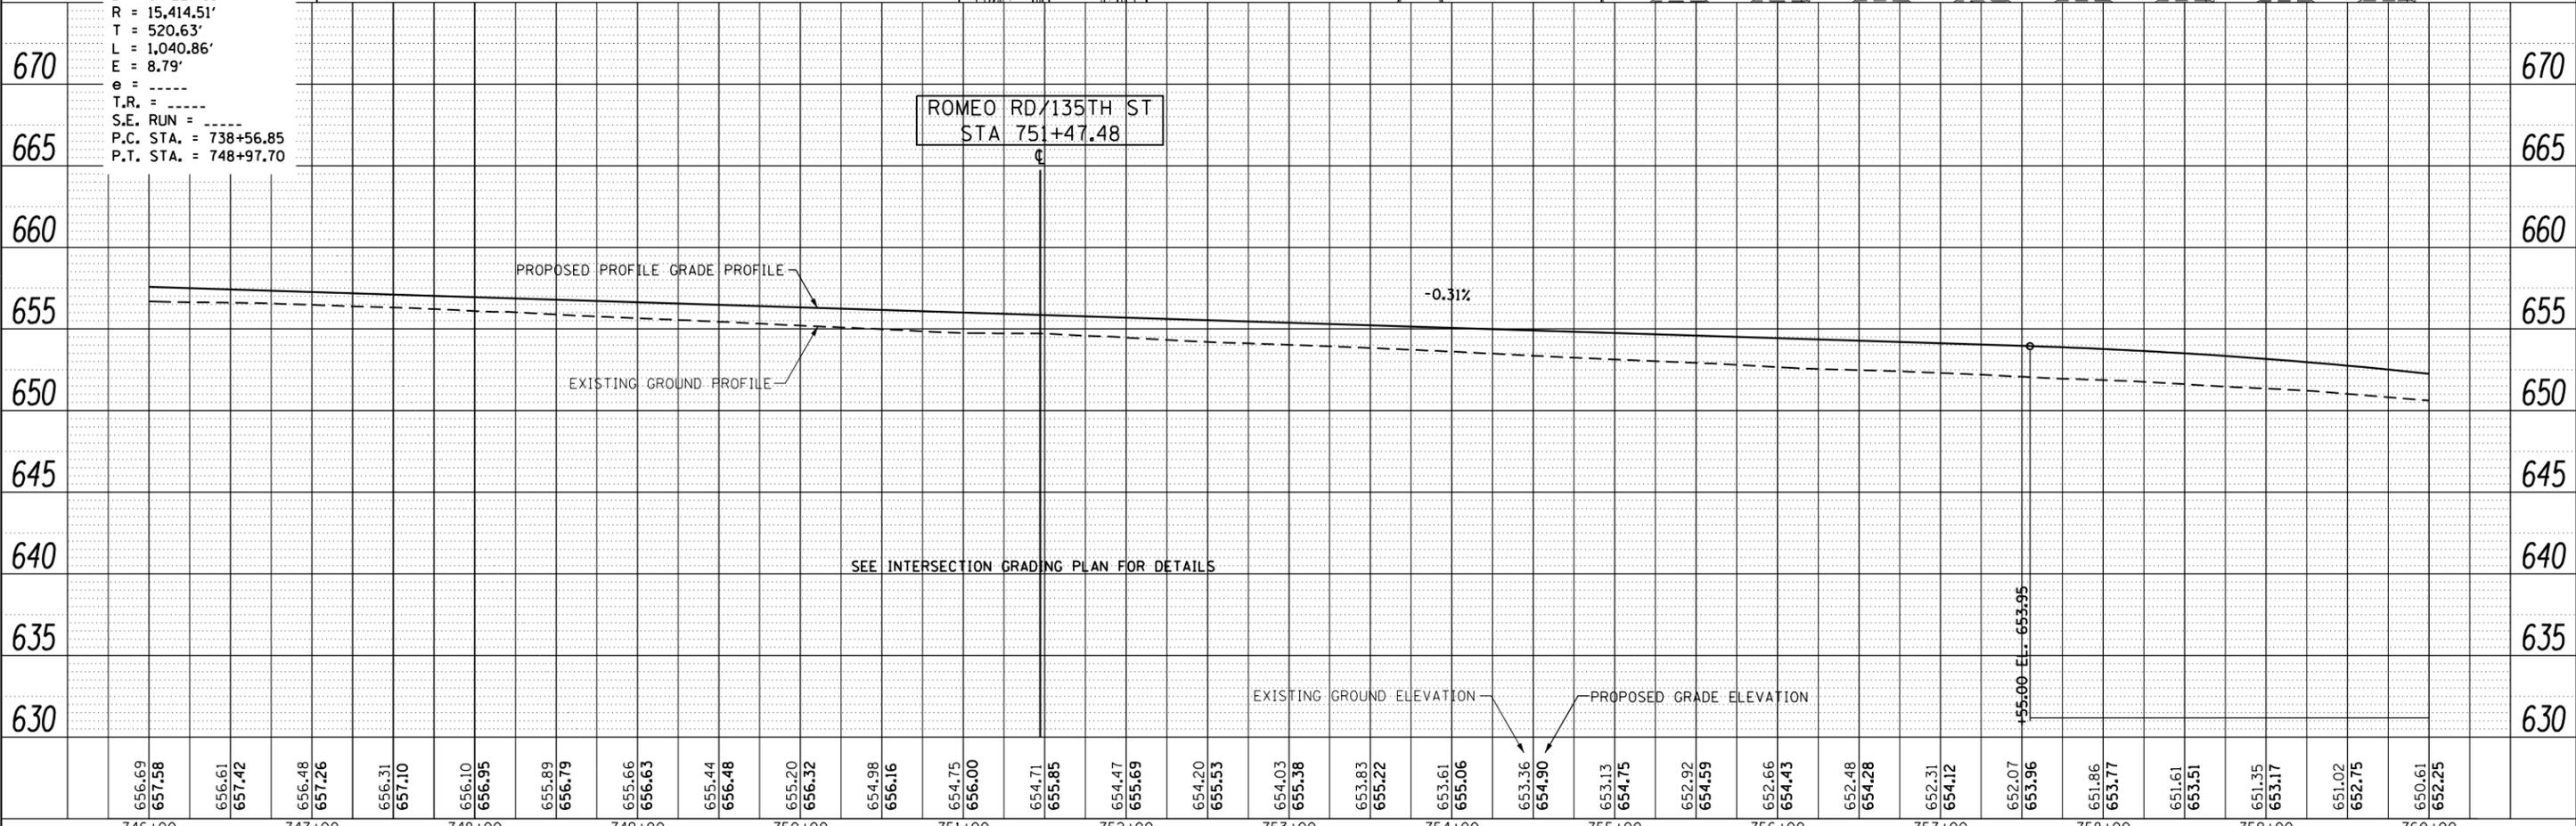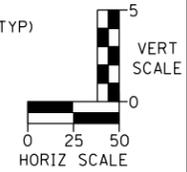

FILE NAME = D:\B\X11-ht-pln-pr-f03.dgn



USER NAME = TEG	DESIGNED - RO	REVISED - 3/3/2015
	DRAWN - JBH	REVISED - 6/19/2015
PLOT SCALE = 100.0000' / 1"	CHECKED - CRC	REVISED - 9/27/2016
PLOT DATE = 11/14/2017	DATE - 11/15/17	REVISED -



STATE OF ILLINOIS
DEPARTMENT OF TRANSPORTATION

PLAN AND PROFILE	
WEBER ROAD	
SCALE: 1"=50'	SHEET 2 OF 7 SHEETS
STA.	TO STA.


F.A.P. RTE.	SECTION	COUNTY	TOTAL SHEETS	SHEET NO.
856	14-00170-42-RP	WILL	394	61
				CONTRACT NO. 61D47
ILLINOIS FED. AID PROJECT				

PLAN	SURVEYED	DATE
	PLOTTED	BY
	GRADES CHECKED	
	STRUCTURE NOTATIONS CHECKED	
NOTE BOOK NO.	FILE NAME	

PROFILE	SURVEYED	DATE
	PLOTTED	BY
	GRADES CHECKED	
	STRUCTURE NOTATIONS CHECKED	
NOTE BOOK NO.	FILE NAME	

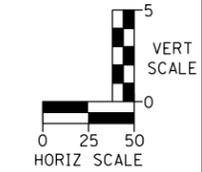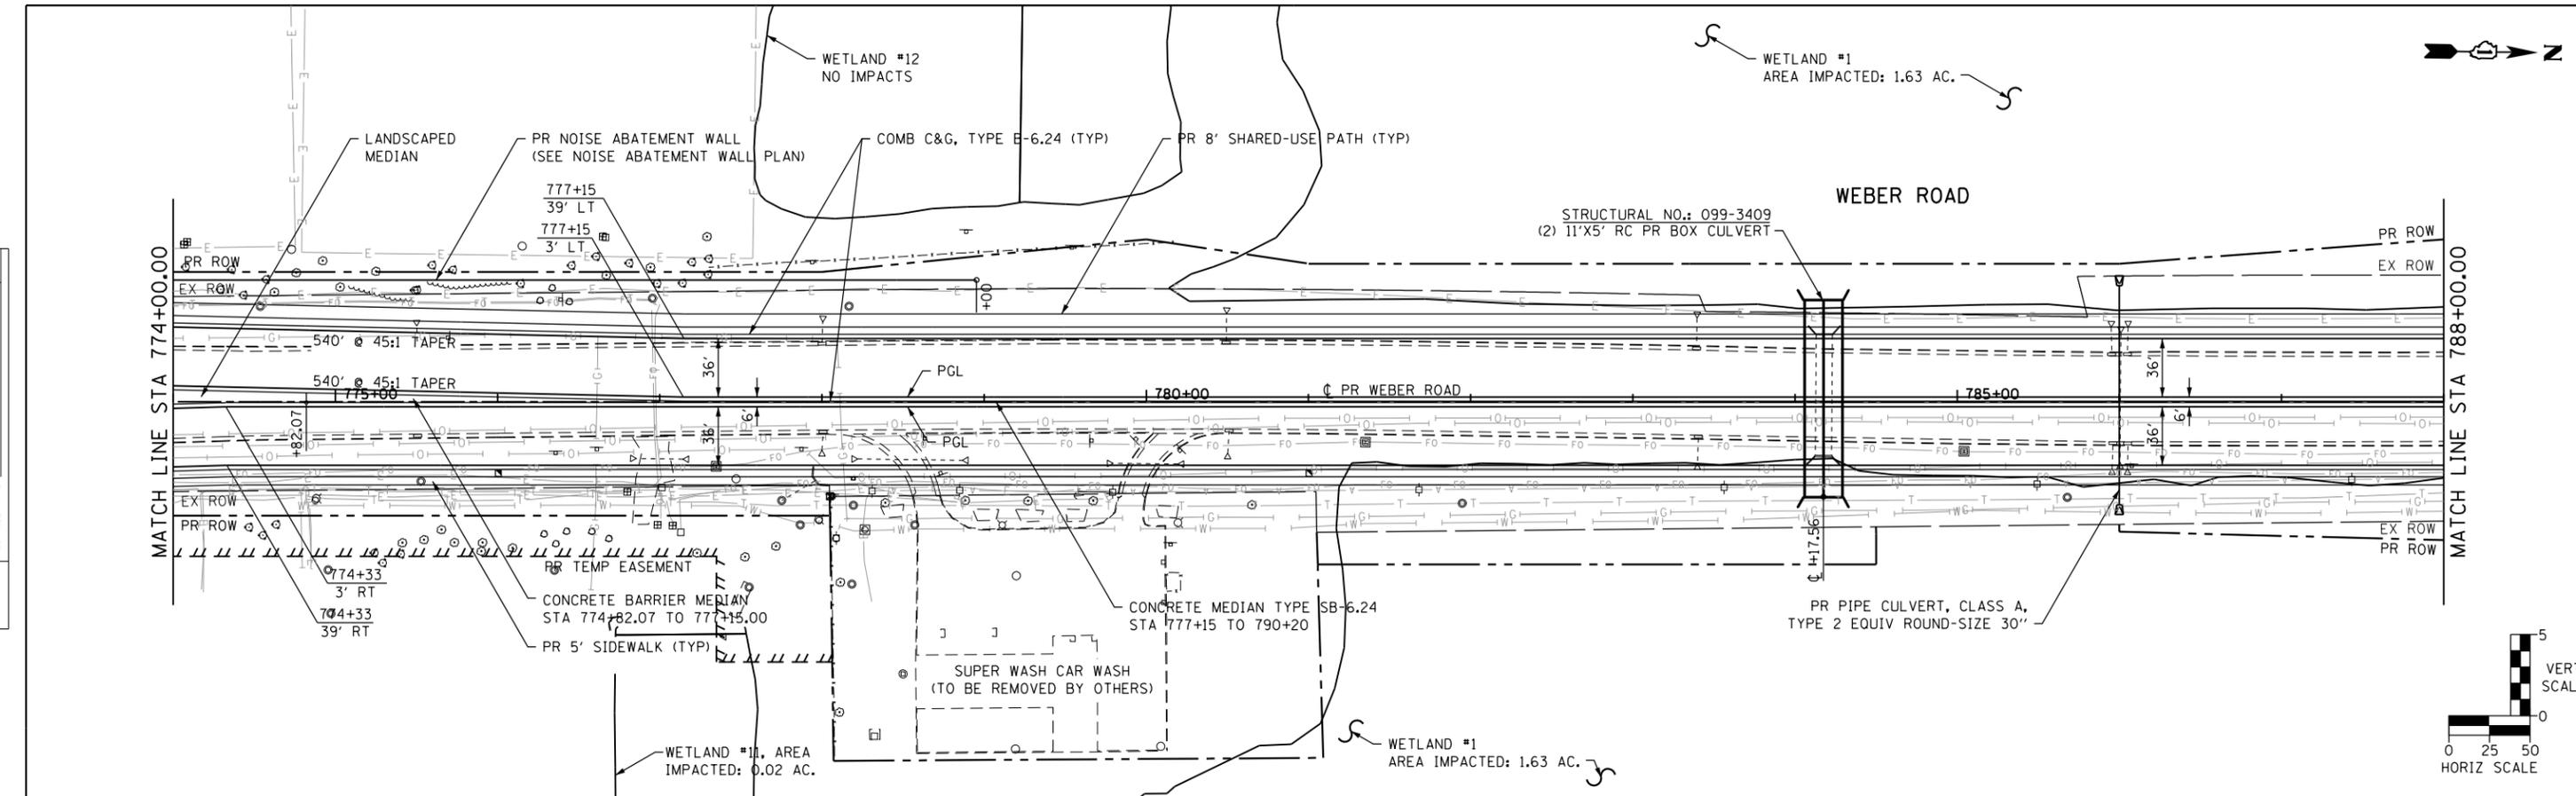

- NOTES**
- FORMER SUPER WASH CAR WASH BUILDING (REMOVED BY OTHERS) TO BECOME FUTURE COMPENSATORY STORAGE SITE.
 - PR ROADWAY AND SHARED-USE PATH PAVEMENT STRUCTURE IDENTIFIED IN TYPICAL SECTIONS.
 - CONTRACTOR TO REFER TO THE CONTRACTOR DESIGNED GROUND IMPROVEMENT DETAIL SHEETS FOR MORE INFORMATION REGARDING THE REQUIRED IMPROVEMENTS FROM STA 780+00 TO 790+20.

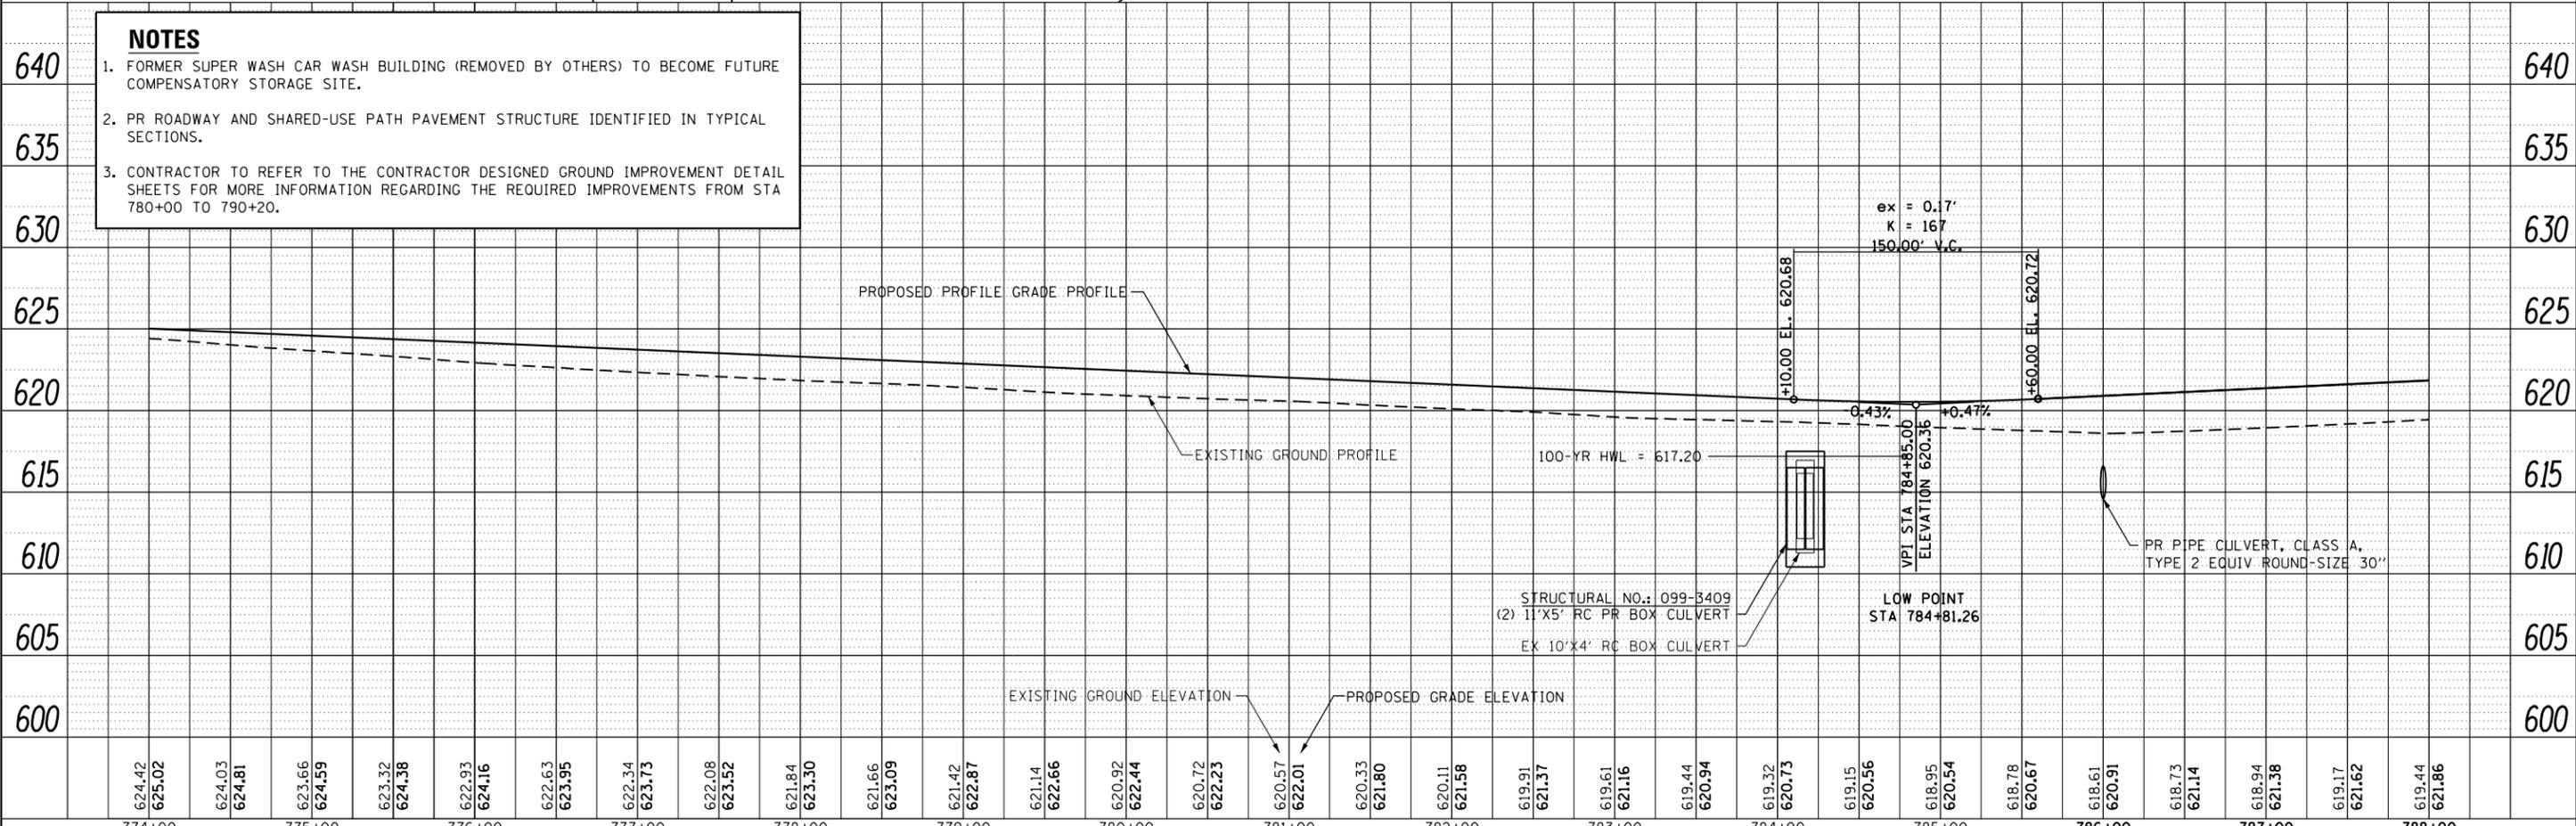


FILE NAME = D:\B\X11-ah-t-pln-pr-f05.dgn

	USER NAME = TEG	DESIGNED - RO	REVISED - 3/3/2015	STATE OF ILLINOIS DEPARTMENT OF TRANSPORTATION	PLAN AND PROFILE WEBER ROAD	F.A.P. RTE. 856	SECTION 14-00170-42-RP	COUNTY WILL	TOTAL SHEETS 394	SHEET NO. 63
	PLOT SCALE = 100.0000' / in.	CHECKED - CRC	REVISED - 6/19/2015			CONTRACT NO. 61D47	ILLINOIS FED. AID PROJECT			
	PLOT DATE = 11/14/2017	DATE - 11/15/17	REVISED - 9/27/2016	SCALE: 1"=50'	SHEET 4 OF 7 SHEETS	STA.	TO STA.			

PLAN	SURVEYED	DATE
	PLOTTED	
	ALIGNED	
	CHECKED	
	STRUCTURE	
	NOTATIONS	
	CHORD	



PROFILE	SURVEYED	DATE
	PLOTTED	
	GRADES	
	CHECKED	
	STRUCTURE	
	NOTATIONS	
	CHORD	

FILE NAME = D:\B\11-ht-pln-prf07.dgn

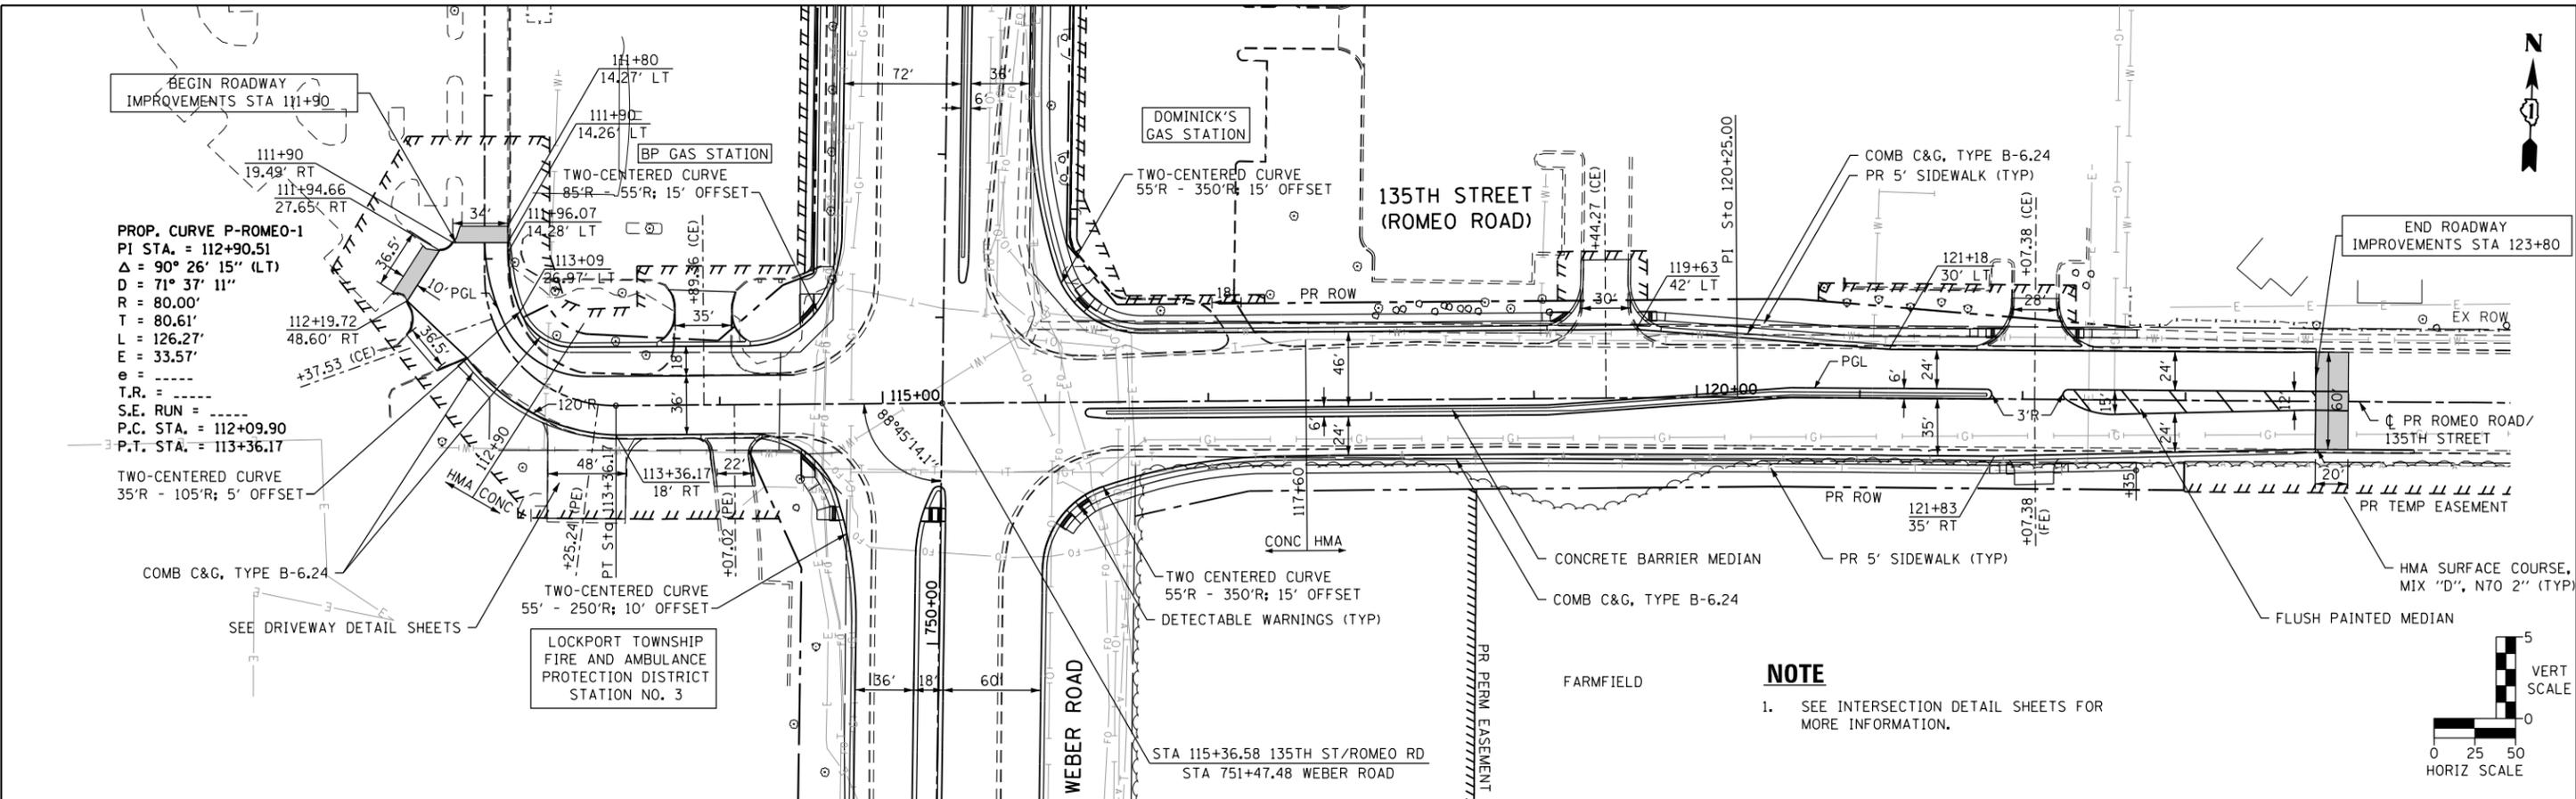

PROP. CURVE P-ROMEO-1
 PI STA. = 112+90.51
 $\Delta = 90^\circ 26' 15''$ (LT)
 $D = 71^\circ 37' 11''$
 $R = 80.00'$
 $T = 80.61'$
 $L = 126.27'$
 $E = 33.57'$
 $e = \dots$
 $T.R. = \dots$
 $S.E. RUN = \dots$
 $P.C. STA. = 112+09.90$
 $P.T. STA. = 113+36.17$

NOTE
 1. SEE INTERSECTION DETAIL SHEETS FOR MORE INFORMATION.

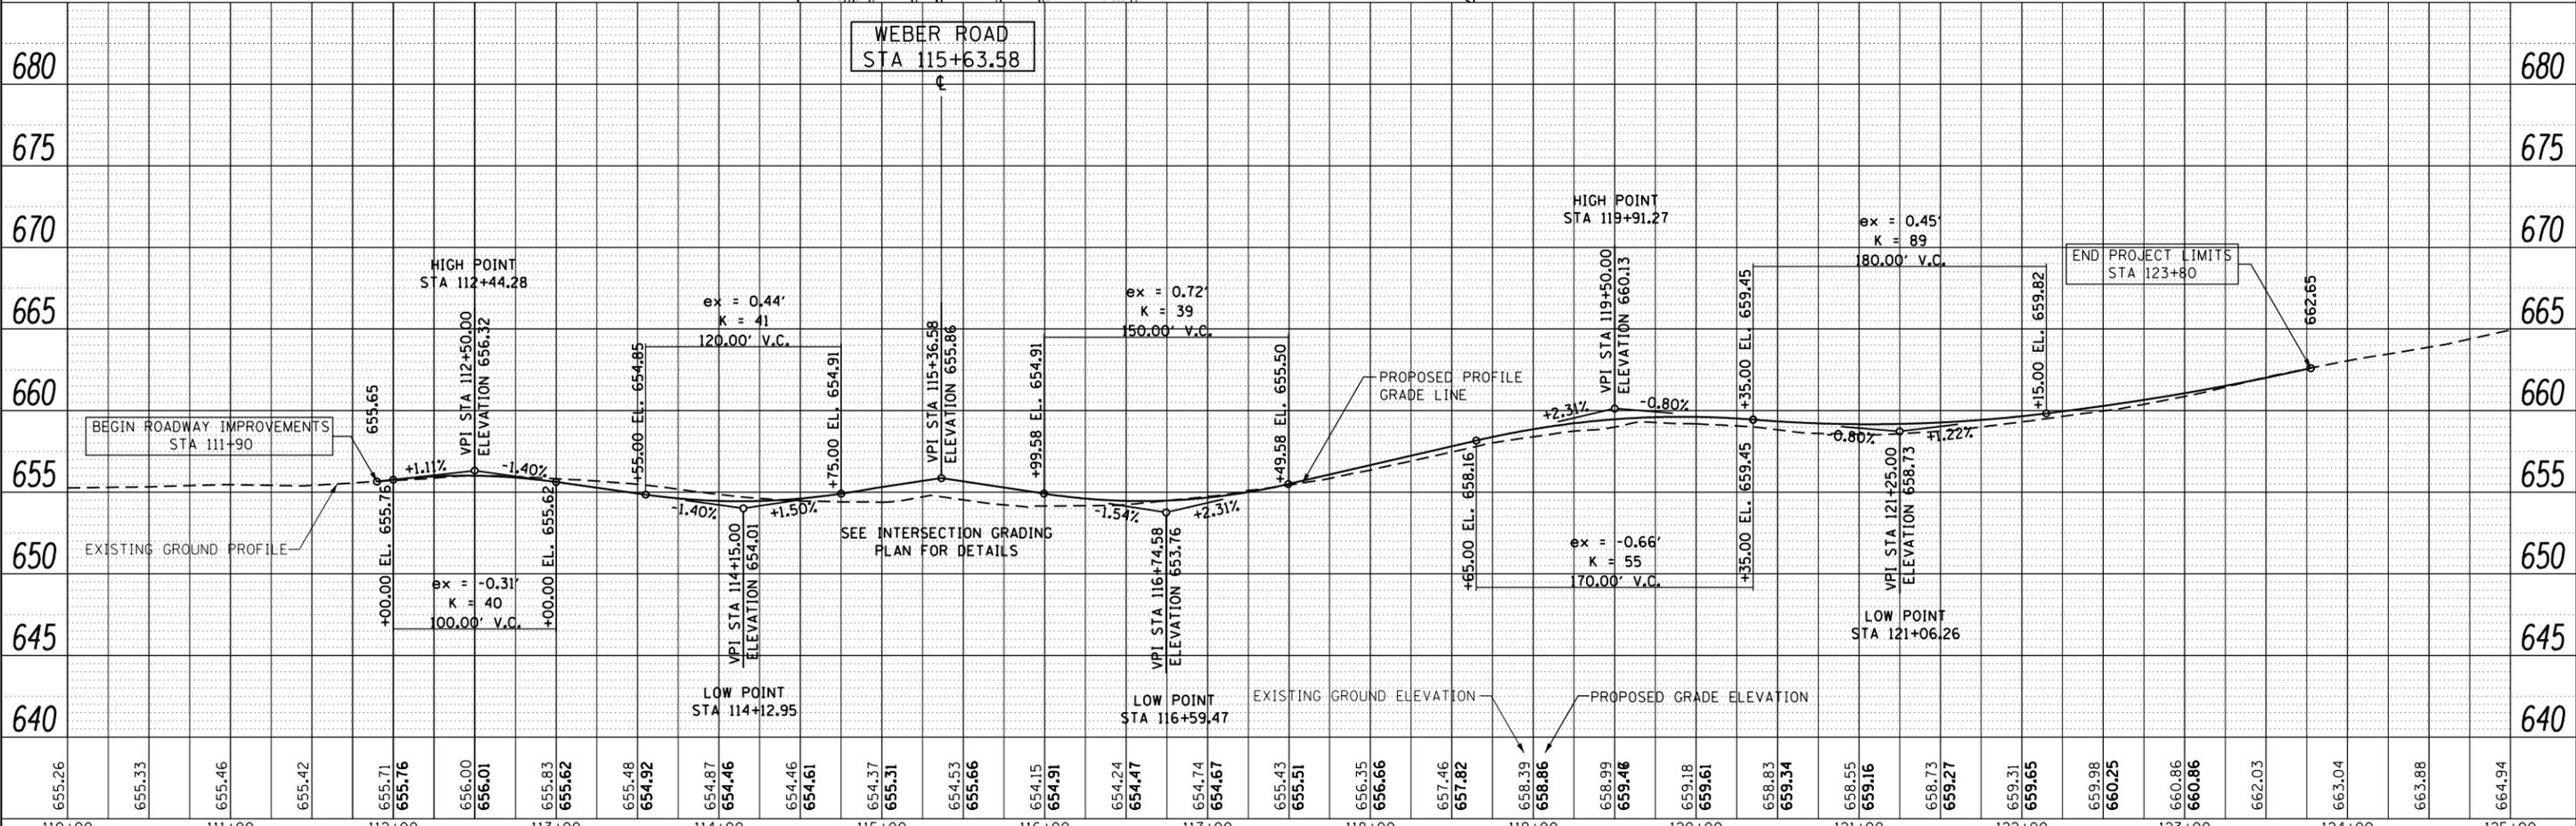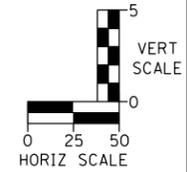

655.26	655.33	655.46	655.42	655.71	655.76	656.00	656.01	655.83	655.62	655.48	654.92	654.87	654.46	654.61	654.37	655.31	654.53	655.66	654.15	654.91	654.24	654.47	654.74	654.67	655.43	655.51	656.35	656.66	657.46	657.82	658.39	658.86	658.99	659.48	659.18	659.61	658.83	659.34	658.55	659.16	658.73	659.27	659.31	659.65	659.98	660.25	660.86	660.86	662.03	663.04	663.88	664.94
110+00	111+00	112+00	113+00	114+00	115+00	116+00	117+00	118+00	119+00	120+00	121+00	122+00	123+00	124+00	125+00																																					

thomas
 engineering group
 service at the highest grade.

USER NAME = TEG	DESIGNED - RO	REVISED - 3/3/2015
	DRAWN - JBH	REVISED - 6/19/2015
PLOT SCALE = 100.0000' / in.	CHECKED - CRC	REVISED - 9/27/2016
PLOT DATE = 11/14/2017	DATE - 11/15/17	REVISED -

STATE OF ILLINOIS
 DEPARTMENT OF TRANSPORTATION


PLAN AND PROFILE
 135TH STREET/ROMEO ROAD
 SCALE: 1"=50' SHEET 6 OF 7 SHEETS STA. TO STA.

F.A.P. RTE. 856	SECTION 14-00170-42-RP	COUNTY WILL	TOTAL SHEETS 394	SHEET NO. 65
CONTRACT NO. 61D47				
ILLINOIS FED. AID PROJECT				

LEGEND

-  PRE-STAGE ZONE GROUND IMPROVEMENT AREA
CONTROLLED STIFFNESS COLUMNS
APPROXIMATELY = 26,100 SQ FT
-  STAGE 1 ZONE GROUND IMPROVEMENT AREA
CONTROLLED STIFFNESS COLUMNS
APPROXIMATELY = 70,600 SQ FT
-  STAGE 2 ZONE GROUND IMPROVEMENT AREA
CONTROLLED STIFFNESS COLUMNS
APPROXIMATELY = 27,000 SQ FT


TOTAL AREA APPROXIMATELY = 123,700 SQ FT

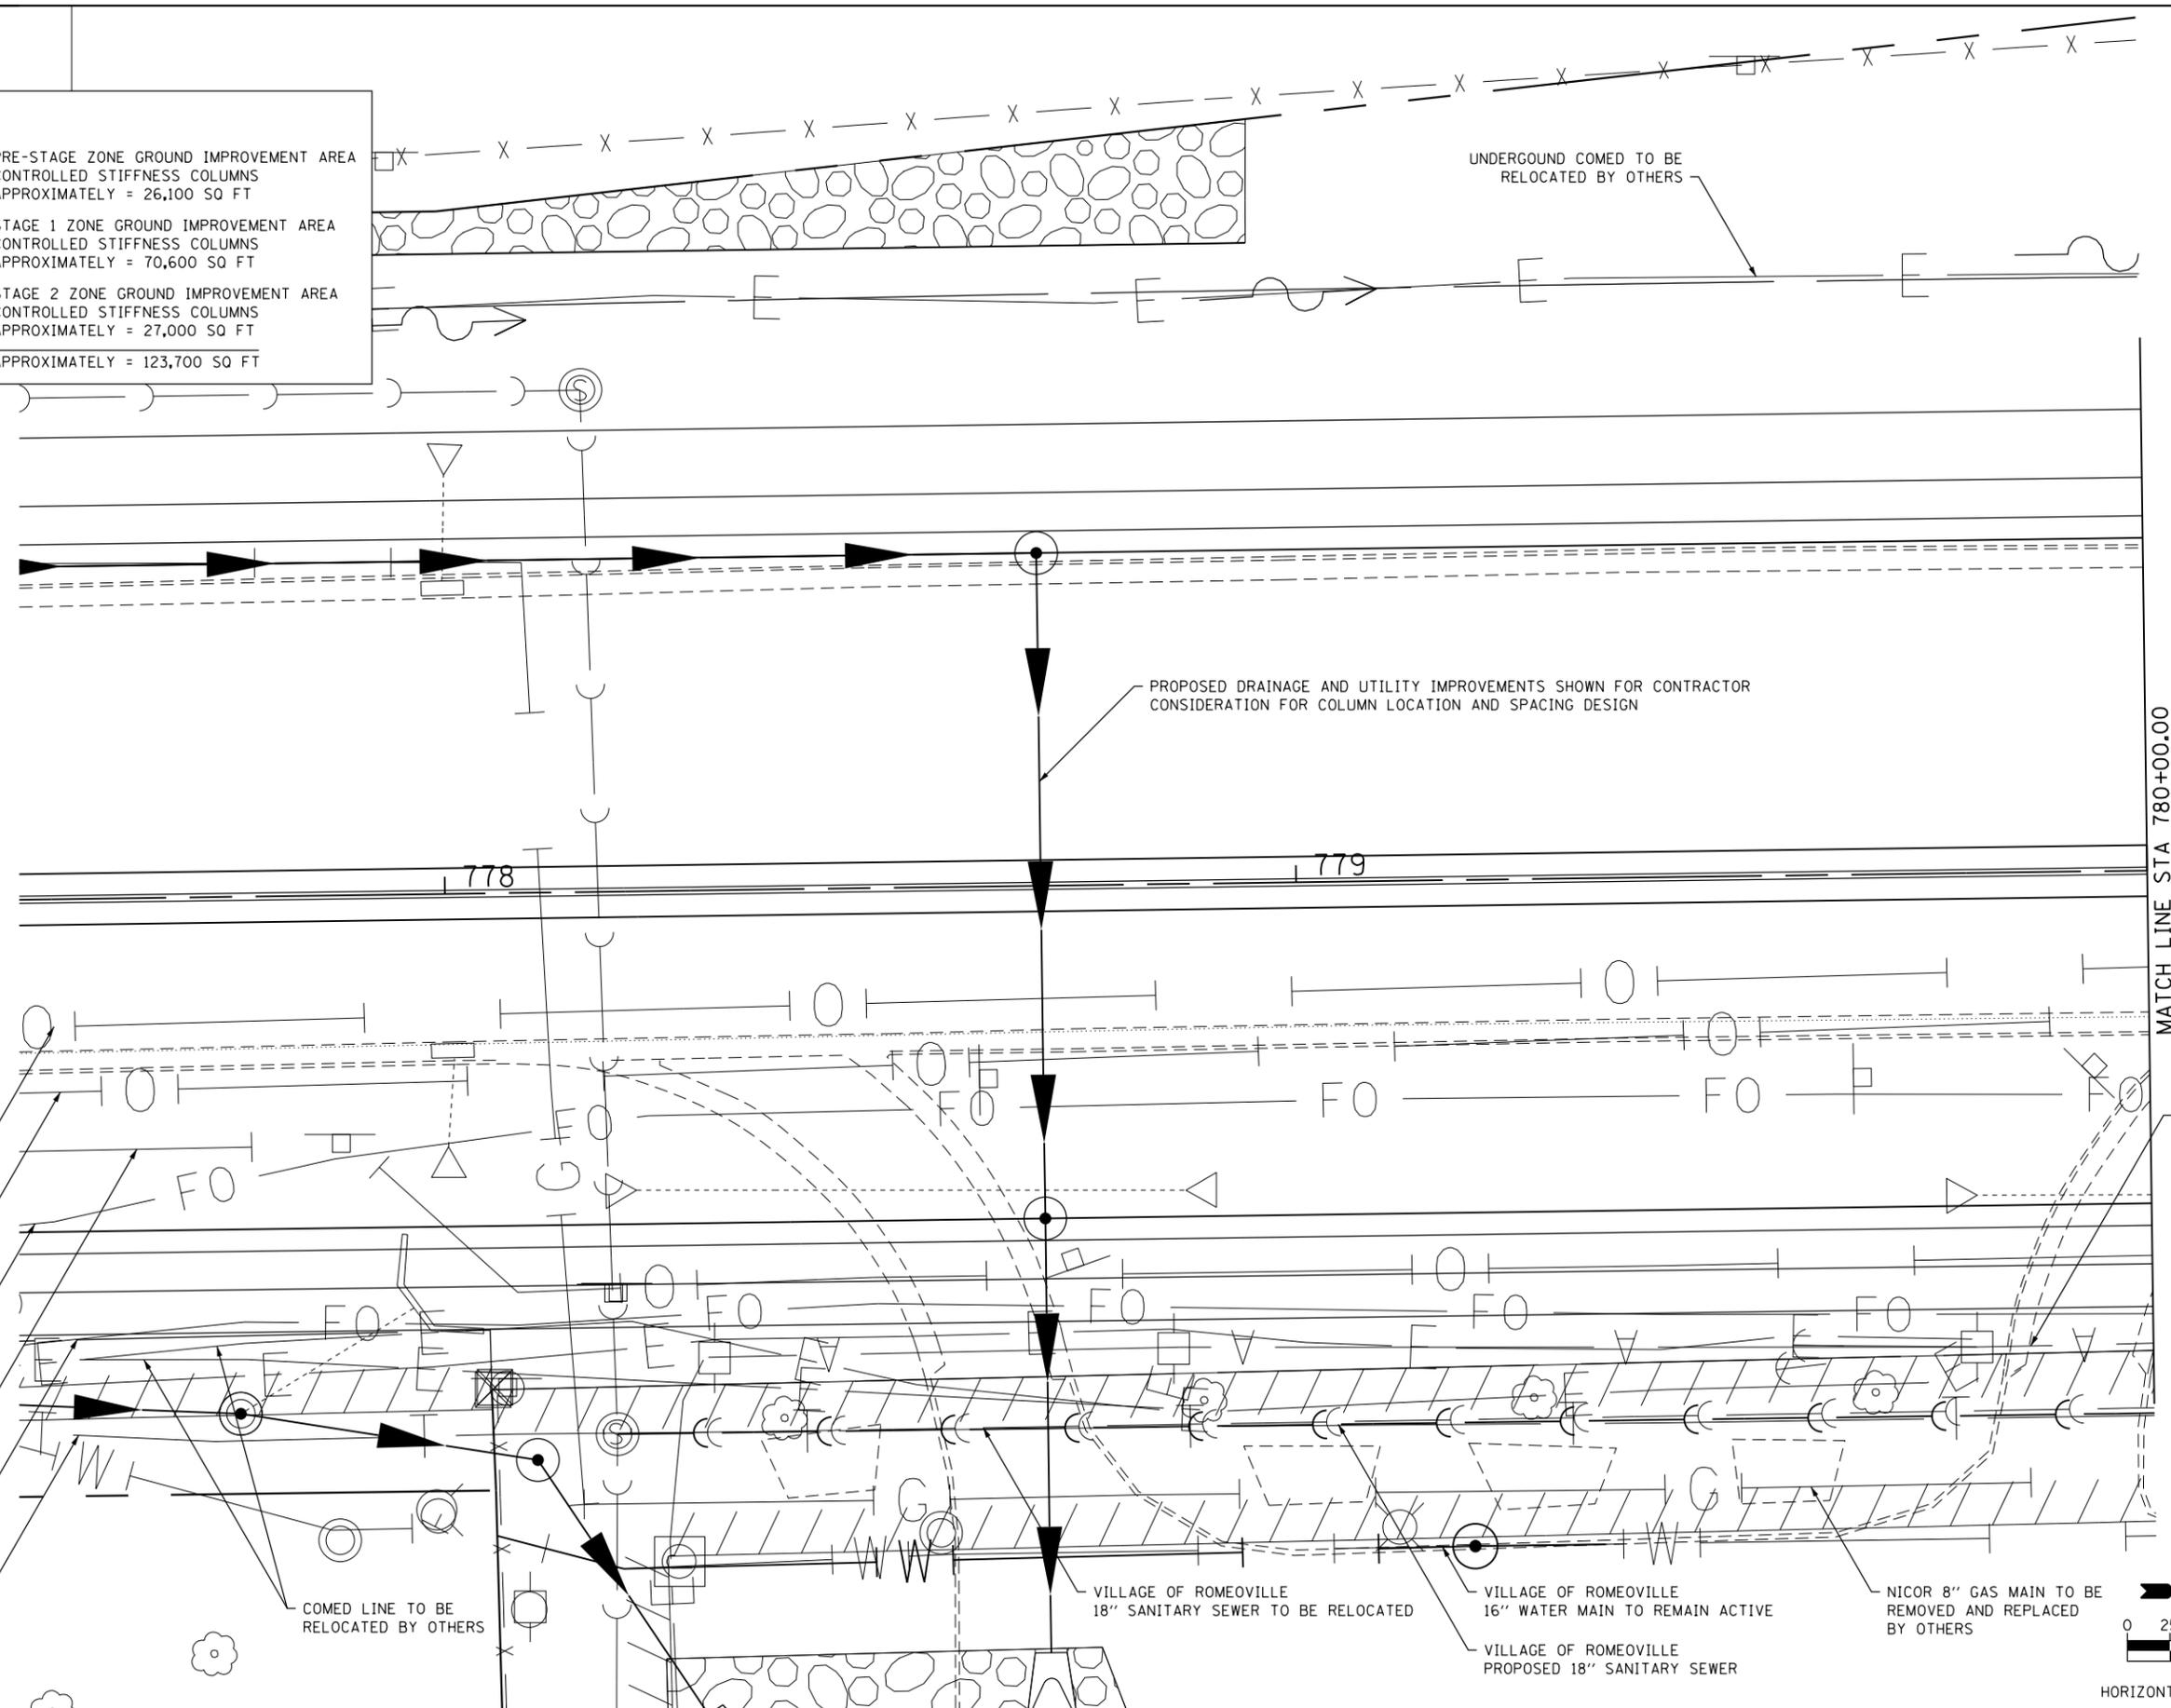

- RETIRED ONEOK OIL LINE TO BE REMOVED BY OTHERS
- RETIRED KINDER MORGAN 24" OIL LINE TO BE REMOVED BY OTHERS
- IDOT FIBER OPTIC LINE TO BE REMOVED
- ONEOK OIL LINE TO BE REMOVED BY OTHERS
- AT&T FIBER OPTIC LINE TO BE RELOCATED BY OTHERS
- AT&T TELEPHONE LINE TO BE RELOCATED BY OTHERS


MATCH LINE STA 780+00.00

COMED AERIAL LINES REMOVED BY OTHERS

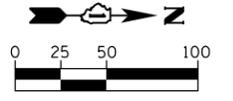

HORIZONTAL SCALE IN FEET

FILE NAME = D:\B\11-ah-t-cd-gpl.dgn

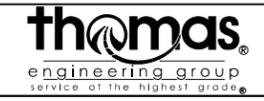


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	DRAWN - JBH	REVISED - 6/19/2015
PLOT SCALE = 20.0000' / in.	CHECKED - CRC	REVISED - 9/27/2016
PLOT DATE = 11/14/2017	DATE - 11/15/17	REVISED -

**STATE OF ILLINOIS
DEPARTMENT OF TRANSPORTATION**

**CONTRACTOR DESIGNED GROUND IMPROVEMENT PLAN
WEBER ROAD**

SCALE: SHEET OF SHEETS STA. TO STA.

F.A.P. RTE.	SECTION	COUNTY	TOTAL SHEETS	SHEET NO.
856	14-00170-42-RP	WILL	394	67
CONTRACT NO. 61D47				
ILLINOIS FED. AID PROJECT				

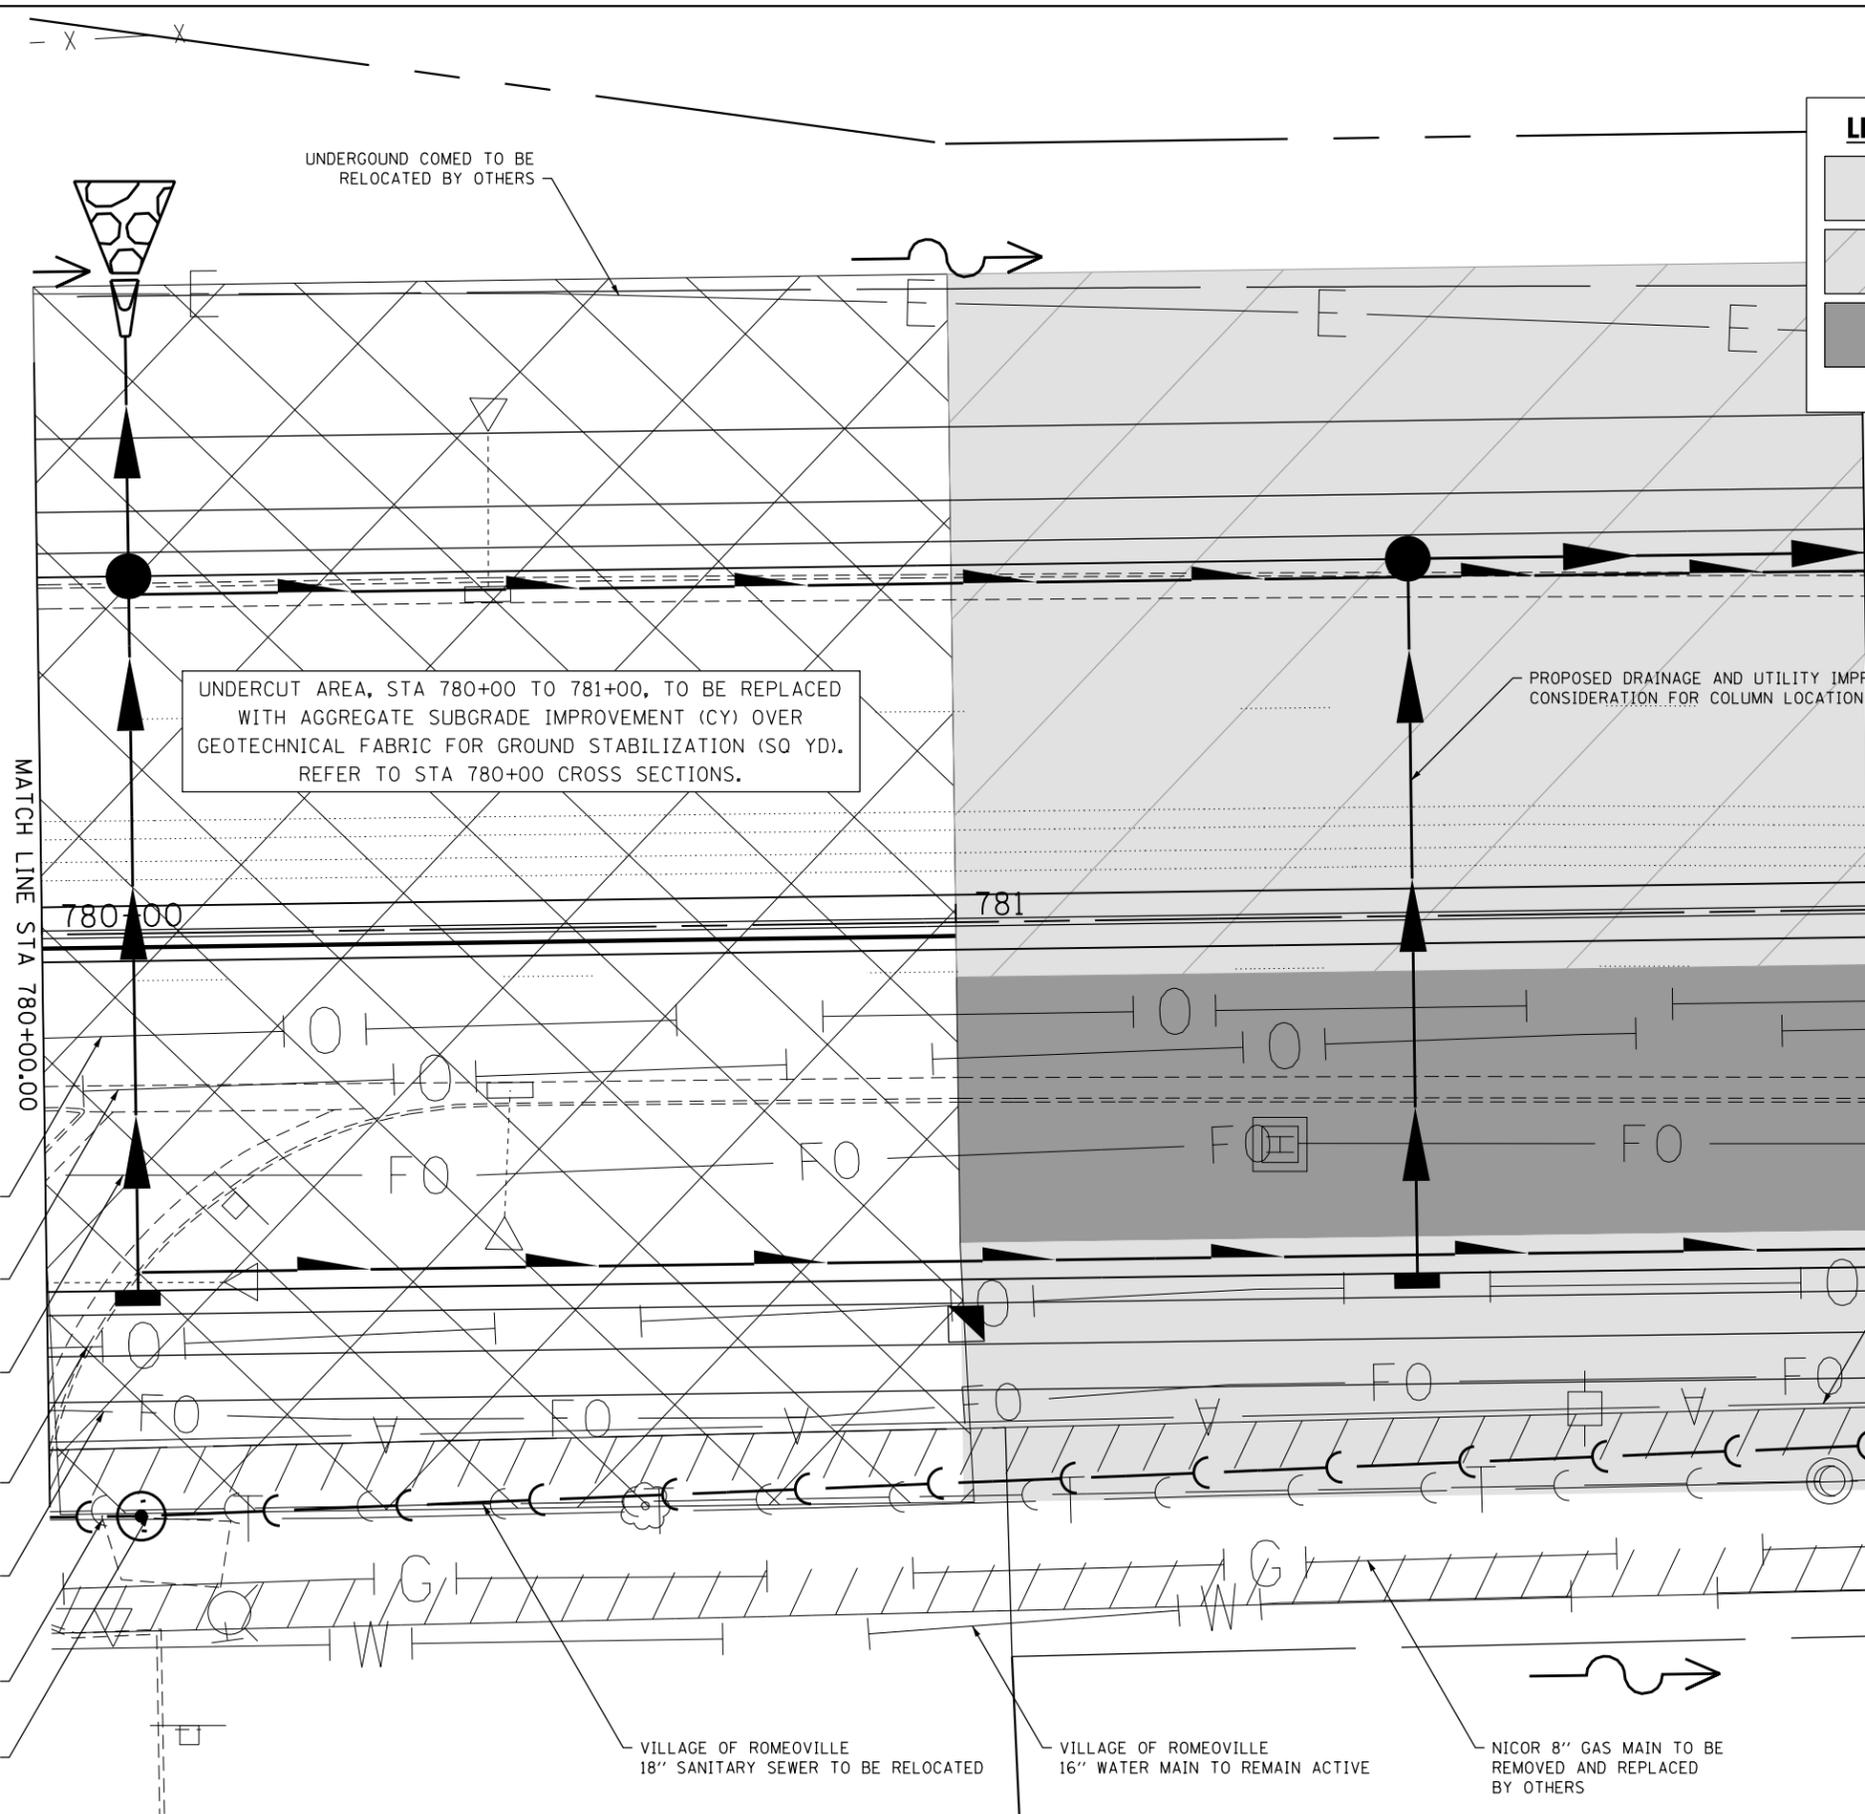

LEGEND

- PRE-STAGE ZONE GROUND IMPROVEMENT AREA CONTROLLED STIFFNESS COLUMNS APPROXIMATELY = 26,100 SQ FT
- STAGE 1 ZONE GROUND IMPROVEMENT AREA CONTROLLED STIFFNESS COLUMNS APPROXIMATELY = 70,600 SQ FT
- STAGE 2 ZONE GROUND IMPROVEMENT AREA CONTROLLED STIFFNESS COLUMNS APPROXIMATELY = 27,000 SQ FT

TOTAL AREA APPROXIMATELY = 123,700 SQ FT

- RETIRED ONEOK OIL LINE TO BE REMOVED BY OTHERS
- RETIRED KINDER MORGAN 24" OIL LINE TO BE REMOVED BY OTHERS
- IDOT FIBER OPTIC LINE TO BE REMOVED
- ONEOK OIL LINE TO BE REMOVED BY OTHERS
- AT&T FIBER OPTIC LINE TO BE RELOCATED BY OTHERS
- AT&T TELEPHONE LINE TO BE RELOCATED BY OTHERS
- VILLAGE OF ROMEOVILLE PROPOSED 18" SANITARY SEWER

UNDERCUT AREA, STA 780+00 TO 781+00, TO BE REPLACED WITH AGGREGATE SUBGRADE IMPROVEMENT (CY) OVER GEOTECHNICAL FABRIC FOR GROUND STABILIZATION (SQ YD). REFER TO STA 780+00 CROSS SECTIONS.

PROPOSED DRAINAGE AND UTILITY IMPROVEMENTS SHOWN FOR CONTRACTOR CONSIDERATION FOR COLUMN LOCATION AND SPACING DESIGN

VILLAGE OF ROMEOVILLE 18" SANITARY SEWER TO BE RELOCATED

VILLAGE OF ROMEOVILLE 16" WATER MAIN TO REMAIN ACTIVE

NICOR 8" GAS MAIN TO BE REMOVED AND REPLACED BY OTHERS

COMED AERIAL LINES REMOVED BY OTHERS



HORIZONTAL SCALE IN FEET

FILE NAME = D:\B\11-ent-cd\p2.dgn



USER NAME = TEG	DESIGNED - RO	REVISED - 3/3/2015
	DRAWN - JBH	REVISED - 6/19/2015
PLOT SCALE = 20.0000' / in.	CHECKED - CRC	REVISED - 9/27/2016
PLOT DATE = 11/14/2017	DATE - 11/15/17	REVISED -

**STATE OF ILLINOIS
DEPARTMENT OF TRANSPORTATION**

**CONTRACTOR DESIGNED GROUND IMPROVEMENT PLAN
WEBER ROAD**

SCALE: SHEET OF SHEETS STA. TO STA.

F.A.P. RTE.	SECTION	COUNTY	TOTAL SHEETS	SHEET NO.
856	14-00170-42-RP	WILL	394	68
CONTRACT NO. 61D47				
ILLINOIS FED. AID PROJECT				

UNDERGROUND COMED TO BE RELOCATED BY OTHERS

LEGEND

	PRE-STAGE ZONE GROUND IMPROVEMENT AREA CONTROLLED STIFFNESS COLUMNS APPROXIMATELY = 26,100 SQ FT
	STAGE 1 ZONE GROUND IMPROVEMENT AREA CONTROLLED STIFFNESS COLUMNS APPROXIMATELY = 70,600 SQ FT
	STAGE 2 ZONE GROUND IMPROVEMENT AREA CONTROLLED STIFFNESS COLUMNS APPROXIMATELY = 27,000 SQ FT
TOTAL AREA APPROXIMATELY = 123,700 SQ FT	

MATCH LINE
STA 782+00.00

MATCH LINE
STA 784+00.00

PROPOSED DRAINAGE AND UTILITY IMPROVEMENTS SHOWN FOR CONTRACTOR CONSIDERATION FOR COLUMN LOCATION AND SPACING DESIGN


- RETIRE ONEOK OIL LINE TO BE REMOVED BY OTHERS
- RETIRE KINDER MORGAN 24" OIL LINE TO BE REMOVED BY OTHERS
- IDOT FIBER OPTIC LINE TO BE REMOVED
- ONEOK OIL LINE TO BE REMOVED BY OTHERS
- AT&T FIBER OPTIC LINE TO BE RELOCATED BY OTHERS
- AT&T TELEPHONE LINE TO BE RELOCATED BY OTHERS
- VILLAGE OF ROMEOVILLE PROPOSED 18" SANITARY SEWER

COMED AERIAL LINES REMOVED BY OTHERS

VILLAGE OF ROMEOVILLE 18" SANITARY SEWER TO BE RELOCATED


VILLAGE OF ROMEOVILLE 16" WATER MAIN TO REMAIN ACTIVE

NICOR 8" GAS MAIN TO BE REMOVED AND REPLACED BY OTHERS

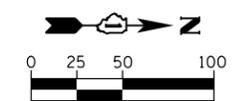

HORIZONTAL SCALE IN FEET

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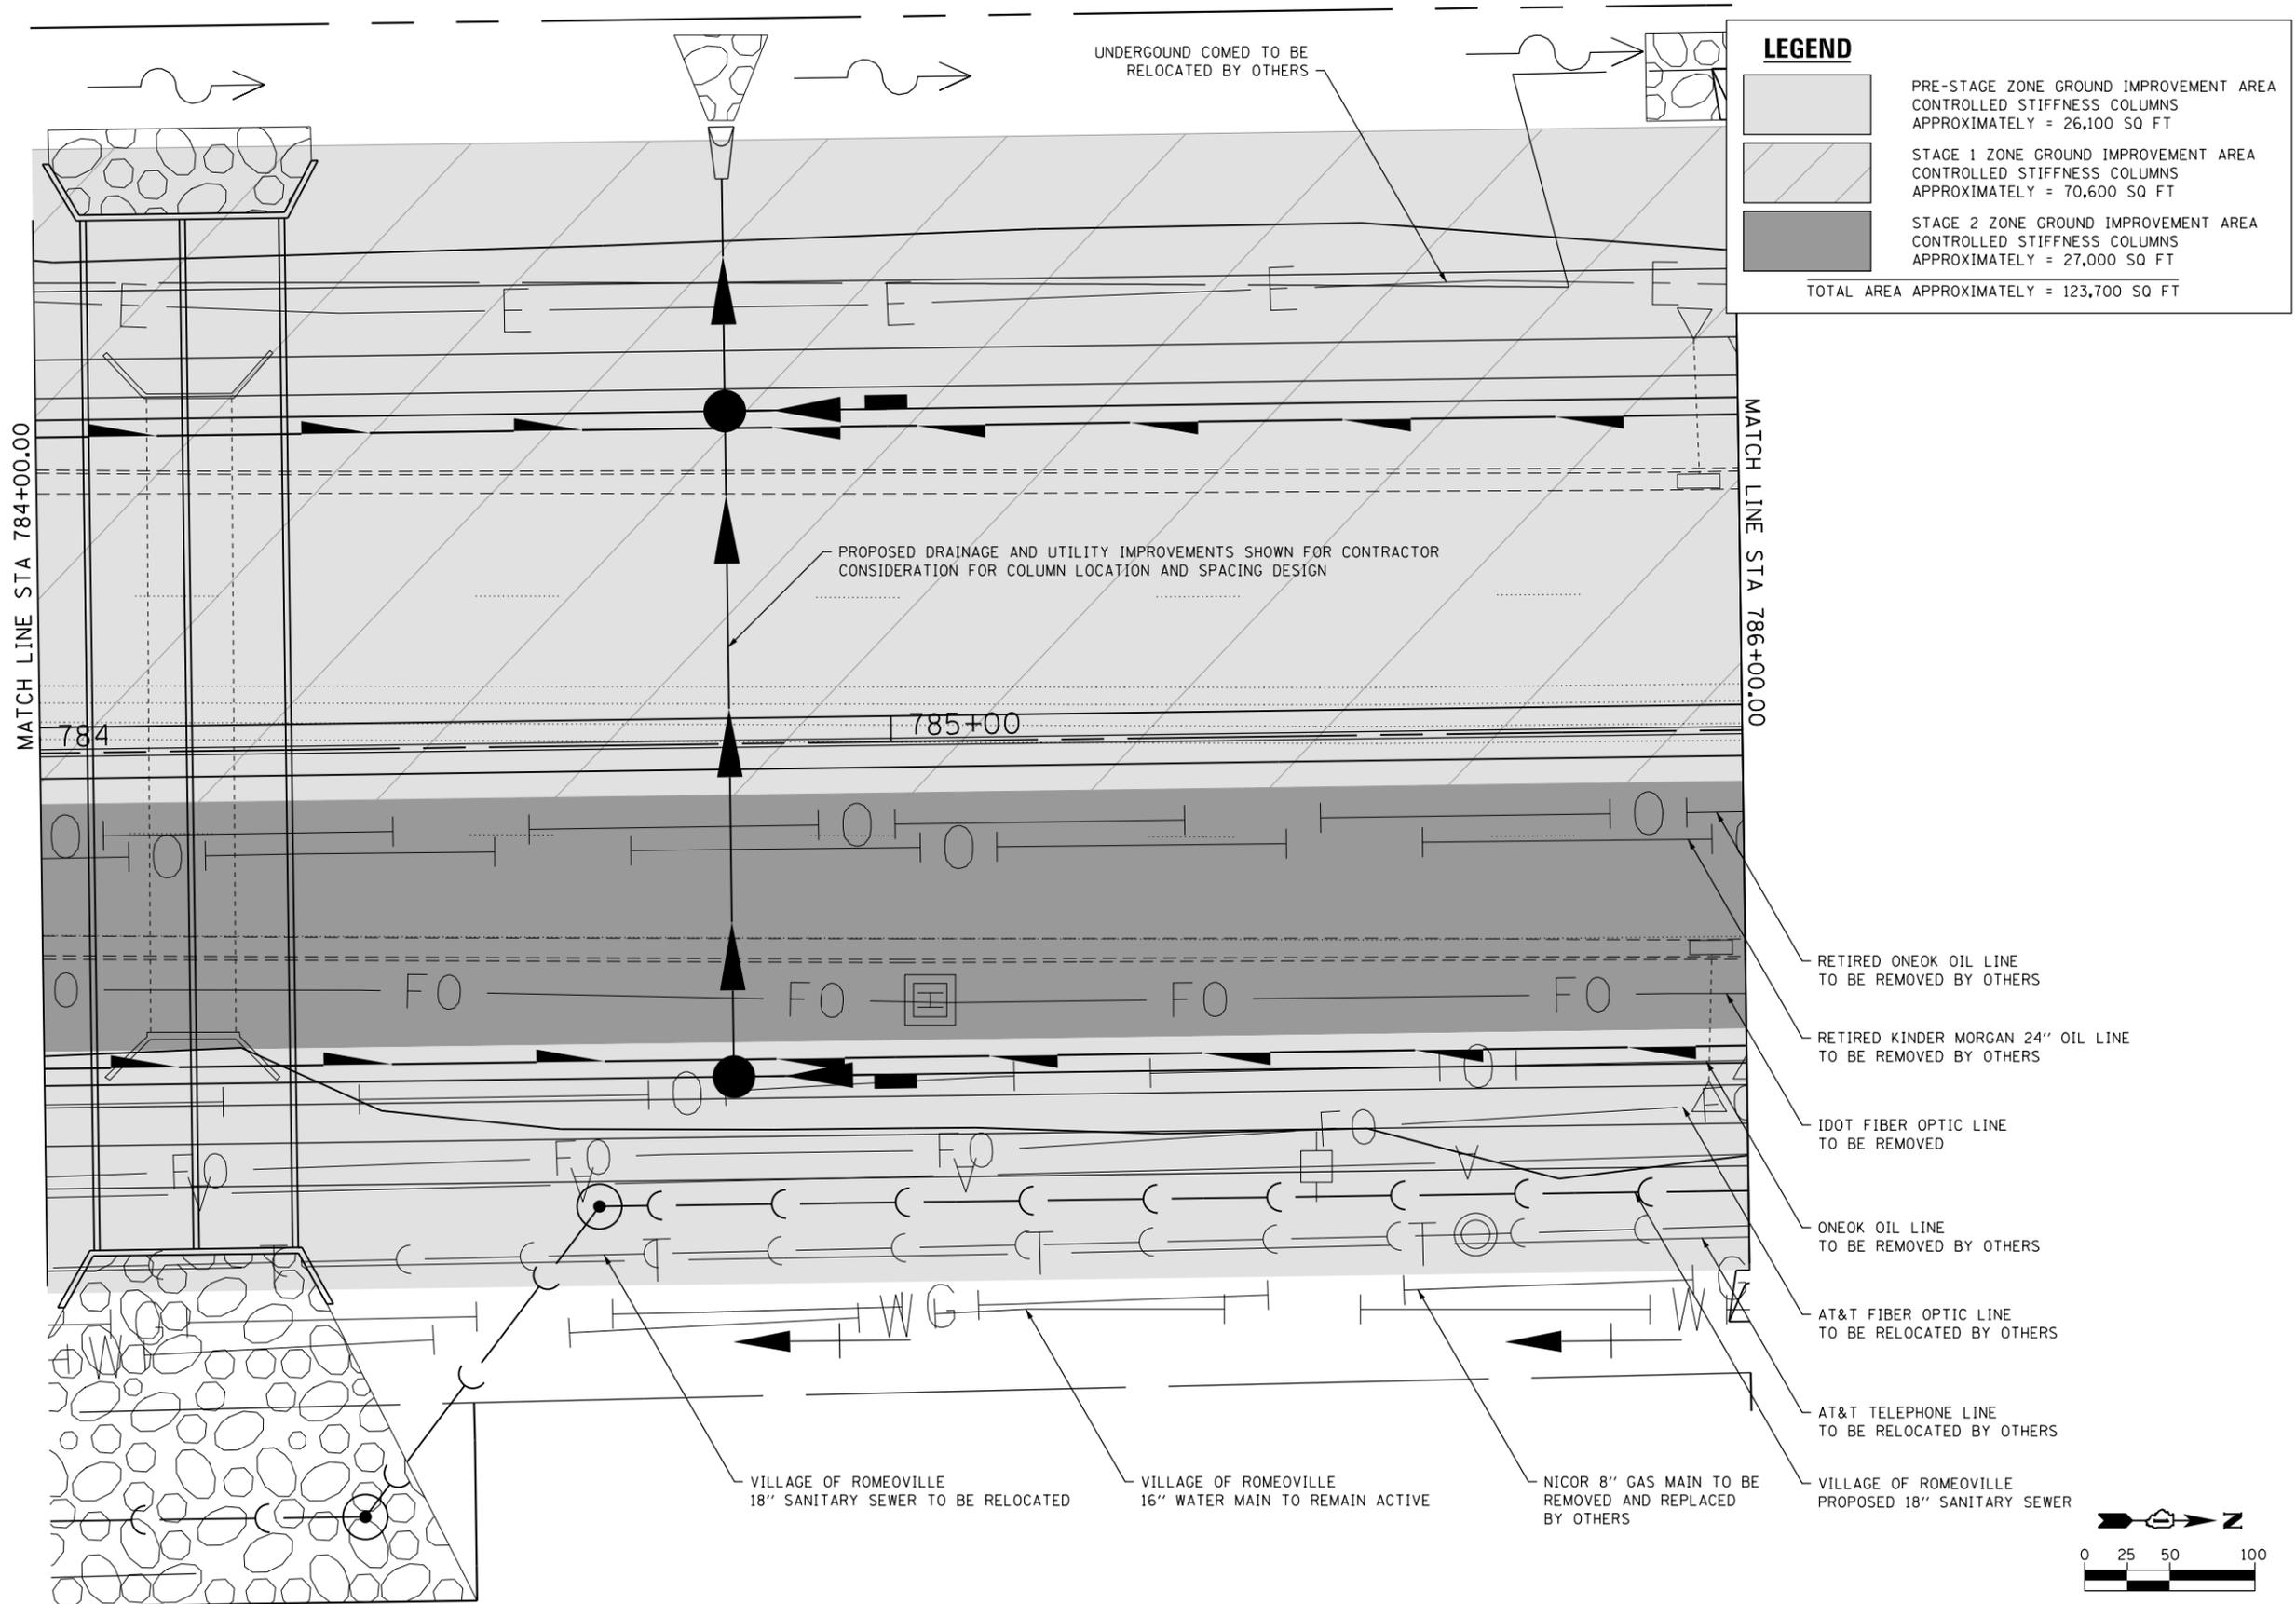
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	DRAWN - JBH	REVISED - 6/19/2015
PLOT SCALE = 20.0000' / in.	CHECKED - CRC	REVISED - 9/27/2016
PLOT DATE = 11/14/2017	DATE - 11/15/17	REVISED -

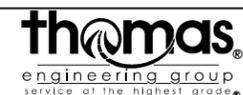STATE OF ILLINOIS
DEPARTMENT OF TRANSPORTATION

CONTRACTOR DESIGNED GROUND IMPROVEMENT PLAN
WEBER ROAD

SCALE: SHEET OF SHEETS STA. TO STA.

F.A.P. RTE.	SECTION	COUNTY	TOTAL SHEETS	SHEET NO.
856	14-00170-42-RP	WILL	394	69
CONTRACT NO. 61D47				
ILLINOIS FED. AID PROJECT				



LEGEND

[Light Gray Box]	PRE-STAGE ZONE GROUND IMPROVEMENT AREA CONTROLLED STIFFNESS COLUMNS APPROXIMATELY = 26,100 SQ FT
[Diagonal Line Box]	STAGE 1 ZONE GROUND IMPROVEMENT AREA CONTROLLED STIFFNESS COLUMNS APPROXIMATELY = 70,600 SQ FT
[Dark Gray Box]	STAGE 2 ZONE GROUND IMPROVEMENT AREA CONTROLLED STIFFNESS COLUMNS APPROXIMATELY = 27,000 SQ FT
TOTAL AREA APPROXIMATELY = 123,700 SQ FT	


- RETired ONEOK OIL LINE TO BE REMOVED BY OTHERS
- RETired KINDER MORGAN 24" OIL LINE TO BE REMOVED BY OTHERS
- IDOT FIBER OPTIC LINE TO BE REMOVED
- ONEOK OIL LINE TO BE REMOVED BY OTHERS
- AT&T FIBER OPTIC LINE TO BE RELOCATED BY OTHERS
- AT&T TELEPHONE LINE TO BE RELOCATED BY OTHERS
- VILLAGE OF ROMEOVILLE PROPOSED 18" SANITARY SEWER

- VILLAGE OF ROMEOVILLE 18" SANITARY SEWER TO BE RELOCATED
- VILLAGE OF ROMEOVILLE 16" WATER MAIN TO REMAIN ACTIVE
- NICOR 8" GAS MAIN TO BE REMOVED AND REPLACED BY OTHERS

PROPOSED DRAINAGE AND UTILITY IMPROVEMENTS SHOWN FOR CONTRACTOR CONSIDERATION FOR COLUMN LOCATION AND SPACING DESIGN

UNDERGROUND COMED TO BE RELOCATED BY OTHERS

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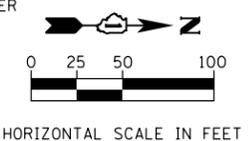
USER NAME = TEG	DESIGNED - RO	REVISED - 3/3/2015
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PLOT SCALE = 20.0000' / in.	CHECKED - CRC	REVISED - 9/27/2016
PLOT DATE = 11/14/2017	DATE - 11/15/17	REVISED -

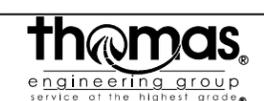STATE OF ILLINOIS
DEPARTMENT OF TRANSPORTATION

CONTRACTOR DESIGNED GROUND IMPROVEMENT PLAN
WEBER ROAD

SCALE: SHEET OF SHEETS STA. TO STA.

F.A.P. RTE.	SECTION	COUNTY	TOTAL SHEETS	SHEET NO.
856	14-00170-42-RP	WILL	394	70
CONTRACT NO. 61D47				
ILLINOIS FED. AID PROJECT				




LEGEND

- PRE-STAGE ZONE GROUND IMPROVEMENT AREA CONTROLLED STIFFNESS COLUMNS APPROXIMATELY = 26,100 SQ FT
- STAGE 1 ZONE GROUND IMPROVEMENT AREA CONTROLLED STIFFNESS COLUMNS APPROXIMATELY = 70,600 SQ FT
- STAGE 2 ZONE GROUND IMPROVEMENT AREA CONTROLLED STIFFNESS COLUMNS APPROXIMATELY = 27,000 SQ FT

TOTAL AREA APPROXIMATELY = 123,700 SQ FT

UNDERGROUND COMED TO BE RELOCATED BY OTHERS

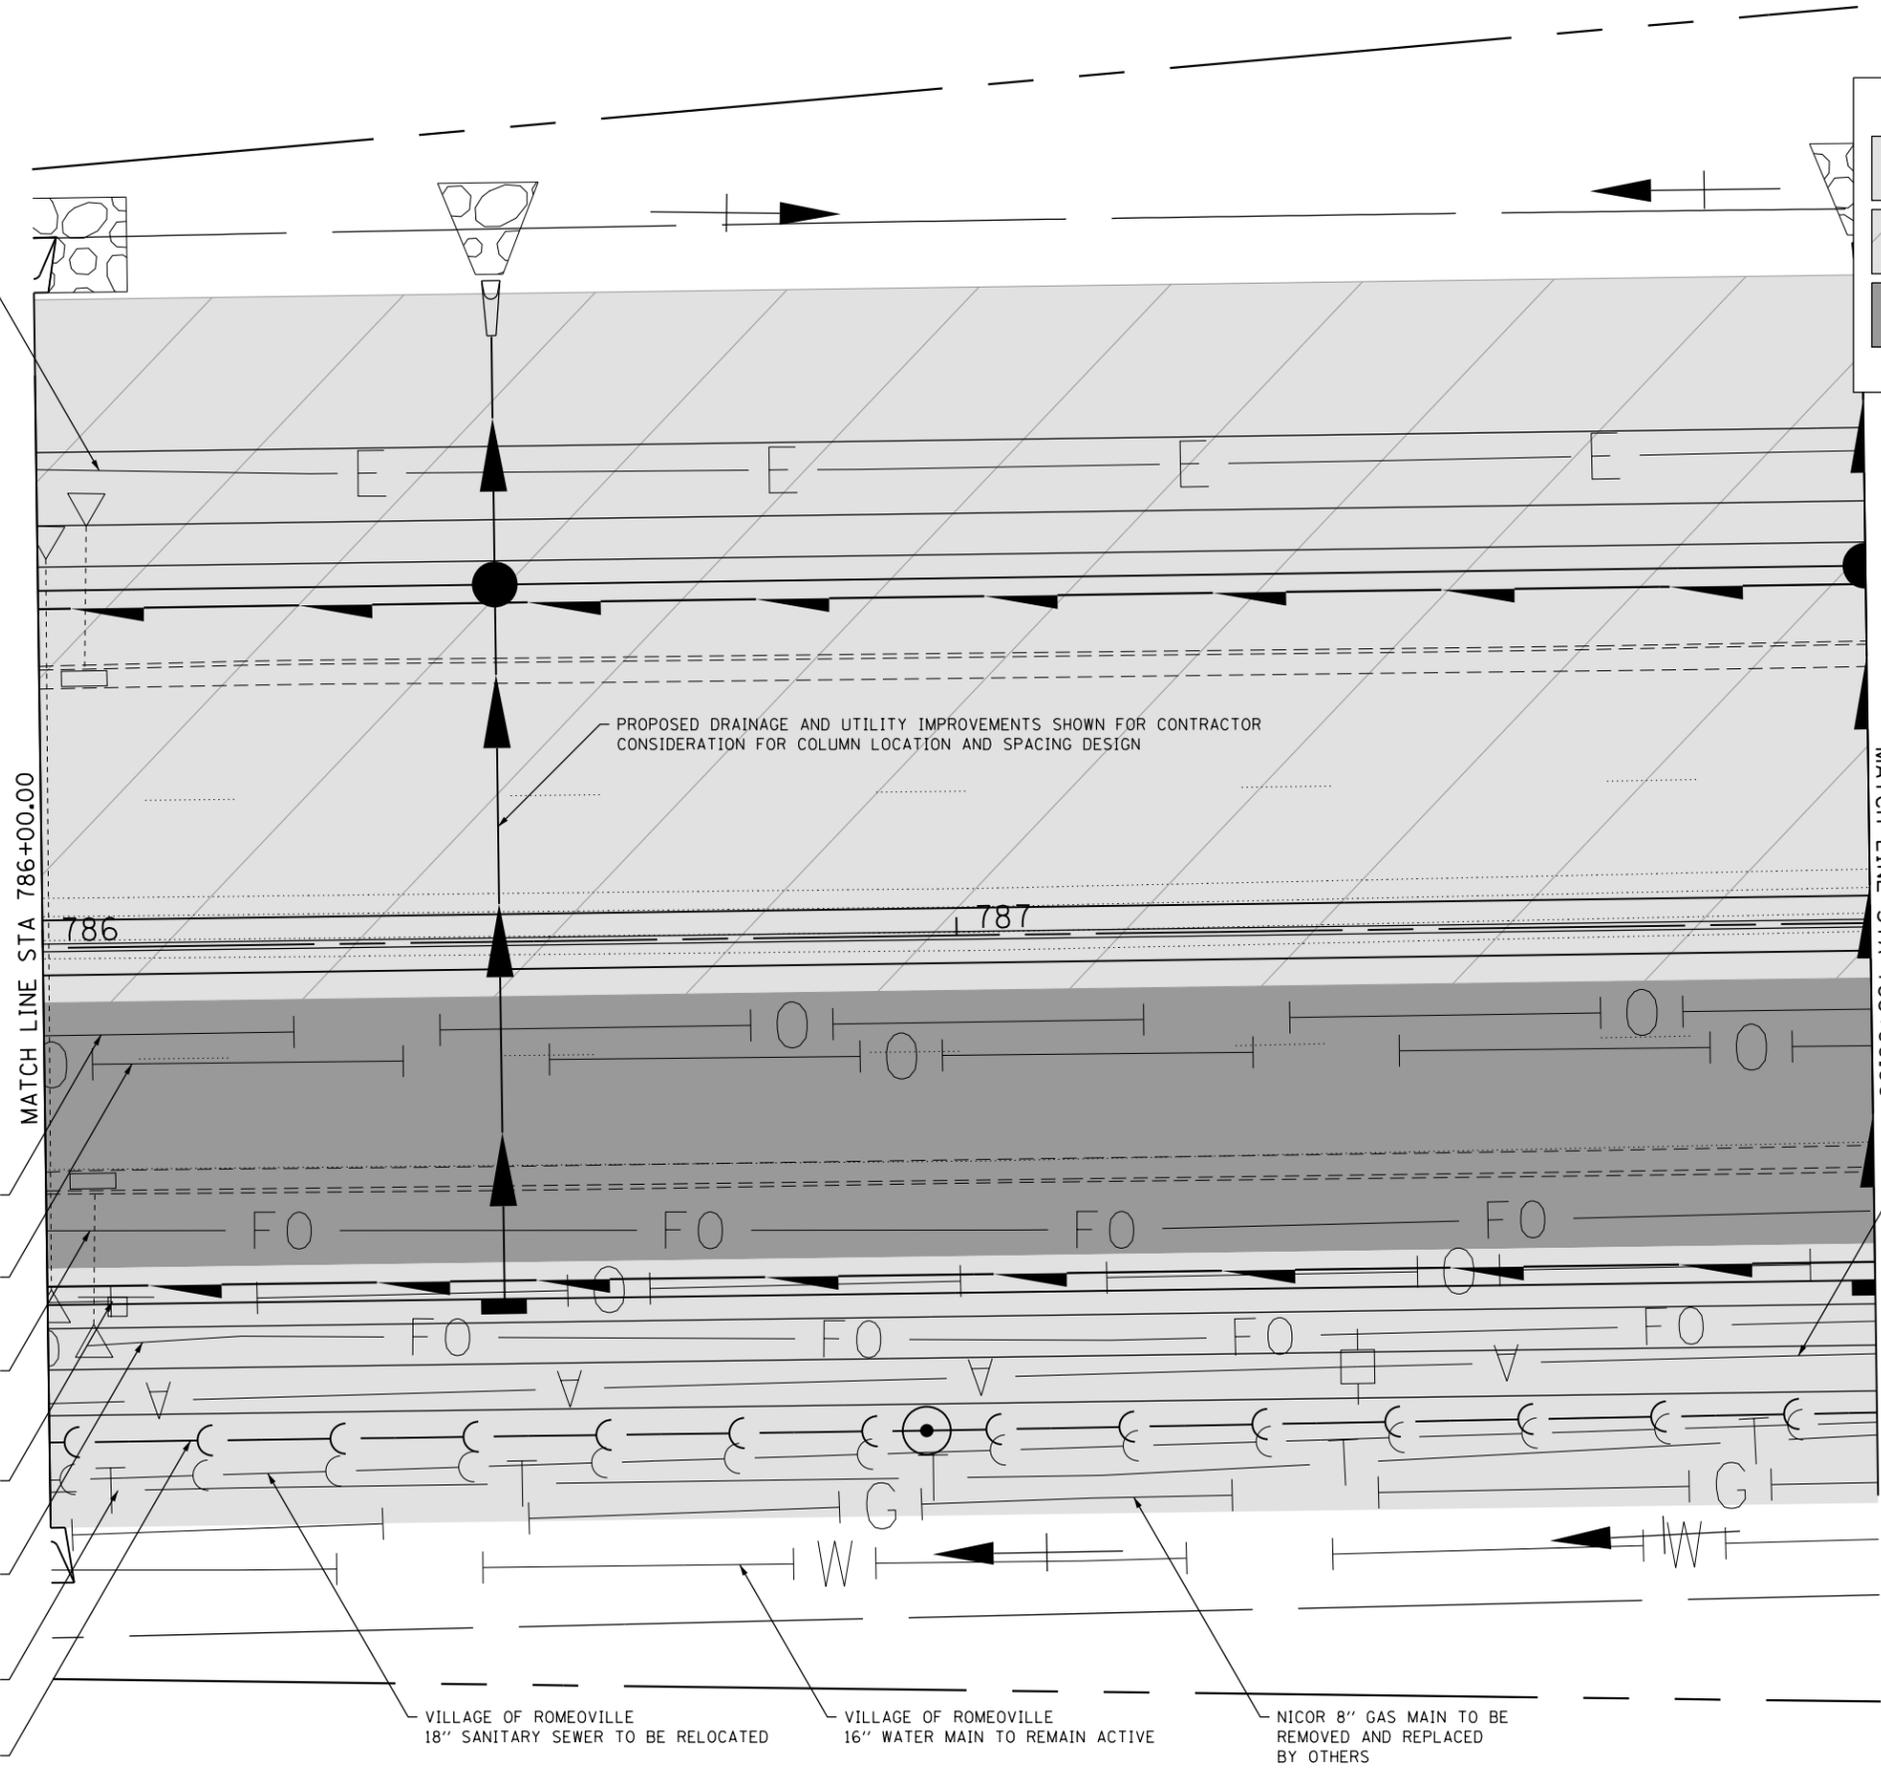

PROPOSED DRAINAGE AND UTILITY IMPROVEMENTS SHOWN FOR CONTRACTOR CONSIDERATION FOR COLUMN LOCATION AND SPACING DESIGN

MATCH LINE STA 786+00.00

MATCH LINE STA 788+00.00

RETIRED ONEOK OIL LINE TO BE REMOVED BY OTHERS

RETIRED KINDER MORGAN 24" OIL LINE TO BE REMOVED BY OTHERS

IDOT FIBER OPTIC LINE TO BE REMOVED

ONEOK OIL LINE TO BE REMOVED BY OTHERS

AT&T FIBER OPTIC LINE TO BE RELOCATED BY OTHERS

AT&T TELEPHONE LINE TO BE RELOCATED BY OTHERS


VILLAGE OF ROMEOVILLE PROPOSED 18" SANITARY SEWER

VILLAGE OF ROMEOVILLE 18" SANITARY SEWER TO BE RELOCATED

VILLAGE OF ROMEOVILLE 16" WATER MAIN TO REMAIN ACTIVE


NICOR 8" GAS MAIN TO BE REMOVED AND REPLACED BY OTHERS

COMED AERIAL LINES REMOVED BY OTHERS

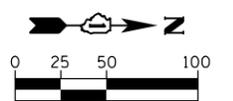

HORIZONTAL SCALE IN FEET

FILE NAME = D:\B\11-ent-cd\p5.dgn

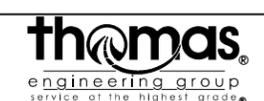

USER NAME = TEG	DESIGNED - RO	REVISED - 3/3/2015
	DRAWN - JBH	REVISED - 6/19/2015
PLOT SCALE = 20.0000' / in.	CHECKED - CRC	REVISED - 9/27/2016
PLOT DATE = 11/14/2017	DATE - 11/15/17	REVISED -

STATE OF ILLINOIS
DEPARTMENT OF TRANSPORTATION

CONTRACTOR DESIGNED GROUND IMPROVEMENT PLAN
WEBER ROAD

SCALE: SHEET OF SHEETS STA. TO STA.


F.A.P. RTE.	SECTION	COUNTY	TOTAL SHEETS	SHEET NO.
856	14-00170-42-RP	WILL	394	71
CONTRACT NO. 61D47				
ILLINOIS FED. AID PROJECT				

END 61D47 BEGIN 60X10

LEGEND

-  PRE-STAGE ZONE GROUND IMPROVEMENT AREA CONTROLLED STIFFNESS COLUMNS APPROXIMATELY = 26,100 SQ FT
-  STAGE 1 ZONE GROUND IMPROVEMENT AREA CONTROLLED STIFFNESS COLUMNS APPROXIMATELY = 70,600 SQ FT
-  STAGE 2 ZONE GROUND IMPROVEMENT AREA CONTROLLED STIFFNESS COLUMNS APPROXIMATELY = 27,000 SQ FT

TOTAL AREA APPROXIMATELY = 123,700 SQ FT

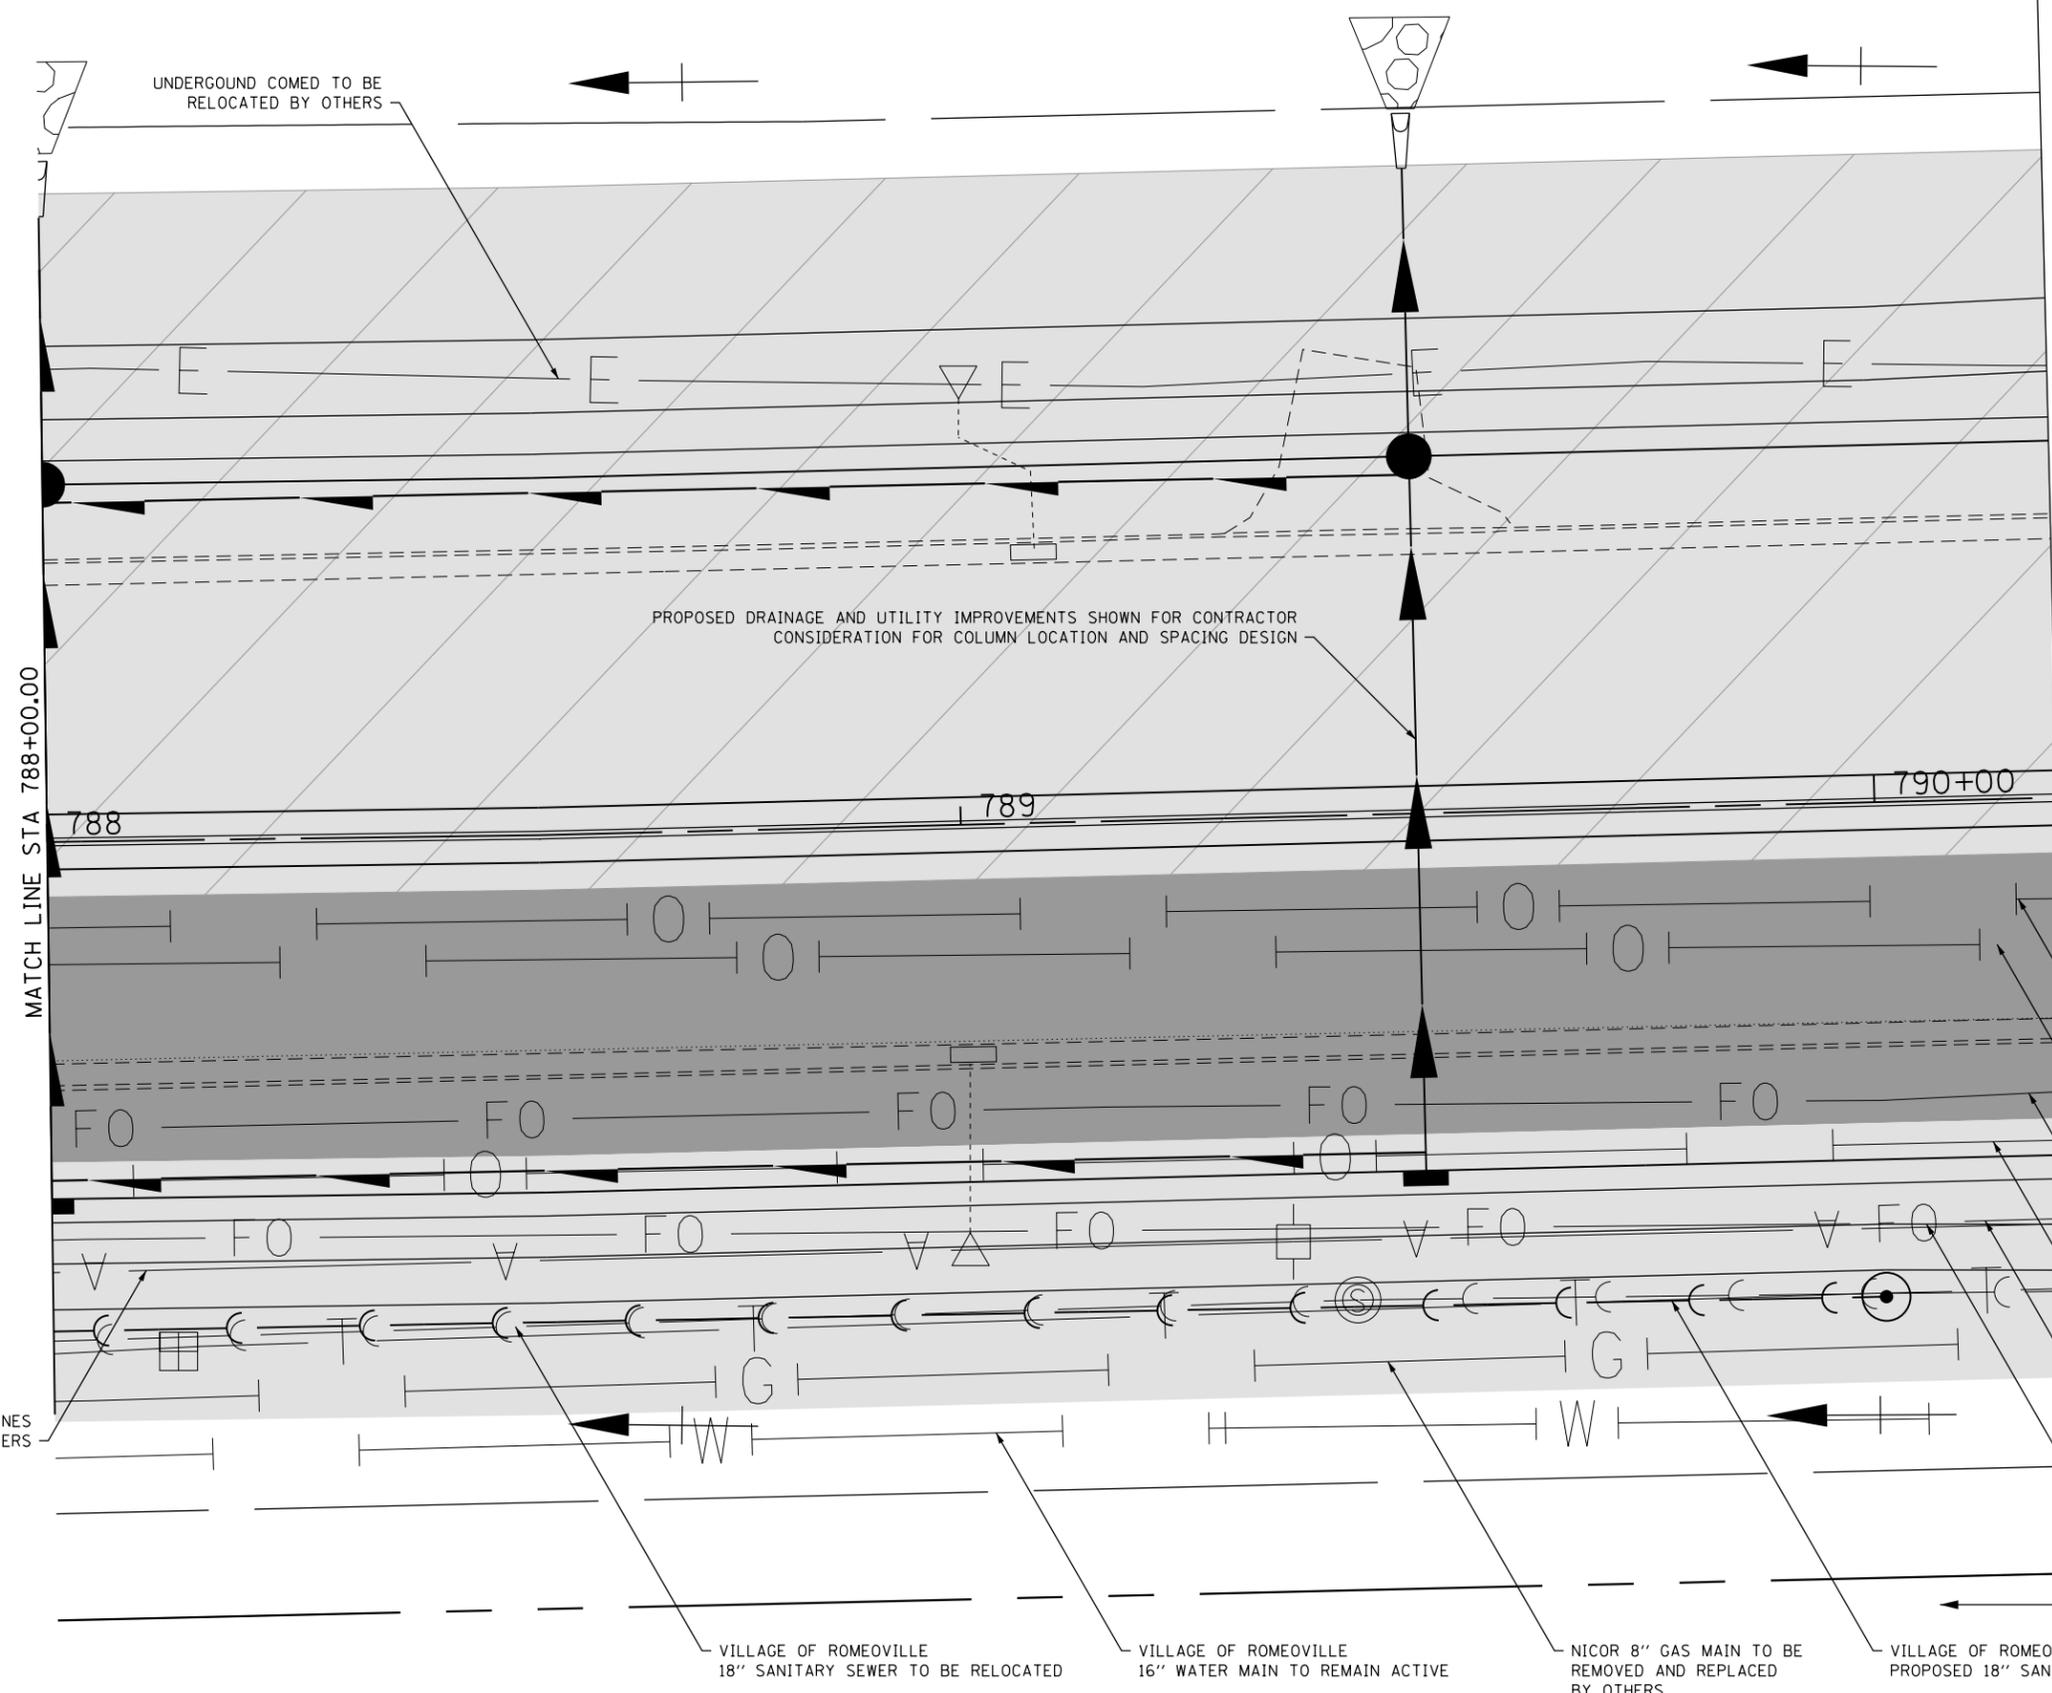

UNDERGROUND COMED TO BE RELOCATED BY OTHERS

PROPOSED DRAINAGE AND UTILITY IMPROVEMENTS SHOWN FOR CONTRACTOR CONSIDERATION FOR COLUMN LOCATION AND SPACING DESIGN


MATCH LINE STA 788+00.00

END CONTRACT 61D47 / BEGIN CONTRACT 60X10 (BY OTHERS) STA 790+20

- RETIRED ONEOK OIL LINE TO BE REMOVED BY OTHERS
- RETIRED KINDER MORGAN 24" OIL LINE TO BE REMOVED BY OTHERS
- IDOT FIBER OPTIC LINE TO BE REMOVED
- ONEOK OIL LINE TO BE REMOVED BY OTHERS
- AT&T FIBER OPTIC LINE TO BE RELOCATED BY OTHERS
- AT&T TELEPHONE LINE TO BE RELOCATED BY OTHERS

COMED AERIAL LINES REMOVED BY OTHERS

- VILLAGE OF ROMEOVILLE 18" SANITARY SEWER TO BE RELOCATED
- VILLAGE OF ROMEOVILLE 16" WATER MAIN TO REMAIN ACTIVE
- NICOR 8" GAS MAIN TO BE REMOVED AND REPLACED BY OTHERS
- VILLAGE OF ROMEOVILLE PROPOSED 18" SANITARY SEWER

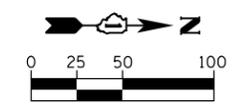

HORIZONTAL SCALE IN FEET

FILE NAME = D:\BX11-ent-cdgm\cdgm.dgn



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	DRAWN - JBH	REVISED - 6/19/2015
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PLOT DATE = 11/14/2017	DATE - 11/15/17	REVISED -

STATE OF ILLINOIS
DEPARTMENT OF TRANSPORTATION

CONTRACTOR DESIGNED GROUND IMPROVEMENT PLAN
WEBER ROAD


SCALE: SHEET OF SHEETS STA. TO STA.

F.A.P. RTE.	SECTION	COUNTY	TOTAL SHEETS	SHEET NO.
856	14-00170-42-RP	WILL	394	72
CONTRACT NO. 61D47				

ILLINOIS FED. AID PROJECT

DATE	
BY	
SURVEYED	
PLOTTED	
TEMPLATE	
AREAS	
CHECKED	
NO.	

DATE	
BY	
SURVEYED	
PLOTTED	
TEMPLATE	
AREAS	
CHECKED	
NO.	

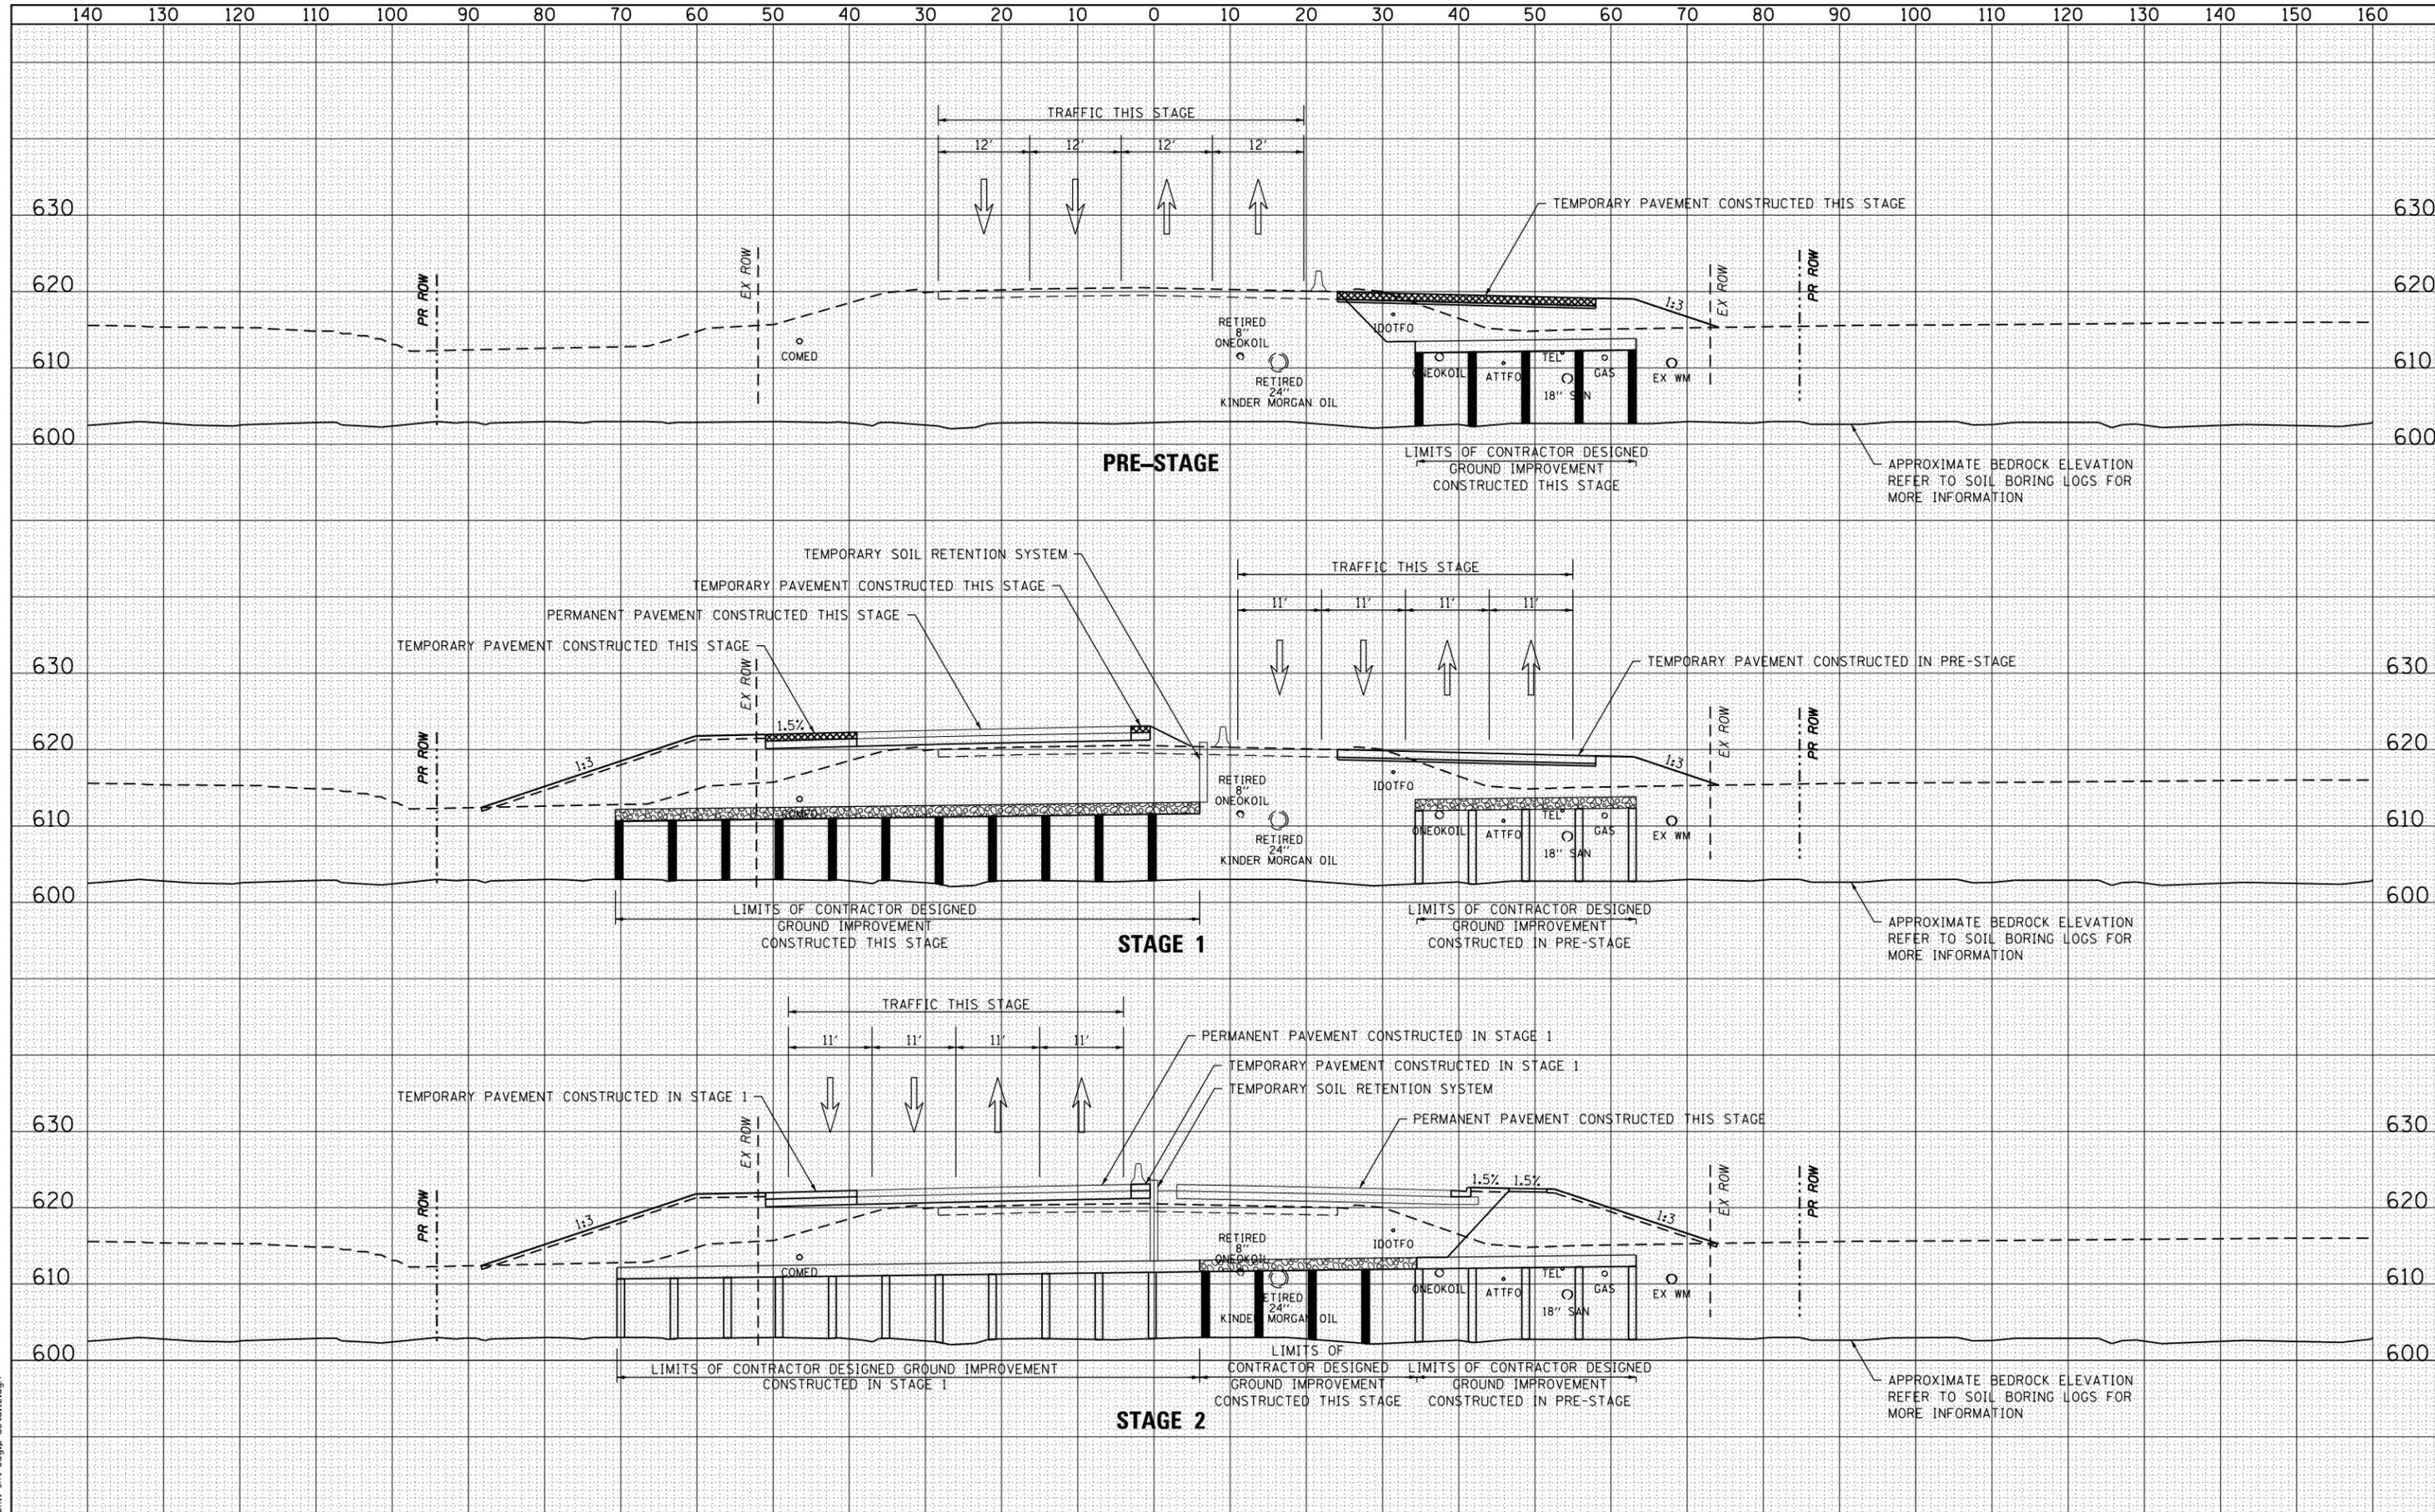

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PLOT DATE = 11/14/2017	DATE - 11/15/17	REVISED -

STATE OF ILLINOIS
DEPARTMENT OF TRANSPORTATION


CONTRACTOR DESIGNED GROUND IMPROVEMENT PLAN
TYPICAL SECTION - STAGING

SCALE: AS SHOWN SHEET OF SHEETS STA. TO STA.


F.A.P. RTE.	SECTION	COUNTY	TOTAL SHEETS	SHEET NO.
856	14-00170-42-RP	WILL	394	73
CONTRACT NO. 61D47				
ILLINOIS FED. AID PROJECT				

DATE	
BY	
SURVEYED	
PLOTTED	
TEMPLATE	
AREAS	
CHECKED	
NO.	

DATE	
BY	
SURVEYED	
PLOTTED	
TEMPLATE	
AREAS	
CHECKED	
NO.	

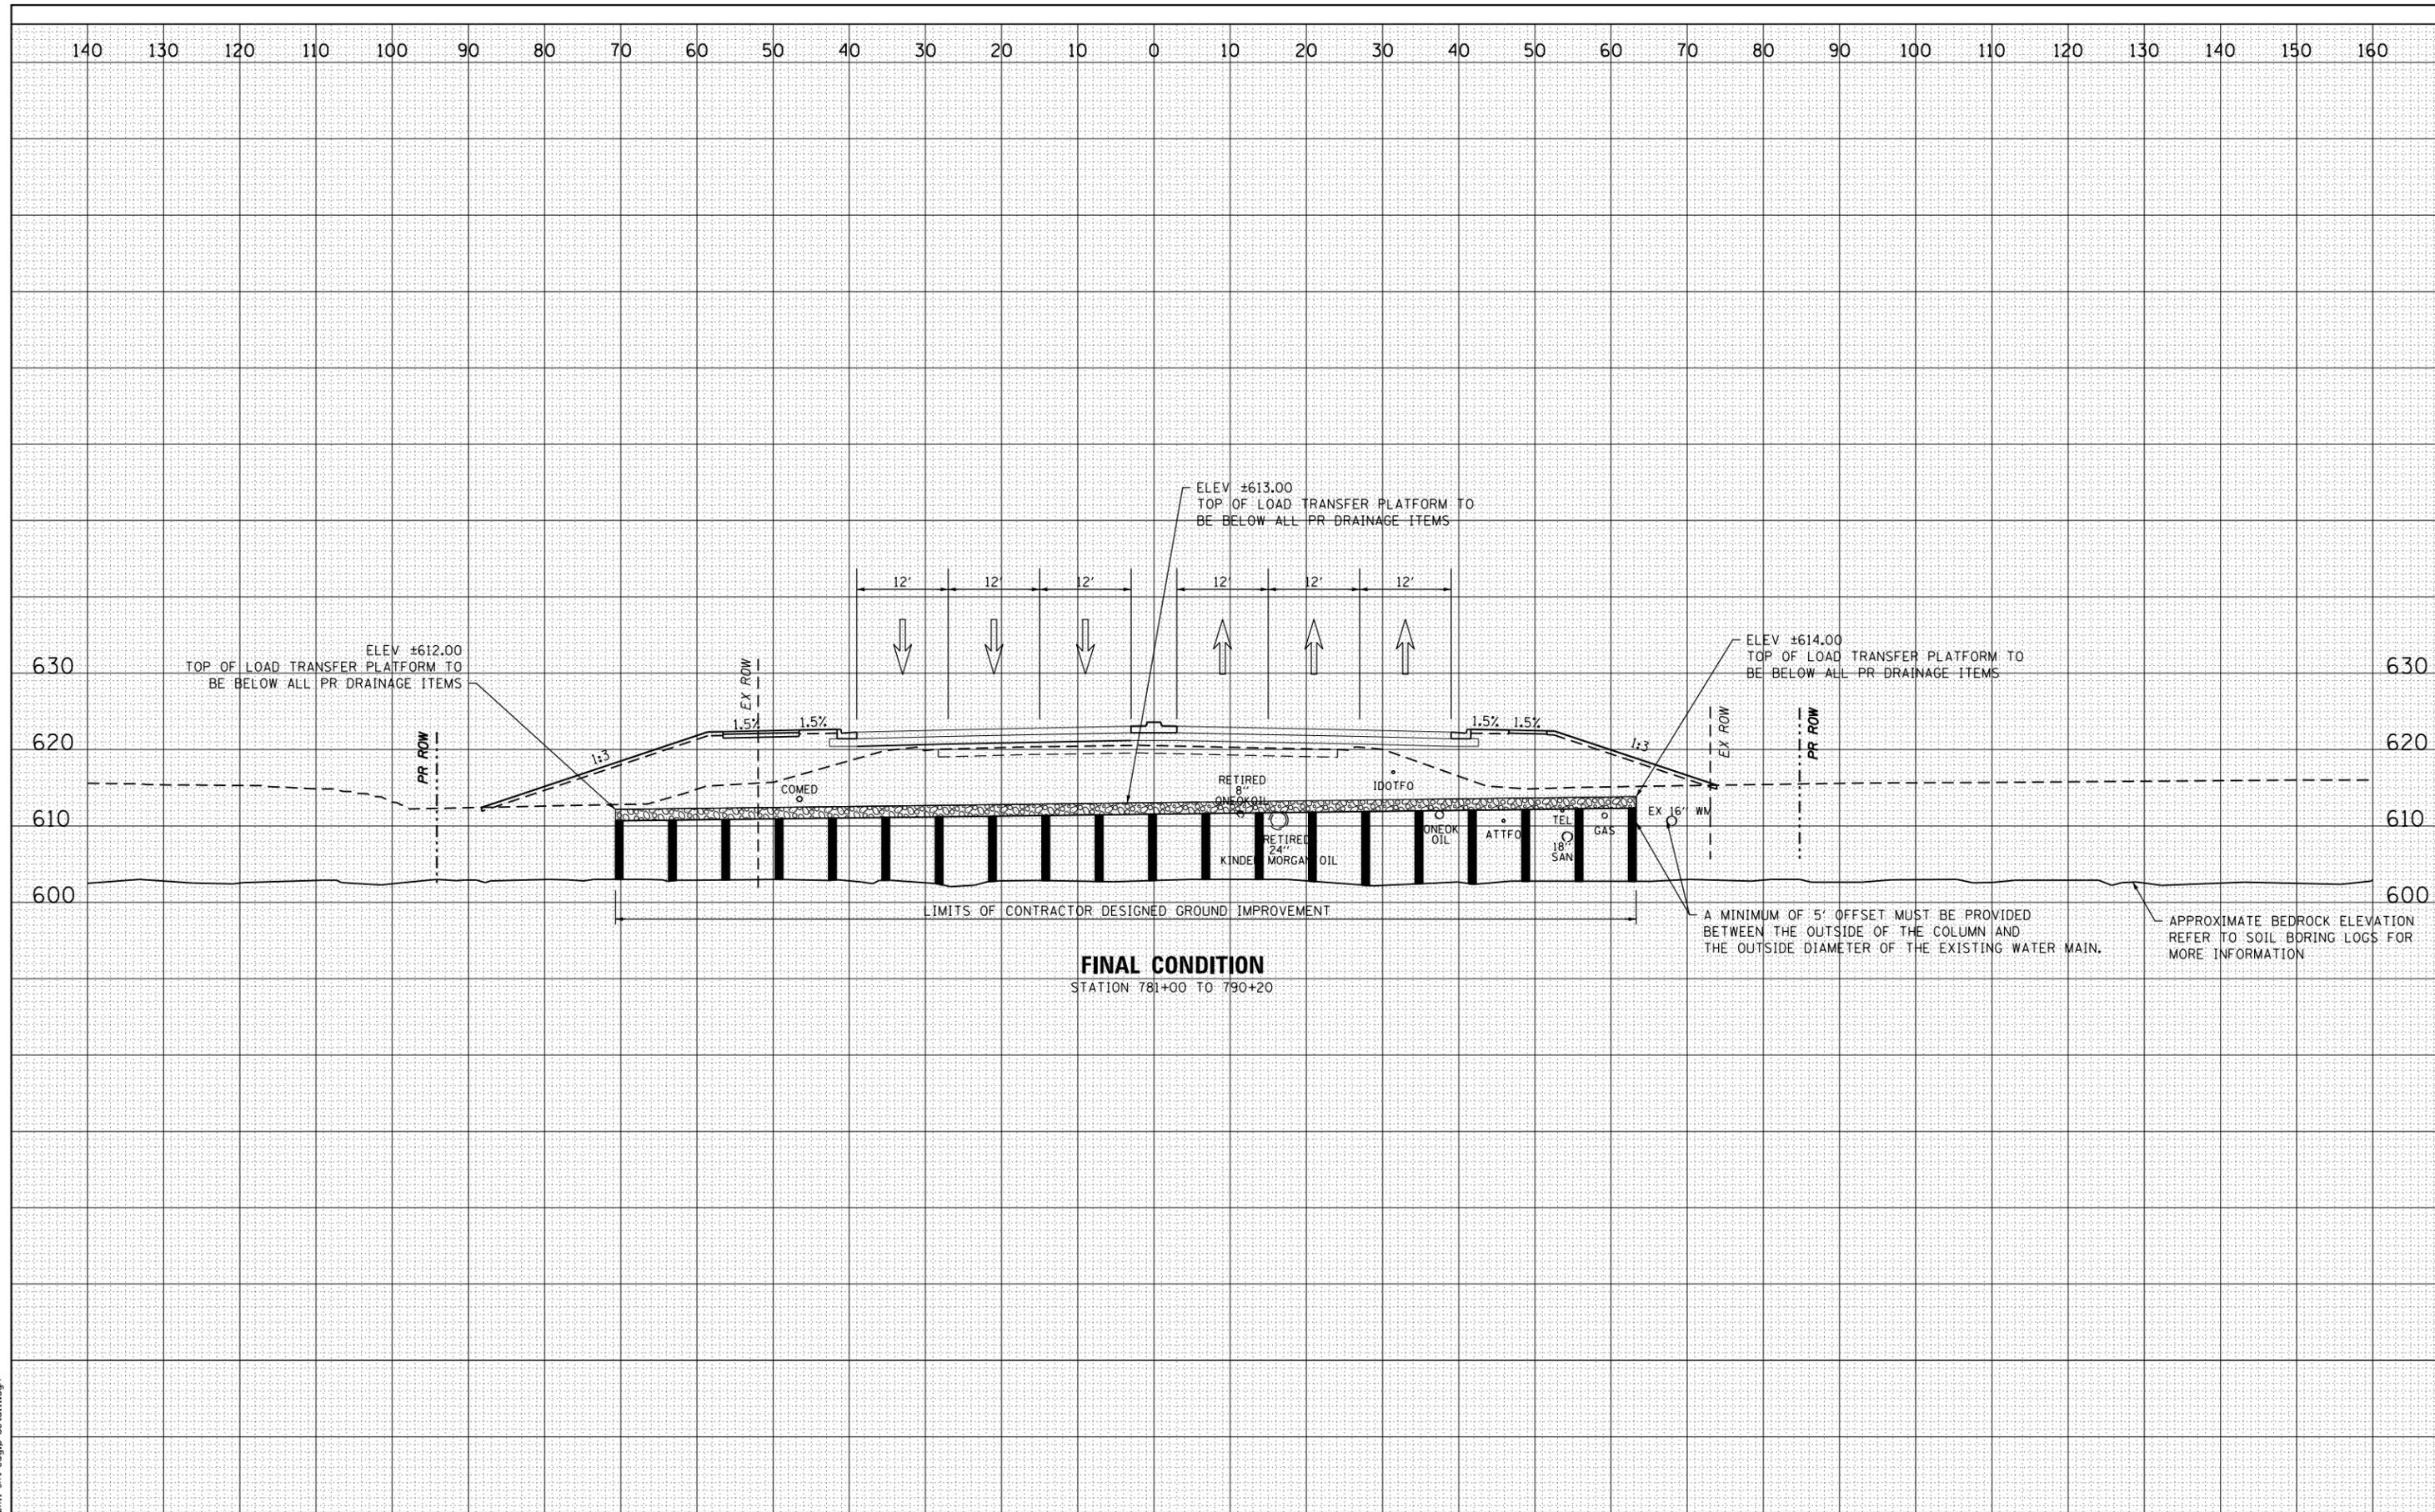

FINAL CONDITION
STATION 781+00 TO 790+20

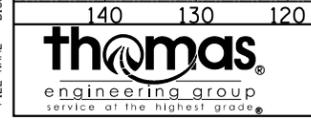

USER NAME - TEG	DESIGNED - BLP	REVISED - 3/3/2015
	DRAWN - JBH	REVISED - 6/19/2015
PLOT SCALE = 2.0000' / in.	CHECKED - CRC	REVISED - 9/27/2016
PLOT DATE = 11/14/2017	DATE - 11/15/17	REVISED -

STATE OF ILLINOIS
DEPARTMENT OF TRANSPORTATION

CONTRACTOR DESIGNED GROUND IMPROVEMENT PLAN
TYPICAL SECTION - FINAL CONDITION
SCALE: AS SHOWN SHEET OF SHEETS STA. TO STA.

F.A.P. RTE.	SECTION	COUNTY	TOTAL SHEETS	SHEET NO.
856	14-00170-42-RP	WILL	394	74
				CONTRACT NO. 61D47
ILLINOIS FED. AID PROJECT				

FILE NAME = D:\B\11-ah-t-cdgp-detail.dgn



SOIL BORING LOG

Page 1 of 1

Date 5/20/15

ROUTE Weber Rd. DESCRIPTION LOGGED BY E. Mueller

SECTION LOCATION SEC. TWP. RNG. Latitude Longitude

COUNTY Will DRILLING METHOD Hollow Stem Auger HAMMER TYPE Automatic

STRUCT. NO.	DEPT	BL	UCS	MOIST	Surface Water Elev.	DEPT	BL	UCS	MOIST
Station	H	(ft)	(tsf)	(%)	ft	H	(ft)	(tsf)	(%)
Groundwater Elev.: First Encounter 611.2 ft Upon Completion 609.2 ft									
HMA Pavement 8" 618.40 6									
Brown Sandy Gravel, Fill 13 5									
616.20 33									
Gray Crushed Stone, Fill 13 2									
613.70 15 20									
Brown Sandy Gravel, Fill 19 8									
611.20 13 15									
Brown Organic Silt Organic Content= 4.5% 0 50									
608.70 0 1 B									
Gray Silty Clay 1 21									
601.70 2 0.6 B									
Sand Seam 4 1.0 B									
600.30 4 17									
Gray Fractured Dolomitic Limestone 80 4									
End of Boring 50/4"									

The Unconfined Compressive Strength (UCS) Failure Mode is indicated by (B-Bulge, S-Shear, P-Penetrometer)
The SPT (N value) is the sum of the last two blow values in each sampling zone (AASHTO T206)
BBS, form 137 (Rev. 8-99)



SOIL BORING LOG

Page 1 of 1

Date 5/21/15

ROUTE Weber Rd. DESCRIPTION LOGGED BY E. Mueller

SECTION LOCATION SEC. TWP. RNG. Latitude Longitude

COUNTY Will DRILLING METHOD Flight Auger HAMMER TYPE Automatic

STRUCT. NO.	DEPT	BL	UCS	MOIST	Surface Water Elev.	DEPT	BL	UCS	MOIST
Station	H	(ft)	(tsf)	(%)	ft	H	(ft)	(tsf)	(%)
Groundwater Elev.: First Encounter 609.8 ft Upon Completion 613.8 ft									
Black Clay, A-7-6 54									
611.80 2 52									
Brown and Black Organic Silt, A-4 0 93									
609.30 1 B									
Gray Silty Loam, A-4 0 24									
601.80 1 0.7 B									
Auger Refusal at 15.5 599.30 2 0.6 B									
End of Boring 1 31									
Gray Gravelly Sand, A-1-a 7 12									
10 9									

The Unconfined Compressive Strength (UCS) Failure Mode is indicated by (B-Bulge, S-Shear, P-Penetrometer)
The SPT (N value) is the sum of the last two blow values in each sampling zone (AASHTO T206)
BBS, form 137 (Rev. 8-99)



SOIL BORING LOG

Page 1 of 1

Date 5/19/15

ROUTE Weber Rd. DESCRIPTION LOGGED BY E. Mueller

SECTION LOCATION SEC. TWP. RNG. Latitude Longitude

COUNTY Will DRILLING METHOD Hollow Stem Auger HAMMER TYPE Automatic

STRUCT. NO.	DEPT	BL	UCS	MOIST	Surface Water Elev.	DEPT	BL	UCS	MOIST
Station	H	(ft)	(tsf)	(%)	ft	H	(ft)	(tsf)	(%)
Groundwater Elev.: First Encounter 608.9 ft Upon Completion 611.9 ft									
Black Silty Clay, Fill 616.90 37									
Black and Dark Brown Silty Clay with Sand, Fill 5 23									
611.80 3 5									
Brown and Black Organic Silt, A-4 4 18									
609.90 6 7									
Gray Silty Loam 0 20									
608.70 1 1									
Gray Silty Loam 0 18									
603.90 1 2									
Sand Seam at 14' 1 16									
601.80 2 0.2 B									
Auger Refusal at 15.5 599.30 17 1.7 B									
End of Boring 52 50 - 2"									

The Unconfined Compressive Strength (UCS) Failure Mode is indicated by (B-Bulge, S-Shear, P-Penetrometer)
The SPT (N value) is the sum of the last two blow values in each sampling zone (AASHTO T206)
BBS, form 137 (Rev. 8-99)

FILE NAME = D:\BX11-sht-cdgp-blog.dgn



USER NAME = TEG	DESIGNED -	REVISED - 3/3/2015
PLOT SCALE = 2.0000' / in.	DRAWN -	REVISED - 6/19/2015
PLOT DATE = 11/14/2017	CHECKED -	REVISED - 9/27/2016
	DATE - 11/15/17	REVISED -

STATE OF ILLINOIS
DEPARTMENT OF TRANSPORTATION

CONTRACTOR DESIGNED GROUND IMPROVEMENT PLAN
SOIL BORING LOGS

SCALE: NTS SHEET 1 OF 4 SHEETS STA. TO STA.

F.A.P. RTE.	SECTION	COUNTY	TOTAL SHEETS	SHEET NO.
856	14-00170-42-RP	WILL	394	75
CONTRACT NO. 61D47				
ILLINOIS FED. AID PROJECT				

MAINTENANCE OF TRAFFIC – GENERAL NOTES

1. THE CONTRACTOR SHALL PROVIDE AND MAINTAIN TWO THROUGH TRAFFIC LANES IN EACH DIRECTION ON WEBER ROAD EXCEPT AS OTHERWISE INDICATED ON THE PLANS. OFF-PEAK PERIOD LANE CLOSURES WILL BE ALLOWED FOR CONSTRUCTION ACTIVITY ONLY AS APPROVED BY THE ENGINEER.
2. THE CONTRACTOR SHALL PROVIDE ALL SIGNS, VERTICAL PANELS, TYPE III BARRICADES, CHANNELIZATION DRUMS, TYPE II BARRICADES, ALL TEMPORARY CONCRETE BARRIERS, AND PROTECTION NECESSARY FOR WORK ZONE TRAFFIC CONTROL AND PROTECTION, OR AS DIRECTED BY THE ENGINEER.
3. THE CONTRACTOR SHALL INSTALL AND MAINTAIN PROPOSED AND TEMPORARY DRAINAGE SYSTEMS, AND EROSION CONTROL THROUGHOUT STAGE CONSTRUCTION DURING THE DURATION OF THE PROJECT.
4. THE CONTRACTOR SHALL MAINTAIN DRIVEWAY, FIELD, COMMERCIAL, PRIVATE ENTRANCES, AND SIDE ROAD ACCESS AT ALL TIMES DURING CONSTRUCTION AND/OR WHERE DIRECTED BY THE ENGINEER. THIS WORK SHALL BE PAID FOR AT THE CONTRACT UNIT PRICE PER EACH FOR TEMPORARY ACCESS (PRIVATE ENTRANCE) AND TEMPORARY ACCESS (COMMERCIAL ENTRANCE). EACH DRIVEWAY, FIELD, COMMERCIAL, PRIVATE ENTRANCE, AND SIDE ROAD SHALL ONLY BE MEASURED FOR PAYMENT ONCE. DURING THE WINTER MONTHS THE CONTRACTOR SHALL CONSTRUCT AND MAINTAIN TEMPORARY ACCESS COMPOSED OF A HOT-MIX ASPHALT SURFACE OVER PREVIOUSLY INSTALLED AGGREGATE TEMPORARY ACCESS. THIS WORK WILL BE PAID FOR SEPARATELY AND SHALL BE IN ACCORDANCE WITH TEMPORARY ACCESS (WINTERIZE). SEE IDOT DISTRICT 1 DETAIL TC-26 FOR TEMPORARY INFORMATION SIGNING REQUIREMENTS AT DRIVEWAYS. IN ADDITION, THE LOCKPORT TOWNSHIP FIRE HOUSE ACCESS MUST BE MAINTAINED AT ALL TIMES. REFER TO PAGE 80 FOR DRIVEWAY CONSTRUCTION SEQUENCING OF TOWNSHIP FIRE HOUSE DRIVEWAY.
5. THE CONTRACTOR SHALL COORDINATE PLACEMENT OF TRAFFIC SIGNS, TRAFFIC CONTROL DEVICES AND TRAFFIC LANE LOCATIONS WITH ADJACENT CONTRACT 60X10 OR AS DIRECTED BY THE ENGINEER.
6. ALL TYPE II BARRICADES, DRUMS, AND VERTICAL PANELS SHALL BE EQUIPPED WITH MONO-DIRECTIONAL STEADY BURNING LIGHTS ON MULTI-LANE ROADWAYS. WHILE BIDIRECTIONAL LIGHTS ARE REQUIRED ON ALL TWO-LANE ROADWAYS.
7. TEMPORARY CONCRETE BARRIER SHALL BE EQUIPPED WITH TYPE "C" REFLECTORS, IN ACCORDANCE WITH HIGHWAY STANDARD 782006 AT 25' CENTERS.
8. ALL CONSTRUCTION WARNING SIGNS SHALL BE BLACK LEGEND ON ORANGE BACKGROUND.
9. ALL CONSTRUCTION WARNING SIGN DIMENSIONS SHALL BE 48" X 48".
10. ALL "ROAD CONSTRUCTION AHEAD" WARNING SIGNS SHALL BE EQUIPPED WITH HIGH INTENSITY FLASHING LIGHTS.
11. THE CONTRACTOR SHALL INSTALL AND COVER ALL TEMPORARY SIGNING BEFORE EXISTING SIGNS ARE REMOVED. THE CONTRACTOR SHALL RELOCATE EXISTING SIGNS IN CONFLICT WITH STAGING. ALL EXISTING GUIDE SIGNS (I.E. STREET NAME SIGNS, ADVANCE STREET NAME SIGNS, ETC.) SHALL BE MAINTAINED AND VISIBLE TO TRAFFIC DURING CONSTRUCTION.
12. THE CONTRACTOR SHALL INSTALL AND COVER ALL PERMANENT SIGNING BEFORE TEMPORARY SIGNS ARE REMOVED.
13. DIRECTION INDICATOR BARRICADES SHALL BE USED AT LANE CLOSURE TAPER LOCATIONS OR AS DIRECTED BY THE ENGINEER.
14. AT THE END OF EACH WORK DAY, THE CONTRACTOR SHALL BACKFILL OR COVER ALL TRENCHES AND OPEN EXCAVATION HOLES FOR TEMPORARY PAVEMENT, PROPOSED PAVEMENT, TEMPORARY DITCHES, PROPOSED STORM SEWER, DRAINAGE STRUCTURES, AND WATER MAINS IN ORDER TO PROVIDE SAFE CONDITION FOR MOTORISTS AND THE PUBLIC DURING NON-WORKING HOURS. THE CONSTRUCTION OF THIS WORK SHALL BE PAID FOR AS TRAFFIC CONTROL AND PROTECTION (SPECIAL).
15. TEMPORARY PAVEMENT MARKING 4" DOUBLE YELLOW LINE SHALL BE INSTALLED TO DELINEATE THE LEFT TRAVEL EDGE OF PAVEMENT AFTER TEMPORARY PAVEMENT HAS BEEN CONSTRUCTED IN EXISTING RAISED MEDIANS IN PRE-STAGE.
16. EXCAVATION AND PAVEMENT WIDENING ON BOTH SIDES OF THE PAVEMENT AT ANY ONE LOCATION AT THE SAME TIME WILL NOT BE PERMITTED PER ARTICLE 701.08 OF THE IDOT SPECS.
17. PORTABLE/CHANGEABLE ELECTRONIC MESSAGE SIGNS SHALL BE USED IN ADVANCE OF THE PROJECT ACCORDING TO IDOT STANDARDS AND SHALL BE IN PLACE A MINIMUM OF 7 DAYS PRIOR TO COMMENCING THE WORK AND REMAIN THROUGHOUT THE ROADWAY CONSTRUCTION WORK (PRE-STAGE):
 - SEQUENCE #1: ROAD CONST BEGINS XX/XX
 - SEQUENCE #2: EXPECT DELAYS
18. DURING CONSTRUCTION ALL SEMI-VEHICLES ARE TO USE TWO COMMERCIAL ENTRANCES (A) CE NEAR WALGREENS ON WEBER ROAD AND (B) CE BEHIND THE COMMERCIAL BUSINESSES ON THE EAST LEG OF 135TH STREET / ROMEO ROAD. ADVANCED SIGNING WILL BE PLACED AS SHOWN ON THE STAGING SHEETS.
19. THE CONTRACTOR WILL BE REQUIRED TO RELOCATE OR REMOVE AND REPLACE ALL ROAD SIGNS WHICH INTERFERE WITH CONSTRUCTION OPERATIONS AND TEMPORARILY RESET ALL SUCH SIGNS DURING ALL STAGES OF CONSTRUCTION. THIS WORK WILL BE INCLUDED IN THE CONTRACT UNIT PRICE FOR TRAFFIC CONTROL AND PROTECTION, (SPECIAL). ALL WORK INVOLVING SIGNS SHALL BE GOVERNED BY THE FOLLOWING:
 - A. SIGNS SHALL NOT BE REMOVED UNTIL NECESSITATED BY THE PROGRESS OF THE WORK.
 - B. EVERY SIGN REMOVED MUST BE RE-ERECTED AT A TEMPORARY LOCATION IN A WORKMANLIKE MANNER AND VISIBLE TO THE TRAFFIC FOR WHICH IT IS INTENDED.
 - C. ALL SIGNS MUST BE MAINTAINED STRAIGHT AND CLEAN FOR THE DURATION OF THE TEMPORARY SETTING.

20. CONTRACTOR IS TO INFORM MR. HARRY TIEGE AND MR. ERIC BJORK 72 HOURS PRIOR TO ANY STAGING CHANGES.
 - A. MR. HARRY TIEGE
MAINTENANCE DIRECTOR AT THE CARILLON ADULT MASTER ASSOCIATION
BUSINESS PHONE: (815) 866-6767; MOBILE PHONE: (815) 693-3766.
 - B. MR. ERIC BJORK
VILLAGE OF ROMEOVILLE DIRECTOR OF PUBLIC WORKS
BUSINESS PHONE: (815) 886-1870
21. REMOVAL OF EX PAVEMENT MARKINGS ON EX PAVEMENT TO EVENTUALLY BE REMOVED SHALL BE PAID FOR AS PAVEMENT MARKING REMOVAL - GRINDING. REMOVAL OF EX PAVEMENT MARKINGS ON EXISTING PAVEMENT TO REMAIN SHALL BE PAID FOR AS PAVEMENT MARKING REMOVAL - WATER BLASTING. REMOVAL OF TEMPORARY PAVEMENT MARKING TAPE, TYPE IV SHALL BE PAID FOR AS TEMPORARY PAVEMENT MARKING REMOVAL.
22. THE CONTRACTOR SHALL USE, DURING ALL WINTER STAGING MONTHS, PERMANENT PAVEMENT MARKINGS. THE PERMANENT PAVEMENT MARKING MATERIAL SHALL BE APPROVED BY THE ENGINEER. PERMANENT PAVEMENT MARKING REMOVAL ON NEW OR EXISTING PAVEMENT OR TEMPORARY PAVEMENT TO REMAIN SHALL BE PAID FOR AS PAVEMENT MARKING REMOVAL - WATER BLASTING. REFER TO SCHEDULES FOR QUANTITY BREAKDOWN OF WINTER PAVEMENT MARKINGS.
23. PRE-STAGE WORKS INCLUDES THE REMOVAL OF EXISTING WATER MAIN, INSTALLATION OF PROPOSED WATER MAIN AND DRAINAGE STORM SEWER AND STRUCTURES. ANY PAVEMENT SHALL BE REPLACED AND WILL BE PAID FOR A CLASS D PATCHES, TYPE IV, 13 INCH.
24. DUE TO STAGING/MAINTENANCE OF TRAFFIC, TEMPORARY PAVEMENT WILL BE PLACED DIRECTLY ADJACENT TO THE PROPOSED EDGE OF PAVEMENT. AS A RESULT, PROPOSED CURB AND GUTTER WILL NOT BE INSTALLED UNTIL STAGE 3. DRAINAGE STRUCTURES IN THE PROPOSED CURB LINE IN THIS AREA SHALL BE BROUGHT TO FINAL GRADE AND THE CONTRACTOR SHALL INSTALL THE PROPOSED FRAME AND GRATES WITHIN THE TEMPORARY PAVEMENT. THE CONTRACTOR SHALL USE MEANS AND METHODS, APPROVED BY THE ENGINEER, TO PROVIDE A JOINT MATERIAL THAT SERVES TO PROTECT THE PROPOSED PCC PAVEMENT FROM THE TEMPORARY PAVEMENT DURING PLACEMENT AND REMOVAL. THE JOINT MATERIAL SHALL BE INCLUDED IN THE COST OF THE PROPOSED TEMPORARY PAVEMENT. WHEN THE CURB AND GUTTER IS READY TO BE INSTALLED, THE TEMPORARY PAVEMENT SHALL BE CAREFULLY REMOVED TO AVOID DAMAGE TO THE PROPOSED DRAINAGE STRUCTURES AND PROPOSED EDGE OF PAVEMENT. IF, DURING THESE OPERATIONS, ANY DAMAGE OCCURS, THE CONTRACTOR SHALL BE RESPONSIBLE FOR ALL COSTS ASSOCIATED WITH REPAIRING THE DAMAGES TO THE SATISFACTION OF THE ENGINEER.

SUGGESTED MAINTENANCE OF TRAFFIC – SIGN LEGEND

FILE NAME = D:\B\11-ah-t-staging\00.dgn



USER NAME = TEG	DESIGNED - RO	REVISED - 3/3/2015
	DRAWN - JBH	REVISED - 6/19/2015
PLOT SCALE = 2.0000' / in.	CHECKED - CRC	REVISED - 9/27/2016
PLOT DATE = 11/14/2017	DATE - 11/15/17	REVISED -

**STATE OF ILLINOIS
DEPARTMENT OF TRANSPORTATION**

MAINTENANCE OF TRAFFIC GENERAL NOTES

SCALE: N.T.S. SHEET 1 OF 1 SHEETS STA. TO STA.

F.A.P. RTE.	SECTION	COUNTY	TOTAL SHEETS	SHEET NO.
856	14-00170-42-RP	WILL	394	79
CONTRACT NO. 61D47				
ILLINOIS FED. AID PROJECT				

SUGGESTED SEQUENCE OF CONSTRUCTION

PRE-STAGE

WEBER ROAD

CONSTRUCTION

INSTALL PRE-STAGE EROSION CONTROL, TEMP SIGNS, CHANGEABLE MESSAGE SIGNS, REMOVE AND/OR RELOCATE EX UTILITIES, SAWCUT EX PAVEMENT TO REMOVE EX WATER MAIN, INSTALL PR WATER MAIN, AND PR STORM SEWER PIPES AND STRUCTURES, BACKFILL AND PATCH DISTURBED PAVEMENT. GRADE THE PR DETENTION BASIN AT ROMEO RD/135TH STREET AND THE COMPENSATORY STORAGE BASIN NEAR THE LILY CACHE SLOUGH AS SHOWN IN THE STAGING CROSS SECTIONS. CONSTRUCT SHARED-USE PATH BETWEEN INTERSECTIONS. SAWCUT AND REMOVE EX C&G AND DRAINAGE STRUCTURES REQUIRED TO INSTALL THE CULVERT EXTENSION ON THE EAST SIDE OF THE EX CULVERT (STA 784+17), CONSTRUCT TEMP PAVEMENT ALONG EAST SIDE OF WEBER ROAD, INSTALL TEMP TRAFFIC SIGNALS, REMOVAL OF EX TRAFFIC SIGNAL EQUIPMENT, INSTALL AND PIN TEMP CONCRETE BARRIER AND VERTICAL PANELS, WHERE APPLICABLE.

TRAFFIC

TRAFFIC IS TO REMAIN IN THE EX LANE CONFIGURATION WITH THE POSSIBILITY OF DAY-TIME LANE CLOSURES ONLY ALLOWED BETWEEN 9AM AND 3PM (OFF-PEAK HOURS). TRAFFIC CONTROL SHALL BE IN ACCORDANCE WITH IDOT STANDARDS 701421 AND 707701, WHERE APPLICABLE.

ROMEO ROAD/135TH STREET

CONSTRUCTION

INSTALL PRE-STAGE EROSION CONTROL, TEMP SIGNS, CHANGEABLE MESSAGE SIGNS, REMOVE AND/OR RELOCATE EX UTILITIES, SAWCUT AND REMOVE EX C&G AND APPURTENANCES REQUIRED TO CONSTRUCT TEMP PAVEMENT ALONG THE SOUTH SIDE OF ROMEO ROAD/135TH ST. INSTALL TEMP TRAFFIC SIGNALS, REMOVE EX TRAFFIC SIGNAL EQUIPMENT, INSTALL VERTICAL PANELS, WHERE APPLICABLE. CONSTRUCT PART OF THE PR SIDEWALK AND TEMP SIDEWALK FOR PEDESTRIAN ACCOMMODATION AS SHOWN IN PLANS.

TRAFFIC

TRAFFIC IS TO REMAIN IN THE EX LANE CONFIGURATION WITH THE POSSIBILITY OF DAY-TIME LANE CLOSURES ONLY ALLOWED BETWEEN 9AM AND 3PM (OFF-PEAK HOURS). TRAFFIC CONTROL SHALL BE IN ACCORDANCE WITH IDOT STANDARDS 701421 AND 707701, WHERE APPLICABLE.

N. CARILLON DRIVE/GRAND BOULEVARD

CONSTRUCTION

INSTALL PRE-STAGE EROSION CONTROL, TEMP SIGNS, CHANGEABLE MESSAGE SIGNS, REMOVE AND/OR RELOCATE EX UTILITIES, SAWCUT AND REMOVE EX C&G PAVEMENT AND APPURTENANCES REQUIRED TO CONSTRUCT TEMP PAVEMENT AND INSTALL VERTICAL PANELS ALONG SOUTH SIDE OF GRAND BOULEVARD (EAST LEG), INSTALL TEMP TRAFFIC SIGNALS, REMOVE EX TRAFFIC SIGNAL EQUIPMENT, REMOVE EX RAISED CONCRETE MEDIANS IN CONFLICT AND REPLACE WITH TEMP PAVEMENT, AND REMOVE THE CORNER ISLAND (SOUTHWEST CORNER) AND REPLACE WITH TEMP PAVEMENT. CONSTRUCT PART OF PR SIDEWALK AND TEMP SIDEWALK FOR PEDESTRIAN ACCOMMODATIONS AS SHOWN IN PLANS.

TRAFFIC

TRAFFIC IS TO REMAIN IN THE EX LANE CONFIGURATION WITH THE POSSIBILITY OF DAY-TIME LANE CLOSURES ONLY ALLOWED BETWEEN 9AM AND 3PM (OFF-PEAK HOURS). TRAFFIC CONTROL SHALL BE IN ACCORDANCE WITH IDOT STANDARDS 701421 AND 707701, WHERE APPLICABLE.

STAGE 1

WEBER ROAD

CONSTRUCTION

INSTALL STAGE 1 EROSION CONTROL, TEMP SIGNS, ACTIVATE TEMP SIGNALS, SAWCUT AND REMOVE EX PAVEMENT, SIDEWALKS, AND APPURTENANCES REQUIRED TO CONSTRUCT THE REMAINING PR STORM SEWER WITHIN THE STAGE 1 AREA. REMOVE THE WEST SIDE OF THE EX CULVERT, CONSTRUCT THE WESTERN HALF OF THE PR DRAINAGE CULVERT AT STA 784+17, CONSTRUCT THE PR NOISE WALL, SB PAVEMENT AND THE TEMP PAVEMENT ALONG THE PR EOP, PR COMMERCIAL ENTRANCES BY HALVES, SHARED-USE PATH, AND ADA RAMPS. CONTRACTOR SHALL PRESERVE STAGE 1 TEMP PAVEMENT MARKINGS FOR SUB-STAGE 1 USE.

TRAFFIC

SHIFT LANES TO THE WEST ONTO THE NEWLY CONSTRUCTED PAVEMENT AND TEMP PAVEMENT. PROVIDE TWO THROUGH LANES IN EACH DIRECTION (AT A MINIMUM) AND A SOUTHBOUND LEFT TURN LANE AT BOTH INTERSECTIONS. CONTRACTOR IS TO MAINTAIN COMMERCIAL ENTRANCE ACCESS AT ALL TIMES.

ROMEO ROAD/135TH STREET

CONSTRUCTION (WEST LEG)

INSTALL STAGE 1 EROSION CONTROL, TEMP SIGNS, ACTIVATE TEMP SIGNALS, SAWCUT AND REMOVE EX PAVEMENT AND APPURTENANCES REQUIRED TO CONSTRUCT THE PR WESTBOUND AND THE EASTBOUND LEFT TURN LANE PAVEMENT, CONSTRUCT THE BP GAS STATION DRIVEWAY ENTRANCE IN HALVES. CONSTRUCT C&G AND TEMP PAVEMENT ON NORTH SIDE OF ROAD (WEST OF BP GAS STATION). SAW CUT PVMT IN BP GAS STATION AND CONSTRUCT PR CURB, TYPE B. SEE STA 753+00 CROSS SECTION.

TRAFFIC (WEST LEG)

TRAFFIC SHIFTS TO THE SOUTH UTILIZING EX AND TEMP PAVEMENT TO PROVIDE AT LEAST ONE WESTBOUND AND ONE EASTBOUND THROUGH LANE AND AN EASTBOUND LEFT TURN LANE. FOLLOW SEQUENCE DETAIL PROVIDED IN PLANS. FIRST SEQUENCE ALLOWS ACCESS TO BOTH THE PARKING LOT AREA AND ROMEO RD/135TH ST AND SECOND SEQUENCE INCLUDES A ROAD CLOSURE ALONG ROMEO RD/135TH ST WITH THE USE OF THE COMMERCIAL PARKING LOT FOR TRAFFIC CONFIGURATION. CONTRACTOR SHALL PRESERVE STAGE 1 TEMP PAVEMENT MARKINGS FOR SUB-STAGE 1 USE.

CONSTRUCTION (EAST LEG)

INSTALL STAGE 1 EROSION CONTROL, ACTIVATE TEMP SIGNALS, TEMP SIGNS, SAWCUT AND REMOVE EX PAVEMENT AND APPURTENANCES REQUIRED TO CONSTRUCT PR WESTBOUND PAVEMENT, TEMPORARY PAVEMENT WITHIN THE PROPOSED MEDIAN AREA, CONSTRUCT THE COMMERCIAL ENTRANCES IN HALVES, AND THE ADA RAMPS.

TRAFFIC (EAST LEG)

TRAFFIC SHIFTS SOUTH TO UTILIZE EX AND TEMP PAVEMENT TO PROVIDE AT LEAST ONE EASTBOUND AND ONE WESTBOUND THROUGH LANE AND A WESTBOUND LEFT TURN LANE. CONTRACTOR IS TO MAINTAIN COMMERCIAL ENTRANCES ACCESS AT ALL TIMES. CONTRACTOR SHALL PRESERVE STAGE 1 TEMP PAVEMENT MARKINGS FOR SUB-STAGE 1 USE.

N. CARILLON DRIVE/GRAND BOULEVARD

CONSTRUCTION

INSTALL STAGE 1 EROSION CONTROL, TEMP SIGNS, ACTIVATE TEMP SIGNALS, SAWCUT AND REMOVE EX PAVEMENT AND APPURTENANCES REQUIRED TO CONSTRUCT PR WESTBOUND PAVEMENT, TEMP PAVEMENT ADJACENT WITHIN THE PR BARRIER MEDIAN AREAS FOR STAGING PURPOSES. CONSTRUCT PR WESTBOUND LANES, NORTHERN HALF OF THE PR MEDIANS, AND THE REMAINING SIDEWALK (ALONG THE NORTH SIDE OF THE EAST LEG) AND THE PR ADA RAMPS AT THE FAIR MEADOW DR AS SHOWN IN THE ADA RAMP DETAILS.

TRAFFIC

TRAFFIC SHIFTS TO THE SOUTH UTILIZING EX AND TEMP PAVEMENT TO PROVIDE AT LEAST ONE EASTBOUND AND ONE WESTBOUND THROUGH AND LEFT TURN LANES AND AN EASTBOUND RIGHT TURN LANE. CONTRACTOR SHALL PROVIDE ACCESS TO FAIR MEADOWS DRIVE AND THE CARILLON GUARD HOUSE AT ALL TIMES. CONTRACTOR SHALL PRESERVE STAGE 1 TEMP PAVEMENT MARKINGS FOR SUB-STAGE 1 USE.

SUB-STAGE 1

WEBER ROAD

CONSTRUCTION

ADJUST THE TEMP SIGNAL HEADS AND TEMP SIGNS, SAWCUT AND REMOVE EX AND TEMP PAVEMENT AND APPURTENANCES REQUIRED TO CONSTRUCT THE PR SOUTHWEST CORNER PAVEMENT OF BOTH INTERSECTIONS AND ADA RAMPS.

TRAFFIC

USE STAGE 1 TRAFFIC CONFIGURATION AND ADJUST THE STOP BAR LOCATIONS AND THE AFFECTED LANE LINES AT THE INTERSECTIONS. CONTRACTOR SHALL PRESERVE SUB-STAGE 1 TEMP PAVEMENT MARKINGS FOR STAGE 2 USE.

ROMEO ROAD/135TH STREET

TRAFFIC (WEST LEG)

TRAFFIC WILL SHIFT TO THE NORTH ONTO THE NEWLY CONSTRUCTED WESTBOUND PAVEMENT MAINTAINING ONE LANE IN EACH DIRECTION AND ACCESS TO ALL DRIVEWAYS AND PARKING LOTS. SUB-STAGE 1 LANE CONFIGURATION IS ALMOST IDENTICAL TO STAGE 2 LANE CONFIGURATION; CONTRACTOR IS TO PRESERVE THESE TEMP PAVEMENT MARKINGS FOR STAGE 2 USE.

TRAFFIC (EAST LEG)

TRAFFIC WILL SHIFT TO THE NORTH ONTO THE NEWLY CONSTRUCTED WESTBOUND PAVEMENT MAINTAINING AT LEAST ONE EASTBOUND LANE, ONE WESTBOUND SHARED LANE, AND A WESTBOUND LEFT TURN LANE. CONTRACTOR IS TO MAINTAIN COMMERCIAL ENTRANCES ACCESS AT ALL TIMES. SUB-STAGE 1 LANE CONFIGURATION IS ALMOST IDENTICAL TO STAGE 2 LANE CONFIGURATION; CONTRACTOR IS TO PRESERVE THESE TEMP PAVEMENT MARKINGS FOR STAGE 2 USE.

N. CARILLON DRIVE/GRAND BOULEVARD

TRAFFIC (WEST LEG)

TRAFFIC WILL SHIFT TO THE NORTH ONTO THE NEWLY CONSTRUCTED WESTBOUND PAVEMENT MAINTAINING AT LEAST ONE EASTBOUND SHARED LANE, EASTBOUND LEFT TURN LANE, AND ONE WESTBOUND THROUGH LANE. CONTRACTOR SHALL PROVIDE ACCESS TO THE PRIVATE CARILLON GUARD HOUSE AND THE COMMERCIAL ACCESS ROAD AT ALL TIMES. SUB-STAGE 1 LANE CONFIGURATION IS ALMOST IDENTICAL TO STAGE 2 LANE CONFIGURATION; CONTRACTOR IS TO PRESERVE THESE TEMP PAVEMENT MARKINGS FOR STAGE 2 USE.

TRAFFIC (EAST LEG)

TRAFFIC WILL SHIFT TO THE NORTH ONTO NEWLY CONSTRUCTED WESTBOUND PAVEMENT TO PROVIDE ONE SHARED WESTBOUND LANE AND AN EASTBOUND THROUGH LANE. CONTRACTOR IS TO MAINTAIN ACCESS TO FAIR MEADOW DRIVE AT ALL TIMES. SUB-STAGE 1 LANE CONFIGURATION IS ALMOST IDENTICAL TO STAGE 2 LANE CONFIGURATION; CONTRACTOR IS TO PRESERVE THESE TEMP PAVEMENT MARKINGS FOR STAGE 2 USE.

PRE-STAGE 2

WEBER ROAD

CONSTRUCTION

ADJUST THE TEMP SIGNAL HEADS AND TEMP SIGNS, SAWCUT AND REMOVE EX AND TEMP PAVEMENT AND APPURTENANCES REQUIRED TO CONSTRUCT THE PR NORTHEAST CORNER PAVEMENT OF BOTH INTERSECTIONS. RELOCATE TEMP CONC BARRIER WALL AS NEEDED.

TRAFFIC

TRAFFIC WILL SHIFT TO THE WEST TO UTILIZE THE NEWLY CONSTRUCTED SOUTHBOUND PAVEMENT AND TEMP PAVEMENT. CONTRACTOR IS TO PROVIDE TWO LANES IN EACH DIRECTION, AT A MINIMUM, WITH EXCLUSIVE LEFT TURN LANES, BUT NO EXCLUSIVE RIGHT TURN LANES. ALL COMMERCIAL ENTRANCE ACCESS SHALL BE MAINTAINED AT ALL TIMES.

ROMEO ROAD/135TH STREET

TRAFFIC

ADJUST TEMP SIGNAL HEADS AND SHIFT TRAFFIC BACK TO THE SOUTH TO UTILIZE MOST OF THE STAGE 1 TEMP PAVEMENT MARKINGS. CONTRACTOR IS TO REPLACE ANY DAMAGED, MISSING, OR CONFLICTING MARKINGS AS PROPOSED IN THE STAGING SHEETS. COMMERCIAL ENTRANCE ACCESS SHALL BE MAINTAINED AT ALL TIMES.

N. CARILLON DRIVE/GRAND BOULEVARD

TRAFFIC

ADJUST TEMP SIGNAL HEADS AND SHIFT TRAFFIC BACK TO THE SOUTH TO UTILIZE MOST OF THE STAGE 1 TEMP PAVEMENT MARKINGS. CONTRACTOR IS TO REPLACE ANY DAMAGED, MISSING, OR CONFLICTING MARKINGS AS PROPOSED IN THE STAGING SHEETS. ACCESS TO THE CARILLON GUARD HOUSE, COMMERCIAL ACCESS ROAD, AND FAIR MEADOW DRIVE SHALL BE MAINTAINED AT ALL TIMES.

STAGE 2

WEBER ROAD

CONSTRUCTION

INSTALL STAGE 2 EROSION CONTROL, ADJUST TEMP TRAFFIC SIGNALS AND TEMP SIGNS, SAWCUT AND REMOVE EX PAVEMENT AND APPURTENANCES REQUIRED TO REMOVE TEMP PAVEMENT FROM PRE-STAGE AND REMAINING EX PAVEMENT, REMOVE EX DRAINAGE STRUCTURES, REMOVE AND REPLACE REMAINING EASTERN HALF OF CULVERT WITH PR CULVERT, CONSTRUCT THE PR NORTHBOUND PAVEMENT, CURB & GUTTER, DRAINAGE STRUCTURES, FINALIZE PR DETENTION GRADING, SIDEWALK, CURB & GUTTER REPLACEMENT AT STA 753+00 (RT) AND RETAINING WALL NEAR N. CARILLON/GRAND INTERSECTION.

TRAFFIC

USE PRE-STAGE 2 TRAFFIC CONFIGURATION AND ADJUST THE STOP BAR LOCATIONS AT THE INTERSECTIONS AND THE AFFECTED LANE LINES TO AS SHOWN IN THE STAGE 2 MOT SHEETS.

ROMEO ROAD/135TH STREET

CONSTRUCTION

INSTALL STAGE 2 EROSION CONTROL, ADJUST THE TEMP TRAFFIC SIGNAL HEADS AND TEMP SIGNS, SAWCUT AND REMOVE THE TEMP PAVEMENT FROM PRE-STAGE AND REMAINING EX PAVEMENT, REMOVE EX DRAINAGE STRUCTURES, CONSTRUCT PR EASTBOUND PAVEMENT, CURB & GUTTER, PART OF THE PR RAISED CURB MEDIAN, DRAINAGE STRUCTURES, AND THE PR SIDEWALK AND ADA RAMPS.

TRAFFIC

USE SUB-STAGE 1 TRAFFIC CONFIGURATION AND ADJUST THE STOP BAR LOCATIONS AND THE AFFECTED LANE LINES TO REFLECT THE STAGE 2 MOT SHEETS.

N. CARILLON DRIVE/GRAND BOULEVARD

CONSTRUCTION

INSTALL STAGE 2 EROSION CONTROL, ADJUST THE TEMP TRAFFIC SIGNAL HEADS AND SIGNS, SAWCUT AND REMOVE THE TEMP PAVEMENT FROM PRE-STAGE AND REMAINING EX PAVEMENT, REMOVE EX DRAINAGE STRUCTURES, CONSTRUCT PR EASTBOUND PAVEMENT, CURB & GUTTER, SOUTHERN HALF OF THE PROPOSED MEDIANS, AND THE SIDEWALK ALONG THE SOUTH SIDE OF THE EAST LEG.

TRAFFIC

USE SUB-STAGE 1 TRAFFIC CONFIGURATION AND ADJUST THE STOP BAR LOCATIONS AND THE AFFECTED LANE LINES TO REFLECT THE STAGE 2 MOT SHEETS.

STAGE 3

WEBER ROAD

CONSTRUCTION

INSTALL THE TEMP SIGNAL HEADS AND TEMP SIGNS, SAWCUT AND REMOVE TEMP PAVEMENT AND APPURTENANCES REQUIRED TO CONSTRUCT THE REMAINING OF THE PR RAISED BARRIER MEDIANS (CONCRETE AND LANDSCAPED) AND THE PROPOSED LEFT TURN LANES. REPLACE THE TEMP PAVEMENT ON THE WEST SIDE NEAR THE LILY CACHE SLOUGH WITH THE PR CURB & GUTTER, SHARED-USE PATH, AND FINAL GRADING.

TRAFFIC

ADJUST BOTH NORTHBOUND AND SOUTHBOUND TRAFFIC FROM STAGE 2 BY PROVIDING A BUFFER ON BOTH THE WEST AND EAST SIDE OF THE PROPOSED RAISED MEDIANS. USE LANE CLOSURES ALONG THE PROPOSED LEFT TURN LANES FOLLOWING IDOT STANDARDS.

ROMEO ROAD/135TH STREET

CONSTRUCTION

ADJUST THE TEMP SIGNAL HEADS AND TEMP SIGNS, SAWCUT AND REMOVE TEMP PAVEMENT AND APPURTENANCES REQUIRED TO CONSTRUCT THE REMAINING OF THE PR RAISED CONCRETE MEDIAN ON THE EAST LEG AND THE PR CURB & GUTTER ON THE WEST LEG NEAR THE BP GAS STATION.

TRAFFIC

TRAFFIC IS SHIFTED AWAY FROM THE PR MEDIAN WHERE THE CONTRACTOR IS TO PROVIDE AT LEAST ONE LANE IN EACH DIRECTION AND PROVIDE EXCLUSIVE TURN LANES AS SHOWN IN PLANS.

N. CARILLON DRIVE/GRAND BOULEVARD


CONSTRUCTION

ADJUST THE TEMP SIGNAL HEADS AND TEMP SIGNS, SAWCUT AND REMOVE TEMP PAVEMENT AND APPURTENANCES REQUIRED TO COMPLETE ANY REMAINING LANDSCAPING WITHIN THE PR MEDIANS. CONSTRUCT THE PR MEDIAN NEAR THE CARILLON GATE HOUSE AND AT THE GRAND BLVD AND FAIR MEADOW DRIVE INTERSECTION. MILL & RESURFACE (STA 238+60 TO 240+31) AS SHOWN IN ROADWAY P&P.

TRAFFIC

TRAFFIC IS SHIFTED AWAY FROM THE PR MEDIANS WHERE THE CONTRACTOR IS TO PROVIDE AT LEAST ONE LANE IN EACH DIRECTION AND PROVIDE EXCLUSIVE TURN LANES AS SHOWN IN PLANS. CONTRACTOR TO USE IDOT STANDARDS (DAY-TIME CLOSURES) TO COMPLETE THE MILLING & RESURFACING OPERATIONS.

FILE NAME = DIBX11-ah-t-staging02.dgn

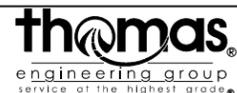

USER NAME = TEG	DESIGNED - RO	REVISED - 3/3/2015
	DRAWN - JBH	REVISED - 6/19/2015
PLOT SCALE = 2.0000' / in.	CHECKED - CRC	REVISED - 9/27/2016
PLOT DATE = 11/14/2017	DATE - 11/15/17	REVISED -

**STATE OF ILLINOIS
DEPARTMENT OF TRANSPORTATION**





**MAINTENANCE OF TRAFFIC
SUGGESTED SEQUENCE OF CONSTRUCTION**

SCALE: SHEET 1 OF 2 SHEETS STA. TO STA.

F.A.P. RTE.	SECTION	COUNTY	TOTAL SHEETS	SHEET NO.
856	14-00170-42-RP	WILL	394	80
				CONTRACT NO. 61D47
ILLINOIS FED. AID PROJECT				

WEBER ROAD

WEBER ROAD LOOKING NORTH (TYP)

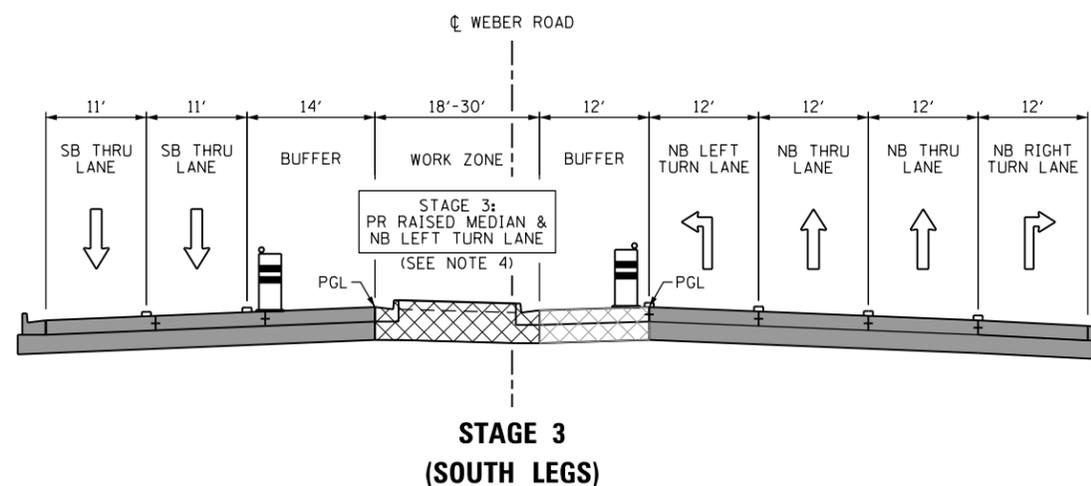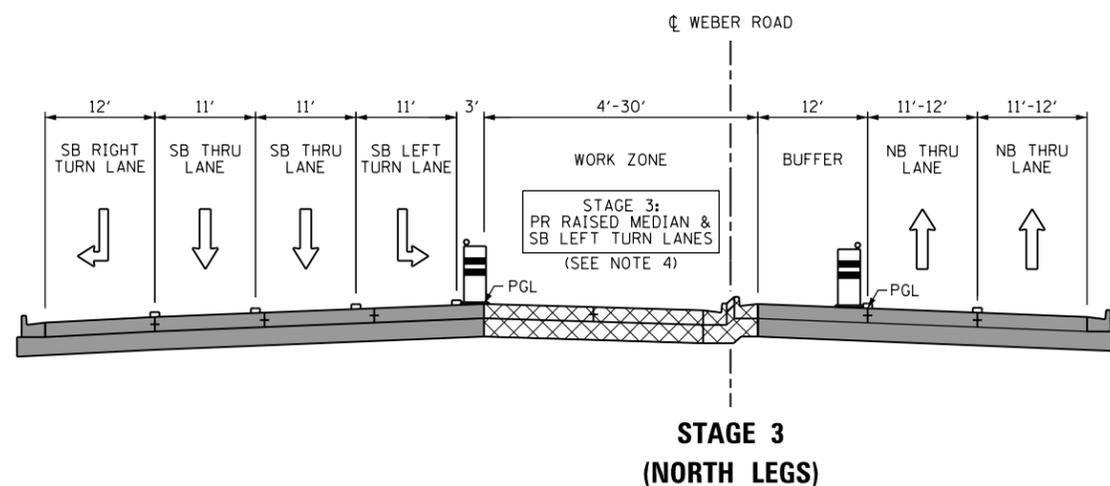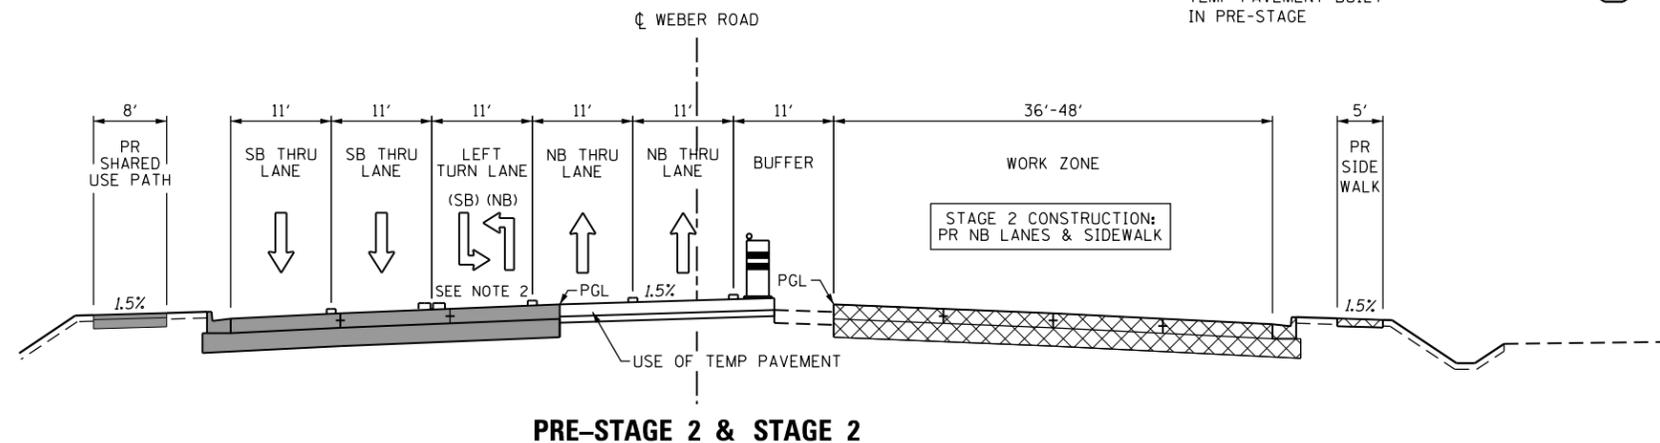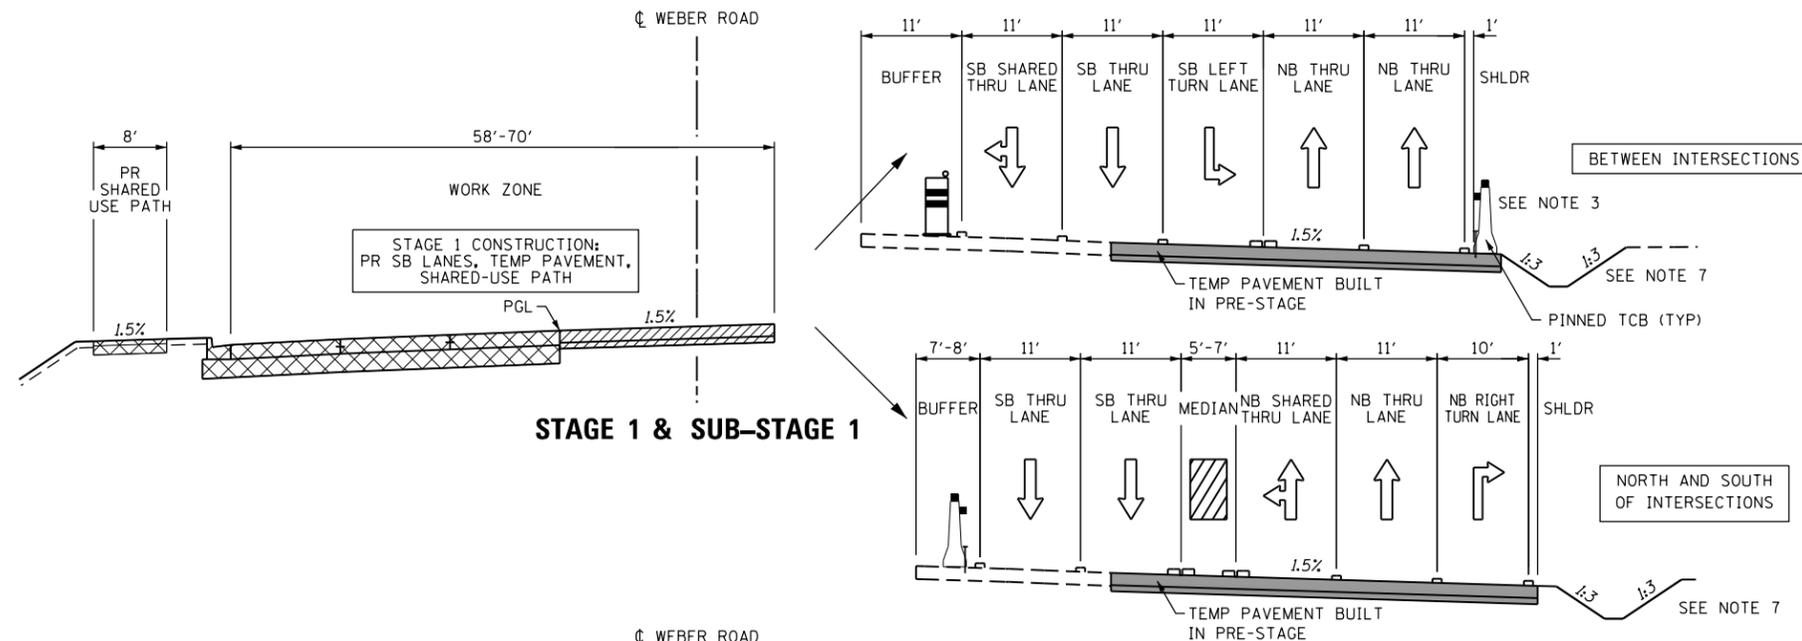

MOT TYPICALS LEGEND

- EX GROUND/PAVEMENT
- [Cross-hatched] PR PAVEMENT IN WORK ZONE
- [Diagonal lines] PR TEMP PAVEMENT IN WORK ZONE
- [Solid grey] CONSTRUCTED IN PREVIOUS STAGE
- [Cylinder with arrow] DRUM WITH STEADY BURN MONODIRECTIONAL LIGHT
- [Vertical panel with arrow] VERTICAL PANEL WITH STEADY BURNING LIGHT ON TRAFFIC SIDE
- [Triangle with arrow] TEMP CONCRETE BARRIER WITH CRYSTAL WALL MARKER AT 25' C-C
- [Square with dot] OR [Square] TEMP PAVEMENT MARKING


GENERAL NOTES

1. CONTRACTOR IS TO ADD OR REMOVE PAVEMENT MARKINGS AS SHOWN IN PLANS WHERE DIFFERENCES OCCUR BETWEEN THE MOT.
2. THIS LEFT TURN LANE IS NOT A SHARED LEFT TURN LANE. EACH LEG WILL PROVIDE AN EXCLUSIVE LEFT TURN LANE AS SHOWN IN PLANS. THE LANE WAS SHOWN AS SUCH FOR VISUAL PURPOSES.
3. THE TEMP CONCRETE BARRIER NEEDED IN BETWEEN THE INTERSECTIONS ON THE EAST SIDE OF WEBER ROAD IS TO BE PINNED (ON THE TRAFFIC SIDE) TO THE TEMP PAVEMENT. CONTRACTOR IS TO FOLLOW IDOT STANDARD 704001 FOR GUIDANCE ON THE ANCHOR PINS AND REFLECTIVE MARKERS.
4. THE BUFFER ZONE ENDS AT STA 745+32. CONTRACTOR IS TO FOLLOW IDOT STANDARD 701421 TO CONSTRUCT THE MEDIAN AREAS SOUTH OF STA 745+32.
5. REFER TO MOT PLAN SHEETS FOR INFORMATION ON TEMPORARY PAVEMENT MARKING TYPES, SIZES, AND COLOR.
6. PRE-STAGE WORK INCLUDES THE CONSTRUCTION OF MOST OF THE PROPOSED DETENTION BASIN AND THE COMPENSATORY STORAGE BASIN AS SHOWN IN THE STAGING CROSS SECTIONS.
7. REFER TO STAGING 1 SHEETS FOR TEMPORARY DRAINAGE (PRE-STAGE AND STAGE 1) FLOW.

TEMPORARY HOT-MIX ASPHALT MIXTURE

ROADWAY	MIXTURE TYPE	AIR VOIDS
WEBER RD	HMA SURFACE COURSE, MIX "D", N50, 2"	4% @ 50 Gyr.
	HMA BASE COURSE (HMA BINDER, IL-19.0, N50, 8")	4% @ 50 Gyr.
135TH ST ROMEO RD GRAND BLVD N. CARILLON DR	HMA SURFACE COURSE, MIX "D", N50, 2"	4% @ 50 Gyr.
	HMA BASE COURSE (HMA BINDER, IL-19.0, N50, 6")	4% @ 50 Gyr.

- THE UNIT WEIGHT USED TO CALCULATE ALL HMA MIXTURES IS 112 LBS/SQ YD/IN
- FOR USE OF RECYCLED MATERIALS SEE DISTRICT ONE DETAIL SPECIAL PROVISIONS.
- ALTERNATE TEMPORARY PAVEMENT
- PC CONCRETE TEMPORARY PAVEMENT SHALL CONSIST OF PV CONCRETE MEETING THE REQUIREMENTS OF ARTICLE 1020 OF THE STANDARD SPECIFICATIONS, 8" THICK. TEMPORARY PCC PAVEMENT DOES NOT REQUIRE DOWEL BARS.

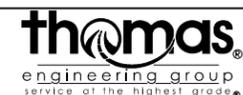

USER NAME = TEG	DESIGNED - RO	REVISED - 3/3/2015
	DRAWN - JBH	REVISED - 6/19/2015
PLOT SCALE = 20.0000' / in.	CHECKED - CRC	REVISED - 9/27/2016
PLOT DATE = 11/14/2017	DATE - 11/15/17	REVISED -

STATE OF ILLINOIS
DEPARTMENT OF TRANSPORTATION

MAINTENANCE OF TRAFFIC - TYPICAL SECTIONS
WEBER ROAD

SCALE: NTS SHEET 1 OF 4 SHEETS STA. TO STA.

F.A.P. RTE.	SECTION	COUNTY	TOTAL SHEETS	SHEET NO.
856	14-00170-42-RP	WILL	394	81
CONTRACT NO. 61D47				
ILLINOIS FED. AID PROJECT				

FILE NAME = D:\B\11-sht-staging\064.dgn

WEBER ROAD AT LILY CACHE SLOUGH

MOT TYPICALS LEGEND

- EX GROUND/PAVEMENT
-  PR PAVEMENT IN WORK ZONE
-  PR TEMP PAVEMENT IN WORK ZONE
-  CONSTRUCTED IN PREVIOUS STAGE
-  DRUM WITH STEADY BURN MONODIRECTIONAL LIGHT
-  VERTICAL PANEL WITH STEADY BURNING LIGHT ON TRAFFIC SIDE
-  TEMP CONCRETE BARRIER WITH CRYSTAL WALL MARKER AT 25' C-C
-  TEMP PAVEMENT MARKING

GENERAL NOTES





- CONTRACTOR IS TO ADD OR REMOVE PAVEMENT MARKINGS AS SHOWN IN PLANS WHERE DIFFERENCES OCCUR BETWEEN THE MOT.
- THIS LEFT TURN LANE IS NOT A SHARED LEFT TURN LANE. EACH LEG WILL PROVIDE AN EXCLUSIVE LEFT TURN LANE AS SHOWN IN PLANS. THE LANE WAS SHOWN AS SUCH FOR VISUAL PURPOSES.
- THE TEMP CONCRETE BARRIER NEEDED IN BETWEEN THE INTERSECTIONS ON THE EAST SIDE OF WEBER ROAD IS TO BE PINNED (ON THE TRAFFIC SIDE) TO THE TEMP PAVEMENT. CONTRACTOR IS TO FOLLOW IDOT STANDARD 704001 FOR GUIDANCE ON THE ANCHOR PINS AND REFLECTIVE MARKERS.
- THE BUFFER ZONE ENDS AT STA 745+32. CONTRACTOR IS TO FOLLOW IDOT STANDARD 701421 TO CONSTRUCT THE MEDIAN AREAS SOUTH OF STA 745+32.
- REFER TO MOT PLAN SHEETS FOR INFORMATION ON TEMPORARY PAVEMENT MARKING TYPES, SIZES, AND COLOR.
- PRE-STAGE WORK INCLUDES THE CONSTRUCTION OF MOST OF THE PROPOSED DETENTION BASIN AND THE COMPENSATORY STORAGE BASIN AS SHOWN IN THE STAGING CROSS SECTIONS.
- REFER TO STAGING 1 SHEETS FOR TEMPORARY DRAINAGE (PRE-STAGE AND STAGE 1) FLOW.

TEMPORARY HOT-MIX ASPHALT MIXTURE

ROADWAY	MIXTURE TYPE	AIR VOIDS
WEBER RD	HMA SURFACE COURSE, MIX "D", N50, 2"	4% @ 50 Gyr.
	HMA BASE COURSE (HMA BINDER, IL-19.0, N50, 8")	4% @ 50 Gyr.
135TH ST ROMEO RD GRAND BLVD N. CARILLON DR	HMA SURFACE COURSE, MIX "D", N50, 2"	4% @ 50 Gyr.
	HMA BASE COURSE (HMA BINDER, IL-19.0, N50, 6")	4% @ 50 Gyr.

- THE UNIT WEIGHT USED TO CALCULATE ALL HMA MIXTURES IS 112 LBS/SQ YD/IN
- FOR USE OF RECYCLED MATERIALS SEE DISTRICT ONE DETAIL SPECIAL PROVISIONS.
- ALTERNATE TEMPORARY PAVEMENT
- PC CONCRETE TEMPORARY PAVEMENT SHALL CONSIST OF PV CONCRETE MEETING THE REQUIREMENTS OF ARTICLE 1020 OF THE STANDARD SPECIFICATIONS, 8" THICK. TEMPORARY PCC PAVEMENT DOES NOT REQUIRE DOWEL BARS.

WEBER ROAD LOOKING NORTH (TYP)

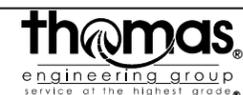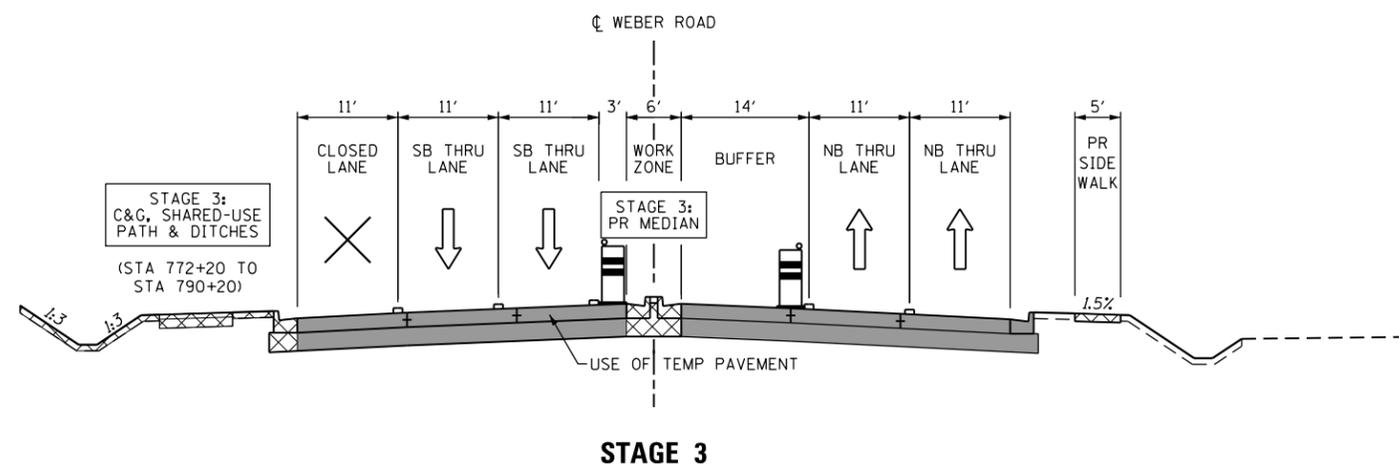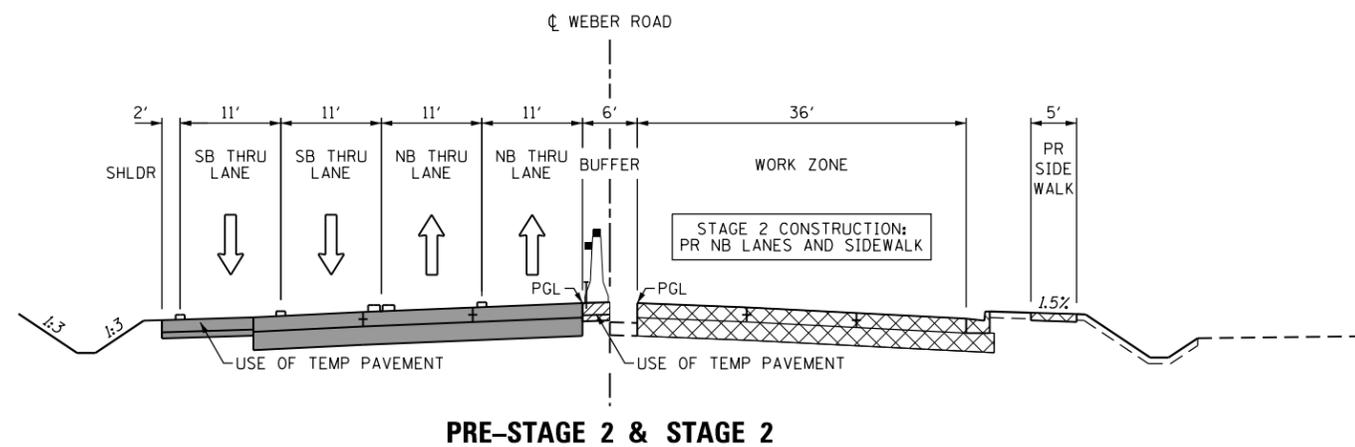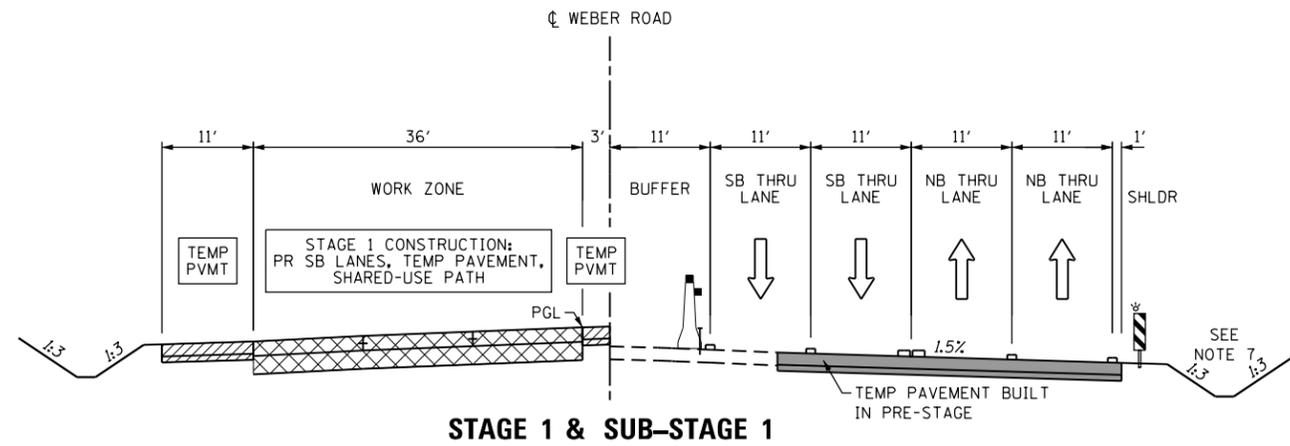

USER NAME = TEG	DESIGNED - RO	REVISED - 3/3/2015
	DRAWN - JBH	REVISED - 6/19/2015
PLOT SCALE = 20.0000' / in.	CHECKED - CRC	REVISED - 9/27/2016
PLOT DATE = 11/14/2017	DATE - 11/15/17	REVISED -

STATE OF ILLINOIS
DEPARTMENT OF TRANSPORTATION

MAINTENANCE OF TRAFFIC - TYPICAL SECTIONS
WEBER ROAD AT LILY CACHE SLOUGH

SCALE: NTS SHEET 2 OF 4 SHEETS STA. TO STA.

F.A.P. RTE.	SECTION	COUNTY	TOTAL SHEETS	SHEET NO.
856	14-00170-42-RP	WILL	394	82
CONTRACT NO. 61D47				
ILLINOIS FED. AID PROJECT				

FILE NAME = D:\B\11-11-17-staging\084.dgn

ROMEO / 135TH AT WEBER RD

MOT TYPICALS LEGEND

- EX GROUND/PAVEMENT
- [Cross-hatched] PR PAVEMENT IN WORK ZONE
- [Diagonal lines] PR TEMP PAVEMENT IN WORK ZONE
- [Solid grey] CONSTRUCTED IN PREVIOUS STAGE
- [Cylinder with light] DRUM WITH STEADY BURN MONODIRECTIONAL LIGHT
- [Vertical panel with light] VERTICAL PANEL WITH STEADY BURNING LIGHT ON TRAFFIC SIDE
- [Barrier with marker] TEMP CONCRETE BARRIER WITH CRYSTAL WALL MARKER AT 25' C-C
- [Square] OR [Circle] TEMP PAVEMENT MARKING

GENERAL NOTES

1. CONTRACTOR IS TO ADD OR REMOVE PAVEMENT MARKINGS AS SHOWN IN PLANS WHERE DIFFERENCES OCCUR BETWEEN THE MOT.
2. REFER TO MOT PLAN SHEETS FOR INFORMATION ON TEMPORARY PAVEMENT MARKING TYPES, SIZES, AND COLOR.
3. PRE-STAGE WORK INCLUDES THE CONSTRUCTION OF MOST OF THE PROPOSED DETENTION BASIN AND THE COMPENSATORY STORAGE BASIN AS SHOWN IN THE STAGING CROSS SECTIONS.
4. REFER TO STAGING 1 SHEETS FOR TEMPORARY DRAINAGE (PRE-STAGE AND STAGE 1) FLOW.


TEMPORARY HOT-MIX ASPHALT MIXTURE

ROADWAY	MIXTURE TYPE	AIR VOIDS
WEBER RD	HMA SURFACE COURSE, MIX "D", N50, 2"	4% @ 50 Gyr.
	HMA BASE COURSE (HMA BINDER, IL-19.0, N50, 8")	4% @ 50 Gyr.
135TH ST ROMEO RD GRAND BLVD N. CARILLON DR	HMA SURFACE COURSE, MIX "D", N50, 2"	4% @ 50 Gyr.
	HMA BASE COURSE (HMA BINDER, IL-19.0, N50, 6")	4% @ 50 Gyr.


- THE UNIT WEIGHT USED TO CALCULATE ALL HMA MIXTURES IS 112 LBS/SQ YD/IN
 - FOR USE OF RECYCLED MATERIALS SEE DISTRICT ONE DETAIL SPECIAL PROVISIONS.
 - ALTERNATE TEMPORARY PAVEMENT
 PC CONCRETE TEMPORARY PAVEMENT SHALL CONSIST OF PV CONCRETE MEETING THE REQUIREMENTS OF ARTICLE 1020 OF THE STANDARD SPECIFICATIONS, 8" THICK. TEMPORARY PCC PAVEMENT DOES NOT REQUIRE DOWEL BARS.

WEST LEG


LOOKING EAST (TYP)

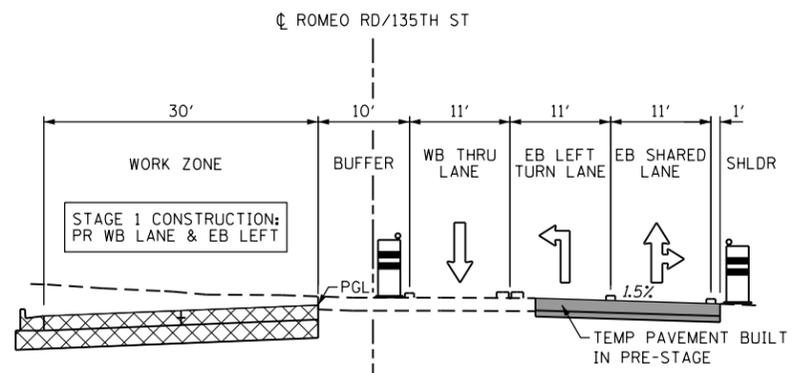

STAGE 1 & PRE-STAGE 2

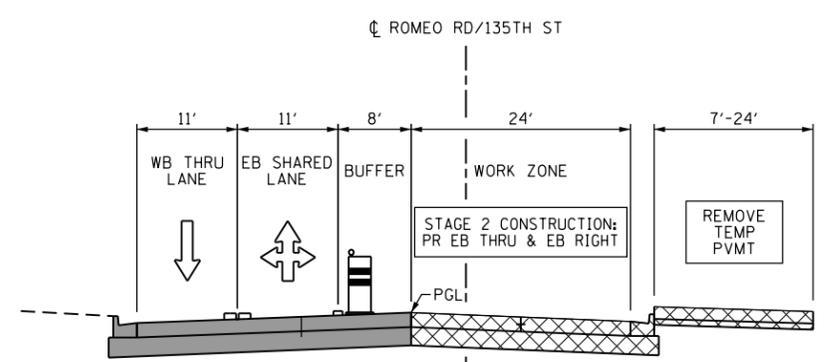


SUB-STAGE 1 & STAGE 2

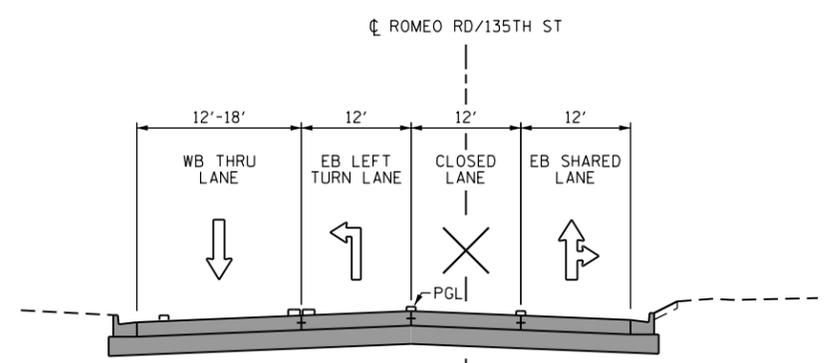


STAGE 3

EAST LEG


LOOKING EAST (TYP)

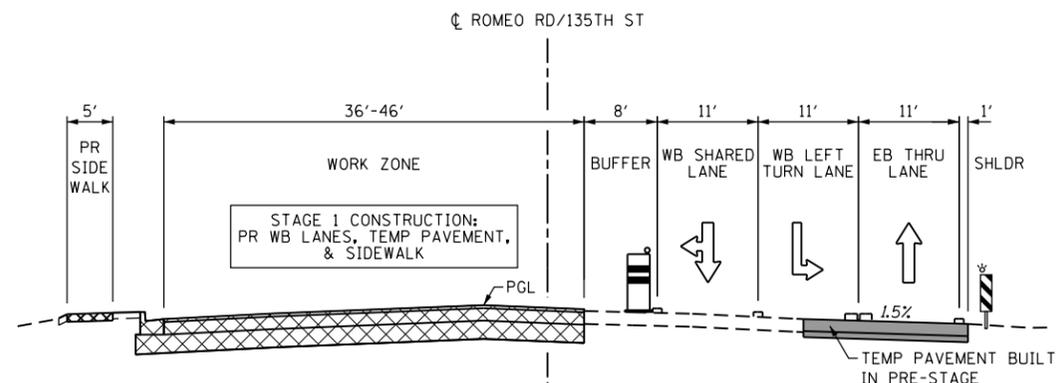

STAGE 1 & PRE-STAGE 2

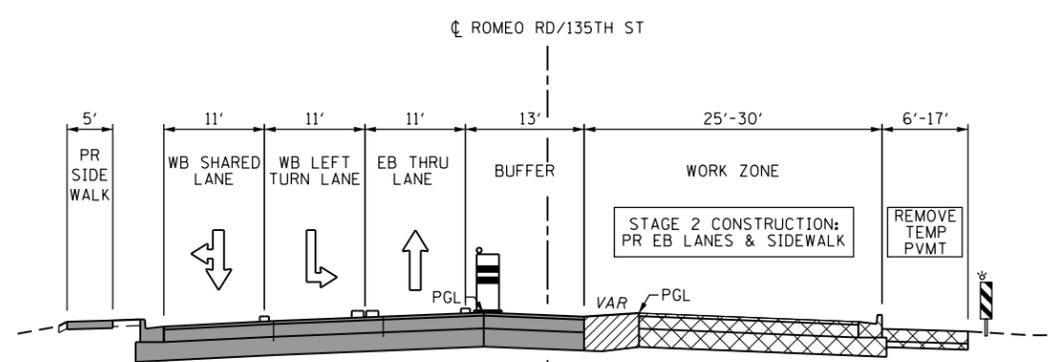

SUB-STAGE 1 & STAGE 2

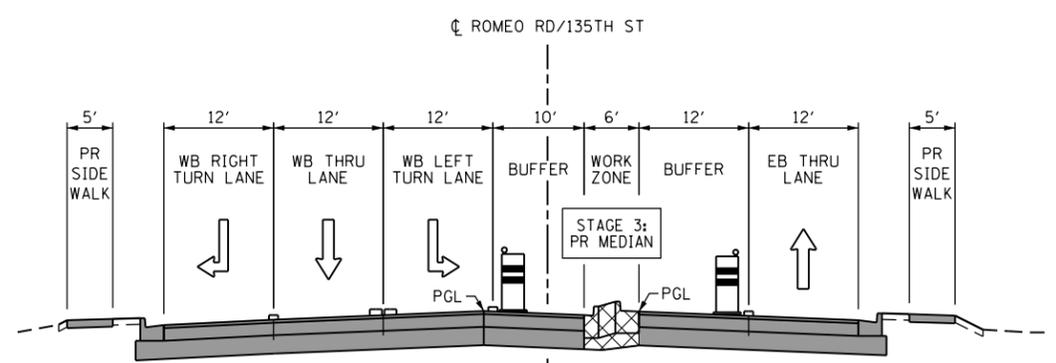

STAGE 3

FILE NAME = D:\B\11-11-15-17-staging\064.dgn



USER NAME = TEG	DESIGNED - RO	REVISED - 3/3/2015
	DRAWN - JBH	REVISED - 6/19/2015
PLOT SCALE = 20.0000' / in.	CHECKED - CRC	REVISED - 9/27/2016
PLOT DATE = 11/14/2017	DATE - 11/15/17	REVISED -

STATE OF ILLINOIS
DEPARTMENT OF TRANSPORTATION

MAINTENANCE OF TRAFFIC - TYPICAL SECTIONS
135TH STREET / ROMEO ROAD

SCALE: NTS SHEET 3 OF 4 SHEETS STA. TO STA.

F.A.P. RTE.	SECTION	COUNTY	TOTAL SHEETS	SHEET NO.
856	14-00170-42-RP	WILL	394	83
CONTRACT NO. 61D47				
ILLINOIS FED. AID PROJECT				

CARILLON / GRAND AT WEBER RD

MOT TYPICALS LEGEND

- EX GROUND/PAVEMENT
- PR PAVEMENT IN WORK ZONE
- PR TEMP PAVEMENT IN WORK ZONE
- CONSTRUCTED IN PREVIOUS STAGE
- DRUM WITH STEADY BURN MONODIRECTIONAL LIGHT
- VERTICAL PANEL WITH STEADY BURNING LIGHT ON TRAFFIC SIDE
- TEMP CONCRETE BARRIER WITH CRYSTAL WALL MARKER AT 25' C-C
- OR TEMP PAVEMENT MARKING

GENERAL NOTES


- CONTRACTOR IS TO ADD OR REMOVE PAVEMENT MARKINGS AS SHOWN IN PLANS WHERE DIFFERENCES OCCUR BETWEEN THE MOT.
- REFER TO MOT PLAN SHEETS FOR INFORMATION ON TEMPORARY PAVEMENT MARKING TYPES, SIZES, AND COLOR.
- PRE-STAGE WORK INCLUDES THE CONSTRUCTION OF MOST OF THE PROPOSED DETENTION BASIN AND THE COMPENSATORY STORAGE BASIN AS SHOWN IN THE STAGING CROSS SECTIONS.
- REFER TO STAGING 1 SHEETS FOR TEMPORARY DRAINAGE (PRE-STAGE AND STAGE 1) FLOW.

TEMPORARY HOT-MIX ASPHALT MIXTURE


ROADWAY	MIXTURE TYPE	AIR VOIDS
WEBER RD	HMA SURFACE COURSE, MIX "D", N50, 2"	4% @ 50 Gyr.
	HMA BASE COURSE (HMA BINDER, IL-19.0, N50, 8")	4% @ 50 Gyr.
135TH ST ROMEO RD GRAND BLVD N. CARILLON DR	HMA SURFACE COURSE, MIX "D", N50, 2"	4% @ 50 Gyr.
	HMA BASE COURSE (HMA BINDER, IL-19.0, N50, 6")	4% @ 50 Gyr.

- THE UNIT WEIGHT USED TO CALCULATE ALL HMA MIXTURES IS 112 LBS/SQ YD/IN
- FOR USE OF RECYCLED MATERIALS SEE DISTRICT ONE DETAIL SPECIAL PROVISIONS.
- ALTERNATE TEMPORARY PAVEMENT
- PC CONCRETE TEMPORARY PAVEMENT SHALL CONSIST OF PV CONCRETE MEETING THE REQUIREMENTS OF ARTICLE 1020 OF THE STANDARD SPECIFICATIONS, 8" THICK. TEMPORARY PCC PAVEMENT DOES NOT REQUIRE DOWEL BARS.


WEST LEG LOOKING EAST (TYP)

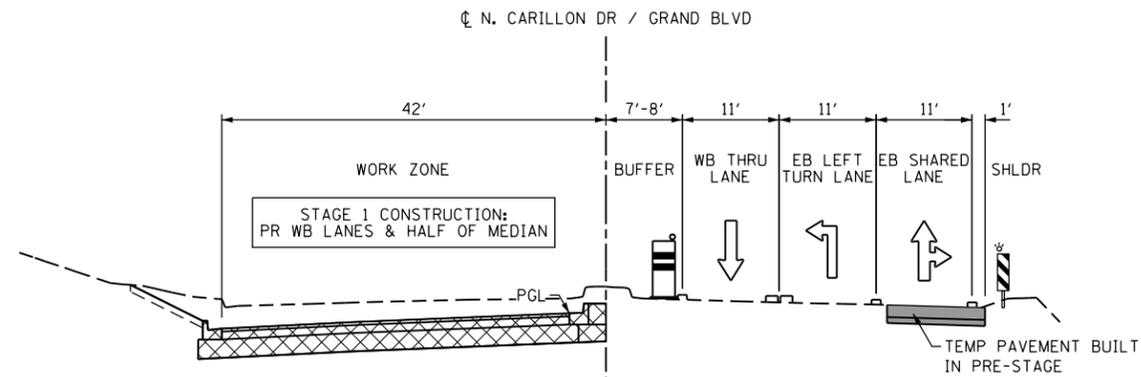

STAGE 1 & PRE-STAGE 2

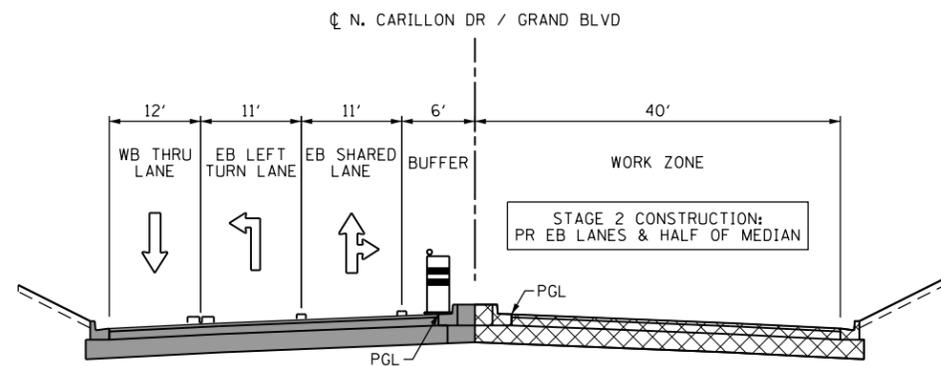


SUB-STAGE 1 & STAGE 2

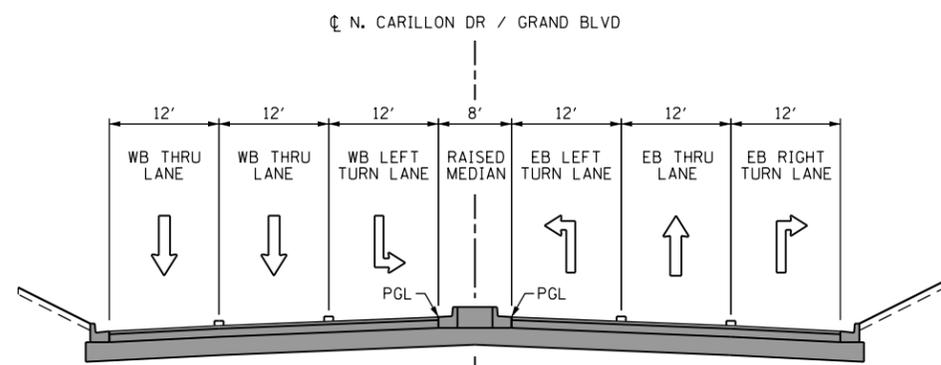


STAGE 3


EAST LEG LOOKING EAST (TYP)

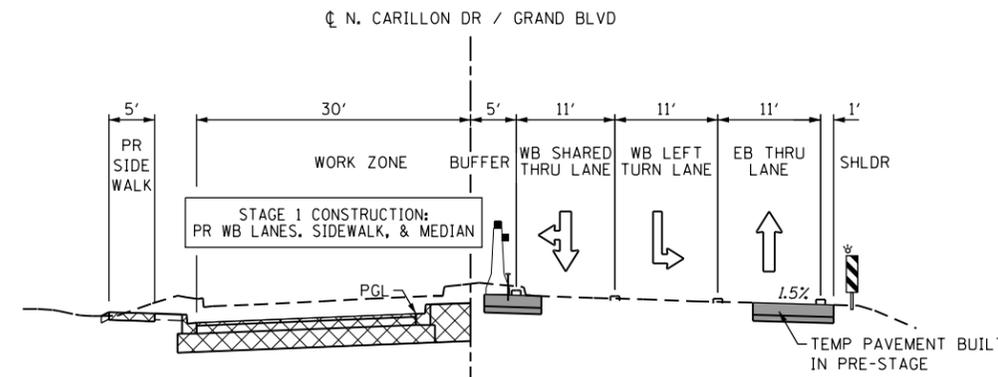

STAGE 1 & PRE-STAGE 2

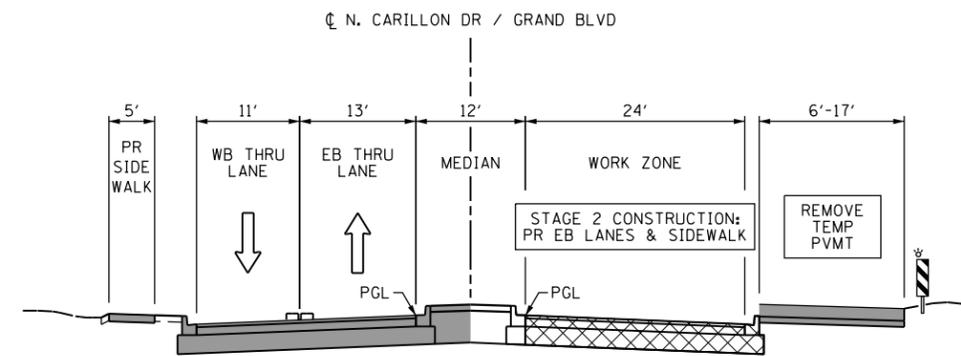

SUB-STAGE 1 & STAGE 2

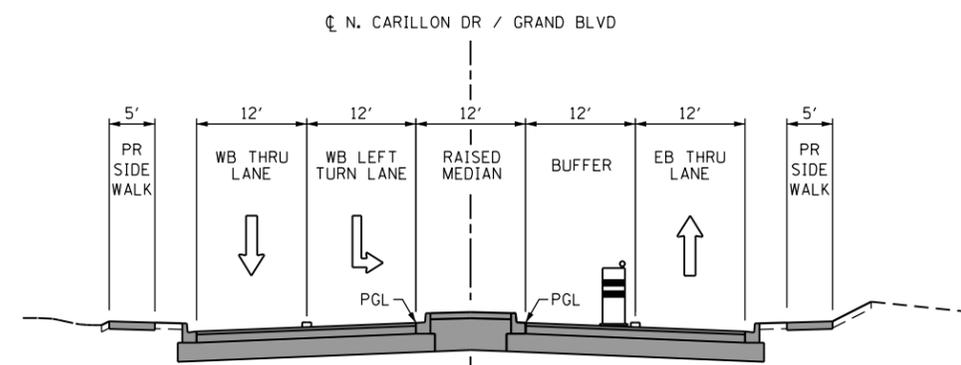

STAGE 3

STATE OF ILLINOIS
DEPARTMENT OF TRANSPORTATION

MAINTENANCE OF TRAFFIC - TYPICAL SECTIONS
N. CARILLON DRIVE / GRAND BOULEVARD


SCALE: NTS SHEET 4 OF 4 SHEETS STA. TO STA.

F.A.P. RTE.	SECTION	COUNTY	TOTAL SHEETS	SHEET NO.
856	14-00170-42-RP	WILL	394	84
CONTRACT NO. 61D47				
ILLINOIS FED. AID PROJECT				


thomas
engineering group
service at the highest grade

USER NAME = TEG	DESIGNED - RO	REVISED - 3/3/2015
	DRAWN - JBH	REVISED - 6/19/2015
PLOT SCALE = 20.0000' / in.	CHECKED - CRC	REVISED - 9/27/2016
PLOT DATE = 11/14/2017	DATE - 11/15/17	REVISED -

FILE NAME = D:\BX11-sht-staging\064.dgn

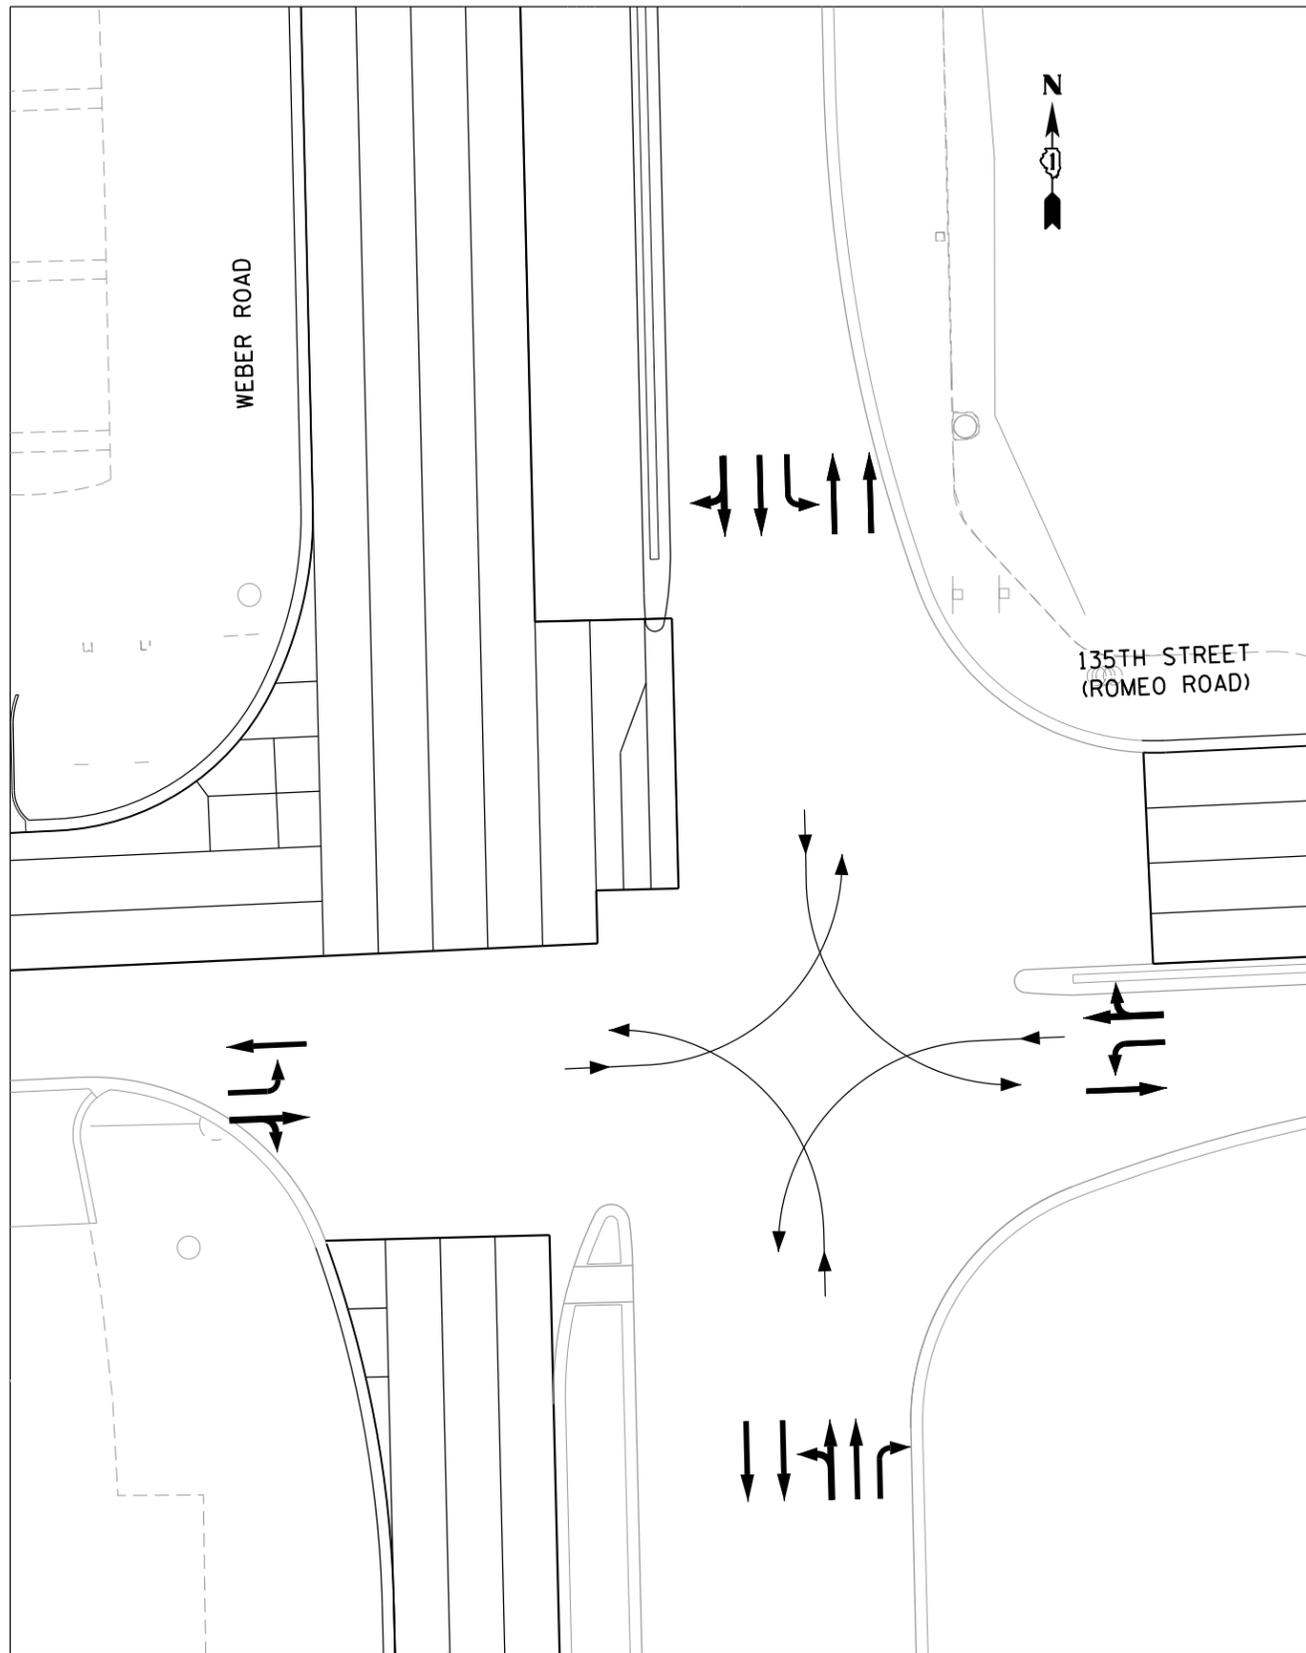

STAGE 1

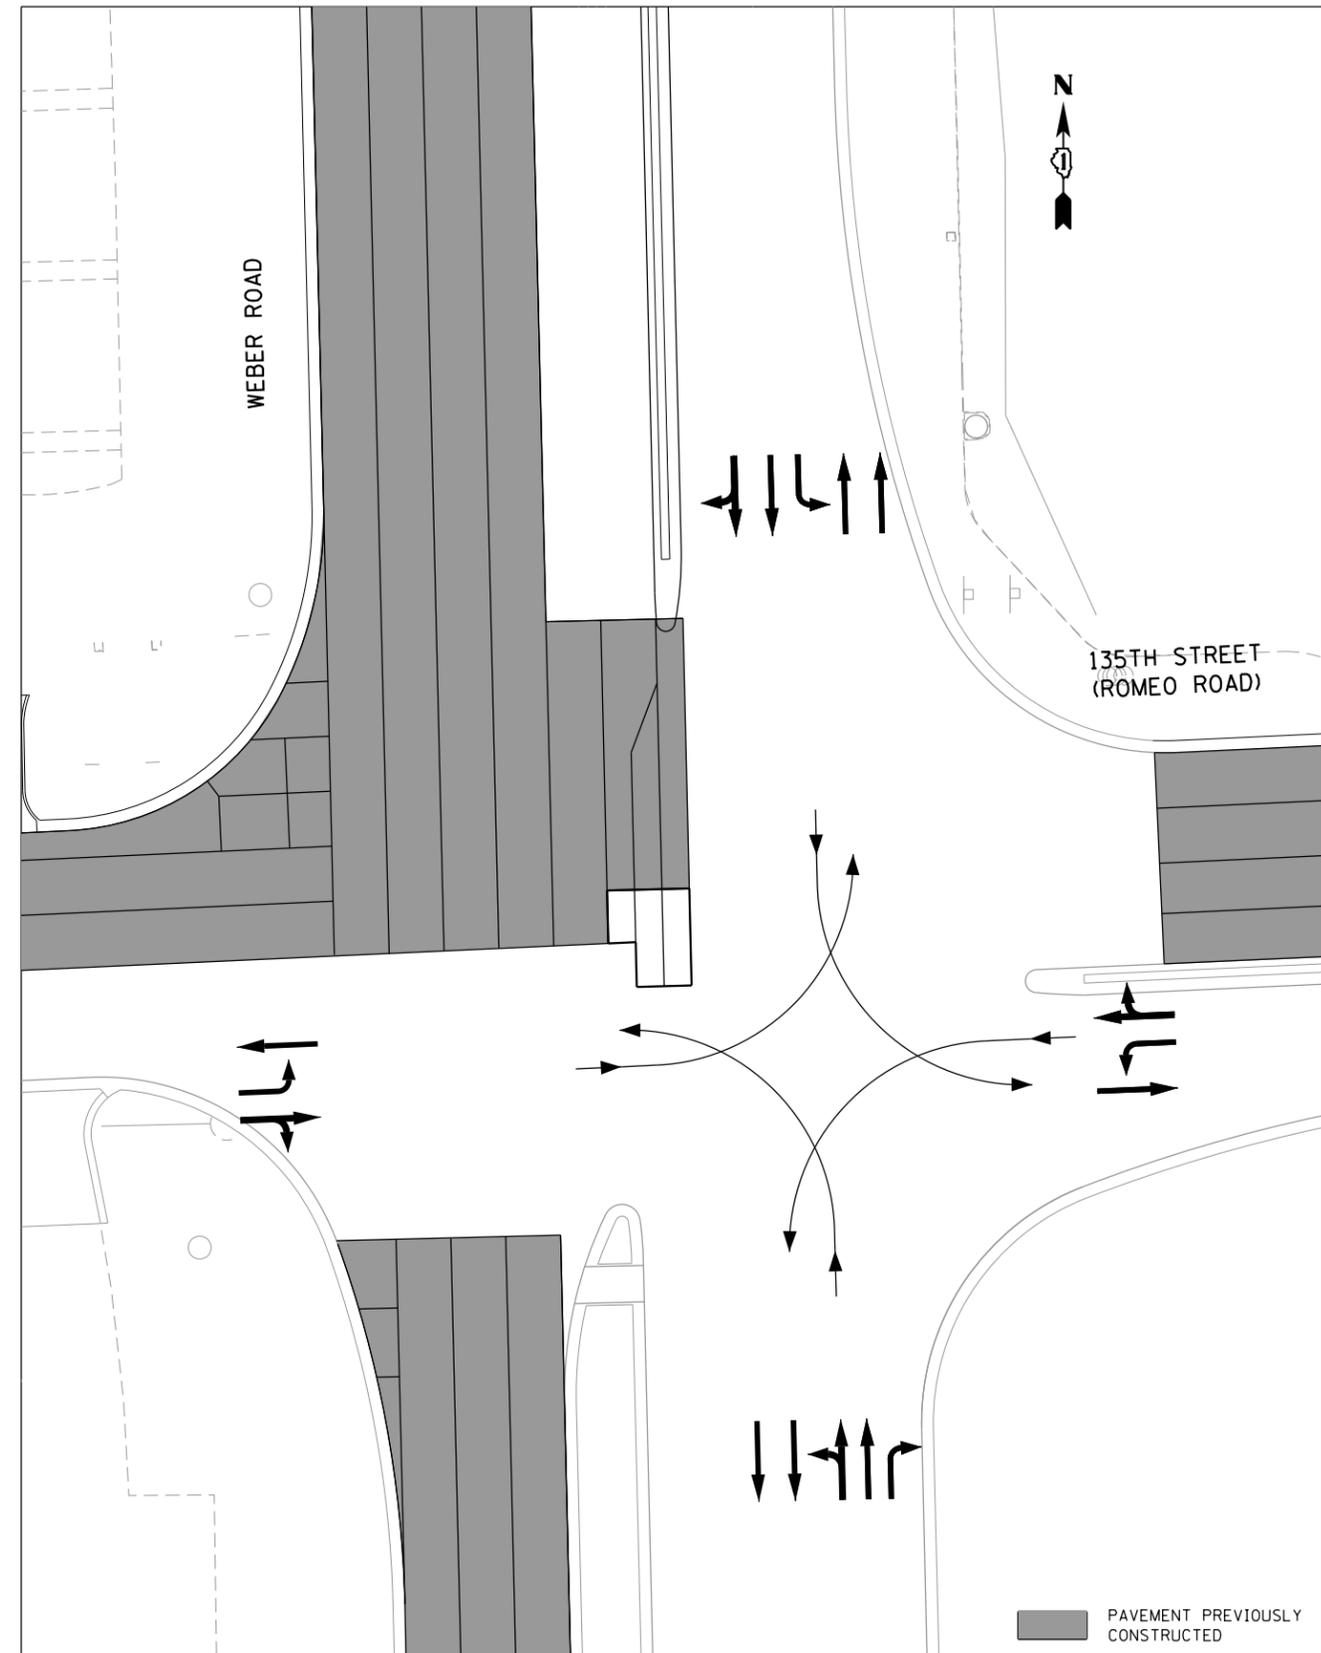

STAGE 1B

FILE NAME = D:\BX11-shc-intersec-mat-1.dgn




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PLOT DATE = 11/14/2017	DATE - 11/15/17	REVISED -

STATE OF ILLINOIS
DEPARTMENT OF TRANSPORTATION


MAINTENANCE OF TRAFFIC - INTERSECTION STAGING
135TH STREET / ROMEO ROAD

SCALE: N.T.S. SHEET 1 OF 8 SHEETS STA. TO STA.

F.A.P. RTE.	SECTION	COUNTY	TOTAL SHEETS	SHEET NO.
856	14-00170-42-RP	WILL	394	85
CONTRACT NO. 61D47				
ILLINOIS FED. AID PROJECT				

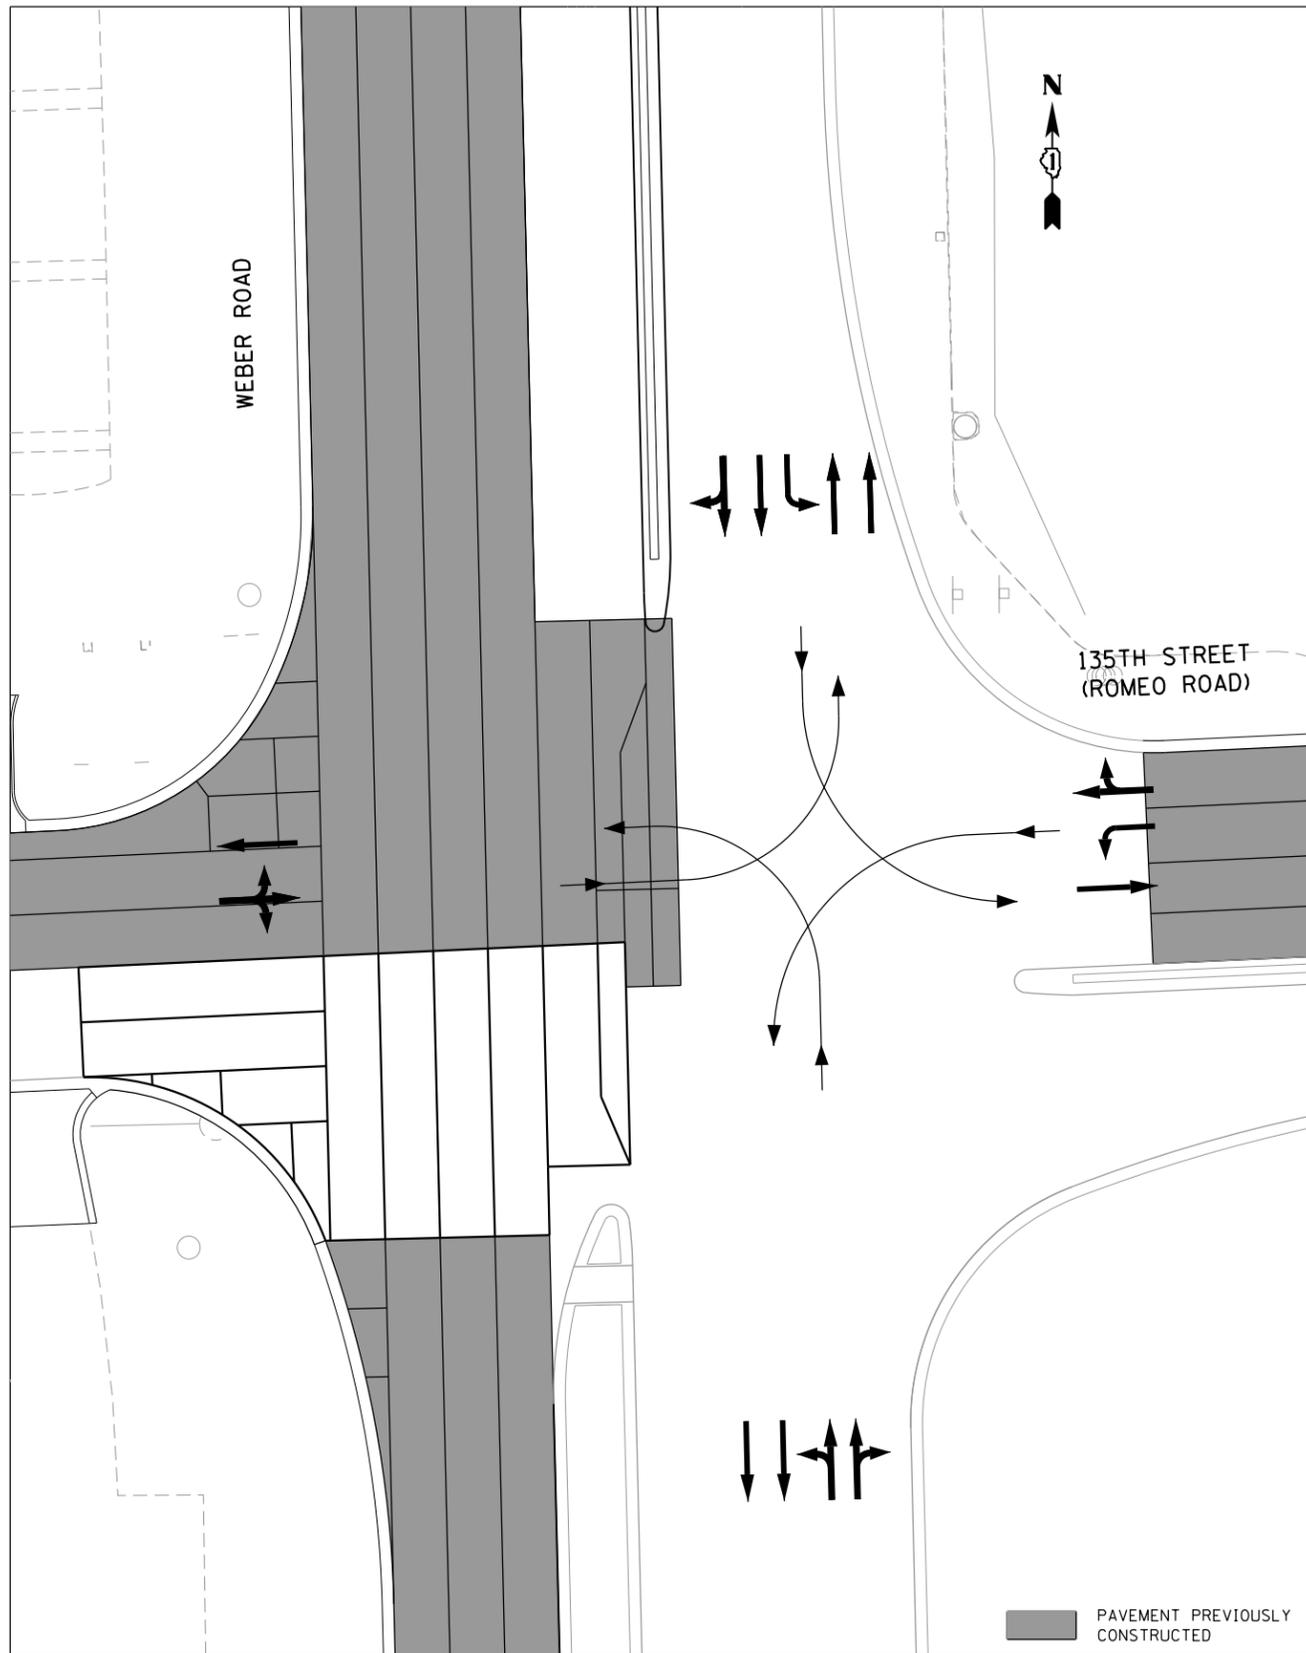


SUB-STAGE 1

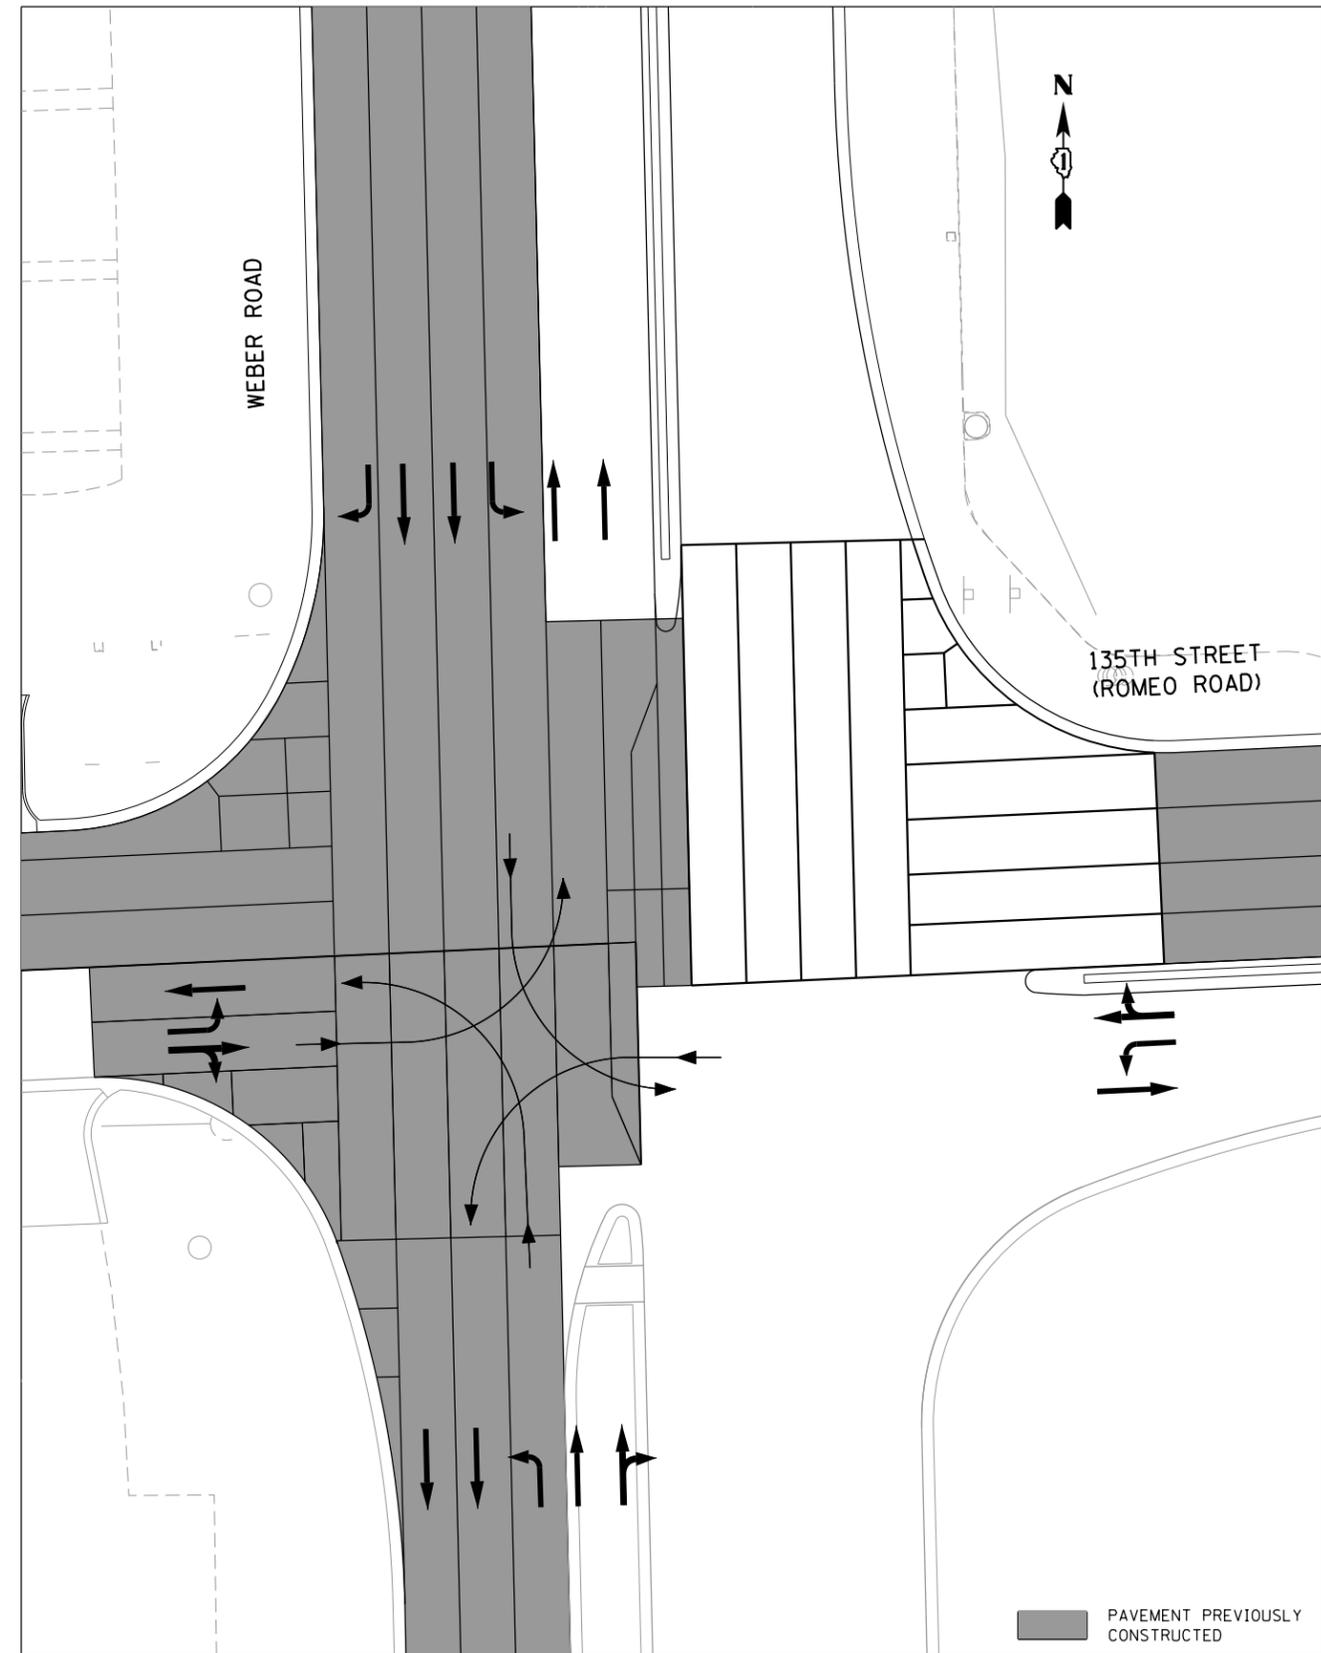

PRE-STAGE 2

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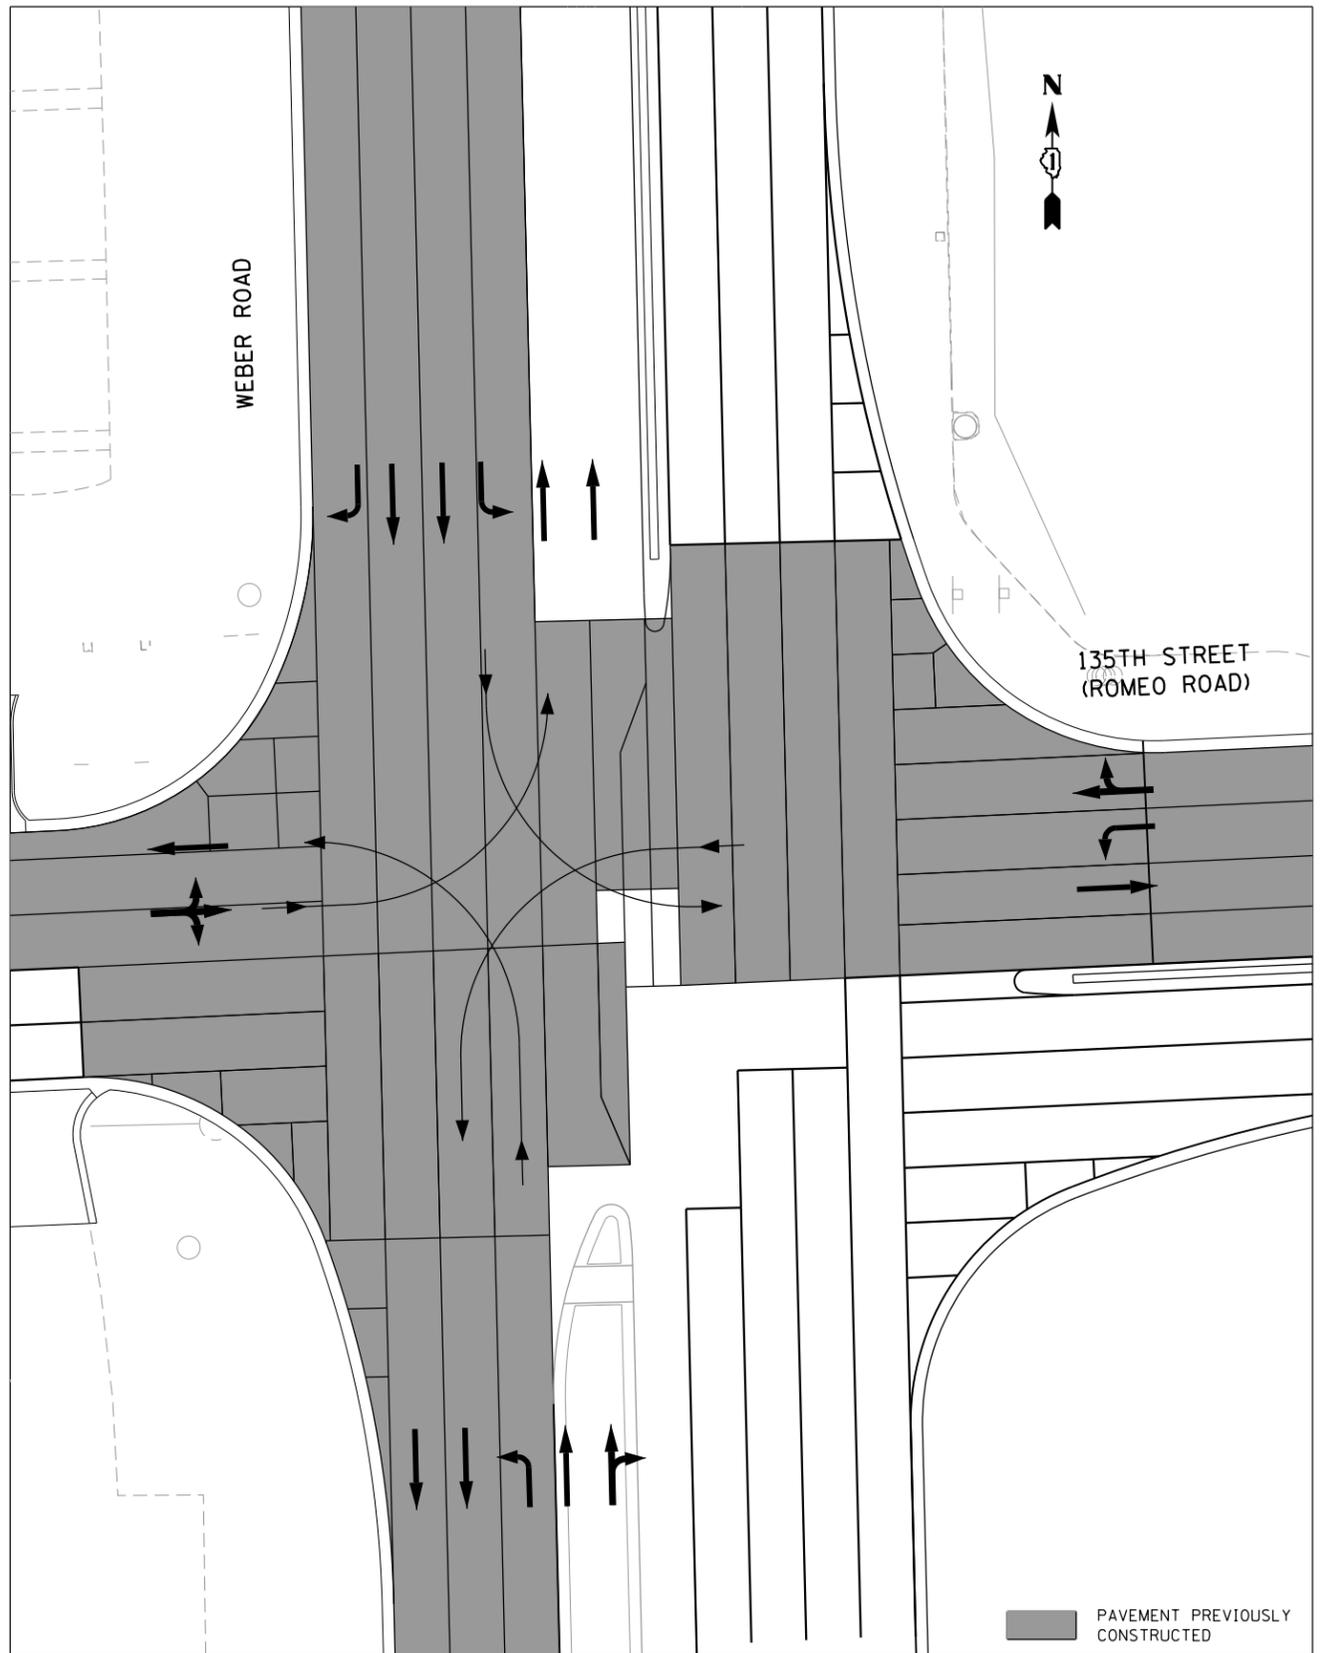
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	DRAWN -	REVISED - 6/19/2015
PLOT SCALE = 40.0000' / in.	CHECKED -	REVISED - 9/27/2016
PLOT DATE = 11/14/2017	DATE - 11/15/17	REVISED -

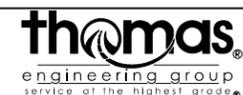**STATE OF ILLINOIS
DEPARTMENT OF TRANSPORTATION**


**MAINTENANCE OF TRAFFIC - INTERSECTION STAGING
135TH STREET / ROMEO ROAD**

SCALE: N.T.S. SHEET 2 OF 8 SHEETS STA. TO STA.

F.A.P. RTE.	SECTION	COUNTY	TOTAL SHEETS	SHEET NO.
856	14-00170-42-RP	WILL	394	86
CONTRACT NO. 61D47				
ILLINOIS FED. AID PROJECT				




STAGE 2

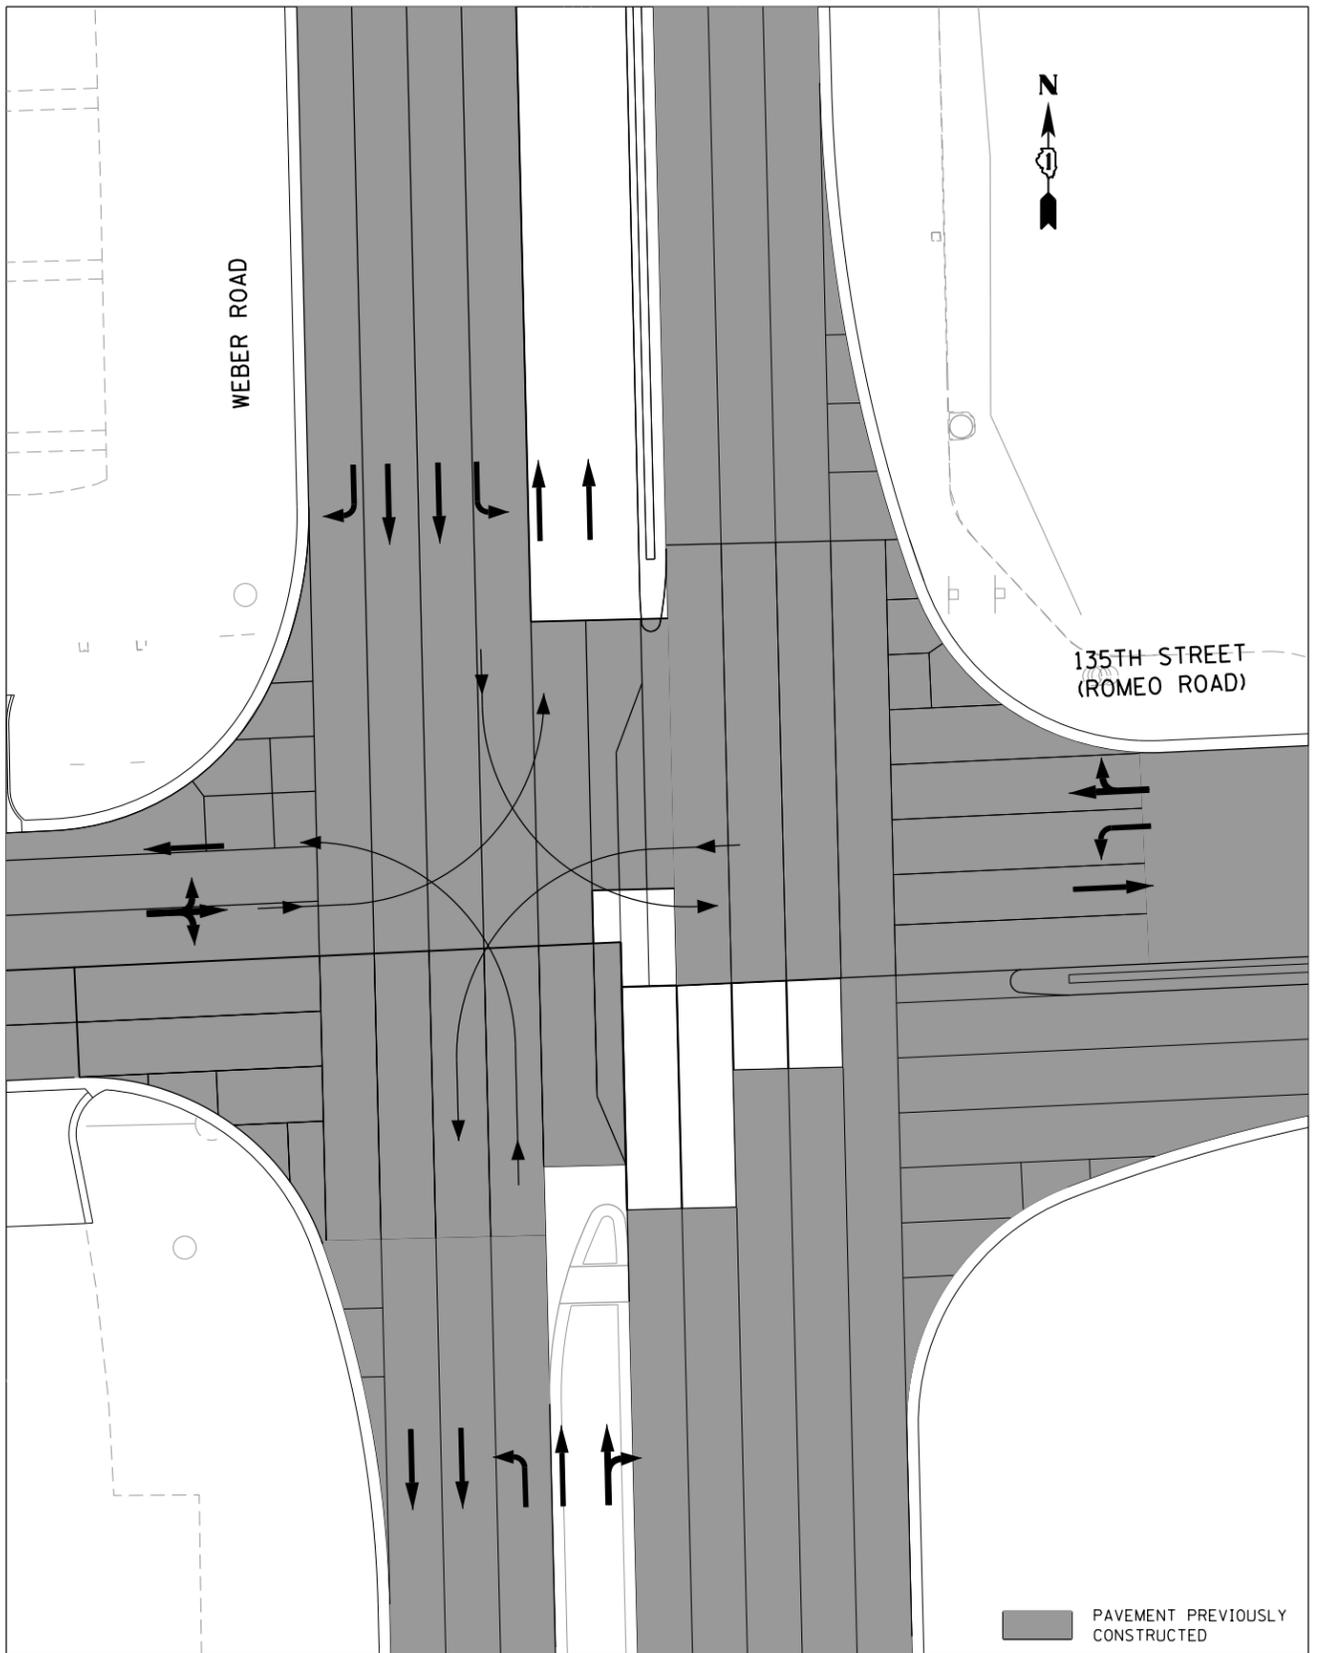

STAGE 2B

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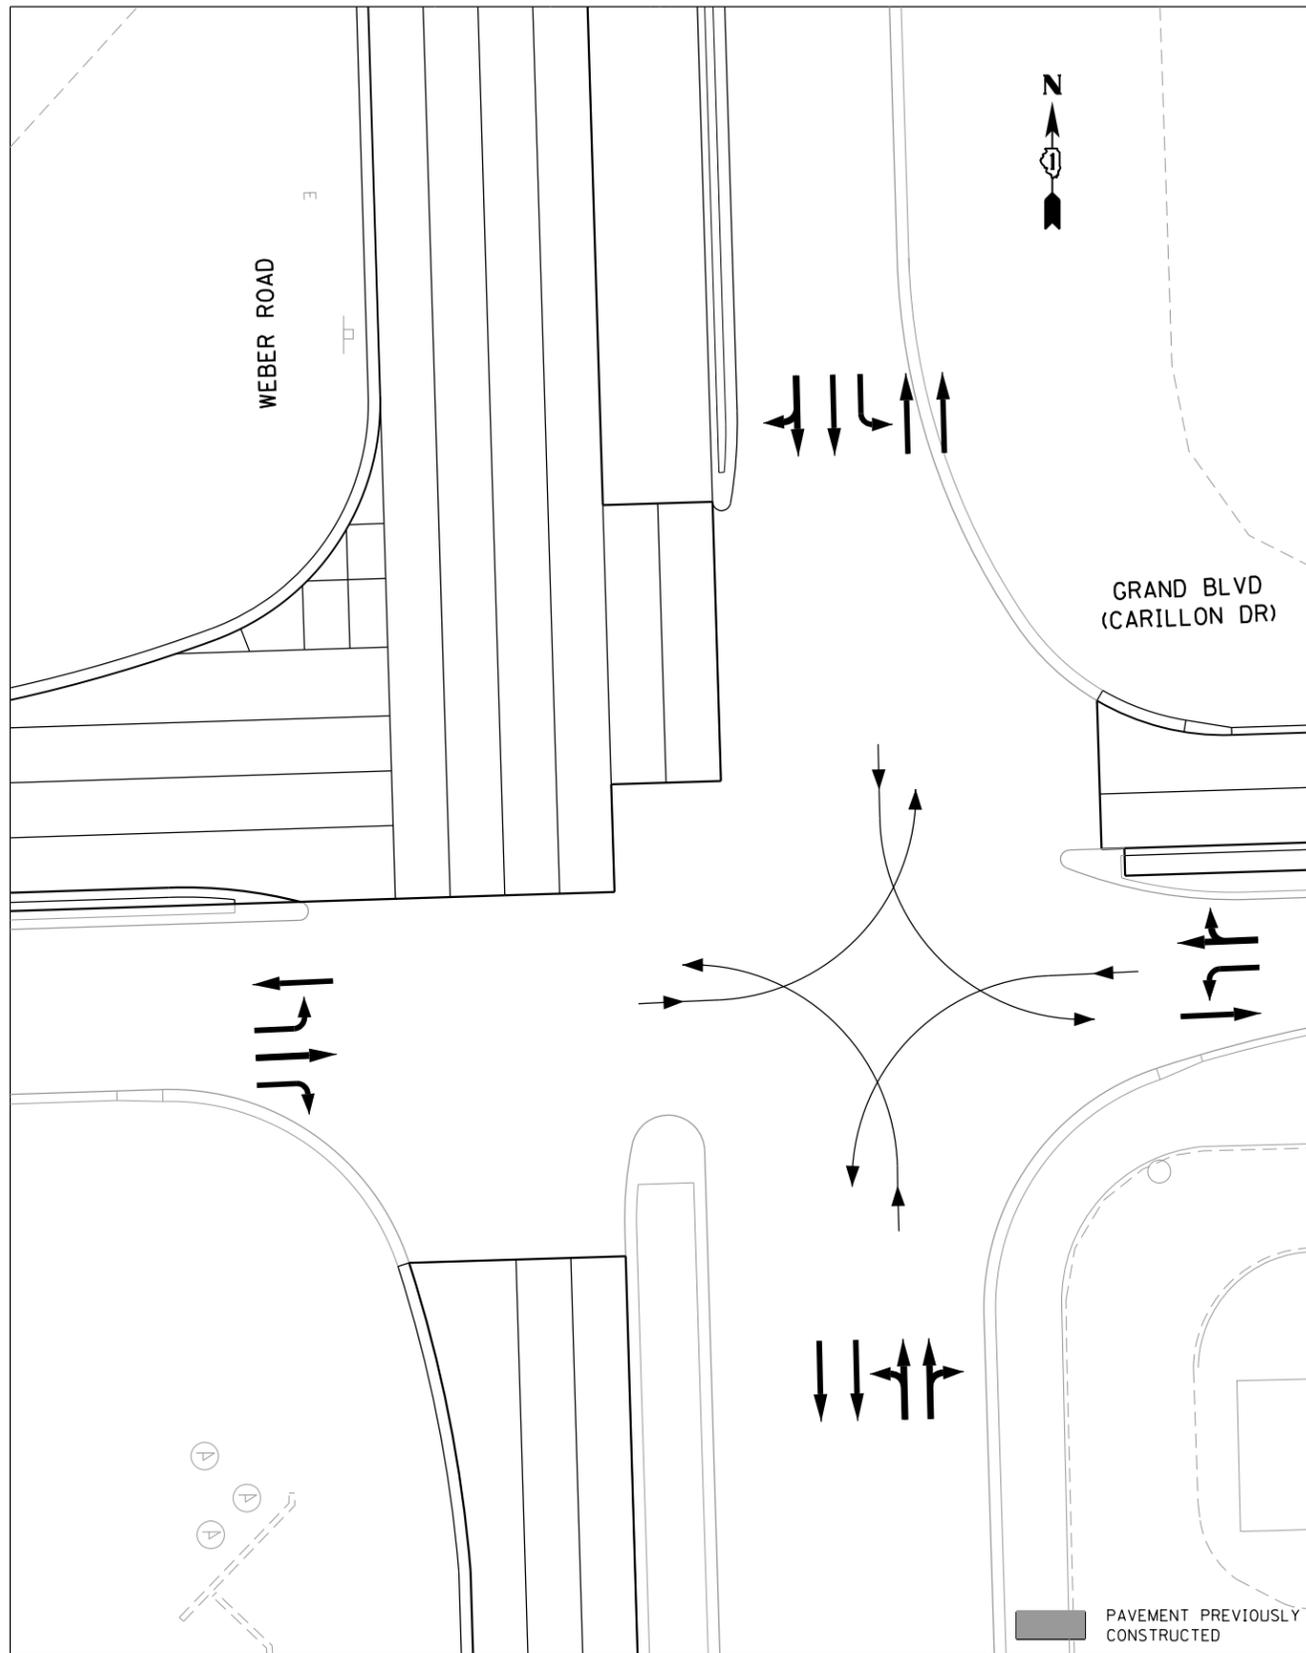
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	DRAWN -	REVISED - 6/19/2015
PLOT SCALE = 40.0000' / in.	CHECKED -	REVISED - 9/27/2016
PLOT DATE = 11/14/2017	DATE - 11/15/17	REVISED -

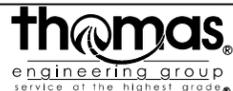STATE OF ILLINOIS
DEPARTMENT OF TRANSPORTATION


MAINTENANCE OF TRAFFIC - INTERSECTION STAGING
135TH STREET / ROMEO ROAD

SCALE: N.T.S. SHEET 3 OF 8 SHEETS STA. TO STA.

F.A.P. RTE.	SECTION	COUNTY	TOTAL SHEETS	SHEET NO.
856	14-00170-42-RP	WILL	394	87
CONTRACT NO. 61D47				
ILLINOIS FED. AID PROJECT				




STAGE 1

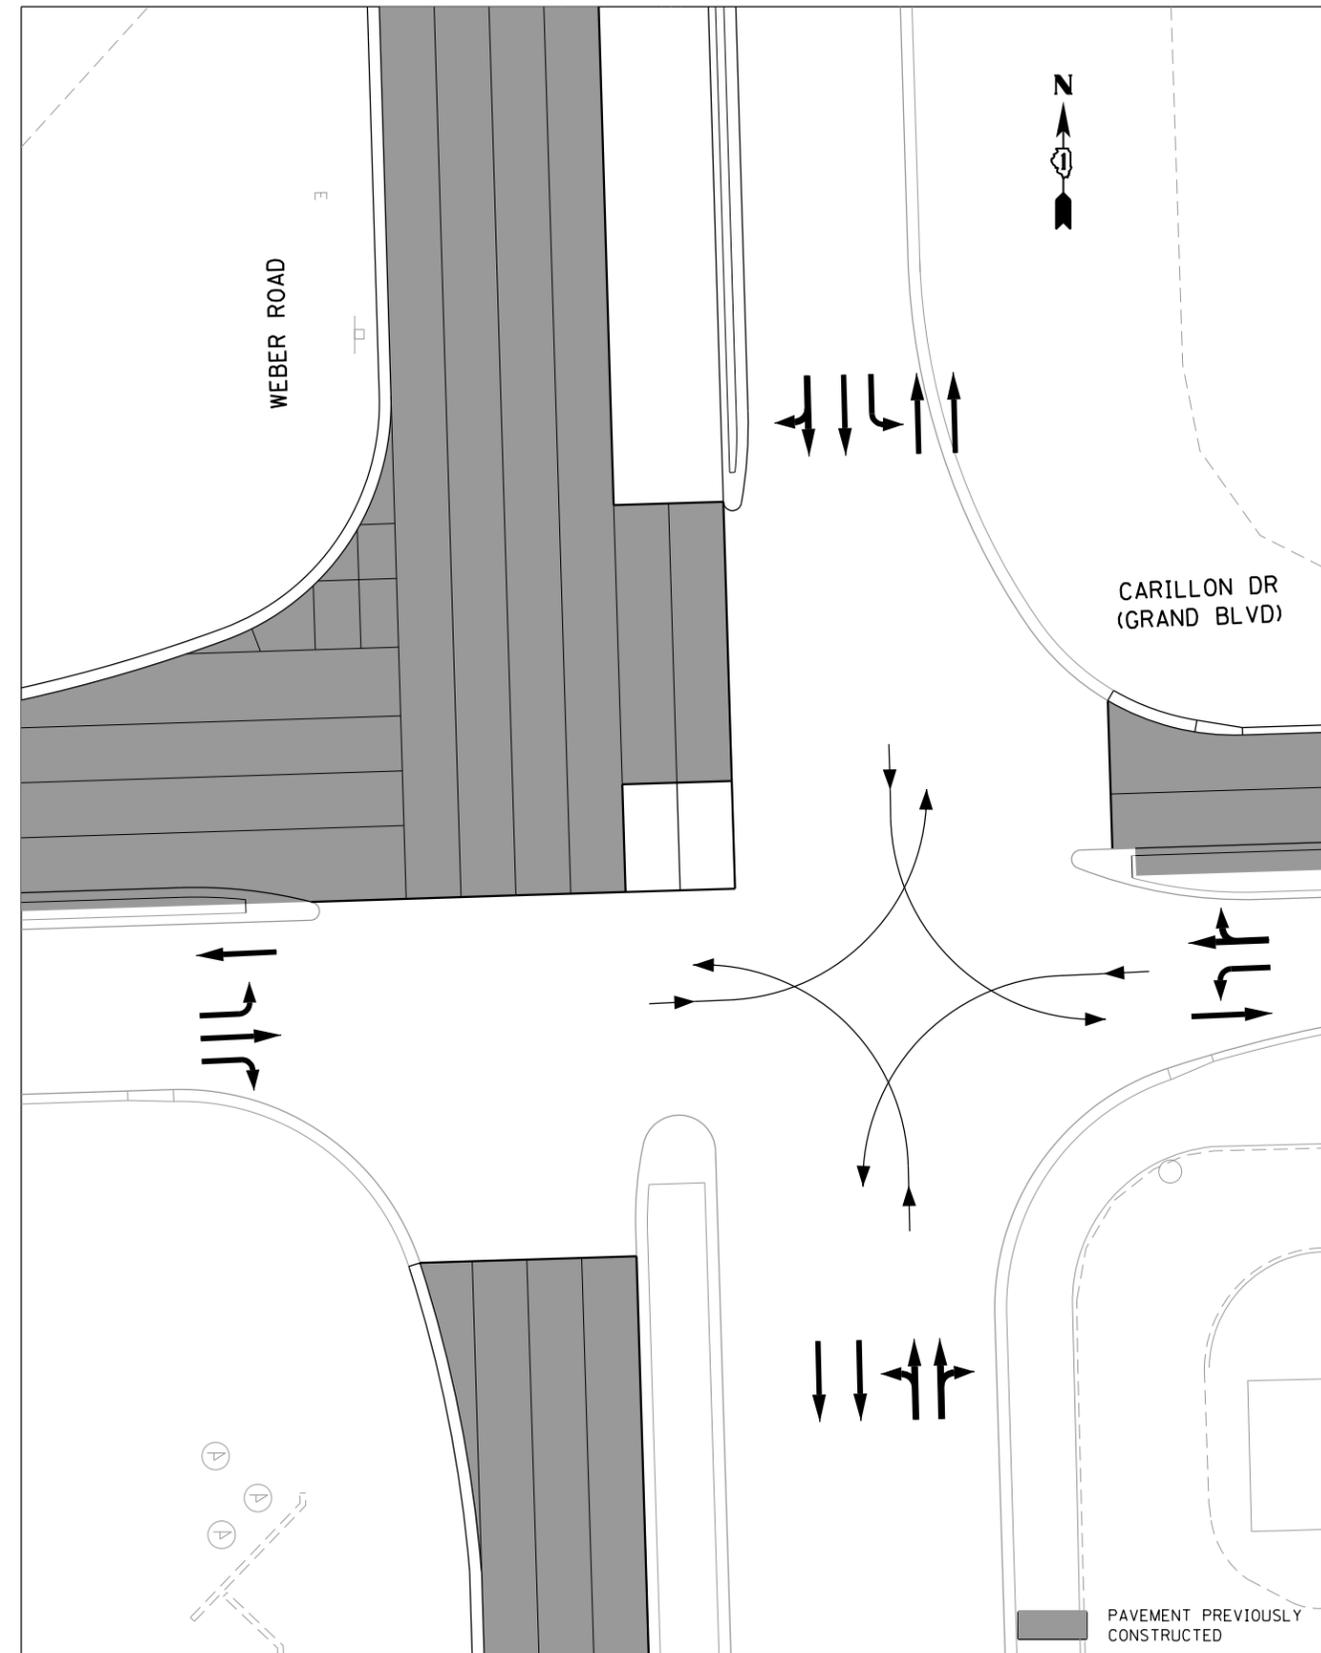

STAGE 1B

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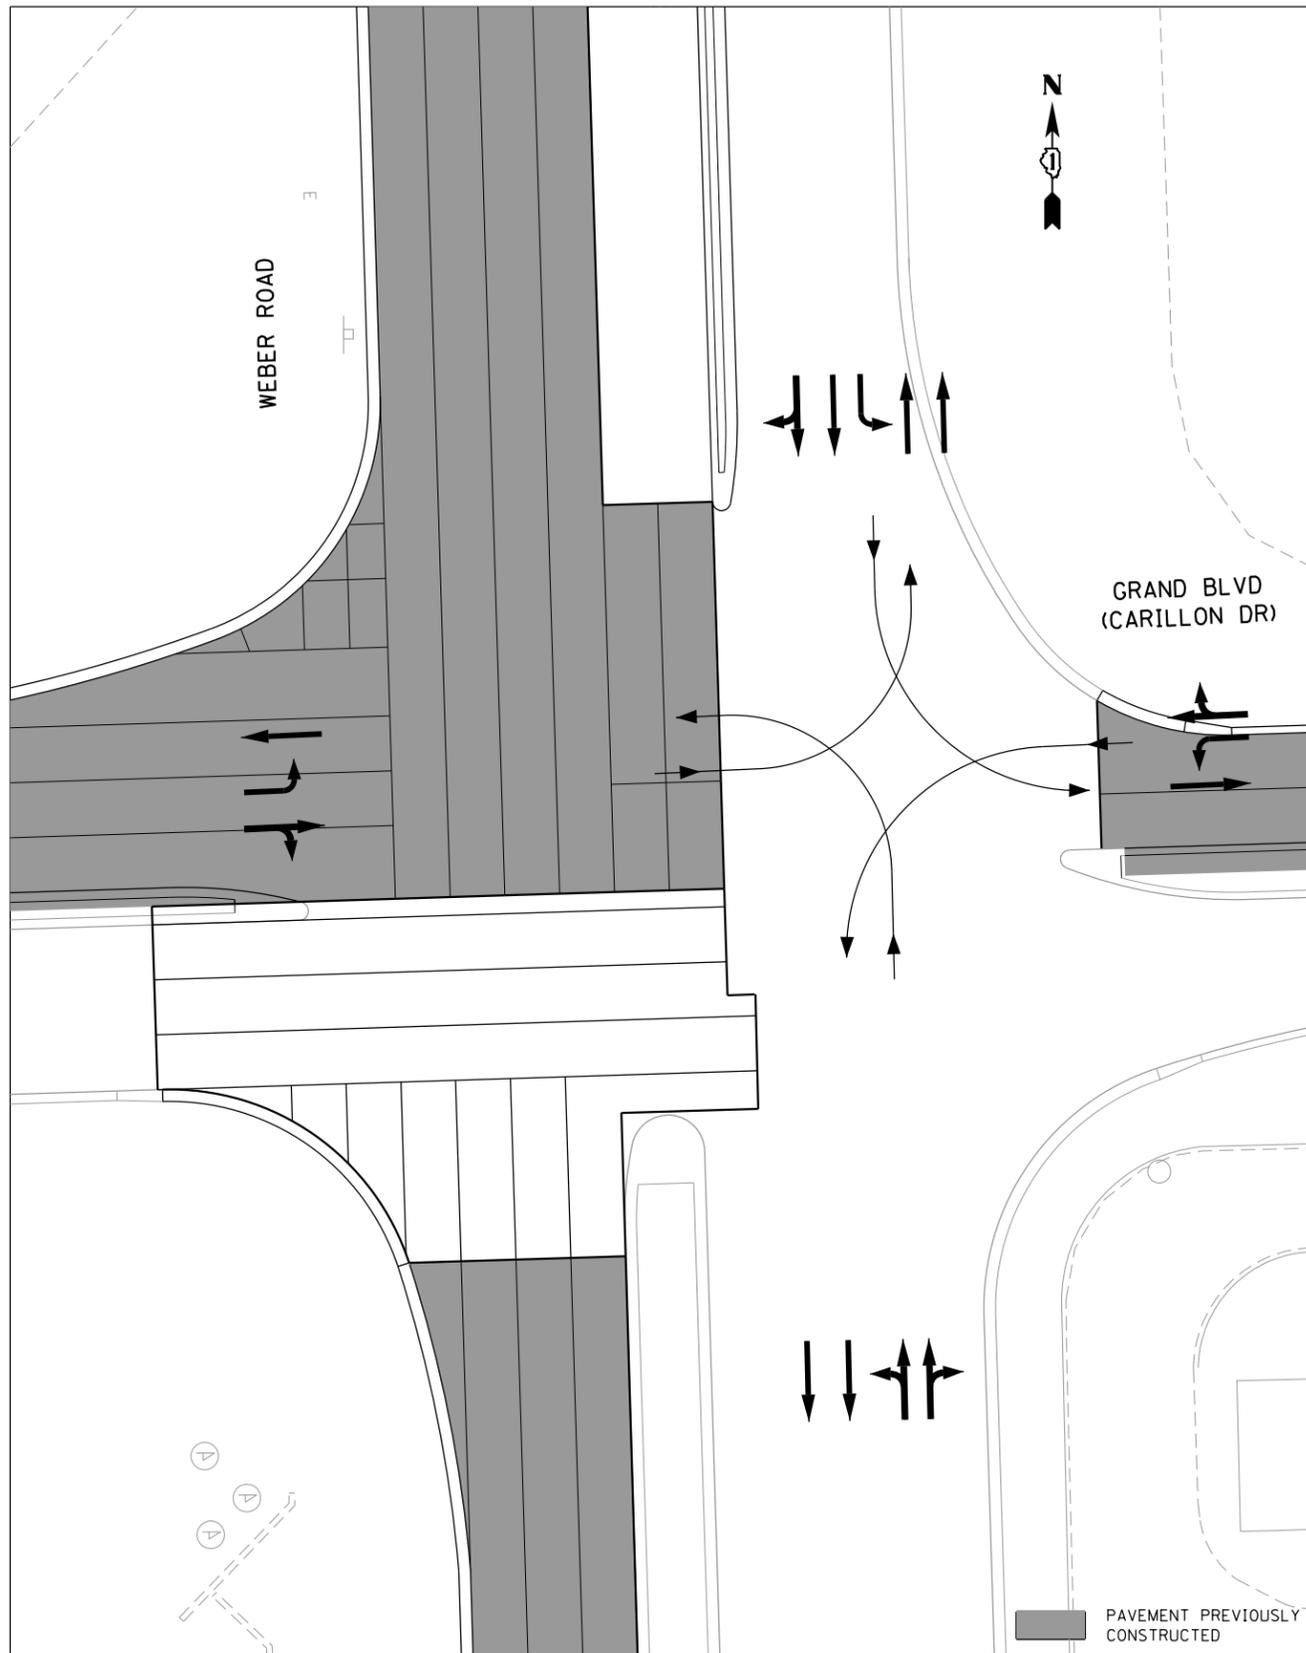
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	DRAWN -	REVISED - 6/19/2015
PLOT SCALE = 40.0000' / in.	CHECKED -	REVISED - 9/27/2016
PLOT DATE = 11/14/2017	DATE - 11/15/17	REVISED -

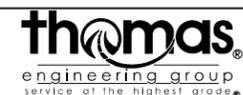STATE OF ILLINOIS
DEPARTMENT OF TRANSPORTATION


MAINTENANCE OF TRAFFIC - INTERSECTION STAGING
CARILLON DRIVE (GRAND BOULEVARD)

SCALE: N.T.S. SHEET 5 OF 8 SHEETS STA. TO STA.

F.A.P. RTE.	SECTION	COUNTY	TOTAL SHEETS	SHEET NO.
856	14-00170-42-RP	WILL	394	89
CONTRACT NO. 61D47				
ILLINOIS FED. AID PROJECT				



SUB-STAGE 1

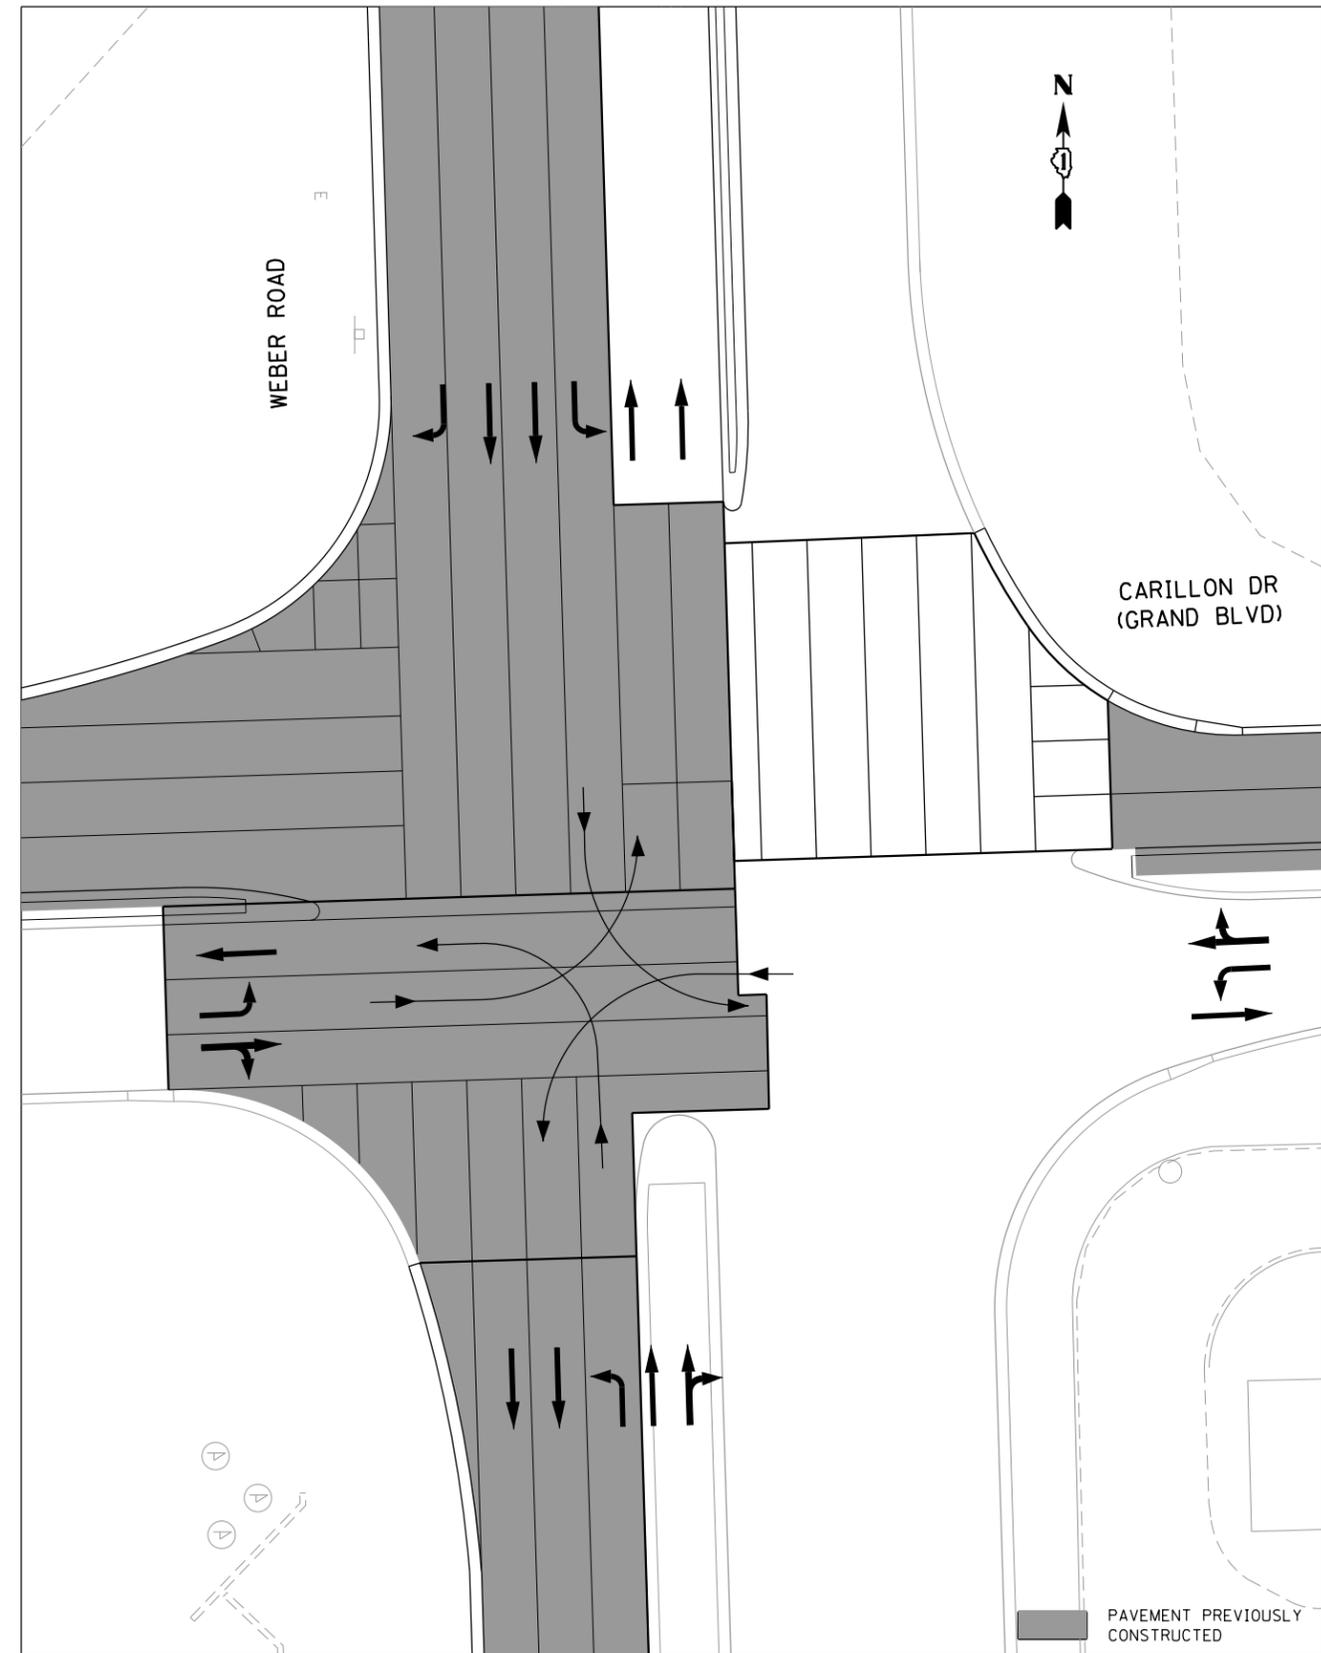

PRE-STAGE 2

FILE NAME = D:\B\11-shr-intersec-mat-6.dgn




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	DRAWN -	REVISED - 6/19/2015
PLOT SCALE = 40.0000' / in.	CHECKED -	REVISED - 9/27/2016
PLOT DATE = 11/14/2017	DATE - 11/15/17	REVISED -

**STATE OF ILLINOIS
DEPARTMENT OF TRANSPORTATION**


**MAINTENANCE OF TRAFFIC - INTERSECTION STAGING
CARILLON DRIVE (GRAND BOULEVARD)**

SCALE: N.T.S. SHEET 6 OF 8 SHEETS STA. TO STA.

F.A.P. RTE.	SECTION	COUNTY	TOTAL SHEETS	SHEET NO.
856	14-00170-42-RP	WILL	394	90
CONTRACT NO. 61D47				
ILLINOIS FED. AID PROJECT				

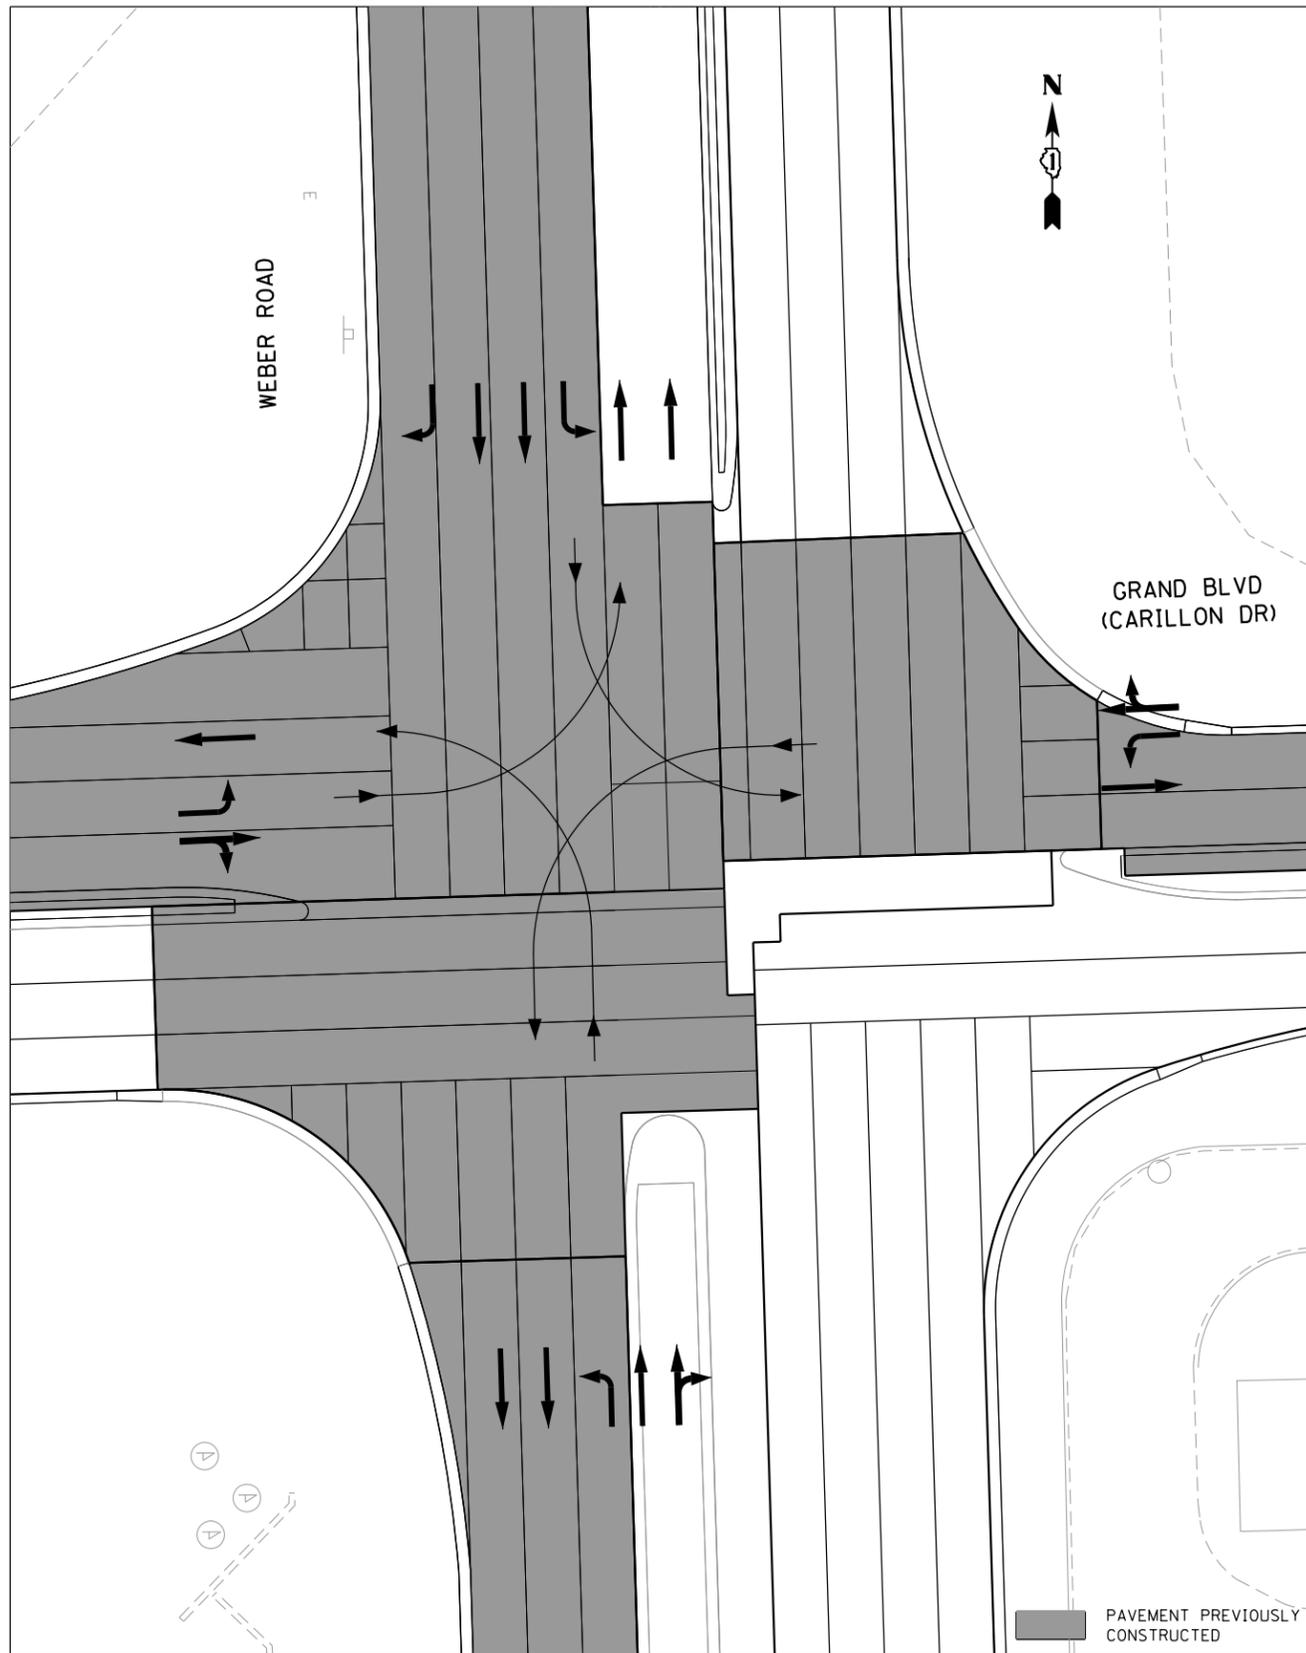


STAGE 2

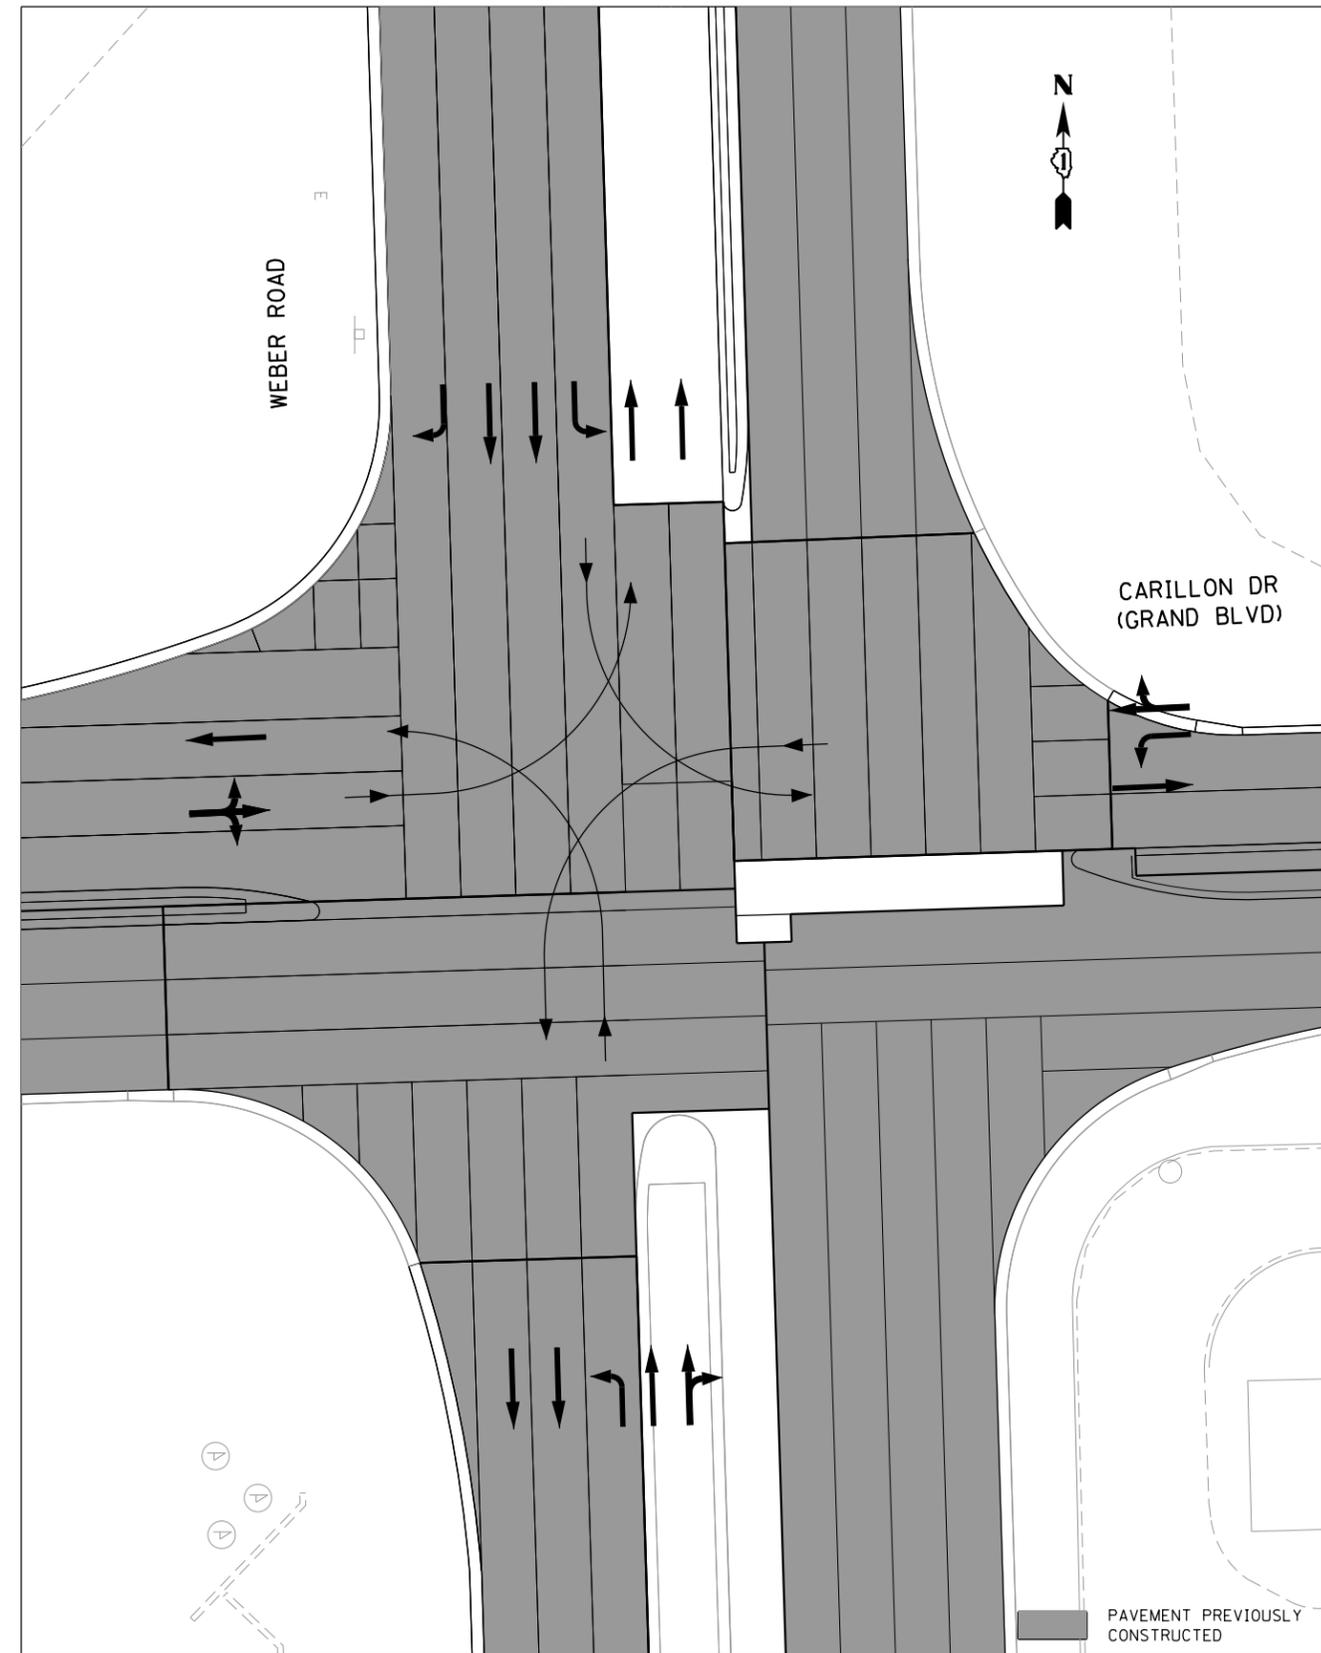

STAGE 2B

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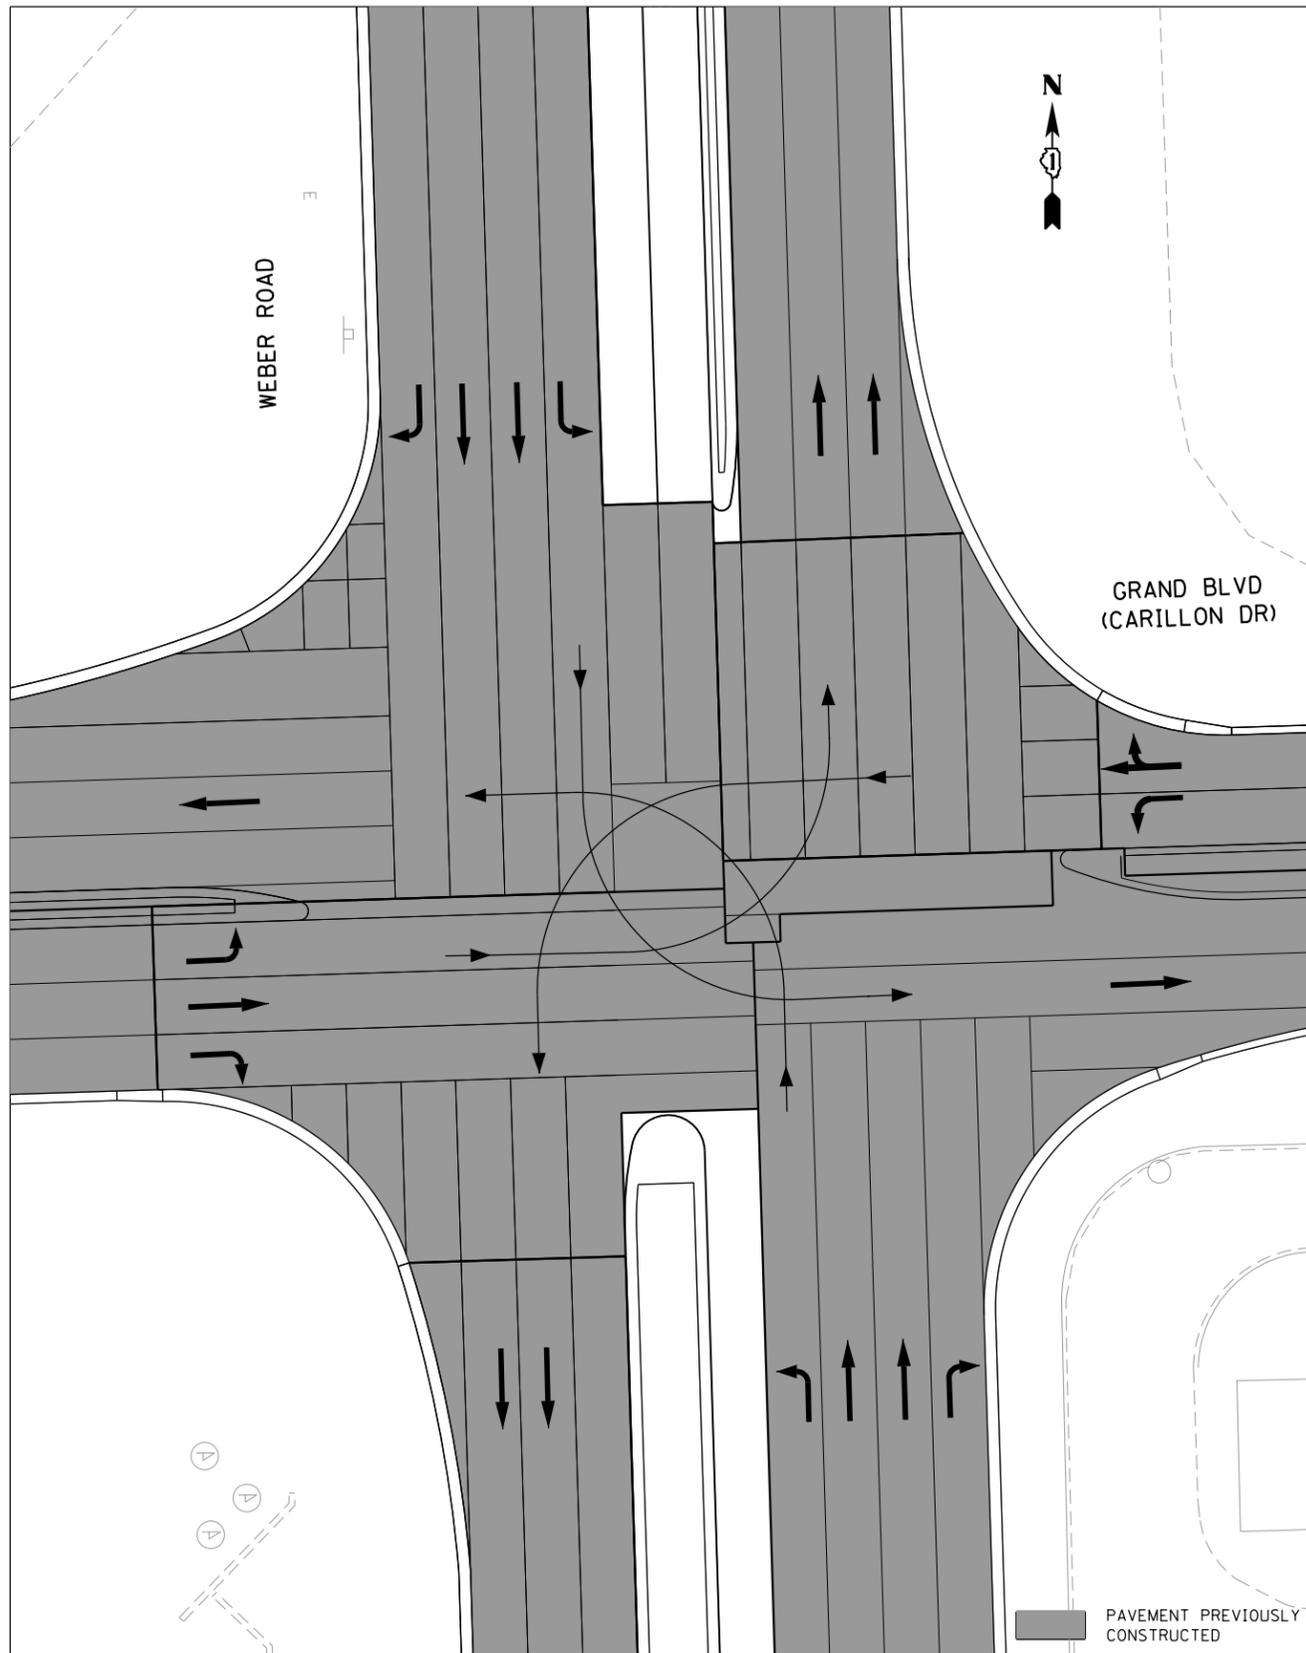
USER NAME = TEG	DESIGNED -	REVISED - 3/3/2015
	DRAWN -	REVISED - 6/19/2015
PLOT SCALE = 40.0000' / in.	CHECKED -	REVISED - 9/27/2016
PLOT DATE = 11/14/2017	DATE - 11/15/17	REVISED -

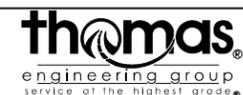STATE OF ILLINOIS
DEPARTMENT OF TRANSPORTATION


MAINTENANCE OF TRAFFIC - INTERSECTION STAGING
CARILLON DRIVE (GRAND BOULEVARD)

SCALE: N.T.S. SHEET 7 OF 8 SHEETS STA. TO STA.

F.A.P. RTE.	SECTION	COUNTY	TOTAL SHEETS	SHEET NO.
856	14-00170-42-RP	WILL	394	91
CONTRACT NO. 61D47				
ILLINOIS FED. AID PROJECT				



STAGE 3

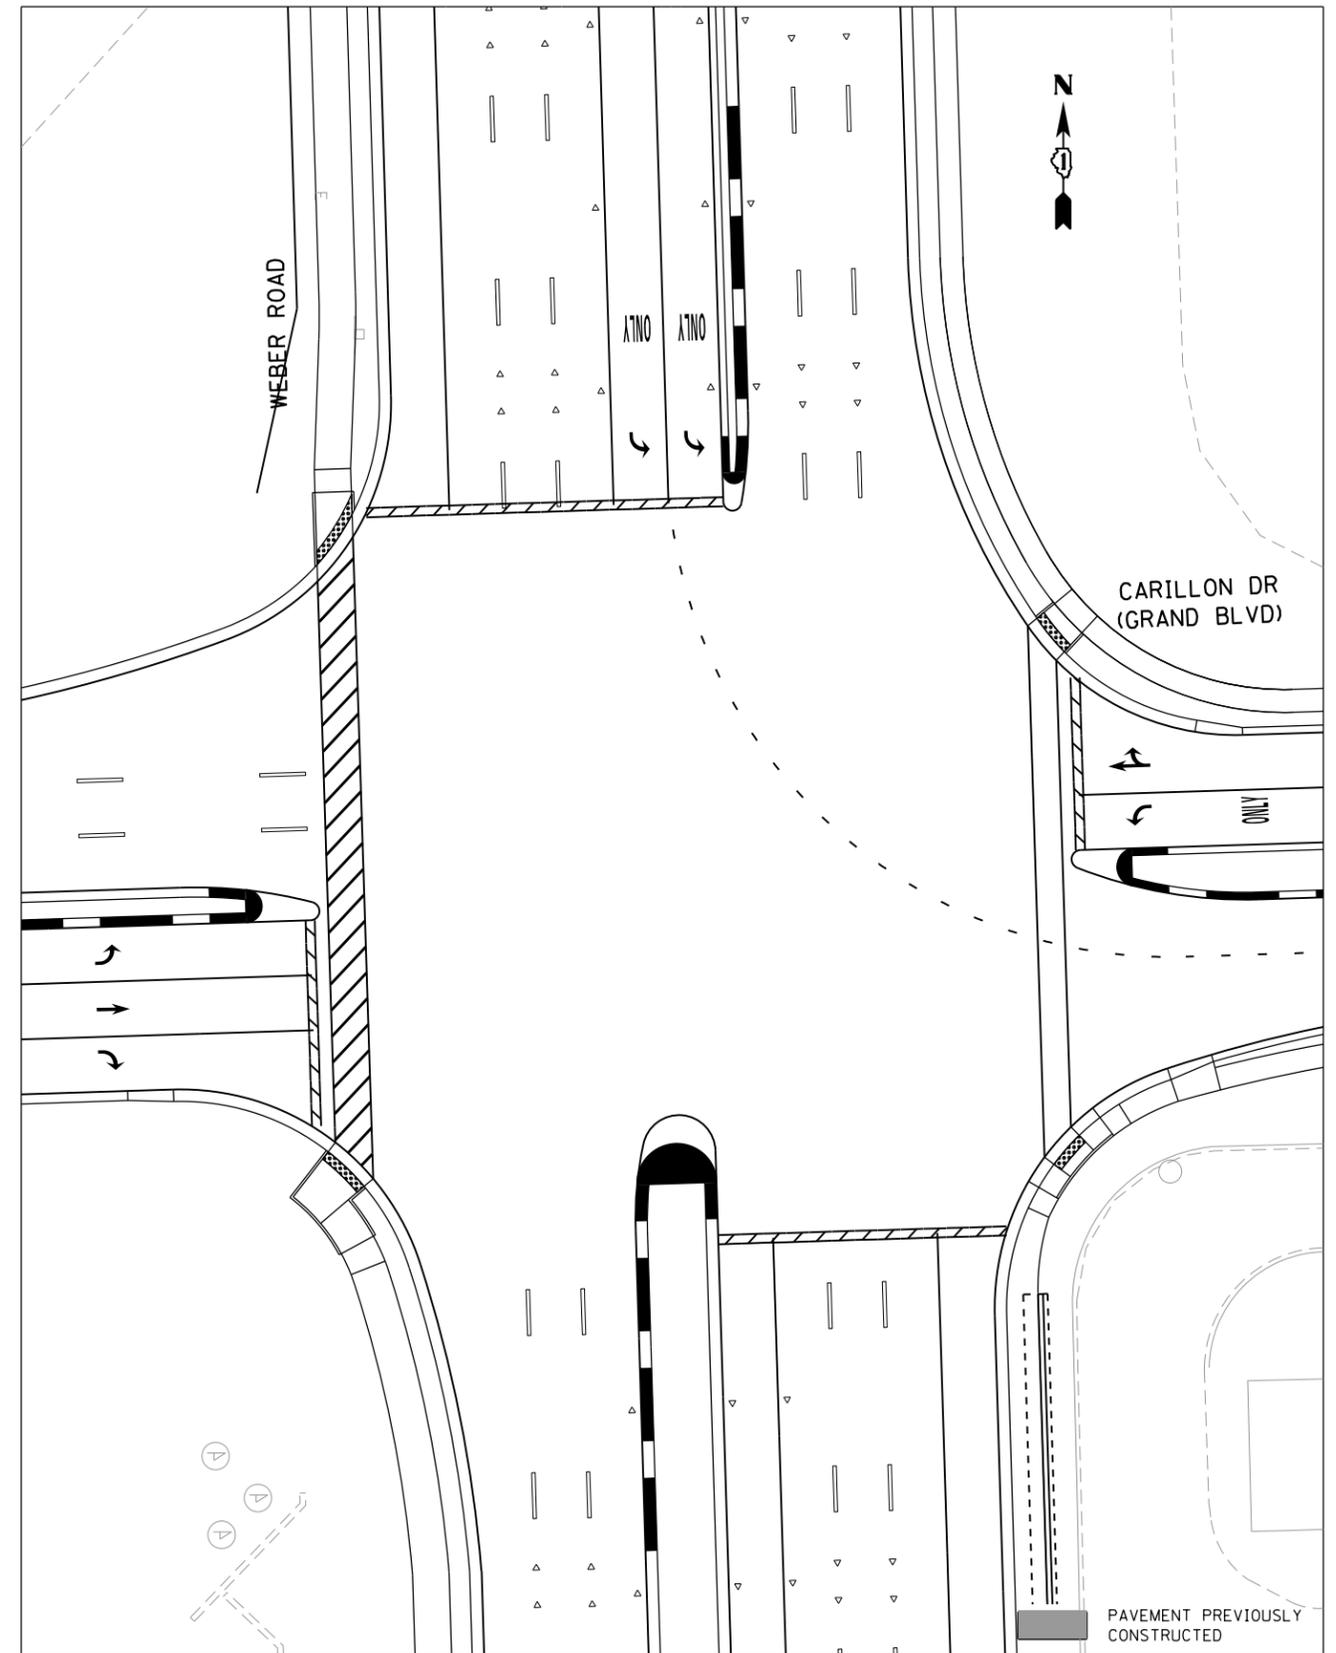

PROPOSED DESIGN

FILE NAME = D:\B\11-shr-intersec-mat-8.dgn





USER NAME = TEG	DESIGNED -	REVISED - 3/3/2015
	DRAWN -	REVISED - 6/19/2015
PLOT SCALE = 40.0000' / in.	CHECKED -	REVISED - 9/27/2016
PLOT DATE = 11/14/2017	DATE - 11/15/17	REVISED -

STATE OF ILLINOIS
DEPARTMENT OF TRANSPORTATION

MAINTENANCE OF TRAFFIC - INTERSECTION STAGING
CARILLON DRIVE (GRAND BOULEVARD)

SCALE: N.T.S. SHEET 8 OF 8 SHEETS STA. TO STA.


F.A.P. RTE.	SECTION	COUNTY	TOTAL SHEETS	SHEET NO.
856	14-00170-42-RP	WILL	394	92
CONTRACT NO. 61D47				
ILLINOIS FED. AID PROJECT				

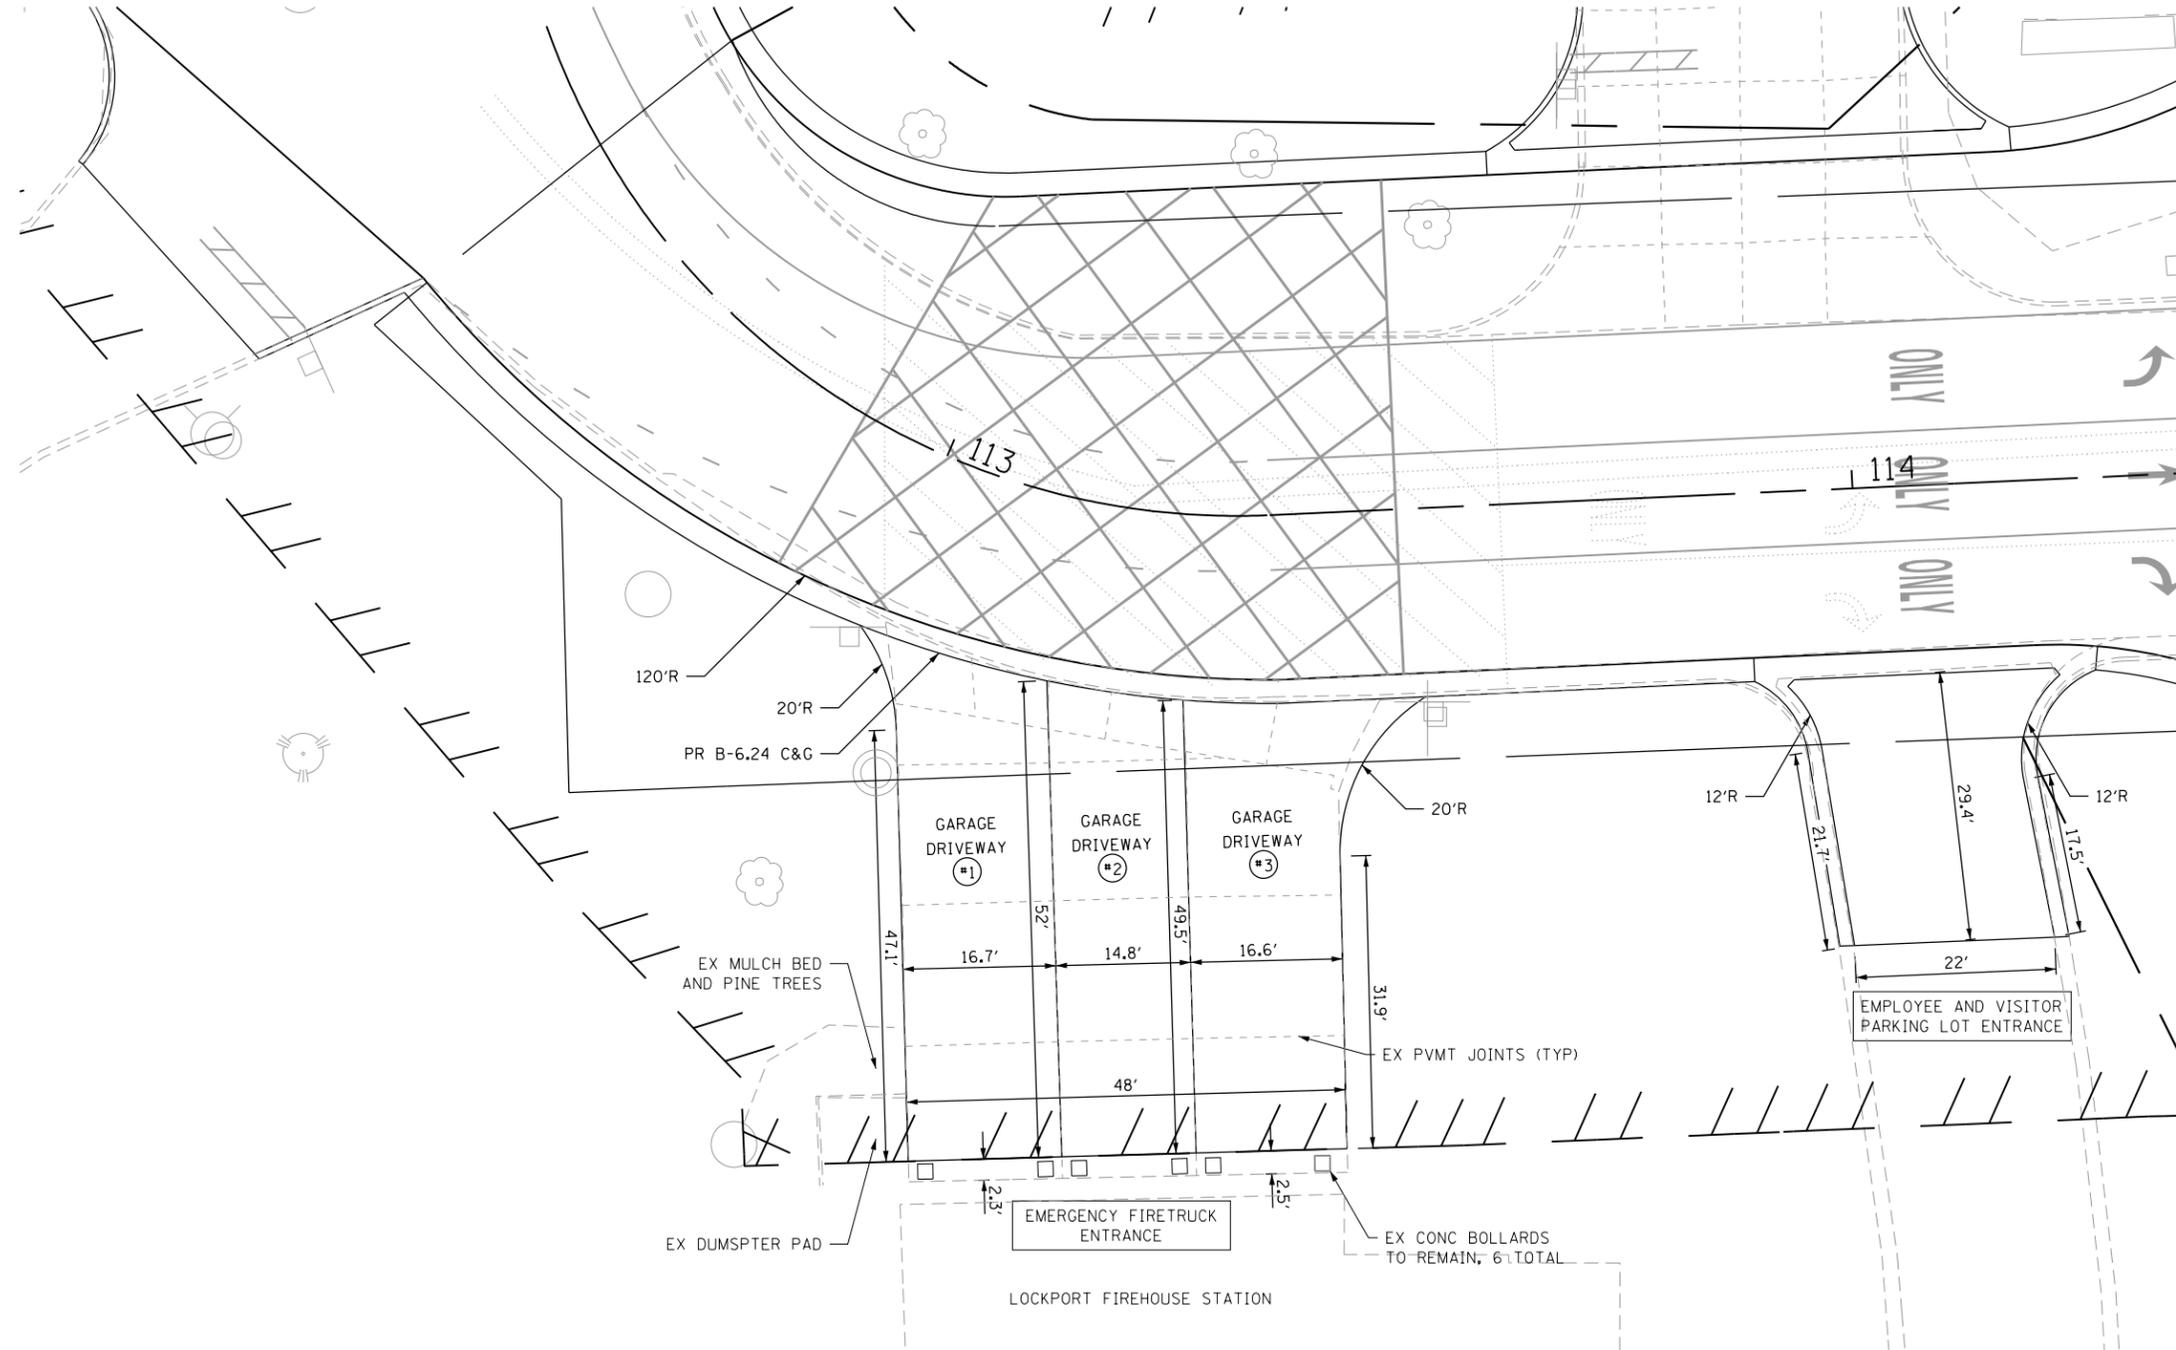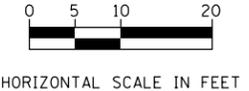

EMERGENCY FIRETRUCK ENTRANCE CONSTRUCTION SEQUENCE

1. DURING STAGE 2 OF THE SUGGESTED MAINTENANCE OF TRAFFIC, CONTRACTOR IS TO REMOVE EXISTING PAVEMENT WITHIN GARAGE DRIVEWAY 1 AND 2. CONTRACTOR IS TO ASSURE THE LOCKPORT FIREHOUSE EMERGENCY VEHICLES MAY ENTER AND EXIT GARAGE DRIVEWAY 3 AND THE EMPLOYEE AND VISITOR PARKING LOT ENTRANCE AT ALL TIMES OF THE DAY AND WEEK DURING THE CONSTRUCTION AND CURING OF DRIVEWAYS 1 AND 2.
2. CONTRACTOR IS TO CONSTRUCT THE PROPOSED (PCC) DRIVEWAY IMPROVEMENTS FOR GARAGE DRIVEWAY 1 AND 2 PAVEMENT AREA. CONTRACTOR IS TO ASSURE CONSTRUCTION EQUIPMENT, TRAFFIC CONTROL DEVICES, OR ANY OTHER OBSTRUCTIONS DO NOT BLOCK THE EMPLOYEE AND VISITOR PARKING LOT ENTRANCE IN CASE AN EMERGENCY FIRETRUCK MUST BE TEMPORARILY PARKED FOR EMERGENCY RESPONDENCE DURING DRIVEWAY 1 AND 2 CONSTRUCTION.
3. UPON THE COMPLETION OF THE CONSTRUCTION OF DRIVEWAY 1 AND 2, CONTRACTOR IS TO REMOVE THE EXISTING PAVEMENT IN DRIVEWAY 3. CONTRACTOR IS TO CONSTRUCT THE REMAINING OF THE PROPOSED (PCC) DRIVEWAY IMPROVEMENTS FOR GARAGE DRIVEWAY 3. CONTRACTOR IS TO ASSURE THERE IS FULL ACCESS FOR THE EMERGENCY FIRETRUCKS TO DRIVEWAYS 1 AND 2 DURING THIS CONSTRUCTION.

FILE NAME = D:\B\11-11-17-staging-Firehouse.dgn

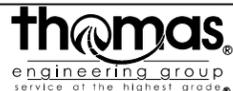


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PLOT DATE = 11/14/2017	DATE - 11/15/17	REVISED -

**STATE OF ILLINOIS
DEPARTMENT OF TRANSPORTATION**


**MAINTENANCE OF TRAFFIC
FIRE STATION DRIVEWAY**

SCALE: 1"=5' SHEET OF SHEETS STA. TO STA.


F.A.P. RTE.	SECTION	COUNTY	TOTAL SHEETS	SHEET NO.
856	14-00170-42-RP	WILL	394	93
CONTRACT NO. 61D47				
ILLINOIS FED. AID PROJECT				

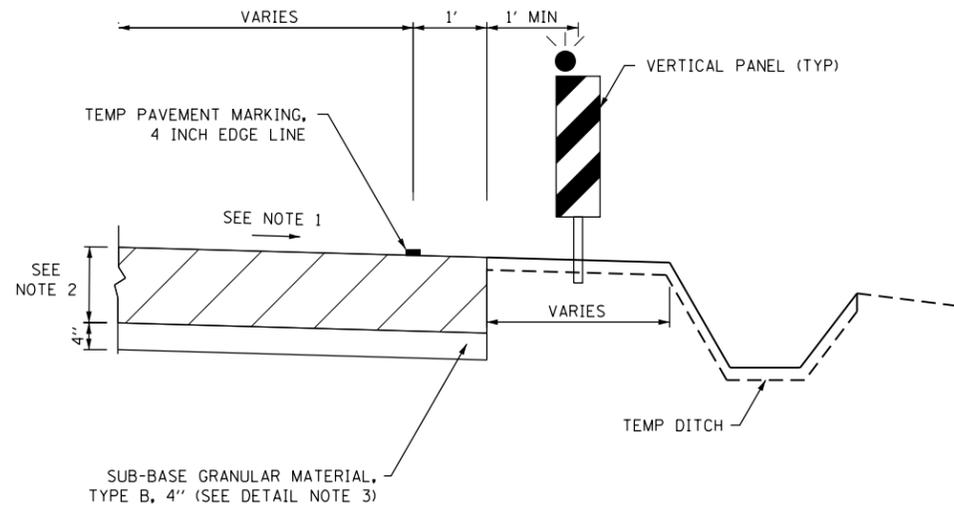


TEMPORARY PAVEMENT DETAIL

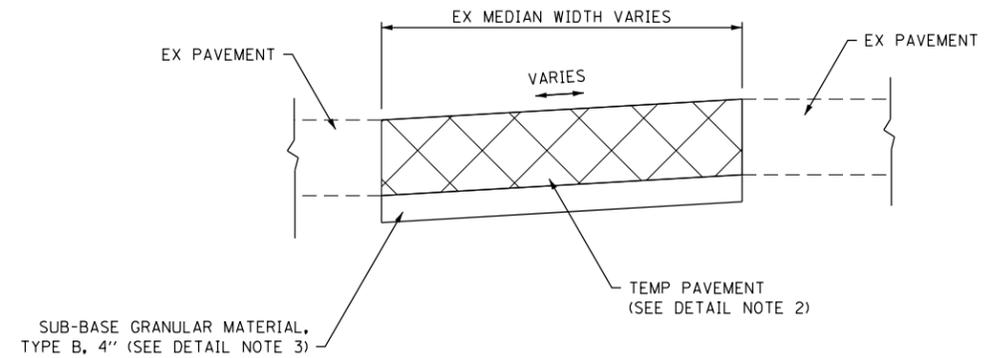

EXISTING MEDIAN TEMPORARY PAVEMENT DETAIL

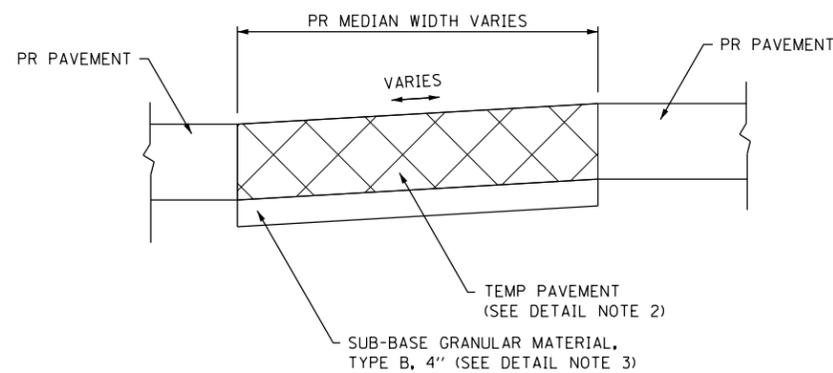

PROPOSED MEDIAN PAVEMENT DETAIL

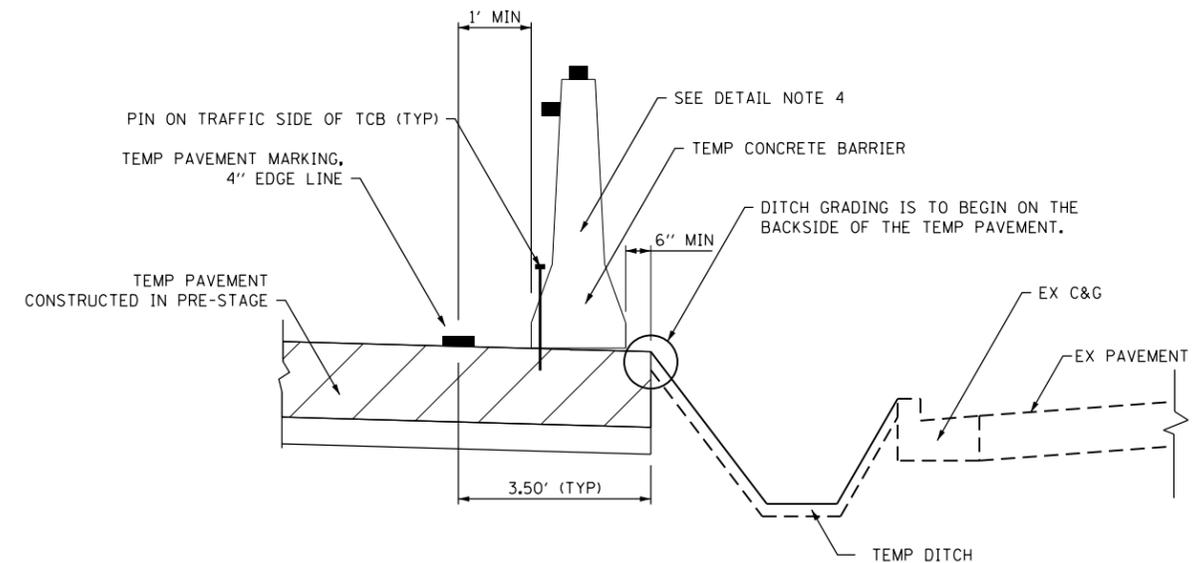


STAGE 1 PINNED TCB DETAIL

TEMPORARY AND PROPOSED PAVEMENT DETAIL NOTES

1. CROSS SLOPE OF TEMPORARY PAVEMENT SHALL MATCH THE CROSS SLOPE OF THE ADJACENT EXISTING OR PROPOSED PAVEMENT, UNLESS OTHERWISE DIRECTED BY THE ENGINEER.
2. THE TEMPORARY PAVEMENT SHALL BE CONSTRUCTED OF EITHER HOT-MIX ASPHALT OR CLASS PV CONCRETE. SEE PAVEMENT MATERIALS MIX CHART IN MOT TYPICAL SECTION SHEETS FOR MATERIAL REQUIREMENTS.
3. SUB-BASE GRANULAR MATERIAL, TYPE B 4" SHALL BE PAID FOR SEPARATELY FROM THE COST OF TEMPORARY PAVEMENT.
4. DETAIL APPLIES TO TCB IN STAGE 1 BETWEEN THE INTERSECTIONS ON THE EAST SIDE OF WEBER AS SHOWN IN THE STAGING PLANS.

FILE NAME = D:\BX11-ah-t-staging\05.dgn

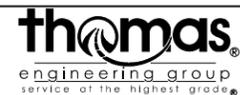


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	DRAWN - JBH	REVISED - 6/19/2015
PLOT SCALE = 2.0000' / in.	CHECKED - CRC	REVISED - 9/27/2016
PLOT DATE = 11/14/2017	DATE - 11/15/17	REVISED -

**STATE OF ILLINOIS
DEPARTMENT OF TRANSPORTATION**


MAINTENANCE OF TRAFFIC DETAILS

SCALE: SHEET 1 OF 2 SHEETS STA. TO STA.

F.A.P. RTE.	SECTION	COUNTY	TOTAL SHEETS	SHEET NO.
856	14-00170-42-RP	WILL	394	94
CONTRACT NO. 61D47				
ILLINOIS FED. AID PROJECT				

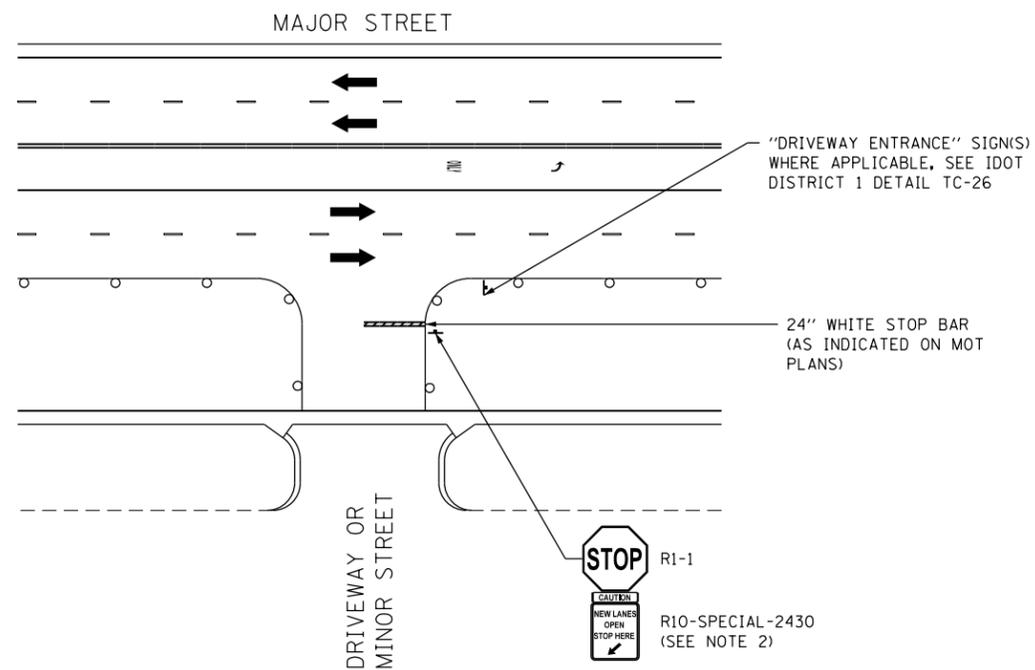

NEW TRAFFIC LANES OPEN OFFSET FROM EDGE OF PAVEMENT

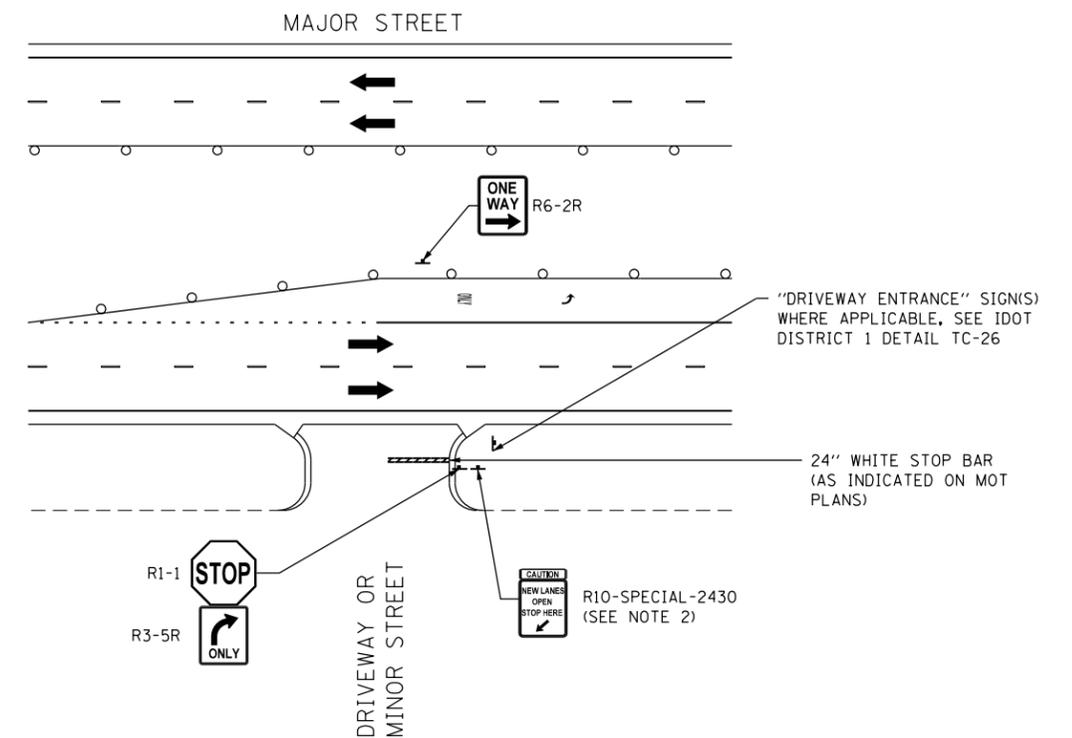


NEW TRAFFIC LANES OPEN ADJACENT TO EDGE OF PAVEMENT

TEMPORARY INFORMATION SIGNING AT DRIVEWAYS/SIDE ROADS NOTES

1. SIGNS SHOWN WITH R10-SPECIAL ON THE MOT PLANS OR THIS DETAIL SHALL BE INSTALLED ABOVE OR TO THE RIGHT OF THE STOP (R1-1) SIGNS. THE TYPICAL MOT SIGNS ARE INCLUDED IN THE COST FOR TRAFFIC CONTROL AND PROTECTION (SPECIAL).
2. R10-SPECIAL-2430 SIGNS USED AT THE COMMERCIAL ENTRANCES, PRIVATE DRIVEWAYS, OR INTERSECTIONS ARE TO BE MEASURED AND PAID FOR SEPARATELY UNDER TEMPORARY INFORMATION SIGNING. THESE SIGNS WILL NOT BE REMEASURED FOR PAYMENT IN SUBSEQUENT STAGES. THE RELOCATION OF THESE SIGNS SHALL BE INCLUDED IN THE COST FOR TEMPORARY INFORMATION SIGNING.
3. R10-SPECIAL-2430 SIGNS ARE TO BE INSTALLED AT ALL DRIVEWAYS AND SIDE ROADS WITHIN THE PROJECT LIMITS, EVEN IF NOT DISPLAYED IN THE STAGING PLANS.

FILE NAME = D:\BX11-sht-staging\065.dgn

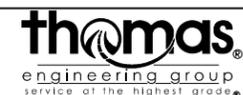


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	DRAWN - JBH	REVISED - 6/19/2015
PLOT SCALE = 2.0000' / 1" =	CHECKED - CRC	REVISED - 9/27/2016
PLOT DATE = 11/14/2017	DATE - 11/15/17	REVISED -

**STATE OF ILLINOIS
DEPARTMENT OF TRANSPORTATION**


MAINTENANCE OF TRAFFIC DETAILS

SCALE: SHEET 2 OF 2 SHEETS STA. TO STA.

F.A.P. RTE.	SECTION	COUNTY	TOTAL SHEETS	SHEET NO.
856	14-00170-42-RP	WILL	394	95
CONTRACT NO. 61D47				
ILLINOIS FED. AID PROJECT				

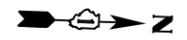

FOR TEMPORARY PAVEMENT CONSTRUCTION USE HIGHWAY STANDARDS NO. 701101, 701106, 701421, AND 701701.
ROAD CONSTRUCTION AHEAD SIGNAGE [W20-I103(O)] SHALL BE IN ACCORDANCE WITH IDOT DISTRICT 1 DETAIL TC-10.

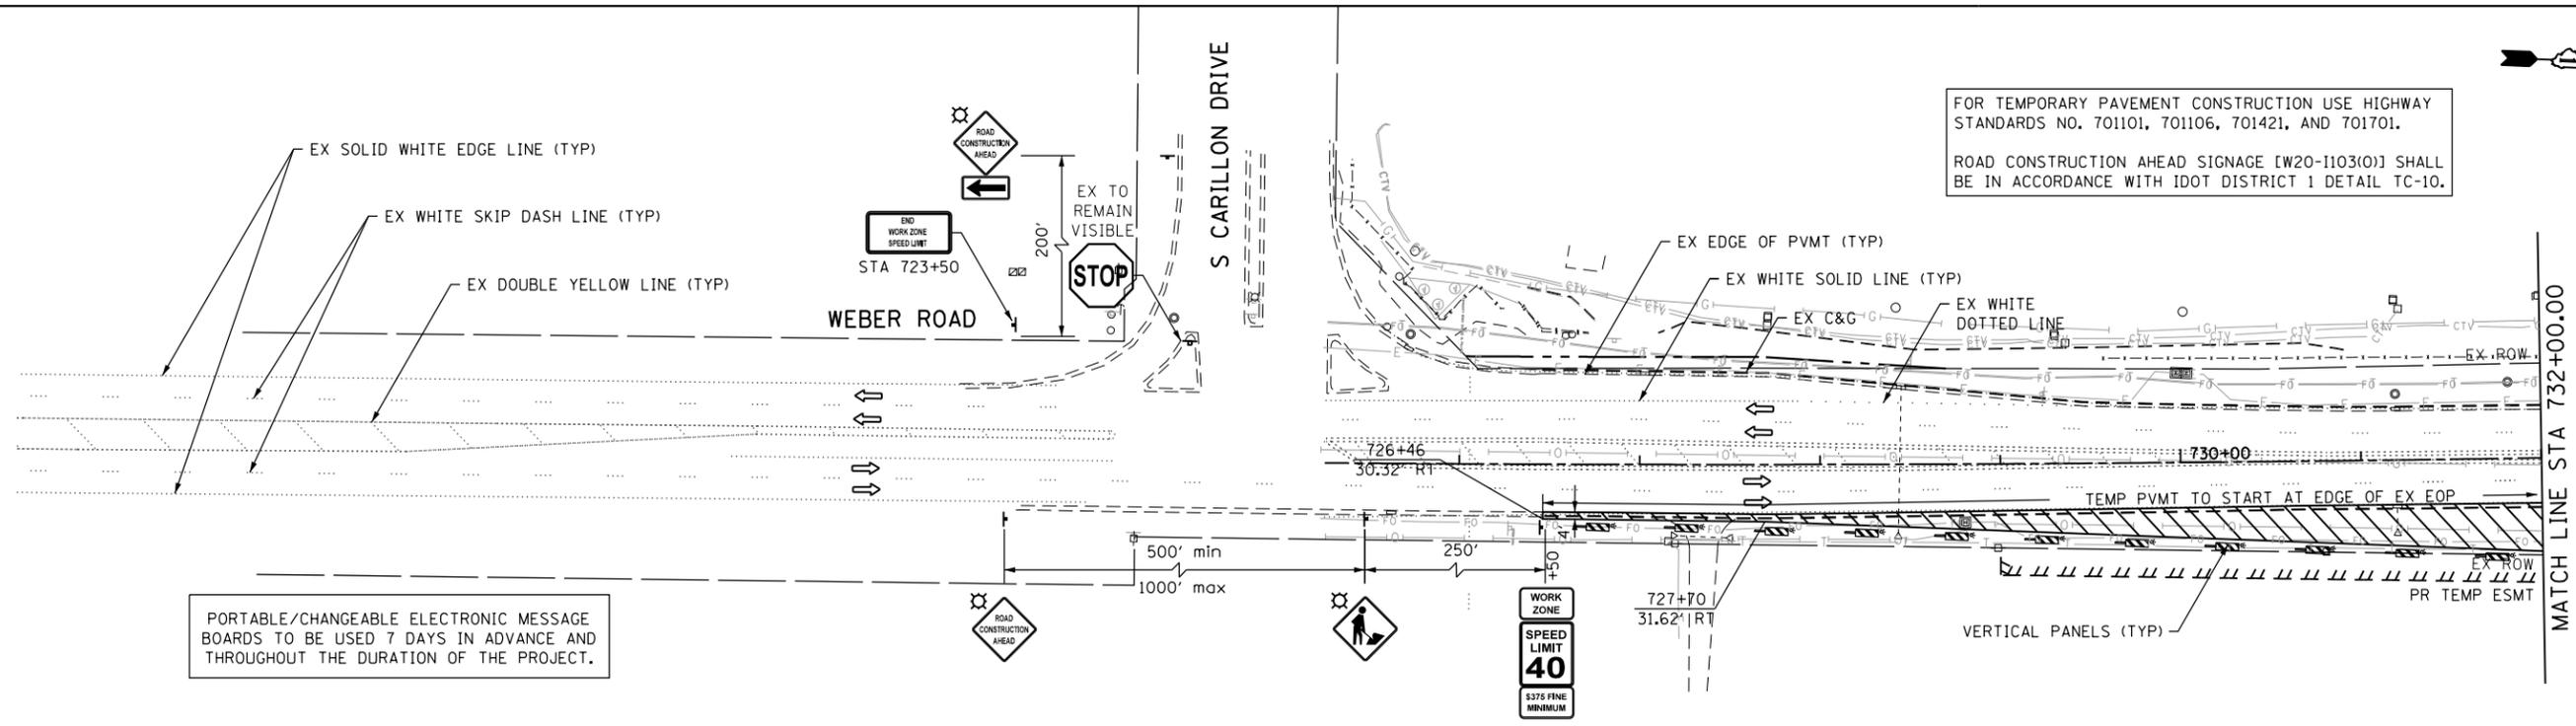


PORTABLE/CHANGEABLE ELECTRONIC MESSAGE BOARDS TO BE USED 7 DAYS IN ADVANCE AND THROUGHOUT THE DURATION OF THE PROJECT.

TEMPORARY PAVEMENT MARKING LEGEND

- | | |
|----------------------------------------------------------------------|--------------------------------------------------------------------------|
| (A) TEMPORARY PAVEMENT MARKING - LINE 4", SOLID WHITE (70300220) | (J) PAVEMENT MARKING TAPE, TYPE IV - LINE 4", SOLID WHITE (70300904) |
| (B) TEMPORARY PAVEMENT MARKING - LINE 4", WHITE SKIP-DASH (70300220) | (K) PAVEMENT MARKING TAPE, TYPE IV - LINE 4", WHITE SKIP-DASH (70300904) |
| (C) TEMPORARY PAVEMENT MARKING - LINE 4", SOLID YELLOW (70300220) | (L) PAVEMENT MARKING TAPE, TYPE IV - LINE 4", SOLID YELLOW (70300904) |
| (D) TEMPORARY PAVEMENT MARKING - LINE 4", DOUBLE YELLOW (70300220) | (M) PAVEMENT MARKING TAPE, TYPE IV - LINE 4", DOUBLE YELLOW (70300904) |
| (E) TEMPORARY PAVEMENT MARKING - LINE 6", SOLID WHITE (70300240) | (N) PAVEMENT MARKING TAPE, TYPE IV - LINE 6", SOLID WHITE (70300906) |
| (F) TEMPORARY PAVEMENT MARKING - LINE 6", WHITE DOTTED (70300240) | (O) PAVEMENT MARKING TAPE, TYPE IV - LINE 6", WHITE DOTTED (70300906) |
| (G) TEMPORARY PAVEMENT MARKING - LINE 12", SOLID YELLOW (70300260) | (P) PAVEMENT MARKING TAPE, TYPE IV - LINE 12", SOLID YELLOW (70300912) |
| (H) TEMPORARY PAVEMENT MARKING - LINE 24", SOLID WHITE (70300280) | (R) PAVEMENT MARKING TAPE, TYPE IV - LINE 24", SOLID WHITE (70300924) |
| (I) TEMPORARY PAVEMENT MARKING - LETTERS & SYMBOLS (70300210) | (S) PAVEMENT MARKING TAPE, TYPE IV - LETTERS & SYMBOLS (70300900) |

MAINTENANCE OF TRAFFIC LEGEND

- | | |
|---------------------------------------------|-----------------------------------------------------------------------------------------------------------------|
| WORK ZONE AREA | IMPACT ATTENUATORS, TEMPORARY (FULL REDIRECTIVE, NARROW) TEST LEVEL 3 |
| TEMPORARY PAVEMENT PLACED DURING THIS STAGE | SIGN ON PORTABLE OR PERMANENT SUPPORT |
| TEMPORARY PAVEMENT | TEMPORARY DITCH FLOW AND LOCATION |
| DRUM OR TYPE II BARRICADE* | ARROW BOARD |
| DIRECTION OF TRAFFIC | * TRAFFIC CONTROL DEVICE SPACING
50' C-C ON TANGENTS
25' C-C ON TAPERS OR LANE SHIFTS
12' C-C ON RADII |
| TYPE III BARRICADE | |
| TEMPORARY CONCRETE BARRIER | |
| VERTICAL PANEL* | |

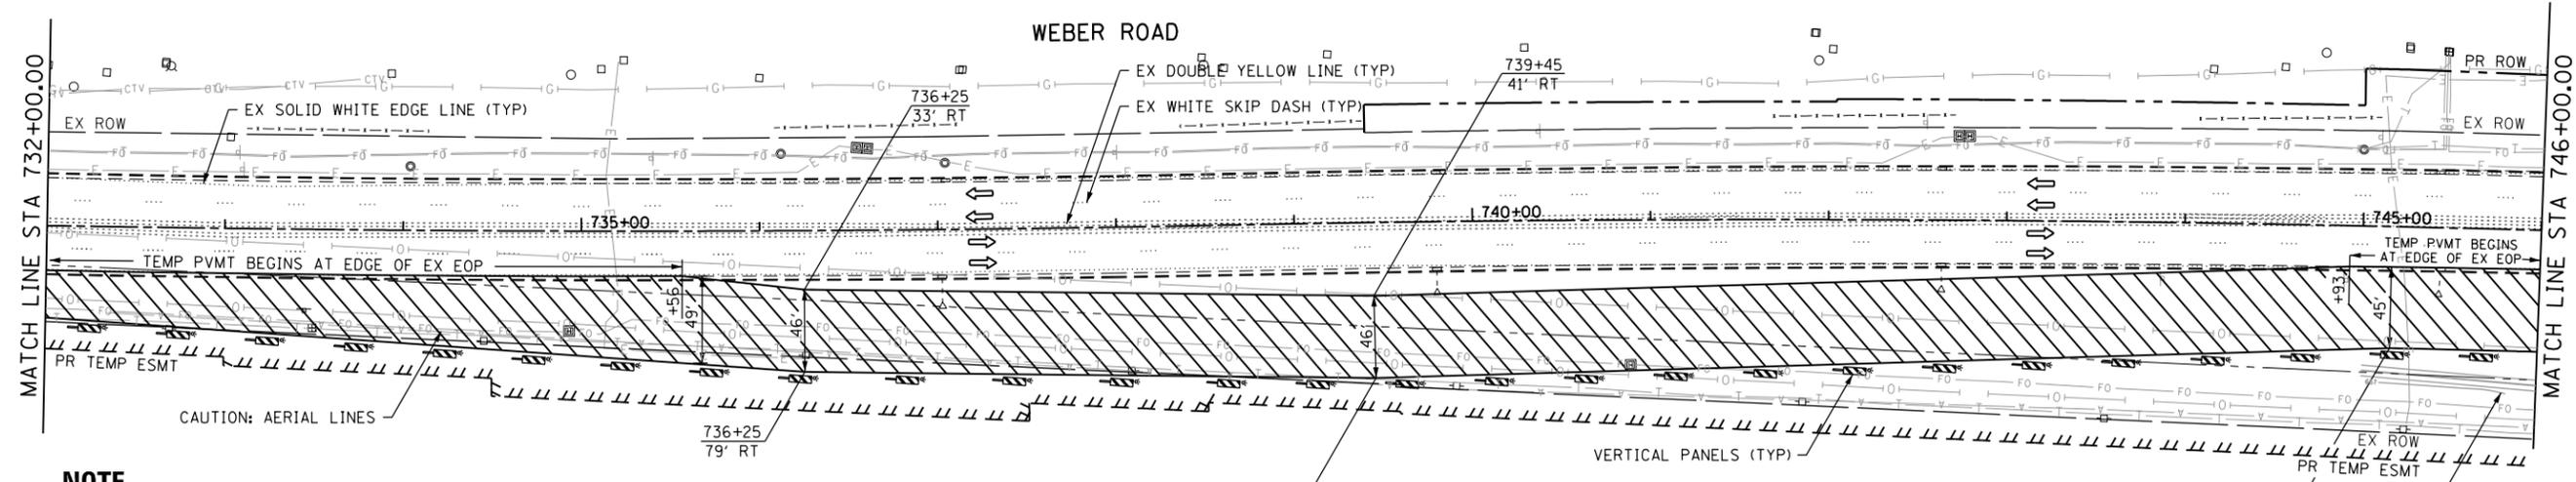

NOTE

- EXISTING LANE CONFIGURATIONS ARE TO REMAIN IN OPERATION DURING THIS STAGE OF CONSTRUCTION
- SEE TEMPORARY PAVEMENT DETAIL ON MAINTENANCE OF TRAFFIC DETAIL SHEET.
- FOLLOW IDOT STANDARD 701421 FOR DAYTIME LANE CLOSURES TO CONSTRUCT TEMPORARY PAVEMENT.
- PRE-STAGE INCLUDES THE CONSTRUCTION OF STORM SEWER STRUCTURES AND PIPES, WATER MAIN, FUTURE UTILITY STEEL CASING, AND THE SHARED-USE PATH AS SHOWN IN THE PRE-STAGE SHEETS. REFER TO DRAINAGE AND UTILITY PLAN & PROFILES AND SPECIAL PROVISIONS FOR MORE INFORMATION.
- ANY EXISTING PAVEMENT DISTURBED DUE TO DRAINAGE AND UTILITY ACTIVITIES SHALL BE REPLACED WITH AND PAID FOR AS CLASS D PATCHES, TYPE III, 13 INCH.

PRE-STAGE WORK INCLUDES GRADING OF THE PR DETENTION BASIN AS SHOWN IN THE STAGING CROSS SECTIONS



HORIZONTAL SCALE IN FEET

FILE NAME = DIBX11-ahc-staging.dgn



USER NAME = TEG	DESIGNED - RO	REVISED - 3/3/2015
	DRAWN - JBH	REVISED - 6/19/2015
PLOT SCALE = 100.0000' / 1"	CHECKED - CRC	REVISED - 9/27/2016
PLOT DATE = 11/14/2017	DATE - 11/15/17	REVISED -

STATE OF ILLINOIS
DEPARTMENT OF TRANSPORTATION



MAINTENANCE OF TRAFFIC
WEBER ROAD - PRE STAGE 1

SCALE: 1"=50' SHEET 1 OF 5 SHEETS STA. TO STA.

F.A.P. RTE.	SECTION	COUNTY	TOTAL SHEETS	SHEET NO.
856	14-00170-42-RP	WILL	394	96
CONTRACT NO. 61D47				
ILLINOIS FED. AID PROJECT				



FOR TEMPORARY PAVEMENT CONSTRUCTION USE HIGHWAY STANDARDS NO. 701101, 701106, 701421, AND 701701.

ROAD CONSTRUCTION AHEAD SIGNAGE [W20-1103(O)] SHALL BE IN ACCORDANCE WITH IDOT DISTRICT 1 DETAIL TC-10.

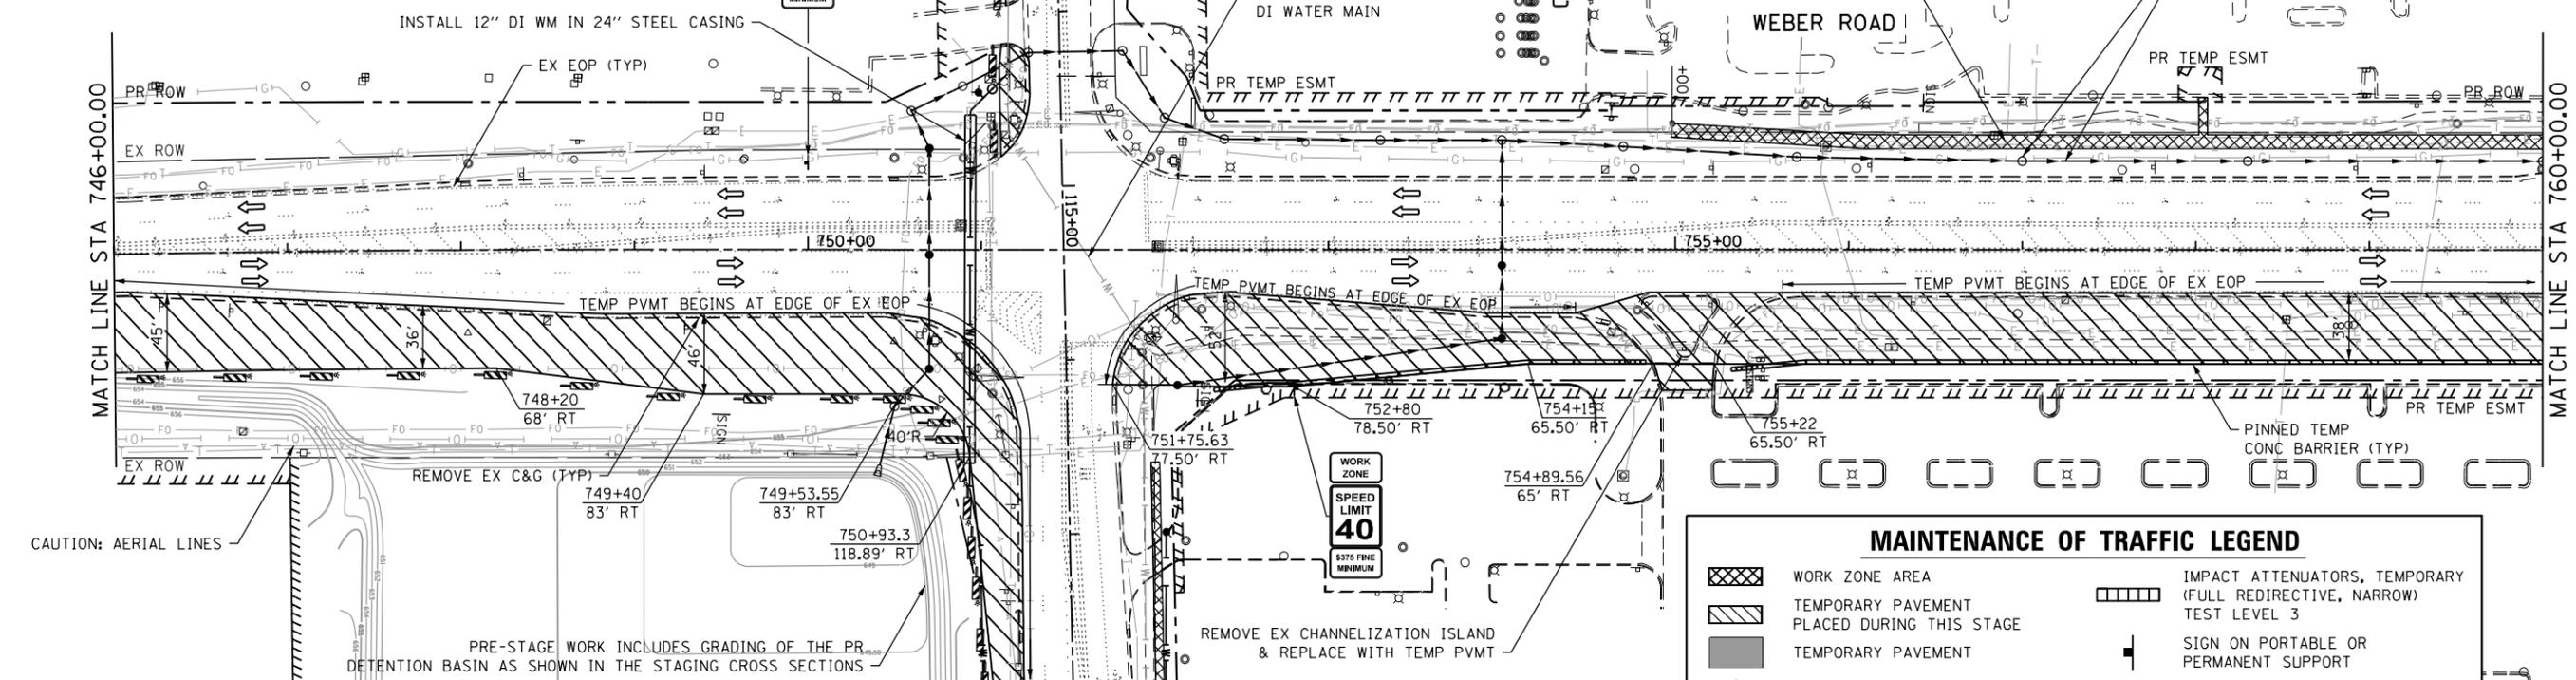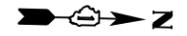


MAINTENANCE OF TRAFFIC LEGEND

<ul style="list-style-type: none"> WORK ZONE AREA TEMPORARY PAVEMENT PLACED DURING THIS STAGE TEMPORARY PAVEMENT DRUM OR TYPE II BARRICADE* DIRECTION OF TRAFFIC TYPE III BARRICADE TEMPORARY CONCRETE BARRIER VERTICAL PANEL* 	<ul style="list-style-type: none"> IMPACT ATTENUATORS, TEMPORARY (FULL REDIRECTIVE, NARROW) TEST LEVEL 3 SIGN ON PORTABLE OR PERMANENT SUPPORT TEMPORARY DITCH FLOW AND LOCATION ARROW BOARD <p style="font-size: small;">* TRAFFIC CONTROL DEVICE SPACING 50' C-C ON TANGENTS 25' C-C ON TAPERS OR LANE SHIFTS 12' C-C ON RADII</p>
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FILE NAME = D:\B\11-11-15\11-15-15\11-15-15.dgn

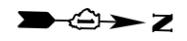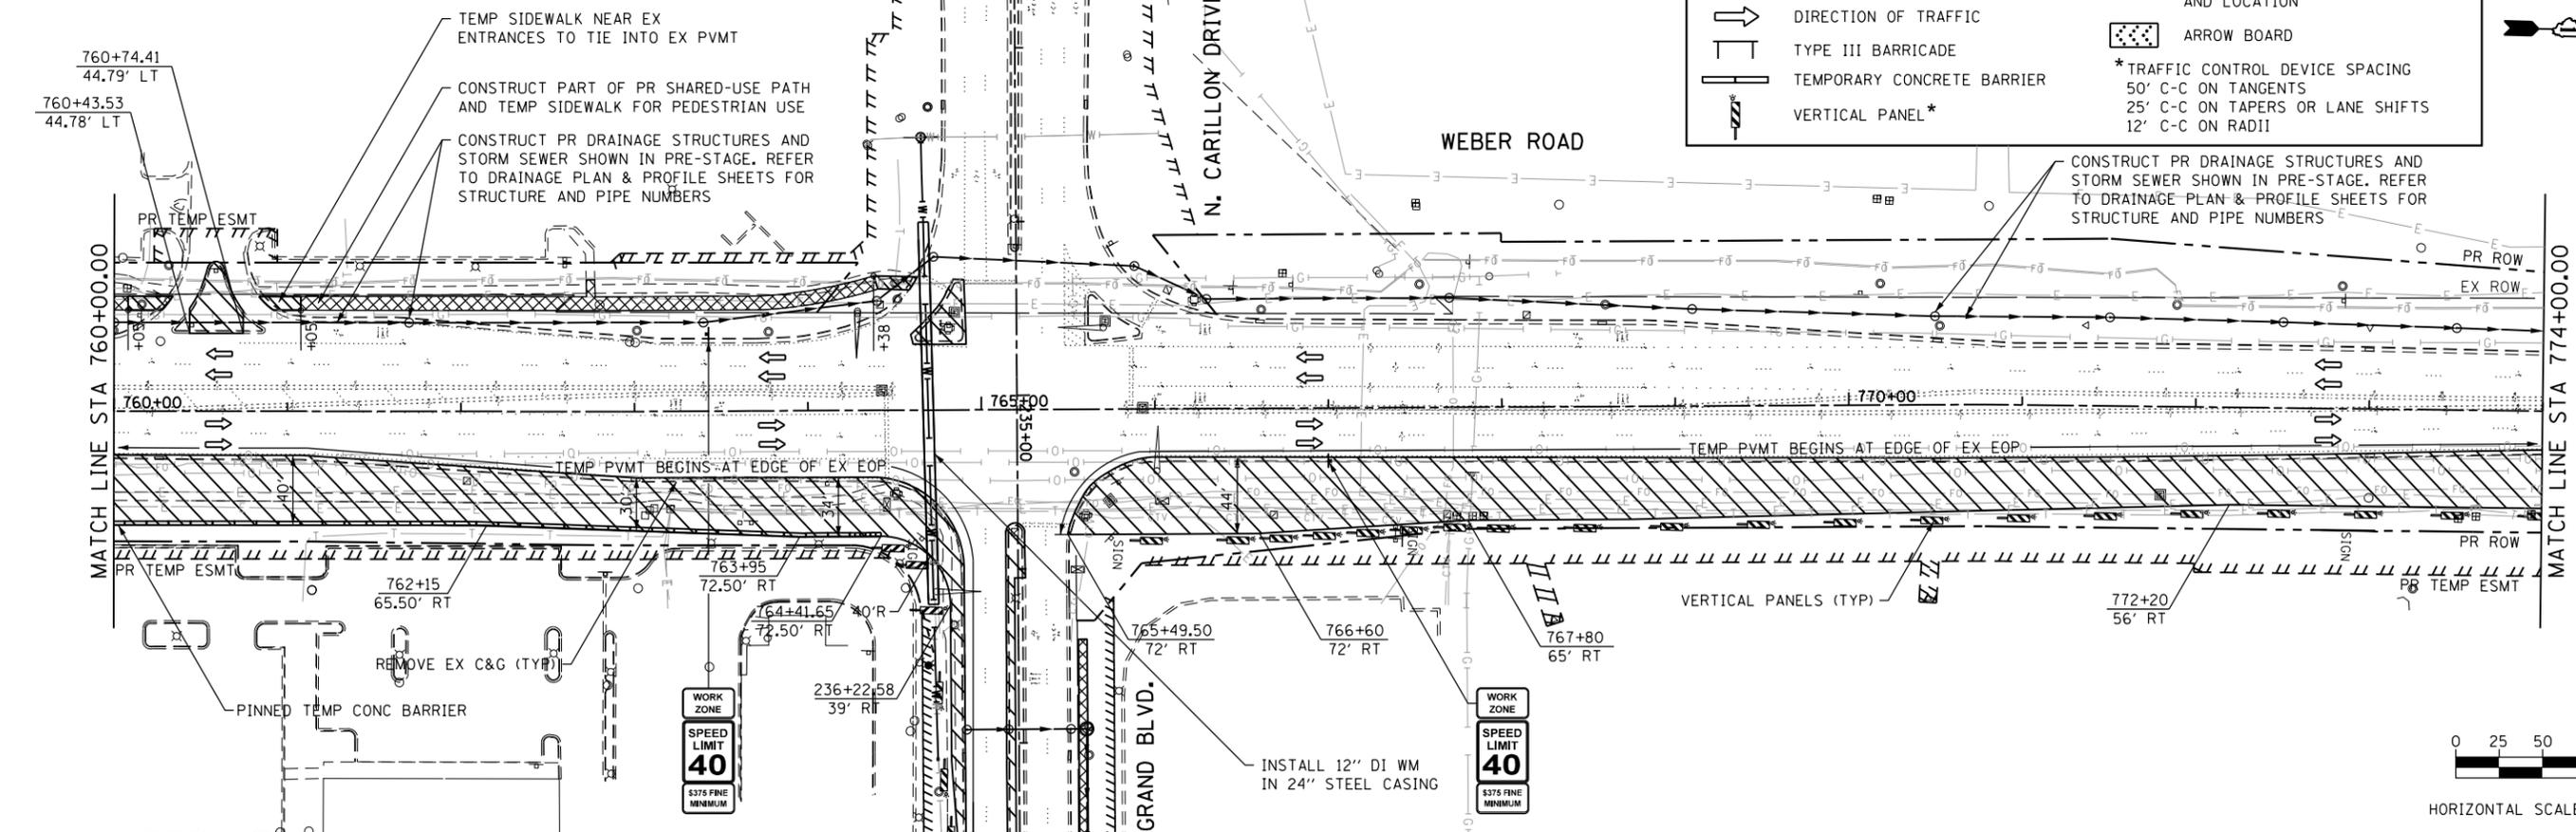

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	DRAWN - JBH	REVISED - 6/19/2015
PLOT SCALE = 100.0000' / 1"	CHECKED - CRC	REVISED - 9/27/2016
PLOT DATE = 11/14/2017	DATE - 11/15/17	REVISED -

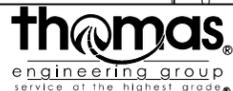**STATE OF ILLINOIS
DEPARTMENT OF TRANSPORTATION**

**MAINTENANCE OF TRAFFIC
WEBER ROAD - PRE STAGE 1**


SCALE: 1"=50' SHEET 2 OF 5 SHEETS STA. TO STA.

F.A.P. RTE.	SECTION	COUNTY	TOTAL SHEETS	SHEET NO.
856	14-00170-42-RP	WILL	394	97
CONTRACT NO. 61D47				
ILLINOIS FED. AID PROJECT				


PORTABLE/CHANGEABLE ELECTRONIC MESSAGE BOARDS TO BE USED 7 DAYS IN ADVANCE AND THROUGHOUT THE DURATION OF THE PROJECT.

FOR TEMPORARY PAVEMENT CONSTRUCTION USE HIGHWAY STANDARDS NO. 701101, 701106, 701421, AND 701701.


ROAD CONSTRUCTION AHEAD SIGNAGE [W20-I103(O)] SHALL BE IN ACCORDANCE WITH IDOT DISTRICT 1 DETAIL TC-10.

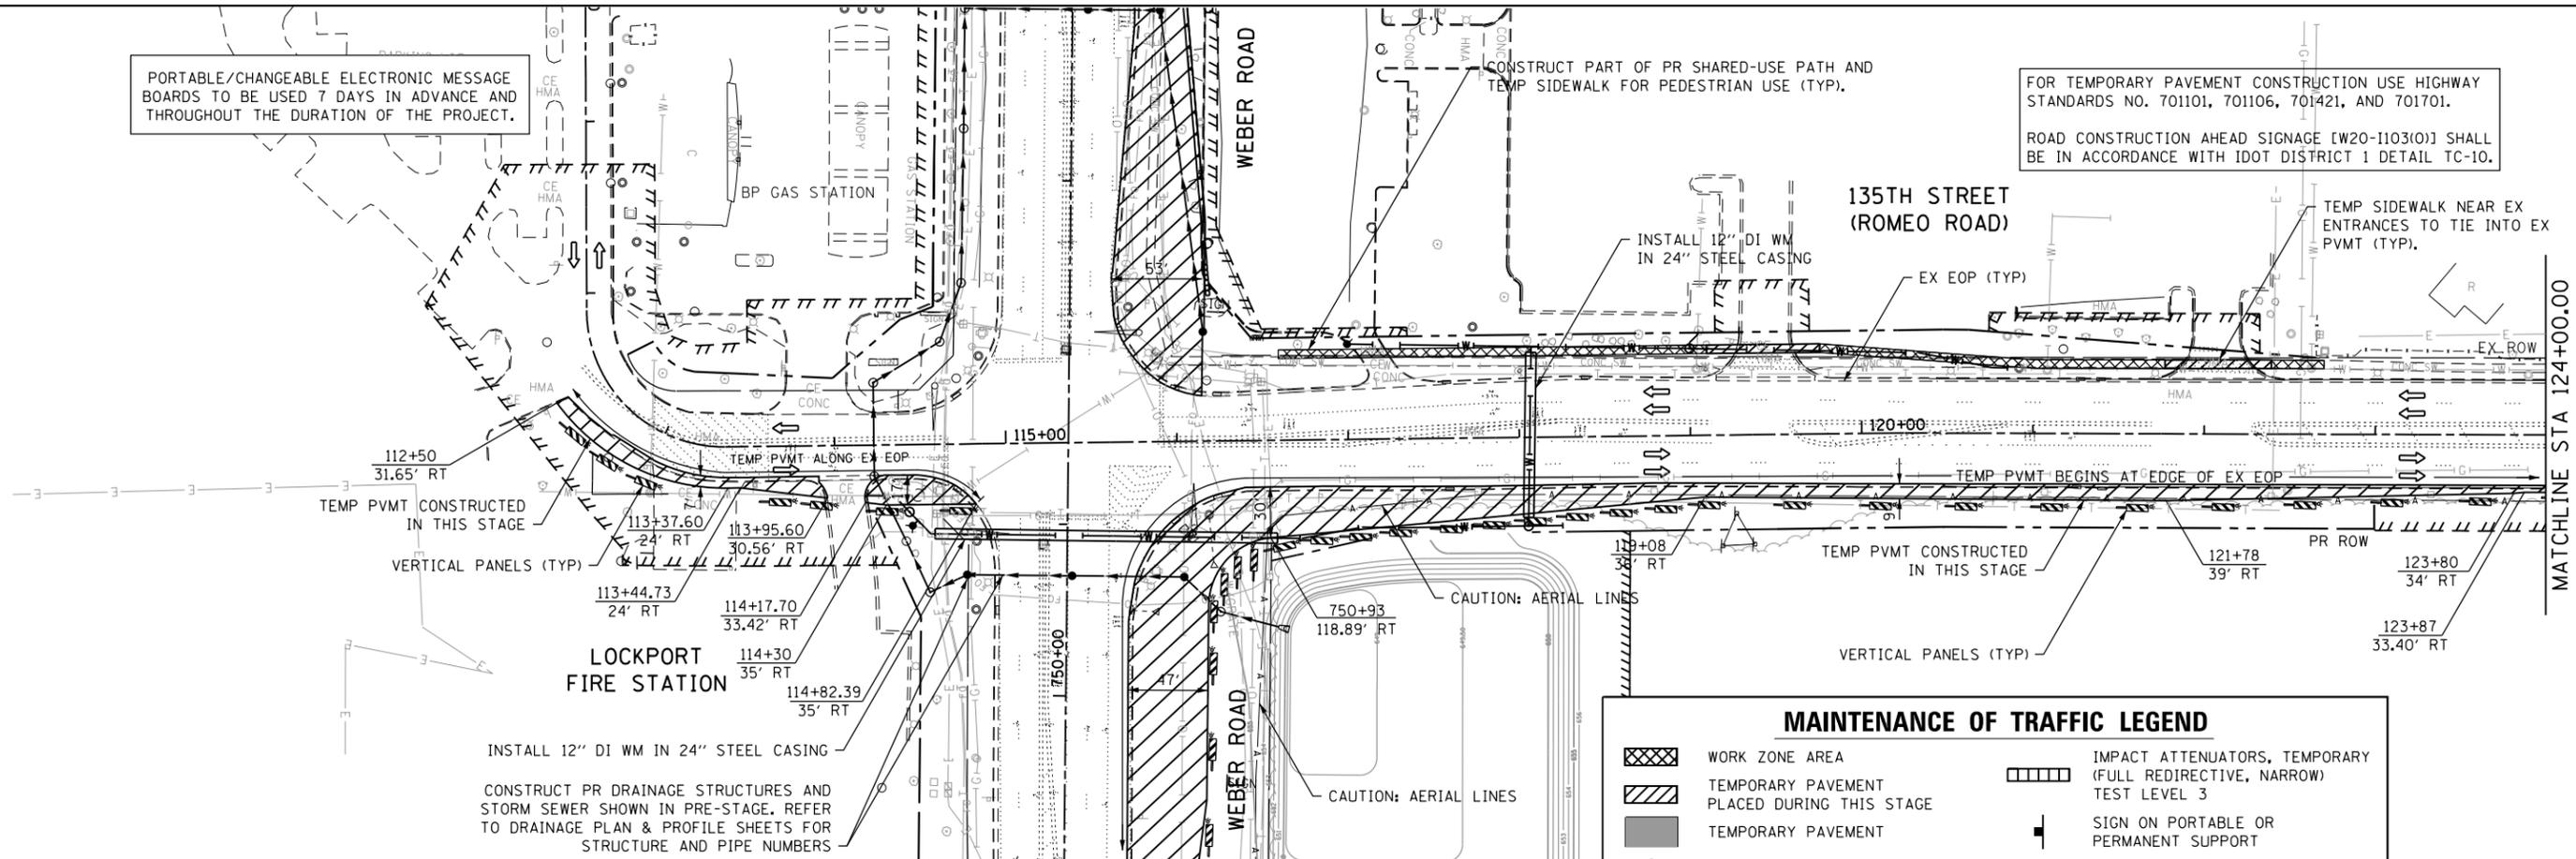

MAINTENANCE OF TRAFFIC LEGEND	
	WORK ZONE AREA
	TEMPORARY PAVEMENT PLACED DURING THIS STAGE
	TEMPORARY PAVEMENT
	DRUM OR TYPE II BARRICADE*
	DIRECTION OF TRAFFIC
	TYPE III BARRICADE
	TEMPORARY CONCRETE BARRIER
	VERTICAL PANEL*
	IMPACT ATTENUATORS, TEMPORARY (FULL REDIRECTIVE, NARROW) TEST LEVEL 3
	SIGN ON PORTABLE OR PERMANENT SUPPORT
	TEMPORARY DITCH FLOW AND LOCATION
	ARROW BOARD
* TRAFFIC CONTROL DEVICE SPACING	
50' C-C ON TANGENTS	
25' C-C ON TAPERS OR LANE SHIFTS	
12' C-C ON RADII	

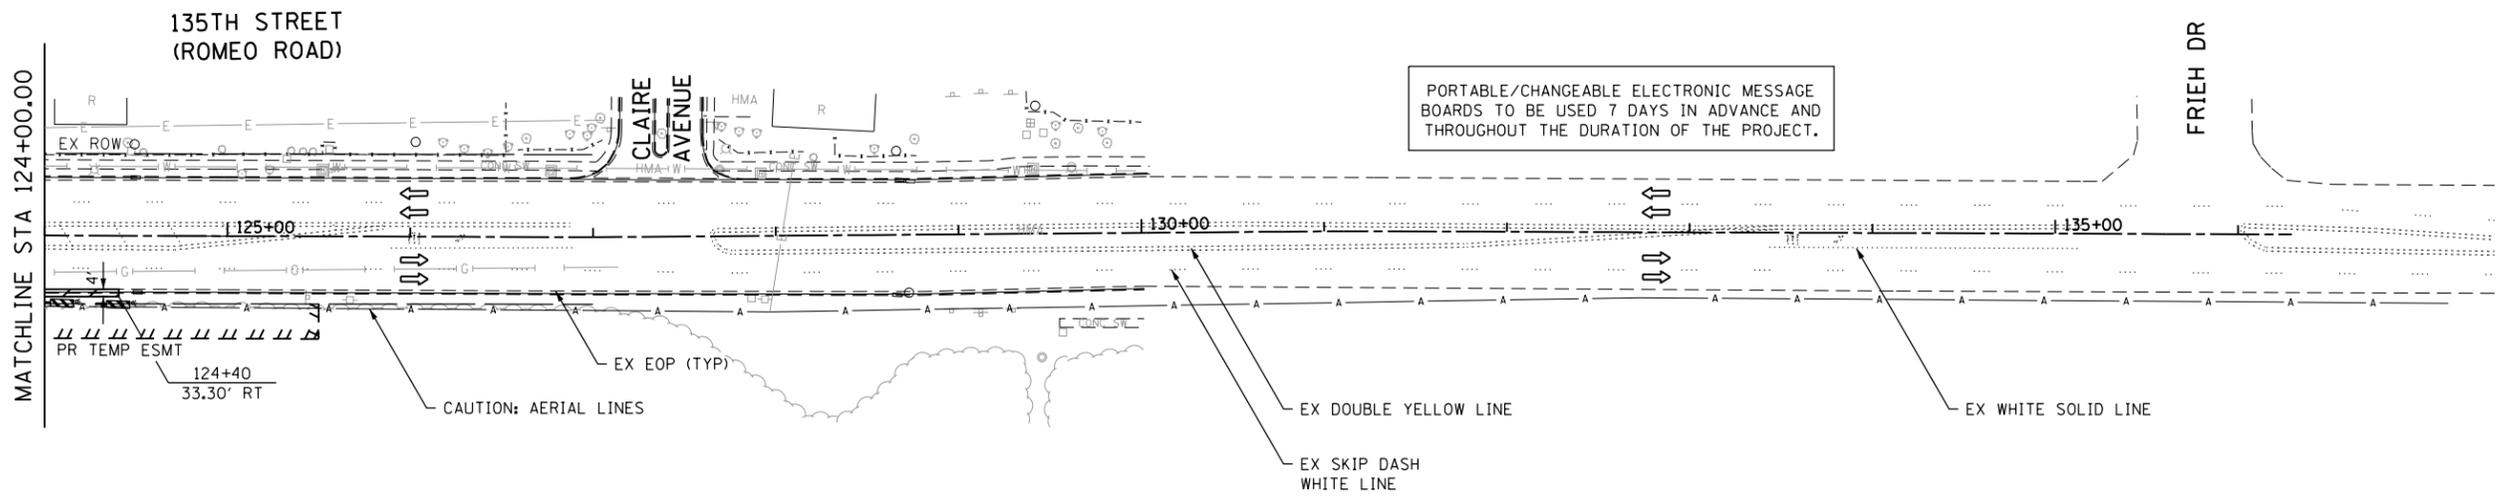

FILE NAME = D:\B\11-11-17-staging\84.dgn

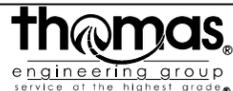

USER NAME = TEG	DESIGNED - RO	REVISED - 3/3/2015
	DRAWN - JBH	REVISED - 6/19/2015
PLOT SCALE = 100.0000' / in.	CHECKED - CRC	REVISED - 9/27/2016
PLOT DATE = 11/14/2017	DATE - 11/15/17	REVISED -

STATE OF ILLINOIS
DEPARTMENT OF TRANSPORTATION


MAINTENANCE OF TRAFFIC
135TH STREET (ROMEO ROAD) - PRE STAGE 1

SCALE: 1"=50' SHEET 4 OF 5 SHEETS STA. TO STA.

F.A.P. RTE.	SECTION	COUNTY	TOTAL SHEETS	SHEET NO.
856	14-00170-42-RP	WILL	394	99
CONTRACT NO. 61D47				
ILLINOIS FED. AID PROJECT				



FOR TEMPORARY PAVEMENT CONSTRUCTION USE HIGHWAY STANDARDS NO. 701101, 701106, 701421, AND 701701.
ROAD CONSTRUCTION AHEAD SIGNAGE [W20-1103(O)] SHALL BE IN ACCORDANCE WITH IDOT DISTRICT 1 DETAIL TC-10.

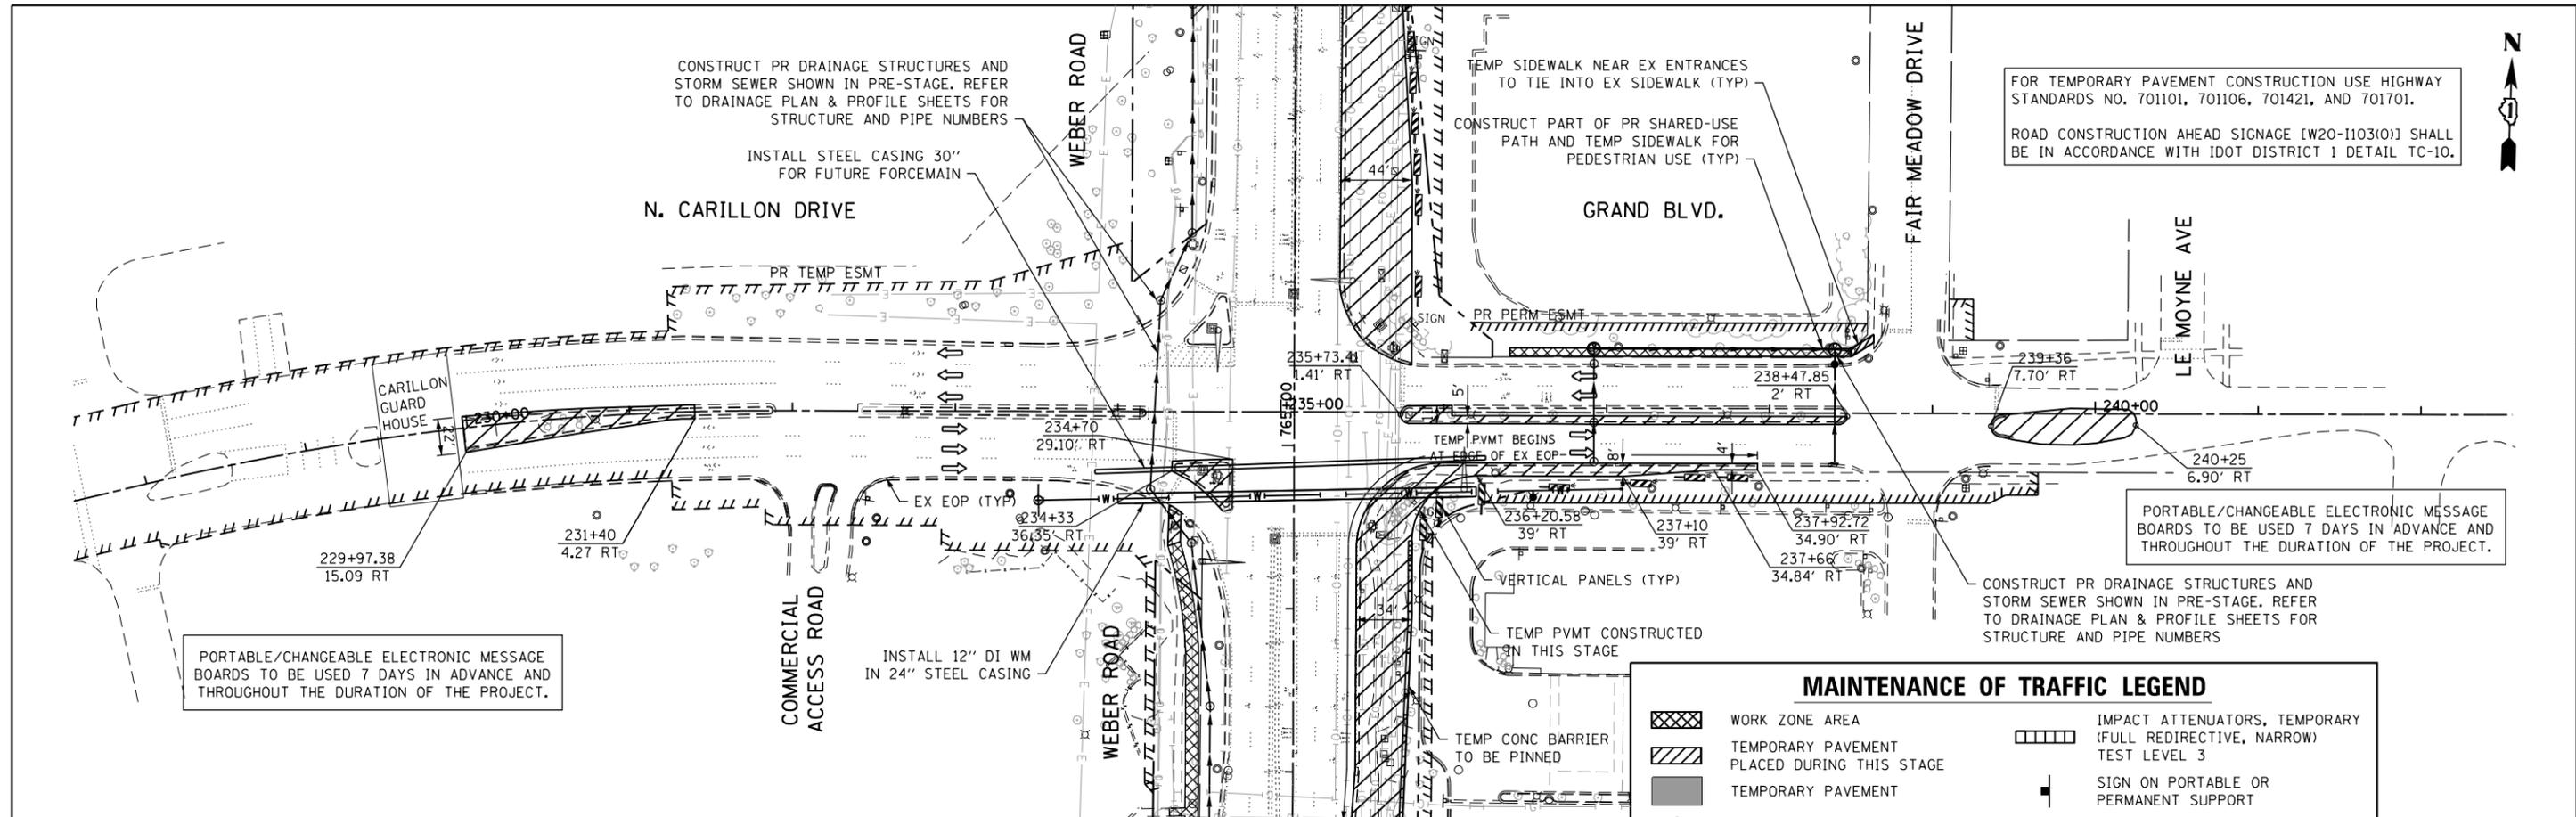


PORTABLE/CHANGEABLE ELECTRONIC MESSAGE BOARDS TO BE USED 7 DAYS IN ADVANCE AND THROUGHOUT THE DURATION OF THE PROJECT.

PORTABLE/CHANGEABLE ELECTRONIC MESSAGE BOARDS TO BE USED 7 DAYS IN ADVANCE AND THROUGHOUT THE DURATION OF THE PROJECT.

MAINTENANCE OF TRAFFIC LEGEND

	WORK ZONE AREA		IMPACT ATTENUATORS, TEMPORARY (FULL REDIRECTIVE, NARROW) TEST LEVEL 3
	TEMPORARY PAVEMENT PLACED DURING THIS STAGE		SIGN ON PORTABLE OR PERMANENT SUPPORT
	TEMPORARY PAVEMENT		TEMPORARY DITCH FLOW AND LOCATION
	DRUM OR TYPE II BARRICADE*		ARROW BOARD
	DIRECTION OF TRAFFIC	* TRAFFIC CONTROL DEVICE SPACING 50' C-C ON TANGENTS 25' C-C ON TAPERS OR LANE SHIFTS 12' C-C ON RADII	
	TYPE III BARRICADE		
	TEMPORARY CONCRETE BARRIER		
	VERTICAL PANEL*		

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	DRAWN - JBH	REVISED - 6/19/2015
PLOT SCALE = 100.0000' / in.	CHECKED - CRC	REVISED - 9/27/2016
PLOT DATE = 11/14/2017	DATE - 11/15/17	REVISED -

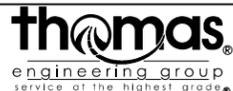**STATE OF ILLINOIS
DEPARTMENT OF TRANSPORTATION**

**MAINTENANCE OF TRAFFIC
N. CARILLON DRIVE / GRAND BLVD. - PRE STAGE 1**

SCALE: 1"=50' SHEET 5 OF 5 SHEETS STA. TO STA.

F.A.P. RTE.	SECTION	COUNTY	TOTAL SHEETS	SHEET NO.
856	14-00170-42-RP	WILL	394	100
CONTRACT NO. 61D47				
ILLINOIS FED. AID PROJECT				

