


NOTES

- 2. PERIMETER EROSION BARRIER SHALL BE ERECTED ADJACENT TO R.O.W., EASEMENT, AND CONSTRUCTION LIMITS AND AS DIRECTED
- 3. SEE PRE-STAGE CROSS SECTIONS FOR GRADING AND TEMPORARY CULVERT ELEVATION INFORMATION.
- 4. INLETS TO BE ADJUSTED WITH NEW TYPE 1 FRAME, CLOSED LID

- 1. SEE PROPOSED DRAINAGE PLANS FOR STORM SEWER INFORMATION. 5. CATCH BASINS TO BE ADUSTED WITH NEW TYPE 1 FRAME, CLOSED LID
 - 6. MANHOLES TO BE ADJUSTED
 - 7. CATCH BASINS TO BE ADJUSTED
 - 8. SANITARY MANHOLES TO BE ADJUSTED
 - 9. STORM SEWER TO BE FULLY CONSTRUCTED ACROSS ENTIRE ROADWAY, USING A SINGLE LANE CLOSURE, DURING OFF-PEAK HOURS.



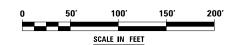


	USER NAME = mmaestra	DESIGNED DGB	REVISED -
ŀΤ		DRAWN DGB	REVISED -
	PLOT SCALE = 1:100	CHECKED PJO	REVISED -
neers & Architects	PLOT DATE = 5/13/2017	DATE 05/12/17	REVISED -

STATE OF ILLINOIS **DEPARTMENT OF TRANSPORTATION**

TEMPOR	RARY DRAINAGE & EROSIO	N CONTROL – STAGE	2 F.A.I/P RTE.	SECTION
	RAMP A		*	(99-1HB-1) R-1
	10.00 7			
SCALE: AS SHOWN	SHEET NO. 11 OF 12 SHEETS	STA. TO STA.	* FAI 55.	FAP 856 ILLINOIS FE

COUNTY WILL 1508 901 CONTRACT NO. 60X10

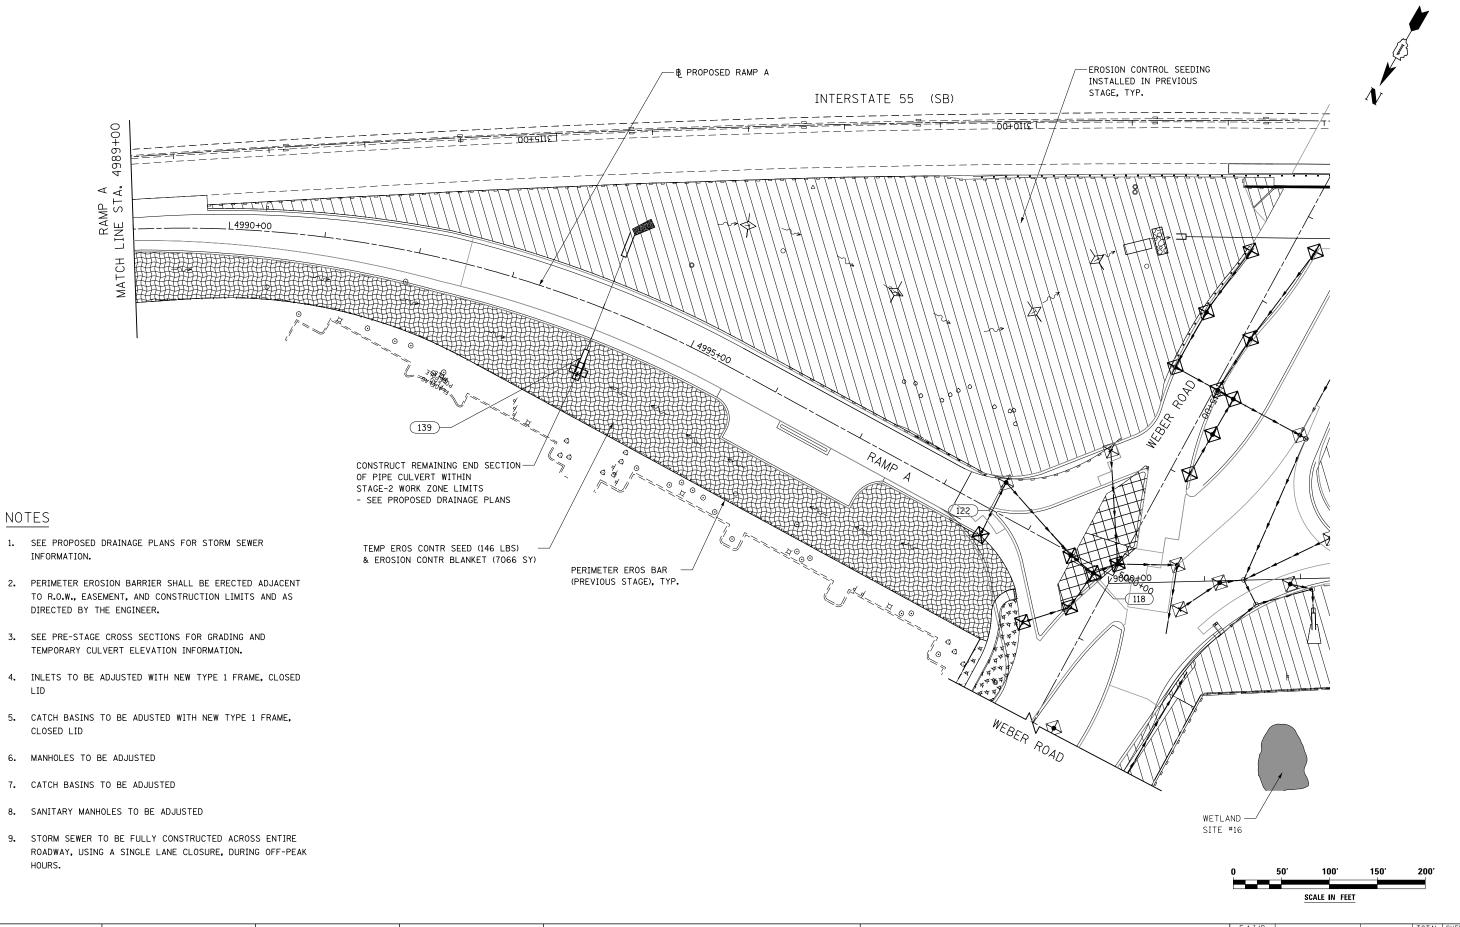


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	USER NAME = mmaestra	DESIGNED	DGB	REVISED -
IT		DRAWN	DGB	REVISED -
	PLOT SCALE = 1:100	CHECKED	PJ0	REVISED -
neers & Architects	PLOT DATE = 5/13/2017	DATE	05/12/17	REVISED -

TEMPORARY DRAINAGE & EROSION CONTROL - STAGE 2											
			R	AMP A							
SCALE: AS SHOWN	SHEET NO.	12 OF	12	SHEETS	STA.	TO STA.					

RTE			SE	ECTION			COUNTY	SHEET		NO.
*			(99-1	IHB-1) R	-1		WILL	1508	3	902
							CONTRACT	NO.	6	0X10
* FAI	55,	FAP	856	ILLINOIS	FED.	ΑI	D PROJECT			



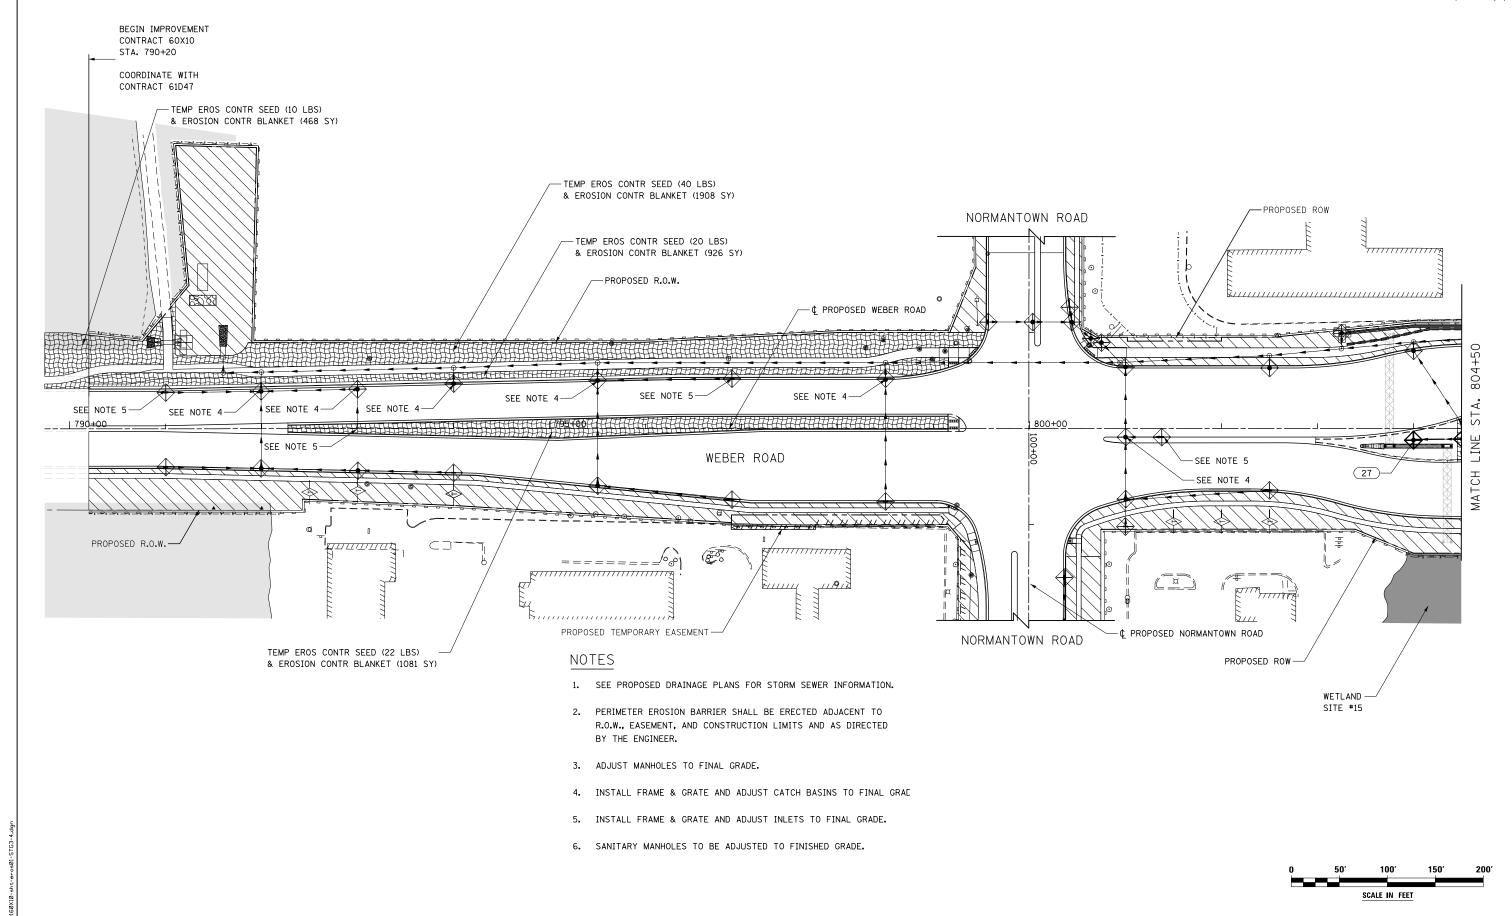

STATE OF ILLINOIS DEPARTMENT OF TRANSPORTATION

TEMPORARY DRAINAGE & EROSION CONTROL - STAGES 3 & 4

WEBER ROAD

SCALE: AS SHOWN | SHEET NO. 1 OF 7 SHEETS | STA. TO STA.


F.A.I/P SECTION COUNTY TOTAL SHEETS NO.

* (99-1HB-1) R-1 WILL 1508 903

CONTRACT NO. 60X10

* FAI 55 FAP 856 ILLINGIS[FD. AD PROJECT



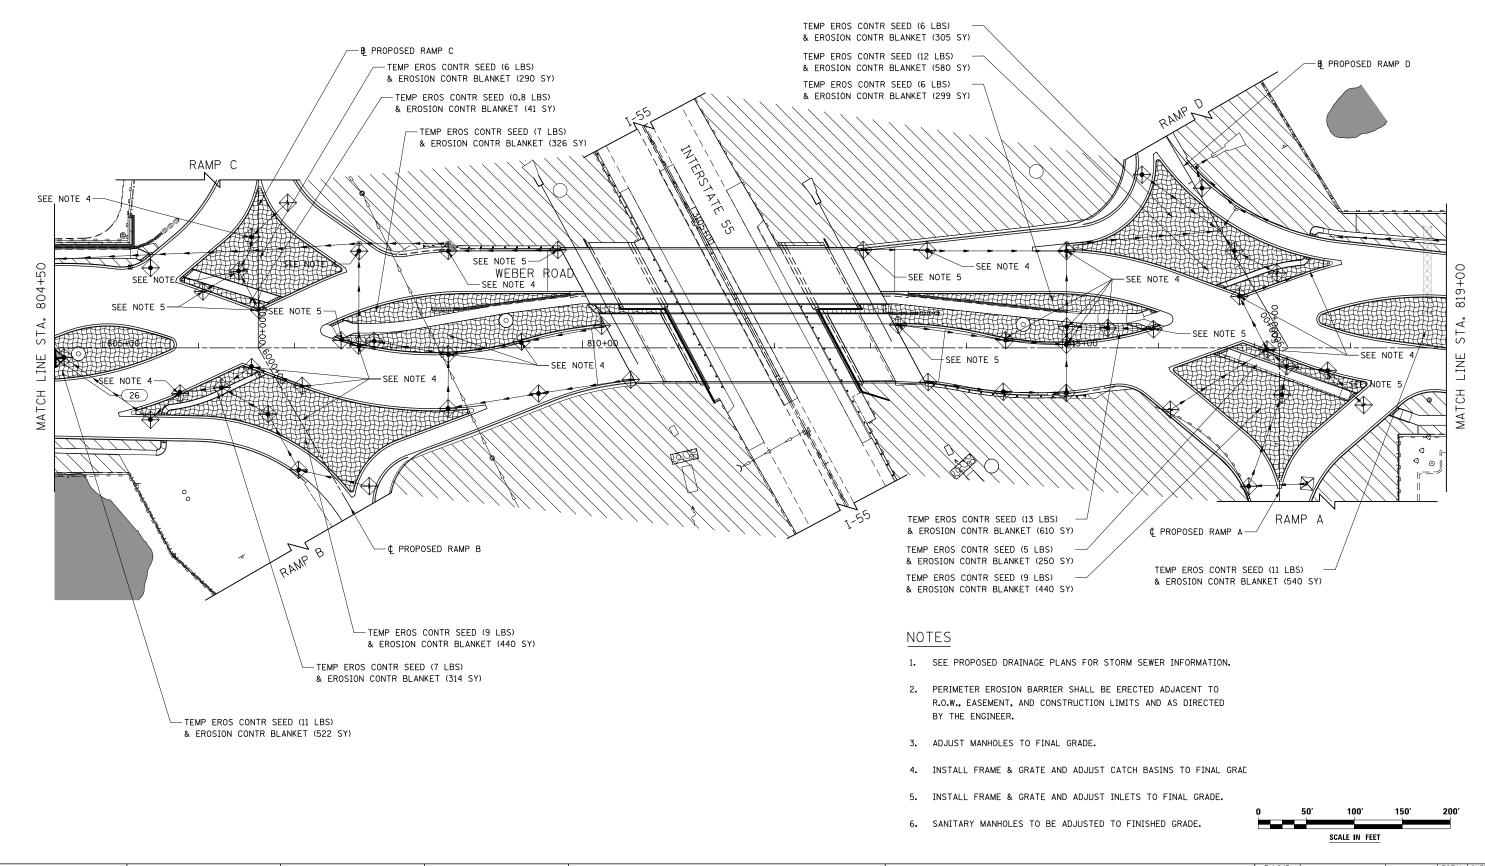


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PLOT SCALE = 1:100	CHECKED PJO	REVISED -
PLOT DATE = 5/13/2017	DATE 05/12/17	REVISED -

TEMPORAR	Y DRAINA	GE &	EF	ROSION	CONTRO	OL – STAGES 3 & 4
		1	ΝEI	BER RO	AD	
SCALE: AS SHOWN	SHEET NO.	2 OF	7	SHEETS	STA.	TO STA.

F.A.I/P RTE.	SECTION		COUNTY	TOTAL SHEETS	SHEE NO.
*	(99-1HB-1) R	-1	WILL	1508	904
			CONTRACT	NO. 6	0X10
* FAI 55,	FAP 856 ILLINOIS	FED. AII	PROJECT		



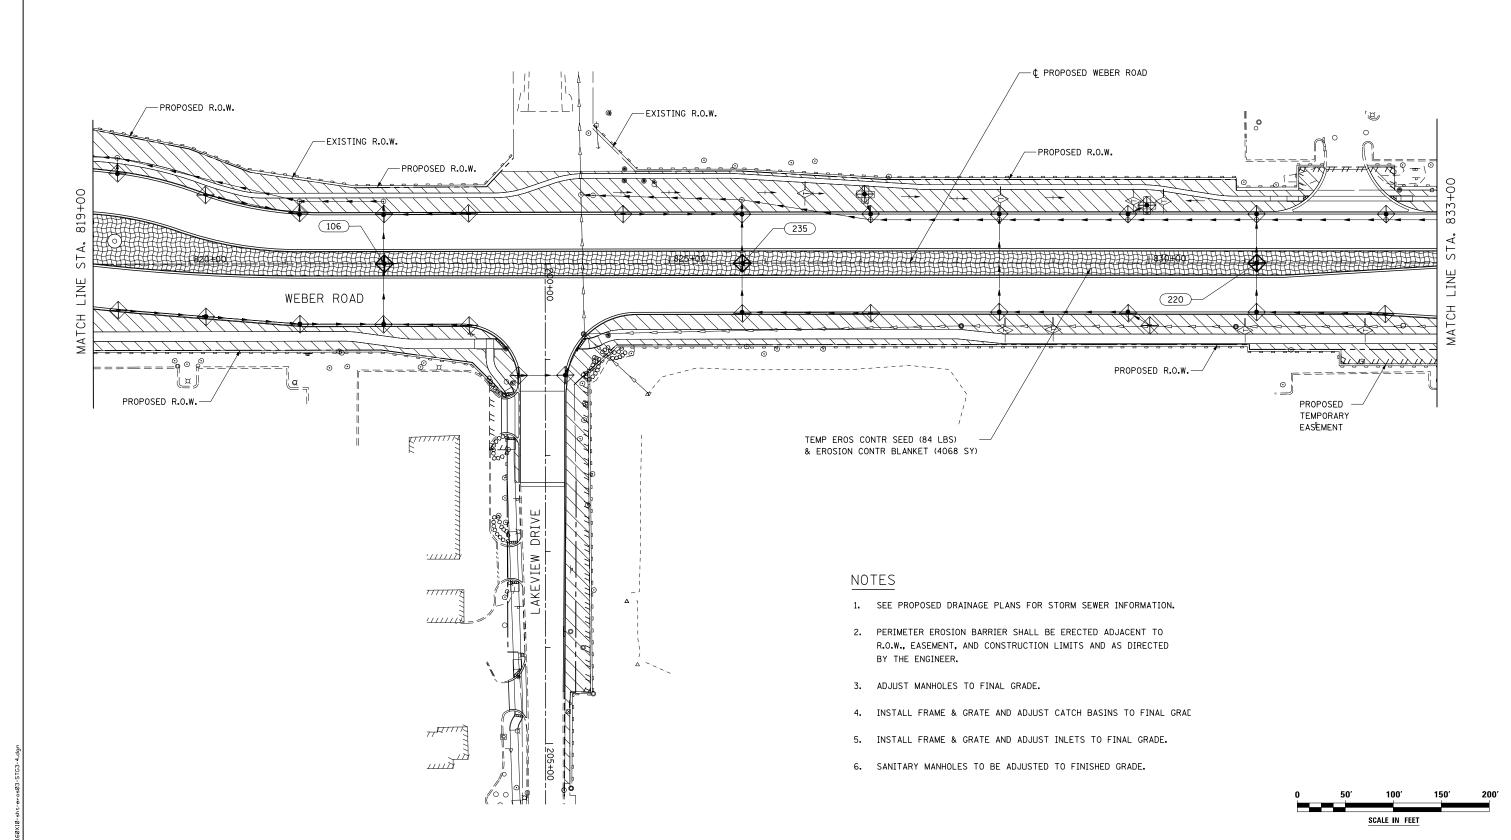


STATE OF ILLINOIS
DEPARTMENT OF TRANSPORTATION

TEMPORARY DRAINAGE & EROSION CONTROL - STAGE 3 & 4
WEBER ROAD AND LAKEVIEW DRIVE

SCALE: AS SHOWN SHEET NO. 3 OF 7 SHEETS STA. TO STA.



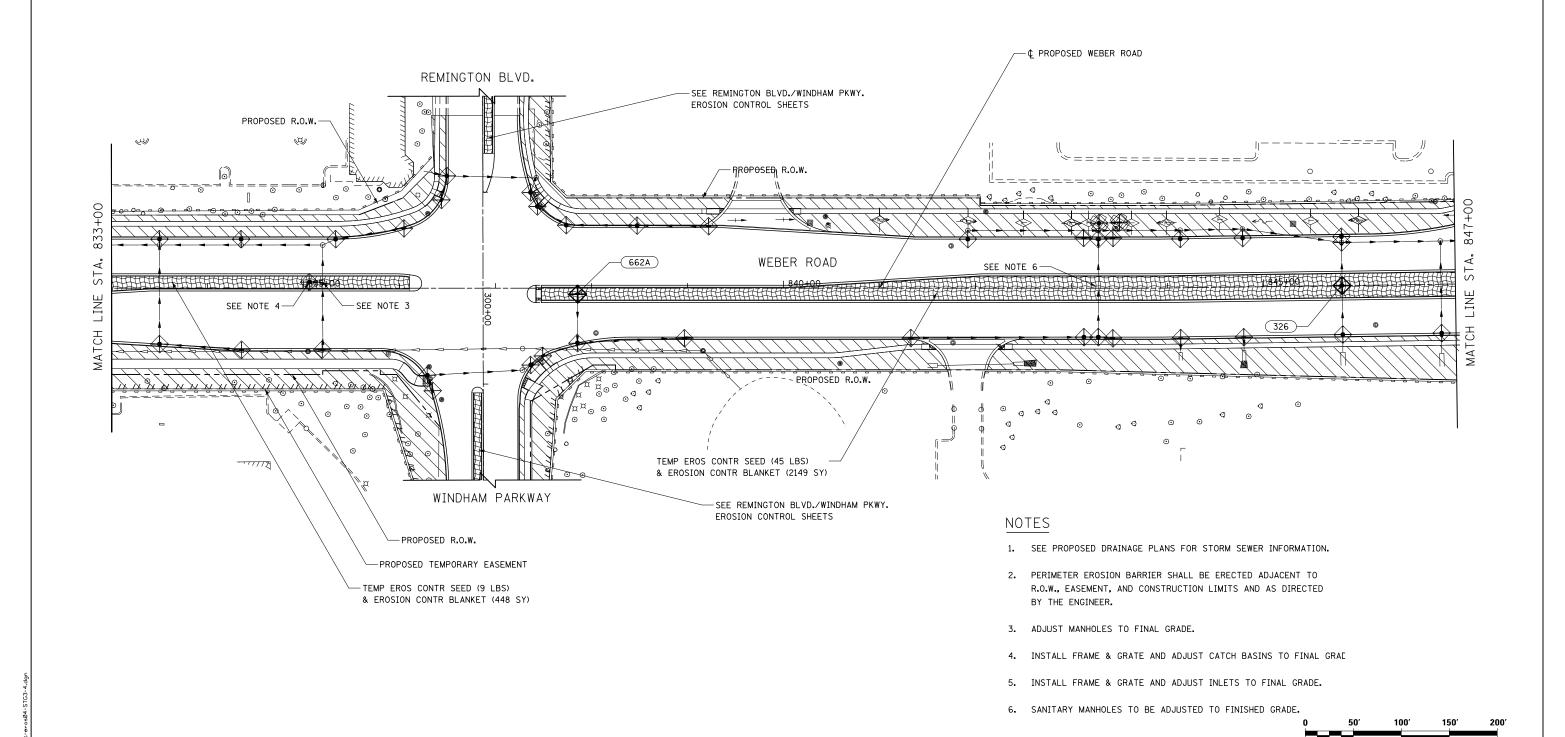


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PLOT SCALE = 1:100	CHECKED	PJ0	REVISED -
PLOT DATE = 5/13/2017	DATE	05/12/17	REVISED -


STATE OF ILLINOIS
DEPARTMENT OF TRANSPORTATION

TEMPORAR	Y DRAINA	GE	&	EF	ROSION	CONTROL	. – STAGES 3 & 4
			٧	۷EI	BER RO	AD	
SCALE: AS SHOWN	SHEET NO.	4	OF	7	SHEETS	STA.	TO STA.

1	F.A.I/P RTE.	SECTIO	N	COUNTY	TOTAL SHEETS	SHE NO
	*	(99-1HB-1)	R-1	WILL	1508	90
				CONTRACT	NO. 6	0X10
	* FAI 55,	FAP 856 ILLING	IS FED. AI	D PROJECT		

SCALE IN FEET

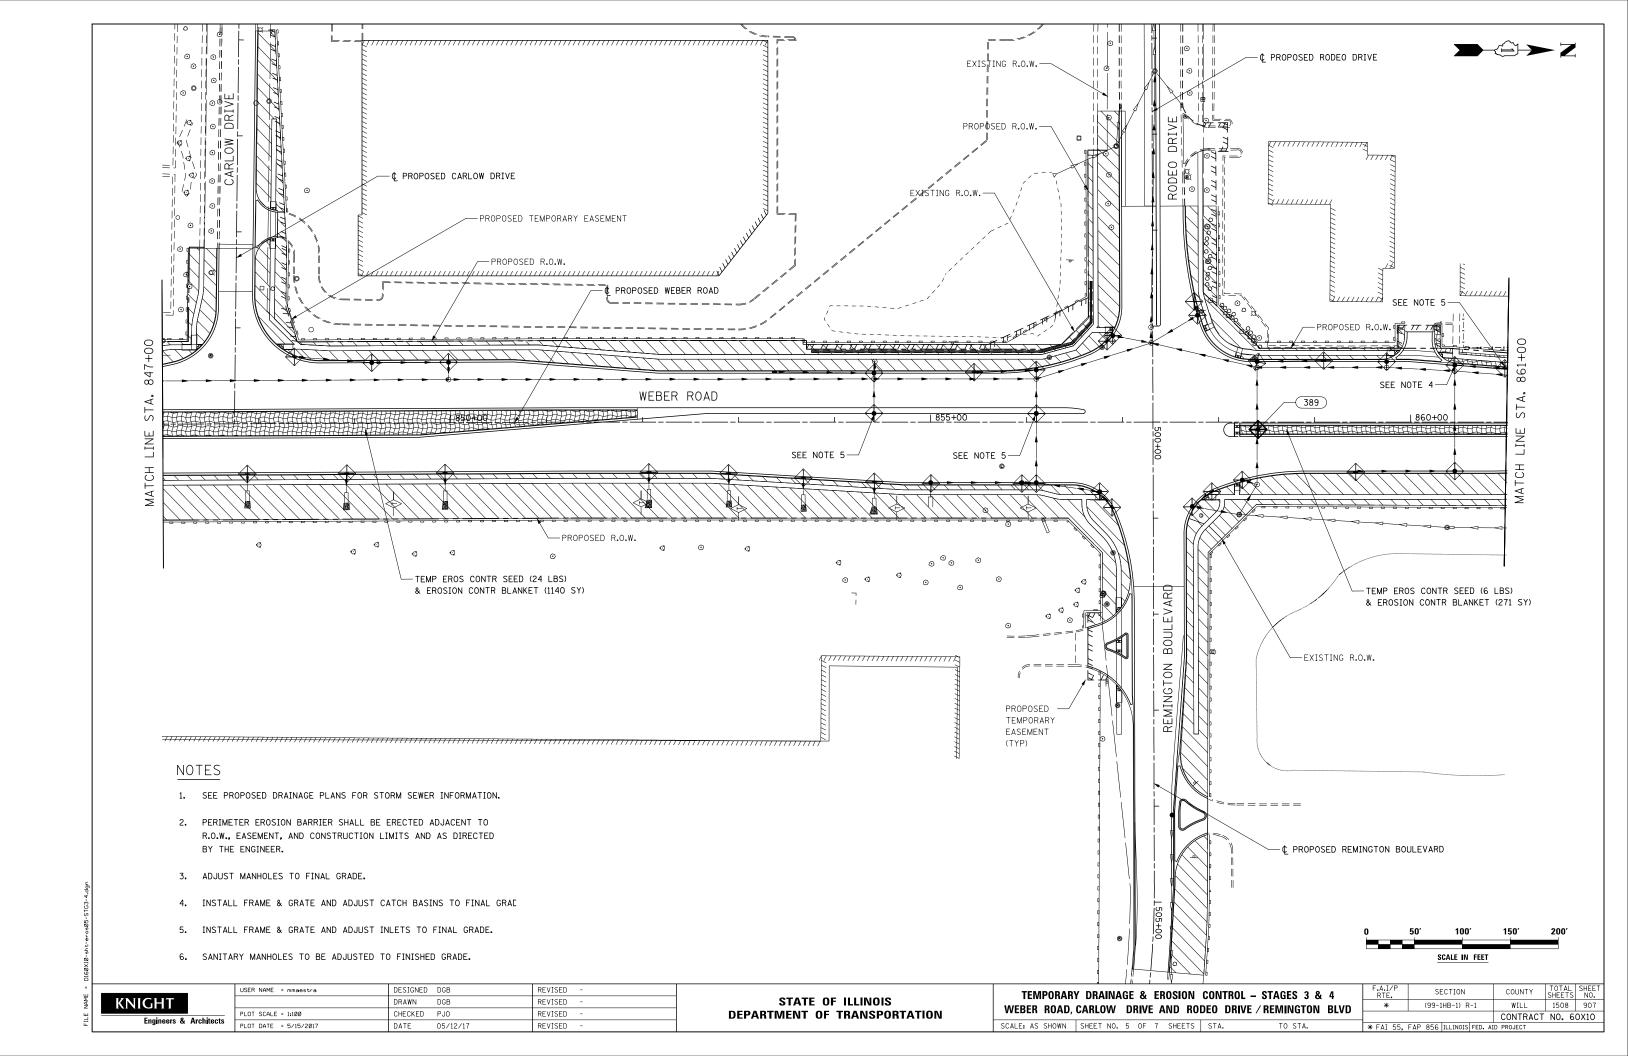

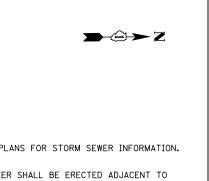

CONTRACT NO. 60X10

NOTES

SEE NOTE 5-


(830A)

EXISTING R.O.W.

SCALE: AS SHOWN SHEET NO. 6 OF 7 SHEETS STA.

TO STA.

- 1. SEE PROPOSED DRAINAGE PLANS FOR STORM SEWER INFORMATION.
- 2. PERIMETER EROSION BARRIER SHALL BE ERECTED ADJACENT TO R.O.W., EASEMENT, AND CONSTRUCTION LIMITS AND AS DIRECTED BY THE ENGINEER.
- 3. ADJUST MANHOLES TO FINAL GRADE.
- 4. INSTALL FRAME & GRATE AND ADJUST CATCH BASINS TO FINAL GRAD
- 5. INSTALL FRAME & GRATE AND ADJUST INLETS TO FINAL GRADE.
- 6. SANITARY MANHOLES TO BE ADJUSTED TO FINISHED GRADE.

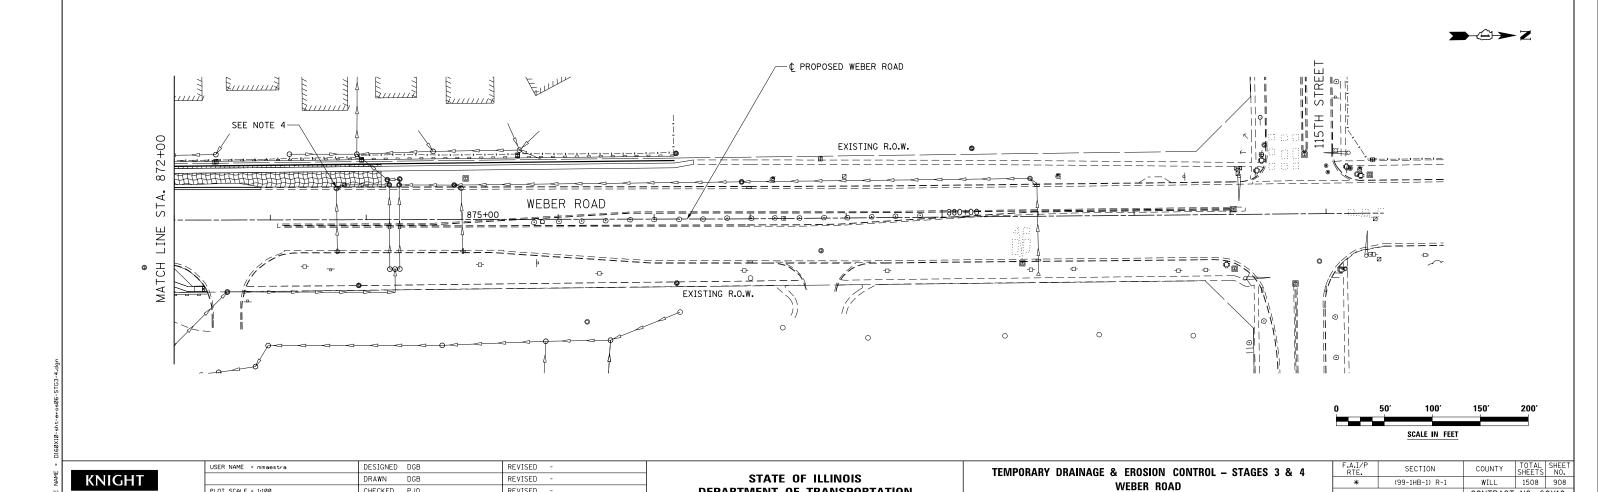

DEPARTMENT OF TRANSPORTATION

PROPOSED WEBER ROAD

EXISTING R.O.W.

WEBER ROAD

-SEE NOTE 5

-EXISTING R.O.W.

11111111

861+00

STA.

LINE

MATCH

SEE NOTE 57

TEMP EROS CONTR SEED (32 LBS) & EROSION CONTR BLANKET (1522 SY)

-SEE NOTE 5

PLOT SCALE = 1:100

PLOT DATE = 5/13/2017

Engineers & Architects

CHECKED PJO

05/12/17


DATE

REVISED

REVISED

SEE NOTE 5-

SEE NOTE 5

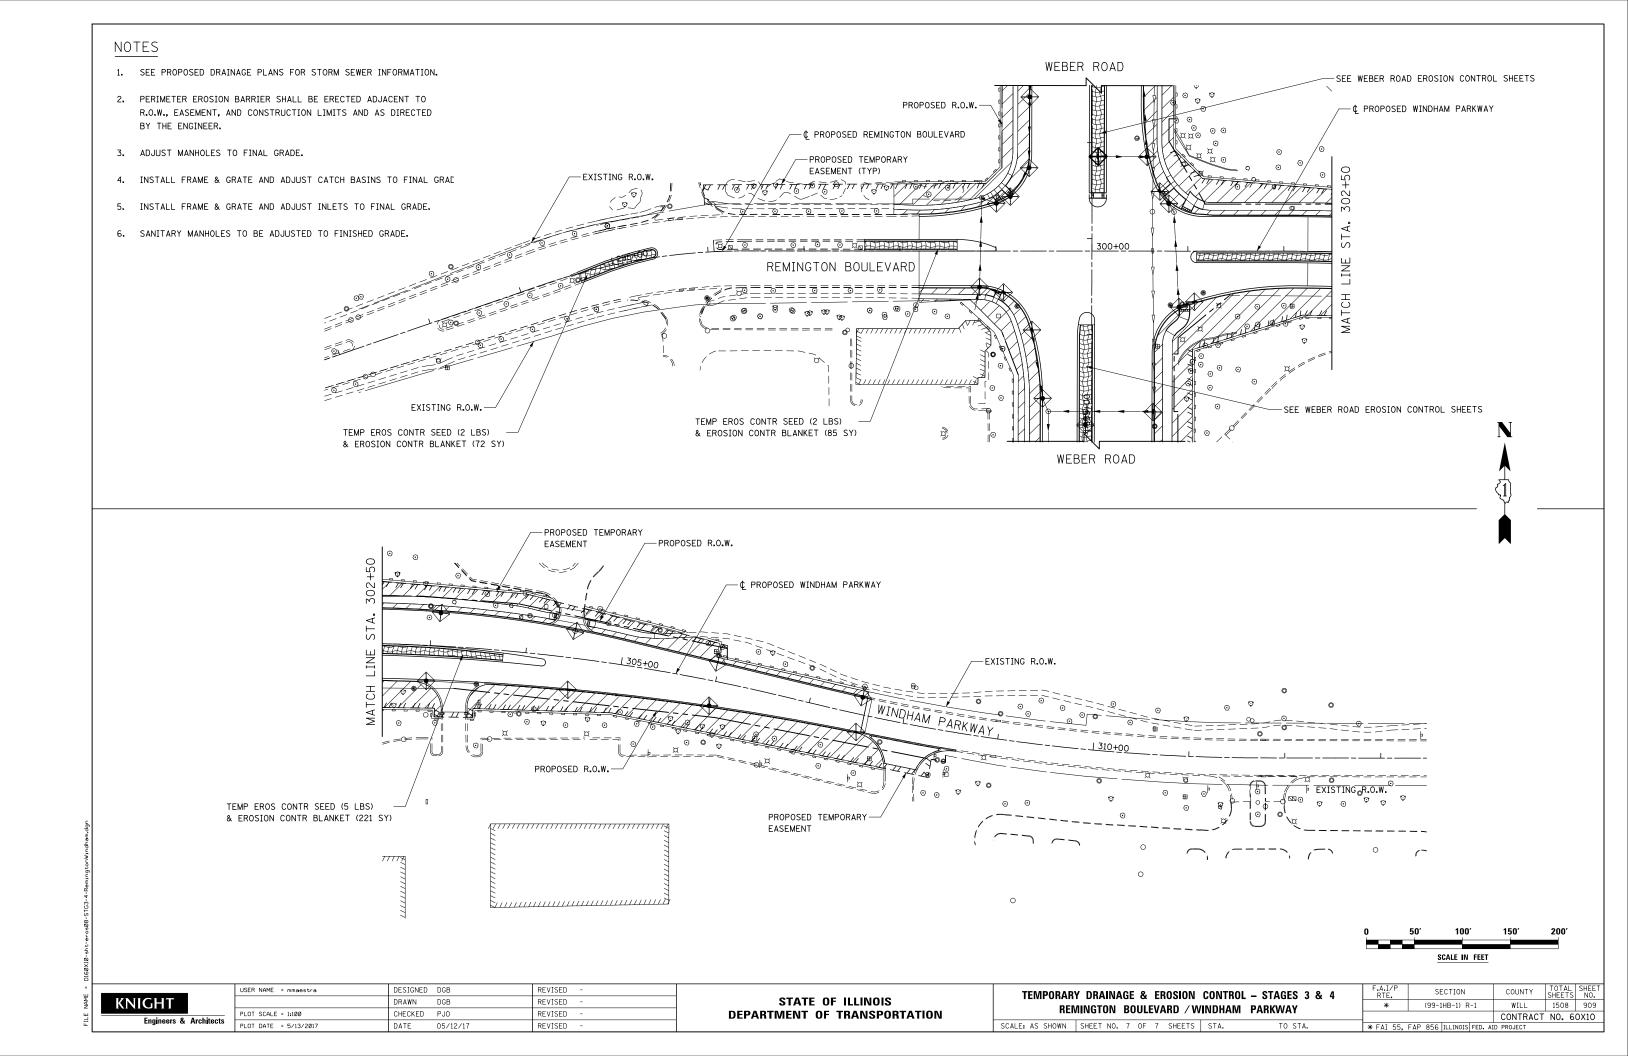

				SC	HEDU	LE OF	LANDS	CAPE	QUANT	TITIES								
									LANDSC	APE PLA	N SHEET	NUMBER	₹					
DESCRIPTION	Unit	Total	Sheet 1	Sheet 2	Sheet 3	Sheet 4	Sheet 5	Sheet 6	Sheet 7	Sheet8	Sheet 9	Sheet 10	Sheet 11	Sheet12	Sheet 13	Sheet 14	Sheet 15	Sheet 16
TREE, ACER X FREEMANII AUTUMN BLAZE (AUTUMN BLAZE FREEMAN MAPLE), 8' HEIGHT CLUMP FORM, BALLED AND BURLAPPED	EACH	7						6	5 1	1								
TREE, AESCULUS FLAVEA (YELLOW SWEET BUCKEYE), 2" CALIPER, BALLED AND BURLAPPED	EACH	22									2	6	9)		4	1	
TREE, AESCULUS CARNEA FORT MCNAIR (FORT MCNAIR BUCKEYE), 2" CALIPER, BALLED AND BURLAPPED,	EACH	11										3				8		
TREE, CARPINUS CAROLINIANA (AMERICAN HORNBEAM), 2" CALIPER, BALLED AND BURLAPPED	EACH	7															7	
TREE, CARYA OVATA (SHAGBARK HICKORY), 2" CALIPER, BALLED AND BURLAPPED	EACH	9											6	3			3	,
TREE, CELTIS OCCIDENTALIS (COMMON HACKBERRY), 2" CALIPER, BALLED AND BURLAPPED	EACH	46	7		7	7 6	6 .	5 6	5 4	1						6	5	,
TREE, GLEDITSIA TRIA CANTHOS INERMIS SKYLINE (SKYLINE THORNLESS COMMON HONEYLOCUST), 2" CALIPER, BALLED AND BURLAPPED	EACH	37			12	2 7	7	3	7	7	5							
TREE, GYMNOCLADUS DIOICUS (KENTUCKY COFFEETREE), 2-1/2" CALIPER, BALLED AND BURLAPPED	EACH	66	23			18	3 8	3 14							3			
TREE, LIRIODENDRON TULIPIFERA (TULIP TREE), 2" CALIPER BALLED AND BURLAPPED	BACH	9						g)									
TREE, OSTRYA VIRGINIANA (AMERICAN HOPHORNBEAM), 8' HEIGHT, CLUMP FORM, BALLED AND BURLAPPED	EACH	19						19)									
TREE, PLATANUS X ACERIFOLIA MORTON CIRCLE (EXCLAMATION LONDON PLANETREE), 2" CALIPER, TREE FORM, BALLED AND BURLAPPED	EACH	35	3		7	' 1 ⁻	1 4	4 10										
TREE, QUERCUS BICOLOR (SWAMP WHITE OAK), 2" CALIPER, BALLED AND BURLAPPED	EACH	28	3		3	3		g) 1	1		2				10		
TREE, QUERCUS IMBRICARIA (SHINGLE OAK), 2" CALIPER, BALLED AND BURLAPPED	EACH	41	12		(3	4	4 6	3		5	8						
TREE, QUERCUS MACROCARPA (BUR OAK), 2" CALIPER, BALLED AND BURLAPPED	EACH	13					-	7	1	1					5			
TREE, QUERCUS MUELENBERGII (CHINKAPIN OAK), 2" CALIPER, BALLED AND BURLAPPED	EACH	2															2	
TREE, QUERCUS RUBRA (RED OAK), 2" CALIPER, BALLED AND BURLAPPED	EACH	7									2					3	2	!

KNIGHT	
Engineers &	Architects

USER NAME = dbarnes	DESIGNED	DGB	REVISED	-
	DRAWN	DGB	REVISED	-
PLOT SCALE = 1:20	CHECKED	PJ0	REVISED	-
PLOT DATE = 6/15/2017	DATE	06/16/17	REVISED	-

			F.A.I/P RTE.	SECTION	COUNTY	TOTAL SHEETS	SHEET NO.	
	LA	NDS	CAPE SCH	*	(99-1HB-1) R-1	WILL	1508	910
						CONTRACT	NO. 6	0X10
SCALE: AS SHOWN	SHEET NO. 1	OF	2 SHEETS	* FAI 55,	FAP 856 ILLINOIS FED. A	D PROJECT		


				SC	HEDUI	E OF	LANDS	CAPE (QUANT	ITIES								
LANDSCAPE PLAN SHEET NUMBER																		
DESCRIPTION	Unit	Total	Sheet 1	Sheet 2	Sheet 3	Sheet 4	Sheet 5	Sheet 6	Sheet 7	Sheet8	Sheet 9	Sheet 10	Sheet 11	Sheet12	Sheet 13	Sheet 14	Sheet 15	Sheet 16
TREE, TA XODIUM DISTICHUM (COMMON BALD CYPRESS), 3" CALIPER, BALLED AND BURLAPPED	EACH	15											9				6	3
TREE, TILIA AMERICANA MCKSENTRY (SENTRY AMERICAN LINDEN/BASSWOOD), 2" CALIPER, BALLED AND BURLAPPED	EACH	24			12	5	7											
TREE, ULMUS AMERICANA PRINCETON (PRINCETON AMERICAN ELM), 2" CALIPER, BALLED AND BURLAPPED	EACH	40	7		22	5	1	5										
TREE, AMELANCHIER X GRANDIFLORA (APPLE SERVICEBERRY), 6' HEIGHT, SHRUB FORM, BALLED AND BURLAPPED	EACH	6			3				3									
TREE, CORNUS MAS 'GOLDEN GLORY' (GOLDEN GLORY CORNELIAN CHERRY DOGWOOD), 6' HEIGHT, CLUMP FORM, BALLED AND BURLAPPED	, EACH	5							5									
TREE, CRATAEGUS CRUSGALLI INERMIS (THORNLESS COCKSPUR HAWTHORN), 6' HEIGHT, SHRUB FORM, BALLED AND BURLAPPED	EACH	11	3													4	. 4	1
TREE, PRUNUS VIRGINIANA SCHUBERT (CANADA RED CHOKE CHERRY), 6' HEIGHT, CLUMP FORM, BALLED AND BURLAPPED	EACH	8										2	4			2		
TREE, SYRNGA RETICULATA IVORY SILK (IVORY SILK JAPANESE TREE LILAC), 2" CALIPER, TREE FORM, BALLED AND BURLAPPED	EACH	31				18				13								
SHRUB, VIBURNUM LENTAGO (NANNY BERRY VIBURNUM), 4' HEIGHT, BALLED AND BURLAPPED	EACH	334														60	274	1
SHRUB, RHUS AROMATICA GRO-LOW (GRO-LOW FRAGRANT SUMAC), 15" WIDTH, CONTAINER	EACH	116					116											
SHRUB, RHUS AROMATICA GRO-LOW (GRO-LOW FRAGRANT SUMAC), 2' WIDTH, CONTAINER	EACH	1410								150		230	140			490	400)
EVERGREEN, PINUS FLEXILIS VANDERWOLF'S PYRAMID (VANDERWOLF'S PYRAMID LIMBER PINE), 6' HEIGHT, BALLED AND BURLAPPED	EACH	28									8	8	4	5	;	3		
VINE-PARTHENOCISSUS QUINQUEFOLIA ENGEL MANNII (ENGELMANNII VIRGINIA CREEPER), 1-GALLON POT	EACH	335					10	325										
PERENNIAL PLANTS, WETLAND TYPE, 2" DIAMETER BY 4" DEEP PLUG	UNIT	42	42															
PERENNIAL PLANTS, SEDGE MEADOW TYPE, 2" DIAMETER BY 4" DEEP PLUG	UNIT	282										60	39			72	111	1
TRANSPLANTED SALVAGED TREES	EACH	33											14			8	11	1

Engineers & /	A l4 4.
KNIGHT	

	USER NAME = mmaestra	DESIGNED	DGB	REVISED	-
		DRAWN	DGB	REVISED	-
_	PLOT SCALE = 1:20	CHECKED	PJ0	REVISED	-
s	PLOT DATE = 5/13/2017	DATE	05/12/17	REVISED	-

STATE	OF ILLINOIS	
DEPARTMENT (OF TRANSPORTATION	N

			F.A.I/P RTE.	SECTION	COUNTY	TOTAL SHEETS	SHEET NO.
	LANDS	CAPE SCH	*	(99-1HB-1) R-1	WILL	1508	911
					CONTRACT	NO. 6	0X10
SCALE: AS SHOWN	SHEET NO. 2 OF	2 SHEETS	* FAI 55,	FAP 856 ILLINOIS FED. AT	D PROJECT		

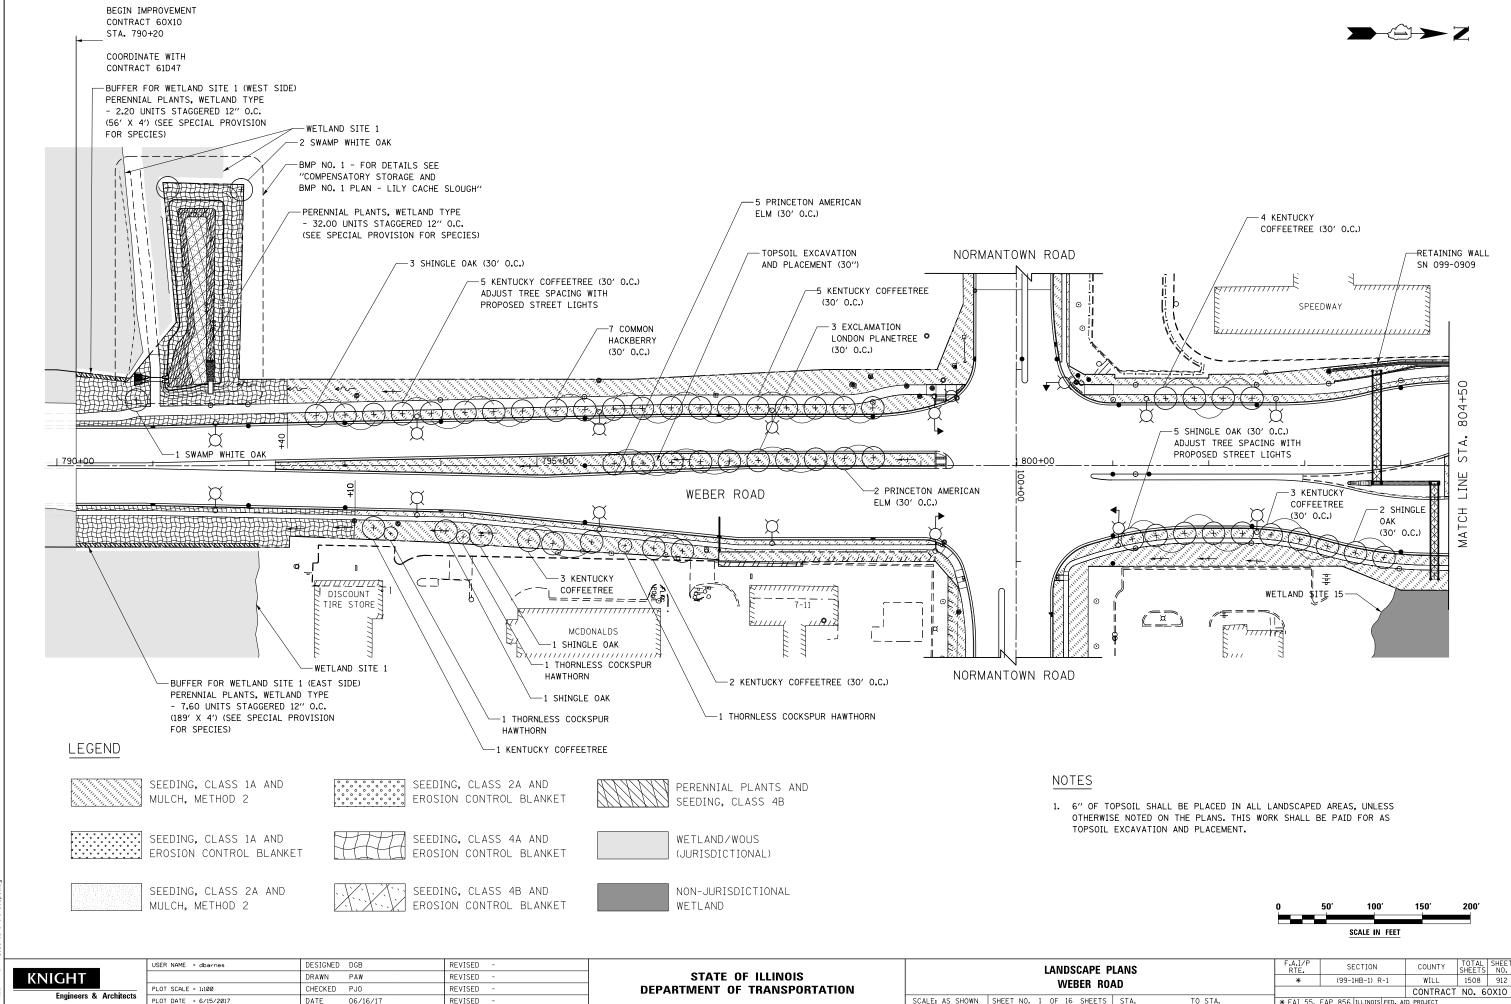


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	PLOT SCALE = 1:100	CHECKED	PJ0	REVISED	-
cts	PLOT DATE = 6/15/2017	DATE	06/16/17	REVISED	-

DEPARTMENT OF TRANSPORTATION

			LANDSCAPE PLANS										
WEBER ROAD											(99-1	HB-1) I	₹-
WEDEN NOAD													П
SHOWN	SHOWN SHEET NO. 1 OF 16 SHEETS					STA.	TO STA.	* FAI	55,	FAP	856	ILLINOIS	3 F



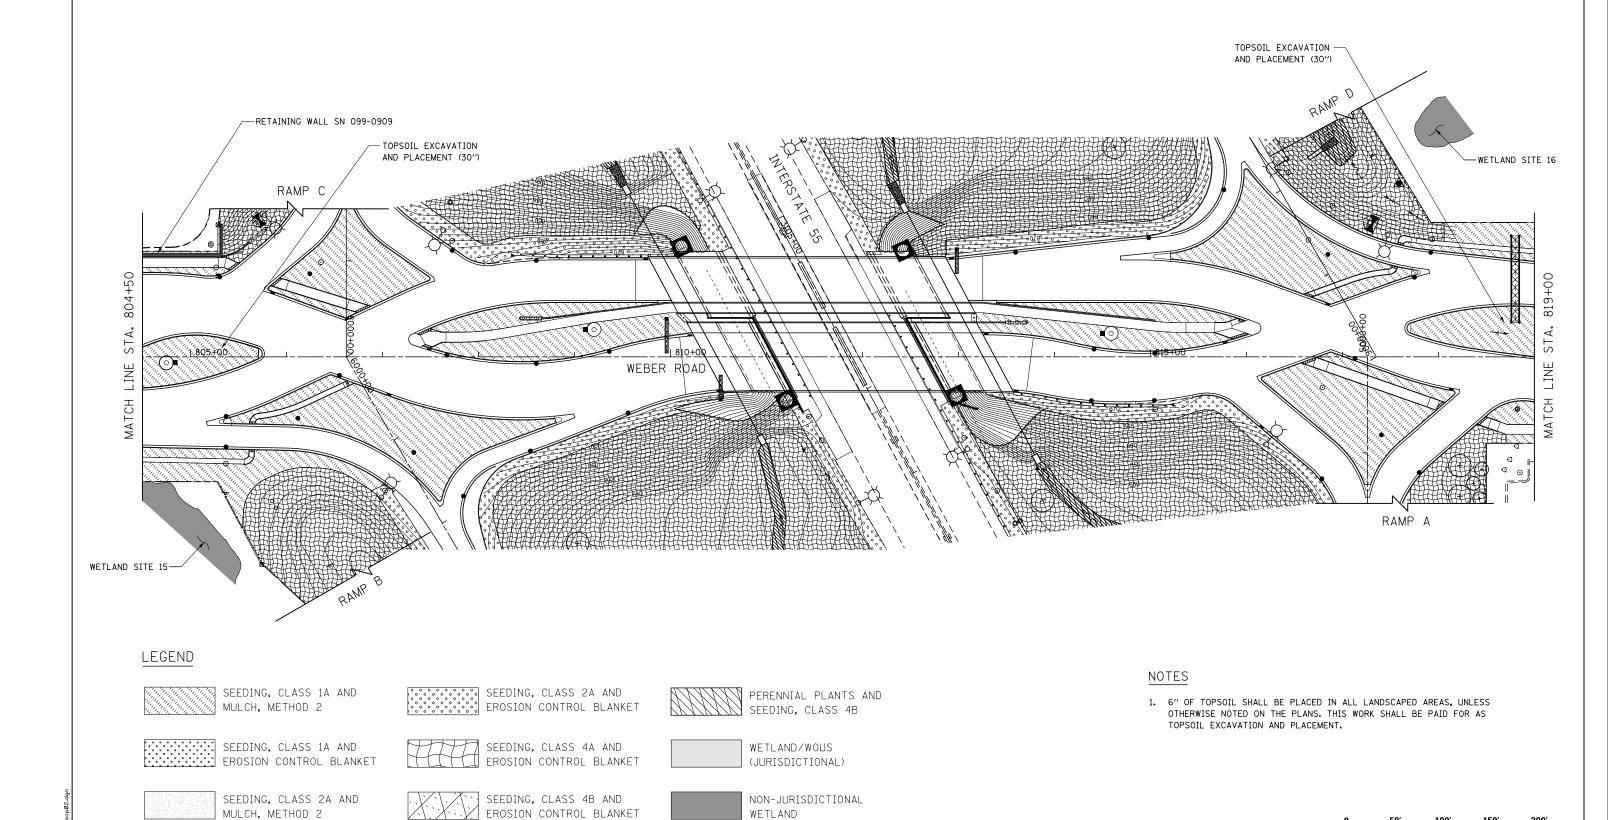


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\$	PLOT DATE = 5/13/2017	DATE	05/12/17	REVISED	-

STATE OF ILLINOIS
DEPARTMENT OF TRANSPORTATION

	LANDSCAPE P	F.A.I/P RTE.	SECTION	COUNTY	TOTAL SHEETS	SHEET NO.
	WEBER ROA	*	(99-1HB-1) R-1	WILL	1508	913
				CONTRACT	NO. 6	0X10
SCALE: AS SHOWN	SHEET NO. 2 OF 16 SHEETS	* FAI 55,	FAP 856 ILLINOIS FED. AI	ID PROJECT		

SCALE IN FEET



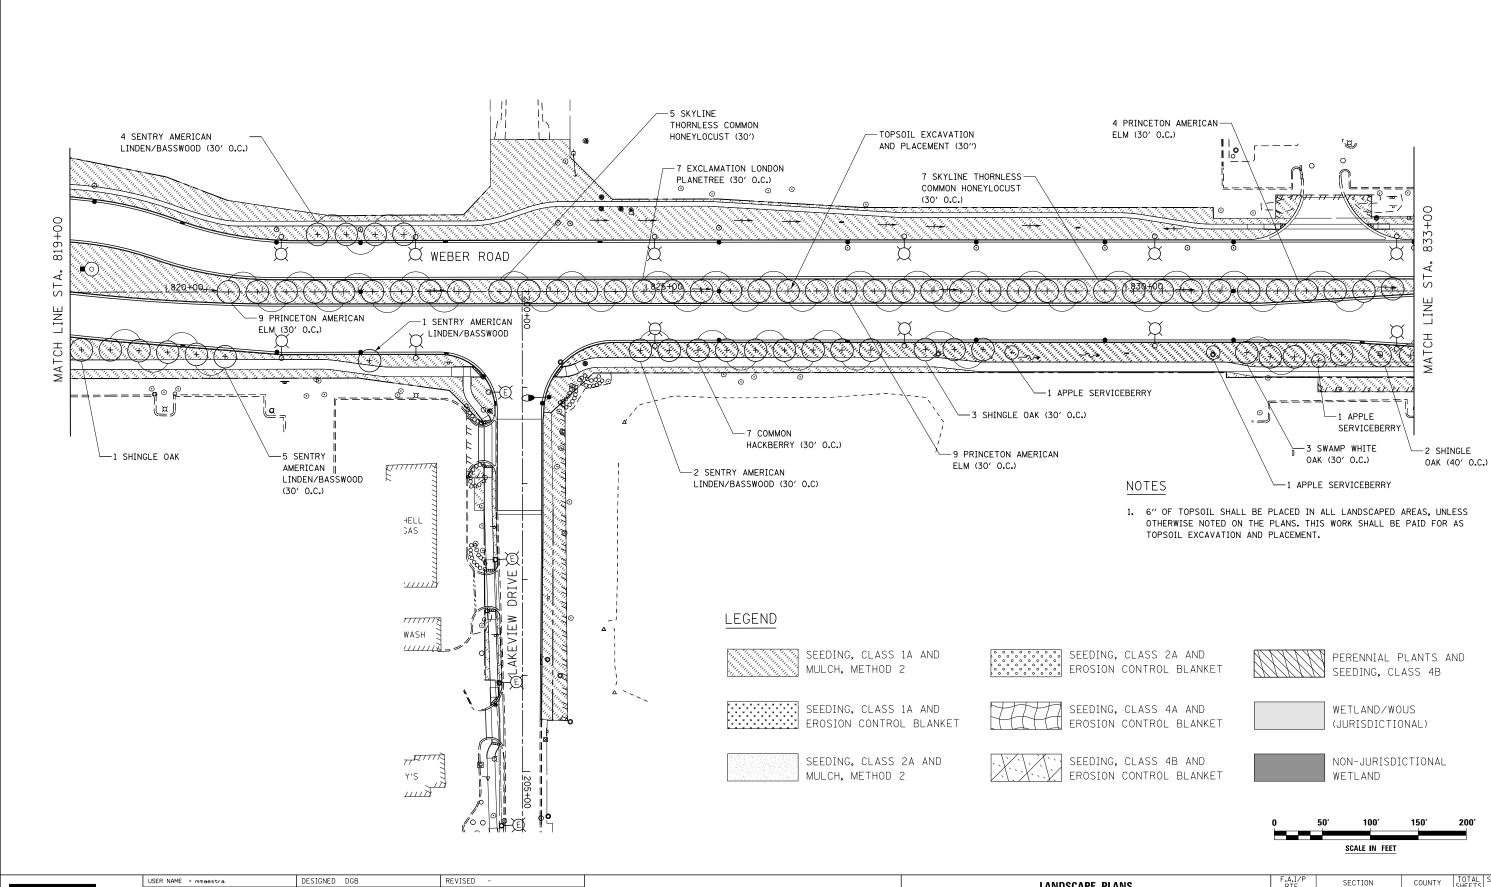

'ILE NAME = DI60X10-sht-l

KNIGHT


Engineers & Architects

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PLOT DATE = 5/13/2017	DATE	05/12/17	REVISED -

STATE OF ILLINOIS DEPARTMENT OF TRANSPORTATION

LANDSCAPE PLANS							
	WEBER	ROAD) AND	LAKEVIEW	DRIVE		
SCALE: AS SHOWN	SHEET NO.	3 OF	16 SHEE	TS STA.		TO S	



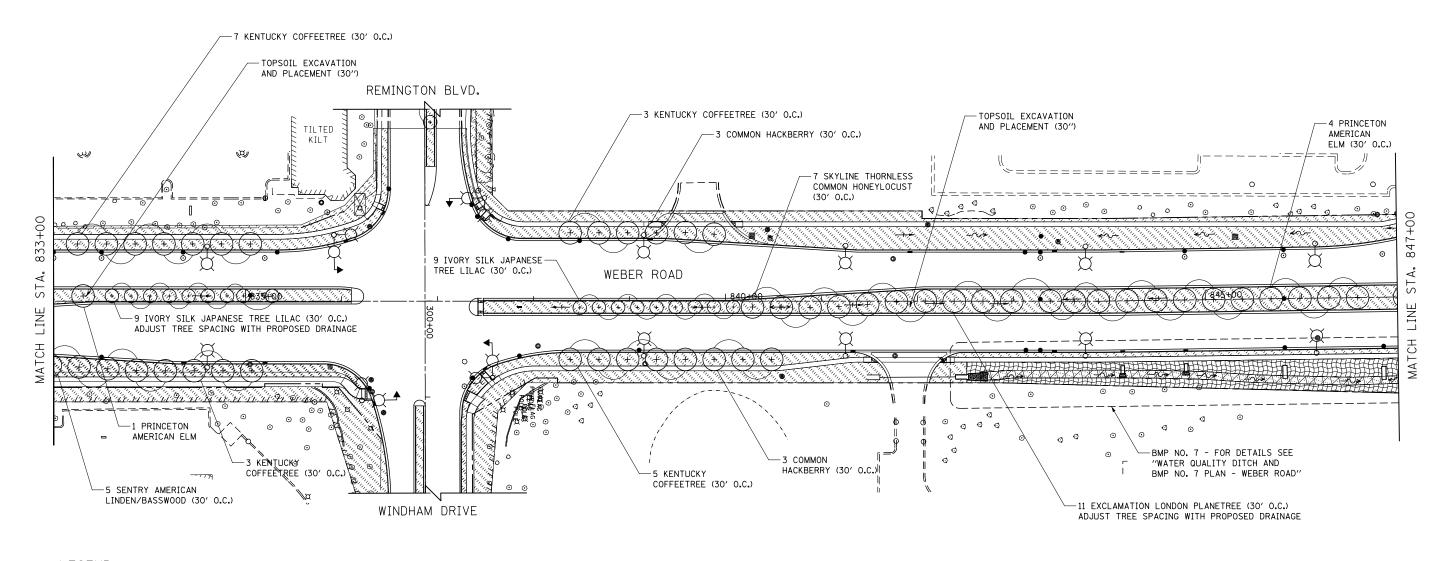

LEGEND

SEEDING, CLASS 1A AND MULCH, METHOD 2

SEEDING, CLASS 1A AND

SEEDING, CLASS 2A AND

MULCH, METHOD 2

EROSION CONTROL BLANKET

SEEDING, CLASS 2A AND EROSION CONTROL BLANKET

SEEDING, CLASS 4A AND

EROSION CONTROL BLANKET



PERENNIAL PLANTS AND SEEDING, CLASS 4B



WETLAND/WOUS (JURISDICTIONAL)




SEEDING, CLASS 4B AND EROSION CONTROL BLANKET



NOTES


1. 6" OF TOPSOIL SHALL BE PLACED IN ALL LANDSCAPED AREAS, UNLESS OTHERWISE NOTED ON THE PLANS. THIS WORK SHALL BE PAID FOR AS TOPSOIL EXCAVATION AND PLACEMENT.

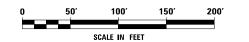






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		DRAWN	PAW	REVISED	-
	PLOT SCALE = 1:100	CHECKED	PJ0	REVISED	-
ers & Architects	PLOT DATE = 5/15/2017	DATE	05/12/17	REVISED	-

	LANDSCAP	E PLANS		F.A.I/P RTE.	SECTION	COUNTY	TOTAL SHEETS	SHEET NO.
	WEBER	*	(99-1HB-1) R-1	WILL	1508	915		
				CONTRACT	NO. 6	0X10		
SCALE: AS SHOWN	SHEET NO. 4 OF 16 SHEE	TS STA.	TO STA.	* FAI 55,	FAP 856 ILLINOIS FED. AT	ID PROJECT		

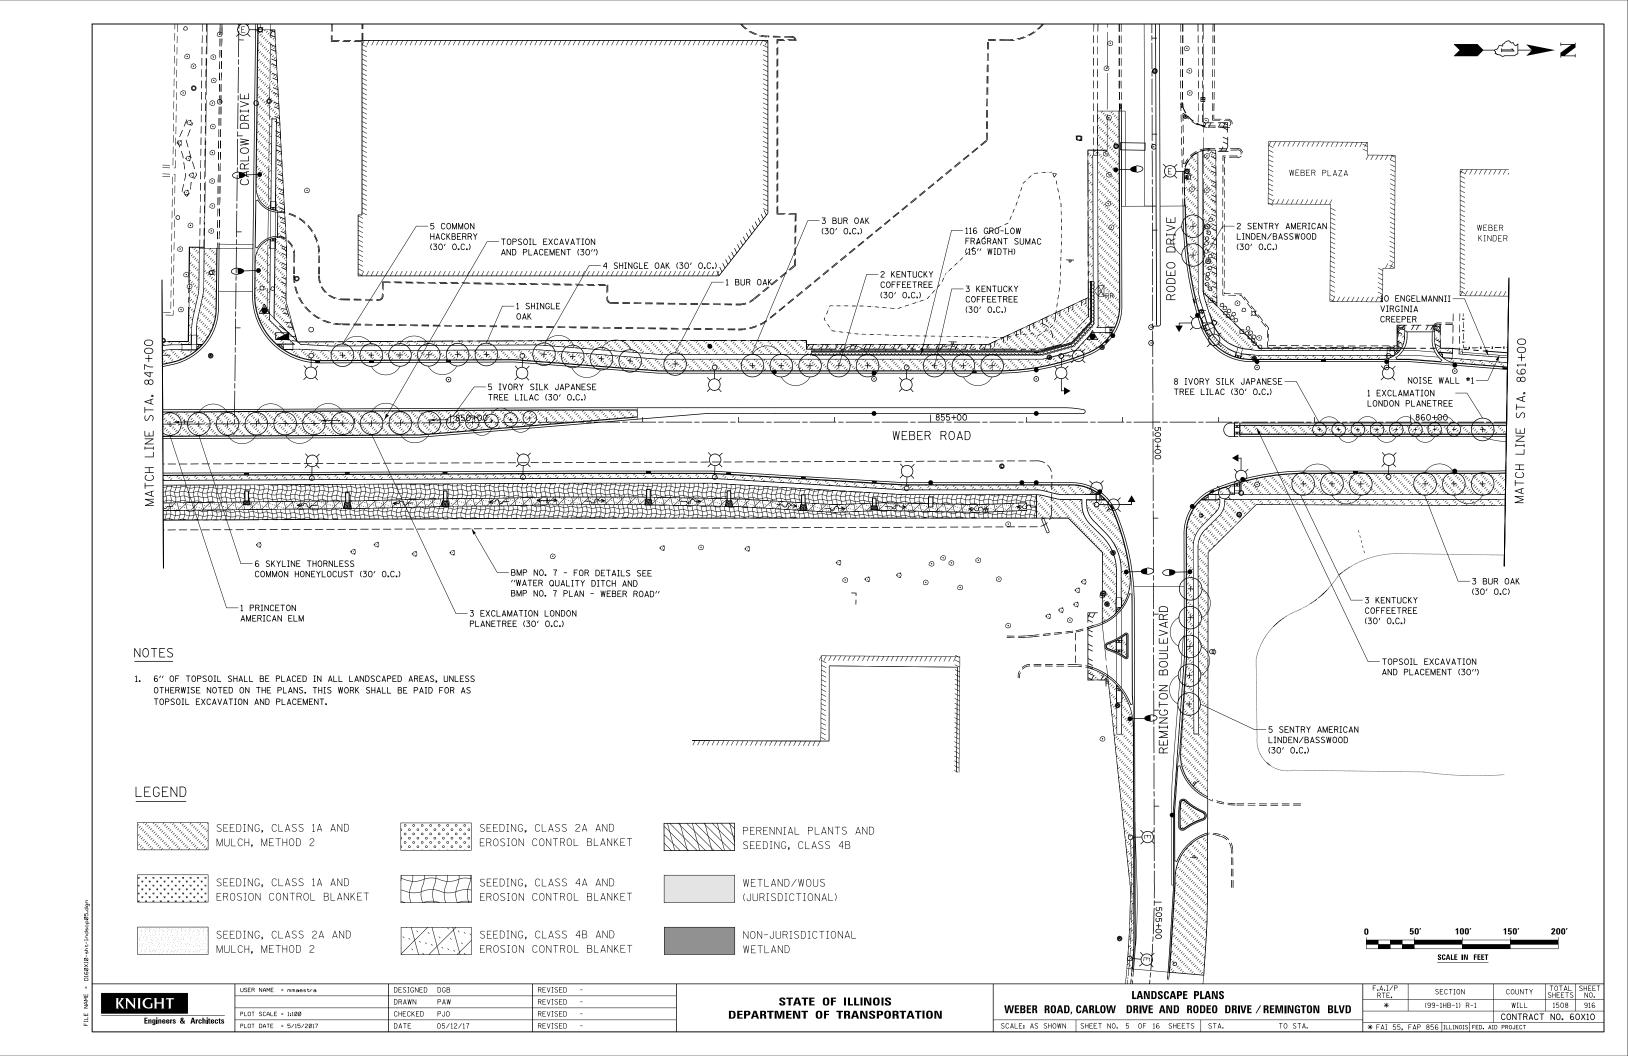


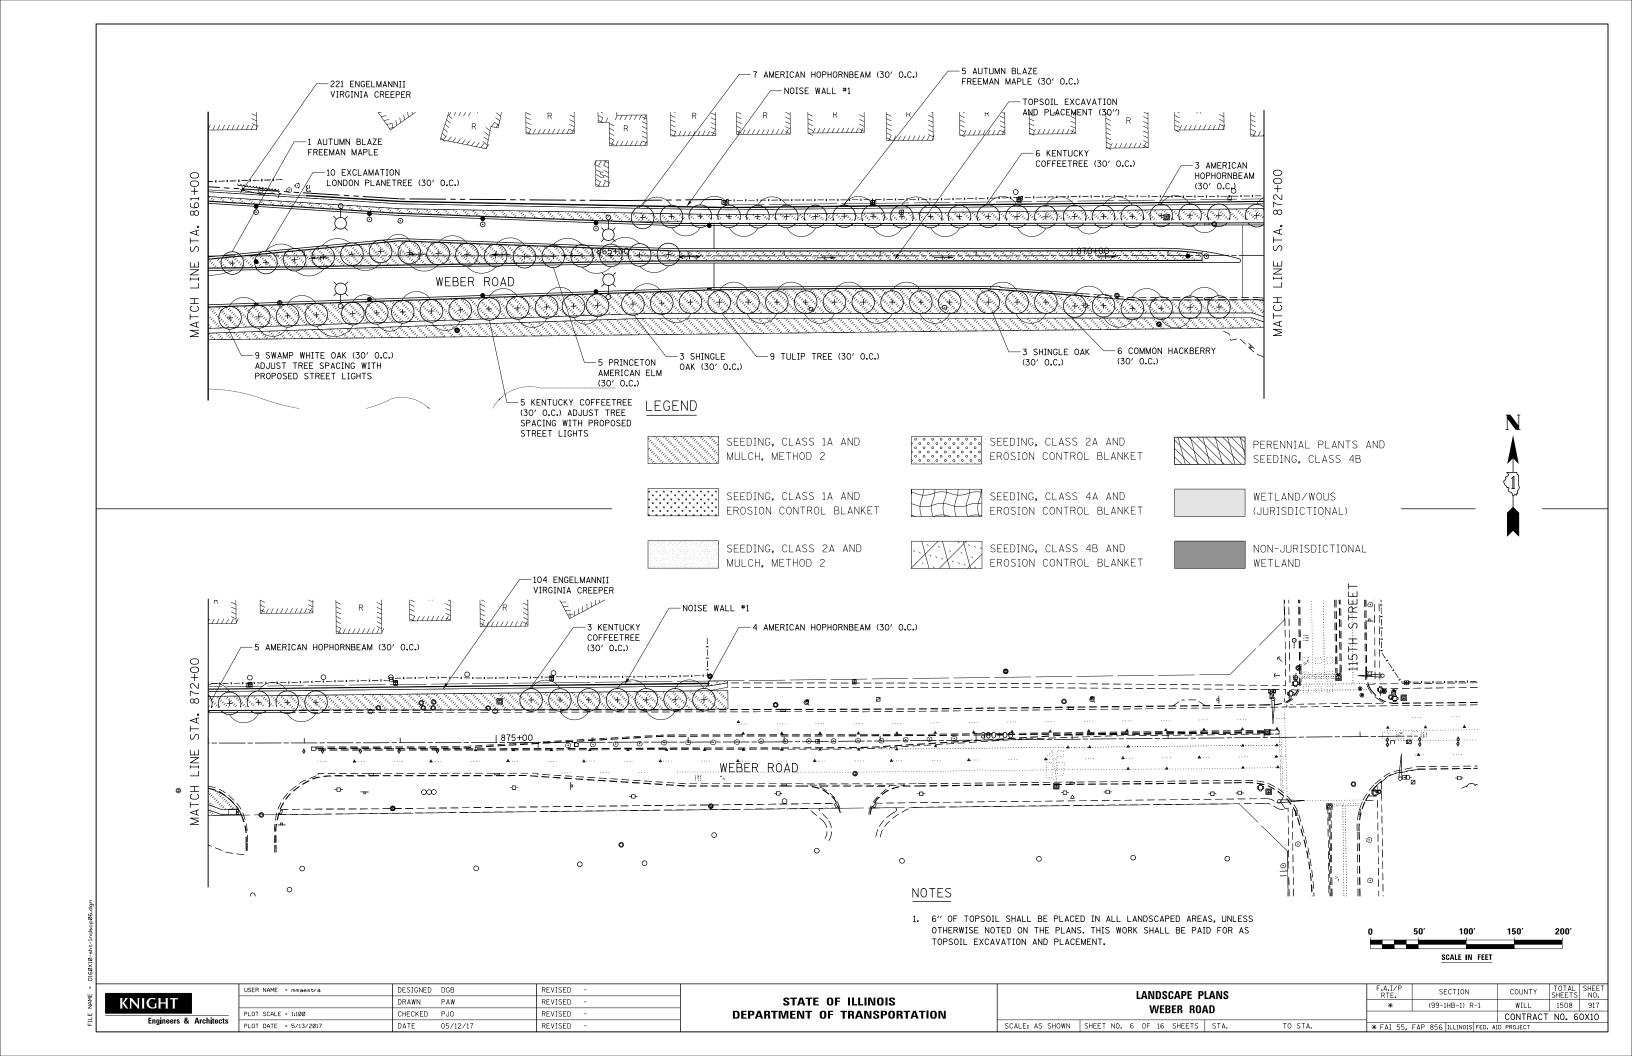

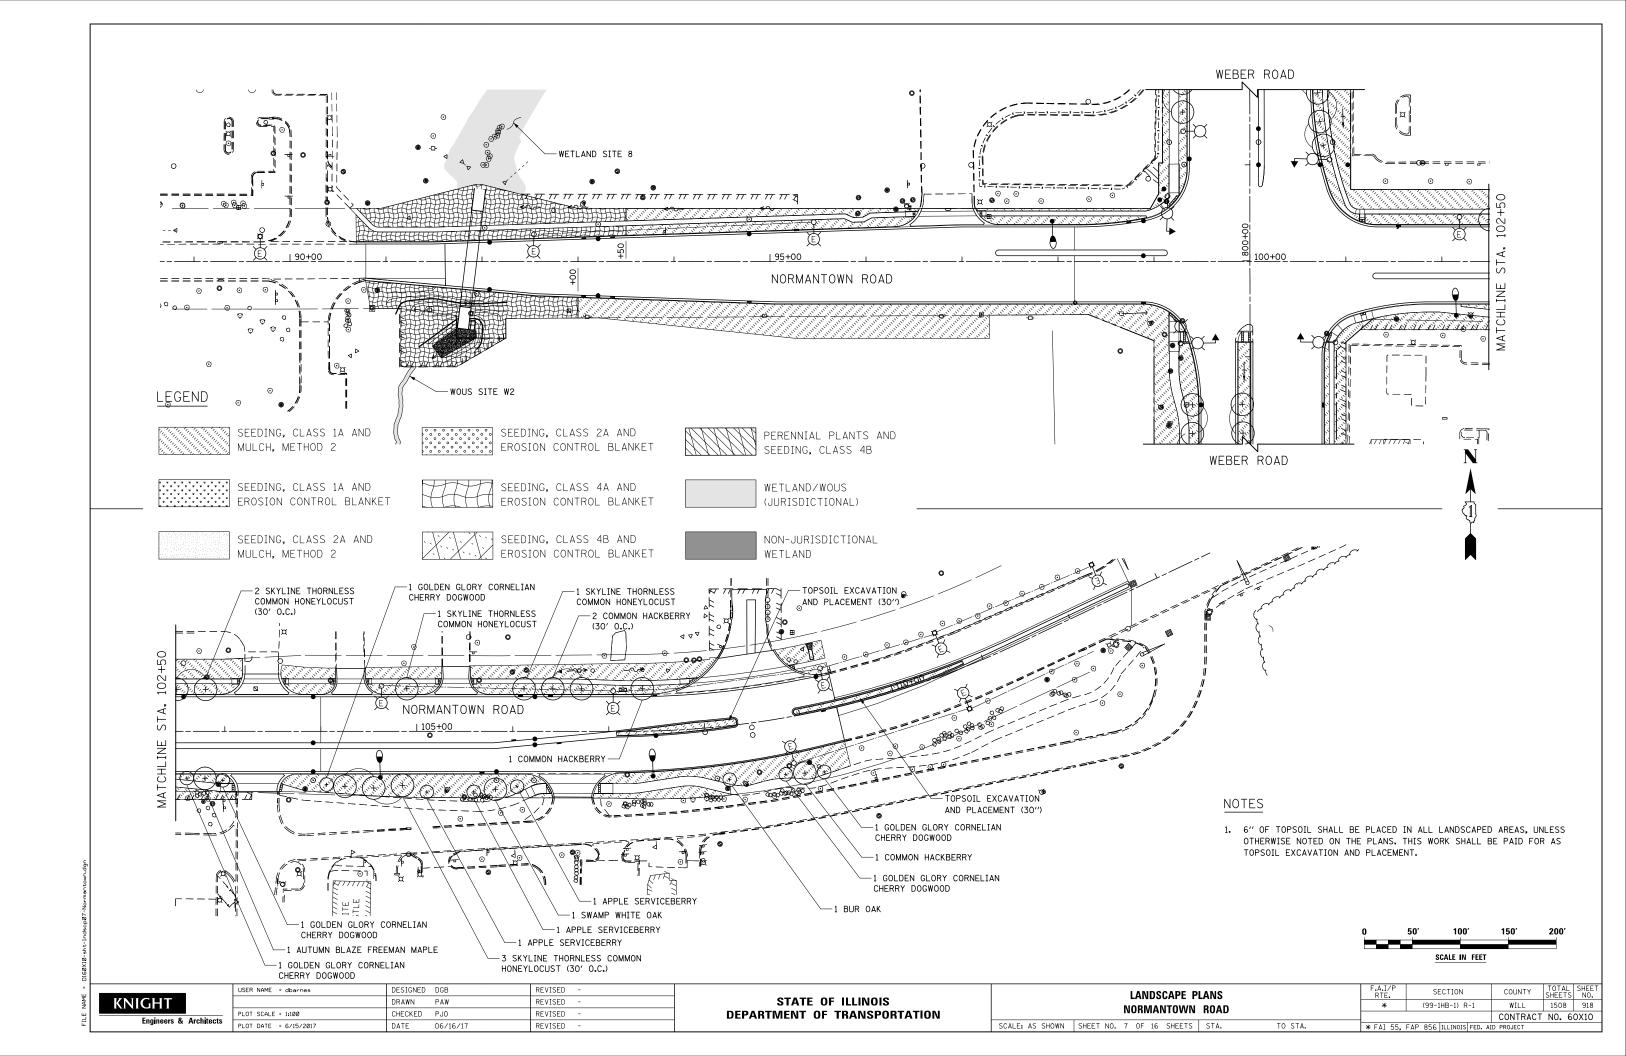

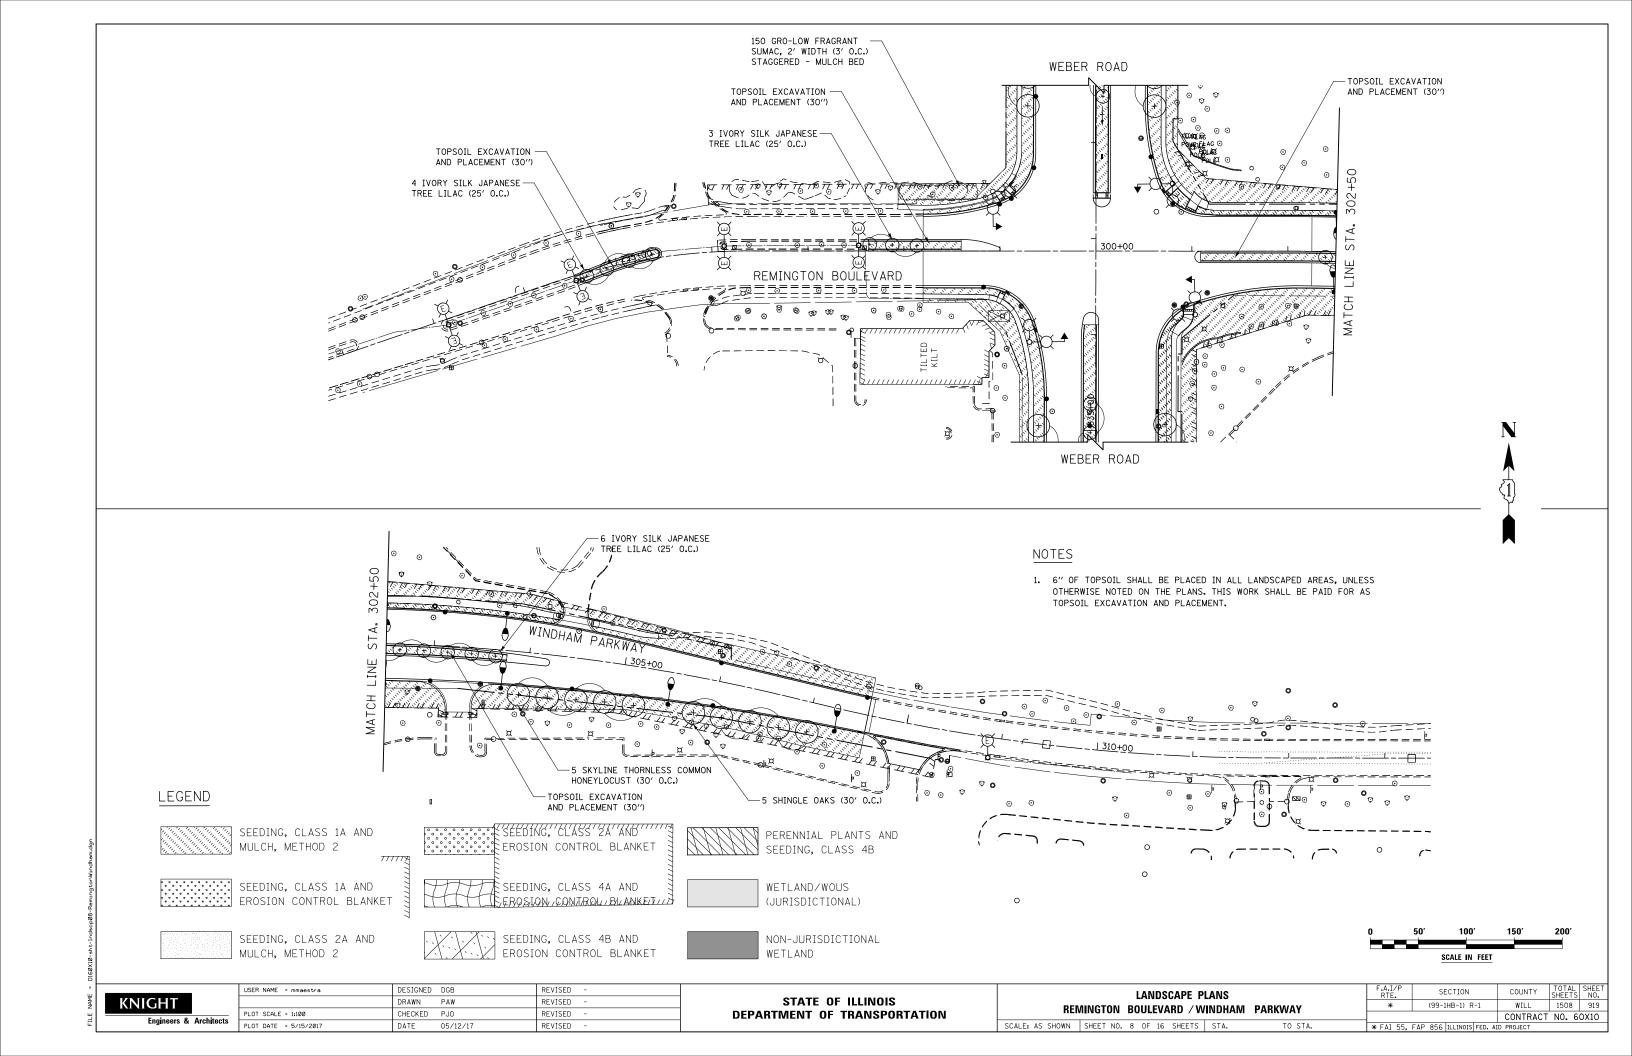



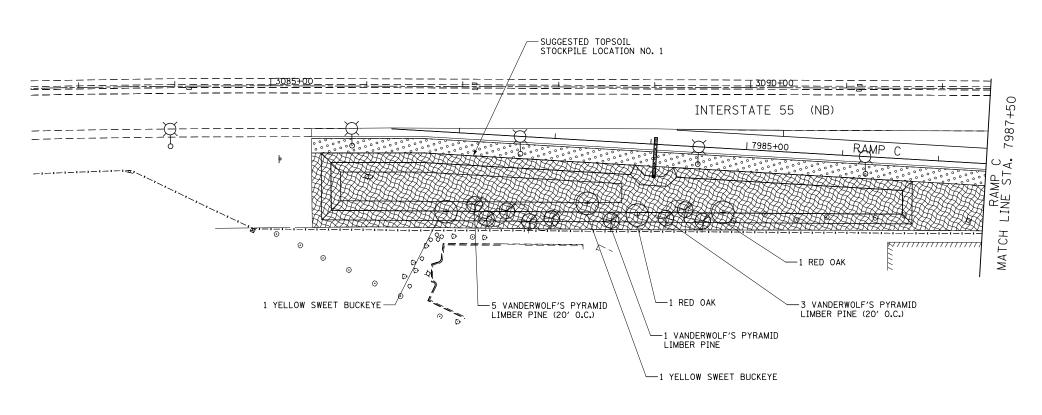

LEGEND



SEEDING, CLASS 1A AND MULCH, METHOD 2

SEEDING, CLASS 1A AND

SEEDING, CLASS 2A AND

MULCH, METHOD 2

EROSION CONTROL BLANKET



EROSION CONTROL BLANKET

SEEDING, CLASS 2A AND



WETLAND/WOUS

SEEDING, CLASS 4B

PERENNIAL PLANTS AND



SEEDING, CLASS 4A AND EROSION CONTROL BLANKET

SEEDING, CLASS 4B AND

EROSION CONTROL BLANKET



NON-JURISDICTIONAL WETLAND

NOTES

1. 6" OF TOPSOIL SHALL BE PLACED IN ALL LANDSCAPED AREAS, UNLESS OTHERWISE NOTED ON THE PLANS, THIS WORK SHALL BE PAID FOR AS TOPSOIL EXCAVATION AND PLACEMENT.

Ō	50′	100′	150′	200′
		SCALE IN FEET		





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IIGHT		DRAWN PAW	REVISED -
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Engineers & Architects	PLOT DATE = 11/1/2017	DATE 11/15/17	REVISED -


STATE OF ILLINOIS **DEPARTMENT OF TRANSPORTATION**

SCALE: AS

	LANDS	F.A.I/P RTE.	SECTION	COUNTY	TOTA			
	R	AMP C	*	(99-1HB-1) R-1	WILL	150		
							CONTRACT	NO.
SHOWN	SHEET NO. 9 OF 16	SHEETS	STA.	TO STA.	* FAI 55,	FAP 856 ILLINOIS FED, AI	D PROJECT	

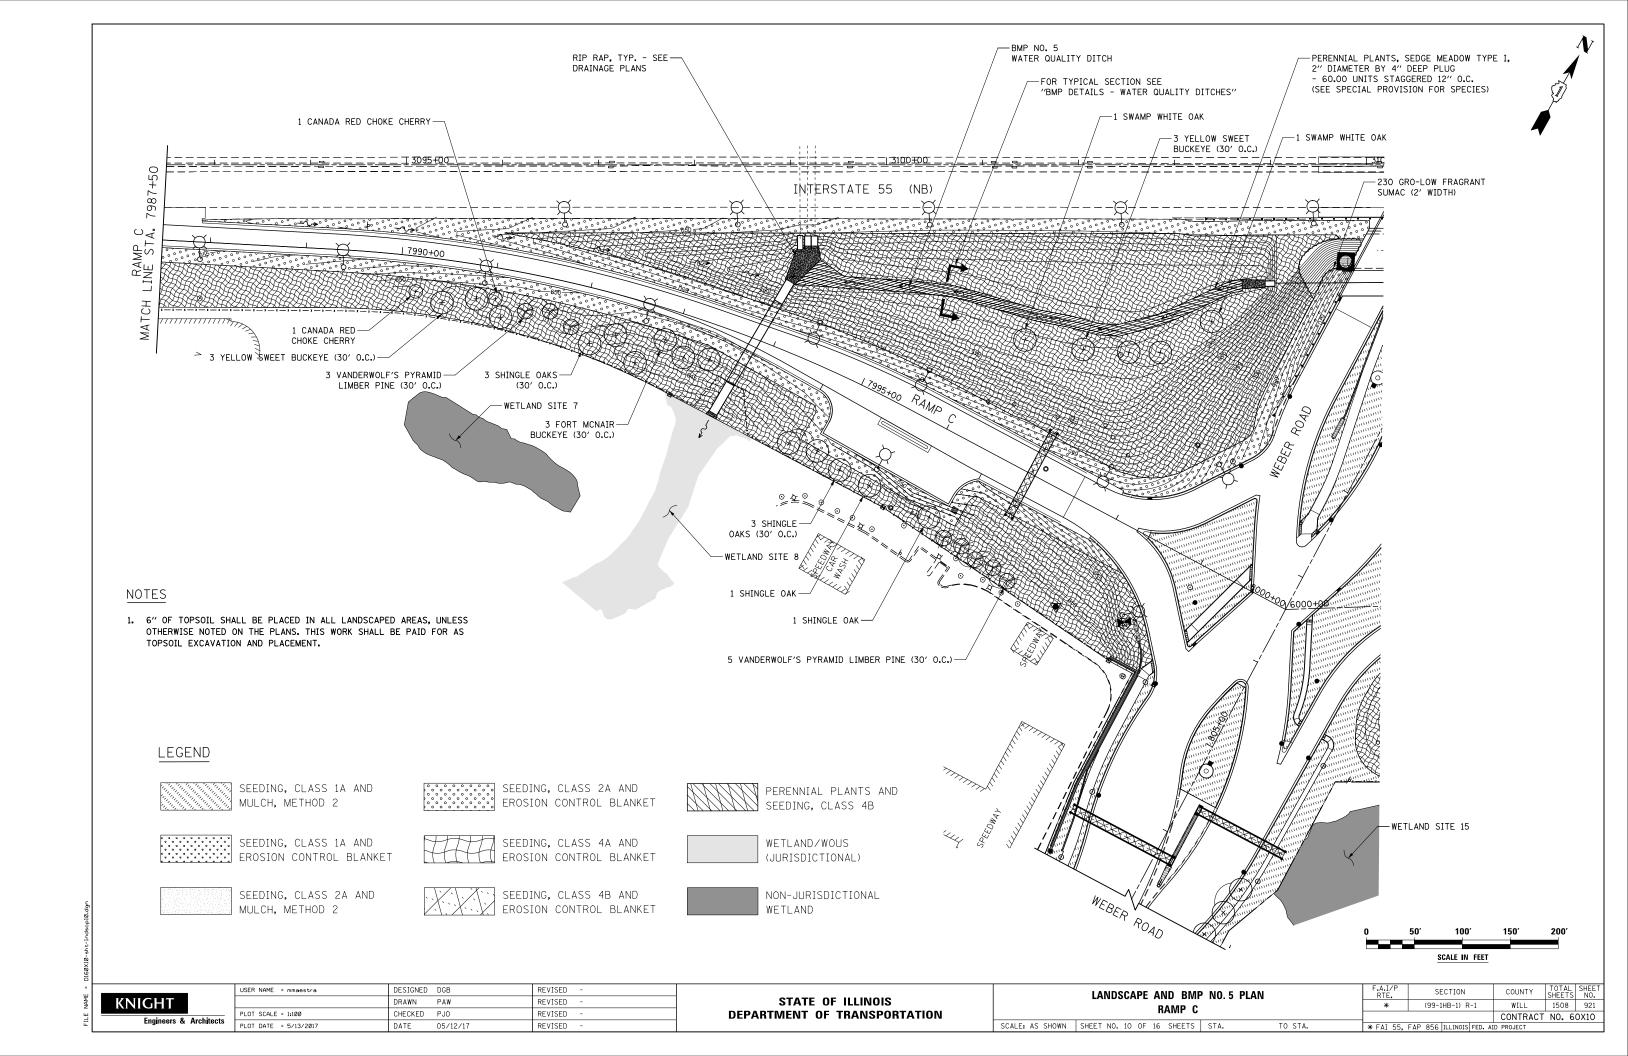

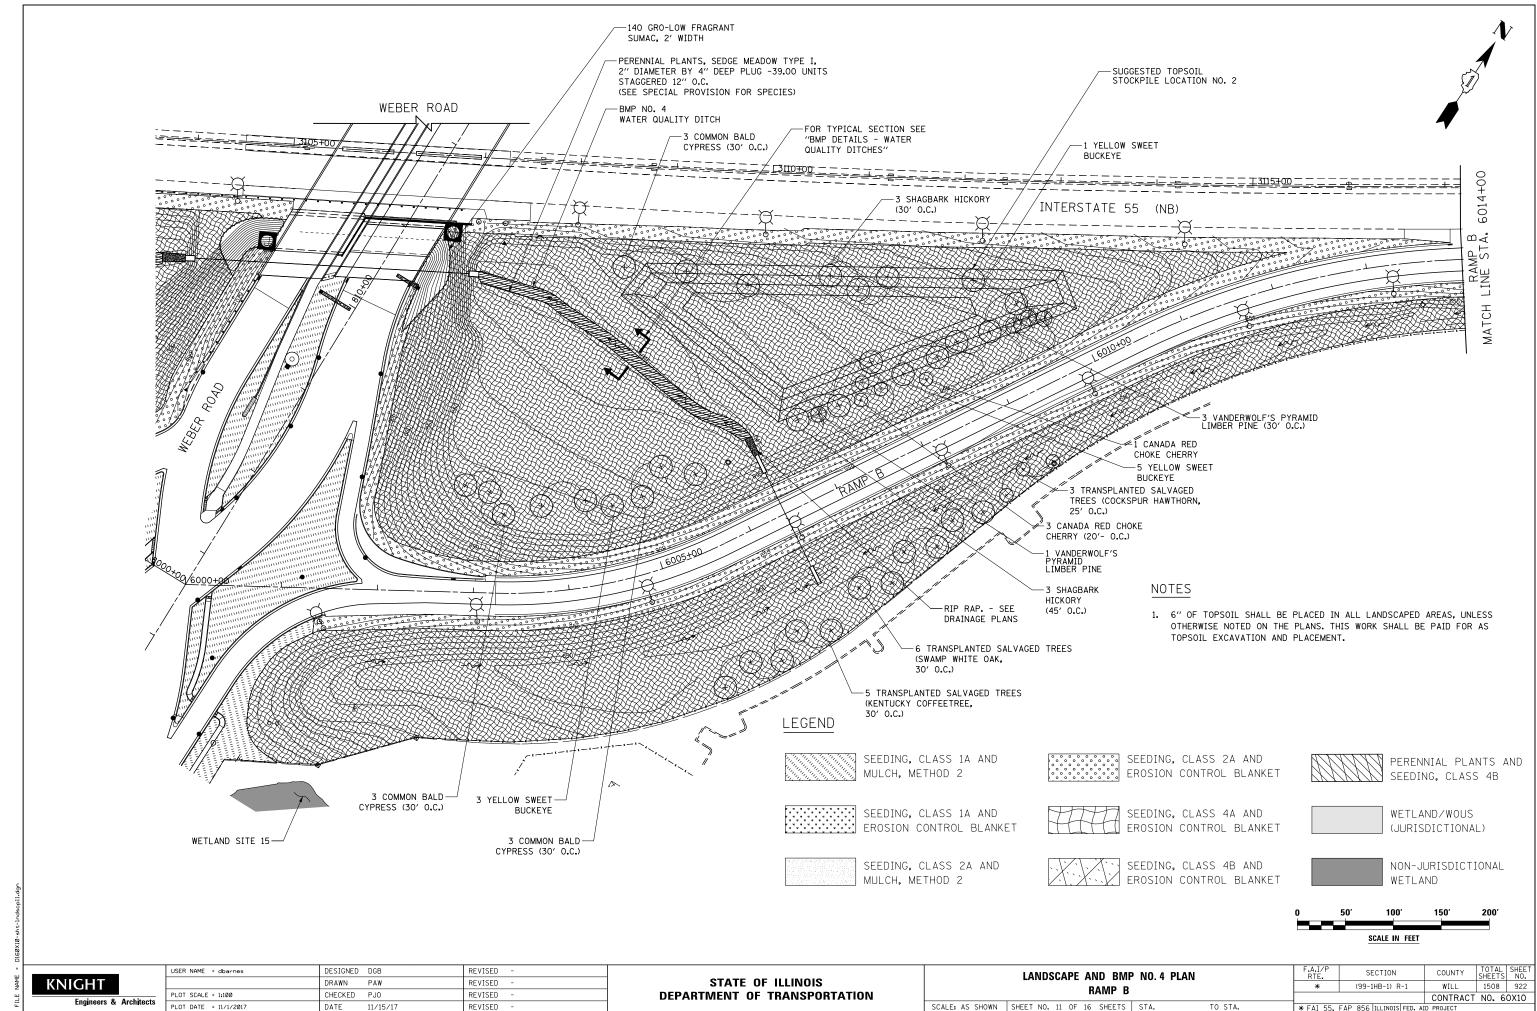


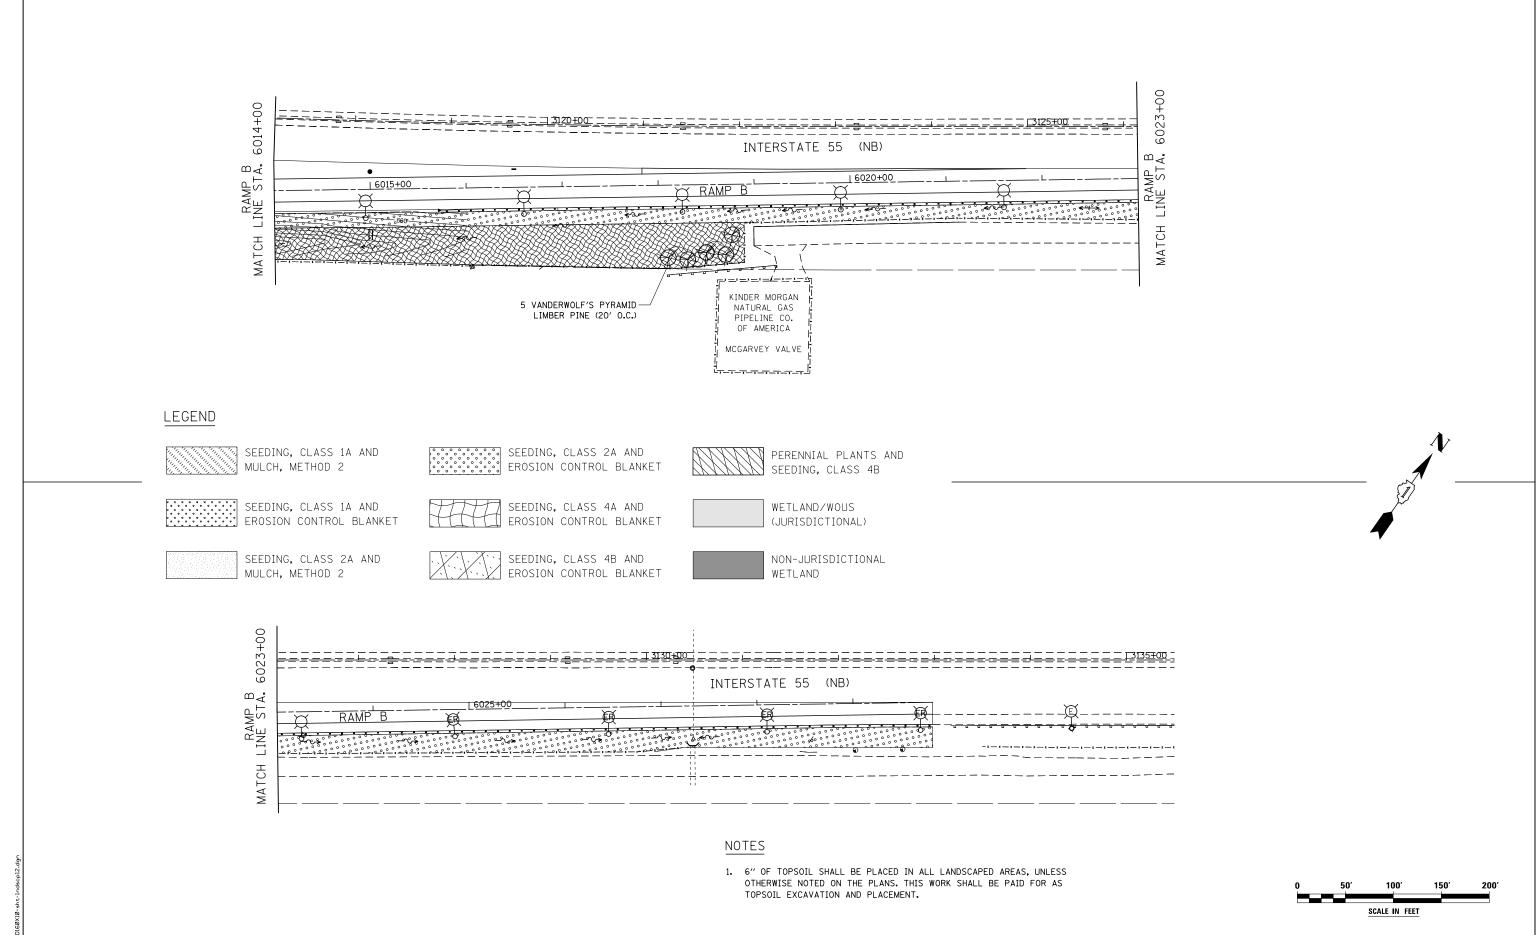

USER NAME = mmoestro DESIGNED DGB REVISED DRAWN PAW REVISED PLOT SCALE = 1:100 CHECKED PJO REVISED PLOT DATE = 5/13/2017 DATE 05/12/17 REVISED
SCALE: AS SHOWN SHEET NO. 12

LANDSCAPE P	LANS		F.A.I/P RTE.	SECTION	COUNTY	TOTAL SHEETS	SHEET NO.
RAMP B			*	(99-1HB-1) R-1	WILL	1508	923
IIAWII D					CONTRACT	NO. 6	0X10
OF 16 SHEETS	STA.	TO STA.	* FAI 55,	FAP 856 ILLINOIS FEE	D. AID PROJECT		



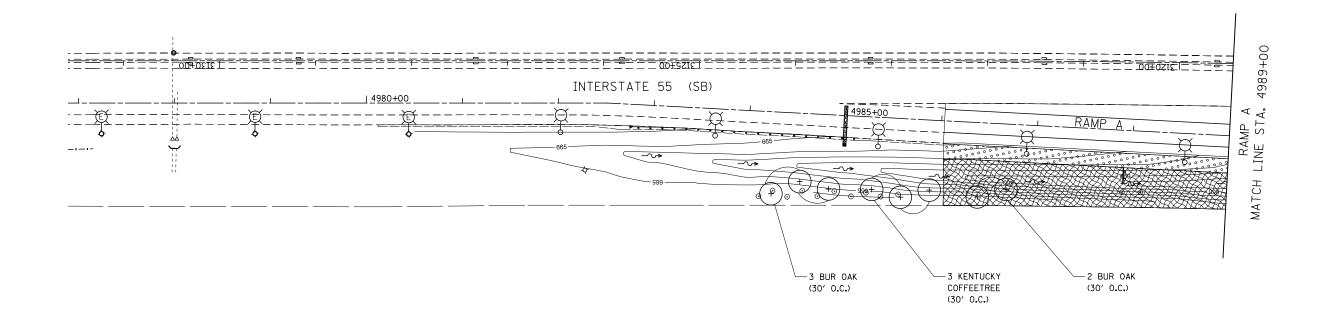


NOTES

 6" OF TOPSOIL SHALL BE PLACED IN ALL LANDSCAPED AREAS, UNLESS OTHERWISE NOTED ON THE PLANS. THIS WORK SHALL BE PAID FOR AS TOPSOIL EXCAVATION AND PLACEMENT.


LEGEND

SEEDING, CLASS 1A AND MULCH, METHOD 2

SEEDING, CLASS 2A AND EROSION CONTROL BLANKET

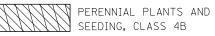

SEEDING, CLASS 1A AND EROSION CONTROL BLANKET

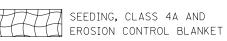





SEEDING, CLASS 4B AND EROSION CONTROL BLANKET



NON-JURISDICTIONAL WETLAND


> 0 50' 100' 150' 200' SCALE IN FEET



	USER NAME = mmaestra	DESIGNED	DGB	REVISED	-
		DRAWN	PAW	REVISED	-
	PLOT SCALE = 1:100	CHECKED	PJ0	REVISED	-
ects	PLOT DATE = 5/13/2017	DATE	05/12/17	REVISED	-

STATE OF ILLINOIS	
DEPARTMENT OF TRANSPORTATION	V

		LANDSCAPE PL	.ANS		F.A.I/P RTE.	SECTION	COUNTY	TOTAL SHEETS	
١		RAMP A	*	(99-1HB-1) R-1	WILL	1508	924		
		IIAWII A		•	CONTRACT	NO. 6	0X10		
	SCALE: AS SHOWN	SHEET NO. 13 OF 16 SHEETS	STA.	TO STA.	* FAI 55,	FAP 856 ILLINOIS FED. AI	D PROJECT		

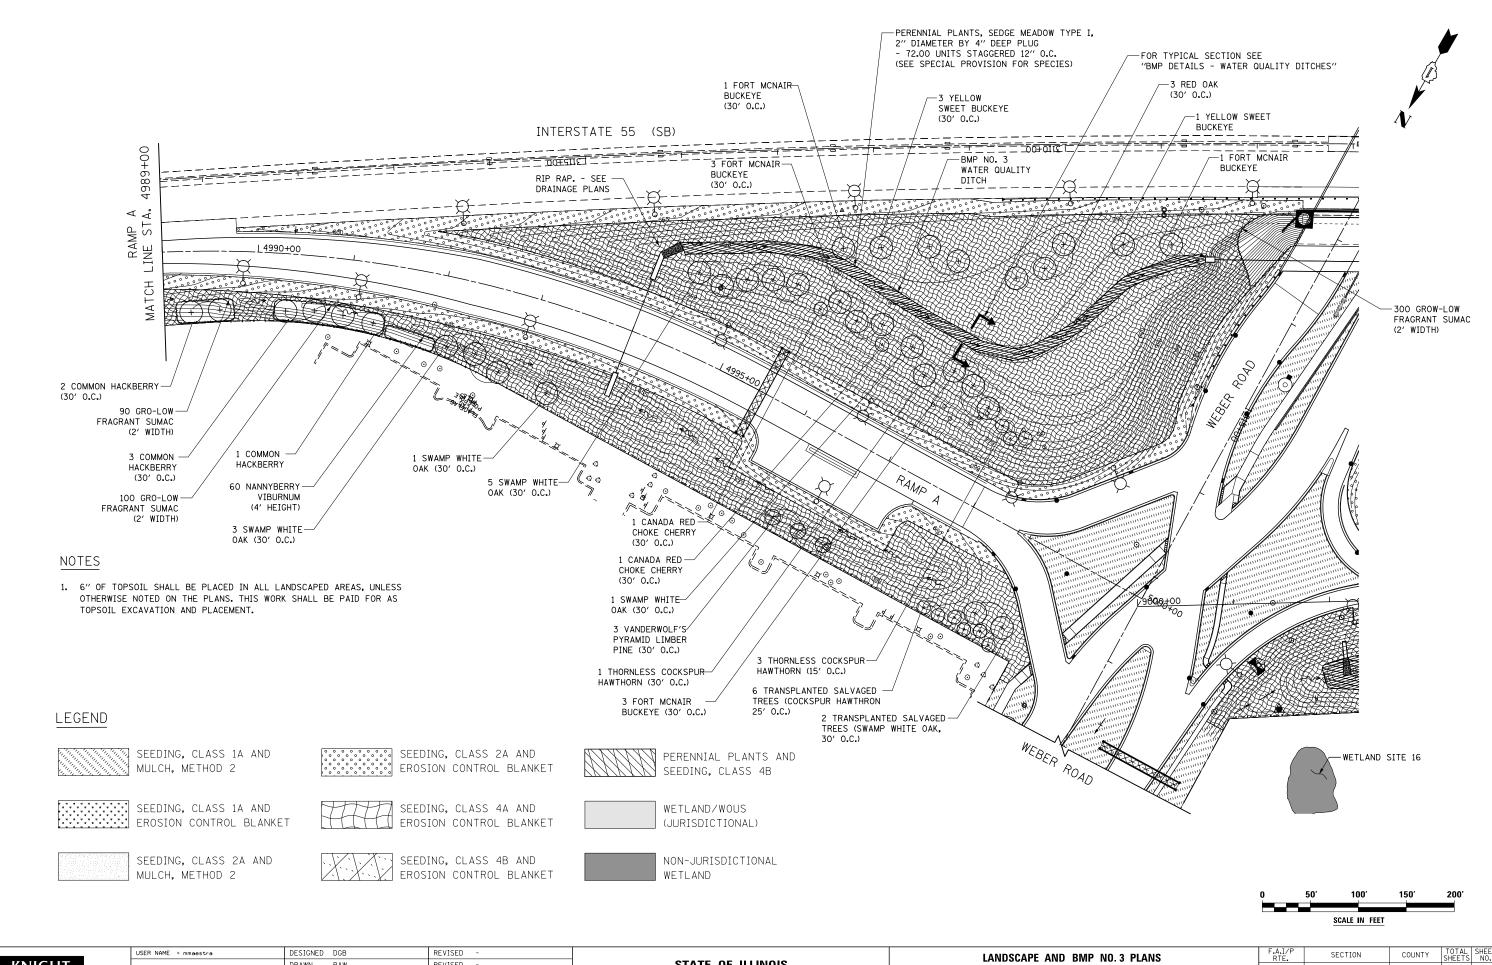


STATE OF ILLINOIS
DEPARTMENT OF TRANSPORTATION


LANDSCAPE AND BMP NO.3 PLANS RAMP A

SCALE: AS SHOWN | SHEET NO. 14 OF 16 SHEETS | STA. TO STA.

FAI 55, FAP 856 | ILLINOIS | FED. AID | PROJECT | NO. 60X10

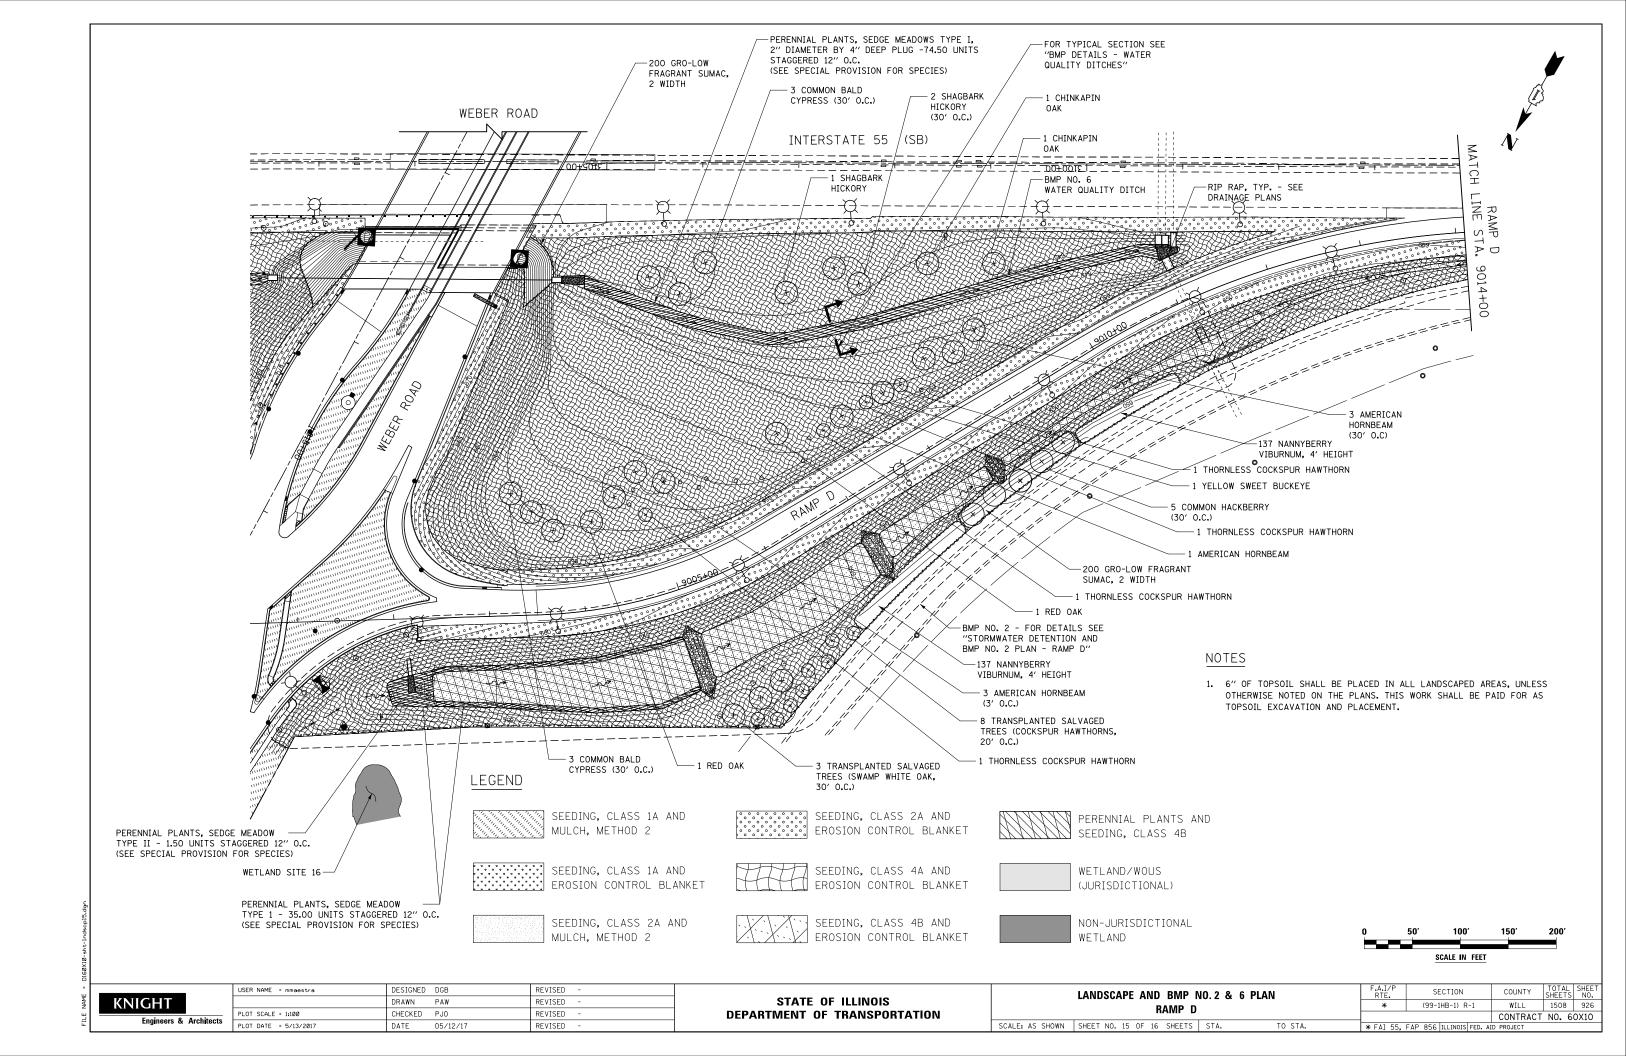



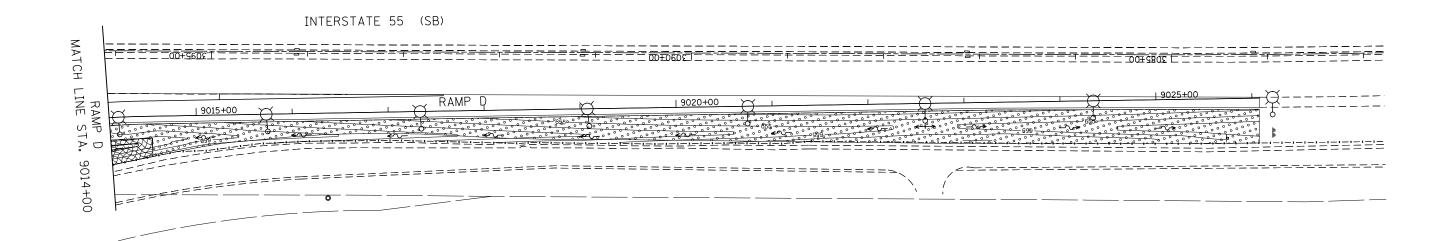

LEGEND



SEEDING, CLASS 1A AND MULCH, METHOD 2



SEEDING, CLASS 1A AND EROSION CONTROL BLANKET



SEEDING, CLASS 2A AND MULCH, METHOD 2



SEEDING, CLASS 2A AND EROSION CONTROL BLANKET



SEEDING, CLASS 4A AND EROSION CONTROL BLANKET



SEEDING, CLASS 4B AND EROSION CONTROL BLANKET



PERENNIAL PLANTS AND SEEDING, CLASS 4B



WETLAND/WOUS (JURISDICTIONAL)



NOTES

SCALE: AS SHOWN

1. 6" OF TOPSOIL SHALL BE PLACED IN ALL LANDSCAPED AREAS, UNLESS OTHERWISE NOTED ON THE PLANS. THIS WORK SHALL BE PAID FOR AS TOPSOIL EXCAVATION AND PLACEMENT.

0	50′	100′	150′	200′
		SCALE IN FEET		

KNIGHT
Engineers & Architects

	USER NAME = mmaestra	DESIGNED	DGB	REVISED	-
		DRAWN	PAW	REVISED	-
s	PLOT SCALE = 1:100	CHECKED	PJ0	REVISED	-
	PLOT DATE = 5/13/2017	DATE	05/12/17	REVISED	-

LANDSCAPE PLANS RAMP D			SECTION	COUNTY	TOTAL SHEETS	SHEET NO.
			(99-1HB-1) R-1	WILL	1508	927
				CONTRACT	NO. 60	0X10
SHEET NO. 16 OF 16 SHEETS STA. TO	STA.	* FAT 55. I	AP 856 ILLINOIS FED. AI	D PROJECT		

SYMBOL LIST PROPOSED LIGHT POLE WITH LUMINAIRE, LED, TYPE C,, 240V, 47.5' M.H. AND 15' DAVIT ARM WITH LIGHT POLE FOUNDATION, 24" DIAMETER AND BREAKAWAY DEVICE, TRANSFORMER BASE, 15 INCH BOLT CIRCLE. 0—Œ) EXISTING LIGHT POLE TO REMAIN **₩** EXISTING LIGHT POLE RE-INSTALLED ON NEW FOUNDATION (IDOT) INCLUDED IN "REMOVE AND RE-ERECT EXISTING LIGHTING UNIT" PAY ITEM. EXISTING LIGHT POLE RE-INSTALLED ON NEW FOUNDATION (NON-IDOT) INCLUDED IN "REMOVE AND RE-ERECT EXISTING LIGHTING UNIT" PAY ITEM OR "RELOCATE EXISTING LIGHTING UNIT" PAY ITEM, AS SPECIFIED ON PLANS REMOVAL OF LIGHTING UNIT, SALVAGE, LETTER SHALL SIGNIFY WHO'S PROPERTY THE REMOVED POLE SHALL REMAIN: "R" - ROMEOVILLE, "B" - BOLINGBROOK, NO LETTER - IDOT. EXISTING LIGHT POLE TO BE REMOVED AND RELOCATED ON NEW FOUNDATION INCLUDED IN "RELOCATE EXISTING LIGHTING UNIT" PAY ITEM OR "REMOVE AND RE-ERECT EXISTING LIGHTING UNIT" PAY ITEM, AS SHOWN ON THE PLANS. LIGHT POLE, WOOD, 60 FOOT, CLASS 4, WITH 15 FOOT MAST ARM **○** AND TEMPORARY LUMINAIRE, HIGH PRESSURE SODIUM VAPOR, HORIZONTAL MOUNT, 400 WATT, 240V, 47.5' M.H., TYPE MCIII, UNLESS NOTED OTHERWISE LIGHT POLE, WOOD, 90 FOOT, CLASS 4, WITH 15 FOOT MAST ARMS AND **⊕**₩ TEMPORARY LUMINAIRE, HIGH PRESSURE SODIUM VAPOR, HIGH MAST, HORIZONTAL MOUNT, 750 WATT, 240V. NUMBER OF ARMS AND LUMINAIRES AS SHOWN ON PLANS LUMINAIRE SHALL BE 70' M.H., TYPE MCIII. -REMOVAL OF TEMPORARY LIGHTING UNIT, NO SALVAGE. PROPOSED COMBINATION LIGHTING - TRAFFIC SIGNAL POLE, LUMINAIRE AND ASSOCIATED ARM AND WIRING AS NOTED ON TRAFFIC SIGNAL PLANS AND ON COMBINATION LIGHTING PLANS. PROPOSED HIGH MAST LIGHT TOWER, 120' M.H., 240V LUMINAIRE, LED, HIGH MAST HORIZONTAL MOUNT, AND LIGHT TOWER SERVICE PAD. NUMBER OF LUMINAIRES AS SHOWN ON PLANS EXISTING HIGH MAST LIGHT TOWER TO REMAIN REMOVAL OF LIGHT TOWER AND REMOVAL OF TOWER FOUNDATION. SALVAGE LUMINAIRES. LUMINAIRE, UNDERPASS, LED, TYPE B, 240V. QR EXISTING UNDERPASS LUMINAIRE TO BE REMOVED PROPOSED LIGHTING JUNCTION BOX. TYPE AND SIZE AS NOTED J PROPOSED LIGHTING CONTROLLER, BASE MOUNTED, 480VOLT, 200AMP (DUAL), RADIO SCADA PROPOSED LIGHTING CONTROLLER, BASE MOUNTED, 480VOLT, 100AMP EXISTING LIGHTING CONTROLLER TO BE REMOVED, NO SALVAGE EXISTING LIGHTING CONTROLLER TO BE RELOCATED, INCLUDED IN "REMOVE AND RELOCATE EXISTING LIGHTING CONTROLLER" PAY ITEM RELOCATED LIGHTING CONTROLLER INCLUDED IN "REMOVE AND ER RELOCATE EXISTING LIGHTING CONTROLLER" PAY ITEM \boxtimes TEMPORARY LIGHTING CONTROLLER, 480V, AMPERAGE AS NOTED ON PLANS \bowtie EXISTING LIGHTING CONTROLLER TO REMAIN TEMPORARY WOOD POLE, 60', CLASS 4, UNLESS OTHERWISE NOTED

SYMBOL LIST (CONTINUATION)

GROUND ROD

UTILITY TRANSFORMER

PROPOSED UNIT DUCT. NO. AND SIZE OF WIRES AS NOTED ON PLANS


EXISTING WIRING


WIRING IN CONDUIT ATTACHED TO STRUCTURE

---AC--- TEMPORARY AERIAL CABLE. NO. AND SIZE OF WIRES AS NOTED ON PLANS

-[--] PROPOSED RGS CONDUIT WITH UNIT DUCT, CONDUIT DIAMETER AND LENGTH AS SHOWN ON PLANS.

CALL-OUT DESCRIPTIONS

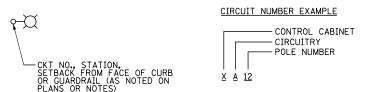

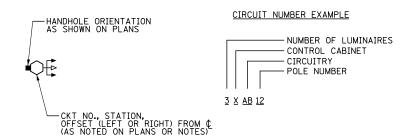

ABBREVIATIONS

Α	AMPS
DIA	DIAMETER
С	CONDUIT
GND	GROUND
FT	FEET
HPS	HIGH PRESSURE SODIUM
IDOT	ILLINOIS DEPARTMENT OF TRANSPORTATION
LT	LEFT
MC	MEDIUM CUTOFF
Р	PUSHED
PC	PHOTO CONTROL
PH	PHASE
PVC	POLYVINYL CHLORIDE
RGS	RIGID GALVANIZED STEEL
RT	RIGHT
STA	STATION
UN0	UNLESS NOTED OTHERWISE
٧	VOLTS
W	WATTS

GENERAL NOTES


- 1. SPLICING OF CONDUCTORS SHALL BE IN POLE BASES OR WEATHER TIGHT JUNCTION BOXES ONLY. SPLICES BELOW GRADE WILL NOT BE PERMITTED.
- 2. LIGHTING CIRCUITS SHALL BE WIRED IN ACCORDANCE WITH THE PLANS. DEVIATIONS WILL NOT BE PERMITTED WITHOUT PRIOR APPROVAL OF THE ENGINEER.
- THE CONTRACTOR SHALL REQUEST A FORMAL MAINTENANCE TRANSFER BEFORE ANY WORK BEGINS. THE CONTRACTOR SHALL CONTACT THE ILLINOIS DEPARTMENT OF TRANSPORTATION AT (708) 524-2145, ROMEOVILLE PUBLIC WORKS DEPARTMENT AT (815) 886-1870, AND BOLINGBROOK PUBLIC SERVICES & DEVELOPMENT DEPARTMENT AT (630) 226-8805.
- THE CONTRACTOR SHALL TAKE ALL NECESSARY MEASURES TO RESTORE ANY SPECIALIZED LANDSCAPING (DECORATIVE ROCKS, PLANTS, ETC.) EXISTING TO REMAIN OR NEW AT NO ADDITIONAL COST TO THE CLIENT.
- ALL WORK SHALL CONFORM TO THE LATEST IDOT AND IDOT DISTRICT 1 STANDARDS, SPECIAL PROVISIONS, SUPPLEMENTAL SPECIFICATIONS, THE NATIONAL ELECTRICAL CODE, AND THE NATIONAL ELECTRICAL SAFETY CODE
- ALL ELECTRICAL EQUIPMENT SHALL BE UL LISTED AND LABELED.
- ALL CONDUITS SHALL BE SEALED.
- ALL CIRCUIT WIRES SHALL BE LABELED WITH CIRCUIT IDENTIFICATION.
- ALL LAMPS SHALL BE FURNISHED AS PART OF THE CONTRACT.
- 10. CIRCUITS SHALL BE TESTED PER SPECIFICATIONS.
- 11. THE LOCATIONS OF ALL PROPOSED EQUIPMENT ARE ILLUSTRATED DIAGRAMMATICALLY, THE ACTUAL LOCATION IN THE FIELD SHALL MEET THE APPROVAL OF THE ENGINEER.
- 12. THE CONTRACTOR MUST MAINTAIN SAFE EQUIPMENT AND WORKING CLEARANCES FROM THE EXISTING COMED OVERHEAD ELECTRIC LINES. THE CONTRACTOR SHALL PLAN HIS WORK CONSIDERING COMED'S LINES TO BE IN SERVICE AND ENERGIZED THROUGHOUT THE CONSTRUCTION PERIOD.
- 13. THE COST OF SPLICING TEMPORARY CONDUCTORS TO EXISTING CONDUCTORS IN EXISTING POLES SHALL BE INCLUDED IN THE PAY ITEM FOR AERIAL CABLE.
- 14. GROUNDING CONDUCTORS SHALL BE CONTINUOUS.
- 15. ALL NEW UNIT DUCTS AND CONDUITS SHALL BE PLACED A MINIMUM OF 30" BENEATH THE FINISHED GRADE.
- 16. LIGHT POLE FOUNDATIONS SHALL BE INSTALLED WITH A 7 FT. DEPTH, UNLESS OTHERWISE NOTED ON PLANS, LIGHT TOWER FOUNDATIONS SHALL BE INSTALLED WITH A DEPTH AS SHOWN ON PLANS, PROPOSED POLE AND TOWER FOUNDATION DEPTH ARE BASED ON AVAILABLE SOIL BORING DATA, IF SOIL CONDITIONS AT FOUNDATION LOCATIONS VARY FROM REPORT DATA, CONTRACTOR SHALL NOTIFY THE ENGINEER AND THE DEPTH SHALL BE REVISED IN ACORDANCE WITH SECTION 516 OF STANDARD SPECIFICATIONS AND IDOT DISTRICT 1 STANDARD DRAWINGS BE-301 AND BE-506.
- 17. REMOVAL OF AN EXISTING LIGHTING UNIT FOR SALVAGE OR FOR RELOCATION SHALL ALWAYS BE FOLLOWED BY THE REMOVAL OF POLE FOUNDATION.
- 18. FOR IDOT LIGHTING SERVICE, CONTACT COMED JOSE LEPE, PH: (815) 724-5569. FOR BOLINGBROOK LIGHTING SERVICE, CONTACT COMED - SHEENA WILLIAMS, PH: (630) 958-4004.



USER NAME = dbarnes	DESIGNED	MLB	REVISED	-
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PLOT DATE = 8/17/2017	DATE	08/25/17	REVISED	-


ELECTRICAL SYMBOLS, ABBREVIATIONS	F.A.I/P RTE.	SECTION	COUNTY	TOTAL SHEETS	SHEET NO.
AND GENERAL NOTES	*	(99-1HB-1) R-1	WILL	1508	928
AND GENERAL NOTES		LT-01		CONTRACT NO. 60X10	
SHEET NO. OF SHEETS STA. TO STA.	* FAI 55.	FAP 856 ILLINOIS FED, A	ID PROJECT		




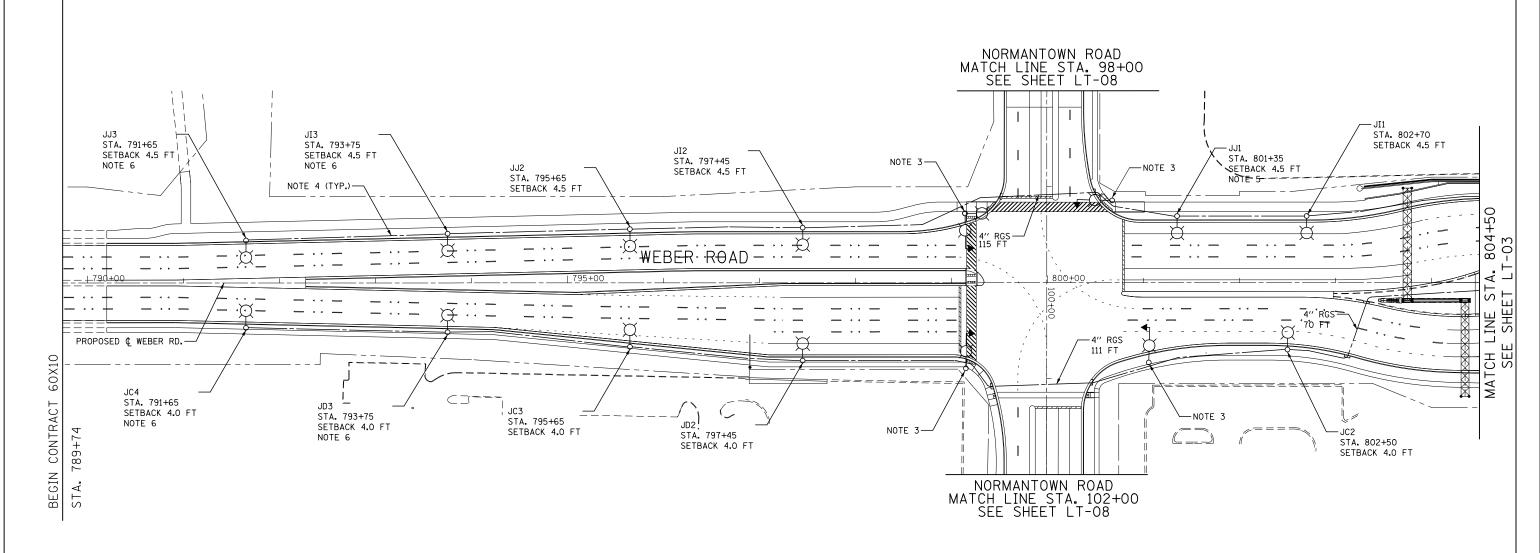

NOTES:

- 1. FOR SYMBOL LIST AND GENERAL ELECTRICAL NOTES, SEE SHEET LT-01.
- 2. ALL LIGHT POLE SETBACKS ARE MEASURED FROM THE FACE OF CURB TO CENTER OF LIGHT POLE BASE, UNLESS NOTED OTHERWISE.
- 3. COMBINATION TRAFFIC SIGNAL POLES AND LUMINAIRE ARM SHALL BE INSTALLED UNDER TRAFFIC SIGNAL CONTROL WORK, SEE TRAFFIC SIGNAL PLANS FOR EXACT COMBINATION POLE LOCATIONS AND SHEET LT-17 FOR MORE DETAILS, COMBINATION LIGHTING WILL BE MAINTAINED BY IDOT.
- 4. UNIT DUCT, 600V, 3-1/C NO. 2, 1/C NO. 4 GROUND, (XLP-TYPE USE), 1 1/2" DIA. POLYETHYLENE.
- LIGHT POLE FOUNDATION, 24" DIA., OFFSET. USE PILE OFFSET 5'-6", AND CAISON SHALL BE ORIENTED TOWARD THE ROAD.
- 6. THE DEPTH OF THE LIGHT POLE FOUNDATION SHALL BE 9'-6".

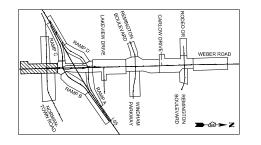

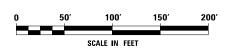



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	PLOT DATE = 8/17/2017	DATE	08/25/17	REVISED	-

STATE OF	ILLINOIS
DEPARTMENT OF	TRANSPORTATION

SCALE: AS SHOWN

	PROPOSED LIGHTING PLAN					F.A.I/P RTE.	SECTION	COUNTY	TOTAL SHEETS	SHEET NO.
WEBER ROAD						*	(99-1HB-1) R-1	WILL	1508	929
	WEDEN NOAD					LT-02 CONTRACT NO.		NO. 6	0X10	
	SHEET NO.	OF	SHEETS	STA.	TO STA.	* FAI 55,	FAP 856 ILLINOIS FED. AI	D PROJECT		

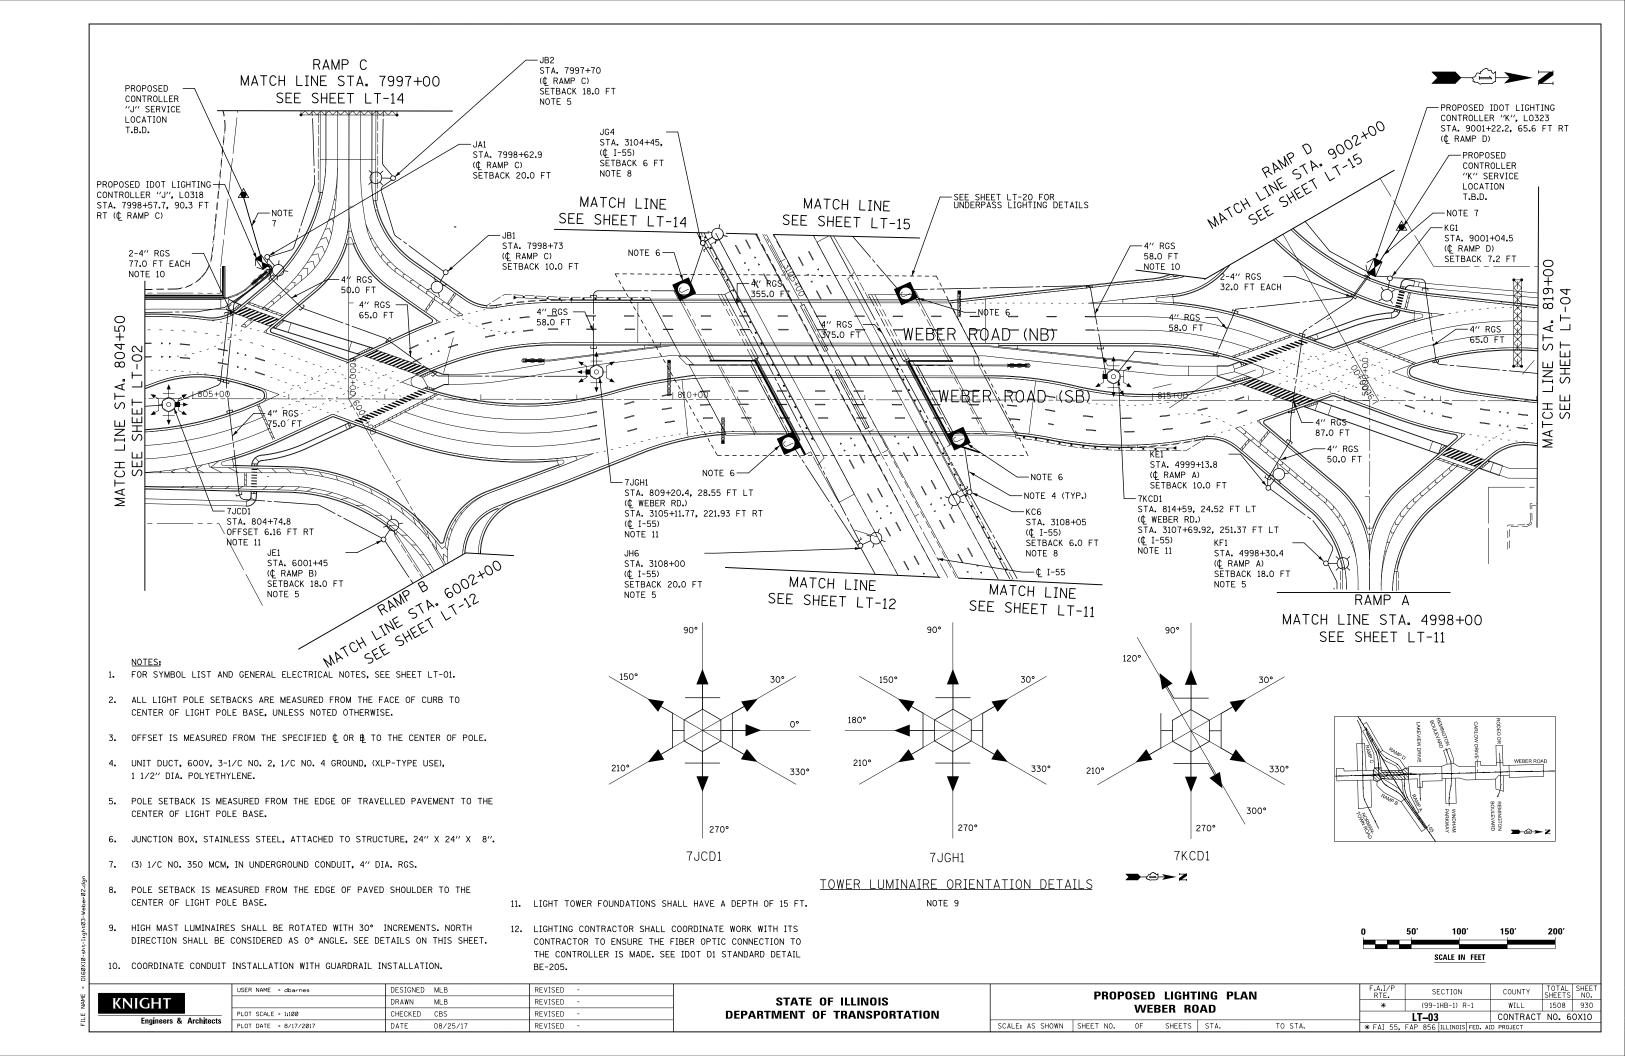


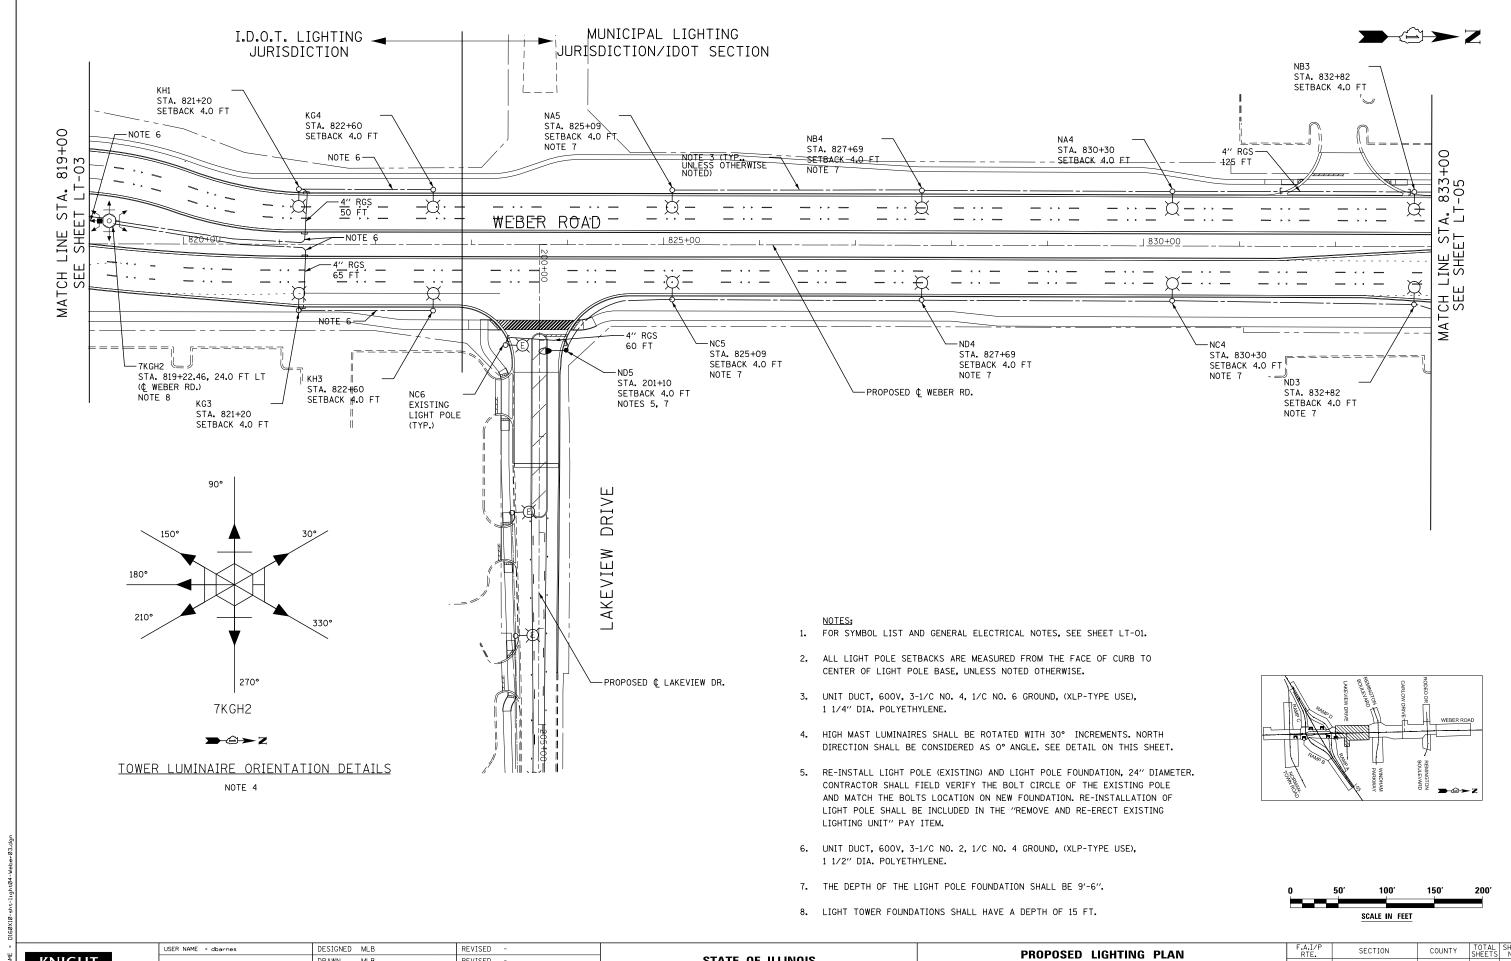


PROPOSED LIGHTING PLAN WEBER ROAD						
SCALE: AS SHOWN	SHEET NO.	OF	SHEETS	STA.		TO STA.

F.A.I/P RTE.	SECTION		COUNTY	TOTAL SHEETS	SHEE NO.
*	(99-1HB-1)	R-1	WILL	1508	931
	LT-04	CONTRACT	NO. 6	0X1C	
* FAI 55,	FAP 856 ILLINOI	S FED. AID	PROJECT		



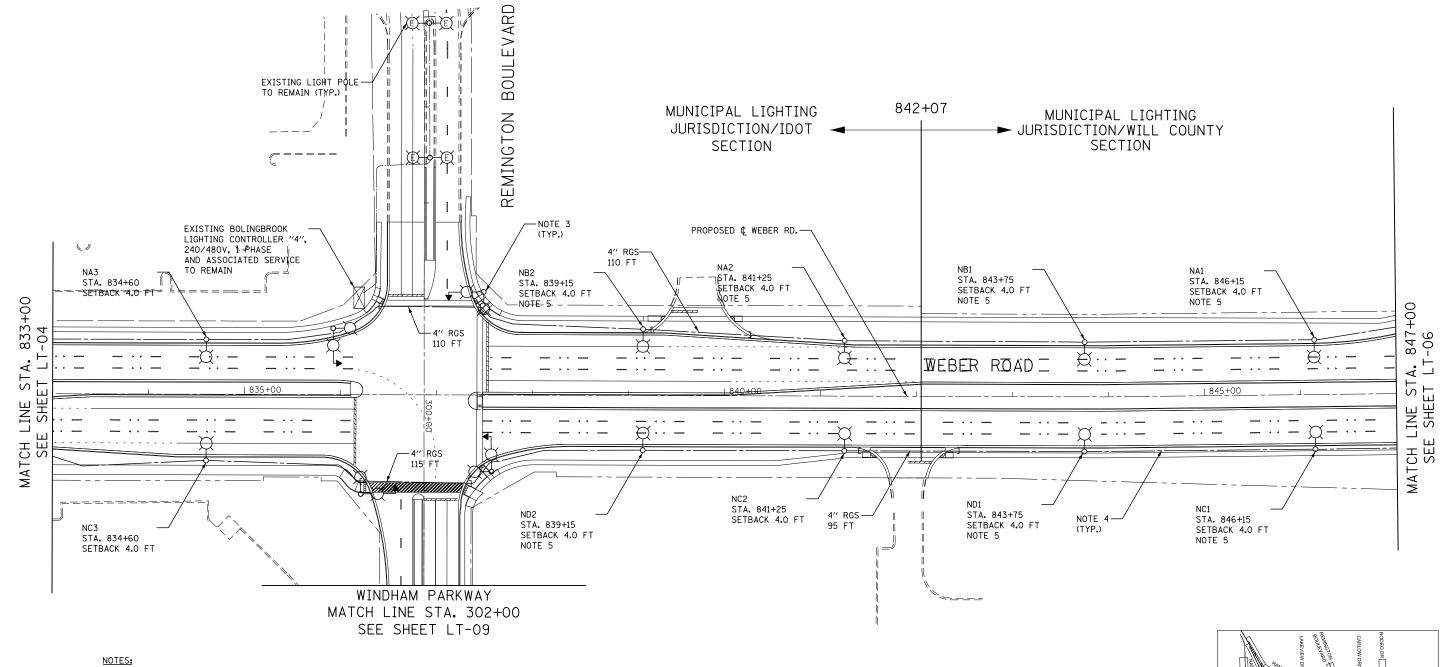

- 1. FOR SYMBOL LIST AND GENERAL ELECTRICAL NOTES, SEE SHEET LT-01.
- 2. ALL LIGHT POLE SETBACKS ARE MEASURED FROM THE FACE OF CURB TO CENTER OF LIGHT POLE BASE, UNLESS NOTED OTHERWISE.
- 3. COMBINATION TRAFFIC SIGNAL POLES SHALL BE INSTALLED UNDER TRAFFIC SIGNAL CONTROL WORK. SEE TRAFFIC SIGNAL PLANS FOR EXACT COMBINATION POLE LOCATIONS AND SHEET LT-18 FOR MORE DETAILS. COMBINATION LIGHTING WILL BE MAINTAINED BY VILLAGE OF BOLINGBROOK.
- UNIT DUCT, 600V, 3-1/C NO. 4, 1/C NO. 6 GROUND, (XLP-TYPE USE), 1 1/4" DIA. POLYETHYLENE.
- THE DEPTH OF THE LIGHT POLE FOUNDATION SHALL BE 9'-6".

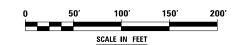




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chitects	PLOT SCALE = 1:100	CHECKED	CBS	REVISED	-
	PLOT DATE = 8/17/2017	DATE	08/25/17	REVISED	-

STATI	OF ILLINOIS	3
DEPARTMENT	OF TRANSPO	RTATION

		PROP	OSED	LIGHT	ING PL	AN	F.A.I/P RTE.	SECT
	WEBER ROAD							(99-1HE
			***	DEII IIO				LT-05
ı	SCALE: AS SHOWN	SHEET NO.	OF	SHEETS	STA.	TO STA.	* FAI 55.	FAP 856 ILL


F.A.I/P RTE.	SECTION	COUNTY	TOTAL SHEETS	SHEET NO.
*	(99-1HB-1) R-1	WILL	1508	932
	LT-05	CONTRACT	NO. 6	0X10
* FAI 55,	FAP 856 ILLINOIS FED. AI	ID PROJECT		

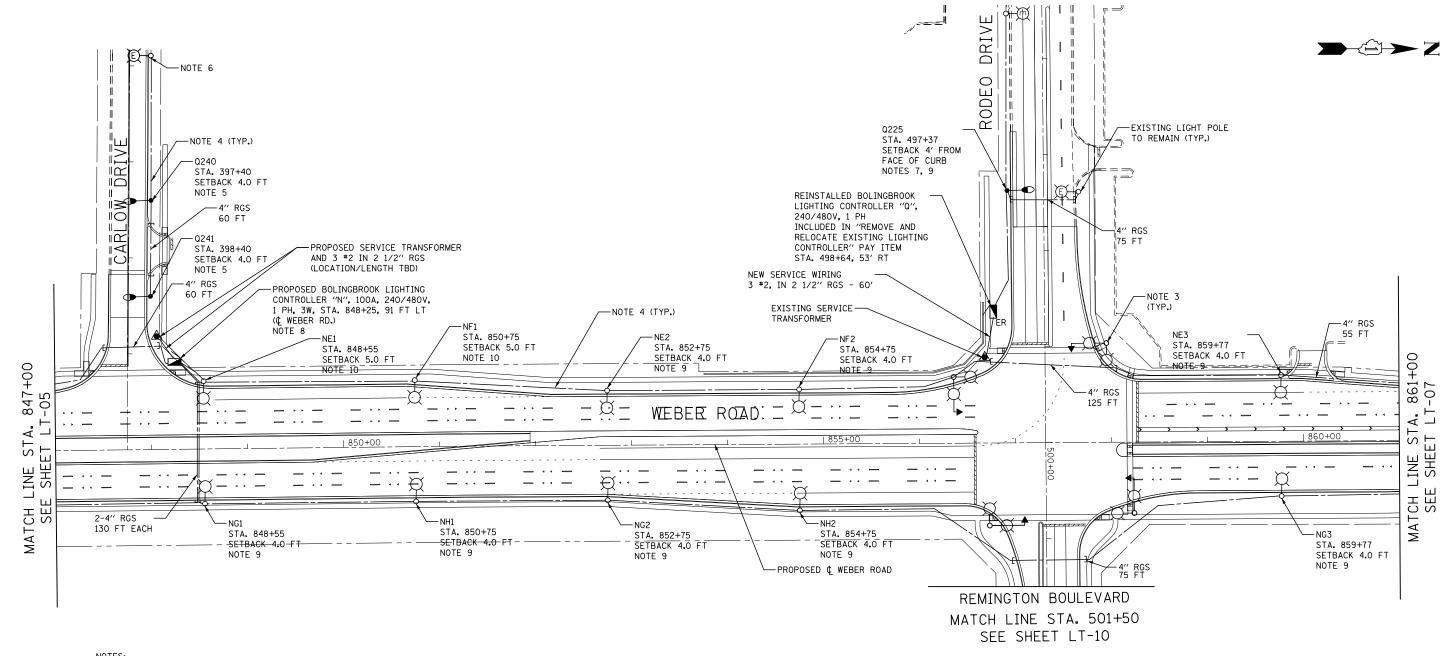


NOTES:

- 1. FOR SYMBOL LIST AND GENERAL ELECTRICAL NOTES, SEE SHEET LT-01.
- 2. ALL LIGHT POLE SETBACKS ARE MEASURED FROM THE FACE OF CURB TO CENTER OF LIGHT POLE BASE, UNLESS NOTED OTHERWISE.
- 3. COMBINATION TRAFFIC SIGNAL POLES SHALL BE INSTALLED UNDER TRAFFIC SIGNAL CONTROL WORK. SEE TRAFFIC SIGNAL PLANS FOR EXACT COMBINATION POLE LOCATIONS AND SHT LT-19 FOR MORE DETAILS. COMBINATION LIGHTING WILL BE MAINTAINED BY VILLAGE OF BOLINGBROOK.
- 4. UNIT DUCT, 600V, 3-1/C NO. 4, 1/C NO. 6 GROUND, (XLP-TYPE USE), 1 1/4" DIA. POLYETHYLENE.
- 5. RE-INSTALL LIGHT POLE (EXISTING) AND LIGHT POLE FOUNDATION, 24" DIAMETER. CONTRACTOR SHALL FIELD VERIFY THE BOLT CIRCLE OF THE EXISTING POLE AND MATCH THE BOLTS LOCATION ON NEW FOUNDATION. RE-INSTALLATION OF LIGHT POLE SHALL BE INCLUDED IN THE "REMOVE AND RE-ERECT EXISTING LIGHTING UNIT" PAY ITEM.
- 6. INTERCEPT EXISTING WIRING IN EXISTING LIGHT POLE AND CONTINUE CIRCUIT TO REINSTALLED LIGHT POLE.

- 7. RELOCATED LIGHT POLE AND LIGHT POLE FOUNDATION, 24" DIAMETER. CONTRACTOR SHALL FIELD VERIFY THE BOLT CIRCLE OF THE EXISTING POLE AND MATCH THE BOLTS LOCATION ON NEW FOUNDATION. SEE PRESTAGE PLANS FOR EXISTING POLE TO BE RELOCATED. RELOCATED LIGHT POLE SHALL BE PAID FOR AS PART OF "RELOCATE EXISTING LIGHTING UNIT" PAY ITEM.
- 8. LIGHTING CONTROLLER FOUNDATION SHALL BE INCLUDED IN LIGHTING CONTROLLER PAY ITEM, NO ADDITIONAL PAYMENT WILL BE MADE. SEE DETAIL ON SHEET LT-53.
- 9. THE DEPTH OF THE LIGHT POLE FOUNDATION SHALL BE 9'-6".
- 10. PROVIDE LIGHT POLE FOUNDATION, 24" DIAMETER, OFFSET. USE PILE OFFSET 5'-6", AND CAISSON SHALL BE ORIENTED TOWARD THE SIDEWALK.

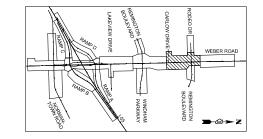

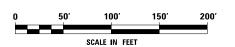



	USER NAME = dbarnes	DESIGNED	MLB	REVISED	-
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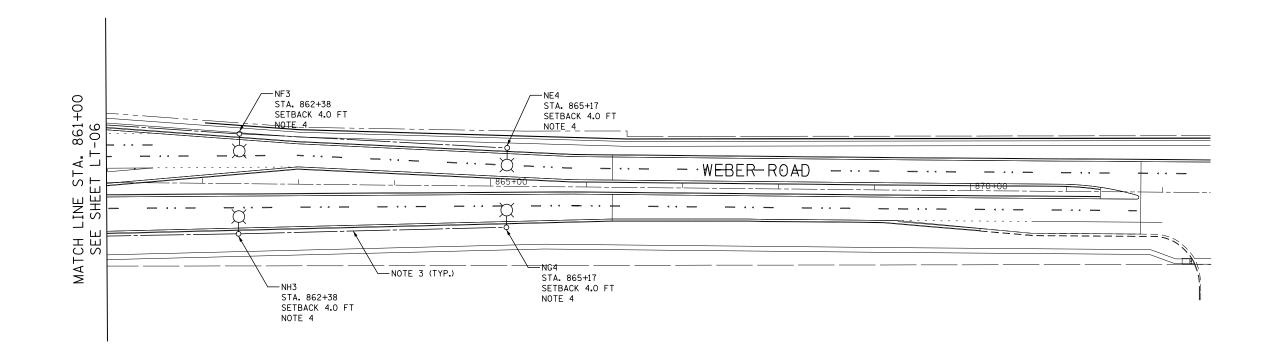
STATE OF ILLINOIS	
DEPARTMENT OF TRANSPORTATION	

	PROPOSED LIGHTING PLAN					F.A.I/P RTE.	5	SECTION	
l	WEBER ROAD						*	(99-	-1HB-1)
ļ	WEDEN NOAD							LT-0	6
I	SCALE: AS SHOWN	SHEET NO.	OF	SHEETS	STA.	TO STA.	* FAI 55.	FAP 856	ILLINO!

F.A.I/P RTE.	SECTION	COUNTY	TOTAL SHEETS	SHEE NO.
*	(99-1HB-1) R-1	WILL	1508	933
	LT-06	CONTRACT	NO. 6	OX1C
* FAI 55.	FAP 856 ILLINOIS FED. AI	D PROJECT		


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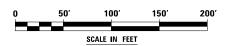




- NOTES:

 1. FOR SYMBOL LIST AND GENERAL ELECTRICAL NOTES, SEE SHEET LT-01.
- 2. ALL LIGHT POLE SETBACKS ARE MEASURED FROM THE FACE OF CURB TO CENTER OF LIGHT POLE BASE, UNLESS NOTED OTHERWISE.
- 3. UNIT DUCT, 600V, 3-1/C NO. 4, 1/C NO. 6 GROUND, (XLP-TYPE USE), 1 1/4" DIA. POLYETHYLENE.
- 4. THE DEPTH OF THE LIGHT POLE FOUNDATION SHALL BE 9'-6".



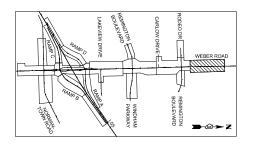





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PLOT DATE = 8/17/2017	DATE	08/25/17	REVISED -	
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STATE OF ILI	LINOIS
DEPARTMENT OF TRA	ANSPORTATION

	PROP	OSEL	LIGHT	ING PL	.AN	F.A.I/P RTE.	SECTIO
WEBER ROAD							(99-1HB-1
WEDER HOAD							LT-07
SCALE: AS SHOWN	SHEET NO.	OF	SHEETS	STA.	TO STA.	* FAI 55.	FAP 856 ILLING


F.A.I/P SECTION					COUNTY	TOTAL SHEETS	SHEE
* (99-1HB-1) R-1					WILL	1508	934
	LT-07				CONTRACT	NO. (50X10
* FAI 55,	FAP 856	ILLINOIS	FED.	AID	PROJECT		



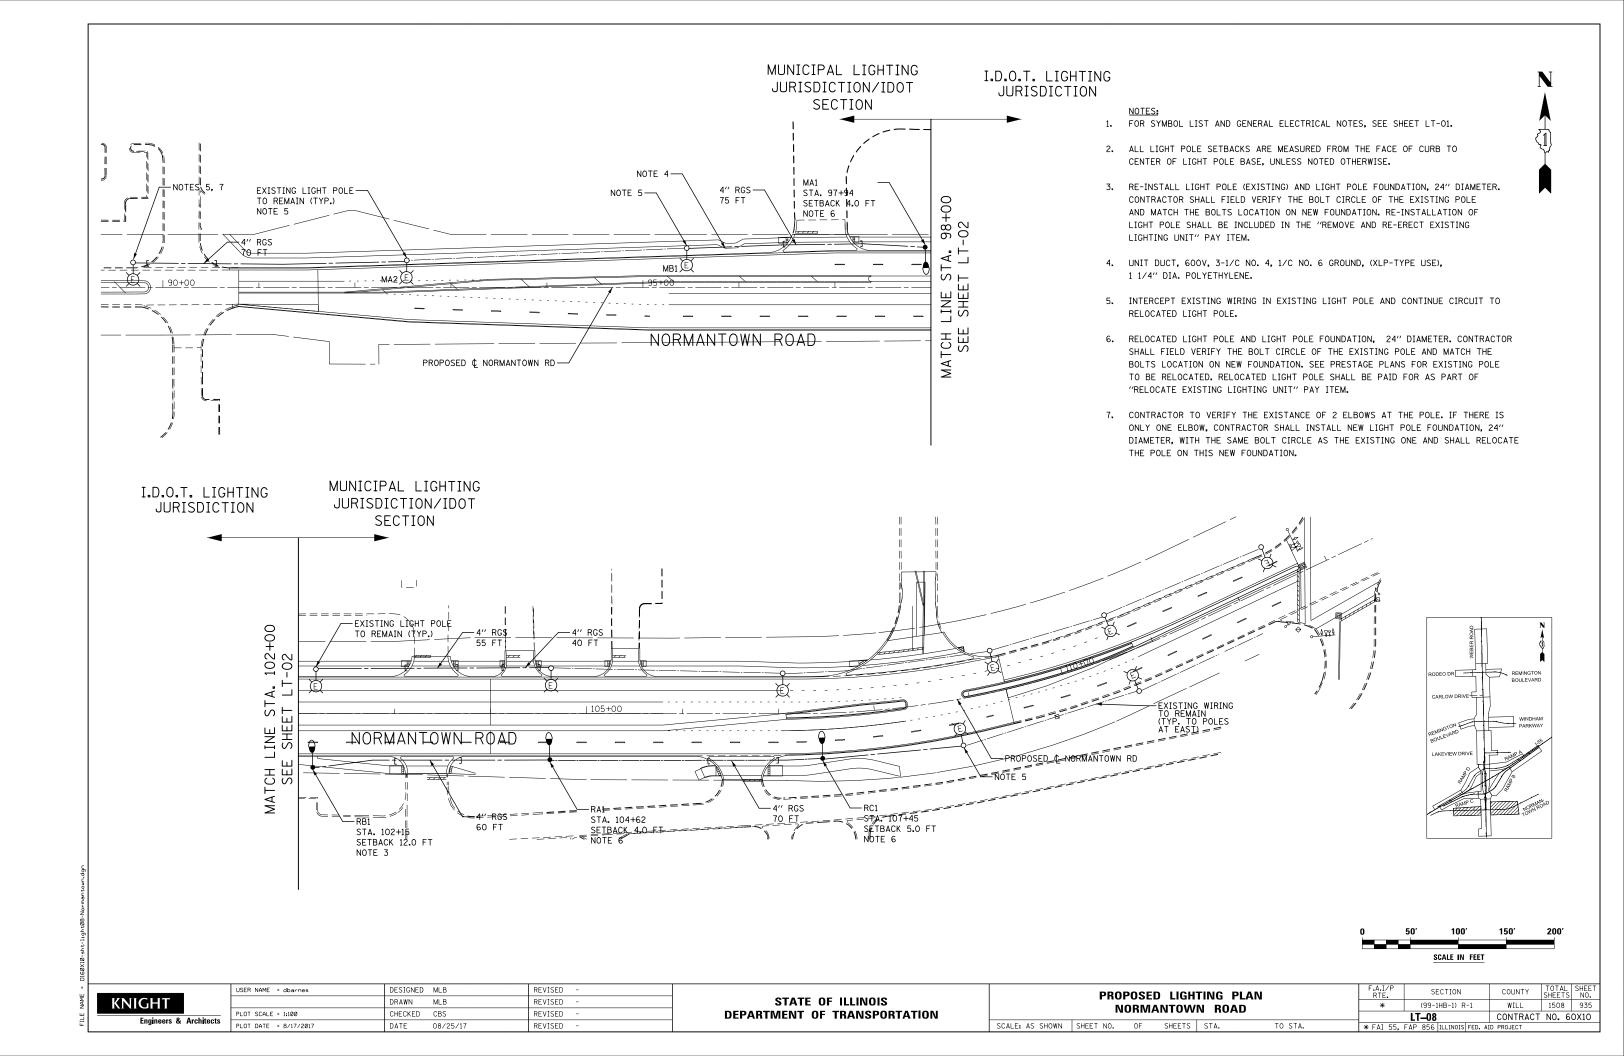

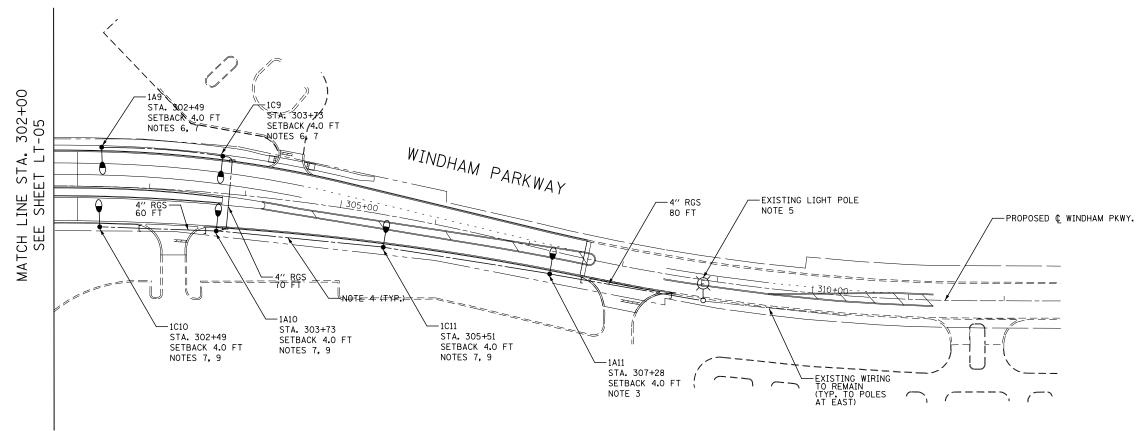NOTES:

- 1. FOR SYMBOL LIST AND GENERAL ELECTRICAL NOTES, SEE SHEET LT-01.
- 2. ALL LIGHT POLE SETBACKS ARE MEASURED FROM THE FACE OF CURB TO CENTER OF LIGHT POLE BASE, UNLESS NOTED OTHERWISE.
- 3. RE-INSTALL LIGHT POLE (EXISTING) AND LIGHT POLE FOUNDATION, 24" DIAMETER. CONTRACTOR SHALL FIELD VERIFY THE BOLT CIRCLE OF THE EXISTING POLE AND MATCH THE BOLTS LOCATION ON NEW FOUNDATION. RE-INSTALLATION OF LIGHT POLE SHALL BE INCLUDED IN THE "REMOVE AND RE-ERECT EXISTING LIGHTING UNIT" PAY ITEM.
- 4. UNIT DUCT, 600V, 3-1/C NO. 4, 1/C NO. 6 GROUND, (XLP-TYPE USE), 1 1/4" DIA. POLYETHYLENE.
- 5. INTERCEPT EXISTING WIRING IN EXISTING LIGHT POLE AND EXTEND CIRCUIT TO RELOCATED LIGHT POLE.
- 6. RE-INSTALL LIGHT POLE (EXISTING) AND LIGHT POLE FOUNDATION, 24" DIAMETER, OFFSET. CONTRACTOR SHALL FIELD VERIFY THE BOLT CIRCLE OF THE EXISTING POLE AND MATCH THE BOLTS LOCATION ON NEW FOUNDATION. RE-INSTALLATION OF LIGHT POLE SHALL BE INCLUDED IN THE "REMOVE AND RE-ERECT EXISTING LIGHTING UNIT" PAY ITEM. FOR OFFSET FOUNDATION, USE PILE OFFSET 5'-6", AND CAISON SHALL BE ORIENTED TOWARD THE SIDEWALK.
- 7. THE DEPTH OF THE LIGHT POLE FOUNDATION SHALL BE 9'-6".
- 8. ALL LIGHTING IS OWNED AND MAINTAINED BY THE MUNICIPALITY.
- 9. RE-INSTALL LIGHT POLE (EXISTING) AND LIGHT POLE FOUNDATION, 24" DIAMETER, OFFSET. CONTRACTOR SHALL FIELD VERIFY THE BOLT CIRCLE OF THE EXISTING POLE AND MATCH THE BOLTS LOCATION ON NEW FOUNDATION, RE-INSTALLATION OF LIGHT POLE SHALL BE INCLUDED IN THE "REMOVE AND RE-ERECT EXISTING LIGHTING UNIT" PAY ITEM. PILE OFFSET AND CAISON ORIENTATION FOR OFFSET FOUNDATION, SHALL BE DETERMINED BASED ON THE EXISTING WATERMAIN TO REMAIN LOCATION.

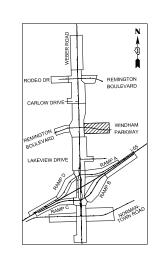


o	50′	100′	150′	200′
		SCALE IN FEET		

USER NAME = dbarnes	DESIGNED	MLB	REVISED -
	DRAWN	MLB	REVISED -
PLOT SCALE = 1:100	CHECKED	CBS	REVISED -
PLOT DATE = 8/17/2017	DATE	08/25/17	REVISED -
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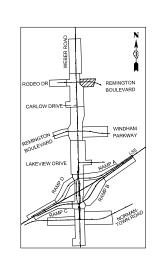
STATE (OF ILLINOIS	
DEPARTMENT OF	TRANSPORTATION	

PROPOSED LIGHTING PLAN WINDHAM PARKWAY				F.A.I/P RTE.	SECTION	COUNTY	TOTAL SHEETS	SHEET NO.	
				*	(99-1HB-1) R-1	WILL	1508	936	
						LT-09		CONTRACT NO. 60X10	
	SCALE: AS SHOWN SHEET NO. OF	SHEETS	STA.	TO STA.	* FAT 55.	FAP 856 ILLINOIS FED. A	D PROJECT		



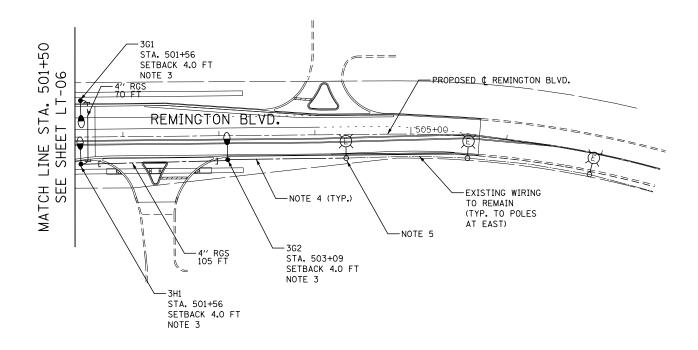


- 1. FOR SYMBOL LIST AND GENERAL ELECTRICAL NOTES, SEE SHEET LT-01.
- 2. ALL LIGHT POLE SETBACKS ARE MEASURED FROM THE FACE OF CURB TO CENTER OF LIGHT POLE BASE, UNLESS NOTED OTHERWISE.
- 3. RE-INSTALL LIGHT POLE (EXISTING) AND LIGHT POLE FOUNDATION, 24" DIAMETER. CONTRACTOR SHALL FIELD VERIFY THE BOLT CIRCLE OF THE EXISTING POLE AND MATCH THE BOLTS LOCATION ON NEW FOUNDATION. RE-INSTALLATION OF LIGHT POLE SHALL BE INCLUDED IN THE "REMOVE AND RE-ERECT EXISTING LIGHTING UNIT" PAY ITEM.
- 4. UNIT DUCT, 600V, 3-1/C NO. 4, 1/C NO. 6 GROUND, (XLP-TYPE USE), $1\ 1/4''$ DIA. POLYETHYLENE.
- 5. INTERCEPT EXISTING WIRING IN EXISTING LIGHT POLE AND EXTEND CIRCUIT TO RELOCATED LIGHT POLE.
- 6. ALL LIGHTING IS OWNED AND MAINTAINED BY THE MUNICIPALITY.




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		SCALE IN FEET		



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		DRAWN	MLB	REVISED	-	
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	PLOT DATE = 8/17/2017	DATE	08/25/17	REVISED	-	
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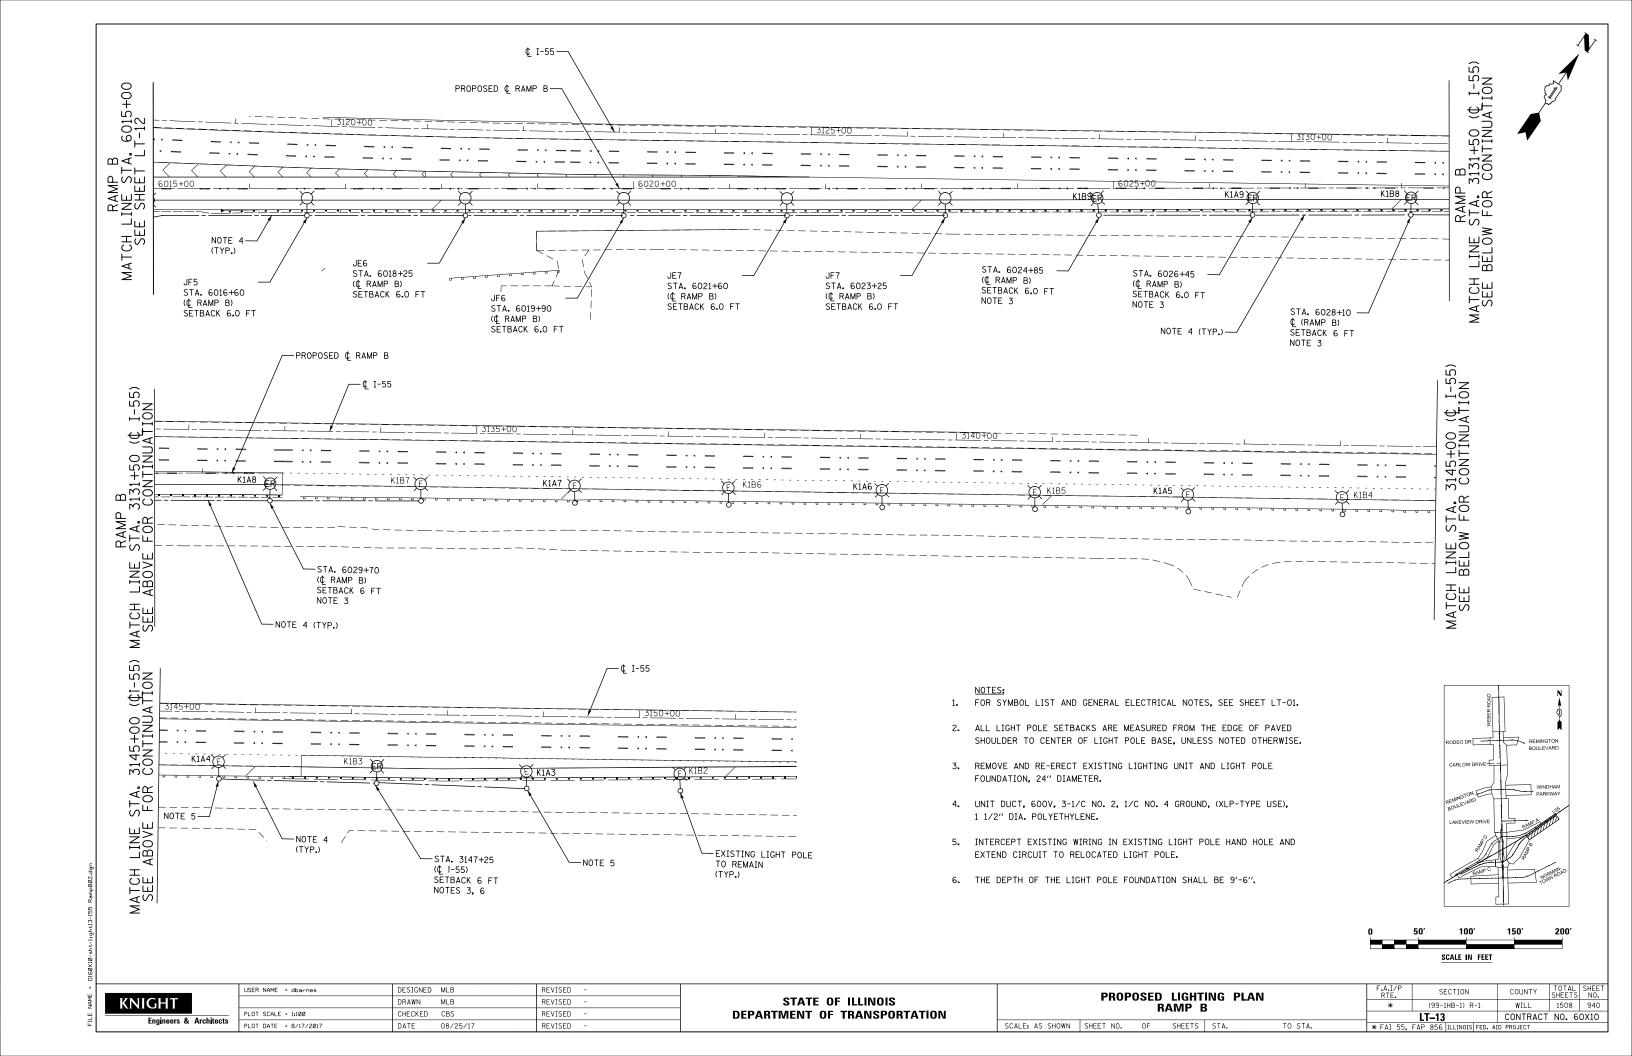
Engineers & Architects

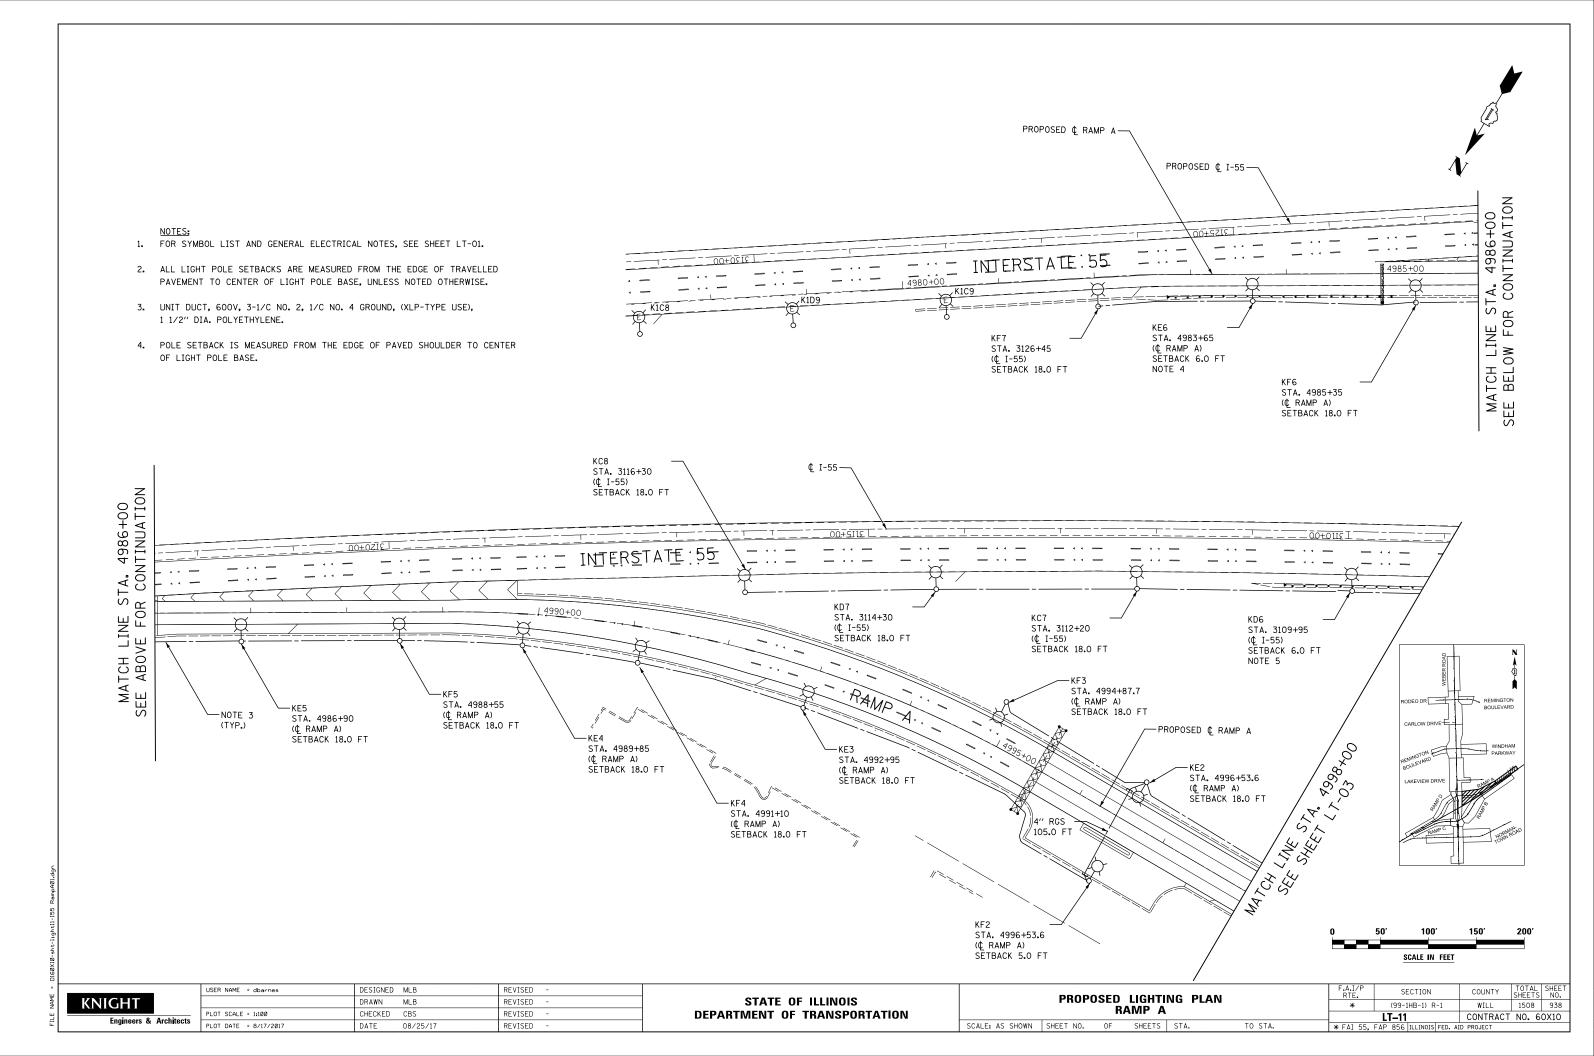
DRAWN MLB REVISED PLOT SCALE = 1:100 CHECKED CBS REVISED PLOT DATE = 8/17/2017 DATE 08/25/17 REVISED

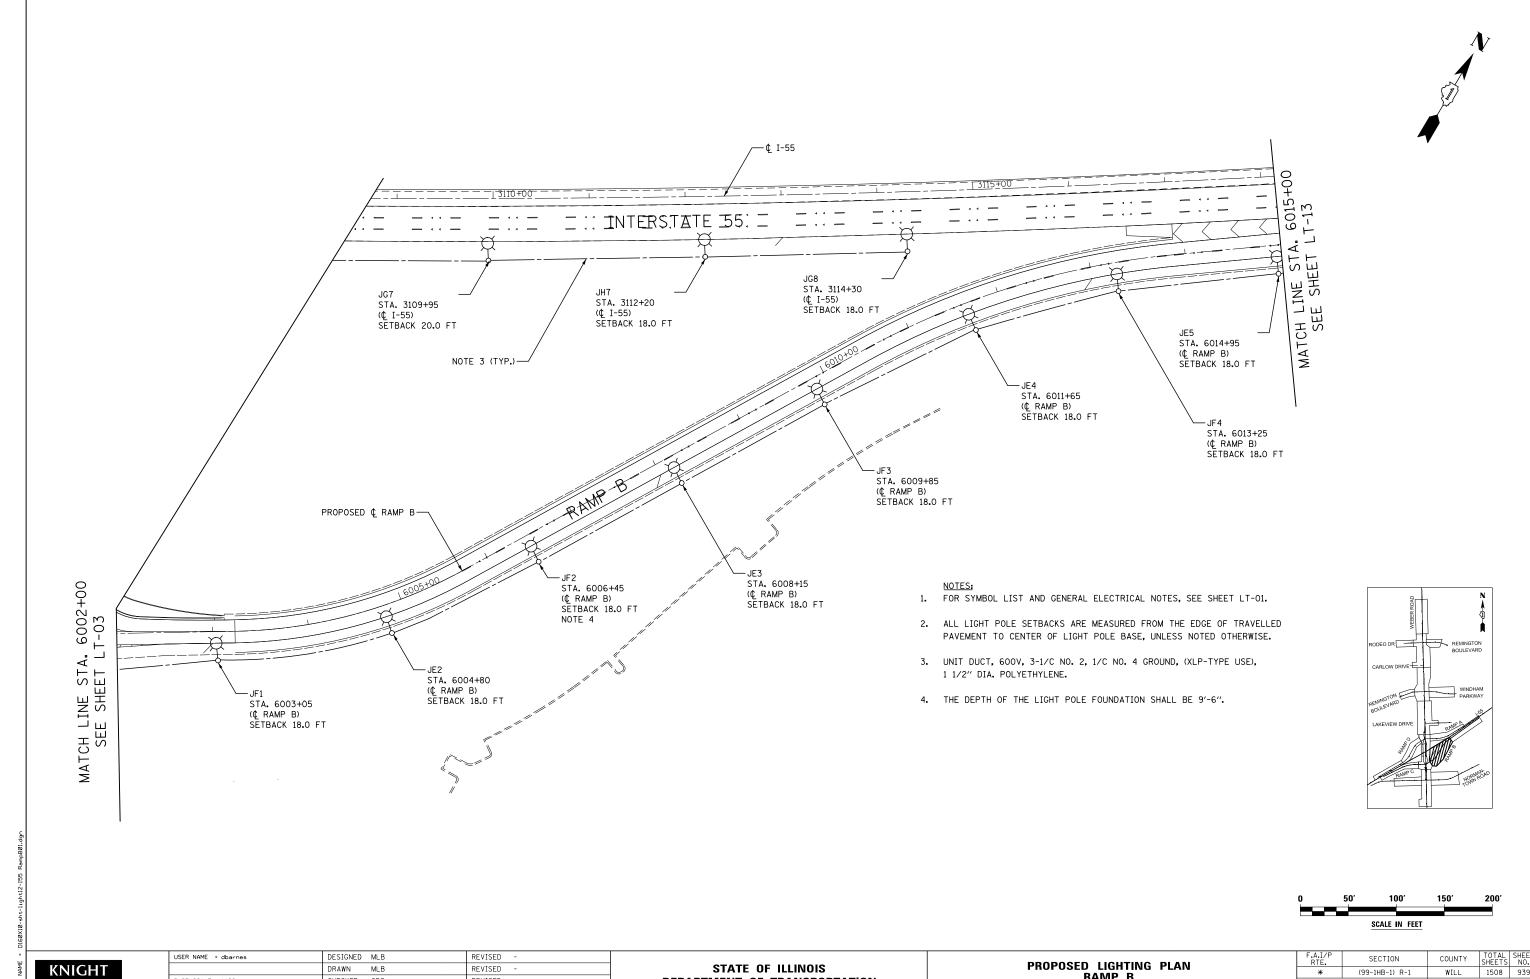DEPARTMENT OF TRANSPORTATION

PROPOSED LIGHTING PLAN RAMP B SCALE: AS SHOWN SHEET NO. OF SHEETS STA. TO STA.

COUNTY TOTAL SHEET NO.
WILL 1508 939
CONTRACT NO. 60X10 (99-1HB-1) R-1 LT-12 , FAP 856 I



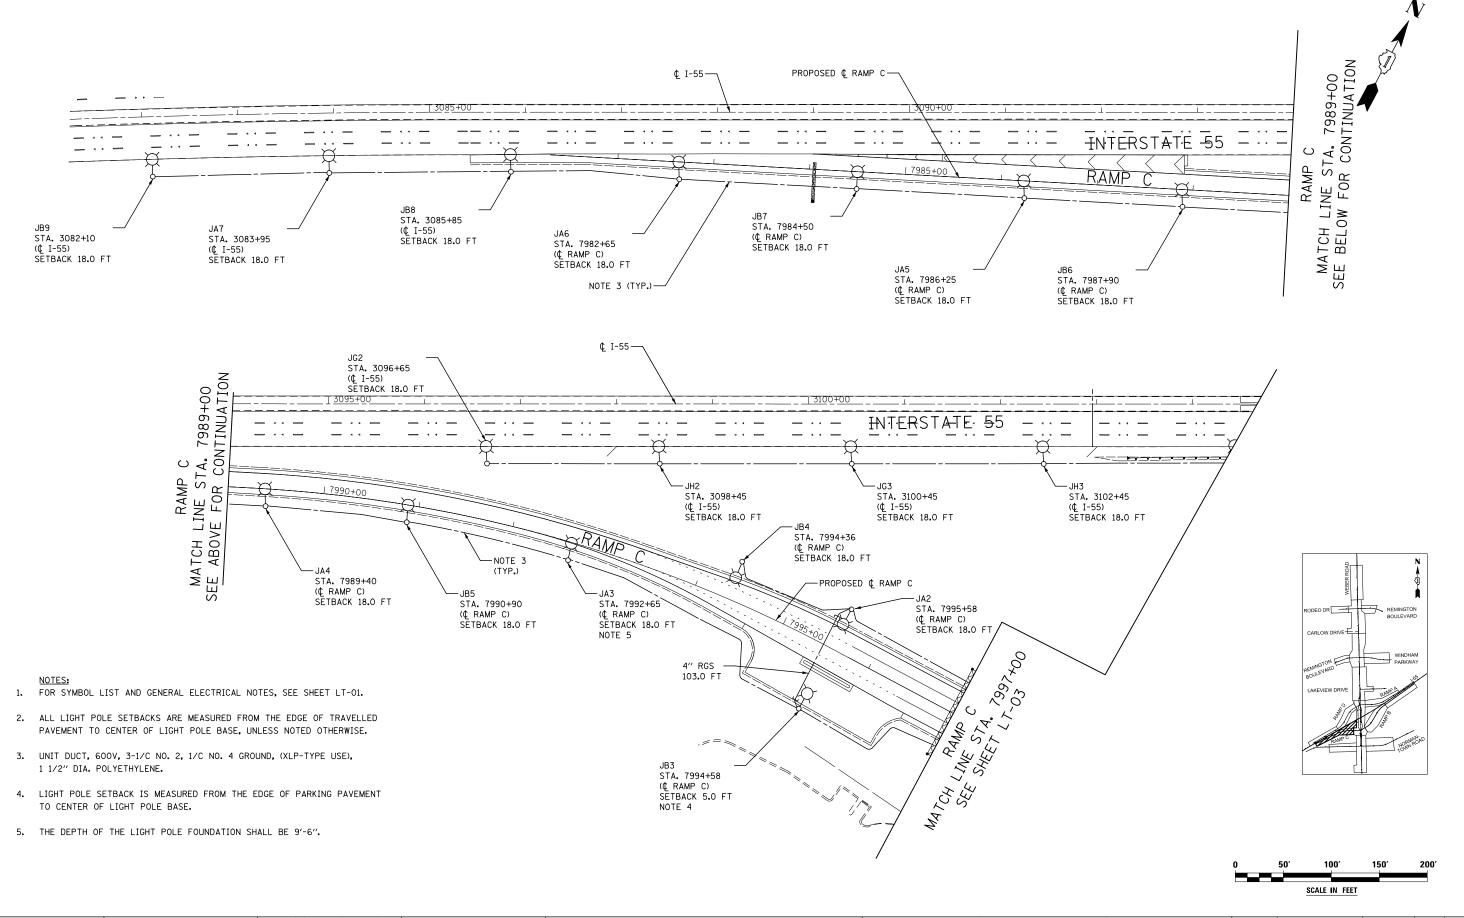

KNIGHT

Engineers & Architects


STATE OF ILLINOIS
DEPARTMENT OF TRANSPORTATION


PROPOSED LIGHTING PLAN RAMP C

SCALE: AS SHOWN SHEET NO. OF SHEETS STA. TO STA.

NOTES: 1. FOR SYMBOL LIST AND GENERAL ELECTRICAL NOTES, SEE SHEET LT-01.

2. ALL LIGHT POLE SETBACKS ARE MEASURED FROM THE EDGE OF TRAVELLED PAVEMENT TO CENTER OF LIGHT POLE BASE, UNLESS NOTED OTHERWISE. 3. UNIT DUCT, 600V, 3-1/C NO. 2, 1/C NO. 4 GROUND, (XLP-TYPE USE), 1 1/2" DIA. POLYETHYLENE.

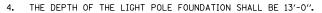

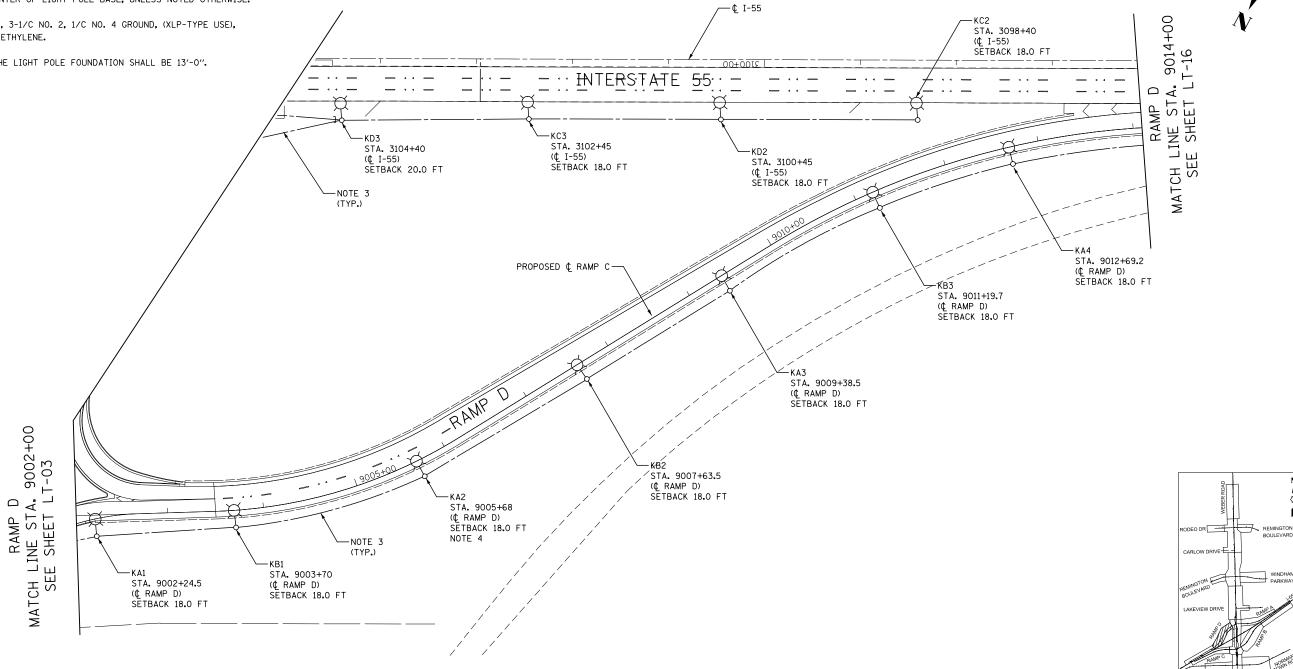

0	50′	100′	150′	200′
		SCALE IN FEET	г	

KNIGHT		
Engineers &	ß.	Architects


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	DRAWN	MLB	REVISED -	
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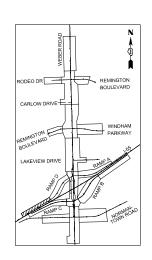
SCALE: AS SHOWN


DDUDU	OED.	LICHTI	VIC DI	LAN	F.A.I/P RTE.	SECTION	COUNTY	SHEETS	SHEET NO.
PROPOSED LIGHTING PLAN RAMP D			*	(99-1HB-1) R-1	WILL	1508	942		
		AIVII D				LT-15	CONTRACT	NO. 6	0X10
SHEET NO.	OF	SHEETS	STA.	TO STA.	* FAI 55,	FAP 856 ILLINOIS FED. A	ID PROJECT		





- 1. FOR SYMBOL LIST AND GENERAL ELECTRICAL NOTES, SEE SHEET LT-01.
- ALL LIGHT POLE SETBACKS ARE MEASURED FROM THE EDGE OF TRAVELLED PAVEMENT TO CENTER OF LIGHT POLE BASE, UNLESS NOTED OTHERWISE.
- UNIT DUCT, 600V, 3-1/C NO. 2, 1/C NO. 4 GROUND, (XLP-TYPE USE), 1 1/2" DIA. POLYETHYLENE.
- 4. THE DEPTH OF THE LIGHT POLE FOUNDATION SHALL BE 9'-6".

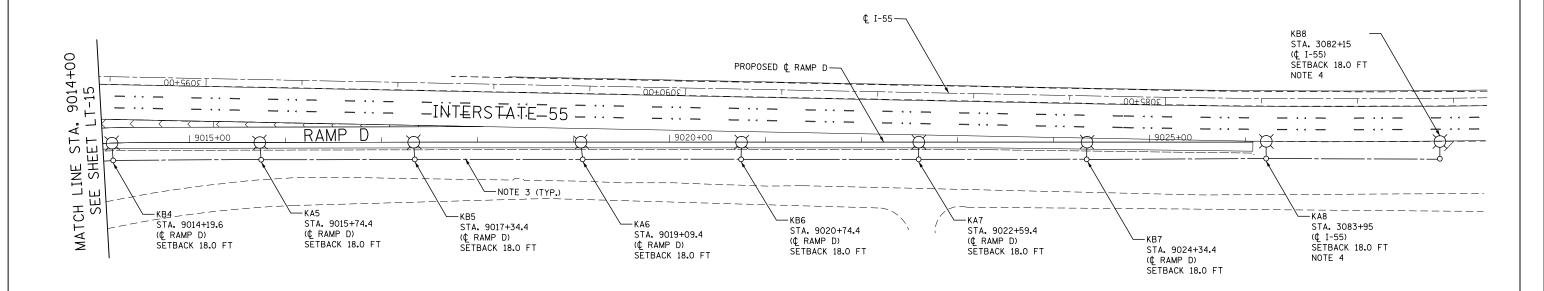

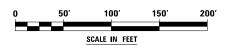




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STATE OF ILLINOIS
DEPARTMENT OF TRANSPORTATION

SCALE: AS SHOWN

PROPOSED LIGHTING PLAN				F.A.I/P RTE.	SECTION		
	RAMP D				*	(99-1HB-1) R-1	
							LT-16
	SHEET NO.	OF	SHEETS	STA.	TO STA.	* FAT 55.	FAP 856 ILLINOIS FED

F.A.I/P RTE.	SECTION	COUNTY	TOTAL SHEETS	SHEE
*	(99-1HB-1) R-1	WILL	1508	943
LT-16		CONTRACT	NO. 6	0X10
* FAI 55,	FAP 856 ILLINOIS FED. A	ID PROJECT		




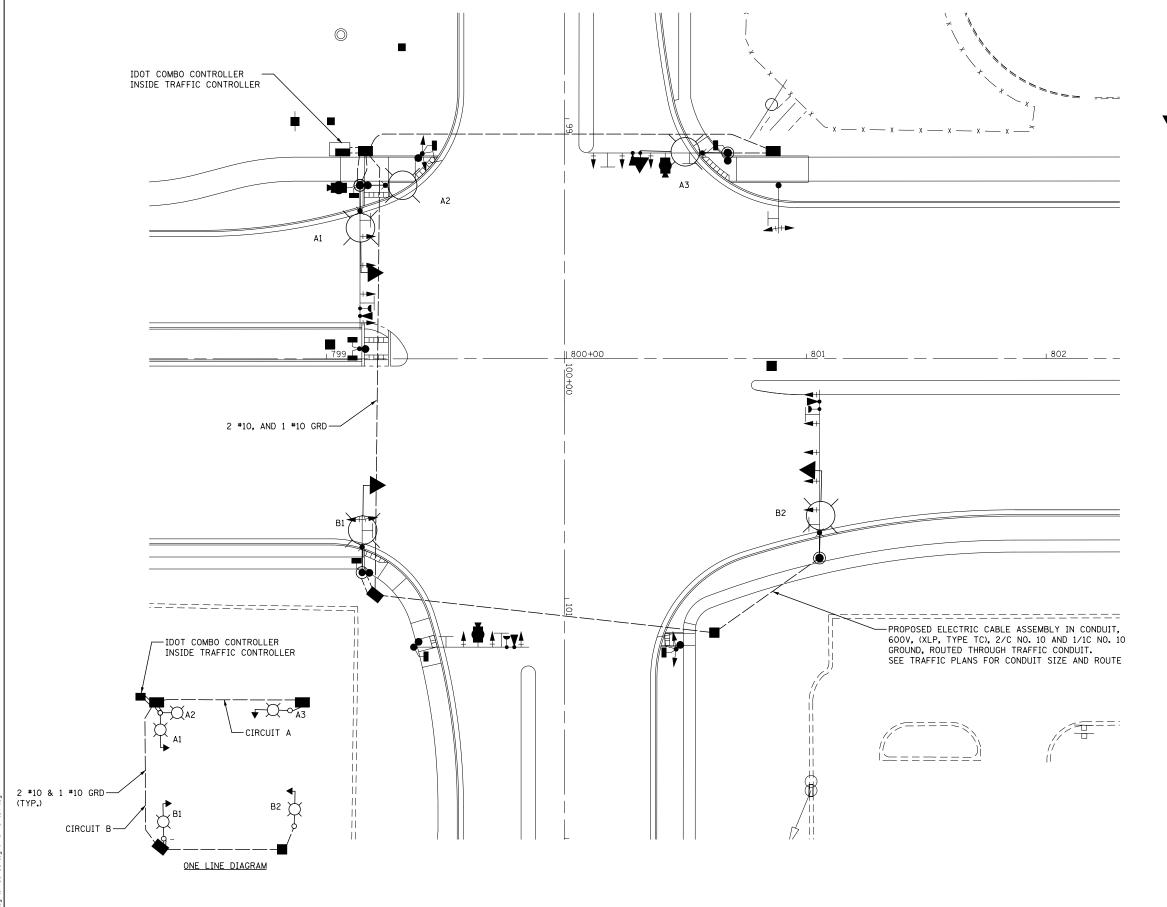



IDOT COMBINATION LIGHTPOLE

45 FT LUMINAIRE MOUNTING HEIGHT
15 FT LUMINAIRE ARM
LUMINAIRE, LED, HORIZONTAL MOUNT, TYPE C,

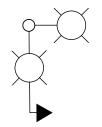


IDOT COMBINATION LIGHTPOLE
45 FT LUMINAIRE MOUNTING HEIGHT
2-15 FT LUMINAIRE ARMS AT 90° APART
TWO LUMINAIRES, LED, HORIZONTAL MOUNT, TYPE C,
120V


NOTES:

- THE IDOT COMBO LIGHTING CIRCUITING SHALL NOT BE CONNECTED TO IDOT ROADWAY OR VILALGE LIGHTING CONTROLLER.
- LUMINAIRES ARE POWERED FROM IDOT TRAFFIC CONTROLLER AS PER DETAIL SHEET BE-240.
- THE COMBO LIGHTING CABLE AND SIGNAL CABLES WILL BE IN SHARED CONDUIT.
- SEE TRAFFIC SIGNAL PLANS FOR LOCATION OF COMBO POLES, HANDHOLES AND CONDUIT.
- CIRCUIT DECALS SHALL NOT BE INSTALLED ON COMBO POLES. FOR CIRCUITING INFORMATION ONLY.

IDOT COMBO LIGHTING SCHEDULE OF Q	UANTITIES	5
DESCRIPTION	UNIT	QUANTITY
LUMINAIRE, LED, HORIZONTAL MOUNT, TYPE C	EACH	5
COMBINATION LIGHTING CONTROLLER	EACH	1
LUMINAIRE SAFETY CABLE ASSEMBLY	EACH	5
ELECTRIC CABLE ASSEMBLY IN CONDUIT, 600V, (XLP, TYPE TC), 2/C NO. 10 AND 1/1C NO. 10 GROUND	FOOT	660

ALL PAY ITEMS ARE PAID FOR AS PART OF TRAFFIC SIGNAL INSTALLATION.

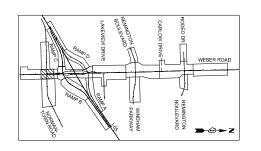

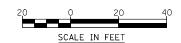


KNIGHT
Engineers & Architects


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_					COMBINATIANTOWN	
SCALE: AS SHOWN	SHEET	NO.	OF	SHEETS	STA.	TO STA.

F.A.I/P RTE.	SECTION			COUNTY	TOTAL SHEETS		
*	* (99-1HB-1) R-1			WILL	1508	944	
LT-17					CONTRACT	NO. 6	50X10
* FAI 55,	FAP 856	ILLINOIS	FED.	AID	PROJECT		





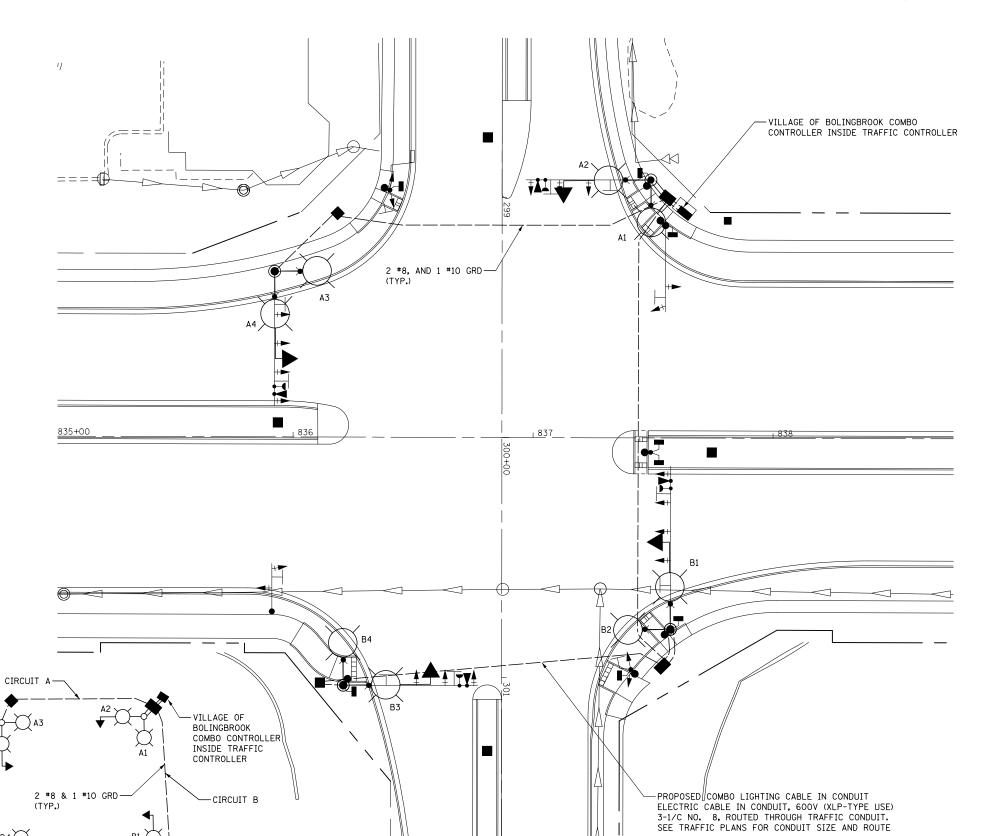

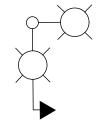
BOLINGBROOK COMBINATION LIGHTPOLE
45 FT LUMINAIRE MOUNTING HEIGHT
2-15 FT LUMINAIRE ARMS AT 90°APART
TWO LUMINAIRE, LED, HORIZONTAL MOUNT, TYPE C,
120V

NOTES:

- 1. THE BOLINGBROOK COMBO LIGHTING CIRCUITING SHALL NOT BE CONNECTED TO BOLINGBROOK ROADWAY LIGHTING CONTROLLER.
- 2. LUMINAIRES ARE POWERED FROM BOLINGBROOK TRAFFIC CONTROLLER, SEE TRAFFIC SIGNAL PLANS.
- THE COMBO LIGHTING CABLE AND SIGNAL CABLES WILL BE IN SHARED CONDUIT.
- SEE TRAFFIC SIGNAL PLANS FOR LOCATION OF COMBO POLES, HANDHOLES AND CONDUIT.

BOLINGBROOK COMBO LIGHTING SCHEDULE OF QUANTITIES						
DESCRIPTION	UNIT	QUANTITY				
LUMINAIRE, LED, HORIZONTAL MOUNT, TYPE C	EACH	8				
COMBINATION LIGHTING CONTROLLER	EACH	1				
LUMINAIRE SAFETY CABLE ASSEMBLY	EACH	8				
ELECTRIC CABLE IN CONDUIT, 600V (XLP-TYPE USE) 3-1/C NO. 8	FOOT	610				

ALL PAY ITEMS ARE PAID FOR AS PART OF TRAFFIC SIGNAL INSTALLATION.

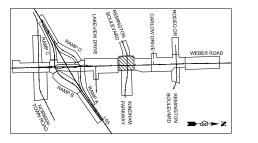



ONE	LINE	DIAGRAM


KNIGHT		
Engineers	&	Architects

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WEBER						NATION VINDHAM	PKWY	ŀ
ALF. AS SHO	WN SHE	FT NO	0F	SHEETS	ΔΤΣ	TO STA		╬

F.A.I/P RTE.	SECTION	COUNTY	TOTAL SHEETS	SHEE NO.		
*	(99-1HB-1) R	-1	WILL	1508	945	
	LT-18	CONTRACT	NO. 6	0X10		
* FAI 55,	FAP 856 ILLINOIS	FED. AII	D PROJECT			



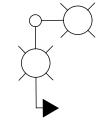


BOLINGBROOK COMBINATION LIGHTPOLE
45 FT LUMINAIRE MOUNTING HEIGHT
2-15 FT LUMINAIRE ARMS AT 90°APART
TWO LUMINAIRE, LED, HORIZONTAL MOUNT, TYPE C,
120V

NOTES:

- 1. THE BOLINGBROOK COMBO LIGHTING CIRCUITING SHALL NOT BE CONNECTED TO BOLINGBROOK ROADWAY LIGHTING CONTROLLER.
- LUMINAIRES ARE POWERED FROM BOLINGBROOK TRAFFIC CONTROLLER, SEE TRAFFIC SIGNAL PLANS.
- 3. THE COMBO LIGHTING CABLE AND SIGNAL CABLES WILL BE IN SHARED CONDUIT.
- SEE TRAFFIC SIGNAL PLANS FOR LOCATION OF COMBO POLES, HANDHOLES AND CONDUIT.

BOLINGBROOK COMBO LIGHTING SCHEDULE OF QUANTITIES					
DESCRIPTION	UNIT	QUANTITY			
LUMINAIRE, LED, HORIZONTAL MOUNT, TYPE C	EACH	8			
COMBINATION LIGHTING CONTROLLER	EACH	1			
LUMINAIRE SAFETY CABLE ASSEMBLY	EACH	8			
ELECTRIC CABLE IN CONDUIT, 600V (XLP-TYPE USE) 3-1/C NO. 8	F00T	665			

ALL PAY ITEMS ARE PAID FOR AS PART OF TRAFFIC SIGNAL INSTALLATION.

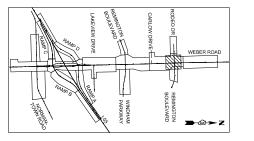



VILLAGE OF BOLINGBROOK COMBO CONTROLLER INSIDE TRAFFIC CONTROLLER A2 A1 A2 A8, AND 1 *10 GRD	A3
	858 B4
VILLAGE OF BOLINGBROOK COMBO CONTROLLER INSIDE TRAFFIC CONTROLLER CIRCUIT A A3 CIRCUIT B A2 A4	B3
2 #8 & 1 #10 GRD (TYP.) B1 B2 ONE LINE DIAGRAM	PROPOSED COMBO LIGHTING CABLE IN CONDUIT ELECTRIC CABLE IN CONDUIT, 600V (XLP-TYPE USE) 3-1/C NO. 8, ROUTED THROUGH TRAFFIC CONDUIT. SEE TRAFFIC PLANS FOR CONDUIT SIZE AND ROUTE

KNIGHT


Engineers & Architects

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ı	PROPOSED	LIGH.	TING	сомви	NATION	F.A R1
WEBER	ROAD AT	RODE	O DR	IVE⁄REN	IINGTON BLVD	
SCALE: AS SHOWN	SHEET NO.	0F	SHEETS	STA.	TO STA.	* FA

F.A.I/P RTE.			SE	ECTION			COUNTY	SHEET	SHEETS	
* (99-1HB-1) R-1			WILL 1508		3	94				
		LT-	-19				CONTRACT	NO.	6	0X10
* FAI 55	5,	FAP	856	ILLINOIS	FED.	AID	PROJECT			



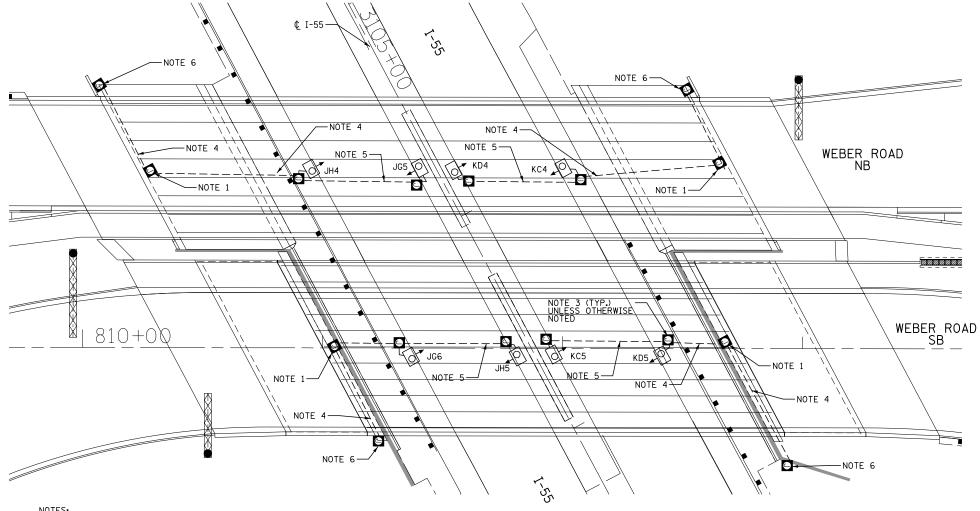

l	UNDERPASS LUMINAIRE LOCATIONS							
NO.	STATION	SETBACK FROM E.O.P.						
KC4	3106+02.5	2 FT						
KD4	3105+81	2 FT						
KC5	3106+69	2 FT						
KD5	3106+90.5	2 FT						
JG5	3105+74.5	2 FT						
JH4	3105+53	2 FT						
JG6	3106+39.5	2 FT						
JH5	3106+62.5	2 FT						


- 1. JUNCTION BOX, STAINLESS STEEL, ATTACHED TO STRUCTURE, 12" X 10" X 6". SEE DETAIL A AND IDOT D1 STANDARD BE-900 FOR INSTALLATION DETAILS.
- 2. UNDERPASS LUMINAIRE, LED, TYPE B. LUMINARES SHALL BE INSTALLED WITH A 2 FT. SETBACK FROM EDGE OF PAVEMENT TO THE CENTER OF LUMINAIRE AND SHALL BE INSTALLED NO LOWER THAN THE BOTTOM BEAM FLANGE. SEE IDOT D1 STANDARD DRAWING BE-900 FOR INSTALLATION DETAILS.
- 3. JUNCTION BOX, STAINLESS STEEL, ATTACHED TO STRUCTURE, 6" X 6" X 4", UNLESS OTHERWISE NOTED ON THIS SHEET. SEE DETAIL A AND IDOT D1 STANDARD DRAWING BE-900 FOR INSTALLATION DETAILS.
- 4. (3) ELECTRIC CABLE IN CONDUIT, 600V (XLP-TYPE USE) 1/C NO. 10 AND ELECTRIC CABLE IN CONDUIT, 600V (XLP-TYPE USE) 1/C NO. 10 GROUND IN CONDUIT ATTACHED TO STRUCTURE, 1" DIA., PVC COATED GALVANIZED
- 5. (2) ELECTRIC CABLE IN CONDUIT, 600V (XLP-TYPE USE) 1/C NO. 10 AND ELECTRIC CABLE IN CONDUIT, 600V (XLP-TYPE USE) 1/C NO. 10 GROUND IN CONDUIT ATTACHED TO STRUCTURE, 1" DIA., PVC COATED GALVANIZED STEEL.
- 6. JUNCTION BOX, STAINLESS STEEL, ATTACHED TO STRUCTURE, 24" X 24" X 8" WITH 30A FUSES AND NEUTRAL SLUG IN SINGLE POLE FUSE HOLDER.

SYMBOL LIST

PROPOSED UNDERPASS LUMINAIRE, TYPE B, LED, 240V

WIRING IN CONDUIT ATTACHED TO STRUCTURE


PROPOSED LIGHTING JUNCTION BOX. TYPE AND SIZE AS NOTED

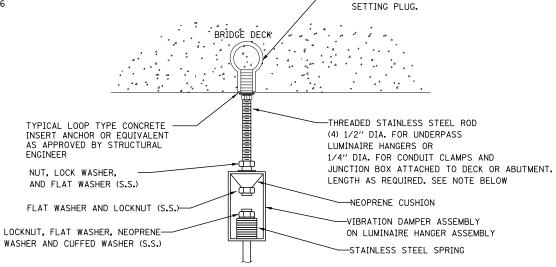

FOR UNDERPASS LUMINAIRE ONLY, RODS SHALL CONTINUE DOWN WITH THE VIBRATION DAMPER.

SINGLE COIL FLARED LOOP INSERT CAST IN CONCRETE

DETAIL A NOT TO SCALE

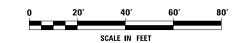

-5/8" x 3 1/2" LOOP TYPE CAST IN PLACE THREADED CONCRETE INSERTS AND




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HT		DRAWN	MLB	REVISED -
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jineers & Architects	PLOT DATE = 8/17/2017	DATE	08/25/17	REVISED -

	PROPOSED LIGHTING PLAN							
INTERS	STATE 55	ΑT	WEBER	ROAD	UNDERPASS			
SCALE: AS SHOWN	SHEET NO.	OF	SHEETS	STA.	TO STA.			

F.A.I/P RTE.	SECTION	COUNTY	TOTAL SHEETS	SHE NO	
*	(99-1HB-1) R	-1	WILL	1508	94
	LT-20		CONTRACT	NO. 6	0X10
* FAI 55,	FAP 856 ILLINOIS	FED. AII	D PROJECT		




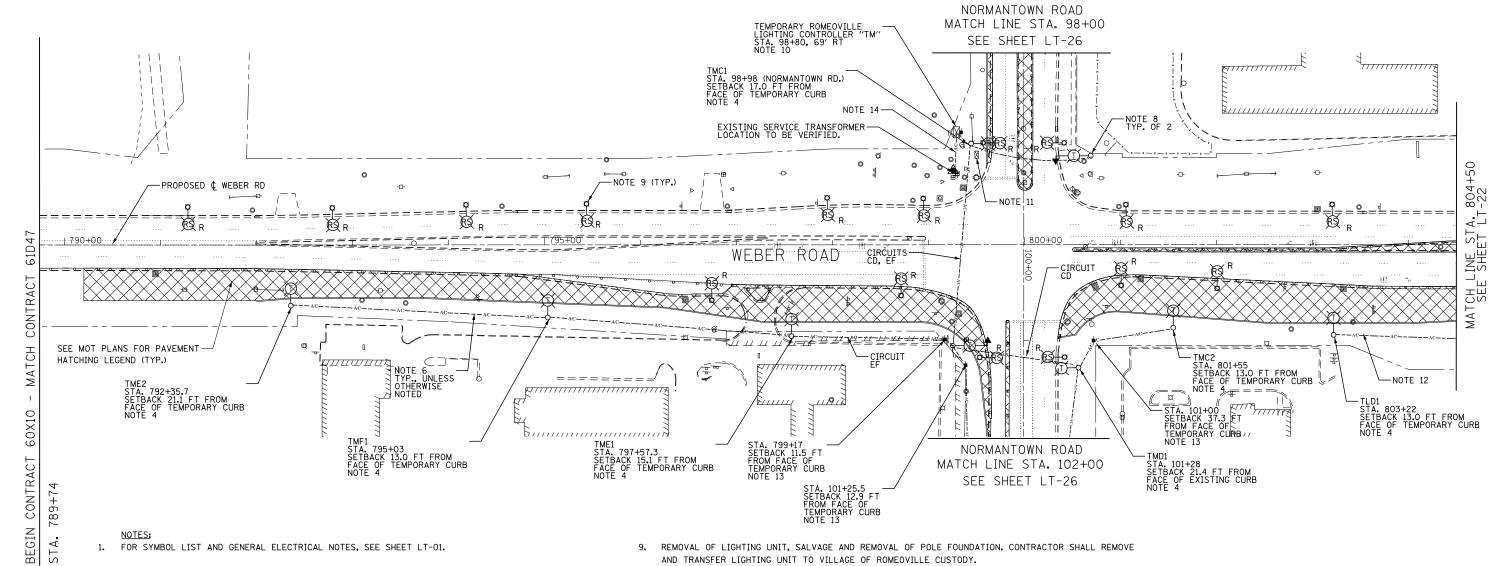

- 1. FOR SYMBOL LIST AND GENERAL ELECTRICAL NOTES, SEE SHEET LT-01.
- 2. CONTRACTOR SHALL COORDINATE AND STAGE TEMPORARY AND PROPOSED LIGHTING INSTALLATION AND EXISTING LIGHTING REMOVALS SUCH THAT NO SECTION OF ROADWAY THAT IS CURRENTLY ILLUMINATED WILL BE WITHOUT LIGHT FOR ANY NIGHTTIME PERIOD.
- 3. ALL WORK SHOWN ON THIS SHEET SHALL BE COORDINATED WITH THE MAINTENANCE OF TRAFFIC PLANS.
- 4. LIGHT POLE, WOOD, 60 FOOT, CLASS 4, WITH 15 FT MAST ARM AND TEMPORARY LUMINAIRE, HIGH PRESSURE SODIUM VAPOR, HORIZONTAL MOUNT, 400 WATT, 240V TYPE III WITH A MOUNTING HEIGHT OF 47.5 FT.
- 5. TEMPORARY WOOD POLE SETBACKS ARE MEASURED FROM EDGE OF PAVEMENT TO THE CENTER OF THE POLE BASE, UNLESS NOTED OTHERWISE.
- AERIAL CABLE, 3-1/C NO.4 WITH MESSENGER WIRE. MAINTAIN CLEARANCE FROM GROUND PER NEC 225.18 AND FROM COMED OVERHEAD ELECTRIC LINES AS REQUIRED BY COMED.
- 7. INTERCEPT EXISTING WIRING IN EXISTING LIGHT POLE AND CONTINUE CIRCUIT TO TEMPORARY LIGHT POLE.
- 8. TEMPORARY LIGHTING FOR INTERSECTION MOUNTED ON TRAFFIC SIGNAL POLE. WOOD POLE INSTALLED UNDER TRAFFIC SIGNAL PLANS, MAST ARM, STREET LIGHTING, 15', TEMPORARY LUMINAIRE, HIGH PRESSURE SODIUM VAPOR, HORIZONTAL MOUNT, 400 WATT (240V, 47.5' M.H., TYPE III) AND WIRING PROVIDED BY LIGHTING CONTRACTOR.

- 9. REMOVAL OF LIGHTING UNIT, SALVAGE AND REMOVAL OF POLE FOUNDATION. CONTRACTOR SHALL REMOVE AND TRANSFER LIGHTING UNIT TO VILLAGE OF ROMEOVILLE CUSTODY.
- 10. TEMPORARY LIGHTING CONTROLLER, SPECIAL, 100A, 240/480 VOLT, 3 WIRE INSTALLED ON WOOD POLE SUPPORT. SEE SHEETS LT-52A AND LT-54 AND SPECIAL PROVISIONS FOR DETAILS.
- 11. REMOVAL OF LIGHTING CONTROLLER AND REMOVAL OF LIGHTING CONTROLLER FOUNDATION.
- 12. AERIAL CABLE, 3-1/C NO.2 WITH MESSENGER WIRE. MAINTAIN CLEARANCE FROM GROUND PER NEC 225.18 AND FROM COMED OVERHEAD ELECTRIC LINES AS REQUIRED BY COMED.
- 13. TEMPORARY WOOD POLE, 60 FT., CLASS 4.
- 14. AERIAL CABLE, 3-1/C NO.2 WITH MESSENGER WIRE. MAINTAIN CLEARANCE FROM GROUND PER NEC 225.18 AND FROM COMED OVERHEAD ELECTRIC LINES AS REQUIRED BY COMED, SERVICE AERIAL CABLE SHALL BE INCLUDED IN THE COST OF "TEMPORARY LIGHTING CONTROLLER" PAY ITEM.

SCALE: AS

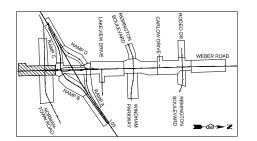

o	50′	100′	150′	200′
		SCALE IN FEET		




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	DRAWN	MLB	REVISED -
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PLOT DATE = 8/17/2017	DATE	08/25/17	REVISED -

STATE OF ILLINOIS

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SHOWN	SHEET NO.	OF	SHEETS	STA.	TO STA.	


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* (99-1HB-1) R-1			WILL	1508	9.		
	LT-21				CONTRACT	NO. 6	0X1
* FAI 55,	FAP 856	ILLINOIS	FED.	AID	PROJECT		

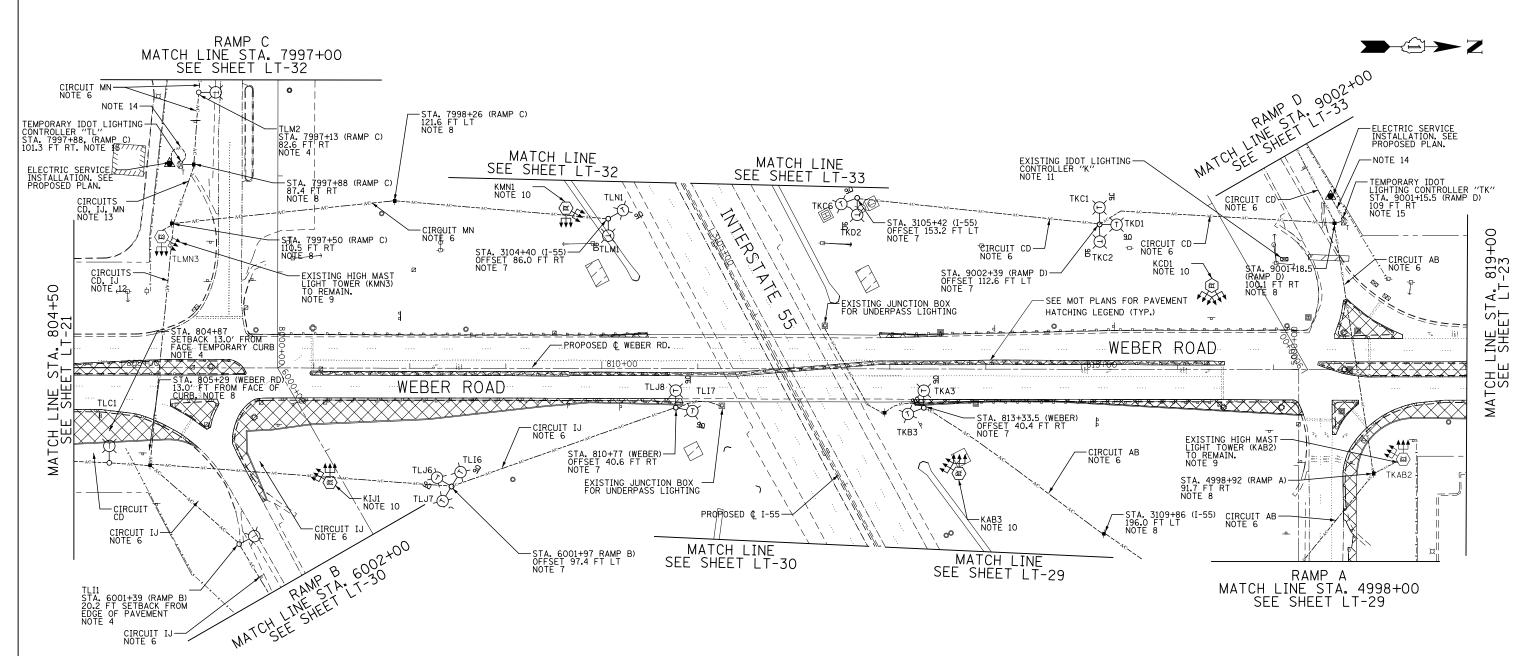


- 1. FOR SYMBOL LIST AND GENERAL ELECTRICAL NOTES, SEE SHEET LT-01.
- CONTRACTOR SHALL COORDINATE AND STAGE TEMPORARY AND PROPOSED LIGHTING INSTALLATION AND EXISTING LIGHTING REMOVALS SUCH THAT NO SECTION OF ROADWAY THAT IS CURRENTLY ILLUMINATED WILL BE WITHOUT LIGHT FOR ANY NIGHTTIME PERIOD.
- 3. ALL WORK SHOWN ON THIS SHEET SHALL BE COORDINATED WITH THE MAINTENANCE OF TRAFFIC PLANS.
- 4. LIGHT POLE, WOOD, 60 FOOT, CLASS 4, WITH 15 FT MAST ARM AND TEMPORARY LUMINAIRE, HIGH PRESSURE SODIUM VAPOR, HORIZONTAL MOUNT, 400 WATT, 240V TYPE III WITH A MOUNTING HEIGHT OF 47.5 FT.
- 5. TEMPORARY WOOD POLE OFFSET IS MEASURED FROM C/B OF ROAD AS SPECIFIED ON CALLOUTS TO THE CENTER OF THE POLE BASE, UNLESS NOTED OTHERWISE.
- 6. AERIAL CABLE, 3-1/C NO.2 WITH MESSENGER WIRE. MAINTAIN CLEARANCE FROM GROUND PER NEC 225.18 AND FROM COMED OVERHEAD ELECTRIC LINES AS REQUIRED BY COMED.
- 7. LIGHT POLE, WOOD, 90 FOOT, CLASS 4, WITH 15 FOOT MAST ARMS AND TEMPORARY LUMINAIRE, HIGH PRESSURE SODIUM VAPOR, HIGH MAST, HORIZONTAL MOUNT, 750 WATT. LUMINAIRES SHALL BE 240V, TYPE III WITH MOUNTING HEIGHT OF 70 FT. MAST ARM AND LUMINAIRE QUANTITY AS SHOWN ON PLAN.
- 8. TEMPORARY WOOD POLE, 60 FT., CLASS 4

- 9. INTERCEPT EXISTING WIRING IN EXISTING LIGHT TOWER AND CONTINUE CIRCUIT TO TEMPORARY LIGHT POLE.
- 10. REMOVAL OF LIGHT TOWER, NO SALVAGE, AND REMOVAL OF TOWER FOUNDATION. LUMINAIRES TO BE SALVAGED TO IDOT.
- 11. REMOVAL OF LIGHTING CONTROLLER AND REMOVAL OF LIGHTING CONTROLLER FOUNDATION.
- 12. 2 AERIAL CABLE, 3-1/C NO.2 WITH MESSENGER WIRE, MAINTAIN CLEARANCE FROM GROUND PER NEC 225.18 AND FROM COMED OVERHEAD ELECTRIC LINES AS REQUIRED BY COMED.
- 13. 3 AERIAL CABLE, 3-1/C NO.2 WITH MESSENGER WIRE. MAINTAIN CLEARANCE FROM GROUND PER NEC 225.18 AND FROM COMED OVERHEAD ELECTRIC LINES AS REQUIRED BY COMED.
- 14. AERIAL CABLE, 3-1/C NO.3/O WITH MESSENGER WIRE. SERVICE AERIAL CABLE SHALL BE INCLUDED IN THE COST OF "TEMPORARY LIGHTING CONTROLLER" PAY ITEM.
- 15. TEMPORARY LIGHTING CONTROLLER, 200A, 240/480 VOLT, 3 WIRE. SEE SHEETS LT-53A THROUGH LT-53D, LT-54 AND SPECIAL PROVISIONS FOR DETAILS. LIGHTING CONTROL CABINET SHALL BE INSTALLED ON A GROUND MOUNTED PLATFORM AS SHOWN ON SHEET LT-54. CONCRETE FOUNDATION, PAD AND CABINET PAINTED IN GREEN AS SHOWN ON LT-53 ARE NOT REQUIRED FOR TEMPORARY LIGHTING CONTROLLER. OPENINGS IN THE CABINEL SHALL BE WEATHERPROOF SEALED AT ALL TIMES.

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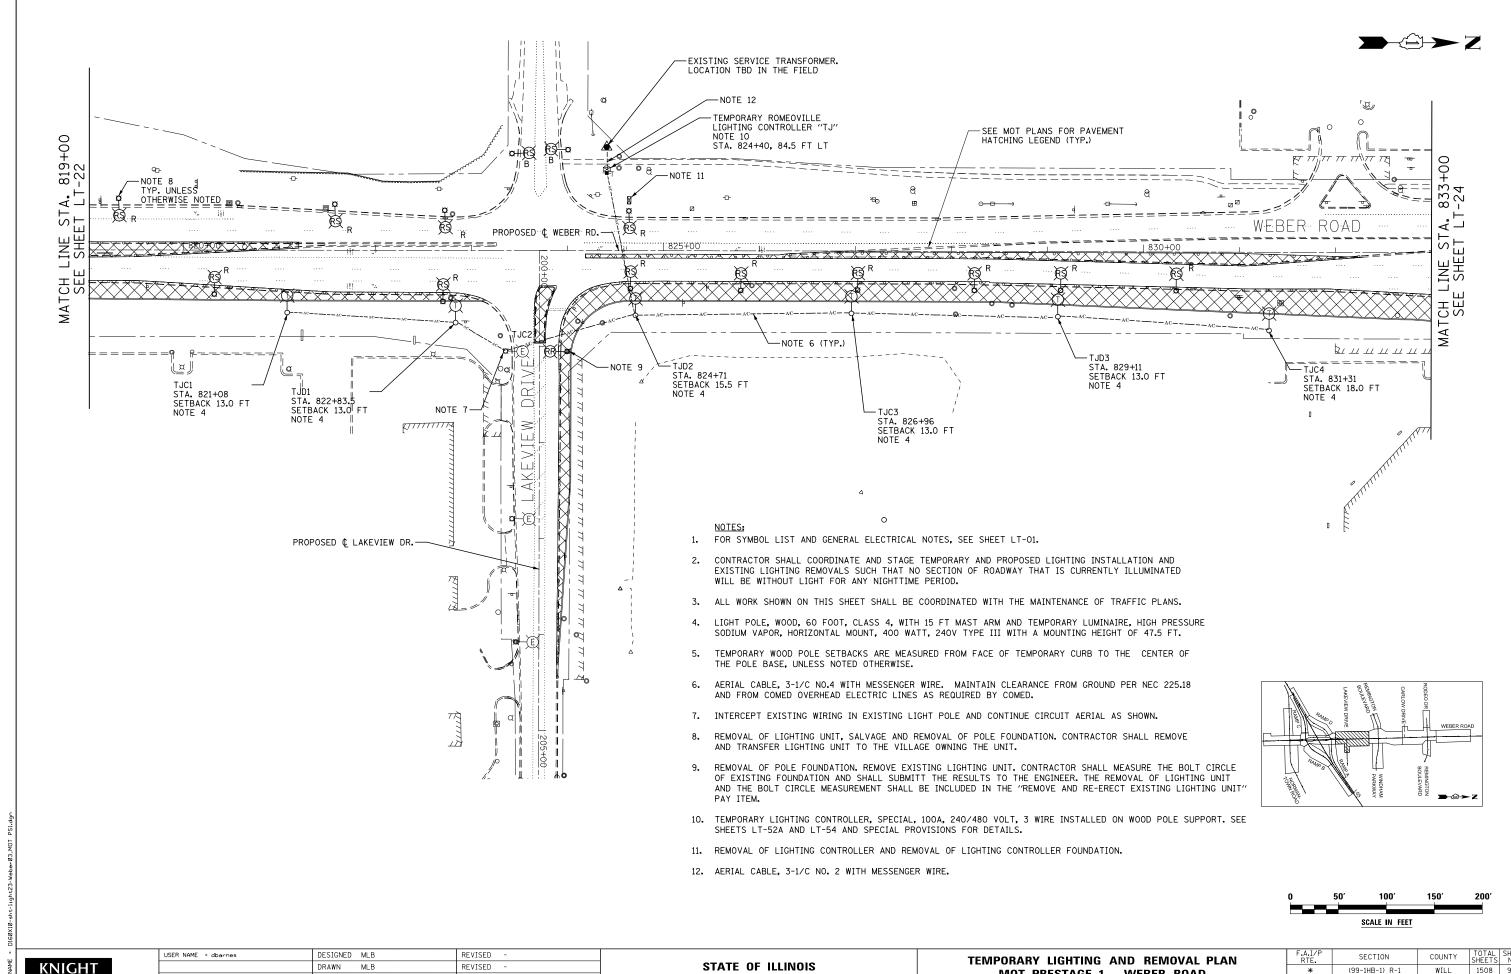


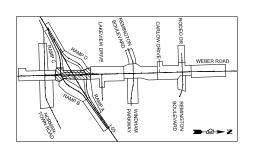
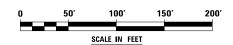
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F.A.I/P RTE.	SECTION	COUNTY	TOTAL SHEETS	SHE NO
*	(99-1HB-1) R-1	WILL	1508	94
	LT-22	CONTRACT	NO. 6	0X10
* FAI 55,	FAP 856 ILLINOIS FED.	AID PROJECT		




KNIGHT Engineers & Architects


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DEPARTMENT OF TRANSPORTATION

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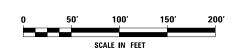
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*	(99-1HB-1) R-1		WIL	L	1508		950	
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- FOR SYMBOL LIST AND GENERAL ELECTRICAL NOTES, SEE SHEET LT-01.
- 2. CONTRACTOR SHALL COORDINATE AND STAGE TEMPORARY AND PROPOSED LIGHTING INSTALLATION AND EXISTING LIGHTING REMOVALS SUCH THAT NO SECTION OF ROADWAY THAT IS CURRENTLY ILLUMINATED WILL BE WITHOUT LIGHT FOR ANY NIGHTTIME PERIOD.
- 3. ALL WORK SHOWN ON THIS SHEET SHALL BE COORDINATED WITH THE MAINTENANCE OF TRAFFIC PLANS.
- 4. LIGHT POLE, WOOD, 60 FOOT, CLASS 4, WITH 15 FT MAST ARM AND TEMPORARY LUMINAIRE, HIGH PRESSURE SODIUM VAPOR, HORIZONTAL MOUNT, 400 WATT, 240V TYPE III WITH A MOUNTING HEIGHT OF 47.5 FT.
- 5. TEMPORARY WOOD POLE SETBACKS ARE MEASURED FROM FACE OF THE CURB TO THE CENTER OF THE POLE BASE, UNLESS NOTED OTHERWISE.
- 6. AERIAL CABLE, 3-1/C NO.4 WITH MESSENGER WIRE. MAINTAIN CLEARANCE FROM GROUND PER NEC 225.18 AND FROM COMED OVERHEAD ELECTRIC LINES AS REQUIRED BY COMED.

- 7. INTERCEPT EXISTING WIRING IN EXISTING LIGHT POLE AND CONTINUE CIRCUIT TO TEMPORARY LIGHT POLE.
- REMOVAL OF LIGHTING UNIT, SALVAGE AND REMOVAL OF POLE FOUNDATION. CONTRACTOR SHALL REMOVE AND TRANSFER LIGHTING UNIT TO THE VILLAGE OWNING THE UNIT.
- 9. REMOVAL OF POLE FOUNDATION. REMOVE EXISTING LIGHTING UNIT. CONTRACTOR SHALL MEASURE THE BOLT CIRCLE OF EXISTING FOUNDATION AND SHALL SUBMIT THE RESULTS TO THE ENGINEER. THE REMOVAL OF LIGHTING UNIT AND THE BOLT CIRCLE MEASUREMENT SHALL BE INCLUDED IN THE "REMOVE AND RE-ERECT EXISTING LIGHTING UNIT"
- 10. SEE "MODIFY EXISTING LIGHTING CONTROLLER" SPECIAL PROVISIONS FOR DETAILS REGARDING TEMPORARY CONNECTIONS.
- 11. CONTRACTOR SHALL REMOVE TEMPORARY LIGHTING ITEMS ONCE THEY ARE NO LONGER REQUIRED FOR MAINTENENCE OF TRAFFIC AND PERMANENT LIGHTING HAS BEEN ENERGIZED.




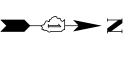
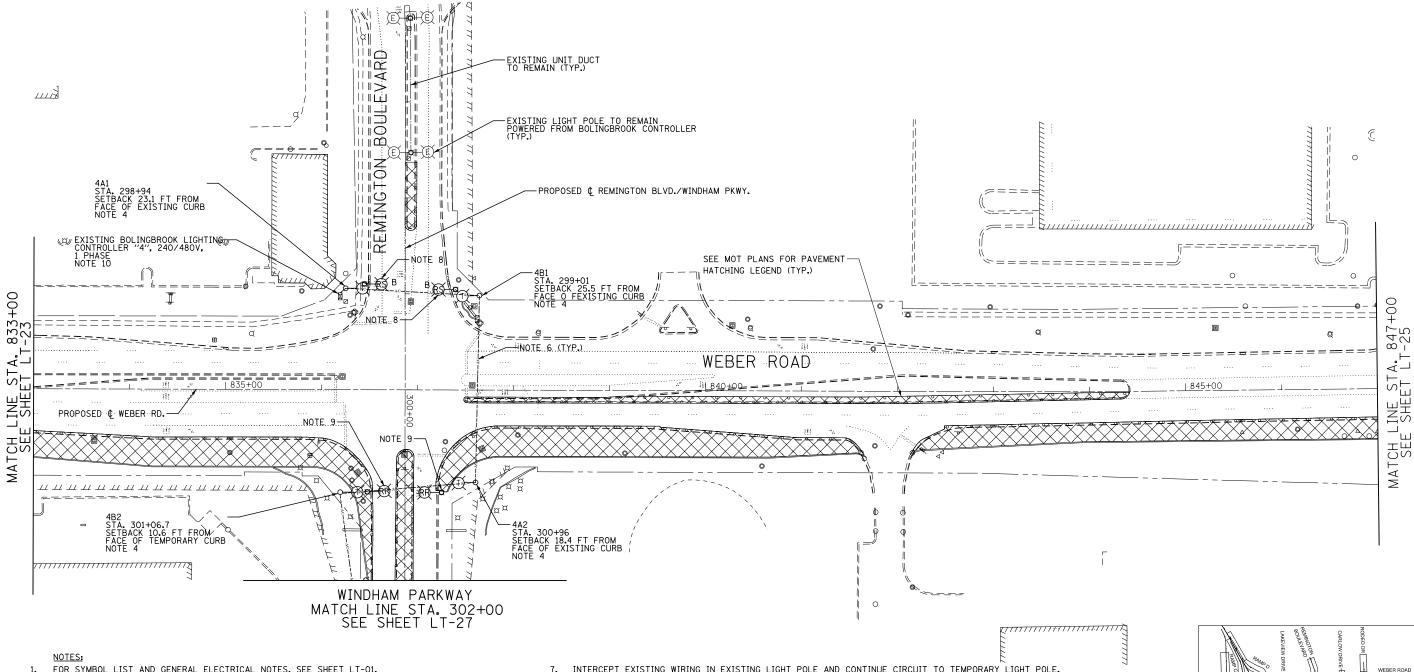
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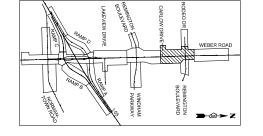
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*	(99-1HB-1) R	-1	WILL	1508	95
	LT-24		CONTRACT	NO. 6	0X10
* FAI 55,	FAP 856 ILLINOIS	FED. AI	D PROJECT		



- EXISTING LIGHTING REMOVALS SUCH THAT NO SECTION OF ROADWAY THAT IS CURRENTLY ILLUMINATED WILL BE WITHOUT LIGHT FOR ANY NIGHTTIME PERIOD.
- 3. ALL WORK SHOWN ON THIS SHEET SHALL BE COORDINATED WITH THE MAINTENANCE OF TRAFFIC PLANS.
- 4. LIGHT POLE, WOOD, 60 FOOT, CLASS 4, WITH 15 FT MAST ARM AND TEMPORARY LUMINAIRE, HIGH PRESSURE SODIUM VAPOR, HORIZONTAL MOUNT, 400 WATT, 240V TYPE III WITH A MOUNTING HEIGHT OF 47.5 FT.
- TEMPORARY WOOD POLE SETBACKS ARE MEASURED FROM EDGE OF PAVEMENT TO THE CENTER OF THE POLE BASE, UNLESS NOTED OTHERWISE.
- 6. AERIAL CABLE, 3-1/C NO.4 WITH MESSENGER WIRE. MAINTAIN CLEARANCE FROM GROUND PER NEC 225.18 AND FROM COMED OVERHEAD ELECTRIC LINES AS REQUIRED BY COMED.
- 7. INTERCEPT EXISTING WIRING IN EXISTING LIGHT POLE AND CONTINUE CIRCUIT TO TEMPORARY LIGHT POLE.
- 8. DISCONNECT "BOLINGBROOK GOLF CLUB" LIGHTED SIGN AND TRANSFER SIGN TO VILLAGE OF BOLINGBROOK. REMOVAL SHALL BE INCLUDED IN "REMOVE EXISTING STREET LIGHTING EQUIPMENT" PAY ITEM.
- 9. REMOVAL OF LIGHTING UNIT, SALVAGE AND REMOVAL OF POLE FOUNDATION. CONTRACTOR SHALL REMOVE AND TRANSFER LIGHTING UNIT TO THE VILLAGE OWNING THE UNIT.

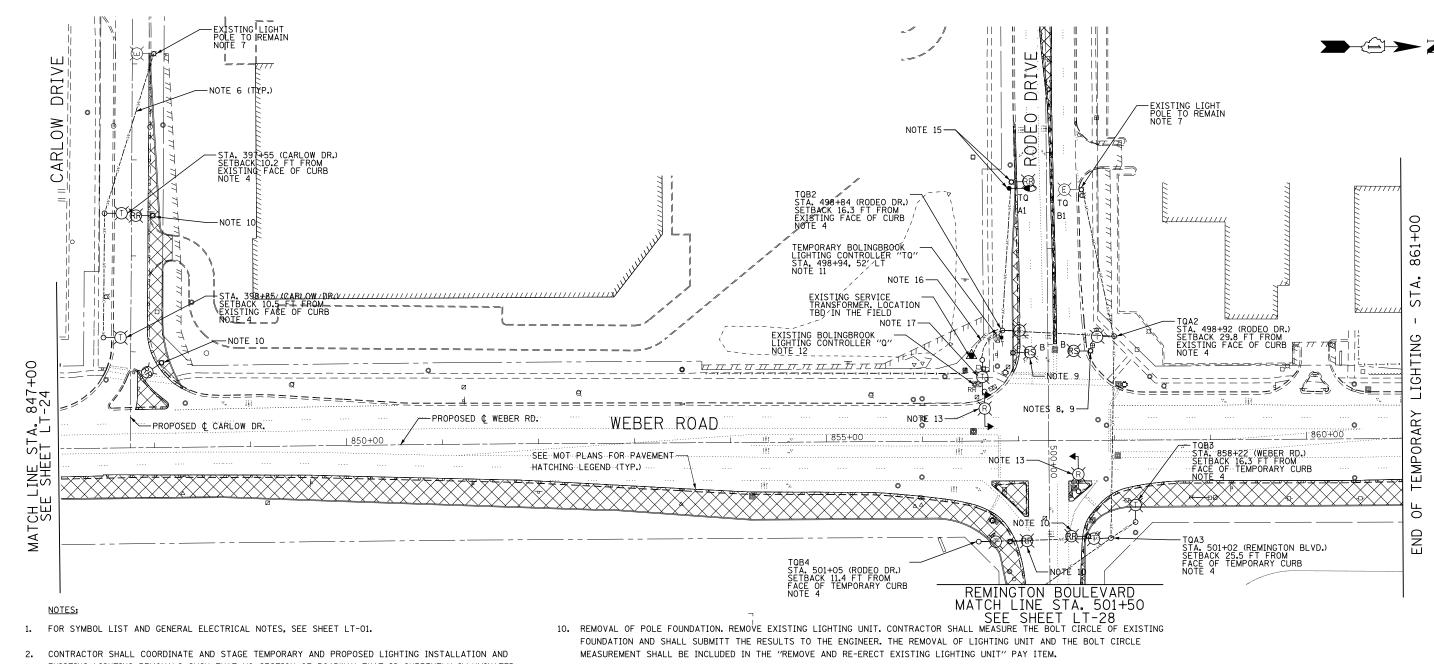- 11. TEMPORARY LIGHTING CONTROLLER, SPECIAL, 100A, 240/480 VOLT, 3 WIRE INSTALLED ON WOOD POLE SUPPORT. SEE SHEETS LT-52A AND LT-54 AND SPECIAL PROVISIONS FOR DETAILS.
- 12. REMOVE AND RELOCATE EXISTING LIGHTING CONTROLLER.
- 13. REMOVAL OF COMBINATION LIGHT POLE IS INCLUDED IN TRAFFIC SIGNAL WORK. SEE TRAFFIC SIGNAL SHEETS FOR DETAILS.
- 14. CONTRACTOR SHALL REMOVE ALL TEMPORARY LIGHTING ITEMS PRIOR TO THE END OF CONTRACT.
- 15. REMOVAL OF POLE FOUNDATION, LIGHT POLE FOUNDATION, 24" DIA., AND RELOCATE EXISTING LIGHTING UNIT. SEE PROPOSED PLANS FOR LIGHT POLE AND NEW POLE FOUNDATION LOCATION.
- 16. AERIAL CABLE, 3-1/C NO.2 WITH MESSENGER WIRE, SERVICE AERIAL CABLE SHALL BE INCLUDED IN THE COST OF "TEMPORARY LIGHTING CONTROLLER" PAY ITEM.
- TEMPORARY LIGHTING FOR INTERSECTION MOUNTED ON TRAFFIC SIGNAL POLE, WOOD POLE INSTALLED UNDER TRAFFIC SIGNAL PLANS. MAST ARM, STREET LIGHTING, 15', TEMPORARY LUMINAIRE, HIGH PRESSURE SODIUM VAPOR, HORIZONTAL MOUNT, 400 WATT (240V, 47.5' M.H., TYPE III) AND WIRING PROVIDED BY LIGHTING CONTRACTOR.
- 18. CONTRACTOR SHALL REMOVE TEMPORARY LIGHTING ITEMS ONCE THEY ARE NO LONGER REQUIRED FOR MAINTENENCE OF TRAFFIC AND PERMANENT LIGHTING HAS BEEN ENERGIZED.




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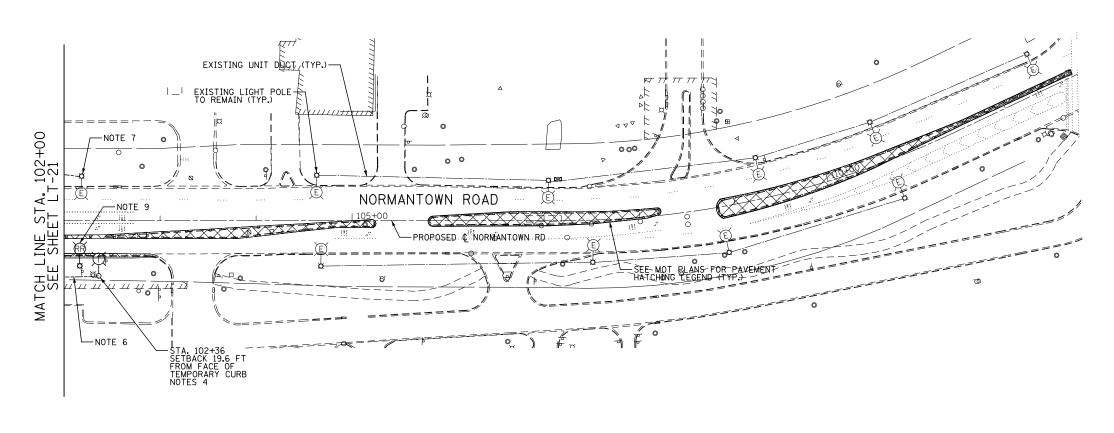
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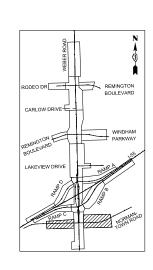
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*	(99-1HB-1) R-1			WILL	1508	952
	LT-25		CONTRACT	NO. 6	0X10	
* FAI 55,	FAP 856	ILLINOIS	FED. A	ID PROJECT		



- 1. FOR SYMBOL LIST AND GENERAL ELECTRICAL NOTES, SEE SHEET LT-01.
- CONTRACTOR SHALL COORDINATE AND STAGE TEMPORARY AND PROPOSED LIGHTING INSTALLATION AND EXISTING LIGHTING REMOVALS SUCH THAT NO SECTION OF ROADWAY THAT IS CURRENTLY ILLUMINATED WILL BE WITHOUT LIGHT FOR ANY NIGHTTIME PERIOD.
- 3. ALL WORK SHOWN ON THIS SHEET SHALL BE COORDINATED WITH THE MAINTENANCE OF TRAFFIC PLANS.
- 4. LIGHT POLE, WOOD, 60 FOOT, CLASS 4, WITH 15 FT MAST ARM AND TEMPORARY LUMINAIRE, HIGH PRESSURE SODIUM VAPOR, HORIZONTAL MOUNT, 400 WATT, 240V TYPE III WITH A MOUNTING HEIGHT OF 47.5 FT.
- 5. TEMPORARY WOOD POLE SETBACKS ARE MEASURED FROM EDGE OF PAVEMENT TO THE CENTER OF THE POLE BASE, UNLESS NOTED OTHERWISE.
- 6. AERIAL CABLE, 3-1/C NO.4 WITH MESSENGER WIRE. MAINTAIN CLEARANCE FROM GROUND PER NEC 225.18 AND FROM COMED OVERHEAD ELECTRIC LINES AS REQUIRED BY COMED.
- 7. INTERCEPT EXISTING WIRING IN EXISTING LIGHT POLE AND CONTINUE CIRCUIT TO TEMPORARY LIGHT POLE.
- 8. REMOVAL OF POLE FOUNDATION AND RELOCATE EXISTING LIGHTING UNIT. SEE PROPOSED PLANS FOR LIGHT POLE AND NEW POLE FOUNDATION LOCATION.
- 9. REMOVAL OF POLE FOUNDATION. REMOVE EXISTING LIGHTING UNIT. CONTRACTOR SHALL MEASURE THE BOLT CIRCLE OF EXISTING FOUNDATION AND SHALL SUBMIT THE RESULTS TO THE ENGINEER, THE REMOVAL OF LIGHTING UNIT AND THE BOLT CIRCLE MEASUREMENT SHALL BE INCLUDED IN "REMOVE AND RE-ERECT EXISTING LIGHTING UNIT" PAY ITEM.



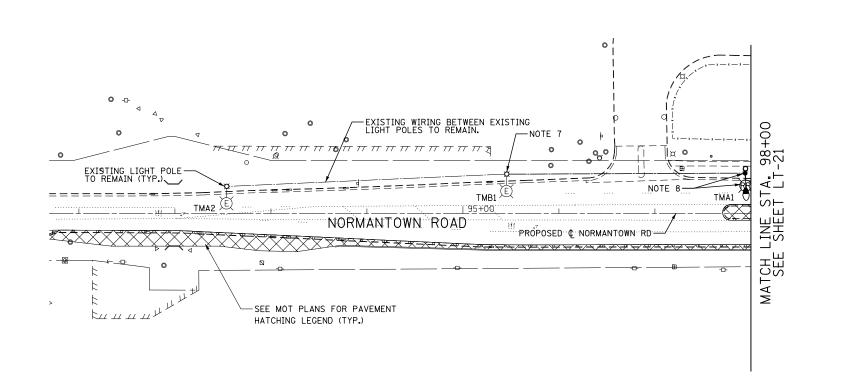

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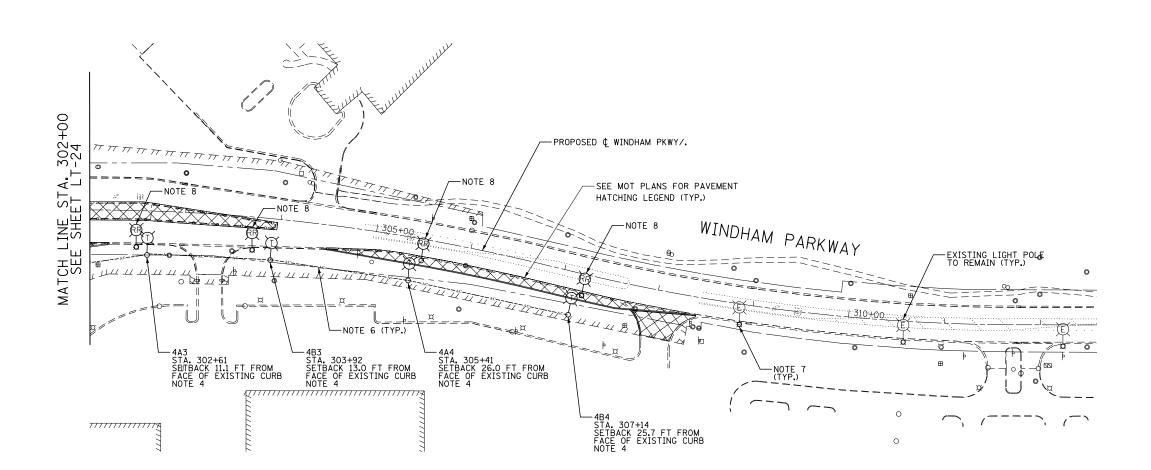
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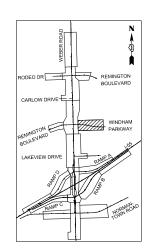
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* FAI 55,	FAP	856	ILLINOIS	FED.	ΑI	D PROJECT				



- 1. FOR SYMBOL LIST AND GENERAL ELECTRICAL NOTES, SEE SHEET LT-01.
- CONTRACTOR SHALL COORDINATE AND STAGE TEMPORARY AND PROPOSED LIGHTING INSTALLATION AND EXISTING LIGHTING REMOVALS SUCH THAT NO SECTION OF ROADWAY THAT IS CURRENTLY ILLUMINATED WILL BE WITHOUT LIGHT FOR ANY NIGHTTIME PERIOD.
- 3. ALL WORK SHOWN ON THIS SHEET SHALL BE COORDINATED WITH THE MAINTENANCE OF TRAFFIC PLANS.
- 4. LIGHT POLE, WOOD, 60 FOOT, CLASS 4, WITH 15 FT MAST ARM AND TEMPORARY LUMINAIRE, HIGH PRESSURE SODIUM VAPOR, HORIZONTAL MOUNT, 400 WATT, 240V TYPE III WITH A MOUNTING HEIGHT OF 47.5 FT.
- 5. TEMPORARY WOOD POLE SETBACKS ARE MEASURED FROM EDGE OF PAVEMENT TO THE CENTER OF THE POLE BASE, UNLESS NOTED OTHERWISE.
- 6. AERIAL CABLE, 3-1/C NO.4 WITH MESSENGER WIRE. MAINTAIN CLEARANCE FROM GROUND PER NEC 225.18 AND FROM COMED OVERHEAD ELECTRIC LINES AS REQUIRED BY COMED.
- 7. EXISTING LIGHT POLE TO REMAIN.
- 8. REMOVAL OF POLE FOUNDATION, REMOVE EXISTING LIGHTING UNIT. CONTRACTOR SHALL MEASURE THE BOLT CIRCLE OF EXISTING FOUNDATION AND SHALL SUBMITT THE RESULTS TO THE ENGINEER, THE REMOVAL OF LIGHTING UNIT AND THE BOLT CIRCLE MEASUREMENT SHALL BE INCLUDED IN THE "REMOVE AND RE-ERECT EXISTING LIGHTING UNIT" PAY ITEM.
- 9. CONTRACTOR SHALL REMOVE TEMPORARY LIGHTING ITEMS ONCE THEY ARE NO LONGER REQUIRED FOR MAINTENENCE OF TRAFFIC AND PERMANENT LIGHTING HAS BEEN ENERGIZED.



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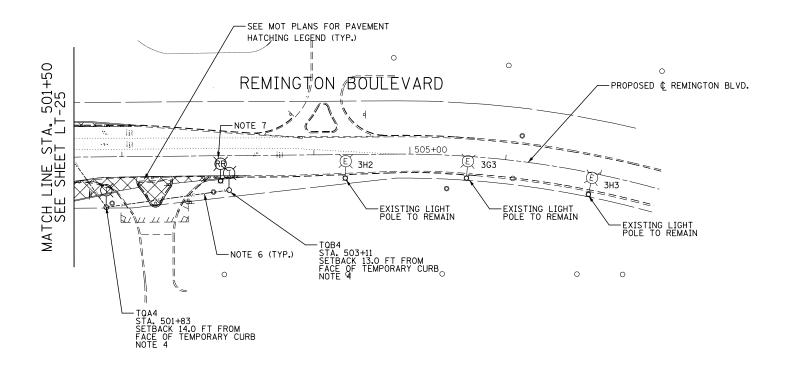
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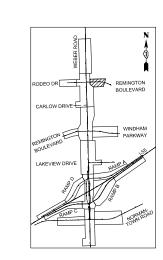
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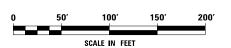
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* FAI 55,	FAP 856	ILLINOIS	FED.	ΑII	PROJECT		





- 1. FOR SYMBOL LIST AND GENERAL ELECTRICAL NOTES, SEE SHEET LT-01.
- 2. CONTRACTOR SHALL COORDINATE AND STAGE TEMPORARY AND PROPOSED LIGHTING INSTALLATION AND EXISTING LIGHTING REMOVALS SUCH THAT NO SECTION OF ROADWAY THAT IS CURRENTLY ILLUMINATED WILL BE WITHOUT LIGHT FOR ANY NIGHTTIME PERIOD.
- 3. ALL WORK SHOWN ON THIS SHEET SHALL BE COORDINATED WITH THE MAINTENANCE OF TRAFFIC PLANS.
- 4. LIGHT POLE, WOOD, 60 FOOT, CLASS 4, WITH 15 FT MAST ARM AND TEMPORARY LUMINAIRE, HIGH PRESSURE SODIUM VAPOR, HORIZONTAL MOUNT, 400 WATT, 240V TYPE III WITH A MOUNTING HEIGHT OF 47.5 FT.
- 5. TEMPORARY WOOD POLE SETBACKS ARE MEASURED FROM EDGE OF PAVEMENT TO THE CENTER OF THE POLE BASE, UNLESS NOTED OTHERWISE.
- 6. AERIAL CABLE, 3-1/C NO.4 WITH MESSENGER WIRE. MAINTAIN CLEARANCE FROM GROUND PER NEC 225.18 AND FROM COMED OVERHEAD ELECTRIC LINES AS REQUIRED BY COMED.
- 7. REMOVAL OF POLE FOUNDATION, REMOVE EXISTING LIGHTING UNIT, CONTRACTOR SHALL MEASURE THE BOLT CIRCLE OF EXISTING FOUNDATION AND SHALL SUBMITT THE RESULTS TO THE ENGINEER. THE REMOVAL OF LIGHTING UNIT AND THE BOLT CIRCLE MEASUREMENT SHALL BE INCLUDED IN THE "REMOVE AND RE-ERECT EXISTING LIGHTING UNIT" PAY ITEM.









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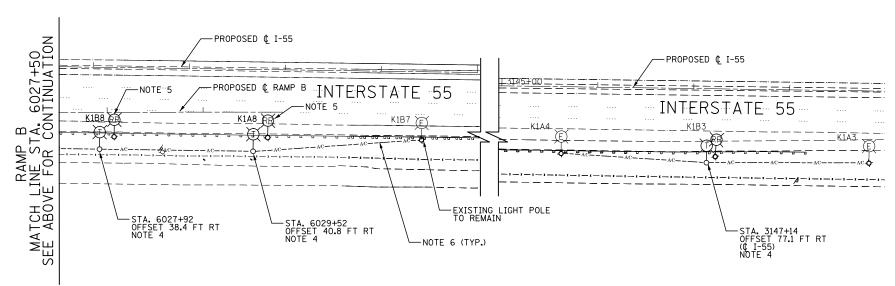


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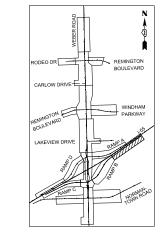
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	E. SECTION (99-1HB-1) R-1 LT-30 55, FAP 856 ILLINOIS FED.		CONTRACT	NO. 6	0X10
* FAI 55,	FAP 856 ILLINOIS	FED. AID	PROJECT		

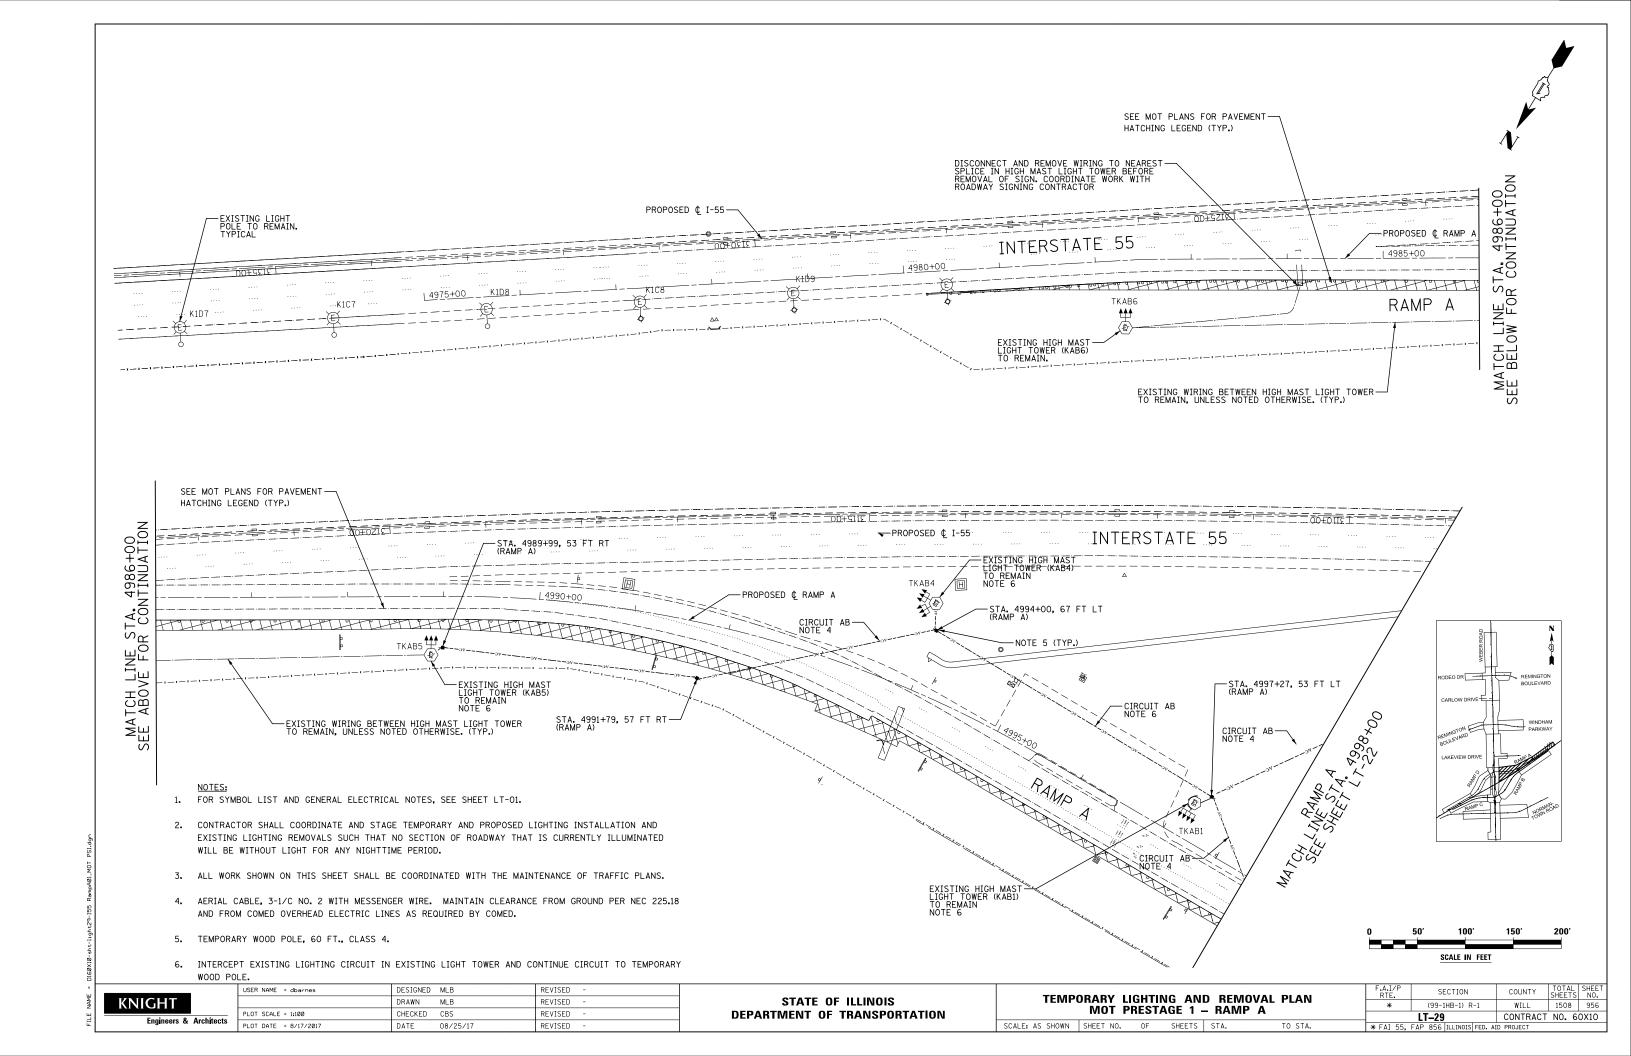

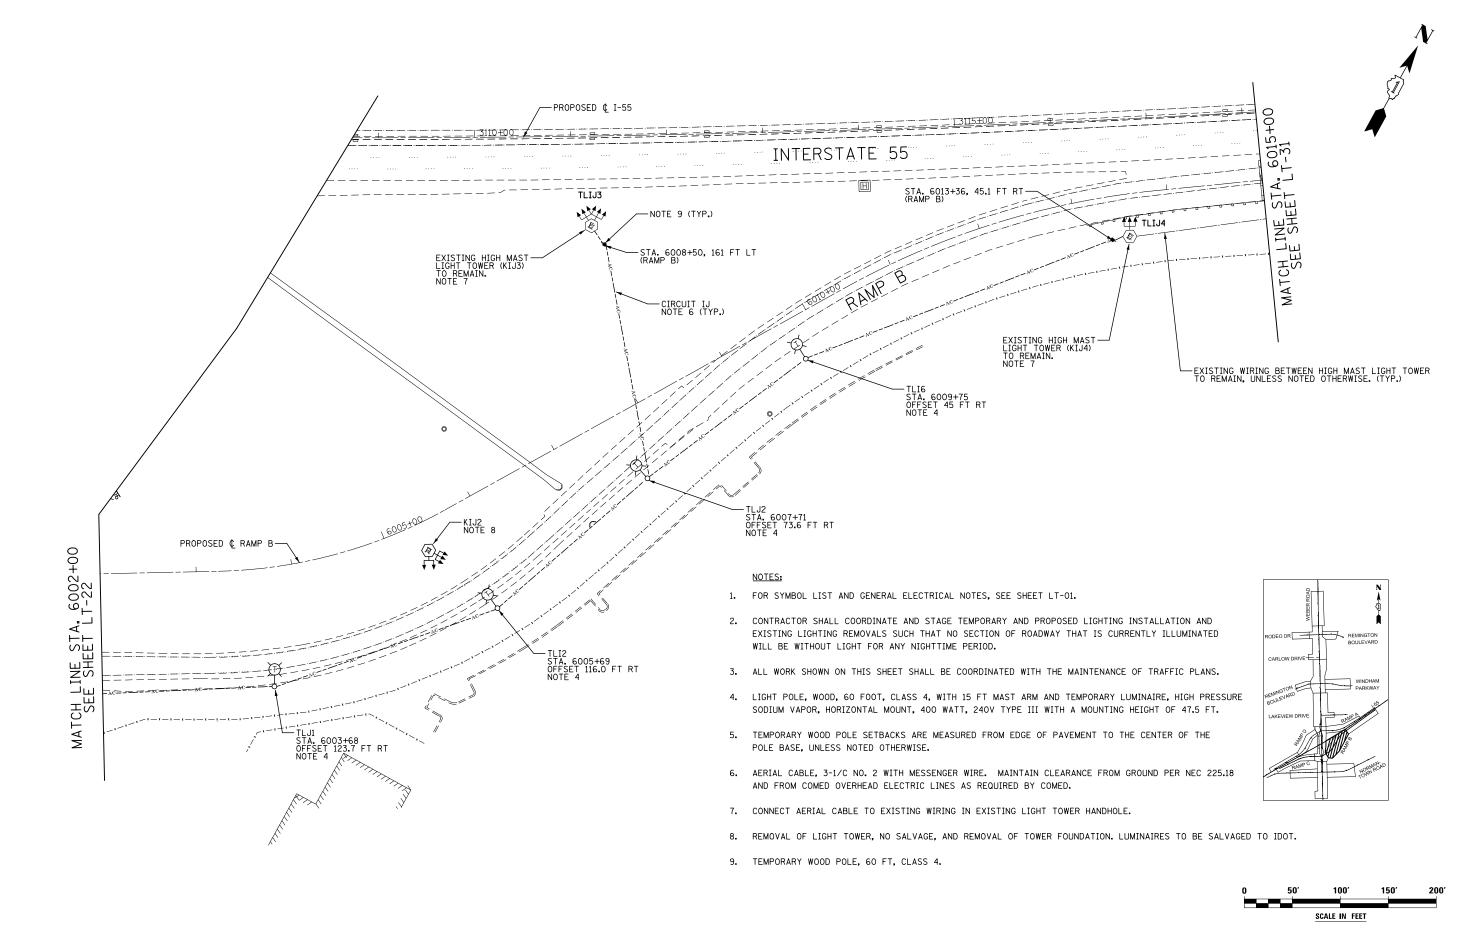- NOTES:
- 1. FOR SYMBOL LIST AND GENERAL ELECTRICAL NOTES, SEE SHEET LT-01.
- CONTRACTOR SHALL COORDINATE AND STAGE TEMPORARY AND PROPOSED LIGHTING INSTALLATION AND EXISTING LIGHTING REMOVALS SUCH THAT NO SECTION OF ROADWAY THAT IS CURRENTLY ILLUMINATED WILL BE WITHOUT LIGHT FOR ANY NIGHTTIME PERIOD.
- 3. ALL WORK SHOWN ON THIS SHEET SHALL BE COORDINATED WITH THE MAINTENANCE OF TRAFFIC PLANS.
- 4. LIGHT POLE, WOOD, 60 FOOT, CLASS 4, WITH 15 FT MAST ARM AND TEMPORARY LUMINAIRE, HIGH PRESSURE SODIUM VAPOR, HORIZONTAL MOUNT, 400 WATT, 240V TYPE III WITH A MOUNTING HEIGHT OF 47.5 FT.
- 5. REMOVAL OF POLE FOUNDATION, REMOVE EXISTING LIGHTING UNIT. THE REMOVAL OF LIGHTING UNIT SHALL BE INCLUDED IN THE "REMOVE AND RE-ERECT EXISTING LIGHTING UNIT" PAY ITEM.

- 6. AERIAL CABLE, 3-1/C NO.2 WITH MESSENGER WIRE. MAINTAIN CLEARANCE FROM GROUND PER NEC 225.18 AND FROM COMED OVERHEAD ELECTRIC LINES AS REQUIRED BY COMED.
- 7. TEMPORARY WOOD POLE STATION/OFFSET ARE MEASURED FROM & RAMP B, UNLESS OTHERWISE NOTED.
- 8. REMOVAL OF POLE FOUNDATION. REMOVE EXISTING LIGHTING UNIT, SALVAGE
- 9. CONTRACTOR SHALL REMOVE TEMPORARY LIGHTING ITEMS ONCE THEY ARE NO LONGER REQUIRED FOR MAINTENENCE OF TRAFFIC AND PERMANENT LIGHTING HAS BEEN ENERGIZED.



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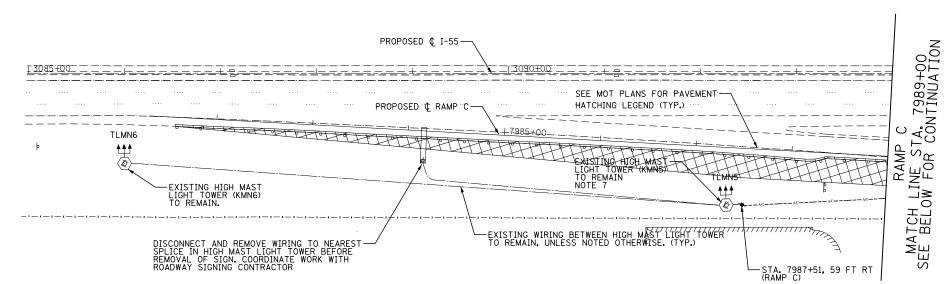
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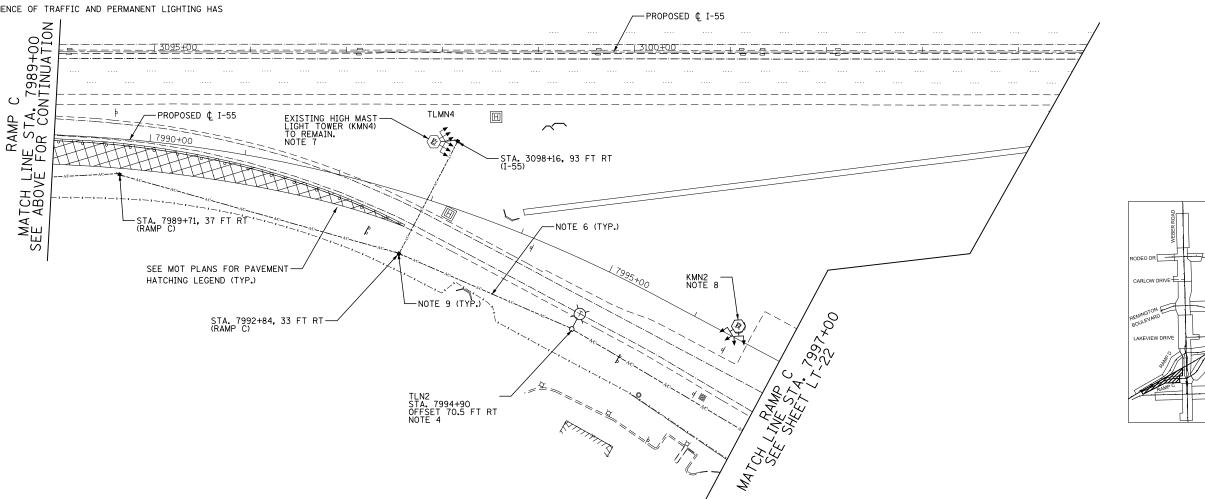
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* FAI 55,	FAP 856 ILLINOIS F	ED. AI	D PROJECT		

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- 1. FOR SYMBOL LIST AND GENERAL ELECTRICAL NOTES, SEE SHEET LT-01.
- 2. CONTRACTOR SHALL COORDINATE AND STAGE TEMPORARY AND PROPOSED LIGHTING INSTALLATION AND EXISTING LIGHTING REMOVALS SUCH THAT NO SECTION OF ROADWAY THAT IS CURRENTLY ILLUMINATED WILL BE WITHOUT LIGHT FOR ANY NIGHTTIME PERIOD.
- ALL WORK SHOWN ON THIS SHEET SHALL BE COORDINATED WITH THE MAINTENANCE OF TRAFFIC PLANS.
- 4. LIGHT POLE, WOOD, 60 FOOT, CLASS 4, WITH 15 FT MAST ARM AND TEMPORARY LUMINAIRE, HIGH PRESSURE SODIUM VAPOR, HORIZONTAL MOUNT, 400 WATT, 240V TYPE III WITH A MOUNTING HEIGHT OF 47.5 FT.
- 5. TEMPORARY WOOD POLE SETBACKS ARE MEASURED FROM EDGE OF PAVEMENT TO THE CENTER OF THE POLE BASE, UNLESS NOTED OTHERWISE.
- 6. AERIAL CABLE, 3-1/C NO.2 WITH MESSENGER WIRE. MAINTAIN CLEARANCE FROM GROUND PER NEC 225.18 AND FROM COMED OVERHEAD ELECTRIC LINES AS REQUIRED BY COMED.
- 7. INTERCEPT EXISTING WIRING IN EXISTING TOWER HAND HOLE AND CONTINUE CIRCUIT TO TEMPORARY LIGHT POLE.
- 8. REMOVAL OF LIGHT TOWER, NO SALVAGE, AND REMOVAL OF TOWER FOUNDATION. LUMINAIRES TO BE SALVAGED TO IDOT.
- 9. TEMPORARY WOOD POLE, 60 FT, CLASS 4.

10. CONTRACTOR SHALL REMOVE TEMPORARY LIGHTING ITEMS ONCE THEY ARE NO LONGER REQUIRED FOR MAINTENENCE OF TRAFFIC AND PERMANENT LIGHTING HAS BEEN ENERGIZED.






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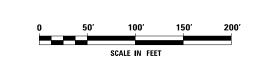
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*	(99-1HB-1) R-1	WILL	1508	959	
	LT-32	CONTRACT	NO. 6	0X10	
* FAI 55,	FAP 856 ILLINOIS FED. A	ID PROJECT			



- 2. CONTRACTOR SHALL COORDINATE AND STAGE TEMPORARY AND PROPOSED LIGHTING INSTALLATION AND EXISTING LIGHTING REMOVALS SUCH THAT NO SECTION OF ROADWAY THAT IS CURRENTLY ILLUMINATED
- 4. LIGHT POLE, WOOD, 60 FOOT, CLASS 4, WITH 15 FT MAST ARM AND TEMPORARY LUMINAIRE, HIGH PRESSURE SODIUM VAPOR, HORIZONTAL MOUNT, 400 WATT, 240V TYPE III WITH A MOUNTING HEIGHT OF 47.5 FT.
- 5. TEMPORARY WOOD POLE OFFSET IS MEASURED FROM & RAMP D, UNLESS NOTED OTHERWISE.
- 6. AERIAL CABLE, 3-1/C NO.2 WITH MESSENGER WIRE. MAINTAIN CLEARANCE FROM GROUND PER NEC 225.18 AND FROM COMED OVERHEAD ELECTRIC LINES AS REQUIRED BY COMED.
- 7. CONNECT AERIAL CABLE TO EXISTING WIRING IN EXISTING LIGHT TOWER HANDHOLE.
- 8. REMOVAL OF LIGHT TOWER, NO SALVAGE, AND REMOVAL OF TOWER FOUNDATION, LUMINAIRES TO BE SALVAGED TO IDOT.
- 9. TEMPORARY WOOD POLE, 60 FT, CLASS 4.



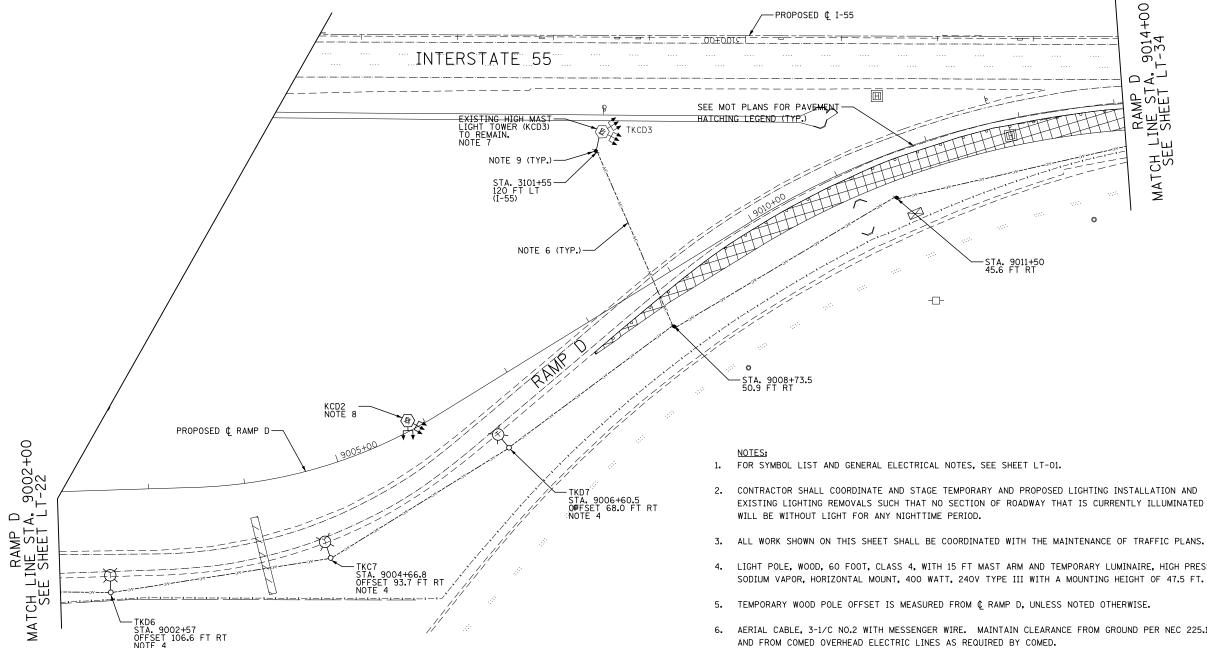

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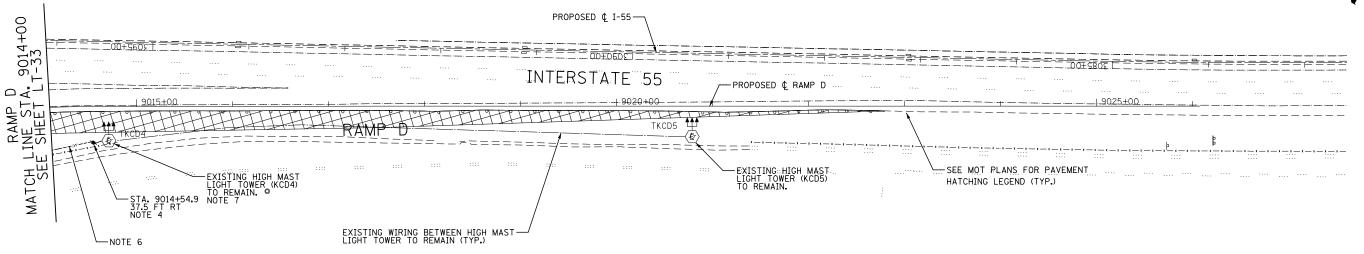
-TKD6 STA. 9002+57 OFFSET 106.6 FT RT NOTE 4

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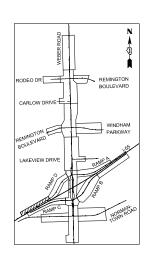
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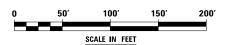
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*	(99-1HB-1) R-1				WILL	1508	
LT-33					CONTRACT	NO. 6	OX1
* FAI 55,	FAP 856	ILLINOIS	FED.	AID	PROJECT		





- 1. FOR SYMBOL LIST AND GENERAL ELECTRICAL NOTES, SEE SHEET LT-01.
- 2. CONTRACTOR SHALL COORDINATE AND STAGE TEMPORARY AND PROPOSED LIGHTING INSTALLATION AND EXISTING LIGHTING REMOVALS SUCH THAT NO SECTION OF ROADWAY THAT IS CURRENTLY ILLUMINATED WILL BE WITHOUT LIGHT FOR ANY NIGHTTIME PERIOD.
- 3. ALL WORK SHOWN ON THIS SHEET SHALL BE COORDINATED WITH THE MAINTENANCE OF TRAFFIC PLANS.
- 4. TEMPORARY WOOD POLE, 60 FT, CLASS 4.
- 5. TEMPORARY WOOD POLE OFFSET IS MEASURED FROM RAMP D ¢ TO THE CENTER OF THE POLE BASE, UNIESS NOTED OTHERWISE.
- 6. AERIAL CABLE, 3-1/C NO.2 WITH MESSENGER WIRE. MAINTAIN CLEARANCE FROM GROUND PER NEC 225.18 AND FROM COMED OVERHEAD ELECTRIC LINES AS REQUIRED BY COMED.
- 7. CONNECT AERIAL CABLE TO EXISTING WIRING IN EXISTING LIGHT TOWER HANDHOLE.
- 8. CONTRACTOR SHALL REMOVE TEMPORARY LIGHTING ITEMS ONCE THEY ARE NO LONGER REQUIRED FOR MAINTENENCE OF TRAFFIC AND PERMANENT LIGHTING HAS BEEN ENERGIZED.








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* (99-1HB-1) R-1			WILL	1508	961	
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* FAI 55,	FAP 856	ILLINOIS	FED. A	ID PROJECT		

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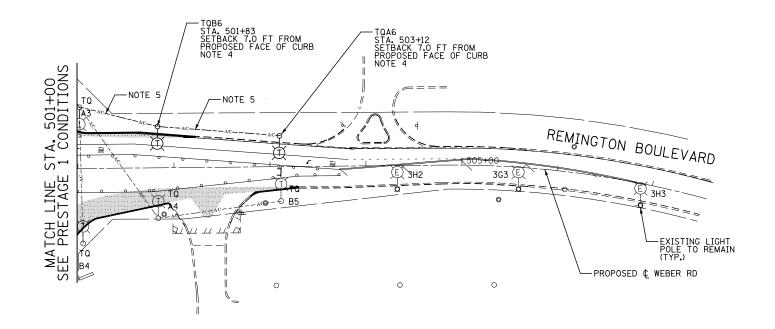
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DEPARTMENT OF TRANSPORTATION


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	MOT ST	AGE	1A – V	VEBER	ROAD
SCALE: AS SHOWN	SHEET NO.	OF	SHEETS	STA.	TO STA.

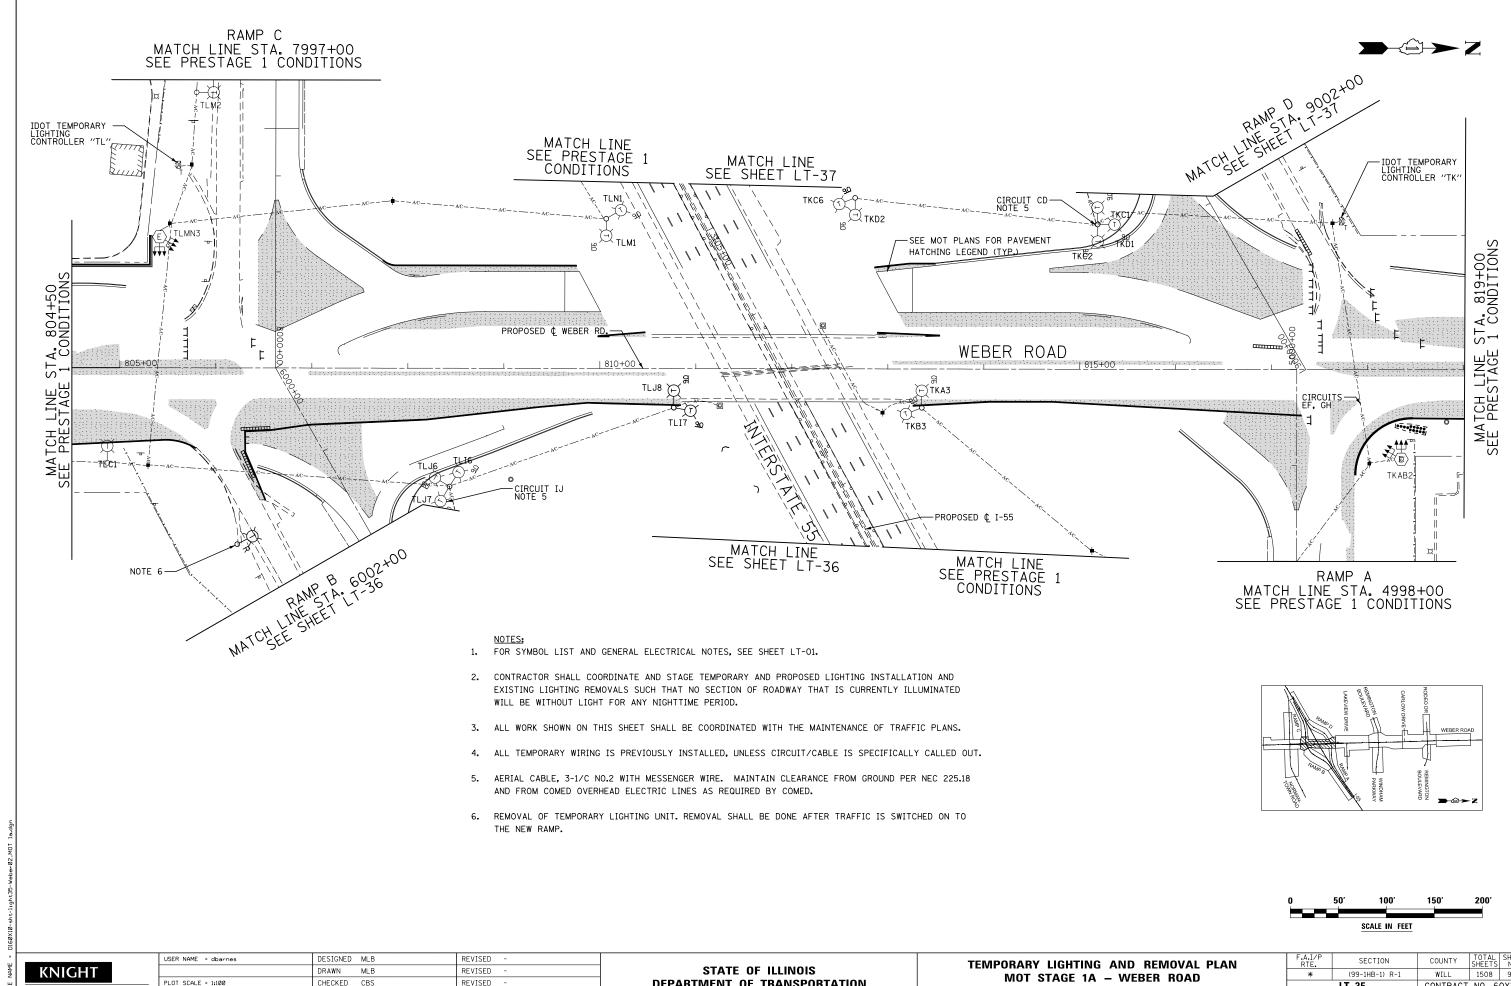1508 962 CONTRACT NO. 60X10 LT-35





- 1. FOR SYMBOL LIST AND GENERAL ELECTRICAL NOTES, SEE SHEET LT-01.
- 2. CONTRACTOR SHALL COORDINATE AND STAGE TEMPORARY AND PROPOSED LIGHTING INSTALLATION AND EXISTING LIGHTING REMOVALS SUCH THAT NO SECTION OF ROADWAY THAT IS CURRENTLY ILLUMINATED WILL BE WITHOUT LIGHT FOR ANY NIGHTTIME PERIOD.
- 3. ALL WORK SHOWN ON THIS SHEET SHALL BE COORDINATED WITH THE MAINTENANCE OF TRAFFIC PLANS.
- 4. LIGHT POLE, WOOD, 60 FOOT, CLASS 4, WITH 15 FT MAST ARM AND TEMPORARY LUMINAIRE, HIGH PRESSURE SODIUM VAPOR, HORIZONTAL MOUNT, 400 WATT, 240V TYPE III WITH A MOUNTING HEIGHT OF 47.5 FT.
- 5. AERIAL CABLE, 3-1/C NO.4 WITH MESSENGER WIRE. MAINTAIN CLEARANCE FROM GROUND PER NEC 225.18 AND FROM COMED OVERHEAD ELECTRIC LINES AS REQUIRED BY COMED.
- 6. CONTRACTOR SHALL REMOVE ALL TEMPORARY LIGHTING ITEMS PRIOR TO THE END OF CONTRACT.
- 7. ALL TEMPORARY WIRING IS PREVIOUSLY INSTALLED, UNLESS CIRCUIT/CABLE IS SPECIFICALLY CALLED OUT.
- 8. CONTRACTOR SHALL REMOVE TEMPORARY LIGHTING ITEMS ONCE THEY ARE NO LONGER REQUIRED FOR MAINTENENCE OF TRAFFIC AND PERMANENT LIGHTING HAS BEEN ENERGIZED.

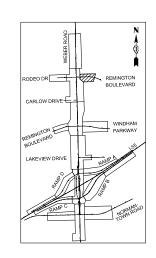


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F.A.I. RTE			SECTION				COUNTY	TOTAL SHEETS	SHEE NO.
*			(99-1HB-1) R-1				WILL	1508	963
		L1	-36				CONTRACT	NO. 6	0X10
* FAI	55,	FAP	856	ILLINOIS	FED.	AID	PROJECT		



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F.A.I/P RTE.	SECTION	COUNTY	TOTAL SHEETS	SHEE NO.
*	(99-1HB-1) R-1	WILL	1508	964
	LT-37	CONTRACT	NO. 6	0X10
* FAI 55,	FAP 856 ILLINOIS FED. A	ID PROJECT		


MATCH LINE STA, 9014+00 SEE PRESTAGE 1 CONDITIONS TKB1 STA. 9006+63 OFFSET 44.5 FT LT NOTE 4 ---TKA1 -STA. 9004+74 OFFSET 46.2 FT LT NOTE 4 CIRCUIT AB-NOTE 6 PROPOSED & RAMP D 9002+00 T-35 1. FOR SYMBOL LIST AND GENERAL ELECTRICAL NOTES, SEE SHEET LT-01. 2. CONTRACTOR SHALL COORDINATE AND STAGE TEMPORARY AND PROPOSED LIGHTING INSTALLATION AND EXISTING LIGHTING REMOVALS SUCH THAT NO SECTION OF ROADWAY THAT IS CURRENTLY ILLUMINATED WILL BE WITHOUT LIGHT FOR ANY NIGHTTIME PERIOD. ٥٠,٦ RAMP | MATCH LINE STA SEE SHEET 3. ALL WORK SHOWN ON THIS SHEET SHALL BE COORDINATED WITH THE MAINTENANCE OF TRAFFIC PLANS. 4. LIGHT POLE, WOOD, 60 FOOT, CLASS 4, WITH 15 FT MAST ARM AND TEMPORARY LUMINAIRE, HIGH PRESSURE SODIUM VAPOR, HORIZONTAL MOUNT, 400 WATT, 240V TYPE III WITH A MOUNTING HEIGHT OF 47.5 FT. 5. TEMPORARY WOOD POLE OFFSETS ARE MEASURED FROM & RAMP D TO THE CENTER OF THE POLE BASE, UNLESS NOTED OTHERWISE. 6. AERIAL CABLE, 3-1/C NO.2 WITH MESSENGER WIRE. MAINTAIN CLEARANCE FROM GROUND PER NEC 225.18 AND FROM COMED OVERHEAD ELECTRIC LINES AS REQUIRED BY COMED. 7. REMOVAL OF TEMPORARY LIGHTING UNIT. REMOVAL OF LIGHTING UNITS SHALL BE DONE AFTER TRAFFIC IS SWITCHED ON TO NEW RAMP. 8. ALL TEMPORARY WIRING IS PREVIOUSLY INSTALLED, UNLESS CIRCUIT/CABLE IS SPECIFICALLY CALLED OUT. 9. CONTRACTOR SHALL REMOVE TEMPORARY LIGHTING ITEMS ONCE THEY ARE NO LONGER REQUIRED FOR MAINTENENCE OF TRAFFIC AND PERMANENT LIGHTING HAS BEEN ENERGIZED. SCALE IN FEET

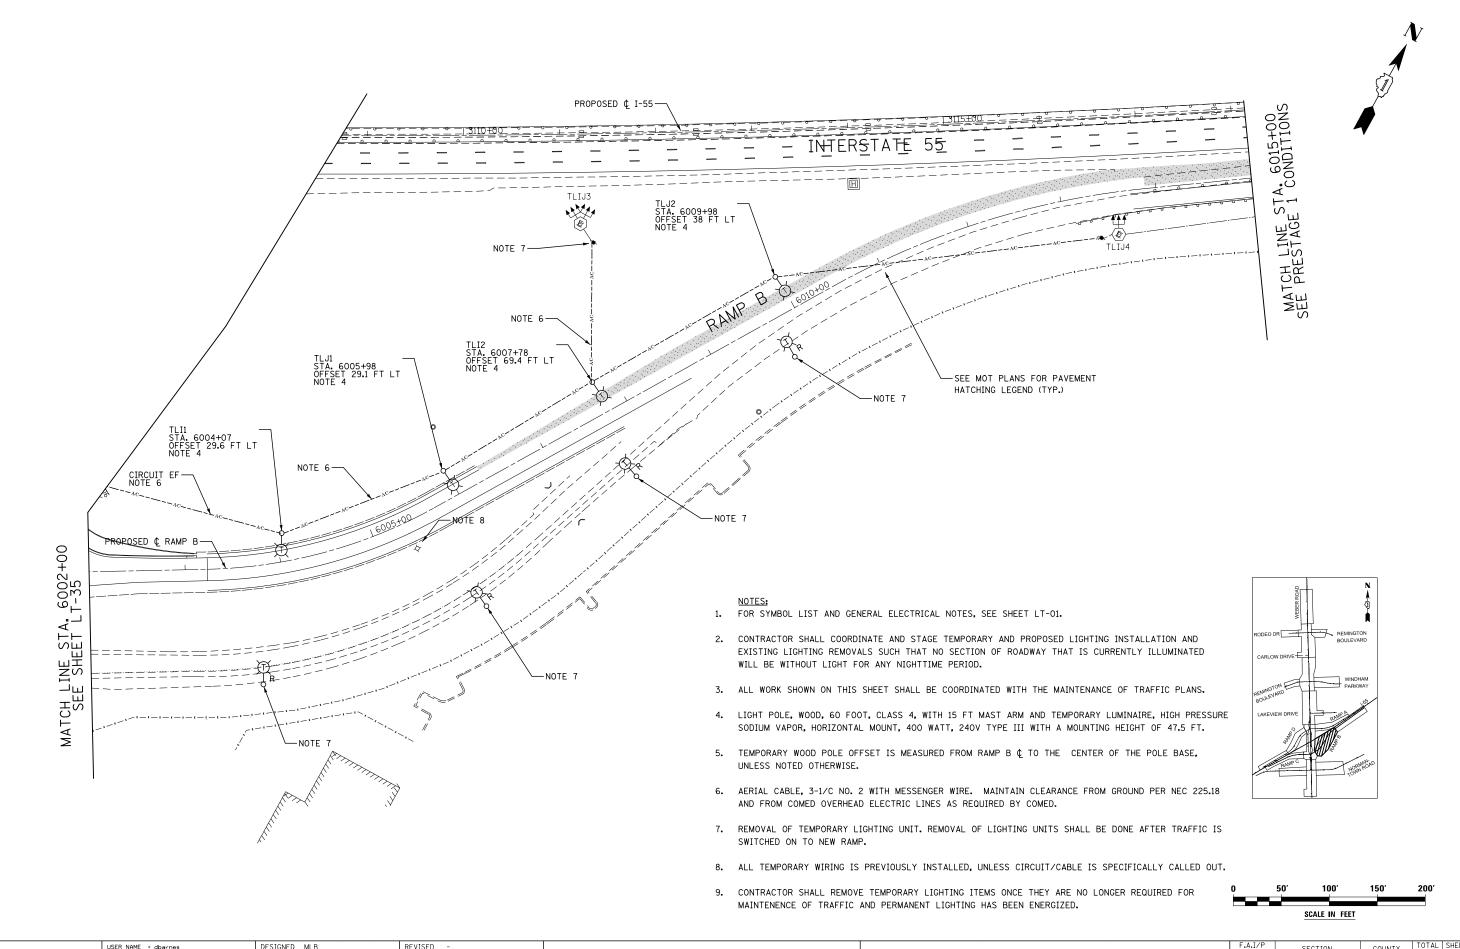
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Engineers &	Architects

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SCALE: AS SHOWN	SHEET NO.	0F	SHEETS	STA.	TO STA.


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*	(99-1	HB-1) R-1		WILL	1508	965
	LT-38			CONTRACT	NO. 6	0X10
* FAI 55,	FAP 856	ILLINOIS	FED. A	ID PROJECT		




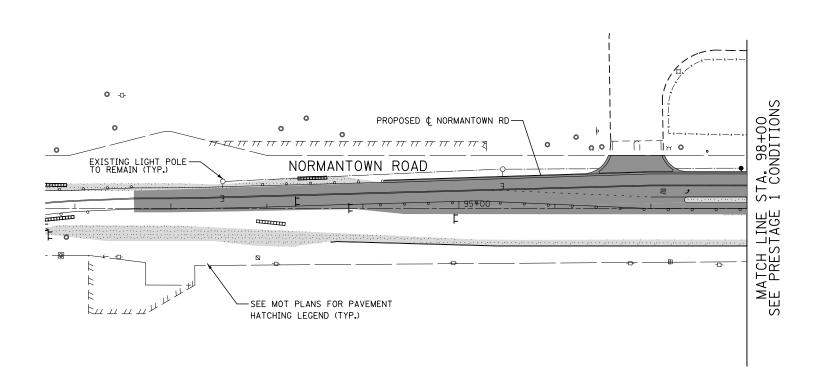

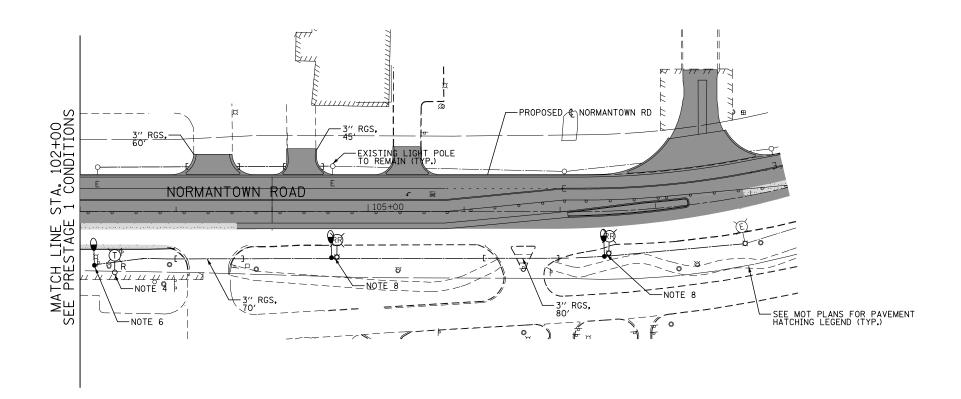

- 1. FOR SYMBOL LIST AND GENERAL ELECTRICAL NOTES, SEE SHEET LT-01.
- 2. CONTRACTOR SHALL COORDINATE AND STAGE TEMPORARY AND PROPOSED LIGHTING INSTALLATION AND EXISTING LIGHTING REMOVALS SUCH THAT NO SECTION OF ROADWAY THAT IS CURRENTLY ILLUMINATED WILL BE WITHOUT LIGHT FOR ANY NIGHTTIME PERIOD.
- 3. ALL WORK SHOWN ON THIS SHEET SHALL BE COORDINATED WITH THE MAINTENANCE OF TRAFFIC PLANS.
- 4. REMOVAL OF TEMPORARY LIGHTING UNIT.
- 5. CONTRACTOR SHALL REMOVE TEMPORARY LIGHTING ITEMS ONCE THEY ARE NO LONGER REQUIRED FOR MAINTENENCE OF TRAFFIC AND PERMANENT LIGHTING HAS BEEN ENERGIZED.
- 6. LIGHT POLE FOUNDATION, 24" DIAMETER AND REINSTALL PREVIOUSLY SALVAGED LIGHTING UNIT. REINSTALLATION SHALL BE PART OF "REMOVE AND RE-ERECT EXISTING LIGHTING UNIT" PAY ITEM.
- 7. INTERCEPT EXISTING WIRING IN EXISTING LIGHT POLE AND CONTINUE CIRCUIT TO RELOCATED LIGHT POLE. SEE PROPOSED LIGHTING PLANS FOR DETAILS.
- 8. RELOCATE EXISTING LIGHTING UNIT, POLE FOUNDATION, 24" DIAMETER AND REMOVAL OF POLE FOUNDATION. SEE PROPOSED LIGHTING PLANS FOR FINAL LIGHT POLE AND POLE FOUNDATION LOCATION. CONTRACTOR SHALL MATCH BOLT CIRCLE FROM OLD AND NEW FOUNDATION.

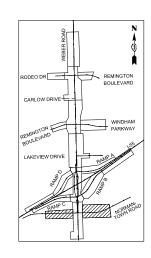

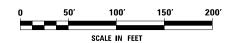




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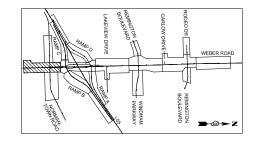
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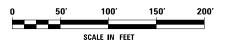
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*		(99-1	1HB-1) R-1			WILL	1508	966
LT-39					Γ	CONTRACT	NO. 6	0X1C
* FAI 55,	FAP	856	ILLINOIS	FED. A	ID	PROJECT		





- 1. FOR SYMBOL LIST AND GENERAL ELECTRICAL NOTES, SEE SHEET LT-01.
- CONTRACTOR SHALL COORDINATE AND STAGE TEMPORARY AND PROPOSED LIGHTING INSTALLATION AND EXISTING LIGHTING REMOVALS SUCH THAT NO SECTION OF ROADWAY THAT IS CURRENTLY ILLUMINATED WILL BE WITHOUT LIGHT FOR ANY NIGHTTIME PERIOD.
- 3. ALL WORK SHOWN ON THIS SHEET SHALL BE COORDINATED WITH THE MAINTENANCE OF TRAFFIC PLANS.
- 4. LIGHT POLE, WOOD, 60 FOOT, CLASS 4, WITH 15 FT MAST ARM AND TEMPORARY LUMINAIRE, HIGH PRESSURE SODIUM VAPOR, HORIZONTAL MOUNT, 400 WATT, 240V TYPE III WITH A MOUNTING HEIGHT OF 47.5 FT.
- 5. AERIAL CABLE, 3-1/C NO.4 WITH MESSENGER WIRE. MAINTAIN CLEARANCE FROM GROUND PER NEC 225.18 AND FROM COMED OVERHEAD ELECTRIC LINES AS REQUIRED BY COMED.
- 6. REMOVAL OF TEMPORARY LIGHTING UNIT.
- CONTRACTOR SHALL REMOVE TEMPORARY LIGHTING ITEMS ONCE THEY ARE NO LONGER REQUIRED FOR MAINTENENCE OF TRAFFIC AND PERMANENT LIGHTING HAS BEEN ENERGIZED.
- 8. TEMPORARY WOOD POLE, 60 FT., CLASS 4.

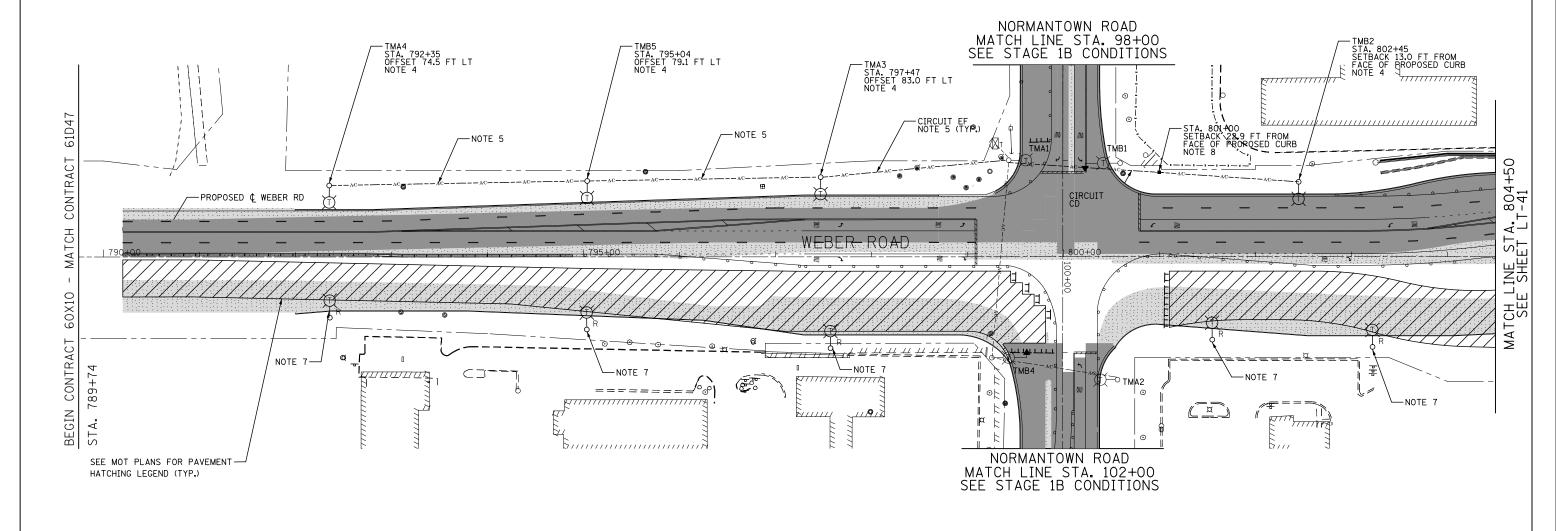






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DEPARTMENT OF	TRANSPORTATION	


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SCALE: AS SHOWN	SHEET NO.	OF	SHEETS	STA.	TO STA.


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*	(99-1HB-	-1) R-1		WILL	WILL 1508	
	LT-40			CONTRACT	NO. 6	0X10
* FAI 55,	FAP 856 ILL	INOIS FED.	AID	PROJECT		

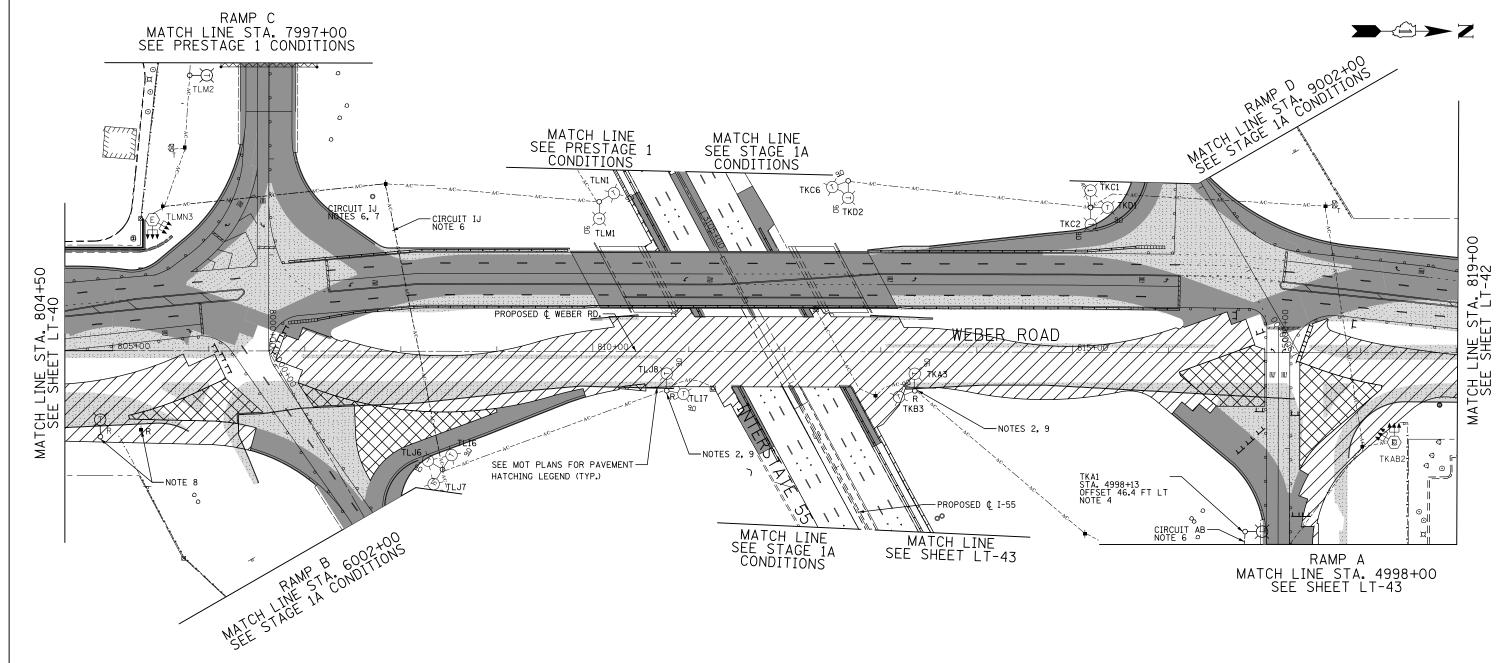

- 1. FOR SYMBOL LIST AND GENERAL ELECTRICAL NOTES, SEE SHEET LT-01.
- 2. CONTRACTOR SHALL COORDINATE AND STAGE TEMPORARY AND PROPOSED LIGHTING INSTALLATION AND EXISTING LIGHTING REMOVALS SUCH THAT NO SECTION OF ROADWAY THAT IS CURRENTLY ILLUMINATED WILL BE WITHOUT LIGHT FOR ANY NIGHTTIME PERIOD.
- 3. ALL WORK SHOWN ON THIS SHEET SHALL BE COORDINATED WITH THE MAINTENANCE OF TRAFFIC PLANS.
- 4. LIGHT POLE, WOOD, 60 FOOT, CLASS 4, WITH 15 FT MAST ARM AND TEMPORARY LUMINAIRE, HIGH PRESSURE SODIUM VAPOR, HORIZONTAL MOUNT, 400 WATT, 240V TYPE III WITH A MOUNTING HEIGHT OF 47.5 FT.
- 5. TEMPORARY WOOD POLE OFFET IS MEASURED FROM RAMP A & TO THE CENTER OF THE POLE BASE, UNLESS NOTED OTHERWISE.
- 6. AERIAL CABLE, 3-1/C NO. 2 WITH MESSENGER WIRE. MAINTAIN CLEARANCE FROM GROUND PER NEC 225.18 AND FROM COMED OVERHEAD ELECTRIC LINES AS REQUIRED BY COMED.

- 7. NEW AERIAL CABLE SHALL BE RUN IN PARALLEL WITH PREVIOUSLY INSTALLED AERIAL CABLE .
- 8. REMOVAL OF TEMPORARY LIGHTING UNIT.
- CONTRACTOR SHALL REMOVE TEMPORARY LIGHTING ITEMS ONCE THEY ARE NO LONGER REQUIRED FOR MAINTENENCE OF TRAFFIC AND PERMANENT LIGHTING HAS BEEN ENERGIZED.
- 10. ALL AERIAL CABLE IS EXISTING, UNLESS CIRCUIT/CABLE TYPE IS SPECIFICALLY CALLED OUT.

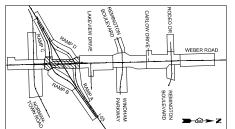

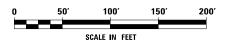




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F.A.I/P RTE.	SE	SECTION			COUNTY	TOTAL SHEETS	SHEE NO.
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	LT-41				CONTRACT	NO. 6	0X10
* FAI 55,	FAP 856	ILLINOIS	FED.	AID	PROJECT		



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		DRAWN MLB	REVISED -
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SCALE: AS SHOWN	SHEET NO.	OF	SHEETS	STA.	TO STA.

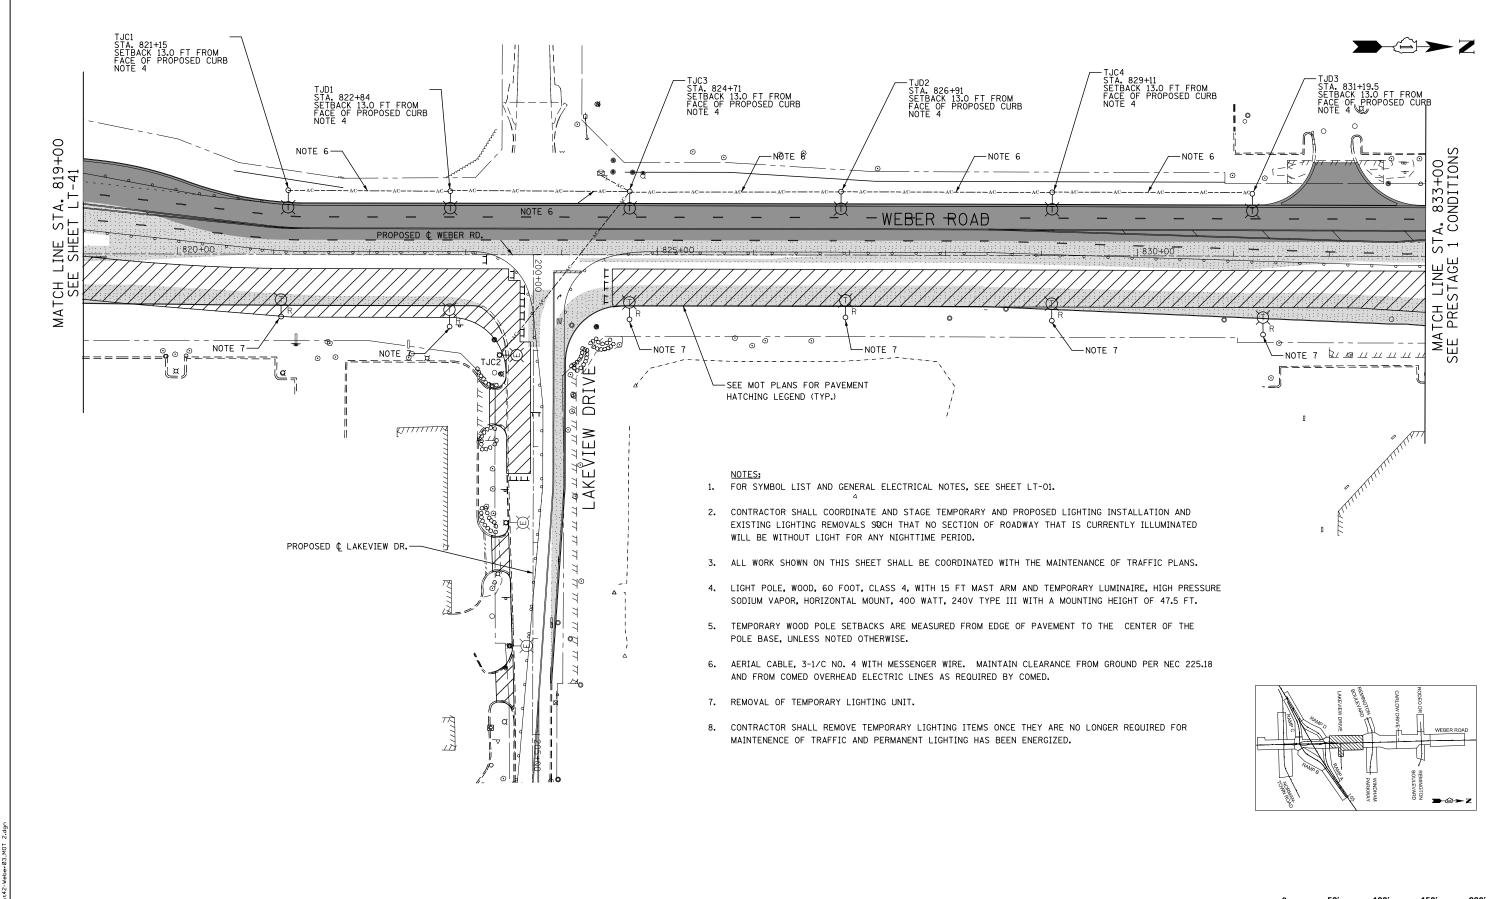F.A.I/P SECTION					COUNTY	TOTAL SHEETS	SHEE NO.	
*	(99-1	(99-1HB-1) R-1			WILL	1508	969	
	LT-42			CONTRACT	NO. 6	0X10		
* FAI 55,	FAP 856	ILLINOIS	FED.	AID	PROJECT			

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Engineers & Architects

PLOT DATE = 8/17/2017

- 1. FOR SYMBOL LIST AND GENERAL ELECTRICAL NOTES, SEE SHEET LT-01.
- 2. CONTRACTOR SHALL COORDINATE AND STAGE TEMPORARY AND PROPOSED LIGHTING INSTALLATION AND EXISTING LIGHTING REMOVALS SUCH THAT NO SECTION OF ROADWAY THAT IS CURRENTLY ILLUMINATED WILL BE WITHOUT LIGHT FOR ANY NIGHTTIME PERIOD.
- 3. ALL WORK SHOWN ON THIS SHEET SHALL BE COORDINATED WITH THE MAINTENANCE OF TRAFFIC PLANS.

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08/25/17


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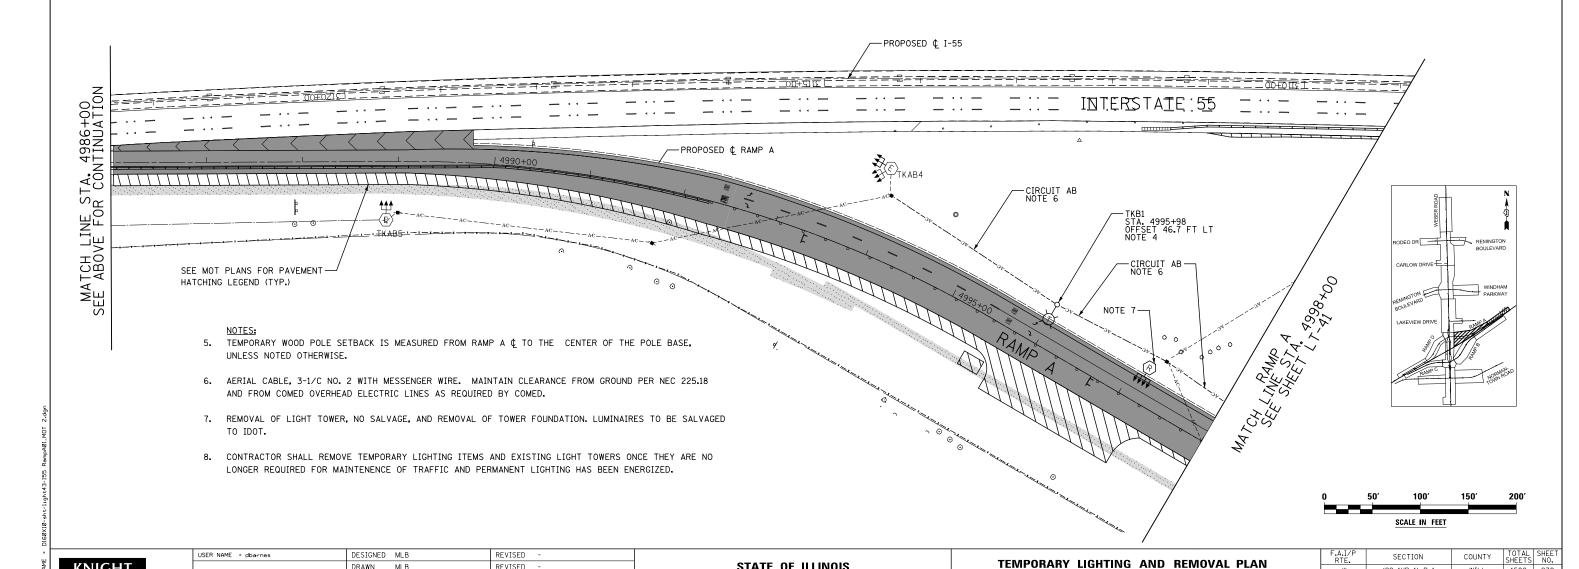
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4. LIGHT POLE, WOOD, 60 FOOT, CLASS 4, WITH 15 FT MAST ARM AND TEMPORARY LUMINAIRE, HIGH PRESSURE SODIUM VAPOR, HORIZONTAL MOUNT, 400 WATT, 240V TYPE III WITH A MOUNTING HEIGHT OF 47.5 FT.





STATE OF ILLINOIS

DEPARTMENT OF TRANSPORTATION

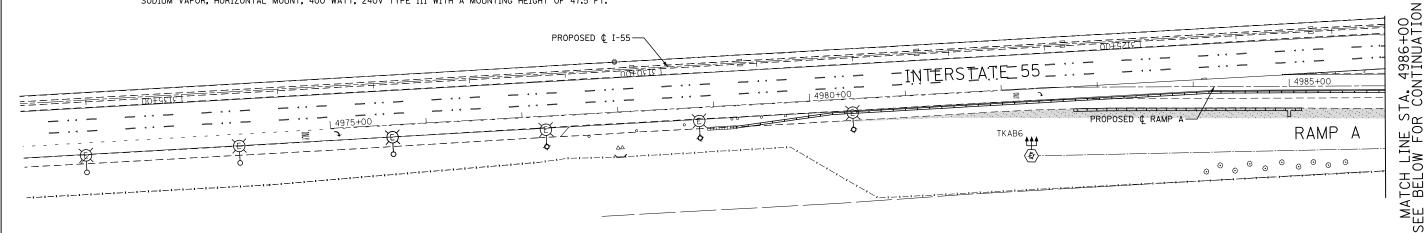(99-1HB-1) R-1

LT-43


MOT STAGE 2 - RAMP A

SCALE: AS SHOWN SHEET NO. OF SHEETS STA.

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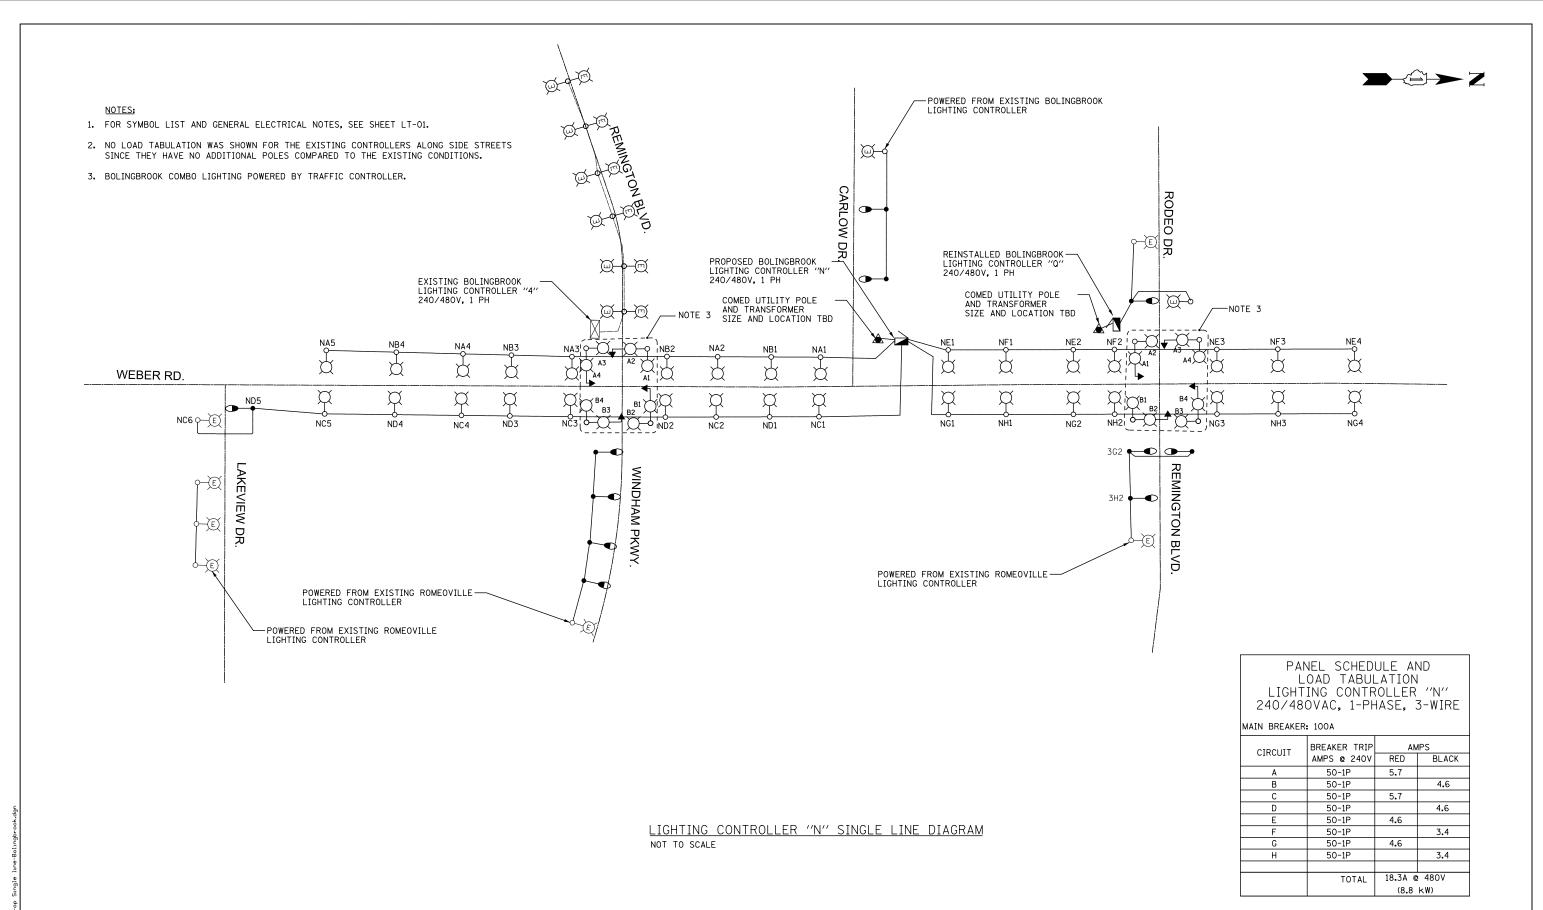
CONTRACT NO. 60X10



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GHT		DRAWN	MLB	REVISED	-
	PLOT SCALE = 1:2	CHECKED	CBS	REVISED	-
Engineers & Architects	PLOT DATE = 8/17/2017	DATE	08/25/17	REVISED	-

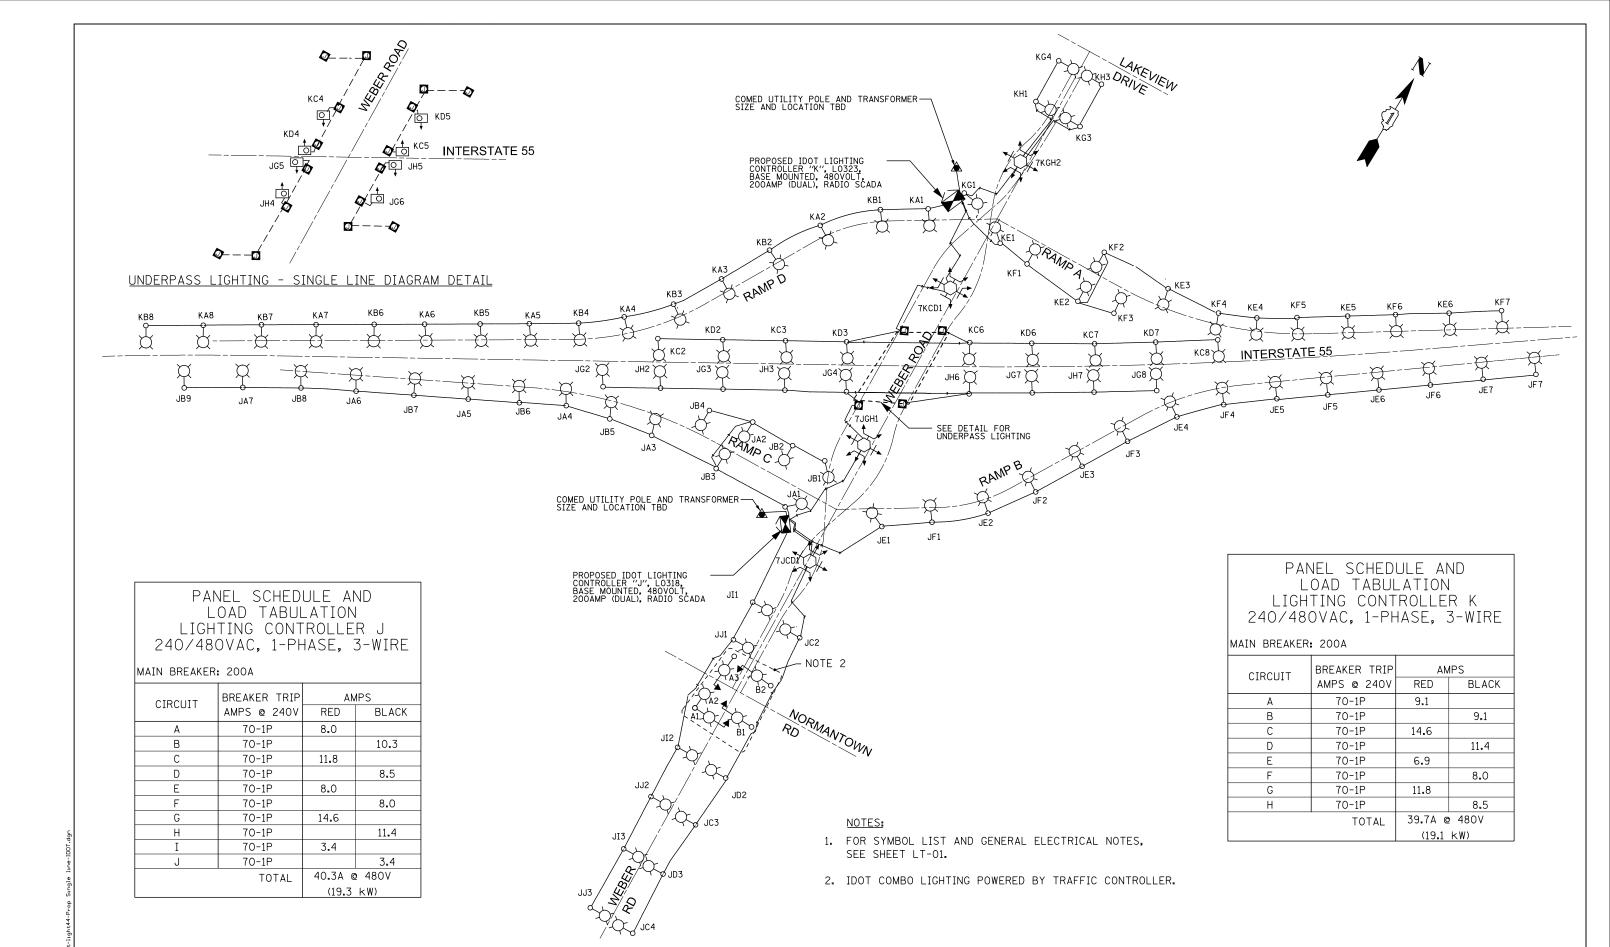LIGHTING CONTROLLER "J" & "K" SINGLE LINE DIAGRAM


SINGLE LINE DIAGRAM PROPOSED IDOT LIGHTING CONTROLLER "K" AND "J"					F.A.I/P RTE.	SECTION	COUNTY	TOTAL SHEETS	SHE		
					*	(99-1HB-1) R-1	WILL	1508	97		
1101 00	וטטו	LIGITIN	001111	IOLLLII				LT-44	CONTRACT	NO. 6	50X1
SHOWN	SHEET NO.	0F	SHEETS	STA.	TO STA.		¥ F∧1 55	EAP 856 THINNIS FED A	ID PROJECT		



KNIGHT		
Engineers	&	Architects

USER NAME = dbarnes	DESIGNED	MLB	REVISED -	
	DRAWN	MLB	REVISED -	
PLOT SCALE = 1:2	CHECKED	CBS	REVISED -	
PLOT DATE = 8/17/2017	DATE	08/25/17	REVISED -	

	PROPOSED LIGHTING SINGLE LINE DIAGRAMS							SECTION	COUNTY	TOTAL SHEETS	SHEET NO.
								(99-1HB-1) R-1	WILL	1508	972
								LT-45 CONTRACT NO.			
	SCALE: AS SHOWN	SHEET NO.	OF	SHEETS	STA.	TO STA.	* FAI 55, FAP 856 ILLINOIS FED. AID PROJECT				

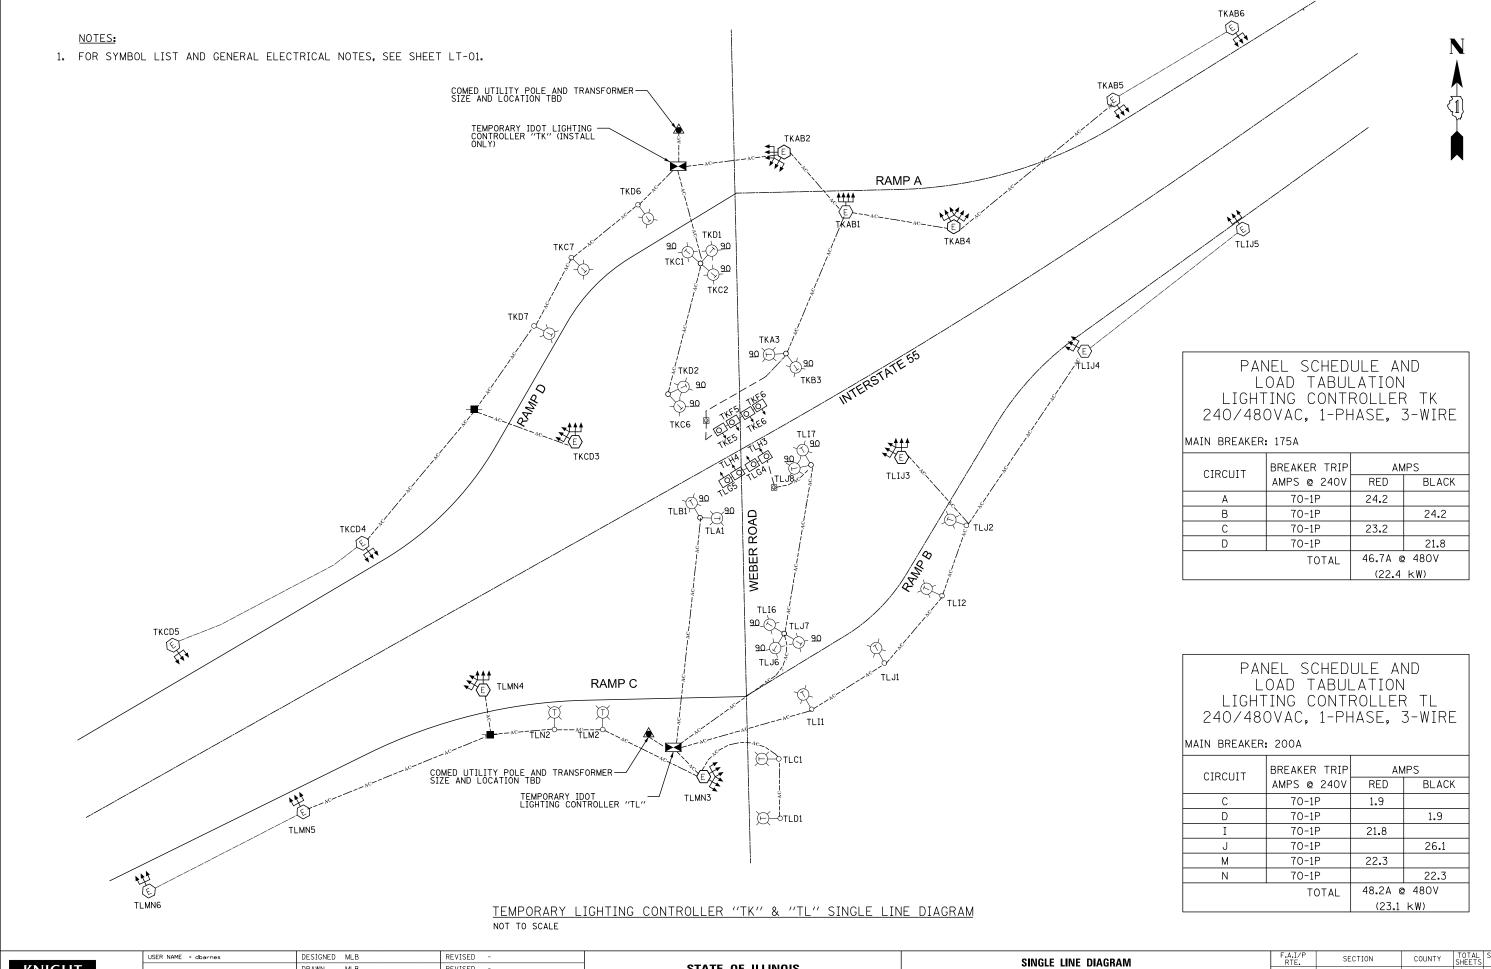

KNIGHT

Engineers & Architects


STATE OF ILLINOIS DEPARTMENT OF TRANSPORTATION SCALE: AS SHOWN SHEET NO. OF SHEETS STA. TO STA.


F.A.I/P SECTION COUNTY TOTAL SHEETS NO.

* (99-1HB-1) R-1 WILL 1508 973

LT-46 CONTRACT NO. 60X10

* FAI 55, FAP 856 | ILLINOIS| FED. AID PROJECT

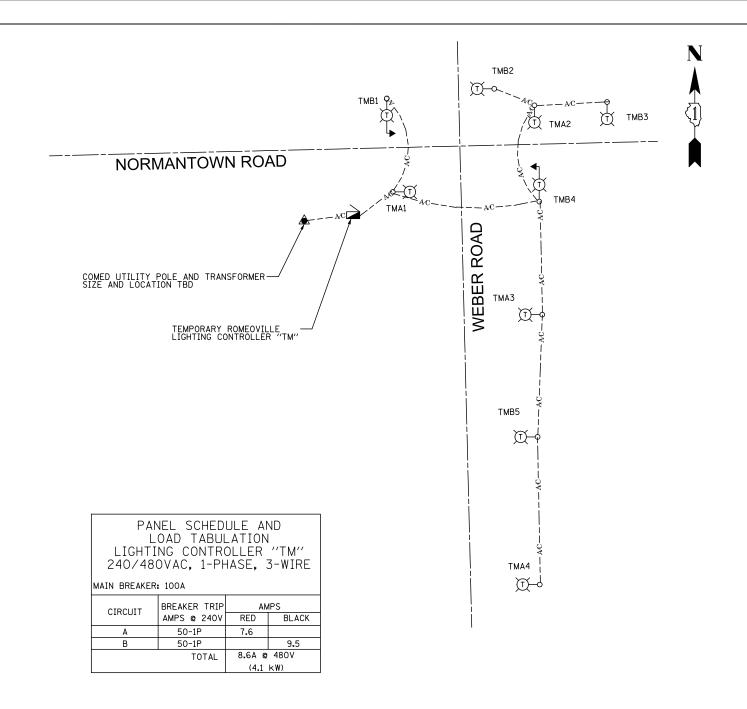

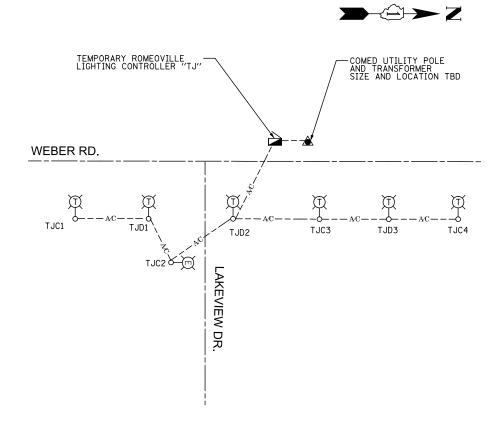

TEMPORARY ROMEOVILLE LIGHTING CONTROLLER "TJ"

SINGLE LINE DIAGRAM

NOT TO SCALE

TEMPORARY ROMEOVILLE LIGHTING CONTROLLER "TM" SINGLE LINE DIAGRAM NOT TO SCALE

NOTES:

- 1. FOR SYMBOL LIST AND GENERAL ELECTRICAL NOTES, SEE SHEET LT-01.
- 2. BOTH LIGHTING CONTROLLERS SHALL HAVE THE POLES ALONG WEBER RD. SWITCHED TO WEST SIDE ON MOT STAGE 2 AND ACTUAL TEMPORARY POLES SHALL BE REMOVED.

Engineers & Architects


USER NAME = dbarnes	DESIGNED	MLB	REVISED -	
	DRAWN	MLB	REVISED -	
PLOT SCALE = 1:2	CHECKED	CBS	REVISED -	
PLOT DATE = 8/17/2017	DATE	08/25/17	REVISED -	

STATE OF ILLINOIS DEPARTMENT OF TRANSPORTATION


SCALE: AS

							EAT/D			TOTAL	CHEET
TEMPORARY LIGHTING SINGLE LINE DIAGRAMS						F.A.I/P RTE.	SECTION	COUNTY	TOTAL SHEETS	SHEET NO.	
						*	(99-1HB-1) R-1	WILL	1508	974	
		JIIV	OLL LII	IL DIAGI	IAIVIO		LT-47 CONTRACT NO. 6				0X10
SHOWN	SHEET	NO.	OF	SHEETS	STA.	TO STA.	* FAI 55,	FAP 856 ILLINOIS FED. AI	D PROJECT		

1. FOR SYMBOL LIST AND GENERAL ELECTRICAL NOTES, SEE SHEET LT-01.

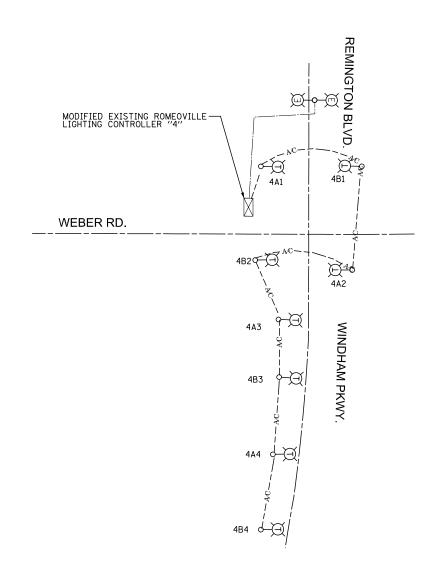

ROMEOVILLE LIGHTING CONTROLLER "4"
TEMPORARY SINGLE LINE DIAGRAM

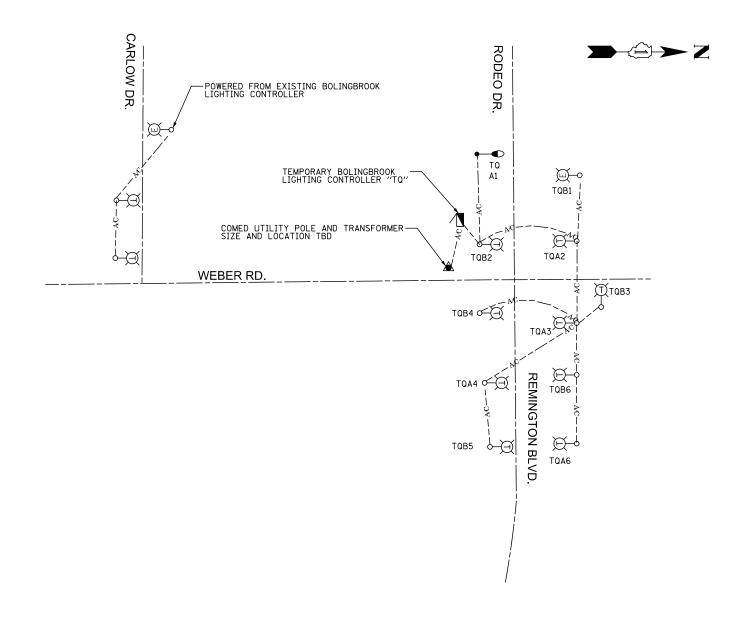

TEMPORARY BOLINGBROOK LIGHTING CONTROLLER "TQ"
SINGLE LINE DIAGRAM

Engineers & Architects

USER NAME = dbarnes	DESIGNED	MLB	REVISED -
	DRAWN	MLB	REVISED -
PLOT SCALE = 1:2	CHECKED	CBS	REVISED -
PLOT DATE = 8/17/2017	DATE	08/25/17	REVISED -

STATE OF ILLINOIS DEPARTMENT OF TRANSPORTATION

	TEMPORARY LIGHTING SINGLE LINE DIAGRAMS						F.A.I/P RTE.	SECTION	COUNTY	TOTAL SHEETS	SHEET NO.
							*	(99-1HB-1) R-1	WILL	1508	975
			OLL LI		IAIVIS			LT-48	CONTRACT	NO. 6	0X10
	SCALE: AS SHOWN	SHEET NO.	0F	SHEETS	STA.	TO STA.	* FAI 55,	FAP 856 ILLINOIS FED. A	ID PROJECT		

IDOT PROPOSED ITEMS

I-55 AT WEBER ROAD INTERC	HANG	E
DESCRIPTION	U.M.	QTY
ELECTRIC SERVICE INSTALLATION	EACH	2
ELECTRIC UTILITY SERVICE CONNECTION	LSUM	1
UNDERGROUND CONDUIT, GALVANIZED STEEL, 4" DIA.	FOOT	1,922
CONDUIT ATTACHED TO STRUCTURE, 1" DIA., PVC COATED GALVANIZED STEEL	FOOT	625
CONDUIT ATTACHED TO STRUCTURE, 3" DIA., PVC COATED GALVANIZED STEEL	FOOT	100
JUNCTION BOX, STAINLESS STEEL, ATTACHED TO STRUCTURE, 6" X 6" X 4"	EACH	8
JUNCTION BOX, STAINLESS STEEL, ATTACHED TO STRUCTURE, 12" X 10" X 6"	EACH	4
JUNCTION BOX, STAINLESS STEEL, ATTACHED TO STRUCTURE, 24" X 24" X 8"	EACH	4
UNIT DUCT, 600V, 3-1C NO.2, 1/C NO.4 GROUND, (XLP-TYPE USE), 1 1/2" DIA. POLYETHYLENE	FOOT	17,575
ELECTRIC CABLE IN CONDUIT, 600V (XLP-TYPE USE) 1/C NO. 10	FOOT	2,380
ELECTRIC CABLE IN CONDUIT, 600V (XLP-TYPE USE) 1/C NO. 4	FOOT	200
ELECTRIC CABLE IN CONDUIT, 600V (XLP-TYPE USE) 1/C 350MCM	FOOT	600
LUMINAIRE, LED, HORIZONTAL MOUNT, TYPE C	EACH	78
LUMINAIRE, LED, HIGH MAST, HORIZONTAL MOUNT	EACH	28
LUMINAIRE, UNDERPASS, LED, TYPE B	EACH	8
LIGHT POLE, ALUMINUM, 47.5 FT. M.H., 15 FT. DAVIT ARM	EACH	78
LIGHT TOWER, 120 FT. MOUNTING HEIGHT, LUMINAIRE MT 8	EACH	4
LIGHT POLE FOUNDATION, 24" DIAMETER	FOOT	590
LIGHT TOWER FOUNDATION, 54" DIAMETER	FOOT	59
BREAKAWAY DEVICE, TRANSFORMER BASE, 15 INCH BOLT CIRCLE	EACH	78
LIGHT TOWER, SERVICE PAD	EACH	4
LIGHTING CONTROLLER, BASE MOUNTED, 480VOLT, 200AMP (DUAL), RADIO SCADA	EACH	2
REMOVE AND RE-ERECT EXISTING LIGHTING UNIT	EACH	5
LUMINAIRE SAFETY CABLE ASSEMBLY	EACH	78
WEBER ROAD		
DESCRIPTION	U.M.	QTY
UNDERGROUND CONDUIT, GALVANIZED STEEL, 4" DIA.	FOOT	411
UNIT DUCT, 600V, 3-1C NO.2, 1/C NO.4 GROUND, (XLP-TYPE USE), 1 1/2" DIA. POLYETHYLENE	FOOT	4,320
LUMINAIRE, LED, HORIZONTAL MOUNT, TYPE C	EACH	15
LIGHT POLE, ALUMINUM, 47.5 FT. M.H., 15 FT. MAST ARM	EACH	15
LIGHT POLE FOUNDATION, 24" DIAMETER	FOOT	108
BREAKAWAY DEVICE, TRANSFORMER BASE, 15 INCH BOLT CIRCLE	EACH	15
LIGHT POLE FOUNDATION, 24" DIAMETER, OFFSET	FOOT	9
LUMINAIRE SAFETY CABLE ASSEMBLY	EACH	15

IDOT JURISDICTION ROMEOVILLE PROPOSED ITEMS

WEBER ROAD		
DESCRIPTION	U.M.	QTY
UNDERGROUND CONDUIT, GALVANIZED STEEL, 4" DIA.	FOOT	210
UNIT DUCT, 600V, 3-1C NO.4, 1/C NO.6 GROUND, (XLP-TYPE USE), 1 1/4" DIA. POLYETHYLENE	FOOT	2,630
LUMINAIRE, SODIUM VAPOR, HORIZONTAL MOUNT, 400 WATT	EACH	7
LIGHT POLE, ALUMINUM, 47.5 FT. M.H., 15 FT. DAVIT ARM	EACH	7
LIGHT POLE FOUNDATION, 24" DIAMETER	FOOT	62
BREAKAWAY DEVICE, TRANSFORMER BASE, 15 INCH BOLT CIRCLE	EACH	7
LUMINAIRE SAFETY CABLE ASSEMBLY	EACH	7
NORMANTOWN ROAD		
DESCRIPTION	U.M.	QTY
UNDERGROUND CONDUIT, GALVANIZED STEEL, 4" DIA.	FOOT	370
UNIT DUCT, 600V, 3-1C NO.4, 1/C NO.6 GROUND, (XLP-TYPE USE), 1 1/4" DIA. POLYETHYLENE	FOOT	1,520
LIGHT POLE FOUNDATION, 24" DIAMETER	FOOT	28
RELOCATE EXISTING LIGHTING UNIT	EACH	3
REMOVE AND RE-ERECT EXISTING LIGHTING UNIT	EACH	1
LAKEVIEW DRIVE		
DESCRIPTION	U.M.	QTY
UNDERGROUND CONDUIT, GALVANIZED STEEL, 4" DIA.	FOOT	60
UNIT DUCT, 600V, 3-1C NO.4, 1/C NO.6 GROUND, (XLP-TYPE USE), 1 1/4" DIA. POLYETHYLENE	FOOT	90
LIGHT POLE FOUNDATION, 24" DIAMETER	FOOT	10
REMOVE AND RE-ERECT EXISTING LIGHTING UNIT	EACH	1
WINDHAM PARKWAY		
DESCRIPTION	U.M.	QTY
UNDERGROUND CONDUIT, GALVANIZED STEEL, 4" DIA.	FOOT	210
UNIT DUCT, 600V, 3-1C NO.4, 1/C NO.6 GROUND, (XLP-TYPE USE), 1 1/4" DIA. POLYETHYLENE	FOOT	915
LIGHT POLE FOUNDATION, 24" DIAMETER	FOOT	26
LIGHT POLE FOUNDATION, 24" DIAMETER, OFFSET	FOOT	43
REMOVE AND RE-ERECT EXISTING LIGHTING	EACH	6

BOLINGBROOK PROPOSED ITEMS

WEBER ROAD						
DESCRIPTION	U.M.	QTY				
UNDERGROUND CONDUIT, GALVANIZED STEEL, 4" DIA.	FOOT	345				
UNIT DUCT, 600V, 3-1C NO.4, 1/C NO.6 GROUND, (XLP-TYPE USE), 1 1/4" DIA. POLYETHYLENE	FOOT	1,775				
LUMINAIRE, LED, HORIZONTAL MOUNT, TYPE C	EACH	7				
LIGHT POLE, ALUMINUM, 47.5 FT. M.H., 15 FT. DAVIT ARM	EACH	7				
LIGHT POLE FOUNDATION, 24" DIAMETER	FOOT	59				
BREAKAWAY DEVICE, TRANSFORMER BASE, 15 INCH BOLT CIRCLE	EACH	7				
LUMINAIRE SAFETY CABLE ASSEMBLY	EACH	7				

NOTES:

1. THE LOCATION OF THE IDOT / WILL COUNTY JURISDICTIONAL INTERFACE IS STA 842+07.



USER NAME = dbarnes	DESIGNED	MLB	REVISED -
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STATE OF ILLINOIS
DEPARTMENT OF TRANSPORTATION

	В	ILL OI	F MATERIA	ALS		F.A.I/P RTE.	SECTION	COUNTY	TOTAL SHEETS	SHEET NO.
PROPOSED LIGHTING ITEMS					*	(99-1HB-1) R-1	WILL	1508	976	
PROPOSED LIGHTING HEINS							LT-49	CONTRACT	NO. 6	0X10
SCALE: AS SHOWN	SHEET NO.	OF	SHEETS	STA.	TO STA.	* FAI 55,	FAP 856 ILLINOIS FED. AI	D PROJECT		

WILL COUNTY JURISDICTION

ROMEOVILLE PROPOSED ITEMS

NOWLOVILLE I NOI OSED I	T LIVIO	
WEBER ROAD		
DESCRIPTION	U.M.	QTY
UNDERGROUND CONDUIT, GALVANIZED STEEL, 4" DIA.	FOOT	168
UNIT DUCT, 600V, 3-1C NO.4, 1/C NO.6 GROUND, (XLP-TYPE USE), 1 1/4" DIA. POLYETHYLENE	FOOT	1,105
LUMINAIRE, LED, HORIZONTAL MOUNT, TYPE C	EACH	6
LIGHT POLE, ALUMINUM, 47.5 FT. M.H., 15 FT. DAVIT ARM	EACH	6
LIGHT POLE FOUNDATION, 24" DIAMETER	FOOT	57
BREAKAWAY DEVICE, TRANSFORMER BASE, 15 INCH BOLT CIRCLE	EACH	6
LUMINAIRE SAFETY CABLE ASSEMBLY	EACH	6
REMINGTON BOULEVAR	D	
DESCRIPTION	U.M.	QTY
UNDERGROUND CONDUIT, GALVANIZED STEEL, 4" DIA.	FOOT	140
UNIT DUCT, 600V, 3-1C NO.4, 1/C NO.6 GROUND, (XLP-TYPE USE), 1 1/4" DIA. POLYETHYLENE	FOOT	375
LIGHT POLE FOUNDATION, 24" DIAMETER	FOOT	14
REMOVE AND RE-ERECT EXISTING LIGHTING UNIT	EACH	2
RODEO DRIVE		
DESCRIPTION	U.M.	QTY
UNIT DUCT, 600V, 3-1C NO.4, 1/C NO.6 GROUND, (XLP-TYPE USE), 1 1/4" DIA. POLYETHYLENE	FOOT	375

BOLINGBROOK PROPOSED ITEMS

WEBER ROAD		
DESCRIPTION	U.M.	QTY
ELECTRIC SERVICE INSTALLATION	EACH	1
UNDERGROUND CONDUIT, GALVANIZED STEEL, 4" DIA.	FOOT	608
UNIT DUCT, 600V, 3-1C NO.4, 1/C NO.6 GROUND, (XLP-TYPE USE), 1 1/4" DIA. POLYETHYLENE	FOOT	3,410
ELECTRIC CABLE IN CONDUIT, 600V (XLP-TYPE USE) 1/C NO. 8	FOOT	100
ELECTRIC CABLE IN CONDUIT, 600V (XLP-TYPE USE) 1/C NO. 2	FOOT	300
LUMINAIRE, LED, HORIZONTAL MOUNT, TYPE C	EACH	12
LIGHTING CONTROLLER, BASE MOUNTED, 480VOLT, 100AMP	EACH	1
LIGHT POLE, ALUMINUM, 47.5 FT. M.H., 15 FT. DAVIT ARM	EACH	12
LIGHT POLE FOUNDATION, 24" DIAMETER	FOOT	95
LIGHT POLE FOUNDATION, 24" DIAMETER, OFFSET	FOOT	18
BREAKAWAY DEVICE, TRANSFORMER BASE, 15 INCH BOLT CIRCLE	EACH	12
LUMINAIRE SAFETY CABLE ASSEMBLY	EACH	12
CARLOW DRIVE		
1		
DESCRIPTION	U.M.	QTY
DESCRIPTION UNDERGROUND CONDUIT, GALVANIZED STEEL, 4" DIA.	U.M.	QTY 60
UNDERGROUND CONDUIT, GALVANIZED		<u>-</u>
UNDERGROUND CONDUIT, GALVANIZED STEEL, 4" DIA. UNIT DUCT, 600V, 3-1C NO.4, 1/C NO.6 GROUND,	FOOT	60
UNDERGROUND CONDUIT, GALVANIZED STEEL, 4" DIA. UNIT DUCT, 600V, 3-1C NO.4, 1/C NO.6 GROUND, (XLP-TYPE USE), 1 1/4" DIA. POLYETHYLENE	FOOT	60
UNDERGROUND CONDUIT, GALVANIZED STEEL, 4" DIA. UNIT DUCT, 600V, 3-1C NO.4, 1/C NO.6 GROUND, (XLP-TYPE USE), 1 1/4" DIA. POLYETHYLENE LIGHT POLE FOUNDATION, 24" DIAMETER REMOVE AND RE-ERECT EXISTING LIGHTING	FOOT FOOT	60 270 14
UNDERGROUND CONDUIT, GALVANIZED STEEL, 4" DIA. UNIT DUCT, 600V, 3-1C NO.4, 1/C NO.6 GROUND, (XLP-TYPE USE), 1 1/4" DIA. POLYETHYLENE LIGHT POLE FOUNDATION, 24" DIAMETER REMOVE AND RE-ERECT EXISTING LIGHTING UNIT	FOOT FOOT	60 270 14
UNDERGROUND CONDUIT, GALVANIZED STEEL, 4" DIA. UNIT DUCT, 600V, 3-1C NO.4, 1/C NO.6 GROUND, (XLP-TYPE USE), 1 1/4" DIA. POLYETHYLENE LIGHT POLE FOUNDATION, 24" DIAMETER REMOVE AND RE-ERECT EXISTING LIGHTING UNIT RODEO DRIVE	FOOT FOOT EACH	60 270 14 2
UNDERGROUND CONDUIT, GALVANIZED STEEL, 4" DIA. UNIT DUCT, 600V, 3-1C NO.4, 1/C NO.6 GROUND, (XLP-TYPE USE), 1 1/4" DIA. POLYETHYLENE LIGHT POLE FOUNDATION, 24" DIAMETER REMOVE AND RE-ERECT EXISTING LIGHTING UNIT RODEO DRIVE DESCRIPTION UNDRGROUND CONDUIT, GALVANIZED STEEL,	FOOT FOOT EACH	60 270 14 2
UNDERGROUND CONDUIT, GALVANIZED STEEL, 4" DIA. UNIT DUCT, 600V, 3-1C NO.4, 1/C NO.6 GROUND, (XLP-TYPE USE), 1 1/4" DIA. POLYETHYLENE LIGHT POLE FOUNDATION, 24" DIAMETER REMOVE AND RE-ERECT EXISTING LIGHTING UNIT RODEO DRIVE DESCRIPTION UNDRGROUND CONDUIT, GALVANIZED STEEL, 4" DIA. UNIT DUCT, 600V, 3-1C NO.4, 1/C NO.6 GROUND,	FOOT FOOT EACH U.M. FOOT	60 270 14 2 QTY 110
UNDERGROUND CONDUIT, GALVANIZED STEEL, 4" DIA. UNIT DUCT, 600V, 3-1C NO.4, 1/C NO.6 GROUND, (XLP-TYPE USE), 1 1/4" DIA. POLYETHYLENE LIGHT POLE FOUNDATION, 24" DIAMETER REMOVE AND RE-ERECT EXISTING LIGHTING UNIT RODEO DRIVE DESCRIPTION UNDRGROUND CONDUIT, GALVANIZED STEEL, 4" DIA. UNIT DUCT, 600V, 3-1C NO.4, 1/C NO.6 GROUND, (XLP-TYPE USE), 1 1/4" DIA. POLYETHYLENE ELECTRIC CABLE IN CONDUIT, 600V (XLP-TYPE	FOOT FOOT EACH U.M. FOOT	60 270 14 2 QTY 110 480
UNDERGROUND CONDUIT, GALVANIZED STEEL, 4" DIA. UNIT DUCT, 600V, 3-1C NO.4, 1/C NO.6 GROUND, (XLP-TYPE USE), 1 1/4" DIA. POLYETHYLENE LIGHT POLE FOUNDATION, 24" DIAMETER REMOVE AND RE-ERECT EXISTING LIGHTING UNIT RODEO DRIVE DESCRIPTION UNDRGROUND CONDUIT, GALVANIZED STEEL, 4" DIA. UNIT DUCT, 600V, 3-1C NO.4, 1/C NO.6 GROUND, (XLP-TYPE USE), 1 1/4" DIA. POLYETHYLENE ELECTRIC CABLE IN CONDUIT, 600V (XLP-TYPE USE) 1/C NO. 8 ELECTRIC CABLE IN CONDUIT, 600V (XLP-TYPE	FOOT FOOT EACH U.M. FOOT FOOT FOOT	60 270 14 2 QTY 110 480
UNDERGROUND CONDUIT, GALVANIZED STEEL, 4" DIA. UNIT DUCT, 600V, 3-1C NO.4, 1/C NO.6 GROUND, (XLP-TYPE USE), 1 1/4" DIA. POLYETHYLENE LIGHT POLE FOUNDATION, 24" DIAMETER REMOVE AND RE-ERECT EXISTING LIGHTING UNIT RODEO DRIVE DESCRIPTION UNDRGROUND CONDUIT, GALVANIZED STEEL, 4" DIA. UNIT DUCT, 600V, 3-1C NO.4, 1/C NO.6 GROUND, (XLP-TYPE USE), 1 1/4" DIA. POLYETHYLENE ELECTRIC CABLE IN CONDUIT, 600V (XLP-TYPE USE) 1/C NO. 8 ELECTRIC CABLE IN CONDUIT, 600V (XLP-TYPE USE) 1/C NO. 2	FOOT FOOT EACH U.M. FOOT FOOT FOOT FOOT	60 270 14 2 QTY 110 480 100 300
UNDERGROUND CONDUIT, GALVANIZED STEEL, 4" DIA. UNIT DUCT, 600V, 3-1C NO.4, 1/C NO.6 GROUND, (XLP-TYPE USE), 1 1/4" DIA. POLYETHYLENE LIGHT POLE FOUNDATION, 24" DIAMETER REMOVE AND RE-ERECT EXISTING LIGHTING UNIT RODEO DRIVE DESCRIPTION UNDRGROUND CONDUIT, GALVANIZED STEEL, 4" DIA. UNIT DUCT, 600V, 3-1C NO.4, 1/C NO.6 GROUND, (XLP-TYPE USE), 1 1/4" DIA. POLYETHYLENE ELECTRIC CABLE IN CONDUIT, 600V (XLP-TYPE USE) 1/C NO. 8 ELECTRIC CABLE IN CONDUIT, 600V (XLP-TYPE USE) 1/C NO. 2 LIGHT POLE FOUNDATION, 24" DIAMETER	FOOT FOOT FOOT FOOT FOOT FOOT FOOT	60 270 14 2 QTY 110 480 100 300 17

NOTES:

1. THE LOCATION OF THE IDOT / WILL COUNTY JURISDICTIONAL INTERFACE IS STA 842+07.

KNIGHT

Engineers & Architec

USER NAME = dbarnes	DESIGNED	MLB	REVISED -
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STATE OF ILLINOIS
DEPARTMENT OF TRANSPORTATION

	В	ILL O	F MATERIA	ALS		F.A.I/P RTE.	SECTION	COUNTY	TOTAL SHEETS	SHEET NO.
PROPOSED LIGHTING ITEMS					*	(99-1HB-1) R-1	WILL	1508	977	
THOI OSED EIGHTING TIENIS							LT-50	CONTRACT	NO. 6	0X10
SCALE: AS SHOWN	SHEET NO.	OF	SHEETS	STA.	TO STA.	* FAI 55,	FAP 856 ILLINOIS FED. AI	D PROJECT		

IDOT JURISDICTION

ROMEOVILLE TEMPORARY ITEMS

WEBER ROAD						
DESCRIPTION	U.M.	QTY				
REMOVAL OF LIGHTING UNIT, SALVAGE	EACH	24				
REMOVAL OF POLE FOUNDATION	EACH	24				
REMOVAL OF TEMPORARY LIGHTING UNIT	EACH	4				
LIGHT POLE, WOOD, 60 FOOT, CLASS 4, WITH 15FT MAST ARM	EACH	4				
TEMPORARY LUMINAIRE, HIGH PRESSURE SODIUM VAPOR, HORIZONTAL MOUNT, 400 WATT	EACH	4				
AERIAL CABLE, 3-1/C NO. 4 WITH MESSENGER WIRE	FOOT	930				
NORMANTOWN ROAD)					
DESCRIPTION	U.M.	QTY				
AERIAL CABLE, 3-1/C NO. 4 WITH MESSENGER WIRE	FOOT	56				
REMOVAL OF TEMPORARY LIGHTING UNIT	EACH	1				
REMOVAL OF LIGHTING UNIT, SALVAGE	EACH	4				
REMOVAL OF POLE FOUNDATION	EACH	8				
LIGHT POLE, WOOD, 60 FOOT, CLASS 4, WITH 15FT MAST ARM	EACH	1				
TEMPORARY LUMINAIRE, HIGH PRESSURE SODIUM VAPOR, HORIZONTAL MOUNT, 400 WATT	EACH	1				
LAKEVIEW DRIVE						
DESCRIPTION	U.M.	QTY				
REMOVAL OF POLE FOUNDATION	EACH	1				
AERIAL CABLE, 3-1/C NO. 4 WITH MESSENGER WIRE	FOOT	135				
WINDHAM PARKWAY						
DESCRIPTION	U.M.	QTY				
AERIAL CABLE, 3-1/C NO. 4 WITH MESSENGER WIRE	FOOT	935				
REMOVAL OF TEMPORARY LIGHTING UNIT	EACH	6				
REMOVAL OF POLE FOUNDATION	EACH	6				
LIGHT POLE, WOOD, 60 FOOT, CLASS 4, WITH 15FT MAST ARM	EACH	6				
TEMPORARY LUMINAIRE, HIGH PRESSURE SODIUM VAPOR, HORIZONTAL MOUNT, 400	EACH	6				

BOLINGBROOK TEMPORARY ITEMS

WEBER ROAD						
DESCRIPTION	U.M.	QTY				
REMOVAL OF LIGHTING UNIT, SALVAGE	EACH	4				
REMOVAL OF POLE FOUNDATION	EACH	6				
TEMPORARY LIGHTING CONTROLLER, SPECIAL	EACH	1				
AERIAL CABLE, 3-1/C NO. 4 WITH MESSENGER WIRE	FOOT	1,041				
REMOVAL OF LIGHTING CONTROLLER	EACH	1				
REMINGTON BLV						
DESCRIPTION	U.M.	QTY				
AERIAL CABLE, 3-1/C NO. 4 WITH MESSENGER WIRE	FOOT	155				
REMOVAL OF TEMPORARY LIGHTING UNIT	EACH	2				
LIGHT POLE, WOOD, 60 FOOT, CLASS 4, WITH 15FT MAST ARM	EACH	2				
TEMPORARY LUMINAIRE, HIGH PRESSURE SODIUM VAPOR, HORIZONTAL MOUNT, 400 WATT	EACH	2				
MODIFYING EXISTING LIGHTING CONTROLLER	EACH	1				

WILL COUNTY JURISDICTION

ROMEOVILLE TEMPORARY ITEMS

REMINGTON BOULEVARD / RODEO DRIVE						
DESCRIPTION	U.M.	QTY				
AERIAL CABLE, 3-1/C NO. 4 WITH MESSENGER WIRE	FOOT	190				
REMOVAL OF TEMPORARY LIGHTING UNIT	EACH	5				
REMOVAL OF POLE FOUNDATION	EACH	2				
LIGHT POLE, WOOD, 60 FOOT, CLASS 4, WITH 15FT MAST ARM	EACH	5				
TEMPORARY LUMINAIRE, HIGH PRESSURE SODIUM VAPOR, HORIZONTAL MOUNT, 400 WATT	EACH	5				

BOLINGBROOK TEMPORARY ITEMS

WEBER ROAD		
DESCRIPTION	U.M.	QTY
AERIAL CABLE, 3-1/C NO. 4 WITH MESSENGER WIRE	FOOT	50
REMOVAL OF LIGHTING UNIT, SALVAGE	EACH	2
REMOVAL OF TEMPORARY LIGHTING UNIT	EACH	1
LIGHT POLE, WOOD, 60 FOOT, CLASS 4, WITH 15FT MAST ARM	EACH	1
TEMPORARY LUMINAIRE, HIGH PRESSURE SODIUM VAPOR, HORIZONTAL MOUNT, 400 WATT	EACH	2
CARLOW DRIVE		
DESCRIPTION	U.M.	QTY
AERIAL CABLE, 3-1/C NO. 4 WITH MESSENGER WIRE	FOOT	305
REMOVAL OF TEMPORARY LIGHTING UNIT	EACH	2
REMOVAL OF POLE FOUNDATION	EACH	2
LIGHT POLE, WOOD, 60 FOOT, CLASS 4, WITH 15FT MAST ARM	EACH	2
TEMPORARY LUMINAIRE, HIGH PRESSURE SODIUM VAPOR, HORIZONTAL MOUNT, 400 WATT	EACH	2
REMINGTON BOULEVARD / ROD	EO DR	IVE
DESCRIPTION	U.M.	QTY
AERIAL CABLE, 3-1/C NO. 4 WITH MESSENGER WIRE	FOOT	895
REMOVAL OF TEMPORARY LIGHTING UNIT	EACH	3
REMOVAL OF POLE FOUNDATION	EACH	4
LIGHT POLE, WOOD, 60 FOOT, CLASS 4, WITH 15FT MAST ARM	EACH	3
MAST ARM,STREET LIGHTING,15'	EACH	1
TEMPORARY LUMINAIRE, HIGH PRESSURE SODIUM VAPOR, HORIZONTAL MOUNT, 400 WATT	EACH	3
TEMPORARY LIGHTING CONTROLLER, SPECIAL	EACH	1

NOTES:

IDOT TEMPORARY ITEMS

I-55 AT WEBER ROAD INTERCHANGE

QTY

13,086

54

2

7

2

25

4

2

20

104

14

25

2

8

22

22

30

QTY

130

2,841

22

20

5

22

2

1

WATT

FOOT

EACH

EACH

CAL MO

U.M.

FOOT

FOOT

EACH

EACH

EACH

EACH

EACH

EACH

EACH

DESCRIPTION

AERIAL CABLE, 3-1/C NO. 2 WITH MESSENGER

REMOVAL OF TEMPORARY LIGHTING UNIT

DISCONNECT SIGN LIGHTING AND REMOVE

LIGHT POLE, WOOD, 60 FOOT, CLASS 4, WITH

LIGHT POLE, WOOD, 90 FOOT, CLASS 4, WITH 2

LIGHT POLE, WOOD, 90 FOOT, CLASS 4, WITH 3

TEMPORARY WOOD POLE, 40 FT., CLASS 4

TEMPORARY LUMINAIRE, HIGH PRESSURE SODIUM VAPOR, HIGH MAST, HORIZONTAL

TEMPORARY LUMINAIRE, HIGH PRESSURE SODIUM VAPOR, HORIZONTAL MOUNT, 400

REMOVAL OF UNDERPASS LIGHTING UNIT, NO

DESCRIPTION

AERIAL CABLE, 3-1/C NO. 2 WITH MESSENGER

AERIAL CABLE, 3-1/C NO. 4 WITH MESSENGER

LIGHT POLE, WOOD, 60 FOOT, CLASS 4, WITH

TEMPORARY WOOD POLE, 40 FT., CLASS 4

TEMPORARY LUMINAIRE, HIGH PRESSURE SODIUM VAPOR, HORIZONTAL MOUNT, 400

MAST ARM, STREET LIGHTING, 15'

REMOVAL OF LIGHTING CONTROLLER

TEMPORARY LIGHTING CONTROLLER, SPECIAL

REMOVAL OF TEMPORARY LIGHTING UNIT

WEBER ROAD

REMOVAL OF LIGHT TOWER, NO SALVAGE

TEMPORARY LIGHTING CONTROLLER

REMOVAL OF TOWER FOUNDATION

MAINTENANCE OF LIGHTING SYSTEM

REMOVAL OF HIGH MAST LUMINAIRES,

REMOVAL OF LIGHTING UNIT, SALVAGE

REMOVAL OF POLE FOUNDATION

WIRING TO NEAREST SPLICE

15FT MAST ARM

15 FOOT MAST ARMS

15 FOOT MAST ARMS

MOUNT, 750 WATT

SALVAGE

WATT

WIRE

WIRE

WATT

15FT MAST ARM


SALVAGE


WIRE

1. THE LOCATION OF THE IDOT / WILL COUNTY JURISDICTIONAL INTERFACE IS STA 842+07.



USER NAME = dbarnes	DESIGNED	MLB	REVISED -
	DRAWN	MLB	REVISED -
PLOT SCALE = 1:2	CHECKED	CBS	REVISED -
PLOT DATE = 8/17/2017	DATE	08/25/17	REVISED -

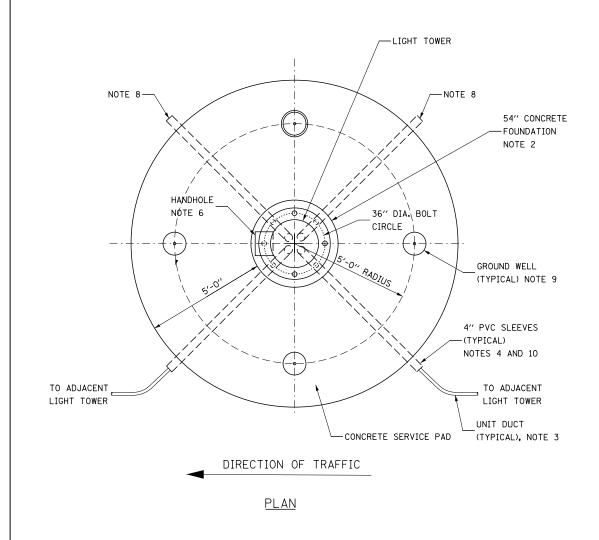

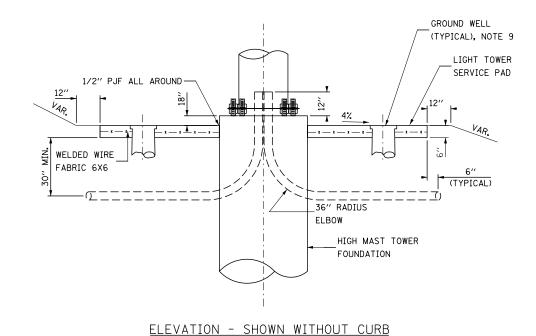

SCALE: AS SHOWN

GROUND MOUNTED HIGH MAST TOWER SERVICE PAD,

GROUNDING AND CONDUIT INSTALLATION DETAILS

NOT TO SCALE

NOTES:


- 1. SEE DRAWINGS LT-01 FOR ELECTRICAL SYMBOLS AND ABBREVIATIONS.
- SEE IDOT STANDARD DRAWING BE-506 FOR ADDITIONAL HIGH MAST LIGHT TOWER FOUNDATION AND GROUND WELL DETAILS.
- 3. SEE PLAN DRAWINGS FOR QUANTITY, SIZE, AND TYPE OF RACEWAY AND LIGHTING CIRCUITS ROUTED TO EACH HIGH MAST LIGHT TOWER FOUNDATION.
- 4. PVC SLEEVED MUST BE EXTENDED 6 INCHES BEYOND THE EDGE OF THE CONCRETE PAD.
- 5. THE PERIMETER EROSION BARRIER IS TO BE PLACED AROUND THE WORK ZONE AREA OR AS DIRECTED BY THE ENGINEER.
- 6. THE HANDHOLE FOR THE HIGH MAST LIGHTING UNIT MUST BE ORIENTED SUCH THAT IT IS MOUNTED ON THE SIDE OF THE POLE THAT IS OPPOSITE THE DIRECTION OF TRAFFIC.
- 7. SEE THE CIVIL CROSS SECTION PLANS FOR THE PROPOSED GRADING AROUND THE LIGHT TOWER FOUNDATION AND PAD.
- 8. EMPTY PVC SLEEVE FOR FUTURE USE, ALL EMPTY SLEEVES MUST BE CAPPED, UNLESS NOTED OTHERWISE ON THE PLANS.
- 9. INSTALL GROUND WELLS 5'-O" AS MEASURED FROM THE CENTER LINE OF THE HIGH MAST TOWER TO THE CENTER LINE OF THE WELL.
- 10. PVC CONDUIT SLEEVES SHALL BE INCLUDED IN THE COST OF THE LIGHT TOWER FOUNDATION AND SHALL NOT BE PAID FOR SEPARATELY.


KNI	GHT		
	Engineers	&	Architects

	USER NAME = dbarnes	DESIGNED	MLB	REVISED	-	
		DRAWN	MLB	REVISED	-	
_	PLOT SCALE = 1:2	CHECKED	CBS	REVISED	-	
ts	PLOT DATE = 8/17/2017	DATE	08/25/17	REVISED	-	

STATE OF ILLINOIS
DEPARTMENT OF TRANSPORTATION

	HOUT TOWER OFFINIOS DAD DETAILS				F.A.I/P RTE.	SECTION	COUNTY	TOTAL SHEETS	SHEET NO.		
LIGHT TOWER SERVICE PAD DETAILS			*	(99-1HB-1) R-1	WILL	1508	979				
								LT-52	CONTRACT	NO. 6	0X10
1	SHEET	NO.	OF	SHEETS	STA.	TO STA.	* FAI 55,	FAP 856 ILLINOIS FED. AI	ID PROJECT		

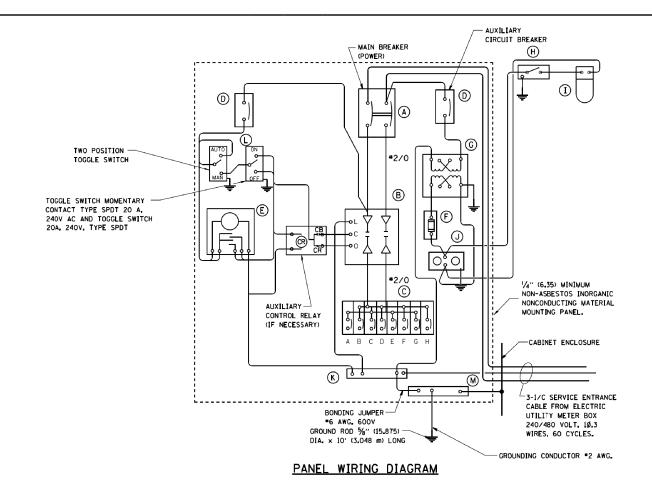

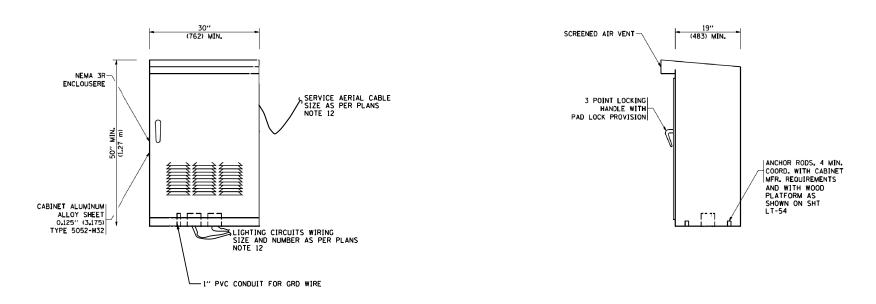

PANEL EQUIPMENT

		BILL OF MATERIAL
ITEM	QUANTITY	DESCRIPTION
Α	1	MAIN CIRCUIT BREAKER, 2 POLE, 600 VOLT 100 AMP. FRAME, 100 AMP. NON-INTERCHANGEABLE TRIP INTERRUPTING RATING NEMA-22000 AMP. AT 480 VOLT.
В	1	REMOTE CONTROL SWITCH, ELECTRICALLY OPERATED, MECHANICALLY HELD, 2 POLE, SINGLE THROW, 100 AMP., 600 VOLTS CONTROL CIRCUIT 240 VOLT.
С	8	CIRCUIT BREAKERS, 1 POLE, 100AMP. FRAME, 50 AMP. NON-INTERCHANGEABLE TRIP INTERRUPTING RATING NEMA-10,000 AMP. AT 240 V.
D	2	CONTROL CIRCUIT-CIRCUIT BREAKER. 1 POLE, 240 V., 100 AMP. FRAME, 15 AMP. NON-INTERCHANGEABLE TRIP INTERRUPTING RATING NEMA-5000 AMP. AT 240 V.
E	1	ASTRONOMIC MICROPROCESSOR-BASED 2-CHANNEL CONTROLLER [TIME SWITCH].
F	1	20 A., 120 V. FUSE.
G	1	1.5 KVA, SINGLE PHASE, ENCAPSULATED TRANSFORMER 240 X 480 / 120 X 240 VOLT, 60 Hz.
Н	1	SPST 20A SWITCH ON DOOR, TO TURN LIGHT ON WHEN Door is open,
I	1	INCANDESCENT LIGHTING FIXTURE ENCLOSED AND GASKETED WITH 60 WATT, 120 V. LAMP.
J	1	20 A., 120 V., DUPLEX RECEPTACLE, GFCI.
К	1	COPPER GROUND BUS 1/4" (6.35) X 1" (25.4) X 12" (304.8 mm) LONG MOUNTED ON PANEL WITH LUGS AND 4 SPARE LUGS
L	1	TOGGLE SWITCHES MOUNTED IN 4" (101.6) X 4" (101.6 mm) BOX
М	1	COPPER GROUND BUS $1/4$ " (6.35) X 1" (25.4) X 12" (304.8 mm) LONG MOUNTED ON PANEL WITH LUGS AND SPARE LUGS

NOTES:


- ALL DIMENSIONS ARE IN INCHES (MILIMETERS) UNLESS OTHERWISE SHOWN.
- 2. DOOR SHALL BE CONSTRUCTED FROM SAME TYPE OF MATERIAL AND THICKNESS AS CABINET.
- 3. DOOR SHALL BE EQUIPPED WITH THREE POINT LATCHING MECHANISM WITH NYLON ROLLERS AT TOP AND BOTTOM.
- 4. DOOR HINGE SHALL BE HEAVY GAUGE CONTINUOUS HINGE WITH A 1/4" DIA. STAINLESS STEEL HINGE PIN.
- 5. ALL EXTERNAL HARDWARE SHALL BE STAINLESS STEEL
- CONTROL WIRING TO BE "12 AWG, 600V, TYPE "SIS" GRAY SWITCH BOARD WIRE, STRANDED COPPER.
- THE HEADS OF CONNECTOR SCREWS SHALL BE PAINTED WHITE FOR NEUTRAL AND GREEN FOR GROUND BAR CONNECTORS.
- 8. ALL WIRING WITHIN THE CABINET SHALL BE COLOR CODED AS INDICATED:


 R = RED
 B = BLACK
 Y = YELLOW
 G = GREEN
- 9. PROVIDE SEALING GROMMETS FOR ALL OPEN WIRING EXTENDED FROM DEVICES IN BOXES OR CABINETS WITHIN THE CONTROL CABINET.
- 10. ALL WIRING SHALL BE NEATLY DRESSED AND SUPPORTED.
- 11. THE CONTROLLER SHALL BE CONSTRUCTED TO U.L. STD. 508
 AND BEAR THE U.L. LABEL "ENCLOSED INDUSTRIAL CONTROL
 PANEL".
- 12. CABLE ENTRANCE INTO THE CABINET SHALL BE SEALED AT ALL TIMES.

KNIGHT		
Engineers	&	Architect

ı	USER NAME = mbalog	DESIGNED	MLB	REVISED -
ſ		DRAWN	MLB	REVISED -
ſ	PLOT SCALE = 1:2	CHECKED	CBS	REVISED -
	PLOT DATE = 8/17/2017	DATE	08/25/17	REVISED -
_				

TEMPORARY LIGHTING CONTROLLER,							SECTION	COUNTY	TOTAL SHEETS	SHEET NO.
SPECIAL						*	(99-1HB-1) R-1	WILL	1508	979A
SPECIAL							LT-52A	CONTRACT	NO. 6	0X10
SCALE: AS SHOWN	SHEET NO.	OF	SHEETS	STA.	TO STA.	* FAI 55.	FAP 856 ILLINOIS FED. AL	D PROJECT		

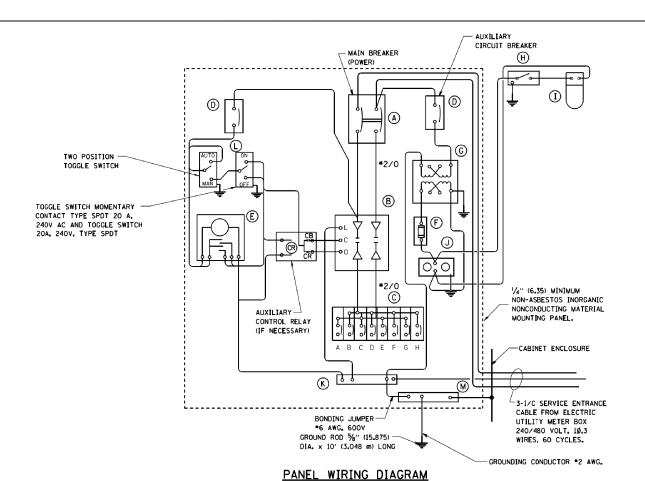

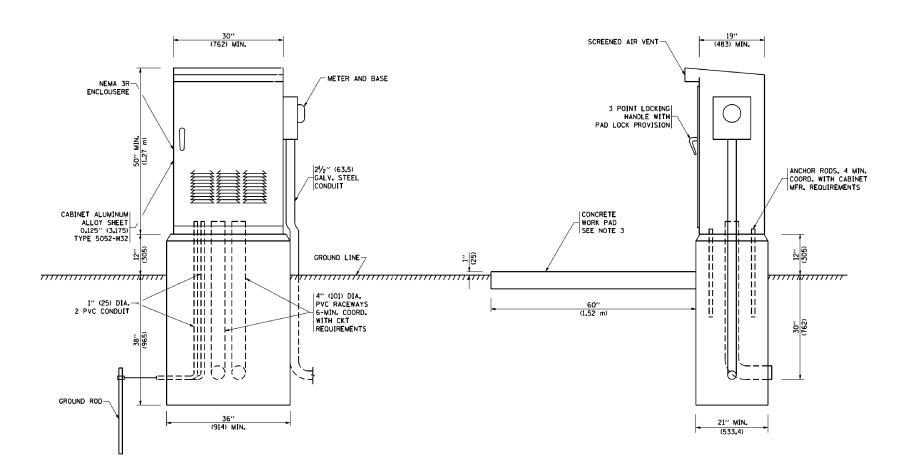

PANEL EQUIPMENT

	BILL OF MATERIAL							
ITEM	QUANTITY	DESCRIPTION						
Α	1	MAIN CIRCUIT BREAKER, 2 POLE, 600 VOLT 100 AMP. FRAME, 100 AMP. NON-INTERCHANGEABLE TRIP INTERRUPTING RATING NEMA-22000 AMP. AT 480 VOLT.						
В	1	REMOTE CONTROL SWITCH, ELECTRICALLY OPERATED, MECHANICALLY HELD, 2 POLE, SINGLE THROW, 100 AMP., 600 VOLTS CONTROL CIRCUIT 240 VOLT.						
С	8	CIRCUIT BREAKERS, 1 POLE, 100AMP. FRAME, 50 AMP. NON-INTERCHANGEABLE TRIP INTERRUPTING RATING NEMA-10,000 AMP. AT 240 V.						
D	2	CONTROL CIRCUIT-CIRCUIT BREAKER. 1 POLE, 240 V., 100 AMP. FRAME, 15 AMP. NON-INTERCHANGEABLE TRIP INTERRUPTING RATING NEMA-5000 AMP. AT 240 V.						
E	1	ASTRONOMIC MICROPROCESSOR-BASED 2-CHANNEL CONTROLLER [TIME SWITCH].						
F	1	20 A., 120 V. FUSE.						
G	1	1.5 KVA, SINGLE PHASE, ENCAPSULATED TRANSFORMER 240 X 480 / 120 X 240 VOLT, 60 Hz.						
Н	1	SPST 20A SWITCH ON DOOR, TO TURN LIGHT ON WHEN Door is open,						
I	1	INCANDESCENT LIGHTING FIXTURE ENCLOSED AND GASKETED WITH 60 WATT, 120 V. LAMP.						
J	1	20 A., 120 V., DUPLEX RECEPTACLE, GFCI.						
К	1	COPPER GROUND BUS 1⁄4" (6.35) X 1" (25.4) X 12" (304.8 mm) LONG MOUNTED ON PANEL WITH LUGS AND 4 SPARE LUGS						
L	1	TOGGLE SWITCHES MOUNTED IN 4" (101.6) X 4" (101.6 mm) BOX.						
М	1	COPPER GROUND BUS $1/4$ " (6.35) X 1" (25.4) X 12" (304.8 mm) LONG MOUNTED ON PANEL WITH LUGS AND SPARE LUGS						

NOTES:

- 1. ALL DIMENSIONS ARE IN INCHES (MILLIMETERS) UNLESS OTHERWISE SHOWN.
- 2. FOUNDATION SIZE SHALL BE COORDINATED WITH CABINET SIZE AND MFR.
- IN FRONT OF CONTROL CABINE! DOUN, REMOVE
 VEGETATION AND 2" (50.8 mm) TOP SOIL, LEVEL THE
 AREA AND ON TOP, PLACE LENGTH WISE PARALLEL

 12. ALL WIRING WITHIN THE CABINET SHALL BE
 COLOR CODED AS INDICATED.

 RI = BLUE W = WHITE 3. IN FRONT OF CONTROL CABINET DOOR, REMOVE TO CONTROL CABINET, A CONCRETE PAD 36" (914.4 mm) \times 60" (18.288 m) \times 4" (101 mm) MIN. SIZE. THE COST OF LABOR AND MATERIALS ARE INCLUDED IN THE COST OF THE CONTROLLER.
- 4. DOOR SHALL BE CONSTRUCTED FROM SAME TYPE OF MATERIAL AND THICKNESS AS CABINET.
- 5. DOOR SHALL BE EQUIPPED WITH THREE POINT LATCHING MECHANISM WITH NYLON ROLLERS AT TOP THE BOTTOM.
- 6. DOOR HINGE SHALL BE A HEAVY GAUGE CONTINUOUS HINGE WITH A 1/4" (6.35 mm) DIA. STAINLESS STEEL HINGE PIN.
- 7. ALL EXTERNAL HARDWARE SHALL BE STAINLESS STEEL.
- 8. CONTROL WIRING TO BE #12 AWG, 600V, TYPE "SIS" GRAY SWITCH BOARD WIRE, STRANDED COPPER.
- 9. METER BOX SHALL BE MOUNTED ON THE SIDE OF CONTROL CABINET.

- 10. CABINETS SHALL BE PRIMED AND PAINTED GREEN, AS PER VILLAGE STANDARD.
- 11. THE HEADS OF CONNECTORS SCREWS SHALL BE PAINTED WHITE FOR NEUTRAL BAR CONNECTION AND GREEN FOR GROUND BAR CONNECTORS.
- BL = BLUE R = RED W = WHITE Y = YELLOW B = BLACK G = GREEN
- 13. PROVIDE SEALING GROMMETS FOR ALL OPEN WIRING EXTENDED FROM DEVICES IN BOXES OR CABINETS WITHIN THE CONTROL CABINET.
- 14. ALL WIRING SHALL BE NEATLY DRESSED AND SUPPORTED.
- 15. THE CONTROLLER SHALL BE CONSTRUCTED TO U.L. STD. 508 AND BEAR THE U.L. LABEL "ENCLOSED INDUSTRIAL CONTROL PANEL".


KNIGHT	
Engineers &	Architects


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	DRAWN	MLB	REVISED -
PLOT SCALE = 1:2	CHECKED	CBS	REVISED -
PLOT DATE = 8/17/2017	DATE	08/25/17	REVISED -


STATE OF ILLINOIS DEPARTMENT OF TRANSPORTATION

LIGHTING CONTROLLER, BASE MOUNTED, 480VOLT, 100AMP									
SCALE: AS SHOWN	SHEET NO.	OF	SHEETS	STA.	TO STA.				

∗FAI 5	5, 1	FAP	856	ILLINOIS	FED.	AID	PROJECT		
LT-53						CONTRACT	NO. 6	0X10	
*		(99-1HB-1) R-1				WILL	1508	980	
RTE.		SECTION					COUNTY	SHEETS	NO.

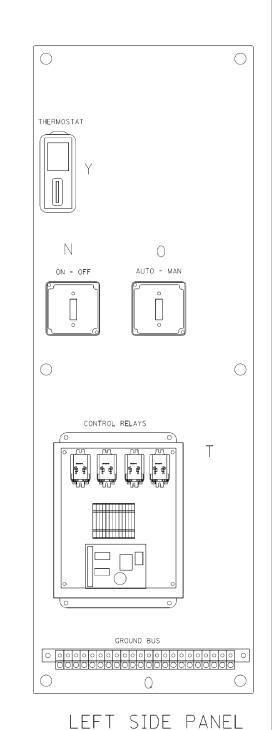

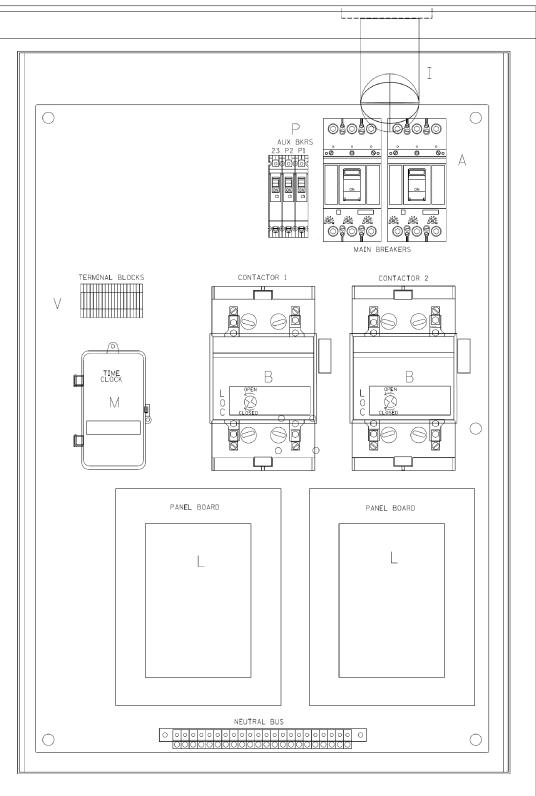

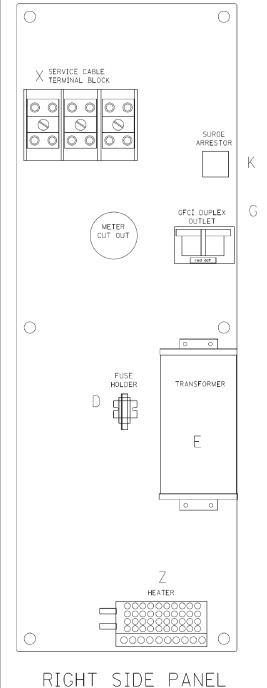



		BILL OF MATERIALS
ITEM *	QTY	DESCRIPITON
А	2	MAIN BREAKERS 2 POLE 200 AMP WITH AUX CONTACT
В	2	MECHANICAL CONTRACTOR 2 POLE 200 AMP 240V COIL WITH AUX CONTACTS
D	1	SECTIONAL FUSE HOLDER
E	1	2.0 KVA 277V-240/120 TRASFORMER
G	1	15 AMP GFCI
Н	2	DOOR SWITCH
I	1	LIGHT FIXTURE
J	1	METER FITTING 1 PHASE 3 WIRE 2CO AMP
К	1	SURGE ARRESTER
L	2	PANEL BOARD 480/240V 1 PHASE, 250 AMP COPPER BU
М	1	2 CHANNEL DIGITAL TIME CLOCK
N	1	MOMENTARY SWITCH ON - OF
0	1	DPDT 20 AMP AUTO-MANUAL
P1	1	BREAKER 1P 15A
P2	1	BREAKER 1P 15A
P3	1	BREAKER 1P 15A
Q	2	COPPER GROUND AND NEUTRAL BUS 1 X 16 X 1/4
Т	1	CONTROL RELAY ASSEMBLY 240V COILS WITH OPDT 25 AMP RELAYS (R1,R2,R3,R4). MOMENTARY CONTACT ADAPTER. GTY 12 TERMINAL BLOCKS
٧	20	TERMINAL BLOCKS
X	1	620 AMP SPLICE BLOCK
Υ	1	CHROMALOX WR 80, 40-80 DEG THERMOSTAT
Z	1	HEATREX 276-10 375 WATT HEATER


KNIGHT
Engineers & Architects


USER NAME = mbalog	DESIGNED	MLB	REVISED -	Γ
	DRAWN	MLB	REVISED -	١
PLOT SCALE = 1:2	CHECKED	CBS	REVISED -	١
PLOT DATE = 8/17/2017	DATE	08/25/17	REVISED -	l


STATE OF ILLINOIS
DEPARTMENT OF TRANSPORTATION

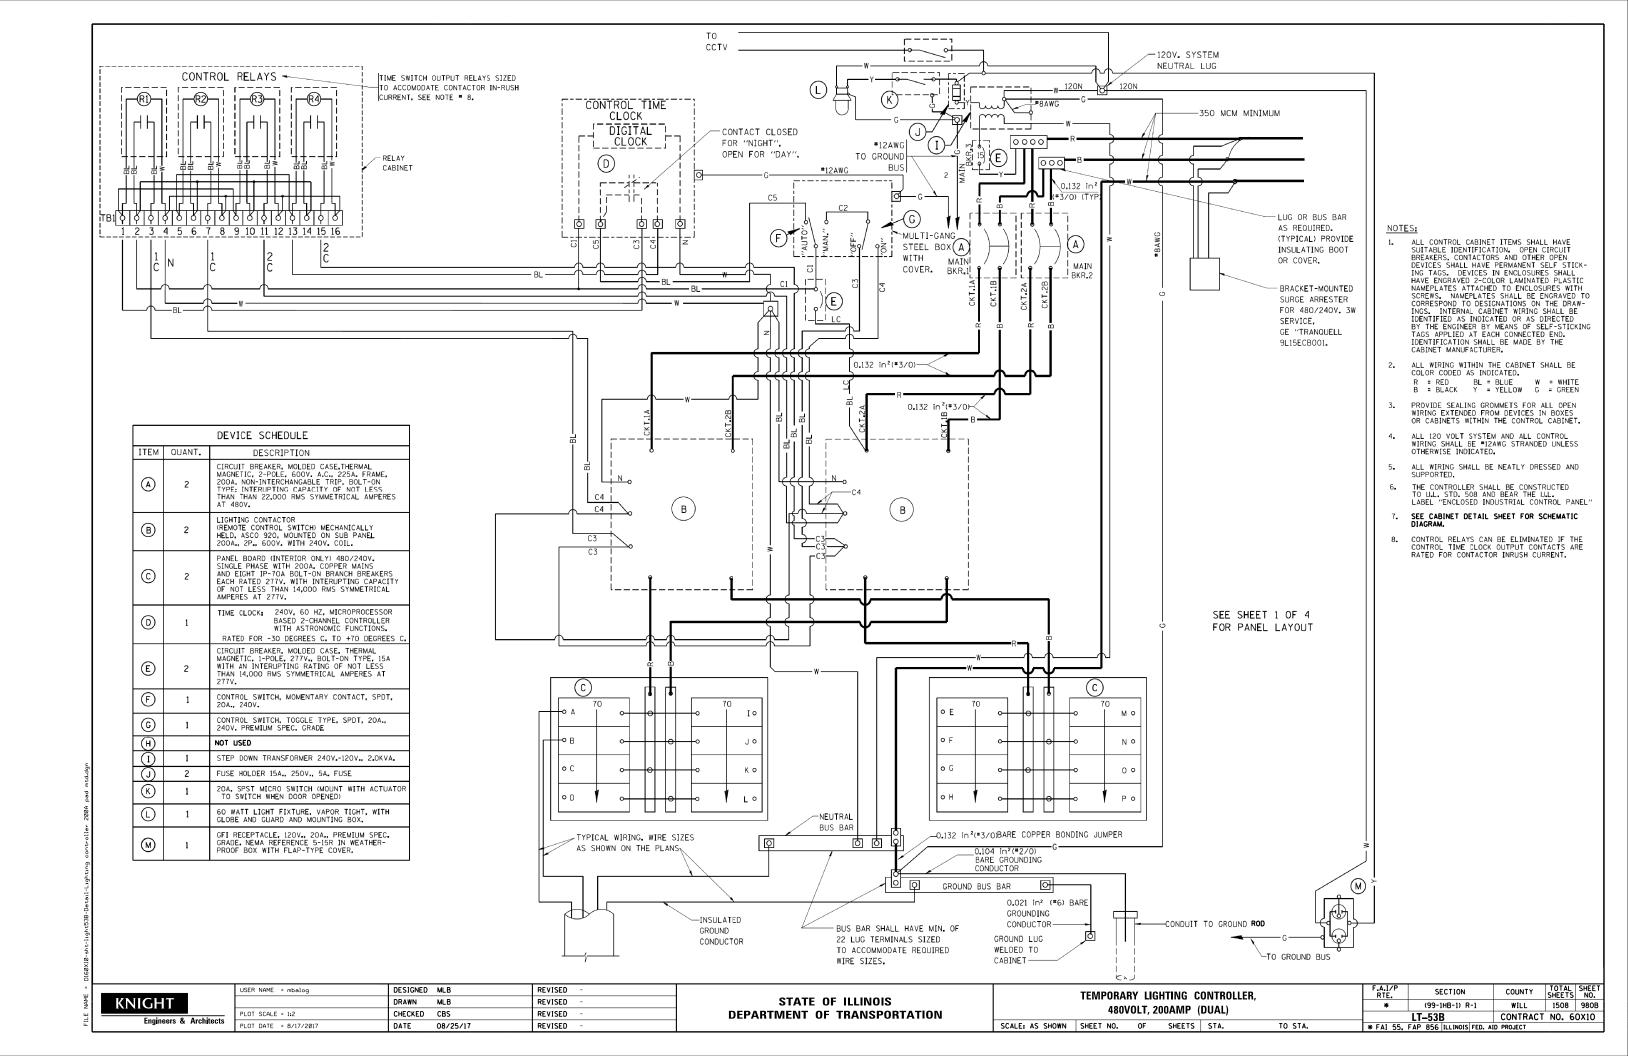

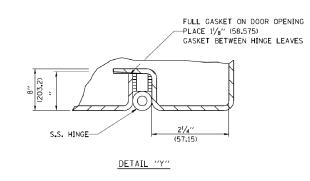


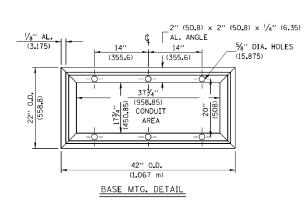

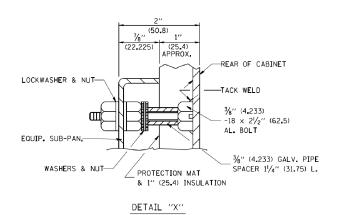


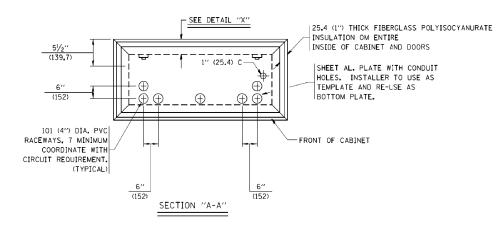

DETAIL "Z"

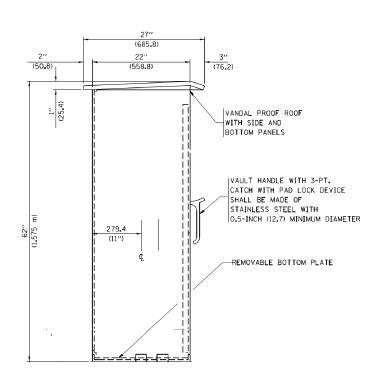

LEFT SIDE ELEVATION

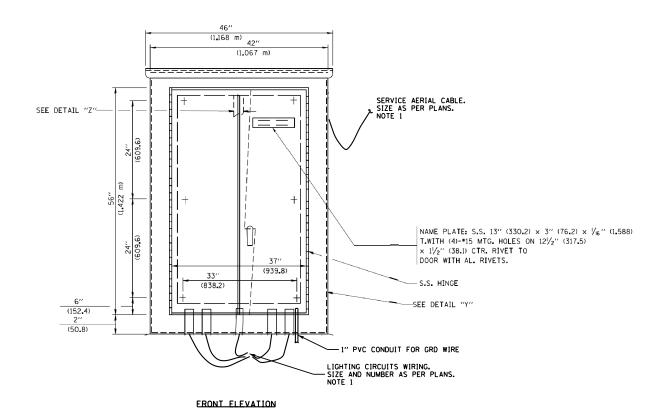

NOTES:

1. CABLE ENTRANCE INTO THE CABINET SHALL BE SEALED AT ALL TIMES.

1/8" (3**.**175)

NEOPRENE RUBBER GASKET

MATCH OPENINGS INTO THE WOOD PLATFORM SHOWN ON SHT. LT-54 TO THE OPENINGS INTO THE CABINET BASE.

KNI	GHT		
	Engineers	&	Architects

	USER NAME = mbalog	DESIGNED	MLB	REVISED	-
		DRAWN	MLB	REVISED	-
Architects	PLOT SCALE = 1:2	CHECKED	CBS	REVISED	-
	PLOT DATE = 8/17/2017	DATE	08/25/17	REVISED	-

STATE OF ILLINOIS **DEPARTMENT OF TRANSPORTATION**

TEMPORARY LIGHTING CONTROLLER, 480VOLT, 200AMP (DUAL)							SECTION	
							(99-1HB-1) R-1	
		LT-53C						
SCALE: AS SHOWN	SHEET NO.	OF	SHEETS	STA.	TO STA.	* FAT 55.	FAP 856 ILLINOIS FED.	

COUNTY TOTAL SHEET NO.
WILL 1508 980C CONTRACT NO. 60X10

- 1. CABINET SHALL BE FABRICATED FROM 0.125-INCH (3.175) SHEET ALUMINUM #3003H14, FORMED AND ARC WELDED ASSEMBLY.
- 2. ALL SCREWS AND HARDWARE SHALL BE PLATED, GALVANIZED, OR MADE OF BRASS, ALUMINUM OR STAINLESS STEEL.
- 3. NAME PLATE SHALL HAVE ENGRAVED 0.75-INCH (19.05) HIGH LETTERS FILLED IN BLACK: "STATE OF ILLINOIS LIGHTING CONTROLS" UNLESS OTHERWISE SPECIFIED.
- 4. NOT USED.
- 5. NOT USED.
- 6. NOT USED.
- 7. THE COMPLETED CONTROLLER SHALL BE U.L. LISTED AS AN INDUSTRIAL CONTROL PANEL UNDER UL508.
- 8. METAL MOUNTING PANEL SHALL BE #10 GAUGE GALVANIZED SHEET STEEL FLANGED BACK 0.75-INCHES I.D. ON 4 SIDES.
- 9. CIRCUIT BREAKERS AND CONTACTORS AND OTHER COMPONENTS SHALL BE MOUNTED ON 0.125-INCH (3.175) THICK GLASTIC INSULATION BACK PANEL.
- 10. ALL DEVICES SHALL BE FRONT REMOVABLE.
- 11. TIME CLOCK CHANNEL 1 N.O. CONTACT IS CLOSED NIGHT AND OPEN DAY.
- 12. SET "ON TIME" TO 30 MINUTES AFTER ASTRONOMICAL SUNSET.
- 13. BUS BAR SHALL HAVE 22 LUG TERMINALS SIZED TO ACCOMMODATE REQUIRED WIRE SIZES.

 NEUTRAL BUS SHALL BE PAINTED WHITE.

 GROUND BUS SHALL BE PAINTED GREEN.
- 14. ALL LUGS SHALL BE OF COPPER SCREWS AND CONNECTORS, SPRING HELD.
- 15. ALL WIRING TERMINATIONS SHALL BE RATED NOT LESS THAN 75 DEGREE CENTIGRADE.
- 16. ALL CONTROL WIRING SHALL BE 600V MACHINE TOOL WIRE TYPE MTW.
- 17. ALL POWER WIRING SHALL BE 600V TYPE RHH/RHW.
- 18. ALL WIRING WITHIN THE CABINET SHALL BE COLOR CODED AS INDICATED:


R - RED Y - YELLOW
B - BLACK W - WHITE
BL- BLUE G - GREEN

- 19. ALL DIMENSIONS ARE IN MILIMETERS (INCHES) UNLESS OTHERWISE INDICATED.
- 20. SCHEMATIC SHOWN WITH BREAKER OPEN, CONTACTOR OPEN, CABINET DOOR CLOSED, CLOCK NOT ACTIVE.
- 21. A LAMINATED COPY OF THE CIRCUIT SCHEMATIC SHALL BE ATTACHED TO THE INSIDE OF THE CONTROLLER.

KNIGHT	
Engineers &	Architects

	USER NAME = mbalog	DESIGNED	MLB	REVISED	-
		DRAWN	MLB	REVISED	-
-	PLOT SCALE = 1:2	CHECKED	CBS	REVISED	-
\$	PLOT DATE = 8/17/2017	DATE	08/25/17	REVISED	-

STATE OF ILLINOIS
DEPARTMENT OF TRANSPORTATION

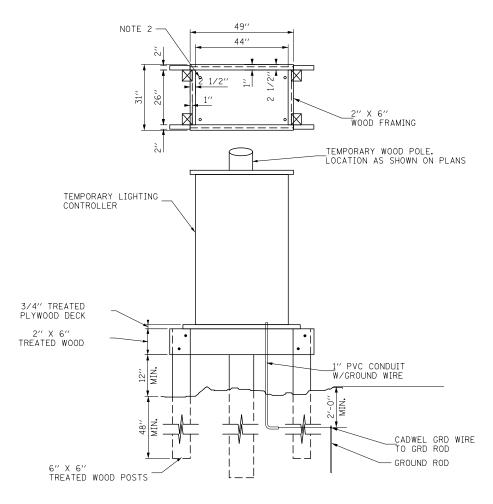

- BASED ON LIGHTING CONTROLLER CABINET, ADJUST PLATFORM SIZE TO FIT BASE DIMENSIONS.
- 2. DRILLED HOLES THROUGH THE PLATFORM BASE TO MATCH THE CONTROLLER CABINET BOLT TEMPLATE, FASTEN THE CONTROLLER CABINET TO THE PLATFORM WITH CARRIAGE BOLTS, WASHERS AND NUTS.
- 3. FASTEN ALL SUPPORT WOOD FRAMING TO THE WOOD POSTS WITH 2 LAG SCREWS FOR EACH CONNECTION.

TEMPORARY LIGHTING CONTROLLER GROUND MOUNTED WOOD SUPPORT PLATFORM DETAIL

KNIGHT	
Engineers &	Architect

	USER NAME = dbarnes	DESIGNED	MLB	REVISED -	
		DRAWN	MLB	REVISED -	
	PLOT SCALE = 1:2	CHECKED	CBS	REVISED -	
	PLOT DATE = 8/17/2017	DATE	08/25/17	REVISED -	
_		-			-

STATE OF ILLINOIS **DEPARTMENT OF TRANSPORTATION**

	TEMPORAI	RY LIG	SHTING C	F.A.I/P RTE.	SECTION	COUNTY	TOTAL SHEETS	SHEET NO.		
DETAILS							(99-1HB-1) R-1	WILL	1508	981
			LIAILS		LT-54	CONTRACT	NO. 6	0X10		
SCALE: AS SHOWN	SHEET NO.	OF	SHEETS	STA.	TO STA.	* FAI 55,	FAP 856 ILLINOIS FED. A	ID PROJECT		

Illinois Depar of Transporto Olivision of Highways OSC CONSULTANTS INC.	ition				SOIL BORING	G LOG		Page Date	10/	01 '17/'
ROUTE Weber Road Normantown Road to 1	DESCRIP 35th			·	ed Weber Road & I-55	•	LOGGED			JH
SECTION Street/Romeo Road COUNTY Will County DRIL			, N	<u>Latitu</u>	ad Sign, SEC. , TWP. , de , Longitude HSA	HAMMER TYPE		A	UTO	
STRUCT. NO. NA	D E P T H - (ff)	B L O W S (/6")	U C S Qu (tsf)	M 0 1 S T	Surface Water Elev. Stream Bed Elev. Groundwater Elev.: First Encounter Upon Completion After NA Irs. Very Stiff to Hard Gray, Moist	NA ft None ft None ft NA ft	D E P T H	B L O W S	U C S Qu (tsf)	M 0 1 S T (%
Brown, Moist FILL: SILTY CLAY, with sand		2 3 4	2.0 P	21	SILTY CLAY (CL/ML) (continued)		9 9 9		NF
		4 4 5	2.3 P	16				3 7 7	3.0 P	20
Hard Brown, Moist SILTY CLAY, with sand and gravel (CL/ML)	657.00 — —	5 9 9		8				3 4 6	2.1 B	20
		8 9 9	4.5 P	18			-30	4 3 5	2.3 B	22
Hard Brown, Moist SILTY CLAY (CL/ML)	552.00 — —	7 8 10	4.6 B	20						
		12 16 16	6.5 P	16			-35	5 7 10	4.5 P	16
Very Stiff to Hard Gray, Moist SILTY CLAY (CL/ML)	647.00	4 6 9	2.7 B	16						
	-20	4 6 9	2.9 B	17			5.00 -40	3 6 8	3.5 B	18

KNIGHT Engineers & Architects

_	USER NAME = dbarnes	DESIGNED	GSG	REVISED	-
		DRAWN	PAW	REVISED	-
	PLOT SCALE = 1:2	CHECKED	CBS	REVISED	-
	PLOT DATE = 8/17/2017	DATE	08/25/17	REVISED	-

HIGH MAST TOWER FOUNDATION SOIL BORING LOGS							F.A.I/P RTE.	SECTION	COUNTY	TOTAL SHEETS	SHEET NO.
							*	(99-1HB-1) R-1	WILL	1508	982
								LT-55	CONTRACT	NO. 6	0X10
CALE: NONE	SHEET	NO. (OF SH	HEETS	STA. T	O STA.	* FAI 55, FAP 856 ILLINOIS FED. AID PROJECT				

The Unconfined Compressive Strength (UCS) Failure Mode is indicated by (B-Bulge, S-Shear, P-Penetrometer) The SPT (N value) is the sum of the last two blow values in each sampling zone (AASHTO T206) BBS, form 137 (Rev. 8-99)


Page $\underline{1}$ of $\underline{1}$ Illinois Department **SOIL BORING LOG** of Transportation Date ___1/14/16__ DESCRIPTION Proposed Weber Road & I-55 Improvements LOGGED BY NE ROUTE Weber Road COUNTY Will County DRILLING METHOD AUTO D B U C P O S T W H S Qu STRUCT, NO. Surface Water Elev. T W H S Qu BORING NO. ___ (ft) (/6") (tsf) (%) 10 inches of Asphalt 8 inches of Sand and Gravel Brown and Gray, Moist FILL: SILTY CLAY, trace gravel 669.40 Brown and Gray, Moist FILL: SILTY CLAY LOAM, with gravel Brown and Gray, Moist Black and Brown, Moist
SILTY CLAY, trace gravel
(CL/ML)
Pushed cobble from 23.5 to 25 ft FILL: SILTY CLAY, with gravel 12 1.5 12 P Medium Stiff to Hard Brown and Gray Moist 2.0 21 Brown, Moist SILTY CLAY, trace gravel (CL/ML) FILL: SILTY CLAY, trace gravel 10 Very moist at 33.5 ft End of Boring Pushed cobble from 18.5 to 20 ft


The Unconfined Compressive Strength (UCS) Failure Mode is indicated by (B-Bulge, S-Shear, P-Penetrometer) The SPT (N value) is the sum of the last two blow values in each sampling zone (AASHTO T206) BBS, form 137 (Rev. 8-99)


				_
USER NAME = dbarnes	DESIGNED	GSG	REVISED -	
	DRAWN	PAW	REVISED -	
PLOT SCALE = 1:2	CHECKED	CBS	REVISED -	
PLOT DATE = 8/17/2017	DATE	08/25/17	REVISED -	


				F.A.I/P RTE.	SECTION	COUNTY	TOTAL SHEETS	SHEET NO.		
HIGH	MASI TOV	VEK F	OUNDATIC	L BORING LOGS	*	(99-1HB-1) R-1	WILL	1508	983	
							LT-56	CONTRACT	NO. 6	0X10
SCALE: NONE	SHEET NO.	OF	SHEETS	STA.	TO STA.	* FAI 55, FAP 856 ILLINOIS FED. A		ID PROJECT		


KNIGHT		
Engineers &	Architects	

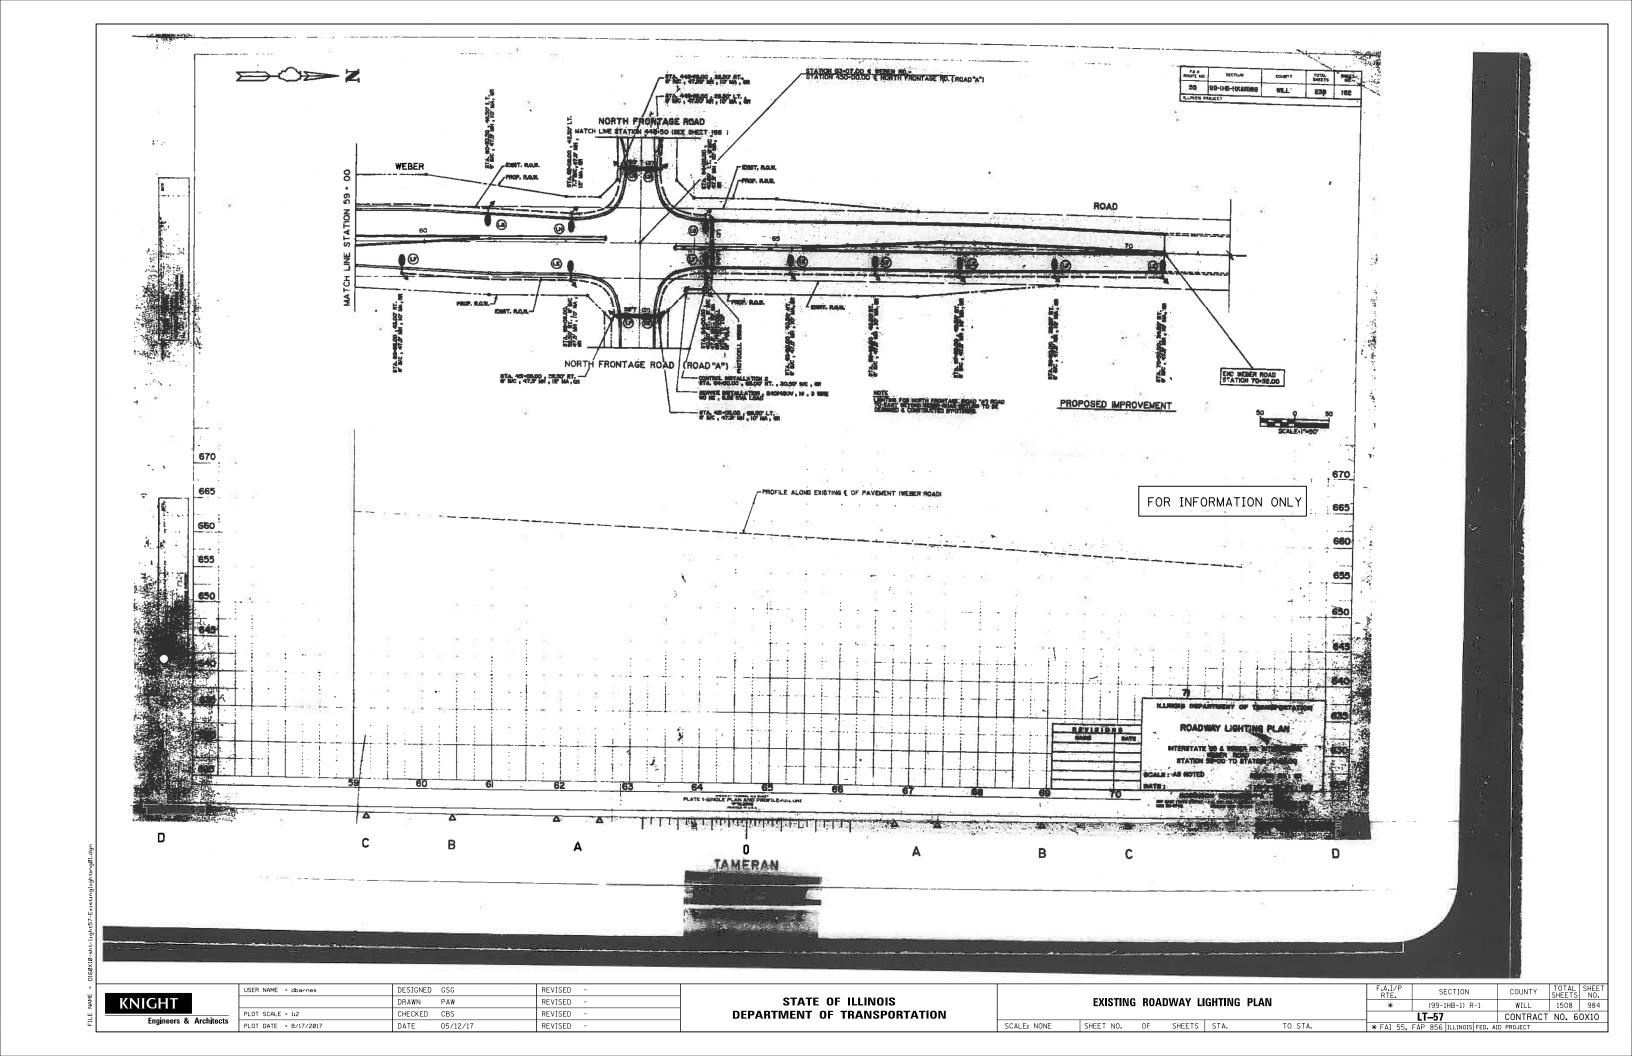

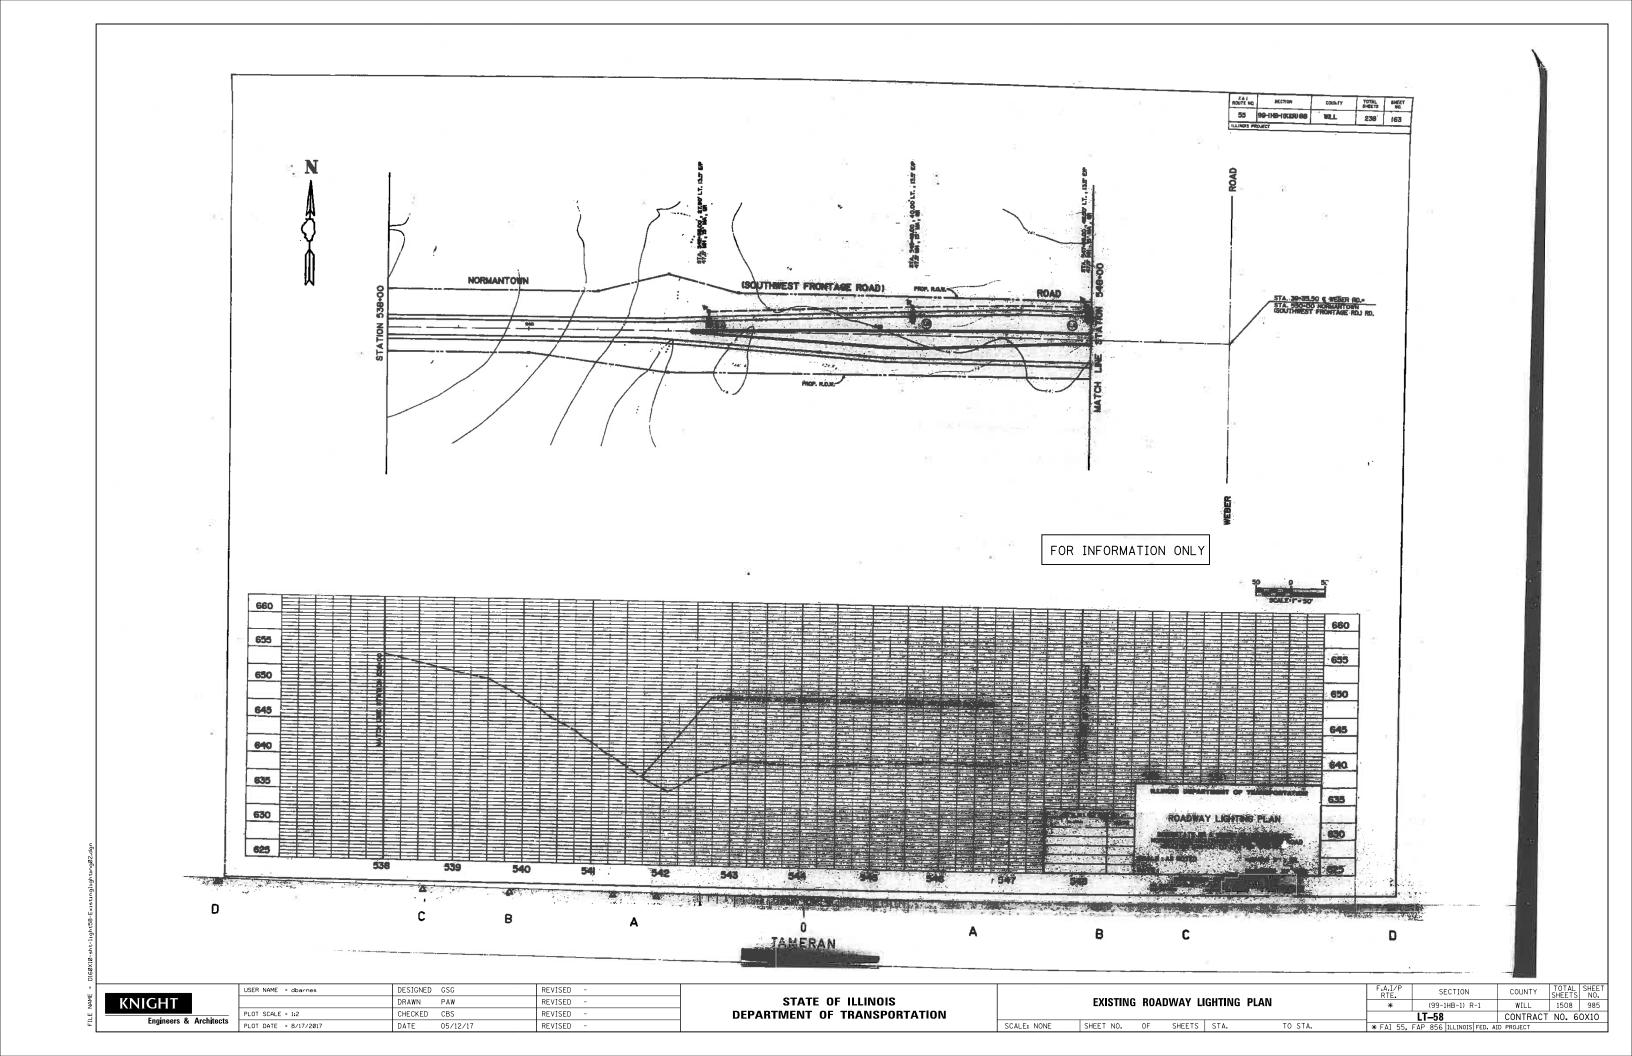

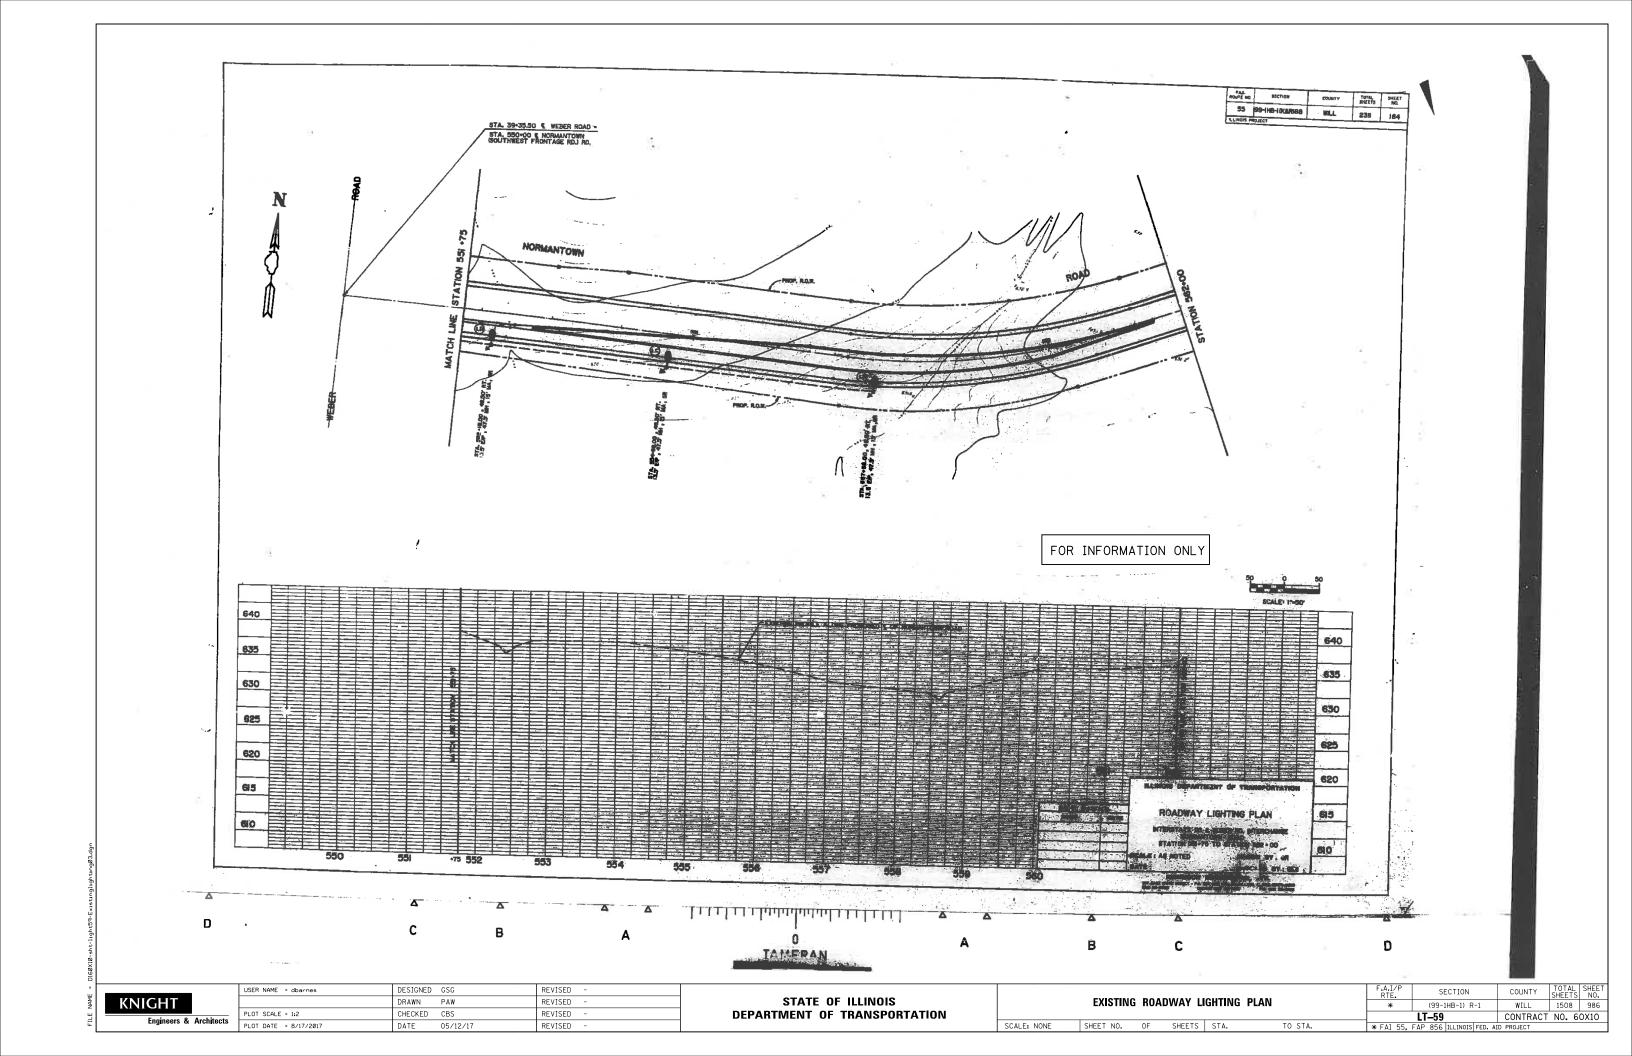

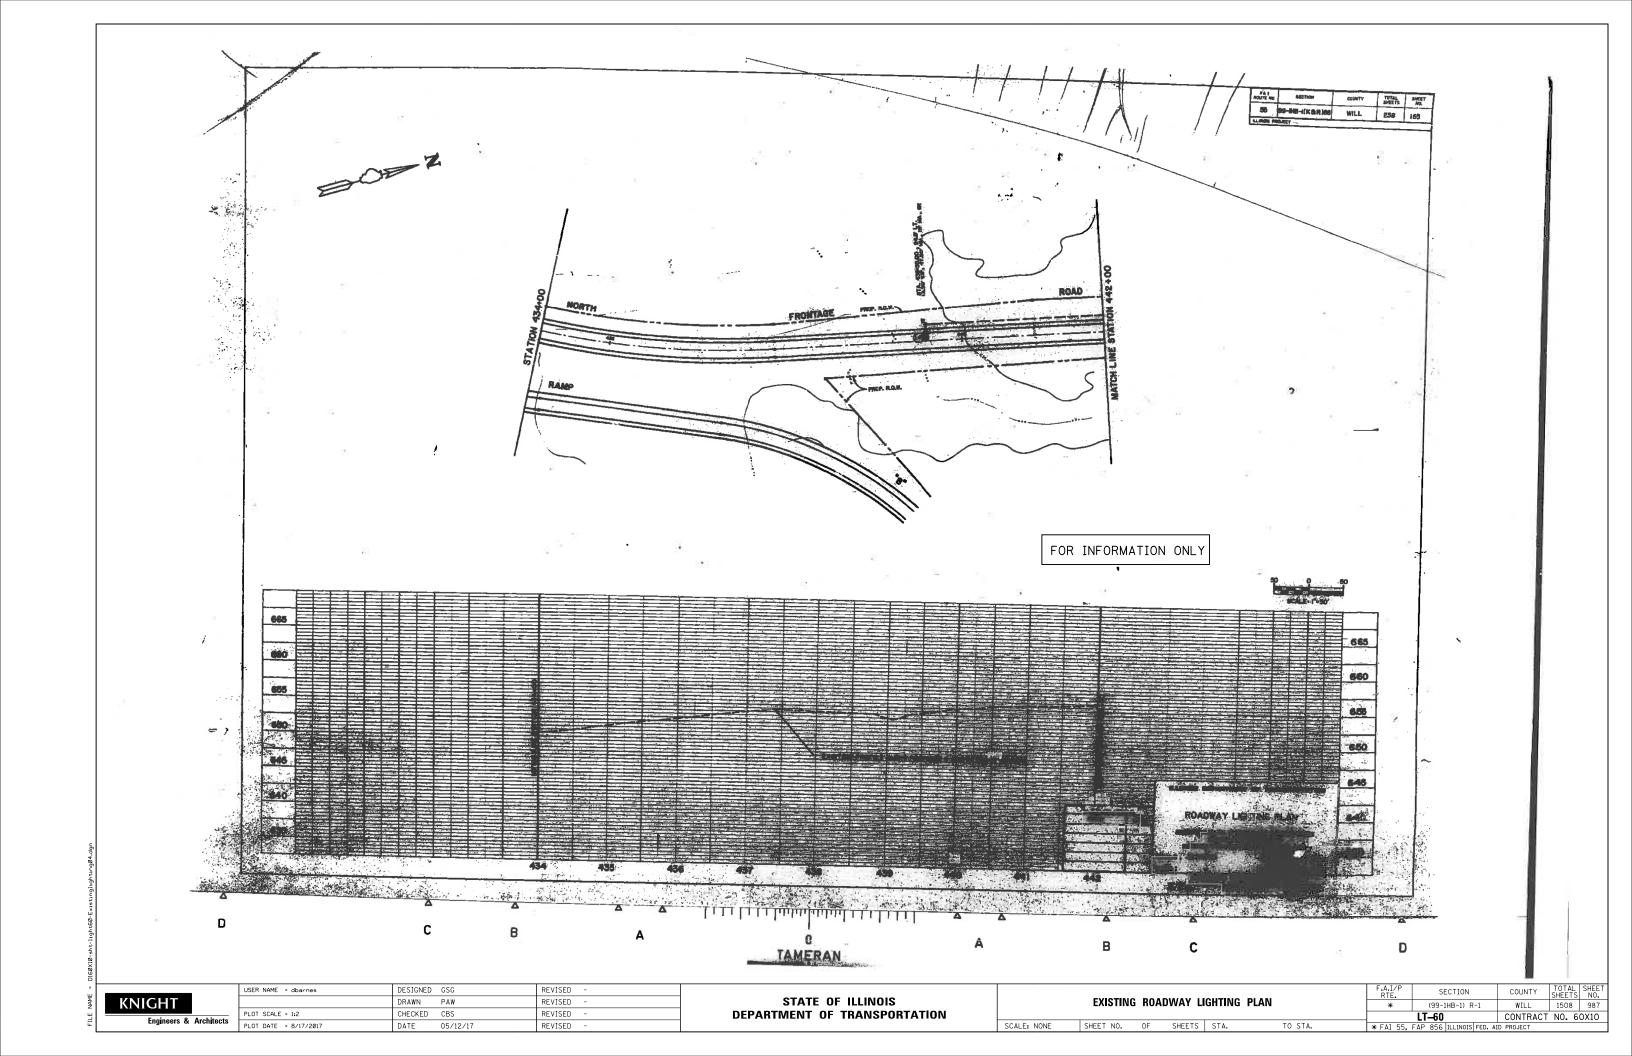

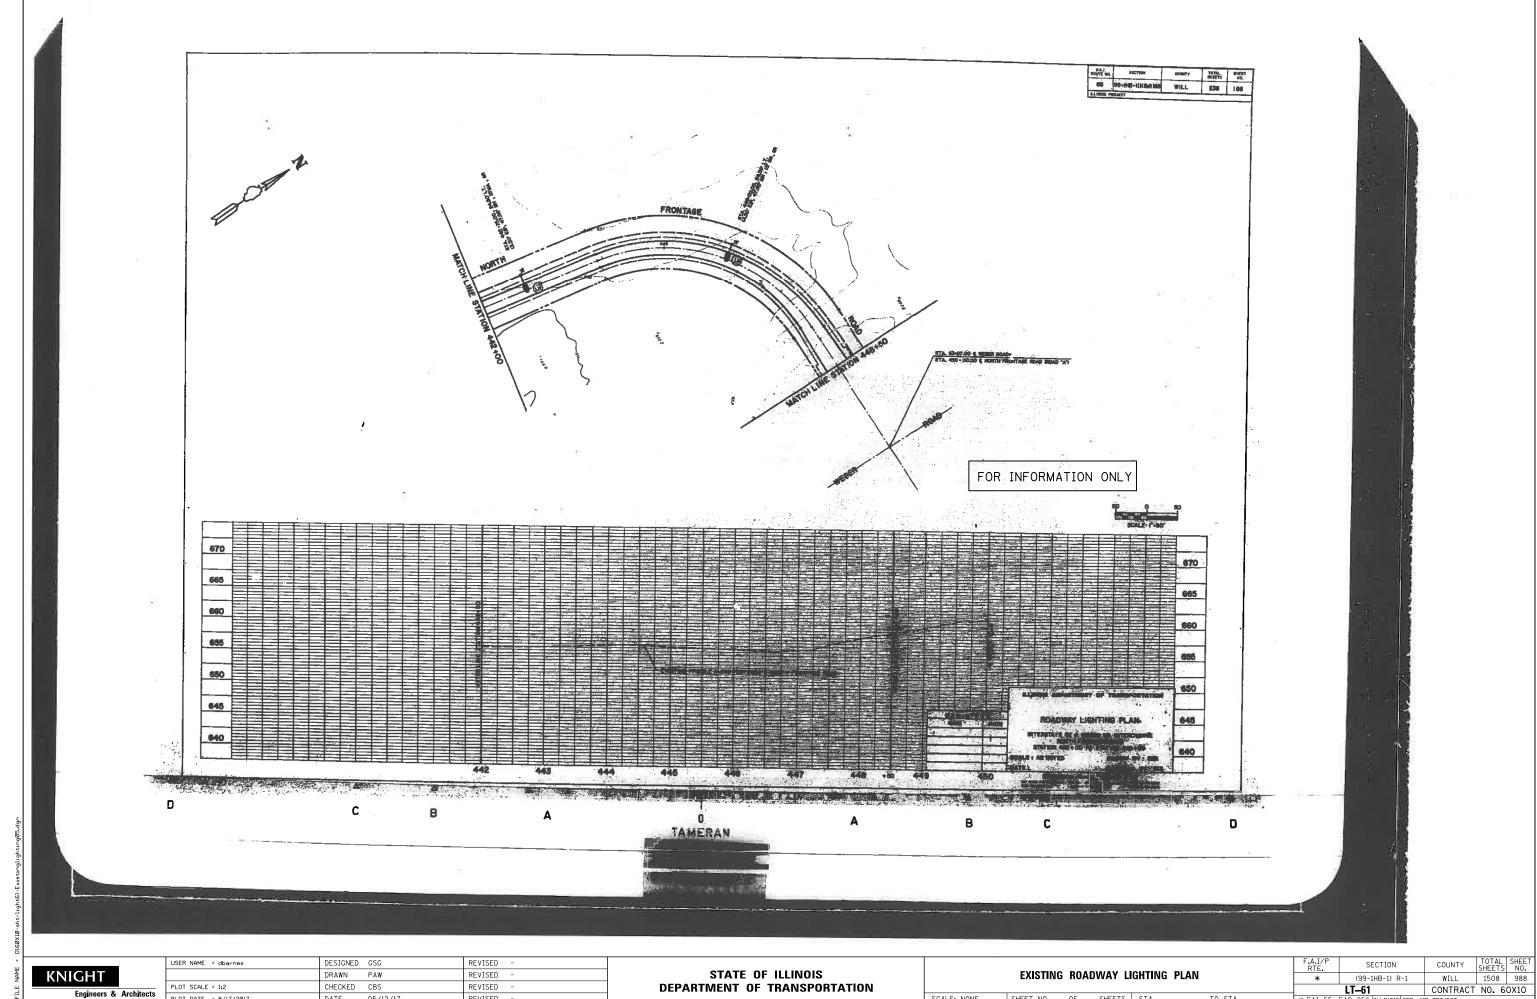


CHECKED CBS REVISED PLOT DATE = 8/17/2017 DATE 05/12/17 REVISED

DEPARTMENT OF TRANSPORTATION

SCALE: NONE SHEET NO. OF SHEETS STA.

LT-61 * FAI 55, FAP 856 I

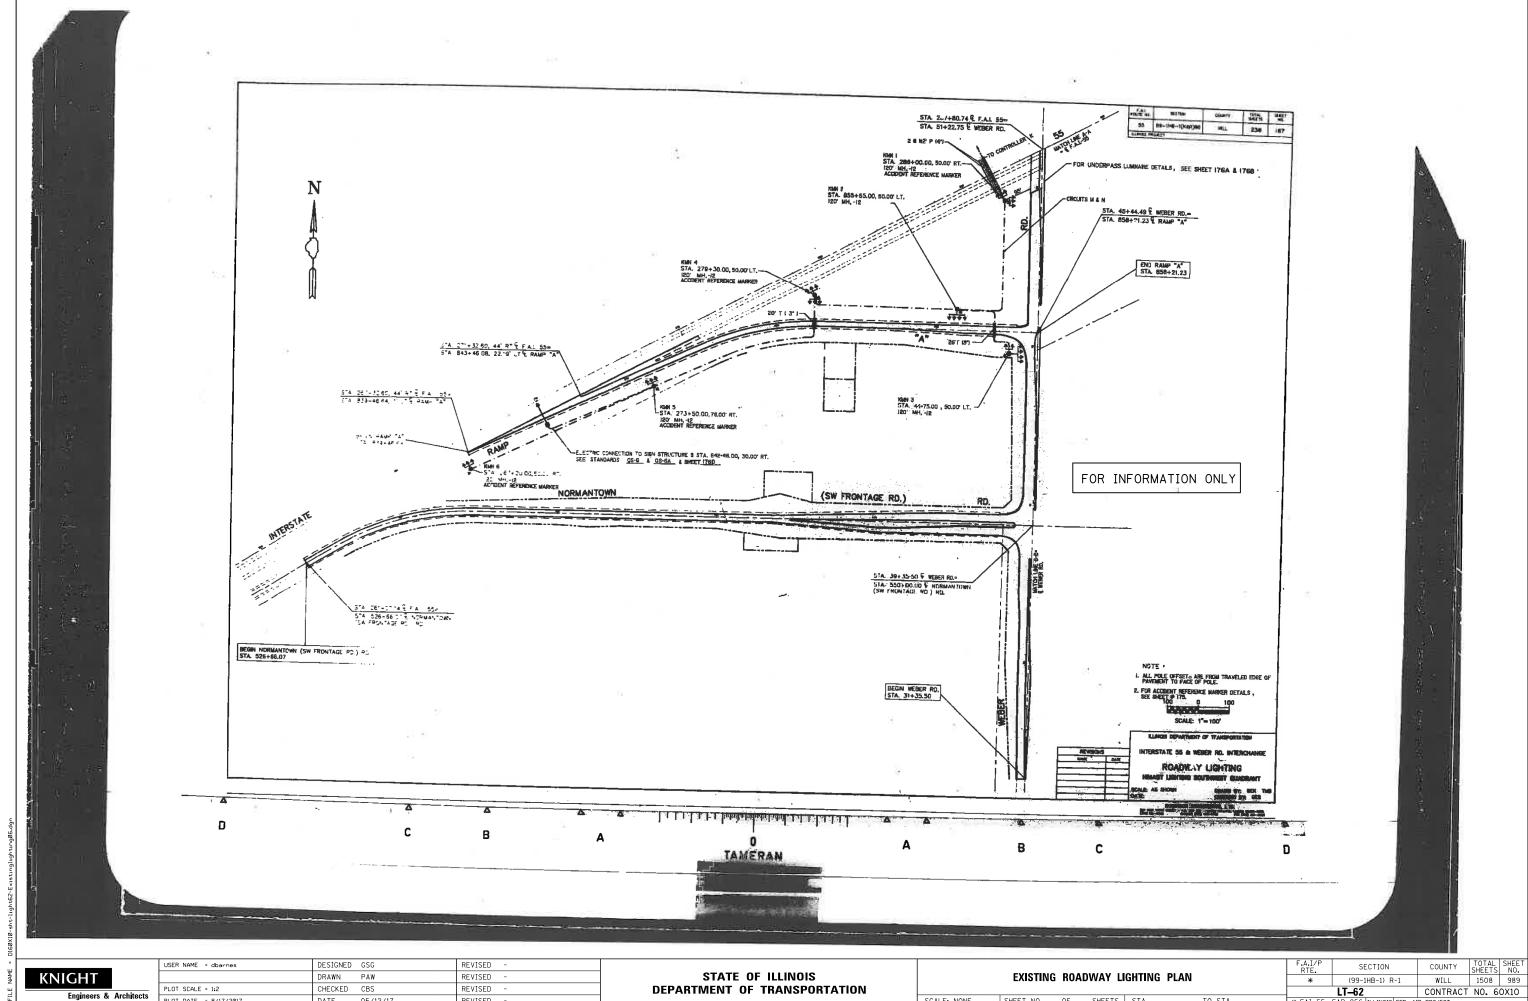


CHECKED CBS REVISED PLOT DATE = 8/17/2017 DATE 05/12/17 REVISED

DEPARTMENT OF TRANSPORTATION

SHEET NO. OF SHEETS STA.

SCALE: NONE

* LT-62 * FAI 55, FAP 856 I

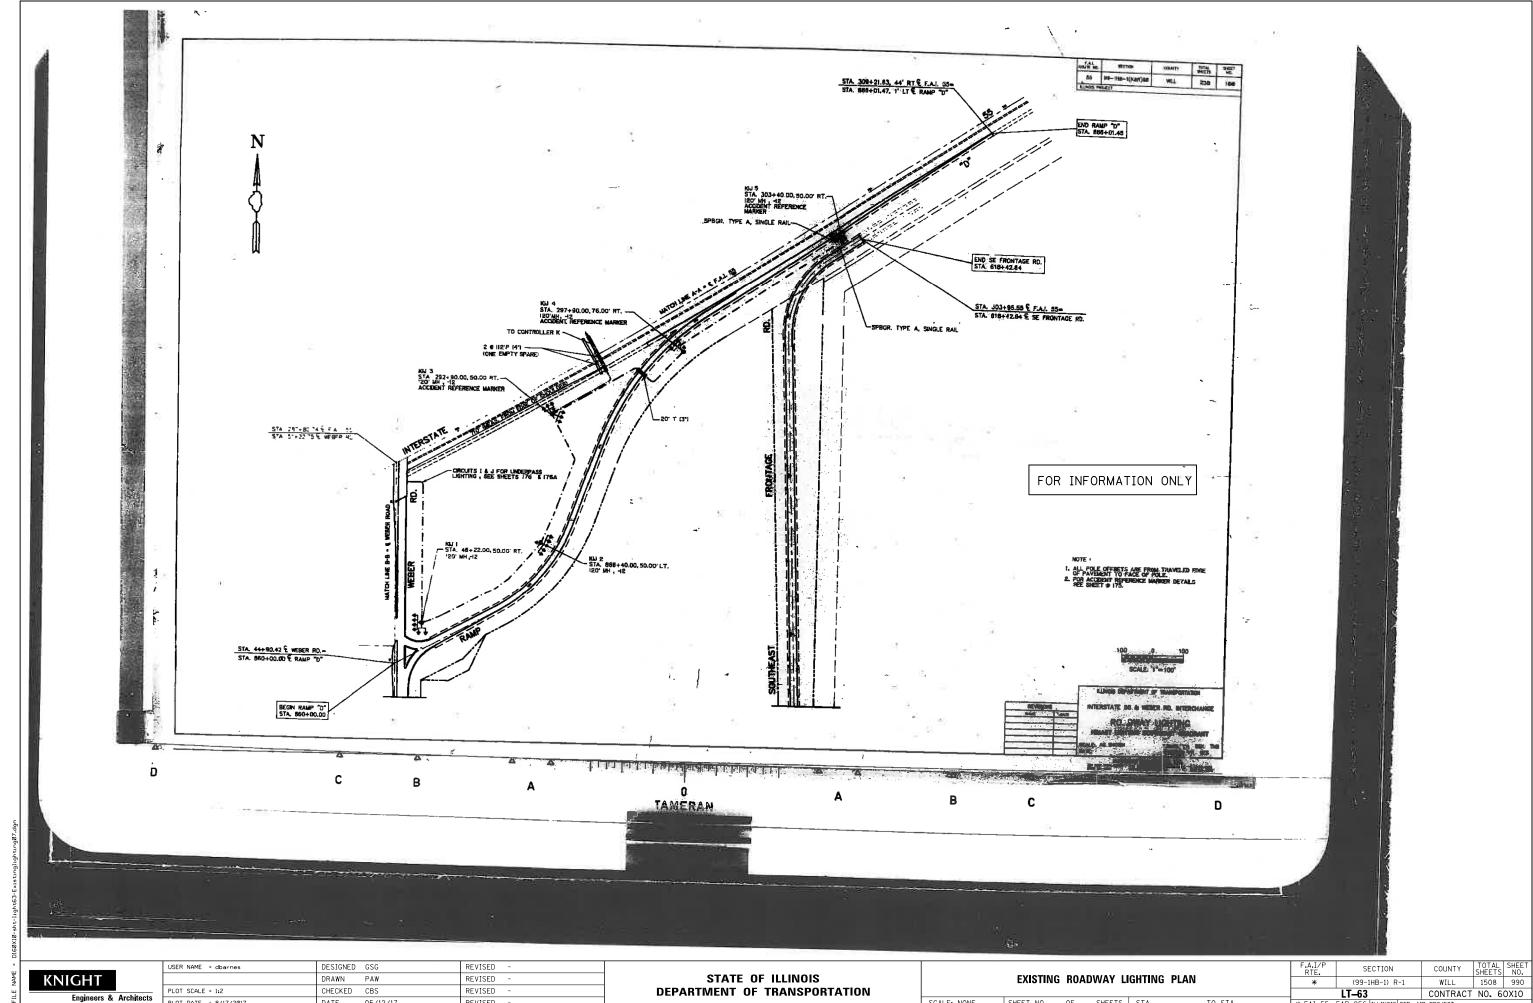

CHECKED CBS REVISED PLOT DATE = 8/17/2017 DATE 05/12/17 REVISED

DEPARTMENT OF TRANSPORTATION


SHEET NO. OF SHEETS STA.

SCALE: NONE

* (99-1HB-1) R-1

LT-63

* FAI 55, FAP 856 | ILLINOIS | FED.

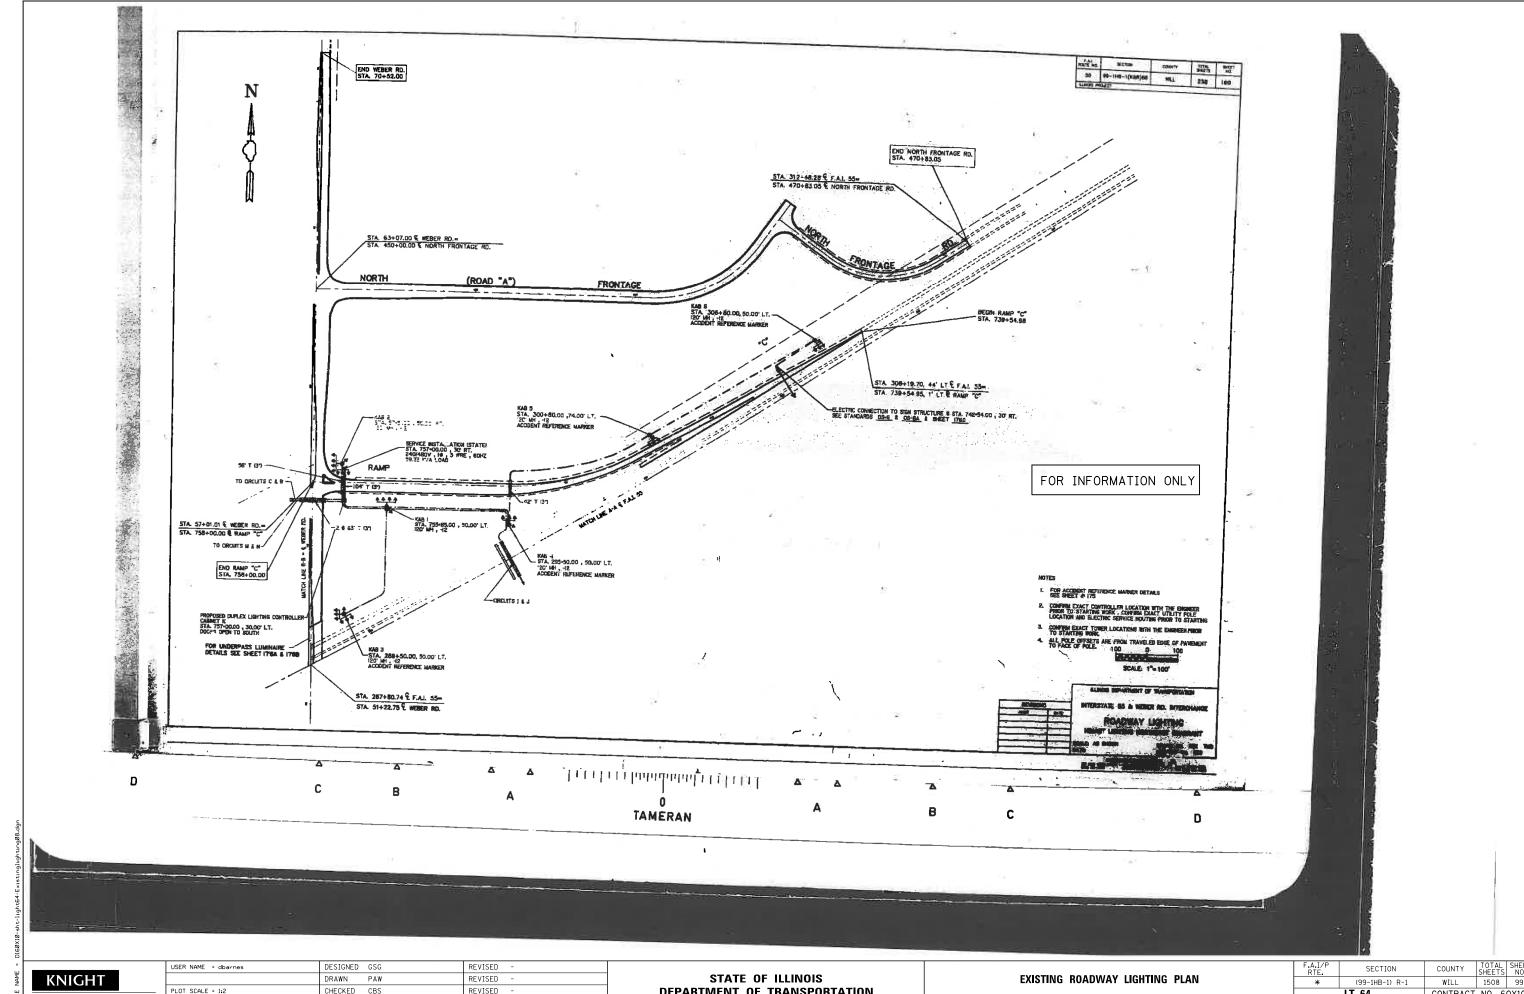


CHECKED CBS REVISED PLOT DATE = 8/17/2017 DATE 05/12/17 REVISED

DEPARTMENT OF TRANSPORTATION

SCALE: NONE SHEET NO. OF SHEETS STA.

COUNTY TOTAL SHEET NO.
WILL 1508 991
CONTRACT NO. 60X10 LT-64 , FAP 856 I

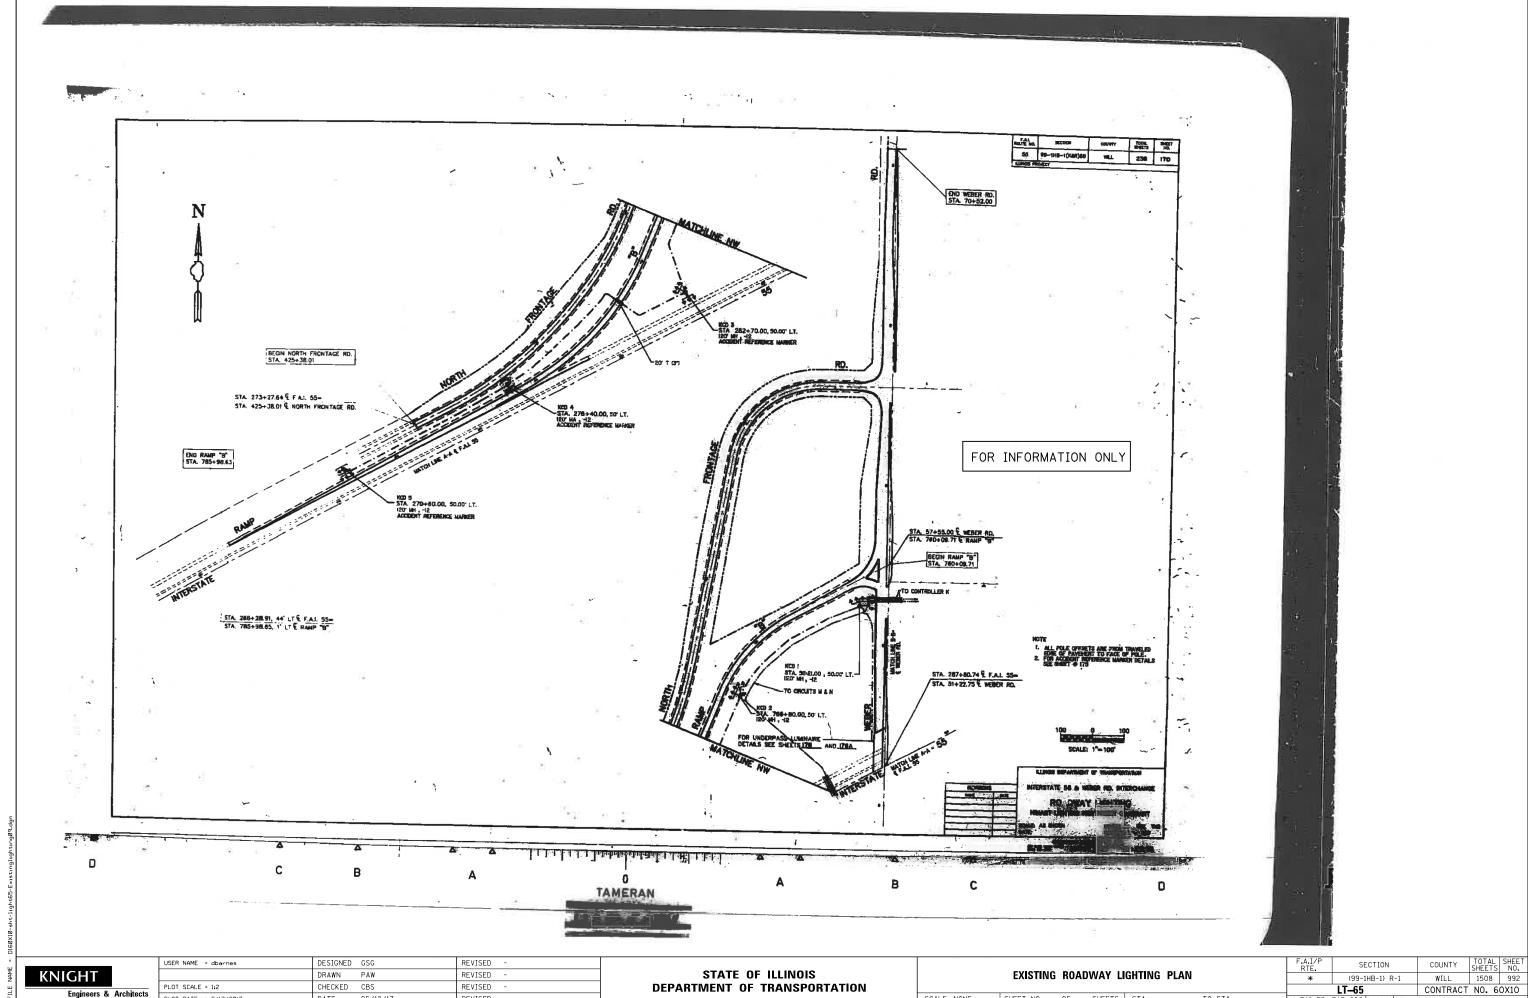


CHECKED CBS REVISED PLOT DATE = 8/17/2017 DATE 05/12/17 REVISED

DEPARTMENT OF TRANSPORTATION

SCALE: NONE SHEET NO. OF SHEETS STA.

* LT-65 * FAI 55, FAP 856 II

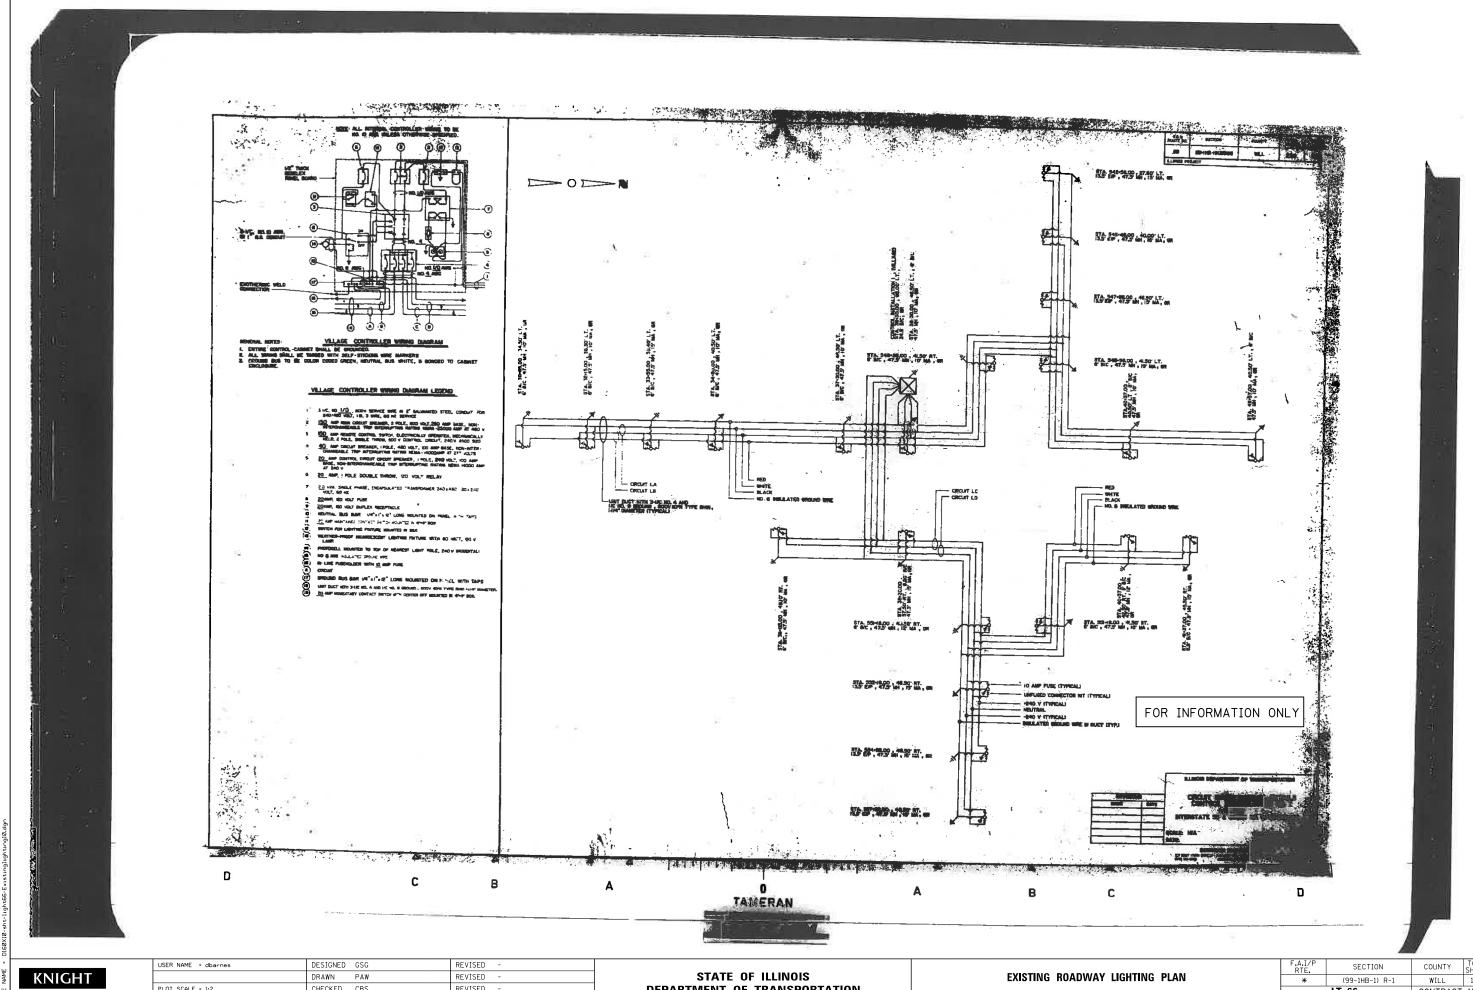


PLOT SCALE = 1:2 CHECKED CBS REVISED PLOT DATE = 8/17/2017 DATE 05/12/17 REVISED

DEPARTMENT OF TRANSPORTATION

SCALE: NONE SHEET NO. OF SHEETS STA.


COUNTY TOTAL SHEET NO. WILL 1508 993 LT-66 CONTRACT NO. 60X10

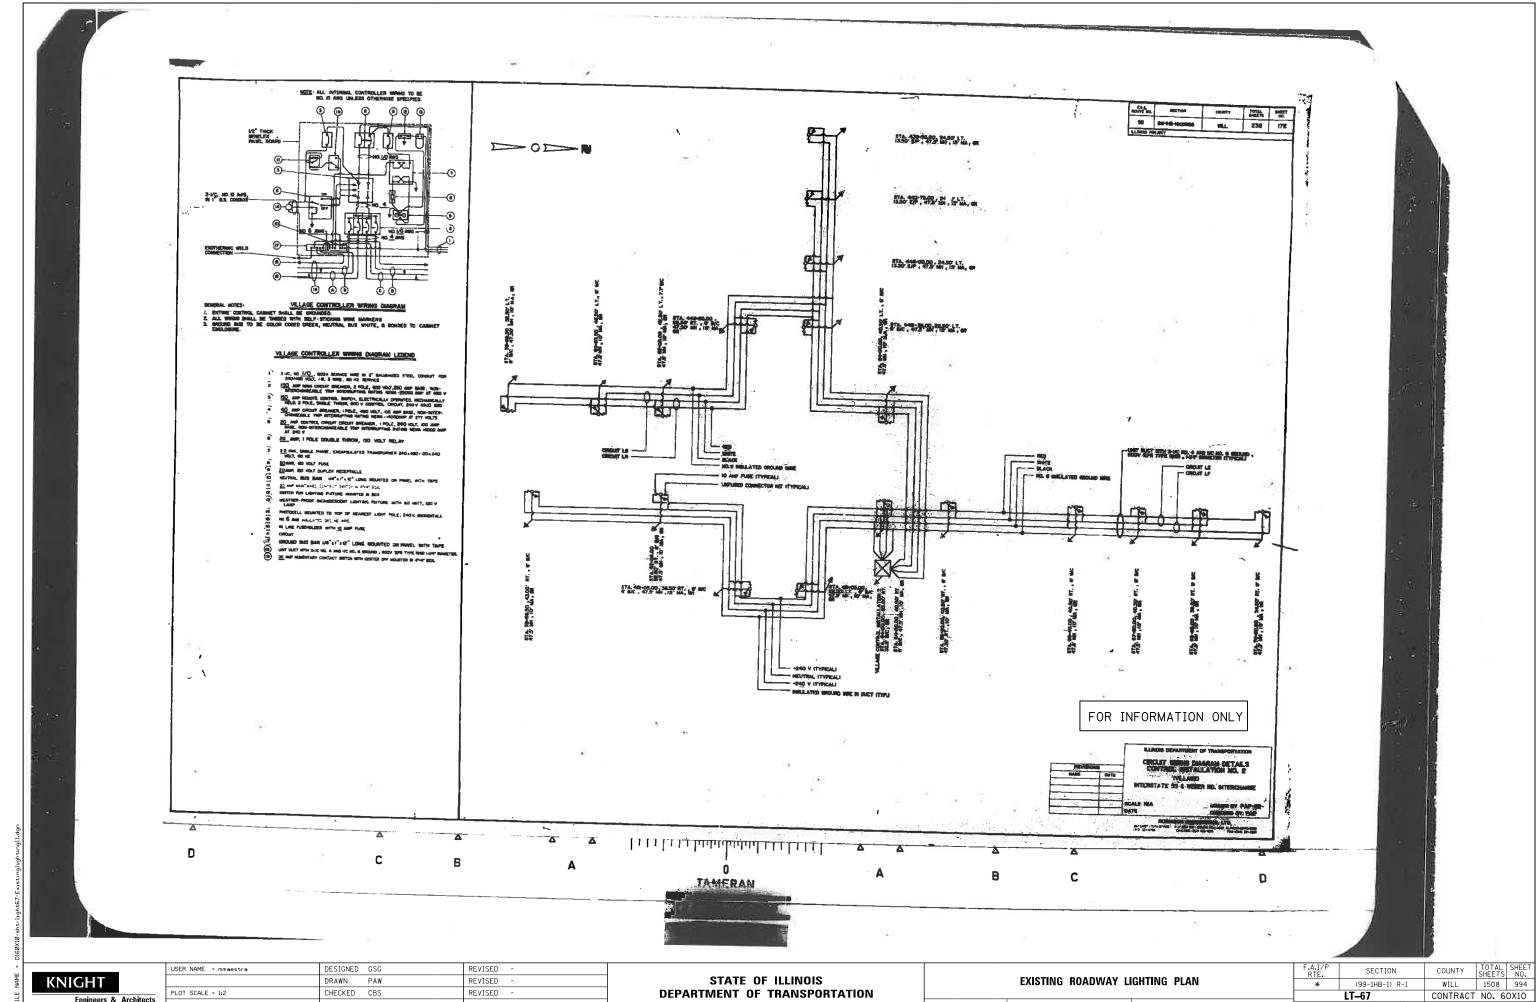


PLOT DATE = 5/13/2017 DATE 05/12/17 REVISED

SCALE: NONE SHEET NO. OF SHEETS STA.

LT-67

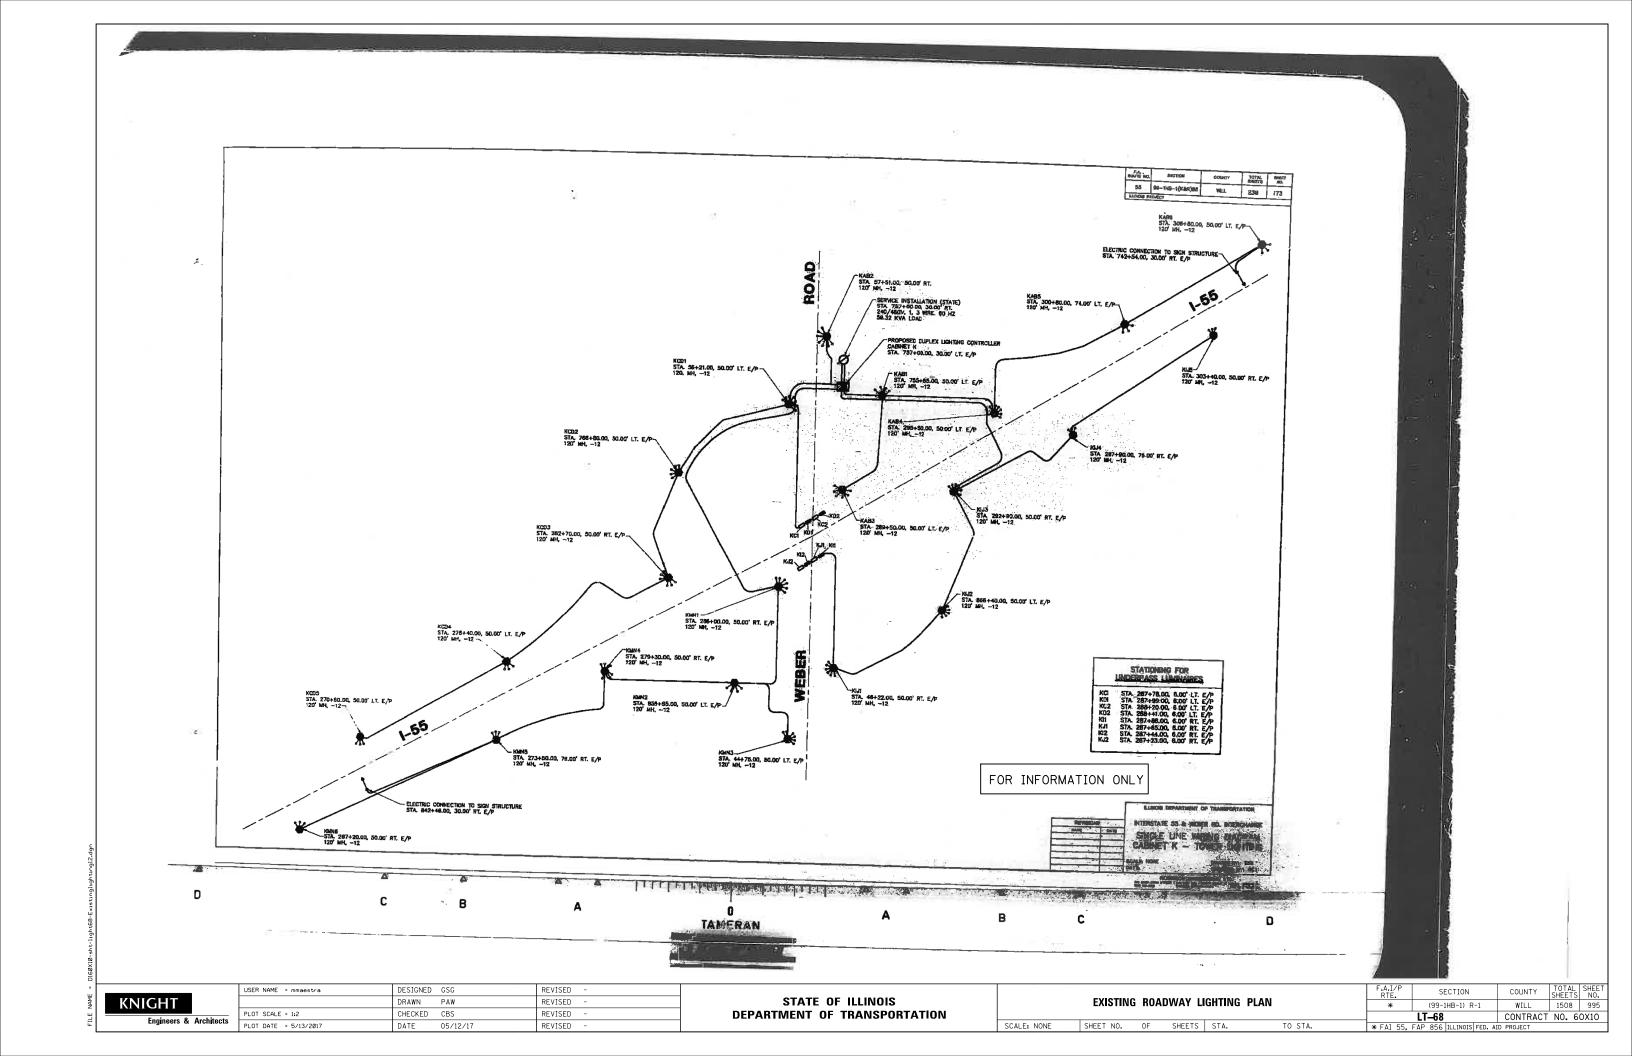

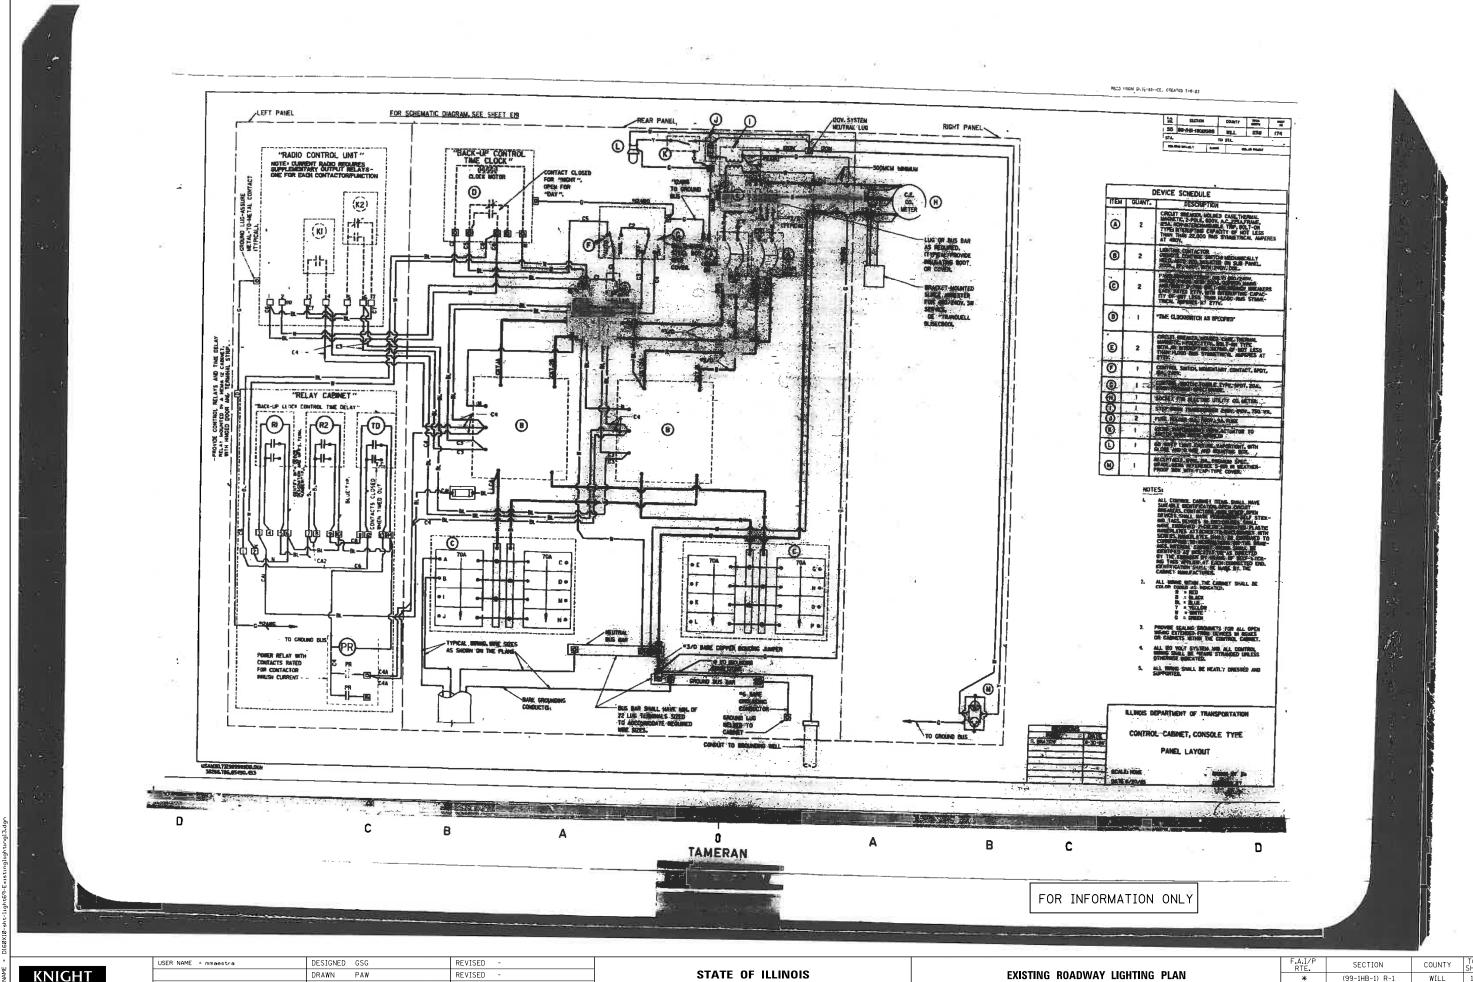

KNIGHT Engineers & Architects


CHECKED CBS REVISED PLOT DATE = 5/13/2017 DATE 05/12/17 REVISED

DEPARTMENT OF TRANSPORTATION

EXISTING ROADWAY LIGHTING PLAN SHEET NO. OF SHEETS STA.

SCALE: NONE

COUNTY TOTAL SHEET NO.
WILL 1508 996
CONTRACT NO. 60X10 (99-1HB-1) R-1 **LT-69*** FAI 55, FAP 856 I

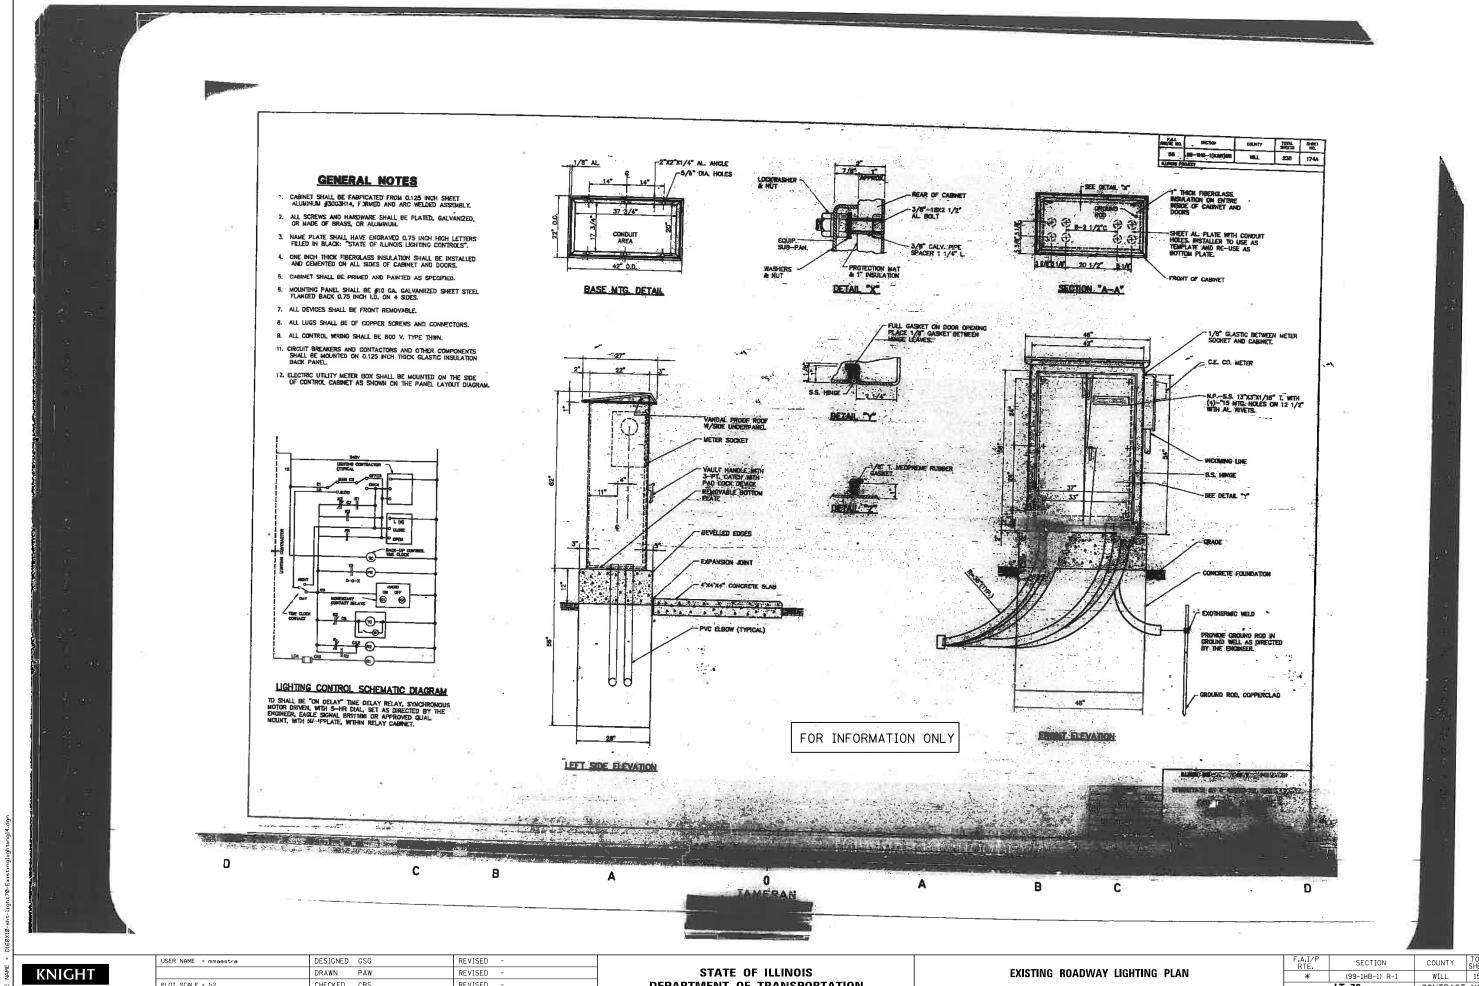


CHECKED CBS REVISED PLOT DATE = 5/13/2017 DATE 05/12/17 REVISED

DEPARTMENT OF TRANSPORTATION

SCALE: NONE

SHEET NO. OF SHEETS STA.

COUNTY TOTAL SHEET NO. WILL 1508 997 LT-70 CONTRACT NO. 60X10

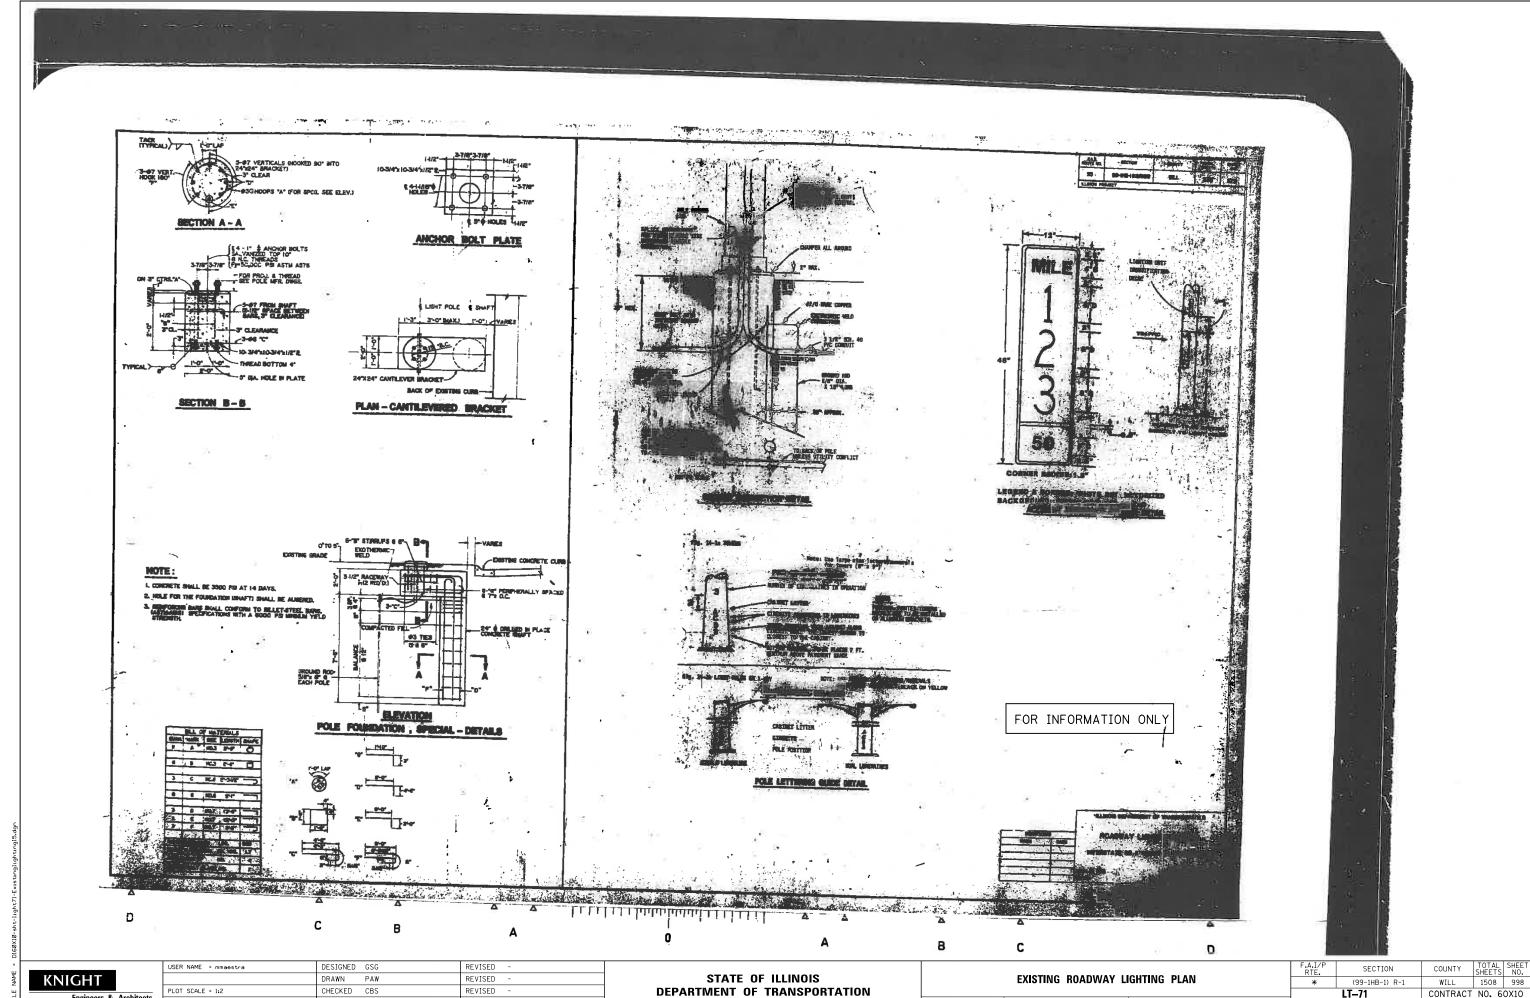


PLOT DATE = 5/13/2017 DATE 05/12/17 REVISED

DEPARTMENT OF TRANSPORTATION

SCALE: NONE SHEET NO. OF SHEETS STA.

WILL 1508 998 LT-71 CONTRACT NO. 60X10

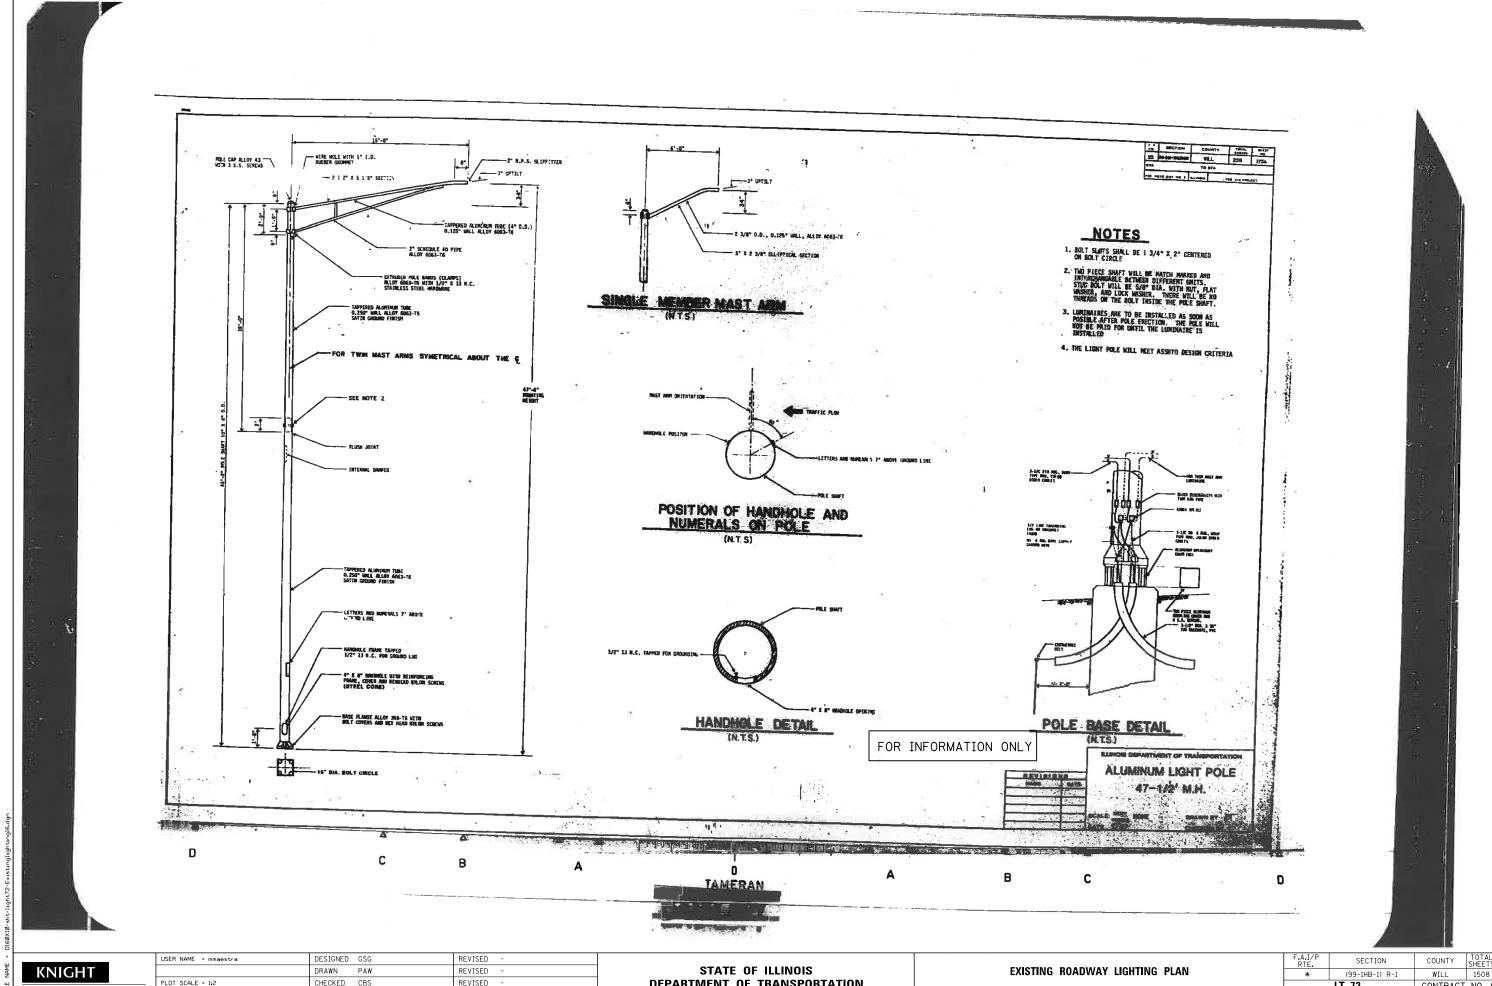


PLOT SCALE = 1:2 CHECKED CBS REVISED PLOT DATE = 5/13/2017 DATE 05/12/17 REVISED

DEPARTMENT OF TRANSPORTATION

SHEET NO. OF SHEETS STA.

SCALE: NONE

COUNTY TOTAL SHEET NO.
WILL 1508 999
CONTRACT NO. 60X10 LT-72 5, FAP 856 I

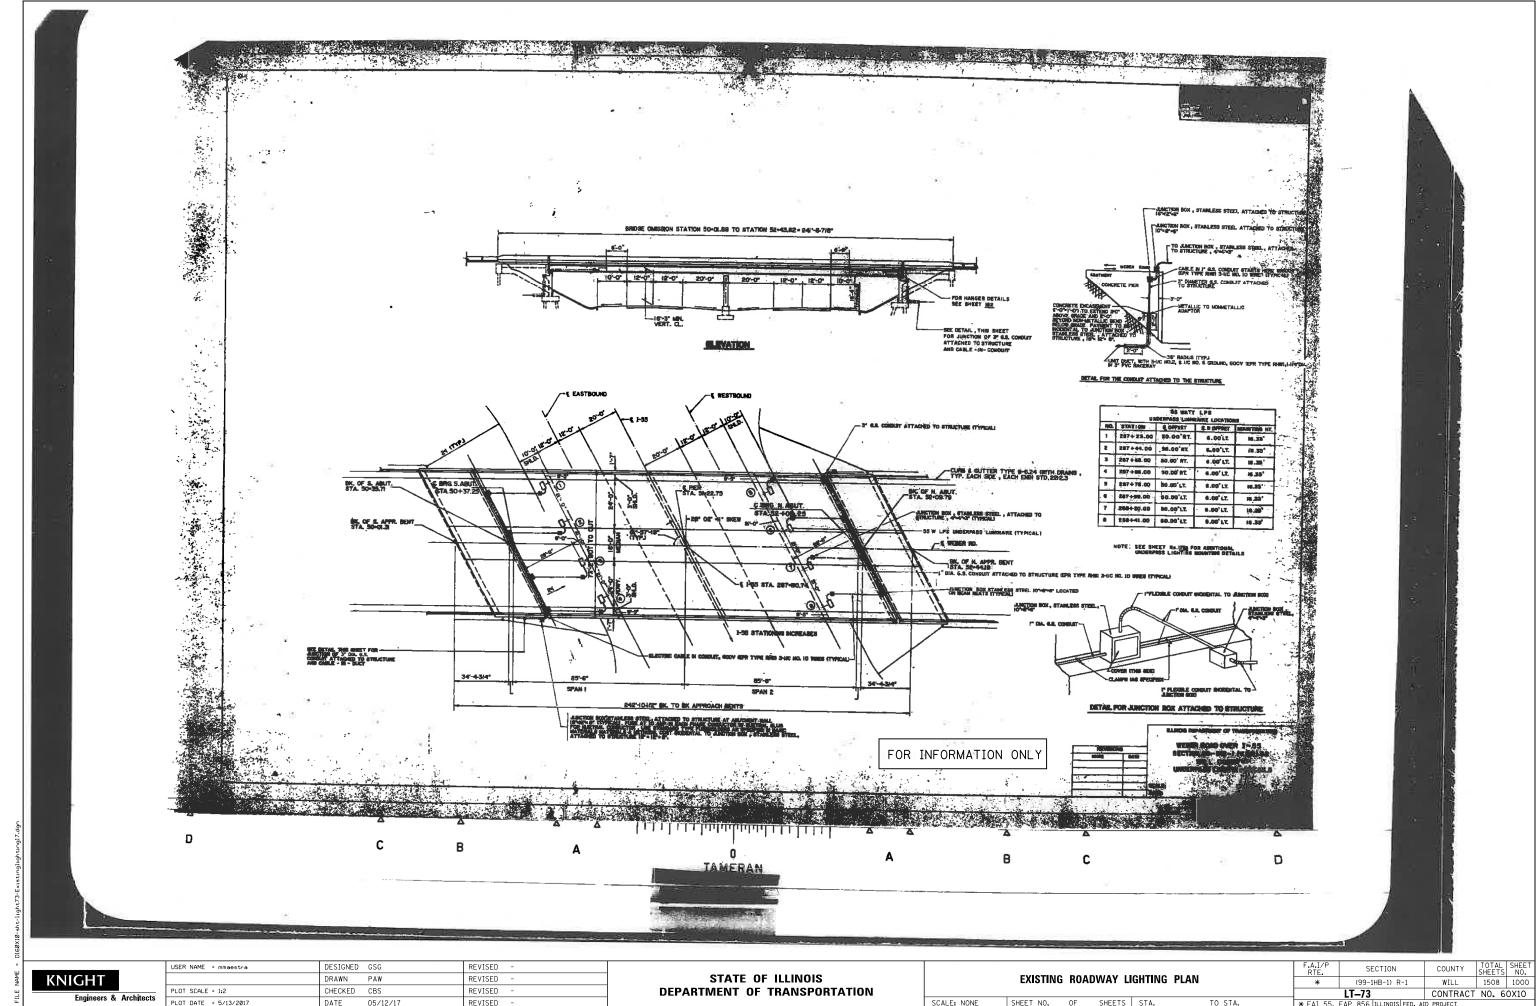

PLOT DATE = 5/13/2017 DATE 05/12/17 REVISED

SHEET NO. OF SHEETS STA.

LT-73 CONTRACT NO. 60X10