03-09-2018 LETTING ITEM 007 FOR INDEX OF SHEETS, STANDARDS,

MICHAEL J. EICHTEN, P.E.
LICENSE EXPIRES 11/30/2017
SHEET PARISE

AND GENERAL NOTES SEE SHEET NO. 2

STATE OF ILLINOIS

DEPARTMENT OF TRANSPORTATION

DIVISION OF HIGHWAYS

DESIGN DESIGNATIONS: POSTED DESIGN SPEEDS: ADT (2040): 70,000 23,000 47,000 63,000 22,000 41,000 5608 (49) INTERSTATE 5.57(PCC-20) 1840 (40) INTERSTATE (RAMP) 2.49(PCC-20) 3760 (40) INTERSTATE (RAMP) 2.34(PCC-20) NB 1-55 Bamp es 45 /50 MPH 35 /35 MPH RAMP EN 35 /35 MPH 4970 (40) INTERSTATE 5.57(PCC-20) 2100 (40) INTERSTATE (RAMP) 1.84(PCC-20) 3250 (40) INTERSTATE (RAMP) 3.24(PCC-20) 45 /50 MPH 35 /35 MPH RAMP NV

PROPOSED HIGHWAY PLANS

F.A.I. ROUTE 55 (STEVENSON EXPRESSWAY) I-55 FROM PRAIRIE AVENUE TO I-55 EASTERN TERMINUS LAKESHORE DRIVE FROM RAMP NW EXIT RAMP TO 23RD STREET PEDESTRIAN BRIDGE **SECTION: 2015-036LS**

NHPP-WS41 (439) PROJECT: **LANDSCAPING COOK COUNTY** C-91-354-15

RANGE 14 EAST - 3RD PM

WESTERN LIMITS ALONG I-55 TO BEGIN AT STA. 80 + 86.00 (SB 1-55 BASELINE



ENGINEERING SCALES. REDUCED SIZED PLANS WILL NOT CONFORM TO STANDARD SCALES. IN MAKING MEASUREMENTS ON REDUCED PLANS, THE ABOVE SCALES MAY BE USED.

C.U.A.N. CHICAGO ULITITY ALERT NETWORK 1-312-744-7000


PROJECT MANAGER – BRIAN KUTTAB

LSD TO END AT STA. 422+00.00 (RAMP NW BASELINE)

SOUTHERN LIMITS ALONG NB & SB

LSD TO END AT STA. 110 + 00.00

(RAMP SW BASELINE)

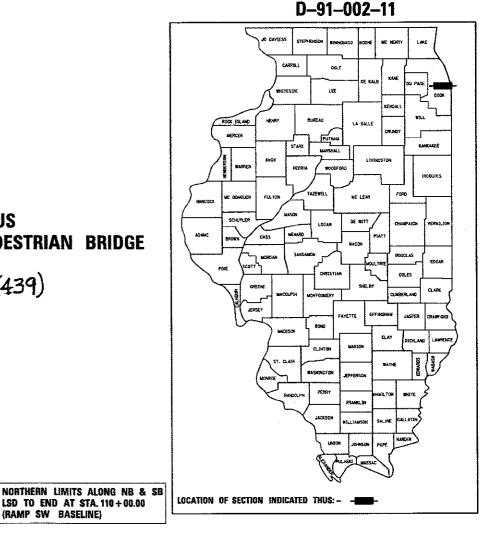

SECTION

2015-036LS

COUNTY

ILLINOIS CONTRACT NO. 62A93

COOK 84 1

303 EAST WACKER DRIVE, SUITE 1400 CHICAGO, 11, 60601-5276 PHONE: (3)23 373-7700 FAX: (3)23 373-6800

STATE OF ILLINOIS DEPARTMENT OF TRANSPORTATION

PRINTED BY THE AUTHORITY OF THE STATE OF ILLINOIS

CONTRACT NO. 62A93

GROSS LENGTH = 5,869 FT. = 1.112 MILE NET LENGTH = 5,869 FT. = 1.112 MILE

LOCATION MAP NOT TO SCALE

062-050948 REGISTERED PROFESSIONAL ENGINEER OF

IMPROVEMENT LOCATED IN CITY OF CHICAGO

0

0

ILLINOIS

SCHAUMBURG,

KUTTAB,

SERVICES: BRIAN

DESIGN

INDEX OF SHEETS

- INDEX OF DRAWINGS, HIGHWAY STANDARDS, AND GENERAL NOTES
- 3-8 SUMMARY OF QUANTITIES
- 9-11 CONSTRUCTION SEQUENCE
- 12-14 ALIGNMENT, TIES, AND BENCHMARKS
- 15-19 EXISTING CONDITIONS SHEETS
- 20-21 GRADING PLAN
- 22-32 LANDSCAPING KEY, PLANS, DETAILS, AND SCHEDULE
- 33-37 SODDING/SEEDING PLAN
- 38-41 SUGGESTED STACES OF CONSTRUCTION AND TRAFFIC CONTROL PLANS AND DETAILS
- 42-46 EROSION CONTROL PLANS
- 47-55 SUE PLANS
- 56-59 EXISTING IRRIGATION PLANS (FOR INFORMATION ONLY)
- 60-64 DISTRICT 1 DETAILS
- 65-84' SOIL BORING LOGS

COMMITMENTS

GENERAL PLANTING NOTES

- 1. DETERMINE EXACT LOCATIONS OF ALL UNDERGROUND UTILITIES AND VERIFY IN FIELD. REPORT ANY CONFLICTS TO ENGINEER PRIOR TO
- 2. INFORM ENGINEER AS EACH PHASE OF WORK IS UNDERTAKEN.
- 3. CONTRACTOR IS RESPONSIBLE FOR MAINTAINING CURRENT CONDITIONS ON SITE. ANY DAMAGE THAT OCCURS TO SITE DURING CONSTRUCTION IS CONTRACTOR'S RESPONSIBILITY WITHOUT EXPENSE TO OWNER.
- 4. PROTECT EXISTING VEGETATION INCLUDING ALL EXISTING PARKWAY AND INTERIOR TREES. REPLACE DAMAGED VEGETATION WITH APPROVED SIMILAR MATERIAL
- 5. CAREFULLY MAINTAIN PRESENT GRADE DRIPLINE OF ALL EXISTING TREES TO REMAIN, PREVENT ANY DISTURBANCE OF EXISTING TREES. USE TREE PROTECTION WHERE INDICATED. PROTECT EXISTING TREES TO REMAIN IN PLACE AGAINST UNNECESSARY CUTTING, BREAKING OR SKINNING OF ROOTS, BRUISING OF BARK OR SMOTHERING OF TREES. DRIVING, PARKING, DUMPING, STOCKPILING AND/OR STORAGE OF VEHICLES, EQUIPMENT, SUPPLIES, MATERIALS OR DEBRIS ON TOP OF THE ROOT ZONES AND/OR WITHIN THE DRIPLINE OF EXISTING TREES OR OTHER PLANT MATERIAL TO REMAIN IS STRICTLY PROHIBITED.
- 6. MAINTAIN SITE DRAINAGE DURING LANDSCAPE INSTALLATION.
- 7. PRIOR TO LANDSCAPE INSTALLATION, VERIFY PLANTING AREAS ARE GRADED AT +/- 0.1 FOOT TO FINISH GRADE.
- 8. FINISH GRADE TO 1" BELOW FINISH PAVING SURFACE IN LAWN AREAS AND 2" BELOW IN PLANTING AREAS.
- 9. REGRADE AND SEED ALL LAWN AREAS DISTURBED DURING CONSTRUCTION THAT ARE NOT CALLED OUT TO BE SODDED OR PLANTED. COVER SEEDED AREAS WITH A BIODEGRADABLE MULCH BLANKET. THIS WILL NOT BE PAID FOR SEPARATELY BUT SHALL BE CONSIDERED INCLUDED IN
- 10. CONFIRM ALL PLANT QUANTITIES. PROVIDE PLANT MATERIALS SUFFICIENT TO COVER AREAS SHOWN ON PLANS AT THE SPACINGS INDICATED.
- 11. PROVIDE IDENTIFICATION TAG FROM THE SUPPLYING NURSERY SHOWING COMMON AND BOTANICAL PLANT NAMES FOR AT LEAST ONE PLANT OF EACH SPECIES DELIVERED TO THE SITE. PROTECT ALL PLANTS AGAINST HEAT, SUN, WIND AND FROST DURING TRANSPORTATION TO THE SITE AND WHILE BEING HELD AT THE SITE. DO NOT STORE PLANTS IN TOTAL DARKNESS MORE THAN ONE DAY.
- 12 DO NOT DAMAGE PLANT ROOT BALL DURING TRANSPORTATION OR PLANTING.
- 13. NOTIFY THE ENGINEER AT THE TIME OF DELIVERY OF ANY PLANT MATERIAL THAT IS DAMAGED OR IN POOR CONDITION.
- 14. ENGINEER RESERVES THE RIGHT TO INSPECT ALL PLANT MATERIALS BEFORE PLANTING. MATERIAL MAY BE REJECTED AT ANY TIME DUE TO CONDITION, FORM OR DAMAGE BEFORE OR AFTER PLANTING.
- 15. REMOVE ALL ROCK AND DEBRIS 1" AND LARGER FROM PLANTING AREAS. LEGALLY DISPOSE ALL EXCESS MATERIALS RESULTING FROM THE WORK.
- 16. REMOVE AGGREGATE (CA-6) TO AN ADEQUATE DEPTH TO ENSURE THAT NO PART OF THE PLANT MATERIAL IS IN CONTACT OR AFFECTED BY THE LIME IN THE AGGREGATE (CA-6) AS APPROVED BY ENGINEER.
- 17. IN PLANTING SOIL PIT. REMOVE CRUSHED AGGREGATE TO AN ADEQUATE DEPTH TO ENSURE THAT NO PART OF THE PLANT MATERIAL IS IN CONTACT OR AFFECTED BY THE LIME OR LIMESTONE IN THE ACGREGATE.
- 18. STAKE LOCATION OF ALL TREES, HEDGE LINES AND PLANTING BEDS AND NOTIFY THE ROADSIDE DEVELOPMENT UNIT AT (847)705-4171 FOR REVIEW, A MINIMUM OF 3 DAYS PRIOR TO PLANTING.

HIGHWAY STANDARDS

STANDARD NO.	DESCRIPTION
000001-06	STANDARD SYMBOLS, ABBREVIATIONS AND PATTERNS
280001-07	TEMPORARY EROSION CONTROL SYSTEMS
701001-02	OFF-RD OPERATIONS, 2L, 2W MORE THAN 15' (4.5m) AWAY
701006-05	OFF-RD OPERATIONS, 2L, 2W, 15° (4.5m) TO 24" (600 mm) FROM PAVEMENT EDGE
701011-04	OFF-RD MOVING OPERATIONS 2L, 2W, DAY ONLY
701101-05	OFF-RD OPERATIONS, MULTILANE, 15' (4.5 m) TO 24" (600 mm) FROM PAVEMENT EDGE
701106-02	OFF-RD OPERATIONS, MULTILANE, MORE THAN 15' (4.5 m) AWAY
701400-09	APPROACH TO LANE CLOSURE, FREEWAY/EXPRESSWAY
701401-11	LANE CLOSURE, FREEWAY/EXPRESSWAY
701406-11	LANE CLOSURE, FREEWAY/EXPRESSWAY, DAY OPERATIONS ONLY
701421-08	LANE CLOSURE, MULTILANE DAY OPERATIONS ONLY, FOR SPEEDS > 45 MPH TO 55 MPH
701426-09	LANE CLOSURE, MULTILANE, INTERMITTENT OR MOVING OPER., FOR SPEEDS > 45 MPH
701427-05	LANE CLOSURE, MULTILANE, INTERMITTENT OR MOVING OPER., FOR SPEEDS < 40 MPH
701428-01	TRAFFIC CONTROL SETUP AND REMOVAL FREEWAY/EXPRESSWAY
701501-06	URBAN LANE CLOSURE, 2L, 2W, UNDIVIDED
701601-09	URBAN LANE CLOSURE, MULTILANE, 1W OR 2W WITH NONTRAVERSABLE MEDIAN
701901-07	TRAFFIC CONTROL DEVICES
704001-08	TEMPORARY CONCRETE BARRIER
782006	GUARDRAIL AND BARRIER WALL REFLECTOR MOUNTING DETAILS

DISTRICT 1 STANDARDS

TC-10	TRAFFIC CONTROL AND PROTECTION FOR SIDE ROADS INTERSECTIONS AND DRIVEWAYS
TC-17	TRAFFIC CONTROL DETAILS FOR FREEWAY SHOULDER CLOSURES AND PARTIAL RAMP CLOSURES
TC-18	FREEWAY/EXPRESSWAY SIGNING FOR FLAGGING OPERATIONS AT WORK ZONE OPENINGS ON FREEWAY/EXPRESSWAYS
TC-22	ARTERIAL ROAD INFORMATION SIGN
TC-25	TRAFFIC CONTROL DETAILS FOR FREEWAY CENTER LANE CLOSURE SHOULDER LANE

GENERAL PLANTING NOTES CONTINUED

- 19. THE PLANTING PLANS ARE DIAGRAMMATIC. SPOT PLANT MATERIALS APPROXIMATELY AS SHOWN ON THE LANDSCAPE DRAWING AND NOTIFY ENGINEER FOR REVIEW BEFORE REMOVING FROM CONTAINERS.
- 20. INSTALL ALL PLANT MATERIAL IN ACCORDANCE WITH DETAILS AND SPECIFICATIONS.
- 21. REMOVE ALL PLANT TYING MATERIAL AND MARKING TAPES AT THE TIME OF PLANTING
- 22. NO PLANT MATERIAL SHALL BE INSTALLED BEFORE BELOW-GROUND IRRIGATION SYSTEM COMPONENTS HAVE BEEN INSTALLED AND ARE OPERATIONAL.
- 23. TREES AND SHRUBS MUST BE INSTALLED PRIOR TO PERENNIALS AND GRASSES TO ESTABLISH PROPER LAYOUT AND TO AVOID DAMAGE TO OTHER SMALLER PLANTINGS.
- 24. PLANTING WORK SHALL NOT BEGIN UNTIL SPRING 2018.
- 25. AN EXISTING IRRIGATION SYSTEM IS LOCATED WITHIN THE MEDIAN OF LAKESHORE DRIVE. EXISTING IRRIGATION PLANS HAVE BEEN INCLUDED FOR INFORMATION ONLY, THESE PLANS MAY NOT REPRESENT ACTUAL FIELD CONDITIONS. IT IS THE CONTRACTOR'S RESPONSIBILITY TO FIELD LOCATE THE EXISTING IRRIGATION SYSTEM AND PROTECT IT DURING THE INSTALLATION OF THE LANDSCAPE IMPROVEMENTS. ANY DAMAGE TO THE IRRIGATION SYSTEM WILL BE REPAIRED AT THE CONTRACTOR'S OWN EXPENSE.
- 26. CONTRACT 62A93 WILL USE THE FIELD OFFICES PROVIDED UNDER CONTRACT 60L70 AND CONTRACT 60X07. WHEN THESE FIELD OFFICES BECOME UNAVAILABLE, THE CONTRACTOR WILL UTILIZE AN AVAILABLE FIELD OFFICE FROM THE CIRCLE INTERCHANGE CONTRACT AS PER THE DIRECTION OF THE ENGINEER.
- 27. ALL ELEVATIONS IN THE PLANS ARE BASED UPON THE NORTH AMERICAN VERTICAL DATUM OF 1988 (NAVD88). THE CONVERSION OF NORTH AMERICAN VERTICAL DATUM OF 1988 (NAVD88) TO CITY OF CHICAGO DATUM IS APPROXIMATELY 579.19 FEET.
- 28. ANY TREE PRUNING OR TREE REMOVALS ON CITY PROPERTY WILL REQUIRE A BUREAU OF FORESTRY PERMIT AND APPROVAL FROM THE CHICAGO DEPARTMENT OF TRANSPORTATION.
- 29. ALL LANDSCAPING WORK SHALL BE CONFINED TO THE WORK ZONES AS SHOWN IN THE PLANS. THE CONTRACTOR WILL NOT BE ALLOWED TO STAGE MATERIALS, EQUIPMENT, OR PARK VEHICLES OUTSIDE THE DEFINED WORK ZONE.
- 30. MULCH SHALL BE PLACED WITH THE PROPOSED LANDSCAPE IMPROVEMENTS IN ACCORDANCE WITH SECTIONS 253 AND 254 OF THE STANDARD SPECIFICATIONS AND INCLUDED IN THE COST OF THE TREES, EVERGREENS, SHRUBS, PERENNIALS, GRASSES, BULBS, AND VINES. MULCH PLACED AT ANY EXISTING TREES AS DIRECTED BY THE ENGINEER SHALL BE PAID FOR AS MULCH PLACEMENT, 3".
- 31. A NOMINAL QUANTITY FOR TREE REMOVALS, STUMP REMOVALS, AND SELECTIVE CLEARING HAS BEEN PROVIDED FOR USE AT THE LOCATIONS AS DIRECTED BY THE ENGINEER.
- 32. NURSERY TREE INSPECTIONS MUST BE COORDINATED BETWEEN IDOT AND CDOT.
- 33. THE GENERAL CONTRACTOR IS REQUIRED TO HIRE AN ENVIRONMENTAL FIRM THAT IS PREQUALIFIED IN HAZARDOUS WASTE BY THE DEPARTMENT TO REMEDIATE THE SOIL CONTAMINATION AND MONITOR FOR WORKER PROTECTION.



USER NAME = HENAOC	DESIGNED - KP	REVISED -
	DRAWN - CRH	REVISED -
PLOT SCALE = 100.8000 '/ in.	CHECKED - MAJE	REVISED -
PLOT DATE = 12/13/2017	DATE - 10/20/2017	REVISED -

STATE OF ILLINOIS **DEPARTMENT OF TRANSPORTATION**

	INDEX OF SHEETS AND GENERAL NOTES	F.A.I. RTE.	SECTION	COUNTY	TOTAL SHEETS	SHEET NO.
	INDEX OF SHEETS AND GENERAL NOTES	55	2015-036LS	COOK	84	2
				CONTRACT	NO. 6	2A93
SCALE:	SHEET NO. 1 OF 1 SHEETS STA. TO STA.		ILLINOIS FED. A	AID PROJECT		

CONS	TR.	CODE
7 7 7 7	FEE STA	DERAL

				10% STATE
				LANDSCAPING
CODE			TOTAL	0031
NO.	ITEM	UNIT	QUANTITY	URBAN
20100110	TREE REMOVAL (6 TO 15 UNITS DIAMETER)	UNIT	180	180
	TREE DENOVAL (OVER 15 HNITS DIAMETER)	LINITT	200	200
20100210	TREE REMOVAL (OVER 15 UNITS DIAMETER)	UNIT	200	200
20101000	TEMPORARY FENCE	FOOT	200	200
	TEM OWN TERVE			
20101200	TREE ROOT PRUNING	EACH	15	15
20101300	TREE PRUNING (1 TO 10 INCH DIAMETER)	EACH	29	29
20101350	TREE PRUNING (OVER 10 INCH DIAMETER)	EACH	15	15
20101400	NITROGEN FERTILIZER NUTRIENT	POUND	360	360
20101600	POTASSIUM FERTILIZER NUTRIENT	POUND	360	360
20400800	FURNISHED EXCAVATION	CU YD	1906	1906
20900110	POROUS GRANULAR BACKFILL	CU YD	212	212
25000210	SEEDING. CLASS 2A	ACRE	1. 25	1.25
25000750	MOWING	ACRE	37.00	37.00
25100115	MULCH, METHOD 2	ACRE	2.00	2.00
				· •
25100630	EROSION CONTROL BLANKET	SQ YD	9203	9203

AECOM

SOS EAST WACKER DRIVE, SUITE 1400
CHICAGO, IL 60601-9376 AU (1312) 373-6800

USER NAME = HENAGO	DESIGNED KP	REVISED	
	DRAWN CRH	REVISED	STATE OF ILLINOIS
PLOT SCALE = 188.8981 '/ in.	CHECKED - MAJE	REVISED -	DEPARTMENT OF TRANSPORTATION
PLOT DATE - 12/13/2017	DATE - 10/20/2017	REVISED	

55 2015-036LS C00K 84 3 CONTRACT NO. 62A93	CHRESTADY OF CHARTETE	F.A.I. RTE.	SECTION	COUNTY	TOTAL SHEETS	SHEET NO.
	SUMMARY OF QUANTITIES	55	2015-036LS		I	3
SCALE: SHEET NO. 1 OF 6 SHEETS STA. TO STA. HALMONS FED. AND PROJECT	course the state of the contract of the contra	<u> </u>	HI INDIS FED. AT		T NO. 6	2A93

CONS	TR.	CODE
90%	FED STA	ERAL TE

				10% STATE
				LANDSCAPINO
CODE	1754	UNIT	TOTAL	0031
NO.	ITEM	UNII	QUANTITI	URBAN
25200110	SODDING, SALT TOLERANT	SO YD	376	376
25200200	SUPPLEMENTAL WATERING	UNIT	320	320
28000250	TEMPORARY EROSION CONTROL SEEDING	POUND	380	380
29000400	DEDINETED EDOCION DADDIED	FOOT	1417	
28000400	PERIMETER EROSION BARRIER	FOOT	1411	1417
28000510	INLET FILTERS	EACH	37	37
28100107	STONE RIPRAP, CLASS A4	SO YD	2656	2656
28200200	FILTER FABRIC	SQ YD	2656	2656
40200300	AGGREGATE SURFACE COURSE, TYPE A 4"	SQ YD	323	323
60108106	PIPE UNDERDRAINS, TYPE 1, 6"	FOOT	345	345
60252800	CATCH BASINS TO BE RECONSTRUCTED	EACH	1.	1
66900200	NON-SPECIAL WASTE DISPOSAL	CU YD	275	275
66900210	HAZARDOUS WASTE DISPOSAL	CU YD	10	10
66900450	SPECIAL WASTE PLANS AND REPORTS	LSUM	ř	1
66900530	SOIL DISPOSAL ANALYSIS	EACH	2.	2

* DENOTES SPECIALTY ITEM ** DENOTES NON-PARTICIPATING ITEM

SER NAME = HENAOC	DESIGNED KP	REVISED -
	DRAWN - CPSH	REVISED -
OT SCALE = 100.0001 // in.	CHECKED MJE	REVISED -
OT DATE - 12/13/2017	DATE - 10/20/2017	REVISED -

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DEPARTMENT	OF	TRANSPORTATION

	OUTERS A DAY OF CUSTITION	F.A.I. RTE.	SECTION	COUNTY	TOTAL SHEET SHEETS NO.
	SUMMARY OF QUANTITIES	55	2015-036LS	COOK	84 4
				CONTRAC	T NO. 62A93
SCALE:	SHEET NO. 2 OF 6 SHEETS STA. TO STA.		ILLINOIS FED. A	ID PROJECT	

CONS	TR.	CODE
	FEI ST/	DERAL ATE

				LANDSCAPING
CODE	ITCM	UNIT	TOTAL	0031 URBAN
NO.	ITEM	UNII	QUANTITI	URBAN
67100100	MOBILIZATION	LSUM	1	1
A2002824	TREE, CATALPA SPECIOSA (NORTHERN CATALPA), 3" CALIPER, BALLED AND BURLAPPED	EACH	13	13
A2002920	TREE, CELTIS OCCIDENTALIS (COMMON HACKBERRY), 2-1/2" CALIPER, BALLED AND BURLAPPED	EACH	17	17
A2004514	TREE, GINKGO BILOBA AUTUMN GOLD (AUTUMN GOLD GINKGO), 2-1/2" CALIPER BALLED AND BURLAPPED	EACH	4	4
A2005024	TREE, GYMNOCLADUS DIOICUS (KENTUCKY COFFEETREE), 3" CALIPER, BALLED AND BURLAPPED	EACH	38	38
A2005924	TREE, PLATANUS X ACERIFOLIA BLOODGOOD (BLOODGOOD LONDON PLANETREE), 3" CALIPER, BALLED AND BURLAPPED	EACH	3 .	3
A2006516	TREE, OUERCUS BICOLOR (SWAMP WHITE OAK), 2" CALIPER, BALLED AND BURLAPPED	EACH	25	25
A2006716	TREE, QUERCUS MACROCARPA (BUR OAK), 2" CALIPER, BALLED AND BURLAPPED	EACH	3.	3
A2007624	TREE, TAXODIUM DISTICHUM (COMMON BALD CYPRESS), 3" CALIPER, BALLED AND BURLAPPED	EACH	6	6
A2008470	TREE, ULMUS AMERICANA PRINCETON (PRINCETON AMERICAN ELM), 2-1/2" CALIPER, BALLED AND BURLAPPED	EACH	40	40
A2008750	TREE, ULMUS X PATRIOT (PATRIOT ELM), 3" CALIPER, TREE FORM, BALLED AND BURLAPPED	EACH	7	7
B2000767	TREE, AMELANCHIER X GRANDIFLORA AUTUMN BRILLIANCE (AUTUMN BRILLIANCE SERVICE BERRY), 8' HEIGHT, CLUMP FORM, BALLED AND BURLAPPED	EACH	5	5
B2001770	TREE, CRATAEGUS CRUSGALLI VAR. INERMIS (THORNLESS COCKSPUR HAWTHORN), 8' HEIGHT, BALLED AND BURLAPPED, MULTI-HEADS	EACH	18	18
B2004000	TREE, MALUS ORANGE CRUSH (ORANGE CRUSH CRABAPPLE), 6' HEIGHT, CLUMP FORM, BALLED AND BURLAPPED	EACH	3	3

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* DENOTES SPECIALTY ITEM ** DENOTES NON-PARTICIPATING TILM

AECOM

SOS EAST WACKER OFFIVE, SUITE 1400
OHCAGO, IL SOSOI-5276

USER NAME = HENAOC	DESIGNED KP	REVISED
	DRAWN CRH	REVISED
PLOT SCALE = 100.0001 1/ in.	CHECKED - MJE	REVISED -
PLDT DATE - 12/13/2017	DATE - 10/20/2017	REVISED -

STATE	E OF	ILLINOIS
DEPARTMENT	0F	TRANSPORTATION

	CUPARA			F.A.I. RTE.	SECTION	COUNTY	TOTAL SHEETS	SHEET NO.
	SUMMAR	OF QUANTITIES		55	2015-036LS	COOK	84	5
						CONTRACT	NO. 1	52A93
SCALE:	SHEET NO, 3 OF 6	SHEETS STA.	TO STA.		ILLINOIS FED. AI	D PROJECT		

CONS	TR.	CODE
90%	FEC	ERAL

				LANDSCAPING
CODE	1754	LINITT	TOTAL	URBAN
NO.	ITEM	UNIT	QUANTITY	URBAN
C2005724	SHRUB, RHUS AROMATICA (FRAGRANT SUMAC), 2' WIDTH, BALLED AND BURLAPPED	EACH	259	259
	SHRUB, VIBURNUM DENTATUM BLUE MUFFIN (BLUE MUFFIN ARROWHEAD),			
C2011600	3' HEIGHT, BALLED AND BURLAPPED	EACH	192	192
D2000636	EVERGREEN, JUNIPERUS CHINENSIS SEA GREEN (SEA GREEN JUNIPER), 3' WIDTH, BALLED AND BURLAPPED	EACH	38	38
D2001660	EVERGREEN, JUNIPERUS VIRGINIANA CANAERTII (CANAERTI RED CEDAR), 5' HEIGHT, BALLED AND BURLAPPED	EACH	47	47
E20200G1	VINE-PARTHENOCISSUS QUINQUEFOLIA (VIRGINIA CREEPER), 1-GALLON POT	EACH	15.	15
E20220G1	VINE-PARTHENOCISSUS TRICUSPIDATA (BOSTON IVY), 1-GALLON POT	EACH	480	480
K0012970	PERENNIAL PLANTS, BULB TYPE	UNIT	8	8
К0012990	PERENNIAL PLANTS, ORNAMENTAL TYPE, GALLON POT	UNIT	28	28
K0026700	TREE CARE	EACH	270	270
K0026810	SHRUB CARE	EACH	600	600
K0026820	VINE CARE	EACH	500	500
K0026850	PERENNIAL PLANT CARE	SQ YD	800	800
K0029614	WEED CONTROL, AQUATIC	GALLON	2:5	2.5
K0029618	WEED CONTROL, BROADLEAF IN TURF	GALLON	2. '5	2. 5

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* DENOTES SPECIALTY LIEW ** DENOTES NON-PARTICIPATING FEM

AECOM
303 EAST WACKER ORIVE, SUITE (400 CHICAGO, IL 60601-5276
PHONE: (312) 373-7700 FAX: (312) 373-6800

USER NAME HENAGO	DESIGNED - KP	REVISED -
	DRAWN - CRH	REVISED -
PLOT SCALE - 100.0001 '/ 10.	CHECKED - MUE	REVISED -
PLOT DATE = 12/13/2017	DATE - 10/20/2017	REVISED

SUMMARY OF QUANTITIES 55 2015-036LS COOK 84 6 CONTRACT NO. 62A93		OJIE OR A PO				F.A.I. RTE.	SECTION	COUNTY	TOTAL SHEETS	SHEET NO.
		20MWAK1	UF UU	IANTITIES		55	2015-036LS	COOK	84	6
								CONTRACT	NO. 6	2A93
SCALE: SILE INC. 4 OF G. SILE IS STA. TO STA. ILLINOIS FED. ATO PROJECT	SCALE:	SHEET NO. 4 OF 6	SHEETS	STA.	TO STA.	ILLINOIS FED. AID PROJECT				

CONS	TR.	CODE
90%		ERAL

			,	TU/ STATE
				LANDSCAPI
CODE			TOTAL	0031
NO.	ITEM	UNIT	QUANTITY	URBAN
(0029632	WEED CONTROL, NON-SELECTIVE AND NON-RESIDUAL	GALLON	15	15
<0029634	WEED CONTROL, PRE-EMERGENT GRANULAR HERBICIDE	POUND	51	51
K0036118	MULCH PLACEMENT 3"	SO YD	314	314
K1003660	MOWING CYCLES	EACH	48	48
Z0013798	CONSTRUCTION LAYOUT	LSUM	1	1
Z0030850	TEMPORARY INFORMATION SIGNING	SQ FT	81	81
Z0064800	SELECTIVE CLEARING	UNIŦ	2 -	2
20076600		#OUR		
70076604	TRAINEES IRAINING PROGRAM GRADUATE	HOUR		
X1800001	SHRUB, VIBURNUM DENTATUM RASTZAM (RASPBERRY TART ARROWWOOD VIBURNUM), 24" HEIGHT, 5-GALLON CONTAINER	EACH	36	36
X2000001	WEED CONTROL, NATIVE LANDSCAPE REMEDIATION	UNIT	200-	200
X2010310	TREE REMOVAL (SPECIAL)	UNIT	100	100
X2010400	STUMP REMOVAL ONLY	UN I, T	200	200
X2110100	TOPSOIL FURNISH AND PLACE, SPECIAL	CU YD	610	610

* DENOTES SPECIALTY LIFM ** DENOTES NON-PARTICIPATING LIFM

DESIGNED - KP REVISED DRAWN REVISED CHECKED - MJE REVISED PLOT SCALE = 100.0001 '/ 10. PLOT DATE = 12/13/2017 DATE - 10/20/2017 REVISED

STATE OF ILLINOIS
DEPARTMENT OF TRANSPORTATION

SUMMARY OF QUANTITIES SHEET NO. 5 OF 6 SHEETS STA. SCALE:

TO STA.

F.A.L. RTE. 55 SECTION 2015-036LS

90% FEDERAL 10% STATE

				10/1 STATE
				LANDSCAPIN
CODE			TOTAL	0031
NO.	ITEM	UNIT	QUANTITY	URBAN
NO.	I I LIVI	ONTI	COANTITI	ONDAN
X2111100	TOPSOIL EXCAVATION AND PLACEMENT, SPECIAL	CU YD	740	740
X2501820	SEEDING, CLASS 5 (MODIFIED)	ACRE	1.50	1.50
X2502014	SEEDING, CLASS 4A (MODIFIED)	ACRE	1.50	1.50
X2503100	MOWING	UNIT	10	10
X2503315	INTERSEEDING, CLASS 4A (MODIFIED)	ACRE	5.00	5.00
X2503321	INTERSEEDING, CLASS 5 (MODIFIED)	ACRE	5.00	5.00
X7010216	TRAFFIC CONTROL AND PROTECTION, (SPECIAL)	LSUM	1	1
X7011015	TRAFFIC CONTROL AND PROTECTION (EXPRESSWAYS)	LSUM	1	1
X7013820	TRAFFIC CONTROL SURVEILLANCE, EXPRESSWAYS	CAL DA	60	60
X180001Z	GYMNOCLADUS DIOICUS (DECAF KENTUCKY COFFEETREE), 2-1/2" CALIPER, BALLED AND BURLAPPED	EACH	6	6
X1800013	TREE, GLEDITSIA TRIACANTHOS VAR. INERMIS DRAVES (STREET KEEPER HONEYLOCUST), 2" CALIPER, BALLED AND BURLAPPED	EACH	26	26
X 18000 14	DIERVILLA KODIAK ORANGE (KODIAK ORANGE BUSH-HONEYSUCKLE), 24" HEIGHT, 5-GALLON CONTAINER	EACH	32	32

* DENOTES SPECIALTY ITEM ** DENOTES NON-PARTICIPATING ITEM

AECOM
SOS EAST WACKER DRIVE, SHITE 1400
CHICAGO, IL 60501-5276

USER NAME = HENAOC DESIGNED - KP REVISED
DRAWN - CRH REVISED

PLOT SCALE - 1860-88881 '/ 1m, CHECKED - MLIE REVISED
PLOT DATE - 12/13/2817 DATE 10/20/2017 REVISED -

STATE OF ILLINOIS
DEPARTMENT OF TRANSPORTATION

62A93 - CALENDAR OF LANDSCAPE CONSTRUCTION AND ESTABLISHMENT WORK

*****	2018														2019								2020					
ITEM	MAY JUN PHASE I	JUL	AU	G	SEP	ост РНА		D	DEC JA	AN	FEB	MAR	APR PHASE	III	JUN	JULY	AUG	PHASE IV	ОСТ	NOV	DEC	JAN FEB	MAR PHASE	APR V	MAY	JUN	JULY AUG SEPT PHASE VI	г ост
ANT MATERIAL INSPECTIONS																				'		1						
JBMIT COMPLETED PLANT INSPECTION FORMS D IDOT			SUBMIT CO PLANT INS SHEETS TO: FALL SPRING PLANT	IDOT FOR 2018 & 2019														SUBMIT COM PLANT INSE SHEETS TO II FALL REPLACEI PLANTI	DOT FOR 2018 MENT	SUBMIT COMPLE INSPECTION SHEE FOR SPRING REPLACEMENT P	TS TO IDOT							
OODY PLANTINGS & WOODY PLANTINGS AND SHRUBS	IT CARE																											
MARCH 15 - APRIL 30 (EVERGREEN)												INS	ING PLANTING - TALLATION OF VERGREENS F REQUIRED)]			PERIOD OF ESTABLISHMENT NSPECTION BY IDOT	-				REP E (IF	ING PLANTING PLACEMENT OI EVERGREENS IF REQUIRED)	f			
MARCH 15 - MAY 31 (DECIDUOUS)												DI	SPRING PLAN PLANTING CIDUOUS TREES	OF SPRING ONLY	,								REPLAC DECID	SPRING PLANT CEMENTS OF S DUOUS TREES (IF REQUIRE	& SHRUBS			
L PLANTING OF TREES AND SHRUBS																	L											
EPTEMBER 15 - OCTOBER 15 (EVERGREEN)					INSTA EVE	PLANTING - NITIAL LLATION OF RGREENS	FALL PLANT.	NG.										FALL PLAN REPLACE INSTALLAT EVERGR REQUIF	TION OF EENS (IF									
NOVEMBER 1 - NOVEMBER 30 (DECIDUOUS)							INSTALLATIO DECIDOUS TR SHRUBS (F ONLY)	N OF EES & ALL												FALL PLANTING - REPLACEMENTS OF DECIDOUS TREES & SHRUBS (IF REQUIRED)								
ZIOD OF ESTABLISHMENT OF TREES, SHRUBS, & ES																				(ii rizgonizo)								
VATER: A.L TREES AND SHRUBS EVERY WEEK OR S DIRECTED BY THE ENGINEER (INCLUDED IN COST OF TREE AND HRUB INSTALLATION)														4	4	5	4	5	4	4								
VEED: ALL TREES, SHRUBS, AND VINES EVERY VEEK OR AS DIRECTED BY THE ENGINEER NCLUDED IN COST OF TREE, SHRUB, & VINE NSTALLATION)														4	4	5	4	5	4	4								
ES, SHRUBS, & VINE CARE FTER COMPLETION OF PERIOD OF STABLISHMENT																												
SUPPLEMENTAL WATERING: WATER ALL TREES, SHRUBS, & VINES EVERY OTHER VEEK OR AS DIRECTED BY THE ENGINEER AS PER SPECIAL PROVISION)																										2	2 2 2	1
VEED, REPLENISH MULCH, & PRUNE: AS PER THE SPECIAL PROVISION AND AS DIRECTED BY THE ENGINEER																											1	

AECOM
303 EAST WACKER DRIVE, SUITE 1400 CHICAGO, IL 60601-5276 PHONE, (312) 373-7703 EAV. (312) 373-6800

USER NAME = HENA	oc DES	GNED - KP	REVISED	-
	DRA	NN - CRH	REVISED	-
PLOT SCALE = 1147.	5000 '/ in. CHE	CKED - MJE	REVISED	-
PLOT DATE = 12/12	/2017 DAT	- 10/20/20	17 REVISED	-

STATE OF ILLINOIS
DEPARTMENT OF TRANSPORTATION

SCALE

CONTRACT NO. 62A93	LANDSCAPING CO	NSTRUC	TION	SCHEDULE	F.A.I. RTE. 55	SECTION 2015-036LS	COUNTY	TOTAL SHEETS 84	SHEET NO.
	SHEET NO. 1 OF 3	SHEETS	STA.	TO STA.		ILLINOIS FED. AI		NO. 6	52A93

62A93 - CALENDAR OF LANDSCAPE CONSTRUCTION AND ESTABLISHMENT WORK

	2018												2019										2020												
ITEM	MAY	JUN	JUL		AUG	:	SEP	ост	NOV	v	DEC	JAN	FEB	MAR	APR	MAY	Y JU	חר אר	ILY /	AUG	SEPT	ост	NOV	/ D	EC	JAN FEB	MAR	APR	MAY	JUN	JULY	AUG S	БЕРТ	ост	NO
	PH	\SE I		•			'	PHAS	E II	'	'	<u>'</u>			PHA	SE III				PI	HASE IV					,	PHASE	V		'		PHASE V	T		
PERENNIAL PLANTING AND PERENN	IAL PLAN	Γ CARE																				T						T							
INSTALL PERENNIALS (ORNAMENTAL TYPE)																PLANT P	PERENNIALS			REPLANT PERENNIALS (IF REQUIRED)									REPLA PERENN (IF REQU	IALS			REPLAN PERENNIA (IF REQUIF	IALS	
PERIOD OF ESTABLISHMENT WORK WATER PERENNIALS TWICE A WEEK FOR FOUR WEEKS AFTER INSTALLATION AND																DED	OF ESTABLISH RENNIALS (30 ED IN COST OF	DAVS)		(,,									ta nace	,,,,,,,,,,,,,,,,,,,,,,,,,,,,,,,,,,,,,,,				,	
WEED PERENNIAL BEDS ONCE A WEEK																	PLANTS																		
PERENNIAL PLANT CARE AFTER COMPLETION OF PERIOD OF ESTABLISHMENT (ONCE A WEEK OR AS DIRECTED BY THE ENGINEER)																				1		1													
SUPPLEMENTAL WATERING AFTER COMPLETION OF PERIOD OF ESTABLISHMENT (ONCE A WEEK OR AS DIRECTED BY THE ENGINEER)																	4	4 !	5	4	5	2													
INSTALL BULBS																							PLANT BULBS												
							I																												—
TREE REMOVAL AND PROTECTION																																			
PROTECTION OF EXISTING PLANT MATERIAL																																			
TEMPORARY FENCE																																			
THE FENCE SHALL BE ERECTED ON ALL FOUR SIDES OF THE DRIP-LINE OF THE TREE TO CREATE A "TREE PROTECTION ZONE"																																			
TREE TRUNK PROTECTION TO PREVENT SCARRING OF TREES																																			
CARE OF EXISTING PLANT MATERIAL																																			
TREE ROOT PRUNING TO BE DONE WHENEVER PROPOSED EXCAVATION FALLS WITHIN DRIPLINE OF A TREE; TO BE PERFORMED BY A PROFESSIONAL ARBORIST																																			
TREE PRUNING SHALL CONSIST OF PRUNING FOR AESTHETIC AND STRUCTURAL ENHANCEMENT; TO BE PERFORMED BY A PROFESSIONAL ARBORIST (OCTOBER 15 - APRIL 15)																																			
TREE REMOVAL																																			
TREE REMOVAL SHALL BE REMOVED TO A DEPTH OF NOT LESS THAN 12" BELOW THE ELEVATION OF THE GROUND LINE																																			
SELECTIVE CLEARING SHALL CONSIST OF EXTENSIVE REMOVAL & DISPOSAL OF SHRUBS, BRUSH, DEBRIS, & SELECTED TREES UP TO 6" IN DIAMETER																																			
STUMP REMOVAL SHALL BE REMOVED TO A DEPTH OF NOT LESS THAN 12" BELOW THE ELEVATION OF THE GROUND																																			

ш	
	AECOM
l	303 EAST WACKER DRIVE, SUITE 1400 CHICAGO, IL 60601-5276

USER NAME = HENAOC	DESIGNED - KP	REVISED -
	DRAWN - CRH	REVISED -
PLOT SCALE = 1147.4999 '/ in.	CHECKED - MJE	REVISED -
PLOT DATE = 12/12/2017	DATE - 10/20/2017	REVISED -

STATE OF ILLINOIS
DEPARTMENT OF TRANSPORTATION

SCALE

LANDSCAPING CONSTRUCTION SCHEDULE	F.A.I. RTE. 55	SECTION 2015-036LS	COUNTY COOK CONTRACT	TOTAL SHEETS 84	SHEET NO. 10 2A93						
SHEET NO. 2 OF 3 SHEETS STA. TO STA.	ILLINOIS FED. AID PROJECT										

62A93 - CALENDAR OF LANDSCAPE CONSTRUCTION AND ESTABLISHMENT WORK

					2018				_							I	2019											2020				
ITEM	MAY	JUN	JUL	AUG	SEP		ОСТ	NOV	DEC	JAN	FEB	MAR		APR	MAY	JUN	JULY	AUG	SEPT	ост	NO	V D	EC JA	AN FEB	MAR	APR	MAY	JUN	JULY	AUG		ост
	PHAS	SE I				P	PHASE II						PI	PHASE III					PHASE IV						PHASE	/				PHASE	VI	
RESTORATION AND ESTABLISH	MENT WOI	₹K																														
ED CONTROL, BROADLEAF WEED CONTROL																																
D CONTROL BROADLEAF WEEDS IN TURF GRASS ND AS DIRECTED BY THE ENGINEER	AS	NEEDED				AS NEEDI	ED								AS	NEEDED				AS NEEDED								AS NEEDED			AS NEE	EDED
DING, SALT TOLERANCE																																
RING: MARCH 15 TO JUNE 30	SPRING INSTA	LLATION OF											SPRING	G INSTALLATIO (IF NECESSAI	ON OF SOD RY)											SPRING INSTALL (IF NECE:	ATION OF SO SARY)	D				
LL: SEPTEMBER 1 TO NOVEMBER 30						FALL INSTALL	LATION OF S CESSARY)	OD											FAL	L INSTALLATION (SOD										FALL INSTAL	LATIO
ING CLASS 2A						(L		(
PRING: APRIL 1 TO JUNE 15	SPRING SEEDIN CLASS 2A	IG OF											SPRIN	NG SEEDING O	F CLASS 2A											SPRING SEEDIN	IG OF CLASS :	2A				
ILL: AUGUST 1 TO NOVEMBER 1	CLASS EA			FALL S	SEEDING OF CL	ASS 2A								(II IVECESSA	uki)				FALL SEEDING OF	CLASS 2A						(ii iiici	.ssaitty			FALL	. SEEDING OF CL	ASS 2A
RMANT SEEDING: NOVEMBER 1 TO MARCH 31					(IF NECESSARY	, 		DORI	MANT SEEDIN	NG OF CLASS 2	A (IF NECES	SARY)							(IF NECESS	AKT)											(IF NECESSA	art)
ING (CYCLE)																																
HEN GRASS REACHES A HEIGHT OF 4" OR AS RECTED BY THE ENGINEER	2	2	2	2	2		2	2				2	,	2	2	2	2	2	2	2	2					2	2	2	2	2	2	2
CONTROL	STABLISHM	IENT WOI	RK																													
CONTROL ED CONTROL, NON-SELECTIVE AND N-RESIDUAL (AQUATIC) ILLI TURE AREAS TO BE INTERSEEDED WITH ITVE SEEDING AND AS DIRECTED BY THE SINEER ED CONTROL, NATIVE LANDSCAPE MEDIATION	STABLISHN	IENT WO	RK		NATI	IVE GRASS AR	REA																									
D CONTROL SED CONTROL, NON-SELECTIVE AND NN-RESIDUAL (AQUATIC) KILL TURF AREAS TO BE INTERSEEDED WITH TIVE SEEDING AND AS DIRECTED BY THE GINEER SED CONTROL, NATIVE LANDSCAPE MEDIATION LECTIVE, SPOT SPRAYING AS DIRECTED BY THE	AS N	EEDED TO ROL WEEDS	RK			IVE GRASS AR		S									AS NEEDE	ED TO CONTRO	DL WEEDS									ASI	NEEDED TO	CONTROL WE	EDS	
TVE AREAS RESTORATION AND ESD CONTROL DEED CONTROL, NON-SELECTIVE AND ON-RESIDUAL (AQUATIC) DILLI, TURF AREAS TO BE INTERSEEDED WITH ATTVE SEEDING AND AS DIRECTED BY THE NGINEER FEED CONTROL, NATIVE LANDSCAPE EMEDIATION LECTIVE, SPOT SPRAYING AS DIRECTED BY THE NGINEER FERSEEDING, CLASS 4, 4A, 5, & 5A PRING SEEDING: MARCH 15 TO MAY 15	AS N	EEDED TO	RK					S									AS NEEDE	ED TO CONTRO	DL WEEDS									AS I	NEEDED TO	CONTROL WE	EDS	
D CONTROL TEED CONTROL, NON-SELECTIVE AND ON-RESIDUAL (AQUATIC) OKILL TURF AREAS TO BE INTERSEEDED WITH ATIVE SEEDING AND AS DIRECTED BY THE GINTER EED CONTROL, NATIVE LANDSCAPE MEDIATION LICTIVE, SPOT SPRAYING AS DIRECTED BY THE GINEER RESEBUING, CLASS 4, 4A, 5, & 5A	AS N	EEDED TO	RK					S	DORM	MANT INTERS	EEDING						AS NEEDE	ED TO CONTRO	DL WEEDS			DORMAN INTERSEC (IF NEED)	ING DOR	RMANT INTERSEE (IF NEEDED)	EDING			ASI	NEEDED TO	CONTROL WE	EDS	
DECONTROL EED CONTROL, NON-SELECTIVE AND ON-RESIDUAL (AQUATIC) KILL TURR AREAS TO BE INTERSEEDED WITH HITTES SEEDING AND AS DIRECTED BY THE GINEER EED CONTROL, NATIVE LANDSCAPE MEDIATION LECTIVE, SPOT SPRAYING AS DIRECTED BY THE GINEER RSEEDING, CLASS 4, 4A, 5, & 5A RING SEEDING: MARCH 15 TO MAY 15 DEMANT SEEDING: NOVEMBER 15 TO MARCH	AS N	EEDED TO	RK					S	DORA	MANT INTERS	EEDING						AS NEEDE	ED TO CONTRO	DL WEEDS			INTERSEED	ING DOR		EDING			ASI	NEEDED TO	CONTROL WE	EDS	
DECONTROL EED CONTROL, NON-SELECTIVE AND ON-RESIDUAL (AQUATIC) KILL TURF AREAS TO BE INTERSEEDED WITH ITTUS SEEDING AND AS DIRECTED BY THE GINEER EED CONTROL, NATIVE LANDSCAPE MEDIATION LECTIVE, SPOT SPRAYING AS DIRECTED BY THE GINEER RSEEDING, CLASS 4, 4A, 5, & 5A RING SEEDING: MARCH 15 TO MAY 15 DRMANT SEEDING: NOVEMBER 15 TO MARCH ING, CLASS 4, 4A, 5, & 5A	AS N	EEDED TO	RK					S		MANT INTERS							AS NEEDE	ED TO CONTRO	DL WEEDS			INTERSEED	IT DOR					ASI	NEEDED TO	CONTROL WE	EDS	
CONTROL IED CONTROL, NON-SELECTIVE AND IN-RESIDUAL (AQUATIC) KILL TURF AREAS TO BE INTERSEEDED WITH TIVE SEEDING AND AS DIRECTED BY THE SIGNEER IED CONTROL, NATIVE LANDSCAPE MEDIATION ECTIVE. SPOT SPRAYING AS DIRECTED BY THE GINEER RESEEDING, CLASS 4, 4A, 5, & 5A RING SEEDING: MOVEMBER 15 TO MARCH ING, CLASS 4, 4A, 5, & 5A RING SEEDING: MOVEMBER 15 TO MAY 15 RMANT SEEDING: MARCH 15 TO MAY 15 RMANT SEEDING: MARCH 15 TO MAY 15	AS N	EEDED TO	RK					S									AS NEEDE	ED TO CONTRO	DL WEEDS			INTERSEED (IF NEEDE DORMAN	IT DOR	(IF NEEDED)				ASI	NEEDED TO	CONTROL WE	EDS	
CONTROL ED CONTROL, NON-SELECTIVE AND N-RESIDUAL (AQUATIC) KILL TURF-AREAS TO BE INTERSEEDED WITH THE SEEDING AND AS DIRECTED BY THE INNERR ED CONTROL, NATIVE LANDSCAPE REDIATION CICTIVE. SPOT SPRAYING AS DIRECTED BY THE INSER SEEDING, CLASS 4, 4A, 5, & 5A ING SEEDING: MARCH 15 TO MAY 15 RMANT SEEDING: NOVEMBER 15 TO MARCH NG, CLASS 4, 4A, 5, & 5A ING SEEDING: MARCH 15 TO MAY 15 RMANT SEEDING: MARCH 15 TO MAY 15 RMANT SEEDING: MARCH 15 TO MAY 15 RMANT SEEDING: MARCH 15 TO MAY 15	AS N	EEDED TO	RK					S								MOW TO G		ED TO CONTRO				INTERSEED (IF NEEDE DORMAN	IT DOR	(IF NEEDED)			h			CONTROL WE		
CONTROL D CONTROL, NON-SELECTIVE AND HERSIDUAL (AQUATIC) IILL TURF AREAS TO BE INTERSEEDED WITH IVE SEEDING AND AS DIRECTED BY THE INSEER D CONTROL, NATIVE LANDSCAPE IEDIATION CITYLE: SPOT SPRAYING AS DIRECTED BY THE INSEER SEEDING, CLASS 4, 4A, 5, & 5A ING SEEDING: MARCH 15 TO MAY 15 IMANT SEEDING: NOVEMBER 15 TO MARCH IG, CLASS 4, 4A, 5, & 5A ING SEEDING: MARCH 15 TO MAY 15 IMANT SEEDING: MOVEMBER 15 TO MARCH NG (ACRE) ING INCERNATION OF STONE OF S	AS N	EEDED TO	RK					S								Mow to 0						INTERSEED (IF NEEDE DORMAN	IT DOR	(IF NEEDED)			N					


AECOM	
303 EAST WACKER DRIVE, SUITE 1400 CHICAGO, IL 60601-5276 PHONEs (312) 373-7700 FAX: (312) 373-6800	

USER NAME = HENAOC	DESIGNED - KP	REVISED -
	DRAWN - CRH	REVISED -
PLOT SCALE = 1147.4995 '/ in.	CHECKED - MJE	REVISED -
PLOT DATE = 12/12/2017	DATE - 10/20/2017	REVISED -

STAT	E OF	ILLINOIS
DEPARTMENT	0F	TRANSPORTATION

SCALE

	NIDOO A DINI		ONOTOLI	TION	COUEDINE	F.A.I. RTE.	SECTION	COUNTY	TOTAL	
LANDSCAPING CONSTRUCTION SCHEDULE					SCHEDOLE	55	2015-036LS	COOK	84	11
								CONTRACT	NO.	62A93
SHE	EET NO. 3 O	F 3	SHEETS	STA.	TO STA.		ILLINOIS FED. AI	D PROJECT		

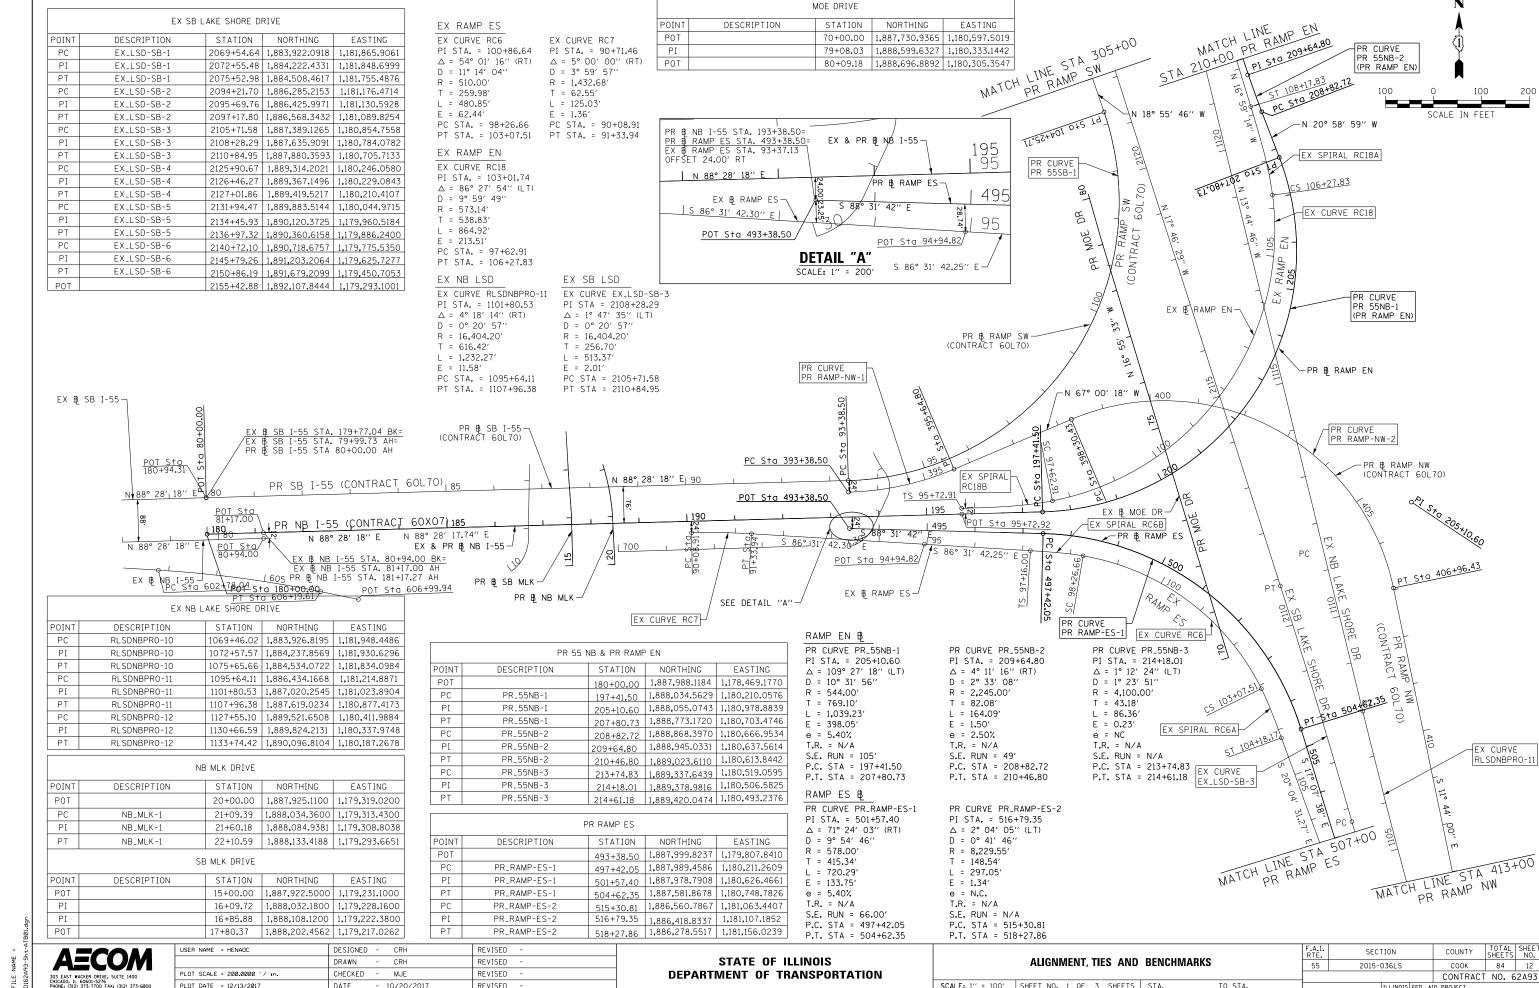


DATE

- 10/20/201

REVISED

PLOT DATE = 12/13/2017

- 10/20/201

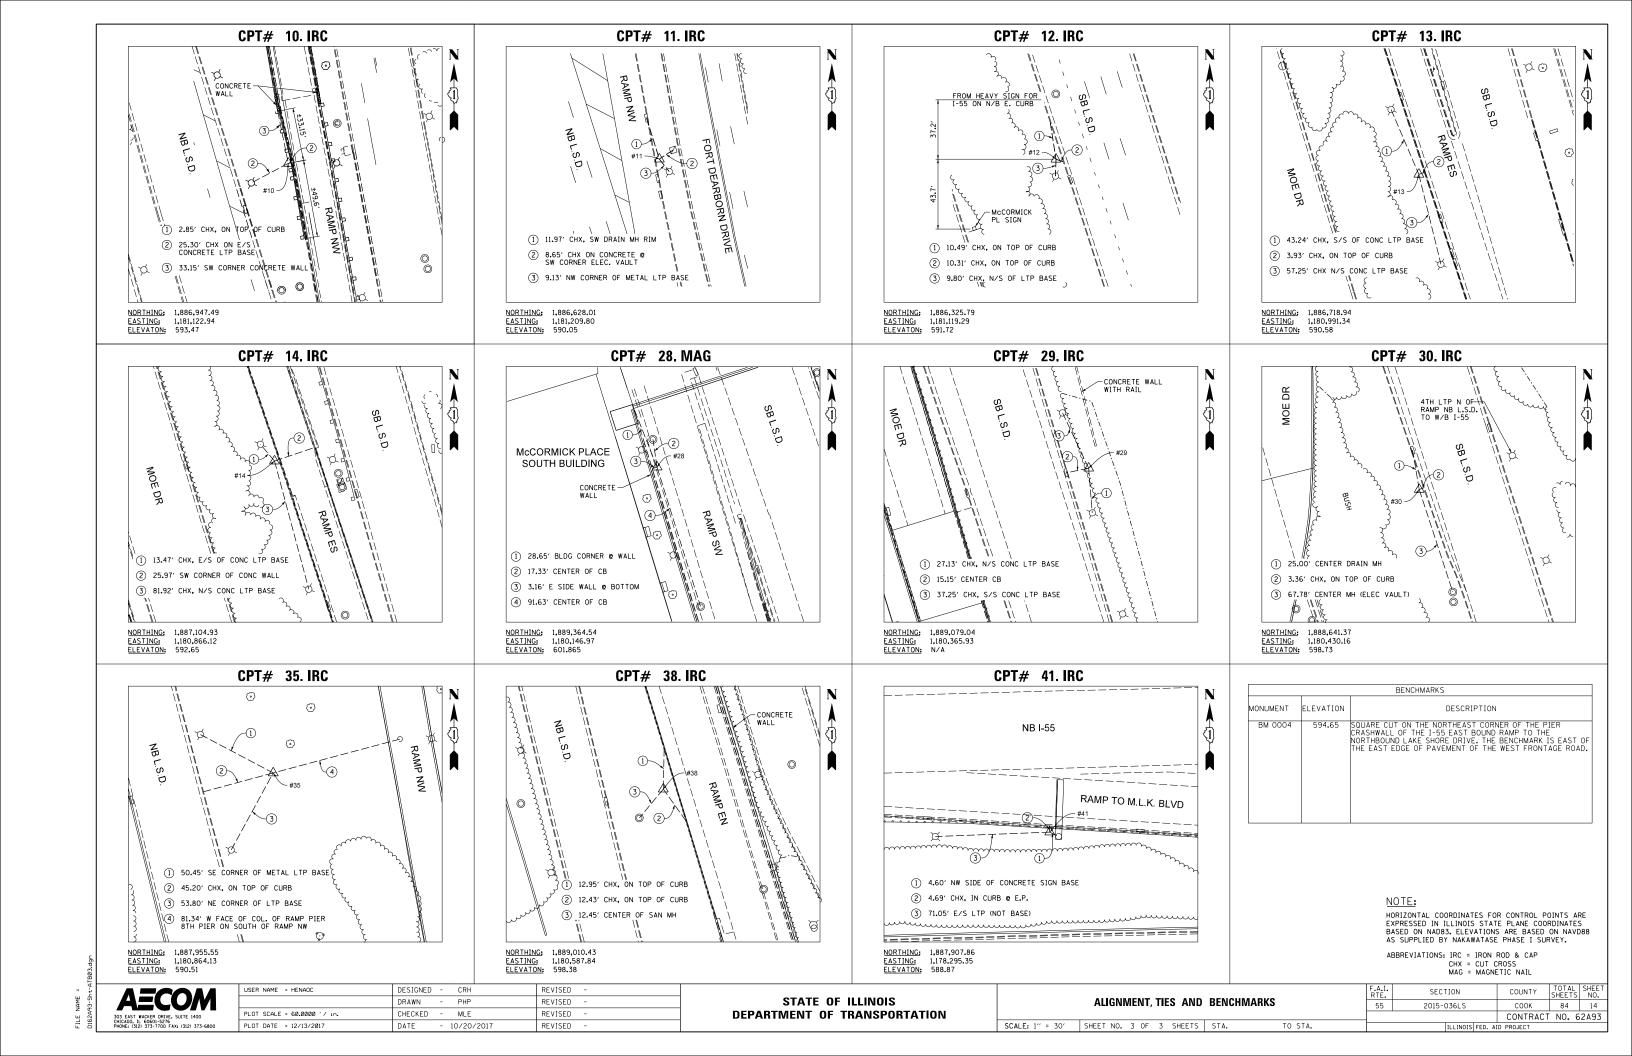

PROPOSED TREE LEGEND

EXISTING LEGEND

EXISTING TREE TO REMAIN


SOIL BORING LOCATION

TREE REMOVAL

TREE PROTECTION (PAID FOR AS TEMPORARY FENCE)

EROSION CONTROL BLANKET
SEEDING, CLASS 2A
TOPSOIL FURNISH AND PLACE, 6"

INSTALLED BY
CONTRACT 60L70 &
CONTRACT 60X07

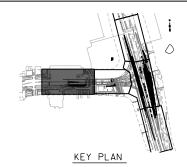

EXISTING CONDITIONS & REMOVALS

SCALE: 1" = 50' SHEET NO. 1 OF 5 SHEETS STA. 180+86.00 TO STA. 188+50.00


SECTION

2015-036LS

COUNTY

COOK 84 15

CONTRACT NO. 62A93

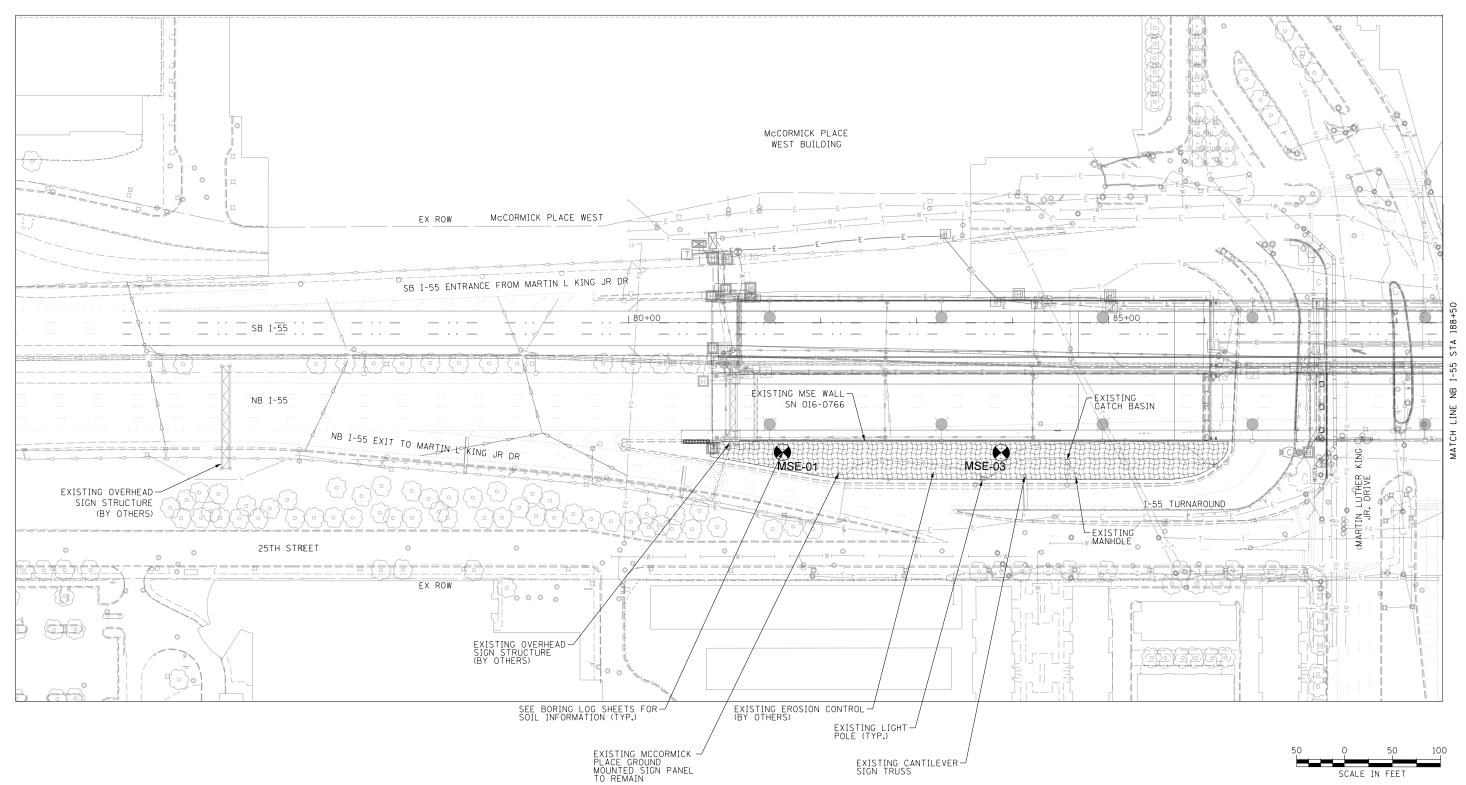

STATE OF ILLINOIS

DEPARTMENT OF TRANSPORTATION

USER NAME = HENAOC

PLOT DATE = 12/13/2017

PLOT SCALE = 100.0001 '/ in.

DESIGNED -

DRAWN

CHECKED

CRH

MJE

- 10/20/201

REVISED

REVISED

REVISED

REVISED


TREE REMOVAL

TREE PROTECTION (PAID FOR AS TEMPORARY FENCE)


EXISTING LEGEND

SOIL BORING LOCATION

EROSION CONTROL BLANKET SEEDING, CLASS 2A TOPSOIL FURNISH AND PLACE, 6" SEONTRACT 60X77

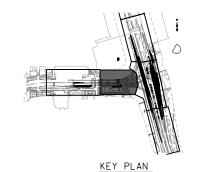

MATCH STA JOY PAMP SW 7 EXISTING EROSION -CONTROL (BY OTHERS) McCORMICK PLACE SOUTH BUILDING EX ROW PR RAMP EN NB I-55 1 495+00 PR RAMP ES 25TH STREET STUMP REMOVAL ONLY (5-8" DIA.) STR-10 MARTIN Leking RAMP 9+00 McCORMICK PLACE PARKING LOT B TREE REMOVAL -(6 TO 15 UNITS DIAMETER) ВВ McCORMICK BUSWAY SELECTIVE CLEARING— (FOR SHRUBS, BUSHES, AND SAPLINGS ALONG EX ROW SEE BORING LOG SHEETS -FOR SOIL INFORMATION (TYP.) FENCE)

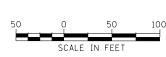



USER NAME = HENAOC	DESIGNED - KP	REVISED -
	DRAWN - CRH	REVISED -
PLOT SCALE = 100.0001 '/ in.	CHECKED - MJE	REVISED -
PLOT DATE = 12/13/2017	DATE - 10/20/2017	REVISED -

STATE OF	ILLINOIS
DEPARTMENT OF T	RANSPORTATION

I					F.A.I. RTE.	SECTION	COUNTY	TOTAL SHEETS	SHEET NO.
ı		EXISTING CONDITION	S & REMOVALS		55	2015-036LS	соок	84	16
L							CONTRAC	T NO. 6	52A93
	SCALE: 1" = 50"	SHEET NO. 2 OF 5 SHEET	STA. 188+50.00	TO STA. 199+00.00		ILLINOIS FED.	AID PROJECT		

PROPOSED TREE LEGEND

EXISTING LEGEND

EXISTING TREE TO REMAIN



SOIL BORING LOCATION




TREE REMOVAL

TREE PROTECTION (PAID FOR AS TEMPORARY FENCE)

EROSION CONTROL BLANKET
SEEDING, CLASS 2A
TOPSOIL FURNISH AND PLACE, 6"

| INSTALLED BY CONTRACT 60L70 & CONTRACT 60X07

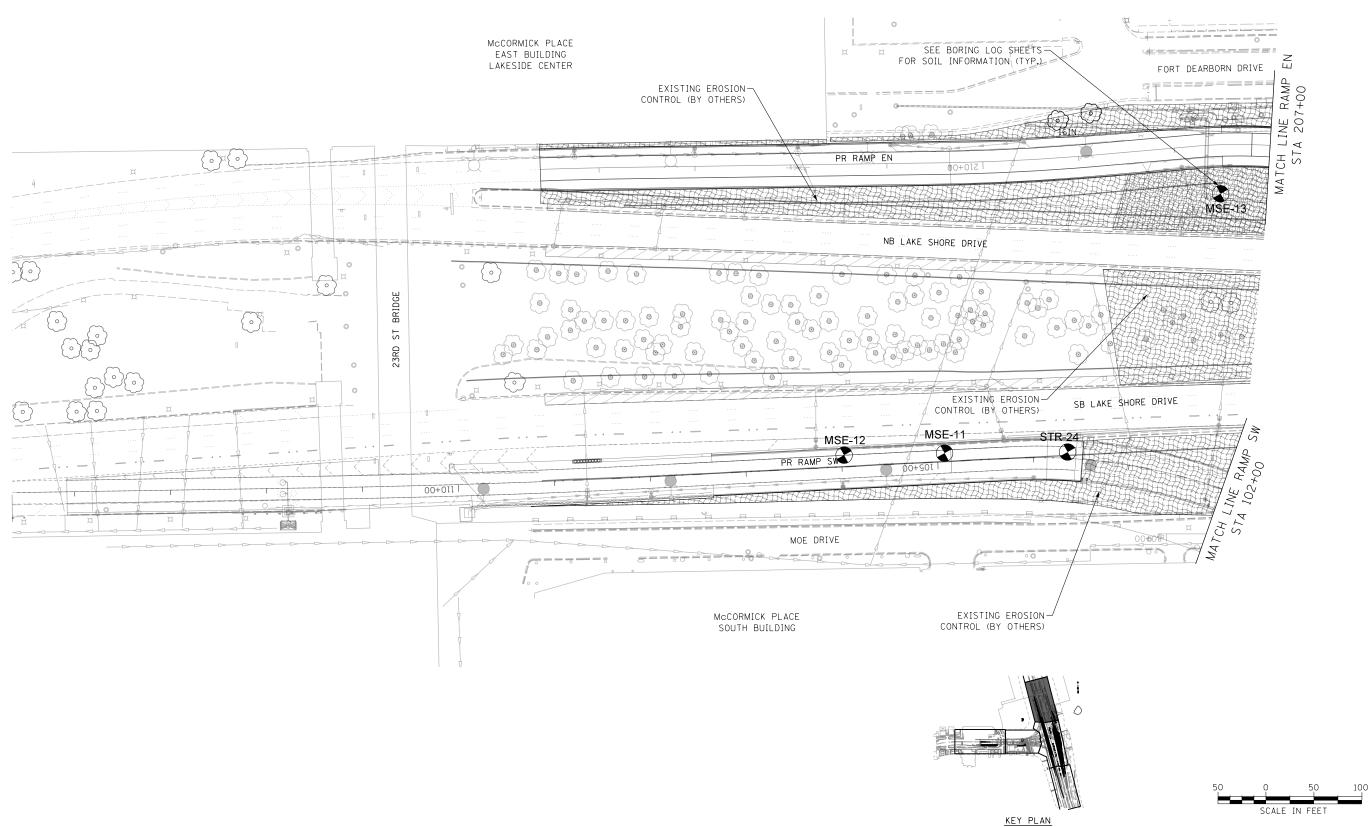



USER NAME = HENAOC	DESIGNED - KP	REVISED -
	DRAWN - CRH	REVISED -
PLOT SCALE = 100.0001 ' / 10.	CHECKED - MJE	REVISED -
PLOT DATE = 12/13/2017	DATE - 10/20/2017	REVISED -

STATE OF ILLINOIS **DEPARTMENT OF TRANSPORTATION**


SCALE: 1"


	5.// 0.Elb/					F.A.I. RTE.	SECTION	COUNTY
	EXISTING	i CONI	JIHONS	& REMOVALS		55	2015-036LS	COOK
								CONTRA
= 50'	SHEET NO. 3	0F 5	SHEETS	STA. 207+00	TO STA. 214+60.73		ILLINOIS FED. A	ID PROJECT

COUNTY TOTAL SHEET NO.


COOK 84 17


CONTRACT NO. 62A93

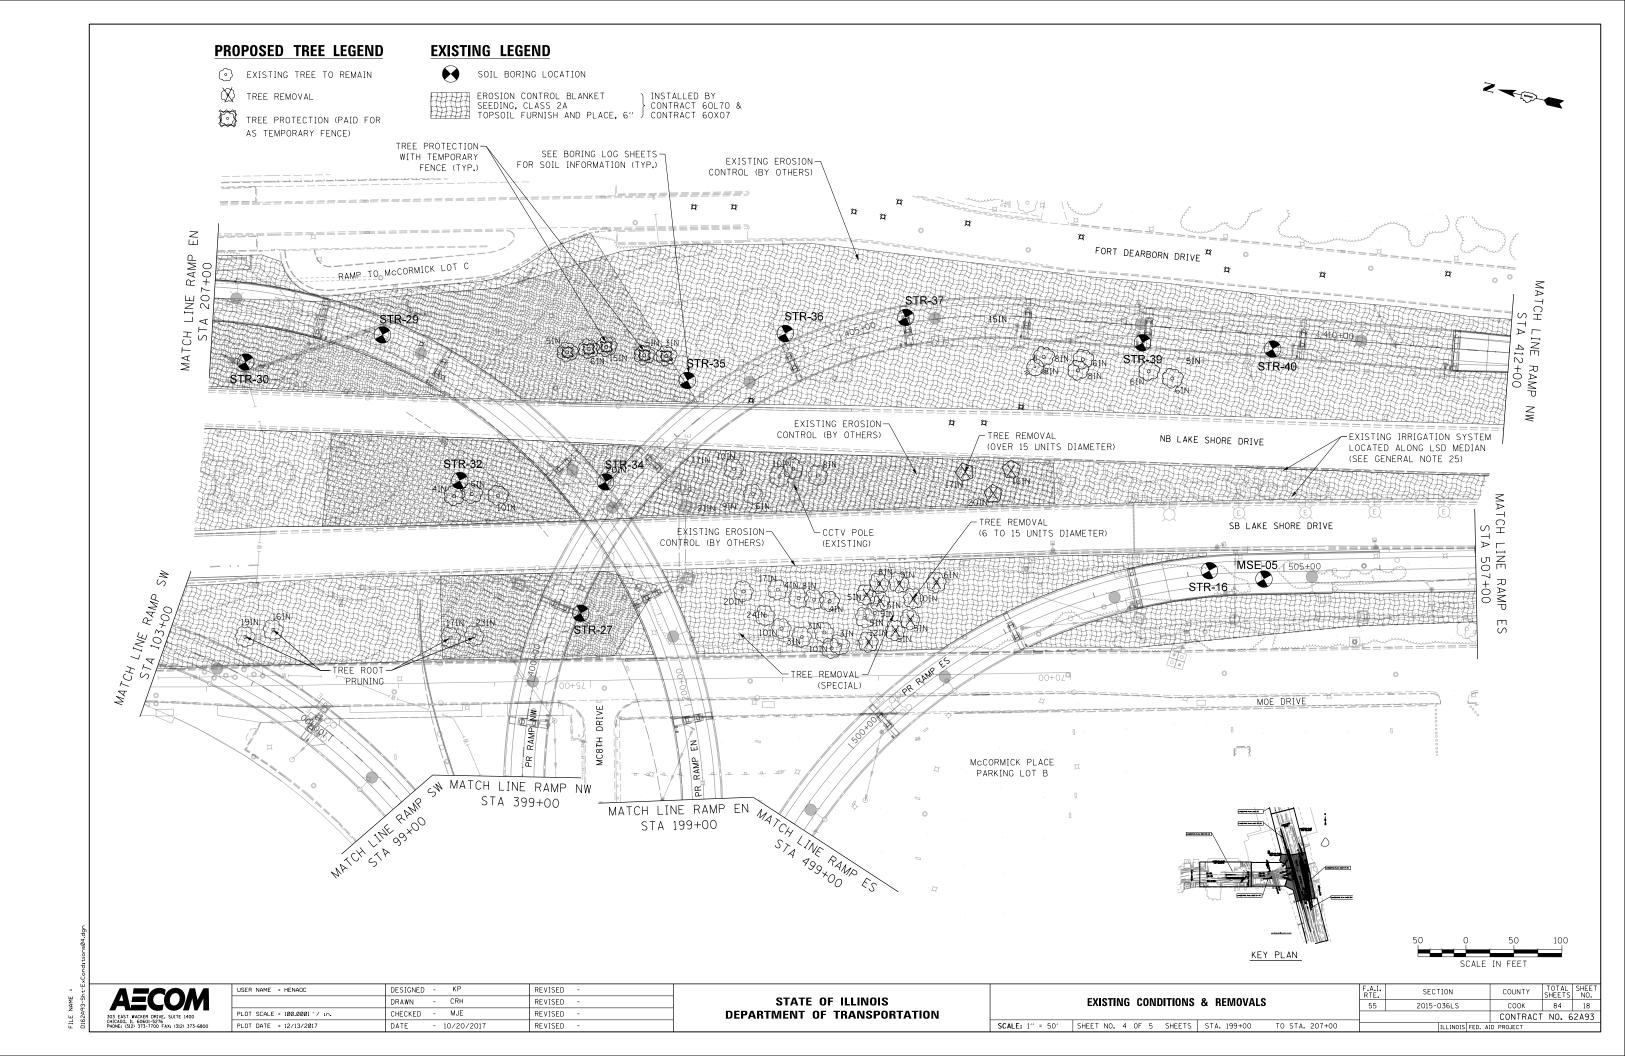

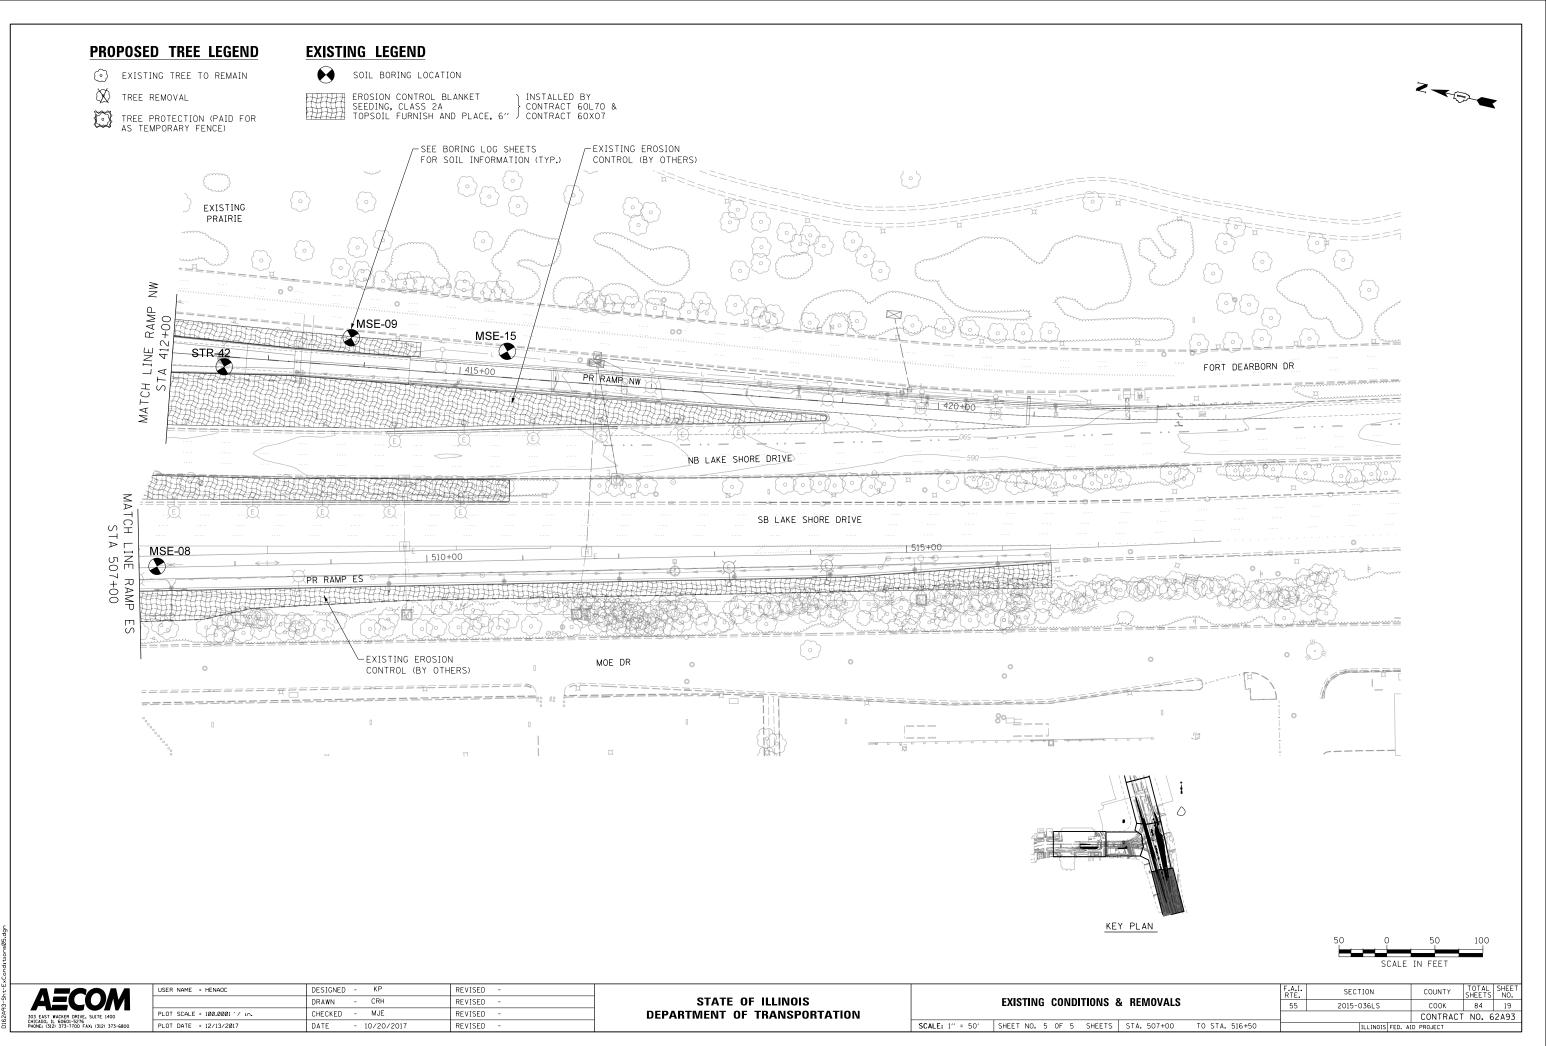

FILE NAME =

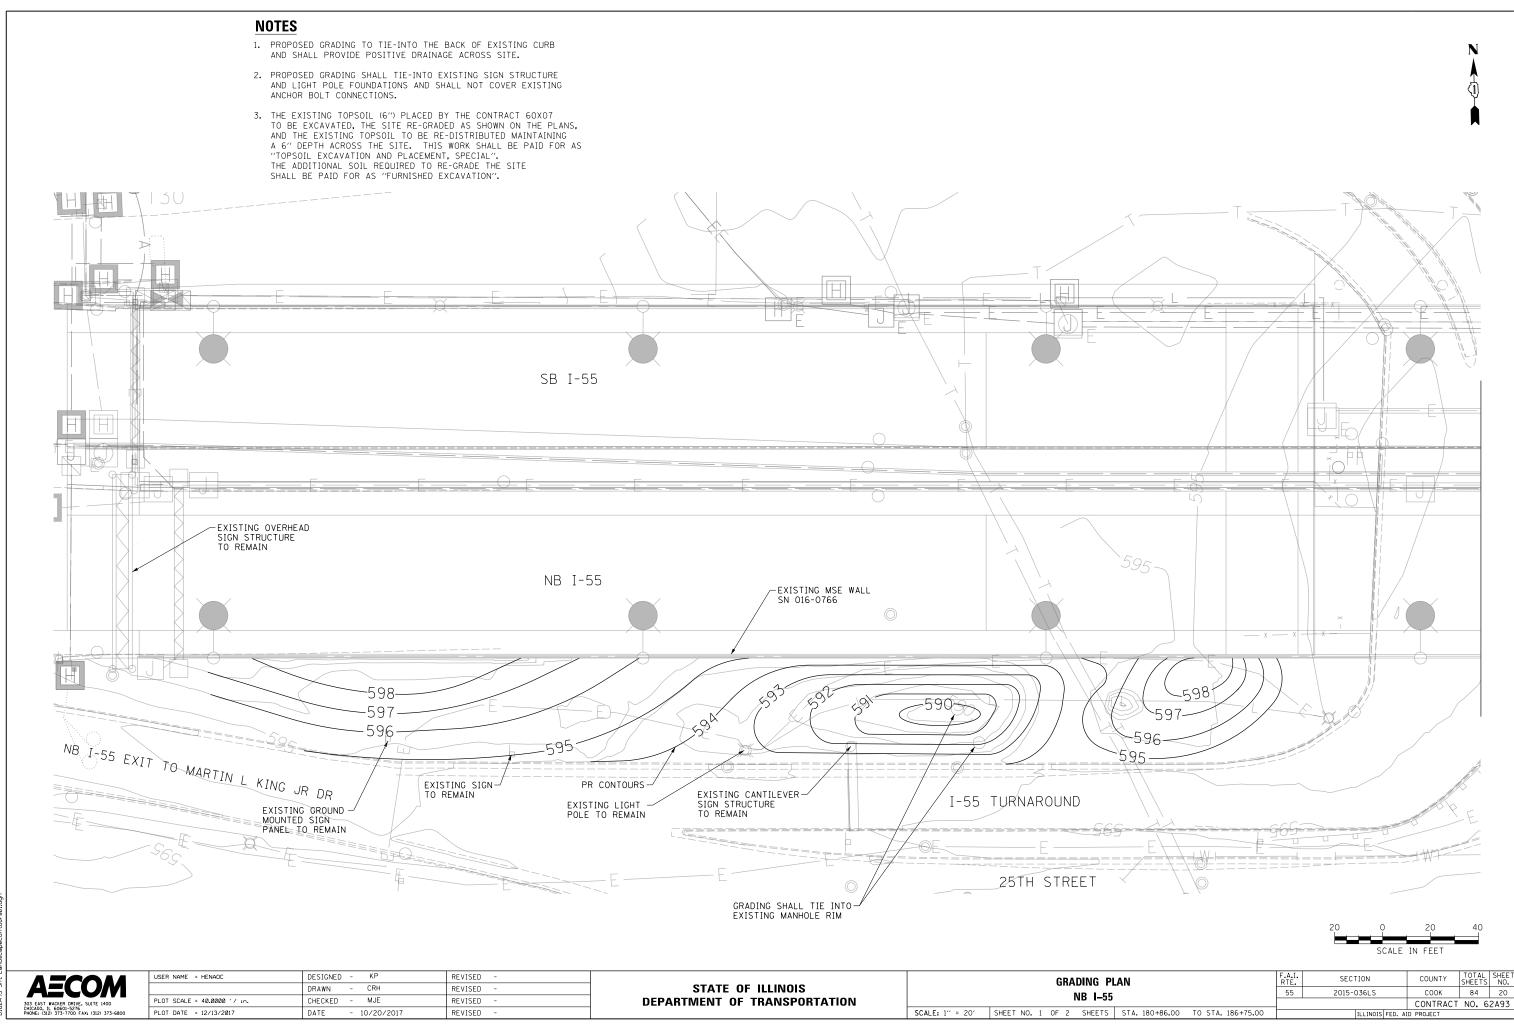

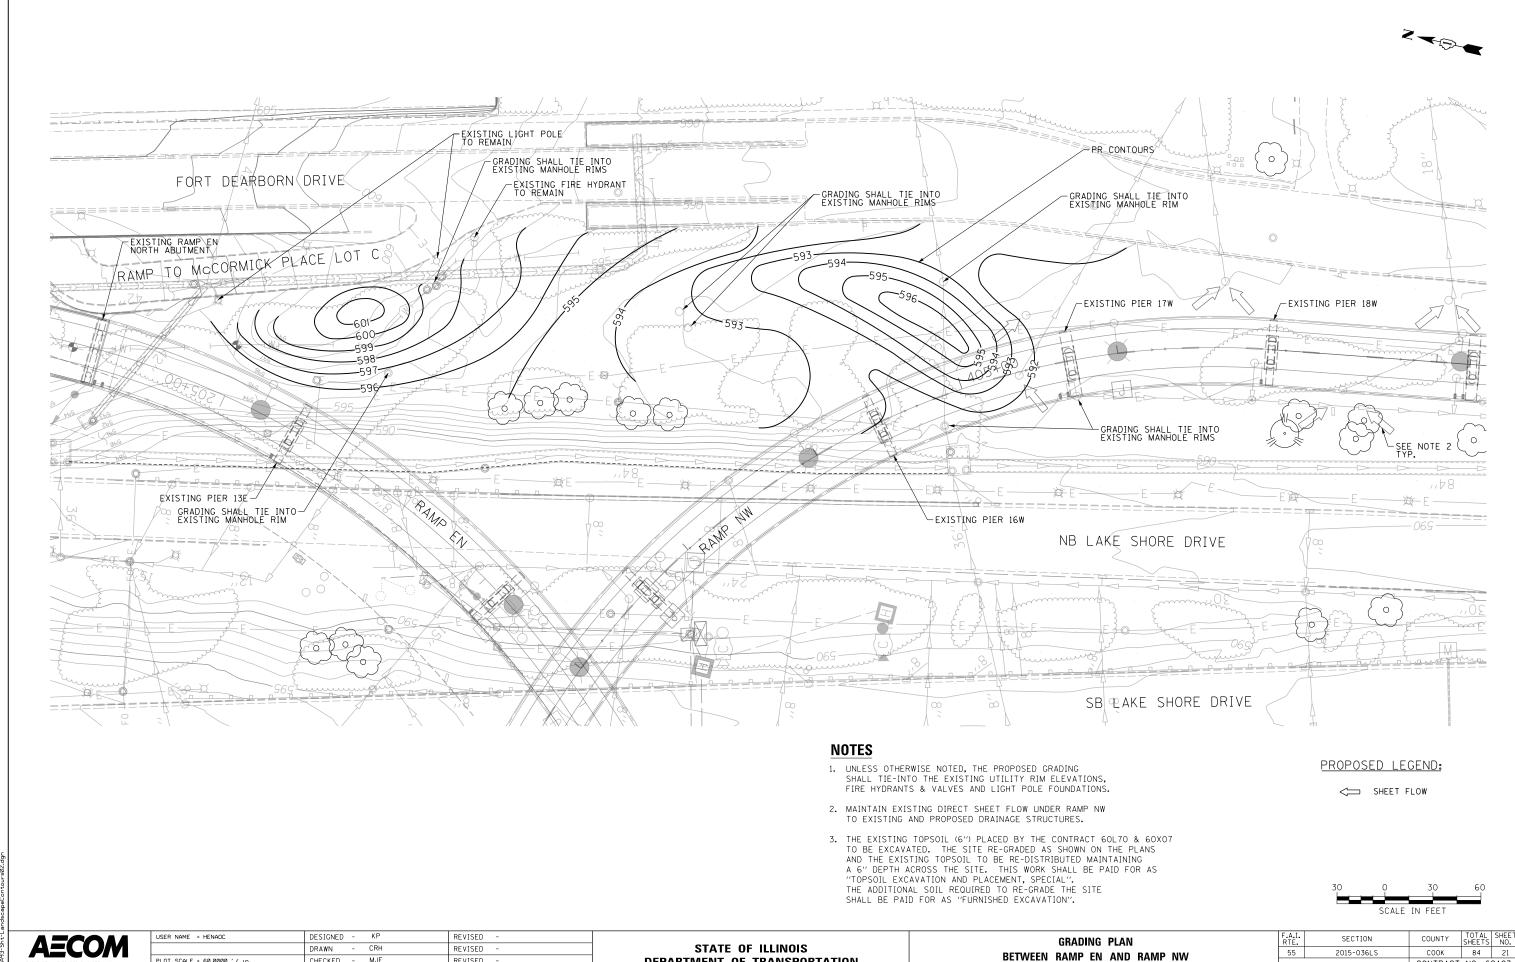

DEPARTMENT OF TRANSPORTATION

SCALE: 1" = 30' SHEET NO. 2 OF 2 SHEETS STA. 206+00 TO STA. 407+00

CONTRACT NO. 62A93

PLOT SCALE = 60.0000 '/ in.

PLOT DATE = 12/13/2017

CHECKED


DATE


MJE

- 10/20/201

REVISED

REVISED

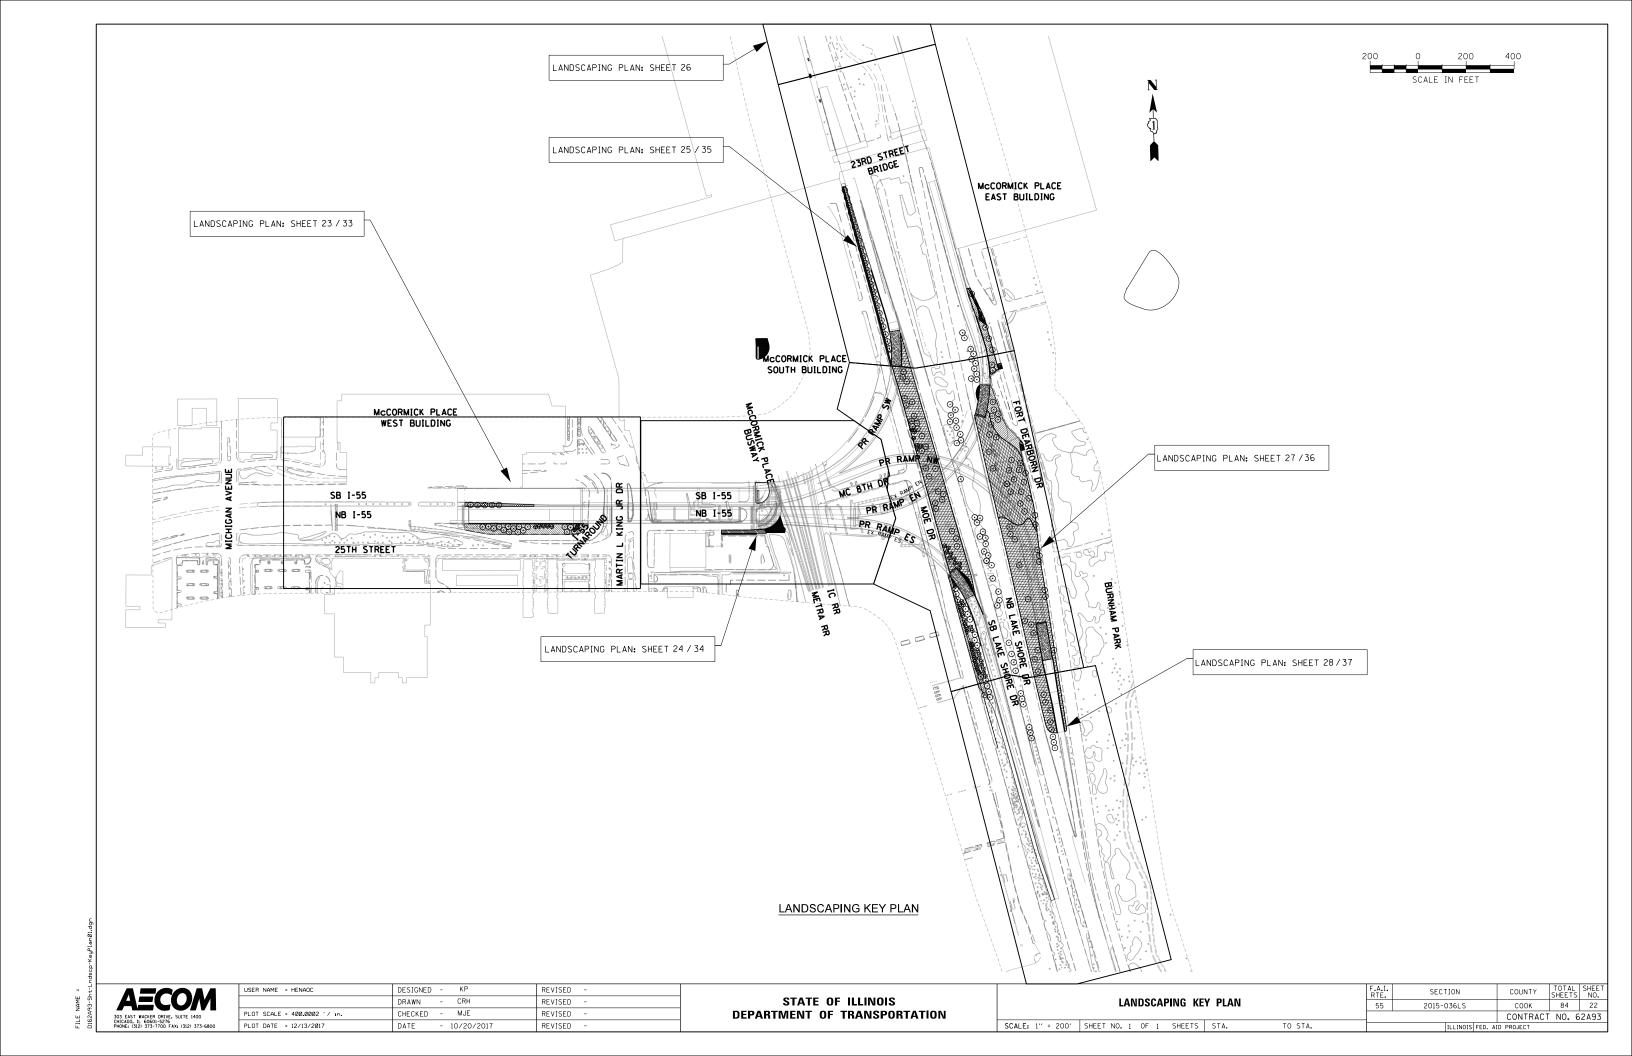

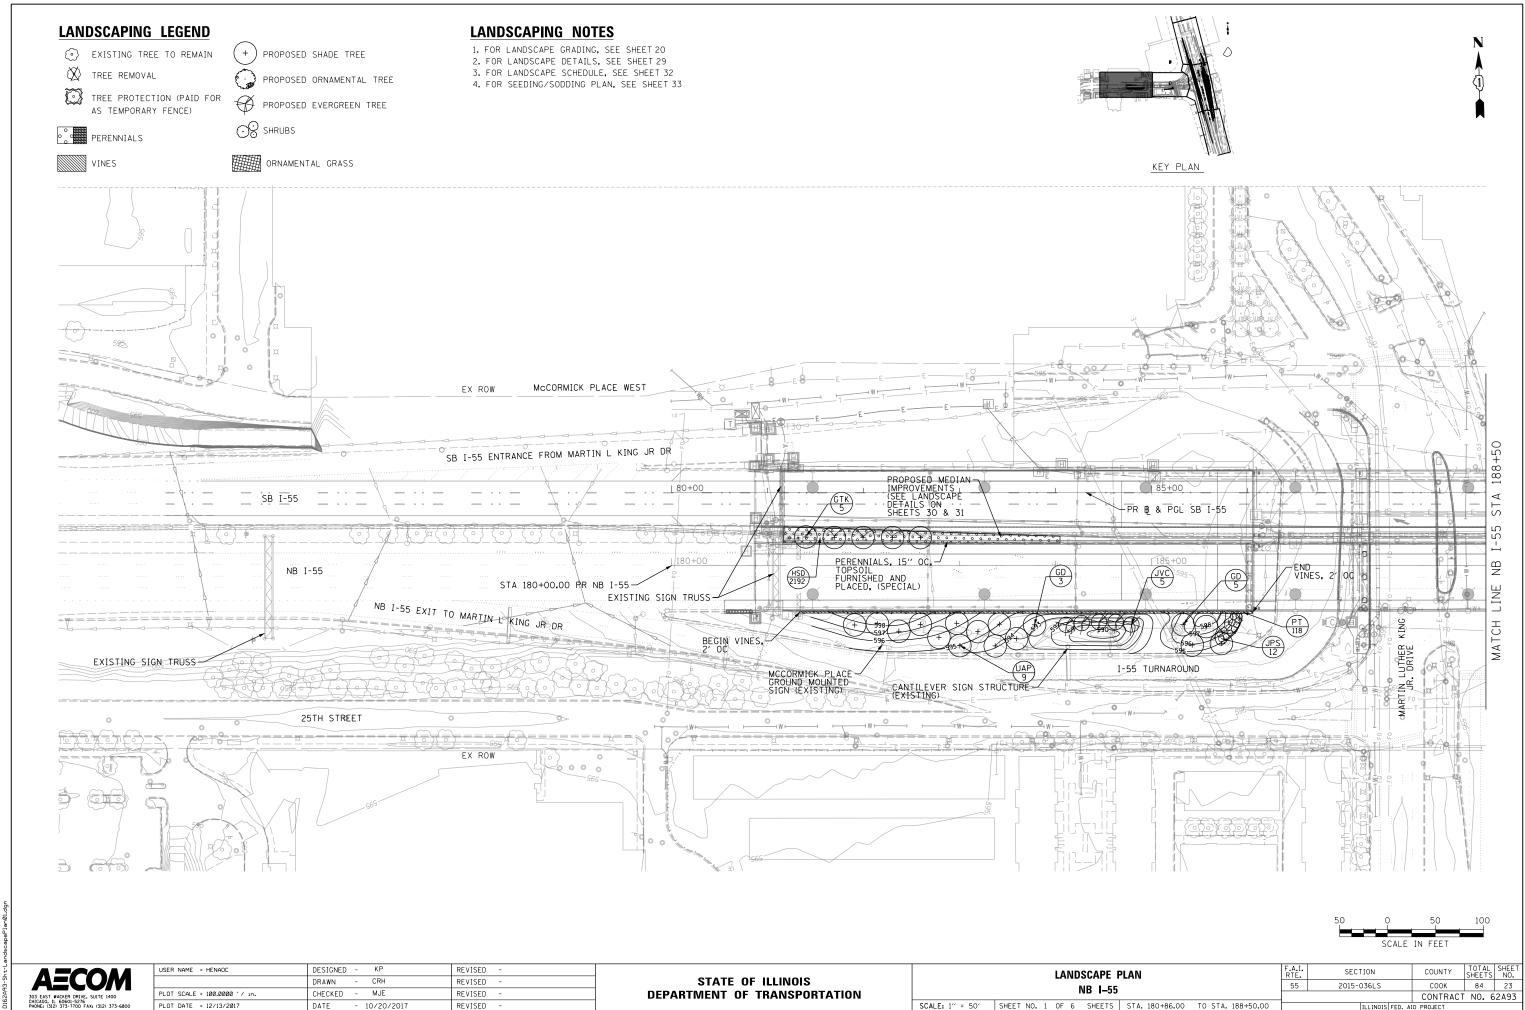

LANDSCAPING LEGEND

EXISTING TREE TO REMAIN

TREE REMOVAL

TREE PROTECTION (PAID FOR

AS TEMPORARY FENCE)

PERENNIALS

VINES

+) PROPOSED SHADE TREE

PROPOSED ORNAMENTAL TREE

PROPOSED EVERGREEN TREE

⊙ SHRUBS


NB

MATCH

ORNAMENTAL GRASS

LANDSCAPING NOTES

- 1. FOR LANDSCAPE DETAILS, SEE SHEET 29 2. FOR LANDSCAPE SCHEDULE, SEE SHEET 32
- 3. FOR SEEDING/SODDING PLAN, SEE SHEET 34

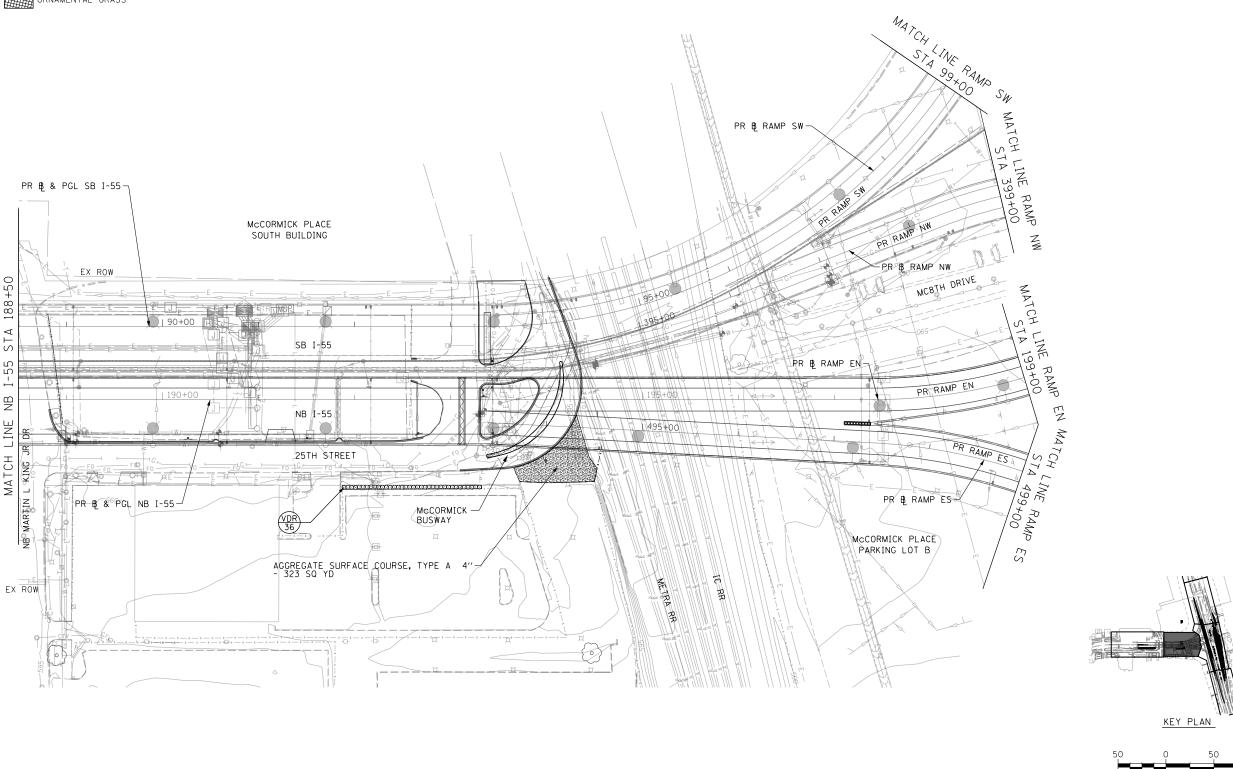




	USER NAME = HENAOC	DESIGNED - KP	REVISED -
		DRAWN - CRH	REVISED -
	PLOT SCALE = 100.0000 ' / in.	CHECKED - MJE	REVISED -
	PLOT DATE = 12/13/2017	DATE - 10/20/2017	REVISED -
_			

STATE OF ILLINOIS **DEPARTMENT OF TRANSPORTATION**

	LANDSCAPE	PLAN		F.A.I. RTE.	SECTION	COUNTY	TOTAL SHEETS	SHEET NO.
	NB I-55			55	2015-036LS	соок	84	24
	NB 1-33	'				CONTRACT	NO. 6	S2A93
SCALE: 1" = 50"	SHEET NO. 2 OF 6 SHEETS	STA. 188+50.00	TO STA. 199+00.00		ILLINOIS FED. A	ID PROJECT		

SCALE IN FEET

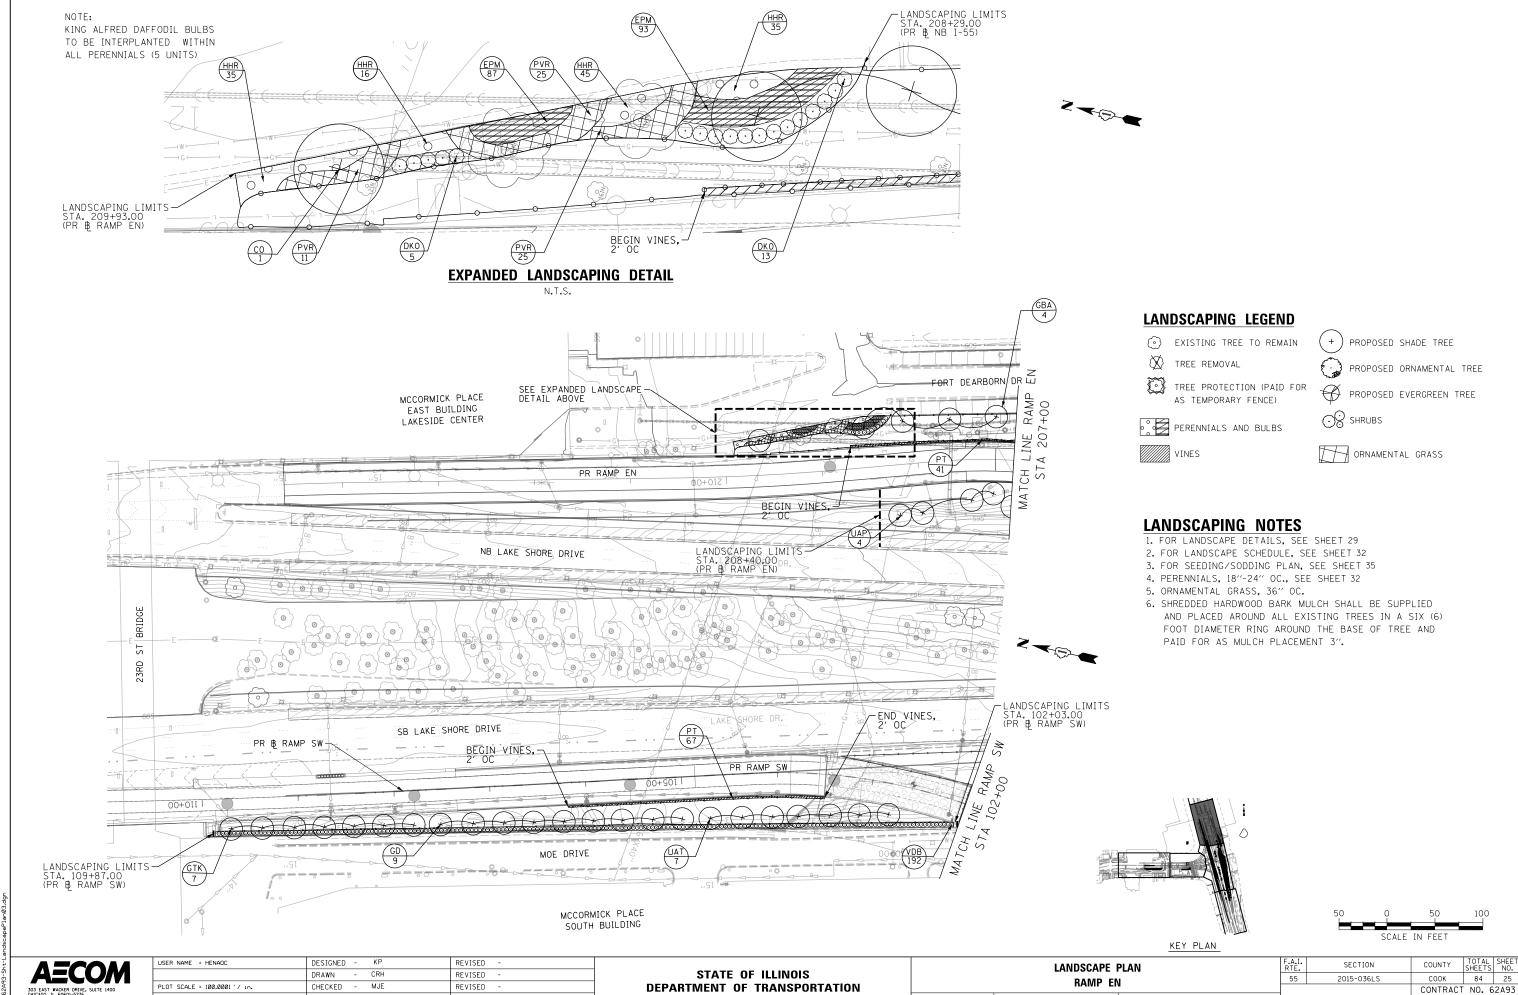


SCALE: 1" = 50' SHEET NO. 3 OF 6 SHEETS STA. 207+00 TO STA. 214+60.73

PLOT DATE = 12/13/2017

DATE

- 10/20/201

REVISED

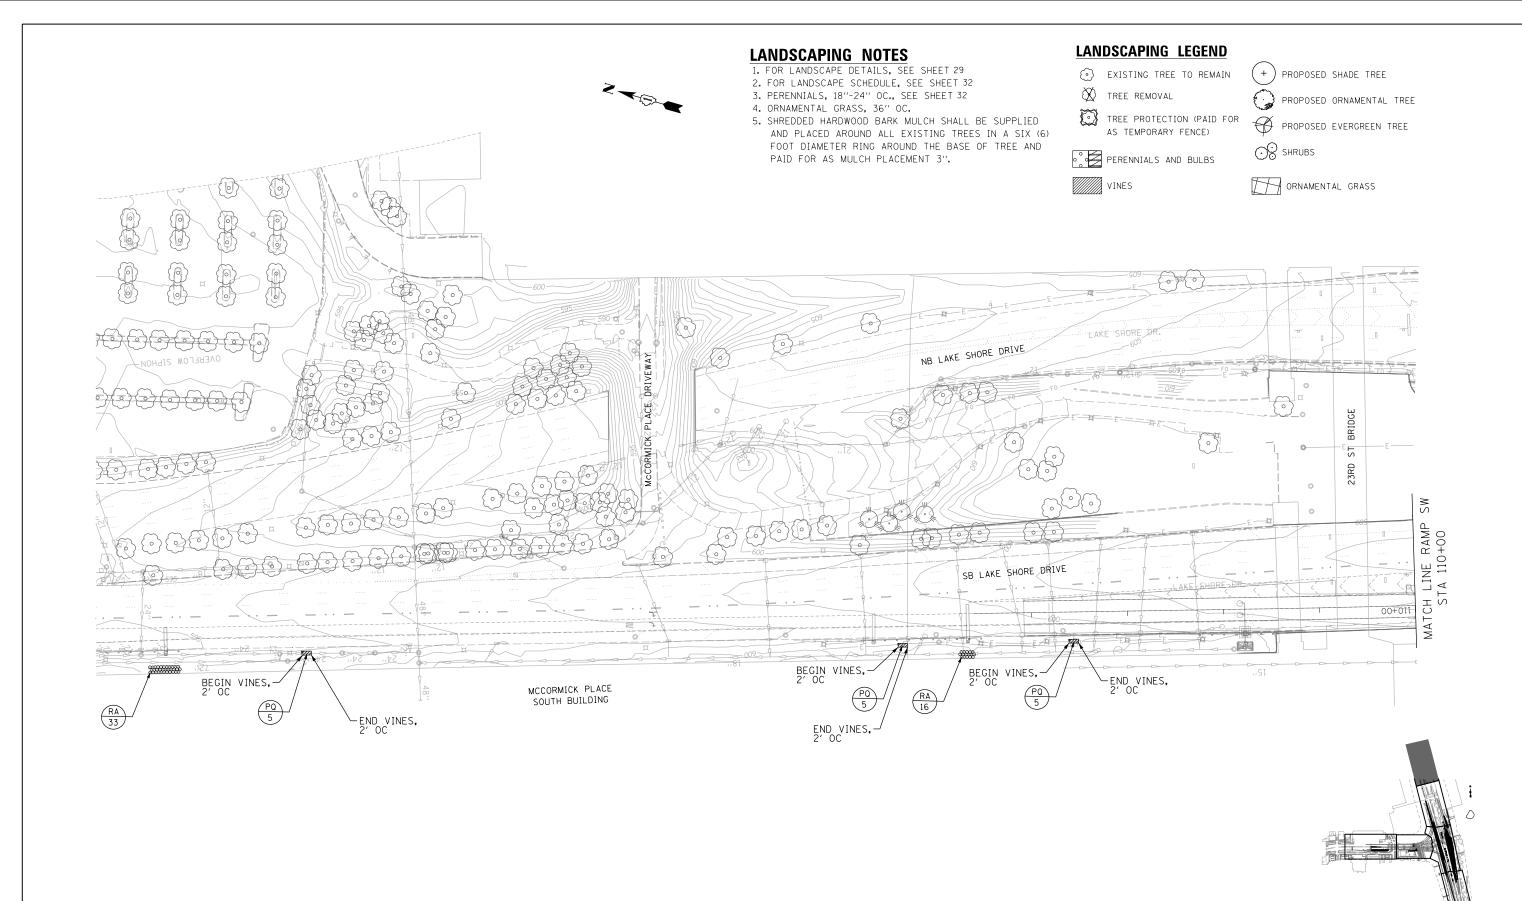

AECOM 303 EAST WACKER DRIVE. SUITE 1400 CHICAGO, IL 60601-5276
PHONE: (312) 373-7700 FAX: (312) 373-6800

USER NAME = HENAOC	DESIGNED - KP	REVISED -
	DRAWN - CRH	REVISED -
PLOT SCALE = 100.0001 ' / in.	CHECKED - MJE	REVISED -
PLOT DATE = 12/13/2017	DATE - 10/20/2017	REVISED -

STATE OF ILLINOIS DEPARTMENT OF TRANSPORTATION


		LANDSCAPE			F.A.I. RTE.	
		RAMP SW E			55	
		23RD ST &	<u> 1814 SI.</u>			
SCALE: 1" = 50"	SHEET NO.	4 OF 6 SHEETS	STA. 110+00.00	TO STA. 114+00.00		

F.A.I. SECTION COUNTY TOTAL SHEET NO.


55 2015-036LS COOK 84 26

CONTRACT NO. 62A93

KEY PLAN

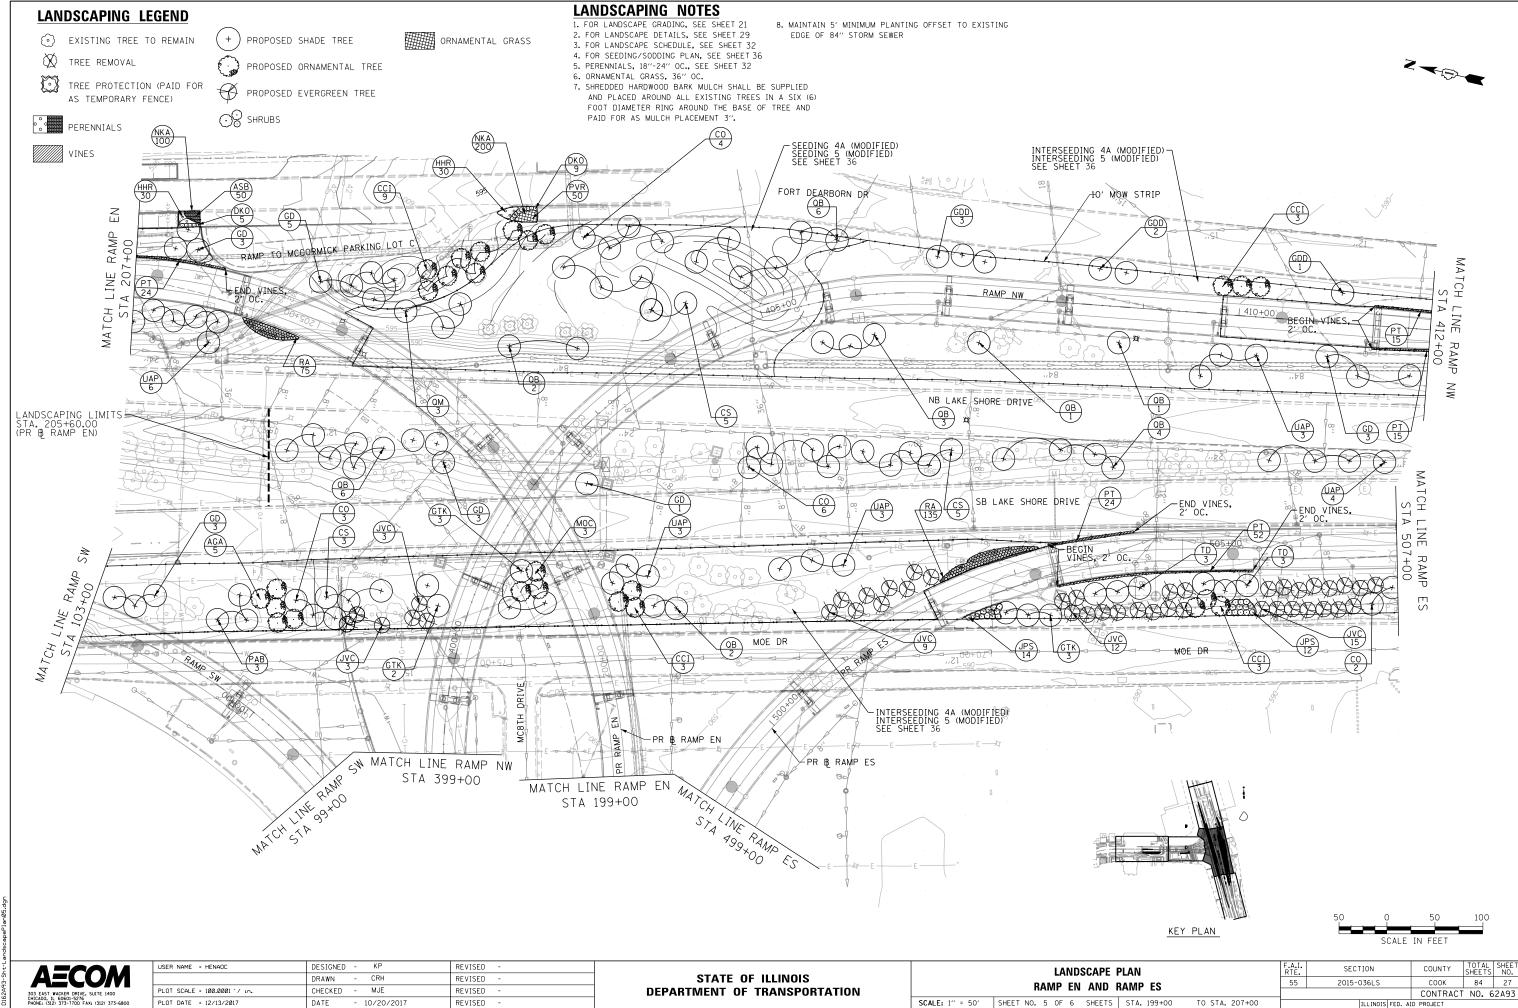

FILE NAME =

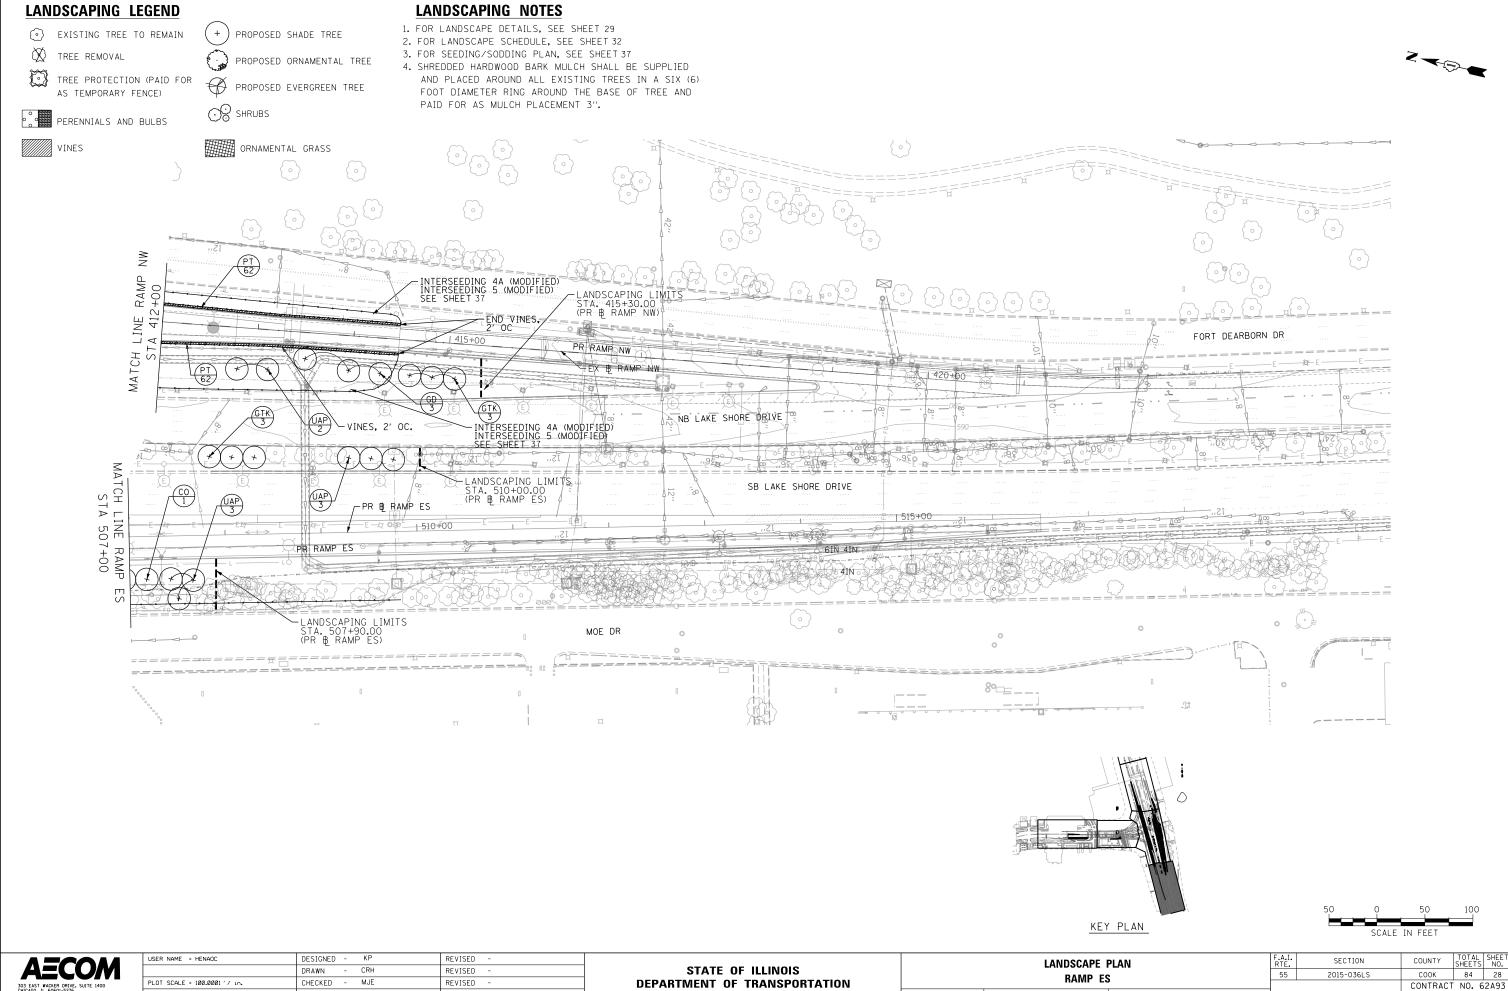

SCALE: 1" = 50' SHEET NO. 6 OF 6 SHEETS STA. 507+00 TO STA. 516+50


D162A93-Sht-Landsca

PLOT DATE = 12/13/2017


DATE

- 10/20/2017

REVISED

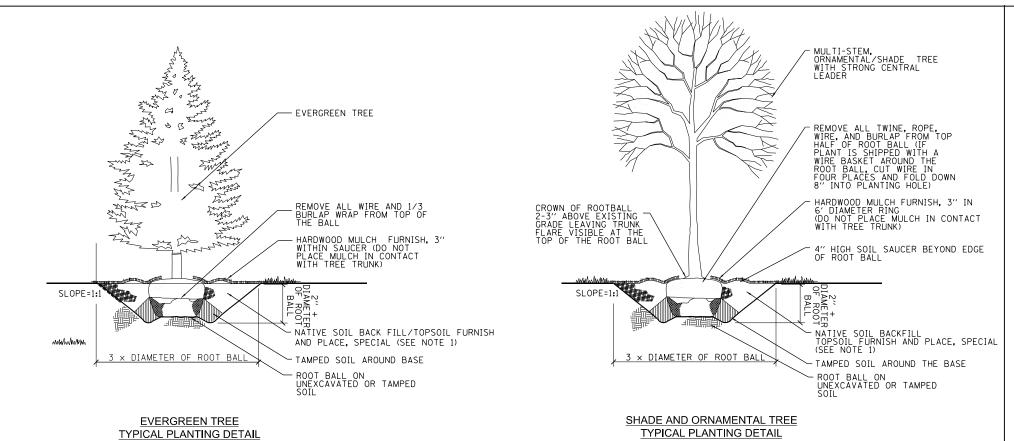


NOTE: PLANT BEDS FOR ALL PLANTING TO BE MARKED AND VERIFIED BY IDOT ROADSIDE DEVELOPMENT UNIT PRIOR TO PLANTING INSTALLATION. CONTACT (847) 705-4171 OR ENGINEER WITH 3 DAYS NOTICE.

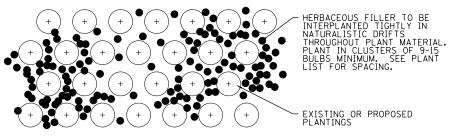


INTERPLANTING DETAIL - SINGLE BULB SPECIES

NOT TO SCALE

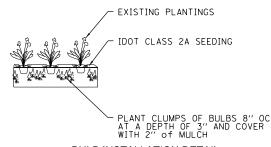


BULB INSTALLATION DETAIL


NOT TO SCALE

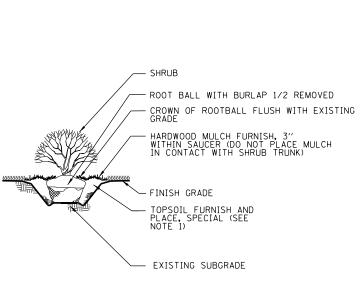

NOT TO SCALE

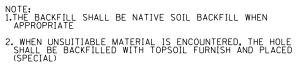


SHRUB PLANTING DETAIL NOT TO SCALE

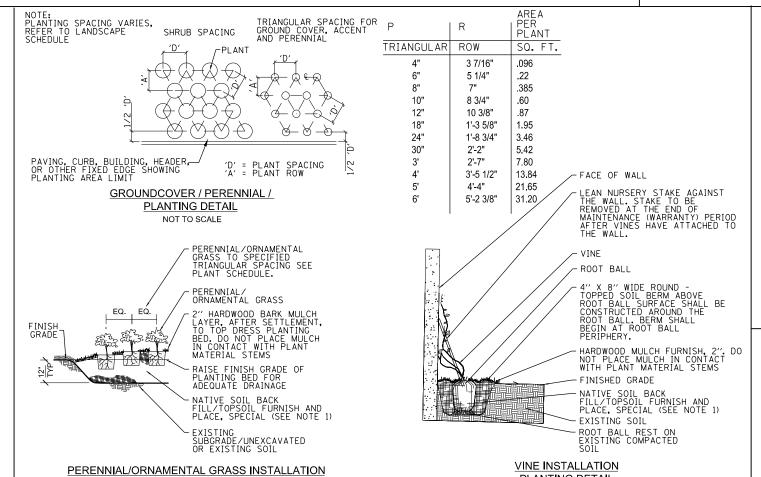

NOT TO SCALE



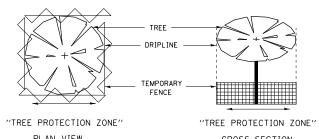

TEMPORARY FENCE DETAIL

PLAN VIEW

CROSS-SECTION

NOT TO SCALE

- 1. TREE PITS TO BE BACKFILLED WITH THE NATIVE SOIL THAT WAS REMOVED FROM THE HOLE. WHEN UNSUITABLE MATERIAL IS ENCOUNTERED, THE HOLE SHALL BE BACKFILLED WITH TOPSOIL FURNISH AND PLACE, SPECIAL.
- 2. SEE LANDSCAPING SCHEDULE ON SHEET NO. 32 FOR PLANT TYPE AND SPACING INFORMATION.
- 3. SHREDDED HARDWOOD BARK MULCH SHALL BE PLACED AROUND ALL NEW PLANTS AND INCLUDED IN THE COST OF THE TREES, SHRUBS, VINES, AND PERENNIAL PLANT PAY ITEMS.

AECON

USER NAME = HENAOC	DESIGNED - KP	REVISED -
	DRAWN - CRH	REVISED -
PLOT SCALE = 40.0000 '/ in.	CHECKED - MJE	REVISED -
PLOT DATE = 12/13/2017	DATE - 10/20/2017	REVISED -

STATE OF ILLINOIS **DEPARTMENT OF TRANSPORTATION**

PLANTING DETAIL

NOT TO SCALE


PLANTING DETAIL


NOT TO SCALE

SCALE: NONE

SHEET NO

			- 1						
					F.A.I. RTE.	SECTION	COUNTY	TOTAL SHEETS	SHEET NO.
	LANDS	CAPING D	EIAILS		55	2015-036LS	COOK	84	29
							CONTRAC	NO. 6	2A93
١0.	OF	SHEETS	STA.	TO STA.		ILLINOIS FED	. AID PROJECT		

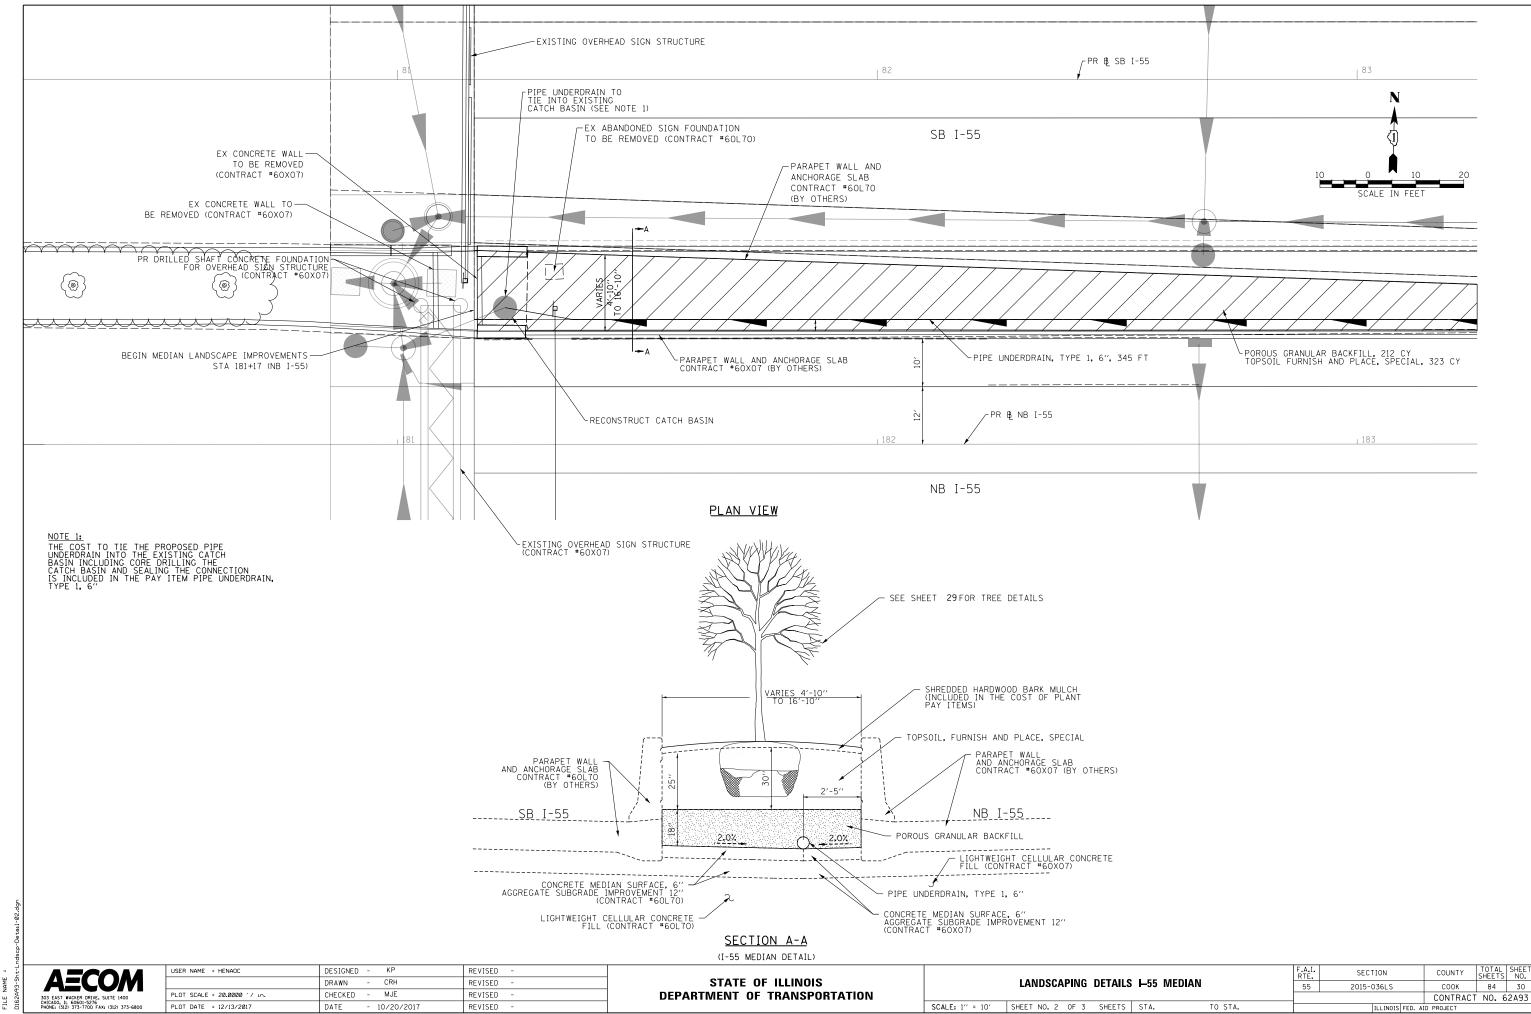

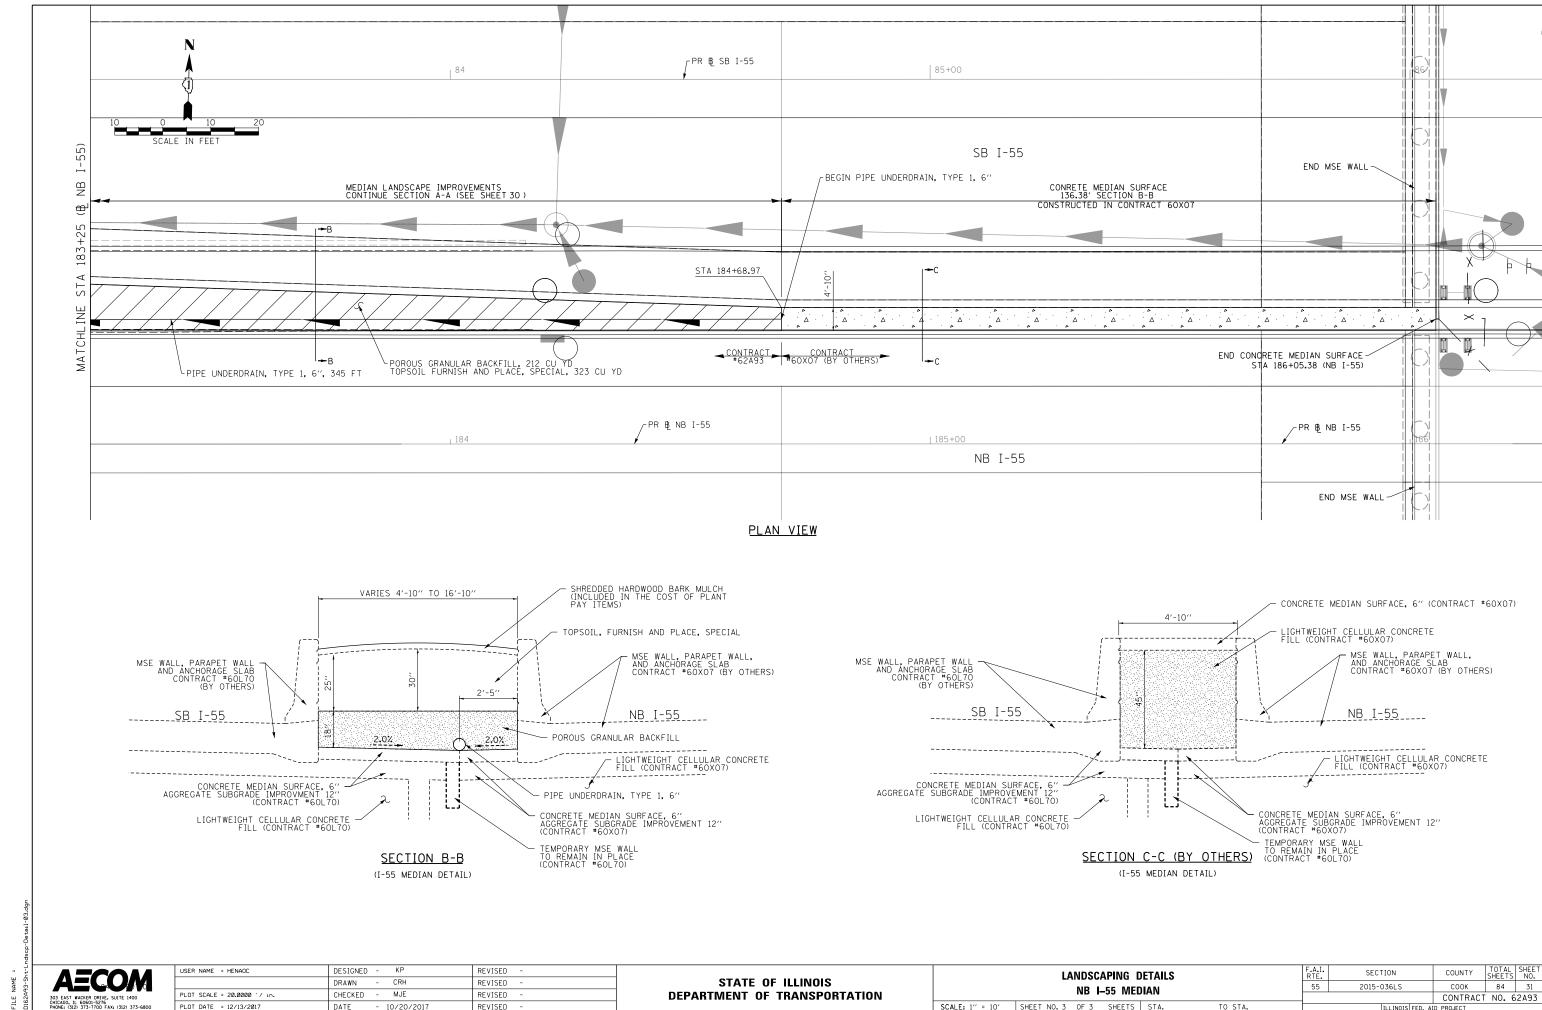

PLOT DATE = 12/13/2017 - 10/20/2017 DATE REVISED SCALE: 1" = 10' SHEET NO. 3 OF 3 SHEETS STA.


ABBEV. CODE	BOTANICAL NAME	COMMON NAME	TYPE	SIZE	ROOT	REMARKS	QUANTITY	UNIT
		SHADE TRE	ES	L				
CS	CATALPA SPECIOSA	NORTHERN CATALPA		3" CAL	B& B	SPECIMEN QUALITY 25' OC	13	EACH
СО	CELTIS OCCIDENTALIS	COMMON HACKBERRY		2 1/2" CAL	B& B	SPECIMEN QUALITY 25' OC	17	EACH
GBA	GINKGO BILOBA 'AUTUMN GOLD'	AUTUMN GOLD GINKGO		2 1/2" CAL	B& B	SPECIMEN QUALITY 25' OC	4	EACH
GTK	GLEDITISIA TRIACANTHOS INERMIS 'DRAVES'	STREET KEEPER HONEYLOCUST		2" CAL	B&B	SPECIMEN QUALITY 25' OC	26	EACH
GD	GYMNOCLADUS DIOICUS	KENTUCKY COFFEETREE		3" CAL	B&B	SPECIMEN QUALITY 25' OC	38	EACH
GDD	GYMNOCLADUS DIOICUS 'DECAF'	DECAF KENTUCKY COFFEETREE		2 1/2" CAL	B&B	SPECIMEN QUALITY 25' OC	6	EACH
TD	TAXODIUM DISTICHUM	COMMON BALD CYPRESS		3" CAL	B& B	SPECIMEN QUALITY 25' OC	6	EACH
PAB	PLATANUS X ACERFOLIA 'BLOODGOOD'	BLOODGOOD PLANETREE		3" CAL	B& B	SPECIMEN QUALITY 25' OC	3	EACH
ОВ	QUERCUS BICOLOR	SWAMP WHITE OAK		2" CAL	B& B	SPECIMEN QUALITY 25' OC	25	EACH
ОМ	QUERCUS MACROCARPA	BUR OAK		2" CAL	B& B	SPECIMEN QUALITY 25' OC	3	EACH
UAT	ULMUS AMERICANA 'PATRIOT'	PATRIOT ELM		3" CAL	B& B	SPECIMEN QUALITY 25' OC	7	EACH
UAP	ULMUS AMERICANA 'PRINCETON'	PRINCETON ELM		2 1/2" CAL	B&B	SPECIMEN QUALITY 25' OC	40	EACH
		ORNAMENTAL	TREES					
AGA	AMELANCHIER GRANDIFLORA 'AUTUMN BRILLIANCE'	AUTUMN BRILLIANCE APPLE SERVICEBERRY		8' HT	B& B	CLUMP FORM, MATCHING HEADS 15' OC	5	EACH
CCI	CRATAEGUS CRUGALLI 'INERMIS'	THORNLESS COCKSPUR		8' HT	B& B	SPECIMEN QUALITY 15' OC	18	EACH
МОС	MALUS 'ORANGE CRUSH'	ORANGE CRUSH CRABAPPLE		6' HT	B& B	SPECIMEN QUALITY 15' OC	3	EACH
		 EVERGREE	<u> </u> :N					
JVC	JUNIPERUS VIRGINIANA 'CANAERTII'	CANAERTII RED CEDAR		5′ HT	B& B	SPACED AS SHOWN	47	EACH
		SHRUBS						
DKO	DIERVILLA 'KODIAK ORANGE'	KODIAK ORANGE BUSH-HONEYSUCKLE	SMALL SHRUB	24" HT	5 GAL CONTAINER	SPACED 48" OC	32	EACH
JPS	JUNIPERUS CHINENSIS 'SEA GREEN'	SEA GREEN JUNIPER	EVERGREEN SHRUB	3′ WIDTH	B&B	SPACED 72" OC	38	EACH
RA	RHUS AROMATICA	FRAGRANT SUMAC	MEDIUM SHRUB	2' WIDTH	B&B	SPACED 36" OC	259	EACH
VDB	VIBURNUM DENTATUM 'BLUE MUFFIN'	BLUE MUFFIN ARROWHEAD	MEDIUM SHRUB	3′ HT	B& B	SPACED 48" OC	192	EACH
VDR	VIBURNUM DENTATUM 'RASTZAM'	RASPBERRY TART ARROWHEAD	MEDIUM SHRUB	24" HT	5 GAL CONTAINER	SPACED 48" OC	36	EACH
		ORNAMENTAL GRASSES	, PERENNIALS, AND BUL	BS			1	
ASB	ALLIUM 'SUMMER BEAUTY'	SUMMER BEAUTY ONION	PERENNIAL	1 GAL	POT	SPACED 18" OC	. 5	UNIT
EPM	ECHINACEA PURPUREA 'MAGNUS'	MAGNUS PURPLE CONEFLOWER	PERENNIAL	1 GAL	POT	SPACED 18" OC	1.8	UNIT
HSD	HEMEROCALLIS 'STELLA DE ORO'	STELLA DE ORO DAYLILY	PERENNIAL	1 GAL	POT	SPACED 15" OC	22	UNIT
HHR	HEMEROCALLIS 'HAPPY RETURNS'	HAPPY RETURNS DAYLILY	PERENNIAL	1 GAL	POT	SPACED 24" OC	1.71	UNIT
PVR	PANICUM VIRGATUM 'ROTSTRAHLBUSCH'	RED SWITCH GRASS	ORNAMENTAL GRASS	1 GAL	POT	SPACED 36" OC	1.11	UNIT
NK A	NARCISSUS 'KING ALFRED'	KING ALFRED DAFFODIL VINES	BULB	15/17 CM		INTERPLANTED/NATURALIZED IN DRIFTS - GROUPINGS OF 9-15 BULBS	8	UNIT
PT	PARTHENOCISSUS TRICUSPIDATA	BOSTON IVY	VINE	1 GAL	РОТ	SPACED 24" OC	480	EACH
PO	PARTHENOCISSUS QUINQUEFOLIA	VIRGINIA CREEPER	VINE	1 GAL	РОТ	SPACED 24" OC	15	UNIT
		SEEDIN						
	CLASS 2A						1. 25	ACRE
	CLASS 4A (MODIFIED)						1.50	ACRE
	CLASS 5 (MODIFIED)						1.50	ACRE
	INTERSEEDING, CLASS 4A (MODIFIED)						5.00	ACRE
	INTERSEEDING CLASS 5 (MODFIED)						5.00	ACRE

A=COM
303 EAST WACKER DRIVE, SUITE 1400 CHICAGO, IL 60601-5276 PHONE: (3)2) 373-7703 FAX: (3)2) 373-6800

USER NAME = HENAOC	DESIGNED - KP	REVISED -
	DRAWN - CRH	REVISED -
PLOT SCALE = 100.0000 ' / in.	CHECKED - MJE	REVISED -
PLOT DATE = 12/13/2017	DATE - 10/20/2017	REVISED -

SCALE

					F.A.I. RTE.	SECTION	COUNTY	TOTAL SHEETS	SHEET NO.
LAI	NDSCA	PING SO	CHEDULE		55	2015-036LS	COOK	84	32
							CONTRACT	NO.	62A93
SHEET NO. 1	OF 1	SHEETS	STA.	TO STA.		ILLINOIS FED. AI	D PROJECT		

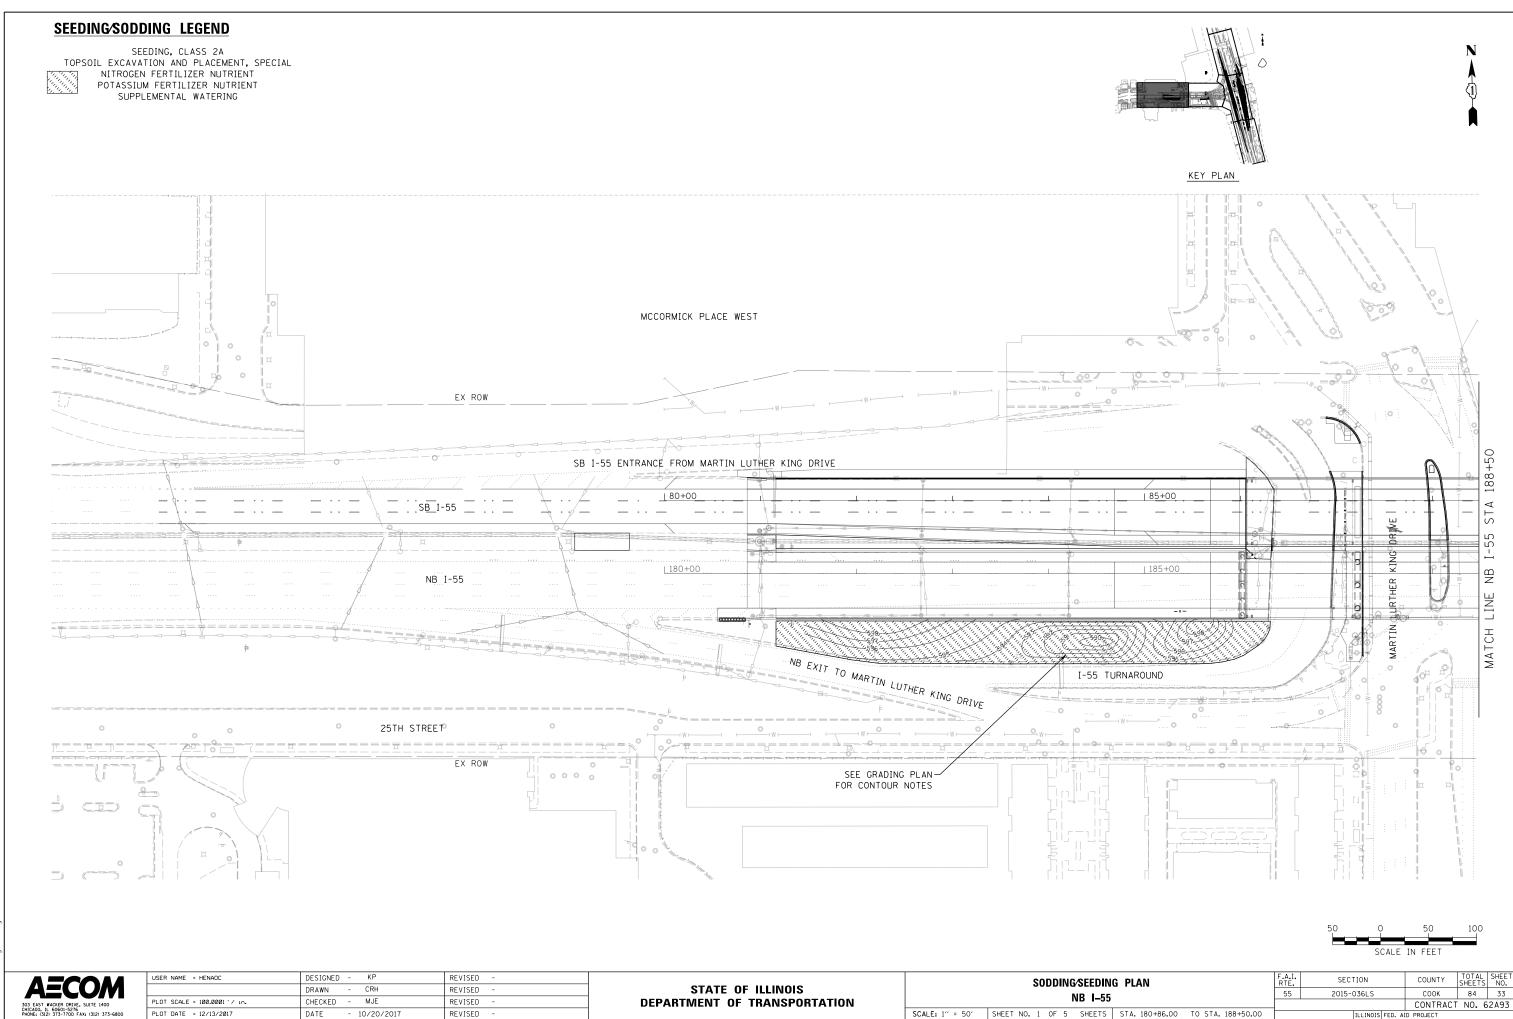



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	DRAWN - CRH	REVISED -
PLOT SCALE = 100.0001 '/ 10.	CHECKED - MJE	REVISED -
PLOT DATE = 12/13/2017	DATE - 10/20/2017	REVISED -

SODDING/SEEDING PLAN									F.A.I. RTE.	SEC.	LION		COUNT
NB I-55							55	2015-	036LS		соок		
						ND 1-33							CONTR
50′	SHEET	NO.	1	OF	5	SHEETS	STA. 180+86.00	TO STA. 188+50.00			ILLINOIS	FED. A	D PROJECT

SEEDING/SODDING LEGEND



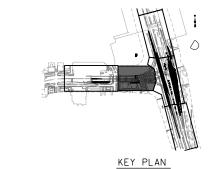

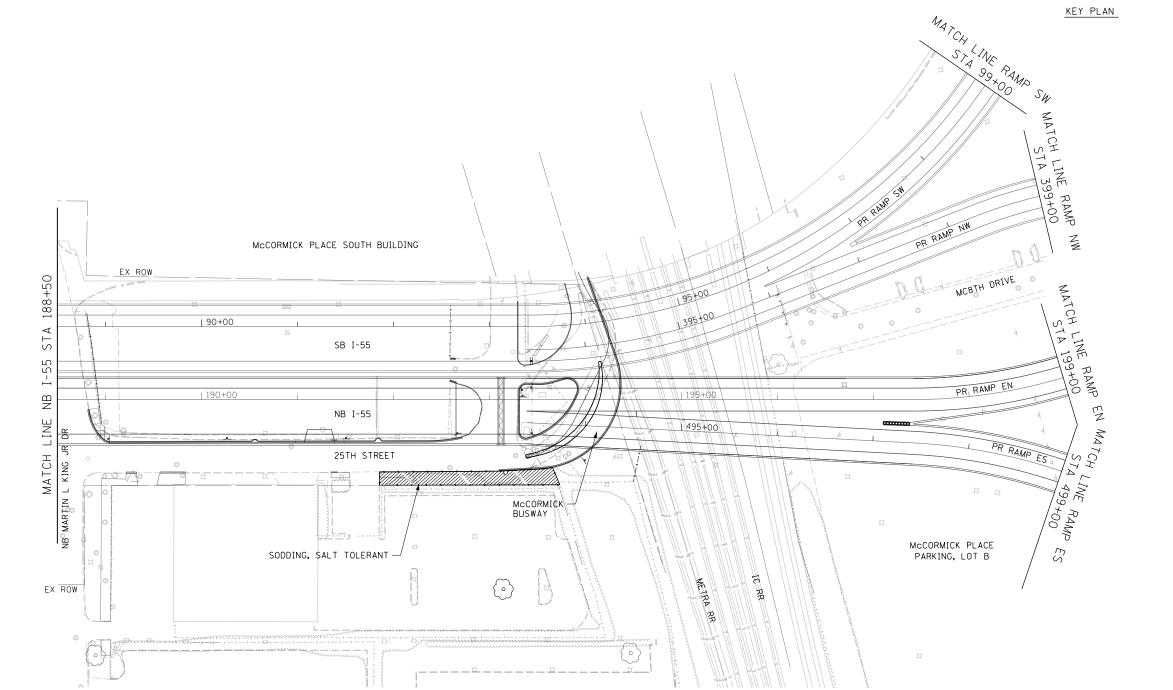





USER NAME = HENAOC	DESIGNED - KP	REVISED -
	DRAWN - CRH	REVISED -
PLOT SCALE = 100.0001 ' / in.	CHECKED - MJE	REVISED -
PLOT DATE = 12/13/2017	DATE - 10/20/2017	REVISED -

STATE OF ILLINOIS
DEPARTMENT OF TRANSPORTATION

	SEEDING/SODDI	NG PLAN		F.A.I. RTE.	SECTION	COUNTY	TOTAL	SHEET NO.
	NB I-5	5		55	2015-036LS	COOK	84	34
ND I-33						CONTRACT	NO. (52A93
SCALE: 1" = 50"	SHEET NO. 2 OF 5 SHEETS	STA. 188+50.00	TO STA. 199+00.00		ILLINOIS FED. A	ID PROJECT		

SEEDING/SODDING LEGEND


SEEDING, CLASS 2A
TOPSOIL EXCAVATION AND PLACEMENT, SPECIAL
NITROGEN FERTILIZER NUTRIENT POTASSIUM FERTILIZER NUTRIENT SUPPLEMENTAL WATERING



INTERSEEDING, CLASS 4A (MODIFIED)
INTERSEEDING, CLASS 5 (MODIFIED) NITROGEN FERTILIZER NUTRIENT POTASSIUM FERTILIZER NUTRIENT SUPPLEMENTAL WATERING



SEEDING, CLASS 4A (MODIFIED)
SEEDING, CLASS 5 (MODIFIED)
NITROGEN FERTILIZER NUTRIENT
POTASSIUM FERTILIZER NUTRIENT
SUPPLEMENTAL WATERING

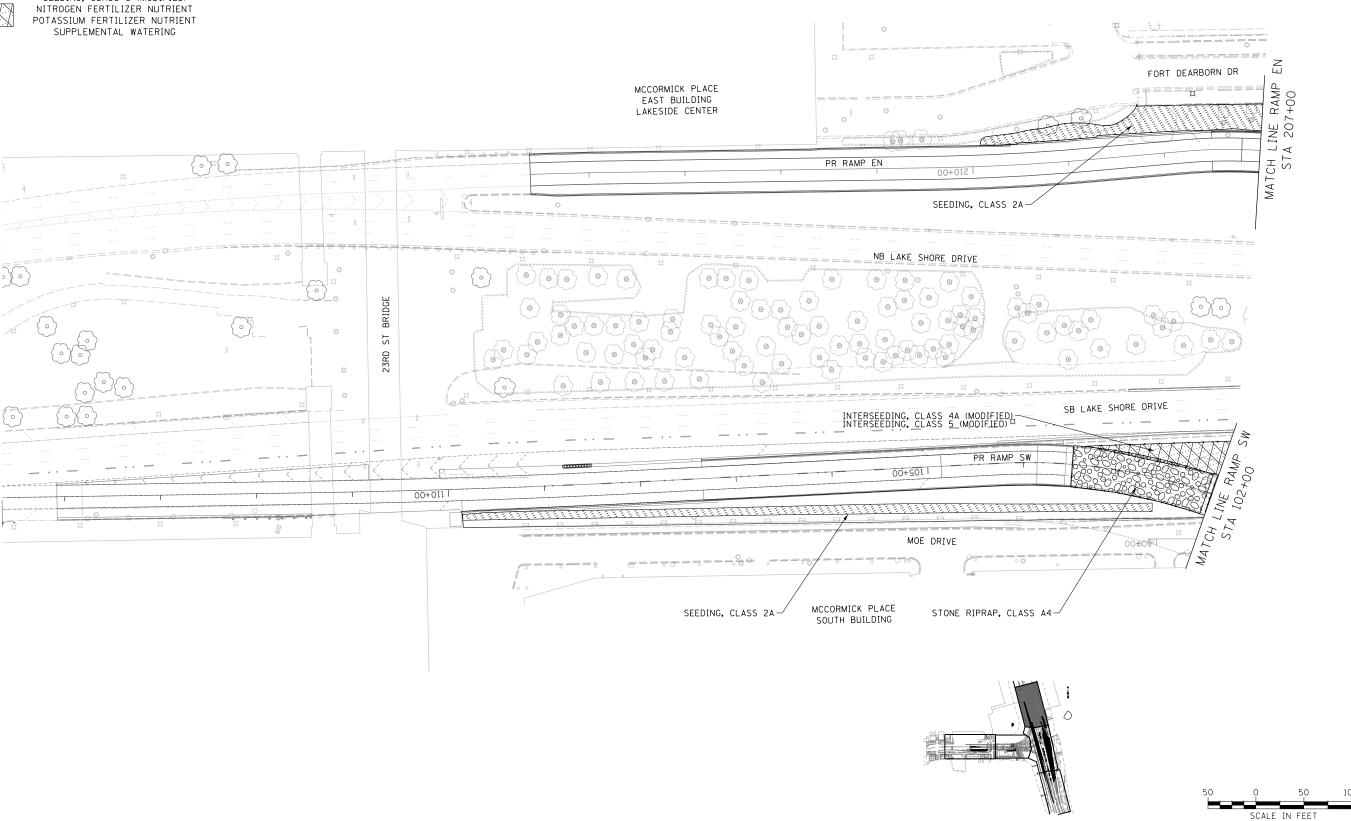


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USER NAME = HENAOC	DESIGNED - KP	REVISED -
	DRAWN - CRH	REVISED -
PLOT SCALE = 100.0001 '/ in.	CHECKED - MJE	REVISED -
PLOT DATE = 12/13/2017	DATE - 10/20/2017	REVISED -

STATE OF ILLINOIS **DEPARTMENT OF TRANSPORTATION**

<u>KET FLAN</u>										
		SEEDING/SO	DDING	G PLAN		F.A.I. RTE.	SECTION	COUNTY	TOTAL SHEETS	SHEET NO.
RAMP EN					55	2015-036LS	соок	84	35	
	IIAWII LIV				CONTRACT NO. 62A93					
	SCALE: 1" = 50"	SHEET NO. 3 OF 5 SH	HEETS	STA. 207+00	TO STA. 214+60.73	ILLINOIS FED. AID PROJECT				

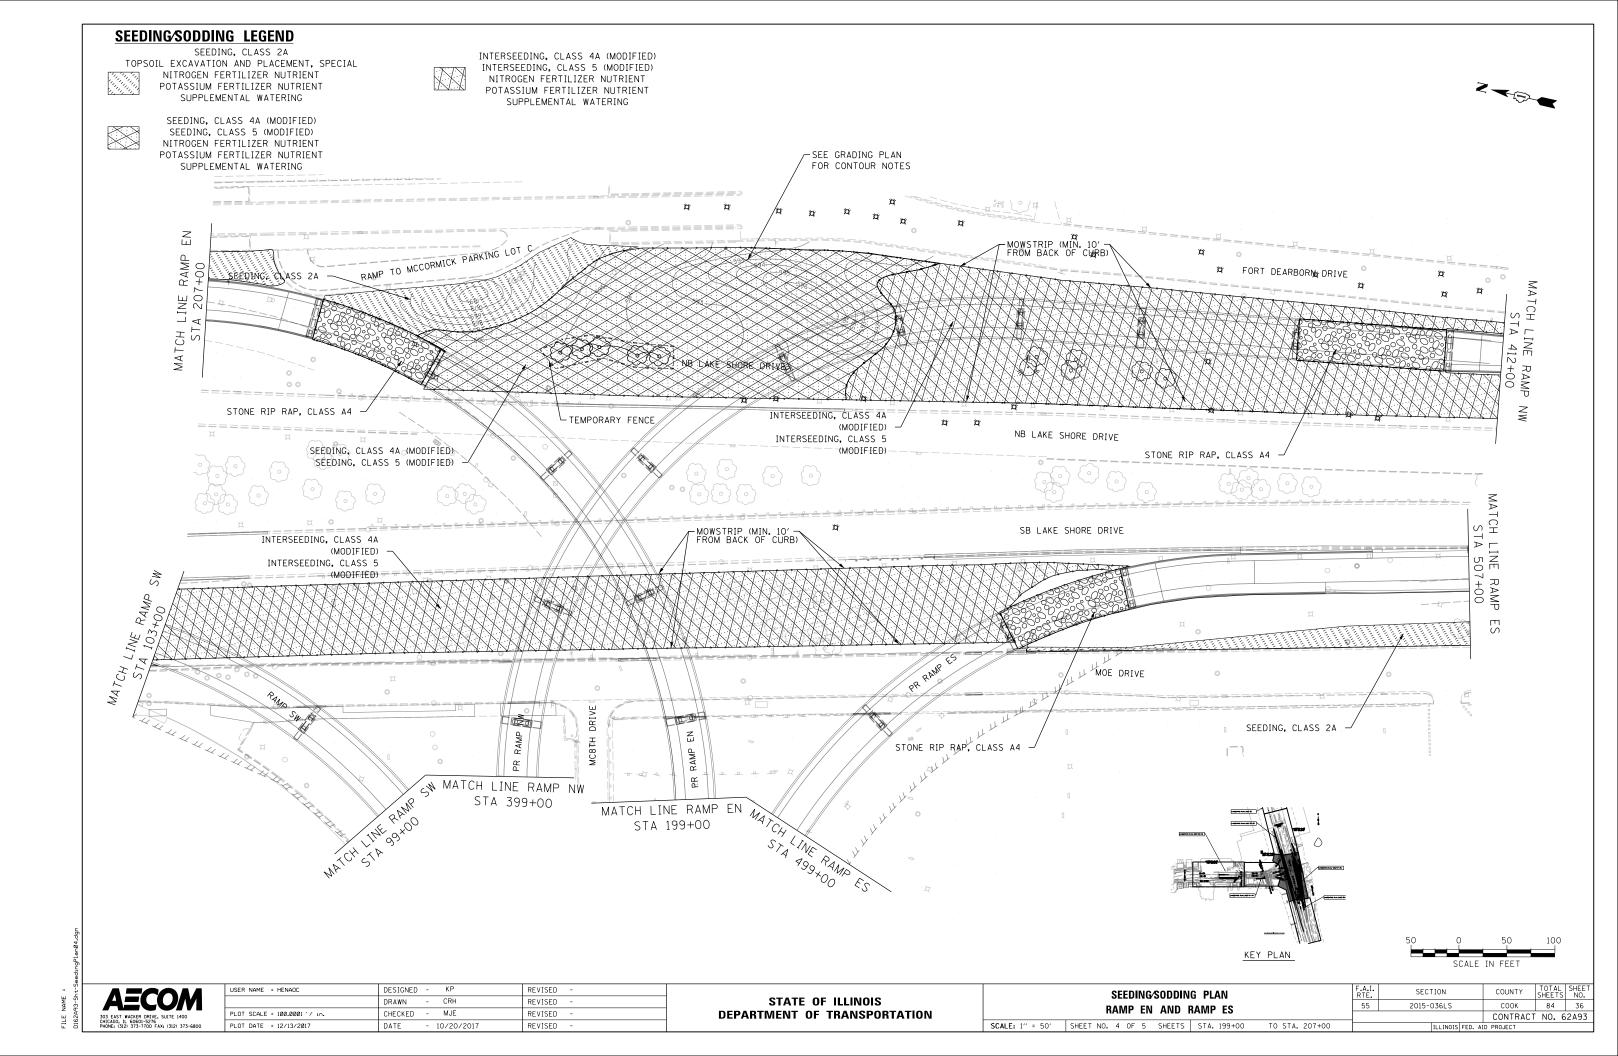

SEEDING/SODDING LEGEND


SEEDING, CLASS 2A TOPSOIL EXCAVATION AND PLACEMENT, SPECIAL MATTER NOTRIGEN FERTILIZER NUTRIENT POTASSIUM FERTILIZER NUTRIENT SUPPLEMENTAL WATERING



INTERSEEDING, CLASS 4A (MODIFIED)
INTERSEEDING, CLASS 5 (MODIFIED) NITROCEN FERTILIZER NUTRIENT POTASSIUM FERTILIZER NUTRIENT SUPPLEMENTAL WATERING



SEEDING, CLASS 4A (MODIFIED) SEEDING, CLASS 5 (MODIFIED) NITROGEN FERTILIZER NUTRIENT POTASSIUM FERTILIZER NUTRIENT SUPPLEMENTAL WATERING

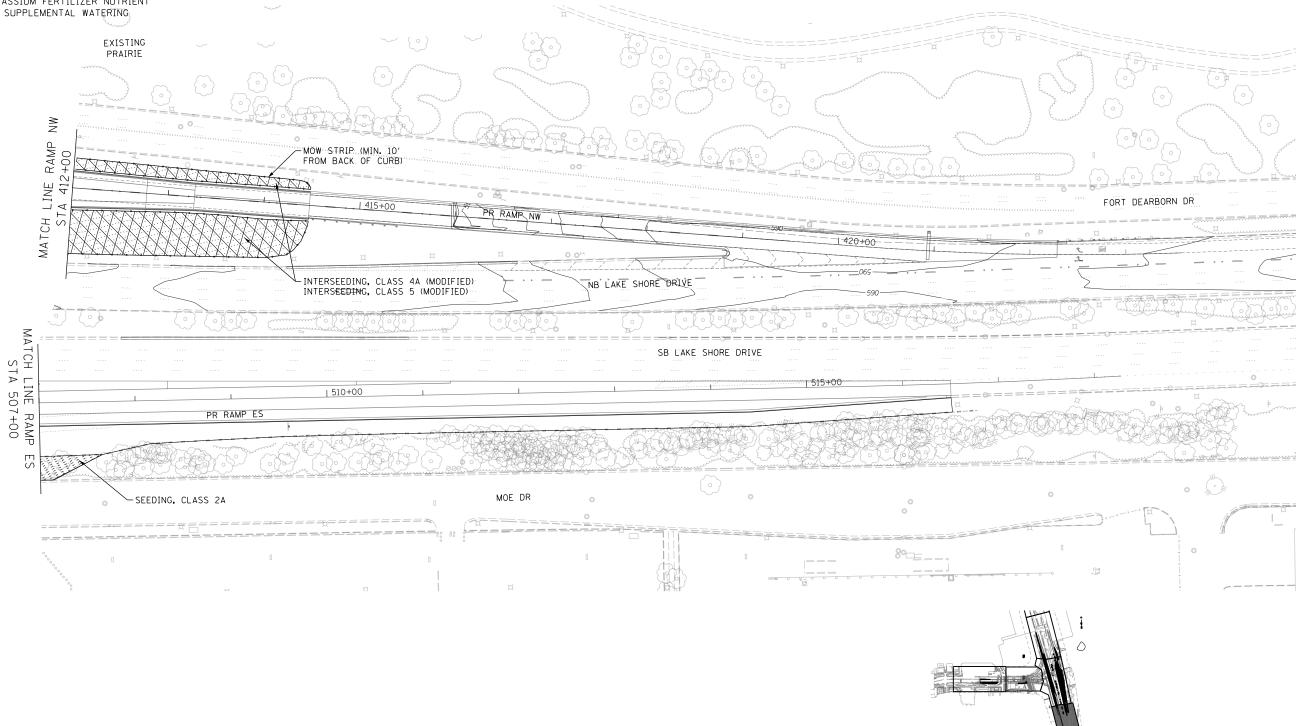



USER NAME = HENAOC	DESIGNED - KP	REVISED -	
	DRAWN - CRH	REVISED -	
PLOT SCALE = 100.0001 '/ 10.	CHECKED - MJE	REVISED -	
PLOT DATE = 12/13/2017	DATE - 10/20/2017	REVISED -	

STATE	: OI	F ILLINOIS	
DEPARTMENT	0F	TRANSPORTATION	

SEEDING/SODDING PLAN						SECTION	COUNTY	TOTAL SHEETS	SHEET NO.
	D	AMP ES	!		55	2015-036LS	соок	84	37
		MIVII LO	,				CONTRACT	NO. 6	2A93
SCALE: 1" = 50'	SHEET NO. 5 OF 5	SHEETS	STA. 507+00	TO STA. 516+50		ILLINOIS FED. A	ID PROJECT		

SCALE IN FEET

KEY PLAN

TRAFFIC CONTROL GENERAL NOTES

- 1. TRAFFIC CONTROL AND PROTECTION SHALL BE PERFORMED IN ACCORDANCE WITH SECTION 701 OF THE STANDARD SPECIFICATIONS FOR ROAD AND BRIDGE CONSTRUCTION.
- 2. TYPE A LOW INTENSITY FLASHING WARNING LIGHTS SHALL BE USED ON EACH SIGN IN ADVANCE OF THE WORK DURING HOURS OF DARKNESS.
- 3. ALL WARNING SIGNS SHALL BE A MINIMUM OF 48" x 48" AND HAVE A BLACK LEGEND AND BORDER ON A FLUORESCENT ORANGE REFLECTORIZED BACKGROUND.
- 4. WHERE ARTIFICIAL LIGHTING IS UTILIZED IN NIGHT OPERATIONS, THE CONTRACTOR SHALL EXERCISE THE UTMOST PRECAUTIONS IN PREVENTING ADVERSE VISIBILITY TO THE MOTORING PUBLIC AND ADJOINING RESIDENTIAL AREAS.
- 5. EXACT LOCATION OF ALL WARNING SIGNS AND BARRICADES SHALL BE STAKED IN THE FIELD FOR APPROVAL BY THE ENGINEER PRIOR TO INSTALLATION.
- 6. PRIOR TO START OF CONSTRUCTION, ALL REQUIRED TRAFFIC CONTROL DEVICES SHALL BE IN PLACE.
- 7. COOPERATION BETWEEN CONTRACTORS WILL BE REQUIRED. THE CONTRACTOR SHALL COORDINATE TRAFFIC CONTROL WITH OTHER ADJACENT CONTRACTS WHICH MAY BE UNDER CONSTRUCTION DURING THE DURATION OF THIS PROJECT. NO ADDITIONAL COMPENSATION IS ALLOWED. ADJACENT CONTRACTS MAY CONSIST OF, BUT ARE NOT LIMITED TO PROJECTS NEAR:
- o CONTRACT 60L70 I-55 OUTBOUND BRIDGES
- o CONTRACT 60X07 I-55 INBOUND BRIDGES
- o McCORMICK PLACE PROJECTS
- o MUSEUM CAMPUS PROJECTS
- o AND OTHERS.
- 8. THE CONTRACTOR SHALL NOTIFY THE ENGINEER 28 DAYS PRIOR TO ANY ANTICIPATED CLOSURES.
- 9. A MINIMUM 11' LANE WIDTH SHALL BE MAINTAINED ON ALL INTERSTATE LANES OPEN TO TRAFFIC DURING CONSTRUCTION.
- 10. PROVIDE CONTINUOUS TEMPORARY ACCESS TO ALL SIDE STREETS, ALLEYS, DRIVEWAYS, AND PARKING LOTS UNLESS SPECIFICALLY IDENTIFIED ON THE PLANS FOR TEMPORARY CLOSURE. LOTS WITH MORE THAN ONE DRIVEWAY MUST BE STAGED TO KEEP AT LEAST ONE DRIVEWAY OPEN AT ALL TIMES.
- 11. THE CONTRACTOR SHALL MAINTAIN TRAFFIC ON ALL STREETS EXCEPT WHERE NOTED ON THE PLANS AND PROHIBIT PARKING WITHIN FIFTY (50) FEET OF THE CONSTRUCTION AREA AT ALL TIMES. NOTIFY CDOT AND OEMC AT LEAST 72 HOURS BEFORE COMMENCING CONSTRUCTION.
- 12. MAINTAIN ACCESS TO FIRE HYDRANTS, BUILDING STANDPIPES AND OTHER EMERGENCY FACILITIES WITHIN THE CONSTRUCTION ZONE.
- 13. THE CONTRACTOR SHALL CONTACT THE DISTRICT OF ARTERIAL TRAFFIC CONTROL SUPERVISOR AT (847) 705-4470 AND THE EXPRESSWAYS TRAFFIC CONTROL SUPERVISOR AT (847) 705-4155 A MINIMUM OF 72 HOURS IN ADVANCE OF BEGINNING WORK.
- 14. SIGNS W20-I103(0)-48 AND "SHOULDER CLOSED AHEAD" SHALL BE TAKEN DOWN WHEN THE WORKERS ARE NOT PRESENT.
- 15. THE FURNISHING, INSTALLING, AND RELOCATION OF ALL TRAFFIC SIGNS ALONG NB & SB LSD, MOE DRIVE, FORT DEARBORN DRIVE, AND ALONG ALL OTHER SIDE STREETS SHALL BE IN ACCORDANCE WITH THE MANUAL ON UNIFORM TRAFFIC CONTROL DEVICES AND THE STANDARD SPECIFICATIONS. THIS WORK SHALL BE INCLUDED IN THE COST FOR TRAFFIC CONTROL AND PROTECTION (SPECIAL) ALL CONFLICTING TRAFFIC SIGNS SHALL BE COVERED AS DIRECTED BY THE ENGINEER. THIS WORK SHALL BE INLUDED IN THE COST OF TRAFFIC CONTROL AND PROTECTION. (SPECIAL).
- THE FURNISHING, INSTALLING, AND RELOCATION OF ALL TRAFFIC SIGNS ALONG NB & SB I-55 AND ALONG THE RAMPS SHALL BE IN ACCORDANCE WITH THE MANUAL ON UNIFORM TRAFFIC CONTROL DEVICES AND THE STANDARD SPECIFICATIONS. THIS WORK SHALL BE INCLUDED IN THE COST FOR TRAFFIC CONTROL AND PROTECTION (EXPRESSWAYS). ALL CONFLICTING TRAFFIC SIGNS SHALL BE COVERED AS DIRECTED BY THE ENGINEER. THIS WORK SHALL BE INLUDED IN THE COST OF TRAFFIC CONTROL AND PROTECTION, (EXPRESSWAYS).
- 17. THE STAGING OF CONTRACT 62A93 IS SHOWN FOR INFORMATION ONLY. ANTICIPATED STAGES MAY CHANGE DURING CONSTRUCTION.

CONSTRUCTION NARRATIVE

MAINTENANCE OF TRAFFIC

- RAMP NW AND SB I-55
 - * SET UP MAINTENANCE OF TRAFFIC ALONG RAMP NW AND SB I-55 AS SHOWN IN THE SUGGESTED STAGES OF CONSTRUCTION AND TRAFFIC CONTROL PLANS
 - SB I-55: THE INSIDE SHOULDER WILL BE PERMITTED TO BE CLOSED FOR DAY OPERATIONS ONLY IN ACCORDANCE WITH IDOT DISTRICT 1 DETAIL TC-17.
 - * NB I-55: THE INSIDE SHOULDER WILL BE PERMITTED TO BE CLOSED FOR DAY OPERATIONS ONLY IN ACCORDANCE WITH IDOT DISTRICT 1 DETAIL TC-17.
 - * I-55 TURNAROUND: ACCESS LANDSCAPING AREA BY UTILIZING IDOT DISTRICT 1 DETAIL TC-18.

-MOE DRIVE, SB LAKESHORE DRIVE, AND FORT DEARBORN DRIVE

- ACCESS LANDSCAPING AREA BETWEEN MOE DRIVE AND SB LAKESHORE DRIVE BY UTILIZING IDOT DISTRICT 1 DETAIL TC-18 FROM MOE DRIVE
- ACCESS THE MEDIAN LANDSCAPING AREA BETWEEN SB LAKESHORE DRIVE AND NB LAKESHORE DRIVE BY UTILIZING IDOT DISTRICT 1 DETAIL TC-18 FROM SB LAKESHORE DRIVE
- ACCESS LANDSCAPING AREA BETWEEN NB LAKESHORE AND FORT DEARBORN DRIVE DRIVE BY UTILIZING IDOT DISTRICT 1 DETAIL TC-18 FROM FORT DEARBORN DRIVE

CONSTRUCTION TO BE COMPLETED

- * REMOVE, PRUNE, AND PROTECT EXISTING TREES AS SHOWN IN THE PLANS
- * PERFORM ALL EARTHWORK AND GRADING AS SHOWN IN THE GRADING PLANS
- SET UP MAINTENANCE OF TRAFFIC ON RAMP NW & SB I-55 AND PERFORM ALL LANDSCAPING MEDIAN WORK BETWEEN NB & SB I-55
- REMOVE MAINTENANCE OF TRAFFIC ON RAMP NW & SB I-55 AND PERFORM ALL OTHER LANDSCAPING WORK AS SHOWN IN THE CONTRACT PLANS

LEGEND



WORK ZONE



TEMPORARY CONCRETE BARRIER




TYPE II BARRICADES OR DRUMS WITH STEADY BURN MONODIRECTIONAL LIGHT (AT SPECIFIED




DIRECTION OF TRAFFIC FLOW


- SIGN
- ARROW BOARD
- TYPE II BARRICADE OR DRUMS WITH STEADY BURN MONODIRECTIONAL LIGHT
- DIRECTIONAL INDICATOR BARRICADE WITH STEADY BURN MONODIRECTIONAL

USER NAME = HENAOC	DESIGNED - KP	REVISED -
	DRAWN - CRH	REVISED -
PLOT SCALE = 2.0000 '/ in.	CHECKED - MJE	REVISED -
PLOT DATE = 12/13/2017	DATE - 10/20/2017	REVISED -

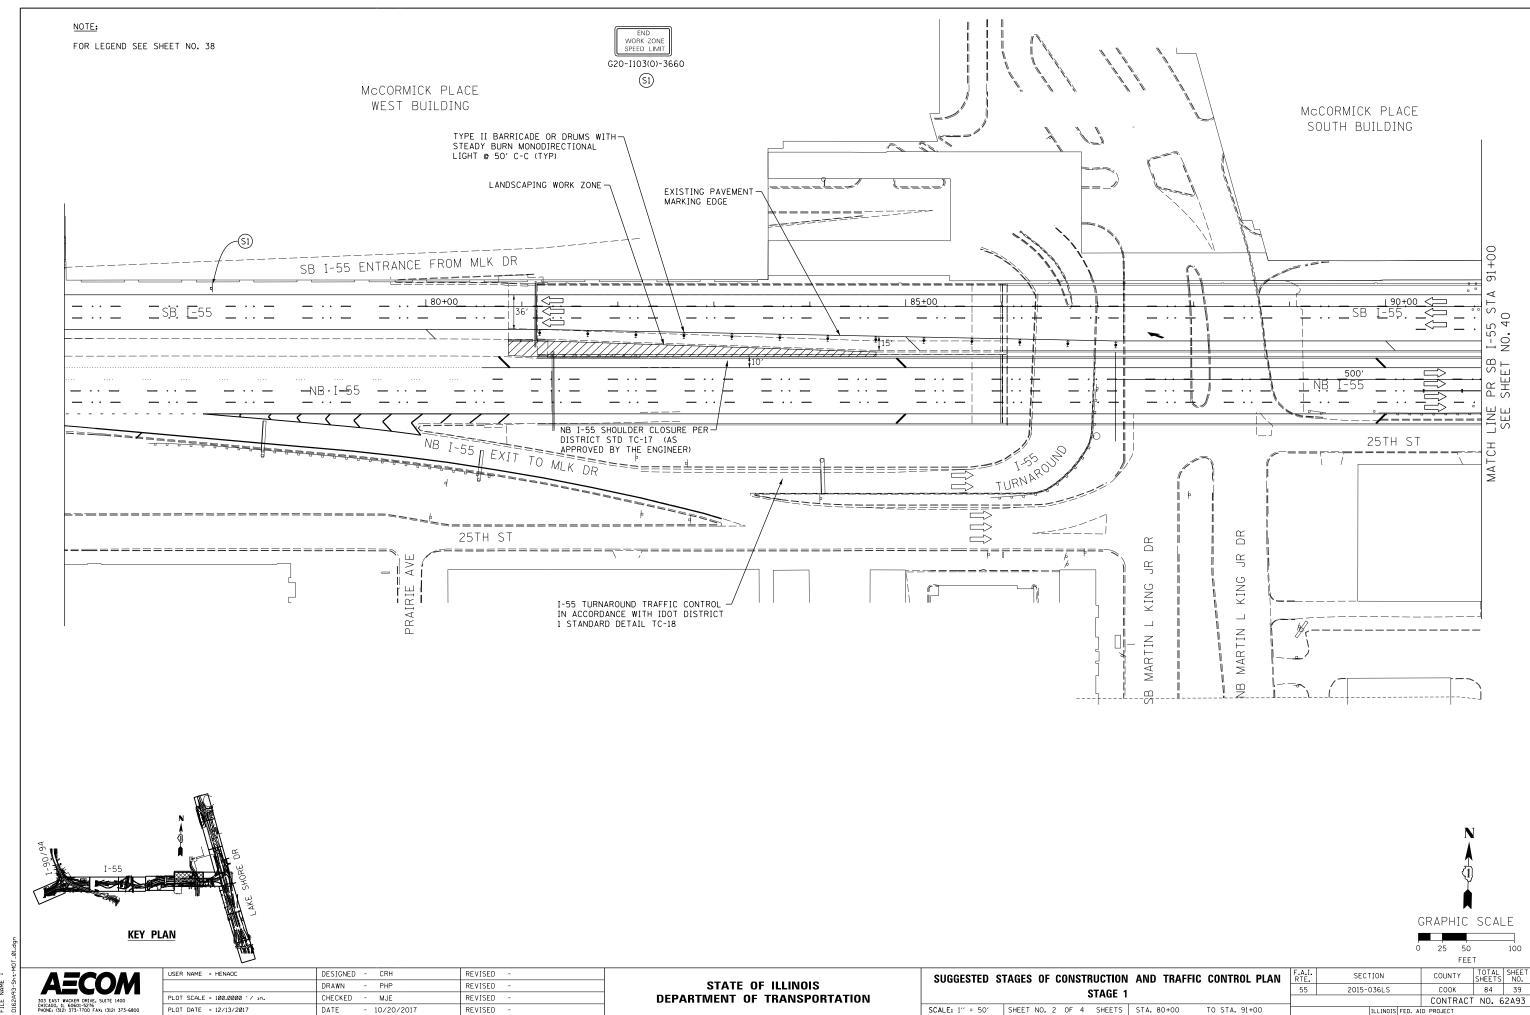

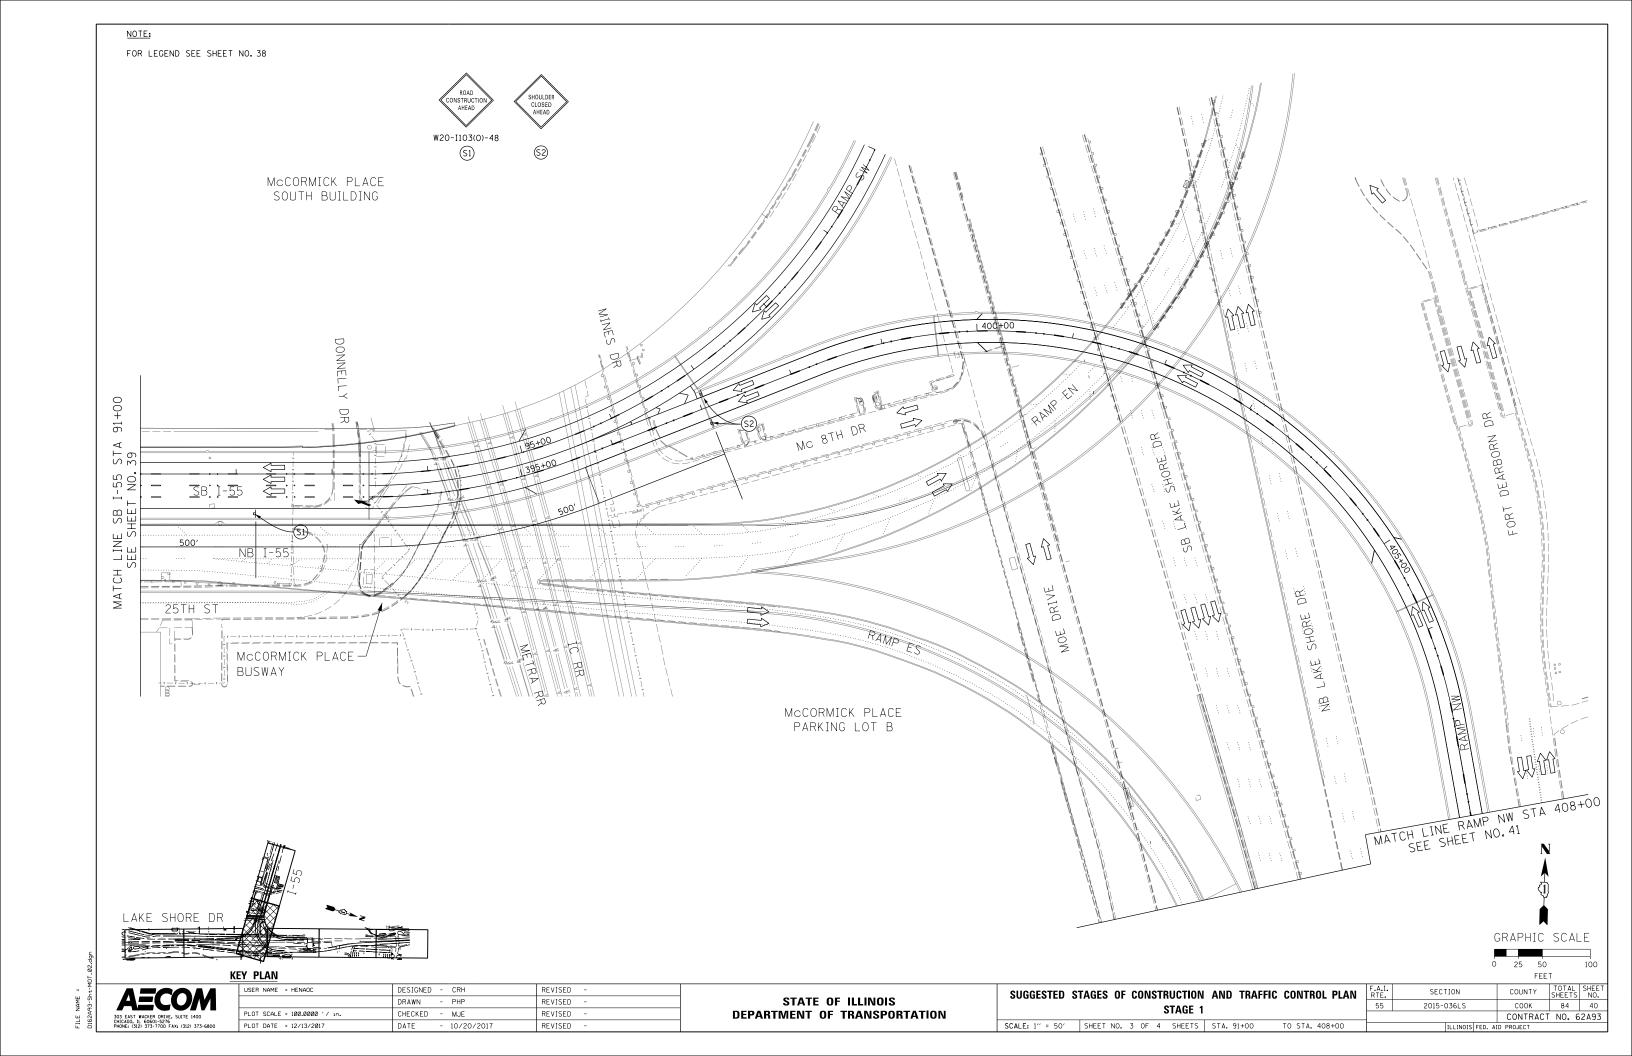

NOTE: 1. FOR LEGEND SEE SHEET NO. 38 408+00 1_1 MATCH LINE SEE SB LAKE SHORE DR MOE DRIVE MOE DRIVE McCORMICK PLACE PARKING LOT B TRUCK MARSHALLING

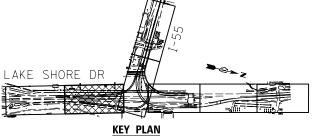

SUGGESTED STAGES OF CONSTRUCTION AND TRAFFIC CONTROL PLAN

STAGE 1

SECTION

STAGE 1

AECOM

 USER NAME
 = HENADC
 DESIGNED
 - CRH
 REVISED

 DRAWN
 - PHP
 REVISED


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 CHECKED
 - MJE
 REVISED

 PLOT DATE
 = 12/13/2017
 DATE
 - 10/20/2017
 REVISED

STATE OF ILLINOIS DEPARTMENT OF TRANSPORTATION

STAGE 1 55

SCALE: 1" = 50' SHEET NO. 4 OF 4 SHEETS STA. 408+00 TO STA. 1095+00

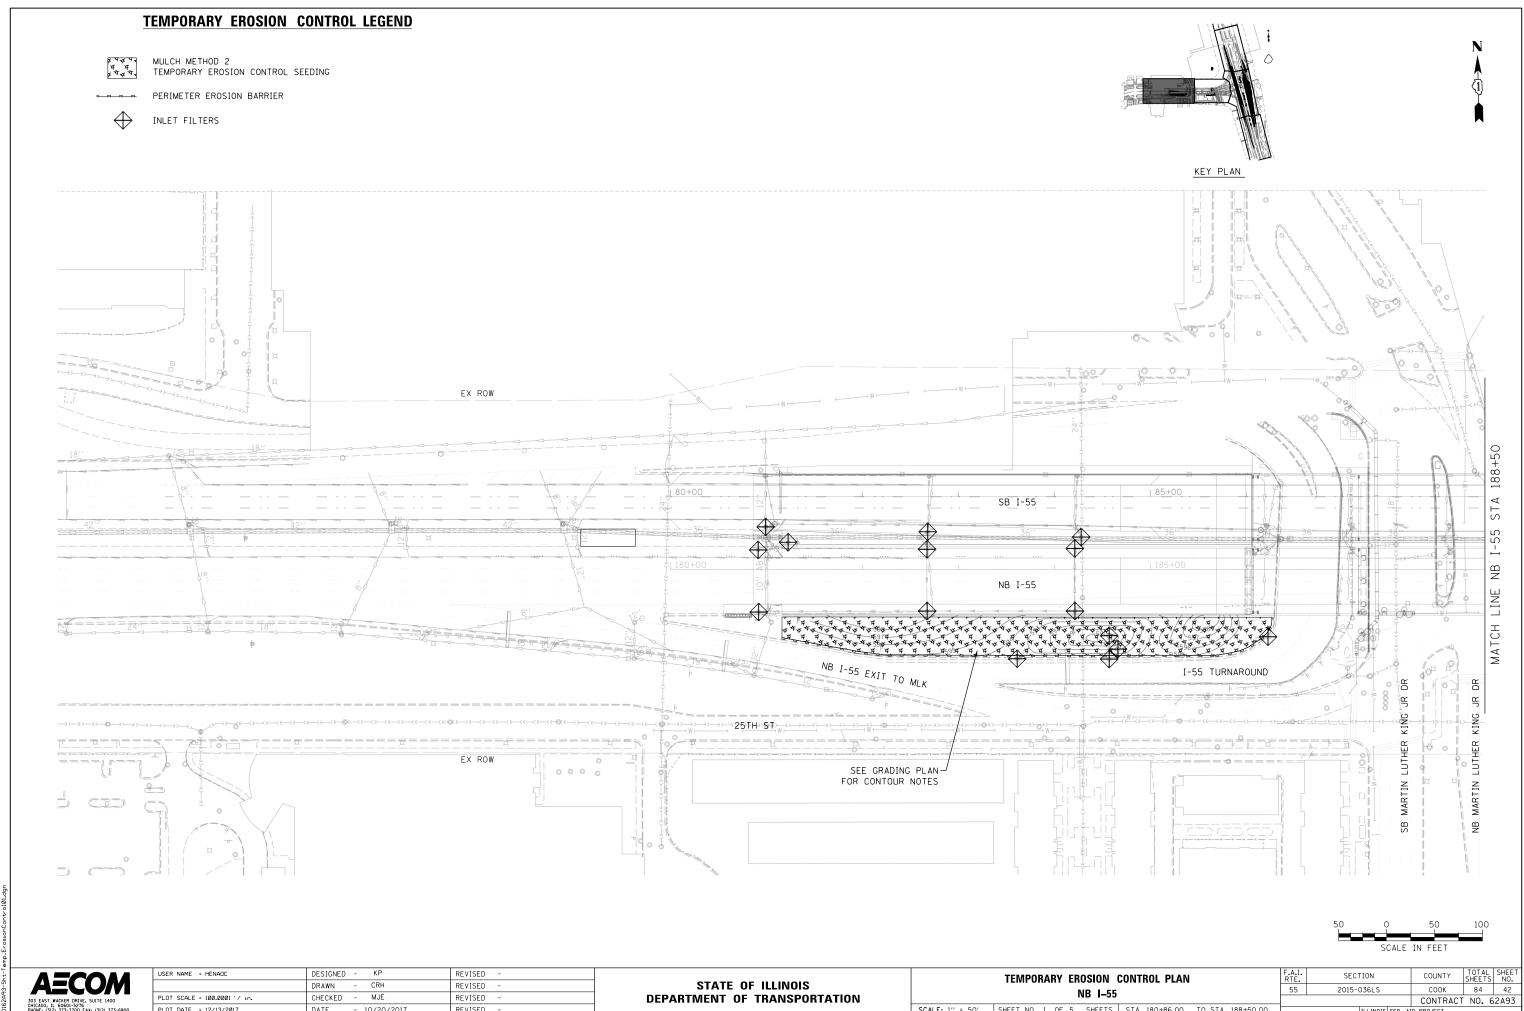

PLOT DATE = 12/13/2017 DATE - 10/20/2017 REVISED


SCALE: 1" = 50' SHEET NO. 1 OF 5 SHEETS STA. 180+86.00 TO STA. 188+50.00

MULCH METHOD 2 TEMPORARY EROSION CONTROL SEEDING

PERIMETER EROSION BARRIER



INLET FILTERS

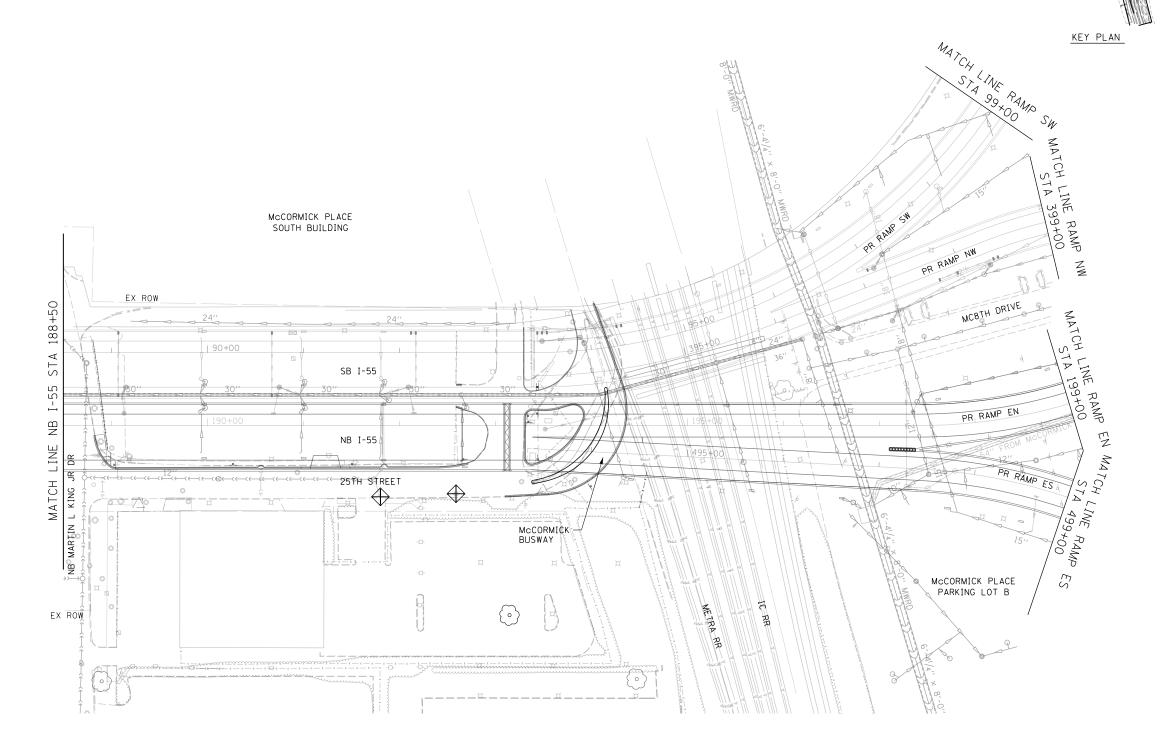



USER NAME = HENAOC	DESIGNED - KP	REVISED -	
	DRAWN - CRH	REVISED -	
PLOT SCALE = 100.0001 '/ in.	CHECKED - MJE	REVISED -	
PLOT DATE = 12/13/2017	DATE - 10/20/2017	REVISED -	

STATE OF ILLINOIS	
DEPARTMENT OF TRANSPORTATION	

	TEMPORARY ER	OSION	CONTROL PLAN		F.A.I. RTE.	SECTION	COUNTY	TOTAL SHEETS	SHEET NO.
	i	NB I-55			55	2015-036LS	COOK	84	43
		4D 1-33					CONTRAC	T NO. 6	52A93
SCALE: 1" = 50"	SHEET NO. 2 OF 5	SHEETS	STA. 188+50.00	TO STA. 199+00.00		ILLINOIS FED	AID PROJECT		

SCALE IN FEET

TEMPORARY EROSION CONTROL LEGEND




MULCH METHOD 2 TEMPORARY EROSION CONTROL SEEDING



PERIMETER EROSION BARRIER



INLET FILTERS

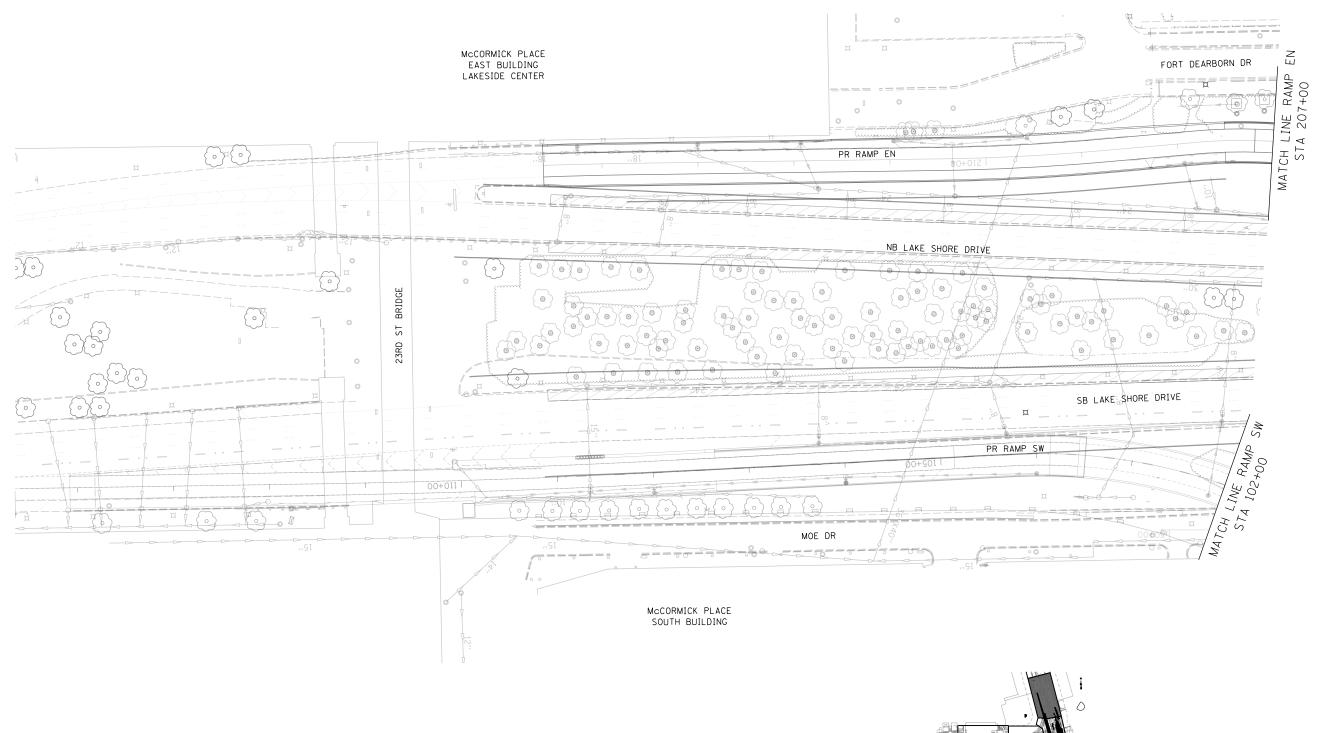



USER NAME = HENAOC	DESIGNED - KP	REVISED -
	DRAWN - CRH	REVISED -
PLOT SCALE = 100.0001 '/ in.	CHECKED - MJE	REVISED -
PLOT DATE = 12/13/2017	DATE - 10/20/2017	REVISED -


STATE OF ILLINOIS **DEPARTMENT OF TRANSPORTATION**


		ROSION CONTROL PLAI RAMP EN	N
SCALE: 1" = 50"	SHEET NO. 3 OF 5	SHEETS STA. 207+00	TO STA. 214+60.73

KEY PLAN

F.A.I. RTE.	SECTION	COUNTY	TOTAL SHEETS	SHE	
55	2015-036LS	соок	84	44	
			CONTRACT	NO. 6	2A9
	ILLINOIS	FED. A	ID PROJECT		

SCALE IN FEET

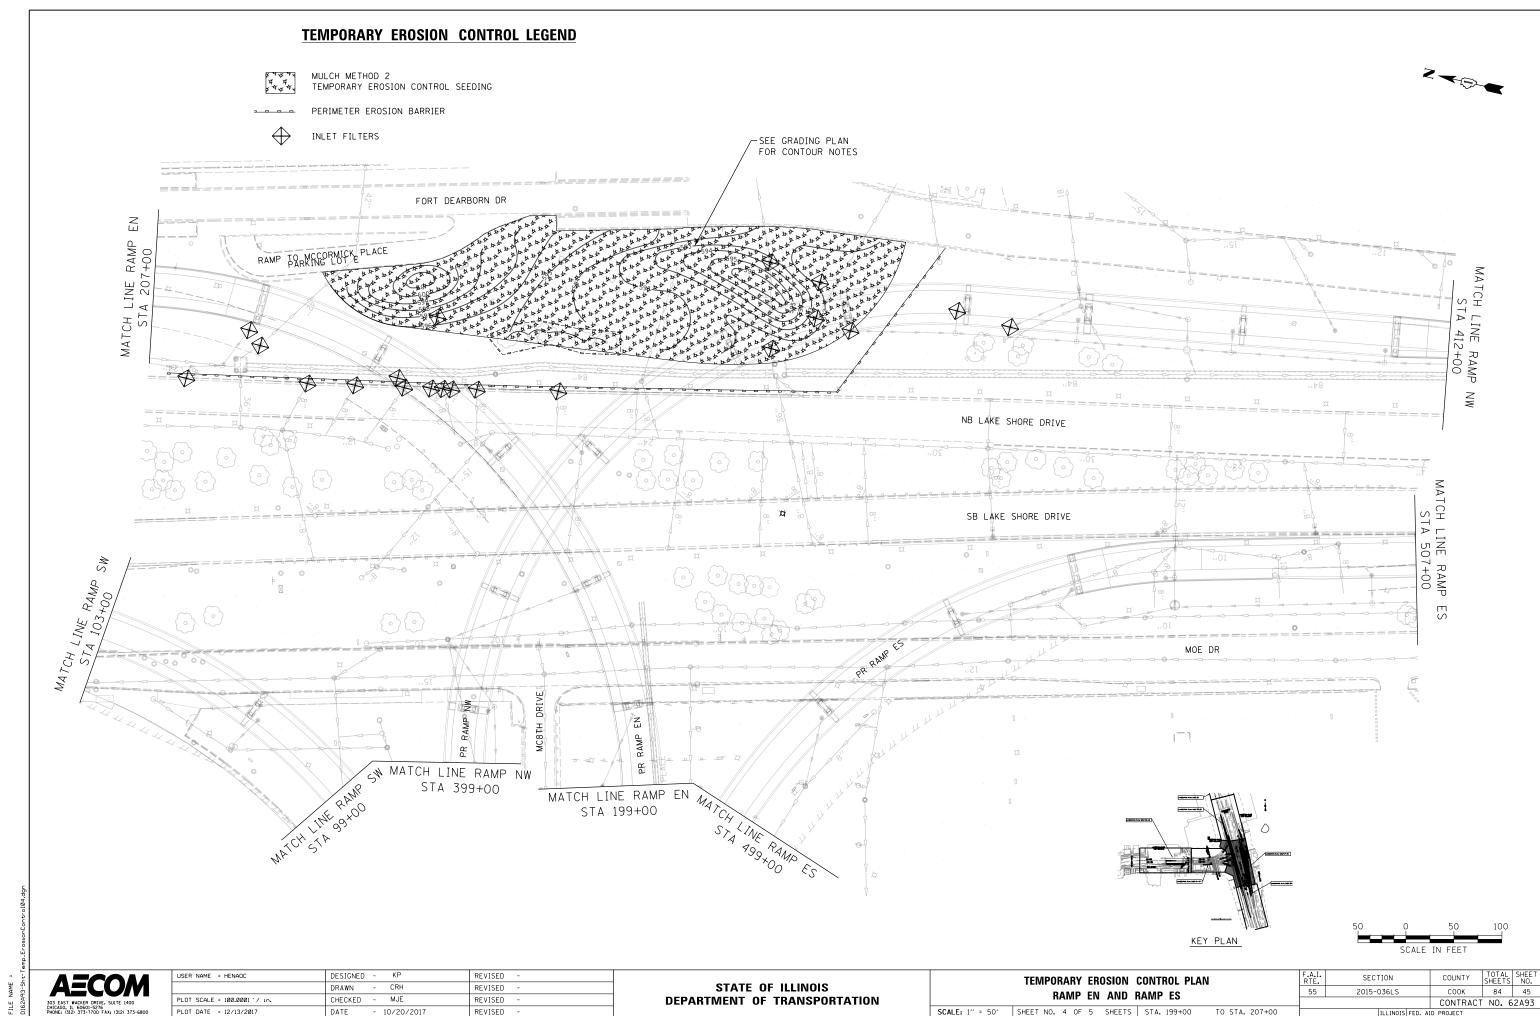

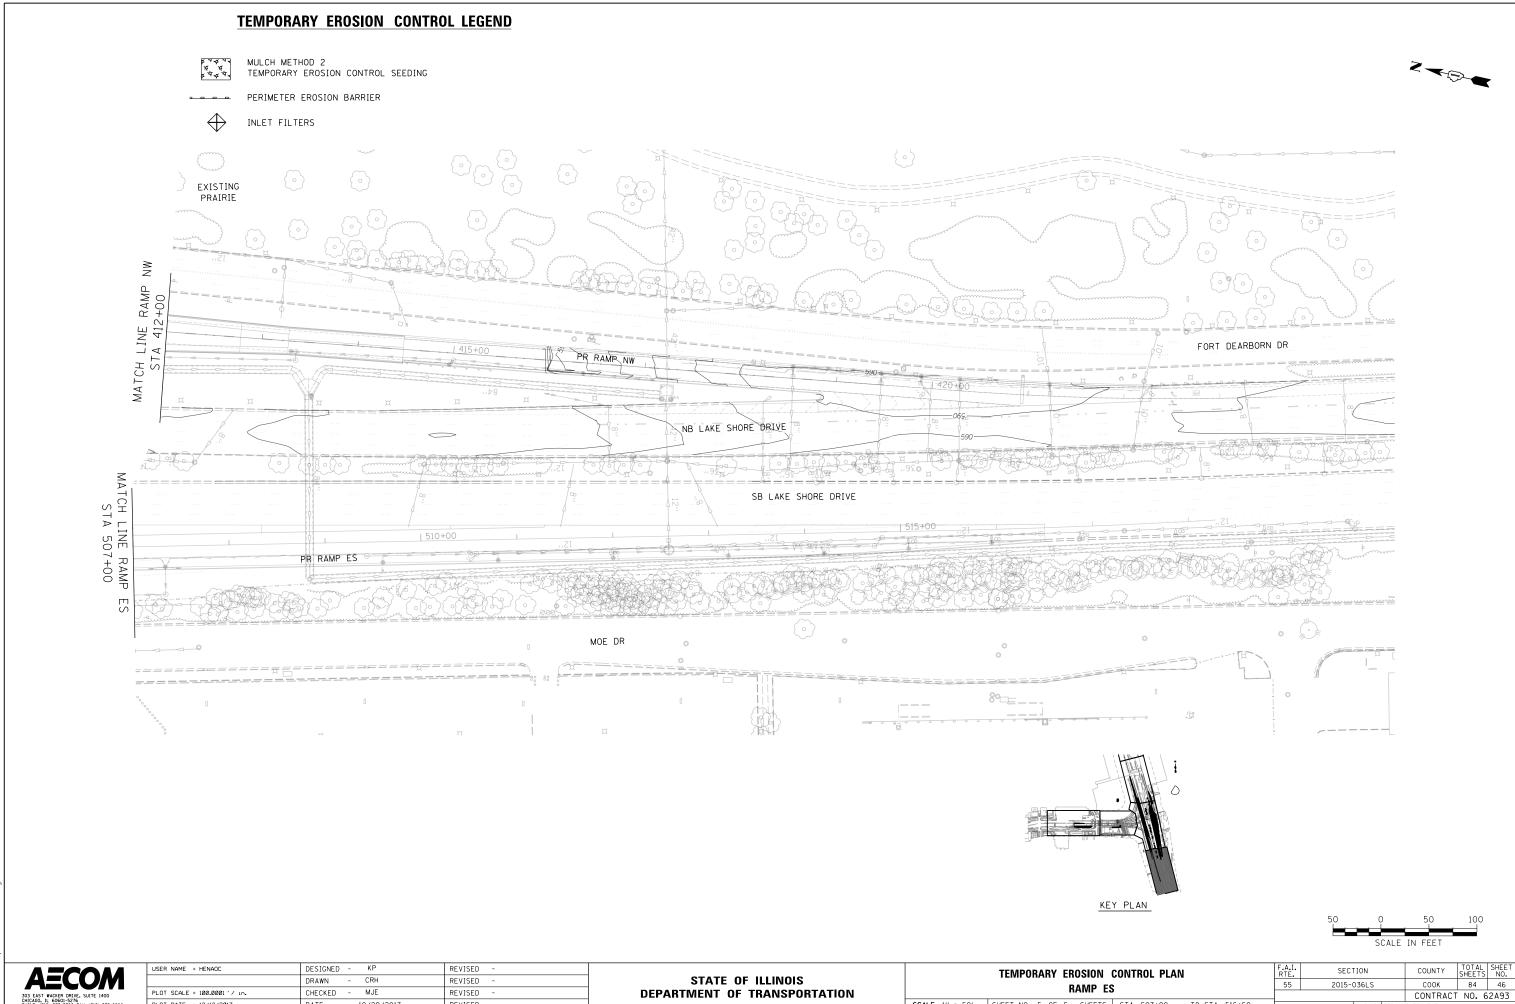


SCALE: 1" = 50' SHEET NO. 5 OF 5 SHEETS STA. 507+00 TO STA. 516+50

PLOT DATE = 12/13/2017

DATE

- 10/20/2017

REVISED

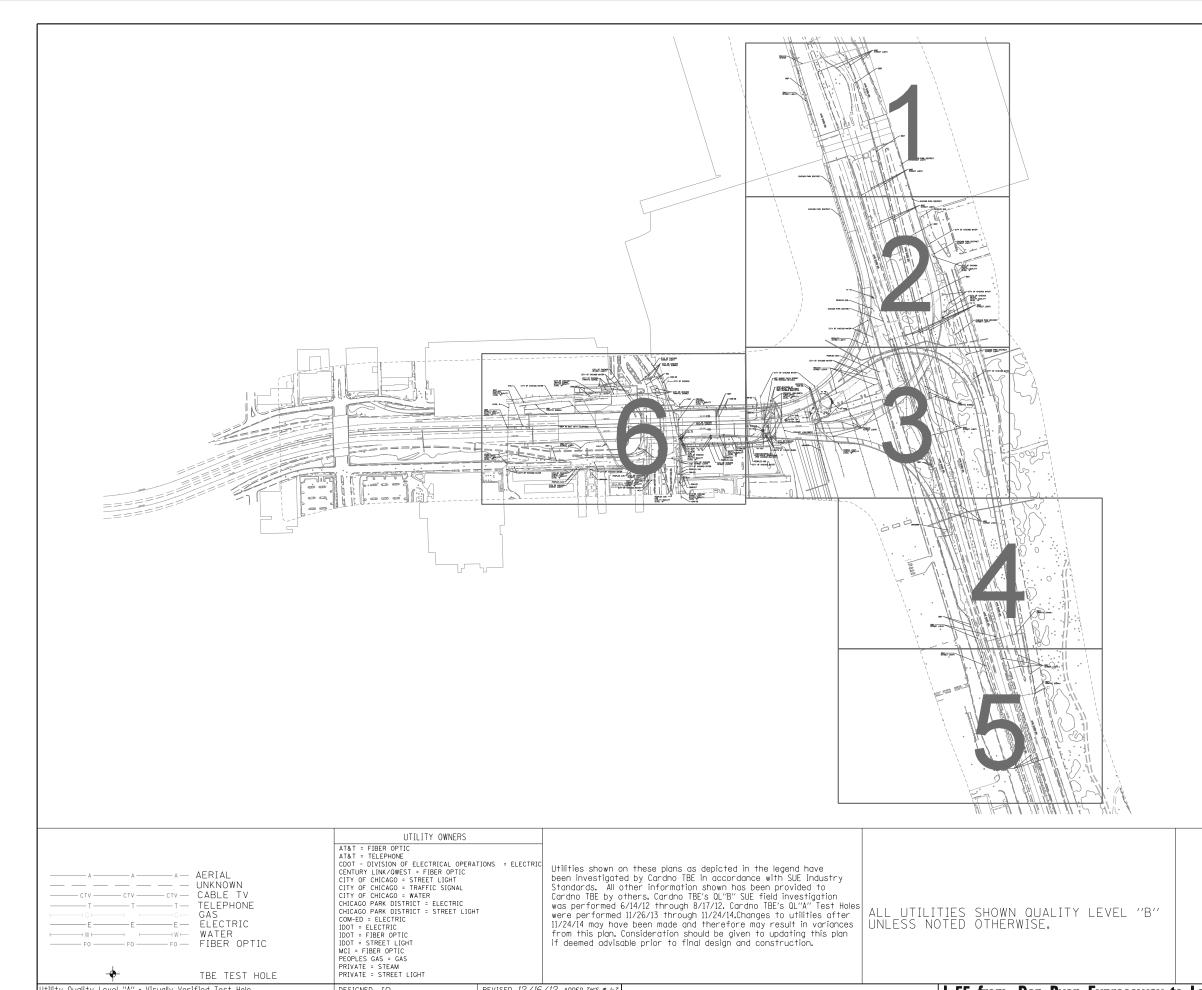

REVISED 12/16/12 ADDED TH'S # 1-7

REVISED 5/29/14 ADDED TH'S # 8-13

REVISED 8/11/14 UPDATED OWNERS

REVISED 12/2/14 ADDED TH'S # 14-1

Jtility Quality Level "A": Visually Verified Test Hole

Utility Quality Level "C": Research with Survey

Utility Quality Level "D" : Records Research

Jtility Quality Level "B": Designating/non Visually Verified Test Hole

DESIGNED IP

DRAWN SRK

CHECKED KFS

DATE 8/31/12


Cardno CIVIL ENGINEERING * TRANSPORTATION * ENVIRONMENTAL * PLANNING * UTILITY ENGINEERING/LOCATING





TBE Job No. IL09510483, 549, 616 SUE Plan Page: Cover


STATE OF ILLINOIS **DEPARTMENT OF TRANSPORTATION** I–55 from Dan Ryan Expressway to Lake Shore Drive Chicago, Illinois


)	F.A. SECTION						COUNTY		TOTAL SHEETS	SHE NO
		N/A							84	47
							Contract	No	62A9	93
	FED. RO	DAD	DIST.	NO.	ILL INOIS	IDOT	Project No.			

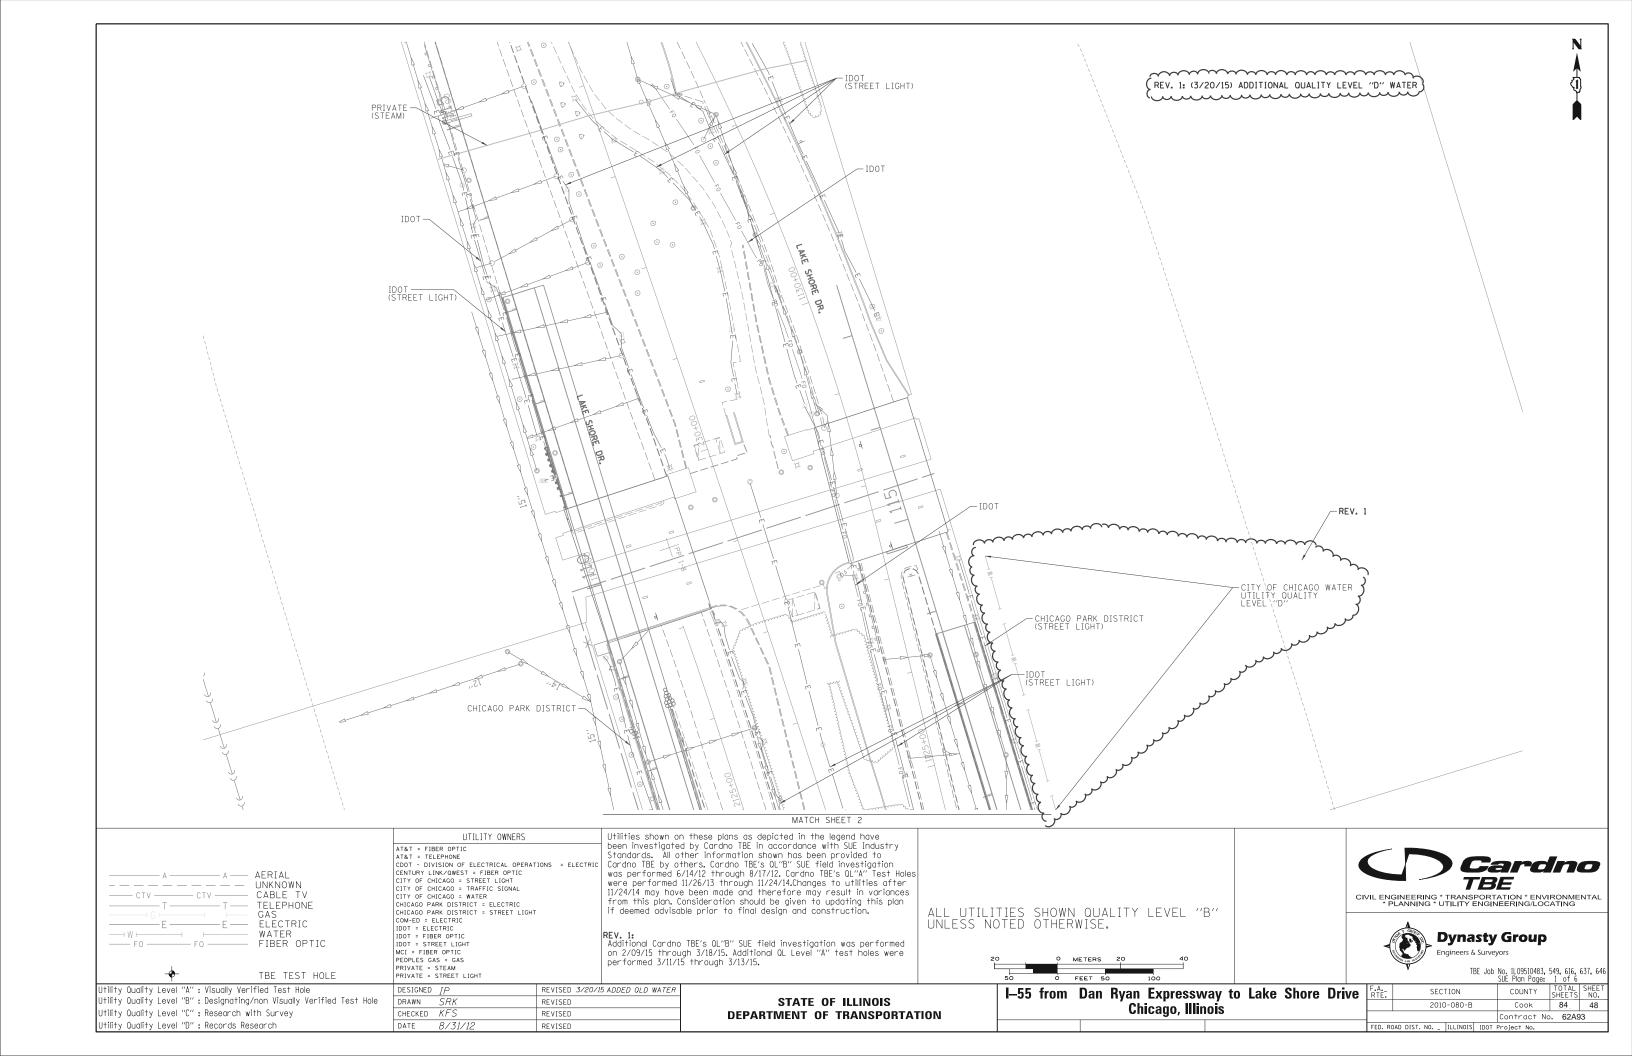


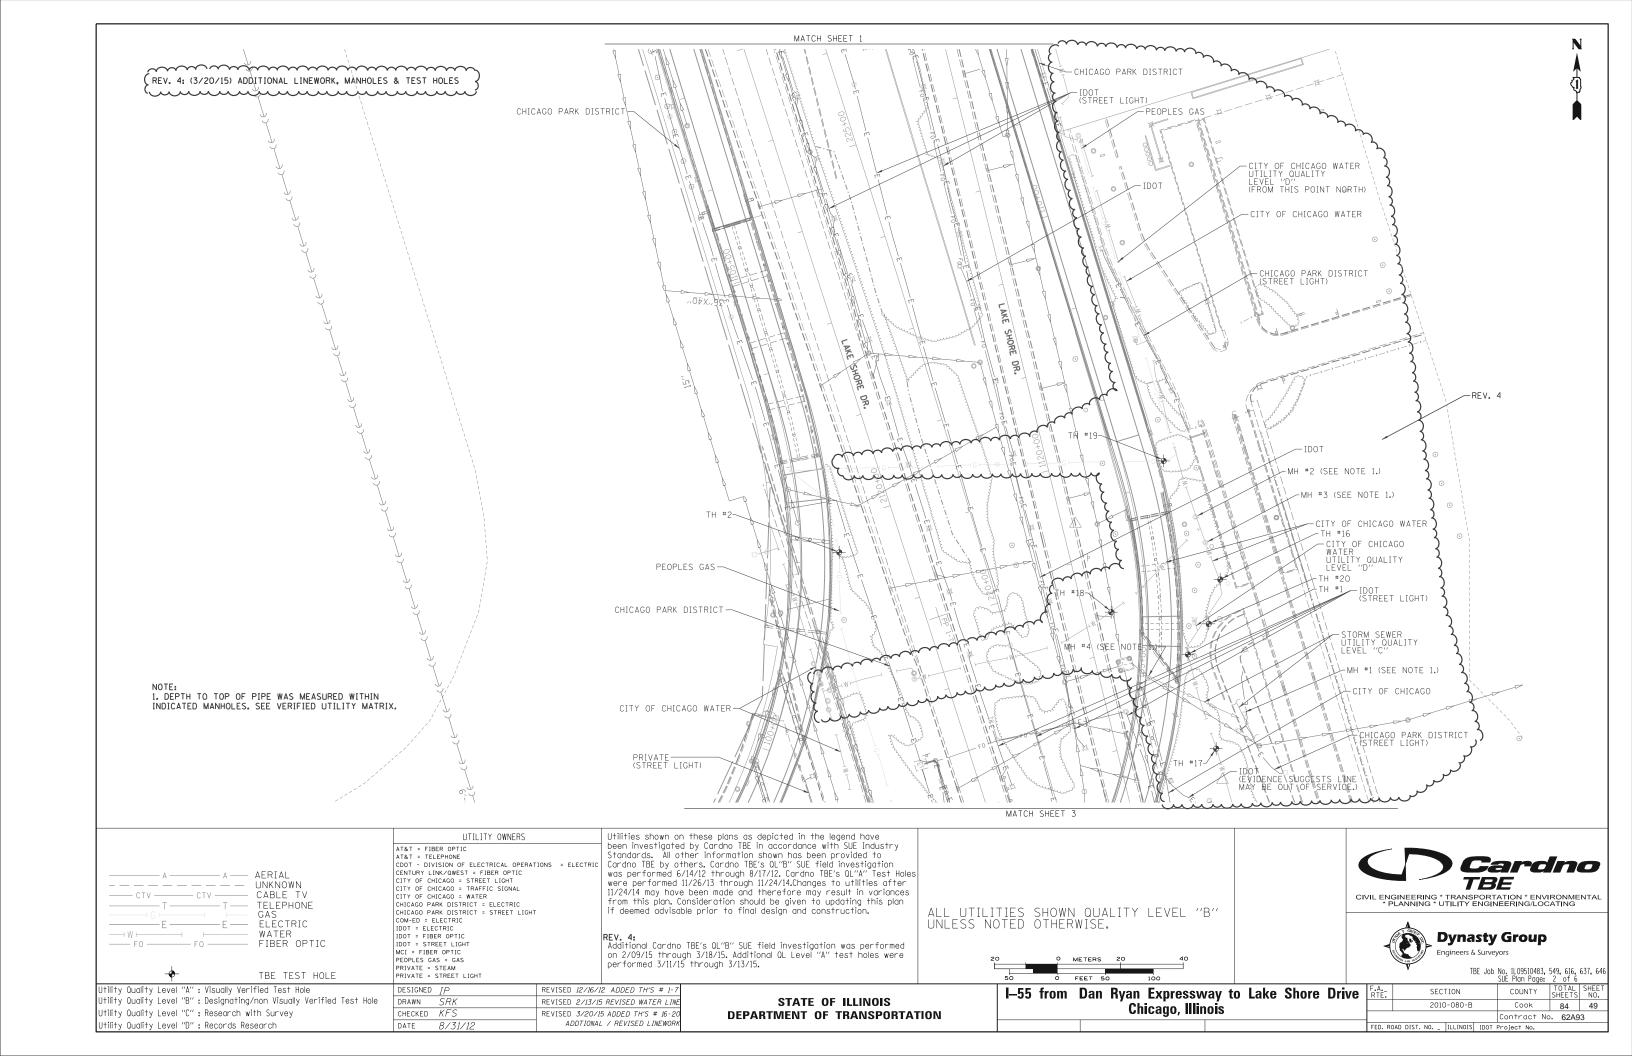

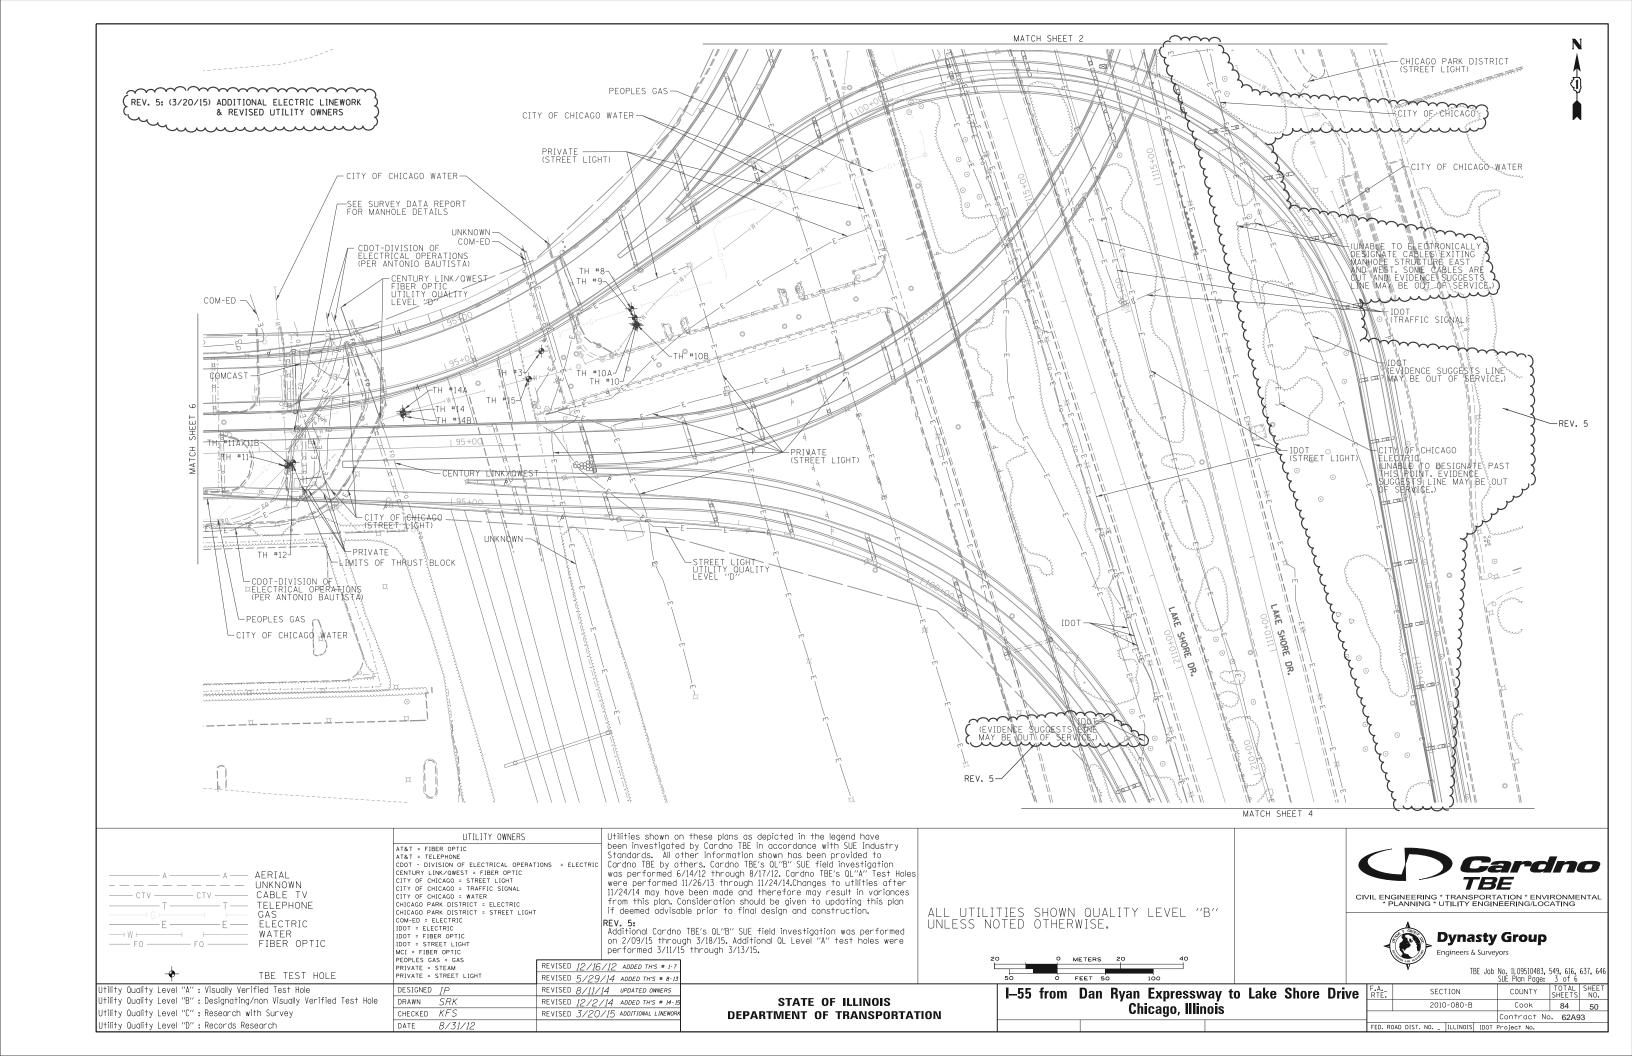

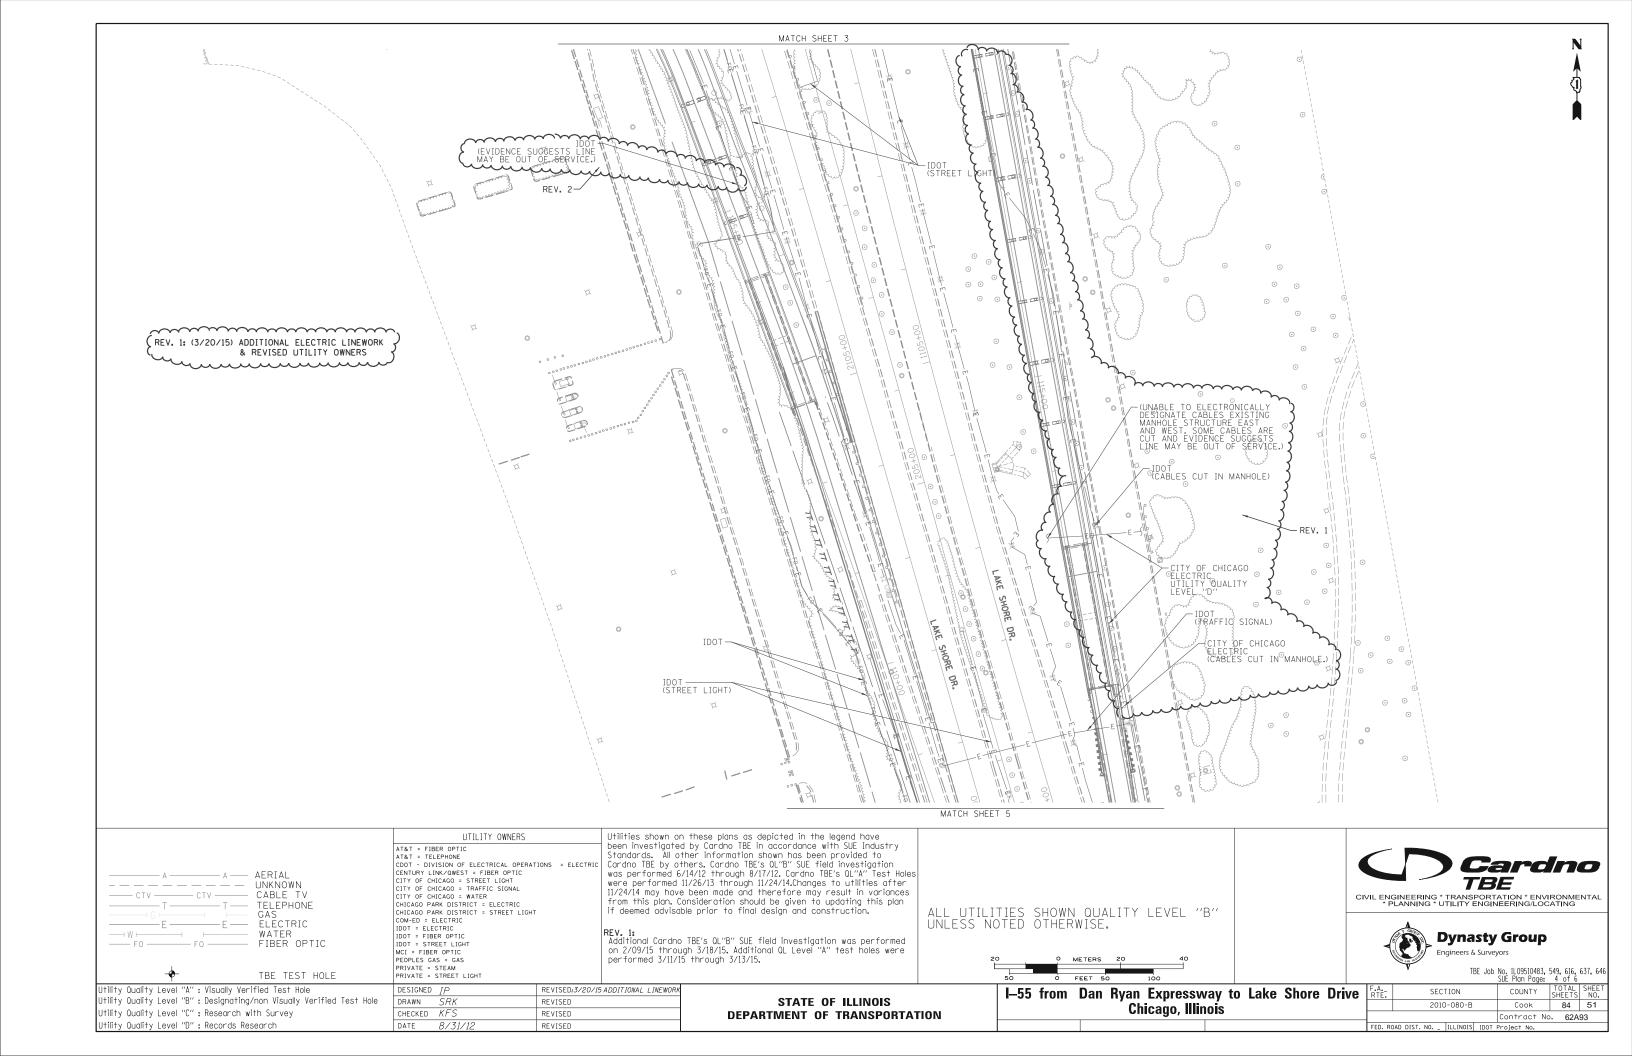

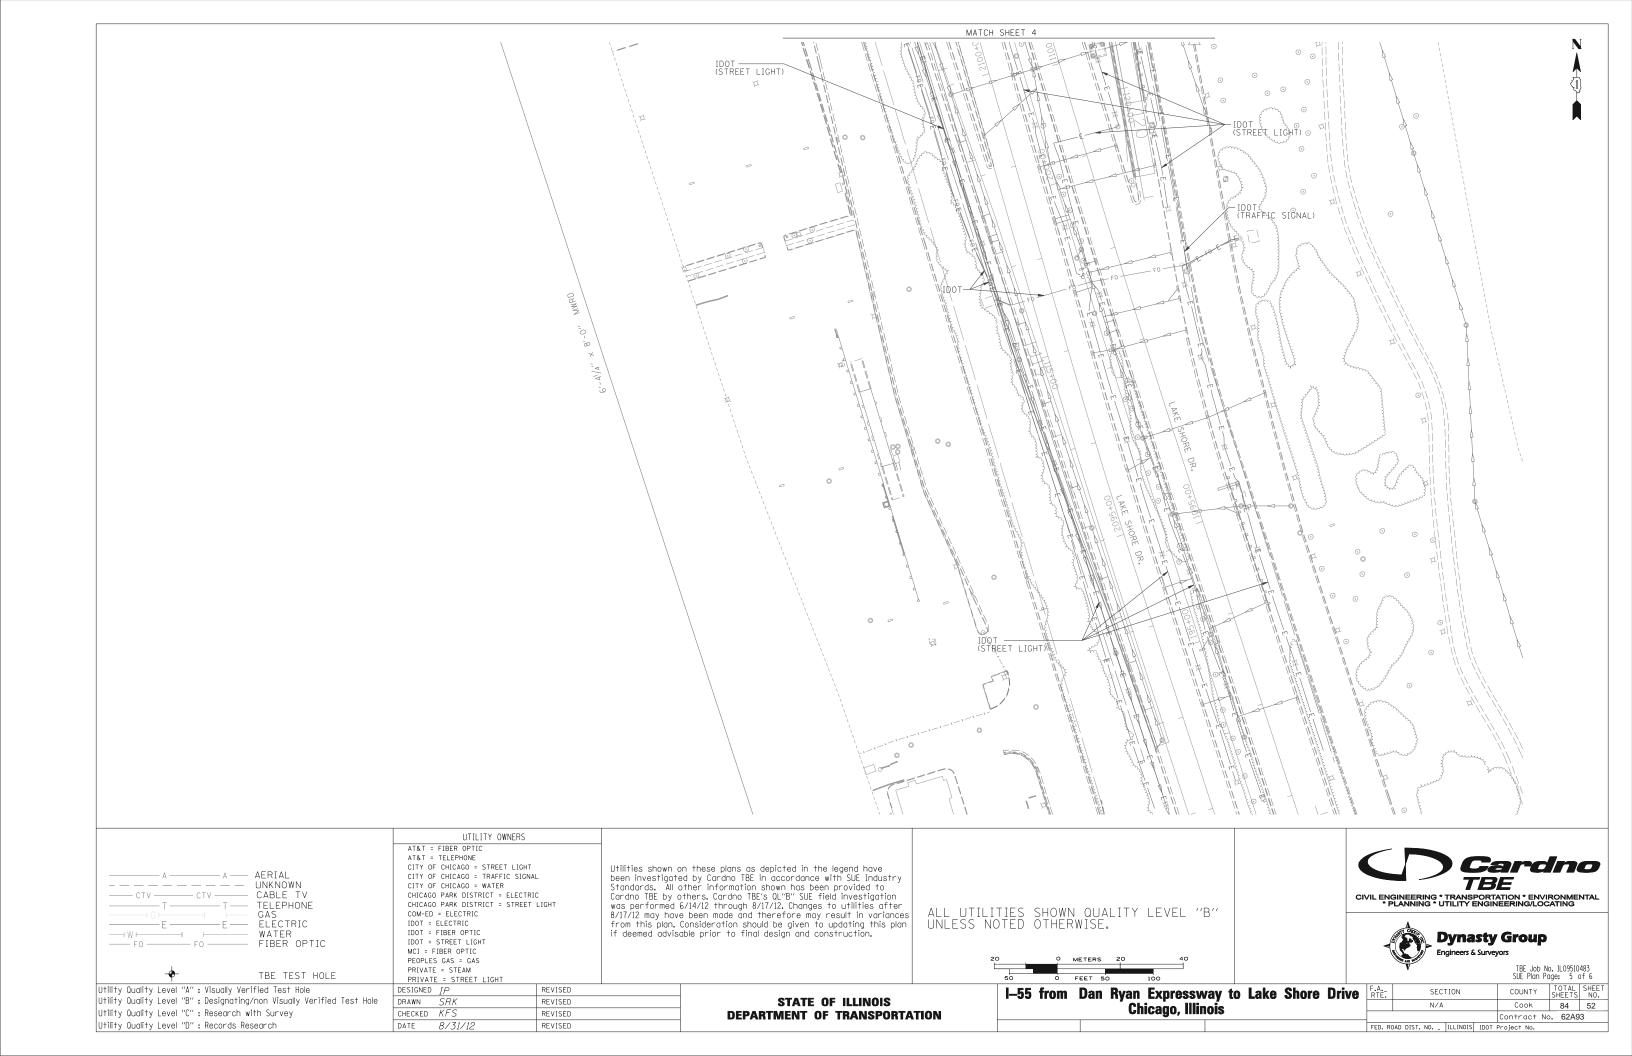

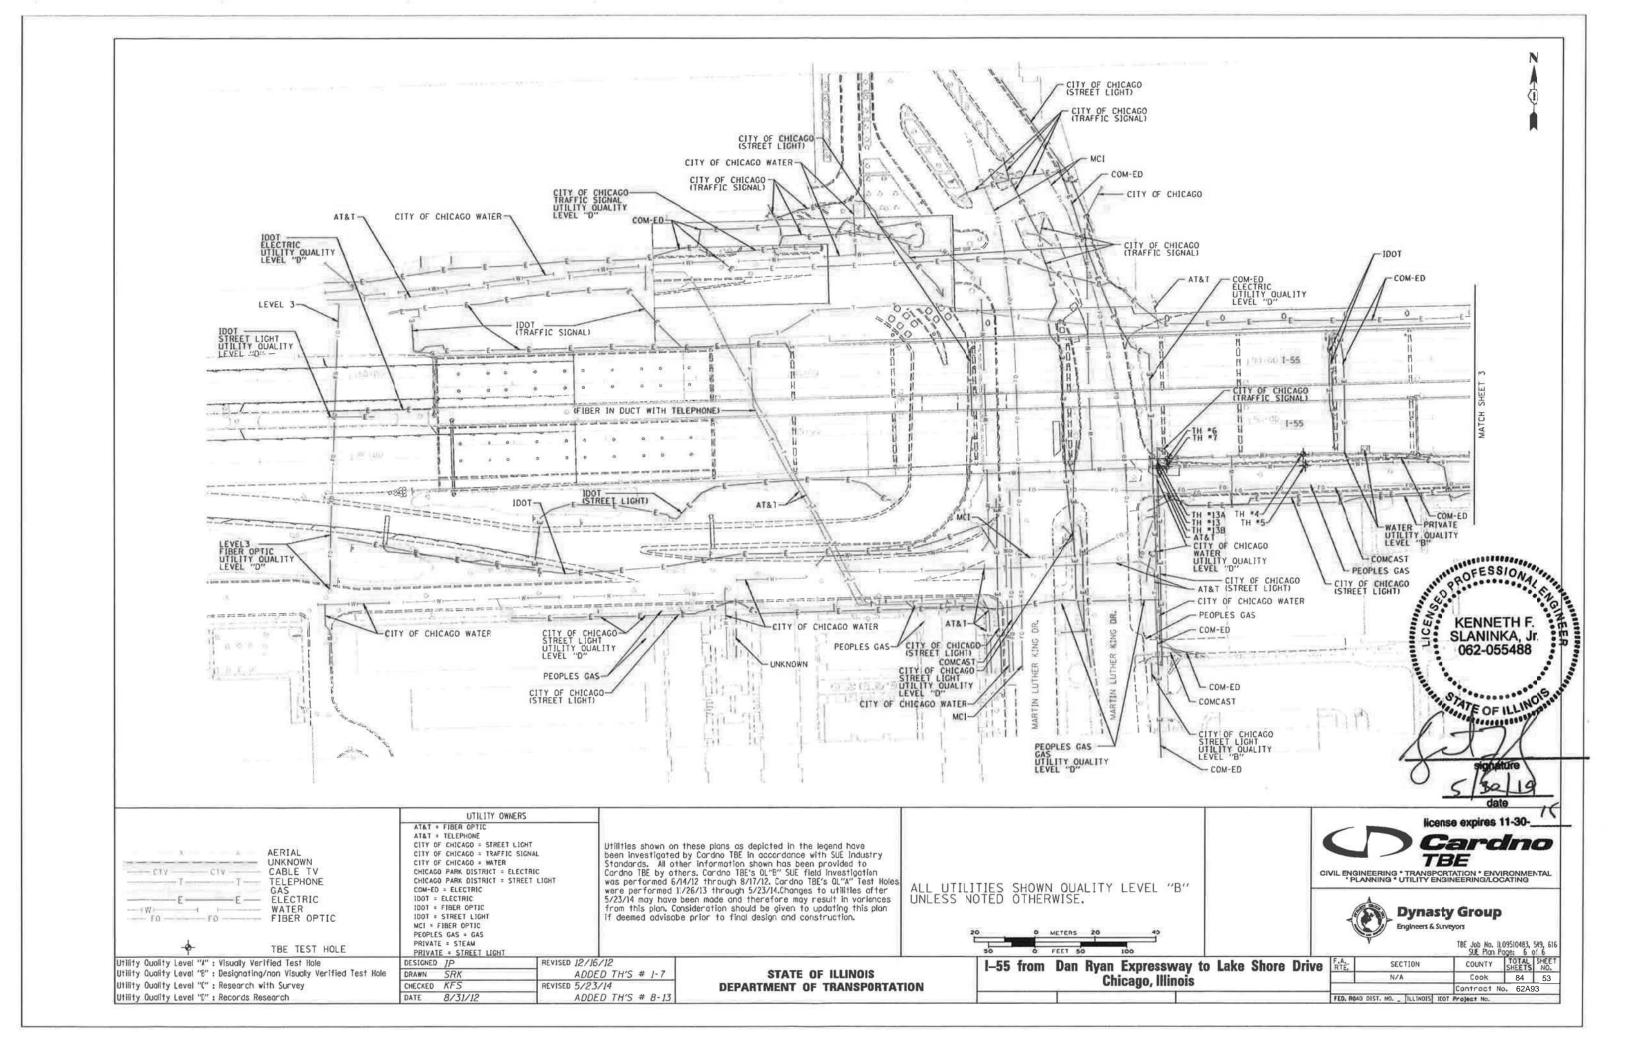

	VERIFIED UTILITY INFORMATION									
TEST HOLE #	SIZE &	TYPE	NORTHING	EASTING	EXISTING TOP ELEVATION	EXISTING CUT	REFERENCE ELEVATION	COMMENTS		
1	SEE NOTE	W	1888596.81	1180736.55	591.11′	7.04′	598.15′	QUALITY LEVEL "A"		
2	8′′	G	1888703.16	1180373.27	597.01′	4.41′	601.42′	QUALITY LEVEL "A"		
3	SEE NOTE	G	1888127.97	1180062.93	578.53′	12.27′	590.80′	QUALITY LEVEL "A"		
4	8′′	W	1887982.08	1179528.27	589.84′	5.26′	595.10′	QUALITY LEVEL "A"		
5	36′′	W	1887969.87	1179530.63	590.91′	3.69′	594.60′	QUALITY LEVEL "A"		
6	8′′	W	1887977.25	1179380.92	589.74′	6.14′	595.88′	QUALITY LEVEL "A"		
7	36′′	W	1887968.25	1179379.95	591.37′	4.14′	595.51′	QUALITY LEVEL "A"		
8	8′′	G	1888172.02	1180156.58	587.33′	3.54′	590.87′	QUALITY LEVEL "A"		
9	SEE NOTE	N/A	1888162.81	1180160.10	585.84′	5.00′	590.84′	QUALITY LEVEL "A"		
10	36′′	W	1888155.55	1180162.03	586.73′	3.88′	590.61′	QUALITY LEVEL "A"		
10A	36′′	W	1888156.42	1180160.81	N/A	N/A	590.65′	QUALITY LEVEL "A"		
10B	36′′	W	1888154.60	1180163.16	N/A	N/A	590.60′	QUALITY LEVEL "A"		
11	SEE NOTE	W	1888008.50	1179798.17	594.09′	2.05′	596.14′	QUALITY LEVEL "A"		
11 A	SEE NOTE	N/A	1888008.17	1179800.26	593.84′	2.82′	596.66′	QUALITY LEVEL "A"		
11B	4′′×36′′	UNK	1888008.17	1179800.26	595.28′	1.38′	596.66′	QUALITY LEVEL "A"		
12	SEE NOTE	N/A	1888011.89	1179804.28	591.69′	5.00′	596.69′	QUALITY LEVEL "A"		
13	36′′	W	1887968.30	1179370.46	590.69′	4.78′	595.47′	QUALITY LEVEL "A"		
13A	SEE NOTE	N/A	1887969.79	1179370.59	N/A	N/A	595.49′	QUALITY LEVEL "A"		
13B	SEE NOTE	N/A	1887966.77	1179370.47	N/A	N/A	595.47′	QUALITY LEVEL "A"		
14	48′′	W	1888063.32	1179918.79	585.68′	5.61′	591.29′	QUALITY LEVEL "A"		
14A	48′′	W	1888065.24	1179918.30	N/A	N/A	591.28′	QUALITY LEVEL "A"		
14B	48′′	W	1888061.38	1179919.22	N/A	N/A	591.29′	QUALITY LEVEL "A"		
15	SEE NOTE	W	1888098.93	1180049.91	584.37′	6.00′	590.37′	QUALITY LEVEL "B"		
16	SEE NOTE	W	1888674.95	1180770.13	591.31′	11.80′	602.39′	QUALITY LEVEL "B"		
17	SEE NOTE	W	1888498.61	1180765.94	588.34′	11.53′	599.87′	QUALITY LEVEL "B"		
18	24′′	W	1888640.85	1180656.62	585.20′	5.88′	591.08′	QUALITY LEVEL "A"		
19	12′′	G	1888798.35	1180711.30	596.63′	6.60′	603.23′	QUALITY LEVEL "A"		
20	SEE NOTE	N/A	1888628.65	1180758.23	590.65′	9.15′	599.80′	QUALITY LEVEL "A"		

NOTES

TH #1 - Unable to visually verify the utility due to gravel/fill caving in the test hole. Tapped what we believe to be the utility with the airlance to verify size, shape and depth.

TH #2 - Found 8" Steel main wrapped in yellow FBE.

TH #3 - Unable to visually verify the utility due to sand and huge rocks caving in the test hole. Had to stop digging for safety reasons. Tapped what we believe to be the utility with the airlance to get manual depth.

But unable to determine the size.

TH#8 - Found 8" Steel main wrapped in yellow FBE.

TH#9 - Excavated to a depth of 5' and did not find evidence of a water main thrust block. Did encounter a lot of large debris i.e. rocks, concrete, wood.

TH#10 - No evidence of bend or thrust block found. 36" water main was wrapped in black p.e. liner. Reference point was placed in line with top of pipe.

TH#10A - Reference point was placed in line with north edge of pipe.

TH#10B - Reference point was placed in line with South edge of pipe.

TH#11 - Found concrete thrust block almost covering what appeared to be the top crown of pipe. Water main was wrapped in black p.e. liner.

TH#11A - Top of concrete thrust block. Same reference point was used for 11B.

TH#11B - Found a 4"x36" concrete duct/ capf Could visually see 2 conduits directly underneath this duct/cap which is believed to be the fiber optic. Reference point was placed in line with the western edge of duct/cap. Reference point same as 11A.

TH#12 - Excavated to a depth of 5' and did find thrust block to be in conflict. Edge of thrust was found to be 2' west of this location.

TH#13 - Reference point placed in line with top of pipe.

TH#13A - Reference point was placed in line with North edge of pipe.

TH#13B - Reference point was placed in line with South edge of pipe.

TH#14A - Reference point was placed in line with North edge of pipe.

TH#14B - Reference point was placed in line with South edge of pipe.

TH#15 - Found large wooden rail road ties, unsure if protection for water main. We were able to probe between 2 of the ties and tapped what is believed to be the water main. Size of pipe could not be determined.

TH#16 - Unable to visually see the utility due to large rocks within the excavated hole. However, by utilizing the air lance we were able to tap and feel what is believed to be the top of pipe.

TH#17 -Unable to visually see the utility due to loose pea gravel continually collapsing within the excavated hole. However, by utilizing the air lance we were able to tap and feel what is believed to be the top of pipe.

TH#20 - Found the edge of the retaining wall footing to the parking garage wall. Reference point was placed directly in line with the edge of footing.

ABBREVIATIONS

G - GAS W - WATER

UNK - UNKNOWN

ALL INFORMATION SHOWN WAS OBTAINED FROM A LOCATION SURVEY.



CIVIL ENGINEERING * TRANSPORTATION * ENVIRONMENTAL * PLANNING * UTILITY ENGINEERING/LOCATING

Checked By: _____

Date: ______ TBE Job No. IL09510549, 616, 637, 646

DESIGNED ER REVISED: 5/29/14 ADDED TH'S 8-13 I-55 from Dan Ryan Expressway to Lake Shore Drive SECTION COUNTY STATE OF ILLINOIS DRAWN SRK REVISED: 11/26/14 ADDED TH'S 14-15 Cook 84 54 2010-080-B Chicago, Illinois CHECKED KFS REVISED: 3/20/15 ADDED TH'S 16-20 **DEPARTMENT OF TRANSPORTATION** Contract 62A93 DATE 12/16/13

MAN	SIZE	&	TYPE	NORTHING	EASTING	EXISTING	EXISTING	RIM	COMMENTS
OLE #						TOP ELEVATION	CUT	ELEVATION	
1	42′′		SS	1888534.96	1180795.20	582.15′	12.54′	594.69′	QUALITY LEVEL "A"
2	24′′		W	1888739.92	1180744.41	590.36′	11.34′	601.70′	QUALITY LEVEL "A"
3	24′′		W	1888713.19	1180754.62	590.55′	11.56′	602.11′	QUALITY LEVEL "A"
4	42′′		SS	1888572.08	1180695.58	582.04′	8.32′	590.36′	QUALITY LEVEL "A"

NOTES	ABBREVIATIONS
	SS - STORM SEWER W - WATER

ALL INFORMATION SHOWN WAS OBTAINED FROM A LOCATION SURVEY.



CIVIL ENGINEERING * TRANSPORTATION * ENVIRONMENTAL * PLANNING * UTILITY ENGINEERING/LOCATING

SECTION

Checked By: ___ Date: ____

TBE Job No. IL09510549, 616, 637, 646

DESIGNED ER REVISED DRAWN SRK REVISED CHECKED KFS
DATE 3/20/15 REVISED REVISED

STATE OF ILLINOIS DEPARTMENT OF TRANSPORTATION I–55 from Dan Ryan Expressway to Lake Shore Drive Chicago, Illinois


COUNTY TOTAL SHEETS NO.

Cook 84 55

Contract 62A93

Job No.: P-91-259-12

2010-080-В

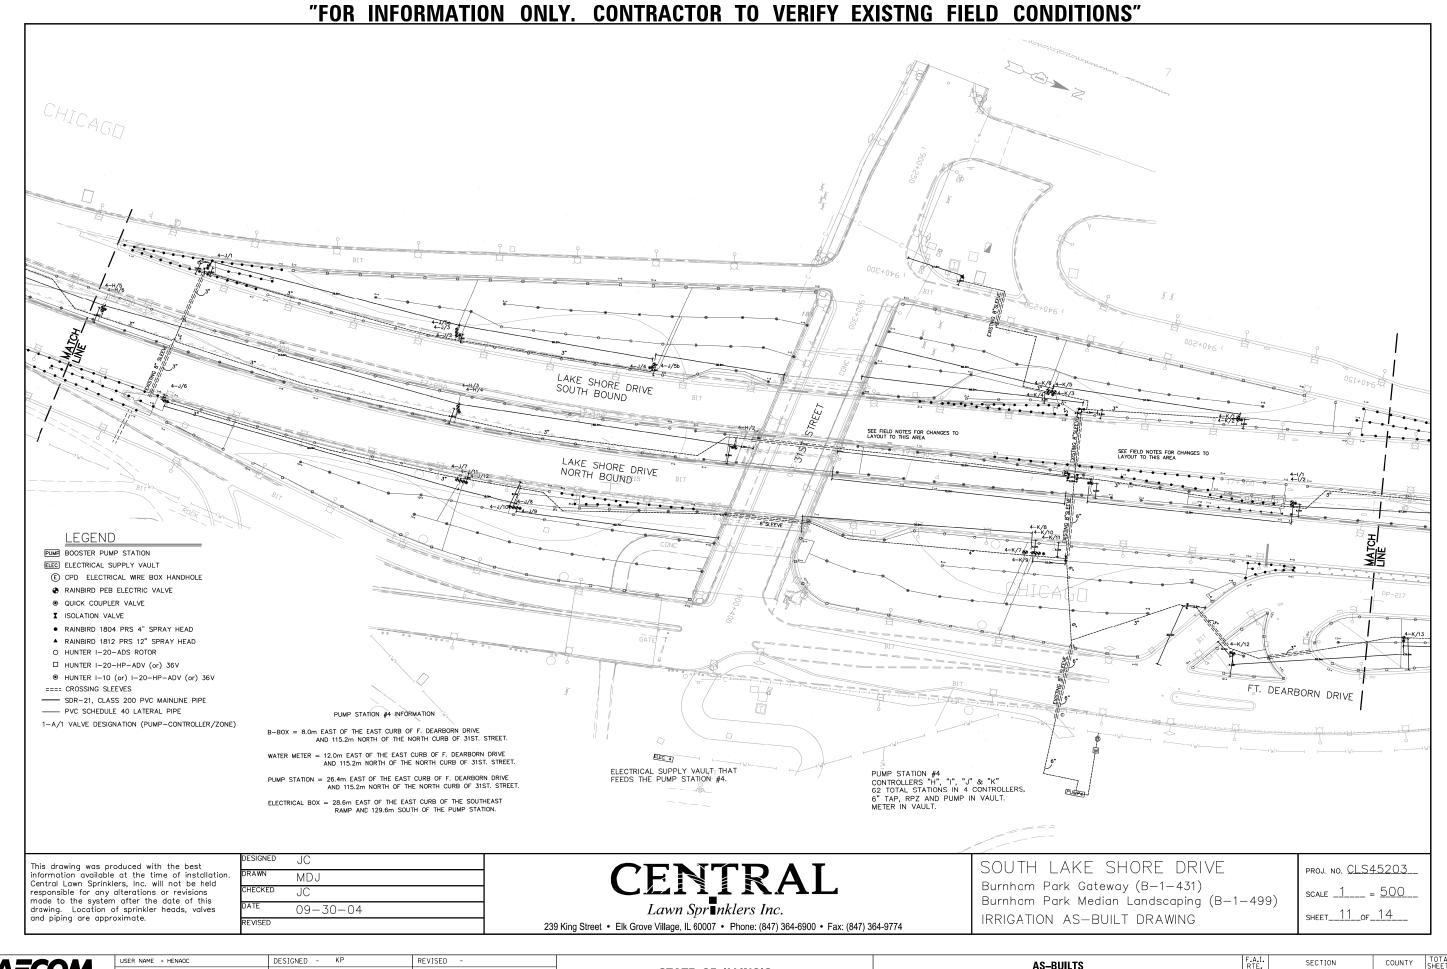


A=CO/ 303 EAST MACKER DRIVE, SUITE 1400 CHICASO, IL 66601-5276 PHONE; (3)2) 373-7700 FAX; (3)2) 373

USER NAME = HENAOC	DESIGNED - KP	REVISED -	_
	DRAWN - CRH	REVISED -	
PLOT SCALE = 0:2.0000 ':' / in.	CHECKED - MJE	REVISED -	
PLOT DATE = 10/13/2017	DATE - 10/20/2017	REVISED -	

STATE OF ILLINOIS DEPARTMENT OF TRANSPORTATION

SCALE

			AS	S-BUILTS	;		F.A.I. RTE.	SECTION	COUNTY	TOTAL SHEETS	SHEET NO.
							55	2015-036LS	COOK	84	56
									CONTRACT	NO.	62A93
SHEET NO	. 1	0F	4	SHEETS	STA.	TO STA.		ILLINOIS FED. AI	D PROJECT		

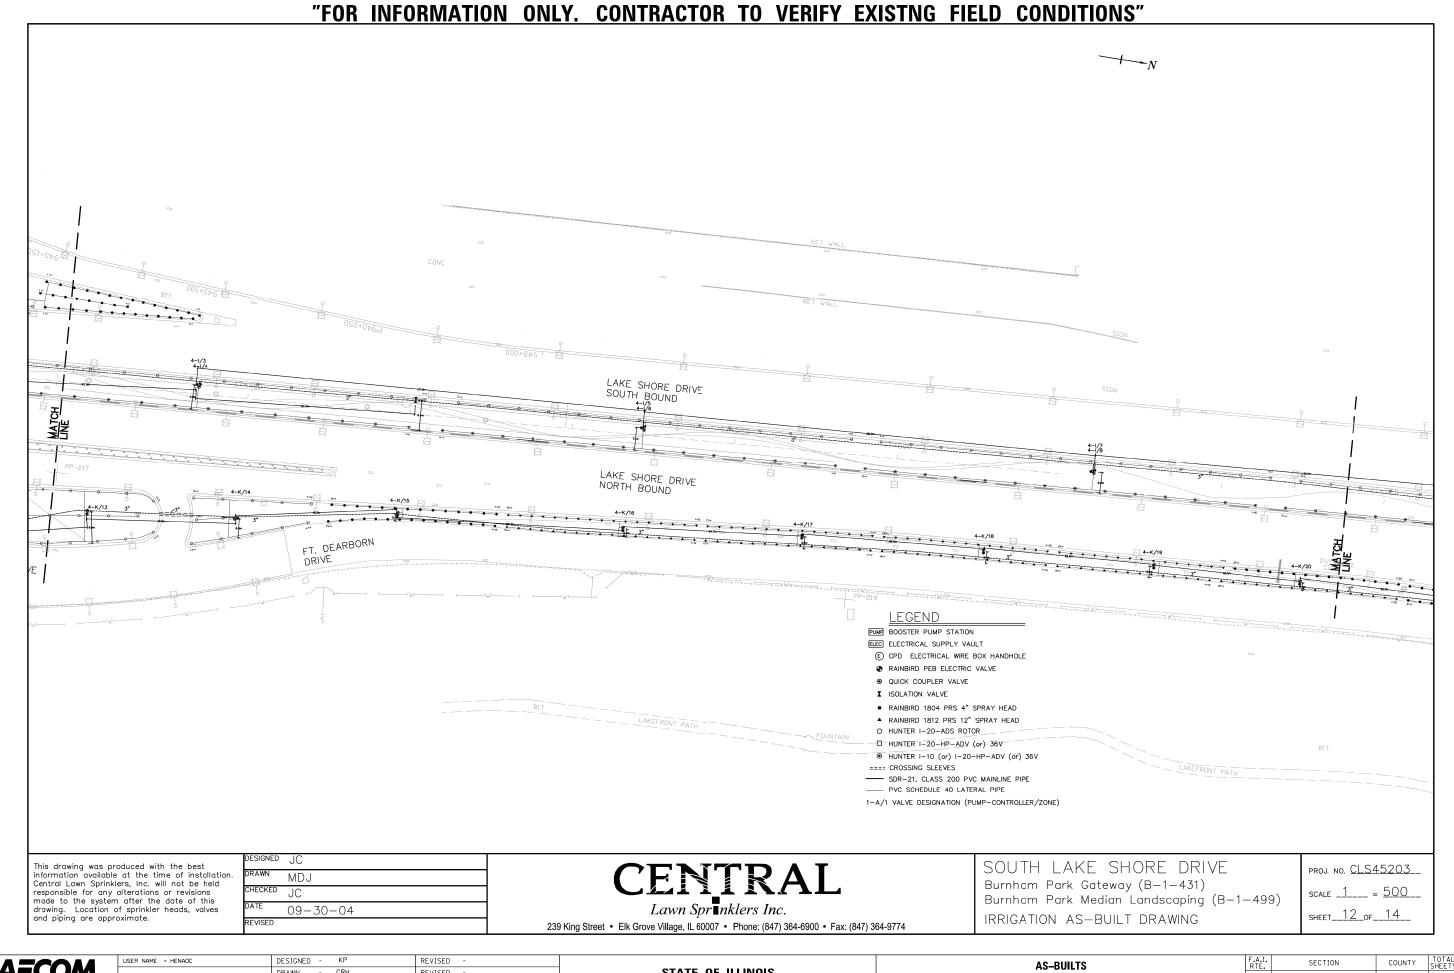

SOS EAST MACKER BRIVE. SUITE 1400 CRISCO. IL GEOTOCO FOR CONTRACT SIZE 373-7070 FAX: (3)21 373-6800


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 DESIGNED - KP
 REVISED

 DRAWN - CRH
 REVISED

 PLOT SCALE = 0:2.0000 ':' / in.
 CHECKED - MJE
 REVISED

 PLOT DATE = 10/13/2017
 DATE - 10/20/2017
 REVISED

STATE OF ILLINOIS DEPARTMENT OF TRANSPORTATION

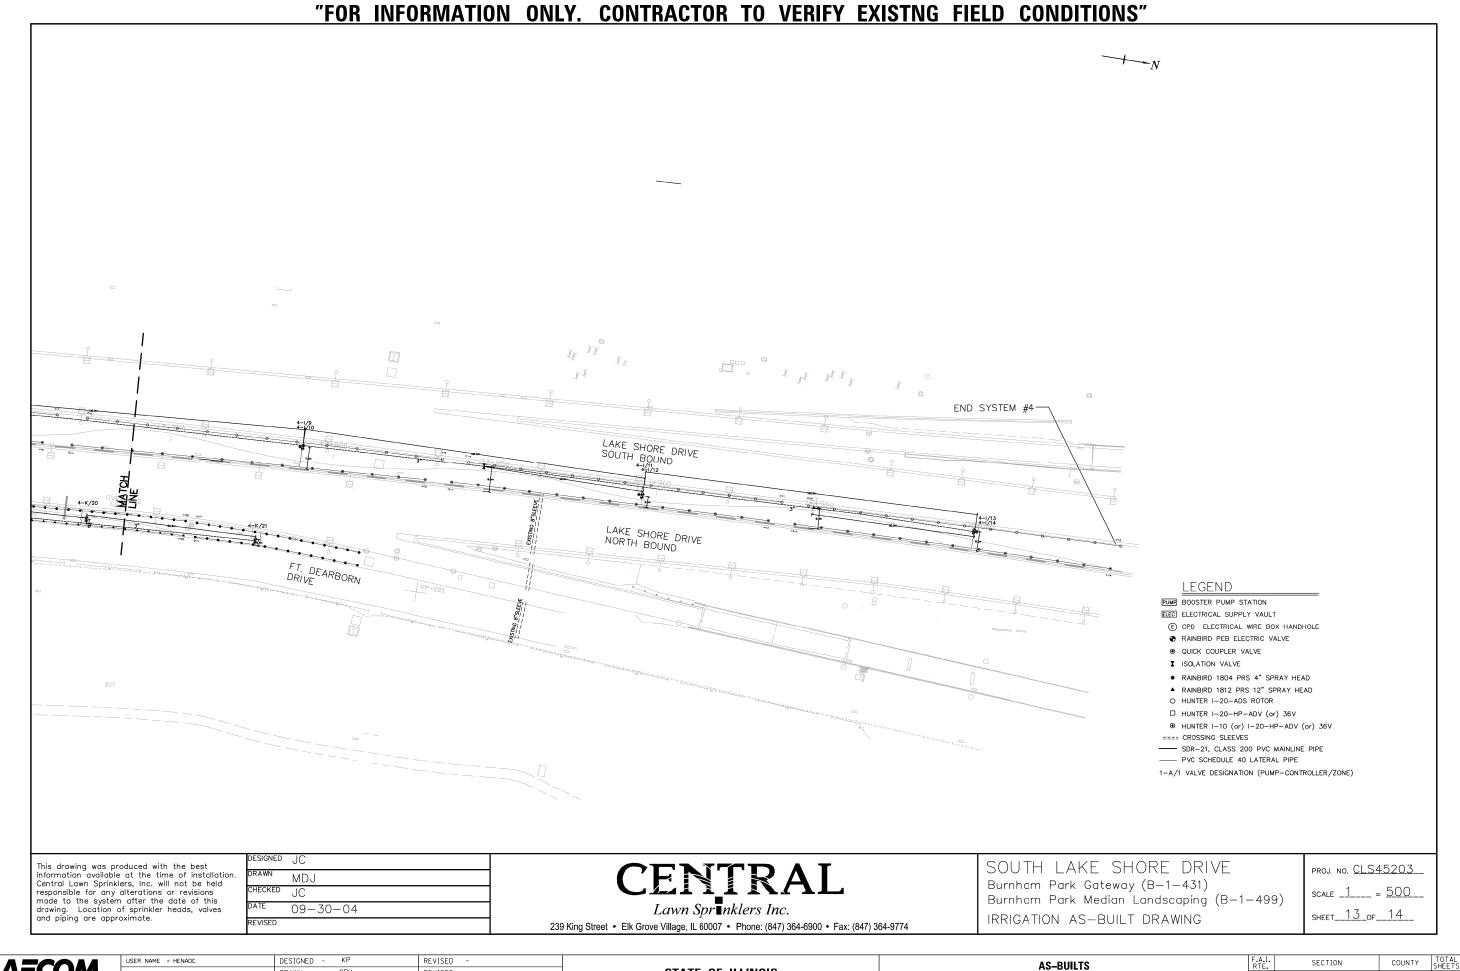

AECOM
303 EAST WACKER DRIVE. SUITE 1400
CHICAGO, IL 66001-5276
PHONE: (312) 373-7700 FAX; (312) 373-6800


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	DRAWN - CRH	REVISED -
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PLOT DATE = 10/13/2017	DATE - 10/20/2017	REVISED -


STATE OF ILLINOIS DEPARTMENT OF TRANSPORTATION


SCALE


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				55	2015-036LS	COOK	84	58
						CONTRACT	NO. 6	2A93
SHEET NO. 3 OF 4	SHEETS	STA.	TO STA.		TILL INDIS FED AT	D PROJECT		


"FOR INFORMATION ONLY. CONTRACTOR TO VERIFY EXISTING FIELD CONDITIONS"

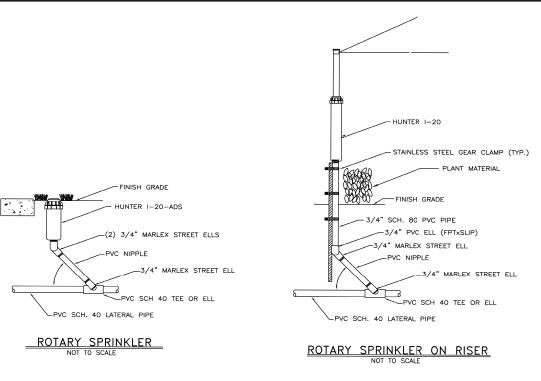


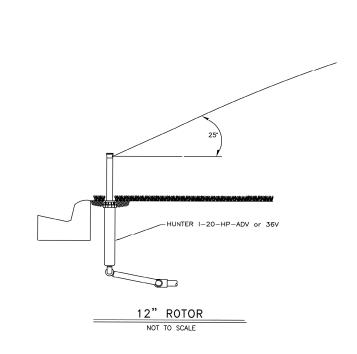

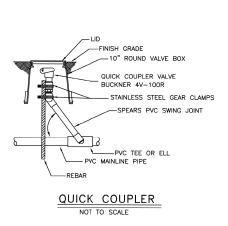

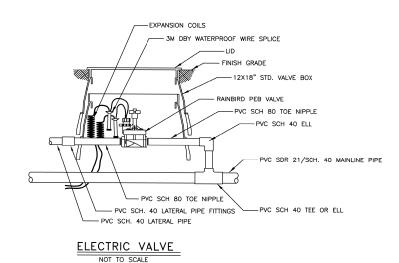

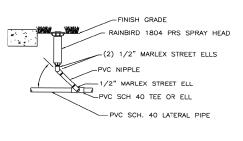

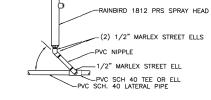

4" POP-UP SPRAY HEAD

SCALE

12" POP-UP SPRAY HEAD

This drawing was produced with the best information available at the time of installation. Central Lawn Sprinklers, Inc. will not be held responsible for any alterations or revisions made to the system after the date of this drawing. Location of sprinkler heads, valves and piping are approximate.

DESIGNED	JC
DRAWN	MDJ
CHECKED	JC
DATE	09-30-04
REVISED	-

CENTRAL

Lawn Spr ■nklers Inc.
239 King Street • Elk Grove Village, IL 60007 • Phone: (847) 364-6900 • Fax: (847) 364-9774

SOUTH LAKE SHORE DRIVE Burnham Park Gateway (B-1-431) Burnham Park Median Landscaping (B-1-499) IRRIGATION AS-BUILT DRAWING PROJ. NO. CLS45203

SCALE _1 = 500


SHEET_14 _ OF_14

$\Delta = (U)M$
303 EAST WACKER DRIVE, SUITE 1400
CHICAGO, IL 60601-5276
DUONE, (312) 373,7700 EAY, (312) 373,6900

	USER NAME = HENAOC	DESIGNED - KP	REVISED -
		DRAWN - CRH	REVISED -
	PLOT SCALE = 0:2.0000 ':' / in.	CHECKED - MJE	REVISED -
	PLOT DATE = 10/13/2017	DATE - 10/20/2017	REVISED -
-			

STATE OF ILLINOIS DEPARTMENT OF TRANSPORTATION

	AS-BUILT:	S		F.A.I. RTE.	SECTION	COUNTY	TOTAL SHEETS	SHEET NO.
				55	2015-036LS	соок	84	59
						CONTRACT	NO. 6	2A93
SHEET NO. 4 OF	4 SHEETS	STA.	TO STA.		ILLINOIS FED	. AID PROJECT		

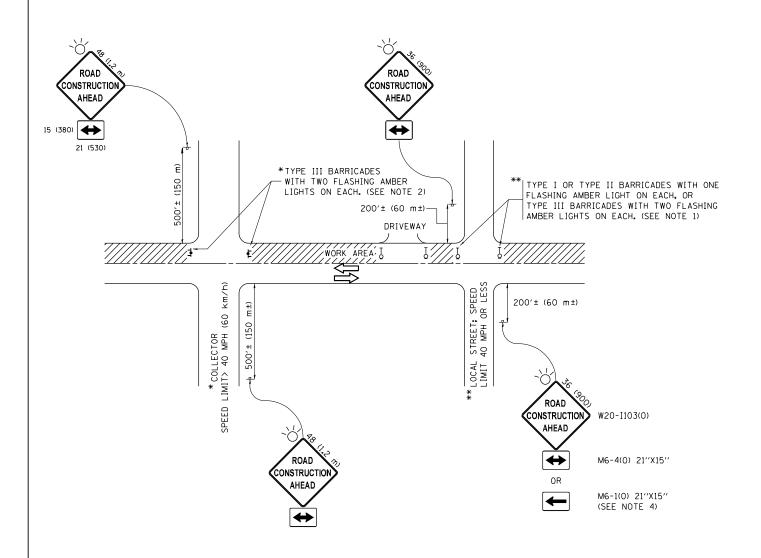

NOTES:

- SIDE ROAD WITH A SPEED LIMIT OF 40 MPH (60 km/h) OR LESS AS SHOWN ON THE DRAWING AND AS DIRECTED BY THE ENGINEER:
 - a) ONE "ROAD CONSTRUCTION AHEAD" SIGN 36 x 36 (900x900) WITH A FLASHER MOUNTED ON IT APPROXIMATELY 200" (60 m) IN ADVANCE OF THE MAIN ROUTE.
 - b) THE CLOSED PORTION OF THE MAIN ROUTE SHALL BE PROTECTED BY BLOCKING WITH TYPE I, TYPE II OR TYPE III BARRICADES, 1/3 OF THE CROSS SECTION OF THE CLOSED PORTION.
- 2. SIDE ROAD WITH A SPEED LIMIT GREATER THAN 40 MPH (60 km/h) AS SHOWN ON THE DRAWING AND AS DIRECTED BY THE ENGINEER:
 - d) ONE "ROAD CONSTRUCTION AHEAD" SIGN 48 x 48 (1.2 m x 1.2 m) WITH A FLASHER MOUNTED ON IT APPROXIMATELY 500' (150 m) IN ADVANCE OF THE MAIN ROUTE.
 - b) THE CLOSED PORTION OF THE MAIN ROUTE SHALL BE PROTECTED BY BLOCKING WITH TYPE III BARRICADES, 1/2 OF THE CROSS SECTION OF THE CLOSED PORTION.
- 3. CONES MAY BE SUBSTITUTED FOR BARRICADES OR DRUMS AT HALF THE SPACING DURING DAY OPERATIONS. CONES SHALL BE A MINIMUM OF 28 (710) IN HEIGHT
- 4. WHEN THE SIDE ROAD LIES BETWEEN THE BEGINNING OF THE MAINLINE SIGNING AND THE WORK ZONE, A SINGLE HEADED ARROW (M6-1) SHALL BE USED IN LIEU OF THE DOUBLE HEADED ARROW (M6-4).

SCALE: NONE


- 5. WHEN WORK IS BEING PERFORMED ON A SIDE ROAD OR DRIVEWAY, FOLLOW THE APPLICABLE STANDARD(S). THE DIRECTIONAL ARROW (M6-1 OR M6-4) SHALL BE COVERED OR REMOVED WHEN NO LONGER CONSISTENT WITH THE TRAFFIC CONTROL SET-UP.
- 6. ADVANCE WARNING SIGNS ARE TO BE OMITTED ON DRIVEWAYS UNLESS OTHERWISE SPECIFIED IN THE PLANS OR BY THE ENGINEER.
- 7. THE TRAFFIC CONTROL AND PROTECTION FOR SIDE ROADS, INTERSECTIONS, AND DRIVEWAYS SHALL BE INCLUDED IN THE COST OF SPECIFIED TRAFFIC CONTROL STANDARDS OR ITEMS.

All dimensions are in inches (millimeters) unless otherwise shown.

FILE NAME =	USER NAME = footemj	DESIGNED - L.H.A.	REVISED	- A. HOUSEH 10-15-96
pw:\\ILØ84EBIDINTEG.:Ill:no:s.gov:PWIDOT\Do	cuments\IDOT Offices\District 1\Projects\Dist	t @R2W8M \CADData\CADsheets\tc10.dgn	REVISED	-T. RAMMACHER 01-06-00
	PLOT SCALE = 50.000 '/ in.	CHECKED -	REVISED	- A. SCHUETZE 07-01-13
Default	PLOT DATE = 9/15/2016	DATE - 06-89	REVISED	 A. SCHUETZE 09-15-16


STATE OF ILLINOIS
DEPARTMENT OF TRANSPORTATION

	TRAFFIC CO	NTROL	F.A. RTE.	SECTION			
SI	NE ROADS II	NTFRSF	CTIONS	AND	DRIVEWAYS		
JI	DE HOADS, H	IVILIIOL	TC-10				
	CHEET 1	OF 1	CHEETS	C T A	TO STA		11. 11010 550

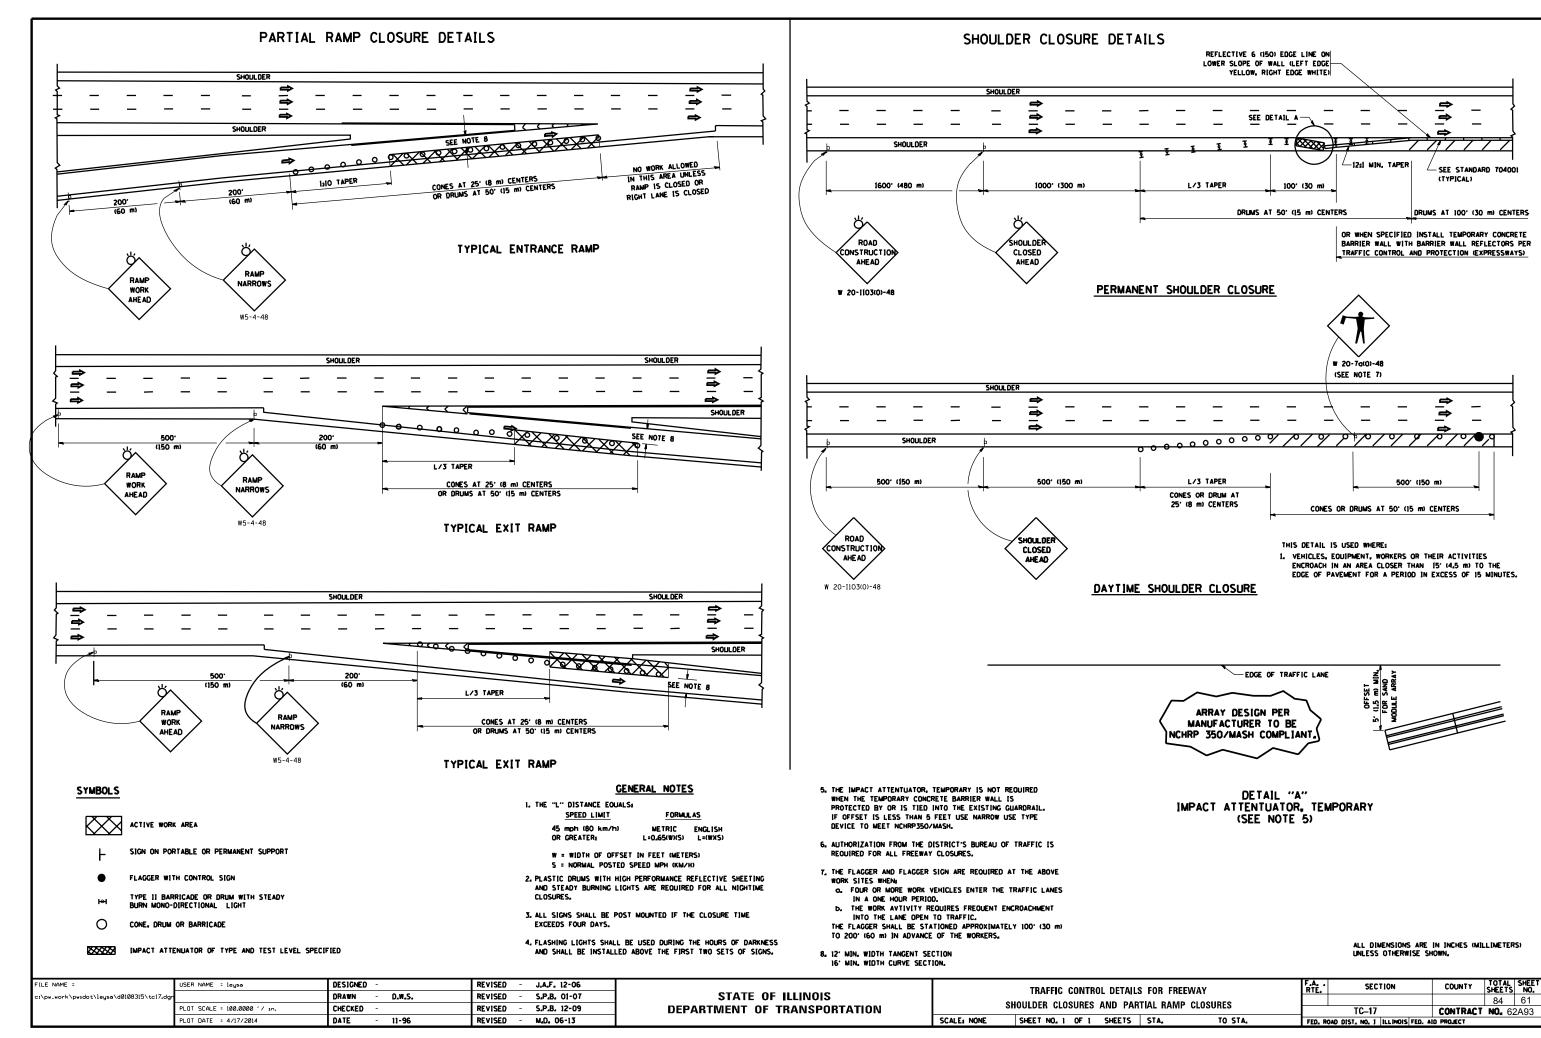


SIGNING FOR FLAGGING OPERATIONS AT WORK ZONE OPENINGS

WORK ZONE EXIT OPENING

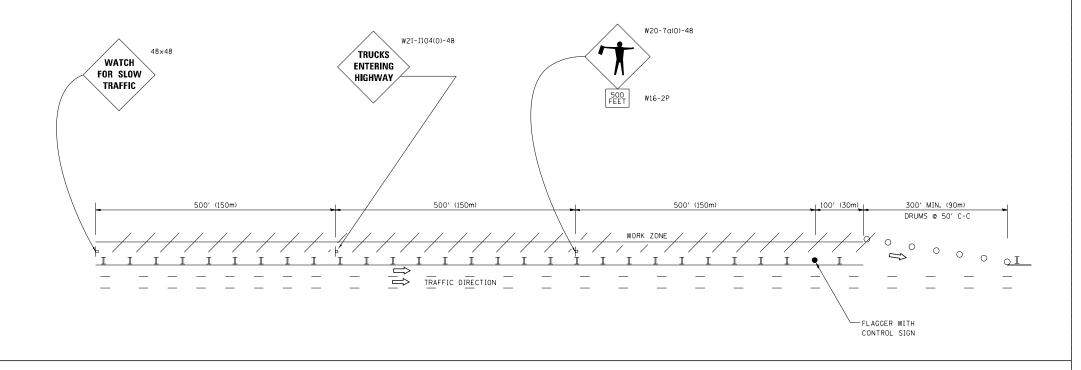


WORK ZONE ENTRY OPENING

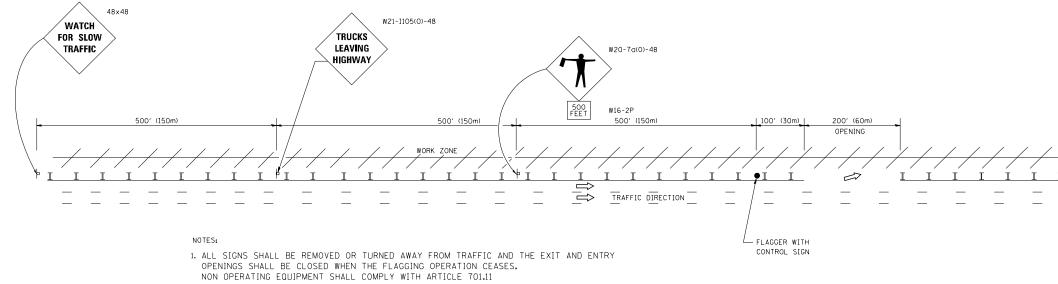

- 2. WORK ZONE OPENINGS SHALL BE A MINIMUM OF ONE HALF MILE APART AND A MINIMUM OF ONE QUARTER MILE FROM ALL ENTRANCE AND EXIT RAMPS.
- 3. EXITING THE WORK ZONE AT ANY PLACE OTHER THAN AT A WORK ZONE EXIT OPENING WILL BE PROHIBITED.
- 4. ALL VEHICLES SHALL ENTER THE WORK ZONE AT ENTRY OPENINGS, USING THEIR TURN SIGNALS TO WARN MOTORISTS
- 5. FLAGGERS SHALL NOT STOP TRAFFIC OR DIRECT TRAFFIC INTO AN ADJACENT LANE.

ALL DIMENSIONS ARE IN INCHES (MILLIMETERS)
UNLESS OTHERWISE SHOWN

FILE NAME =	USER NAME = footemj	DESIGNED -	REVISED - J.A.F. UZ-U6		EDEEW/AV	Y/EXPRESSWAY SIGNING FOR	ELACCING OPERATIONS	RTF	SECTION	COUNTY SHEETS NO
c:\pw_work\pwidot\footemj\dØ108315\tc18.d	lgn	DRAWN -	REVISED - S.P.B. 01-07	STATE OF ILLINOIS				1112		84 62
	PLOT SCALE = 50.000 ' / 10.	CHECKED -	REVISED - S.P.B. 12-09	DEPARTMENT OF TRANSPORTATION	AT WO	ORK ZONE OPENINGS ON FR	EEWAYS/EXPRESSWAYS		TC-18	CONTRACT NO. 62A93
	PLOT DATE = 7/8/2013	DATE -	REVISED - M.D. 06-13		SCALE: NONE SH	HEET NO. 1 OF 1 SHEETS	STA. TO STA.	FED. ROA	AD DIST. NO. 1 ILLINOIS FED. AI	D PROJECT

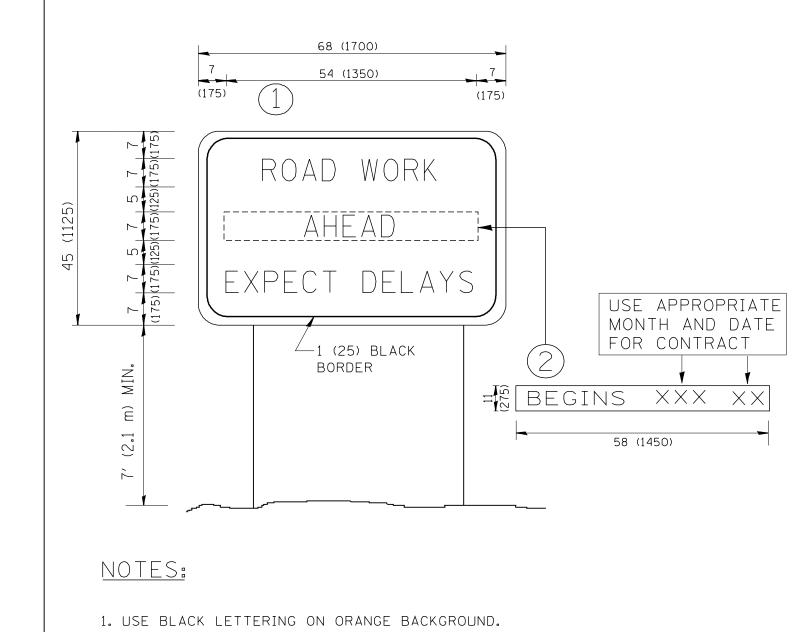

- 2. ERECT SIGNS IN ADVANCE OF THE LOCATION FOR THE "ROAD CONSTRUCTION AHEAD" SIGN AT LOCATIONS AS DIRECTED BY THE ENGINEER.
- 3. ERECT SIGN () WITH INSTALLED PANEL (2) ONE WEEK PRIOR TO THE START OF CONSTRUCTION.
- 4. REMOVE PANEL (2) SOON AFTER THE START OF CONSTRUCTION.
- 5. SEE SPECIAL PROVISION FOR "TEMPORARY INFORMATION SIGNING" FOR ADDITIONAL INFORMATION.
- 6. ONE SIGN ASSEMBLY EQUALS 25.70 SQ. FT. (2.3 SQ. M.)
- 7. SHALL BE PAID FOR AS TEMPORARY INFORMATION SIGNING.

ALL DIMENSIONS ARE IN INCHES (MILLIMETERS) UNLESS OTHERWISE SHOWN.


FILE NAME =	USER NAME = gaglianobt	DESIGNED -	REVISED - R. MIRS 09-15-97	
W:\diststd\22x34\tc22.dgn		DRAWN -	REVISED - R. MIRS 12-11-97	STATE OF ILLINOIS
	PLOT SCALE = 50.000 '/ IN.	CHECKED -	REVISED -T. RAMMACHER 02-02-99	DEPARTMENT OF TRANSPORTATION
	PLOT DATE = 1/4/2008	DATE -	REVISED - C. JUCTUS 01-31-07	


ARTERIAL ROAD	F.A RTE.	SECTION	COUNTY	TOTAL SHEETS	SHEET NO.	
INFORMATION SIGN				84	63	
INFORMATION SIGN		TC-22 CONTRAC			T NO. 62A93	
SCALE: NONE SHEET NO. 1 OF 1 SHEETS STA. TO STA.	Ī	FED. ROAD DIST. NO. 1 ILLINOIS FED. AID PROJECT				


CENTER LANE CLOSURE TYPE I CHECK BARRICADES > DRUMS AT 50' (15 m) CENTERS AT 100' (30 m) CENTERS ΝΙΜ ARROW BOARD DISPLAYING-DOUBLE ARROW PATTERN CENTER LANE CLOSE AHEAD, W9-3-48 * ₩9-3a-48 SIGNING & BARRICADING ACCORDING TO FREEWAY STANDARD FOR A ONE LANE CLOSURE INSTALLATION SEQUENCE 1. CLOSE LANES 1&2 ACTIVE NOTES WORK AREA 1. DRUMS WITH STEADY BURN LIGHTS SHALL BE USED AT 50' (15 m) CENTERS ON ALL TAPERS AND TANGENTS IN 2. ERECT INSIDE LANE 2 TAPER ADVANCE OF WORK AREA. 2. CLOSURE SHALL BE USED ONLY FOR OPERATIONS LASTING 72 HOURS OR LESS. 3. OPEN LANE 2 BY RELOCATING FIRST TAPER 3. CENTER LANE CLOSURE CONFIGURATION NON-ACTIVE IS NOT TO BE USED WITH WORKERS WORK AREA PRESENT. 4. REMOVE CLOSURE IN REVERSE ORDER

SHOULDER LANE

NOTE: CLOSURE SHALL BE USED ONLY FOR OPERATIONS LASTING 72 HOURS OR LESS.

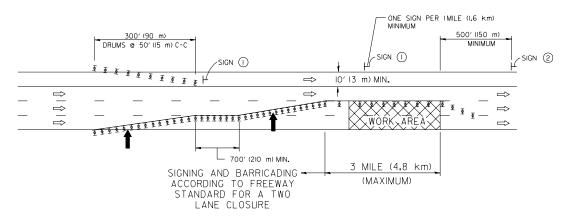

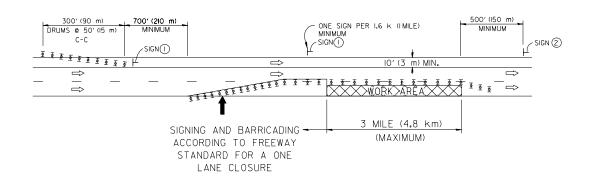

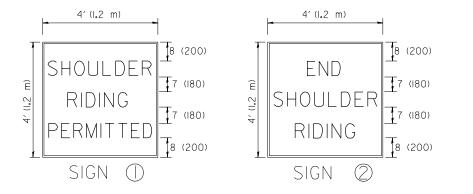

SYMBOLS

DIRECTION OF TRAFFIC

■ ARROWBOARD

ACTIV

ACTIVE WORK AREA

- ⊢ SIGN ON PORTABLE OR PERMANENT SUPPORT ★
- TYPE II BARRICADE, OR DRUM WITH MONO-DIRECTIONAL STEADY BURN LIGHT

ALL DIMENSIONS ARE IN INCHES (MILLIMETERS)
UNLESS OTHERWISE SHOWN

* ALL SIGNS SHALL BE MOUNTED AT A MINIMUM HEIGHT OF 5'(1.5 m).

6 (150) SERIES "C" LEGEND BLACK LEGEND

1(25) BORDER

WHITE REFLECT. BACKGROUND

FILE NAME = USER NAME = leyso DESIGNED - REVISED - J.A.F. 04-03
Wikdostatd\22x34\te25.dgn
PLOT SCALE = 50.000 '/ IN. CHECKED - REVISED - S.P.B. 12-09
PLOT DATE = 1/26/2010 DATE - REVISED -

STATE OF ILLINOIS
DEPARTMENT OF TRANSPORTATION

	TRAFFIC CONTROL DETAILS	F.A RTE.	SECTION	COUNTY	TOTAL SHEETS	SHEET NO.		
	CENTER LANE CLOSURE S				84	64		
	CENTER DAIL GEOSCIE (TC-25	CONTRACT NO. 62A93		2A93		
SCALE: NONE	SHEET NO. 1 OF 1 SHEETS	STA.	TO STA.	FED. R	FED. ROAD DIST. NO. 1 ILLINOIS FED. AID PROJECT			

AECOM	STRU	CTURE SO	OIL BORING LOG	Page 1 of 2
AECOM PROJ NO. <u>60225454</u>	-			Date <u>2/27/13</u>
ROUTE FAI 55 DESCI	RIPTION _	<u>-94 (DAN RYA</u>	N EXPRESSWAY) TO US 41 (LAKE	SHORE DRIVE)
SECT. <u>2013-049B</u>	STRUCT.	NO. <u>016-076</u>	6 DRILLED BY	STRATA - KOMEN
COUNTY COOK LOCA	ATION <u>CI</u>	HICAGO, ILLIN	NOIS_	
Boring No. MSE-01 Station 181+60.35 Offset 58.98ft RT	D B L P O T W	Qu W	Surface Water Elev. None Groundwater Elev.: when drilling 585.6 at Completion	E L P O Qu W
Surface Elev. 596.11 ft	H S	tsf %	after Hrs	H S tsf %
FILL: Black, dry, medium dense TOPSOIL, BRICK, CONCRETE and CINDERS	5 6	27.5	Gray, saturated, medium dense to loose, fine SAND to SANDY LOAM	5 23.8 5 7
	23 11 8	14.3		ST 23.2
Brown, dry to wet, medium dense to loose, fine SAND	-5 -5 - 5 - 5	3.4		
	5 4 4	8.8	Very dark gray to dark gray, medium to stiff CLAY - slightly organic	1
585.11 Brown, saturated, medium	-10 -3 4 2	23.8		ST 0.97* 42.4
dense, fine SAND	9 13 11	29.6		=
579.11	-15 -4 -6 -8	22.6		ST 1.0P 61.4
Gray, saturated, medium dense to loose, fine SAND to SANDY LOAM	7 8 9	24.4	Dark gray, stiff SILTY CLAY LOAM - trace shells	1 =
	-20 -7 - 8 - 8	25.9		ST 1.0P 59.7
	5 23.2 - 5 4			
	-25		546.1	1 -50
SPT. (N) = Sum of last two blow value Stations, Depths, Offset, and Elevation	es in sample			wi

STRUCTURE SOIL BORING LOG

Page 2 of 2
Date _____2/27/13

AECOM

SPT. (N) = Sum of last two blow values in sample. (Qu) B=Bulge S=Shear P=Penetration Test Stations, Depths, Offset, and Elevations are in Feet

SCALE

A=COM
303 EAST WACES DRIVE, SUITE 1400
600 PHONE; (3)(2) 373-760 FAX; (3)(2) 373-600

USER NAME = HENAOC	DESIGNED - <u>KP</u>	REVISED
	DRAWN - <u>CRH</u>	REVISED
PLOT SCALE = 0:2 ':" / in.	CHECKED - MJE	REVISED
PLOT DATE = 10/16/2017	DATE - 10 <u>/20/2017</u>	REVISED

STATE OF ILLINOIS
DEDARTMENT OF TRANSPORTATION
DEPARTMENT OF TRANSPORTATION

	BORING LOGS						F.A.I. SECTION		COUNTY	TOTAL SHEETS	SHEET NO.
							,	2015-036LS	соок	84	65
									CONTRAC	T NO. 6	2A93
	SHEET NO	OF	SHEETS	STA.	TO STA.			ILLINOIS FED. A	ID PROJECT		

AECOM

STRUCTURE SOIL BORING LOG

Page 1 of 2 Date ____2/26/13__

AECOM PROJ NO. 60225454 ROUTE FAI 55 DESCRIPTION 1-94 (DAN RYAN EXPRESSWAY) TO US 41 (LAKE SHORE DRIVE) DRILLED BY STRATA - KOMEN SECT. <u>2013-049B</u> STRUCT. NO. <u>016-0766</u>

COUNTY COOK LOCA	TION	<u>CH</u>	ICAGO), ILLIN	OIS				
Boring No. MSE-03 Station 183+88.23 Offset 59.53ft RT Surface Elev. 591.71 ft	D E P T H	B L O W S	Qu tsf	W %	Surface Water Elev. None Groundwater Elev.: when drilling 584.2 at Completion after Hrs.	D E P T H	B L O W S	Qu tsf	w %
TOPSOIL \int 591.54 Brown, dry to wet, medium dense, fine SAND		6 6 6		25.9	Gray, saturated, medium dense to loose, fine SAND to SANDY LOAM	_	ST		21.2
	\exists	4 5 5		8.1	Gray, medium SILTY CLAY LOAM		3 2 4	0.7B	30.6
		3 2 5		23.2	Very dark gray to black, soft CLAY - slightly organic		ST	1.0P	61.9
Brown, wet to saturated, loose to medium dense, fine SAND		7 11 11		29.5					
Grav saturated medium 580.21	10 	5 7 9		26.8	Gray to dark gray, medium to soft SILTY CLAY LOAM - trace shells	35	WOH WOH WOH	0.7B	53.9
Gray, saturated, medium dense to loose, fine SAND to SANDY LOAM		6 9 8		46.6					
	-15	6 8 9		25.9		-40 	ST	1.08*	51.2
		5 6 5		30.7					
	20 	5 6 10		27.4	Gray, very stiff SILTY CLAY 546.71	45 	5 9 14	3.1B	17.5
		6 5 4		26.5					
					542.21	-50			

SPT. (N) = Sum of last two blow values in sample. (Qu) B=Bulge S=Shear P=Penetration Test Stations, Depths, Offset, and Elevations are in Feet

A=COM

STRUCTURE SOIL BORING LOG

Page 2 of 2 Date ___2/26/13__

AECOM PROJ NO. 60225454

STRUCTURE NO. 016-0766

ROUTE FAI 55

SECTION 2013-049B

COUNTY COOK

 Boring No.
 MSE-03

 Station
 183+88.23

 Offset
 59.53ft RT
 Qu tsf Elevation 541.71 ft Possible weathered BEDROCK, COBBLES or large GRAVEL

End of Boring
Diedrich D-50 drill rig used
for drilling
Automatic Diedrich
hammer used for SPT
Casing used: 37 ft of 4 in
diameter
Driller converted to rotary
wash drilling at 10 ft depth
Borehole grouted upon
completion

SPT. (N) = Sum of last two blow values in sample. (Qu) B=Bulge S=Shear P=Penetration Test Stations, Depths, Offset, and Elevations are in Feet

SCALE

USER NAME = HENAOC	DESIGNED - <u>KP</u>	REVISED
	DRAWN - <u>CRH</u>	REVISED
PLOT SCALE = 0:2 ':" / in.	CHECKED - MJE	REVISED
PLOT DATE = 10/16/2017	DATE - 10 <u>/20/2017</u>	REVISED

BORING LOGS						SECTION	COUNTY	TOTAL SHEETS	SHEET NO.
					55	2015-036LS	соок	84	66
							CONTRAC	T NO. 6	2A93
SHEET NO	0F	SHEETS	STA.	TO STA.		ILLINOIS FED.	AID PROJECT		

AECOM	STRUCTURE SOIL BORING LOG	Page 1 of 2
AECOM PROJ NO. 60225454		Date4/17/13
ROUTE FAI 55 DESC	RIPTION <u>I-94 (DAN RYAN EXPRESSWAY) TO US 41 (LAK</u>	E SHORE DRIVE)
SECT. 2013-049B	STRUCT. NO. 016-0773 DRILLED BY	STRATA - BAKER
COUNTY COOK LOC	TION CHICAGO, ILLINOIS	
Boring No. MSE-05 Station 504+70.59 Offset 7.93ft LT	D B S Groundwater Elev. None Groundwater Elev.: When drilling at Completion	E
Surface Elev. 591.35 ft	H S tsf % after Hrs	_ H S tsf %
FILL: Black, brown and gray, moist to wet, loose SAND, GRAVEL, BRICK and CINDERS	1	85 <u>7 21.0</u> 9 5.1S 18.7 12
	2 20.8 - 3 3	6 3.6S 15.8 12 14
	ST 0.54* 31.3 ST 39.2	
		12
	2 39.0 - 1 - 1	
Wood noted at 10.0'	ST24.0	
FILL: Black, saturated, medium dense to very loose SAND, GRAVEL and CINDERS	5 26.3 8 4	
		-40 -40 3.0B 21.0 -7 -10
	1 20.9 Gray, medium SILTY CLAY 548.	35
FILL: Brown, gray and black, saturated, loose to medium dense SAND,		-45
SILT and CINDERS	2 117.8 6 25.9 7	
SPT. (N) = Sum of last two blow values Stations, Depths, Offset, and Elevati	 es in sample. (Qu) B=Bulge S=Shear P=Penetration Test ns are in Feet	-50

AECOM STRUCTURE SOIL BORING LOG AECOM PROJ NO. 60225454
 Boring No.
 MSE-05

 Station
 504+70.59

 Offset
 7.93ft LT
 Qu tsf Elevation 541.35 ft Gray, medium SILTY CLAY .8B 24.6 WOH .9B 25.4 WOH .5B 20.8 Gray, saturated, extremely dense SILT - large gravel and rock fragments noted End of Boring Mobile B-61 drill rig used for drilling Automatic Mobile hammer used for SPT Casing used: 25 ft of 4 in diameter Driller converted to rotary wash drilling at 20 ft depth Borehole grouted upon completion 527.85

SPT. (N) = Sum of last two blow values in sample. (Qu) B=Bulge S=Shear P=Penetration Test Stations, Depths, Offset, and Elevations are in Feet

SCALE

AECOM
303 FAST WACKER DRIVE, SUITE 1400

USER NAME = HENAOC	DESIGNED - <u>KP</u>	REVISED
	DRAWN - <u>CRH</u>	REVISED
PLOT SCALE = 0:2 ':" / in.	CHECKED - MJE	REVISED
PLOT DATE = 10/16/2017	DATE - 10 <u>/20/2017</u>	REVISED

STATE	OF ILLINOIS
DEPARTMENT C	F TRANSPORTATION

BORING LO	GS		F.A.I. RTE.	SECTION	COUNTY	TOTAL SHEETS	SHEET NO.	
			55	2015-036LS	соок	_84	67	
					CONTRAC	T NO. 6	2A93	
SHEET NO OF SHEETS	STA.	TO STA.	_	ILLINOIS FED. AID PROJECT				

Page 2 of 2
Date <u>4/17/13</u>

-E NAME = A93_BDB_MSE Ø5.don

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A=COM	STRU	CTURE	SC	OIL BORING LOG			-	1 of 2
AECOM PROJ NO. <u>60225454</u>						Date	4/	1/13
ROUTE FAI 55 DESCR	IPTION <u>I</u> -	94 (DAN	RYAN	N EXPRESSWAY) TO US 41 (LAKE S	SHOR	E DRIV	E)	
SECT. 2013-049B	STRUCT. N	IO. <u>016</u> -	-0773	DRILLED BY	STRA	ATA - UI	LRICH	1
COUNTY COOK LOCA	TION <u>C</u>	ICAGO,	ILLIN	<u>OIS</u>				
Boring No. MSE-08 Station 507+10.42 Offset 7.19ft LT	D B L P O T W		w	Surface Water Elev. Groundwater Elev.: when drilling 585.2 at Completion	- Н Ф Ш Ф	B L O W	Qu	w
Surface Elev. 594.15 ft	H S	tsf	%	after Hrs	Н	S 6	tsf	% 16.9
FILL: Black, brown and gray, moist, medium dense to loose SAND, GRAVEL and SILT	4 6		11.2	FILL: Gray, brown and black, saturated, medium dense to extremely dense SAND, GRAVEL, BRICK and FRACTURED STONE	_	14 _50/3"		16.9
	2 5 6	1	18.2	FRAGMENTS	_	65/4"		10.8
	-5 -5 - 2 - 3 - 2	0.5P 1	16.2		30	10 14 12		12.7
585.15		1	18.1	Gray and dark gray, saturated, very loose SILTY LOAM				
FILL: Gray and dark gray, medium to soft CLAY	-10 WOH WOH WOH	2	21.0		35	1 1 2	0.5P	45.4
	WOR WOR 1	0.5B 3	38.9	556.65 Dark gray, stiff CLAY - slightly organic				
577.15	-15 WOR WOR WOR	0.4B 2	27.8		40	ST	1.37*	58.7
FILL: Gray, brown and black, saturated, medium dense to extremely dense SAND, GRAVEL, BRICK and FRACTURED STONE	1 16 50/3"	2	43.5	551.15 Gray, medium SILTY CLAY				
FRAGMENTS Boulders or obstructions from 17.5'-29.0'	-20 20 	3	30.9		45	ST	0.5P	52.5
100% water loss at 22.5'	24 50/3"			Very dark gray, wet, stiff SILTY CLAY LOAM to SILTY LOAM - slightly organic, trace shells	-50			
SPT. (N) = Sum of last two blow value Stations, Depths, Offset, and Elevation	es in sample ns are in Fee	. (Qu) B=	=Bulg		-50			

AECOM STRUCTURE SOIL BORING LOG AECOM PROJ NO. 60225454 STRUCTURE NO. 016-0773

ROUTE FAI 55

SECTION 2013-049B

COUNTY COOK
 Boring No.
 MSE-08

 Station
 507+10.42

 Offset
 7.19ft LT
 L O W Qu S tsf Elevation 544.15 ft Very dark gray, wet, stiff SILTY CLAY LOAM to SILTY LOAM - slightly organic, trace shells ST 2.5P 47.0 Gray, wet, loose LOAM Brown and gray, very stiff to hard SILTY CLAY 9 2.6B 21.6 8 4.6B 22.4 11 13 End of Boring
Mobile B-57 drill rig used
for drilling
Automatic Mobile hammer
used for SPT
Casing used: 35 ft of 4 in
diameter
Driller converted to rotary
wash drilling at 12.5 ft
depth
Borehole grouted upon
completion 532.65

Page 2 of 2
Date ____4/1/13

SPT. (N) = Sum of last two blow values in sample. (Qu) B=Bulge S=Shear P=Penetration Test Stations, Depths, Offset, and Elevations are in Feet

AECOM

301 EAST MACKER DRIVE. SUITE 1400
PHONE (3)2 373-7700 FAM (3)2 373-8800

USER NAME = HENAOC	DESIGNED - <u>KP</u>	REVISED
	DRAWN - <u>CRH</u>	REVISED
PLOT SCALE = 0:2 ':' / in.	CHECKED - MJE	REVISED
PLOT DATE = 10/16/2017	DATE - 10 <u>/20/2017</u>	REVISED

STATE OF ILLINOIS
DEPARTMENT OF TRANSPORTATION

SCALE

BORING LOGS	F.A.I. RTE.	SECTION	COUNTY	TOTAL SHEETS	SHEET NO.	
	55	2015-036LS	COOK	<u>84</u>	_68_	
			CONTRACT	NO. 6	2A93	
SHEET NO OF SHEETS STA TO STA	ILLINOIS FED. AID PROJECT					

ILE NAME =

A=COM

STRUCTURE SOIL BORING LOG

Page 1 of 2

Date <u>4/19/13</u> AECOM PROJ NO. 60225454 ROUTE FAI 55 DESCRIPTION 1-94 (DAN RYAN EXPRESSWAY) TO US 41 (LAKE SHORE DRIVE) STRUCT. NO. 016-0746 & 016-0749 DRILLED BY STRATA - ULLRICH COUNTY COOK LOCATION CHICAGO, ILLINOIS Surface Water Elev. Groundwater Elev.:
when drilling
at Completion
after _____ Hrs. L O W S L O W S 581.6 Qu tsf Qu tsf Surface Elev. 592.56 ft FILL: Gray, soft CLAY, SAND and SILT FILL: Black, brown and WOH 0.3B 25.2 gray, moist to wet, medium dense to very loose BRICK, SAND, GRAVEL and CINDERS _566.06 Gray, saturated, loose LOAM to SILTY LOAM 65.2 Unable to advance Shelby tube, pounded split spoon 27.6 9.7 Shelby tube attempted, no recovery; pushed split spoon 28.7 Dark gray, stiff SILTY CLAY LOAM - trace organics 1.0B 48.0 FILL: Black, brown and gray, saturated, very loose to medium dense SAND, SILT, GRAVEL and BRICK 555.06 75.2 65.9 Brown and gray, medium SILTY CLAY FILL: Gray, soft CLAY, SAND and SILT ST 0.93* 43.3

544.06

Dark gray, wet CLAY LOAM - trace shells

SPT. (N) = Sum of last two blow values in sample. (Qu) B=Bulge S=Shear P=Penetration Test Stations, Depths, Offset, and Elevations are in Feet

A=COM

STRUCTURE SOIL BORING LOG

Page 2 of 2 Date 4/19/13

AECOM PROJ NO. 60225454

STRUCTURE NO. 016-0746 & 016-0749

ROUTE FAI 55 STRUCTURE NO. <u>016-0746 & 016-0749</u> ROUTE <u>FAI 55</u>

COUNTY <u>COOK</u>						COUNTY <u>COOK</u>				
Boring No. MSE-09 Station 413+67.04 Offset 31.23ft LT Elevation 542.56 ft		D E P T H	B L O W S	Qu tsf	W %	Elevation <u>517.56</u> ft	D E P T H	в∟о⊗∽	Qu tsf	W %
Dark gray, wet CLAY LOAM - trace shells	500 50		ST	1.0P	26.1	Automatic Mobile hammer used for SPT Casing used: 25 ft of 4 in diameter Driller converted to rotary wash drilling at 17.5 ft	_			•
Brown and gray, very stiff SILTY CLAY	_539.56	-55	ST	3.0P	22.2	depth Borehole grouted upon completion				
	534.56	_								
Gray, stiff SILTY CLAY		-60	3 5	1.1B	24.0					
			5 6							
Gray, wet, medium dense	_527.56	-65	5		12.4					
CLAY LOAM			9 16		12.4					
							-95			
Apparent weathered	_520.56									
Apparent weathered BEDROCK Apparent solid BEDROCK End of Boring Mobile B-57 drill rig used for drilling	_519.56 _519.06	-75								

SPT. (N) = Sum of last two blow values in sample. (Qu) B=Bulge S=Shear P=Penetration Test Stations, Depths, Offset, and Elevations are in Feet

SHEET NO. ___

SCALE

USER NAME = HENAOC	DESIGNED - <u>KP</u>	REVISED
	DRAWN - <u>CRH</u>	REVISED
PLOT SCALE = 0:2 ':' / in.	CHECKED - MJE	REVISED
PLOT DATE = 10/16/2017	DATE - 10 <u>/20/2017</u>	REVISED

STATE OF ILLINOIS
DEPARTMENT OF TRANSPORTATION

BORING LOGS			F.A.I. RTE.	SECTION	COUNTY	TOTAL SHEETS	SHEET NO.	
				55	2015-036LS	соок	84	69
						CONTRACT	NO. 6	2A93
OF _	SHEETS	STA	TO STA.		ILLINOIS FED. A	ID PROJECT		

AECOM	S	TRUC	CTUR	RE SC	DIL BORING LOG				Page	
AECOM PROJ NO. <u>60225454</u>	_							Date	4/2	2/13
ROUTE FAI 55 DESCR	RIPTIC	ON <u>I-9</u>	94 (DAI	N RYA	N EXPRESSWAY) TO US 41 (LA	KE S	HOR	E DRIV	E)	
SECT. <u>2013-049B</u>	STR	UCT. N	O. <u>01</u>	16-077	DRILLED BY	<u> </u>	STRA	<u> ATA - M</u>	CART	HY
COUNTY COOK LOCA	AOITA	L CH	ICAGO), ILLIN	<u>OIS</u>					
Boring No. MSE-13 Station 207+43.28 Offset 41.15ft LT Surface Elev. 593.83 ft	DEPTH	B L O W S	Qu tsf	W %	Surface Water Elev. None Groundwater Elev.: when drilling at Completion after Hrs.	2	DEPFH	B L O W S	Qu tsf	W %
TOPSOIL 593.33		2		9.0	FILL: Gray, soft CLAY -			6	0.4B	26.0
FILL: Black, brown and gray, moist to wet, medium	=	8 10			trace cinders and brick		_	2 2		
dense to loose GRAVEL, SAND, BRICK, CINDERS					Gray, soft SILTY CLAY	.83	_			
and CLAY		6 7		14.6	·		$\overline{}$	WOH 1		24.2
	_	6			564	.33	_	1		
	5	2		15.0	Brown and gray, hard SILTY CLAY		-30	ST	4.5+P	16.7
	_	2					_	0.		
	_				561	22	_			
	_	1 2		9.6	Gray, very stiff to stiff SILTY	.55	_			
		2			CLAT					
	 10						-35			
		3 4 3		4.4			_	4 6	2.2B	21.0
		3					_	8		
	_	2		48.2			_			
	-	3					=			
FILL: Black and gray,	-15						-40			
saturated, very loose to loose SAND, CLAY and		WOH WOH		29.1			_	ST	1.91*	18.0
SILT	_	1					=			
	_	ST	0.28*	26.2			_			
	=	01	0.20	20.2			_			
							=			
	20	3 2		24.6		-	-45 —	ST	1.0P	22.0
		1								
	_				546	.33	_			
	\exists	2		44.5	Gray, soft to medium SILTY CLAY		_			
569.33	\exists	1					_			
SPT. (N) = Sum of last two blow valu	<u>-25</u>		(0)	D-D. 1	C-Chan D-Danatation Tool	-	-50			

A=COM STRUCTURE SOIL BORING LOG Page 2 of 2 Date 4/22/13 AECOM PROJ NO. 60225454 STRUCTURE NO. 016-0778

ROUTE FAL55

SECTION 2013-049B

COUNTY COOK Boring No. MSE-13
Station 207+43.28
Offset 41.15ft LT L O W S L O W S Qu tsf Qu W tsf % Elevation 543.83 ft H S tsf % BEDROCK

2 3 CME-75 drill rig used for drilling Automatic CME hammer used for SPT Casing used: 30 ft of 4 in diameter Driller converted to rotary wash drilling at 12.5 ft depth Borehole grouted upon completion Gray, soft to medium SILTY CLAY 0.3B 23.9 Gray, hard SILTY CLAY 4.4S 17.3 ___519.33 ___ _518.83 __-75

SPT. (N) = Sum of last two blow values in sample. (Qu) B=Bulge S=Shear P=Penetration Test Stations, Depths, Offset, and Elevations are in Feet

SCALE

USER NAME = HENAOC	DESIGNED - <u>KP</u>	REVISED
	DRAWN - <u>CRH</u>	REVISED
PLOT SCALE = 0:2 ':' / in.	CHECKED - MJE	REVISED
PLOT DATE = 10/16/2017	DATE - 10 <u>/20/2017</u>	REVISED

STATE OF ILLINOIS **DEPARTMENT OF TRANSPORTATION**

Apparent weathered

BORING LOGS					F.A.I. RTE.	SECTION	COUNTY	TOTAL SHEETS	SHEET NO.
					55	2015-036LS	COOK	84	_70_
							CONTRAC	T NO. 6	2A93
SHEET NO	OF	SHEETS	STA	TO STA.	ILLINOIS FED. AID PROJECT				

AECOM

STRUCTURE SOIL BORING LOG

Page 1 of 2

Date <u>4/16/13</u> AECOM PROJ NO. 60225454 ROUTE FAI 55 DESCRIPTION 1-94 (DAN RYAN EXPRESSWAY) TO US 41 (LAKE SHORE DRIVE) _____ STRUCT. NO. 016-0746 & 016-0749 DRILLED BY STRATA - BAKER COUNTY COOK LOCATION CHICAGO, ILLINOIS Surface Water Elev.
Groundwater Elev.:
when drilling at Completion after Hrs. L O W S L O W S Qu tsf Qu tsf Surface Elev. <u>592.84</u> ft WOH <0.25P 31.7 FILL: Black, brown and FILL: Gray, soft CLAY Brown and gray, saturated, medium dense SAND
Dark gray, saturated, loose
SANDY CLAY LOAM to
SANDY LOAM gray, moist to wet, loose to medium dense SAND, GRAVEL, CINDERS and CLAY <0.25P 39.6 wон ST 0.79* 23.7 12.1 Brown and gray, stiff SILTY 560.34 CLAY 1.6S 22.1 49.1 Gray, stiff to medium SILTY FILL: Black, saturated, very loose SAND, GRAVEL, CINDERS and SHELLS 1.0B 20.8 WOH WOH FILL: Gray, soft CLAY WOH WOH WOH WOH WOH 1.0P 20.0

SPT. (N) = Sum of last two blow values in sample. (Qu) B=Bulge S=Shear P=Penetration Test Stations, Depths, Offset, and Elevations are in Feet

ST 0.23* 29.4

AECOM

STRUCTURE SOIL BORING LOG

Page 2 of 2 Date <u>4/16/13</u>

AECOM PROJ NO. 60225454

 STRUCTURE NO.
 016-0746 & 016-0749
 STRUCTURE NO.
 016-0746 & 016-0749

 ROUTE FAI 55
 ROUTE FAI 55
 ROUTE FAI 55

 SECTION 2010-080-B
 SECTION 2010-080-B

 COUNTY COOK
 COUNTY COOK

SECTION 2010-080-B COUNTY COOK				_	SECTION 2010-080-B COUNTY COOK
Boring No. MSE-15 Station 415+29.64 Offset 31.15ft LT Elevation 542.84 ft	DEPTH	B L O W S	Qu tsf	W %	D B E L P O T W Qu W H S tsf %
Gray, stiff to medium SILTY CLAY	-555	5		25.7	Apparent weathered BEDROCK
Gray, stiff SILTY CLAY 525.34	-65 	WOH 4 5	0.8B	21.2	
_518.34		4 6 14	1.8B	17.9	

SPT. (N) = Sum of last two blow values in sample. (Qu) B=Bulge S=Shear P=Penetration Test Stations, Depths, Offset, and Elevations are in Feet

SCALE

AECOM

303 EAST WACEEN DRIVE. SUITE 1400

FROMES 132 373-7700 FAX (3)2 373-6800

USER NAME = HENAOC	DESIGNED - <u>KP</u>	REVISED
	DRAWN - <u>CRH</u>	REVISED
PLOT SCALE = 0:2 ':' / in.	CHECKED - MJE	REVISED
PLOT DATE = 10/16/2017	DATE - 10 <u>/20/2017</u>	REVISED

BORING LOGS					F.A.I. RTE.	SECTION	COUNTY	TOTAL SHEETS	SHEET NO.
					55	2015-036LS	соок	84	_71_
							CONTRACT	NO. 6	2A93
SHEET NO	OF	SHEETS	STA.	TO STA.		ILLINOIS FED. AI	D PROJECT		

A=COM	STRI	JCTUR	E SC	OIL BORING LOG				1 of 3
AECOM PROJ NO. 60225454						Date	2/2	8/13
ROUTE FALSS DESCR	IPTION .	I-94 (DA	N RYA	N EXPRESSWAY) TO US 41 (LAK	E SHO	RE DRIV	E)	
SECT. 2013-049B	STRUCT.	NO. <u>01</u>	6-150	DRILLED BY	STR	RATA - KO	OMEN	
COUNTY COOK LOCA	L NOIT	CHICAGO), ILLIN	IOIS				
Soring No. STR-10	D B L P O T W H S	Qu tsf	W %	Surface Water Elev. Groundwater Elev.: when drilling at Completion Not Meas	_ E _ P _ T	B L O W S	Qu tsf	W %
FILL: Gray and black,	п S		12.7	after Hrs. Not Meas Gray, saturated, medium	- "	10	ısı	21.4
frozen, medium dense, GRAVEL, SAND and CLAY 595.55	6 10		12.1	dense, fine SAND to	_	10		21.4
FILL: Black, moist, medium dense to loose,					_	+		
SAND and CINDERS	12		21.4		_	11		21.9
	10			567	_ 	- 8 7		
	-5 4		13.3	Gray, saturated, loose		0 4		34.7
	$\frac{3}{3}$		13.3	SILTI LOAW	_	4 5		34.7
Brown, moist to wet,				564		+ -		
medium dense, fine SAND	6 7		6.7	Gray, soft to medium CLAY, trace organics	55 <u> </u>	1		
	11			CLAT, trace organics	_			
	-10		4.8		3	5 WOH	.4B	28.9
	9 7 8		4.0		_	WOH	.40	20.9
					_			
	8		23.1		_			
	9 9				_	_		
582.05	-15				4			
Brown, saturated, medium dense, fine SAND	8 8		30.3		_	1 2 2	.6B	38.4
					_			
Gray, saturated, medium	10		21.1		_	1		
dense, fine SAND to SANDY LOAM	10 16			553	05 _	_		
	-20			Dark gray, medium to stiff SILTY CLAY LOAM to	4	5		
			26.3	SILTY LOAM, trace shells, wood and organics	_	WOH 2 3	.6B	52.6
	8				_	3		
	5 5		21.8		_	_		
	5				_	\exists		
	-25					0		
SPT. (N) = Sum of last two blow value Stations, Depths, Offset, and Elevatio	es in samp ns are in F	le. (Qu) eet	B=Bulç	ge S=Shear P=Penetration Test				

AECOM STRUCTURE SOIL BORING LOG AECOM PROJ NO. 60225454 STRUCTURE NO. <u>016-1500</u>

ROUTE <u>FAI 55</u>

SECTION <u>2013-049B</u>

COUNTY <u>COOK</u>
 Boring No.
 STR-10

 Station
 93+82.21

 Offset
 76.68ft RT
 L O W S Qu tsf Elevation 547.05 ft Dark gray, medium to stiff SILTY CLAY LOAM to SILTY LOAM, trace shells, WOH 1.2S 64.5 wood and organics 1.3B 22.2 539.55 Brown and gray, very stiff SILTY CLAY 2.1B 27.0 Pressuremeter Test performed at 61.75 ft po = 3.5 tsf / pf = 7.5 tsf / pl = 12.1 tsf Ed = 140 tsf / E+ = 221 tsf Gray, very dense CLAY LOAM to LOAM 534.55 1.7B 25.2 530.55 Apparent weathered
BEDROCK 529.55
Apparent solid BEDROCK _527.05 __-70 SPT. (N) = Sum of last two blow values in sample. (Qu) B=Bulge S=Shear P=Penetration Test

Stations, Depths, Offset, and Elevations are in Feet

AECOM

Page 2 of 3

Date _____2/28/13___

SCALE

SHEET NO.

Page 3 of 3 Date <u>2/28/13</u> STRUCTURE ROCK CORING LOG ROUTE FAI 55 DESCRIPTION 1-94 (DAN RYAN EXPRESSWAY) TO US 41 (LAKE SHORE DRIVE) SECT. 2013-049B STRUCT. NO. <u>016-1500</u> ____ DRILLED BY <u>STRATA - KOMEN</u> COUNTY COOK Core Type NX
Core Diameter 2.16 in
Core Length 15 ft CORE COMP. Boring No. ____ M Surface Elev. 597.05 ft Top Elev. ft Core Run (#) H (tsf) Coring Notes and Rock Description ft) 527.05 Gray, hard, horizonally fractured, occasional dipping fracture, slightly vuggy, slightly weathered to fresh, poor to fair, DOLOMITE -80.0 100 53 512.05 End of Boring
Diedrich D-50 drill rig used for drilling
Automatic Diedrich hammer used for SPT
Casing used: 37 ft of 4 in diameter
Driller converted to rotary wash drilling at 15 ft depth
2-inch diameter PVC well installed with screen interval - 63.0'-73.0'
Well developed on 4/3/13

Color pictures of the cores

Yes - See Appendix

Cores will be stored for examination until

Minimum 60 days

AECOM

303 EAST WACKER DRIVE, SUITE 1400

FINDER 1312 373-7700 FAX: (3)23 373-6800

USER NAME = HENAOC	DESIGNED - KP	REVISED
	DRAWN - <u>CRH</u>	REVISED
PLOT SCALE = 0:2 ':" / in.	CHECKED - MJE	REVISED
PLOT DATE = 10/16/2017	DATE - 10/20/2017	REVISED

STATE OF IL	LINOIS
DEPARTMENT OF TRA	ANSPORTATION

BORING LOGS		F.A.I. RTE.	SECTION	COUNTY	TOTAL SHEETS	SHEET NO.
		55	2015-036LS	COOK	84	72
Г.				CONTRACT	NO. 6	2A93
OF SHEETS STA	TO STA		ILLINOIS FED. A	D PROJECT		

AECOM	S	TRUC	TUF	RE SC	DIL BORING LOG		Data	Page	1 of 3
AECOM PROJ NO. <u>60225454</u>							Date		.5/10
ROUTE FAI 55 DESCR	IPTIC	ON <u>I-9</u>	4 (DA	N RYA	N EXPRESSWAY) TO US 41 (LAKE	SHOR	E DRIV	E)	
SECT. <u>2013-049B</u>	STR	UCT. N	o. <u>01</u>	6-077	DRILLED BY	STRA	ATA - KO	OMEN	
COUNTY COOK LOCA	TION	<u>CH</u>	CAGC), ILLIN	<u>OIS</u>				
Boring No. STR-16 Station 504+14.23 Offset 19.99ft LT Surface Elev. 593.22 ft	DEPFH	B L O W S	Qu tsf	W %	Surface Water Elev. None Groundwater Elev.: when drilling 580.2 at Completion after Hrs.	D E P T H	B L O W S	Qu tsf	W %
TOPSOIL 592.22 FILL: Gray and black, moist, medium dense to	_	2 8 3		6.5	FILL: Brown, black and gray, saturated SAND, GRAVEL and SILT Sample 11: Wood noted	_	32 17 11		190.4
moist, medium dense to loose SAND, GRAVEL and CLAY		6 8 7		12.9	Sample 12: Wood noted 564.22 Brown and gray, very stiff	=	24 12 10		100.9
	-5 -	3 4 3		4.3	to hard SILTY CLAY	30	10 13 17	1.25P	20.7
	_	3 2 3		23.4					
Sample 5: Wood noted	-10 —	6 4 6		62.9		35	9 12 14	4.28	22.5
Sample 6: Strong petroleum oder noted FILL: Brown, black and	_	2 2 1		30.3	Gray, very stiff to stiff SILTY CLAY	=			
gray, saturated SAND, GRAVEL and SILT	-15	1 2 1		16.8		40	6 10 9	2.6S	20.9
	_	50/2"		2.5		=			
	-20 	18 24 22		26.4		45	6 5 7	1.6B	20.0
Sample 10: Wood noted		9 18 11		199.2	Gray, medium SILTY CLAY				
SPT. (N) = Sum of last two blow value Stations, Depths, Offset, and Elevation	-25 es in s ns are	sample. e in Feet	(Qu)	B=Bulç	 e S=Shear P=Penetration Test	50			

A=COM STRUCTURE SOIL BORING LOG AECOM PROJ NO. 60225454 STRUCTURE NO. 016-0773

ROUTE FAI 55

SECTION 2013-049B

COUNTY COOK
 Boring No.
 STR-16

 Station
 504+14.23

 Offset
 19.99ft LT
 L O W Qu S tsf Elevation 543.22 ft Gray, medium SILTY CLAY .8B 21.9 .7B 25.1 .7B 21.6 Gray, hard SILTY CLAY 4B 17.6 523.72 Apparent weathered BEDROCK or large GRAVEL _521.22 SPT. (N) = Sum of last two blow values in sample. (Qu) B=Bulge S=Shear P=Penetration Test

Stations, Depths, Offset, and Elevations are in Feet

AECOM

Page 2 of 3

Date 3/29/13

Page 3 of 3 Date ___3/29/13 ROUTE FAI 55 DESCRIPTION 1-94 (DAN RYAN EXPRESSWAY) TO US 41 (LAKE SHORE DRIVE) STRUCT. NO. 016-0773 DRILLED BY STRATA - KOMEN SECT. 2013-049B COUNTY COOK
 Boring No.
 STR-16

 Station
 504+14.23

 Offset
 19.99ft LT
 Core Type NX
Core Diameter 2.16 in
Core Length 15 ft CORE COMP. Surface Elev. 593.22 ft M E Top Elev. ft Core Run (#) H (tsf) Coring Notes and Rock Description (%) (%) 521.22 Gray, hard, horizontally fractured, occasional dipping fracture, slightly vuggy, slightly weathered to fresh, fair, DOLOMITE 100 67 -75.0 -80.0 2 -85.0 506.22 End of Boring
Diedrich D-50 drill rig used for drilling
Automatic Diedrich hammer used for SPT
Casing used: 30 ft of 4 in diameter
Driller converted to rotary wash drilling at 12.5 ft depth
Borehole grouted upon completion -90.0

STRUCTURE ROCK CORING LOG

Color pictures of the cores

Yes - See Appendix

Cores will be stored for examination until

Minimum 60 days

USER NAME = HENAOC	DESIGNED - <u>ONES</u>	REVISED
	DRAWN - <u>ARB</u>	REVISED
PLOT SCALE = 0:2 ':" / in.	CHECKED - MIRIE	REVISED
PLOT DATE = 10/16/2017	DATE - 10 <u>0/250/2017</u>	REVISED

BORING LOGS IV - S.N. 016-0773					F.A.I. RTE.	SECTION	COUNTY	TOTAL SHEETS	SHEET NO.
					55	2015-036LS	соок	84	_73_
					_		CONTRACT	T NO. 6	2A93
	SHEET NO OF	\$18#6/EREATHS	STA.	TO STA.	_	ILLINOIS FED. A	ID PROJECT		

AECOM	S	TRUC	TUF	RE SC	OIL BORING LOG			Page	1 of 3
AECOM PROJ NO. 60225454							Date	3/2	5/13
ROUTE FAI 55 DESCR	IPTIC	N <u>I-9</u>	4 (DA	N RYA	N EXPRESSWAY) TO US 41 (LAKE :	SHOF	RE DRIV	E)	
SECT. <u>2010-080-B</u>	STR	JCT. N	D. <u>0</u>	6-150	DRILLED BY	STRA	<u> </u>	OMEN	
COUNTY COOK LOCA	TION	<u>CH</u>	ICAGO), ILLIN	OIS				
Boring No. STR-27 Station 100+90.61 Offset 44.98ft RT	D E P T	B L O W	Qu	W	Surface Water Elev. Groundwater Elev.: when drilling at Completion None None None None None None	D E P T	B L O W	Qu	w
Surface Elev. 593.84 ft	Н	S	tsf	%	after Hrs. Not Meas.	Н	S	tsf	%
TOPSOIL		6 12 12		15.7	FILL: Gray and dark gray, soft to stiff CLAY and SANDY CLAY - occasional gravel and sand noted Wood noted	=	5 5 6		32.5
		1 1 3		15.1	Gray and brown, saturated, medium dense SAND	=	15 17 7	.7B	19.5
FILL: Gray and dark gray, soft to stiff CLAY and SANDY CLAY - occasional gravel and sand noted	-5 	2 2 7		22.8	Gray, medium SILTY CLAY LOAM to SILTY LOAM - trace shells	30	WOH WOH 2	5.38	51.8
		1 1 2		20.8					
	-10	4 4 6		16.2	No sample at 35.0'	-35			
		2 2 3		22.6	554.84				
	-15	6 4 8	.4B	24.2	Brown and gray, very stiff SILTY CLAY	40	13 19 26	3.8S	20.3
Petroleum ODOR noted		3 3 3		23.8					
	-20	4 4 8	.6B	21.0			17 27 29	3.2B	17.0
		3 3 5	.7B	22.0					
SPT. (N) = Sum of last two blow value Stations, Depths, Offset, and Elevation	-25 es in s	ample.	(Qu)	B=Bulç	 e S=Shear P=Penetration Test	-50			

A=COM	
AECOM PROJ NO.	60225454

STRUCTURE NO. <u>016-1505</u>

ROUTE <u>FAI 55</u>

SECTION <u>2010-080-B</u>

COUNTY <u>COOK</u>

Boring No. STR-27
Station 100+90.61
Offset 44.98ft RT

Elevation 543.84 ft

Brown and gray, very stiff SILTY CLAY

Gray, very stiff to hard SILTY CLAY

Gray, moist, extremely dense CLAY LOAM to LOAM - large gravel noted

Apparent weathered and fractured BEDROCK

523.34

518.84 -75

SPT. (N) = Sum of last two blow values in sample. (Qu) B=Bulge S=Shear P=Penetration Test Stations, Depths, Offset, and Elevations are in Feet

STRUCTURE SOIL BORING LOG

L O W S

Qu tsf

10 3.3B 21.8

4.8B 21.8

3.1B 20.2

Page 2 of 3
Date ___3/25/13__

SCALE

AECOM

Page 3 of 3 Date <u>3/25/13</u> STRUCTURE ROCK CORING LOG ROUTE FAI 55 DESCRIPTION 1-94 (DAN RYAN EXPRESSWAY) TO US 41 (LAKE SHORE DRIVE) ___ DRILLED BY <u>STRATA - KOMEN</u> SECT. 2010-080-B STRUCT. NO. 016-1505 COUNTY COOK Boring No. STR-27
Station 100+90.61
Offset 44.98ft RT Core Type NX
Core Diameter 2.16 in
Core Length 15 ft CORE COMP. M E Surface Elev. 593.84 ft Top Elev. ft Core Run (#) Coring Notes and Rock Description 518.84 Gray, hard, horizontally fractured, vuggy to slightly vuggy, slightly weathered, fair to good, DOLOMITE -85.0 100 503.84 End of Boring
Diedrich D-50 drill rig used for drilling
Automatic Diedrich hammer used for SPT
Casing used: 30 ft of 4 in diameter
Driller converted to rotary wash drilling at 10 ft depth
Borehole grouted upon completion

Color pictures of the cores

Yes - See Appendix

Cores will be stored for examination until

Minimum 60 days

AECOM

303 EAST WACKER DRIVE, SUITE 1400
CHICAGO, IL, 60501-527E, 53X (312) 373-6800

USER NAME = HENAOC	DESIGNED - KP	REVISED
	DRAWN - <u>CRH</u>	REVISED
PLOT SCALE = 0:2 ':" / in.	CHECKED - MJE	REVISED
PLOT DATE = 10/16/2017	DATE - 10/20/2017	REVISED

STATE (OF ILLINOIS
DEPARTMENT OF	F TRANSPORTATION

		BORING LO	GS		F.A.I. RTE.	SECTION	COUNTY	TOTAL SHEETS	SHEET NO.
					55	2015-036LS	COOK	84	74
COI						CONTRACT	NO. 6	2A93	
	SHEET NO C	F SHEETS	STA.	TO STA	ILLINOIS FED. AID PROJECT				

AECOM	STRUCTURE SOIL BORING LOG	Page 1 of 3
AECOM PROJ NO. 60225454		Date <u>3/28/13</u>
ROUTE FAI 55 DESCR	PTION _I-94 (DAN RYAN EXPRESSWAY) TO US 41 (LAKE S	SHORE DRIVE)
SECT. 2013-049B	TRUCT. NO. <u>016-1503</u> DRILLED BY _	STRATA - ULLRICH
COUNTY COOK LOCA	ON CHICAGO, ILLINOIS	
Boring No. STR-29 Station 104+58.80 Offset 52.35ft RT	D	D B E L P O T W Qu W
Surface Elev. <u>597.53</u> ft	H S tsf % after Hrs. Not Meas.	H S tsf %
TOPSOIL 596.93 FILL: Black, brown and gray, moist, medium dense to loose SAND, BRICK and	2 20.9 FILL: Gray and dark gray, 4 wet to saturated, loose 7 SAND, GRAVEL and SILT - trace brick noted 570.53	4
CLAY	5 19.8 FILL: Black and gray, saturated, loose GRAVEL, BRICK, SAND and SILT - petroleum odor noted	2 21.2 3 3 3
	-5 -2 21.7 -2 4	2 2 2
	3 21.9 564.53 Gray, saturated, loose SILTY CLAY LOAM	
Obstruction encountered, offset hole 10.0' and blank drilled to 12.5'	-10 -17 -50/6" -14.2	
	560.53 Gray, soft to medium SILTY CLAY	
	-15	3 .6B 21.8 34
FILL: Gray and dark gray, wet to saturated, loose SAND, GRAVEL and SILT - trace brick noted	7 16.4 - 4 - 2	
	2 26.6 2 4	
SDT (N) = Sum of last two blows also	in sample. (Qu) B=Bulge S=Shear P=Penetration Test	-50
Stations, Depths, Offset, and Elevation		

A=COM STRUCTURE SOIL BORING LOG Page 2 of 3
Date ___3/28/13__ AECOM PROJ NO. 60225454 STRUCTURE NO. <u>016-1503</u>

ROUTE <u>FAI 55</u>

SECTION <u>2013-049B</u>

COUNTY <u>COOK</u>
 Boring No.
 STR-29

 Station
 104+58.80

 Offset
 52.35ft RT
 L O W S Qu tsf Qu tsf Elevation 547.53 ft Elevation <u>522.53</u> ft Gray, soft to medium SILTY CLAY .7B 21.8 Apparent weathered BEDROCK - Driller notes hard drilling at 73.5' .6B 21.6 .8B 19.5 Gray, very stiff SILTY CLAY 2.1B 21.0 Apparent weathered BEDROCK - Driller notes hard drilling at 73.5'

AECOM

	STRUCTURE ROCK CORING	G LO	G			Paç Date	ge 3 of 3 3/28/13		
ROUTE FAI 55 DESC	CRIPTION <u>I-94 (DAN RYAN EXPRESSWA</u>	Y) TO	<u>JS 41 (L</u>	AKE S	HORE	DRIVE)			
SECT. 2013-049B STRUCT. NO. 016-1503 DRILLED BY STRATA									
COUNTY COOK	-								
Boring No. STR-29 Station 104+58.80 Offset 52.35ft RT	Core Type NX Core Diameter 2.16 in Core Length 16 ft			R E C O	R · Q	CORE T I	COMP. S T R		
Surface Elev. <u>597.53</u> ft				V	D	M E	N G		
ft	Notes and Rock Description		Core Run (#)	R Y (%)	(%)	(Min/ ft)	T H (tsf)		
520.53 Gray, hard, horizonally vuggs to slighty vuggy, DOLOMITE 100% Water loss at 77.	fractured, occasional dipping fracture, trace slighlty weathered to fresh, good to fair, 0' to 93.0'		1	98	88	2			
		- <u>80.0</u>							
			2	100	68	2			
		- <u>85.0</u>							
		Ξ							
		<u>-90.0</u>	3	100	80	2			
		\exists							
504.53 End of Boring Mobile B-57 drill rig use Automatic Mobile ham Casing used: 45 ft of 4 Driller converted to rota Driller did not encounte Borehole grouted upon	ner used for SPT in diameter ary wash drilling at 10.0 ft depth ar free water before switching to rotary drilling	- <u>95.0</u> - <u>—</u>							

Yes - See Appendix Color pictures of the cores Cores will be stored for examination until Minimum 60 days

USER NAME = HENAOC	DESIGNED - KP	REVISED
	DRAWN - <u>CRH</u>	REVISED
PLOT SCALE = 0:2 ':" / in.	CHECKED - MJE	REVISED
PLOT DATE = 10/16/2017	DATE - 10/20/2017	REVISED

SCALE

SPT. (N) = Sum of last two blow values in sample. (Qu) B=Bulge S=Shear P=Penetration Test Stations, Depths, Offset, and Elevations are in Feet

		BO	RING LO	GS		F.A.I. RTE.	SECTION	COUNTY	TOTAL SHEETS	SHEET NO.
						55	2015-036LS	соок	84	75
								CONTRAC	T NO. 6	2A93
	SHEET NO	_ OF	SHEETS	STA.	TO STA.	ILLINOIS FED. AID PROJECT				

A ECOM		S	TRUC	TUF	RE SC	OIL BORING LOG			-	1 of 3
AECOM PROJ NO. 602254	154							Date	4/	1/13
ROUTE FAI 55	DESCR	IPTIC	N <u>I-9</u>	94 (DA	N RYA	N EXPRESSWAY) TO US 41 (LAKE	SHOR	E DRIV	E)	
SECT. <u>2013-049B</u>		STRI	JCT. N	D. <u>0</u>	6-150	DRILLED BY .	STRA	TA - UL	LRICH	1
COUNTY COOK	LOCA	TION	<u>CH</u>	ICAGO), ILLIN	<u>OIS</u>				
Boring No. STR-30 Station 105+80.61 Offset 22.83ft LT Surface Elev. 591.93		D E P T H	B L O W S	Qu tsf	W %	Surface Water Elev. Groundwater Elev.: when drilling at Completion after Hrs. Not Meas.	D E P T H	B L O W S	Qu tsf	W %
TOPSOIL			2	LSI	25.4	alter Tils. Not mede.		4	LSI	29.2
FILL: Black, brown and gray, moist, loose to medium dense SAND, GRAVEL, BRICK and	_591.23		6 6		15.3	Gray, soft to stiff SILTY		2 2	.4B	30.4
CINDERS			6 5 4		15.3	CLAT		1 2	.46	30.4
		-5 —	2 3 3		19.3		30	1 2 4	.9B	22.8
			7 5 6		18.4					
	-	-10	5 5 6		35.5		-35	3 3 4	.5B	19.9
			2 3 2		22.5					
FILL: Black, gray and brown, wet, loose to medium dense SAND, CLAY and SILT - trace gravel and brick noted -	_577.43	-15	2 1 3		37.5		40 	1 1 2	Dist	24.5
samples contained strong petroleum/chemical odor			3 2 1		17.4					
		-20	18 9 4		23.0		45 	WOH 2 4	.5B	24.1
FILL: Gray and dark gray, saturated, very loose to loose SAND and SILT - trace petroleum odor and cinders noted	_569.93		1 1 2		31.0					
SPT. (N) = Sum of last two l Stations, Depths, Offset, and	olow value d Elevatior	-25 es in s	ample.	(Qu)	B=Bulç	 ge S=Shear P=Penetration Test	-50			

STRUCTURE SOIL BORING LOG Page 2 of 3 Date ____4/1/13___ AECOM PROJ NO. 60225454 STRUCTURE NO. <u>016-1503</u>

ROUTE <u>FAI 55</u>

SECTION <u>2013-049B</u>

COUNTY <u>COOK</u> STRUCTURE NO. <u>016-1503</u> ROUTE _FAI 55 SECTION _2013-049B COUNTY _COOK Boring No. ____ Station ____ Offset ____ L O W S L O W S Qu tsf Qu tsf Elevation 541.93 ft Elevation <u>516.93</u> ft Gray, soft to stiff SILTY CLAY 1B 24.4 did not reach Pf 516.43 did not reach Pf
Apparent weathered
BEDROCK
Pressuremeter Test
performed at 74.25 ft
po = 6.0 tsf / pf = > 64 tsf
/ pl = tsf
Ed = 5684 tsf / E+ =
11922 tsf
Pressurized test area to 64
tsf and did not reach Pf
Apparent solid BEDROCK No recovery from sample at 55 ft .4B 29.1 Gray, very stiff to hard SILTY CLAY 2.5B 15.5 522.43 37 4.4S 11.8 46 Gray, moist, extremely dense CLAY LOAM TO LOAM - large gravel noted Pressuremeter Test
performed at 71.25 ft
po = 6.0 tsf / pf = > 25 tsf
/ pl = tsf
Ed = 1727 tsf / E+ = tsf
Large test area - soil and
rock in test zone,
pressurized to 25 tsf and 519.93 517.93

AECOM

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	STRUCTURE ROCK CORING	S LO	G				ge 3 of 3 4/1/13
ROUTE _F	FAI 55 DESCRIPTION <u>I-94 (DAN RYAN EXPRESSWA</u>	Y) TO (JS 41 (L	AKE S	HORE	DRIVE)	
SECT. <u>201</u>	3-049B STRUCT. NO. <u>016-1503</u>	_ DI	RILLED I	BY _S	STRAT	A - ULLRI	CH
COUNTY	COOK						
Boring No. Station Offset				R E C O	R Q	CORE T I	COMP. S T R
Surface Ele	ev. <u>591.93</u> ft			V E	D	M E	N G
Top Elev. ft	Coring Notes and Rock Description		Core Run (#)	R Y (%)	(%)	(Min/ ft)	T H (tsf)
516.43	Gray, hard, horizonally fractured, slightly vuggy, slightly weathered, poor, DOLOMITE	-	1	100	36	2	
508.93	25% Water loss at 78.5'	-80.0					
	End of Boring Mobile B-57 drill rig used for drilling Automatic Mobile hammer used for SPT Casing used: 30 ft of 4 in diameter Driller converted to rotary wash drilling at 10.0 ft depth Driller did not encounter free water before switching to rotary drilling Borehole caved in at 74 ft, unable to flush hole and continue coring Borehole grouted upon completion	-85.0 95.0					

Yes - See Appendix Color pictures of the cores Cores will be stored for examination until Minimum 60 days

USER NAME = HENAOC	DESIGNED	-	KP	REVISED	-	-
	DRAWN	-	CRH	REVISED	-	-
PLOT SCALE = 0:2 ':" / in.	CHECKED	-	<u>MJE</u>	REVISED	-	-
PLOT DATE = 10/16/2017	DATE	- :	10 <u>/20/2017</u>	REVISED	-	-

SCALE

SPT. (N) = Sum of last two blow values in sample. (Qu) B=Bulge S=Shear P=Penetration Test Stations, Depths, Offset, and Elevations are in Feet

	В	ORING LO	GS		F.A.I. RTE.	SECTION	COUNTY	TOTAL SHEETS	SHEET NO.
					55	2015-036LS	соок	84	76
							CONTRAC	T NO. 6	2A93
SHEET NO	OF _	SHEETS	STA.	TO STA		ILLINOIS FED. A	ID PROJECT		

A ECOM		S	STRUC	CTUR	RE SC	DIL BORING LOG			-	1 of 3
AECOM PROJ NO. 6022545	54							Date	4/	4/13
ROUTE FAI 55	DESCR	IPTIC	ON L	94 (DA	N RYA	N EXPRESSWAY) TO US 41 (LAKE	SHOR	E DRIV	Ξ)	
SECT. <u>2013-049B</u>		STR	UCT. N	O. <u>01</u>	16-150	DRILLED BY	STRA	ATA - BA	KER	
COUNTY COOK	LOCA	TION	<u>CH</u>	IICAGO), ILLIN	IOIS_				
Station STR-32	it	D E P T H	B L O W S	Qu tsf	W %	Surface Water Elev. Groundwater Elev.: when drilling 580.3 at Completion Not Meas. after Hrs. Not Meas.	DEPTH	B L O W S	Qu tsf	W %
TOPSOIL FILL: Black, brown and	_586.54	_	4 7 10		13.5	Gray, soft to medium, SILTY CLAY - sand seams noted		2 1 2	.4B	21.8
gray, moist to wet, medium dense SAND, GRAVEL, BRICK and CINDERS		=	2 6 4		19.8			3 2 2	.7B	29.1
		5 	2 3 7		5.8		30	1 1 1	.25P	28.5
FILL: Black, brown and gray, saturated, medium dense to dense SAND, BRICK, CLAY and	_580.34		3 4 4		30.6					
CINDERS Sample 5: Fiberous material noted	575.84	-10 —	1 WOH WOH		32.1		35 	WOH WOH WOH	.3B	21.9
Obstruction encoutered while drilling 12 to 13 ft FILL: Brown and gray, SILTY CLAY - gravel noted	_573.84		3 WOH 5		33.3					
Obstruction encoutnered while drilling 14.5 to 16 ft FILL: Black, brown and	_571.84	15	1		25.3		40	2 5 4	.7B	22.1
gray, saturated, loose to medium SAND, GRAVEL, and BRICK - wood noted		=	2 2				_			
FILL: Gray, SILTY CLAY -	_567.84	-20	14 9 6		22.8			3	.8B	21.9
cinders, wood and sand noted		Ξ	3				_	3 3 5		
			2 2 3		25.9	Gray, very stiff SILTY CLAY	‡ <u> </u>			
	_562.84	-25					-50			
SPT. (N) = Sum of last two b Stations, Depths, Offset, and	low value Elevatio	es in : ns ar	sample. e in Fee	(Qu) t	B=Bulç	ge S=Shear P=Penetration Test				

A=COM STRUCTURE SOIL BORING LOG AECOM PROJ NO. 60225454
 Boring No.
 STR-32

 Station
 103+10.65

 Offset
 31.66ft LT
 L O W Qu S tsf Elevation 537.84 ft Gray, very stiff SILTY CLAY 2.2B 22.9 Gray, medium SILTY CLAY 535.34 .5B 27.2 Gray, hard SILTY CLAY 4.6B 17.0 _524.84 Gray, moist, extremely dense LOAM - large gravel noted noted
Pressuremeter Test
performed at 68.25 ft
po = 6.0 tsf / pf = 45 tsf /
pl = * tsf
Ed = 673 tsf / E+ = 1861
tsf
* Hardpan with layers of
apparent layered or broken
rock
Apparent weathered
BEDROCK
Pressuremeter Test
performed at 68.25 ft
po = 6.0 tsf / pf = > 64 tsf
/ pl = tsf
Ed = 8151 tsf / E+ =
17905 tsf
Pressurized test area to 64
tsf and did not reach Pf
Apparent solid BEDROCK 521.34 518.84 ___ 517.84 __-70 SPT. (N) = Sum of last two blow values in sample. (Qu) B=Bulge S=Shear P=Penetration Test Stations, Depths, Offset, and Elevations are in Feet

AECOM

Page 2 of 3
Date _____4/4/13___

		STRUCTURE ROCK CORIN	NG LO	G				ge 3 of 3 4/4/13
ROUTE FA	AI 55 DESCI	RIPTION <u>I-94 (DAN RYAN EXPRESSW</u>	AY) TO	US 41 (L	AKE S	HORE	DRIVE)	
SECT. 2013-	-049B	STRUCT. NO. <u>016-1503</u>	D	RILLED I	3Y _	STRAT	A - BAKE	R
COUNTY _	СООК							
Offset	103+10.65 31.66ft LT				R E C O	R Q	CORE T I	COMP. S T R
Surface Elev.	<u>587.84</u> ft				V E	D .	M E	N G
Top Elev. ft		Notes and Rock Description		Core Run (#)	R Y (%)	(%)	(Min/ ft)	T H (tsf)
517.84 G	Gray, hard, horizonally f slightly weathered to fres	ractured, slightly vuggy to trace vuggs, sh, fair to good, DOLOMITE		1	95	54	2	
2	25% Water loss at 78.5'		-75.0 -75.0 	2	100	89	2	
502.84			-85.0	2	100	89	2	
M A	End of Boring Mobile B-57 drill rig used Automatic Mobile hamm Casing used: 25 ft of 4 in Driller converted to rotar Boring grouted upon cor	ner used for SPT n diameter ry wash drilling at 22.5 ft depth						

Color pictures of the cores _____

Yes - See Appendix

Cores will be stored for examination until

Minimum 60 days

AECOM
303 EAST MACKEN DRIVE. SUITE 1400
PHONE (3) 23 737-700 FAX: (3)23 373-6800

USER NAME = HENAOC	DESIGNED	-	KP	REVISED	-	-
	DRAWN	-	CRH	REVISED	-	-
PLOT SCALE = 0:2 ':' / in.	CHECKED	-	<u>MJE</u>	REVISED	-	-
PLOT DATE = 10/16/2017	DATE	- :	10 <u>/20/2017</u>	REVISED	-	-

BOR	ING LOC	 3S		F.A.I. RTE.	SECTION		COUNTY	TOTAL SHEETS	SHEET NO.
				55	2015-036LS		COOK	_84_	_77
							CONTRACT	NO. 6	52A93
SHEET NO OF	SHEETS	STA	TO STA.		ILLINOIS FE	ED. AID	PROJECT		

A=COM	ST	ruc	CTUR	E SC		e 1 of 3
AECOM PROJ NO. 60225454					Date	/22/13
ROUTE FAI 55 DESCR	IPTIO	N <u>I-9</u>	94 (DAI	N RYA	N EXPRESSWAY) TO US 41 (LAKE SHORE DRIVE)	
SECT. 2013-049B	STRU	ICT. N	O. <u>01</u>	6-150	3 DRILLED BY STRATA - ULLRI	CH
COUNTY COOK LOCA	TION	<u>CH</u>	ICAGO	, ILLIN	IOIS_	
STR-34	DEPTH	B L O W S	Qu tsf	W %	Surface Water Elev.	
TOPSOIL / 588.42		4		15.6	2 <0.5	
FILL: Black and brown, moist to wet, medium	\exists	5 8			Gray, saturated, loose fine SAND	00.0
dense to very loose SAND, GRAVEL, BRICK and	\exists				Gray, medium SILTY CLAY 561.72	23.2
CINDERS	\mp	5 6		16.8	4 0.5	≥ 20.6
	4	8			4	
	-5	1		21.8	3 0.7	3 21.8
	4	0 0			3 3	
	=					
FILL: Black, saturated,		2 2		33.9		
loose SAND, GRAVEL, BRICK and CINDERS	4	3				
	-10	4		47.1		3 21.1
	\exists	3 4			4 5	2
FILL: Gray, soft CLAY -	\mp				551.22	
wood, gravel and brick noted	\mp	1	<0.5P	25.0	Gray and dark gray, stiff SILTY CLAY LOAM	
	4	ż			=	
	-15	1		23.6		3 20.6
	\exists	1		20.0		20.0
	_				546.22	
	\pm	1		25.9	Brown and gray, very stiff SILTY CLAY	
	4	1			J J J J J J J J J J J J J J J J J J J	
	-20	MOL	<0.5P	20.0		20.8
		WOH 1	\U.5F	20.9	5 3.5 - 7 - 10	20.0
	\pm	'				
	\pm	1	<0.5P	27.3	Gray, medium SILTY CLAY	
	4	2 2				
	-25					
SPT. (N) = Sum of last two blow value Stations, Depths, Offset, and Elevatio	es in sa ns are	imple. in Fee	(Qu) t	B=Bulg	ge S=Shear P=Penetration Test	

AECOM STRUCTURE SOIL BORING LOG AECOM PROJ NO. <u>60225454</u> STRUCTURE NO. 016-1503

ROUTE FAL55

SECTION 2013-049B

COUNTY COOK
 Boring No.
 STR-34

 Station
 102+29.72

 Offset
 0.63ft RT
 D B E L P O T W Qu W H S tsf % Elevation 538.72 ft 0.7B 26.9 Gray, medium SILTY CLAY -55 WOH 0.5P 27.3 WOH 4 Gray, very stiff SILTY CLAY Gray, dry, extremely dense CLAY LOAM to LOAM -large gravel noted Apparent weathered 524.72 BEDROCK 523.72 -65 SPT. (N) = Sum of last two blow values in sample. (Qu) B=Bulge S=Shear P=Penetration Test Stations, Depths, Offset, and Elevations are in Feet

AECOM

Page 2 of 3

Date <u>4/22/13</u>

SCALE

	STRUCTURE ROCK CORING LO	OG			Paç Date	ge 3 of 3 4/22/13
ROUTE FAI 55 DE	SCRIPTION <u>I-94 (DAN RYAN EXPRESSWAY) TO</u>	US 41 (L	AKE S	HORE	DRIVE)	
SECT. <u>2013-049B</u>	STRUCT. NO. <u>016-1503</u>	DRILLED	BY 🕹	STRAT	A - ULLRI	CH
COUNTY COOK	_					
Boring No. STR-34 Station 102+29.72 Offset 0.63ft RT	Core Type NX Core Diameter 2.16 in Core Length 15 ft		R E C	R Q	CORE	COMP. S T R
Surface Elev. <u>588.72</u> ft			V	Ď	M E	N G
ft	ing Notes and Rock Description	Core Run (#)	R Y (%)	(%)	(Min/ ft)	T H (tsf)
523.72 Gray, hard, horizona moderately weather	Illy fractured, vuggy , slightly weathered to ed, excellent to fair DOLOMITE	1	100	94		
	-					
	- <u>70.</u> -	0				
	<u>-</u>					
	— - <u>75.</u>	2	100	64		
	- - - - - -					
	- - -					
508.72 End of Boring	-80.	0				
Mobile B-57 drill rig Automatic Mobile ha Casing used: 25 ft o	mmer used for SPT f 4 in diameter					
Driller converted to r Borehole grouted up	otary wash drilling at 12.5 ft depth					
	- - 					

Color pictures of the cores

Yes - See Appendix

Cores will be stored for examination until

Minimum 60 days

AECOM

JOJ EAST WACKER DRIVE, SUITE 1400
CHICAGO, 15, 06001-5276, 51xt (312) 373-6800

USER NAME = HENAOC	DESIGNED - KP	REVISED
	DRAWN - <u>CRH</u>	REVISED
PLOT SCALE = 0:2 ':" / in.	CHECKED - MJE	REVISED
PLOT DATE = 10/16/2017	DATE - 10/20/2017	REVISED

STATE OF	ILLINOIS
DEPARTMENT OF	TRANSPORTATION

	BOF	RING LOC	as		F.A.I. RTE.	SECTION	COUNTY	TOTAL SHEETS	SHEET NO.
					55	2015-036LS	соок	_84	_78_
							CONTRAC	T NO. 6	2A93
SHEET NO	OF	SHEETS	STA	TO STA	_	ILLINOIS FED. A	ID PROJECT		

AECOM	STRUCTURE SOIL BORING	
AECOM PROJ NO. 60225454		Date <u>4/11/13</u>
ROUTE FAI 55 DESCI	TION <u>I-94 (DAN RYAN EXPRESSWA</u>)	Y) TO US 41 (LAKE SHORE DRIVE)
SECT. <u>2010-080-B</u>	TRUCT. NO. <u>016-1505</u>	DRILLED BY STRATA - ULLRICH
COUNTY COOK LOCA	ON <u>CHICAGO, ILLINOIS</u>	
Boring No. STR-35 Station 103+63.26 Offset 14.05ft LT	D B Surface Water E L Groundwater E When drilling T W Qu W at Completion	lev.: E L
Surface Elev. <u>588.52</u> ft		Hrs. Not Meas. H S tsf %
TOPSOIL 588.02 FILL: Crushed BRICK and GRAVEL	9 29.4 FILL: Gray, sof SILTY CLAY	1
FILL: Brown, black and gray, dry, very dense to loose SAND and GRAVEL	Gray, soft to me 5 15.1 SILTY CLAY	edium 561.52 WOH .2B 23.9 WOH
	12	<u> </u>
	30 11.8 40 29	—30 WOH .7B 18.9 — 3 — 3
	40 21.9 4 1	
FILL: Black, wet, very loose SAND, BRICK, GRAVEL, WOOD and SILT 577.52	-10 -2 1 19.6	
FILL: Black, saturated, loose SAND, BRICK, GRAVEL, WOOD and SILT	1 14.3	WOH
_574.02 FILL: Gray, soft to medium	1 3	-40
SILTY CLÁY	1 24.8 — 1 — 3	WOH .3B 26.7
	5 23.1 1 2	\exists
	-20 1 .4B 31.1 1 1	
	WOH .2B 28.0 WOH WOH Gray, stiff to me	540.52
SPT. (N) = Sum of last two blow valustations, Depths, Offset, and Elevation	in sample. (Qu) B=Bulge S=Shear P=Peare in Feet	enetration Test

D B E L P O T W Gu W H S tsf %
 Boring No.
 STR-35

 Station
 103+63.26

 Offset
 14.05ft LT
 Elevation 538.52 ft Gray, stiff to medium SILTY CLAY 1.1B 20.3 WOH .6B 26.9 Apparent solid BEDROCK 528.52 __60 Pressuremeter Test
performed at 61.75 ft
po = 6.0 tsf / pf = > 64 tsf
/ pl = tsf
Ed = 9690 tsf / E+ =
34166 tsf
Pressurized test area to 64
tsf and did not reach Pf

SPT. (N) = Sum of last two blow values in sample. (Qu) B=Bulge S=Shear P=Penetration Test Stations, Depths, Offset, and Elevations are in Feet

STRUCTURE SOIL BORING LOG

AECOM

AECOM PROJ NO. <u>60225454</u>

STRUCTURE NO. <u>016-1505</u>

ROUTE <u>FAL55</u>

SECTION <u>2010-080-B</u>

COUNTY <u>COOK</u>

AECOM

Page 2 of 3
Date <u>4/11/13</u>

STRUCTURE ROCK CORING LO)G			Pag Date	ge 3 of : 4/11/13
ROUTE FAI 55 DESCRIPTION 1-94 (DAN RYAN EXPRESSWAY) TO	US 41 (L	AKE S	HORE	DRIVE)	
SECT. <u>2010-080-B</u> STRUCT. NO. <u>016-1505</u>	DRILLED	BY _S	STRAT	A - ULLR	СН
COUNTY COOK					
Soring No.		R E C O V E	R . Q . D	CORE T I M E	COMP. S T R N G
Top Elev. Coring Notes and Rock Description ft	Core Run (#)	R Y (%)	(%)	(Min/ ft)	T H (tsf)
525.52 Gray, hard, horizontally fractured, slightly vuggy to trace vuggs, slightly weathered to fresh, excellent, DOLOMITE -65.	2	100	100		
510.52 End of Boring Mobile B-57 drill rig used for drilling Automatic Mobile hammer used for SPT Casing used: 40 ft of 4 in diameter Driller converted to rotary wash drilling at 12.5 ft depth Borehole grouted upon completion	 				

Page 3 of 3

Color pictures of the cores

Yes - See Appendix

Minimum 60 days

Cores will be stored for examination until

USER NAME = HENAOC	DESIGNED - <u>KP</u>	REVISED
	DRAWN - <u>CRH</u>	REVISED
PLOT SCALE = 0:2 ':" / in.	CHECKED - MJE	REVISED
PLOT DATE = 10/16/2017	DATE - 10/20/2017	REVISED

В	DRING LO	GS		F.A.I. RTE.	SECTION	COUNTY	TOTAL SHEETS	SHEET NO.
				55	2015-036LS	соок	84	_79_
1						CONTRAC	T NO. 6	2A93
SHEET NO OF _	SHEETS	STA.	TO STA.		ILLINOIS FED.	AID PROJECT		

AECOM	STRUCTURE	SOIL BORING LOG	Page 1 of 3
AECOM PROJ NO. <u>60225454</u>			Date <u>4/15/13</u>
ROUTE FAI 55 DESCR	TION <u>I-94 (DAN F</u>	RYAN EXPRESSWAY) TO US 41 (LAKE	SHORE DRIVE)
SECT. 2010-080-B	TRUCT. NO. <u>016-</u>	DRILLED BY	STRATA - ULLRICH
COUNTY COOK LOCA	ON <u>CHICAGO, IL</u>	LINOIS	
Boring No. STR-36 Station 104+74.20 Offset 4.01ft LT Surface Elev. 592.29 ft		Surface Water Elev. Groundwater Elev.: when drilling at Completion at Completion at Groundwater Elev.: when drilling At Completion at Completion at Completion At Most Meas.	D B E L P O T W Qu W H S tsf %
TOPSOIL 7591.99 FILL: Black and brown, moist, medium dense to very loose SAND,	4 20 15 10	O.8 Gray, medium SILTY CLAY	WOH 0.5P 28.2 WOH 1
GRAVEL, BRICK and WOOD	13 12 8 5	2.0	1 .6B 27.3 - 1 - 2
	-5 21 1. 50/2"	1.9	1 0.5P 27.8 1
	16 13 9 11	3.4	
	-10 -10 -10 -10 -10 -10 -10 -10 -10 -10	4.7	
	1 1! WOH 1	5.0	
FILL: Gray and black SILTY CLAY - large gravel noted		2.5	
Limited recovery at 17.5 ft.	1 3 3 2 2	6	
No recovery at 20.0 ft. 570.29	-20 - 5 - 9 - 4		WOH 0.5P 21.9
FILL: Black and gray, saturated, medium dense SAND, GRAVEL and WOOD	7 25 - 8 - 9	5.8	
Gray, medium SILTY CLAY SPT. (N) = Sum of last two blow value Stations, Pootbo, Offset, and Flovation	in sample. (Qu) B=	542.2 Bulge S=Shear P=Penetration Test	950
Stations, Depths, Offset, and Elevatio	are ill Feet		

A=COM STRUCTURE SOIL BORING LOG AECOM PROJ NO. <u>60225454</u> STRUCTURE NO. 016-1505 ROUTE _FAI_55 SECTION _2010-080-B COUNTY _COOK Boring No. STR-36
Station 104+74.20
Offset 4.01ft LT D B E L P O T W Qu H S tsf Elevation 542.29 ft Gray, stiff to medium SILTY CLAY 1.2B 19.1 .4B 25.9 WOH 0.5B 27.5 _521.79 _521.29 50/3" Apparent weathered 521.29
BEDROCK or Hardpan 520.29
Apparent solid BEDROCK 520.29

SPT. (N) = Sum of last two blow values in sample. (Qu) B=Bulge S=Shear P=Penetration Test

Stations, Depths, Offset, and Elevations are in Feet

AECOM

Page 2 of 3

SCALE

Page 3 of 3 Date <u>4/15/13</u> STRUCTURE ROCK CORING LOG ROUTE FAI 55 DESCRIPTION 1-94 (DAN RYAN EXPRESSWAY) TO US 41 (LAKE SHORE DRIVE) SECT. 2010-080-B STRUCT. NO. 016-1505 DRILLED BY STRATA - ULLRICH COUNTY COOK Boring No. STR-36
Station 104+74.20
Offset 4.01ft LT Core Type <u>NX</u>

Core Diameter <u>2.16</u> in

Core Length <u>15</u> ft CORE COMP. M E Surface Elev. 592.29 ft Top Elev. ft Core Run (#) H (tsf) Coring Notes and Rock Description (%) (%) ft) 520.29 Gray, hard, horizonally fractured, occasional dipping fracture, slightly vuggy to trace vuggs, slightly weathered to fresh, fair to good DOLOMITE -75.0 -80.0 100 83 -85.0 505.29 End of Boring
Mobile B-57 drill rig used for drilling
Automatic Mobile hammer used for SPT
Casing used: 30 ft of 4 in diameter
Driller converted to rotary wash drilling at 12.5 ft depth
Borehole grouted upon completion -90.0

Color pictures of the cores

Yes - See Appendix

Cores will be stored for examination until

Minimum 60 days

AECOM
303 EAST MACKEN DRIVE. SUITE 1400
PHONE (3) 23 737-700 FAX: (3)23 373-6800

USER NAME = HENAOC	DESIGNED - <u>KP</u>	REVISED
	DRAWN - <u>CRH</u>	REVISED
PLOT SCALE = 0:2 ':" / in.	CHECKED - MJE	REVISED
PLOT DATE = 10/16/2017	DATE - 10 <u>/20/2017</u>	REVISED

STATE OF ILLINOIS
017111 01 111111010
DEPARTMENT OF TRANSPORTATION

	В	ORING LO	3S		F.A.I. RTE.	SECTION	COUNTY	TOTAL SHEETS	SHEET NO.
					55	2015-036LS	соок	84	_80_
							CONTRACT	NO. 6	2A93
SHEET NO	_ OF _	SHEETS	STA.	TO STA		ILLINOIS FED. A	D PROJECT		

AECOM	STRUCTURE SOIL BORING LOG	Page 1 of 3
AECOM PROJ NO. 60225454		Date4/15/13
ROUTE FAI 55 DESCR	IPTION <u>I-94 (DAN RYAN EXPRESSWAY) TO US 41 (LAKE SHOR</u>	E DRIVE)
SECT. 2010-080-B	STRUCT. NO. 016-1505 DRILLED BY STRA	ATA - BAKER
COUNTY COOK LOCA	TION CHICAGO, ILLINOIS	
STR-37	D B C Surface Water Elev. None D E L Groundwater Elev.: when drilling 579.3 P T W Qu W at Completion Not Meas. T Not Meas. H H S tsf % after Hrs. Not Meas. H	B L C C C C C C C C C C C C C C C C C C
FILL: Black brown and gray, moist to wet, loose to very dense SAND, BRICK and GRAVEL - clay and	4 14.6 FILL: Gray, soft CLAY - rock fragments noted	WOH 0.6S 23.4 1 2
wood noted	Gray, medium to soft SILTY CLAY — — — — — — — — — — — — — — — — — — —	WOH 0.4B 23.1 WOH WOH
		WOH 0.5B 24.6 WOH 1
	23 15.1	
		WOH <0.25P 24.0 WOH WOH
FILL: Black and gray, saturated, loose to very loose SAND - wood and gravel noted	3 26.5	WOH
g. a		WOH 0.6B 23.9 WOH 2
FILL: Gray, soft CLAY - rock fragments noted		1 <0.25P 22.3 2 4
	WOH <0.25P 26.5	
SPT. (N) = Sum of last two blow valu Stations, Depths, Offset, and Elevation		

AECOM PROJ NO. <u>60225454</u> STRUCTURE NO. <u>016-1505</u>

ROUTE <u>FAL55</u>

SECTION <u>2010-080-B</u>

COUNTY <u>COOK</u>
 Boring No.
 STR-37

 Station
 106+01.17

 Offset
 16.42ft RT
 D B E L P O T W Gu W H S tsf % Elevation 541.29 ft Gray, medium to soft SILTY CLAY WOH <0.25P 28.3 2 2 1.5B 22.7 1.1B 22.2 1.1B 23.5 523.29 SPT. (N) = Sum of last two blow values in sample. (Qu) B=Bulge S=Shear P=Penetration Test Stations, Depths, Offset, and Elevations are in Feet

STRUCTURE SOIL BORING LOG

A=COM

AECOM

Page 2 of 3
Date <u>4/15/13</u>

SCALE

		STRUCTURE RC	CK CORING	G LO	3			Pag Date	ge 3 of 3 4/15/13
ROUTE _	FAI 55 DESC	RIPTION <u>I-94 (DAN RYA</u>	N EXPRESSWA	Y) ΤΟ (JS 41 (L	AKE S	HORE	DRIVE)	
SECT. 2010-080-B STRUCT. NO. 016-1505 DRILLED B						3Y _	STRAT	A - BAKEI	₹
COUNTY	СООК								
Boring No. Station Offset	106+01.17 16.42ft RT	Core Type NX Core Diameter 2.16 Core Length 15 ft	_ in			R E C O	R Q	CORE T	COMP. S T R
Surface Ele	ev. <u>591.29</u> ft					V E	D .	M E	N G
Top Elev. ft	Coring	Notes and Rock Description	1		Core Run (#)	R Y (%)	(%)	(Min/ ft)	T H (tsf)
523.29		fractured, occasional dippin iggs, slightly weathered, fair			1	100	58		
				-70.0					
				ᆿ					
				크	2	100	45		
				\exists	2	100	45		
				<u>-75.0</u>					
				=					
				-75.0 -75.0 -75.0 -75.0	3	100	90		
				4	ŭ				
				ㅋ					
				-80.0					
				=	4	100	30		
500.00				\exists					
508.29	End of Boring Mobile B-61 drill rig used	d for drilling		- 🛨					
	Automatic Mobile hamm Casing used: 30 ft of 4 in	er used for SPT		<u>-85.0</u>					
	Driller converted to rotal Borehole grouted upon	y wash drilling at 10.0 ft der	oth	-05.0					
	3	•		\exists					
				ᆿ					

Color pictures of the cores

Yes - See Appendix

Cores will be stored for examination until Minimum 60 days

USER NAME = HENAOC	DESIGNED - <u>KP</u>	REVISED
	DRAWN - <u>CRH</u>	REVISED
PLOT SCALE = 0:2 ':' / in.	CHECKED - MJE	REVISED
PLOT DATE = 10/16/2017	DATE - 10/20/2017	REVISED

STATE OF ILLINOIS
DEPARTMENT OF TRANSPORTATION

		BORI	NG LO	GS			F.A.I. RTE.	SECTION	COUNTY	TOTAL SHEETS	SHEET NO.
							55	2015-036LS	соок	84	_81_
									CONTRAC	T NO. 6	2A93
	SHEET NO	OF S	SHEETS	STA	TO STA			ILLINOIS FED. AI	D PROJECT		

A=COM	S	TRU	CTUF	RE SC	OIL BORING LOG			Page	
AECOM PROJ NO. <u>60225454</u>							Date	4/1	2/13
ROUTE FAI 55 DESCR	IPTIC	ON <u>I-</u>	94 (DA	N RYA	N EXPRESSWAY) TO US 41 (LAKE S	HOR	E DRIV	E)	
SECT. 2010-080-B	STR	UCT. N	O. <u>0</u>	16-150	5 DRILLED BY	STRA	ATA - M	ALOUF	:
COUNTY COOK LOCA	TION	<u>C</u>	IICAGO), ILLIN	IOIS_				
Boring No. STR-39 Station 108+54.97 Offset 34.48ft RT Surface Elev. 590.77 ft	DEPTH	B L O W S	Qu tsf	W %	Surface Water Elev. Groundwater Elev.: when drilling at Completion after Hrs. Not Meas.	DEPTH	B L O W S	Qu tsf	W %
TOPSOIL		4 9 8		18.2	Brown and gray, stiff SILTY CLAY		WOH 2 3	0.6B	25.7
to Ioose SAND, GRAVEL, BRICK and CLAY		9 7 10		14.8	Brown and gray, hard to very stiff SILTY CLAY Sampling device broken off in borehole at 27.5 ft.		6 14 16 19	5.1B	19.5
	-5 —	4 4 5		19.1	No recovery at 30.0 ft.	-30	16 24 21		
		1 2 5		25.5			11 18 17	2.0P	24.9
FILL: Gray and dark gray, CLAY, BRICK and GRAVEL	-10	2 2 3		22.3	Brown and gray, stiff SILTY 555.77 CLAY	-35	13 13 15	1.0P	28.0
		ST		34.8	Gray, stiff to medium SILTY 552.77 CLAY				
	-15	ST		27.1	No recovery at 40.0 ft.	-40	9 11 12	1.0P	23.3
		18 16 6		24.8		=			
	-20	43 8 4		15.9		-45 —	4 4 6	1.3B	20.4
No recovery at 22.5 ft. Brown and gray, stiff SILTY 567.77 CLAY		2 3 4							
SPT. (N) = Sum of last two blow value Stations, Depths, Offset, and Elevation	-25 es in s	sample.	(Qu)	B=Bulg	ge S=Shear P=Penetration Test	-50			

A=COM STRUCTURE SOIL BORING LOG AECOM PROJ NO. <u>60225454</u> STRUCTURE NO. <u>016-1505</u>

ROUTE <u>FAI.55</u>

SECTION <u>2010-080-B</u>

COUNTY <u>COOK</u>
 Boring No.
 STR-39

 Station
 108+54.97

 Offset
 34.48ft RT
 D B E L P O T W Gu W H S tsf % Elevation 540.77 ft Gray, stiff to medium SILTY CLAY 0.6B 24.5 0.5P 25.7 4 0.75P 24.8 Apparent solid BEDROCK 524.27 SPT. (N) = Sum of last two blow values in sample. (Qu) B=Bulge S=Shear P=Penetration Test Stations, Depths, Offset, and Elevations are in Feet

AECOM

Page 2 of 3
Date <u>4/12/13</u>

	STRUCTURE ROCK CORING LOG	Page 3 of 3 Date <u>4/12/13</u>
ROUTE FAI 55 DESC	RIPTION <u>I-94 (DAN RYAN EXPRESSWAY) TO US 41 (L</u>	AKE SHORE DRIVE)
SECT. 2010-080-B	STRUCT. NO. 016-1505 DRILLED	BY STRATA - MALOUF
COUNTY COOK		
Boring No. STR-39 Station 108+54.97 Offset 34.48ft RT	Core Type NX Core Diameter 2.16 in Core Length 15 ft	R R CORE COMP. E . S C Q T T O . I R
Surface Elev. 590.77 ft		V
Top Elev. Coring ft	Notes and Rock Description Core Run (#)	R
523.27 Gray, hard, horizonally f DOLOMITE 513.27 End of Boring Mobile B-61 drill rig used Automatic Mobile hamm Casing used: 30 ft of 4 in Driller converted to rotan Borehole abandoned at at bottom of hole.	-75.0 -75.0 -75.0 -75.0 -75.0 -75.0 -75.0 -75.0 -75.0 -75.0 -75.0 -75.0 -75.0 -75.0	100 66

Color pictures of the cores

Yes - See Appendix

Minimum 60 days

Cores will be stored for examination until

USER NAME = HENAOC	DESIGNED	-	KP	REVISED	-	-
	DRAWN	-	<u>CRH</u>	REVISED	-	-
PLOT SCALE = 0:2 ':' / in.	CHECKED	-	<u>MJE</u>	REVISED	-	-
PLOT DATE = 10/16/2017	DATE	- 1	10 <u>/20/2017</u>	REVISED	-	-

STATE OF ILLINOIS
DEPARTMENT OF TRANSPORTATION

	BO	RING LO	GS		F.A.I. RTE.	SECTION	COUNTY	TOTAL SHEETS	SHEET NO.
					55	2015-036LS	COOK	84	82
							CONTRACT	NO. 6	2A93
SHEET NO	OF _	SHEETS	STA.	TO STA.		ILLINOIS FED. AI	D PROJECT		

A=COM		S	TRUC	CTUR	RE SC	OIL BORING LOG			Page																																																	
AECOM PROJ NO. 6022545	54							Date	4/1	0/13																																																
ROUTE FAI 55	DESCR	IPTIC	ON <u>I-</u>	94 (DA	N RYA	N EXPRESSWAY) TO US 41 (LAKE S	HOR	E DRIV	E)																																																	
SECT. <u>2010-080-B</u>		STR	UCT. N	O. <u>01</u>	16-150	5 DRILLED BY	STRA	TA - BA	AKER																																																	
COUNTY COOK	LOCA	TION	<u>C</u> H	IICAGO), ILLIN	<u>IOIS</u>																																																				
Boring No. STR-40 Station 109+90.60 Offset 27.59ft RT		D E P T	B L O W	Qu	w	Surface Water Elev. None Groundwater Elev.: when drilling 579.2 at Completion Not Meas.	DHPT	B L O W	Qu	W																																																
Surface Elev. <u>590.71</u> f	t	Н	S	tsf	%	after Hrs. Not Meas.	Н	S	tsf	%																																																
TOPSOIL FILL: Black and gray, moist to wet, medium	_589.91	=	2 6 8		18.6	FILL: Gray, medium CLAY - gravel noted 563.71	\exists	7 15 13		27.6																																																
dense to loose, SAND, BRICK and GRAVEL		=	6 4 16		20.0	Brown and gray, very stiff to hard SILTY CLAY	=	5 7 12		21.0																																																
		-5	6		13.8		-30	5 9	DIST	24.7																																																
			2 3		17.4			11																																																		
	579.21	-10	3 3 3 3		36.6		-35	6 11 13	4.7S	20.3																																																
FILL: Gray, saturated, loose to very loose SILT, SAND and CLAY - brick and gravel	_379.21		3 1 1		21.7	Gray, stiff to very stiff SILTY CLAY																																																				
		-15	1 1 1		79.8		-40 	5 8 12	1.7B	19.2																																																
																																																			2 4 4		22.2	Pressuremeter Test performed at 41.75 ft po = 3.0 tsf / pf = 7.0 tsf / pl = 13.2 tsf Ed = 143 tsf / E+ = 352 tsf				
		-20 	3 9 9			Ed = 140 tol 7 E 1 = 502 tol	-45 	5 8 10	3.6B	12.7																																																
	566.71		3 1 1		25.6																																																					
FILL: Gray, medium CLAY - gravel noted		-25				540.71	-50																																																			

STRUCTURE SOIL BORING LOG AECOM PROJ NO. 60225454 STRUCTURE NO. <u>016-1505</u>

ROUTE <u>FAL55</u>

SECTION <u>2010-080-B</u>

COUNTY <u>COOK</u> D B E L P O T W Qu H S tsf
 Boring No.
 STR-40

 Station
 109+90.60

 Offset
 27.59ft RT
 Elevation 540.71 ft Gray, stiff to medium SILTY CLAY 1.5B 23.0 .9B 24.2 .7B 25.1 Gray, stiff SILTY CLAY 1.9B 21.5 Pressuremeter Test
performed at 66.08 ft
po = 3.0 tsf / pf = 8.0 tsf /
pl = 17.2 tsf
Ed = 149 tsf / E+ = 397 tsf

Apparent weathered
BEDROCK
Pressuremeter Test
por = 6.0 tsf / pf = > 64 tsf
/ pl = tsf
Ed = tsf / E+ = tsf
Pressurized test area to 64
tsf and did not reach Pf SPT. (N) = Sum of last two blow values in sample. (Qu) B=Bulge S=Shear P=Penetration Test Stations, Depths, Offset, and Elevations are in Feet

AECOM

AECOM

Page 2 of 3
Date <u>4/10/13</u>

SCALE

		STRUCTURE ROCK CORI	NG LO	G				ge 3 of 3 4/10/13
ROUTE _	FAI 55 DESC	RIPTION <u>I-94 (DAN RYAN EXPRESSV</u>	VAY) TO	US 41 (L	AKE S	HORE	DRIVE)	
SECT. 201	0-080-B	STRUCT. NO. <u>016-1505</u>	D	RILLED I	BY _	STRAT	A - BAKE	R
COUNTY	COOK							
Boring No. Station Offset	109+90.60 27.59ft RT	Core Diameter 2.16 in			R E C O	R . Q .	CORE T	COMP. S T R
Surface Ele	ev. <u>590.71</u> ft				V E	D .	M E	N G
Top Elev. ft	Coring	Notes and Rock Description		Core Run (#)	R Y (%)	(%)	(Min/ ft)	T H (tsf)
520.21		fractured, vuggy to slightly vuggy, slightly y weathered, good to poor DOLOMITE		1	98	78		
			-75.0 					
			- <u>75.0</u>					
			_					
			=					
			-80.0	2	92	38		
			<u>-80.0</u>					
			=					
506.21	End of Boring Mobile B-61 drill rig used	d for drillina	<u>-85.0</u>					
	Automatic Mobile hamm Casing used: 30 ft of 4 in	ner used for SPT	_					
	Borehole grouted upon		-90.0					
			<u>-90.0</u>					

Color pictures of the cores Yes - See Appendix

Cores will be stored for examination until

Minimum 60 days

USER NAME = HENAOC	DESIGNED	-	KP	REVISED	-	-
	DRAWN	-	CRH	REVISED	-	-
PLOT SCALE = 0:2 ':" / in.	CHECKED	-	<u>MJE</u>	REVISED	-	-
PLOT DATE = 10/16/2017	DATE	- :	10 <u>/20/2017</u>	REVISED	-	-

	ВС	RING LO	GS		F.A.I. RTE.	SECTION	COUNTY	TOTAL SHEETS	SHEET NO.
					55	2015-036LS	соок	_84_	83
							CONTRAC	T NO. 6	2A93
SHEET NO	OF _	SHEETS	STA.	TO STA		ILLINOIS FED. A	ID PROJECT		

A=COM STRUCTURE SOIL BORING LOG Page 1 of 3 Date ____4/3/13___ AECOM PROJ NO. 60225454 ROUTE FAI 55 DESCRIPTION I-94 (DAN RYAN EXPRESSWAY) TO US 41 (LAKE SHORE DRIVE) ____ STRUCT. NO. 016-0746 & 016-0749 ____ DRILLED BY ____STRATA - FRANKS COUNTY COOK LOCATION CHICAGO, ILLINOIS Surface Water Elev. L 0 W S Groundwater Elev.: L O W S Station 580.1 when drilling Qu tsf at Completion Surface Elev. <u>590.58</u> ft after __ TOPSOIL FILL: Gray, saturated, very loose to medium dense SAND, SILT and CLAY FILL: Black, brown and gray, moist to wet, medium dense to very loose SAND, GRAVEL, CINDER and BRICK Gray, saturated, loose to very loose SILTY CLAY LOAM to SILTY LOAM 32.4 558.08 30.6 Gray, soft CLAY FILL: Black, saturated, very loose SAND, GRAVEL and SILT FILL: Gray, saturated, very loose to medium dense SAND, SILT and CLAY DIST 49.5 WÖH 46.4 Gray, wet, loose SILTY LOAM - trace shells noted won. Gray, soft to medium SPT. (N) = Sum of last two blow values in sample. (Qu) B=Bulge S=Shear P=Penetration Test Stations, Depths, Offset, and Elevations are in Feet

A=COM STRUCTURE SOIL BORING LOG AECOM PROJ NO. 60225454 Boring No. ___ Qu tsf Elevation <u>540.58</u> ft Gray, soft to medium SILTY CLAY 1.75P 23.9 .7B 25.1 _528.08 Gray, hard SILTY CLAY -20.1 _522.58 520.58

SPT. (N) = Sum of last two blow values in sample. (Qu) B=Bulge S=Shear P=Penetration Test Stations, Depths, Offset, and Elevations are in Feet

AECOM

Page 2 of 3

Date ____4/3/13

Page 3 of 3 Date <u>4/3/13</u> STRUCTURE ROCK CORING LOG DESCRIPTION 1-94 (DAN RYAN EXPRESSWAY) TO US 41 (LAKE SHORE DRIVE) ROUTE FAI 55 STRUCT. NO. 016-0746 & 016-0749 DRILLED BY STRATA - FRANKS SECT. 2010-080-B COUNTY COOK Core Type NX
Core Diameter 2.16 in
Core Length 15 ft CORE COMP. Boring No. _ Q Offset R N G T Ď Surface Elev. 590.58 ft Ε Core Run (#) Top Elev. Coring Notes and Rock Description (Min/ ft) H (tsf) 93 45 520.58 Gray, hard, horizontally fractured, occasional dipping fracture, vuggy, slightly weathered, poor, DOLOMITE -75.0 -80.0 86 43 505.58 End of Boring
Diedrich D-50 drill rig used for drilling
Automatic Diedrich hammer used for SPT
Driller converted to rotary wash drilling at 12.5 ft depth Borehole grouted upon completion

Color pictures of the cores

Yes - See Appendix

Cores will be stored for examination until

Minimum 60 days

AECOM303 EAST WACKER DRIVE, SUITE 1400
CHICAGO, IL 60601-5276
PHONE: 1312 373-700 FAN; 1312: 373-6800

USER NAME = HENAOC	DESIGNED - <u>KP</u>	REVISED
	DRAWN - <u>CRH</u>	REVISED
PLOT SCALE = 0.16667 '/ in.	CHECKED - MJE	REVISED
PLOT DATE = 10/16/2017	DATE - 10 <u>/20/2017</u>	REVISED

STATE OF ILLINOIS								
DEPARTMENT OF	TRANSPORTATION							

BORING LOGS					F.A.I. RTE.	SECTION	COUNTY	TOTAL SHEETS	SHEET NO.	
						55	2015-036LS	соок	_84	84
								CONTRAC	T NO. 6	2A93
	SHEET NO.	OF _	SHEETS	STA	TO STA.	ILLINOIS FED. AID PROJECT				