


STAGE 1

PRIOR TO STAGE 1 CONSTRUCTION

1. PLACE PERIMETER EROSION BARRIER ON DISTURBED SLOPES AS SHOWN ON EROSION CONTROL PLANS.
2. INSTALL PROPOSED BASE COURSE (OPTION) AND PRE-STAGE 6" HMA SHOULDER ON THE WEST SIDE FROM EDGE OF PAVEMENT TO EXISTING GUARDRAIL, USING TRAFFIC CONTROL STANDARD 701201.

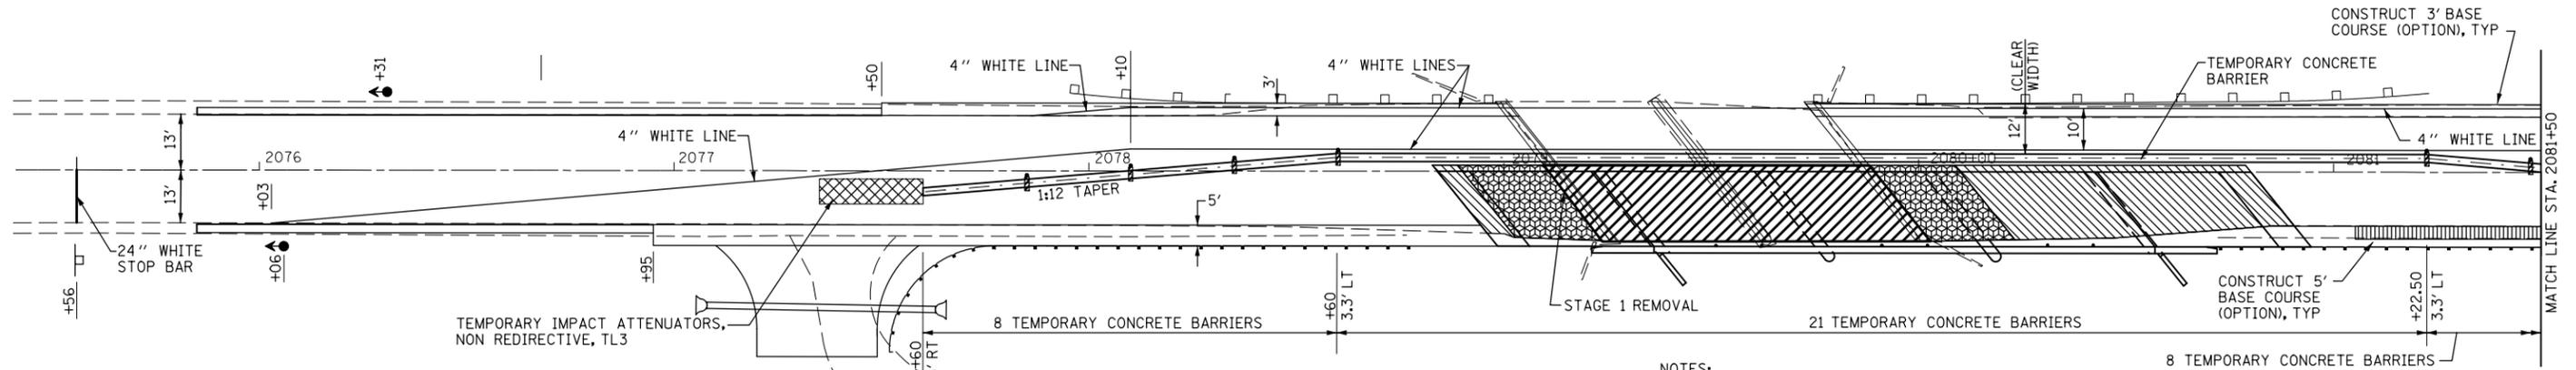

LEGEND

- (4) VERTICAL PANELS W/LIGHTS @ 25' CENTERS ON TCB FOR THE LAST 100' OF TAPER PRIOR TO TANGENT
- PAVEMENT REMOVAL
- STRUCTURE REMOVAL
- PAVED SHOULDER REMOVAL
- APPROACH SLAB REMOVAL

STAGE 1 CONSTRUCTION OF EAST SIDE

1. INSTALL BARRICADES SIGNS, TRAFFIC SIGNALS AND TEMPORARY MARKINGS AS DETAILED ON TRAFFIC CONTROL AND PROTECTION STANDARD 701321.
2. PLACE TEMPORARY CONCRETE BARRIERS. ANCHORS WILL BE REQUIRED.
3. EXISTING GUARD RAIL ON WEST SIDE TO REMAIN IN PLACE DURING STAGE 1 CONSTRUCTION.
4. INSTALL TEMPORARY SOIL RETENTION SYSTEM AS SHOWN ON SHEET 16 S.N. 010-0286 STRUCTURAL PLANS.
5. REMOVE GUARDRAIL, APPROACH PAVEMENT AND EAST SIDE OF EXISTING STRUCTURE. CONSTRUCT PROPOSED STRUCTURE, APPROACH PAVEMENT, APPROACH PAVEMENT CONNECTORS, HMA SHOULDER SECTION, GUARDRAIL AND ALL OTHER COLLATERAL WORK FOR EAST SIDE OF THE ROADWAY AS SHOWN.


NOTES:

1. PLACE TRAFFIC CONTROL SIGNS AND DEVICES AS SHOWN IN STANDARD 701321.
2. ALL TEMPORARY BRIDGE TRAFFIC SIGNALS FOR STAGE 1 AND STAGE 2 SHALL BE CONSIDERED AS ONE UNIT.
3. BARRIER OFFSETS ARE FROM THE CENTER OF THE BARRIER. TEMPORARY PAVEMENT MARKINGS INCLUDED IN COST OF TRAFFIC CONTROL AND PROTECTION 701321.
4. EXISTING PAVEMENT MARKINGS THAT ARE IN CONFLICT WITH THE STAGED TRAFFIC PATTERNS DURING ALL PHASES OF STAGE CONSTRUCTION SHALL BE REMOVED AS SPECIFIED IN SECTION 783 OF THE STANDARD SPECIFICATIONS AND PAID FOR AS "PAVEMENT MARKING REMOVAL".
5. THE CONTRACTOR SHALL MAINTAIN ACCESS TO ALL PRIVATE AND COMMERCIAL PROPERTIES DURING ALL PHASES OF CONSTRUCTION.



PLAN GRAPHIC SCALE

20' 10' 0' 20'

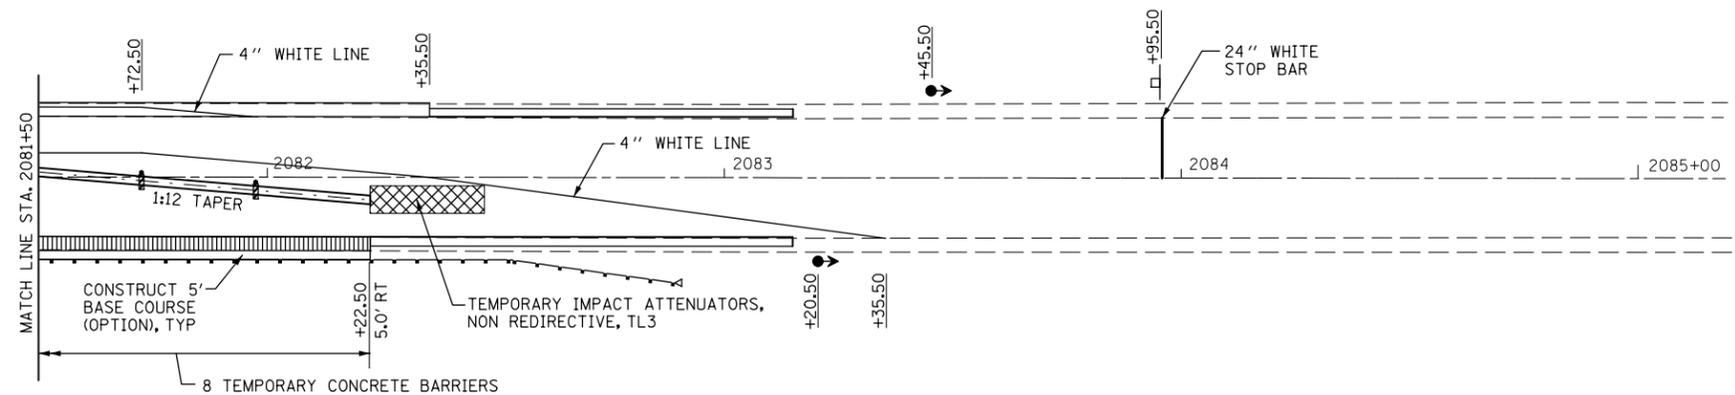

PLAN	SURVEYED	BY	DATE
	PLOTTED		
	CHECKED		
	NO. _____		

PROFILE	SURVEYED	BY	DATE
	PLOTTED		
	CHECKED		
	NO. _____		

HURST-ROSCHKE ENGINEERS, INC.
HILLSBORO, ILLINOIS 62049
(217)532-3959 FAX (217)532-3212



FILE NAME =	USER NAME = keysrb	DESIGNED - JJC	REVISED -
c:\pwork\pwork\keysrb\d0101443\0570582	sh1-staging.l.dgn	DRAWN - TWC	REVISED -
	PLOT SCALE = 40.0000' / in.	CHECKED - MAR	REVISED -
	PLOT DATE = 6/2/2011	DATE - 5-13-11	REVISED -

STATE OF ILLINOIS
DEPARTMENT OF TRANSPORTATION

STAGE 1 CONSTRUCTION PLAN

SCALE: 1"=20' SHEET NO. 1 OF 2 SHEETS STA. 2077+00 TO STA. 2083+00

F.A.P. RTE.	SECTION	COUNTY	TOTAL SHEETS	SHEET NO.
808	94BR-1	CHAMPAIGN	50	11
CONTRACT NO. 70582				
FED. ROAD DIST. NO. 5 ILLINOIS FED. AID PROJECT				