STATE OF ILLINOIS DEPARTMENT OF TRANSPORTATION DIVISION OF HIGHWAYS

PLANS FOR PROPOSED FEDERAL AID PROJECT


FAU 1453 (WEST 22ND STREET)
SPRING ROAD TO SALT CREEK
STREETSCAPE ENHANCEMENTS
SECTION NO: 11-00043-00-LS
PROJECT NO: TE-00D1 (872)
VILLAGE OF OAK BROOK
DUPAGE COUNTY
JOB NO: C-91-501-11

INDEX OF SHEETS

HEET NO.	SHEET DESCRIPTION
1	COVER SHEET
2	SUMMARY OF QUANTITIES, GENERAL NOTES
	AND HIGHWAY STANDARDS
3	EXISTING CONDITIONS
4	TYPICAL SECTIONS
5-6	LAYOUT AND MATERIALS PLAN
7-8	LANDSCAPE PLAN
9	LANDSCAPE DETAILS AND NOTES
10-11	ELECTRICAL PLAN
12	ELECTRICAL DETAILS AND NOTES
13-14	IRRIGATION PLAN
15	IRRIGATION LEGEND AND NOTES
16	IRRIGATION DETAILS
17-20	CONSTRUCTION DETAILS
	HIGHWAY STANDARDS

TRAFFIC DATA

ADT = 29,700 VPD (2011)
POSTED SPEED LIMIT = 40 MPH
FUNCTIONAL CLASSIFICATION = MINOR ARTERIAL

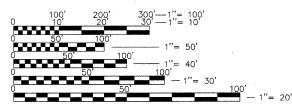

FULL SIZE PLANS HAVE BEEN PREPARED USING STANDARD ENGINEERING SCALES. REDUCED SIZED PLANS WILL NOT CONFORM TO STANDARD SCALES. IN MAKING MEASUREMENTS ON REDUCED PLANS, THE ABOVE SCALES MAY BE USED.



CONTACT JULIE 48 HOURS (2 WORKING DAYS) BEFORE YOU DIG AT 811 OR 800-892-0123 WITH THE FOLLOWING:

COUNTY: DU PAGE VILLAGE: OAK BROOK TOWNSHIP: YORK




LOCATION MAP SCALE: 1" = 500' GROSS LENGTH OF IMPROVEMENT: 3,095 FT (0.586 MILES) NET LENGTH OF IMPROVEMENT: 3,095 FT (0.586 MILES)



EXISTING STRUCTURE NOS. 022-9901 022-9941

EXISTING STRUCTURE NO. 022-0084


PROJECT ENDS STA 2137+78.00

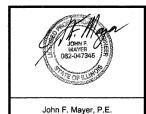

IL. P.E. NO. 062-047345 Expires November 30, 2013





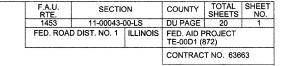



STATE OF ILLINOIS
DEPARTMENT OF TRANSPORTATION
DIVISION OF HIGHWAYS

PPROVED 20 11
VILLAGE REPRESENTATIVE

PASSED JANUARY 5 20 12

DISTRICT 1 ENGINEER OF LOCAL ROADS & STREETS

RELEASING FOR BID
BASED ON LIMITED

REVIEW JANUARY 6, 20 12

Diam M. O'Kesfe

DEPUTY DIRECTOR OF HIGHWAYS, REGION ONE ENGINEER

PRINTED BY THE AUTHORITY OF THE STATE OF ILLINOIS

HDG PROJECT NO: 03-0745-008-01-06

DATE: 12-19-11

IN OFFICE ENGINEER: CHARLES E RIDDLE DE 847,705,4406 SCHALIMBI

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CONTRACT NO. 63663

701901-02 TRAFFIC CONTROL DEVICES

000001-06 STANDARD SYMBOLS, ABBREVIATIONS AND PATTERNS

CONSTRUCTION SEQUENCING / TRAFFIC CONTROL NOTES

- 1. THE CONTRACTOR SHALL NOTIFY THE ENGINEER AT LEAST 72 HOURS IN ADVANCE OF BEGINNING WORK.
- 2. SPECIAL ATTENTION IS CALLED TO TRAFFIC REGULATION. TWO-WAY TRAFFIC SHALL BE MAINTAINED AT ALL TIMES ON ALL ROADWAYS. CONTRACTOR SHALL FOLLOW ALL APPLICABLE STATE TRAFFIC REGULATIONS SHOWN ON STANDARD 701601-07 AND PROVIDE FLAGMEN DURING CONSTRUCTION ACTIVITIES AS NEEDED TO MAINTAIN TWO-WAY TRAFFIC.
- 3. CONTRACTOR TO HAVE LIMITED ACCESS FOR STORAGE OF EQUIPMENT AND/OR MATERIALS. STAGING OF EQUIPMENT AND/OR MATERIALS WITHIN RIGHT OF WAYS (R.O.W.) SHALL BE GRANTED ON A LIMITED BASIS TO ACCOMODATE DAILY CONSTRUCTION ACTIVITIES WITH PRIOR APPROVAL BY THE ENGINEER. OVERNIGHT STORAGE IN R.O.W. IS PROHIBITED. CONTRACTOR MAY STORE MATERIALS AND EQUIPMENT AT THE VILLAGE OF OAK BROOK PUBLIC WORKS YARD LOCATED AT 3003 JORIE BOULEVARD WITH PRIOR APPROVAL FROM THE PUBLIC WORKS DIRECTOR (TEL. NO. 630-368-5270). STORAGE AT THE PUBLIC WORKS YARD IS AT CONTRACTOR'S RISK.
- 4. SIDEWALK CLOSURES SHALL BE GRANTED ON A LIMITED BASIS TO ACCOMMODATE DAILY CONSTRUCTION ACTIVITIES WITH PRIOR APPROVAL BY THE ENGINEER. SIDEWALK CLOSURES, IF NECESSARY, SHALL BE LIMITED TO ONE SIDE OF THE STREET AT A TIME. CONTRACTOR SHALL FOLLOW IDOT STANDARD 701801-05 TO REDIRECT PEDESTRIAN TRAFFIC ACCORDINGLY.
- 5. DAILY LANE CLOSURES WILL BE ALLOWED ONLY ON WEEKDAYS BETWEEN THE HOURS OF 9:00 AM AND 3:00 PM. TRAFFIC CONTROL SHALL BE IN ACCORDANCE WITH IDOT HIGHWAY STANDARDS 701901-02, 701801-05, AND 701601-07.

GENERAL NOTES

- VERIFY SITE CONDITIONS AND INFORMATION ON DRAWINGS. PROMPTLY REPORT ANY CONCEALED CONDITIONS, MISTAKES, DISCREPANCIES OR DEVIATIONS FROM THE INFORMATION SHOWN IN THE CONTRACT DOCUMENTS. THE DEPARTMENT IS NOT RESPONSIBLE FOR UNAUTHORIZED CHANGES OR EXTRA WORK REQUIRED TO CORRECT UNREPORTED DISCREPANCIES.
- 2. CONTRACTOR TO PROVIDE FOR AT LEAST ONE LANE OF TRAFFIC BOTH EAST-BOUND AND WEST-BOUND ON 22ND STREET AT ALL TIMES DURING CONSTRUCTION. ALL WORK ZONE TRAFFIC CONTROLS WILL CONFORM TO IDOT SECTION 700 WORK ZONE TRAFFIC CONTROL STANDARDS. OVERNIGHT LANE CLOSURES ARE PROHIBITIED UNLESS WRITTEN PERMISSION IS OBTAINED FROM THE ENGINEER. SEE TRAFFIC CONTROL PLANS FOR MORE DETAILS.
- THE CONTRACTOR WILL BE REQUIRED TO DISPOSE OF ALL MATERIALS EXCAVATED OR REMOVED DUE TO CONSTRUCTION OPERATIONS. ALL EXCESS EXCAVATED MATERIAL SHALL BE REMOVED FROM SITE ON THE DAY IT IS EXCAVATED. HAULING OR TRUCKING THE MATERIAL TO LOCATIONS, SHALL BE PROVIDED BY THE CONTRACTOR, OUTSIDE THE LIMITS OF IMPROVEMENT. THIS WORK SHALL BE INCLUDED IN THE COST OF THE REMOVED ITEMS.
- ALL SAW CUTS REQUIRED FOR REMOVAL ITEMS SHALL BE INCLUDED IN THE COST OF THAT ITEM. ALL SAW CUTS FOR PROPOSED ITEMS SHALL BE INCLUDED IN THE COST OF THAT ITEM.
- VILLAGE OF OAK BROOK WILL PROVIDE THE CONTRACTOR WITH WATER AND WATER METER, AND BATHROOM FACILITIES AT THE PUBLIC WORKS YARD LOCATED AT 3003 JORIE BOULEVARD.
- 7. THE RESIDENT ENGINEER SHALL CONTACT THE TRAFFIC CONTROL SUPERVISOR AT 847-705-4407 A MINIMUM OF 72 HOURS PRIOR TO THE PLACEMENT OF ANY TEMPORARY TRAFFIC CONTROL DEVICES.



BOXED NOTES INDICATE ITEMS OF WORK THAT ARE

		INCLUDED IN THE	COST OF ANOTHER PATTIE	ZIVI.
	DESIGNED - MEU		REVISED - 01-03-12	
	DRAWN - BLG		REVISED -	
7	CHECKED - TCK		REVISED -	
1	DATE - 12-19	L-11	REVISED -	

SUMMARY OF QUANTITIES

	ITEM	DESCRIPTION	UNIT	0031 TOTAL QUANTITY
	20200100	EARTH EXCAVATION	CUYD	788
	21101505	TOPSOIL EXCAVATION AND PLACEMENT	CUYD	394
Ķ	21101600	TOPSOIL FURNISH AND PLACE, VARIABLE DEPTH	SQ YD	1,350
k	25000400	NITROGEN FERTILIZER NUTRIENT	POUND	10
X	25000500	PHOSPHORUS FERTILIZER NUTRIENT	POUND	10
×	25000600	POTASSIUM FERTILIZER NUTRIENT	POUND	10
ĸ	25200100	SODDING, SALT TOLERANT	SQ YD	1,000
K	25200200	SUPPLEMENTAL WATERING	UNIT	6
	35101400	AGGREGATE BASE COURSE, TYPE B	TON	150
	60100080	FRENCH DRAINS	CUYD	10
	60100085	GEOTECHNICIAL FABRIC FOR FRENCH DRAINS	SQ YD	63
	60109510	PIPE UNDERDRAINS, FABRIC LINED TRENCH 4"	FOOT	1,867
	60603451	PRECAST CONCRETE CURB	FOOT	1,140
	67100100	MOBILIZATION	LSUM	1
	70102630	TRAFFIC CONTROL AND PROTECTION, STANDARD 701601	LSUM	1
	70102640	TRAFFIC CONTROL AND PROTECTION, STANDARD 701801	LSUM	1
*	81028210	UNDERGROUND CONDUIT, GALVANIZED STEEL, 2 1/2" DIA.	FOOT	286
*	81603035	UNIT DUCT, 600V, 2-1C NO 6, 1/C NO 6 GROUND, (XLP-TYPE USE), 1" DIA. POLYETHYLENE	FOOT	505
*	89502200	MODIFY EXISTING CONTROLLER	EACH	2
۲	A2004515	TREE, GINKGO BILOBA AUTUMN GOLD (AUTUMN GOLD GINKGO), 3" CALIPER, BALLED AND BURLAPPED	EACH	4
k	A2004568	TREE, GINKGO BILOBA MAGYAR ARISTOCRAT (MAGYAR ARISTOCRAT GINKO), TREE FORM, 3" CALIPER BALLED AND BURLAPPED	EACH	4

				0031
	ITEM	DESCRIPTION	UNIT	TOTAL
	Y I Latvi	DECOM FION	† Oran	QOARTIT
		TREE, ULMUS CARPINIFOLIA MORTON, (ACCOLADE ELM), 2-1/2"	 	
*	A2018720	CALIPER, BALLED AND BURLAPPED	EACH	6
ų		TREE, SYRINGA PEKINENSIS MORTON (CHINA SNOW PEKING LILAC), 7'	1	
*	B2006168	HEIGHT, CLUMP FORM, BALLED AND BURLAPPED	EACH	16
*	00000404	SHRUB, HYDRANGEA ARBORESCENS ANNABELLE (ANNABELLE	EACH	450
*	G2003424	SMOOTH HYDRANGEA), 2' HEIGHT CONTAINER	EACH	158
			ļ	
*	C2005224	SHRUB, POTENTILLA FRUTICOSA MCKAY'S WHITE (MCKAY'S WHITE BUSH CINQUEFOIL), 2' HEIGHT CONTAINER	EACH	74
		SHRUB, VIBURNUM PRUNIFOLIUM (BLACKHAW VIBURNUM), 6' HEIGHT,	 	
*	C2012772	BALLED AND BURLAPPED	EACH	10
¥£		SHRUB, ROSA AMBER ROSE (AMBER ROSE FLOWER CARPET ROSE),		
*	C2C06402	24° HEIGHT, CONTAINER	EACH	119
¥	D2015401	EVERGREEN, JUNIPERUS CHINENSIS KALLAYS COMPACTA, (KALLAY COMPACT JUNIPER), 24" WIDTH, BALLED AND BURLAPPED	EACH	25
	22010401	OCOM TO TOTAL EN, ET THE ITT STREETS THE STREET IT ES	1	
				
*	K0012990	PERENNIAL PLANTS, ORNAMENTAL TYPE, GALLON POT	UNIT	32.06
			 	
ж	K1001988	IRRIGATION SYSTEM SPECIAL	LSUM	1
*				
7	K1005481	SHREDDED BARK MULCH 3"	SQYD	1,340
×	X0326146	SOIL CONDITIONER	SQYD	1,340
*			+	
-	X0326357	ROADWAY LIGHTING MODIFICATIONS	LSUM	1
	X4240430	PORTLAND CEMENT CONCRETE SIDEWALK 5 INCH, SPECIAL	SQFT	7,285
			ļ	
	X4240460	PORTLAND CEMENT CONCRETE SIDEWALK 8 INCH, SPECIAL	SQFT	160
			T	
*	X5620035	WATER SERVICE CONNECTION, 1 1/2"	EACH	1
			1	
	XX000541	EXPLORATORY EXCAVATION	CUYD	5
	XXVUSEES	PRE-CONSTRUCTION VIDEO TAPING	LSUM	1
	AA003008	TO THE CONTROL HOLD WIDEO THE ING	LOUVI	'
			 	
	Z0013798	CONSTRUCTION LAYOUT	LSUM	11
			 	
	Z0017400	DRAINAGE & UTILITY STRUCTURES TO BE ADJUSTED	EACH	3
		* INDICATES SPECIALTY/TEMS		


INDICATES SPECIALTY ITEMS


STATE OF ILLINOIS **DEPARTMENT OF TRANSPORTATION** SUMMARY OF QUANTITIES, GENERAL NOTES, AND HIGHWAY STANDARDS

PROJECT - 03-0745-008

SCALE: N/A

COUNTY TOTAL SHEET NO. SECTION 11-00043-00-LS DUPAGE 20 2

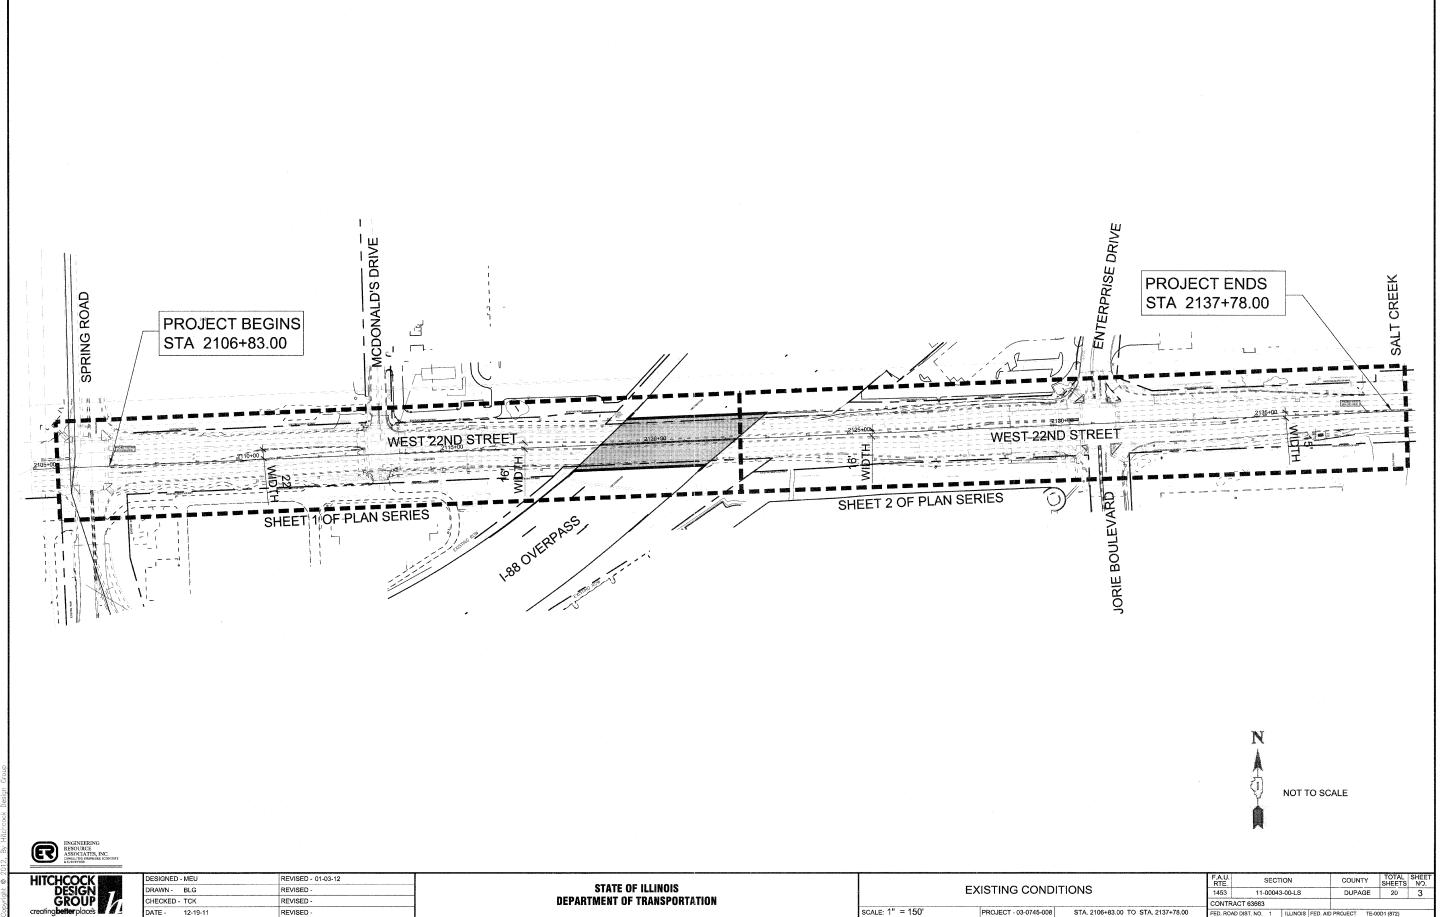

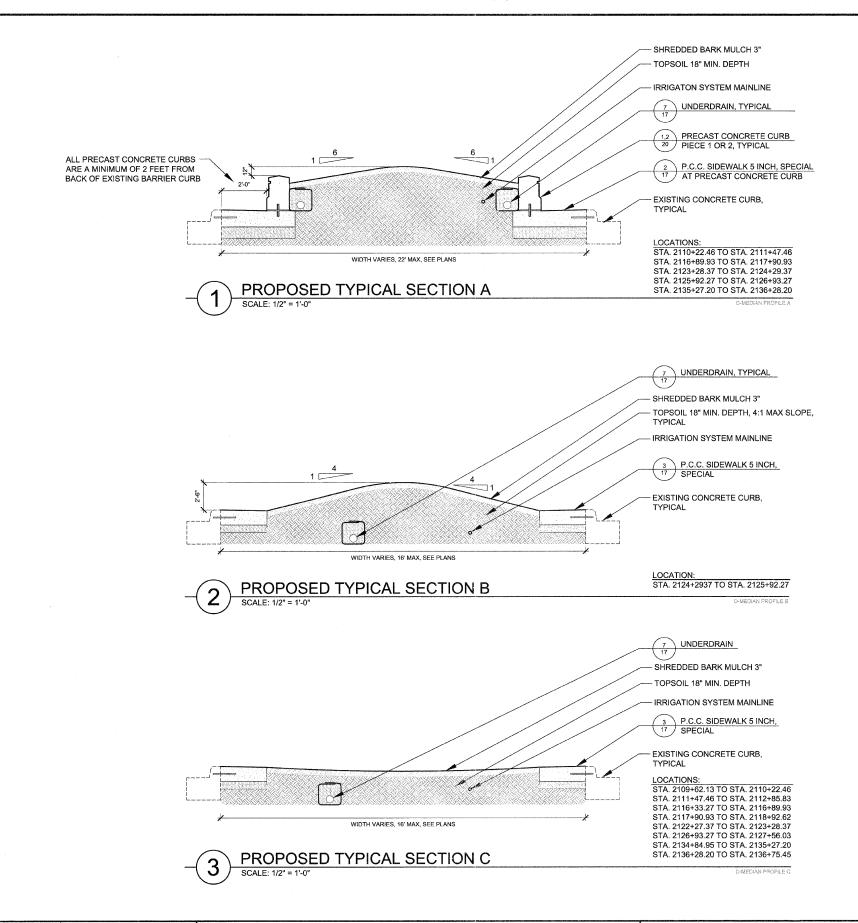

ENGINEERING
RESOURCE
ASSOCIATES, INC.
CONSULTABLE PARIMETERS, ACIENTIFOR
& HRAYPTORS

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DESIGN	
GROUP	
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STATE OF ILLINOIS
DEPARTMENT OF TRANSPORTATION

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SCALE: AS SHOWN


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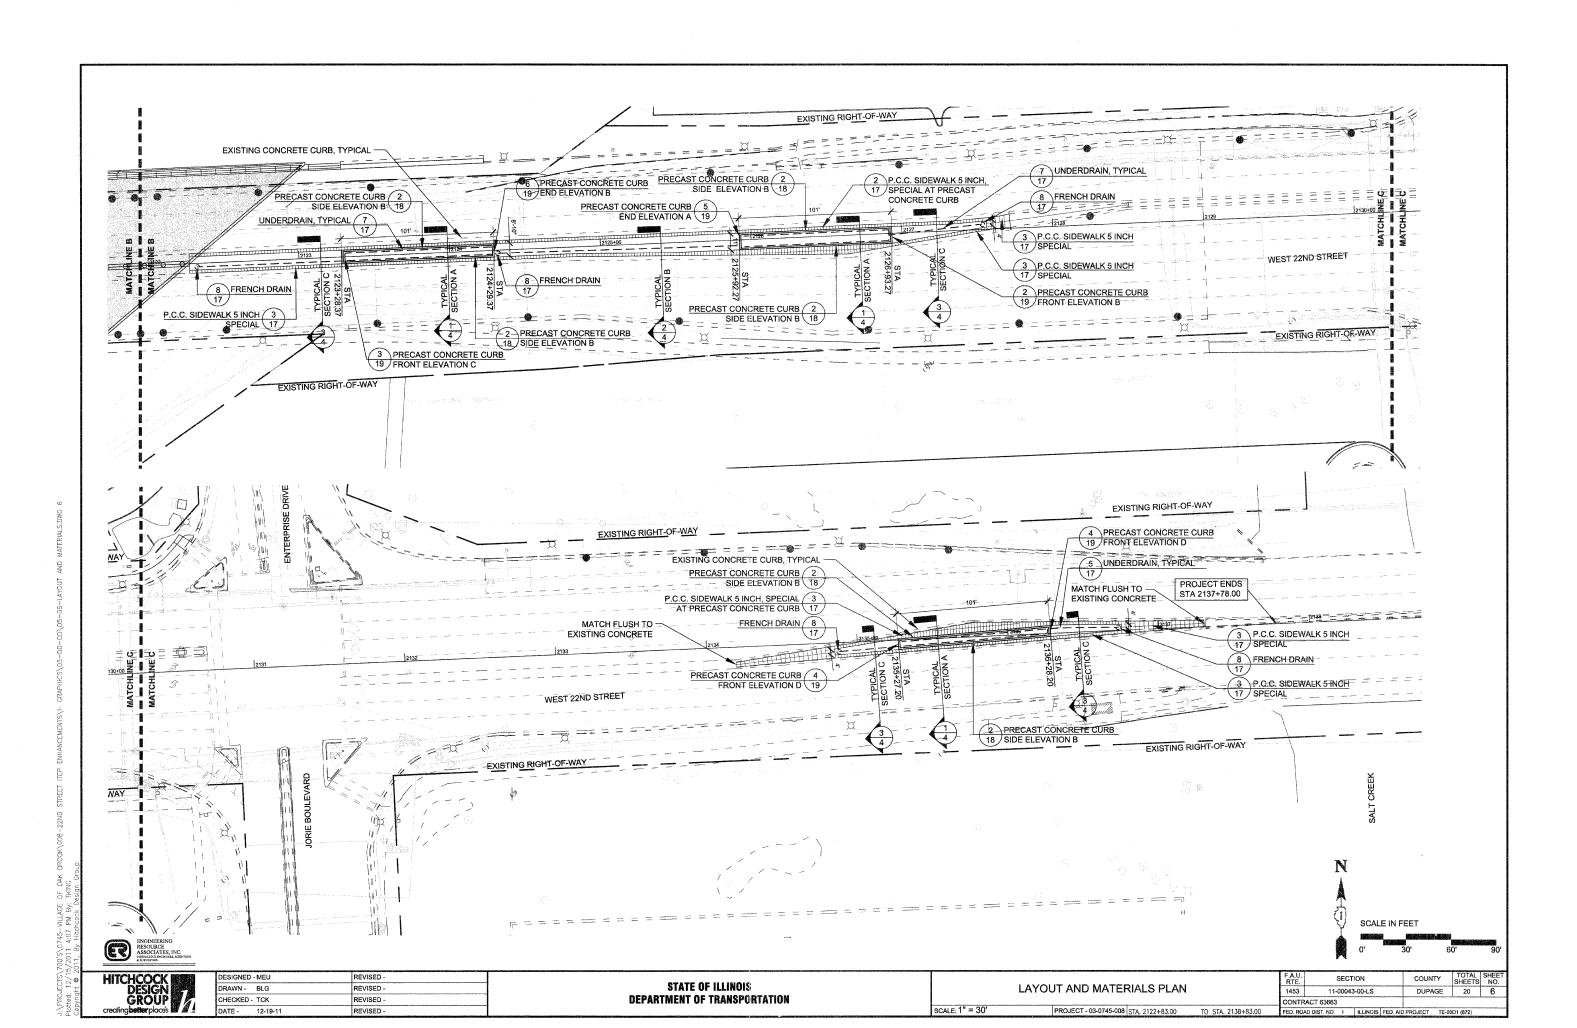
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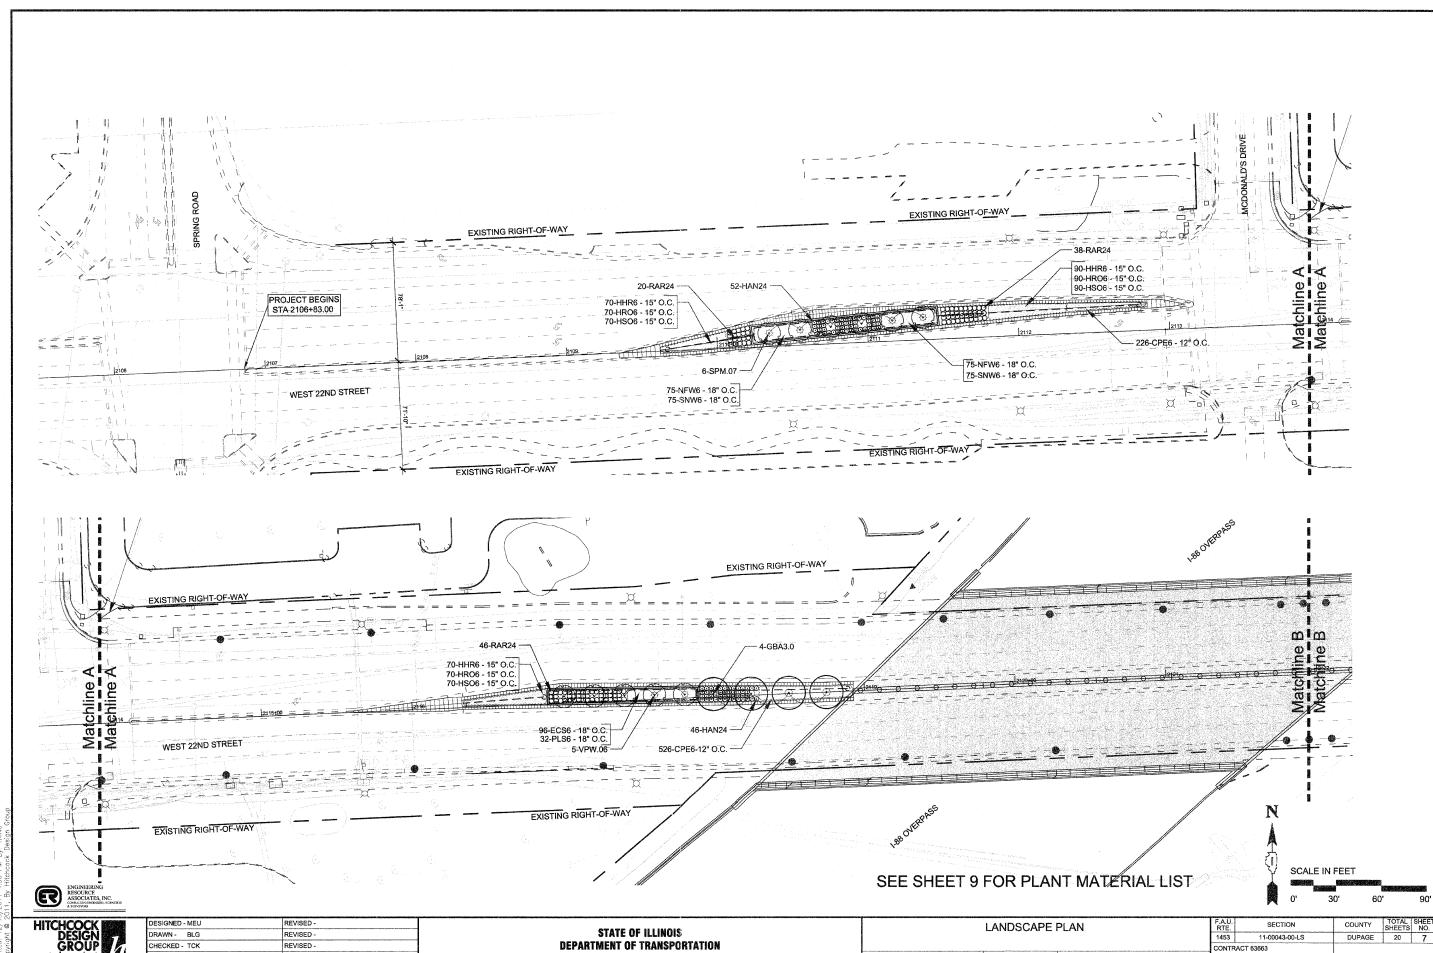
 CONTRACT 63663

 FED. ROAD DIST. NO.
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 ILLINOIS FED. AID PROJECT
 TE-0001 (872)

45-WLLAGE OF DAK BROOK\008-22ND STREET HEP ENHANCEMENTS\H GRAPH







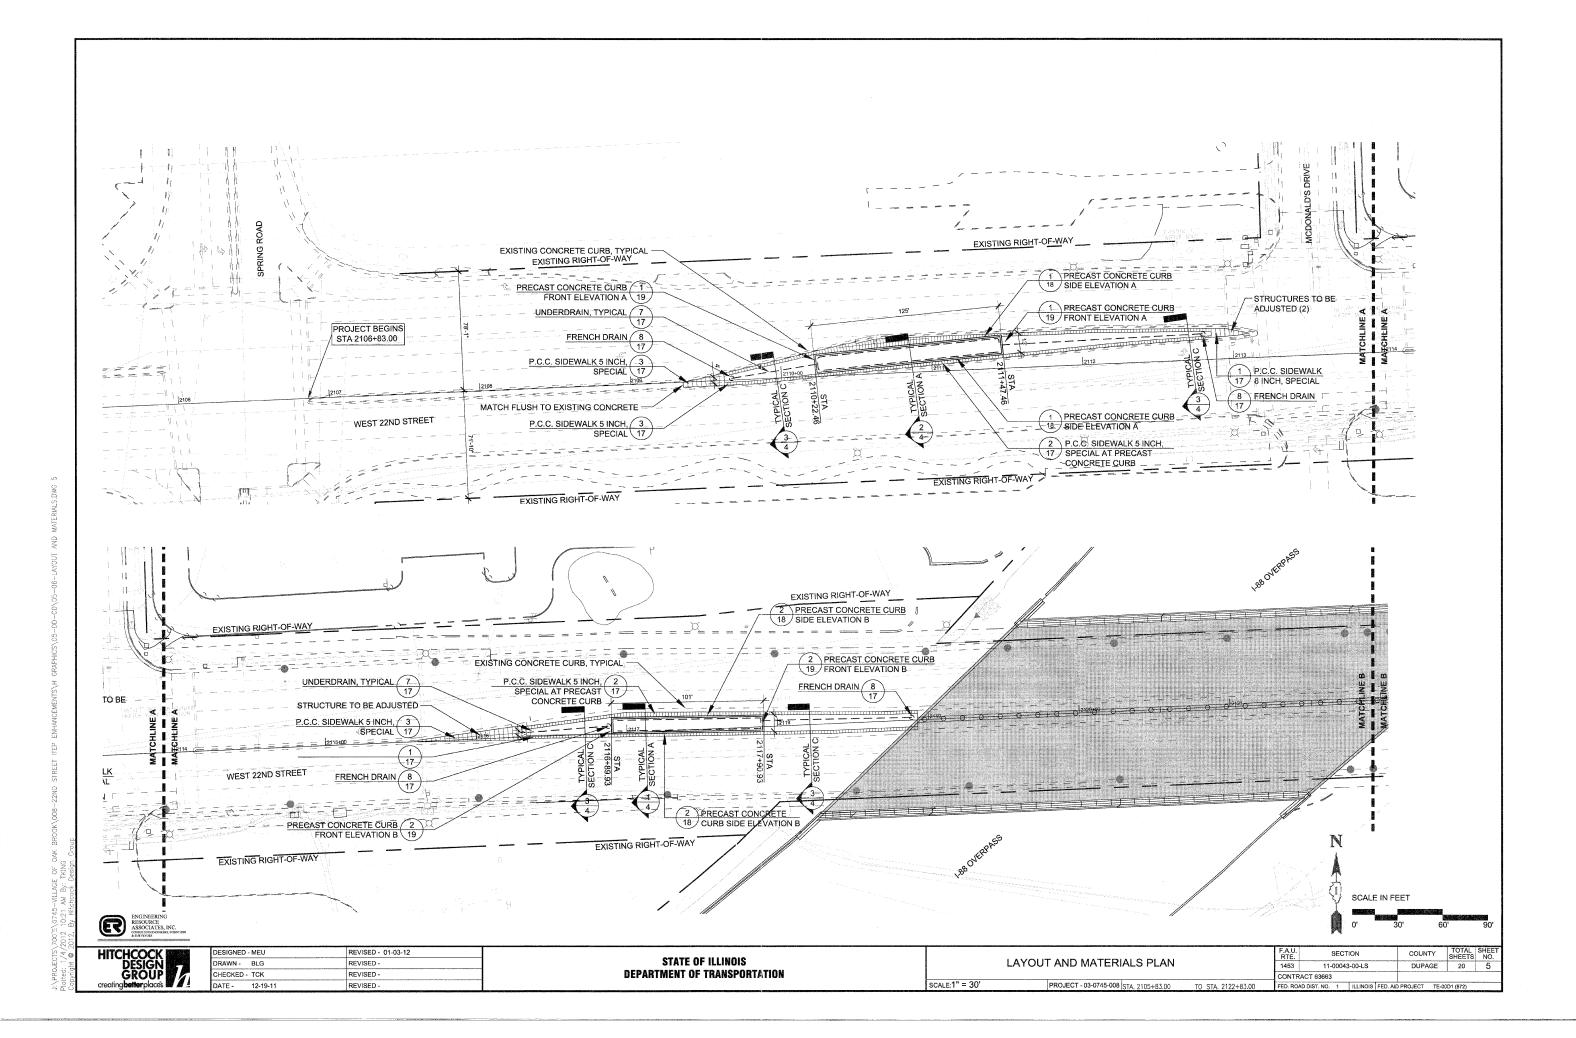

PROJECT - 03-0745-008 STA, 2105+83.00

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PERENNIAL PLANTING D-ANNUAL-PERENNIAL

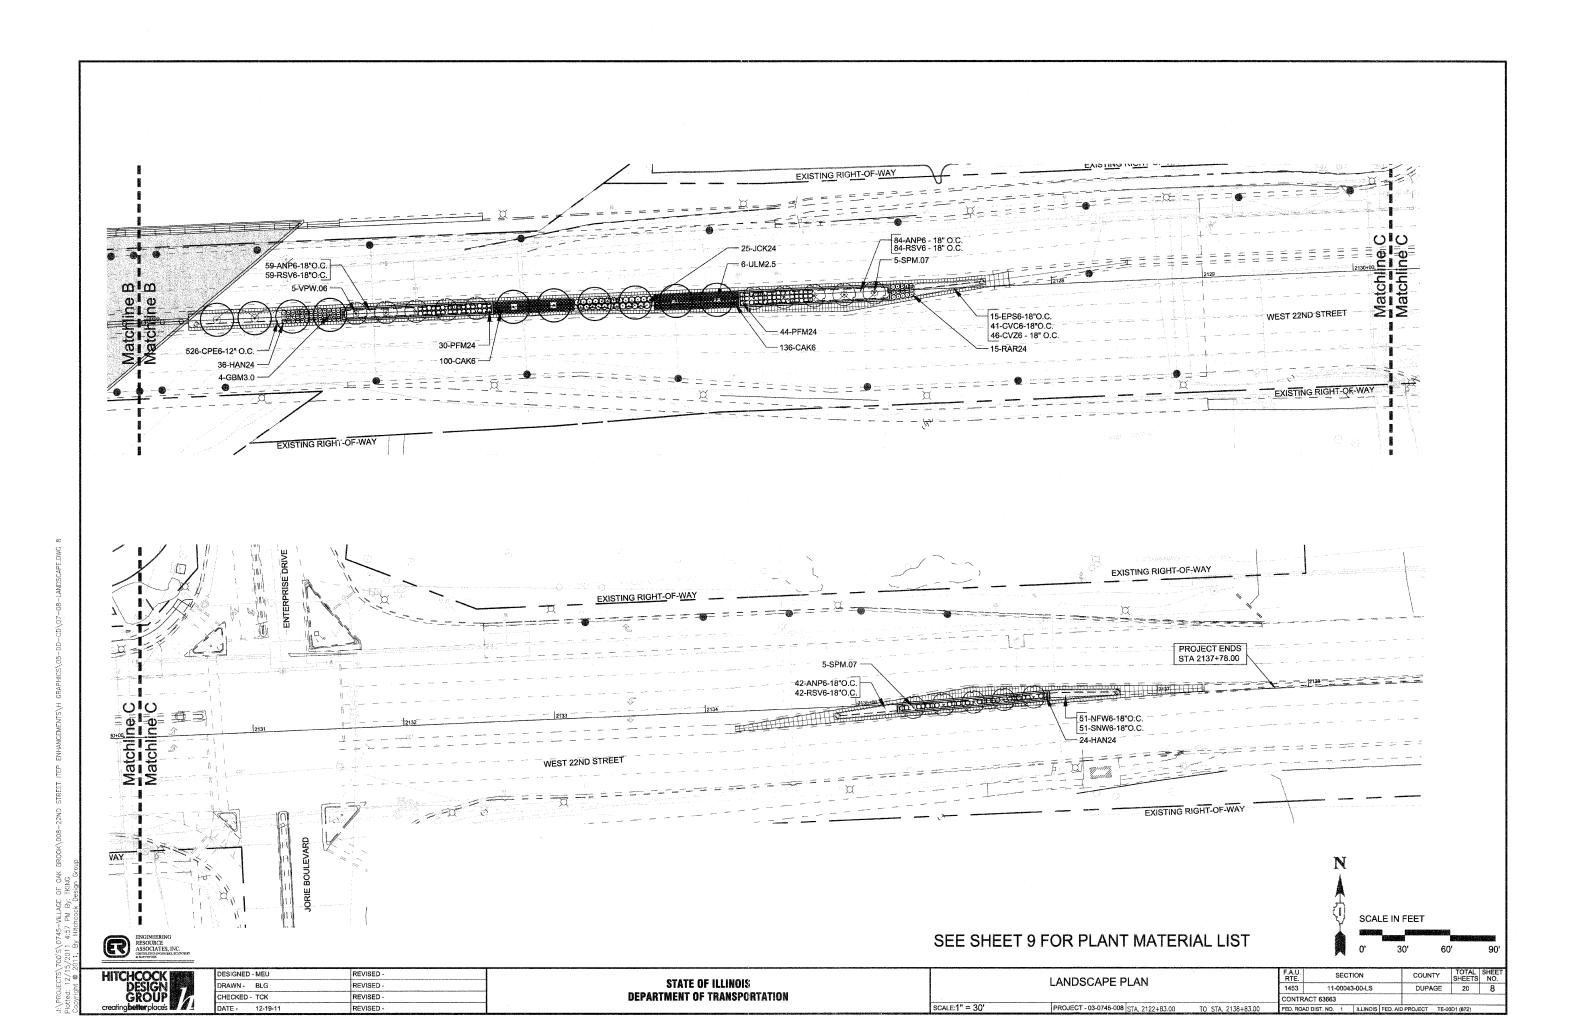
PLANT MATERIALS LIST

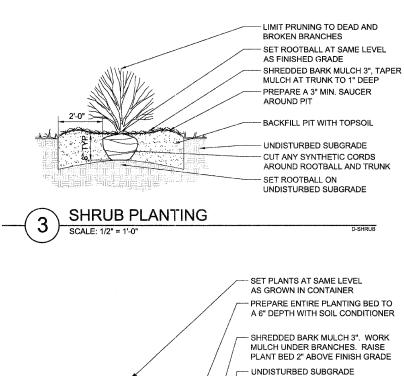CODE	BOTANICAL NAME	COMMON NAME	SIZE	QTY
SHADE	TREES		ļ	
GBA3.0	GINKGO BILOBA 'AUTUMN GOLD'	AUTUMN GOLD GINKGO	3" C	
GBM3.0	GINKGO BILOBA 'MAGYAR'	MAGYAR UPRIGHT GINKGO	3" C	
ULM2.5	ULMUS JAPONICA X WILSONIANA 'MORTON'	ACCOLADE™ ELM	2 1/2" C	6
INTER	MEDIATE TREES	The second is contained by the second of the		
SPM.07	SYRINGA PEKINENSIS 'MORTON'	CHINA SNOW PEKING LILAC	7'HT	16
DECID	UOUS SHRUBS	The contraction and an interest contract to the contract to th		
HAN24	HYDRANGEA ARBOR, 'ANNABELLE'	ANNABELLE SMOOTH HYDRANGEA	24" HT	158
PFM24	POTENTILLA FRUTICOSA 'MCKAY'S WHITE'	MCKAY'S WHITE BUSH CINQUEFOIL	24" HT	74
RAR24	ROSA 'AMBER ROSE'	AMBER ROSE FLOWER CARPET ROSE	24" HT	119
VPW.06	VIBURNUM PRUNIFOLIUM WILSON	WILSON BLACKHAW VIBURNUM	6' HT	10
EVERG	GREEN SHRUBS			
JCK24	JUNIPERUS CHINENSIS KALLAY COMPACT	KALLAY COMPACT CHINESE JUNIPER	24" HT	25
PEREN	INIALS		t En estraporte de como de la constitu	national actions and a
ANP6	ASTER NOVAE ANGLIAE 'PURPLE DOME'	PURPLE DOME NEW ENLGAND ASTER	1 GAL	185
CAK6	CALAMAGROSTIS X ACUTIFLORA 'KARL FOERSTER'	KARL FOERSTER FEATHER REED GRASS	1 GAL	236
CPE6	CAREX PENSYLVANICA "	OAK SEDGE	1 GAL	1278
CVC6	COREOPSIS VERTICILLATA 'CRÈME BRULEE'	CRÈME BRULEE THREADLEAF COREOPSIS	1 GAL	41
CVZ6	COREOPSIS VERTICILLATA 'ZAGREB'	ZAGREB THREADLEAF COREOPSIS	1 GAL	46
EPS6	ECHINACEA PARADOX	YELLOW CONEFLOWER	1 GAL	15
ECS6	ECHINACEA 'HARVEST MOON'	HARVEST MOON CONEFLOWER	1 GAL	96
HHR6	HEMEROCALLIS 'HAPPY RETURNS'	HAPPY RETURNS DAYLILY	1 GAL	230
HRO6	HEMEROCALLIS 'ROSEY RETURNS'	ROSEY RETURNS DAYLILIY	1 GAL	230
HSO6	HEMEROCALLIS 'STELLA DE ORO'	STELLA DE ORO DWARF DAYLILY	1 GAL	230
NFW6	NEPETA X FAASSENII 'WALKER'S LOW'	WALKER'S LOW CATMINT	1 GAL	201
PLS6	PEROVSKIA ATRIPLICIFOLIA 'LITTLE SPIRE'	LITTLE SPIRE RUSSIAN SAGE	1 GAL	32
RSV6	RUDBECKIA SPECIOSA VIETTE'S LITTLE SUZY'	VIETTE'S LITTLE SUZY BLACK-EYED SUSAN	1 GAL	185
SNW6	SALVIA NEMOROSA WESUWE'	WESUWE SALVIA	1 GAL	201
		TOTAL PF	RENNIALS:	3206

ALL PERENNIALS TO BE PAID FOR AS PERENNIAL PLANTS, ORNAMENTAL TYPE, GALLON POT (1 UNIT = 100 PLANTS)

PLANTING NOTES

- 1. SOD TO LIMITS OF DISTURBANCE FOR RESTORATION ONLY. CONTRACTOR IS RESPONSIBLE FOR RESTORATION OF ANY UNAUTHORIZED DISRUPTION OUTSIDE OF DESIGNATED CONSTRUCTION AREA.
- 2. CONTRACTOR IS RESPONSIBLE FOR EROSION CONTROL IN ALL DISTURBED AREAS. ALL DISTURBED AREAS ARE TO BE PROTECTED WITHIN 24 HOURS. DO NOT DISTURB MORE AREA THAN CAN BE COMPLETED AND PROTECTED WITHIN 24 HOURS.
- 3. PLANTS AND OTHER MATERIALS ARE QUANTIFIED AND SUMMARIZED FOR THE CONVENIENCE OF THE DEPARTMENT AND LOCAL AGENCY. CONFIRM AND INSTALL SUFFICIENT QUANTITIES TO COMPLETE THE WORK AS DRAWN AND SPECIFIED.
- 4. REFER TO THE SPECIAL PROVISIONS FOR ADDITIONAL CONDITIONS, STANDARDS AND NOTES.

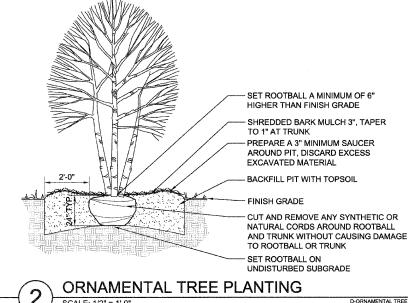



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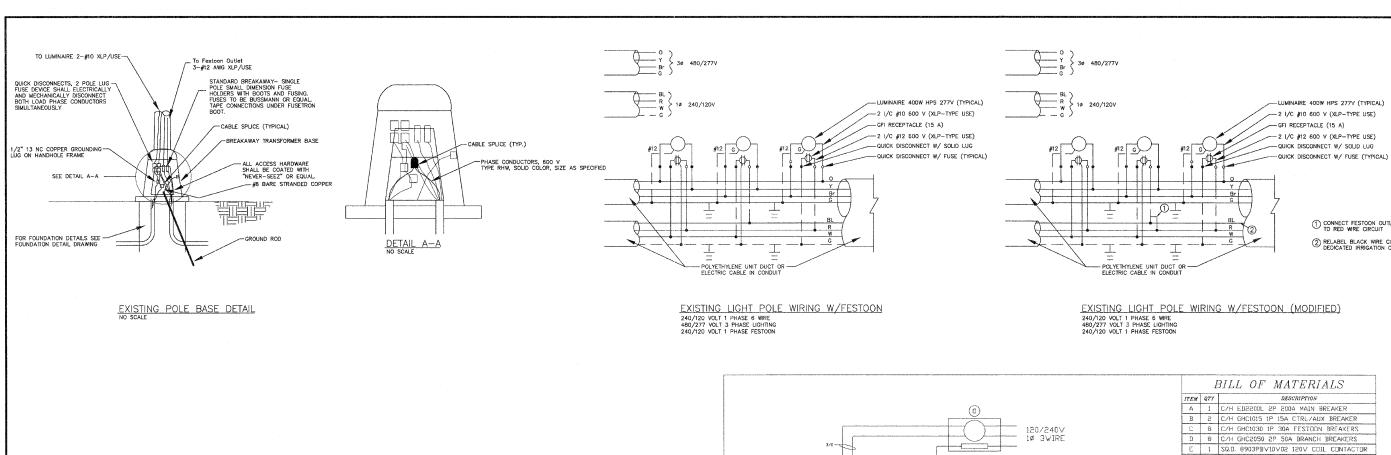
STATE OF ILLINOIS **DEPARTMENT OF TRANSPORTATION** LANDSCAPE DETAILS PROJECT - 03-0745-008


SECTION COUNTY DUPAGE 20 ONTRACT 63663

SCALE: AS SHOWN



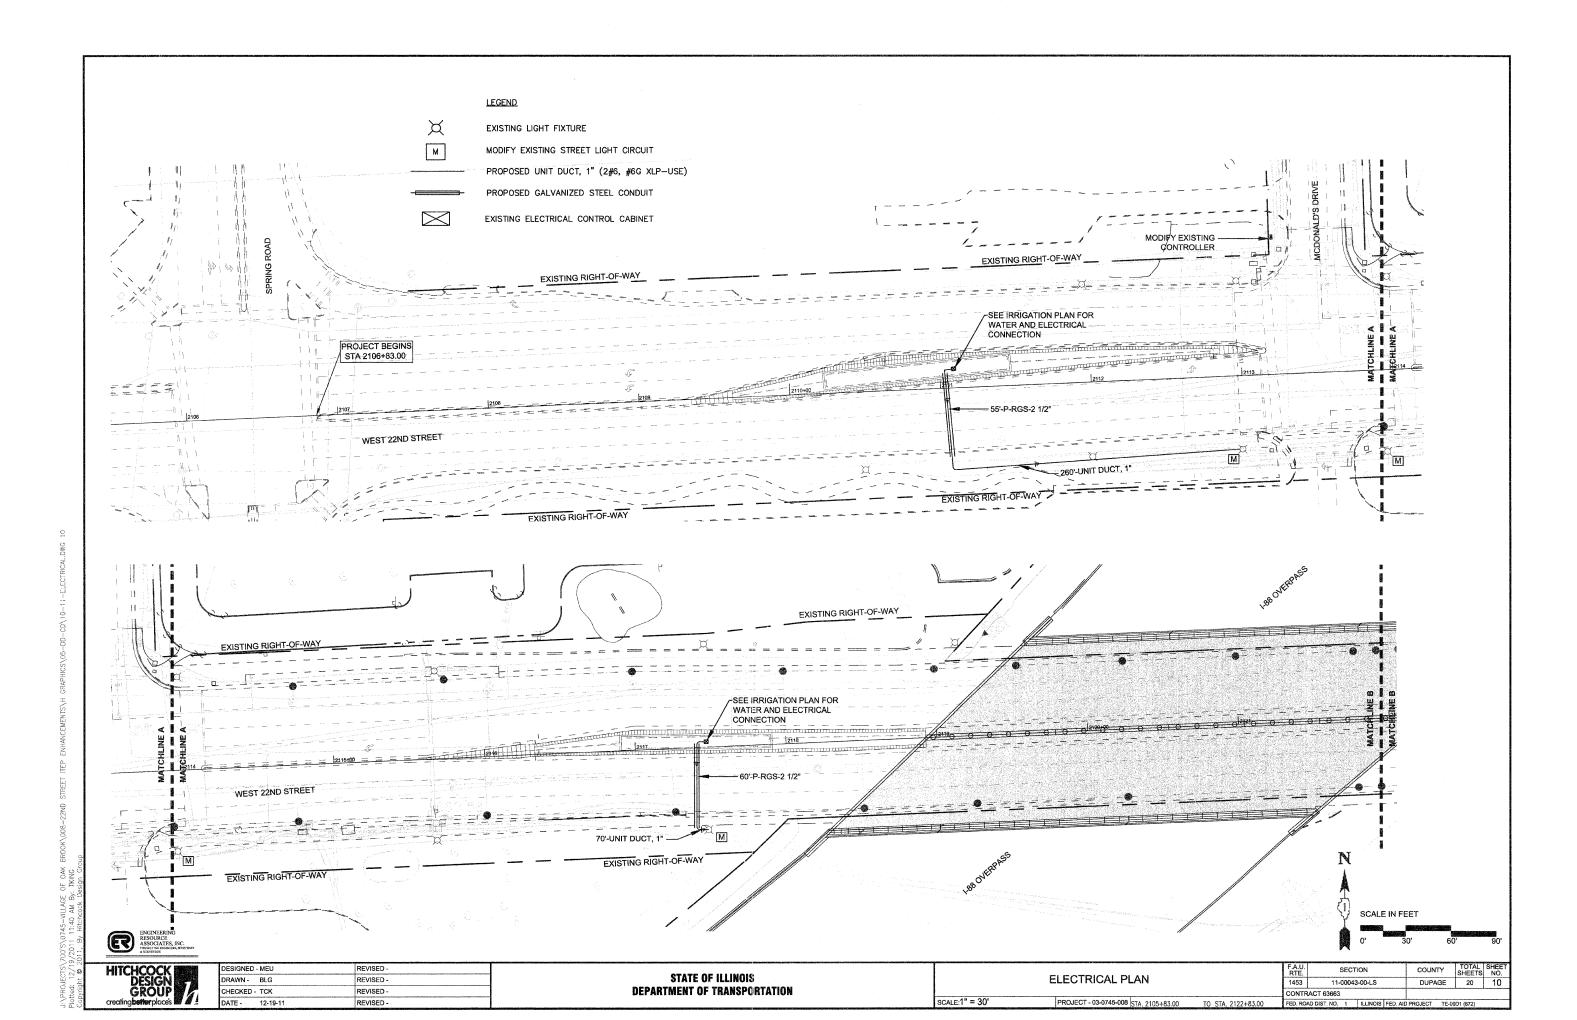

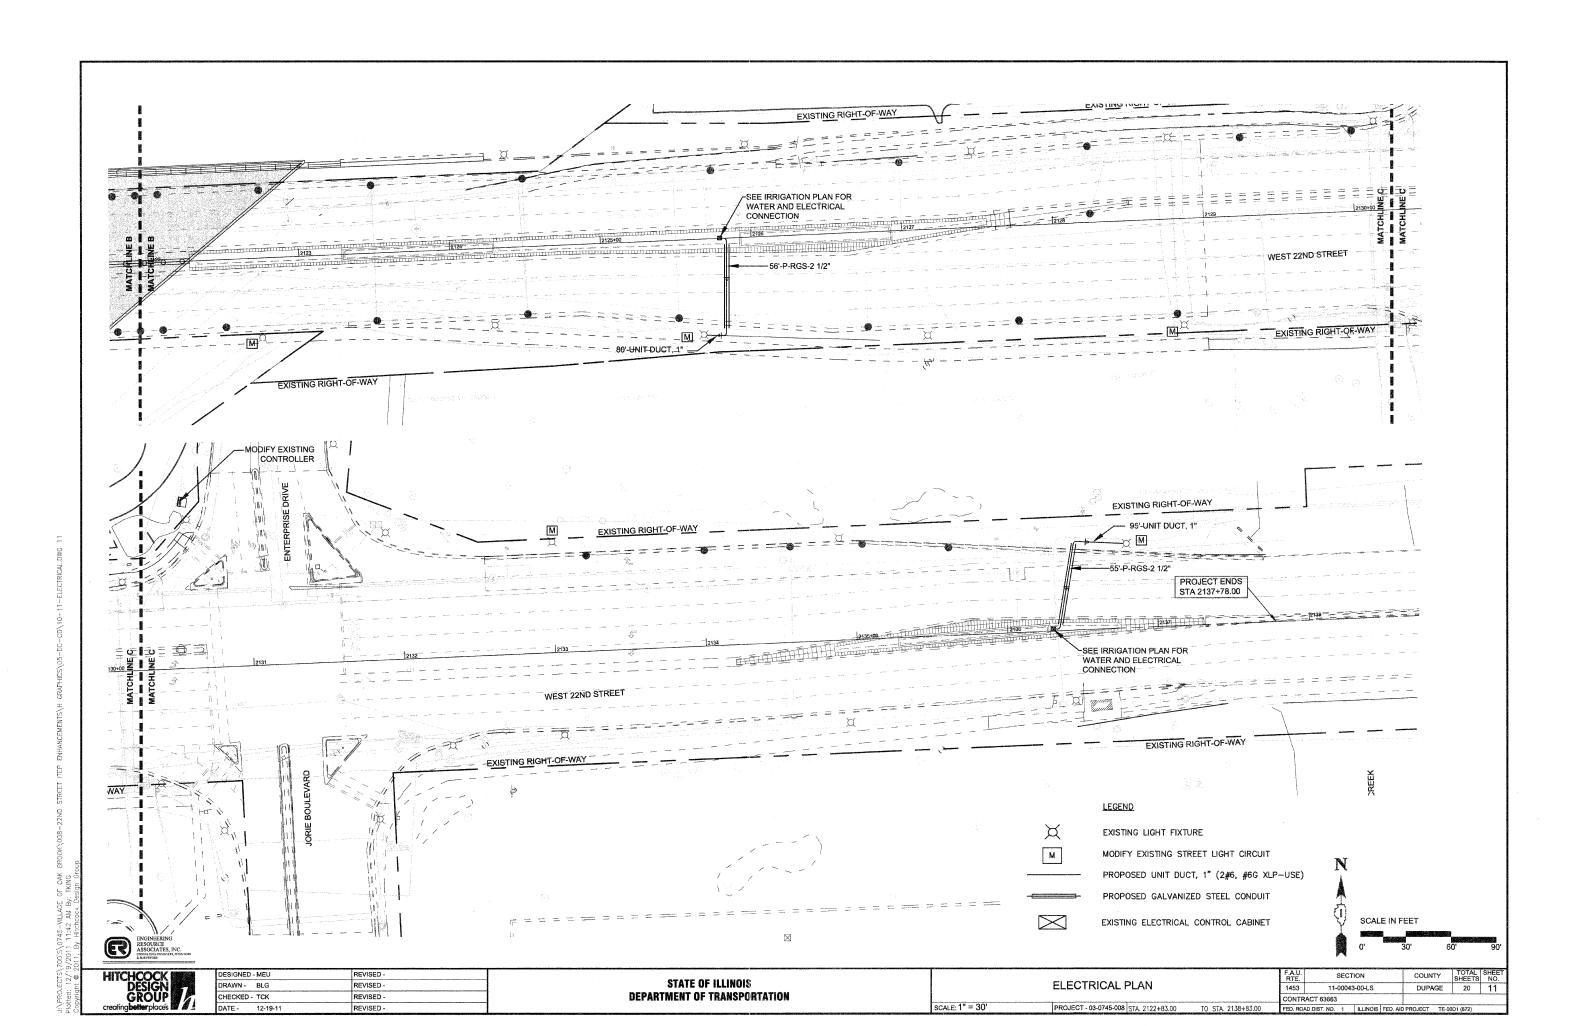


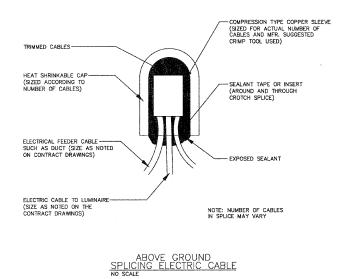


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TRENCH BACKFILL FOR STREETLIGHTING DETAIL NO SCALE



22ND STREET - ISTHA I-06-5518

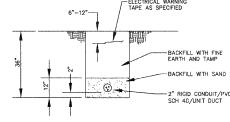FESTOON LIGHTING CONTROLLER DRAWING NUMBER 11201101JB

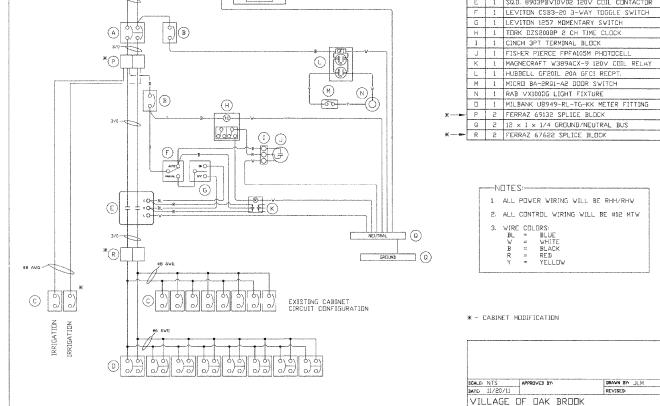



DESIGNED - MEU RAWN - BLG

HECKED - TCK

EXISTING FESTOON CABINET SCHEMATIC

	STATE OF ILLINOIS	ELECTRICAL DETAILS AND NOTES		F.A.U. RTE. 1453	SECTION 11-00043-00-LS	COUNTY	TOTAL SHEETS 20	SHEET NO.	matrix manufacture
_	DEPARTMENT OF TRANSPORTATION			CONTRACT	63663		***************************************		
		SCALE:AS SHOWN	PROJECT - 03-0745-008	FED. ROAD DI	ST. NO. 1 ILLINOIS FED. AID	PROJECT TE-0	0D1 (872)		1

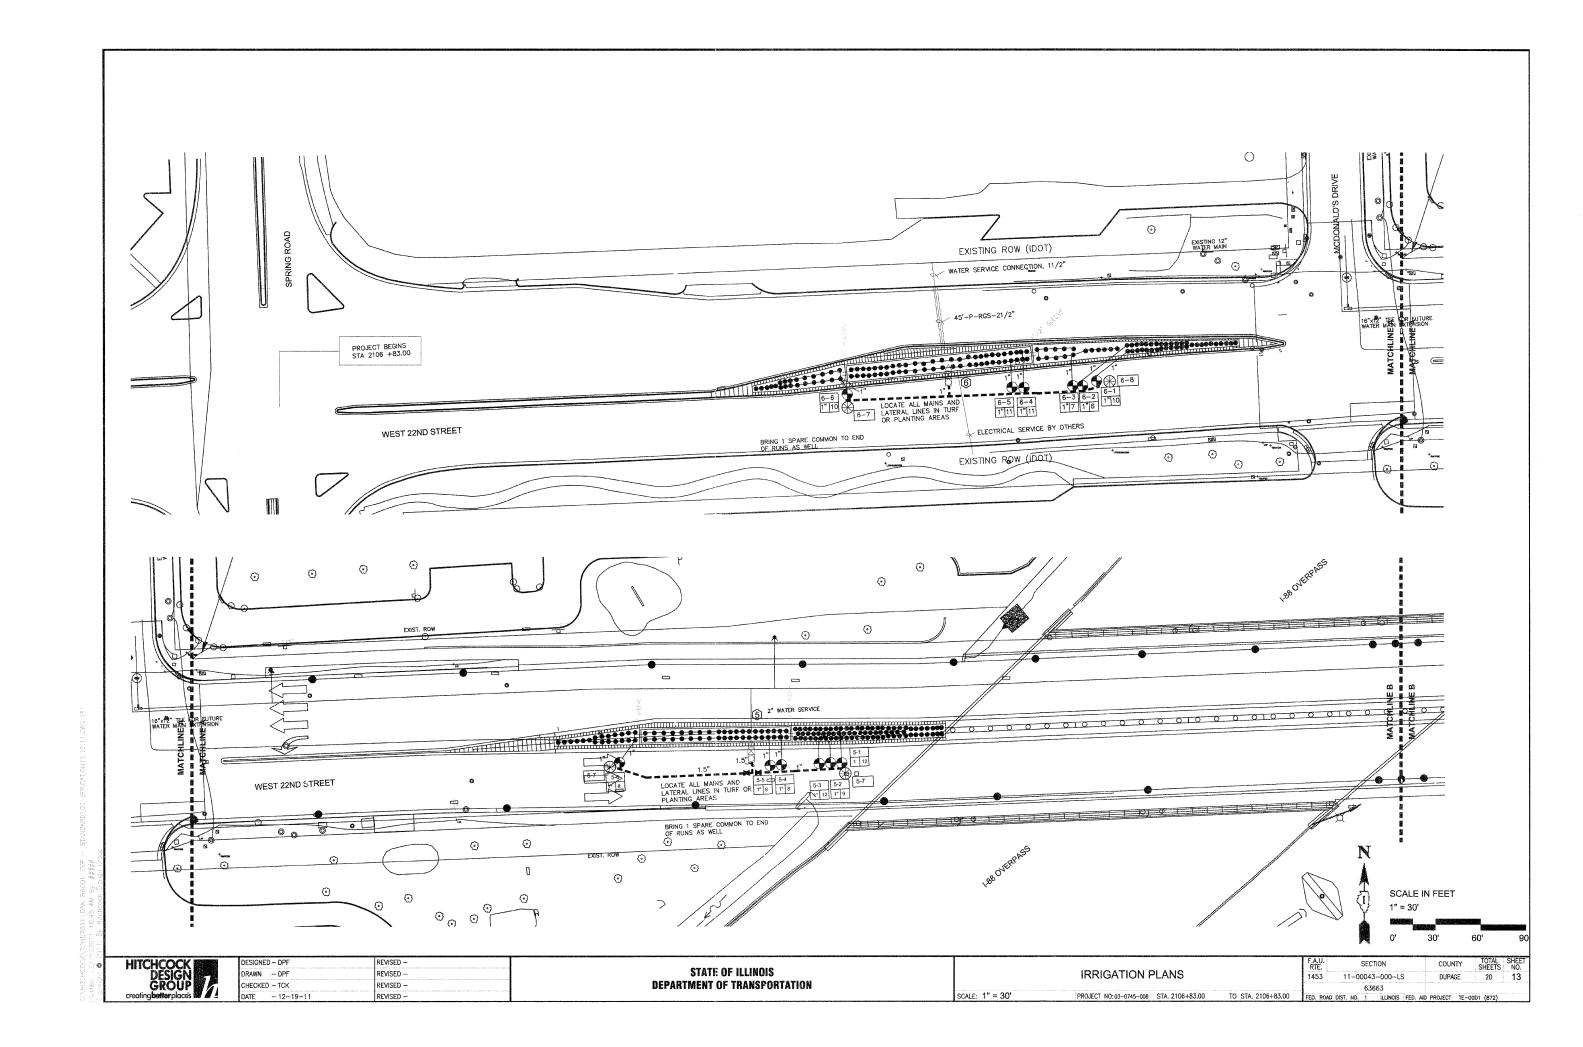

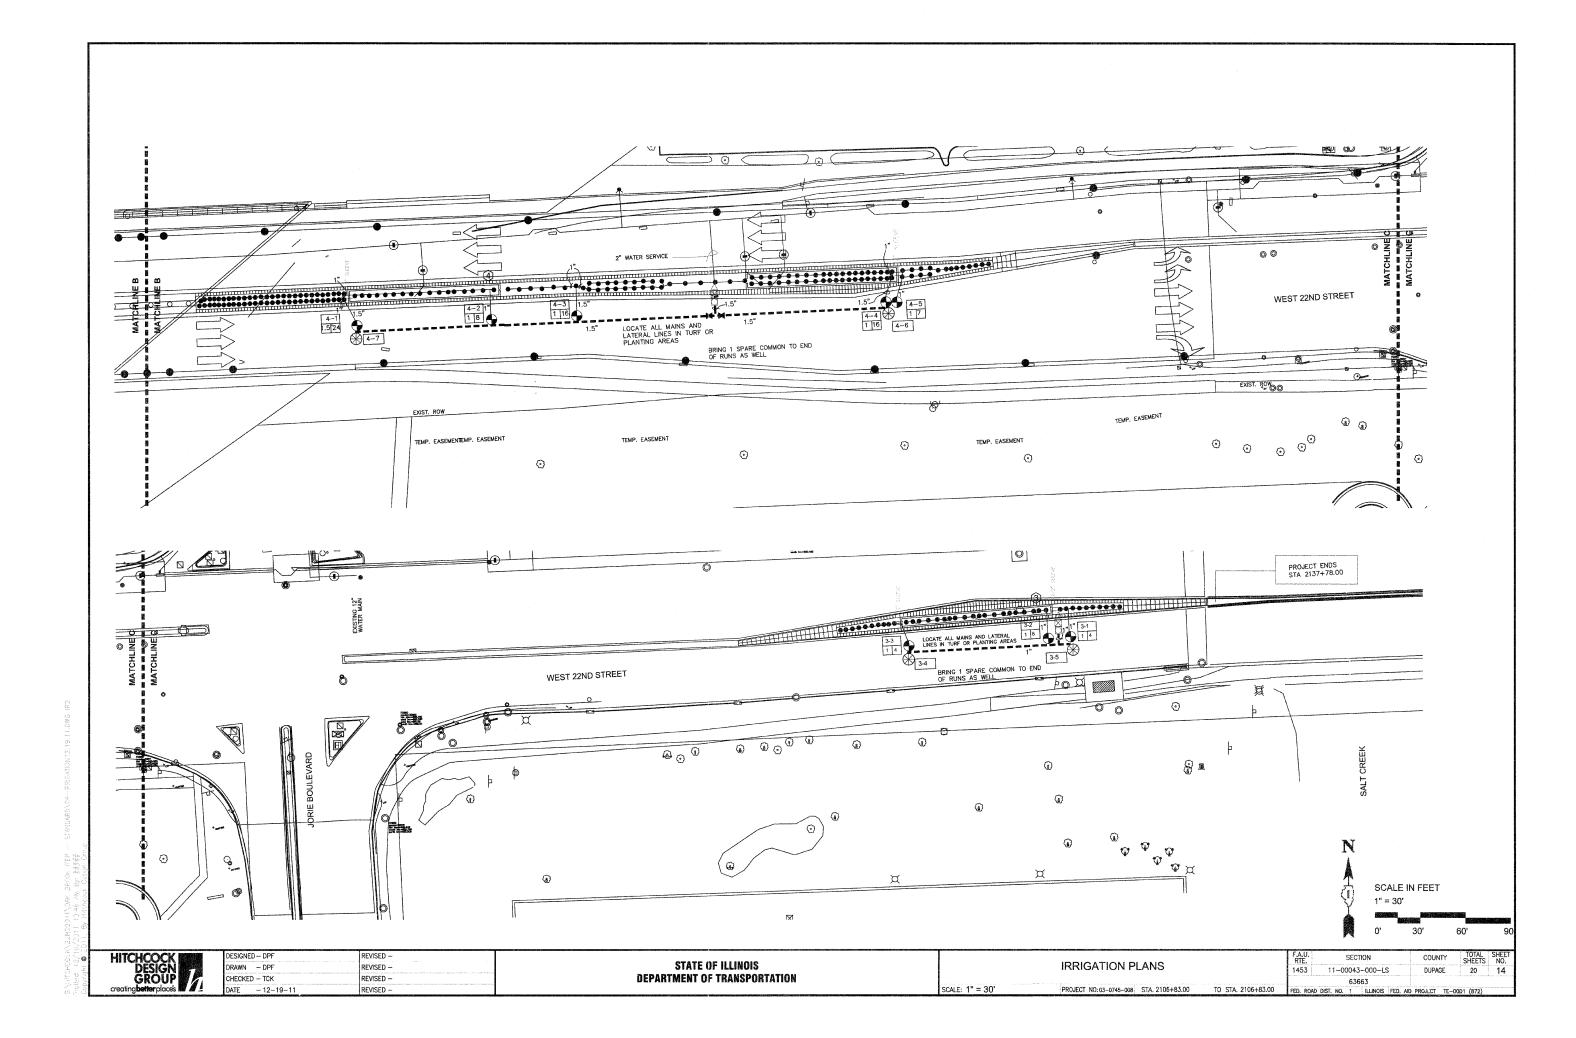


GENERAL IRRIGATION NOTES

- 1. CONTACT ALL UTILITIES AND ENGINEER AT LEAST 5 DAYS PRIOR TO THE START OF CONSTRUCTION.
- 2. MAINTAIN ALL CODES REQUIRED BY STATE AND LOCAL AUTHORITIES.
- 3. COORDINATE ELECTRICAL HOOKUP WITH OTHER TRADES, ELECTRICIAN AND ENGINEER THE CONTROLLER WILL BE A STAND ALONE MOUNT WITH ELECTRICAL BROUGHT TO THE CONTROLLER LOCATION THE IRRIGATION CONTRACTOR WILL BE
- RESPONSIBLE FOR CONNECTIONS FROM THE POWER DROP TO THE CONTROLLER.
- 4. COORDINATE ALL SLEEVES AND PENETRATIONS WITH OTHER TRADES.

 5. IRRIGATION CONTRACTOR IS RESPONSIBLE FOR BORES, SLEEVES OR PENETRATIONS RELATED TO THE IRRIGATION.
- 6. INSTALL ALL PIPING AND FITTINGS USING GLUE METHODS CONSISTENT WITH MANUFACTURER'S RECOMMENDATIONS.
- 7. MAINLINE PIPING SHALL BE INSTALLED AT MINIMUM OF 12" LATERAL LINES SHALL BE INSTALLED AT A MINIMUM DEPTH OF 12"
- 8. CAP OR PLUG ALL OPENINGS AS SOON AS LINES ARE INSTALLED TO PREVENT DEBRIS IN THE LINE.
- THOROUGHLY FLUSH ALL LINES PRIOR TO THE OPERATION OF SPRINKLER HEADS.
- 10. INSTALL WIRES A MIN. OF 10" BELOW GRADE.
 - -SPLICES ARE NOT ALLOWED IN THE TRENCH.
 - -PROVIDE A 24" EXPANSION LOOP AT EACH CHANGE IN DIRECTION.
 - -5 FEET OF EXCESS DECODER WIRE IS TO BE AT EACH DECODER LOCATION FOR EASE OF ACCESS.
- 11. THE IRRIGATION SYSTEM SHALL BE TESTED AT OPERATING PRESSURE FOR A MINIMUM OF 4 HOURS. REPAIR ALL LEAKS AND RETEST AFTER CURING.

 12. UPON COMPLETION OF TEST, COMPLETE ASSEMBLY OF ALL EQUIPMENT AND SPRINKLERS FOR PROPER DISTRIBUTION.
- 13. PROVIDE 'AS BUILT' DRAWINGS SHOWING ALL COMPONENTS OF THE SYSTEM PRIOR TO FINAL PAYMENT. PROVIDE FINAL GPM OF ZONES, WIRE RUNS, HEADS, VALVES, PIPE SIZES ETC.
- 14. SLEEVE UNDER ROAD, WALLS, PAVERS, AND DRIVES
 —SLEEVE WIRE AND PIPING SEPARATELY, SEE PLAN FOR SIZING
 15. ALL GASKETED PRESSURE PIPE AND FITTINGS SHALL BE THRUST BLOCKED. NO CONCRETE PREFORMED BLOCKS WILL BE ALLOWED.
- 16. ALL EXISTING UTILITIES WHICH ARE NOT SHOWN ON THESE DOCUMENTS
- WHICH NEED TO BE REMOVED, RELOCATED AND/OR ADJUSTED SHALL BE THE RESPONSIBILITY OF THE IRRIGATION CONTRACTOR.

 17. ALL BIDDERS SHALL VISIT AND REVIEW THE SITE AND FAMILIAR THEMSELVES
- WITH THE SITE THE SITE PRIOR TO SUBMITTING A BID.
- 18. CONTRACTOR TO PROVIDE BLOW OUT TAP AFTER RPZ UNIT.
- 19. CONTRACTOR IS RESPONSIBLE FOR SUBMITTING AND ACQUIRING ALL PERMITS
 20. PRIOR TO INSTALLATION, FIELD TEST THE SYSTEM PRESSURE AT THE POINT
- OF CONNECTION THE SYSTEM IS BASED ON GPM AND PRESSURE FURNISHED BY OTHERS. CONTRACTOR IS RESPONSIBLE TO VERIFY PRESSURE IS AT LEAST 60 STATIC PSI AND NOTIFY OWNER IF PRESSURE IS LOWER.
- 21. DRAWING IS SCHEMATIC, FIELD ADJUSTMENTS MAY BE NEEDED. LOCATE ALL MAIN LINES AND LATERAL LINES IN TURF OR PLANTING AREAS.
- COMPONENTS ARE DRAWN OUTSIDE OF AREAS FOR EASE OF READING. 22. WATER METER WILL BE PROVIDED BY THE OWNER, COORDINATE WITH DON LANGE
- 23. CONTRACTOR TO VERIFY THAT THE EXISTING B BOX/CURB STOP IS SELF DRAINING, IF NOT PROVIDE A SELF DRAINING B BOX/CURB STOP BETWEEN TAP AND IRRIGATION SYSTEM FOR WINTERIZATION.

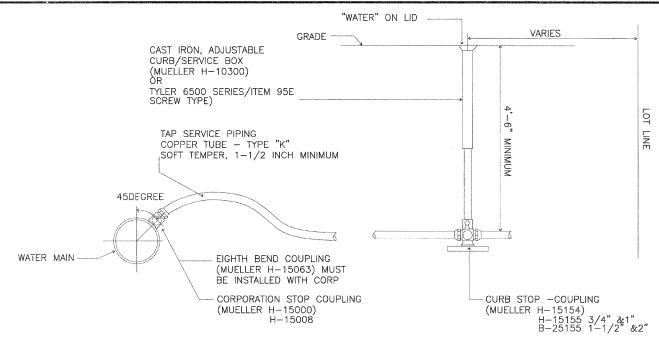

MUELLER BRONZE SERVICE SADDLE-DOUBLE STRAP WITH AWWA TAPER (CC) THREAD, BASE CATALOG NUMBER BR2B SERIES SHALL BE PROVIDED IN ALL

WATER SERVICE CONNECTION

NTS

LEGEND

- RAINBIRD 1812 SAM-PRS OR EQUAL SPRAY HEAD
- NOZZLES XPCN FULL

CL 200 PVC PIPE - MAINLINE, SEE PLAN FOR SIZES

1" & 11/2" PE PIPE

- ③ ④ HUNTER I-CORE 12 STATION OR EQUAL WITH PLASTIC PEDESTAL CONTROLLER AND SOLAR SYNC. MOUNT SOLAR SYNC IN PEDESTAL
- COORDINATE WITH OWNER FOR MOUNTING LOCATION, INSTALL AND GROUND TO MANUFACTURER'S RECOMMENDATIONS AND DETAILS CONTRACTOR RESPONSIBLE FOR PROVIDING POWER FROM TAP DROP TO CONTROLLER CONTROLLER IS TO BE LOCATED IN A GS-NP-1 ENCLOSURE BY BPDI OR EQUAL. COLOR TO BE DARK GREEN INSTALL ENCLOSURE PER MANUFACTURES RECOMMENDATIONS.
- EXTRA WIRE DROP, LABEL AND LOCATE IN ADJACENT VALVE BOX.
- ISOLATION GATE VALVE SIZE TO PIPE
- HUNTER PGV OR EQUAL ELECTRIC VALVES SIZE PER PLAN
- BLOW OUT TAP WITH PLUG
- RPZ BACKFLOW PREVENTER AND METER PROVIDED BY THIS CONTRACTOR. RPZ AND METER ARE TO BE LOCATED IN A ENCLOSURE BY BPDI OR EQUAL. COLOR TO BE DARK GREEN CONTRACTOR IS RESPONSIBLE TO ENSURE THAT THE METER AND BACKFLOW FIT IN THE ENCLOSURE.
- INSTALL PER MANUFACTURES RECOMMENDATIONS. IF A LARGER ENCLOSURE IS NEEDED, THE CONTRACTOR IS RESPONSIBLE TO PROVIDE IT. POINT OF CONNECTION — COORDINATE WITH OWNER & GENERAL CONTRACTOR IRRIGATION TAP IS TO BE 1.5" & 1". FOLLOW STATE AND LOCAL CODES FROM TAP
- THROUGH BACKFLOW PREVENTER, METER AND SYSTEM.

SCALE: N/A

PVC Class 200 SLEEVE IN LANDSCAPE - SIZE PER PLAN

4"/2" SLEEVE WIRE SLEEVE SIZE PIPE SLEEVE

STATION NUMBER 1"35 ZONE GPM

VALVE SIZE

-CONTROLLER NUMBER PULSE WIRE COLOR CODE #14 GAUGE

White - COMMON #14 GA.




ESIGNED — DPF	REVISED -
RAWN - DPF	REVISED -
HECKED TCK	REVISED —
ATF 12_10_11	REVISED


STATE OF ILLINOIS **DEPARTMENT OF TRANSPORTATION**



SECTION COUNTY 11-00043-000-LS DUPAGE 20 63663

PROJECT NO: 03-0745-008 STA, 2106+83.00 TO STA, 2106+83.00

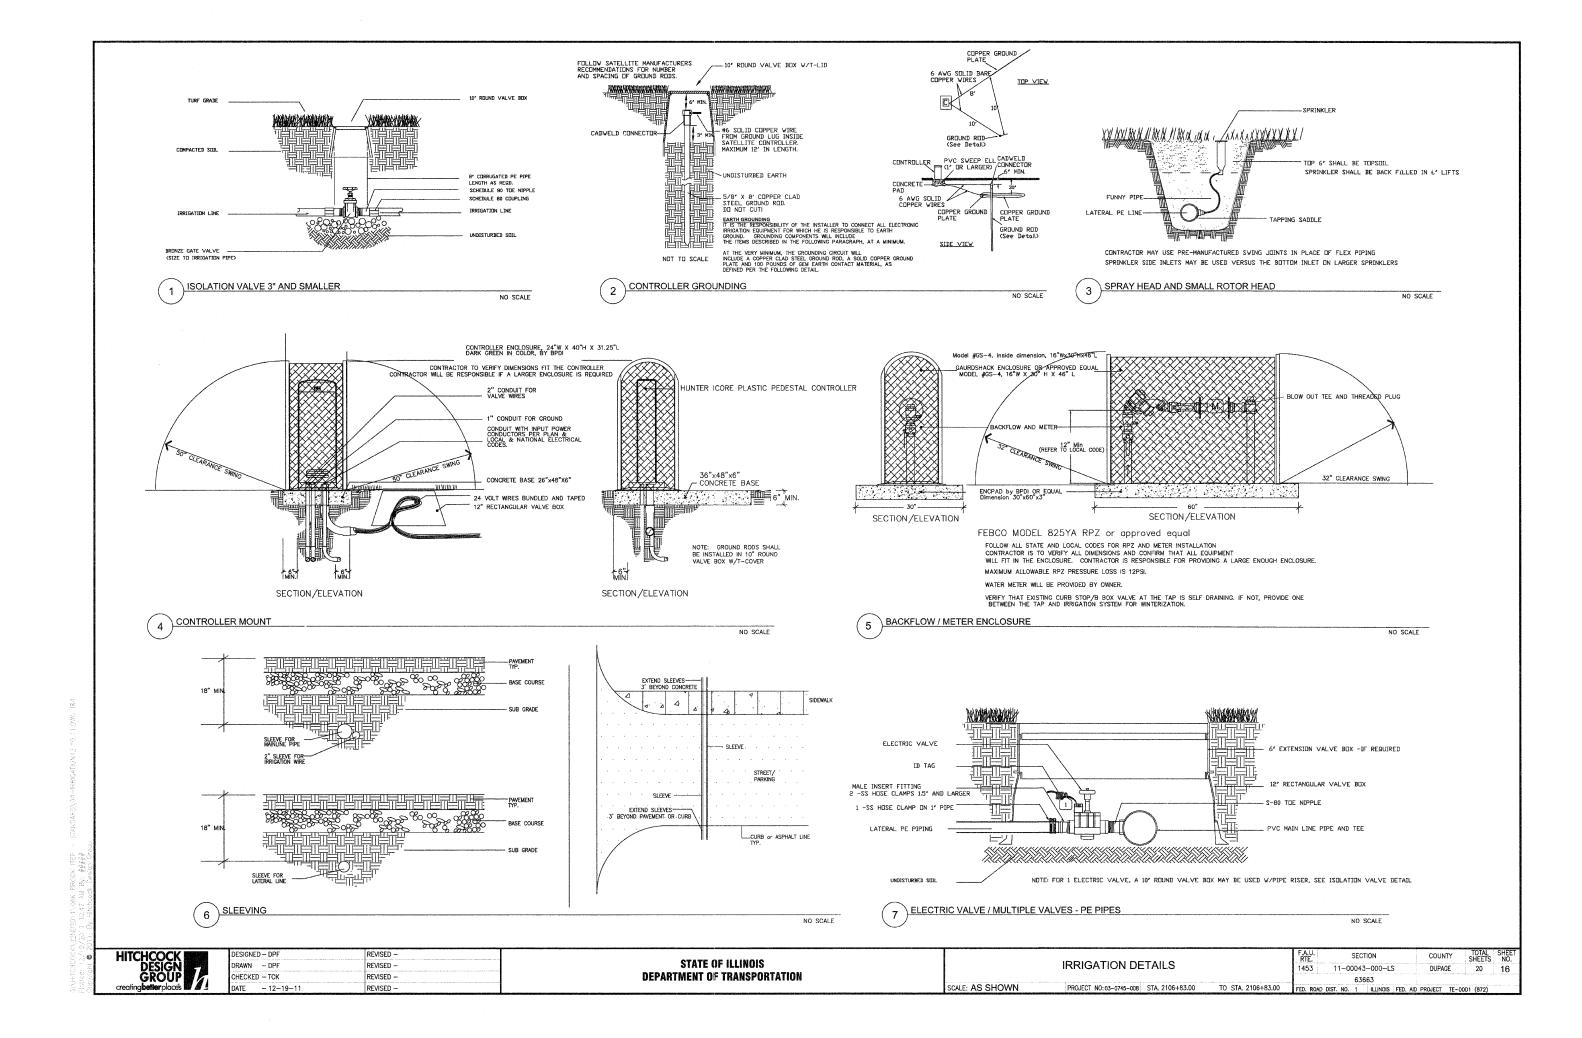

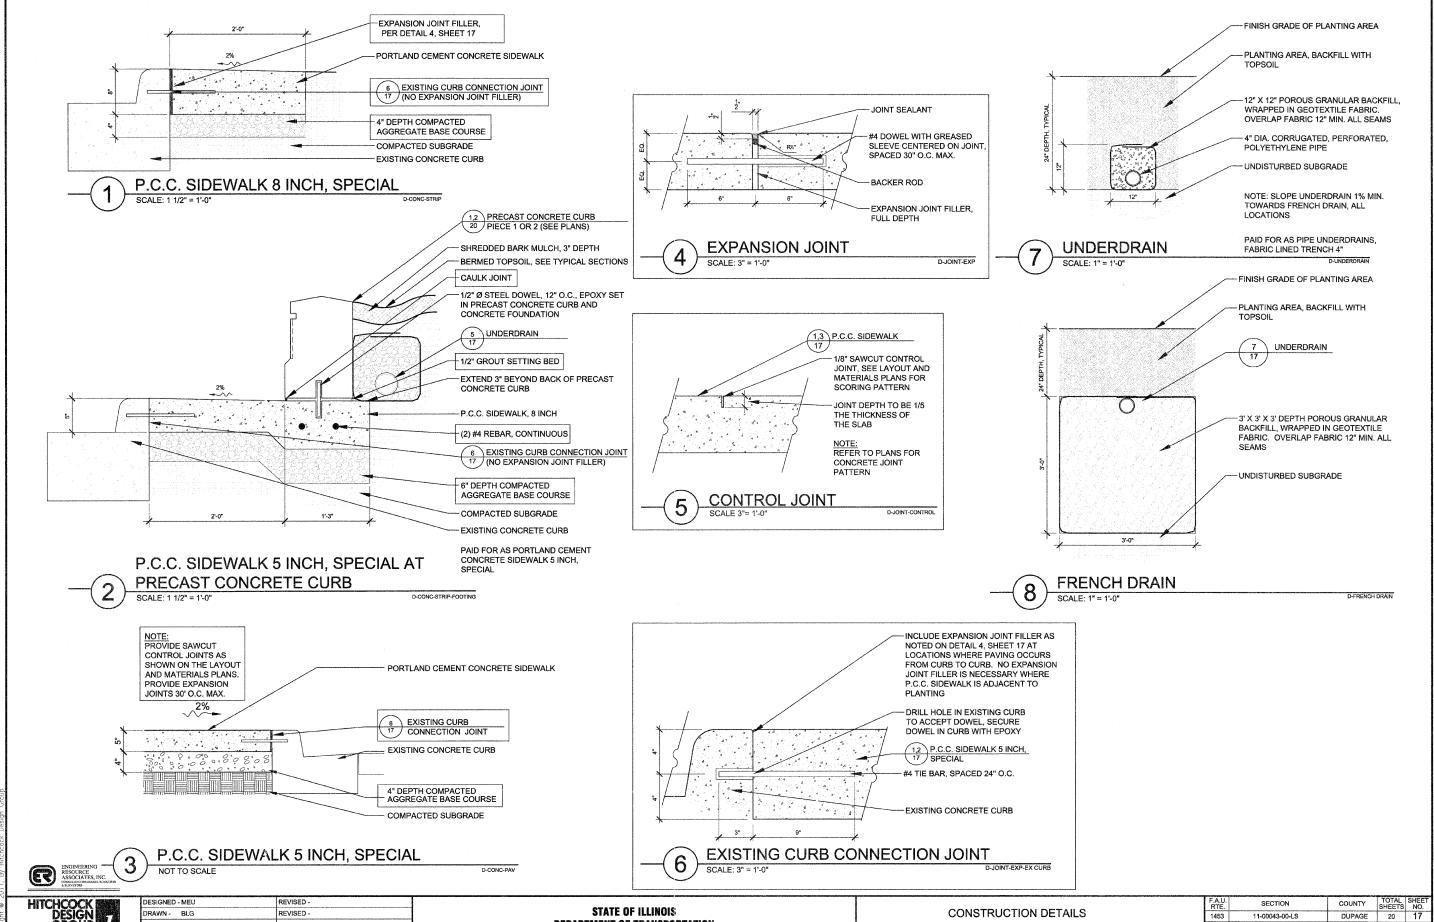

HECKED - TCK

DATE - 12-19-11

REVISED -

REVISED -

STATE OF ILLINOIS **DEPARTMENT OF TRANSPORTATION** **CONSTRUCTION DETAILS** PROJECT - 03-0745-008

SCALE:AS SHOWN

1453 11-00043-00-LS CONTRACT 63663

PRECAST CONCRETE CURB - SIDE ELEVATION A

SCALE: 3/4" = 1'-0"

LOCATION: STA. 2110+22.46 TO STA. 2111+47.46

D-ELEV-WALL-SIDE A

PRECAST CONCRETE CURB
PIECE 1, TYPICAL

PRECAST CONCRETE CURB
PIECE 3 AND 4, TYPICAL

PRECAST CONCRETE CURB
PIECE 3 AND 4, TYPICAL

PRECAST CONCRETE CURB

ENGINEERING
RESOURCE
ASSOCIATES, INC.
COMMUTING EMORIERS, SCIENTIST
A BLAVETURE

HITCHCOCK DESIGN GROUP creating botter places

 DESIGNED - MEU
 REVISED

 DRAWN - BLG
 REVISED

 CHECKED - TCK
 REVISED

 DATE - 12-19-11
 REVISED

STATE OF ILLINOIS
DEPARTMENT OF TRANSPORTATION

CONSTRUCTION DETAILS


SCALE:AS SHOWN | PROJECT - 03-0745-008 |

 F.A.U. RTE.
 SECTION
 COUNTY
 TOTAL SHEETS
 SHEETS NO.

 1453
 11-00043-00-LS
 DUPAGE
 20
 18

 CONTRACT 63663

J:\PROJECTS\700'S\0745-VILLAGE OF OAK BI

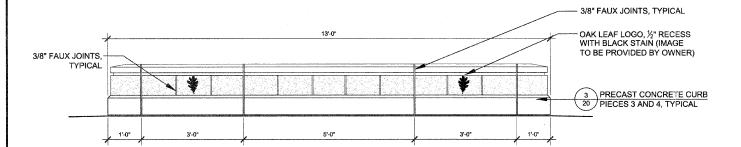

LOCATIONS: STA. 2110+22.46 STA. 2111+47.46 PRECAST CONCRETE CURB - FRONT ELEVATION A

SCALE: 3/4" = 1'-0"

D-ELEV-WALL-NOSE A

3/8" FAUX JOINTS,

PRECAST CONCRETE CURB - FRONT ELEVATION D

-OAK LEAF LOGO, ½" RECESS WITH BLACK STAIN (IMAGE PROVIDED BY OWNER)

3/8" FAUX JOINTS, TYPICAL

STA. 2136+28.20

3 PRECAST CONCRETE CURB 19 PIECES 3 AND 4, TYPICAL

-3/8" FAUX JOINT, TYPICAL OAK LEAF LOGO, 1/2" RECESS WITH BLACK STAIN (IMAGE PROVIDED BY OWNER) 3/8" FAUX JOINTS, -3/8" FAUX JOINTS, TYPICAL 3 PRECAST CONCRETE CURB 20 PIECES 3 AND 4, TYPICAL

PRECAST CONCRETE CURB - FRONT ELEVATION B

LOCATIONS: STA. 2116+89.93 STA. 2117+90.93 STA. 2126+93.27

FINISH GRADE BEING RETAINED BEHIND WALL, SEE PLANS 3/8" FAUX JOINTS -TYPICAL 3 PRECAST CONCRETE CURB 20 PIECES 3 AND 4, TYPICAL 1'-0" 1'-0" LOCATION: STA. 2125+92.27

PRECAST CONCRETE CURB - END ELEVATION A SCALE: 3/4" = 1'-0"

PRECAST CONCRETE CURB 2
PIECE 2
20 OAK LEAF LOGO, ½" RECESS WITH BLACK STAIN (IMAGE PROVIDED BY OWNER) 3/8" FAUX JOINTS,--3/8" FAUX JOINTS, TYPICAL 3 PRECAST CONCRETE CURB 20 PIECES 3 AND 4, TYPICAL LOCATION: STA. 2123+28.37

PRECAST CONCRETE CURB - FRONT ELEVATION C SCALE: 3/4" = 1'-0"

FINISH GRADE BEING RETAINED PRECAST CONCRETE CURB / BEHIND WALL, SEE PLANS -FINISH GRADE IN FRONT OF WALL, SEE PLANS AND TYPICAL MEDIAN SECTION B 3/8" FAUX JOINTS,-TYPICAL 3 PRECAST CONCRETE CURB 20 PIECES 3 AND 4, TYPICAL 1'-0" 6'-10" LOCATION: STA. 2124+29.37

SCALE: 3/4" = 1'-0"


PRECAST CONCRETE CURB - END ELEVATION B

D-END-ELEV-WALL-B

ESIGNED - MEU REVISED -RAWN - BLG REVISED -HECKED - TCK REVISED -

STATE OF ILLINOIS **DEPARTMENT OF TRANSPORTATION**

COUNTY TOTAL SHEETS
DUPAGE 20 SECTION CONSTRUCTION DETAILS 1453 11-00043-00-LS CONTRACT 63663 CALE:AS SHOWN PROJECT - 03-0745-008

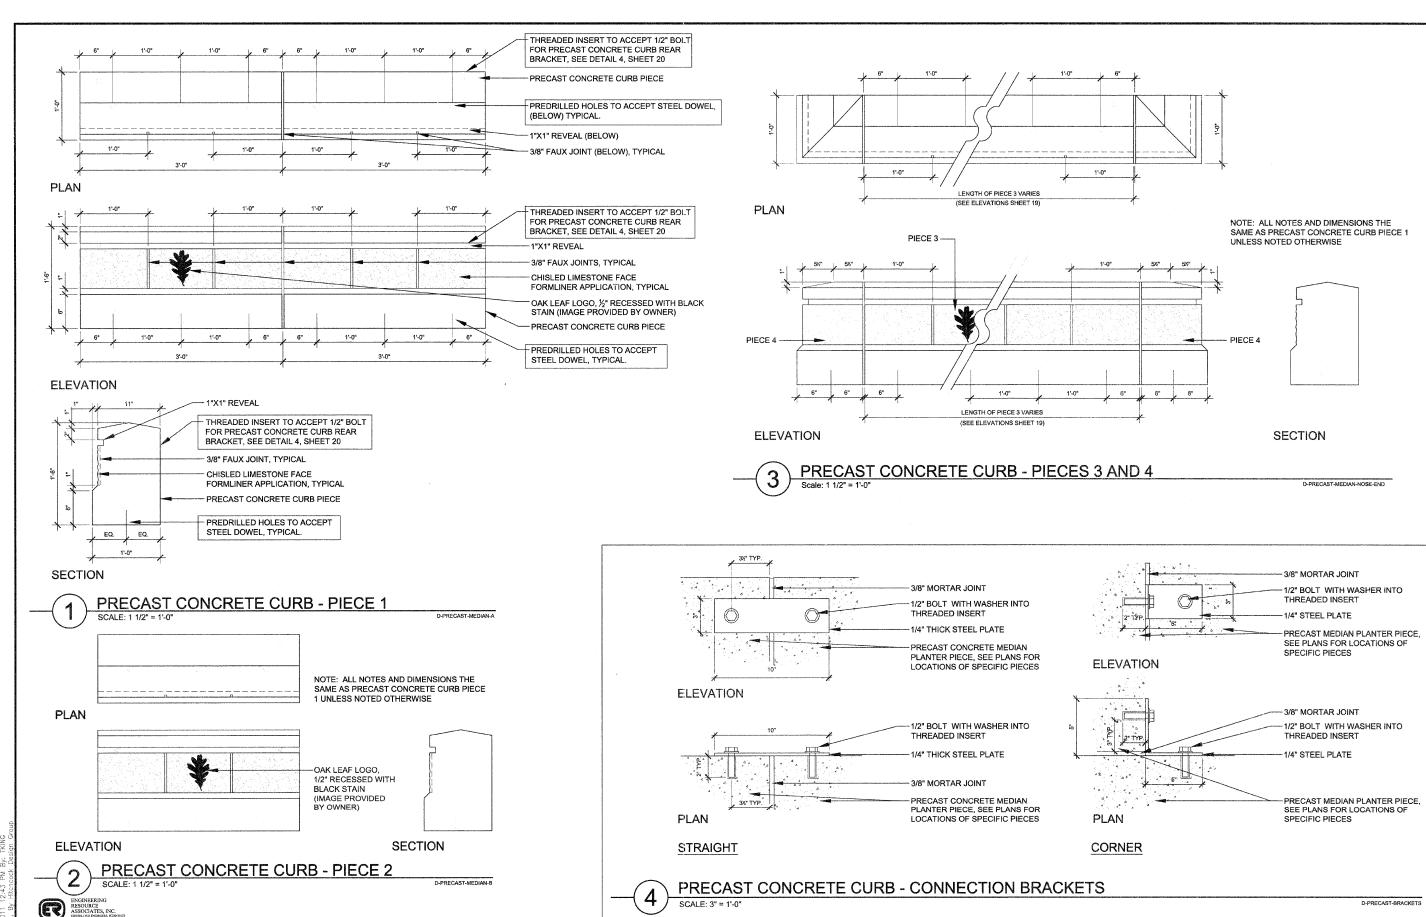

STATE OF ILLINOIS

DEPARTMENT OF TRANSPORTATION

COUNTY TOTAL SHEET NO.

DUPAGE 20 20

SECTION

11-00043-00-LS

FED ROAD DIST NO. 1 JULINOIS FED AID PROJECT TE-00D1/87

1453

CONTRACT 63663

CONSTRUCTION DETAILS

PROJECT - 03-0745-008

SCALE: AS SHOWN

J:\PROJECTS\700'S\0745-VILLAUE OF OAK BROOK\008-22ND STREET ITEP ENHANCEMENTS\H GRAPHICS\05-

HECKED - TCK

12-19-11

REVISED -

REVISED -