03-08-2019 LETTING ITEM 102

STATE OF ILLINOIS **DEPARTMENT OF TRANSPORTATION**

SECTION GRS-1 GREENE//ERSEY 12 1

D-98-102-17



FUNCTIONAL CLASSIFICATION RURAL MINOR ARTERIAL 2017 ADT = 2500P.V.=92.0% S.U.=3.6% M.U.=4.4%

LOCATION OF SECTION INDICATED THUS: - -

STATE OF ILLINOIS **DEPARTMENT OF TRANSPORTATION**

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OF THE STATE OF ILLINOIS

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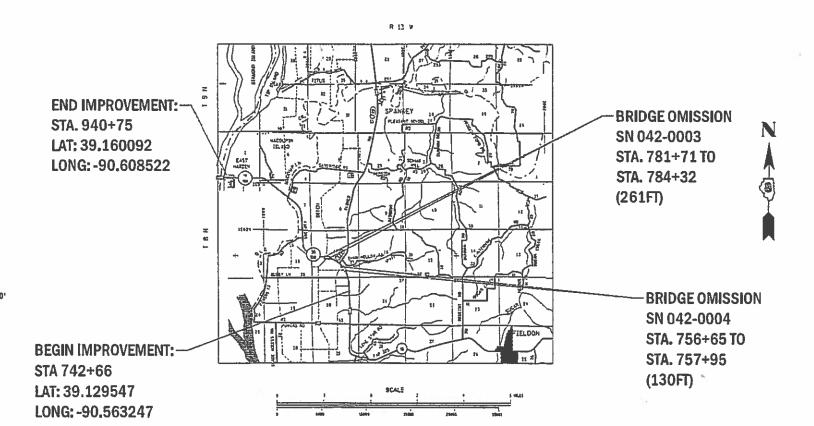
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PROPOSED HIGHWAY PLANS

FAP ROUTE 304 (IL 16/ IL 100) **SECTION 6RS-4** PROJECT STP-5HGD(022) **3P RESURFACING** (0.1 MI S OF BUSBY LANE TO THE JOE PAGE BRIDGE) **GREENE & JERSEY COUNTIES**

C-98-217-18



PROJECT ENGINEER: TIM PADGETT (618)346-3325 PROJECT MANAGER: DREW RUHOLL (618)346-3454

FULL SIZE PLANS HAVE BEEN PREPARED USING STANDARD

ENGINEERING SCALES, REDUCED SIZED PLANS WILL NOT

ON REDUCED PLANS, THE ABOVE SCALES MAY BE USED.

JOINT UTILITY LOCATION INFORMATION FOR EXCAVATION

CONFORM TO STANDARD SCALES. IN MAKING MEASUREMENTS

GROSS LENGTH = 19809 FT. = 3,752 MILE NET LENGTH = 19418 FT. = 3.678 MILE

CONTRACT NO. 76K71

J.U.L.I.E.

OR 811

1-800-892-0123

0

REV. - MS

HIGHWAY STANDARDS

000001-07	STANDARD SYMBOLS, ABBREVIATIONS AND PATTERNS
001006	DECIMAL OF AN INCH AND OF A FOOT
482011-03	HMA SHOULDERS STRIPS/SHOULDERS WITH RESURFACING OR WIDENING PROJECTS
642006	SHOULDER RUMBLE STRIPS, 8 INCH
701011-04	OFF-RD MOVING OPERATIONS, 2L, 2W DAY ONLY
701201-05	LANE CLOSURE, 2L, 2W, DAY ONLY, FOR SPEEDS ≥ 45 MPH
701301-04	LANE CLOSURE, 2L, 2W, SHORT TIME OPERATIONS
701306-04	LANE CLOSURE, 2L, 2W, SLOW MOVING OPERATIONS DAY ONLY, FOR SPEEDS ≥ 45 MPH
701311 - 03	LANE CLOSURE, 2L, 2W, MOVING OPERATIONS - DAY ONLY
701326-04	LANE CLOSURE, 2L, 2W, PAVEMENT WIDENING, FOR SPEEDS ≥ 45 MPH
701901-08	TRAFFIC CONTROL DEVICES
780001-05	TYPICAL PAVEMENT MARKINGS
781001-04	TYPICAL APPLICATIONS RAISED REFLECTIVE PAVEMENT MARKERS

GENERAL NOTES:

(1) ILLINOIS STATE LAW REQUIRES A 48-HOUR NOTICE TO BE GIVEN TO ALL UTILITIES WITHIN THE PROJECT AREA BEFORE DIGGING. FIELD MARKING OF FACILITIES MAY BE OBTAINED BY CONTACTING J.U.L.I.E. OR FOR NON-MEMBERS, THE UTILITY COMPANY DIRECTLY. AGENCIES KNOWN TO HAVE FACILITIES WITHIN THE PROJECT AREA ARE AS FOLLOWS:

	AERIAL	BURIED
*FRONTIER COMMUNICATIONS (COMMUNICATIONS)	×	X
*M.J.M. ELECTRIC COOPERATIVE, INC. (ELECTRIC)	×	

MEMBERS OF J.U.L.I.E. CALL TOLL FREE (800) 892-0123 OR 811 AND ARE INDICATED BY *. NON-J.U.L.I.E. MEMBERS MUST BE NOTIFIED INDIVIDUALLY.

- (2) THE CONTRACTOR AND THE ENGINEER SHALL BE AWARE THAT NO SURVEY WAS PERFORMED FOR THIS PROJECT. THE STATIONING, TOPOGRAPHY, AND QUANTITIES SHOWN IN THE PLANS WERE CREATED USING MICROFILM AND FIELD MEASUREMENTS. ALL SHALL BE ASSUMED TO BE APPROXIMATE. THE CONTRACTOR SHALL VERIFY DIMENSIONS AND CONDITIONS IN THE FIELD PRIOR TO CONSTRUCTION AND ORDERING OF MATERIALS.
- (3) THE THICKNESS OF HOT-MIX-ASPHALT SURFACE MIXTURES SHOWN ON THE PLANS IS THE NOMINAL THICKNESS. DEVIATIONS MAY OCCUR DUE TO IRREGULARITIES IN THE EXISTING SURFACE OR BASE ON WHICH THE BITUMINOUS MIXTURE IS PLACED.
- (4) AN ESTIMATED QUANTITY OF 4,390 TONS OF CUTTINGS FROM HMA REMOVAL IS ANTICIPATED.
- (5) NO OVERNIGHT LANE CLOSURES WILL BE PERMITTED.
- (6) THE PROPOSED PAVEMENT MARKINGS SHALL MATCH THE LOCATIONS OF THE EXISTING PAVEMENT MARKINGS, AS DIRECTED BY THE ENGINEER.
- 7 THE CONTRACTOR SHALL PROVIDE POSITIVE AND ADEQUATE DRAINAGE AT ALL TIMES.
- (8) ALL AREAS DISTURBED FOR ANY REASON SHALL BE PERMANENTLY SEEDED AS DIRECTED BY THE ENGINEER. ALL AREAS DISTURBED BY THE CONTRACTOR OUTSIDE THE PROPOSED CONSTRUCTION LIMITS SHALL BE SEEDED AT THE CONTRACTOR'S EXPENSE.
- oxiny 9 . ALL TRAFFIC CONTROL DEVICES SHALL BE NEW OR "LIKE NEW" CONDITION AT THE BEGINNING OF THE PROJECT.
- (1) MTD CAN OPERATE IN AN UNLOADED CONDITION ON SN 042-0003, SN 042-0004, & SN 042-2424

MIXTURE REQUIREMENTS

THE FOLLOWING MIXTURE REQUIREMENTS ARE APPLICABLE FOR THIS PROJECT:

ROUTE	FAP 304 (IL16/IL100)
SECTION	6RS-4
COUNTY	GREENE / JERSEY
CONTRACT	76K71

	3P RESURFACING			ΙL	100	FROM TH	IE JOE	PAGE	BRIDGE	TO 0.1	
DESCRIFTION	MILES SOUTH OF	BUSBY	LANE								

ADT (CONSTRUCTION YR.):	2500
MU%	4.4
SU%	3.6
20 YR. ESAL'S	0.71

MIXTURE USE	SURFACE	LEVEL BINDER	INCIDENTAL
AC/PG	PG 64-22	PG 64-22	PG 64-22
RAP % (MAX)	SEE SPECIAL PROVISION	SEE SPECIAL PROVISION	SEE SPECIAL PROVISION
DESIGN AIR VOIDS	4.0% @ Ndes=70	4.0% @ Ndes=70	4.0% @ Ndes=70
MIX COMPOSITION (Gradation)	IL 9.5	IL 9.5 FG	IL 9.5
FRICTION AGG	MIXTURE "C"	MIXTURE "C"	MIXTURE "C"
QUALITY MGMT PROGRAM	QCP	QCP	QC/QA

MIXTURE USE	SHOULDERS ≥ 2.25"	SHOULDERS < 2.25"
AC/PG	PG 64-22	PG 64-22
RAP % (MAX)	SEE SPECIAL PROVISION	SEE SPECIAL PROVISION
DESIGN AIR VOIDS	4.0% @ Ndes=70	4.0% @ Ndes=70
MIX COMPOSITION	IL 19.0L	IL 9.5L
(Gradation)	16 19.06	16 9.36
FRICTION AGG		
QUALITY MGMT PROGRAM	QC/QA	QC/QA

Plan quantities for Bituminous Concrete Surface Course items are calculated using a unit weight of 112 lb/sq yd/in (59.8 kg/sq m/25mm thickness)

COMMITMENTS

SCALE:

ONE

USER NAME = ruhollds	DESIGNED -	REVISED -
	DRAWN -	REVISED -
PLOT SCALE = 100.0000 ' / in.	CHECKED -	REVISED -
PLOT DATE = 11/26/2018	DATE -	REVISED -

GENERAL NOTES, HIGHWAY STANDARDS, MIXTURE REQUIREMENTS & COMMITMENTS						F.A.P RTE. SECTION			COUNTY	TOTAL SHEETS	SHEET NO.
						304 6RS-4 G			GREENE/JERSEY	12	2
										CONTRACT	NO. 76
LE:	SHEET 1	OF	1	SHEETS	STA.	TO STA.	ILLINOIS FED. AI		ID PROJECT		

				CONSTRUC	TION CODE
CODE			80% FED 20% STATE	GREENE COUNTY ROADWAY 0005	JERSEY COUNTY ROADWAY 0005
NO.	ITEM	UNIT	QUANT ITY	RURAL	RURAL
20200600	EXCAVATING AND GRADING EXISTING SHOULDER	UNIT	357	238	119
40600290	BITUMINOUS MATERIALS (TACK COAT)	POUND	35019	23252	11767
40600637	LEVELING BINDER (MACHINE METHOD), IL-9.5FG, N70	TON	2179	1447	732
40600982	HOT-MIX ASPHALT SURFACE REMOVAL - BUTT JOINT	SQ YD	415	363	52
40600990	TEMPORARY RAMP	SQ YD	277	243	34
40603315	HOT-MIX ASPHALT SURFACE COURSE, MIX "C", N70	TON	4358	2894	1464
40800029	BITUMINOUS MATERIALS (TACK COAT)	POUND	213	94	119
40800050	INCIDENTAL HOT-MIX ASPHALT SURFACING	TON	16	9	7
44000155	HOT-MIX ASPHALT SURFACE REMOVAL, 1 1/2"	SQ YD	52266	34738	17528
44004250	PAVED SHOULDER REMOVAL	SQ YD	1224	1002	222
48100100	AGGREGATE SHOULDERS, TYPE A	TON	41	41	
48102100	AGGREGATE WEDGE SHOULDER, TYPE B	TON	1023	692	331
48203029	HOT-MIX ASPHALT SHOULDERS, 8"	SQ YD	12201	8006	4195
48203100	HOT-MIX ASPHALT SHOULDERS	TON	91	74	17

USER NAME = ruhollds	DESIGNED -	REVISED -
	DRAWN -	REVISED -
PLOT SCALE = 100.0000 ' / in.	CHECKED -	REVISED -
PLOT DATE = 11/26/2018	DATE -	REVISED -

STATE OF ILLINOIS DEPARTMENT OF TRANSPORTATION

	F.A.P. RTE	SECT	ION		COUNTY	TOTAL SHEETS	SHEET NO.	
SUMMARY OF QUANTITIES	304	6RS	6RS-4		REENE/JERSEY	12	3	
					CONTRACT	NO. 76	K71	
CALE: SHEET 1 OF 2 SHEETS STA. TO STA.	ILLINOIS FED. AID PROJECT							

				CONSTRUCT	TION CODE	
			80% FED 20% STATE	GREENE COUNTY	JERSEY COUNTY	
CODE NO .	ITEM	UNIT	TOTAL QUANTITY	ROADWAY 0005 RURAL	ROADWAY 0005 RURAL	_ [
						ø
64200108	SHOULDER RUMBLE STRIPS, 8 INCH	FOOT	37157	25173	11984	ا کو
						ø
67000400	ENGINEER'S FIELD OFFICE, TYPE A	CAL MO	3	2	1	
67100100	MOBILIZATION	LSUM	1	0.67	0.33	
70100450	TRAFFIC CONTROL AND PROTECTION, STANDARD 701201	LSUM	1	0.67	0.33	_
70100460	TRAFFIC CONTROL AND PROTECTION, STANDARD 701306	LSUM	1	0.67	0.33	
70100500	TRAFFIC CONTROL AND PROTECTION, STANDARD 701326	LSUM	1	0.67	0.33	
			-			
70103815	TRAFFIC CONTROL SURVEILLANCE	CAL DA	14	7	7	
70300100	SHORT TERM PAVEMENT MARKING	FOOT	5295	3507	1788	_
70300150	SHORT TERM PAVEMENT MARKING REMOVAL	SQ FT	589	390	199	
70300220	TEMPORARY PAVEMENT MARKING - LINE 4"	FOOT	49633	31349	18284	_
70300220	PEN GIVIN TAVELLEN TANINATING ETNE	, 661	73033	31313	70207	-
78000300	THERMOPLASTIC PAVEMENT MARKING - LINE 5"	FOOT	49633	31349	18284	-
78100100	RAISED REFLECTIVE PAVEMENT MARKER	EACH	279	197	82	_
78300200	RAISED REFLECTIVE PAVEMENT MARKER REMOVAL	EACH	243	161	82	-
X7030005	TEMPORARY PAVEMENT MARKING REMOVAL	SQ FT	16545	10450	6095	

					CONSTRUCT	ION CODE
				80% FED 20% STATE	GREENE COUNTY	JERSEY COUNTY
					ROADWAY	ROADWAY
	CODE			TOTAL	0005	0005
	NO.	ITEM	UNIT	QUANT ITY	RURAL	RURAL
ð 2	Z0076600	TRAINEES	HOUR	2000	2000	
Z	0033700	LONGITUDINAL JOINT SEALANT	FOOT	19418	12865	6553
ð	Z0076604	TRAINEES TRAINING PROGRAM GRADUATE	HOUR	2000	2000	
Z	0034105	MATERIAL TRANSFER DEVICE	TON	6519	4323	2196


Ø 0042

* SPECIALTY ITEM

USER NAME = ruhollds	DESIGNED -	REVISED -
	DRAWN -	REVISED -
PLOT SCALE = 100.0000 ' / in.	CHECKED -	REVISED -
PLOT DATE = 11/26/2018	DATE -	REVISED -

STATE OF ILLINOIS DEPARTMENT OF TRANSPORTATION

	OUMANDY OF QUANTIE	150	F.A.P. RTE	SECTION	COUNTY	TOTAL SHEETS	
	SUMMARY OF QUANTIT	IES	304	6RS-4	GREENE/JERSE	12	4
					CONTRACT	NO. 70	6K71
SCALE:	SHEET 2 OF 2 SHEETS STA.	TO STA.		ILLINOIS FED.	AID PROJECT		

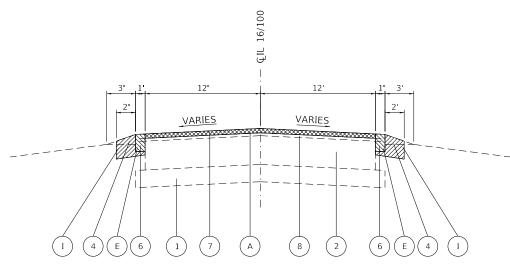


EXISTING TYPICAL SECTION

STA. 742+66 TO STA. 796+00

BRIDGE OMISSION STA. 756+65 TO STA. 757+95 BRIDGE OMISSION STA. 781+71 TO STA. 784+32


NO SHOULDER REMOVAL AT THESE LOCTIONS, SEE DETAIL A

STA. 754+58 LT. TO STA. 756+65 LT. STA. 755+26 RT. TO STA. 756+65 RT. STA. 757+95 LT. STA. 757+95 LT. STA. 757+95 RT. TO STA. 759+34 RT. STA. 779+91 LT. TO STA. 759+34 LT. STA. 780+45 RT. TO STA. 781+71 LT. STA. 784+32 LT. TO STA. 785+55 RT. STA. 784+32 RT. TO STA. 785+55 RT.

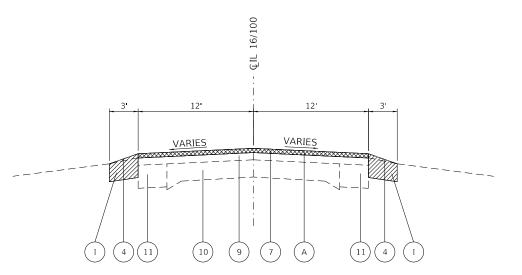


EXISTING TYPICAL SECTION


STA. 796+00 TO STA. 938+84
SEE DETAIL B FOR RT. STA 882+75 TO STA. 884+75
SEE DETAIL C FOR LT. STA 830+83 TO STA. 833+48

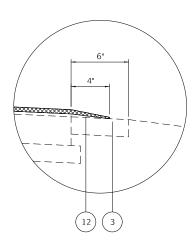

(DETAIL A)

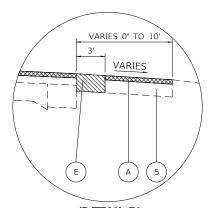


(DETAIL B)

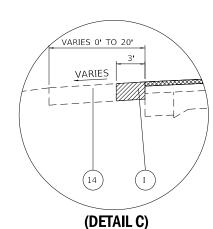

LEGEND

- (1) EXISTING SUB-BASE GRANULAR MATERIAL TYPE A, 6"
- 2 EXISTING PCC PACEMENT 10"
- (3) EXISTING HMA SHOULDER 9"
- (4) EXISTING AGGREGATE WEDGE
- (5) EXISTING HMA SHOULDER (AGRICULTURAL TURN AROUND), DEPTH UNKNOWN
- (6) EXISTING HMA SHOULDER 3½"
- (7) EXISTING HMA SURFACE COURSE. $1\frac{1}{2}$ "
- (8) EXISTING HMA LEVELING BINDER 1"
- 9 EXISTING HMA RESURFACING, VARIES
- (10) EXISTING PCC PAVEMENT (9"-6"-9")
- 1) EXISTING HMA BASE COURSE WIDENING, 8"
- (12) EXISTING HMA SHOULDER, VARIES
- (13) EXISTING CONCRETE RAIL
- (14) EXISTING AGGREGATE SHOULDER
- (B) PROPOSED BITUMINOUS MATERIAL (TACK COAT)
- C) PROPOSED LEVELING BINDER (MACHINE METHOD), IL-9.5FG, N70, ¾"
- \bigcirc PROPOSED HMA SURFACE COURSE, MIX "C", N70, $1\frac{1}{2}$ "
- (E) PROPOSED PAVED SHOULDER REMOVAL
- (F) PROPOSED HMA SHOULDER 21/4"
- G PROPOSED HMA SHOULDERS 8" (SEE NOTE **)
- (H) PROPOSED AGGREGATE WEDGE SHOULDER, TYPE B
- (I) PROPOSED EXCAVATING AND GRADING EXISTING SHOULDERS
- PROPOSED LONGITUDINAL JOINT SEALANT (ONLY THE BETWEEN BINDER AND SURFACE)
- (K) PROPOSED AGGREGATE SHOULDERS, TYPE A

NOTE**: SEE RESURFACING DETAILS FOR SHOULDER CONSTRUCTION

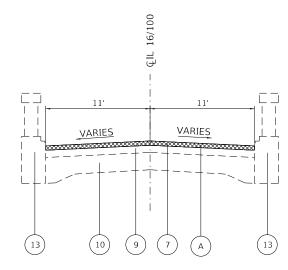

EXISTING TYPICAL SECTION


STA. 938+84 TO STA. 940+75

USER NAME = ruhollds	DESIGNED -	REVISED -
	DRAWN -	REVISED -
PLOT SCALE = 100.0000 ' / in.	CHECKED -	REVISED -
PLOT DATE = 11/26/2018	DATE -	REVISED -

STATE OF ILLINOIS
DEPARTMENT OF TRANSPORTATION

SCALE:

	T/DIO4	LOFOTI	0110		F.A.P RTE	SECTION	COUNTY	TOTAL SHEETS	
	TYPICA	L SECTI	UNS		304	6RS-4	GREENE/JERS	EY 12	5
							CONTRAC	T NO. 7	6K71
SHEET 1	OF 2	SHEETS	STA	TO STA		II LINOIC	EED AID BROJECT		

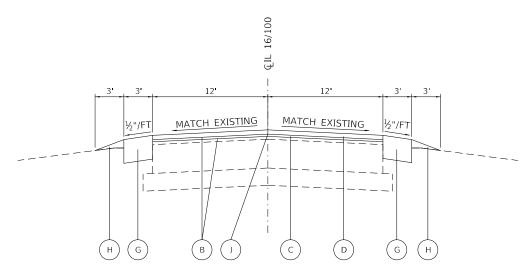


PROPOSED TYPICAL SECTION

STA. 742+66 TO STA. 796+00

BRIDGE OMISSION STA. 756+65 TO STA. 757+95 BRIDGE OMISSION STA. 781+71 TO STA. 784+32


NO SHOULDER REMOVAL AT THESE LOCTIONS, SEE DETAIL A

STA. 754+58 LT. TO STA. 756+65 LT. STA. 755+26 RT. TO STA. 756+65 RT. STA. 757+95 LT. TO STA. 757+95 LT. STA. 757+95 RT. TO STA. 759+34 RT. STA. 779+91 LT. TO STA. 781+71 LT. STA. 780+45 RT. TO STA. 781+71 RT. STA. 784+32 LT. TO STA. 786+84 LT. STA. 784+32 RT. TO STA. 785+55 RT.

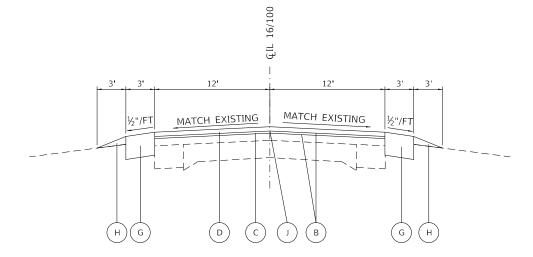


PROPOSED TYPICAL SECTION


STA. 796+00 TO STA. 938+84
SEE DETAIL B FOR RT. STA 882+75 TO STA. 884+75
SEE DETAIL C FOR LT. STA 830+83 TO STA. 833+48

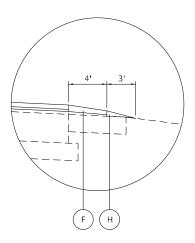

(DETAIL A)

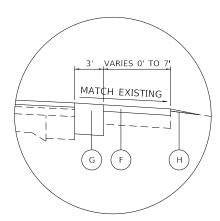

(DETAIL B)

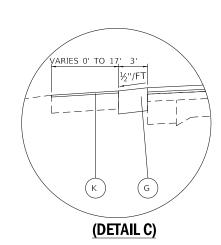


SCALE:

LEGEND

- 1 EXISTING SUB-BASE GRANULAR MATERIAL TYPE A, 6"
- 2) EXISTING PCC PACEMENT 10"
- EXISTING HMA SHOULDER 9"
- (4) EXISTING AGGREGATE WEDGE
- (5) EXISTING HMA SHOULDER (AGRICULTURAL TURN AROUND), DEPTH UNKNOWN
- (6) EXISTING HMA SHOULDER 3½"
-) EXISTING HMA SURFACE COURSE. $1\frac{1}{2}$ "
- (8) EXISTING HMA LEVELING BINDER 1"
- 9 EXISTING HMA RESURFACING, VARIES
- 10 EXISTING PCC PAVEMENT (9"-6"-9")
- (1) EXISTING HMA BASE COURSE WIDENING, 8"
- (12) EXISTING HMA SHOULDER, VARIES
- (13) EXISTING CONCRETE RAIL
- (14) EXISTING AGGREGATE SHOULDER
- A PROPOSED HMA SURFACE REMOVAL 1½"
- (B) PROPOSED BITUMINOUS MATERIAL (TACK COAT)
- PROPOSED LEVELING BINDER (MACHINE METHOD), IL-9.5FG, N70, 3/4"
- (D) PROPOSED HMA SURFACE COURSE, MIX "C", N70, $1\frac{1}{2}$ "
- (E) PROPOSED PAVED SHOULDER REMOVAL
- (F) PROPOSED HMA SHOULDER 21/4"
- (G) PROPOSED HMA SHOULDERS 8" (SEE NOTE **)
- (H) PROPOSED AGGREGATE WEDGE SHOULDER, TYPE B
- (I) PROPOSED EXCAVATING AND GRADING EXISTING SHOULDERS
- (J) PROPOSED LONGITUDINAL JOINT SEALANT (ONLY BETWEEN THE BINDER AND SURFACE)
- (K) PROPOSED AGGREGATE SHOULDERS, TYPE A

NOTE**: SEE RESURFACING DETAILS FOR SHOULDER CONSTRUCTION

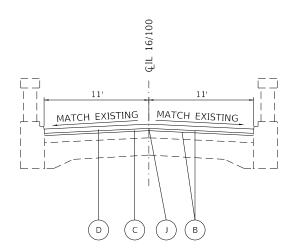

PROPOSED TYPICAL SECTION

STA. 938+84 TO STA. 940+75

USER NAME = ruhollds	DESIGNED -	REVISED -	
	DRAWN -	REVISED -	
PLOT SCALE = 100.0000 / in.	CHECKED -	REVISED -	
PLOT DATE = 11/26/2018	DATE -	REVISED -	

STATE OF ILLINOIS
DEPARTMENT OF TRANSPORTATION

TOPICAL OFFICIAL	F.A.P RTE	SECTION	COUNTY	TOTAL SHEETS	SHEET NO.
TYPICAL SECTIONS	304	6RS-4	GREENE/JERSEY	12	6
			CONTRACT	NO. 76	6K71
CHEET 2 OF 2 CHEETS STA TO STA					

							PAVEM	ENT MARKING S	CHEDULE						
			THERM		PAVEMENT MA E - 5"	RKING	RAISED REFLECTIVE	RAISED REFLECTIVE	SHORT TERM	SHORT TERM	TEM	PORARY PA LIN	VEMENT MARK E - 4"	ING	TEMPORARY
	LOCATIO	ON	SOLID SOLI WHITE DOUB EDGELINE YELL		SKIP-DASH YELLOW CENTERLINE	VELLOW	PAVEMENT MARKER REMOVAL	PAVEMENT MARKER	PAVEMENT MARK I NG	PAVEMENT MARKING REMOVAL	SOLID WHITE EDGELINE ¹	SOLID DOUBLE YELLOW	SKIP-DASH YELLOW CENTERLINE	SOLID YELLOW	PAVEMENT MARKING REMOVAL
STA	TO	STA	FOOT	FOOT	FOOT	FOOT	EACH	EACH	FOOT	SQ FT	FOOT	FOOT	FOOT	FOOT	SQ FT
742+6		756+65	2675		350		17	17	381	42.3	2675		350		1008.3
756+6	5 TO	757+95						BRIDGE C	MISSION						
757+9	5 TO	781+71	4581		594		30	30	648	72.0	4581		594		1725.0
781+7	1 TO	784+32						BRIDGE C	MISSION						
784+3	2 TO	796+00	2336		292		15	15	318	35.3	2336		292		876.0
796+0	0 TO	824+20	5598		705		35	71	768	85.3	5598		705		2101.0
824+2	0 TO	875+22	10148	576	1204	2290	64	64	1392	154.7	10148	576	1204	2290	4739.3
GREENE	COUNTY	SUBTOTAI	25338	576	3145	2290	161	197	3507	389.6	25338	576	3145	2290	10449.6
GREE	NE COUNT	Y TOTAL		3	1349		161	197	3507	390		3	1349		10450
875+2	2 TO	940+75	13066	1216	1486	2516	82	82	1788	198.7	13066	1216	1486	2516	6094.7
JERSE'	COUNTY	SUBTOTAL	13066	1216	1486	2516	82	82	1788	198.7	13066	1216	1486	2516	6094.7
JERS				1	8284		82	82	1788	199		1	8284		6095
	GRAND TO	TAL		4	9633		243	279	5295	589		4	9633		16545

¹ FINAL QUANTITY INCLUDES SIDEROAD OMISSIONS ² RAISED REFLECTIVE PAVEMENT MARKERS SHALL BE AT 40 FOOT SPACING BETWEEN STA. 796+00 TO 824+20

						SHOULDER S	CHEDULE				
	LOCA	TION		HMA SURFACE REMOVAL 1.5	HMA SHOULDERS (2 1/4")	PAVED SHOULDER REMOVAL	EXCAVATING AND GRADING EXISTING, SHOULDER	HMA SHOUDERS, 8"	AGGREGATE WEDGE SHOULDERS, TYPE B	AGGREGATE SHOULDERS, TYPE A	SHOULDER RUMBLE STRIPS 8 INCH 3/5
STA	TO	STA	SIDE	SQ YD	TON	SQ YD	UNIT	SQ YD	TON	TON	FOOT
742+66	TO	755+26	RT			140.0	12.60	420.0	35.0		1260
755+26	TO	756+65	RT	55.1	5.2				2.6		92
756+65	TO	757+95	RT				BR I DGE	OMISSION			
757+95	TO	759+34	RT	55.1	7.8				3.9		139
759+34	TO	780+45	RT			215.6	19.40	646.7	53.9		1940
780+45	TO	781+71	RT	49.3	7.1				3.5		126
781+71	TO	784+32	RT				BR I DGE	OMISSION			
784+32	TO	785+55	RT	48.0	6.9				3.4		123
785+55	TO	796+00	RT			116.1	10.45	348.3	29.0		1045
796+00	TO	875+22	RT				78.66	2622.0	218.5		7866
742+66	TO	754+58	LT			124.0	11.16	372.0	31.0		1116
754+58	TO	756+65	LT	85.3	11.6				5.8		207
756+65	TO	757+95	LT				BRIDGE	OMISSION		•	
757+95	757+95 TO 759+97 LT 8				11.3				5.6		202
759+97	TO	779+91	LT			221.6	19.94	664.7	55.4		1994
779+91	TO	781+71	LT	73.3	10.1				5.0		180
781+71	TO	784+32	LT				BRIDGE	OMISSION	•		
784+32	TO	786+84	LT	105.3	14.1				7.0		252
786+84	TO	796+00	LT			101.8	9.16	305.3	25.4		916
796+00	TO	830+83	LT				34.41	1147.0	95.6		3441
830+83	TO	833+48	LT				2.65	88.3		40.6	265
833+48	TO	875+22	LT				39.24	1391.3	109.0		4009
GREEN	E COUN	TY SUBTOT	AL	554.5	74.1	919.1	237.67	8005.6	689.6	40.6	25173
GRE	ENE COL	JNTY TOTAL		555	74	919	238	8006	690	41	25173
875+22	TO	882+75	RT				6.93	251.0	19.3		693
882+75	TO	884+45	RT	132.2	16.7	56.7		56.7			170
884+45	TO	938+84	RT				50.84	1784.7	141.2		5114
938+84	TO	940+75	RT								
875+22	ТО	938+84	LT				61.42	2102.3	170.6		6007
938+84	TO	940+75	LT				01.12	2102.3	1,0.0		000,
330104	- 10	3,0,,3	- '								
JERSE	Y COUN	TY SUBTOT	AL	132.2	16.7	56.7	119.19	4194.7	331.1	0.0	11984
		JNTY TOTAL		132	17	57	119	4195	331	0	11984
, ETKS	GRAND			687	91	976	357	12201	1021	41	37157

SEE ENTRANCE SCHEDULE FOR ADDITIONAL QUANTITIES
SEE MAINLINE RESURFACING SCHEDULE FOR ADDDITIONAL QUANTITIES

USER NAME = ruhollds	DESIGNED -	REVISED -	
	DRAWN -	REVISED -	
PLOT SCALE = 100.0000 ' / in.	CHECKED -	REVISED -	DEP/
PLOT DATE = 11/26/2018	DATE -	REVISED -	

					NTITIES		F.A.P. RTE	SECTION	COUNTY	TOTAL SHEETS	SHEET NO.
	8	CHEL	ULE	OF QUA	ANTITIES		304	6RS-4	GREENE/JERSE	12	7
									CONTRACT	NO. 70	5K71
SCALE:	SHEET 1	OF	2	SHEETS	STA.	TO STA.		ILLINOIS FEE	. AID PROJECT		

FINAL QUANTITY INCLUDES SIDE ROAD OMISSIONS
SEE SIDEROAD SCHEDULE FOR ADDITIONAL QUANTITIES
FINAL QUANTITY INCLUDES ENTRANCE OMISSIONS

						QUANTITIES
6	SEE	SIDEROAD	SCHEDULE	FOR	ADDITIONAL	QUANTITIES

				MAINLINE R	ESURFACING SCHEDUL	.E		
LOCATIONS			HMA SURFACE, REMOVAL 1.5"	BITUMINOUS MATERIALS (TACK COAT) ⁶	LEVELING BINDER (MACHINE METHOD), IL-9.5FG, N70	HMA SURFACE COURSE, MIX "C", N70°	LONGITUDINAL JOINT SEALANT	MATERIAL TRANSFER DEVICE
STA	ТО	STA	SQ YD	POUND	TON	TON	FOOT	TON
742+66	ТО	756+65	3650.7	2518.2	156.7	313.4	1399	470.1
756+65	ТО	757+95			BRIDGE OMI	SSION		
757+95	ТО	781+71	6296	4276.8	266.1	532.2	2376	798.3
781+71	ТО	784+32			BRIDGE OMI	SSION		
784+32 TO 875+22			24200	16362.0	1018.1	2036.2	9090	3054.3
GREENE	COUNTY	SUBTOTAL	34146.7	23157.0	1440.9	2881.8	12865	4322.7
GREENE	COUNT	/ TOTAL	34147	23157	1441	2882	12865	4323
875+22	TO	938+84	16965.3	11451.6	712.5	1425.1	6362	2137.6
938+84	ТО	940+75	430.2	315.2	19.6	39.2	191	58.8
JERSEY	COUNTY	SUBTOTAL	17395.5	11766.8	732.1	1464.3	6553	2196.4
JERSE\	Y COUNT	/ TOTAL	17396	11767	732	1464	6553	2196
GF	RAND TO	ΓAL	51543	34924	2173	4346	19418	6519

THERE IS APPROXIMATELY 90 SQ YD OF EXISTING CONCRETE PATCHING WHICH WILL BE MILLED AND WILL BE INCLUDED IN THE COST OF HMA SURFACE REMOVAL 1.5"

SEE SHOULDER SCHEDULE FOR ADDITIONAL QUANTITIES SEE SIDEROAD SCHEDULE FOR ADDITIONAL QUANTITIES

	BUTT JOINT SCHEDULE											
STATION	LOCATION	LENGTH	WIDTH	HMA SURFACE REMOVAL - BUTT JOINT	TEMPORARY RAMP ⁷							
		FOOT	FOOT	SQ YD	SQ YD							
742+66	IL 16/100	15.0	24.0	40.0	20.0							
755+84	SHAW HALLOW RD	47.0	3.5	18.3	18.3							
756+65	IL 16/100	15.0	30.0	50.0	25.0							
757+95	IL 16/100	15.0	30.0	50.0	25.0							
760+68	ELDRED RD	171.0	3.5	66.5	66.5							
781+71	IL 16/100	15.0	30.0	50.0	25.0							
784+32	IL 16/100	15.0	30.0	50.0	25.0							
823+99	POWERS RD	42.0	3.5	16.3	16.3							
873+47	SANDR I DGE ⁷	56.0	3.5	21.8	21.8							
	GREENE COUNTY SUI	BTOTAL		362.9	242.9							
	GREENE COUNTY T	OTAL		363	243							
	_											
903+66	COUNTY RD 1700N	40.0	3.5	15.6	15.6							
940+75	IL 16/100	15.0	22.0	36.7	18.3							
	JERSEY COUNTY SUI	BTOTAL		52.3	33.9							
		OTAL		52	34							
	GRAND TOTAL			415	277							

⁷ THE TEMPORARY RAMPS LOCATED AT THE SIDE ROADS CANNOT BE CONSTRUCTED AT A TAPER RATE OF 40:1 WITHOUT IMPACTING THE MAINLINE PAVEMENT RESURFACING. THE TEMPORARY RAMPS AT THE SIDEROADS SHALL BE CONSTRUCTED TO THE EDGE OF PAVEMENT (WIDTH OF 3.5FT) AT THESE LOCATIONS.

SCALE:

					SIDEROAD SCHE	DULE				
LOCATION			S I DEROAD L ENGTH	SIDEROAD WIDTH	BITUMINOUS MATERIALS (TACK COAT) ^{1,4}	INCIDENTAL HMA SURFACING⁵	HMA SURFACE REMOVAL 1.5"	LEVELING BINDER (MACHINE METHOD), IL-9.5FG, N70	HMA SURFACE COURSE, MIX "C", N70	AGGREGATE WEDGE SHOULDER, TYPE B
NAME	STATION	RT/LT	FOOT	FOOT	POUND	TON	SQ YD	TONS	TONS	TONS
BUSBY LN	745+95	LT	SEE RESURFAC	CING DETAILS	95.3		35.8	5.9	11.9	2.1
SHAW HALLOW RD	755+84	RT	47	3.5	8.2	1.0				
ELDRED RD	760+68	RT	171	3.5	29.9	3.7				
POWERS RD	823+99	LT	42	3.5	7.4	0.9				
SANDRIDGE RD	873+47	RT	56	3.5	9.8	1.2				
GREENE COUN	Y SUBTOTA	L,			150.6	6.8	35.8	5.9	11.9	2.1
GREENE COU	NTY TOTAL				151	7	36	6	12	2
COUNTY RD 1700N	903+66	RT	40	3.5	7.0	0.9				
JERSEY COUNTY SUBTOTAL					7.0	0.9	0.0	0.0	0.0	0.0
JERSEY COU	NTY TOTAL				7	1	0	0	0	0
GRAND	TOTAL				158	8	36	6	12	2

⁹⁵ POUNDS OF BITUMINOUS MATERIALS (TACK COAT) WILL BE PAID AS 4060029 AT BUSBY LN.

⁵ SEE ENTRANCE SCHEDULE FOR ADDITIONAL QUANTITIES

USER NAME = ruhollds	DESIGNED -	REVISED -
	DRAWN -	REVISED -
PLOT SCALE = 100.0000 / in.	CHECKED -	REVISED -
PLOT DATE = 11/26/2018	DATE -	REVISED -

												i
	001150111	E 0 E 0 I I	4 A I T I T I T C		F.A.P. RTE	SEC.	TION		COUNTY	TOTAL SHEETS	SHEET NO.	
SCHEDULE OF QUANTITIES						6R	S-4		GREENE/JERSEY	12	8	i
									CONTRACT	NO. 76	5K71	i
SHEET 2	OF 2	SHEETS	STA.	TO STA.			ILLINOIS	FED. A	ID PROJECT			i

SEE SHOULDER SCHEDULE FOR ADDITIONAL QUANTITIES


SEE MAINLINE RESURFACING SCHEDULE FOR ADDITIONAL QUANTITIES

EROSION AND SETTLEMENT CONTROL

- 1. THE WORK DESCRIBED ON THESE DRAWINGS ARE THE INTEGRAL PART OF THE STORM WATER POLLUTION PREVENTION PLAN USED TO OBTAIN THE NPDES FROM IEPA FOR THE CONSTRUCTION OF THIS PROJECT.
- 2. THE PURPOSE OF THE EROSION AND SEDIMENT CONTROL MEASURES INCLUDED FOR THIS PROJECT IS TO LIMIT THE SEDIMENT POLLUTION IMPACT OF ANY STORM WATER DISCHARGES THAT ORIGINATE ON THIS SITE OR OFF-SITE FLOWS THAT FLOW OVER THE DISTURBED AREAS OR DOWNSTREAM AREAS. A COPY OF THE EROSION AND SEDIMENT CONTROL SCHEDULE BEING IMPLEMENTED BY THE CONTRACTOR WILL BE ON THE SITE AT ALL TIMES.
- 3. TO THE MAXIMUM EXTENT POSSIBLE, ALL FLOWS ORIGINATING OFF THE CONSTRUCTION SITE WILL BE DIVERTED AROUND DISTURBED AREAS OR WILL BE CONVEYED THROUGH THE SITE IN A MANNER THAT UNTREATED ON-SITE RUNOFF DOES NOT MIX WITH THE OFF-SITE RUNOFF.
- 4. ALL RUNOFF ORIGINATING ON DISTURBED AREAS ASSOCIATED WITH THIS PROJECT WILL PASS THROUGH ONE OR MORE MEASURES THAT WILL MINIMIZE OFF-SITE SEDIMENT IMPACTS OF THE CONSTRUCTION ACTIVITY.
- DISTURBED AREAS ARE TO BE PROTECTED FROM EROSION IN A TIMELY MANNER. UPON COMPLETION OF GRADING OR CONSTRUCTION, THE AREA WILL BE STABILIZED USING PERMANENT MEASURES.
- 6. THE CONTRACTOR SHALL DESIGNATE ONE OF HIS EMPLOYEES AS RESPONSIBLE FOR IMPLEMENTATION OF THE EROSION AND SEDIMENT CONTROL PLAN ON ALL DISTURBED AREAS. THIS PERSON IS TO BE KNOWLEDGEABLE ABOUT THE INSTALLAION AND MAINTENANCE OF THE REQUIRED MEASURES. THIS EMPLOYEE IS TO HAVE THE AUTHORITY TO CARRY OUT THE IMPLEMENTATION OF ANY INSTRUCTIONS CONCERNING THE EROSION AND SEDIMENT CONTROL PLAN GIVEN BY THE ENGINEER. ALL MEASURES WILL BE INSPECTED BY THE INDIVIDUAL AND THE ENGINEER ON A REGULAR BASIS (AT LEAST ONCE EVERY SEVEN DAYS) AND AFTER RAINFALL EVENTS GREATER THAN 1/2 INCH.
- 7. THE CONTRACTOR SHALL REMOVE ALL EXCAVATED MATERIAL FOR THE CONSTRUCTION OF THE 3FT HMA SHOULDERS FROM THE JOB SITE UNLESS DIRECTED BY THE RESIDENT ENGINEER.
- 8. THE CONTRACTOR SHALL REPLACE THE MATERIAL REMOVED FOR THE CONSTRUCTION OF THE 3FT HMA SHOULDER WITH THE FIRST LIFT OF THE HMA SHOULDER WITHIN THE SAME DAY TO PREVENT SEDIMENT EROSION.
- 9. THE EXCAVATED MATERIAL FROM THE CONSTRUCTION OF THE 3FT HMA SHOULDERS SHALL NOT BE DEPOSITED ON THE SHOULDER UNLESS DIRECTED BY THE RESIDENT ENGINEER.

LEGEND


- 1) PROPOSED AGGREGATE WEDGE SHOULDER, TYPE B
- 2 PROPOSED HMA SHOULDER, 8"

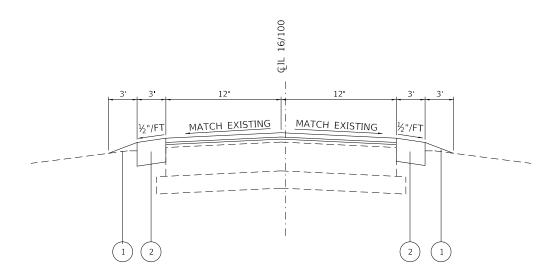

TYPICAL EROSION CONTROL SECTION

STA. 742+66 TO STA. 796+00 (SEE NOTE BELOW)

NOTE: SEE THE SHOULDER SCHEDULE FOR PAVED SHOULDER REMOVAL AND EXCAVATION AND GRADING OF EXISTING SHOULDERS OMISSIONS.

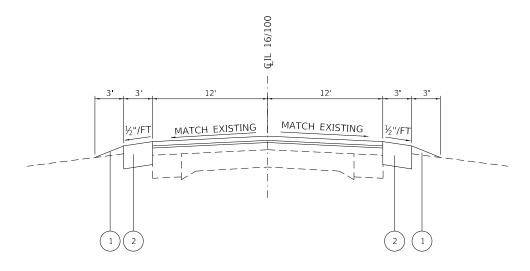

TYPICAL EROSION CONTROL SECTION


STA. 796+00 TO STA. 938+84

USER NAME = ruhollds	DESIGNED -	REVISED -
	DRAWN -	REVISED -
PLOT SCALE = 100.0000 ' / in.	CHECKED -	REVISED -
PLOT DATE = 11/26/2018	DATE -	REVISED -

STATE OF ILLINOIS
DEPARTMENT OF TRANSPORTATION

SCALE: N.T.S.

EDOCION CONTROL DETAILO	F.A.P RTE	SECTION	COUNTY	TOTAL SHEETS	SHEET NO.
EROSION CONTROL DETAILS	304	6RS-4	GREENE/JERSEY	12	9
			CONTRACT	NO. 76	5K71
SHEET 1 OF 1 SHEETS STA TO STA		TILLINOIS FED A	ID PROJECT		

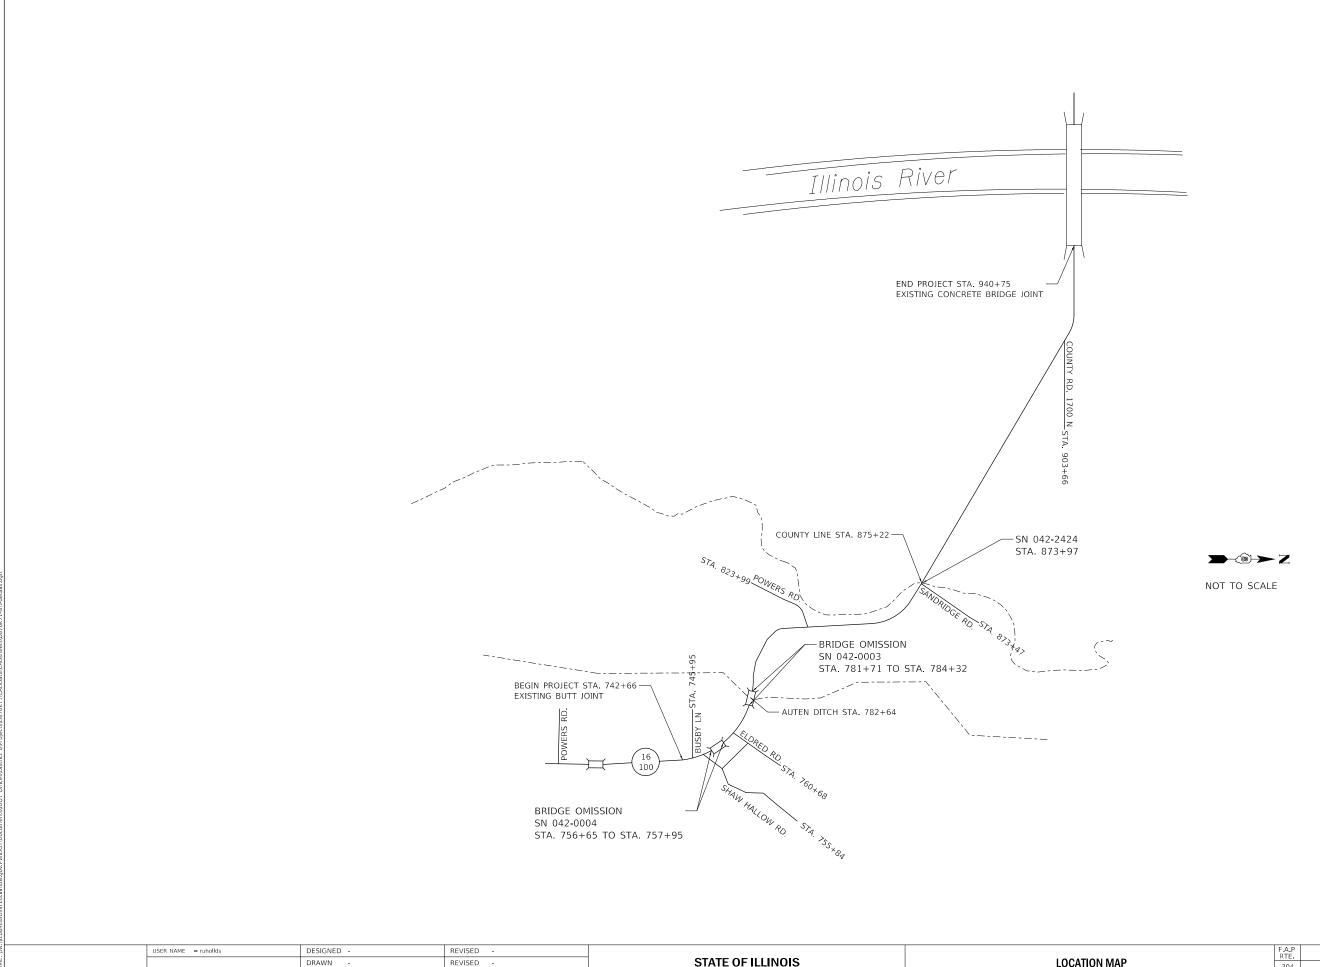

PLOT SCALE = 100.0000 ' / in.

PLOT DATE = 11/26/2018

CHECKED

DATE

REVISED

REVISED

STATE OF ILLINOIS DEPARTMENT OF TRANSPORTATION


SCALE: N.T.S.


LOCATION MAP SHEET 1 OF 1 SHEETS STA. TO STA.

COUNTY TOTAL SHEET NO.

GREENE/JERSEY 12 10 6RS-4 CONTRACT NO. 76K71

SECTION

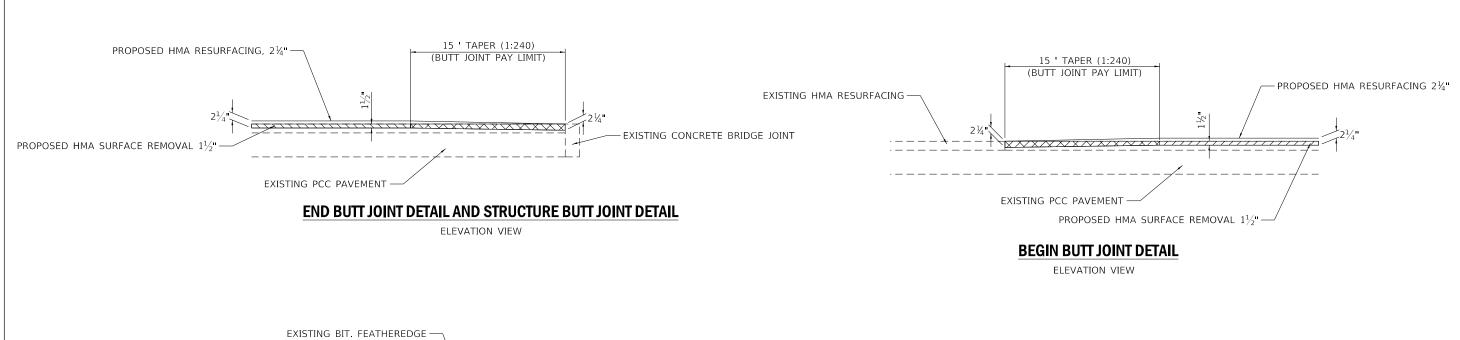

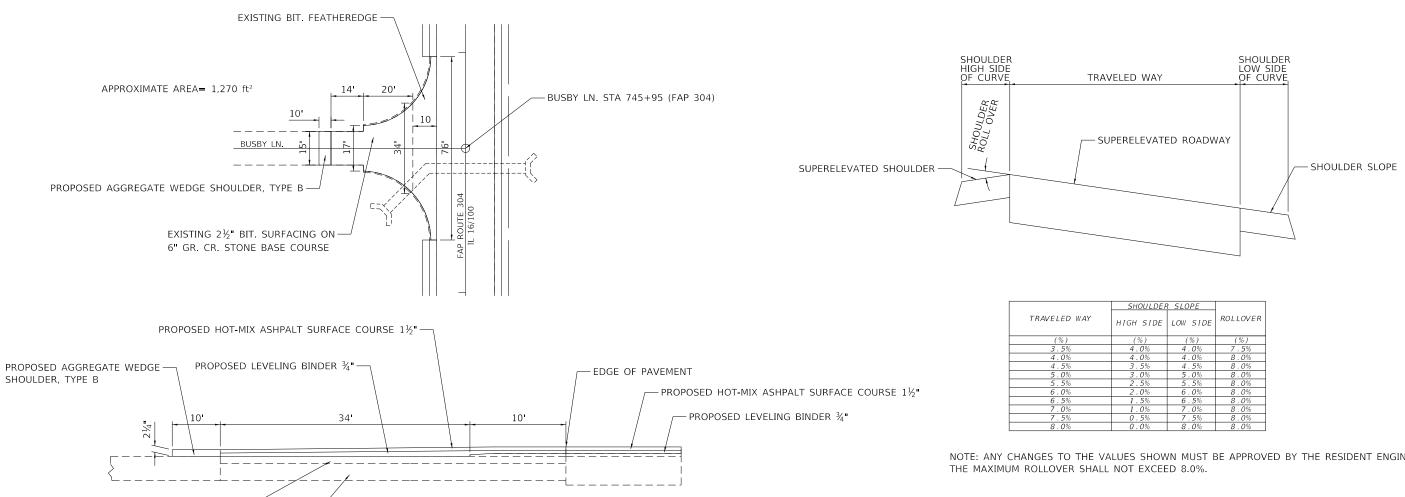

EXISTING $2\frac{1}{2}$ "BIT. SURFACING

EXISTING 6" GR. CR STONE BASE COURSE


BUSBY LN. DETAIL NOT TO SCALE


NOTE: ANY CHANGES TO THE VALUES SHOWN MUST BE APPROVED BY THE RESIDENT ENGINEER.

SHOULDER DETAIL FOR SUPERELEVATED CURVES

NOT TO SCALE

USER NAME = ruhollds	DESIGNED -	REVISED -							F.A.P RTE	SECTION	COUNTY	TOTAL	SHEET
	DRAWN -	REVISED -	STATE OF ILLINOIS			RESURFACING DI			304	6RS-4	GREENE/JERSE	12	11
PLOT SCALE = 100.0000 ' / in.	CHECKED -	REVISED -	DEPARTMENT OF TRANSPORTATION								CONTRAC	T NO. 7/	6K71
PLOT DATE = 11/26/2018	DATE -	REVISED -		SCALE: N.T.S.	SHEET 1	OF 2 SHEETS	STA.	TO STA.		ILLINOIS F	D. AID PROJECT		

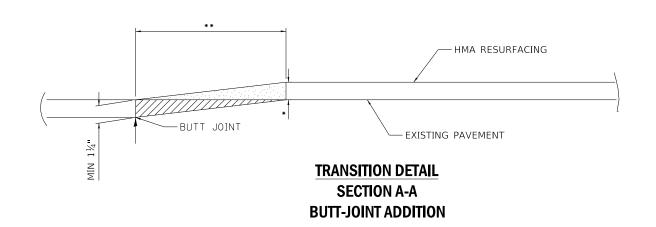

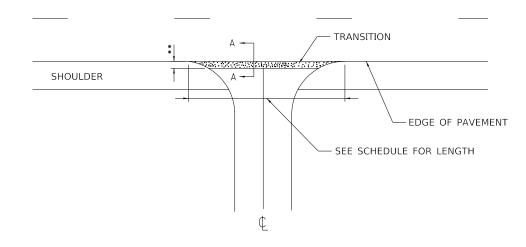

SIDE ROAD DETAIL

*EOP ELEVATION CHANGE	** TOTAL TRANSITION LENGTH
1/u 2/2 3/u 4 1"	3.0'
3/4"	3.5'
1"	5.0'
$1\frac{1}{2}$ "	7.5'
2"	10.0'
21/2"	12.5'
3"	15.0'
31/2"	17.5
4"	20.0'
4½"	22.5'
5 "	25.0'
5½"	27.5
6"	30.0'


NOTE: WHERE THE HMA TRANSITION IS MATCHING INTO AN EXISTING HMA SIDE ROAD SURFACE. A MILLED BUTT JOINT SHALL BE CONSTRUCTED WITHIN THE LIMITS OF

THE TOTAL TRANSITION LENGTH ON THE LOCAL ROUTE

INCIDENTAL HMA SURFACING

EXISTING PAVEMENT

FEATHEREDGE DETAIL SECTION A-A

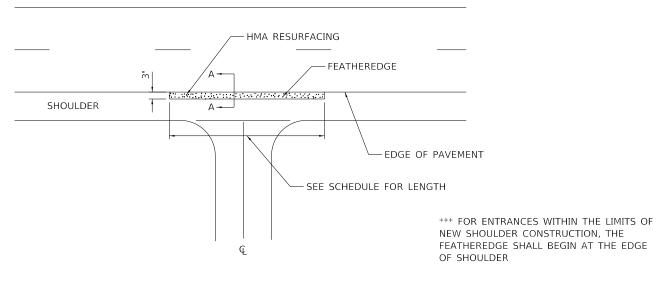

ENTRANCE DETAIL ***

USER NAME = ruhollds	DESIGNED -	REVISED -	
	DRAWN -	REVISED -	
PLOT SCALE = 100.0000 ' / in.	CHECKED -	REVISED -	
PLOT DATE = 11/26/2018	DATE -	REVISED -	

		DEGLIE				F.A.P RTE	SECTION		COUNTY	TOTAL SHEETS	SHEET NO.
		RESUL	RFACING D	304	6RS-4	GREENE/JERSEY	12	12			
							CONTRACT	NO. 76	5K71		
SCALE: N.T.S.	SHEET 2	OF 2	SHEETS	STA.	TO STA.		ILLINOIS	FED. AI	D PROJECT		