## **GENERAL NOTES**

- THE CONTRACTOR WILL NOT BE ALLOWED TO SET UP A YARD OR FIELD OFFICE ON STATE (OR TOLLWAY) PROPERTY WITHOUT WRITTEN PERMISSION FROM THE DEPARTMENT (OR TOLLWAY).
- ALL MILLED SURFACES SHALL BE A UNIFORM CROSS SLOPE PER LANE AND FREE OF RIDGES BETWEEN PASSES. ANY DEVIATIONS SHALL BE CORRECTED AT NO COST TO THE DEPARTMENT.
- 3. TYPE AND SIZE OF COMBINATION CONCRETE CURB AND GUTTER REMOVAL AND REPLACEMENT SHALL MATCH EXISTING AND WILL BE DETERMINED BY THE CONTRACTOR.
- 4. TEN (10) FOOT TRANSITIONS SHALL BE USED TO MATCH PROPOSED CURB AND GUTTER AND MEDIAN ITEMS OF WORK TO EXISTING CURBS AND GUTTER AND MEDIANS IN THE FIELD, UNLESS OTHERWISE SHOWN.
- 5. IT SHALL BE THE CONTRACTOR'S RESPONSIBILITY TO VERIFY ALL DIMENSIONS AND CONDITIONS EXISTING IN THE FIELD PRIOR TO CONSTRUCTION AND ORDERING OF MATERIALS.
- 6. HANDHOLE, JUNCTION BOX, AND FRAMES AND GRATES ADJUSTMENT OF PRIVATE UTILITIES WITHIN THE LIMITS OF THE IMPROVEMENTS SHALL BE DONE BY THEIR RESPECTIVE OWNERS AND ARE NOT PART OF THIS CONTRACT.
- STORM SEWER CONSTRUCTED UNDER THE ROADWAY SHALL BE BACKFILLED ACCORDING TO METHOD 1 OF ARTICLE 550.07 OF THE STANDARD SPECIFICATIONS.
- THE CONTRACTOR SHALL BE REQUIRED TO KEEP A RECORD OF THE LOCATIONS OF PLATED STRUCTURES BY STATION AND OFFSET LEFT OR RIGHT OF THE CENTERLINE OF PAVEMENT.
- . EXISTING BROKEN FRAMES AND LIDS SHALL BE REMOVED AND DISPOSED OF BY THE CONTRACTOR AND SHALL BE REPLACED AS DIRECTED BY THE ENGINEER. REPLACEMENT FRAMES AND LIDS WILL BE PAID FOR ACCORDING TO ARTICLE 109.04 OF THE STANDARD SPECIFICATIONS UNLESS A SEPARATE PAY ITEM HAS BEEN PROVIDED.
- 10. THE CONTRACTOR SHALL CONTACT THE DISTRICT ONE TRAFFIC CONTROL SUPERVISOR AT KALPANA.KANNAN-HOSADURGA@ILLINOIS.GOV A MINIMUM OF 72 HOURS IN ADVANCE OF BEGINNING WORK
- 11. ALL EXISTING ROW SHOWN IS APPROXIMATE AND MAY NEED TO BE VERIFIED IN THE FIELD. ALL PROPOSED WORK SHALL TAKE PLACE WITHIN EXISTING ROW WITHIN EXISTING FACILITIES INCLUDING HANDHOLES, CONDUITS, OR TRAFFIC SIGNAL CABINETS.
- 12. THE EXACT LOCATION OF ALL UTILITIES SHALL BE FIELD VERIFIED BY THE CONTRACTOR BEFORE ORDERING ANY MATERIALS AND STARTING ANY WORK. FOR LOCATION OF UTILITIES, LOCALLY OWNED EQUIPMENT, LEASED ENFORCEMENT CAMERA SYSTEM FACILITIES AND IDOT UNDERGROUND FACILITIES, CONTACT THE LOCAL COUNTIES, MUNICIPALITIES AND IDOT FOR LOCATES. THE CONTRACTOR SHALL CALL "JULIE" AT (800) 892-0123 OR 811. IN THE CITY OF CHICAGO CONTACT DIGGER AT (312) 744-7000 FOR FIELD LOCATIONS OF BURIED UTILITIES (48 HOURS NOTIFICATIONS REQUIRED).
- 13. THE CONTRACTOR SHALL CHECK THE PROPOSED TRAFFIC SIGNAL EQUIPMENT LOCATIONS FOR UNDERGROUND AND OVERHEAD UTILITIY CONFLICTS. THE CONTRACTOR SHALL NOTIFY THE AREA ENGINEER, THE RESIDENT ENGINEER, AND ANY IMPACTED UTILITY COMPANY OF THE CONFLICT, AND SHALL COORDINATE AND RESOLVE THE ISSUE PRIOR TO ORDERING MATERIALS, AND PRIOR TO POUR FOUNDATIONS.
- 14. THE CONTRACTOR SHALL COORDINATE CONSTRUCTION ACTIVITIES WITH UTILITY COMPANIES, LOCAL GOVERMENT AGENCIES, AND IDOT.
- 15. RESTORATION OF THE TRAFFIC SIGNAL WORK AREA SHALL BE INCLUDED IN THE RELATED PAY ITEM SUCH AS FOUNDATION, CONDUIT, HANDHOLE, ETC., AND NO EXTRA COMPENSATION SHALL BE ALLOWED. ALL ROADWAY SURFACES SUCH AS SHOULDERS, MEDIANS, SIDEWALKS, PAVEMENT, ETC. SHALL BE REPLACED IN KIND. ALL DAMAGE TO MOWED LAWNS SHALL BE REPLACED WITH AN APPROVED SOD, AND ALL DAMAGED TO UNMOWED FIELDS SHALL BE SEEDED IN ACCORDANCE WITH STANDARD SPECIFICATIONS 252 AND 250, RESPECTIVELY. THE CONTRACTOR IS RESPONSIBLE FOR RETURNING ALL AREAS AFFECTED BY EQUIPMENT OR LABORERS TO EXISTING CONDITIONS.
- 16. PARTIAL PAYMENT AS DESCRIBED IN ARTICLE 109.07(b) OF THE STANDARD SPECIFICTIONS WILL NOT BE ALLOWED FOR ITEMS INCLUDED IN THIS CONTRACT.
- 17. THE CONTRACTOR SHALL SOLELY BE RESPONSIBLE FOR THE INSTALLATION AND MAINTENANCE OF ADEQUATE SIGNS, TRAFFIC CONTROL DEVICES, AND WARNING DEVICES TO INFORM AND PROTECT THE PUBLIC DURING ALL CONSTRUCTION ACTIVITIES.
- 18. THE CONTRACTOR SHALL COORDINATE WITH IDOT AND EQUIPMENT VENDORS FOR THE BEST LOCATION AND ORIENTATION OF EACH PROPOPSED PTZ CAMERA PRIOR TO CAMERA INSTALLATION.
- 19. THE CONTRACTOR SHALL MARK THE RECORD DRAWINGS TO REFLECT ANY CHANGES TO THE PLANS. THE RECORD DRAWINGS REQUIREMENTS ARE IDENTIFIED IN SECTION 801.16 OF THE STANDARD SPECIFICATIONS AND SPECIAL PROVISIONS.

## **GENERAL NOTES (CONTINUED)**

- 20. THE QUANTITY FOR TEMPORARY INFORMATION SIGNING IS FOR USE WITH DISTRICT DETAIL ARTERIAL ROAD INFORMATION SIGN (TC 22). ONE SIGN IS TO BE USED FOR EACH END OF EACH INTERCONNECT CORRIDOR, MAIN ROUTE, OR ZONE.
- 21. THE RESIDENT ENGINEER SHALL CONTACT WALTER CZARNY, AREA TRAFFIC FIELD ENGINEER, AT WALTER.CZARNY@ILLINOIS.GOV A MINIMUM OF TWO (2) WEEKS PRIOR TO THE PLACEMENT OF PERMANENT PAVEMENT MARKINGS.
- 22. THE CONTRACTOR SHALL BE RESPONSIBLE FOR THE NOTIFICATION OF ALL EMERGENCY SERVICES, SCHOOL DISTRICTS, IDOT'S COMMUNICATIONS CENTER, SPRINGFIELD TRUCK PERMIT SECTION AND OTHER AGENCIES AFFECTED BY THE CLOSURE. THE CONTRACTOR SHALL ALSO BE RESPONSIBLE FOR POSTING SIGNS THAT WILL INDICATE THE DATES THE CLOSURE WILL BE IN PLACE.
- 23. THE "ARTERIAL ROAD INFORMATION SIGN (TC-22)" IS APPLICABLE ONLY TO ARTERIAL ROADS AND SHALL NOT BE APPLIED TO EXPRESSWAYS/TOLLWAYS
- 24. OVERNIGHT LANE CLOSURES SHALL NOT BE ALLOWED FOR REHABILITATION PROJECTS INVOLVING DAYTIME MILLING AND RESURFACING OPERATIONS AND CLASS D PATCHING UNLESS OTHER CONDITIONS WARRANT EXTENDED LANE CLOSURES AS DETERMINED AND APPROVED IN WRITING BY THE ENGINEER OR AS PROVIDED FOR IN THE CONTRACT SPECIFICATIONS.
- 25. THE CONTRACTOR SHALL NOTIFY PACE OR THE ILLINOIS CONVENIENCE AND SAFETY CORPORATION (ICSC) AT LEAST SEVEN (7) DAYS IN ADVANCE OF THE REMOVAL OF THE BUS STOP SHELTER OR CLOSURE OF THE BUS STOP.
- 26. THE CONTRACTOR SHALL COMPLETE CONSTRUCTION AT EACH BUS STOP IN A TIMELY MANNER AND LEAVE NO BUS STOP UNUSABLE FOR AN EXTENDED PERIOD OF TIME.
- 27. IF A BUS STOP IS BEING RELOCATED, THE INFRASTRUCTURE AT THE NEW LOCATION SHALL BE CONSTRUCTED PRIOR TO THE REMOVAL OF THE INFRASTRUCTURE AT THE EXISTING LOCATION
- 28. THE UTILITY CROSSING ENCROACHMENT APPLICATION RELATED TO CANADIAN NATIONAL (CN) RAILWAY CAN BE FOUND AT THE FOLLOWING LINK:

HTTPS://WWW.CN.CA/-/MEDIA/FILES/DELIVERING-RESPONSIBLY/SAFETY/UTILITY-INSTALLATION/UTILITY-CROSSING-ENCROACHMENT-APPLICATION-PACKET.PDF

- 29. IL 64 (NORTH AVE) IS A CRITICAL CORRIDOR AND THE CONTRACTOR SHALL MAINTAIN THE TRAFFIC SIGNALS ALONG IL 64 (NORTH AVE) IN NORMAL OPERATION AT ALL TIMES IN ACCORDANCE WITH THE SPECIAL PROVISION MAINTENANCE OF EXISTING TRAFFIC SIGNAL AND FLASHING BEACON INSTALLATION.
- 30. EXISTING VEGETATED AREAS (TREES, SHRUBS, VEGETATIVE BUFFERS, TURF AREAS, ETC.)
  WHERE DISTURBANCE IS NOT OCCURRING (INCLUDING AREAS OUTSIDE THE PROJECT LIMITS)
  SHALL NOT BE DISTURBED TO ENSURE THAT EXISTING VEGETATION IS PRESERVED HEALTHY TO
  MINIMIZE SOIL EROSION AND TO ELIMINATE SOIL COMPACTION. NO MATERIALS ARE TO BE
  STORED OR VEHICLES DRIVEN OR PARKED WITHIN THESE UNDISTURBED AREAS AT ANY TIME.
- 31. EXISTING FACILITIES LOCATED IN THE AREA OF THE SUBJECT IMPROVEMENT TO BE PROTECTED FROM DAMAGE BY THE CONTRACTOR. CONTRACTOR TO CALL BILL O'MALLEY MINIMUM 24 HOURS IN ADVANCE OF WORK WITHIN 25 FT OF THE WEST SHORE PIPELINE (WSPL). WSPL WILL HAVE A REPRESENTATIVE ON SITE CONTINUOUSLY FOR ANY WORK WITHIN 10 FT OF THE PIPELINES. PLEASE PROVIDE MINIMUM 2 FT SEPARATION WHEN CROSSING THE PIPELINES WITH THE PROPOSED CONDUITS AND BACKFILL WITH SAND. PLEASE EXPOSE THE SIDES OF THE PIPELINES (IF DEEMED NECESSARY) PRIOR TO PERFORMING AUGER FOR THE LARGE TRAFFIC SIGNAL FOUNDATIONS.

## NOTICE TO UTILITY COMPANIES

THE DESIGN INTENT OF THIS PROJECT DOES NOT REQUIRE ANY EXISTING UTILITY RELOCATIONS.
DETAILS RELATED TO THE DEPTH OF ALL FOUNDATIONS AND CONDUIT INSTALLATION HAS BEEN
INCLUDED IN THESE DESIGN PLANS. CONTRACTOR TO WORK WITH ENGINEER IF UTILITY CONFLICTS
ARE DISCOVERED SUCH THAT NO EXISTING UTILITY RELOCATIONS ARE TO BE REQUIRED.

## **RED LIGHT RUNNING (RLR) NOTES**

DUE TO THE PRESENCE OF A RED LIGHT RUNNING (RLR) CAMERA FOR THE BELOW LISTED LOCATIONS, THE CONTRACTOR SHALL NOTIFY THE MUNICIPALITY AND RLR CAMERA COMPANY PRIOR TO THE START OF CONSTRUCTION. THE MUNCIPALITY OR THE RLR CAMERA COMPANY SHALL MAKE THE CAMERA INOPERATIVE FOR THE TIME OF CONSTRUCTION. ANY RLR CAMERA EQUIPMENT THAT IS IN CONFLICT WITH THE PROPOSED CONSTRUCTION SHALL BE REMOVED BY ITS RESPECTIVE OWNERS PRIOR TO THE START OF CONSTRUCTION.

RLR CAMERA LOCATIONS:

IL 64 (NORTH AVE) AT KUHN RD (TS 6445)

VILLAGE OF CAROL STREAM 500 N GARY AVE CAROL STREAM, IL 60188 (630) 655-7050

IL 64 (NORTH AVE) AT GARY AVE (TS 6435)

VILLAGE OF CAROL STREAM 500 N GARY AVE CAROL STREAM, IL 60188 (630) 655-7050

IL 64 (NORTH AVE) AT GLEN ELLYN RD/MAIN ST (TS 6450)

 VILLAGE OF GLENDALE HEIGHTS
 REDSPEED ILLINOIS, LLC

 1615 GLEN ELLYN RD
 400 EISENHOWER LN

 GLENDALE HEIGHTS, IL 60139
 LOMBARD, IL 60148

 (630) 260-6000
 (630) 317-5700

IL 64 (NORTH AVE) AT VILLA AVE (TS 6480)

 VILLAGE OF VILLA PARK
 REDSPEED ILLINOIS, LLC
 JOSE CHAVEZ

 20 S ARDMORE AVENUE
 400 EISENHOWER LN
 (630) 936-9129

 VILLA PARK, IL 60181
 LOMBARD, IL 60148
 JOSE.CHAVEZ@REDSPEED-USA.COM

 (630) 834-8500
 (630) 317-5700

(323, 321 313

HOT-MIX ASPHALT MIXTURE REQUIREMENTS										
MIXTURE TYPE	AIR VOIDS @Ndes	QMP								
RESURFACING AT ADA RAMPS										
HOT-MIX ASPHALT SURFACE COURSE, IL-9.5, MIX "D", N70; 2"	4% @ 70 Gyr.	QC/QA								
HMA DRIVEWAY PAVEMENT 8"										
HOT-MIX ASPHALT SURFACE COURSE, IL-9.5, MIX "D", N50; 2"	4% @ 50 Gyr.	QC/QA								
HOT-MIX ASPHALT BINDER COURSE, IL-19.0, N50; 6"	4% @ 50 Gyr.	QC/QA								
CLASS D PATCHING (SPECIAL)										
HOT-MIX ASPHALT SURFACE COURSE, IL-9.5, MIX "D", N70; TOP 2"	4% @ 70 Gyr.	QC/QA								
HOT-MIX ASPHALT BINDER COURSE, IL-19.0, N70; 8"	4% @ 70 Gyr.	QC/QA								
QMP DESIGNATIONS: QUALITY CONTROL/QUALITY ASSURANCE (QC/QA)										

NOTE 1: THE "AC TYPE" FOR POLYMERIZED HMA MIXES SHALL BE "SBS/SBR PG 76-22" AND FOR NON-POLYMERIZED HMA THE "AC TYPE" SHALL BE "PG 64-22" UNLESS MODIFIED BY RECLAIMED MATERIALS SPECIFICATIONS.

NOTE 2: THE UNIT WEIGHT USED TO CALCULATE ALL HMA SURFACE MIXTURE QUANTITIES IS 112 LBS/SQ YD/IN.

REVISED SHEET 2/25/2025

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Kimiev»Horn
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© 2023 KIMLEY-HORN AND ASSOCIATES, INC.
4201 WINFIELD ROAD, SUITE 600
WARRENVILLE, IL 60555
PHONE: 630-487-5550
WWW KIMLEY-HORN COM

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\* SPECIALTY ITEM

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SUMMARY OF QUANTITIES							307	2020-263-S	UR,SW&	TS	DUPAGE	529	16	
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REVISED SHEET 2/25/2025

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*	78009024 MODIFIED URETHANE PAVEMENT MARKING - LINE 24"	FOOT	371	371																											
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	81028200 UNDERGROUND CONDUIT, GALVANIZED STEEL, 2" DIA.	FOOT	7920					5	518	5	5	342	15	36	5	5	306	521	19	336	43	4	128								5331
	81028220 UNDERGROUND CONDUIT, GALVANIZED STEEL, 3" DIA.	FOOT	1815						41	172	90	534	106		72	3	96	195	70	222		2	214					<u> </u>			
	81028240 UNDERGROUND CONDUIT, GALVANIZED STEEL, 4" DIA.	FOOT	34382						717	410		2992	293	46	141	128	431	599		251	256	2	283							27835	
	81029102 UNDERGROUND CONDUIT, 2" DIA., PVC COATED GALVANIZED STEEL	FOOT	487	· · · · · · · · · · · · · · · · · · ·		<b>M</b>	m		m	~~	<u> </u>						m	m	m									<del></del>		487	
	81029104 UNDERGROUND CONDUIT, 4" DIA., PVC COATED, GALVANIZED STEEL	FOOT	546			, , ,		, , ,		, , , ,																				546	<u> </u>
	81101005 CONDUIT ATTACHED TO STRUCTURE, 4" DIA., PVC COATED GALVANIZED STEEL	FOOT	1040				~~~																							1040	
	FVC COATED GALVANIZED STEEL																														

\* SPECIALTY ITEM

Kimley» Horn

5 201 MARTH AND MEDICATION INC.
401 WARREN MARTE BOX SUTT 601

HOWERS DEATH 500

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STATE OF ILLINOIS
DEPARTMENT OF TRANSPORTATION

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REVISED SHEET 2/25/2025

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INTER-CONNECT + NHPP FUNDING (COLUMNS 2, 4, 6-11, 13-15, 17-18, 20) ROADWAY EVP DMS TRAFFIC SIGNALS 0044 0021 0021 0021 0021 CODE TOTAL URBAN ITEM UNIT URBAN URBAN URBAN URBAN QUANTITY \*1 +6 +7 +8 +9 +10 +11 12 +13 +14 +15 16 +17 +18 19 +20 21 22 23 24 25 26 27 \*28 \*29 81300550 JUNCTION BOX, STAINLESS STEEL, ATTACHED TO STRUCTURE, 12" X 12" X 6" 2 2 81300945 JUNCTION BOX, STAINLESS STEEL, ATTACHED TO STRUCTURE, 24" X 24" X 8" 10 EACH 10 81300948 JUNCTION BOX, STAINLESS STEEL, ATTACHED TO STRUCTURE, 24" X 24" X 10" EACH 2 2 <del>amahaantaahaataa</del> <del>matandanatandanatandanatan</del>  $\sim$ 81400100 HANDHOLE EACH 26 3 0 2 18 1 1 1 <del>ululuuluuluuluu</del> <del>who</del> استسلست سلس 9 81400200 HEAVY-DUTY HANDHOLE EACH 9 81400300 DOUBLE HANDHOLE EACH 4 81702120 ELECTRIC CABLE IN CONDUIT, 600V (XLP-TYPE USE) 1/C NO. 6 FOOT 2895 2895 81702415 ELECTRIC CABLE IN CONDUIT, 600V (XLP-TYPE USE) 3-1/C NO. 6 FOOT 60 60 81702420 ELECTRIC CABLE IN CONDUIT, 600V (XLP-TYPE USE) 3-1/C NO. 8 60 60 83800205 BREAKAWAY DEVICE, TRANSFORMER BASE, 15 EACH 3 3  $\overline{\mathbb{L}}$ 85000200 MAINTENANCE OF EXISTING TRAFFIC SIGNAL INSTALLATION

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CONSTRUCTION CODE

87301215	ELECTRIC CABLE IN CONDUIT, SIGNAL NO. 14 2C	FOOT	29098	
87301225	ELECTRIC CABLE IN CONDUIT, SIGNAL NO. 14 3C	FOOT	39739	

87300925 ELECTRIC CABLE IN CONDUIT, TRACER, NO. 14

\* CMAQ FUNDING (COLUMNS 1, 28, 29)

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Kimley»Horn	
© 2023 KIMLEY-HÖRN AND ASSOCIATES, INC.	
4201 WINFIELD ROAD, SUITE 600	
WARRENVILLE, IL 60555	
PHONE; 630-487-5550	
WWW KIMLEY-HORN,COM	

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STATE	OF ILLINOIS	
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	87700404	STEEL MAST ARM ASSEMBLY AND POLE, 62 FT.	EACH	1						1																							ĺ
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<u> </u>		1	l	1													 	1				1		1	1								
	87700408	STEEL MAST ARM ASSEMBLY AND POLE, 64 FT.	EACH	3						1		1							1														<u> </u>
																																	·
$\vdash$	87700414	STEEL MAST ARM ASSEMBLY AND POLE, 66 FT.	EACH	4						1		1						1	1			1											
<u> </u>	07700414		LACII	1						1		1					<u> </u>		1			1	1			1							
																																	<u> </u>
	87700420	STEEL MAST ARM ASSEMBLY AND POLE, 70 FT.	EACH	1															1														i '
$\vdash$										Ť				i				1				1	<u> </u>	İ	1								
<u> </u>										-			_				1					-		1									
	87700430	STEEL MAST ARM ASSEMBLY AND POLE, 75 FT.	EACH	3									2					1															
																																	·
	87702484	STEEL MAST ARM ASSEMBLY AND POLE WITH DUAL MAST ARMS, 30 FT. AND 54 FT.	EACH	2									1						1					1									
<u> </u>	1	MAST ARMS, 30 FT. AND 54 FT.	1	<u> </u>									-						1 1			1											
	87702490	STEEL MAST ARM ASSEMBLY AND POLE WITH DUAL MAST ARMS, 32 FT. AND 40 FT.	EACH	1								1																					·
														i					İ			İ											Ī
<u> </u>		  STEEL MAST ARM ASSEMBLY & POLE WITH DUAL																1				1	<u> </u>	1	1	1							
Ļ	87703282	STEEL MAST ARM ASSEMBLY & POLE WITH DUAL MAST ARMS, <b>75</b> FT. & 42 FT.	EACH	1						1								<u> </u>	ļ			<u> </u>			<u> </u>	<u> </u>							<u> </u>
_	~~~~						~~~																										İ
j\$	87702900	STEEL COMBINATION MAST ARM ASSEMBLY AND POLE 34 FT.	EACH	1			• • • •			<u> </u>			T			1						İ	İ	İ	İ								
		POLE 34 FT.					w		<del></del>	<del>  </del>			$\dashv$				l 						<u> </u>										
<u></u>		CTEEL COMPLINATION MACT ADM ACCEMBLY AND											_					_							_								
L	87702930	STEEL COMBINATION MAST ARM ASSEMBLY AND POLE 40 FT.	EACH	2												1								1									<u> </u>
										İ			T																				
-	07702010	STEEL COMBINATION MAST ARM ASSEMBLY AND POLE 56 FT.	EACH	1									1				<u> </u>	$\vdash$				+	<del>                                     </del>	1	$\vdash$	1							
_	0//03010	POLE 56 FT.	EACH	1									1					<u> </u>				1			<u> </u>								<u></u>
		i e e e e e e e e e e e e e e e e e e e	·																														

CONSTRUCTION CODE

$\Lambda$	REVISED	SHEET	2/25/2025
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PLOT SCALE =	CHECKED _	REVISED _
	DRAWN _	REVISED _
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STATI	E OF	- ILLINOIS
DEPARTMENT	0F	TRANSPORTATION

								RTE.	SECTION	COUNTY	SHEETS	NO.
		SUI	VIIVI <i>F</i>	AHY	OF QU	ANTITIES		307	2020-263-SUR,SW&TS	DUPAGE	529	21
										CONTRAC	T NO. 62	2N33
SCALE:	SHEET	8	OF	14	SHEETS	STA.	TO STA.		ILLINOIS FED. A	ID PROJECT		

\* CMAQ FUNDING (COLUMNS 1, 28, 29)

		*CMAQ FUNDING (COLUMNS 1, 28, 29)				CONSTRUCTION CODE												INITED															
		+ NHPP FUNDING (COLUMNS 2, 4, 6 -11, 13-15, 17-18	, 20)		ROADWAY		TRAFFIC SIGNALS												INTER- CONNECT	DMS													
	CODE			TOTAL	0021		0021												0021	0044													
SP	CODE NO .	ITEM	UNIT	TOTAL QUANT I TY	URBAN										URBAN													URBAN					URBAN
$\square$				`	*1	+2	3	3   +4   5   +6   +7   +8   +9   +10   +11   12   +13   +14   +15   16   +17   +18   19   -										+20	21	22	23	24	25	26	27	*28	*29						
																										i l							
	87703020	STEEL COMBINATION MAST ARM ASSEMBLY AND POLE 58 FT.	EACH	2		İ							1	İ							1						İ				İ		
+		POLE 58 FT.		_									-	1																			
	87703050	STEEL COMBINATION MAST ARM ASSEMBLY AND POLE 64 FT.	EACH	7							1			1	2	2			1														ı
$\vdash$		STEEL COMBINATION MAST ARM ASSEMBLY AND		_								-		+ -			-				 								 				
	87703070	STEEL COMBINATION MAST ARM ASSEMBLY AND POLE 66 FT.	EACH	3							1			1				1															
																																	1
	87703080	STEEL COMBINATION MAST ARM ASSEMBLY AND POLE 68 FT.	EACH	1			İ					İ	İ	İ	İ	İ	İ	1	İ							İ	İ	İ	İ		İ		
$\vdash$		PULE DO FI.			<u> </u>	<u> </u>	l							1		<u> </u>																	
		CTEEL COMPLINATION MACT ARM ACCESSED V												1																			
	87703120	STEEL COMBINATION MAST ARM ASSEMBLY AND POLE 75 FT.	EACH	6									6																				1
1	07000100	CONCRETE FOUNDATION, TYPE A	ГООТ	216					4	36	4		60	4	4	12			12		24	4		20					<u> </u>				
	87800100	CONCRETE FOUNDATION, TIPE A	FOOT	216					4	36	4	8	60	4	4	12	8	8	12	8	24	4		20		ı							
																																	1
	87800150	CONCRETE FOUNDATION, TYPE C	FOOT	8									4											4									
						<u> </u>																											
$\square$		CONCRETE FOUNDATION TYPE F 30 INCH												-																			
	87800400	CONCRETE FOUNDATION, TYPE E 30-INCH DIAMETER	FOOT	148							10	10				20		10	30	14	27			27									1
	07000/15	CONCRETE FOUNDATION, TYPE E 36-INCH DIAMETER	FOOT	195						13	14	14	64			22			16		13			39									
	0/000413	DIAMETER	1 1001	195	1					13	14	14	04			22		<u> </u>	10		13			29					<u> </u>				
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:	87800420	CONCRETE FOUNDATION, TYPE E 42-INCH DIAMETER	FOOT	836						92	46	50	242	46	42	42		100	92	42	42												í
		D 17 WILL I LIN			Ι.Δ.				$\overline{\Lambda}$					1				<u> </u>															
$\vdash$			1 (	mm	1				717	$\sim$	17							l											 				
	87900200	DRILL EXISTING HANDHOLE	EACH	266	<u> R</u>	1				38	3 9	5	72	12	4	12	3	22	20	6	9	7		12								34	
			'		Υ						ľ																						í
	87900205	DRILL EXISTING HEAVY DUTY HANDHOLE	EACH	1			İ								İ		İ		İ													1	i
$\vdash$		Z. Z. Z. Z. Z. Z. Z. Z. Z. Z. Z. Z. Z. Z	1 27.671	1																													
Ц																											ļ						
	88030020	SIGNAL HEAD, LED, 1-FACE, 3-SECTION, MAST-ARM MOUNTED	EACH	233						17	12	14	62	10	12	12		28	24	12	16			14								,	ı
H			İ				İ							1	İ		İ													İ			
$\vdash$		  SIGNAL HEAD   FD   1-FACE   3-SECTION	_,				<u> </u>					<u> </u>		+	-	_	_	_	<u> </u>								<u> </u>						
	88030050	SIGNAL HEAD, LED, 1-FACE, 3-SECTION, BRACKET MOUNTED	EACH	73					4	2	2	4	21	6	2	2	1	6	4	5	4			10			<u> </u>						
		l .	1	1	1													1	1			1											

CONSTRUCTION CODE

/	Λ RE\	/ISED	SHEET	2/25/2025
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	DRAWN -	REVISED -
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PLOT DATE =	DATE -	REVISED -

STATE	OF ILLINOIS	
DEPARTMENT O	F TRANSPORTATION	

SCALE:

	F.A.P. RTE.	SECTION	COUNTY	TOTAL	SHEET NO.		
SUMMARY OF QUANTITIES	307	2020-263-SUR,SW&TS	DUPAGE	529	22		
				CONTRACT	NO. 62	2N33	
SHEET 9 OF 14 SHEETS STA.	TO STA.		ILLINOIS FED.	AID PROJECT			

89502385 REMOVE EXISTING CONCRETE FOUNDATION EACH 79 6 5 14 2 5 X0320023 CLOSED CIRCUIT TELEVISION DOME CAMERA, HD EACH 20 20 X0324085 EMERGENCY VEHICLE PRIORITY SYSTEM LINE SENSOR CABLE, NO. 20 3/C FOOT 15133 X0324600 IDOT COMM CENTER NODE EACH X0326948 CLOSED CIRCUIT TELEVISION CAMERA STRUCTURE, 50 FT. MOUNTING HEIGHT EACH 3 X0326949 CLOSED CIRCUIT TELEVISION CAMERA STRUCTURE FOUNDATION, 30" DIAMETER FOOT 41 X0327130 DMS FRONT ACCESS, FULL MATRIX, NTCIP 1203 EACH 3 X0328020 CENTRACS LICENSE EXPANSION EACH 10 1 1 1 X0328033 TERMINAL SERVER EACH

ROADWAY

0021

URBAN

\*1

2

82

221

82 | 81 | 130 | 134

1

3

1

2

1

3

1

TOTAL

QUANTITY

40

UNIT

EACH

EACH

REVISED SHEET 2/25/20	25
<u> </u>	

\* CMAQ FUNDING (COLUMNS 1, 28, 29)

89502376 REBUILD EXISTING HANDHOLE

89502380 REMOVE EXISTING HANDHOLE

X1400096 LED LAMP MODULE REPLACEMENT

X1400102 OUTDOOR RATED NETWORK CABLE

X1400150 SERVICE INSTALLATION, GROUND MOUNTED,

CODE

+ NHPP FUNDING (COLUMNS 2, 4, 6-11, 13-15, 17-18, 20)

ITEM

USER NAME =	DESIGNED -	REVISED -
	DRAWN -	REVISED -
PLOT SCALE =	CHECKED -	REVISED -
PLOT DATE =	DATE -	REVISED -

EACH

FOOT

EACH

849

2851

26

STATI	E OF	ILLINOIS
DEPARTMENT	OF	TRANSPORTATION

145

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1

1

1

359 | 159 | 258 | 1193 | 387

1

CONSTRUCTION CODE

+6 +7 +8 +9 +10 +11 12 +13 +14 +15 16 +17 +18 19 +20 21 22 23 24 25 26 27

2

3

6

4

TRAFFIC SIGNALS

0021

URBAN

2

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7

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56

2

2

SCALE:

1

30

1

2 1

2

75

124

2

90

1

2

3

11

4

13 2

	F.A.P. RTE.	SECTION		COUNTY	TOTAL SHEETS	SHEET NO.
SUMMARY OF QUANTITIES	307	307 2020-263-SUR,SW&TS DUF		DUPAGE	529	24
				CONTRACT	NO. 62	2N33
SHEET 11 OF 14 SHEETS STA. TO STA		ILLINOIS	FED. AI	D PROJECT		

INTER-CONNECT

0021

URBAN

\*28

DMS

0044

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\*29

2

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3

41

3

EVP

0021

URBAN

2047 | 2648 | 2772 | 1370 | 2488 | 2978 | 830

CODE NO . TOTAL QUANT I TY ITEM URBAN URBAN \*1 +2 3 +4 5 +6 +7 +8 +9 +10 +11 12 +13 +14 +15 16 +17 +18 19 +20 21 22 23 24 25 26 27 2 1 1 5 2 X1400215 REMOTE CONTROLLED VIDEO SYSTEM EACH 15 1 2 2 2 2 X1400216 LAYER II (DATALINK) SWITCH EACH 7 31 ىلىك X1400217 TERMINATE FIBER IN CABINET 1925 X1400221 UPGRADE EXISTING CONTROLLER TO NTCIP EACH 5 1 1 1 1 1 EACH 43 2 10 2 2 9 8 2 4 4 X1400367 PEDESTRIAN SIGNAL POST, 10 FT. X1400378 PEDESTRIAN SIGNAL POST, 5 FT. 3 18 1 2 4 3 2 EACH 42 1 8 X1400381 CABLE, SPECIAL FOOT 974 X1400416 CABINET, MODEL 336S EACH 3 EACH X1400460 LAYER III (NETWORK) SWITCH 9 1 1 X1400514 TACTICS LICENSE EXPANSION EACH 1 1 1 2 1 1 | 1 | 5 | 2 | 1 | 1 1 2 21 X4400501 COMBINATION CURB AND GUTTER REMOVAL AND REPLACEMENT LESS THAN OR EQUAL TO 10 FEET FOOT 17 17 X4400503 COMBINATION CURB AND GUTTER REMOVAL AND REPLACEMENT GREATER THAN 10 FEET FOOT 2360 2360 X4421761 CLASS D PATCHES, TYPE I, 10 INCH (SPECIAL) SQ YD 30 30 X6700410 ENGINEER'S FIELD OFFICE, TYPE A (SPECIAL) CAL MO 27 27

ROADWAY

0021

Λ	REVISED SHEET 2/25/2025

INTER-CONNECT

0021

URBAN

\*28

1925

7

DMS

0044

URBAN

\*29

974

3

EVP

0021

URBAN

<b>Kimley»Horn</b>
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4201 WINFIELD ROAD, SUITE 600
WARRENVILLE, IL 60555
PHONE; 630-487-5550
WWW.KIMI EX-HODN.COM

\* CMAQ FUNDING (COLUMNS 1, 28, 29)

+ NHPP FUNDING (COLUMNS 2, 4, 6-11, 13-15, 17-18, 20)

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	DRAWN -	REVISED -
PLOT SCALE =	CHECKED -	REVISED -
PLOT DATE =	DATE -	REVISED -

STATE OF ILLINOIS **DEPARTMENT OF TRANSPORTATION** 

SCALE:

CONSTRUCTION CODE

TRAFFIC SIGNALS

0021

OURSEADLY OF QUANTITIES					F.A.P. RTE.	SECTION	COUNTY	TOTAL SHEETS	SHEET NO.		
SUMMARY OF QUANTITIES				307	2020-263-SUR,SW&TS	DUPAGE	529	25			
				CONTRACT	NO. 62	2N33					
	SHEET	12	OF	14	SHEETS	STA.	TO STA.	ILLINOIS FED. AID PROJECT			

		* CMAQ FUNDING (COLUMNS 1, 28, 29)		CONSTRUCTION CODE																													
		+ NHPP FUNDING (COLUMNS 2, 4, 6 -11, 13-15, 17-18)	, 20)		ROADWAY									TRAFI	FIC S	I GNAL	S											EVP	_			INTER- CONNECT	DMS
	CODE	_		T	0021																0021				0021	0044							
SP	CODE NO.	ITEM	UNIT	TOTAL QUANT I TY	URBAN					_	_				URBA													URBAN				URBAN	
-					*1	+2	3	+4	5	+6	+7	+8	+9	+10	+11	12	+13	+14	+15	16	+17	+18	19	+20	21	22	23	24	25	26	27	*28	*29
				1	<u> </u>	-						<u> </u>						-					<u> </u>		-			-		<u> </u>	<u> </u>	<u> </u>	<u> </u>
	X701021	TRAFFIC CONTROL AND PROTECTION, (SPECIAL)	L SUM	1	1																												
	~~~		· · · · · · · · · · · · · · · · · · ·		· · · · · · · · · · · · · · · · · · ·	$\downarrow$																											
{	X783005	RAISED REFLECTIVE PAVEMENT MARKER, REFLECTOR REMOVAL	EACH	30	30	$ A \wedge A $																											
			<del>luu</del>	<del>hiiii</del>								İ			İ		İ																
	X810110	UNDERGROUND CONDUIT, MULTI-DUCT, 7-18MM MICRODUCTS	FOOT	90850								<del>                                     </del>	+	+		1	1						1									90850	<u> </u>
	X010110	MICRODUCTS	1001	30030		-			l I		<u> </u>	<u> </u>	+	+		Ì		+					<u> </u>		-		1			-		70030	<u> </u>
						-	1	-				<u> </u>	+-	-		1		+							-					-	-	<u> </u>	<u> </u>
	X814011	HANDHOLE TO BE ADJUSTED	EACH	1	1	1						<u> </u>					<u> </u>													<u> </u>		<u> </u>	ļ
																																	ļ
	X844010	RELOCATE EXISTING LUMINAIRE	EACH	2									2																				
												İ					İ																
	X857021	FULL-ACTUATED CONTROLLER IN EXISTING CABINET	EACH	24		1	1	1	1	1	1	1	4	2	1	1	1	1	2	1	2	1	1										
-		CADINET				1	1		İ		<u> </u>	<u> </u>	1		İ	İ	<u> </u>		<u> </u>				<u> </u>	<u> </u>			<u> </u>		<u> </u>	<u> </u>			†
	V057022	FULL-ACTUATED CONTROLLER AND TYPE IV CABINET, SPECIAL	EACH			1							+ .	1																	+		-
-	70370220	CABINET, SPECIAL	EACH	2		-	1			1		-	1	+			-	+						1	-			<u> </u>		-			-
<u> </u>		LININTERBURTARI E POWER CURRI V AND CARINET				<u> </u>						<u> </u>					<u> </u>											<u> </u>		<u> </u>		<u> </u>	<u> </u>
	X8620250	OUNINTERRUPTABLE POWER SUPPLY AND CABINET, SPECIAL	EACH	1																				1						<u> </u>			
	X862031	REMOVE AND REPLACE BATTERIES FOR UNINTERUPTABLE POWER SUPPLY, EXTENDED	EACH	25																												25	
												İ					İ													<u> </u>			
	X8710029	FIBER OPTIC CABLE 24 FIBERS, SINGLE MODE	FOOT	3755		†	1		1			1	+	†		1	1	1							1					†	+-	3755	1
						+						+	+	+			+	+													_		+
þ					mm	<u>+~</u>	<del> </del>	<u> </u>	<del>\</del>	<del>                                      </del>	<del>\</del>	<del>                                     </del>	<del>\</del>	<del> </del>	+	<del> </del>	<del> </del>	<del>\</del>	<del>\</del>	<del></del>	m	<del>                                     </del>	<del>                                     </del>	<u> </u>	$\frac{1}{1}$	<del>                                     </del>	<del>                                      </del>	<del>                                     </del>	<u> </u>	<del>                                     </del>	<del>                                      </del>		K A
		FIBER OPTIC CABLE 144 FIBERS, SINGLE MODE	FOOT	192600	*****		1 2 2 2		k	X	1 2 2	XI X X X		X	1 2 2	XI X X X	1 2 2	212.2			1 2 2 .	X	N N N .	12.2.2	N N N	N		X	K X X Z	X		192600	<u>}                                    </u>
																																	<u> </u>
	X871005	FIBER OPTIC TERMINATION PANEL, 12 F OR 24F	EACH	37																												34	
	X871006	FIBER OPTIC CABLE, MICRO, 144 FIBERS, SINGLE MODE	FOOT	183520		1						1	1		İ		İ	İ					Ì		1			1		İ		183520	
		STREE PIODE							1		1	<del>                                     </del>	+		1	1	1		+	+			†							†			
	V071000	4 FIBER OPTIC INTERCONNECT CENTER. 48 PORT	EACH	37		1			1		<u> </u>	<u> </u>	1		1	1	1		1	1			1	<u> </u>			<u> </u>	1		1	+	37	<u> </u>
	V0 / 100 8	FILE OF IC INTERCONNECT CENTER, 48 PORT	EACH	31		-			1		1	1			1	1	1		_	1			-							-	-	3/	

REVISED SHEET 2/25/202
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4201 WINFIELD ROAD, SUITE 600
WARRENVILLE, IL 60555
PHONE; 630-487-5550
MANAGEMENT BY HORN COM

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PLOT SCALE =	CHECKED -	REVISED -	
PLOT DATE =	DATE -	REVISED -	

STATE OF ILLINOIS								
DEPARTMENT	OF TRA	NSPORTATION						

SCALE:

CUMANADY OF QUANTITIES									SECTION	COUNTY	TOTAL SHEETS	SHEET NO.		
	SUMMARY OF QUANTITIES							307	2020-263-SUR,SW&TS	DUPAGE	529	26		
										CONTRACT	NO. 62	2N33		
	SHEET 13 OF 14 SHEETS STA. TO STA.						ILLINOIS FED. A	D PROJECT						

CONSTRUCTION CODE \* CMAQ FUNDING (COLUMNS 1, 28, 29) INTER-CONNECT + NHPP FUNDING (COLUMNS 2, 4, 6-11, 13-15, 17-18, 20) ROADWAY TRAFFIC SIGNALS DMS 0021 0021 0021 0021 0044 TOTAL QUANTITY CODE ITEM URBAN URBAN URBAN URBAN URBAN NO. +2 3 +4 5 +6 +7 +8 +9 +10 +11 12 +13 +14 +15 16 +17 +18 19 +20 21 22 23 24 25 26 27 \*1 \*28 \*29 X8710304 FIBER OPTIC CABLE SPLICE - LATERAL EACH 37 37 56 X8760200 ACCESSIBLE PEDESTRIAN SIGNALS EACH 157 4 2 10 5 2 2 12 16 8 18 16 X8780012 CONCRETE FOUNDATION, TYPE A 12-INCH 112 12 340 4 20 44 48 8 48 12 24 EACH 22 | 22 | 22 | 22 | 22 | 22 | 22 | 22 | 22 | 22 | 22 | 22 | 22 X8809005 LED SIGNAL FACE, LENS COVER 433 147 SQ YD 277 277 X4060290 HOT-MIX ASPHALT DRIVEWAY PAVEMENT, 8" Z0013798 CONSTRUCTION LAYOUT L SUM 1 1 SQ FT X7200061 TEMPORARY INFORMATION SIGNING 380 380 27 27 X8000003 MAINTENANCE OF LIGHTING SYSTEM Z0033052 COMMUNICATIONS VAULT EACH 132 132 Z0048665 RAILROAD PROTECTIVE LIABILITY INSURANCE L SUM 1 1 Z0073510 TEMPORARY TRAFFIC SIGNAL TIMING EACH 1 1 Z0076600 TRAINEES HOUR 2000 2000 Ø Z0076604 TRAINEES TRAINING PROGRAM GRADUATE 2000 2000

REVISED SHEET 2/25/2025
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Kimley» Horn

D 2021 MARLY-HÖRN NO A BSOCIATIS, NC.
4901 WARRENMLLE, IL 00005

WARRENMLLE, IL 00005

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PLOT DATE =	DATE -	REVISED -

STATE OF ILLINOIS
DEPARTMENT OF TRANSPORTATION

SCALE:

		1	7.2	/
	F.A.P. RTE.	SECTION	COUNTY S	OTAL SHEET HEETS NO.
SUMMARY OF QUANTITIES	307	2020-263-SUR,SW&TS	DUPAGE	529 27
			CONTRACT N	NO. 62N33
SHEET 14 OF 14 SHEETS STA. TO STA.		ILLINOIS FE	ED. AID PROJECT	

Ø 0042

## **MAINTENANCE OF TRAFFIC GENERAL NOTES**


- 1. THE MAINTENANCE OF TRAFFIC PLANS SHALL SERVE AS A GUIDE FOR THE SAFE DIVERSION OF TRAFFIC DURING THE EXECUTION OF THIS CONTRACT. THE CONTRACTOR MAY MODIFY THE MAINTENANCE OF TRAFFIC PLANS TO MEET CONSTRUCTION NEEDS BUT NOT AT THE EXPENSE OF PUBLIC SAFETY OR CONVENIENCE. ANY CHANGES TO THE TRAFFIC CONTROL PLANS SHALL BE SUBMITTED TO THE ENGINEER
- 2. ALL TRAFFIC CONTROL DEVICES SHALL BE REFLECTORIZED PRIOR TO INSTALLATION AND CLEANED AS SPECIFIED IN THE TRAFFIC CONTROL SPECIAL PROVISIONS OR AS DIRECTED BY THE ENGINEER.
- 3. FOR STABILIZATION, ANY REQUIRED TYPE III BARRICADES SHALL REQUIRE A MINIMUM OF FOUR SAND BAGS PER BARRICADE.
- 4. EXISTING SIGNS WITHIN THE LIMITS OF TRAFFIC CONTROL WHICH ARE OBSTRUCTED BY OR OTHERWISE INTERFERED WITH BY CONSTRUCTION OPERATIONS OF DESIGNATED TRAFFIC CONTROL, SHALL BE COVERED OR REMOVED BY THE CONTRACTOR UNLESS SPECIFIED IN THE PLANS OR WHEN DIRECTED BY THE ENGINEER. THIS WORK SHALL BE AS SPECIFIED IN ARTICLE 107.25 OF THE STANDARD SPECIFICATIONS
- 5. THE CONTRACTOR SHALL CONTACT THE DISTRICT ONE ARTERIAL TRAFFIC CONTROL SUPERVISOR AT KALPANA.KANNAN-HOSADURGA@ILLINOIS.GOV A MINIMUM OF 72 HOURS IN ADVANCE OF BEGINNING ANY
- 6. THE ENGINEER SHALL COORDINATE CLOSURES WITH PACE AT LEAST TWO WEEKS PRIOR TO BEGINNING OF CONSTRUCTION.
- 7. ALL DRIVEWAY ENTRANCE SIGNING REQUIRED PER DISTRICT STANDARD TC-26 SHALL BE PAID FOR AT THE CONTRACT UNIT PRICE PER SQUARE FOOT FOR TEMPORARY INFORMATION SIGNING.
- 8. THE CONTRACTOR IS ADVISED THAT THE EXISTING AND/OR TEMPORARY TRAFFIC SIGNAL INSTALLATION MUST REMAIN IN OPERATION DURING ALL CONSTRUCTION STAGES, EXCEPT FOR THE MOST ESSENTIAL DOWN TIME ANY SHUTDOWN OF THE TRAFFIC SIGNAL INSTALLATION, WHICH EXCEEDS FIFTEEN (15) MINUTES MUST HAVE PRIOR APPROVAL OF THE ENGINEER APPROVAL TO TURN OFF THE TRAFFIC SIGNAL INSTALLATION WILL ONLY BE GRANTED DURING THE PERIOD EXTENDING FROM 9:00 AM TO 3:00 PM ON WEEKDAYS UNLESS PRIOR APPROVAL OF AN EXCEPTION IS RECEIVED IN WRITING FROM THE ENGINEER. SHUTDOWNS SHALL NOT BE ALLOWED DURING INCLEMENT WEATHER OR HOLIDAY PERIODS. PRIOR TO ANY SHUTDOWN WITH DARK SIGNAL INDICATIONS, THE CONTRACTOR SHALL INSTALL CONES ON THE ENDS OF ALL LANE LINES AT THE STOP BAR ON EACH APPROACH, 48" R1-1 STOP SIGNS AT THE STOP BAR ON EACH APPROACH ON THE RIGHT SIDE AND ON RAISED MEDIANS (WHERE APPLICABLE), AND 48" X 48" BLACK ON FLUORESCENT ORANGE "SIGNALS OUT AHEAD" WARNING SIGNS FOLLOWED BY 48" X 48" FLUORESCENT ORANGE W3-1 SYMBOLIC STOP AHEAD WARNING SIGNS ON ALL APPROACHES TO THE INTERSECTION.

# **SUGGESTED SEQUENCE OF OPERATIONS**


### STAGE 1

- INSTALL TRAFFIC CONTROL DEVICES AND TEMPORARY PAVEMENT MARKINGS AT DMS LOCATIONS 1, 2, & 3 AS SHOWN IN THE MAINTENANCE OF TRAFFIC PLANS.
- CLOSE THE OUTSIDE SHOULDER/RIGHT TURN LANE OF EB IL 64 AT DMS LOCATION 1 AS SHOWN IN THE MAINTENANCE OF TRAFFIC PLAN.
- CLOSE THE OUTSIDE SHOULDER OF WB IL 64 AT DMS LOCATION 2 AS SHOWN IN THE MAINTENANCE
- CLOSE THE INSIDE THROUGH LANE OF WB IL 64 AND LEFT TURN/U-TURN LANE OF EB IL 64 AT DMS LOCATION 3 AS SHOWN IN THE MAINTENANCE OF TRAFFIC PLAN.
- CONSTRUCT DYNAMIC MESSAGE SIGNS & CCTV CAMERAS ALONG IL 64 AND AS SHOWN IN THE MAINTENANCE OF TRAFFIC AND DMS & CCTV SITE INSTALLATION PLANS.
- UTILIZING APPLICABLE HIGHWAY AND DISTRICT STANDARDS, PERFORM TRAFFIC SIGNAL INSTALLATION AND ADA SIDEWALK IMPROVEMENTS AT THE LOCATIONS SHOWN ON THE PLANS.


UTILIZING APPLICABLE DISTRICT AND HIGHWAY STANDARDS, PLACE PERMANENT PAVEMENT MARKINGS ALONG IL 64 AT THE LOCATIONS SHOWN IN THE PLANS

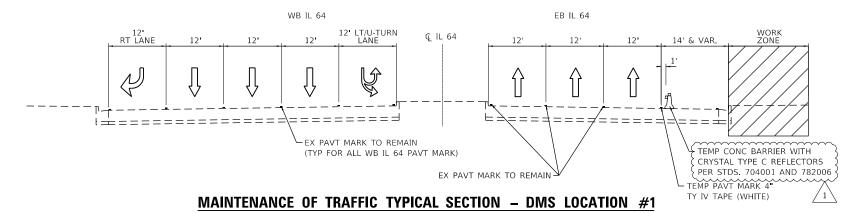

IL 64 (NORTH AVE) AT DMS STRUCTURE LOOKING EAST

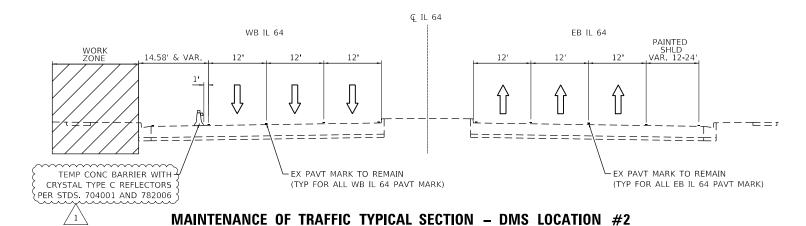


IL 64 (NORTH AVE) AT DMS STRUCTURE LOOKING EAST

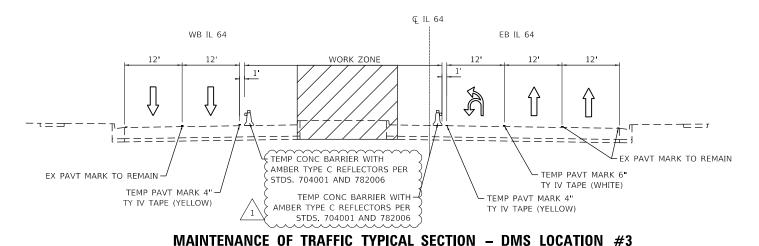

IL 64 (NORTH AVE) AT DMS STRUCTURE LOOKING EAST


	USER NAME = Joel.Turk	DESIGNED -	RC	REVISED - <u>\(\)</u> 2/18/2025
٠		DRAWN -	RC	REVISED -
	PLOT SCALE = 20.0000 ' / in.	CHECKED -	ST	REVISED -
	PLOT DATE = 2/18/2025	DATE -	1/18/2024	REVISED -


			F.A.P. RTE	SECTION	COUNTY	TOTAL SHEETS	
MAINTENANC	: OF TRAFFIC – GENERAL	NOTES AND TYPICAL SECTIONS	307	2020-263-SUR,SW&TS	DUPAGE	529	31
					CONTRACT	NO. 62	2N33
SCALE: N.T.S.	SHEET 1 OF 1 SHEET	S STA. TO STA.		ILLINOIS FED. A	ID PROJECT		

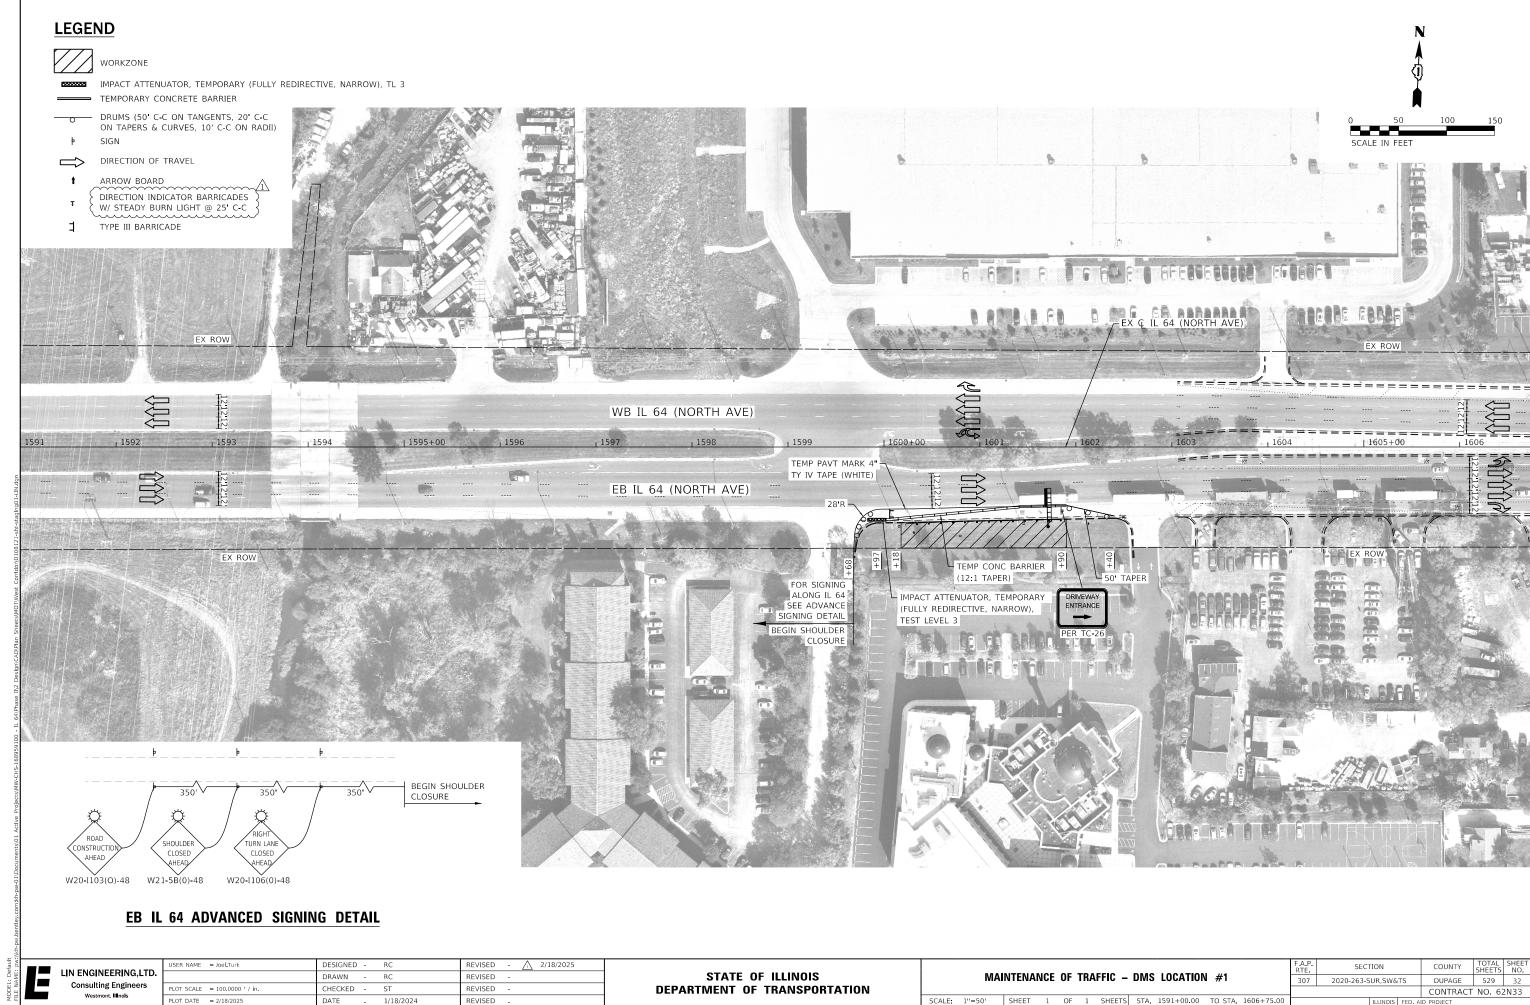



DATE


1/18/2024

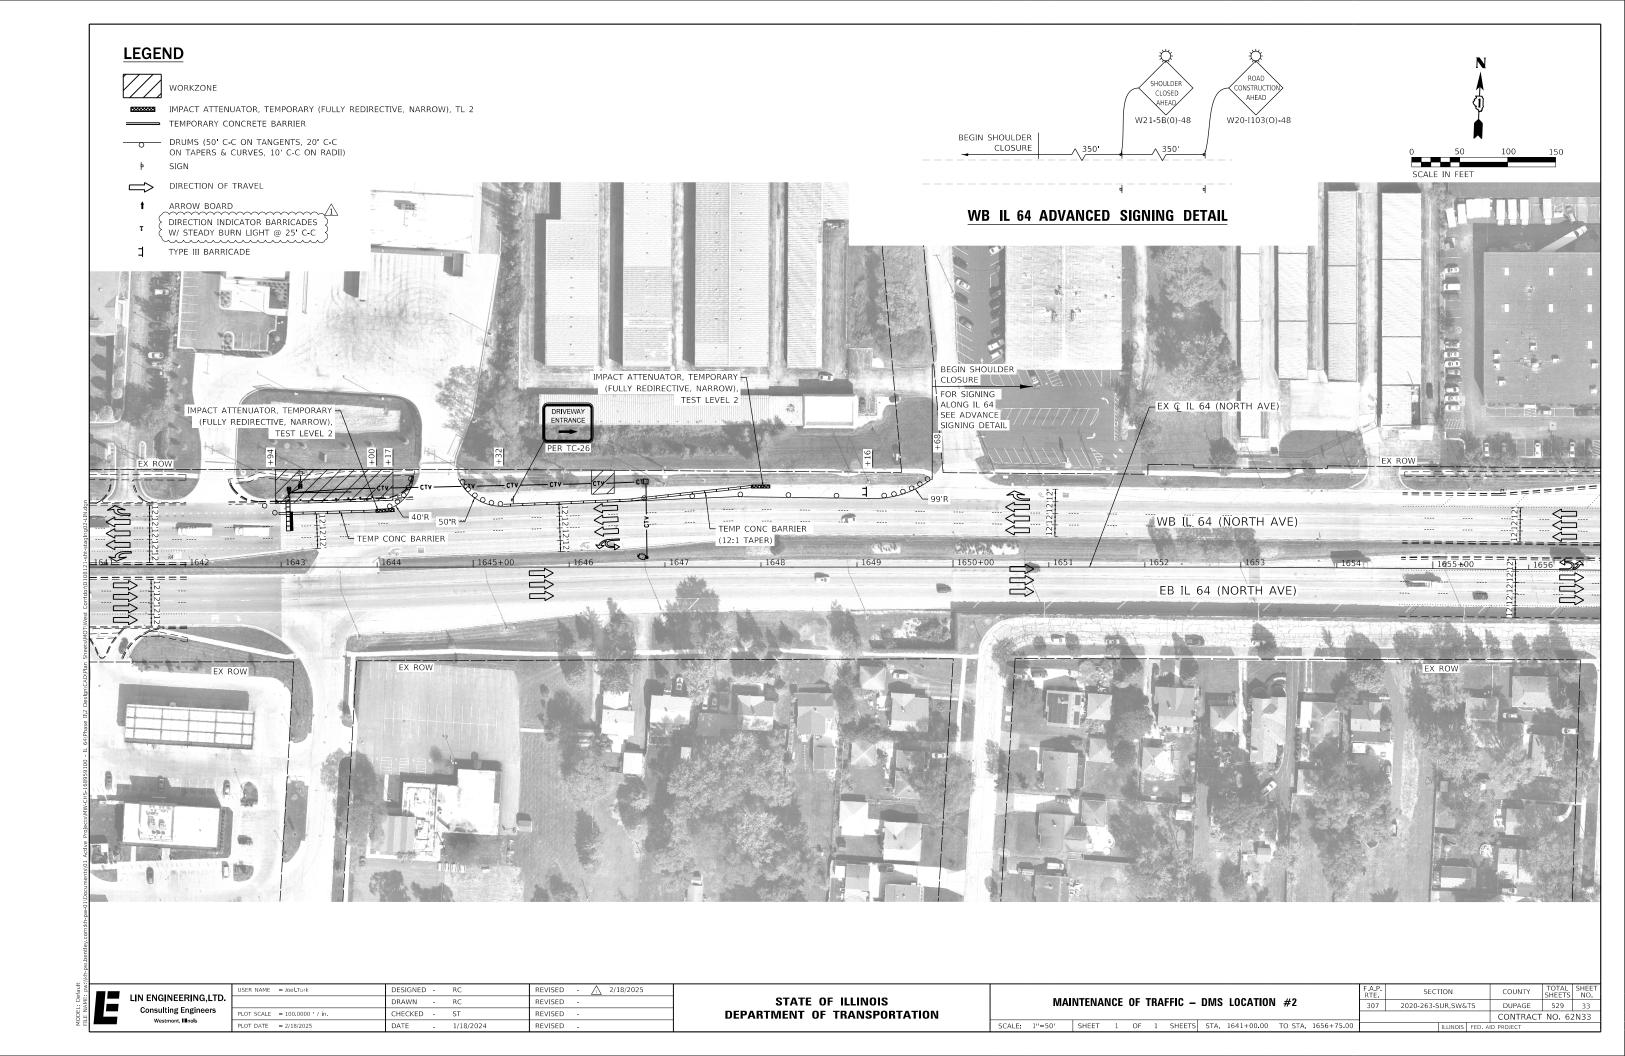

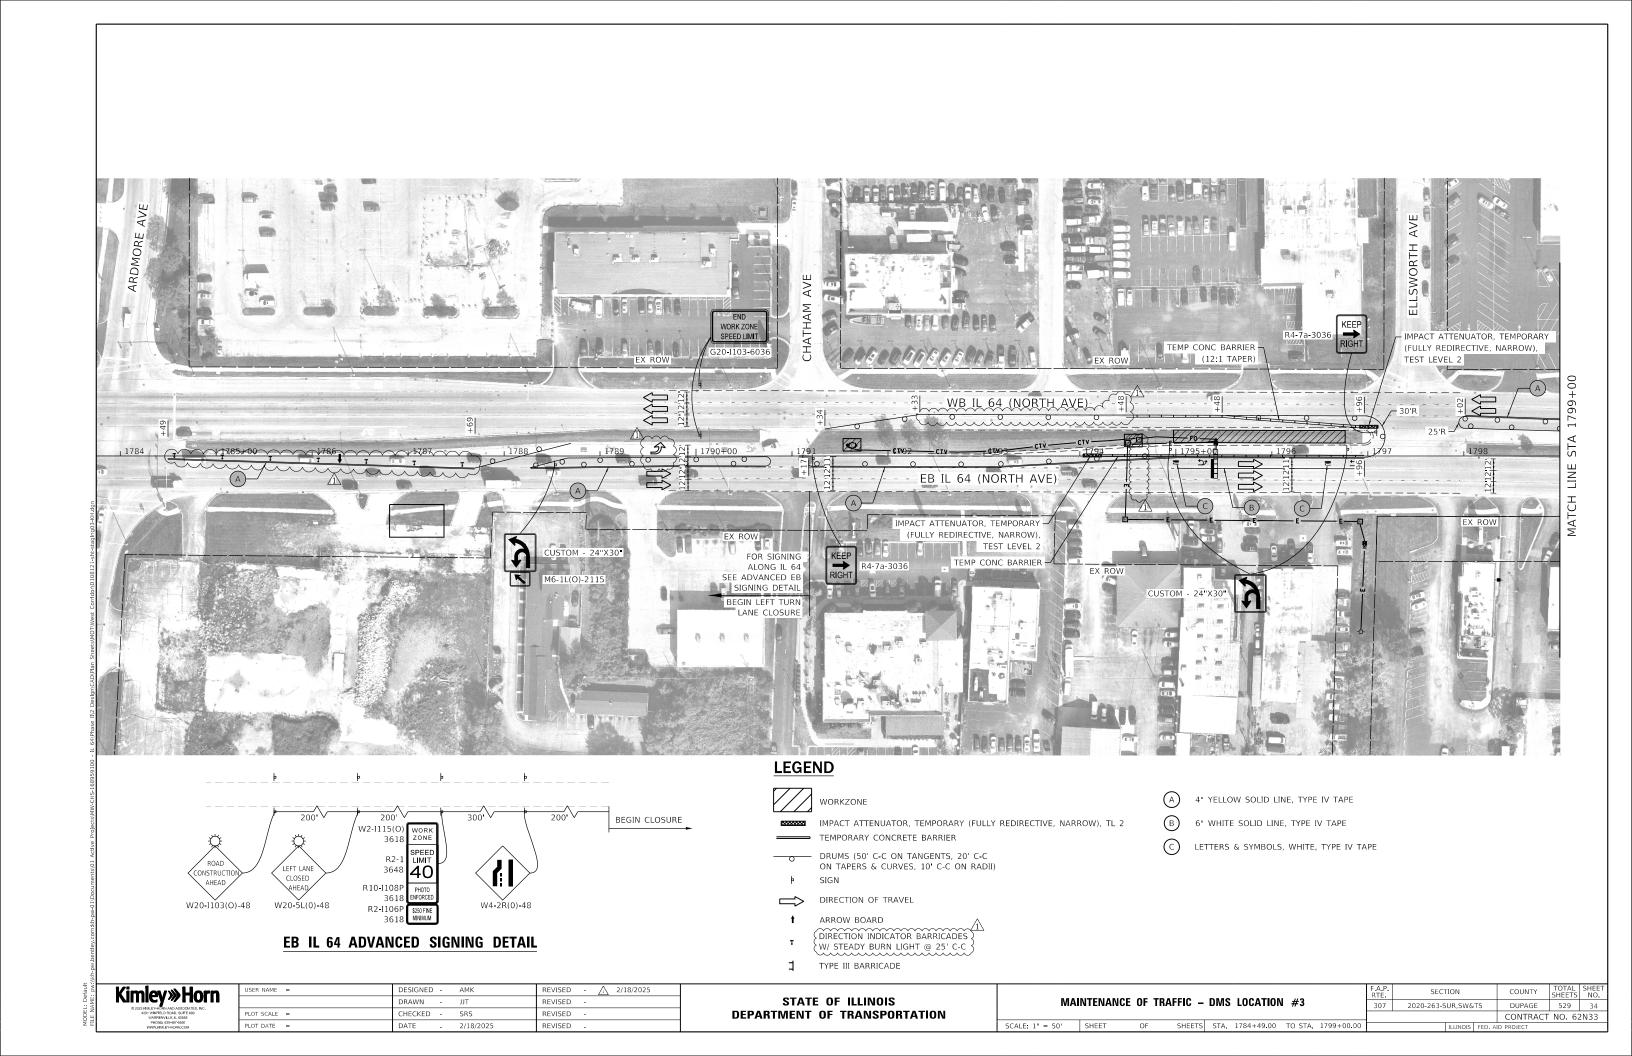

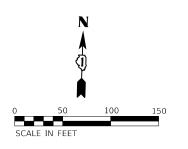

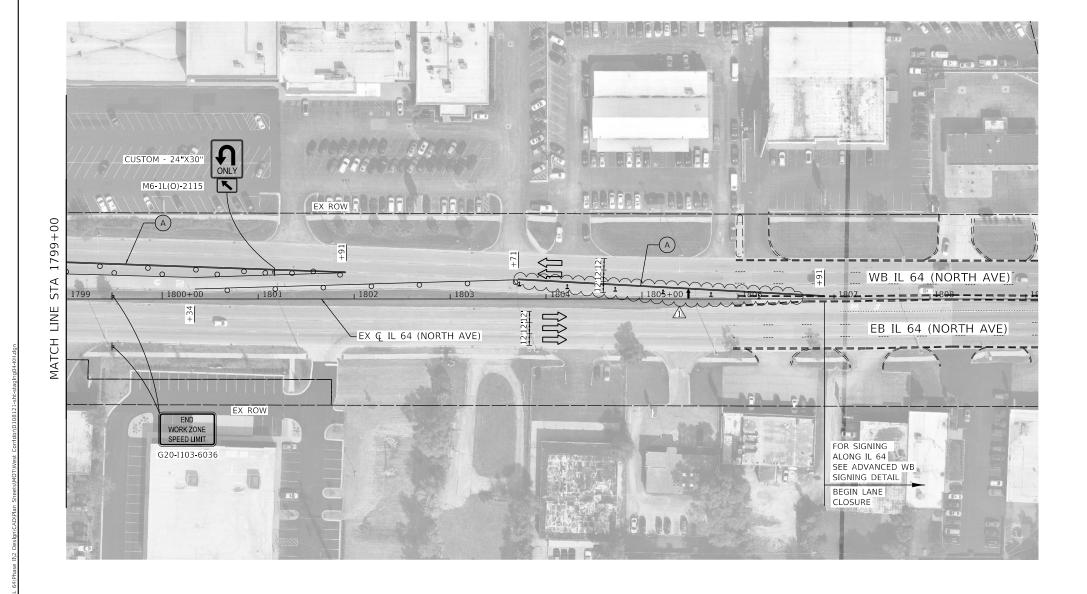

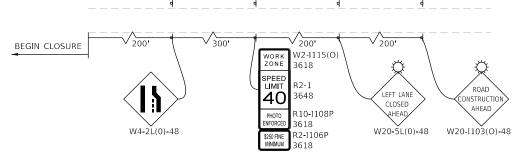

# WB IL 64 ADVANCED SIGNING DETAIL

Kimley»Horn	USER NAME =	DESIGNED -	AMK	REVISED - 🛕 2/1
CALL HECY # 1 TO 1 11		DRAWN -	JJT	REVISED -
4201 WINFIELD ROAD, SUITE 600 WARRENVILLE, IL 60555	PLOT SCALE =	CHECKED -	SRS	REVISED -
PHONE: 630-487-5550	DI OT DATE	DATE	2/10/2025	DEVICED

## STATE OF ILLINOIS **DEPARTMENT OF TRANSPORTATION**

MAINTENANCE OF TRAFFIC PAGE LOCATION #2							F.A.P. RTE			
	MAINTENANCE OF TRAFFIC – DMS LOCATION #3							307		
SCALE:	1"=50"	SHEET	OF	SHEETS	STA.	1799+00.00	TO STA.	1806+91.00		Т

**LEGEND** 

WORKZONE

DIRECTION OF TRAVEL ARROW BOARD

TYPE III BARRICADE

- DRUMS (50' C-C ON TANGENTS, 20' C-C ON TAPERS & CURVES, 10' C-C ON RADII)

DIRECTION INDICATOR BARRICADES W/ STEADY BURN LIGHT @ 25' C-C


4" YELLOW SOLID LINE, TYPE IV TAPE

6" WHITE SOLID LINE, TYPE IV TAPE

LETTERS & SYMBOLS, WHITE, TYPE IV TAPE


SECTION 2020-263-SUR,SW&TS DUPAGE 529 35 CONTRACT NO. 62N33

2/18/2025

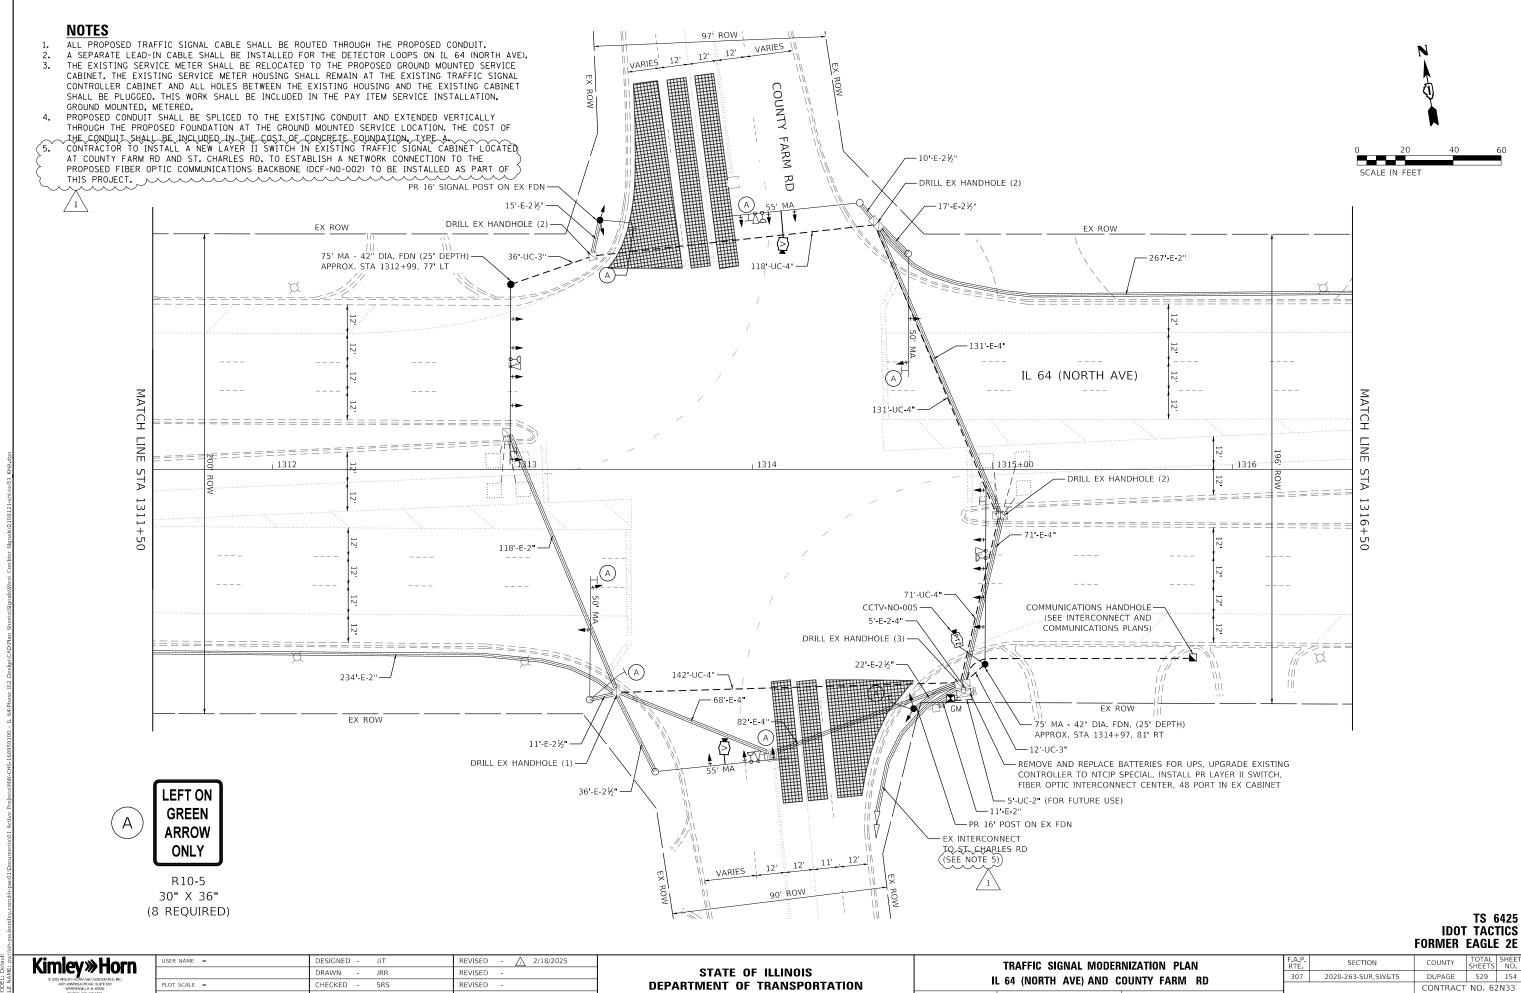

MODEL: Default

# County Farm Rd

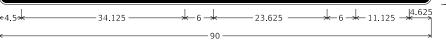

DESIGN	AREA	SIGN PANEL	SHEETING	QTY.
SERIES	(SQ FT)	TYPE	TYPE	REQUIRED
D	11.25	2	ZZ	2



DESIGN SERIES	AREA (SQ FT)	SIGN PANEL TYPE	SHEETING TYPE	QTY. REQUIRED	
D	12.5	2	ZZ	2	

# **SCHEDULE OF QUANTITIES**

ITEM DESCRIPTION	UNIT	QUANTITY
SIGN PANEL - TYPE 2	SQ FT	47.5
UNDERGROUND CONDUIT, GALVANIZED STEEL, 2" DIA.	FOOT	5
UNDERGROUND CONDUIT, GALVANIZED STEEL, 3" DIA.	FOOT	48
UNDERGROUND CONDUIT, GALVANIZED STEEL, 4" DIA.	FOOT	462
MAINTENANCE OF EXISTING TRAFFIC SIGNAL INSTALLATION	EACH	1
ELECTRIC CABLE IN CONDUIT, SIGNAL NO. 14 3C	FOOT	652
ELECTRIC CABLE IN CONDUIT, SIGNAL NO. 14 5C	FOOT	4168
ELECTRIC CABLE IN CONDUIT, SIGNAL NO. 14 7C	FOOT	1258
ELECTRIC CABLE IN CONDUIT, LEAD-IN, NO. 14 1 PAIR	FOOT	1422
ELECTRIC CABLE IN CONDUIT, SERVICE, NO. 6 2 C	FOOT	36
ELECTRIC CABLE IN CONDUIT, EQUIPMENT GROUNDING CONDUCTOR, NO. 6 1C	FOOT	546
TRAFFIC SIGNAL POST, GALVANIZED STEEL 16 FT.	EACH	2
STEEL MAST ARM ASSEMBLY AND POLE, 75 FT.	EACH	2
CONCRETE FOUNDATION, TYPE A	FOOT	4
CONCRETE FOUNDATION, TYPE E 42-INCH DIAMETER	FOOT	50
DRILL EXISTING HANDHOLE	EACH	10
SIGNAL HEAD, LED, 1-FACE, 3-SECTION, MAST-ARM MOUNTED	EACH	16
SIGNAL HEAD, LED, 1-FACE, 3-SECTION, BRACKET MOUNTED	EACH	4
SIGNAL HEAD, LED, 1-FACE, 5-SECTION, MAST-ARM MOUNTED	EACH	4
TRAFFIC SIGNAL BACKPLATE, LOUVERED, FORMED PLASTIC	EACH	20
RELOCATE EXISTING EMERGENCY VEHICLE PRIORITY SYSTEM, DETECTOR UNIT	EACH	2
REMOVE ELECTRIC CABLE FROM CONDUIT	FOOT	8082
REMOVE EXISTING TRAFFIC SIGNAL EQUIPMENT	EACH	1
REMOVE EXISTING HANDHOLE	EACH	1
REMOVE EXISTING CONCRETE FOUNDATION	EACH	2
CLOSED CIRCUIT TELEVISION DOME CAMERA, HD	EACH	1
EMERGENCY VEHICLE PRIORITY SYSTEM LINE SENSOR CABLE, NO. 20 3/C	FOOT	652
OUTDOOR RATED NETWORK CABLE	FOOT	138
SERVICE INSTALLATION, GROUND MOUNTED, METERED	EACH	1
BEMOTE CONTROLLED VIDEO SYSTEM	EACH	nooho.
LAVED II (DATALINE) CMITCH	T V C L	2
TERMINATE FIBER IN CABINET	<b>LEACH</b>	24
UPGRADE EXISTING CONTROLLER TO NTCIP SPECIAL	EACH	1
TACTICS LICENSE EXPANSION	EACH	1
REMOVE AND REPLACE BATTERIES FOR UNINTERUPTABLE POWER SUPPLY, EXTENDED	EACH	1
FIBER OPTIC INTERCONNECT CENTER, 48 PORT	EACH	1
LED SIGNAL FACE, LENS COVER	EACH	24
VIDEO VEHICLE DETECTION SYSTEM, SINGLE APPROACH	EACH	2


\* - 100% COST TO THE VILLAGE OF CAROL STREAM


TS 6425 IDOT TACTICS FORMER EAGLE 2E

Kimley >>> Horn

10 2020 HIMERI-HÜNG WARD ARBORDENER ING.
4007 WINNELD ROOM, DIETTE 600
HARBENLIE IL 00505
PHOTOLE 630-487-8505

USER NAME =	DESIGNED - JJT	REVISED - <u>A</u> 2/18/2025
	DRAWN - JRR	REVISED -
PLOT SCALE =	CHECKED - SRS	REVISED -
PLOT DATE =	DATE - 2/18/2025	REVISED -

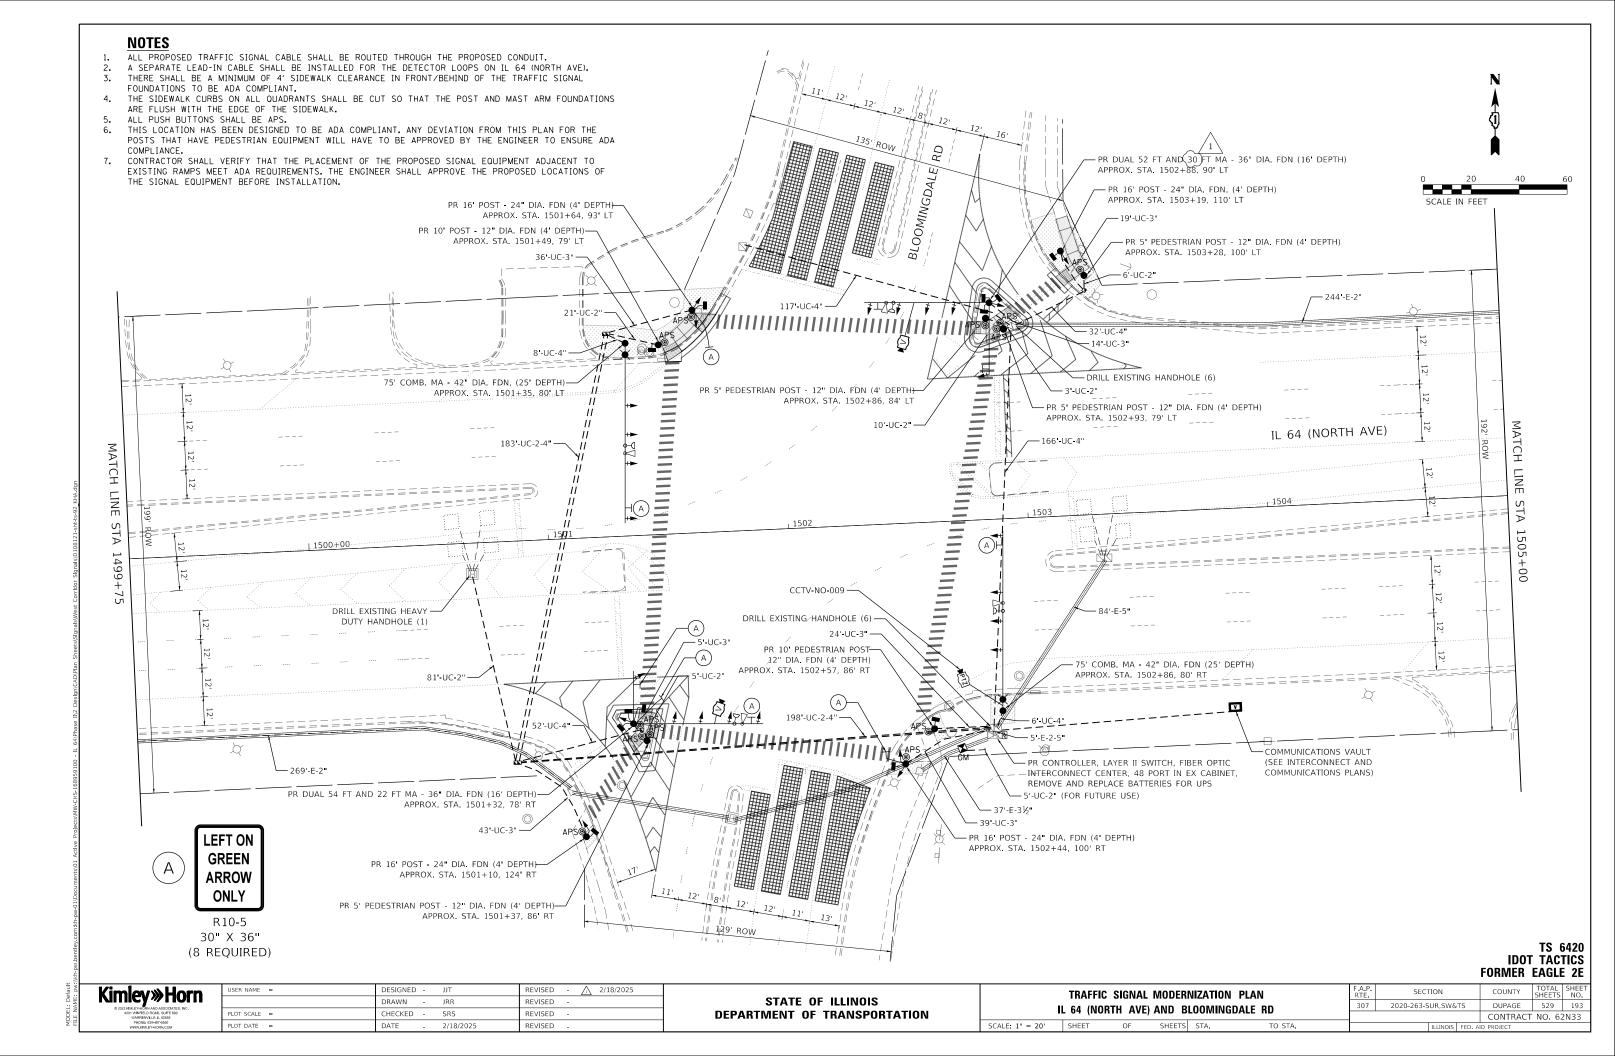

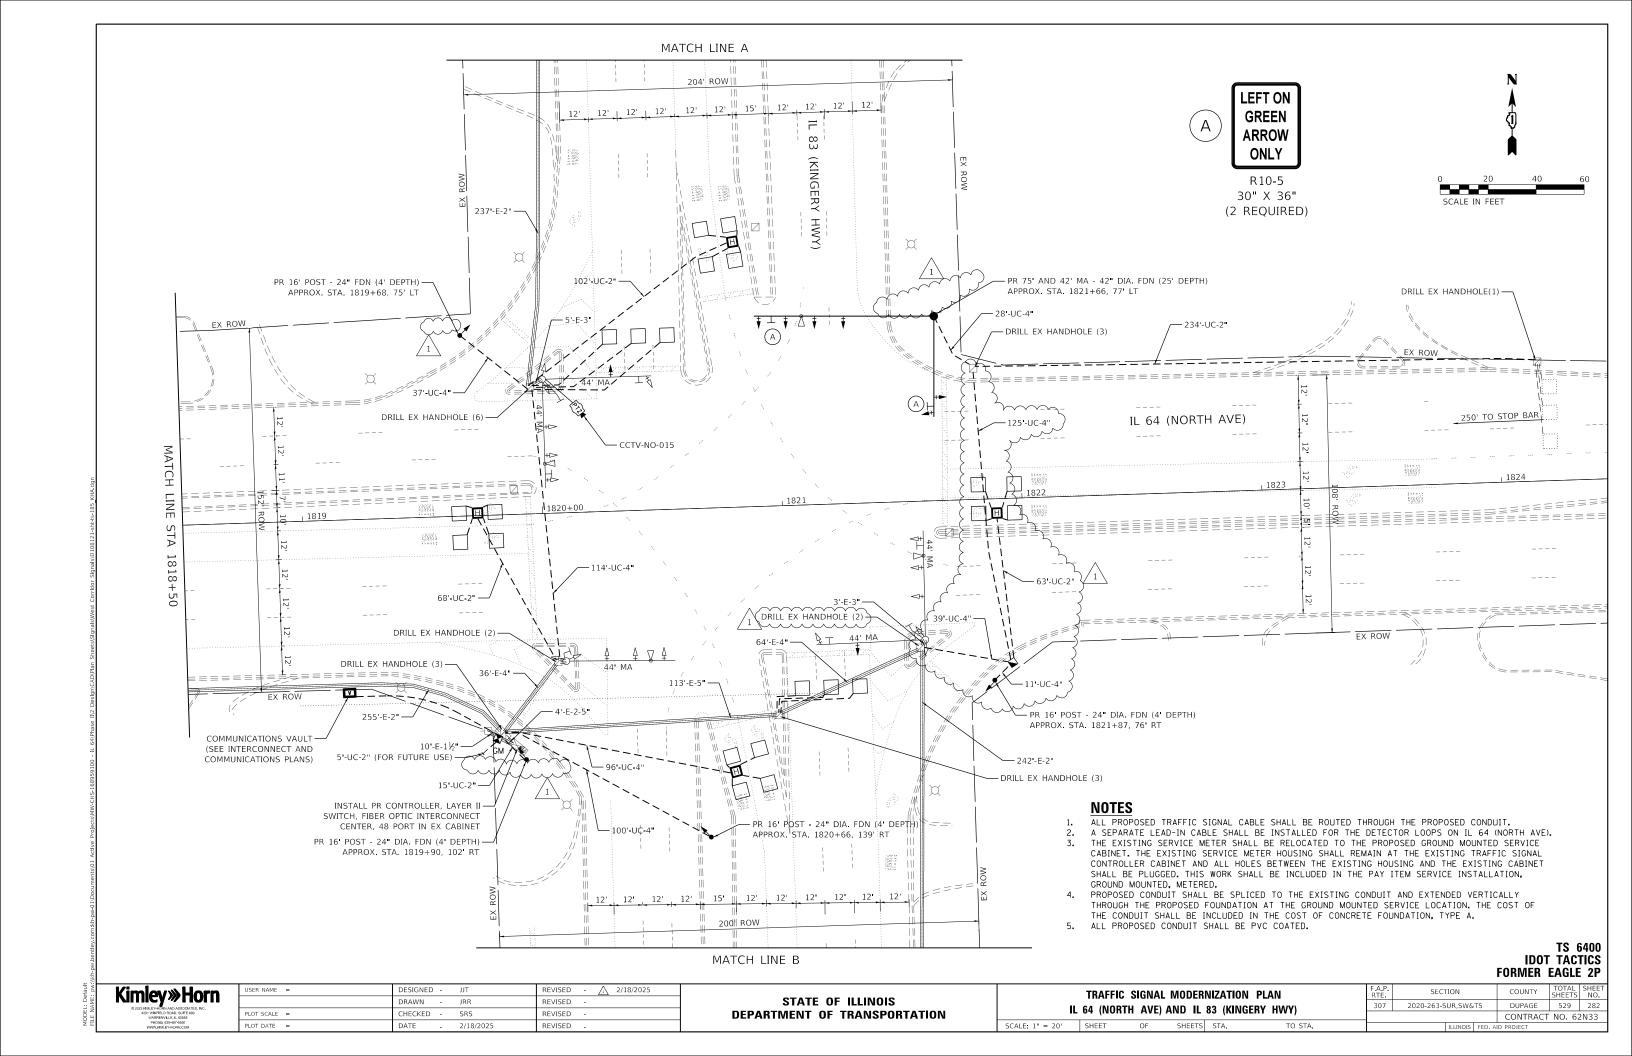



ALL DIMENSIONS ARE IN INCHES UNLESS OTHERWISE NOTED



DESIGN SERIES	AREA (SQ FT)	SIGN PANEL TYPE	SHEETING TYPE	QTY. REQUIRED
D	1 F	2	77	2



DESIGN	AREA	SIGN PANEL	SHEETING	QTY.
SERIES	(SQ FT)	TYPE	TYPE	REQUIRED
D	12.5	2	ZZ	2

## **SCHEDULE OF QUANTITIES**

		1
ITEM DESCRIPTION	UNIT	QUANTITY
SIGN PANEL - TYPE 1	SQ FT	15
SIGN PANEL TYPE?	SQ-FT	<u> </u>
UNDERGROUND CONDUIT, 2" DIA., PVC COATED GALVANIZED STEEL	FOOT	487
UNDERGROUND CONDUIT, 4" DIA., PVC COATED, GALVANIZED STEEL	FOOT	546
HANDHOLE	EACH	1
MAINTÉNANCE OF EXISTING TRAFFIC SIGNAL-INSTALLATION	TEACH	
ELECTRIC CABLE IN CONDUIT, SIGNAL NO. 14 5C	FOOT	2264
ELECTRIC CABLE IN CONDUIT, SIGNAL NO. 14 7C	FOOT	1835
ELECTRIC CABLE IN CONDUIT, LEAD-IN, NO. 14 1 PAIR	FOOT	944
ELECTRIC CABLE IN CONDUIT, SERVICE, NO. 6 2 C	FOOT	32
ELECTRIC CABLE IN CONDUIT, EQUIPMENT GROUNDING CONDUCTOR, NO. 6 1C	FOOT	1041
TRAFFIÇ-SIGNAL POŞT-GALVANIZED STEEL 16 FT.	EACH	
STEEL MAST ARM ASSEMBLY & POLE WITH DUAL MAST ARMS 75 FT & 42 FT	EACH	1
CONCRETE FOUNDATION, TYPE A	4001	<del></del>
CONCRETE FOUNDATION-TYPE E 42-UNCH-DIAMETER	F00T	25
DRILL EXISTING HANDHOLE	EACH	19
SIGNAL-HEAD, LEBY, 1-PACE, 3-SECTION, MAST-ARM MOUNTED	PÉACH!	
SIGNAL HEAD, LED, 1-FACE, 5-SECTION, BRACKET MOUNTED	EACH	4
SIGNAL HEAD, LED, 1-FACE, 5-SECTION, MAST-ARM MOUNTED	EACH	3
TRAFFIC SIGNAL BACKPLATE, RETROREFLECTIVE	EACH	8
INDUCTIVE LOOP DETECTOR	EACH	12
DETECTOR LOOP, TYPE I	FOOT	528
RELOCATE EXISTING EMERGENCY VEHICLE PRIORITY SYSTEM, DETECTOR UNIT	EACH	1
REMOVE ELECTRIC CABLE FROM CONDUIT	FOOT	730
REMOVE EXISTING TRAFFIC SIGNAL EQUIPMENT	EACH	1
REMOVE EXISTING HANDHOLE	EACH	3
REMOVE EXISTING CONCRETE FOUNDATION	EACH	1
CLOSED CIRCUIT TELEVISION DOME CAMERA, HD	EACH	1
EMERGENCY VEHICLE PRIORITY SYSTEM LINE SENSOR CABLE, NO. 20 3/C	FOOT	466
LED LAMP MODULE REPLACEMENT	EACH	54
OUTDOOR RATED NETWORK CABLE	FOOT	228
SERVICE INSTALLATION, GROUND MOUNTED, METERED	EACH	1
REMOTE CONTROLLED VIDEO SYSTEM	EACH	1
TERMINATE FIBER IN CABINET	EACH	12
LED SIGNAL FACE VISOR HEATER	EACH	29
LAYER III (NETWORK) SWITCH	EACH	1
TACTICS LICENSE EXPANSION	EACH	1
FULL-ACTUATED CONTROLLER IN EXISTING CABINET	EACH	1
FIBER OPTIC INTERCONNECT CENTER, 48 PORT	EACH	1


\* - 100% COST TO THE CITY OF ELMHURST


TS 6400 IDOT TACTICS FORMER EAGLE 2P


Kimley > Horn


O 2023 MALEY-MEN, ALD, ASSOCIATIES, INC.
ASSY MATERIA BOOK SUFFE 600
WARRENVILLE IL 05505
HOVEL 555-145-75505


USER NAME =	DESIGNED - JJT	REVISED - <u>A</u> 2/18/2025
	DRAWN - JRR	REVISED -
PLOT SCALE =	CHECKED - SRS	REVISED -
PLOT DATE =	DATE - 2/18/2025	REVISED -

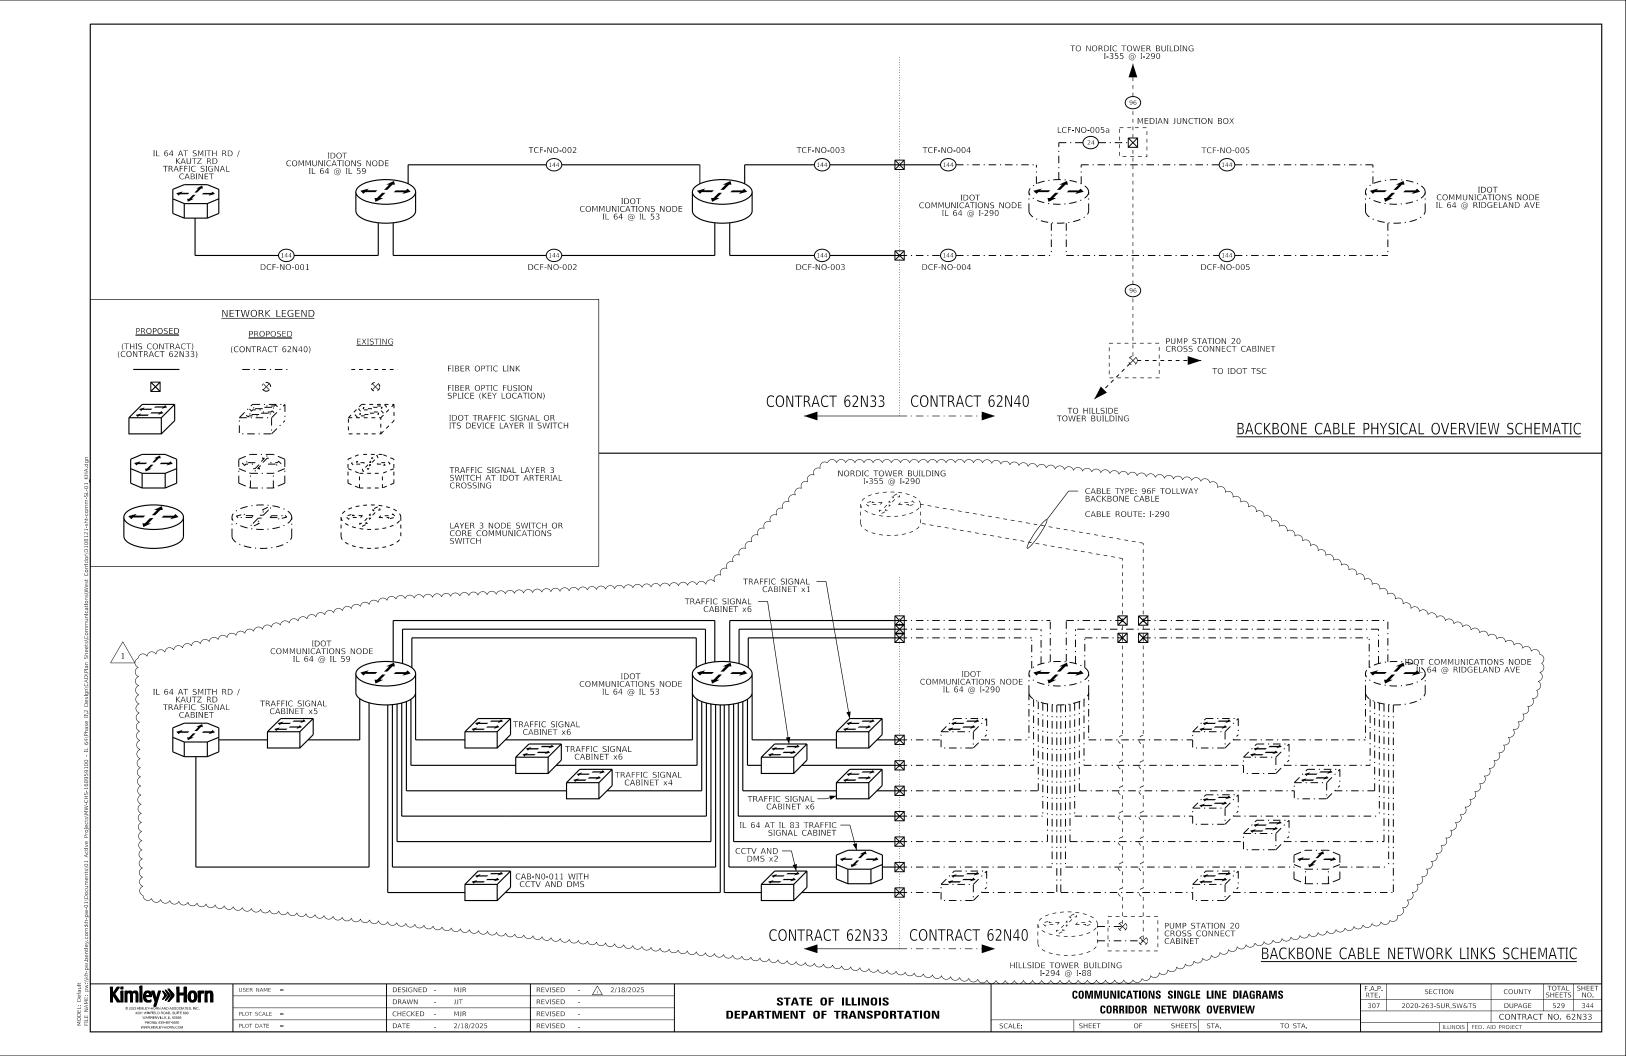


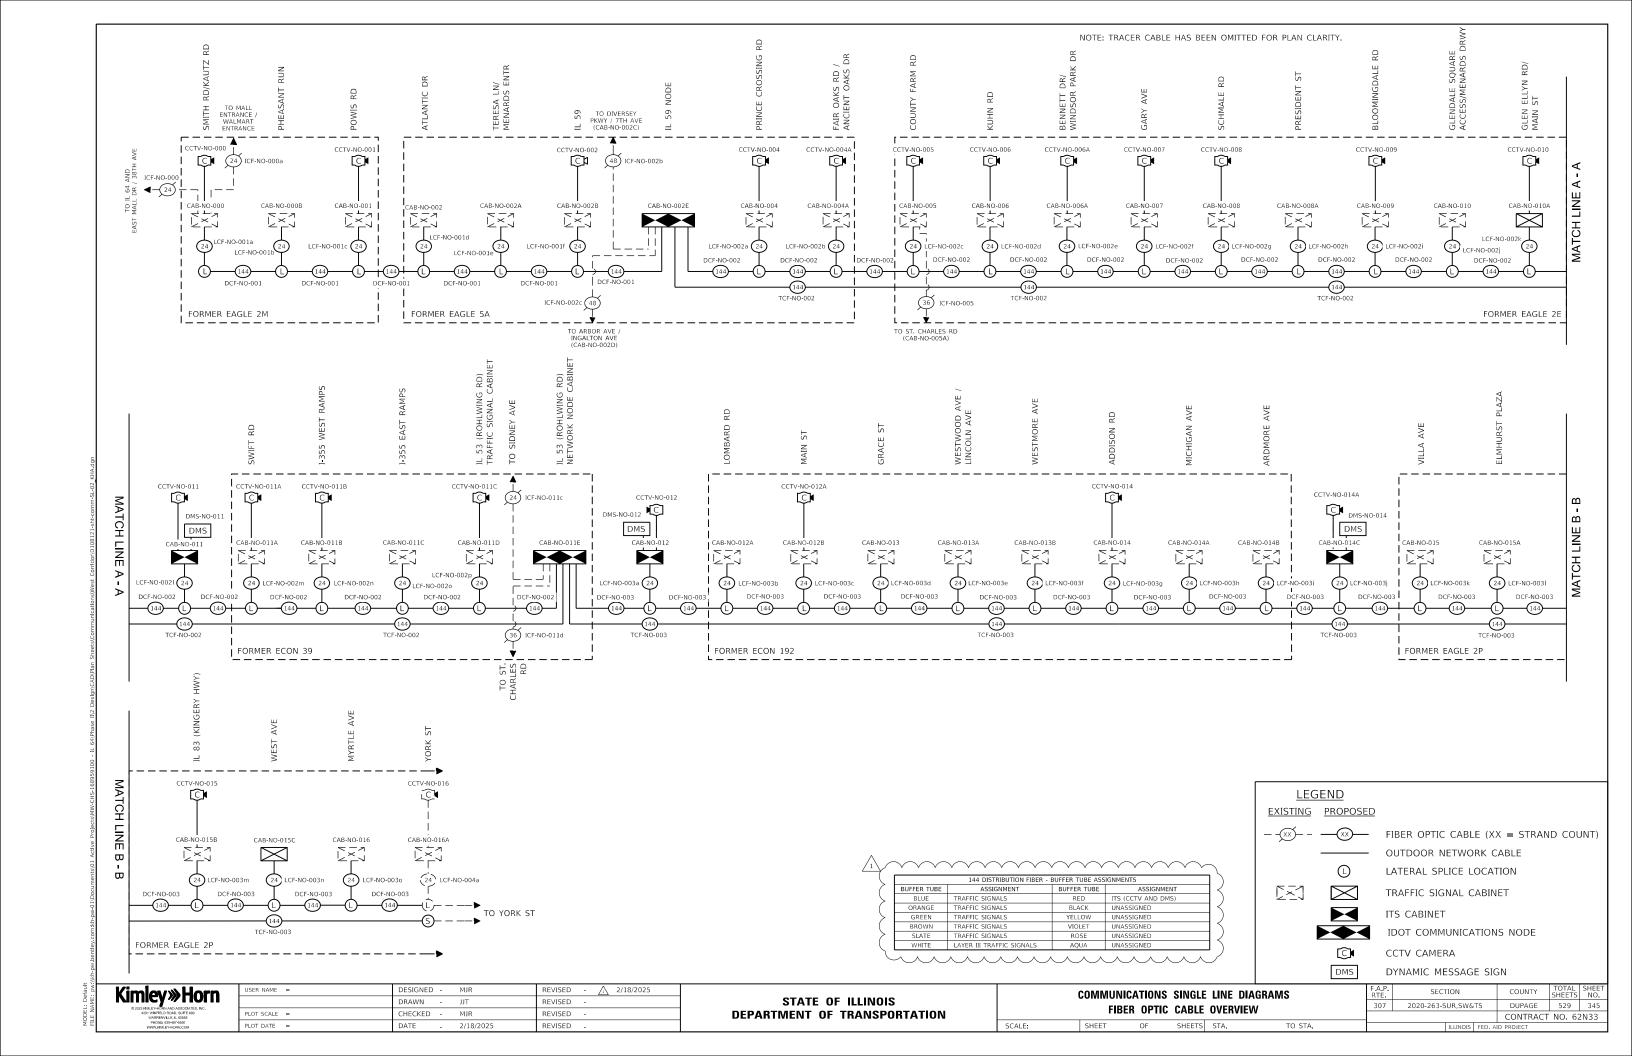


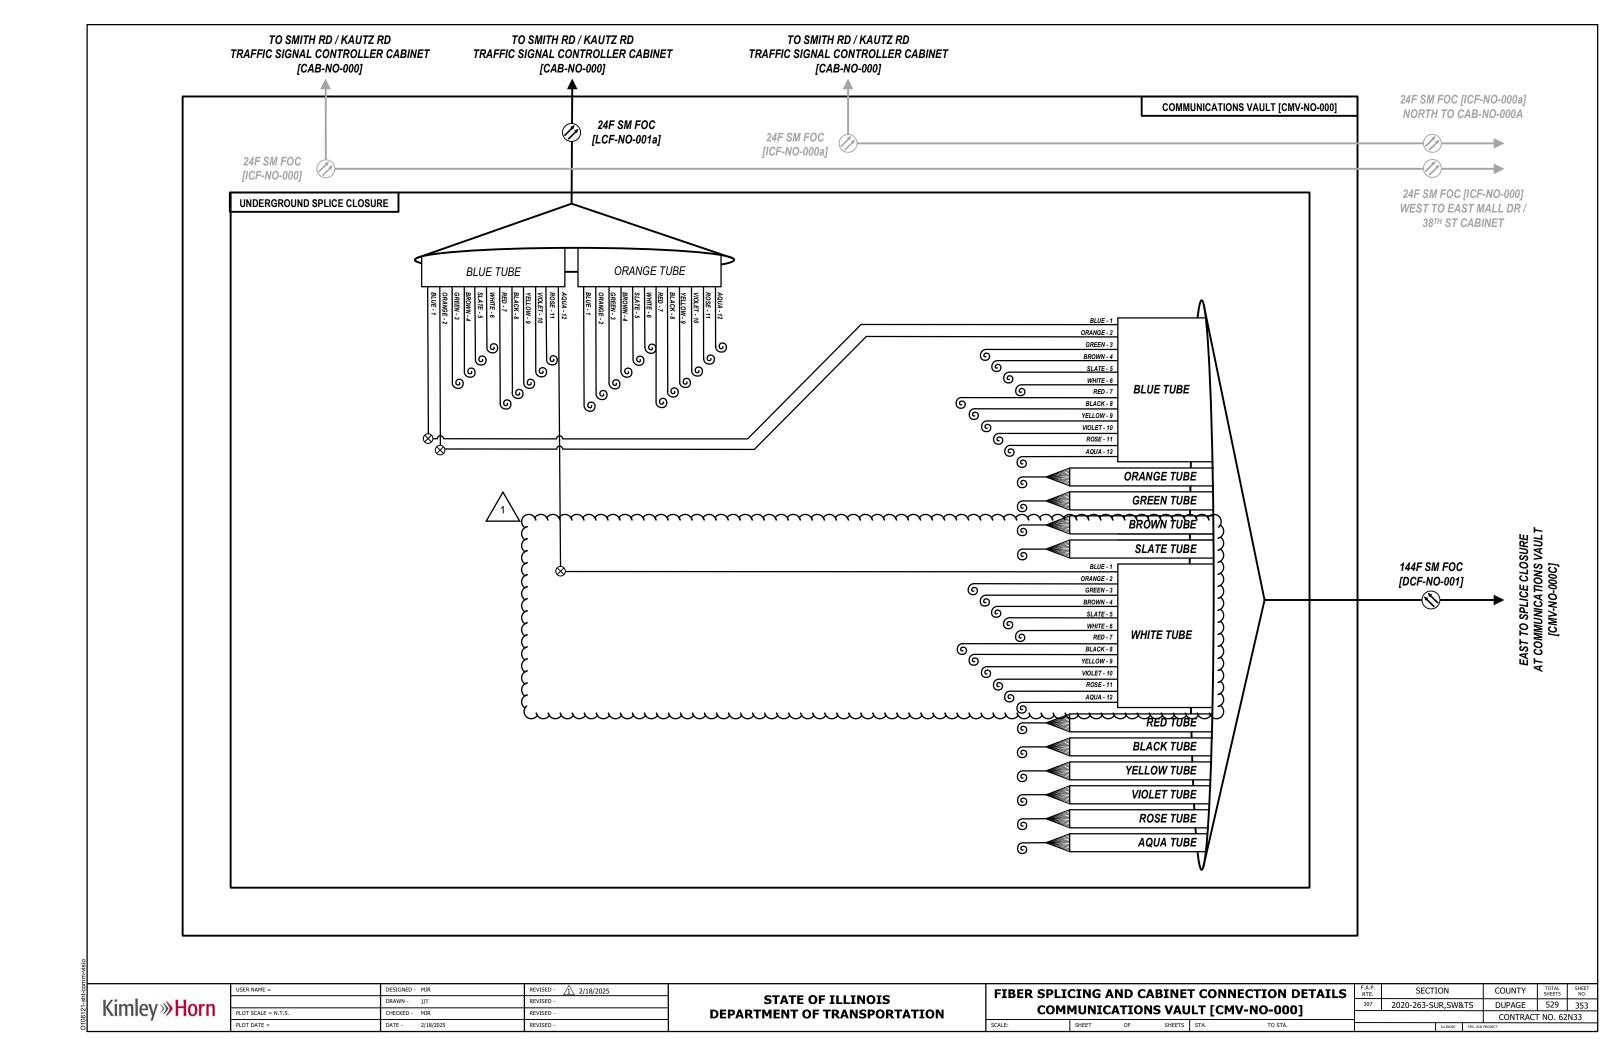


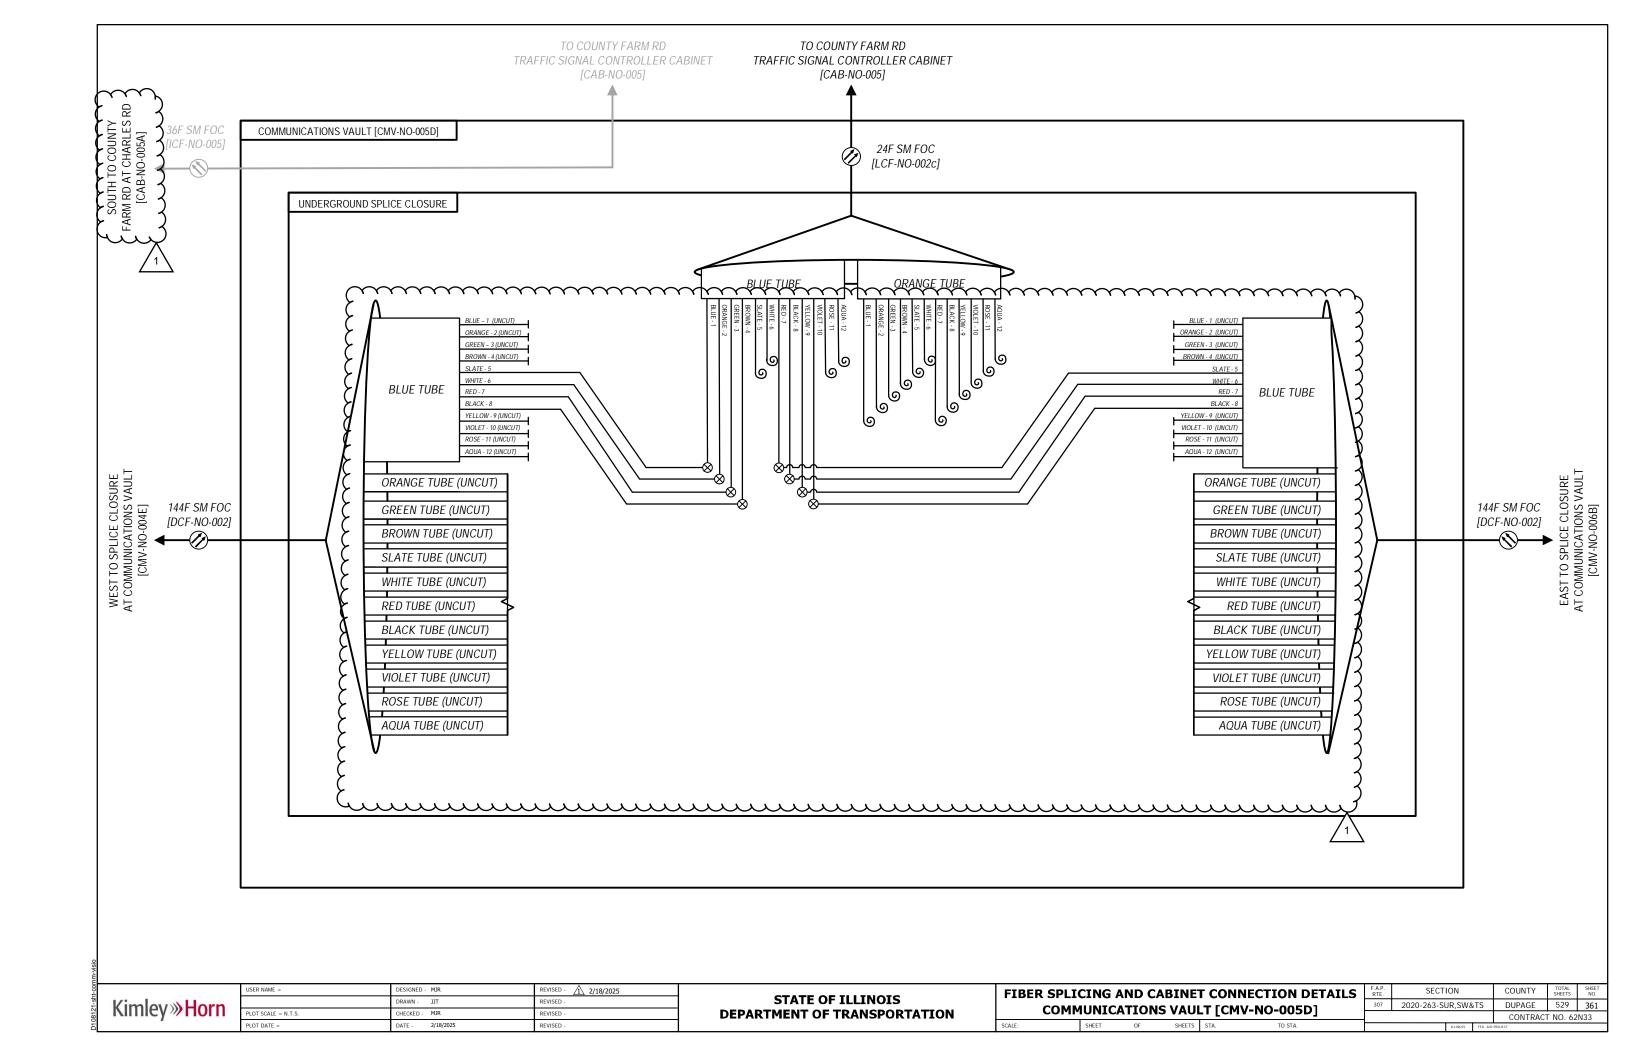


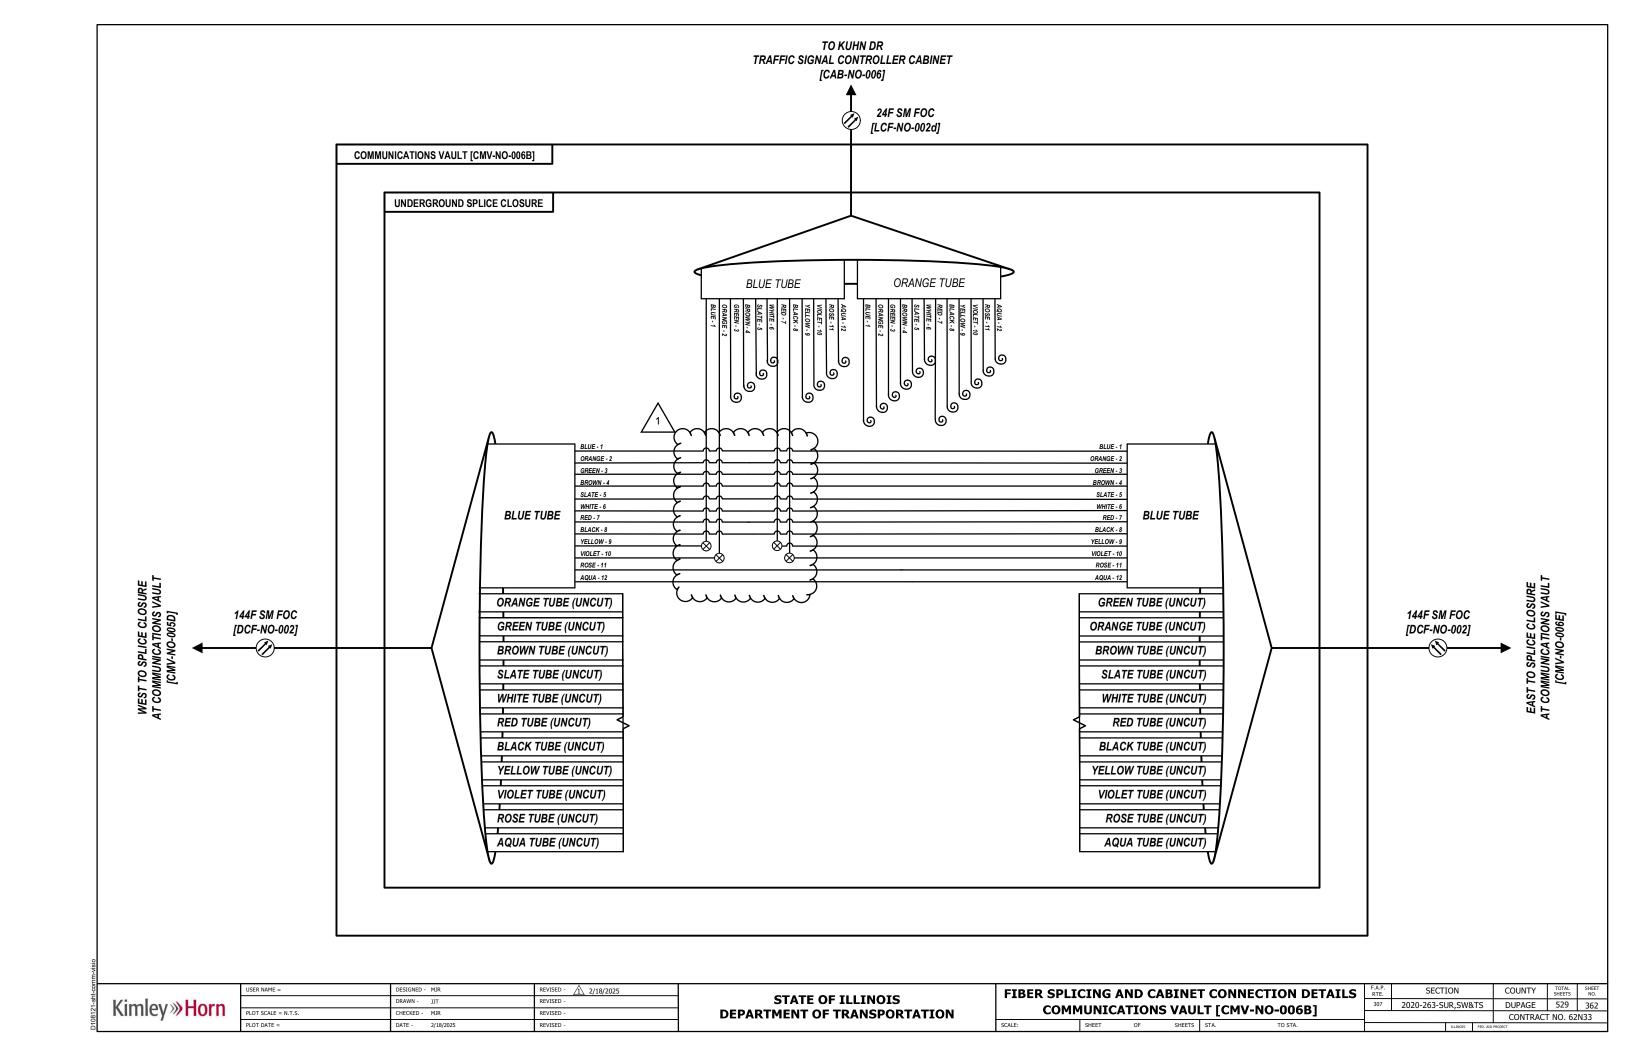


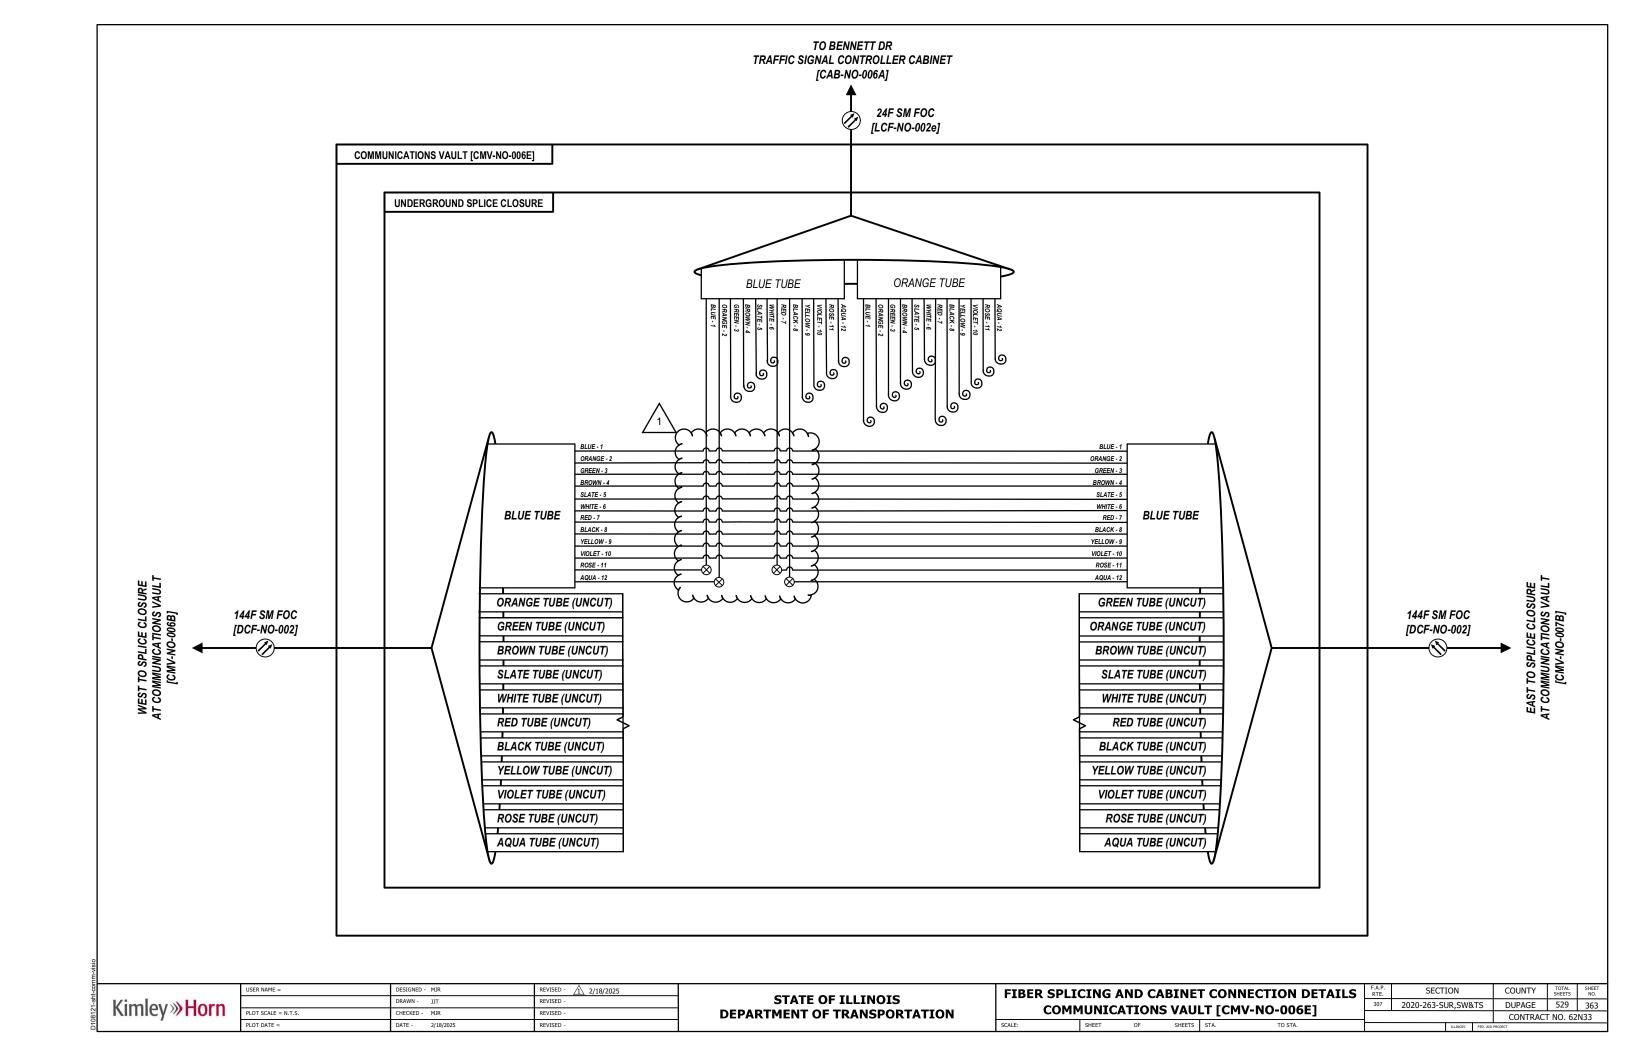


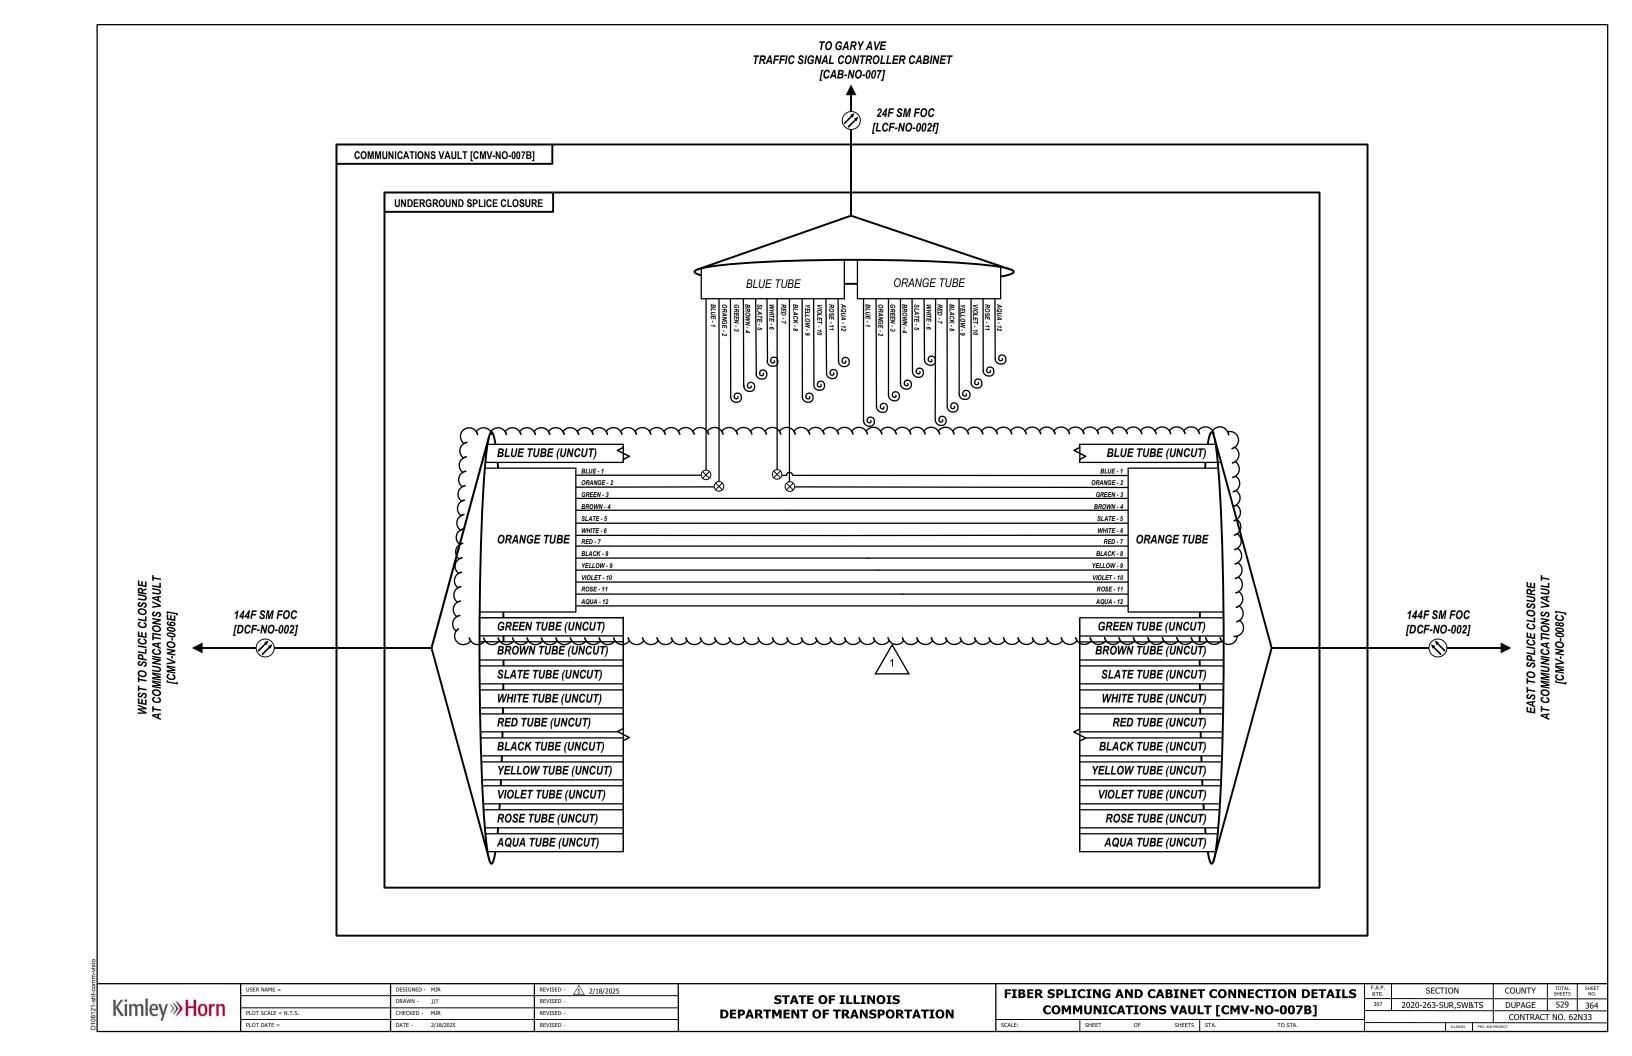


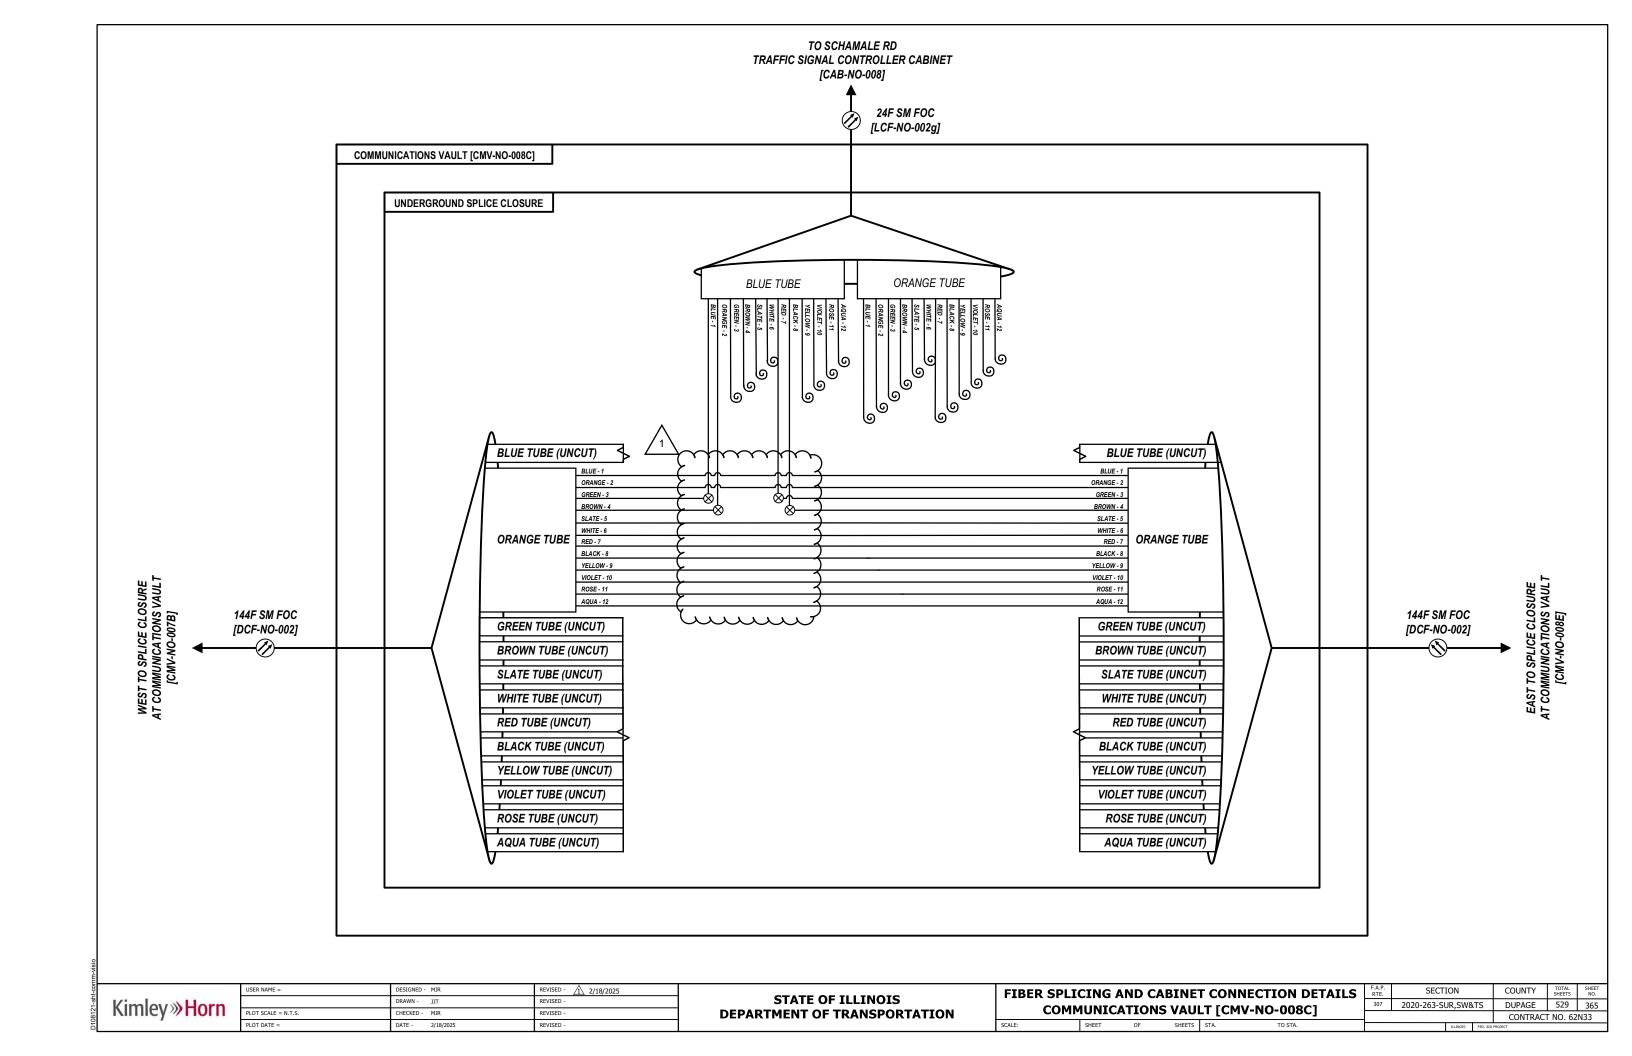


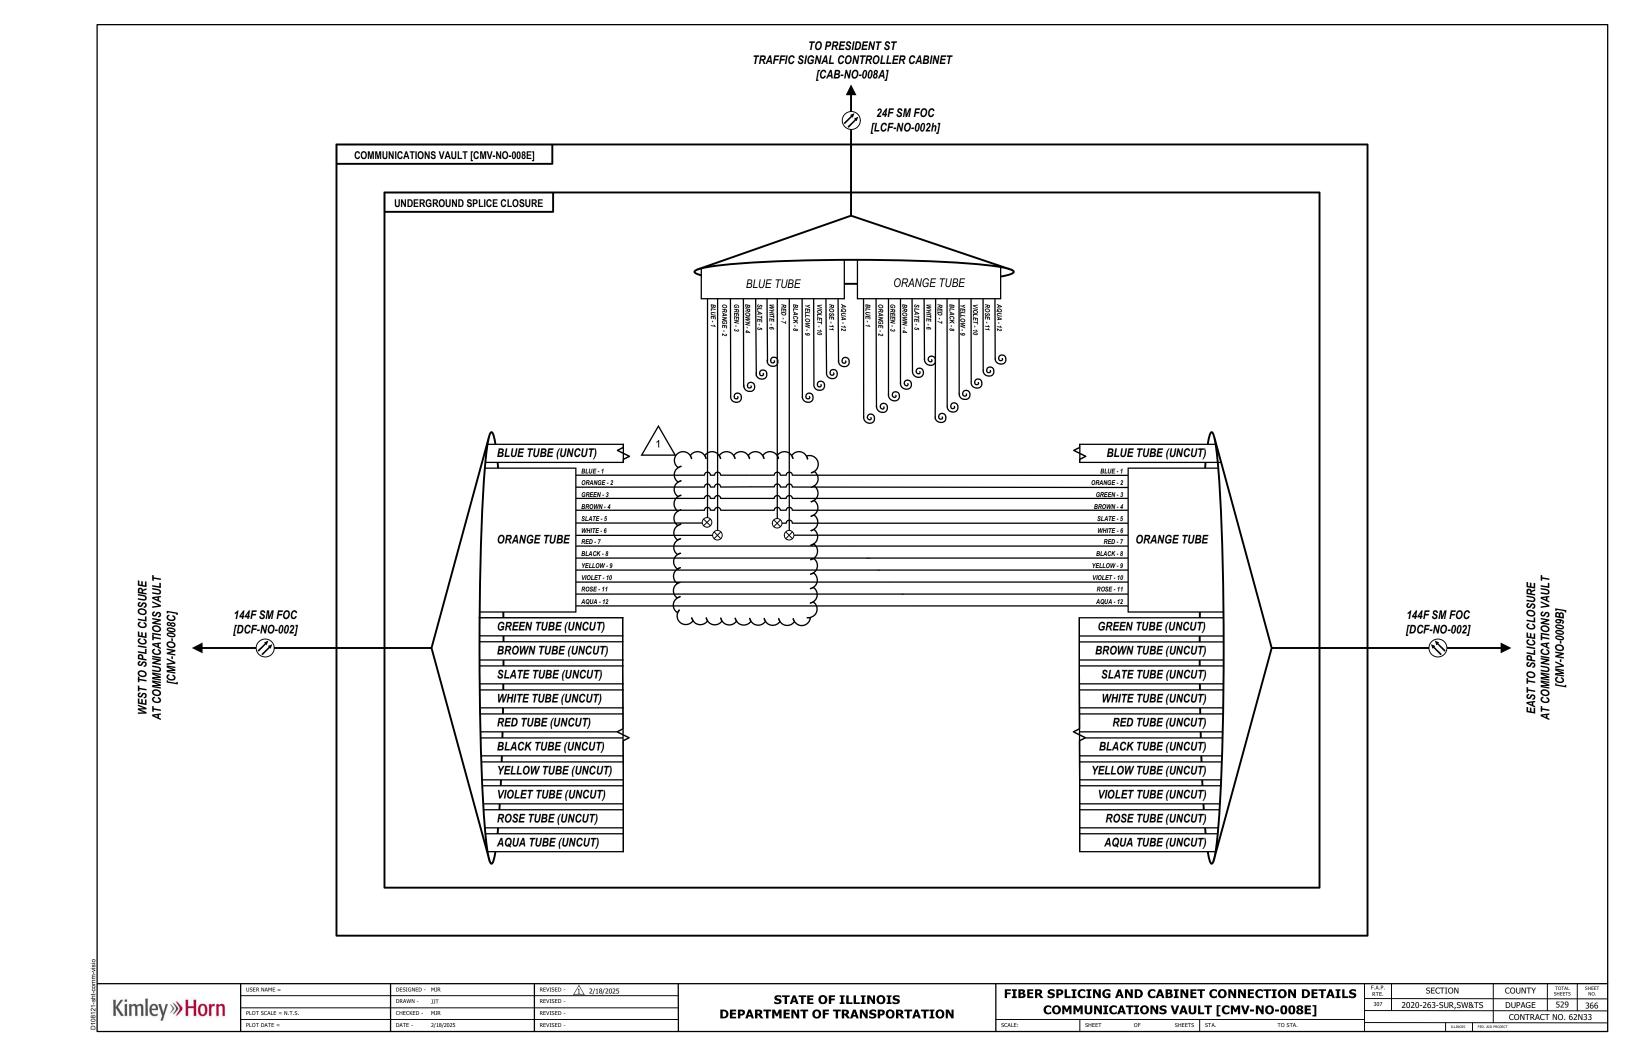


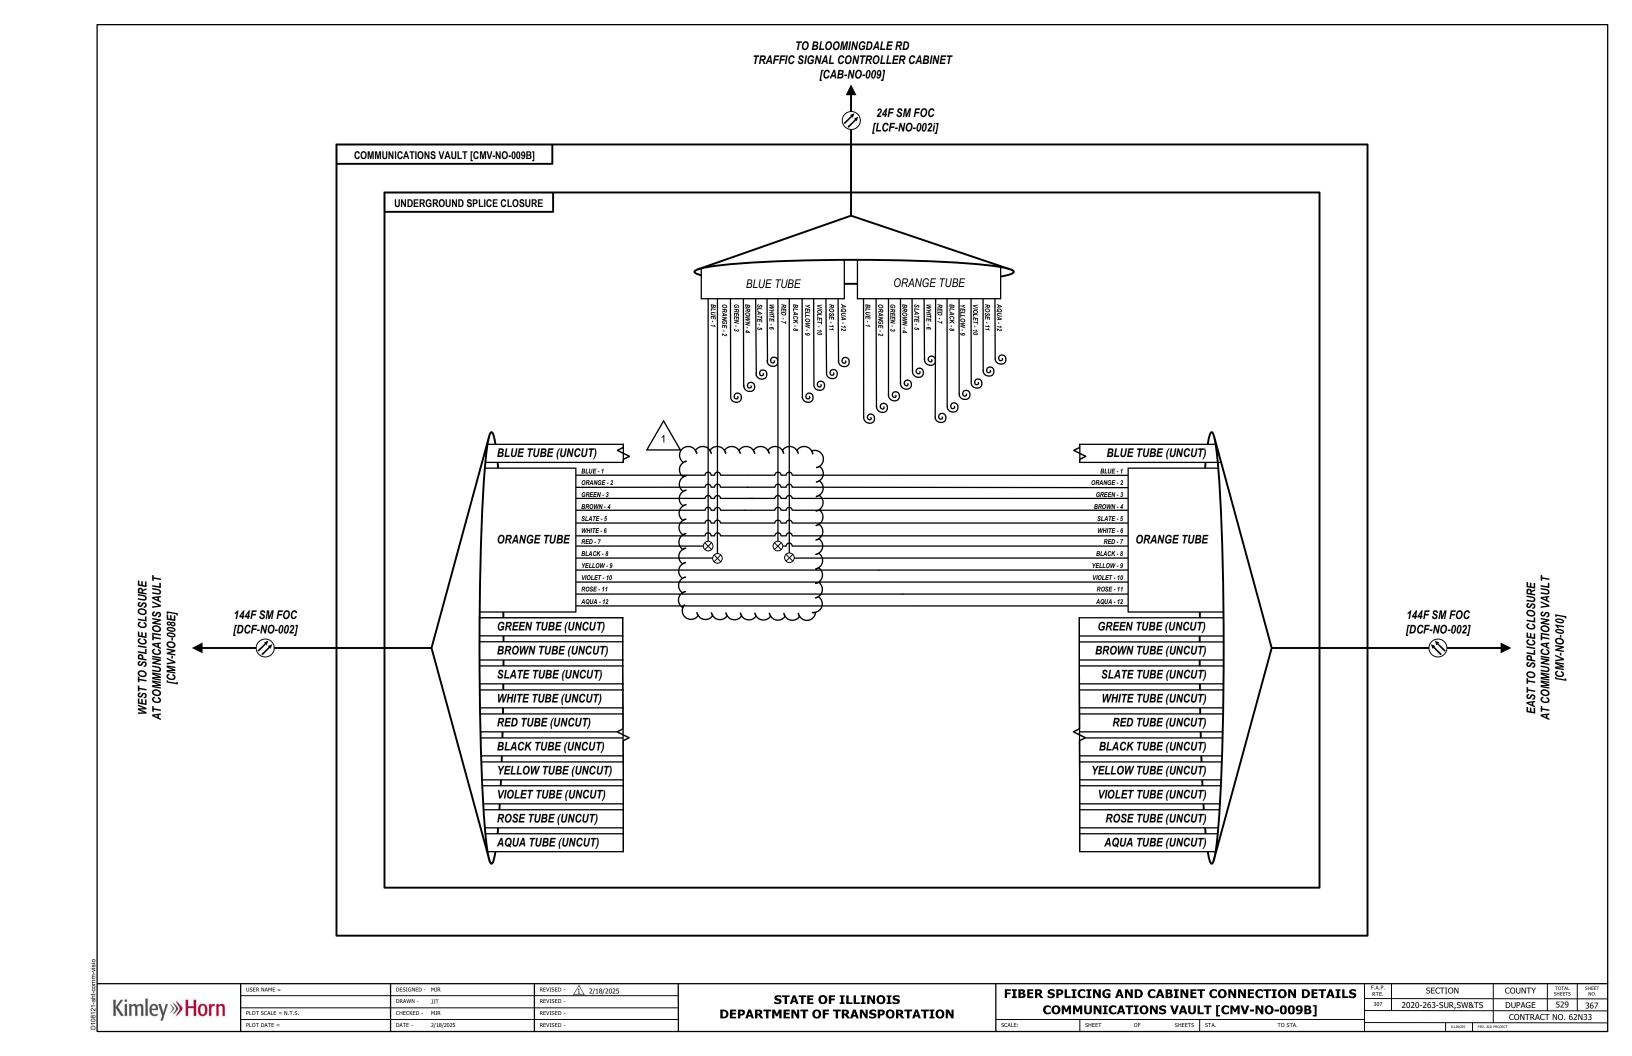


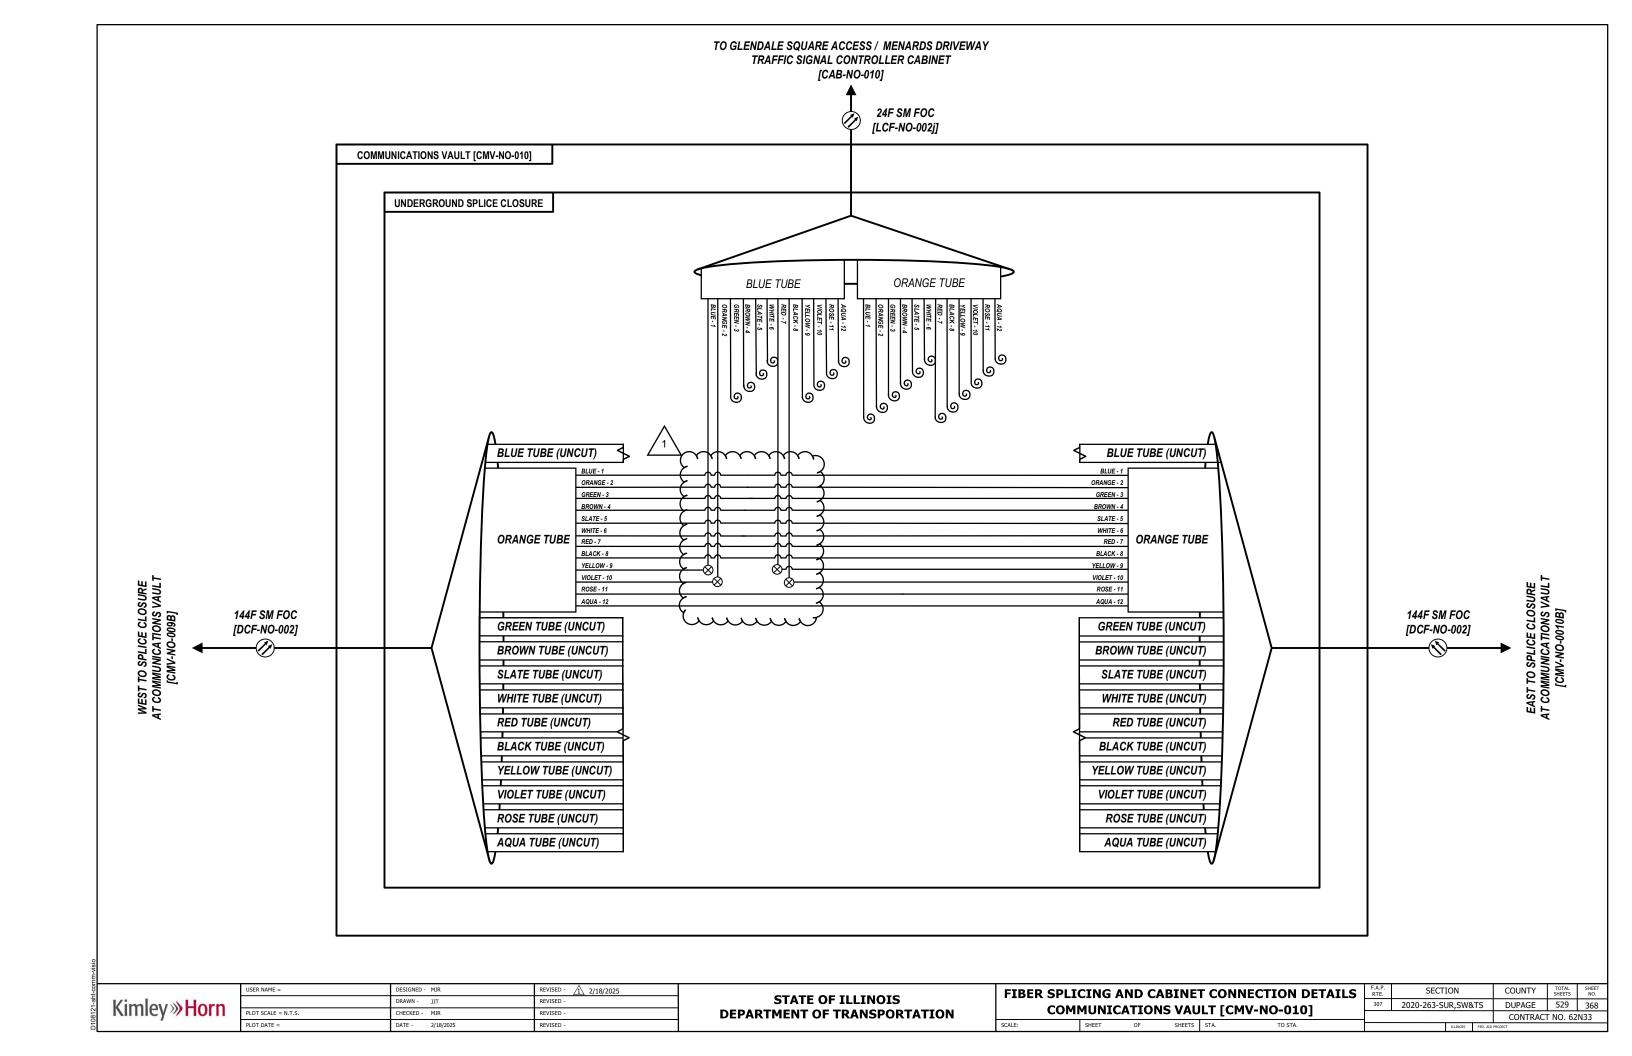


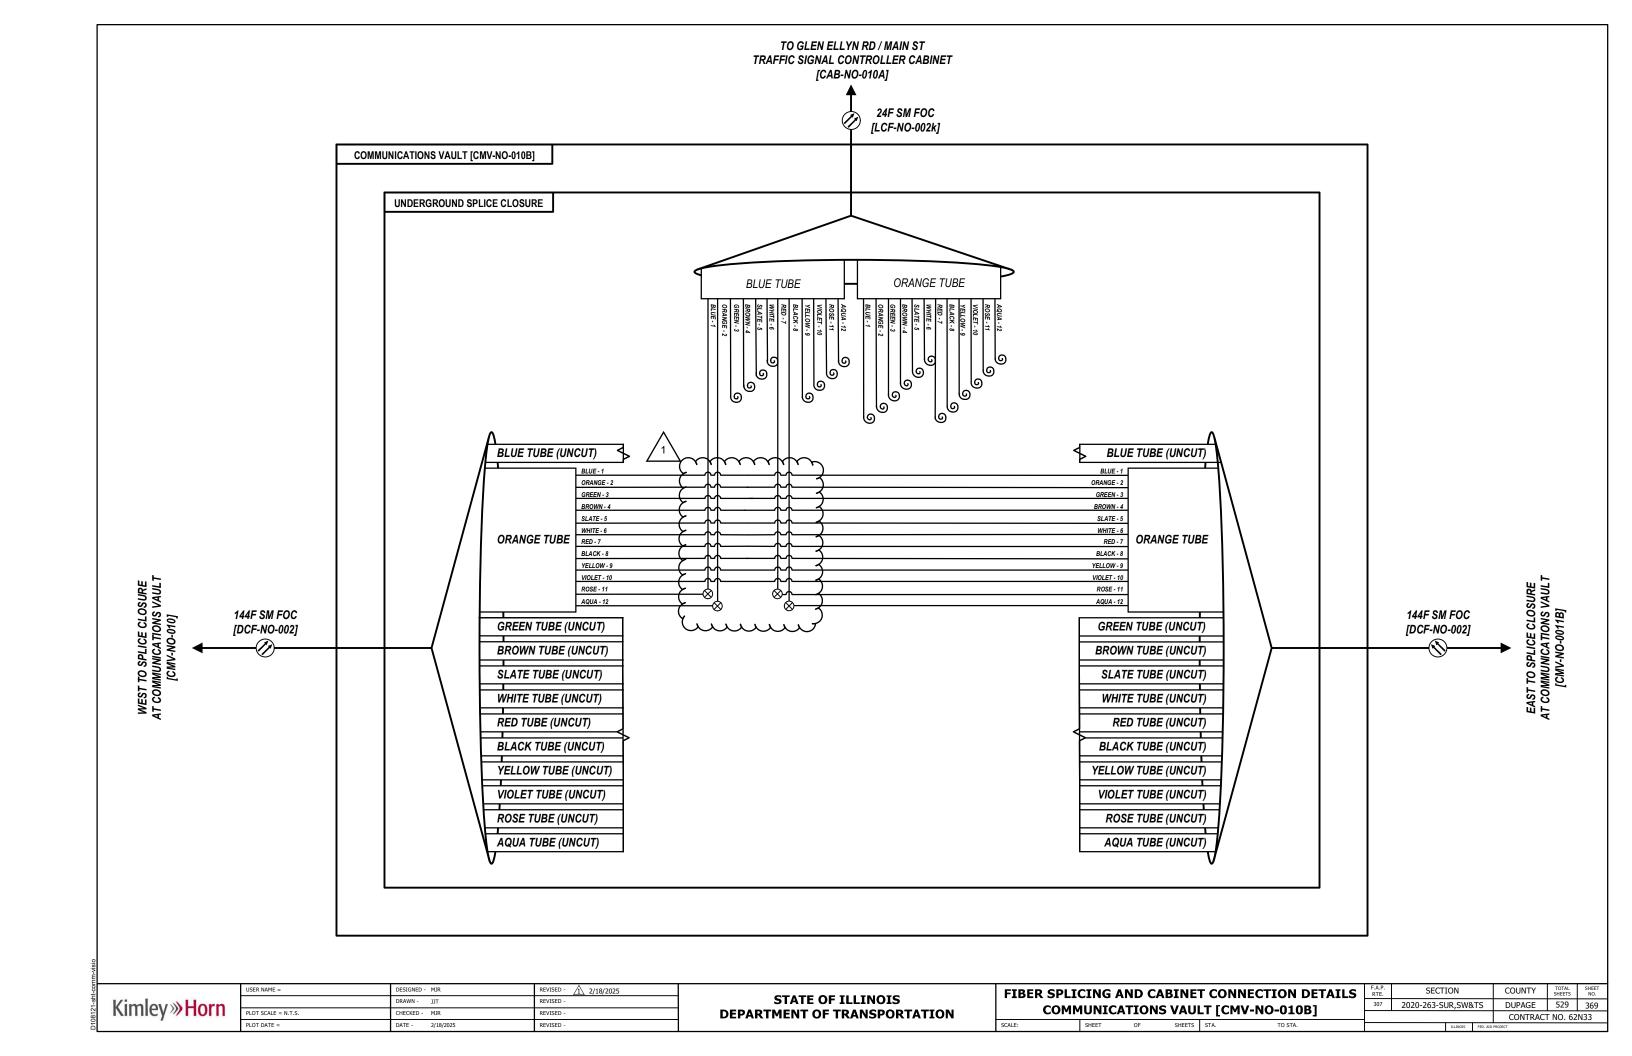


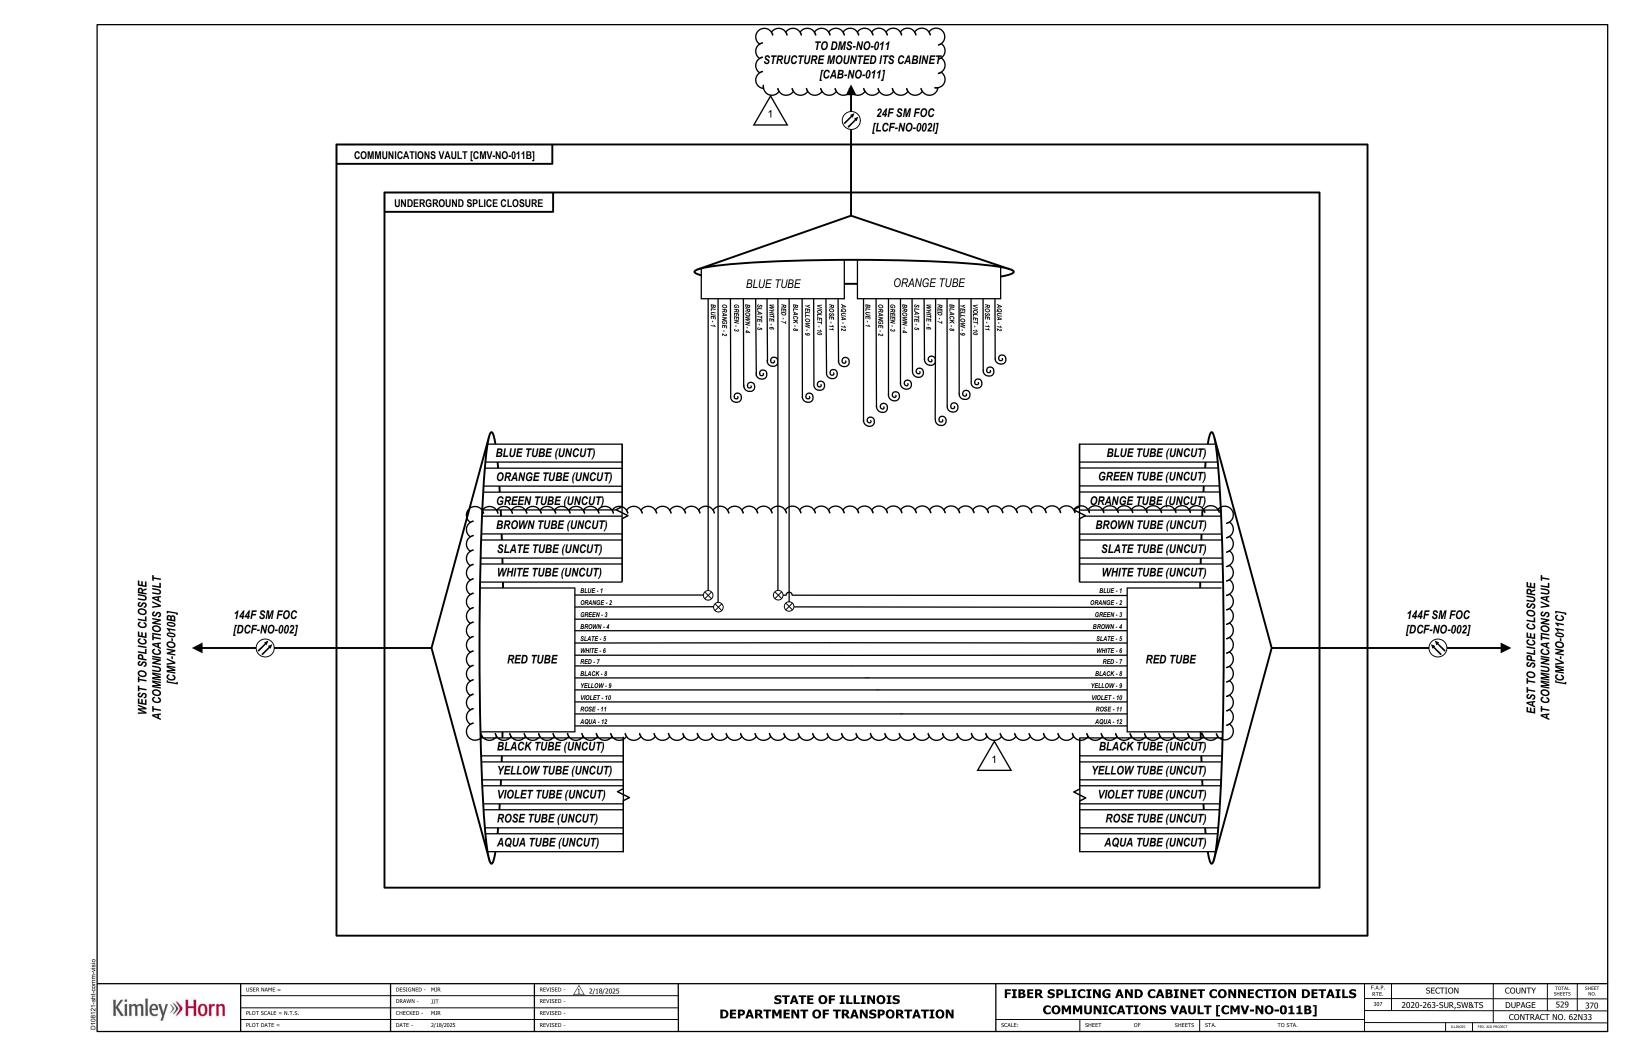


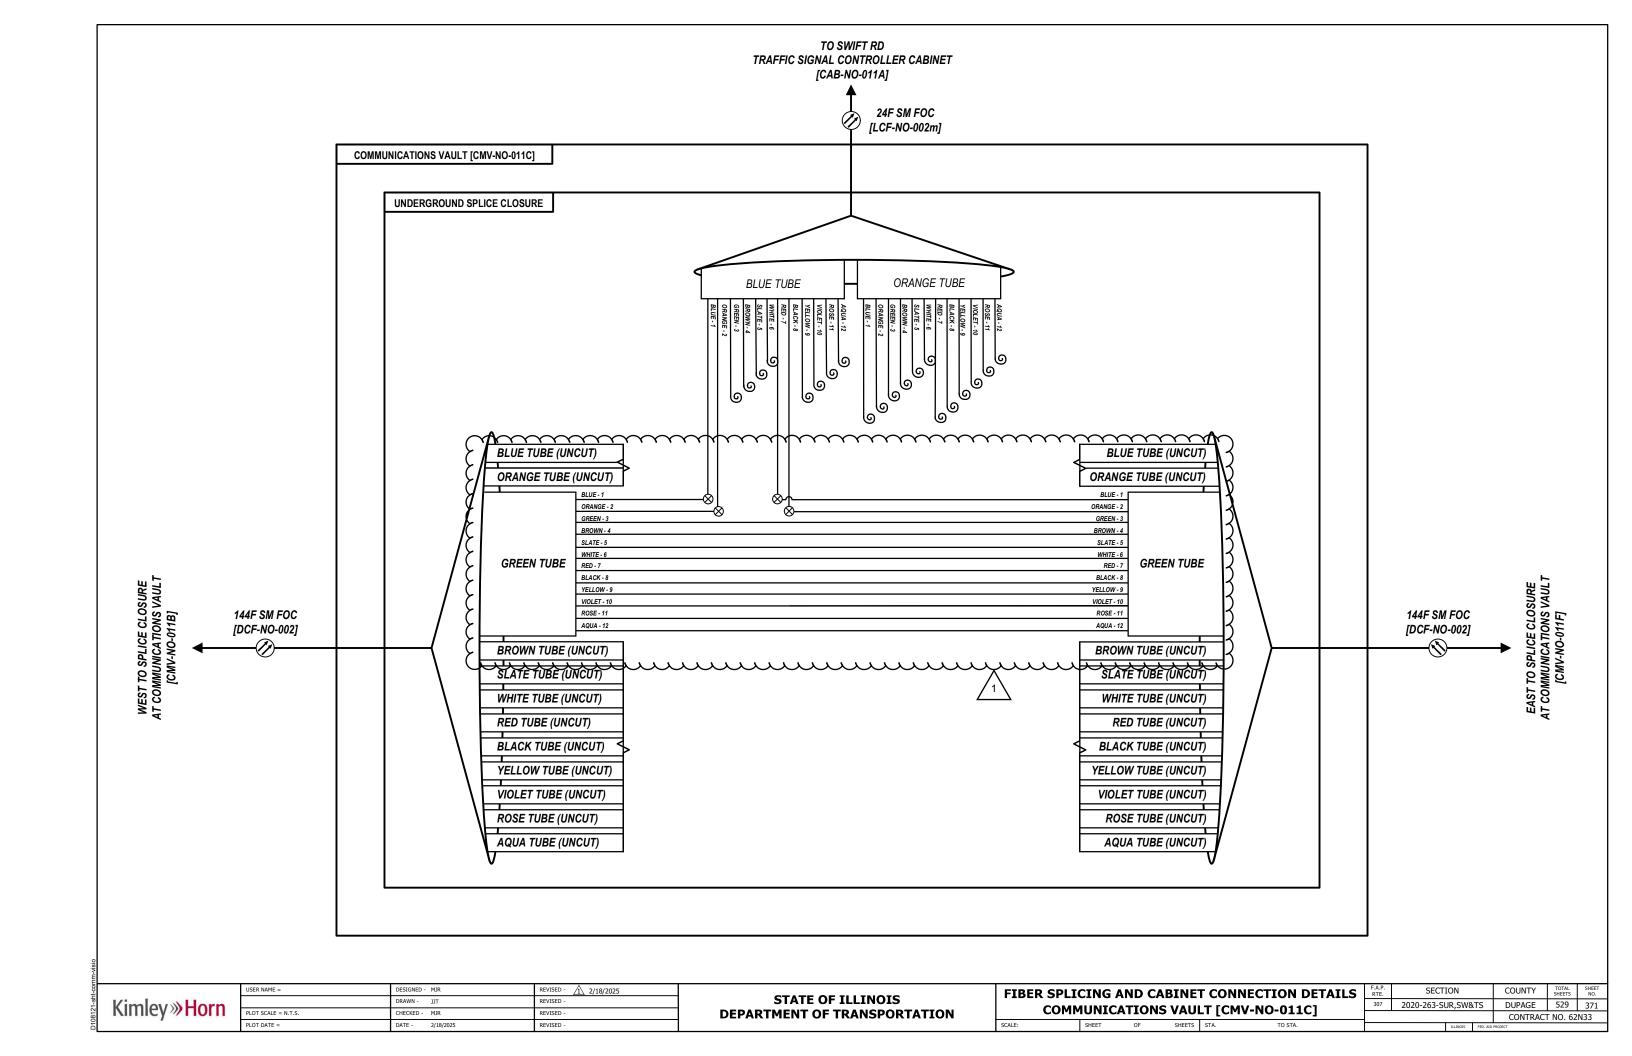


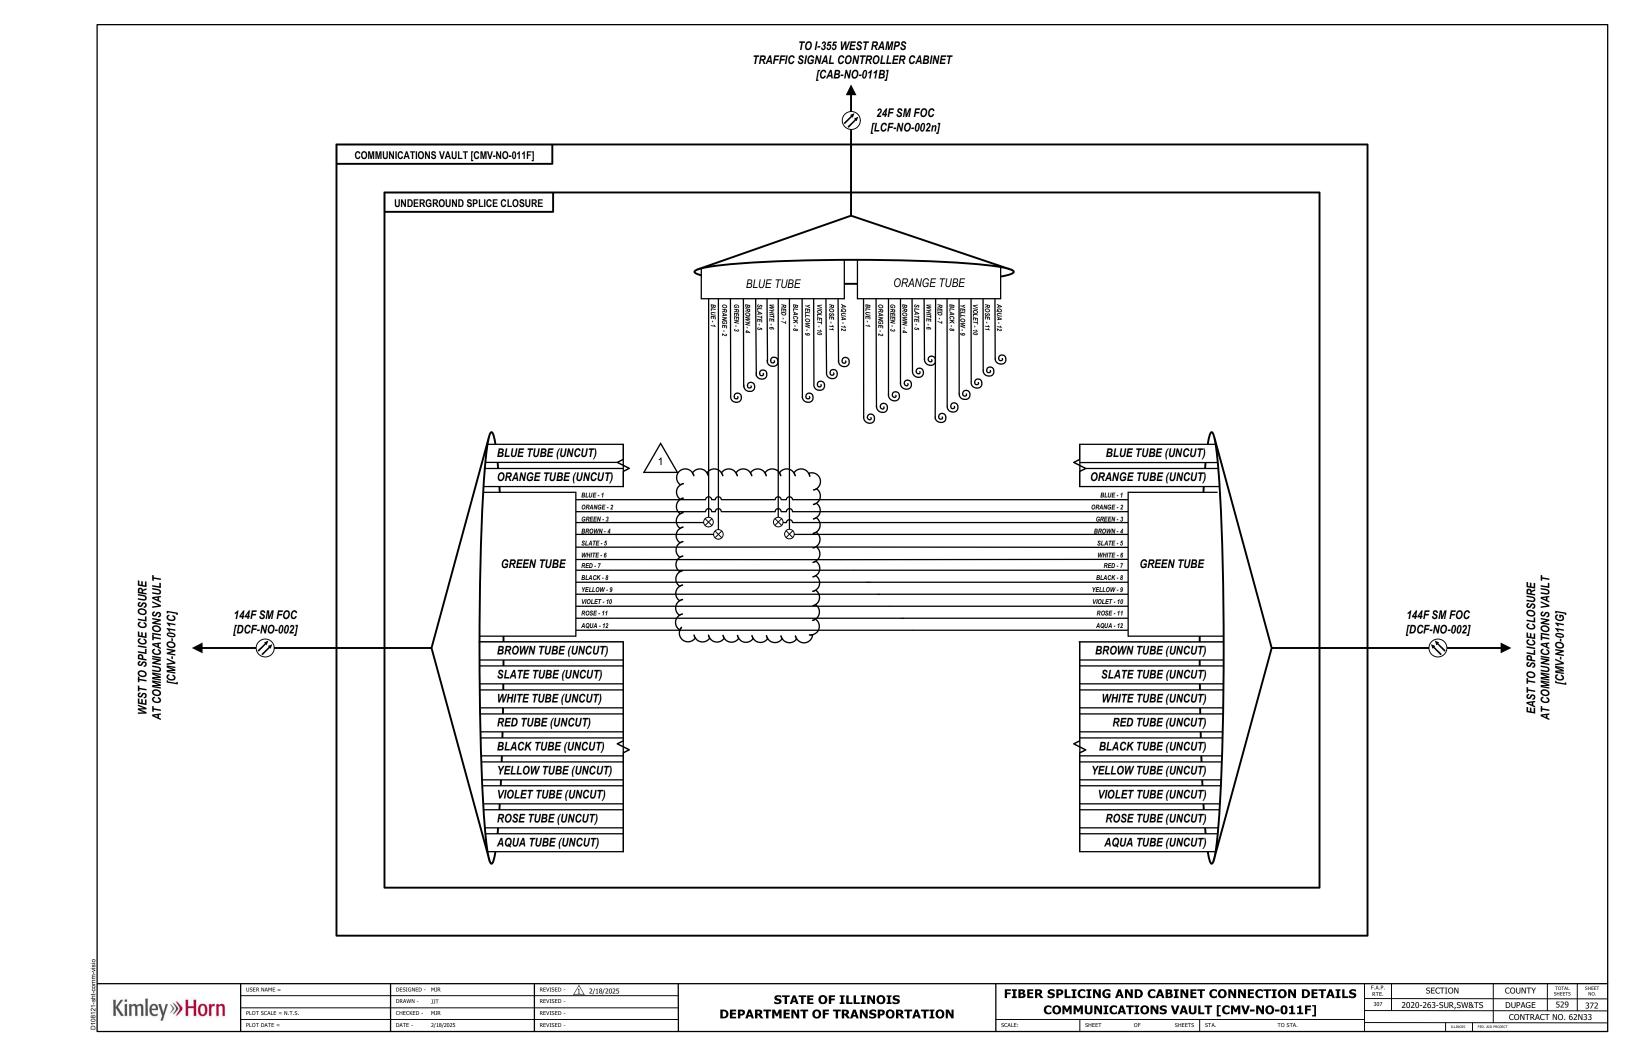


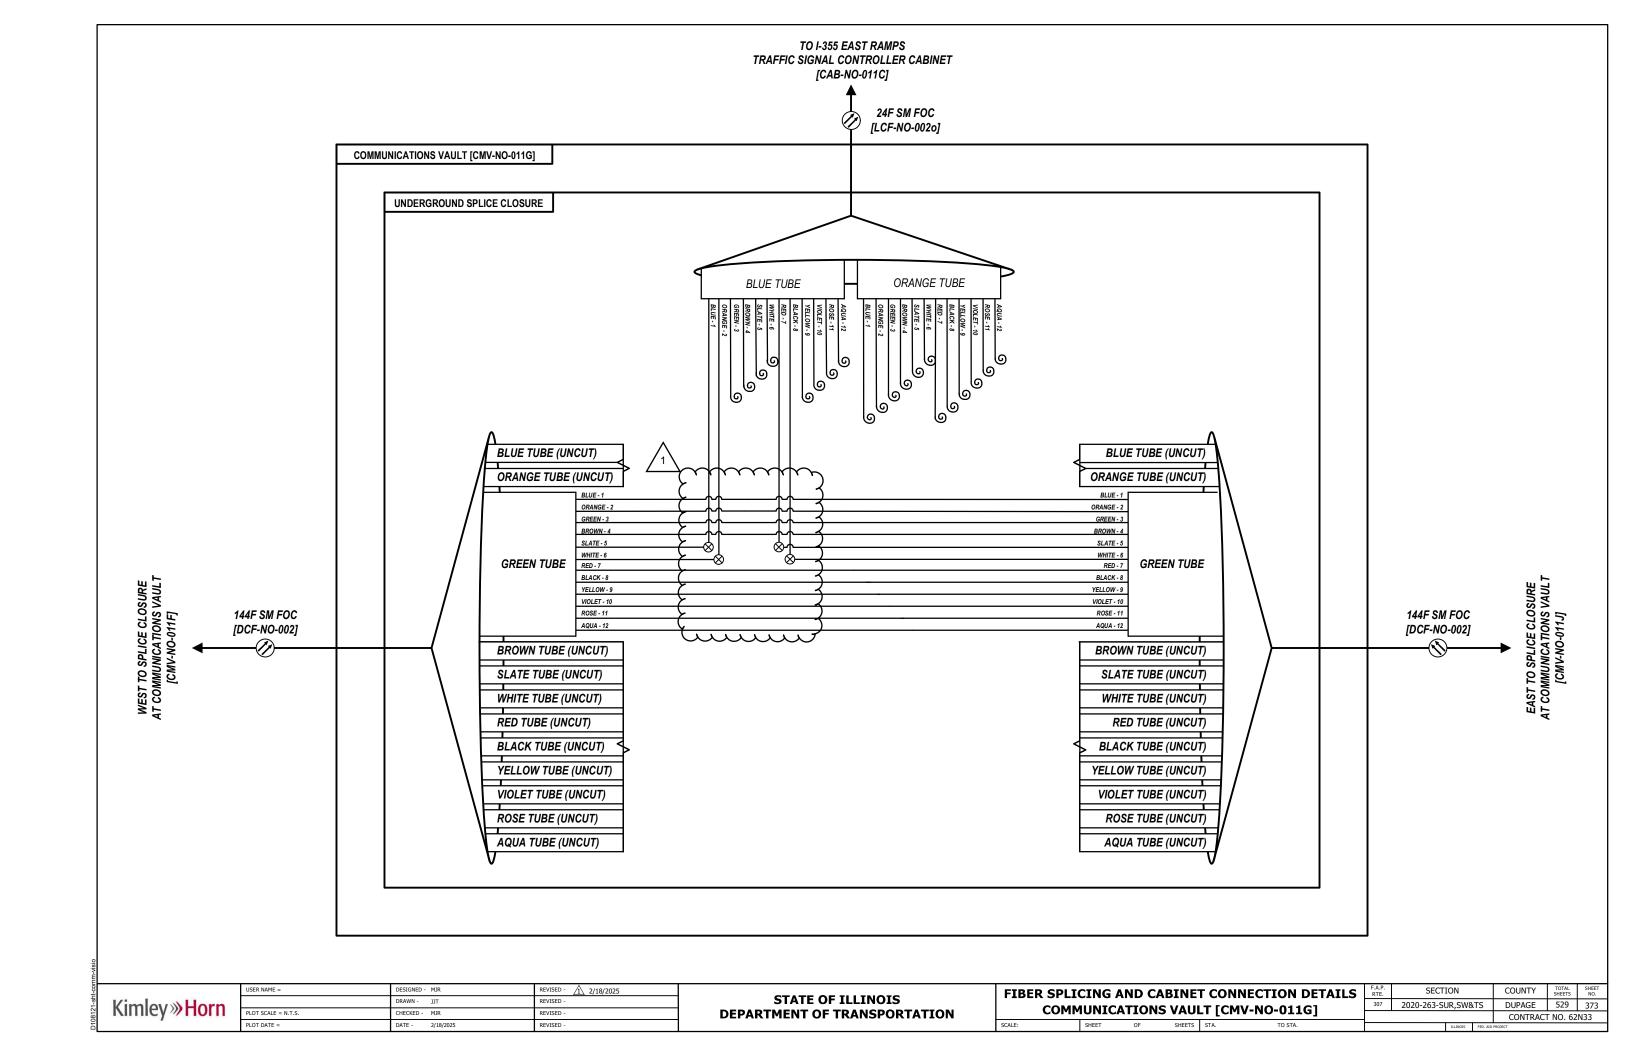


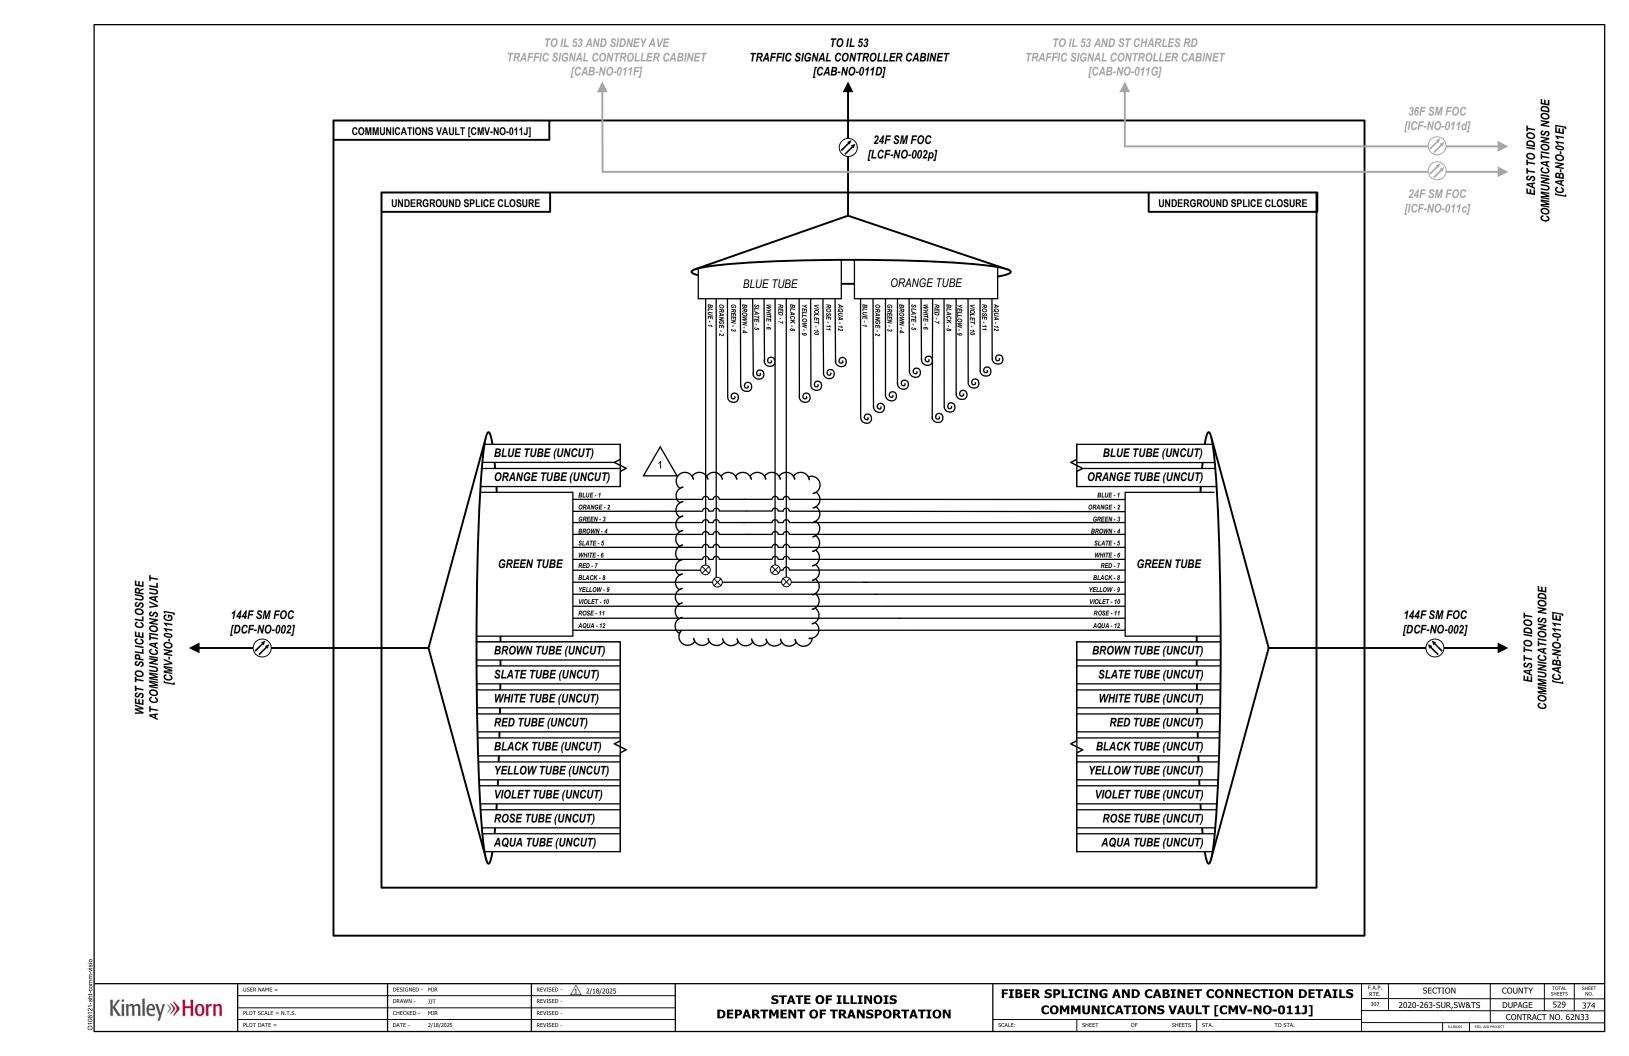

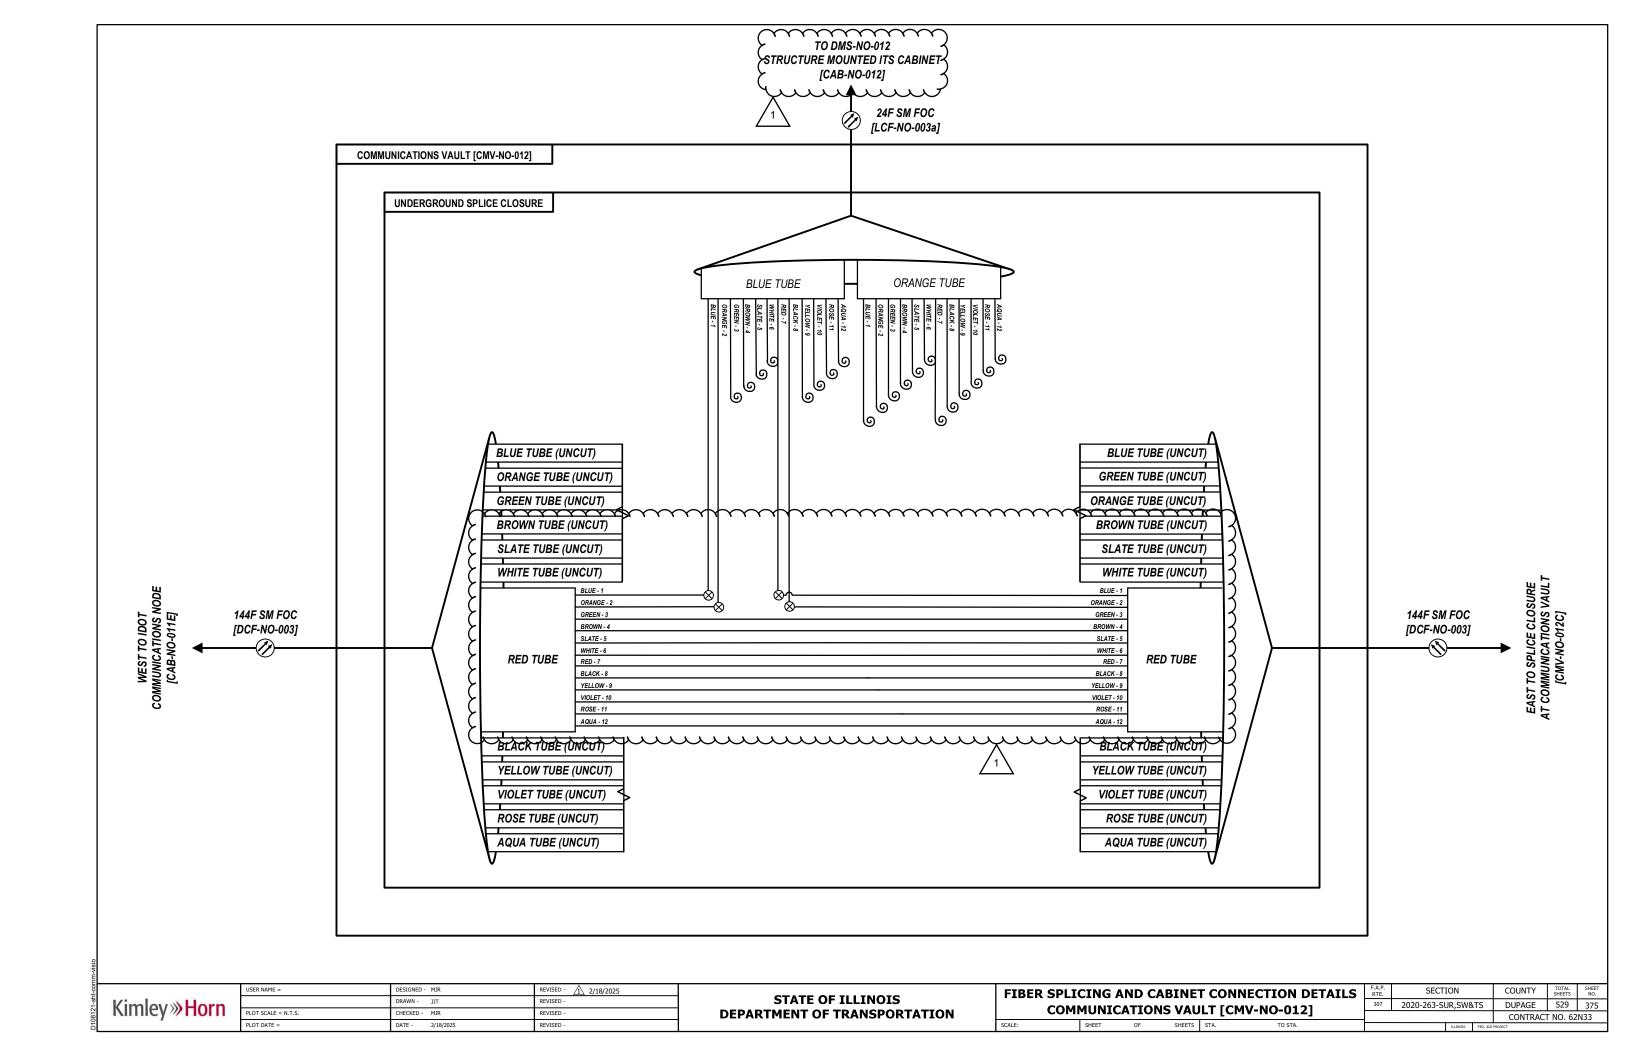

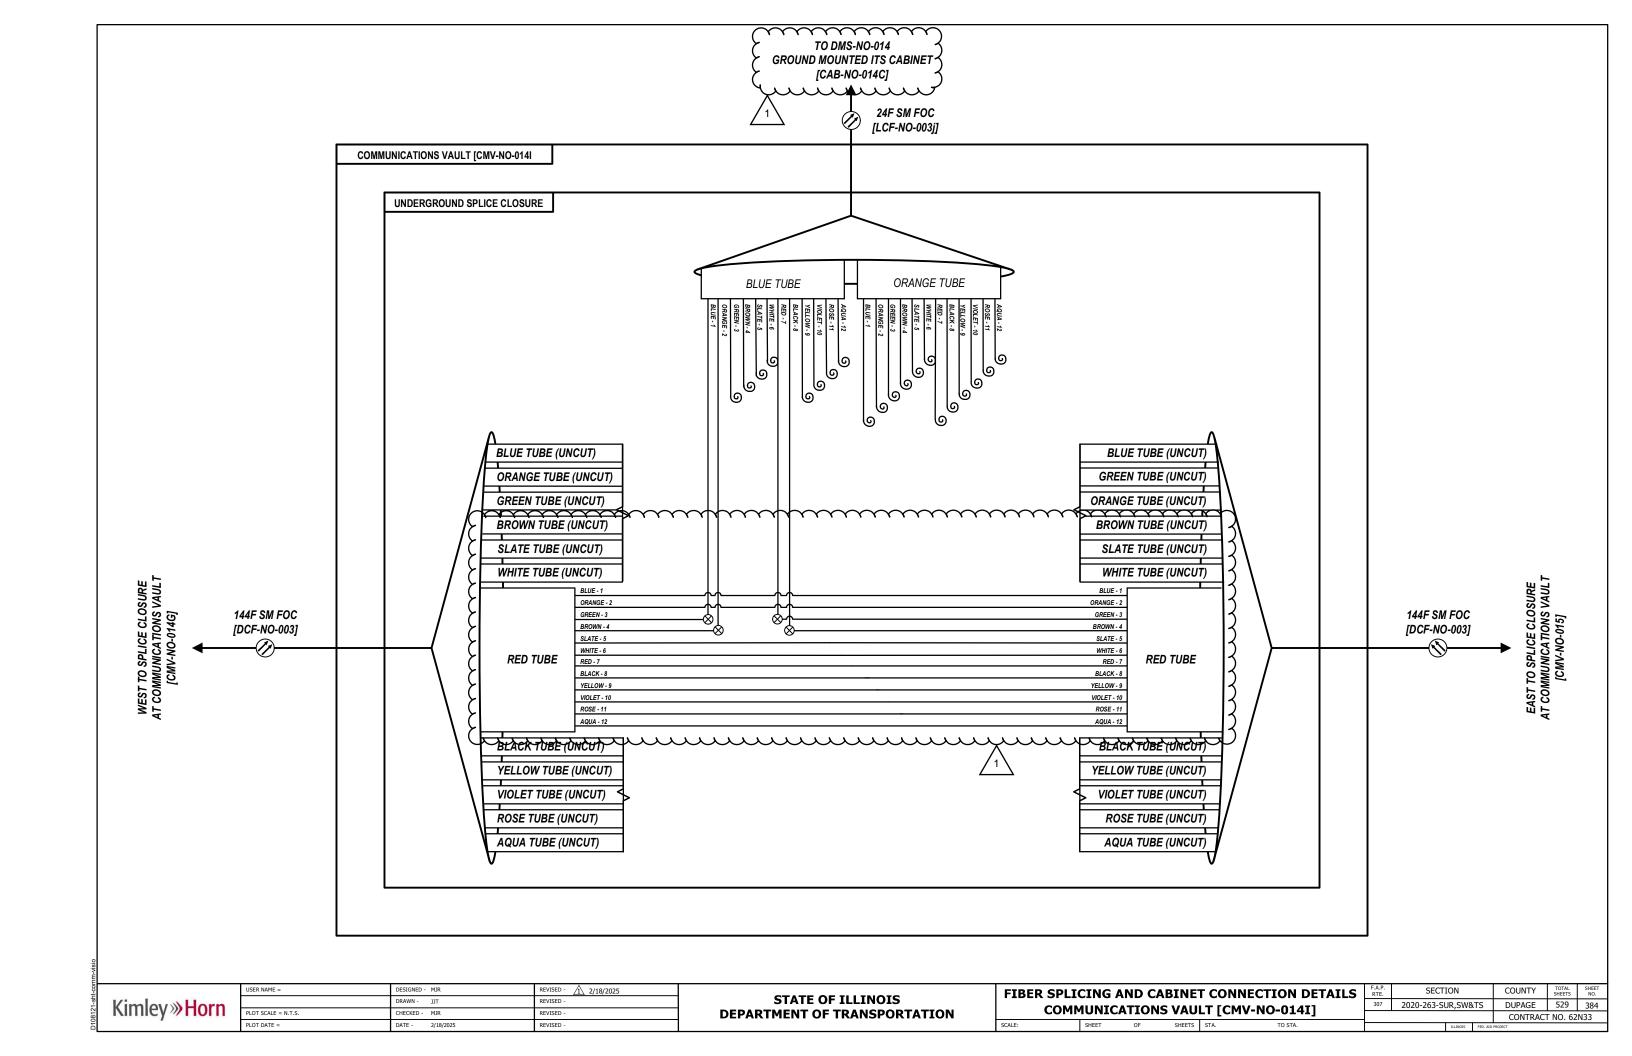

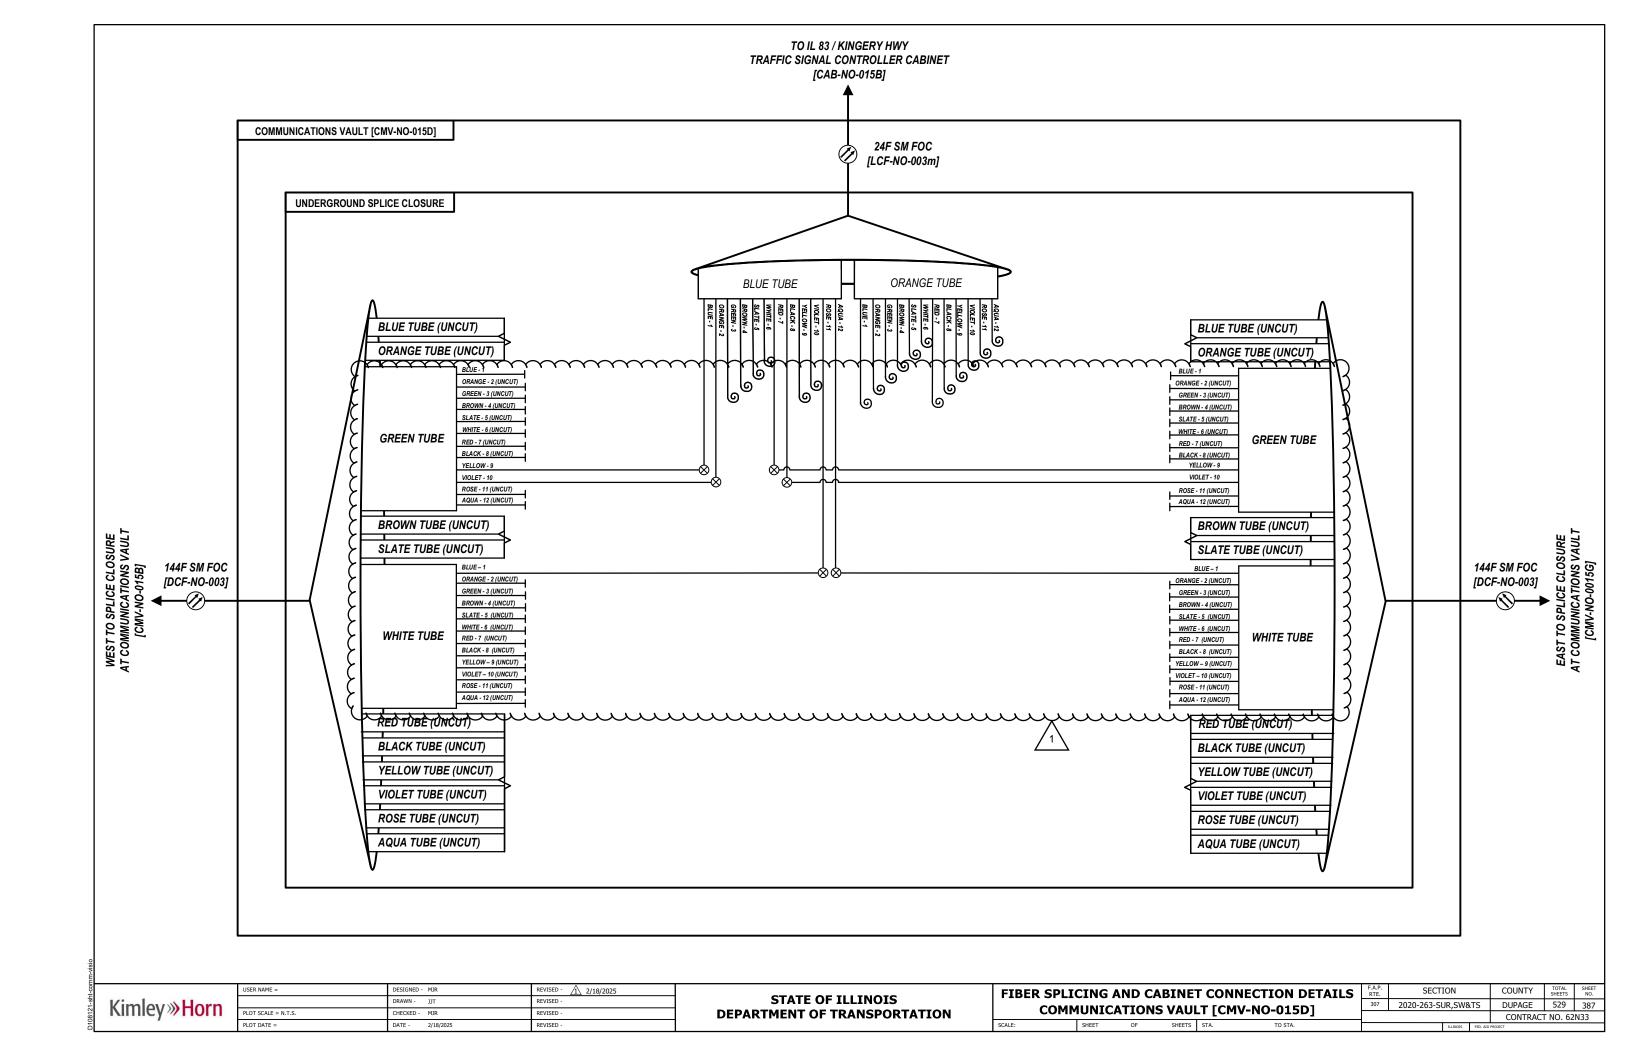

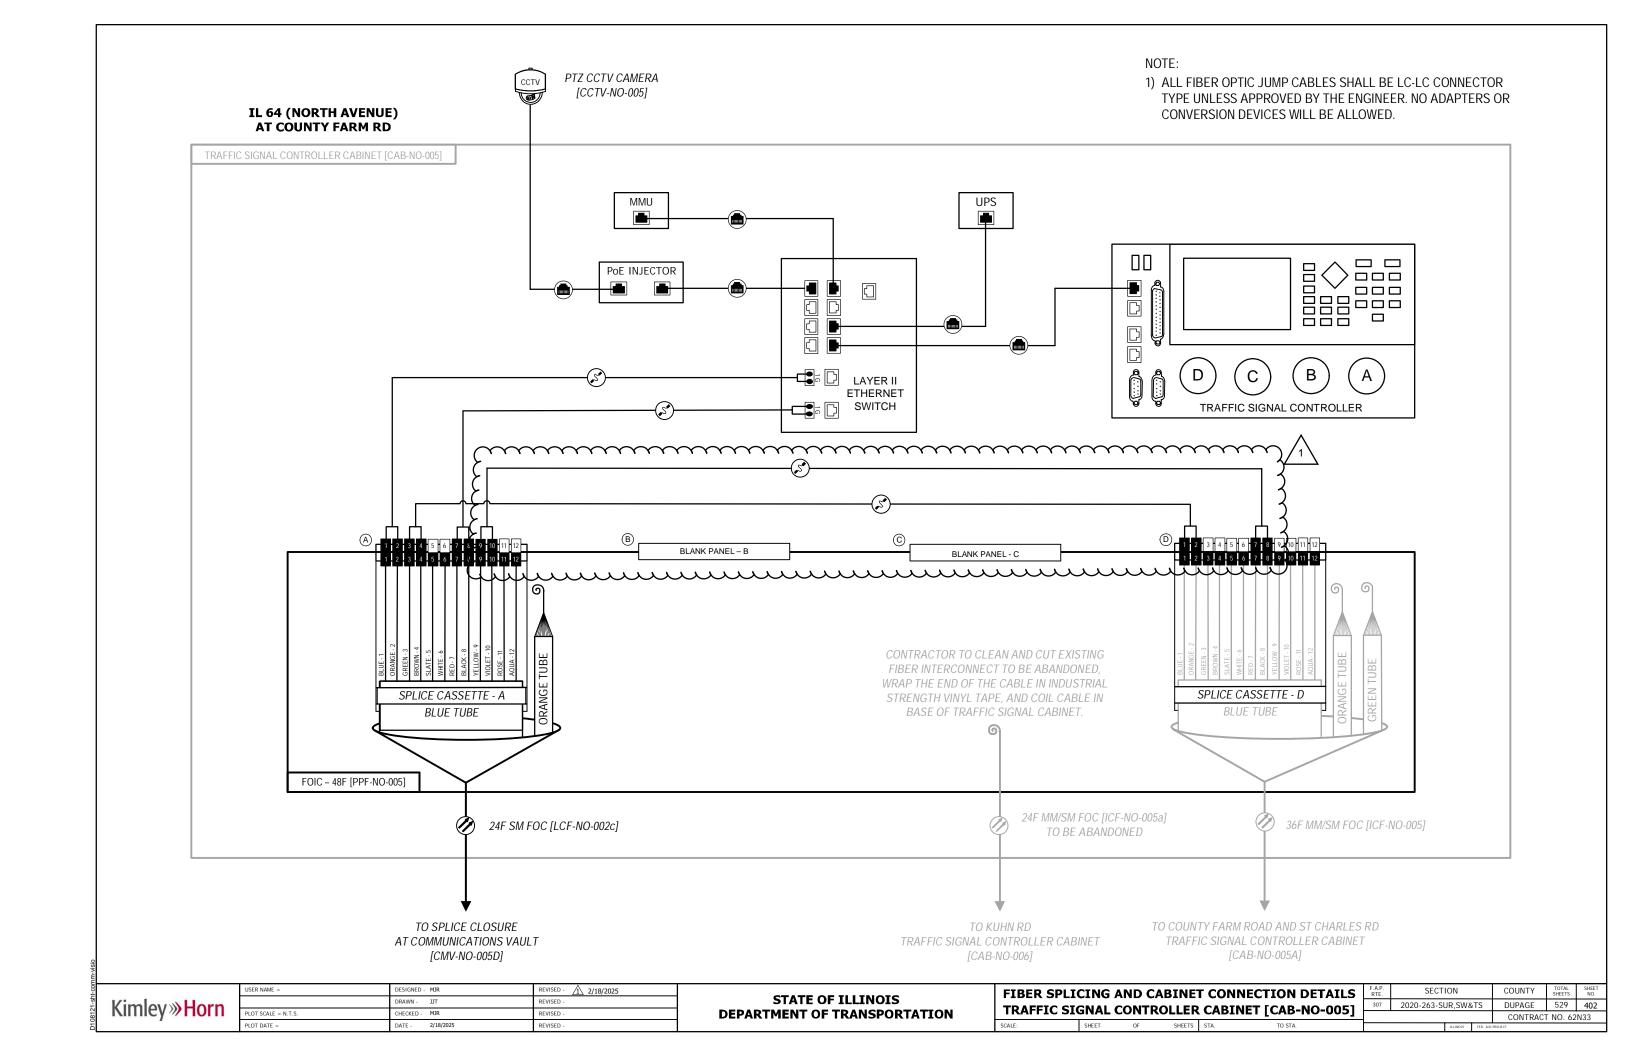

	BUTION CABLE	E DESIGI	NATION DCF-NO-001			(SMITH RD / KAUTZ RD TRAFFC SIGNAL CABINET) E (IDOT COMMUNICATIONS NODE AT IL 59)
Page   1						
Page	Blue	1	1 TRAFFIC SIGNAL CONTROLLER CABINET CAB-NO-000			
	Orang	ige 2	2 TRAFFIC SIGNAL CONTROLLER CABINET CAB-NO-000			
Part	Greer	n 3	3 TRAFFIC SIGNAL CONTROLLER CABINET CAB-NO-000B			
	Brown	/n 4	4 TRAFFIC SIGNAL CONTROLLER CABINET CAB-NO-000B			76 DARK
Part   Part   Slate	2 5	5 TRAFFIC SIGNAL CONTROLLER CABINET CAB-NO-001			77 DARK
Part   Part   White	e 6	6 TRAFFIC SIGNAL CONTROLLER CABINET CAB-NO-001	DED.		
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Figure   1			57 W.V.			
Fame						
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Red   7   55						
Black   8   56   DARK     Yellow   9   57   DARK     Yellow   9   57   DARK     Yellow   9   129   DARK     Yellow   9   129   DARK     Yellow   9   120   DARK     Yellow   9   120   DARK     Yellow   9   120   DARK     Yellow   9   120   DARK     Yell	-			ROSE		
Yellow   9   57   DARK						
Violet   10   58						
Rose   1   59						
Aqua   12   60   DARK     Blue   1   61   SMITH RD / KAUTZ RD LAYER III SWITCH TO IL 59 CORE SWITCH (10G LINK)     Crange   2   62   DARK     Crange   3   63   DARK     Brown   4   64   DARK     Brown   4   64   DARK     Slate   5   65   DARK     Red   7   67   DARK     Black   8   68   DARK     Black   8   68   DARK     Rose   11   71   DARK     Rose   11   71   DARK     DARK     Aqua   12   132   DARK     Aqua   12   133   DARK     Blue   1   133   DARK     Green   3   135   DARK     Blue   1   133   DARK     Green   3   135   DARK     Blue   1   136   DARK     Blown   4   136   DARK     Blown   4   136   DARK     White   6   138   DARK     Red   7   139   DARK     Black   8   140   DARK     Violet   10   70   DARK     Rose   11   71   DARK     DARK     Blue						
Part						
From   3   63   DARK   DARK   DARK   Brown   4   64   DARK   DARK   Brown   4   136   DARK   DARK   Brown   4   64   DARK     Slate   5   65   DARK     White   6   66   DARK     Red   7   67   DARK     Black   8   68   DARK     Yellow   9   69   DARK     Yellow   10   70   DARK     Rose   11   71   DARK     Rose   11   71   DARK     Rose   11   71   DARK     Rose   12   Rose   13   DARK     Slate   5   137   DARK     Slate   5   137   DARK     White   6   138   DARK     Red   7   139   DARK     How   9   141   DARK     Violet   10   142   DARK     Rose   11   143   DARK     Rose   11   143   DARK     Rose   11   143   DARK     Rose   11   143   DARK     Rose   11   143   DARK     Rose   11   143   DARK     Rose   11   143   DARK     Rose   11   143   DARK     Rose   11   143   DARK     Rose   11   143   DARK     Rose   11   143   DARK     Rose   11   143   DARK     Rose   11   143   DARK     Rose   11   143   DARK     Rose   11   143   DARK     Rose   11   Rose   12   Rose     Rose   13   Rose   14   Rose     Rose   14   Rose   15   Rose     Rose   15   Rose   15   Rose     Rose   16   Rose   16   Rose     Rose   17   Rose   16   Rose     Rose   17   Rose   17   Rose     Rose   18   Rose     Rose   18   _	57 W.V.			
Slate   5   65   DARK   DARK   Mite   6   66   DARK   DARK   Mite   6   138   DARK   Mite   6   138   DARK   Mite   6   138   DARK   Mite   6   138   DARK   Mite   6   138   DARK   Mite   6   138   DARK   Mite   6   138   DARK   Mite   6   138   DARK   Mite   6   138   DARK   Mite   6   138   DARK   Mite   6   138   DARK   Mite   6   138   DARK   Mite   6   138   DARK   Mite   6   138   DARK   Mite   6   138   DARK   Mite   6   138   DARK   Mite   6   138   DARK   Mite   Mite   White   6   66   DARK						
Red 7 67 DARK Black 8 68 DARK Yellow 9 69 DARK Violet 10 70 DARK Rose 11 71 DARK  Nose 11 71 DARK  Red 7 139 DARK Red 7 139 DARK Red 7 139 DARK Red 7 139 DARK Red 7 139 DARK Red 7 139 DARK Red 7 139 DARK Red 7 139 DARK Red 7 139 DARK Red 7 139 DARK Red 7 139 DARK						
Red         7         67         DARK           Black         8         68         DARK           Yellow         9         69         DARK           Violet         10         70         DARK           Rose         11         71         DARK           Rose         11         71         DARK           Rose         11         143         DARK           Rose         11         143         DARK	-			AOUA		
Yellow         9         69         DARK           Violet         10         70         DARK           Rose         11         71         DARK           Rose         11         71         DARK	Red					
Violet         10         70         DARK           Rose         11         71         DARK           Rose         11         143         DARK					Black 8	140 DARK
Rose 11 71 DARK Rose 11 143 DARK	-	_	571111		Yellow 9	141 DARK
1000 11 110 1100	Violet	t 10			Violet 10	142 DARK
Aqua   12   72     DARK     Aqua   12   144     DARK						
	Aqua	12	72 DARK		Agua 12	144 DARK

Kimlay WHorn
MITTICY # MUTTI
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PHONE: 630-487-5550

USER NAME =	DESIGNED	=	MJR	REVISED	-	Zi 2/18/2025
	DRAWN	-	JJT	REVISED	-	
PLOT SCALE =	CHECKED	-	MJR	REVISED	-	
PLOT DATE =	DATE	-	2/18/2025	REVISED	-	

STAT	E OI	F ILLINOIS
DEPARTMENT	<b>OF</b>	TRANSPORTATION

						F.A.P.				TOTAL	SHEET
FIBER C	PTIC DIS	TRIBUTIO	N CABL	E SPLICE	ASSIGNMENTS	RTE	SECTION		COUNTY	SHEETS	
		חת	F-NO-00	11		307	2020-263-SUR,SW&T	·s	DUPAGE	529	438
		D(	1 -140-00	, i					CONTRACT	NO. 62	2N33
	SHEET	OF	SHEETS	STA.	TO STA.		ILLINOIS	FED. AI	D PROJECT		

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DISTRIBUTION	N CABLE FIBER ASSIGNMENTS	ORIGINATION	CAB-NO-00	2E (IDOT COMMUNICATIONS NODE AT IL 59)
BUFFER TUBE		BUFFER TUBE		LE (IDOT COMMUNICATIONS NODE AT IL 53)  FIBER NO. ASSIGNMENT
BOTTER TOBE	Blue 1 1 TRAFFIC SIGNAL CONTROLLER CABINET CAB-NO-004	BOTTER TOBE	Blue 1	73 DMS-NO-011
<b>)</b>	Orange 2 2 TRAFFIC SIGNAL CONTROLLER CABINET CAB-NO-004		Orange 2	75 516 110 011
8	Green 3 3 TRAFFIC SIGNAL CONTROLLER CABINET CAB-NO-004A		Green 3	75 DARK
<b>)</b>	Brown 4 4 TRAFFIC SIGNAL CONTROLLER CABINET CAB-NO-004A		Brown 4	
8	Slate 5 5 TRAFFIC SIGNAL CONTROLLER CABINET CAB NO 005		Slate 5	
BLUE	White 6 6 TRAFFIC SIGNAL CONTROLLER CABINET CAB-NO-005  Red 7 7 TRAFFIC SIGNAL CONTROLLER CABINET CAB-NO-005	RED	White 6	78 DARK 79 DARK
8	Black 8 8 TRAFFIC SIGNAL CONTROLLER CABINET CAB-NO-005		Red 7 Black 8	
ξ	Yellow 9 9 TRAFFIC SIGNAL CONTROLLER CABINET CAB-NO-006		Yellow 9	1 1 1 1 1 1 1 1 1 1 1 1 1 1 1 1 1 1 1 1
8	Violet 10 10 TRAFFIC SIGNAL CONTROLLER CABINET CAB-NO-006		Violet 10	82 DARK
8	Rose 11 11 TRAFFIC SIGNAL CONTROLLER CABINET CAB-NO-006A		Rose 11	
\	Aqua     12     12     TRAFFIC SIGNAL CONTROLLER CABINET CAB-NO-006A       Blue     1     13     TRAFFIC SIGNAL CONTROLLER CABINET CAB-NO-007		Aqua 12	
8	Orange 2 14 TRAFFIC SIGNAL CONTROLLER CABINET CAB-NO-007		Blue 1 Orange 2	85 DARK 86 DARK
8	Green 3 15 TRAFFIC SIGNAL CONTROLLER CABINET CAB-NO-008		Green 3	ν
8	Brown 4 16 TRAFFIC SIGNAL CONTROLLER CABINET CAB-NO-008		Brown 4	
Я	Slate 5 17 TRAFFIC SIGNAL CONTROLLER CABINET CAB-NO-008A		Slate 5	89 DARK
ORANGE	White 6 18 TRAFFIC SIGNAL CONTROLLER CABINET CAB-NO-008A	BLACK	White 6	1 I
Я	Red 7 19 TRAFFIC SIGNAL CONTROLLER CABINET CAB-NO-009  Black 8 20 TRAFFIC SIGNAL CONTROLLER CABINET CAB-NO-009		Red 7	
В	Yellow 9 21 TRAFFIC SIGNAL CONTROLLER CABINET CAB-NO-010		Black 8 Yellow 9	
Я	Violet 10 22 TRAFFIC SIGNAL CONTROLLER CABINET CAB-NO-010		Violet 10	
B	Rose 11 23 TRAFFIC SIGNAL CONTROLLER CABINET CAB-NO-010A		Rose 11	
<b></b>	Aqua 12 24 TRAFFIC SIGNAL CONTROLLER CABINET CAB-NO-010A		Aqua 12	96 DARK
K	Blue 1 25 TRAFFIC SIGNAL CONTROLLER CABINET CAB NO 011A		Blue 1	97 DARK
Ì	Orange 2 26 TRAFFIC SIGNAL CONTROLLER CABINET CAB-NO-011A  Green 3 27 TRAFFIC SIGNAL CONTROLLER CABINET CAB-NO-011B		Orange 2	98 DARK
B	Brown 4 28 TRAFFIC SIGNAL CONTROLLER CABINET CAB-NO-011B		Green 3 Brown 4	99 DARK 100 DARK
Ì	Slate 5 29 TRAFFIC SIGNAL CONTROLLER CABINET CAB-NO-011C		Slate 5	
GREEN	White 6 30 TRAFFIC SIGNAL CONTROLLER CABINET CAB-NO-011C	YELLOW	White 6	
GKLLN	Red 7 31 TRAFFIC SIGNAL CONTROLLER CABINET CAB-NO-011D	TELEGVV	Red 7	103 DARK
8	Black 8 32 TRAFFIC SIGNAL CONTROLLER CABINET CAB-NO-011D		Black 8	
}	Yellow         9         33         DARK           Violet         10         34         DARK		Yellow 9	
8	Rose 11 35 DARK		Violet 10 Rose 11	
<u> </u>	Aqua 12 36 DARK		Aqua 12	
8	Blue 1 37 DARK		Blue 1	109 DARK
Ì	Orange 2 38 DARK		Orange 2	
}	Green 3   39   DARK		Green 3 Brown 4	
Ĵ	Slate 5 41 DARK		Slate 5	
BROWN	White 6 42 DARK	VIOLET	White 6	
) BROWN	Red 7 43 DARK	VIOLET	Red 7	115 DARK
8	Black 8 44 DARK		Black 8	
Я	Yellow         9         45         DARK           Violet         10         46         DARK		Yellow 9 Violet 10	
$\mathbb{R}$	Rose 11 47 DARK			119 DARK
<b>S</b>	Aqua 12 48 DARK		Agua 12	
8	Blue 1 49 DARK		Blue 1	121 DARK
Я	Orange 2 50 DARK		Orange 2	
8	Green 3   51   DARK		Green 3	
9	Brown 4         52         DARK           Slate 5         53         DARK		Brown 4 Slate 5	
8	White 6 54 DARK	DOCE	White 6	
SLATE	Red 7 55 DARK	ROSE	Red 7	
В	Black 8 56 DARK		Black 8	
J	Yellow 9 57 DARK		Yellow 9	
В	Violet         10         58         DARK           Rose         11         59         DARK		Violet 10	
Ì	Aqua 12 60 DARK		Rose 11 Agua 12	
8	Blue 1 61 IL 59 CORE SWITCH SMITH TO IL 53 CORE SWITCH (10G LINK)		Blue 1	133 DARK
Я	Orange 2 62 DARK		Orange 2	134 DARK
В	Green 3 63 DARK		Green 3	135 DARK
Ì	Brown 4 64 DARK Slate 5 65 DARK		Brown 4	
В	Slate         5         65         DARK           White         6         66         DARK	4	Slate 5 White 6	
WHITE	Red 7 67 DARK	AQUA	Red 7	
8	Black 8 68 DARK		Black 8	u
Я	Yellow 9 69 DARK		Yellow 9	
B	Violet         10         70         DARK           Rose         11         71         DARK		Violet 10 Rose 11	
Q.	Aqua 12 72 DARK			143 DARK 144 DARK
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<u> </u>				

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4201 WINFIELD ROAD, SUITE 600
WARRENVILLE, IL 60555
PHONE: 630-487-5550

USER NAME =	DESIGNED -	MJR	REVISED	-	Zi 2/18/2025
	DRAWN -	JJT	REVISED	-	
PLOT SCALE =	CHECKED -	MJR	REVISED	-	
PLOT DATE =	DATE -	2/18/2025	REVISED	-	

STATI	E 01	F ILLINOIS
DEPARTMENT	OF	TRANSPORTATION

FIBER O	PTIC DIS	TRIBUTIO	N CABL	E SPLICE	ASSIGNMENTS	F.A.P. RTE	SECTION	COUNTY	TOTAL SHEETS	SHEET NO.
		nr	F-NO-00	2		307	2020-263-SUR,SW&TS	DUPAGE	529	439
			1 -140-00	, <u>z</u>				CONTRACT	NO. 62	2N33
	SHEET	OF	SHEETS	STA.	TO STA.		ILLINOIS FED. A	ID PROJECT		

CTDIDUTIO	DN CABLE FIBER ASSIGNMENTS DN CABLE DESIGNATION DCF-NO-003			D11E (IDOT COMMUNICATIONS NODE AT IL 53) D17C (IDOT COMMUNICATIONS NODE AT I-290)
	BE FIBER FIBER NO. ASSIGNMENT	BUFFER TUBE		FIBER NO.   ASSIGNMENT
TTER TODA	Blue 1 1 DARK	BOTTER TOBE	Blue 1	1 73 DMS-NO-012
	Orange 2 2 DARK		Orange 2	
	Green 3 3 DARK		Green 3	
	Brown 4 4 DARK		Brown 4	
	Slate 5 5 DARK White 6 6 DARK		Slate 5 White 6	
BLUE	Red 7 7 DARK	RED	Red 7	
	Black 8 8 DARK		Black 8	
	Yellow 9 9 TRAFFIC SIGNAL CONTROLLER CABINET CAB·NO-016		Yellow 9	
	Violet 10 10 TRAFFIC SIGNAL CONTROLLER CABINET CAB-NO-016		Violet 10	
	Rose 11 11 TRAFFIC SIGNAL CONTROLLER CABINET CAB-NO-016A  Aqua 12 12 TRAFFIC SIGNAL CONTROLLER CABINET CAB-NO-016A		Rose 11	
	Blue 1 13 TRAFFIC SIGNAL CONTROLLER CABINET CAB-NO-012A		Aqua 12 Blue 1	12 84 DARK 1 85 DARK
	Orange 2 14 TRAFFIC SIGNAL CONTROLLER CABINET CAB-NO-012A		Orange 2	
	Green 3 15 TRAFFIC SIGNAL CONTROLLER CABINET CAB-NO-012B		Green 3	
	Brown 4 16 TRAFFIC SIGNAL CONTROLLER CABINET CAB-NO-012B		Brown 4	
	Slate 5 17 TRAFFIC SIGNAL CONTROLLER CABINET CAB NO. 013		Slate 5	
ORANGE	White 6   18   TRAFFIC SIGNAL CONTROLLER CABINET CAB-NO-013   Red 7   19   TRAFFIC SIGNAL CONTROLLER CABINET CAB-NO-013A	BLACK	White 6	
	Black 8 20 TRAFFIC SIGNAL CONTROLLER CABINET CAB-NO-013A		Red 7 Black 8	
	Yellow 9 21 TRAFFIC SIGNAL CONTROLLER CABINET CAB-NO-013B		Yellow 9	
	Violet 10 22 TRAFFIC SIGNAL CONTROLLER CABINET CAB-NO-013B		Violet 10	
	Rose 11 23 TRAFFIC SIGNAL CONTROLLER CABINET CAB-NO-014		Rose 11	
	Aqua 12 24 TRAFFIC SIGNAL CONTROLLER CABINET CAB-NO-014		Aqua 12	
	Blue 1 25 TRAFFIC SIGNAL CONTROLLER CABINET CAB-NO-014A  Orange 2 26 TRAFFIC SIGNAL CONTROLLER CABINET CAB-NO-014A		Blue 1	1 97 DARK 2 98 DARK
	Green 3 27 TRAFFIC SIGNAL CONTROLLER CABINET CAB-NO-014B		Orange 2 Green 3	
	Brown 4 28 TRAFFIC SIGNAL CONTROLLER CABINET CAB-NO-014B		Brown 4	
	Slate 5 29 TRAFFIC SIGNAL CONTROLLER CABINET CAB-NO-015		Slate 5	
GREEN	White 6 30 TRAFFIC SIGNAL CONTROLLER CABINET CAB-NO-015	YELLOW	White 6	6 102 DARK
	Red 7 31 TRAFFIC SIGNAL CONTROLLER CABINET CAB-NO-015A		Red 7	7 105 57444
	Black 8   32   TRAFFIC SIGNAL CONTROLLER CABINET CAB-NO-015A     Yellow 9   33   TRAFFIC SIGNAL CONTROLLER CABINET CAB-NO-015B		Black 8	
	Violet 10 34 TRAFFIC SIGNAL CONTROLLER CABINET CAB-NO-015B		Yellow 9 Violet 10	
	Rose 11 35 TRAFFIC SIGNAL CONTROLLER CABINET CAB-NO-015C		Rose 11	
	Aqua 12 36 TRAFFIC SIGNAL CONTROLLER CABINET CAB-NO-015C		Aqua 12	
	Blue 1 37 DARK		Blue 1	1 109 DARK
	Orange 2 38 DARK		Orange 2	
	Green 3   39   DARK     Brown 4   40   DARK		Green 3	
	Slate 5 41 DARK		Brown 4 Slate 5	
DDOWN	White 6 42 DARK	VIOLET	White 6	
BROWN	Red 7 43 DARK	VIOLET	Red 7	
	Black 8 44 DARK		Black 8	
	Yellow 9 45 DARK		Yellow 9	
	Violet         10         46         DARK           Rose         11         47         DARK		Violet 10	10         118         DARK           11         119         DARK
	Aqua 12 48 DARK			12 120 DARK
	Blue 1 49 DARK		Blue 1	1 121 DARK
	Orange 2 50 DARK		Orange 2	
	Green 3 51 DARK		Green 3	
	Brown 4 52 DARK		Brown 4	
	Slate         5         53         DARK           White         6         54         DARK		Slate 5	
SLATE	Red 7 55 DARK	ROSE	White 6 Red 7	
	Black 8 56 DARK		Black 8	1 IET BANK
	Yellow 9 57 DARK		Yellow 9	
	Violet 10 58 DARK		Violet 10	
	Rose 11 59 DARK		Rose 11	
	Aqua   12   60   DARK     Blue   1   61   IL 59 CORE SWITCH SMITH TO YORK ST LAYER III SWITCH (10G LINK)		Aqua 12 Blue 1	
	Orange 2 62 DARK		Orange 2	
	Green 3 63 DARK		Green 3	3 135 DARK
	Brown 4 64 DARK		Brown 4	
	Slate 5 65 DARK		Slate 5	5 137 DARK
WHITE	White 6 66 DARK	AQUA	White 6	0 130 5/11/1
	Red 7   67   DARK     Black 8   68   DARK		Red 7	7 135 Britis
	Black 8 68 DARK  Yellow 9 69 DARK		Black 8 Yellow 9	
	Violet 10 70 DARK		Violet 10	
	Rose 11 71 DARK			11 143 DARK
	Agua 12 72 DARK			12 144 DARK
$\sim$				

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PLOT SCALE =	CHECKED	-	MJR	REVISED	-	
PLOT DATE =	DATE	-	2/18/2025	REVISED	-	

STATI	E OI	F ILLINOIS
DEPARTMENT	OF	TRANSPORTATION

FIBER O	OPTIC DIS	TRIBUTIO	ON CABL	E SPLIC	F.A.P. RTE	SECTION COUNTY TO SHE				
DCF-N0-003							2020-263-SUR,SW&TS	DUPAGE	529	440
								CONTRACT	NO. 62	2N33
	SHEET	OF	SHEETS	STA.	TO STA.	ILLINOIS FED. A		ID PROJECT		

ATERAL CABLE	FIBER ASSIGN	IMENTS		ORIGINATION CAB-NO-000
TERAL CABLE	DESIGNATION		LCF-NO-001a	DESTINATION CMV-NO-000
BUFFER TUBE	FIBER	FIBER NO.	CABINET CONNECTIONS	DISTRIBUTION CABLE CONNECTIONS
	Blue 1	1	PATCH PANEL "A" PORT 1 (JUMPERED TO LAYER III ETHERNET SWITCH)	DCF-NO-001 (EB), FIBER 1
	Orange 2	2	PATCH PANEL "A" PORT 2 (JUMPERED TO LAYER III ETHERNET SWITCH)	DCF-NO-001 (EB), FIBER 2
	Green 3	3	PATCH PANEL "A" PORT 3	NO CONNECTION (LATERAL STRANDS COILED IN SPLICE CLOSURE
	Brown 4	4	PATCH PANEL "A" PORT 4	NO CONNECTION (LATERAL STRANDS COILED IN SPLICE CLOSURE
	Slate 5	5	PATCH PANEL "A" PORT 5	NO CONNECTION (LATERAL STRANDS COILED IN SPLICE CLOSURE
BLUE	White 6	6	PATCH PANEL "A" PORT 6	NO CONNECTION (LATERAL STRANDS COILED IN SPLICE CLOSURI
BLUE	Red 7	7	PATCH PANEL "A" PORT 7	NO CONNECTION (LATERAL STRANDS COILED IN SPLICE CLOSUR
	Black 8	8	PATCH PANEL "A" PORT 8	NO CONNECTION (LATERAL STRANDS COILED IN SPLICE CLOSUR)
	Yellow 9	9	PATCH PANEL "A" PORT 9	NO CONNECTION (LATERAL STRANDS COILED IN SPLICE CLOSUR
	Violet 10	10	PATCH PANEL "A" PORT 10	NO CONNECTION (LATERAL STRANDS COILED IN SPLICE CLOSUR
	Rose 11	11	PATCH PANEL "A" PORT 11	NO CONNECTION (LATERAL STRANDS COILED IN SPLICE CLOSUR
	Aqua 12	12	PATCH PANEL "A" PORT 12 (JUMPERED TO LAYER III ETHERNET SWITCH)	DCF-NO-001 (EB), FIBER 61
	Blue 1	13	COILED IN FIBER OPTIC INTERCONNECT CENTER	NO CONNECTION (LATERAL STRANDS COILED IN SPLICE CLOSUR
	Orange 2	14	COILED IN FIBER OPTIC INTERCONNECT CENTER	NO CONNECTION (LATERAL STRANDS COILED IN SPLICE CLOSUR
	Green 3	15	COILED IN FIBER OPTIC INTERCONNECT CENTER	NO CONNECTION (LATERAL STRANDS COILED IN SPLICE CLOSUR
	Brown 4	16	COILED IN FIBER OPTIC INTERCONNECT CENTER	NO CONNECTION (LATERAL STRANDS COILED IN SPLICE CLOSUR
	Slate 5	17	COILED IN FIBER OPTIC INTERCONNECT CENTER	NO CONNECTION (LATERAL STRANDS COILED IN SPLICE CLOSUR
ORANGE	White 6	18	COILED IN FIBER OPTIC INTERCONNECT CENTER	NO CONNECTION (LATERAL STRANDS COILED IN SPLICE CLOSUR
ONANGE	Red 7	19	COILED IN FIBER OPTIC INTERCONNECT CENTER	NO CONNECTION (LATERAL STRANDS COILED IN SPLICE CLOSUR
	Black 8	20	COILED IN FIBER OPTIC INTERCONNECT CENTER	NO CONNECTION (LATERAL STRANDS COILED IN SPLICE CLOSUR
	Yellow 9	21	COILED IN FIBER OPTIC INTERCONNECT CENTER	NO CONNECTION (LATERAL STRANDS COILED IN SPLICE CLOSUR
	Violet 10	22	COILED IN FIBER OPTIC INTERCONNECT CENTER	NO CONNECTION (LATERAL STRANDS COILED IN SPLICE CLOSUR
	Rose 11	23	COILED IN FIBER OPTIC INTERCONNECT CENTER	NO CONNECTION (LATERAL STRANDS COILED IN SPLICE CLOSUR
	Aqua 12	24	COILED IN FIBER OPTIC INTERCONNECT CENTER	NO CONNECTION (LATERAL STRANDS COILED IN SPLICE CLOSUR

Kimley» Horn

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 PLOT DATE
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 DATE
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STATE OF ILLINOIS
DEPARTMENT OF TRANSPORTATION

FIBER OPTIC LATERAL CABLE SPLICE ASSIGNMENTS

LCF-NO-001a

SHEET OF SHEETS STA. TO STA.

kh-pw.bentley.com.kh-pw-01\Documents\01 Active Projects\MW-CHS-1689

DEP

ATERAL CABLE	FIBER ASSIG	NMENTS		ORIGINATION CAB-NO-005
ATERAL CABLE	DESIGNATIO	V	LCF-NO-002c	DESTINATION CMV-NO-005F
BUFFER TUBE	FIBER	FIBER NO.	CABINET CONNECTIONS	DISTRIBUTION CABLE CONNECTIONS
	Blue 1	1	PATCH PANEL "A" PORT 1 (JUMPERED TO LAYER II ETHERNET SWITCH)	DCF-NO-002 (WB), FIBER 5
	Orange 2	2	PATCH PANEL "A" PORT 2 (JUMPERED TO LAYER II ETHERNET SWITCH)	DCF-NO-002 (WB), FIBER 6
	Green 3	3	PATCH PANEL "A" PORT 3 (JUMPERED TO PATCH PANEL "D" PORT 1)	DCF-NO-002 (WB), FIBER 7
	Brown 4	4	PATCH PANEL "A" PORT 4 (JUMPERED TO PATCH PANEL "D" PORT 2)	DCF-NO-002 (WB), FIBER 8
	Slate 5	5	PATCH PANEL "A" PORT 5	NO CONNECTION (LATERAL STRANDS COILED IN SPLICE CLOSURE
BLUE	White 6	6	PATCH PANEL "A" PORT 6	NO CONNECTION (LATERAL STRANDS COILED IN SPLICE CLOSURE
BLUE	Red 7	7	PATCH PANEL "A" PORT 7 (JUMPERED TO LAYER II ETHERNET SWITCH)	DCF-NO-002 (EB), FIBER 5
	Black 8	8	PATCH PANEL "A" PORT 8 (JUMPERED TO LAYER II ETHERNET SWITCH)	DCF-NO-002 (EB), FIBER 6
	Yellow 9	9	PATCH PANEL "A" PORT 9 (JUMPERED TO PATCH PANEL "D" PORT 7)	DCF-NO-002 (EB), FIBER 7
	Violet 10	10	PATCH PANEL "A" PORT 10 (JUMPERED TO PATCH PANEL "D" PORT 8)	DCF-NO-002 (EB), FIBER 8
	Rose 1	11	PATCH PANEL "A" PORT 11	NO CONNECTION (LATERAL STRANDS COILED IN SPLICE CLOSURI
	Aqua 12	2 12	PATCH PANEL "A" PORT 12	NO CONNECTION (LATERAL STRANDS COILED IN SPLICE CLOSURI
	Blue 1	13	COILED IN FIBER OPTIC INTERCONNECT CENTER	NO CONNECTION (LATERAL STRANDS COILED IN SPLICE CLOSURI
	Orange 2	14	COILED IN FIBER OPTIC INTERCONNECT CENTER	NO CONNECTION (LATERAL STRANDS COILED IN SPLICE CLOSURI
	Green 3	15	COILED IN FIBER OPTIC INTERCONNECT CENTER	NO CONNECTION (LATERAL STRANDS COILED IN SPLICE CLOSURI
	Brown 4	16	COILED IN FIBER OPTIC INTERCONNECT CENTER	NO CONNECTION (LATERAL STRANDS COILED IN SPLICE CLOSURI
	Slate 5	17	COILED IN FIBER OPTIC INTERCONNECT CENTER	NO CONNECTION (LATERAL STRANDS COILED IN SPLICE CLOSURI
ORANGE	White 6	18	COILED IN FIBER OPTIC INTERCONNECT CENTER	NO CONNECTION (LATERAL STRANDS COILED IN SPLICE CLOSURE
ONANGE	Red 7	19	COILED IN FIBER OPTIC INTERCONNECT CENTER	NO CONNECTION (LATERAL STRANDS COILED IN SPLICE CLOSURI
	Black 8	20	COILED IN FIBER OPTIC INTERCONNECT CENTER	NO CONNECTION (LATERAL STRANDS COILED IN SPLICE CLOSUR
	Yellow 9	21	COILED IN FIBER OPTIC INTERCONNECT CENTER	NO CONNECTION (LATERAL STRANDS COILED IN SPLICE CLOSUR
	Violet 10	22	COILED IN FIBER OPTIC INTERCONNECT CENTER	NO CONNECTION (LATERAL STRANDS COILED IN SPLICE CLOSURI
	Rose 1	23	COILED IN FIBER OPTIC INTERCONNECT CENTER	NO CONNECTION (LATERAL STRANDS COILED IN SPLICE CLOSUR
	Aqua 12	24	COILED IN FIBER OPTIC INTERCONNECT CENTER	NO CONNECTION (LATERAL STRANDS COILED IN SPLICE CLOSURI

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	PHONE: 630-487-5550
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USER NAME =	DESIGNED -	MJR	REVISED - 🛆 2/18/2025
	DRAWN -	JJT	REVISED -
PLOT SCALE =	CHECKED -	MJR	REVISED -
PLOT DATE =	DATE -	2/18/2025	REVISED -

FIBE	FIBER OPTIC LATERAL CABLE SPLICE ASSIGNMENTS						SECTION COUN		COUNTY	TOTAL SHEETS	SHEET NO.
LCF-N0-002c						307	2020-263-SUR,SW8	DUPAGE	529	447	
	LGI -NO-002C								CONTRACT	NO. 62	2N33
	SHEET	OF	SHEETS	STA.	TO STA.		ILLINOIS	FED. A	ID PROJECT		

ATERAL CABLE	FIBER ASSIGN	MENTS		ORIGINATION CAB-NO-006
ATERAL CABLE	DESIGNATION	I	LCF-NO-002d	DESTINATION CMV-NO-006B
BUFFER TUBE	FIBER	FIBER NO.	CABINET CONNECTIONS	DISTRIBUTION CABLE CONNECTIONS
	Blue 1	1	PATCH PANEL "A" PORT 1 (JUMPERED TO LAYER II ETHERNET SWITCH)	DCF-NO-002 (WB), FIBER 9
	Orange 2	2	PATCH PANEL "A" PORT 2 (JUMPERED TO LAYER II ETHERNET SWITCH)	DCF-NO-002 (WB), FIBER 10
	Green 3	3	PATCH PANEL "A" PORT 3	NO CONNECTION (LATERAL STRANDS COILED IN SPLICE CLOSUR
	Brown 4	4	PATCH PANEL "A" PORT 4	NO CONNECTION (LATERAL STRANDS COILED IN SPLICE CLOSUR
	Slate 5	5	PATCH PANEL "A" PORT 5	NO CONNECTION (LATERAL STRANDS COILED IN SPLICE CLOSUR
BLUE	White 6	6	PATCH PANEL "A" PORT 6	NO CONNECTION (LATERAL STRANDS COILED IN SPLICE CLOSUR
BLUE	Red 7	7	PATCH PANEL "A" PORT 7 (JUMPERED TO LAYER II ETHERNET SWITCH)	DCF-NO-002 (EB), FIBER 9
	Black 8	8	PATCH PANEL "A" PORT 8 (JUMPERED TO LAYER II ETHERNET SWITCH)	DCF-NO-002 (EB), FIBER 10
	Yellow 9	9	PATCH PANEL "A" PORT 9	NO CONNECTION (LATERAL STRANDS COILED IN SPLICE CLOSUR
	Violet 10	10	PATCH PANEL "A" PORT 10	NO CONNECTION (LATERAL STRANDS COILED IN SPLICE CLOSUR
	Rose 11	11	PATCH PANEL "A" PORT 11	NO CONNECTION (LATERAL STRANDS COILED IN SPLICE CLOSUR
	Aqua 12	12	PATCH PANEL "A" PORT 12	NO CONNECTION (LATERAL STRANDS COILED IN SPLICE CLOSUR
	Blue 1	13	COILED IN FIBER OPTIC INTERCONNECT CENTER	NO CONNECTION (LATERAL STRANDS COILED IN SPLICE CLOSUR
	Orange 2	14	COILED IN FIBER OPTIC INTERCONNECT CENTER	NO CONNECTION (LATERAL STRANDS COILED IN SPLICE CLOSUR
	Green 3	15	COILED IN FIBER OPTIC INTERCONNECT CENTER	NO CONNECTION (LATERAL STRANDS COILED IN SPLICE CLOSUR
	Brown 4	16	COILED IN FIBER OPTIC INTERCONNECT CENTER	NO CONNECTION (LATERAL STRANDS COILED IN SPLICE CLOSUR
	Slate 5	17	COILED IN FIBER OPTIC INTERCONNECT CENTER	NO CONNECTION (LATERAL STRANDS COILED IN SPLICE CLOSUR
ORANGE	White 6	18	COILED IN FIBER OPTIC INTERCONNECT CENTER	NO CONNECTION (LATERAL STRANDS COILED IN SPLICE CLOSUR
ONANGL	Red 7	19	COILED IN FIBER OPTIC INTERCONNECT CENTER	NO CONNECTION (LATERAL STRANDS COILED IN SPLICE CLOSUR
	Black 8	20	COILED IN FIBER OPTIC INTERCONNECT CENTER	NO CONNECTION (LATERAL STRANDS COILED IN SPLICE CLOSUR
	Ye <b>ll</b> ow 9	21	COILED IN FIBER OPTIC INTERCONNECT CENTER	NO CONNECTION (LATERAL STRANDS COILED IN SPLICE CLOSUR
	Violet 10	22	COILED IN FIBER OPTIC INTERCONNECT CENTER	NO CONNECTION (LATERAL STRANDS COILED IN SPLICE CLOSUR
	Rose 11	23	COILED IN FIBER OPTIC INTERCONNECT CENTER	NO CONNECTION (LATERAL STRANDS COILED IN SPLICE CLOSUR
	Aqua 12	24	COILED IN FIBER OPTIC INTERCONNECT CENTER	NO CONNECTION (LATERAL STRANDS COILED IN SPLICE CLOSUP

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PLOT SCALE =	CHECKED -	MJR	REVISED -
PLOT DATE =	DATE -	2/18/2025	REVISED -

FIBER	R OPTIC LA	F.A.P. RTE	SECTION				
LCF-NO-02d							2020-263-SUR,S
		LU	1 -110-02	u			
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F.A.P. RTE	SECT	ΓΙΟΝ	COUNTY	TOTAL SHEETS	SHE	
307	2020-263-S	UR,SW&	TS	DUPAGE	529	44
				CONTRACT	NO. 62	2N33
		ILLINOIS	FED. A	ID PROJECT		

STATE OF ILLINOIS DEPARTMENT OF TRANSPORTATION

ATERAL CABLE	FIBER ASSIG	VMENTS		ORIGINATION CAB-NO-006A			
ATERAL CABLE	DESIGNATIO	٧	LCF-NO-002e	DESTINATION CMV-NO-006E			
BUFFER TUBE	FIBER	FIBER NO.	CABINET CONNECTIONS	DISTRIBUTION CABLE CONNECTIONS			
	Blue 1	1	PATCH PANEL "A" PORT 1 (JUMPERED TO LAYER II ETHERNET SWITCH)	DCF-NO-002 (WB), FIBER 11			
	Orange 2	2	PATCH PANEL "A" PORT 2 (JUMPERED TO LAYER II ETHERNET SWITCH)	DCF-NO-002 (WB), FIBER 12			
	Green 3	3	PATCH PANEL "A" PORT 3	NO CONNECTION (LATERAL STRANDS COILED IN SPLICE CLOSURE			
	Brown 4	4	PATCH PANEL "A" PORT 4	NO CONNECTION (LATERAL STRANDS COILED IN SPLICE CLOSURE			
	Slate 5	5	PATCH PANEL "A" PORT 5	NO CONNECTION (LATERAL STRANDS COILED IN SPLICE CLOSURE			
BLUE	White 6	6	PATCH PANEL "A" PORT 6	NO CONNECTION (LATERAL STRANDS COILED IN SPLICE CLOSURE			
BLUE	Red 7	7	PATCH PANEL "A" PORT 7 (JUMPERED TO LAYER II ETHERNET SWITCH)	DCF-NO-002 (EB), FIBER 11			
	Black 8	8	PATCH PANEL "A" PORT 8 (JUMPERED TO LAYER II ETHERNET SWITCH)	DCF-NO-002 (EB), FIBER 12			
	Yellow 9	9	PATCH PANEL "A" PORT 9	NO CONNECTION (LATERAL STRANDS COILED IN SPLICE CLOSURE			
	Violet 10	10	PATCH PANEL "A" PORT 10	NO CONNECTION (LATERAL STRANDS COILED IN SPLICE CLOSURE			
	Rose 1	11	PATCH PANEL "A" PORT 11	NO CONNECTION (LATERAL STRANDS COILED IN SPLICE CLOSURE			
	Aqua 12	12	PATCH PANEL "A" PORT 12	NO CONNECTION (LATERAL STRANDS COILED IN SPLICE CLOSURE			
	Blue 1	13	COILED IN FIBER OPTIC INTERCONNECT CENTER	NO CONNECTION (LATERAL STRANDS COILED IN SPLICE CLOSURE			
	Orange 2	14	COILED IN FIBER OPTIC INTERCONNECT CENTER	NO CONNECTION (LATERAL STRANDS COILED IN SPLICE CLOSURE			
	Green 3	15	COILED IN FIBER OPTIC INTERCONNECT CENTER	NO CONNECTION (LATERAL STRANDS COILED IN SPLICE CLOSURE			
	Brown 4	16	COILED IN FIBER OPTIC INTERCONNECT CENTER	NO CONNECTION (LATERAL STRANDS COILED IN SPLICE CLOSURE			
	Slate 5	17	COILED IN FIBER OPTIC INTERCONNECT CENTER	NO CONNECTION (LATERAL STRANDS COILED IN SPLICE CLOSURE			
ORANGE	White 6	18	COILED IN FIBER OPTIC INTERCONNECT CENTER	NO CONNECTION (LATERAL STRANDS COILED IN SPLICE CLOSURE			
ONANGE	Red 7	19	COILED IN FIBER OPTIC INTERCONNECT CENTER	NO CONNECTION (LATERAL STRANDS COILED IN SPLICE CLOSURE			
	Black 8	20	COILED IN FIBER OPTIC INTERCONNECT CENTER	NO CONNECTION (LATERAL STRANDS COILED IN SPLICE CLOSURE			
	Yellow 9	21	COILED IN FIBER OPTIC INTERCONNECT CENTER	NO CONNECTION (LATERAL STRANDS COILED IN SPLICE CLOSURE			
	Violet 10	22	COILED IN FIBER OPTIC INTERCONNECT CENTER	NO CONNECTION (LATERAL STRANDS COILED IN SPLICE CLOSURE			
	Rose 1	23	COILED IN FIBER OPTIC INTERCONNECT CENTER	NO CONNECTION (LATERAL STRANDS COILED IN SPLICE CLOSURE			
	Aqua 12	24	COILED IN FIBER OPTIC INTERCONNECT CENTER	NO CONNECTION (LATERAL STRANDS COILED IN SPLICE CLOSURI			

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PLOT SCALE =	CHECKED - MJR	REVISED -
PLOT DATE =	DATE - 2/18/2025	REVISED -

FIBEF	R OPTIC L	ATERAL	CABLE S	SPLICE A	SSIGNMENTS	F.A.P. RTE	SECT	ION		COUNTY	TOTAL SHEETS	SHEET NO.	
		ıc	F_NO_002	20		307	2020-263-S	UR,SW&	TS	DUPAGE	529	449	
		LU	-110-002	2.G						CONTRACT	F NO. 62	2N33	
	SHEET	OF	SHEETS	STA.	TO STA.			ILLINOIS	FED. AI	ID PROJECT			

ATERAL CABLE	FIBER ASSIGN	IMENTS		ORIGINATION CAB-NO-007
ATERAL CABLE	DESIGNATION	I	LCF-NO-002f	DESTINATION CMV-NO-007B
BUFFER TUBE FIBER NO.			CABINET CONNECTIONS	DISTRIBUTION CABLE CONNECTIONS
	Blue 1	1	PATCH PANEL "A" PORT 1 (JUMPERED TO LAYER II ETHERNET SWITCH)	DCF-NO-002 (WB), FIBER 13
	Orange 2	2	PATCH PANEL "A" PORT 2 (JUMPERED TO LAYER II ETHERNET SWITCH)	DCF-NO-002 (WB), FIBER 14
	Green 3	3	PATCH PANEL "A" PORT 3	NO CONNECTION (LATERAL STRANDS COILED IN SPLICE CLOSUR
	Brown 4	4	PATCH PANEL "A" PORT 4	NO CONNECTION (LATERAL STRANDS COILED IN SPLICE CLOSUR
	Slate 5	5	PATCH PANEL "A" PORT 5	NO CONNECTION (LATERAL STRANDS COILED IN SPLICE CLOSUR
BLUE	White 6	6	PATCH PANEL "A" PORT 6	NO CONNECTION (LATERAL STRANDS COILED IN SPLICE CLOSUR
BLUE	Red 7	7	PATCH PANEL "A" PORT 7 (JUMPERED TO LAYER II ETHERNET SWITCH)	DCF-NO-002 (EB), FIBER 13
	Black 8	8	PATCH PANEL "A" PORT 8 (JUMPERED TO LAYER II ETHERNET SWITCH)	DCF-NO-002 (EB), FIBER 14
	Yellow 9	9	PATCH PANEL "A" PORT 9	NO CONNECTION (LATERAL STRANDS COILED IN SPLICE CLOSUR
	Violet 10	10	PATCH PANEL "A" PORT 10	NO CONNECTION (LATERAL STRANDS COILED IN SPLICE CLOSUR
	Rose 11	11	PATCH PANEL "A" PORT 11	NO CONNECTION (LATERAL STRANDS COILED IN SPLICE CLOSUR
	Aqua 12	12	PATCH PANEL "A" PORT 12	NO CONNECTION (LATERAL STRANDS COILED IN SPLICE CLOSUR
	Blue 1	13	COILED IN FIBER OPTIC INTERCONNECT CENTER	NO CONNECTION (LATERAL STRANDS COILED IN SPLICE CLOSUR
	Orange 2	14	COILED IN FIBER OPTIC INTERCONNECT CENTER	NO CONNECTION (LATERAL STRANDS COILED IN SPLICE CLOSUR
	Green 3	15	COILED IN FIBER OPTIC INTERCONNECT CENTER	NO CONNECTION (LATERAL STRANDS COILED IN SPLICE CLOSUR
	Brown 4	16	COILED IN FIBER OPTIC INTERCONNECT CENTER	NO CONNECTION (LATERAL STRANDS COILED IN SPLICE CLOSUR
	Slate 5	17	COILED IN FIBER OPTIC INTERCONNECT CENTER	NO CONNECTION (LATERAL STRANDS COILED IN SPLICE CLOSUR
ORANGE	White 6	18	COILED IN FIBER OPTIC INTERCONNECT CENTER	NO CONNECTION (LATERAL STRANDS COILED IN SPLICE CLOSUR
ONANGE	Red 7	19	COILED IN FIBER OPTIC INTERCONNECT CENTER	NO CONNECTION (LATERAL STRANDS COILED IN SPLICE CLOSUR
	Black 8	20	COILED IN FIBER OPTIC INTERCONNECT CENTER	NO CONNECTION (LATERAL STRANDS COILED IN SPLICE CLOSUR
	Ye <b>ll</b> ow 9	21	COILED IN FIBER OPTIC INTERCONNECT CENTER	NO CONNECTION (LATERAL STRANDS COILED IN SPLICE CLOSUR
	Violet 10	22	COILED IN FIBER OPTIC INTERCONNECT CENTER	NO CONNECTION (LATERAL STRANDS COILED IN SPLICE CLOSUR
	Rose 11	23	COILED IN FIBER OPTIC INTERCONNECT CENTER	NO CONNECTION (LATERAL STRANDS COILED IN SPLICE CLOSUR
	Aqua 12	24	COILED IN FIBER OPTIC INTERCONNECT CENTER	NO CONNECTION (LATERAL STRANDS COILED IN SPLICE CLOSUR

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PLOT SCALE =	CHECKED -	MJR	REVISED -
PLOT DATE =	DATE -	2/18/2025	REVISED -

		F.A.P. RTE	SEC <sup>-</sup>	SECTION		COUNTY	TOTAL SHEETS				
		ır	F-NO-00	of.		307	2020-263-S	ur,sw8	TS	DUPAGE	529
			1-140-00	41						CONTRACT	NO. 6
	SHEET	OF	SHEETS	STA.	TO STA.			ILLINOIS	FED A	ID PROJECT	

ATERAL CABLE	FIBER ASSIGN	MENTS		ORIGINATION CAB-NO-008
TERAL CABLE	DESIGNATION		LCF-NO-002g	DESTINATION CMV-NO-008C
BUFFER TUBE	FIBER	FIBER NO	. CABINET CONNECTIONS	DISTRIBUTION CABLE CONNECTIONS
	Blue 1	1	PATCH PANEL "A" PORT 1 (JUMPERED TO LAYER II ETHERNET SWITCH)	DCF-NO-002 (WB), FIBER 15
	Orange 2	2	PATCH PANEL "A" PORT 2 (JUMPERED TO LAYER II ETHERNET SWITCH)	DCF-NO-002 (WB), FIBER 16
	Green 3	3	PATCH PANEL "A" PORT 3	NO CONNECTION (LATERAL STRANDS COILED IN SPLICE CLOSURE
	Brown 4	4	PATCH PANEL "A" PORT 4	NO CONNECTION (LATERAL STRANDS COILED IN SPLICE CLOSURE
	Slate 5	5	PATCH PANEL "A" PORT 5	NO CONNECTION (LATERAL STRANDS COILED IN SPLICE CLOSURE
BLUE	White 6	6	PATCH PANEL "A" PORT 6	NO CONNECTION (LATERAL STRANDS COILED IN SPLICE CLOSURE
BLUE	Red 7	7	PATCH PANEL "A" PORT 7 (JUMPERED TO LAYER II ETHERNET SWITCH)	DCF-NO-002 (EB), FIBER 15
	Black 8	8	PATCH PANEL "A" PORT 8 (JUMPERED TO LAYER II ETHERNET SWITCH)	DCF-NO-002 (EB), FIBER 16
	Yellow 9	9	PATCH PANEL "A" PORT 9	NO CONNECTION (LATERAL STRANDS COILED IN SPLICE CLOSURE
	Violet 10	10	PATCH PANEL "A" PORT 10	NO CONNECTION (LATERAL STRANDS COILED IN SPLICE CLOSURE
	Rose 11	11	PATCH PANEL "A" PORT 11	NO CONNECTION (LATERAL STRANDS COILED IN SPLICE CLOSURE
	Aqua 12	12	PATCH PANEL "A" PORT 12	NO CONNECTION (LATERAL STRANDS COILED IN SPLICE CLOSURE
	Blue 1	13	COILED IN FIBER OPTIC INTERCONNECT CENTER	NO CONNECTION (LATERAL STRANDS COILED IN SPLICE CLOSURE
	Orange 2	14	COILED IN FIBER OPTIC INTERCONNECT CENTER	NO CONNECTION (LATERAL STRANDS COILED IN SPLICE CLOSURE
	Green 3	15	COILED IN FIBER OPTIC INTERCONNECT CENTER	NO CONNECTION (LATERAL STRANDS COILED IN SPLICE CLOSURE
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	Slate 5	17	COILED IN FIBER OPTIC INTERCONNECT CENTER	NO CONNECTION (LATERAL STRANDS COILED IN SPLICE CLOSURE
ORANGE	White 6	18	COILED IN FIBER OPTIC INTERCONNECT CENTER	NO CONNECTION (LATERAL STRANDS COILED IN SPLICE CLOSURE
UNANGE	Red 7	19	COILED IN FIBER OPTIC INTERCONNECT CENTER	NO CONNECTION (LATERAL STRANDS COILED IN SPLICE CLOSURE
	B <b>l</b> ack 8	20	COILED IN FIBER OPTIC INTERCONNECT CENTER	NO CONNECTION (LATERAL STRANDS COILED IN SPLICE CLOSURE
	Ye <b>ll</b> ow 9	21	COILED IN FIBER OPTIC INTERCONNECT CENTER	NO CONNECTION (LATERAL STRANDS COILED IN SPLICE CLOSURE
	Violet 10	22	COILED IN FIBER OPTIC INTERCONNECT CENTER	NO CONNECTION (LATERAL STRANDS COILED IN SPLICE CLOSURE
	Rose 11	23	COILED IN FIBER OPTIC INTERCONNECT CENTER	NO CONNECTION (LATERAL STRANDS COILED IN SPLICE CLOSURE
	Aqua 12	24	COILED IN FIBER OPTIC INTERCONNECT CENTER	NO CONNECTION (LATERAL STRANDS COILED IN SPLICE CLOSURE

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	PHONE: 630-487-5550

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PLOT SCALE =	CHECKED - MJR	REVISED -
PLOT DATE =	DATE - 2/18/2025	REVISED -

STATE OF ILLINOIS **DEPARTMENT OF TRANSPORTATION** 

SCALE:

FIBER OPTIC LATERAL CABLE SPLICE ASSIGNMENTS							SECTION
		LCI	307	2020-263-SUR,SW&TS			
		LUI					
	CHEET	0.5	CHEETC	CTA	TO CT4		

COUNTY TOTAL SHEET NO.

DUPAGE 529 451 CONTRACT NO. 62N33

ATERAL CABLE	FIBER ASSIGN	IMENTS		ORIGINATION CAB-NO-008A
ATERAL CABLE	DESIGNATION		LCF-NO-002h	DESTINATION CMV-NO-008D
BUFFER TUBE	FIBER	FIBER NO.	CABINET CONNECTIONS	DISTRIBUTION CABLE CONNECTIONS
	Blue 1	1	PATCH PANEL "A" PORT 1 (JUMPERED TO LAYER II ETHERNET SWITCH)	DCF-NO-002 (WB), FIBER 17
	Orange 2	2	PATCH PANEL "A" PORT 2 (JUMPERED TO LAYER II ETHERNET SWITCH)	DCF-NO-002 (WB), FIBER 18
	Green 3	3	PATCH PANEL "A" PORT 3	NO CONNECTION (LATERAL STRANDS COILED IN SPLICE CLOSURE)
	Brown 4	4	PATCH PANEL "A" PORT 4	NO CONNECTION (LATERAL STRANDS COILED IN SPLICE CLOSURE
	Slate 5	5	PATCH PANEL "A" PORT 5	NO CONNECTION (LATERAL STRANDS COILED IN SPLICE CLOSURE
DLUE	White 6	6	PATCH PANEL "A" PORT 6	NO CONNECTION (LATERAL STRANDS COILED IN SPLICE CLOSURE
BLUE	Red 7	7	PATCH PANEL "A" PORT 7 (JUMPERED TO LAYER II ETHERNET SWITCH)	DCF-NO-002 (EB), FIBER 17
	Black 8	8	PATCH PANEL "A" PORT 8 (JUMPERED TO LAYER II ETHERNET SWITCH)	DCF-NO-002 (EB), FIBER 18
	Yellow 9	9	PATCH PANEL "A" PORT 9	NO CONNECTION (LATERAL STRANDS COILED IN SPLICE CLOSURE
	Violet 10	10	PATCH PANEL "A" PORT 10	NO CONNECTION (LATERAL STRANDS COILED IN SPLICE CLOSURE
	Rose 11	11	PATCH PANEL "A" PORT 11	NO CONNECTION (LATERAL STRANDS COILED IN SPLICE CLOSURE
	Aqua 12	12	PATCH PANEL "A" PORT 12	NO CONNECTION (LATERAL STRANDS COILED IN SPLICE CLOSURE
	Blue 1	13	COILED IN FIBER OPTIC INTERCONNECT CENTER	NO CONNECTION (LATERAL STRANDS COILED IN SPLICE CLOSURE
	Orange 2	14	COILED IN FIBER OPTIC INTERCONNECT CENTER	NO CONNECTION (LATERAL STRANDS COILED IN SPLICE CLOSURE
	Green 3	15	COILED IN FIBER OPTIC INTERCONNECT CENTER	NO CONNECTION (LATERAL STRANDS COILED IN SPLICE CLOSURE
	Brown 4	16	COILED IN FIBER OPTIC INTERCONNECT CENTER	NO CONNECTION (LATERAL STRANDS COILED IN SPLICE CLOSURE
	Slate 5	17	COILED IN FIBER OPTIC INTERCONNECT CENTER	NO CONNECTION (LATERAL STRANDS COILED IN SPLICE CLOSURE
ORANGE	White 6	18	COILED IN FIBER OPTIC INTERCONNECT CENTER	NO CONNECTION (LATERAL STRANDS COILED IN SPLICE CLOSURE
UNANGE	Red 7	19	COILED IN FIBER OPTIC INTERCONNECT CENTER	NO CONNECTION (LATERAL STRANDS COILED IN SPLICE CLOSURE
	B <b>l</b> ack 8	20	COILED IN FIBER OPTIC INTERCONNECT CENTER	NO CONNECTION (LATERAL STRANDS COILED IN SPLICE CLOSURE
	Yellow 9	21	COILED IN FIBER OPTIC INTERCONNECT CENTER	NO CONNECTION (LATERAL STRANDS COILED IN SPLICE CLOSURE
	Violet 10	22	COILED IN FIBER OPTIC INTERCONNECT CENTER	NO CONNECTION (LATERAL STRANDS COILED IN SPLICE CLOSURE
	Rose 11	23	COILED IN FIBER OPTIC INTERCONNECT CENTER	NO CONNECTION (LATERAL STRANDS COILED IN SPLICE CLOSURE
	Agua 12	24	COILED IN FIBER OPTIC INTERCONNECT CENTER	NO CONNECTION (LATERAL STRANDS COILED IN SPLICE CLOSURE

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PLOT SCALE =	CHECKED -	MJR	REVISED -
PLOT DATE =	DATE -	2/18/2025	REVISED -

FIBER OPTIC LATERAL CABLE SPLICE ASSIGNMENTS							SECTION	COUNTY	TOTAL SHEETS	SHEET NO.
	LCF-N0-002h						2020-263-SUR,SW&TS	DUPAGE	529	452
	LGF=INO=OUZII							CONTRACT	NO. 67	2N33
	SHEET	OF	SHEETS	STA.	TO STA.		ILLINOIS FED. A	ID PROJECT		

ATERAL CABLE	FIBER ASSIC	SNMENTS		ORIGINATION CAB-NO-009		
ATERAL CABLE	DESIGNATIO	N	LCF-NO-002i	DESTINATION CMV-NO-009B		
BUFFER TUBE	FIBER	FIBER NO.	CABINET CONNECTIONS	DISTRIBUTION CABLE CONNECTIONS		
	Blue	1 1	PATCH PANEL "A" PORT 1 (JUMPERED TO LAYER II ETHERNET SWITCH)	DCF-NO-002 (WB), FIBER 19		
	Orange 2	2 2	PATCH PANEL "A" PORT 2 (JUMPERED TO LAYER II ETHERNET SWITCH)	DCF-NO-002 (WB), FIBER 20		
	Green :	3 3	PATCH PANEL "A" PORT 3	NO CONNECTION (LATERAL STRANDS COILED IN SPLICE CLOSURE		
	Brown 4	4 4	PATCH PANEL "A" PORT 4	NO CONNECTION (LATERAL STRANDS COILED IN SPLICE CLOSURE		
	Slate !	5 5	PATCH PANEL "A" PORT 5	NO CONNECTION (LATERAL STRANDS COILED IN SPLICE CLOSURE		
DILLE	White 6	6	PATCH PANEL "A" PORT 6	NO CONNECTION (LATERAL STRANDS COILED IN SPLICE CLOSURE		
BLUE	Red	7 7	PATCH PANEL "A" PORT 7 (JUMPERED TO LAYER II ETHERNET SWITCH)	DCF-NO-002 (EB), FIBER 19		
	Black 8	3 8	PATCH PANEL "A" PORT 8 (JUMPERED TO LAYER II ETHERNET SWITCH)	DCF-NO-002 (EB), FIBER 20		
	Yellow 9	9	PATCH PANEL "A" PORT 9	NO CONNECTION (LATERAL STRANDS COILED IN SPLICE CLOSURE		
	Violet 1	0 10	PATCH PANEL "A" PORT 10	NO CONNECTION (LATERAL STRANDS COILED IN SPLICE CLOSURE		
	Rose 1	1 11	PATCH PANEL "A" PORT 11	NO CONNECTION (LATERAL STRANDS COILED IN SPLICE CLOSURE		
	Aqua 1	2 12	PATCH PANEL "A" PORT 12	NO CONNECTION (LATERAL STRANDS COILED IN SPLICE CLOSURE		
	Blue	1 13	COILED IN FIBER OPTIC INTERCONNECT CENTER	NO CONNECTION (LATERAL STRANDS COILED IN SPLICE CLOSURE		
	Orange 2	2 14	COILED IN FIBER OPTIC INTERCONNECT CENTER	NO CONNECTION (LATERAL STRANDS COILED IN SPLICE CLOSURE		
	Green :	3 15	COILED IN FIBER OPTIC INTERCONNECT CENTER	NO CONNECTION (LATERAL STRANDS COILED IN SPLICE CLOSURE		
	Brown 4	16	COILED IN FIBER OPTIC INTERCONNECT CENTER	NO CONNECTION (LATERAL STRANDS COILED IN SPLICE CLOSURE		
	Slate !	5 17	COILED IN FIBER OPTIC INTERCONNECT CENTER	NO CONNECTION (LATERAL STRANDS COILED IN SPLICE CLOSURE		
ORANGE	White 6	5 18	COILED IN FIBER OPTIC INTERCONNECT CENTER	NO CONNECTION (LATERAL STRANDS COILED IN SPLICE CLOSURE		
ORANGE	Red	7 19	COILED IN FIBER OPTIC INTERCONNECT CENTER	NO CONNECTION (LATERAL STRANDS COILED IN SPLICE CLOSURE		
	Black 8	3 20	COILED IN FIBER OPTIC INTERCONNECT CENTER	NO CONNECTION (LATERAL STRANDS COILED IN SPLICE CLOSURE		
	Yellow 9	9 21	COILED IN FIBER OPTIC INTERCONNECT CENTER	NO CONNECTION (LATERAL STRANDS COILED IN SPLICE CLOSURE		
	Violet 1	0 22	COILED IN FIBER OPTIC INTERCONNECT CENTER	NO CONNECTION (LATERAL STRANDS COILED IN SPLICE CLOSURE		
	Rose 1	1 23	COILED IN FIBER OPTIC INTERCONNECT CENTER	NO CONNECTION (LATERAL STRANDS COILED IN SPLICE CLOSURE		
	Agua 1	2 24	COILED IN FIBER OPTIC INTERCONNECT CENTER	NO CONNECTION (LATERAL STRANDS COILED IN SPLICE CLOSURE		

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PLOT DATE =	DATE -	2/18/2025	REVISED -

FIBER OPTIC LATERAL CABLE SPLICE ASSIGNMENTS							SECTION		COUNTY	TOTAL SHEETS	SHEET NO.
	LCF-NO-002i						2020-263-SUR,SW&	TS	DUPAGE	529	453
LGI -INO-UUZI									CONTRACT	NO. 62	2N33
	SHEET	OF	SHEETS	STA.	TO STA.		ILLINOIS	EED. Al	ID PROJECT		

ATERAL CABLE	FIBER ASSIC	GNMENTS		ORIGINATION CAB-NO-010
ATERAL CABLE	DESIGNATIO	N	LCF-NO-002j	DESTINATION CMV-NO-010
BUFFER TUBE	FIBER	FIBER NO.	CABINET CONNECTIONS	DISTRIBUTION CABLE CONNECTIONS
	Blue	1 1	PATCH PANEL "A" PORT 1 (JUMPERED TO LAYER II ETHERNET SWITCH)	DCF-NO-002 (WB), FIBER 21
	Orange :	2 2	PATCH PANEL "A" PORT 2 (JUMPERED TO LAYER II ETHERNET SWITCH)	DCF-NO-002 (WB), FIBER 22
	Green	3 3	PATCH PANEL "A" PORT 3	NO CONNECTION (LATERAL STRANDS COILED IN SPLICE CLOSURE
	Brown 4	4 4	PATCH PANEL "A" PORT 4	NO CONNECTION (LATERAL STRANDS COILED IN SPLICE CLOSURE
	Slate	5 5	PATCH PANEL "A" PORT 5	NO CONNECTION (LATERAL STRANDS COILED IN SPLICE CLOSURE
DILLE	White	6 6	PATCH PANEL "A" PORT 6	NO CONNECTION (LATERAL STRANDS COILED IN SPLICE CLOSURE
BLUE	Red	7 7	PATCH PANEL "A" PORT 7 (JUMPERED TO LAYER II ETHERNET SWITCH)	DCF-NO-002 (EB), FIBER 21
	Black	8 8	PATCH PANEL "A" PORT 8 (JUMPERED TO LAYER II ETHERNET SWITCH)	DCF-NO-002 (EB), FIBER 22
	Yellow	9 9	PATCH PANEL "A" PORT 9	NO CONNECTION (LATERAL STRANDS COILED IN SPLICE CLOSURE
	Violet 1	.0 10	PATCH PANEL "A" PORT 10	NO CONNECTION (LATERAL STRANDS COILED IN SPLICE CLOSURE
	Rose 1	.1 11	PATCH PANEL "A" PORT 11	NO CONNECTION (LATERAL STRANDS COILED IN SPLICE CLOSURE
	Aqua 1	.2 12	PATCH PANEL "A" PORT 12	NO CONNECTION (LATERAL STRANDS COILED IN SPLICE CLOSURE
	Blue	1 13	COILED IN FIBER OPTIC INTERCONNECT CENTER	NO CONNECTION (LATERAL STRANDS COILED IN SPLICE CLOSURE
	Orange :	2 14	COILED IN FIBER OPTIC INTERCONNECT CENTER	NO CONNECTION (LATERAL STRANDS COILED IN SPLICE CLOSURE
	Green	3 15	COILED IN FIBER OPTIC INTERCONNECT CENTER	NO CONNECTION (LATERAL STRANDS COILED IN SPLICE CLOSURE
	Brown	4 16	COILED IN FIBER OPTIC INTERCONNECT CENTER	NO CONNECTION (LATERAL STRANDS COILED IN SPLICE CLOSURE
	Slate	5 17	COILED IN FIBER OPTIC INTERCONNECT CENTER	NO CONNECTION (LATERAL STRANDS COILED IN SPLICE CLOSURE
ORANGE	White	6 18	COILED IN FIBER OPTIC INTERCONNECT CENTER	NO CONNECTION (LATERAL STRANDS COILED IN SPLICE CLOSURE
ORANGE	Red	7 19	COILED IN FIBER OPTIC INTERCONNECT CENTER	NO CONNECTION (LATERAL STRANDS COILED IN SPLICE CLOSURE
	Black	8 20	COILED IN FIBER OPTIC INTERCONNECT CENTER	NO CONNECTION (LATERAL STRANDS COILED IN SPLICE CLOSURE
	Yellow	9 21	COILED IN FIBER OPTIC INTERCONNECT CENTER	NO CONNECTION (LATERAL STRANDS COILED IN SPLICE CLOSURE
	Violet 1	.0 22	COILED IN FIBER OPTIC INTERCONNECT CENTER	NO CONNECTION (LATERAL STRANDS COILED IN SPLICE CLOSURE
	Rose 1	.1 23	COILED IN FIBER OPTIC INTERCONNECT CENTER	NO CONNECTION (LATERAL STRANDS COILED IN SPLICE CLOSURE
	Aqua 1	.2 24	COILED IN FIBER OPTIC INTERCONNECT CENTER	NO CONNECTION (LATERAL STRANDS COILED IN SPLICE CLOSURE

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5 2623 MANEY-MOTOL AND ASSOCIATES. INC.
4007 MARTICE POLO, SUPE 400

MARRIEWILLE IL (2555)

PHOLE 6250-647-6509

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STATE OF ILLINOIS
DEPARTMENT OF TRANSPORTATION

FIBER OPTIC LATERAL CABLE SPLICE ASSIGNMENTS

LCF-N0-002j

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ATERAL CABLE	FIBER ASSIG	NMENTS		ORIGINATION CAB-NO-010A
LATERAL CABLE DESIGNATION LCF-NO-002k			LCF-NO-002k	DESTINATION CMV-NO-010C
BUFFER TUBE	FIBER	FIBER NO.	CABINET CONNECTIONS	DISTRIBUTION CABLE CONNECTIONS
	Blue 1	1	PATCH PANEL "A" PORT 1 (JUMPERED TO LAYER II ETHERNET SWITCH)	DCF-NO-002 (WB), FIBER 23
	Orange 2	2	PATCH PANEL "A" PORT 2 (JUMPERED TO LAYER II ETHERNET SWITCH)	DCF-NO-002 (WB), FIBER 24
	Green 3	3	PATCH PANEL "A" PORT 3	NO CONNECTION (LATERAL STRANDS COILED IN SPLICE CLOSURE
	Brown 4	4	PATCH PANEL "A" PORT 4	NO CONNECTION (LATERAL STRANDS COILED IN SPLICE CLOSURE
	Slate 5	5	PATCH PANEL "A" PORT 5	NO CONNECTION (LATERAL STRANDS COILED IN SPLICE CLOSURE
BLUE	White 6	6	PATCH PANEL "A" PORT 6	NO CONNECTION (LATERAL STRANDS COILED IN SPLICE CLOSURE
BLUE	Red 7	7	PATCH PANEL "A" PORT 7 (JUMPERED TO LAYER II ETHERNET SWITCH)	DCF-NO-002 (EB), FIBER 23
	Black 8	8	PATCH PANEL "A" PORT 8 (JUMPERED TO LAYER II ETHERNET SWITCH)	DCF-NO-002 (EB), FIBER 24
	Yellow 9	9	PATCH PANEL "A" PORT 9	NO CONNECTION (LATERAL STRANDS COILED IN SPLICE CLOSURE
	Violet 10	10	PATCH PANEL "A" PORT 10	NO CONNECTION (LATERAL STRANDS COILED IN SPLICE CLOSURE
	Rose 1	1 11	PATCH PANEL "A" PORT 11	NO CONNECTION (LATERAL STRANDS COILED IN SPLICE CLOSURE
	Aqua 12	12	PATCH PANEL "A" PORT 12	NO CONNECTION (LATERAL STRANDS COILED IN SPLICE CLOSURE
	Blue 1	13	COILED IN FIBER OPTIC INTERCONNECT CENTER	NO CONNECTION (LATERAL STRANDS COILED IN SPLICE CLOSURE
	Orange 2	14	COILED IN FIBER OPTIC INTERCONNECT CENTER	NO CONNECTION (LATERAL STRANDS COILED IN SPLICE CLOSURE
	Green 3	15	COILED IN FIBER OPTIC INTERCONNECT CENTER	NO CONNECTION (LATERAL STRANDS COILED IN SPLICE CLOSURE
	Brown 4	16	COILED IN FIBER OPTIC INTERCONNECT CENTER	NO CONNECTION (LATERAL STRANDS COILED IN SPLICE CLOSURE
	Slate 5	17	COILED IN FIBER OPTIC INTERCONNECT CENTER	NO CONNECTION (LATERAL STRANDS COILED IN SPLICE CLOSURE
ORANGE	White 6	18	COILED IN FIBER OPTIC INTERCONNECT CENTER	NO CONNECTION (LATERAL STRANDS COILED IN SPLICE CLOSURE
ONANGE	Red 7	19	COILED IN FIBER OPTIC INTERCONNECT CENTER	NO CONNECTION (LATERAL STRANDS COILED IN SPLICE CLOSURE
	Black 8	20	COILED IN FIBER OPTIC INTERCONNECT CENTER	NO CONNECTION (LATERAL STRANDS COILED IN SPLICE CLOSURI
	Yellow 9	21	COILED IN FIBER OPTIC INTERCONNECT CENTER	NO CONNECTION (LATERAL STRANDS COILED IN SPLICE CLOSURI
	Violet 10	22	COILED IN FIBER OPTIC INTERCONNECT CENTER	NO CONNECTION (LATERAL STRANDS COILED IN SPLICE CLOSURE
	Rose 1	1 23	COILED IN FIBER OPTIC INTERCONNECT CENTER	NO CONNECTION (LATERAL STRANDS COILED IN SPLICE CLOSURE
	Aqua 12	2 24	COILED IN FIBER OPTIC INTERCONNECT CENTER	NO CONNECTION (LATERAL STRANDS COILED IN SPLICE CLOSURE

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	DRAWN - JJT	REVISED -
PLOT SCALE =	CHECKED - MJR	REVISED -
PLOT DATE =	DATE - 2/18/2025	REVISED -

FIBEI	R OPTIC L	ATERAL	CABLE S	SPLICE AS	SIGNMENTS	F.A.P. RTE	SECT	ΠΟN		COUNTY	TOTAL SHEETS	SHEET NO.
	LCF-NO-002k				307	2020-263-S	UR,SW&	TS	DUPAGE	529	455	
		LU	1-110-002	2N						CONTRACT	T NO. 62	2N33
	SHEET	OF	SHEETS	STA.	TO STA.			ILLINOIS	FED. A	ID PROJECT		

ATERAL CABLE	FIBER ASSIG	NMENTS		ORIGINATION CAB-NO-011
			LCF-NO-002I	DESTINATION CMV-NO-011B
BUFFER TUBE	FIBER	FIBER NO.	CABINET CONNECTIONS	DISTRIBUTION CABLE CONNECTIONS
DOTTER TOBE	Blue 1	1	PATCH PANEL "A" PORT 1 (JUMPERED TO LAYER II ETHERNET SWITCH)	DCF-NO-002 (WB), FIBER 73
	Orange 2	2	PATCH PANEL "A" PORT 2 (JUMPERED TO LAYER II ETHERNET SWITCH)	DCF-NO-002 (WB), FIBER 74
	Green 3	3	PATCH PANEL "A" PORT 3	NO CONNECTION (LATERAL STRANDS COILED IN SPLICE CLOSURE
	Brown 4	4	PATCH PANEL "A" PORT 4	NO CONNECTION (LATERAL STRANDS COILED IN SPLICE CLOSURE
	Slate 5	5	PATCH PANEL "A" PORT 5	NO CONNECTION (LATERAL STRANDS COILED IN SPLICE CLOSURE
BLUE	White 6	6	PATCH PANEL "A" PORT 6	NO CONNECTION (LATERAL STRANDS COILED IN SPLICE CLOSURE
BLUE	Red 7	7	PATCH PANEL "A" PORT 7 (JUMPERED TO LAYER II ETHERNET SWITCH)	DCF-NO-002 (EB), FIBER 73
	Black 8	8	PATCH PANEL "A" PORT 8 (JUMPERED TO LAYER II ETHERNET SWITCH)	DCF-NO-002 (EB), FIBER 74
	Yellow 9	9	PATCH PANEL "A" PORT 9	NO CONNECTION (LATERAL STRANDS COILED IN SPLICE CLOSURE
	Violet 10	10	PATCH PANEL "A" PORT 10	NO CONNECTION (LATERAL STRANDS COILED IN SPLICE CLOSURE
	Rose 1	11	PATCH PANEL "A" PORT 11	NO CONNECTION (LATERAL STRANDS COILED IN SPLICE CLOSURE
	Aqua 12	2 12	PATCH PANEL "A" PORT 12	NO CONNECTION (LATERAL STRANDS COILED IN SPLICE CLOSURE
	Blue 1	13	COILED IN FIBER OPTIC INTERCONNECT CENTER	NO CONNECTION (LATERAL STRANDS COILED IN SPLICE CLOSURE
	Orange 2	14	COILED IN FIBER OPTIC INTERCONNECT CENTER	NO CONNECTION (LATERAL STRANDS COILED IN SPLICE CLOSURI
	Green 3	15	COILED IN FIBER OPTIC INTERCONNECT CENTER	NO CONNECTION (LATERAL STRANDS COILED IN SPLICE CLOSURE
	Brown 4	16	COILED IN FIBER OPTIC INTERCONNECT CENTER	NO CONNECTION (LATERAL STRANDS COILED IN SPLICE CLOSURE
	Slate 5	17	COILED IN FIBER OPTIC INTERCONNECT CENTER	NO CONNECTION (LATERAL STRANDS COILED IN SPLICE CLOSURE
ORANGE	White 6	18	COILED IN FIBER OPTIC INTERCONNECT CENTER	NO CONNECTION (LATERAL STRANDS COILED IN SPLICE CLOSURE
ONANGE	Red 7	19	COILED IN FIBER OPTIC INTERCONNECT CENTER	NO CONNECTION (LATERAL STRANDS COILED IN SPLICE CLOSURI
	Black 8	20	COILED IN FIBER OPTIC INTERCONNECT CENTER	NO CONNECTION (LATERAL STRANDS COILED IN SPLICE CLOSUR
	Yellow 9	21	COILED IN FIBER OPTIC INTERCONNECT CENTER	NO CONNECTION (LATERAL STRANDS COILED IN SPLICE CLOSURI
	Violet 10	22	COILED IN FIBER OPTIC INTERCONNECT CENTER	NO CONNECTION (LATERAL STRANDS COILED IN SPLICE CLOSURE
	Rose 1	23	COILED IN FIBER OPTIC INTERCONNECT CENTER	NO CONNECTION (LATERAL STRANDS COILED IN SPLICE CLOSURE
	Aqua 12	24	COILED IN FIBER OPTIC INTERCONNECT CENTER	NO CONNECTION (LATERAL STRANDS COILED IN SPLICE CLOSUR

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FIBE	R OPTIC I	LATERAL	CABLE S	SPLICE A	ASSIGNMENTS	F.A.P. RTE	SECT	ION		COUNTY	TOTAL SHEETS	SHEET NO.
		ır	F-NO-00	21		307	2020-263-S	UR,SW&	TS	DUPAGE	529	456
	LGF-NU-UUZI									CONTRACT	NO. 62	2N33
	SHEET	OF	SHEETS	STA.	TO STA.			ILLINOIS	FED. AI	D PROJECT		

ATERAL CABLE	FIBER ASSIGN	MENTS		ORIGINATION CAB-NO-011A
ATERAL CABLE	DESIGNATION		LCF-NO-002m	DESTINATION CMV-NO-011C
BUFFER TUBE	FIBER	FIBER NO	. CABINET CONNECTIONS	DISTRIBUTION CABLE CONNECTIONS
	Blue 1	1	PATCH PANEL "A" PORT 1 (JUMPERED TO LAYER II ETHERNET SWITCH)	DCF-NO-002 (WB), FIBER 25
	Orange 2	2	PATCH PANEL "A" PORT 2 (JUMPERED TO LAYER II ETHERNET SWITCH)	DCF-NO-002 (WB), FIBER 26
	Green 3	3	PATCH PANEL "A" PORT 3	NO CONNECTION (LATERAL STRANDS COILED IN SPLICE CLOSURE
	Brown 4	4	PATCH PANEL "A" PORT 4	NO CONNECTION (LATERAL STRANDS COILED IN SPLICE CLOSURE
	Slate 5	5	PATCH PANEL "A" PORT 5	NO CONNECTION (LATERAL STRANDS COILED IN SPLICE CLOSURE
BLUE	White 6	6	PATCH PANEL "A" PORT 6	NO CONNECTION (LATERAL STRANDS COILED IN SPLICE CLOSURE
BLUE	Red 7	7	PATCH PANEL "A" PORT 7 (JUMPERED TO LAYER II ETHERNET SWITCH)	DCF-NO-002 (EB), FIBER 25
	Black 8	8	PATCH PANEL "A" PORT 8 (JUMPERED TO LAYER II ETHERNET SWITCH)	DCF-NO-002 (EB), FIBER 26
	Yellow 9	9	PATCH PANEL "A" PORT 9	NO CONNECTION (LATERAL STRANDS COILED IN SPLICE CLOSURE
	Violet 10	10	PATCH PANEL "A" PORT 10	NO CONNECTION (LATERAL STRANDS COILED IN SPLICE CLOSURE
	Rose 11	11	PATCH PANEL "A" PORT 11	NO CONNECTION (LATERAL STRANDS COILED IN SPLICE CLOSURE
	Aqua 12	12	PATCH PANEL "A" PORT 12	NO CONNECTION (LATERAL STRANDS COILED IN SPLICE CLOSURE
	Blue 1	13	COILED IN FIBER OPTIC INTERCONNECT CENTER	NO CONNECTION (LATERAL STRANDS COILED IN SPLICE CLOSURE
	Orange 2	14	COILED IN FIBER OPTIC INTERCONNECT CENTER	NO CONNECTION (LATERAL STRANDS COILED IN SPLICE CLOSURE
	Green 3	15	COILED IN FIBER OPTIC INTERCONNECT CENTER	NO CONNECTION (LATERAL STRANDS COILED IN SPLICE CLOSURE
	Brown 4	16	COILED IN FIBER OPTIC INTERCONNECT CENTER	NO CONNECTION (LATERAL STRANDS COILED IN SPLICE CLOSURE
	Slate 5	17	COILED IN FIBER OPTIC INTERCONNECT CENTER	NO CONNECTION (LATERAL STRANDS COILED IN SPLICE CLOSURE
ORANGE	White 6	18	COILED IN FIBER OPTIC INTERCONNECT CENTER	NO CONNECTION (LATERAL STRANDS COILED IN SPLICE CLOSURE
UNANGE	Red 7	19	COILED IN FIBER OPTIC INTERCONNECT CENTER	NO CONNECTION (LATERAL STRANDS COILED IN SPLICE CLOSURE
	B <b>l</b> ack 8	20	COILED IN FIBER OPTIC INTERCONNECT CENTER	NO CONNECTION (LATERAL STRANDS COILED IN SPLICE CLOSURE
	Yellow 9	21	COILED IN FIBER OPTIC INTERCONNECT CENTER	NO CONNECTION (LATERAL STRANDS COILED IN SPLICE CLOSURE
	Violet 10	22	COILED IN FIBER OPTIC INTERCONNECT CENTER	NO CONNECTION (LATERAL STRANDS COILED IN SPLICE CLOSURE
	Rose 11	23	COILED IN FIBER OPTIC INTERCONNECT CENTER	NO CONNECTION (LATERAL STRANDS COILED IN SPLICE CLOSURE
	Aqua 12	24	COILED IN FIBER OPTIC INTERCONNECT CENTER	NO CONNECTION (LATERAL STRANDS COILED IN SPLICE CLOSURE

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PLOT DATE =	DATE -	2/18/2025	REVISED -

						F.A.P. RTE	SECTION	COUNTY	TOTAL SHEETS	SHEET NO.
		I CI	-NO-002	)m		307	2020-263-SUR,SW&TS	DUPAGE	529	457
LGI -IVO-00ZIII							CONTRACT	Γ NO. 62	2N33	
	SHEET	OF	SHEETS	STA.	TO STA.		ILLINOIS FED. A	AID PROJECT		

LATERAL CABLE	FIBER ASSIG	NMENTS		ORIGINATION CAB-NO-011B
LATERAL CABLE DESIGNATION L			LCF-NO-002n	DESTINATION CMV-NO-011F
BUFFER TUBE	FIBER	FIBER NO.	CABINET CONNECTIONS	DISTRIBUTION CABLE CONNECTIONS
JOHNEK TOSE	Blue 1	1	PATCH PANEL "A" PORT 1 (JUMPERED TO LAYER II ETHERNET SWITCH)	DCF-NO-002 (WB), FIBER 27
	Orange 2	2	PATCH PANEL "A" PORT 2 (JUMPERED TO LAYER II ETHERNET SWITCH)	DCF-NO-002 (WB), FIBER 28
	Green 3	3	PATCH PANEL "A" PORT 3	NO CONNECTION (LATERAL STRANDS COILED IN SPLICE CLOSURE
	Brown 4	4	PATCH PANEL "A" PORT 4	NO CONNECTION (LATERAL STRANDS COILED IN SPLICE CLOSURE
	Slate 5	5	PATCH PANEL "A" PORT 5	NO CONNECTION (LATERAL STRANDS COILED IN SPLICE CLOSURE
DLLIE	White 6	6	PATCH PANEL "A" PORT 6	NO CONNECTION (LATERAL STRANDS COILED IN SPLICE CLOSURI
BLUE	Red 7	7	PATCH PANEL "A" PORT 7 (JUMPERED TO LAYER II ETHERNET SWITCH)	DCF-NO-002 (EB), FIBER 27
	Black 8	8	PATCH PANEL "A" PORT 8 (JUMPERED TO LAYER II ETHERNET SWITCH)	DCF-NO-002 (EB), FIBER 28
	Yellow 9	9	PATCH PANEL "A" PORT 9	NO CONNECTION (LATERAL STRANDS COILED IN SPLICE CLOSUR
	Violet 10	10	PATCH PANEL "A" PORT 10	NO CONNECTION (LATERAL STRANDS COILED IN SPLICE CLOSUR
	Rose 13	. 11	PATCH PANEL "A" PORT 11	NO CONNECTION (LATERAL STRANDS COILED IN SPLICE CLOSUR
	Aqua 12	12	PATCH PANEL "A" PORT 12	NO CONNECTION (LATERAL STRANDS COILED IN SPLICE CLOSUR
	Blue 1	13	COILED IN FIBER OPTIC INTERCONNECT CENTER	NO CONNECTION (LATERAL STRANDS COILED IN SPLICE CLOSUR
	Orange 2	14	COILED IN FIBER OPTIC INTERCONNECT CENTER	NO CONNECTION (LATERAL STRANDS COILED IN SPLICE CLOSUR
	Green 3	15	COILED IN FIBER OPTIC INTERCONNECT CENTER	NO CONNECTION (LATERAL STRANDS COILED IN SPLICE CLOSUR
	Brown 4	16	COILED IN FIBER OPTIC INTERCONNECT CENTER	NO CONNECTION (LATERAL STRANDS COILED IN SPLICE CLOSUR
	Slate 5	17	COILED IN FIBER OPTIC INTERCONNECT CENTER	NO CONNECTION (LATERAL STRANDS COILED IN SPLICE CLOSUR
ORANGE	White 6	18	COILED IN FIBER OPTIC INTERCONNECT CENTER	NO CONNECTION (LATERAL STRANDS COILED IN SPLICE CLOSUR
ORANGE	Red 7	19	COILED IN FIBER OPTIC INTERCONNECT CENTER	NO CONNECTION (LATERAL STRANDS COILED IN SPLICE CLOSUR
	Black 8	20	COILED IN FIBER OPTIC INTERCONNECT CENTER	NO CONNECTION (LATERAL STRANDS COILED IN SPLICE CLOSUR
	Yellow 9	21	COILED IN FIBER OPTIC INTERCONNECT CENTER	NO CONNECTION (LATERAL STRANDS COILED IN SPLICE CLOSUR
	Violet 10	22	COILED IN FIBER OPTIC INTERCONNECT CENTER	NO CONNECTION (LATERAL STRANDS COILED IN SPLICE CLOSUR
	Rose 13	. 23	COILED IN FIBER OPTIC INTERCONNECT CENTER	NO CONNECTION (LATERAL STRANDS COILED IN SPLICE CLOSUR
	Aqua 12	24	COILED IN FIBER OPTIC INTERCONNECT CENTER	NO CONNECTION (LATERAL STRANDS COILED IN SPLICE CLOSUR

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FIBER OPTIC LATERAL CABLE SPLICE ASSIGNMENTS						F.A.P. RTE	SEC <sup>-</sup>	ΓΙΟΝ		COUNTY	TOTAL SHEETS	SHEET NO.
	LCF-NO-002n					307	2020-263-S	UR,SW&	TS	DUPAGE	529	458
		LU	1-110-002	411						CONTRACT	NO. 62	2N33
	SHEET	OF	SHEETS	STA.	TO STA.			ILLINOIS	FED. A	D PROJECT		

LATERAL CABLE	FIBER ASSIGN	IMENTS		ORIGINATION CAB-NO-011C	
ATERAL CABLE	DESIGNATION	Į	LCF-NO-002o	DESTINATION CMV-NO-011G	
BUFFER TUBE	FIBER	FIBER NO.	CABINET CONNECTIONS	DISTRIBUTION CABLE CONNECTIONS	
	Blue 1	1	PATCH PANEL "A" PORT 1 (JUMPERED TO LAYER II ETHERNET SWITCH)	DCF-NO-002 (WB), FIBER 29	
	Orange 2	2	PATCH PANEL "A" PORT 2 (JUMPERED TO LAYER II ETHERNET SWITCH)	DCF-NO-002 (WB), FIBER 30	
	Green 3	3	PATCH PANEL "A" PORT 3	NO CONNECTION (LATERAL STRANDS COILED IN SPLICE CLO	SUR
	Brown 4	4	PATCH PANEL "A" PORT 4	NO CONNECTION (LATERAL STRANDS COILED IN SPLICE CLO	SURI
	Slate 5	5	PATCH PANEL "A" PORT 5	NO CONNECTION (LATERAL STRANDS COILED IN SPLICE CLO	SUR
BLUE	White 6	6	PATCH PANEL "A" PORT 6	NO CONNECTION (LATERAL STRANDS COILED IN SPLICE CLO	SUR
BLUE	Red 7	7	PATCH PANEL "A" PORT 7 (JUMPERED TO LAYER II ETHERNET SWITCH)	DCF-NO-002 (EB), FIBER 29	
	Black 8	8	PATCH PANEL "A" PORT 8 (JUMPERED TO LAYER II ETHERNET SWITCH)	DCF-NO-002 (EB), FIBER 30	
	Yellow 9	9	PATCH PANEL "A" PORT 9	NO CONNECTION (LATERAL STRANDS COILED IN SPLICE CLO	SUR
	Violet 10	10	PATCH PANEL "A" PORT 10	NO CONNECTION (LATERAL STRANDS COILED IN SPLICE CLO	SUR
	Rose 11	11	PATCH PANEL "A" PORT 11	NO CONNECTION (LATERAL STRANDS COILED IN SPLICE CLO	SUR
	Aqua 12	12	PATCH PANEL "A" PORT 12	NO CONNECTION (LATERAL STRANDS COILED IN SPLICE CLO	SUR
	Blue 1	13	COILED IN FIBER OPTIC INTERCONNECT CENTER	NO CONNECTION (LATERAL STRANDS COILED IN SPLICE CLO	)SUR
	Orange 2	14	COILED IN FIBER OPTIC INTERCONNECT CENTER	NO CONNECTION (LATERAL STRANDS COILED IN SPLICE CLO	)SUR
	Green 3	15	COILED IN FIBER OPTIC INTERCONNECT CENTER	NO CONNECTION (LATERAL STRANDS COILED IN SPLICE CLO	)SUR
	Brown 4	16	COILED IN FIBER OPTIC INTERCONNECT CENTER	NO CONNECTION (LATERAL STRANDS COILED IN SPLICE CLO	)SUR
	Slate 5	17	COILED IN FIBER OPTIC INTERCONNECT CENTER	NO CONNECTION (LATERAL STRANDS COILED IN SPLICE CLO	SUR
ORANGE	White 6	18	COILED IN FIBER OPTIC INTERCONNECT CENTER	NO CONNECTION (LATERAL STRANDS COILED IN SPLICE CLO	)SUR
ONANGE	Red 7	19	COILED IN FIBER OPTIC INTERCONNECT CENTER	NO CONNECTION (LATERAL STRANDS COILED IN SPLICE CLO	SUR
	Black 8	20	COILED IN FIBER OPTIC INTERCONNECT CENTER	NO CONNECTION (LATERAL STRANDS COILED IN SPLICE CLO	)SUR
	Yellow 9	21	COILED IN FIBER OPTIC INTERCONNECT CENTER	NO CONNECTION (LATERAL STRANDS COILED IN SPLICE CLO	SUR
	Violet 10	22	COILED IN FIBER OPTIC INTERCONNECT CENTER	NO CONNECTION (LATERAL STRANDS COILED IN SPLICE CLO	JSUR
	Rose 11	23	COILED IN FIBER OPTIC INTERCONNECT CENTER	NO CONNECTION (LATERAL STRANDS COILED IN SPLICE CLO	SUR
	Aqua 12	24	COILED IN FIBER OPTIC INTERCONNECT CENTER	NO CONNECTION (LATERAL STRANDS COILED IN SPLICE CLO	)SUR

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FIBER OPTIC LATERAL CABLE SPLICE ASSIGNMENTS						F.A.P. RTE	SEC <sup>-</sup>	ΓΙΟΝ		COUNTY	TOTAL SHEETS	SHEET NO.
	LCF-NO-002o					307	2020-263-SUR,SW&TS			DUPAGE	529	459
	LGF-140-0020									CONTRACT	NO. 62	2N33
	SHEET	OF	SHEETS	STA.	TO STA.			ILLINOIS	FED. A	ID PROJECT		

ATERAL CABLE	FIBER ASSIGN	IMENTS		ORIGINATION CAB-NO-014
LATERAL CABLE DESIGNATION LCF-NO-003g				DESTINATION CMV-NO-014A
BUFFER TUBE	FIBER	FIBER NO.	CABINET CONNECTIONS	DISTRIBUTION CABLE CONNECTIONS
	Blue 1	1	PATCH PANEL "A" PORT 1 (JUMPERED TO LAYER II ETHERNET SWITCH)	DCF-NO-003 (WB), FIBER 23
	Orange 2	2	PATCH PANEL "A" PORT 2 (JUMPERED TO LAYER II ETHERNET SWITCH)	DCF-NO-003 (WB), FIBER 24
	Green 3	3	PATCH PANEL "A" PORT 3	NO CONNECTION (LATERAL STRANDS COILED IN SPLICE CLOSURE
	Brown 4	4	PATCH PANEL "A" PORT 4	NO CONNECTION (LATERAL STRANDS COILED IN SPLICE CLOSURE
	Slate 5	5	PATCH PANEL "A" PORT 5	NO CONNECTION (LATERAL STRANDS COILED IN SPLICE CLOSURE
DILLE	White 6	6	PATCH PANEL "A" PORT 6	NO CONNECTION (LATERAL STRANDS COILED IN SPLICE CLOSURE
BLUE	Red 7	7	PATCH PANEL "A" PORT 7 (JUMPERED TO LAYER II ETHERNET SWITCH)	DCF-NO-003 (EB), FIBER 23
	Black 8	8	PATCH PANEL "A" PORT 8 (JUMPERED TO LAYER II ETHERNET SWITCH)	DCF-NO-003 (EB), FIBER 24
	Yellow 9	9	PATCH PANEL "A" PORT 9	NO CONNECTION (LATERAL STRANDS COILED IN SPLICE CLOSURE
	Violet 10	10	PATCH PANEL "A" PORT 10	NO CONNECTION (LATERAL STRANDS COILED IN SPLICE CLOSURE
	Rose 11	11	PATCH PANEL "A" PORT 11	NO CONNECTION (LATERAL STRANDS COILED IN SPLICE CLOSURE
	Aqua 12	12	PATCH PANEL "A" PORT 12	NO CONNECTION (LATERAL STRANDS COILED IN SPLICE CLOSURE
	Blue 1	13	COILED IN FIBER OPTIC INTERCONNECT CENTER	NO CONNECTION (LATERAL STRANDS COILED IN SPLICE CLOSURE
	Orange 2	14	COILED IN FIBER OPTIC INTERCONNECT CENTER	NO CONNECTION (LATERAL STRANDS COILED IN SPLICE CLOSURE
	Green 3	15	COILED IN FIBER OPTIC INTERCONNECT CENTER	NO CONNECTION (LATERAL STRANDS COILED IN SPLICE CLOSURE
	Brown 4	16	COILED IN FIBER OPTIC INTERCONNECT CENTER	NO CONNECTION (LATERAL STRANDS COILED IN SPLICE CLOSURE
	Slate 5	17	COILED IN FIBER OPTIC INTERCONNECT CENTER	NO CONNECTION (LATERAL STRANDS COILED IN SPLICE CLOSURE
ORANGE	White 6	18	COILED IN FIBER OPTIC INTERCONNECT CENTER	NO CONNECTION (LATERAL STRANDS COILED IN SPLICE CLOSURE
ORANGE	Red 7	19	COILED IN FIBER OPTIC INTERCONNECT CENTER	NO CONNECTION (LATERAL STRANDS COILED IN SPLICE CLOSURE
	B <b>l</b> ack 8	20	COILED IN FIBER OPTIC INTERCONNECT CENTER	NO CONNECTION (LATERAL STRANDS COILED IN SPLICE CLOSURE
	Yellow 9	21	COILED IN FIBER OPTIC INTERCONNECT CENTER	NO CONNECTION (LATERAL STRANDS COILED IN SPLICE CLOSURE
	Violet 10	22	COILED IN FIBER OPTIC INTERCONNECT CENTER	NO CONNECTION (LATERAL STRANDS COILED IN SPLICE CLOSURE
	Rose 11	23	COILED IN FIBER OPTIC INTERCONNECT CENTER	NO CONNECTION (LATERAL STRANDS COILED IN SPLICE CLOSURE
	Aqua 12	24	COILED IN FIBER OPTIC INTERCONNECT CENTER	NO CONNECTION (LATERAL STRANDS COILED IN SPLICE CLOSURE

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PLOT DATE =	DATE -	2/18/2025	REVISED -

FIBE	FIBER OPTIC LATERAL CABLE SPLICE ASSIGNMENTS						SECTION	COUNTY	TOTAL SHEETS	SHEET NO.
LCF-NO-002p					307	2020-263-SUR,SW&TS	DUPAGE	529	460	
	LGF-140-002p							CONTRACT	NO. 62	2N33
	SHEET	OF	SHEETS	STA.	TO STA.		ILLINOIS FED. A	ID PROJECT		

ATERAL CABLE	FIBER ASSIGN	IMENTS		ORIGINATION CAB-NO-012
TERAL CABLE	DESIGNATION		LCF-NO-003a	DESTINATION CMV-NO-012
BUFFER TUBE	FIBER	FIBER NO	. CABINET CONNECTIONS	DISTRIBUTION CABLE CONNECTIONS
	Blue 1	1	PATCH PANEL "A" PORT 1 (JUMPERED TO LAYER II ETHERNET SWITCH)	DCF-NO-003 (WB), FIBER 73
	Orange 2	2	PATCH PANEL "A" PORT 2 (JUMPERED TO LAYER II ETHERNET SWITCH)	DCF-NO-003 (WB), FIBER 74
	Green 3	3	PATCH PANEL "A" PORT 3	NO CONNECTION (LATERAL STRANDS COILED IN SPLICE CLOSURE
	Brown 4	4	PATCH PANEL "A" PORT 4	NO CONNECTION (LATERAL STRANDS COILED IN SPLICE CLOSURE
	Slate 5	5	PATCH PANEL "A" PORT 5	NO CONNECTION (LATERAL STRANDS COILED IN SPLICE CLOSURE
BLUE	White 6	6	PATCH PANEL "A" PORT 6	NO CONNECTION (LATERAL STRANDS COILED IN SPLICE CLOSURE
BLUE	Red 7	7	PATCH PANEL "A" PORT 7 (JUMPERED TO LAYER II ETHERNET SWITCH)	DCF-NO-003 (EB), FIBER 73
	Black 8	8	PATCH PANEL "A" PORT 8 (JUMPERED TO LAYER II ETHERNET SWITCH)	DCF-NO-003 (EB), FIBER 74
	Yellow 9	9	PATCH PANEL "A" PORT 9	NO CONNECTION (LATERAL STRANDS COILED IN SPLICE CLOSURE
	Violet 10	10	PATCH PANEL "A" PORT 10	NO CONNECTION (LATERAL STRANDS COILED IN SPLICE CLOSURE
	Rose 11	11	PATCH PANEL "A" PORT 11	NO CONNECTION (LATERAL STRANDS COILED IN SPLICE CLOSURE
	Aqua 12	12	PATCH PANEL "A" PORT 12	NO CONNECTION (LATERAL STRANDS COILED IN SPLICE CLOSURE
	Blue 1	13	COILED IN FIBER OPTIC INTERCONNECT CENTER	NO CONNECTION (LATERAL STRANDS COILED IN SPLICE CLOSURE
	Orange 2	14	COILED IN FIBER OPTIC INTERCONNECT CENTER	NO CONNECTION (LATERAL STRANDS COILED IN SPLICE CLOSURE
	Green 3	15	COILED IN FIBER OPTIC INTERCONNECT CENTER	NO CONNECTION (LATERAL STRANDS COILED IN SPLICE CLOSURE
	Brown 4	16	COILED IN FIBER OPTIC INTERCONNECT CENTER	NO CONNECTION (LATERAL STRANDS COILED IN SPLICE CLOSURE
	Slate 5	17	COILED IN FIBER OPTIC INTERCONNECT CENTER	NO CONNECTION (LATERAL STRANDS COILED IN SPLICE CLOSURE
ORANGE	White 6	18	COILED IN FIBER OPTIC INTERCONNECT CENTER	NO CONNECTION (LATERAL STRANDS COILED IN SPLICE CLOSURE
ONANGE	Red 7	19	COILED IN FIBER OPTIC INTERCONNECT CENTER	NO CONNECTION (LATERAL STRANDS COILED IN SPLICE CLOSURE
	Black 8	20	COILED IN FIBER OPTIC INTERCONNECT CENTER	NO CONNECTION (LATERAL STRANDS COILED IN SPLICE CLOSURE
	Yellow 9	21	COILED IN FIBER OPTIC INTERCONNECT CENTER	NO CONNECTION (LATERAL STRANDS COILED IN SPLICE CLOSURE
	Violet 10	22	COILED IN FIBER OPTIC INTERCONNECT CENTER	NO CONNECTION (LATERAL STRANDS COILED IN SPLICE CLOSURE
	Rose 11	23	COILED IN FIBER OPTIC INTERCONNECT CENTER	NO CONNECTION (LATERAL STRANDS COILED IN SPLICE CLOSURE
	Aqua 12	24	COILED IN FIBER OPTIC INTERCONNECT CENTER	NO CONNECTION (LATERAL STRANDS COILED IN SPLICE CLOSURE

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FIBER OPTIC LATERAL CABLE SPLICE ASSIGNMENTS						F.A.P. RTE	SECTION		COUNTY	TOTAL SHEETS	SHEET NO.
LCF-NO-003a					307	2020-263-SUR,SW&TS		DUPAGE	529	461	
LGI -IVO-003a								CONTRACT	NO. 62	2N33	
	SHEET	OF	SHEETS	STA.	TO STA.		ILLINOIS F	ED. AID	PROJECT		

ATERAL CABLE	FIBER ASSIGN	IMENTS		ORIGINATION CAB-NO-014C
ATERAL CABLE	DESIGNATION	l	LCF-NO-003j	DESTINATION CMV-NO-014I
BUFFER TUBE	FIBER	FIBER NO.	CABINET CONNECTIONS	DISTRIBUTION CABLE CONNECTIONS
	Blue 1	1	PATCH PANEL "A" PORT 1 (JUMPERED TO LAYER II ETHERNET SWITCH)	DCF-NO-003 (WB), FIBER 75
	Orange 2	2	PATCH PANEL "A" PORT 2 (JUMPERED TO LAYER II ETHERNET SWITCH)	DCF-NO-003 (WB), FIBER 76
	Green 3	3	PATCH PANEL "A" PORT 3	NO CONNECTION (LATERAL STRANDS COILED IN SPLICE CLOSURE
	Brown 4	4	PATCH PANEL "A" PORT 4	NO CONNECTION (LATERAL STRANDS COILED IN SPLICE CLOSURE
	Slate 5	5	PATCH PANEL "A" PORT 5	NO CONNECTION (LATERAL STRANDS COILED IN SPLICE CLOSURE
DLUE	White 6	6	PATCH PANEL "A" PORT 6	NO CONNECTION (LATERAL STRANDS COILED IN SPLICE CLOSURE
BLUE	Red 7	7	PATCH PANEL "A" PORT 7 (JUMPERED TO LAYER II ETHERNET SWITCH)	DCF-NO-003 (EB), FIBER 75
	Black 8	8	PATCH PANEL "A" PORT 8 (JUMPERED TO LAYER II ETHERNET SWITCH)	DCF-NO-003 (EB), FIBER 76
	Yellow 9	9	PATCH PANEL "A" PORT 9	NO CONNECTION (LATERAL STRANDS COILED IN SPLICE CLOSURE
	Violet 10	10	PATCH PANEL "A" PORT 10	NO CONNECTION (LATERAL STRANDS COILED IN SPLICE CLOSURE
	Rose 11	11	PATCH PANEL "A" PORT 11	NO CONNECTION (LATERAL STRANDS COILED IN SPLICE CLOSURE
	Aqua 12	12	PATCH PANEL "A" PORT 12	NO CONNECTION (LATERAL STRANDS COILED IN SPLICE CLOSURE
	Blue 1	13	COILED IN FIBER OPTIC INTERCONNECT CENTER	NO CONNECTION (LATERAL STRANDS COILED IN SPLICE CLOSURE
	Orange 2	14	COILED IN FIBER OPTIC INTERCONNECT CENTER	NO CONNECTION (LATERAL STRANDS COILED IN SPLICE CLOSURE
	Green 3	15	COILED IN FIBER OPTIC INTERCONNECT CENTER	NO CONNECTION (LATERAL STRANDS COILED IN SPLICE CLOSURE
	Brown 4	16	COILED IN FIBER OPTIC INTERCONNECT CENTER	NO CONNECTION (LATERAL STRANDS COILED IN SPLICE CLOSURE
	Slate 5	17	COILED IN FIBER OPTIC INTERCONNECT CENTER	NO CONNECTION (LATERAL STRANDS COILED IN SPLICE CLOSURE
ORANGE	White 6	18	COILED IN FIBER OPTIC INTERCONNECT CENTER	NO CONNECTION (LATERAL STRANDS COILED IN SPLICE CLOSURE
UNANGE	Red 7	19	COILED IN FIBER OPTIC INTERCONNECT CENTER	NO CONNECTION (LATERAL STRANDS COILED IN SPLICE CLOSURE
	B <b>l</b> ack 8	20	COILED IN FIBER OPTIC INTERCONNECT CENTER	NO CONNECTION (LATERAL STRANDS COILED IN SPLICE CLOSURE
	Yellow 9	21	COILED IN FIBER OPTIC INTERCONNECT CENTER	NO CONNECTION (LATERAL STRANDS COILED IN SPLICE CLOSURE
	Violet 10	22	COILED IN FIBER OPTIC INTERCONNECT CENTER	NO CONNECTION (LATERAL STRANDS COILED IN SPLICE CLOSURE
	Rose 11	23	COILED IN FIBER OPTIC INTERCONNECT CENTER	NO CONNECTION (LATERAL STRANDS COILED IN SPLICE CLOSURE
	Agua 12	24	COILED IN FIBER OPTIC INTERCONNECT CENTER	NO CONNECTION (LATERAL STRANDS COILED IN SPLICE CLOSURE

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FIBER OPTIC LATERAL CABLE SPLICE ASSIGNMENTS						F.A.P. RTE	SECTION	COUNTY	TOTAL SHEETS	SHEET NO.
LCF-NO-003i					307	307 2020-263-SUR,SW&TS DUPAGE		529	470	
LGI -140-003j								CONTRACT	NO. 62	2N33
	SHEET	OF	SHEETS	STA.	TO STA.		ILLINOIS FED. A	ID PROJECT		

ATERAL CABLE	FIBER ASSIGN	IMENTS		ORIGINATION CAB-NO-015B
ATERAL CABLE	DESIGNATION		LCF-NO-003m	DESTINATION CMV-NO-015E
BUFFER TUBE	FIBER	FIBER NO.	CABINET CONNECTIONS	DISTRIBUTION CABLE CONNECTIONS
	Blue 1	1	PATCH PANEL "A" PORT 1 (JUMPERED TO LAYER III ETHERNET SWITCH)	DCF-NO-003 (WB), FIBER 33
	Orange 2	2	PATCH PANEL "A" PORT 2 (JUMPERED TO LAYER III ETHERNET SWITCH)	DCF-NO-003 (WB), FIBER 34
	Green 3	3	PATCH PANEL "A" PORT 3	NO CONNECTION (LATERAL STRANDS COILED IN SPLICE CLOSURE
	Brown 4	4	PATCH PANEL "A" PORT 4	NO CONNECTION (LATERAL STRANDS COILED IN SPLICE CLOSURE
	Slate 5	5	PATCH PANEL "A" PORT 5	NO CONNECTION (LATERAL STRANDS COILED IN SPLICE CLOSURE
BLUE	White 6	6	PATCH PANEL "A" PORT 6	NO CONNECTION (LATERAL STRANDS COILED IN SPLICE CLOSURE
BLUE	Red 7	7	PATCH PANEL "A" PORT 7 (JUMPERED TO LAYER III ETHERNET SWITCH)	DCF-NO-003 (EB), FIBER 33
	Black 8	8	PATCH PANEL "A" PORT 8 (JUMPERED TO LAYER III ETHERNET SWITCH)	DCF-NO-003 (EB), FIBER 35
	Yellow 9	9	PATCH PANEL "A" PORT 9	NO CONNECTION (LATERAL STRANDS COILED IN SPLICE CLOSURE
	Violet 10	10	PATCH PANEL "A" PORT 10	NO CONNECTION (LATERAL STRANDS COILED IN SPLICE CLOSURE
	Rose 11	11	PATCH PANEL "A" PORT 11 (JUMPERED TO LAYER III ETHERNET SWITCH)	DCF-NO-003 (WB), FIBER 61
	Aqua 12	12	PATCH PANEL "A" PORT 12 (JUMPERED TO LAYER III ETHERNET SWITCH)	DCF-NO-003 (EB), FIBER 61
	Blue 1	13	COILED IN FIBER OPTIC INTERCONNECT CENTER	NO CONNECTION (LATERAL STRANDS COILED IN SPLICE CLOSURE
	Orange 2	14	COILED IN FIBER OPTIC INTERCONNECT CENTER	NO CONNECTION (LATERAL STRANDS COILED IN SPLICE CLOSURE
	Green 3	15	COILED IN FIBER OPTIC INTERCONNECT CENTER	NO CONNECTION (LATERAL STRANDS COILED IN SPLICE CLOSURE
	Brown 4	16	COILED IN FIBER OPTIC INTERCONNECT CENTER	NO CONNECTION (LATERAL STRANDS COILED IN SPLICE CLOSURE
	Slate 5	17	COILED IN FIBER OPTIC INTERCONNECT CENTER	NO CONNECTION (LATERAL STRANDS COILED IN SPLICE CLOSURE
ORANGE	White 6	18	COILED IN FIBER OPTIC INTERCONNECT CENTER	NO CONNECTION (LATERAL STRANDS COILED IN SPLICE CLOSURE
ONANGE	Red 7	19	COILED IN FIBER OPTIC INTERCONNECT CENTER	NO CONNECTION (LATERAL STRANDS COILED IN SPLICE CLOSURE
	Black 8	20	COILED IN FIBER OPTIC INTERCONNECT CENTER	NO CONNECTION (LATERAL STRANDS COILED IN SPLICE CLOSURE
	Yellow 9	21	COILED IN FIBER OPTIC INTERCONNECT CENTER	NO CONNECTION (LATERAL STRANDS COILED IN SPLICE CLOSURE
	Violet 10	22	COILED IN FIBER OPTIC INTERCONNECT CENTER	NO CONNECTION (LATERAL STRANDS COILED IN SPLICE CLOSURE
	Rose 11	23	COILED IN FIBER OPTIC INTERCONNECT CENTER	NO CONNECTION (LATERAL STRANDS COILED IN SPLICE CLOSURE
	Aqua 12	24	COILED IN FIBER OPTIC INTERCONNECT CENTER	NO CONNECTION (LATERAL STRANDS COILED IN SPLICE CLOSURE

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Kimie	V»» HOTO
1011110	7 '7   1011
	ORN AND ASSOCIATES, INC.
4201 WINFI	ELD ROAD, SUITE 600
WARRE	NVILLE, IL 60555
PHON	E: 630-487-5550

USER NAME =	DESIGNED -	MJR	REVISED - <u>\(\lambda\)</u> 2/18/2025
	DRAWN -	JJT	REVISED -
PLOT SCALE =	CHECKED -	MJR	REVISED -
PLOT DATE =	DATE -	2/18/2025	REVISED -

							F.A.P. SECTION			COUNTY	TOTAL SHEETS	SHEE NO.
		I CE	-NO-003	m		307	2020-263-S	UR,SW8	xTS	DUPAGE	529	473
CONTRACT					NO. 62	2N33						
	SHEET	OF	SHEETS	STA.	TO STA.			ILLINOIS	EED A	ID PROJECT		

ATERAL CABLE	FIBER ASSIG	NMENTS		ORIGINATION CAB-NO-016
ATERAL CABLE	DESIGNATIO	N	LCF-NO-003o	DESTINATION CMV-NO-016A
BUFFER TUBE	FIBER	FIBER NO.	CABINET CONNECTIONS	DISTRIBUTION CABLE CONNECTIONS
	Blue 1	1	PATCH PANEL "A" PORT 1 (JUMPERED TO LAYER II ETHERNET SWITCH)	DCF-NO-003 (WB), FIBER 1
	Orange 2	2	PATCH PANEL "A" PORT 2 (JUMPERED TO LAYER II ETHERNET SWITCH)	DCF-NO-003 (WB), FIBER 2
	Green 3	3	PATCH PANEL "A" PORT 3	NO CONNECTION (LATERAL STRANDS COILED IN SPLICE CLOSURE
	Brown 4	4	PATCH PANEL "A" PORT 4	NO CONNECTION (LATERAL STRANDS COILED IN SPLICE CLOSURE
	Slate 5	5	PATCH PANEL "A" PORT 5	NO CONNECTION (LATERAL STRANDS COILED IN SPLICE CLOSURE
BLUE	White 6	6	PATCH PANEL "A" PORT 6	NO CONNECTION (LATERAL STRANDS COILED IN SPLICE CLOSURE
BLUE	Red 7	7	PATCH PANEL "A" PORT 7 (JUMPERED TO LAYER II ETHERNET SWITCH)	DCF-NO-003 (EB), FIBER 1
	Black 8	8	PATCH PANEL "A" PORT 8 (JUMPERED TO LAYER II ETHERNET SWITCH)	DCF-NO-003 (EB), FIBER 2
	Yellow 9	9	PATCH PANEL "A" PORT 9	NO CONNECTION (LATERAL STRANDS COILED IN SPLICE CLOSURE
	Violet 10	10	PATCH PANEL "A" PORT 10	NO CONNECTION (LATERAL STRANDS COILED IN SPLICE CLOSURE
	Rose 1	1 11	PATCH PANEL "A" PORT 11	NO CONNECTION (LATERAL STRANDS COILED IN SPLICE CLOSURE
	Aqua 12	12	PATCH PANEL "A" PORT 12	NO CONNECTION (LATERAL STRANDS COILED IN SPLICE CLOSURE
	Blue 1	13	COILED IN FIBER OPTIC INTERCONNECT CENTER	NO CONNECTION (LATERAL STRANDS COILED IN SPLICE CLOSURE
	Orange 2	14	COILED IN FIBER OPTIC INTERCONNECT CENTER	NO CONNECTION (LATERAL STRANDS COILED IN SPLICE CLOSURE
	Green 3	15	COILED IN FIBER OPTIC INTERCONNECT CENTER	NO CONNECTION (LATERAL STRANDS COILED IN SPLICE CLOSURE
	Brown 4	16	COILED IN FIBER OPTIC INTERCONNECT CENTER	NO CONNECTION (LATERAL STRANDS COILED IN SPLICE CLOSURE
	Slate 5	17	COILED IN FIBER OPTIC INTERCONNECT CENTER	NO CONNECTION (LATERAL STRANDS COILED IN SPLICE CLOSURE
ORANGE	White 6	18	COILED IN FIBER OPTIC INTERCONNECT CENTER	NO CONNECTION (LATERAL STRANDS COILED IN SPLICE CLOSURE
ONANGE	Red 7	19	COILED IN FIBER OPTIC INTERCONNECT CENTER	NO CONNECTION (LATERAL STRANDS COILED IN SPLICE CLOSURE
	Black 8	20	COILED IN FIBER OPTIC INTERCONNECT CENTER	NO CONNECTION (LATERAL STRANDS COILED IN SPLICE CLOSURI
	Yellow 9	21	COILED IN FIBER OPTIC INTERCONNECT CENTER	NO CONNECTION (LATERAL STRANDS COILED IN SPLICE CLOSURE
	Violet 10	22	COILED IN FIBER OPTIC INTERCONNECT CENTER	NO CONNECTION (LATERAL STRANDS COILED IN SPLICE CLOSURE
	Rose 1	1 23	COILED IN FIBER OPTIC INTERCONNECT CENTER	NO CONNECTION (LATERAL STRANDS COILED IN SPLICE CLOSURE
	Aqua 12	2 24	COILED IN FIBER OPTIC INTERCONNECT CENTER	NO CONNECTION (LATERAL STRANDS COILED IN SPLICE CLOSURI

Kimley»Horn
© 2023 KIMLEY-HORN AND ASSOCIATES, INC.
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PHONE: 630-487-5550

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	DRAWN - JJT	REVISED -
PLOT SCALE =	CHECKED - MJR	REVISED -
PLOT DATE =	DATE - 2/18/2025	REVISED -

FIBER OPTIC LATERAL CABLE SPLICE ASSIGNMENTS					F.A.P. RTE	SECTION	COUNTY	TOTAL SHEETS	SHEET NO.	
LCF-NO-003o				307	2020-263-SUR,SW&TS	DUPAGE	529	475		
FOI -140-0030					CONTRACT NO. 62N33					
	SHEET	OF	SHEETS	STA.	TO STA.		ILLINOIS FED. AID PROJECT			