### 03-07-2025 LETTING ITEM 090

### INDEX OF SHEETS

- L COVER SHEET
- 2 HIGHWAY STANDARD AND GENERAL NOTES
- 3-4 SUMMARY OF QUANTITIES
- 5 TYPICAL SECTION
- 6 SITE PLAN
- 7-9 ITS PLAN
- 10 21 WEIGH IN MOTION DETAILS
- 22 ELECTRIC SERVICE METER DETAIL
- 23 DISTRICT 6 DETAILS

# STATE OF ILLINOIS DEPARTMENT OF TRANSPORTATION

### PROPOSED HIGHWAY PLANS

FAI ROUTE 72 (I-72)
SECTION 75-4WS
PROJECT NHPP-E2CV(129)
VIRTUAL WEIGH STATION
PIKE COUNTY

C-96-052-24

### DESIGN DESIGNATION INTERSTATE


### TRAFFIC DATA

**EXISTING AADT: 8,850 (2023)** 

% PV = 61 % SU = 4

% MU = 35

DESIGN SPEED: 70 MPH POSTED SPEED: 70 MPH

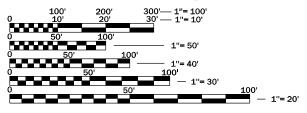

FULL SIZE PLANS HAVE BEEN PREPARED USING STANDARD ENGINEERING SCALES. REDUCED SIZED PLANS WILL NOT CONFORM TO STANDARD SCALES. IN MAKING MEASUREMENTS ON REDUCED PLANS, THE ABOVE SCALES MAY BE USED.


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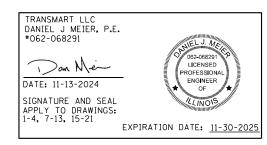
JOINT UTILITY LOCATION INFORMATION FOR EXCAVATION 1-800-892-0123


PROJECT ENGINEER: KEITH DONOVAN (217) 782–8414 CONTRACT NO. 72736




GROSS LENGTH = 2,780 FT. = 0.527 MILES

NET LENGTH = 300 FT. = 0.057 MILES

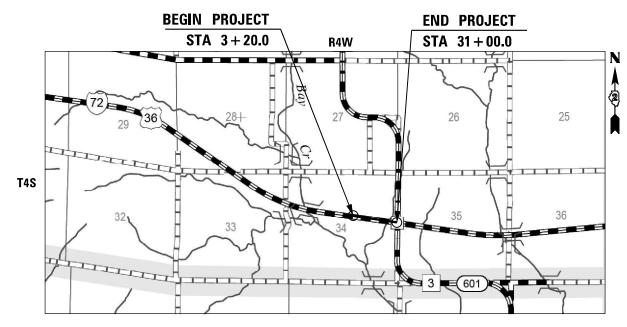

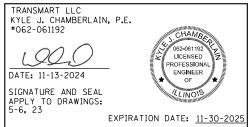

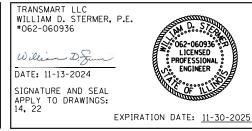


#### D-96-033-24



SEDABED BV.



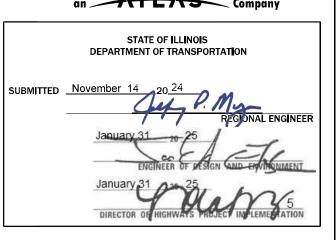

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REV - MS

### **HIGHWAY STANDARDS**

STANDARD SYMBOLS, ABBREVIATIONS AND PATTERNS 000001-08 AREAS OF REINFORCEMENT BARS 001001-02 001006 DECIMAL OF AN INCH AND OF A FOOT 420001-10 PAVEMENT JOINTS 420701-03 PAVEMENT WELDED WIRE REINFORCEMENT 442101-09 CLASS B PATCHES 601001-05 PIPE UNDERDRAIN 642001-03 SHOULDER RUMBLE STRIPS, 16" 701001-02 OFF-RD OPERATIONS, 2L, 2W, MORE THAN 15' AWAY 701006-05 OFF-RD OPERATIONS, 2L, 2W, 15' TO 24" FROM PAVEMENT EDGE 701101-05 OFF-RD OPERATIONS, MULTILANE, 15' TO 24' FROM PAVEMENT EDGE OFF-RD OPERATIONS, MULTILANE, MORE THAN 15' AWAY 701106-02 APPROACH TO LANE CLOSURE, FREEWAY/EXPRESSWAY 701400-12 701401-13 LANE CLOSURE, FREEWAY/EXPRESSWAY LANE CLOSURE, MULTILANE, INTERMITTENT OR MOVING OPERATIONS 701426-09 FOR SPEEDS >=45 MPH 701901<del>-</del>10 TRAFFIC CONTROL DEVICES 780001-05 TYPICAL PAVEMENT MARKINGS ELECTRICAL SERVICE INSTALLATION DETAILS 805001-01 814001-03 HANDHOLES

### **GENERAL NOTES**

- 1. THE CONTRACTOR SHALL SEED ALL DISTRUBED AREAS WITHIN THE PROJECT LIMITS. SEEDING CLASS 2A SHALL BE USED ON FRONT SLOPES AND DITCH BOTTOMS. THIS WORK SHALL BE CONSIDERED AS INCLUDED IN THE COST OF THE CONTRACT.
- THE CONTRACTOR SHALL NOTIFY THE DISTRICT 6 BUREAU OF OPERATIONS, (217) 785-5306, AT LEAST 72 HOURS IN ADVANCE OF BEGINNING WORK AND THREE WEEKS PRIOR TO IMPLEMENTING ANY TRAFFIC CONTROL.
- 3. CONDUIT, HANDHOLES, FOUNDATIONS, AND ALL OTHER ITS ELEMTNS SHALL NOT BE PLACED IN THE DITCHLINE OR A DRAINAGE/WATER COLLECTION AREA.
- 4. WELDED WIRE REINFORCEMENT WILL NOT BE REQUIRED IN CONSTRUCTING THE CLASS B PATCHING, TYPE IV.

### **COMMITMENTS**

NONE

# STATE OF ILLINOIS DEPARTMENT OF TRANSPORTATION DIVISION OF HIGHWAYS DISTRICT 6

EXAMINED November 14 20 24

ENGINEER OF OPERATIONS

EXAMINED November 14 20 24

ENGINEER OF PROJECT IMPLEMENTATION

EXAMINED November 14 20 24

ENGINEER OF PROGRAM DEVELOPMENT

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	PLOT DATE = 11/12/2024	DATE - 11/13/2024	REVISED -

SCALE: NONE

PPS #0-02117-6001

CONST. CODE 90% FED 10% STATE

				ROADWAY
CODE NO.		UNIT	TOTAL QUANTITY	0044
NO.	ITEM		QUANTITY	RURAL
20201200	REMOVAL AND DISPOSAL OF UNSUITABLE MATERIAL	CU YD	305	305
35102000	AGGREGATE BASE COURSE, TYPE B 8"	SQ YD	534	534
44004250	PAVED SHOULDER REMOVAL	SQ YD	534	534
44200988	CLASS B PATCHES, TYPE IV, 11 INCH	SQ YD	800	800
44201299	DOWEL BARS 1 1/2"	EACH	360	360
44213200	SAW CUTS	FOOT	80	80
44213200	JAW CUIS	1001	00	80
44213204	TIE BARS 3/4"	EACH	300	300
48102100	AGGREGATE WEDGE SHOULDER, TYPE B	TON	115	115
48300600	PORTLAND CEMENT CONCRETE SHOULDERS 11"	SQ YD	534	534
60108104	PIPE UNDERDRAINS, TYPE 1, 4"	FOOT	600	600
64200116	SHOULDER RUMBLE STRIPS, 16 INCH	FOOT	600	600
67000400	ENGINEER'S FIELD OFFICE, TYPE A	CAL MO	4	4
67100100	MOBILIZATION	L SUM	1	1
70100800	TRAFFIC CONTROL AND PROTECTION, STANDARD 701401	L SUM	1	1

\* = SPECIALTY ITEM

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PPS #0-02117-6001

CONST. CODE

90% FED 10% STATE

					ROADWAY
	CODE NO.	ITEM	UNIT	TOTAL	0044
	NO.	I I EIVI	UNII	QUANTITY	RURAL
	70107025	CHANGEABLE MESSAGE SIGN	CAL DA	14	14
*	78009005	MODIFIED URETHANE PAVEMENT MARKING - LINE 5"	FOOT	675	675
*	78011030	GROOVING FOR RECESSED PAVEMENT MARKING 6"	FOOT	675	675
	81028250	UNDERGROUND CONDUIT, GALVANIZED STEEL, 5" DIA.	FOOT	395	395
	81028750	UNDERGROUND CONDUIT, COILABLE NONMETALLIC CONDUIT, 2" DIA.	FOOT	2,982	2,982
	81400200	HEAVY-DUTY HANDHOLE	EACH	10	10
	81702120	ELECTRIC CABLE IN CONDUIT, 600V (XLP-TYPE USE) 1/C NO. 8	FOOT	3,019	3,019
	81702140	ELECTRIC CABLE IN CONDUIT, 600V (XLP-TYPE USE) 1/C NO. 4	FOOT	9,057	9,057
			f:		
	X4202010	PROFILE DIAMOND GRINDING CONCRETE PAVEMENT	SQ YD	800	800
				3	
	X8050115	SERVICE INSTALLATION, TYPE A (MODIFIED)	EACH	1	1
	Z0026290	FURNISHING AND INSTALLING WEIGH-IN- MOTION COMPONENTS	L SUM	1	1
	Z0040530	PIPE UNDERDRAIN REMOVAL	FOOT	600	600
Ø	Z0076600	TRAINEES	HOUR	500	500
					i i
Ø	Z0076604	TRAINEES TRAINING PROGRAM GRADUATE	HOUR	500	500
					-
*	SPECIAL	TY ITEM Ø 0042			

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\* SPECIALTY ITEM

Ø 0042

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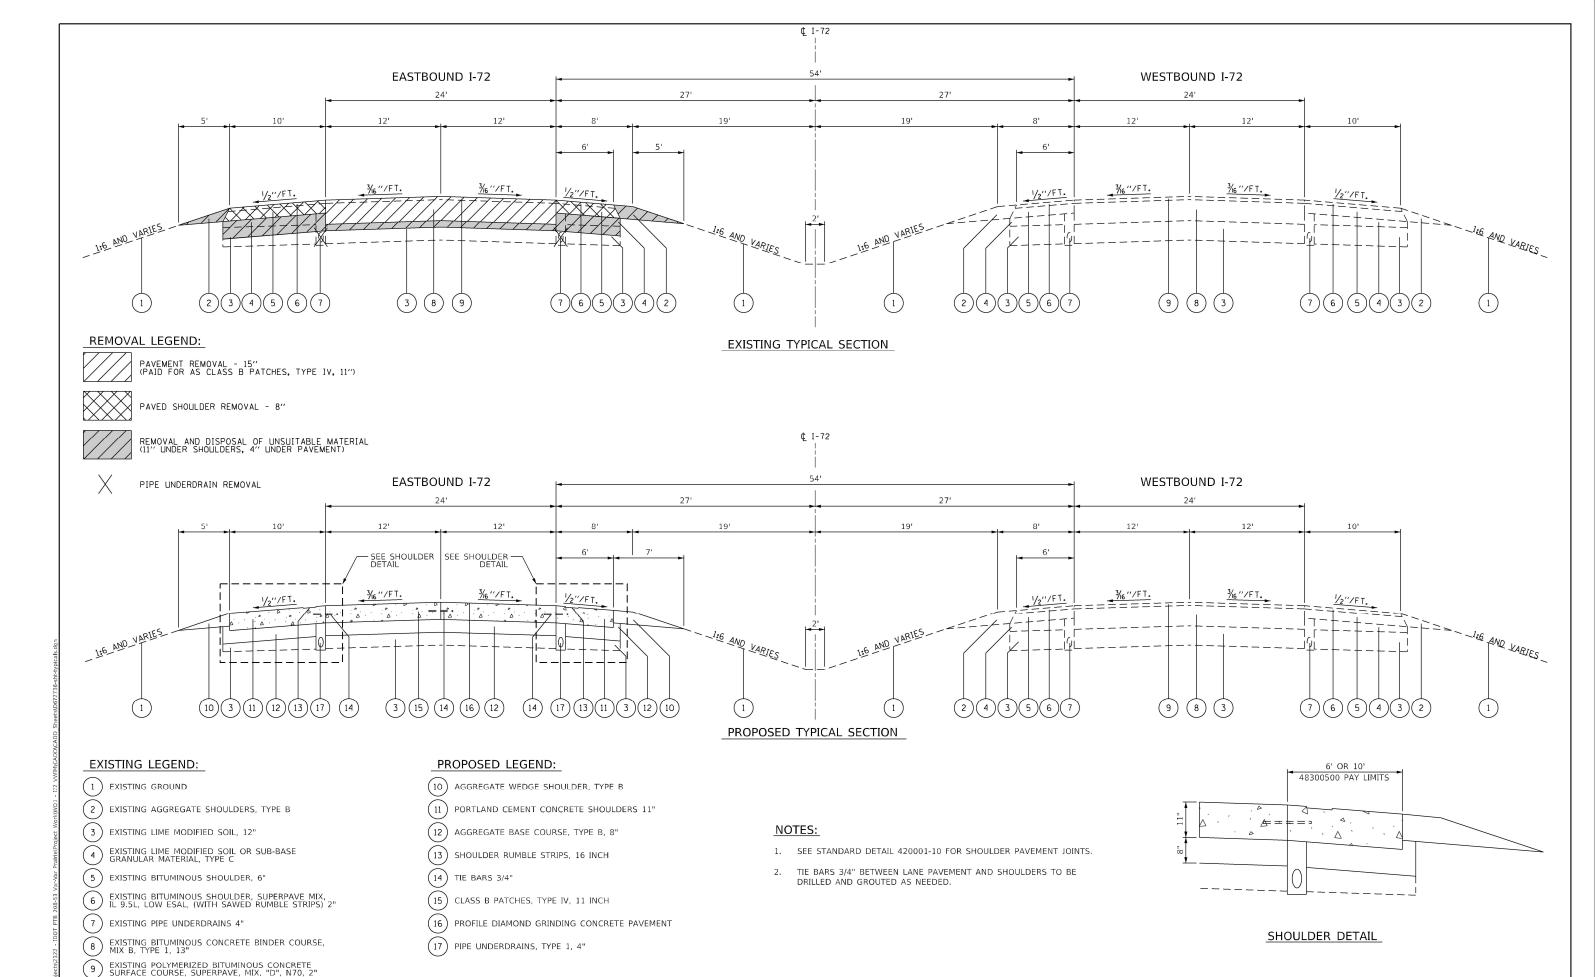
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Suite 400
Chicago, IL 60606

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	su	FAI ROU IMMARY			
SCALE: NONE	SHEET 2	OF 2	SHEETS	STA.	TO STA.

SECTION	COUNTY	TOTAL SHEETS	SHEET NO.
75-4WS	PIKE	23	4
	CONTRACT	NO.72	736
ILLINOIS FED. A	ID PROJECT		

\* = SPECIALTY ITEM




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Chicago, IL 60606


STATE OF ILLINOIS
DEPARTMENT OF TRANSPORTATION

SCALE: N.T.S.

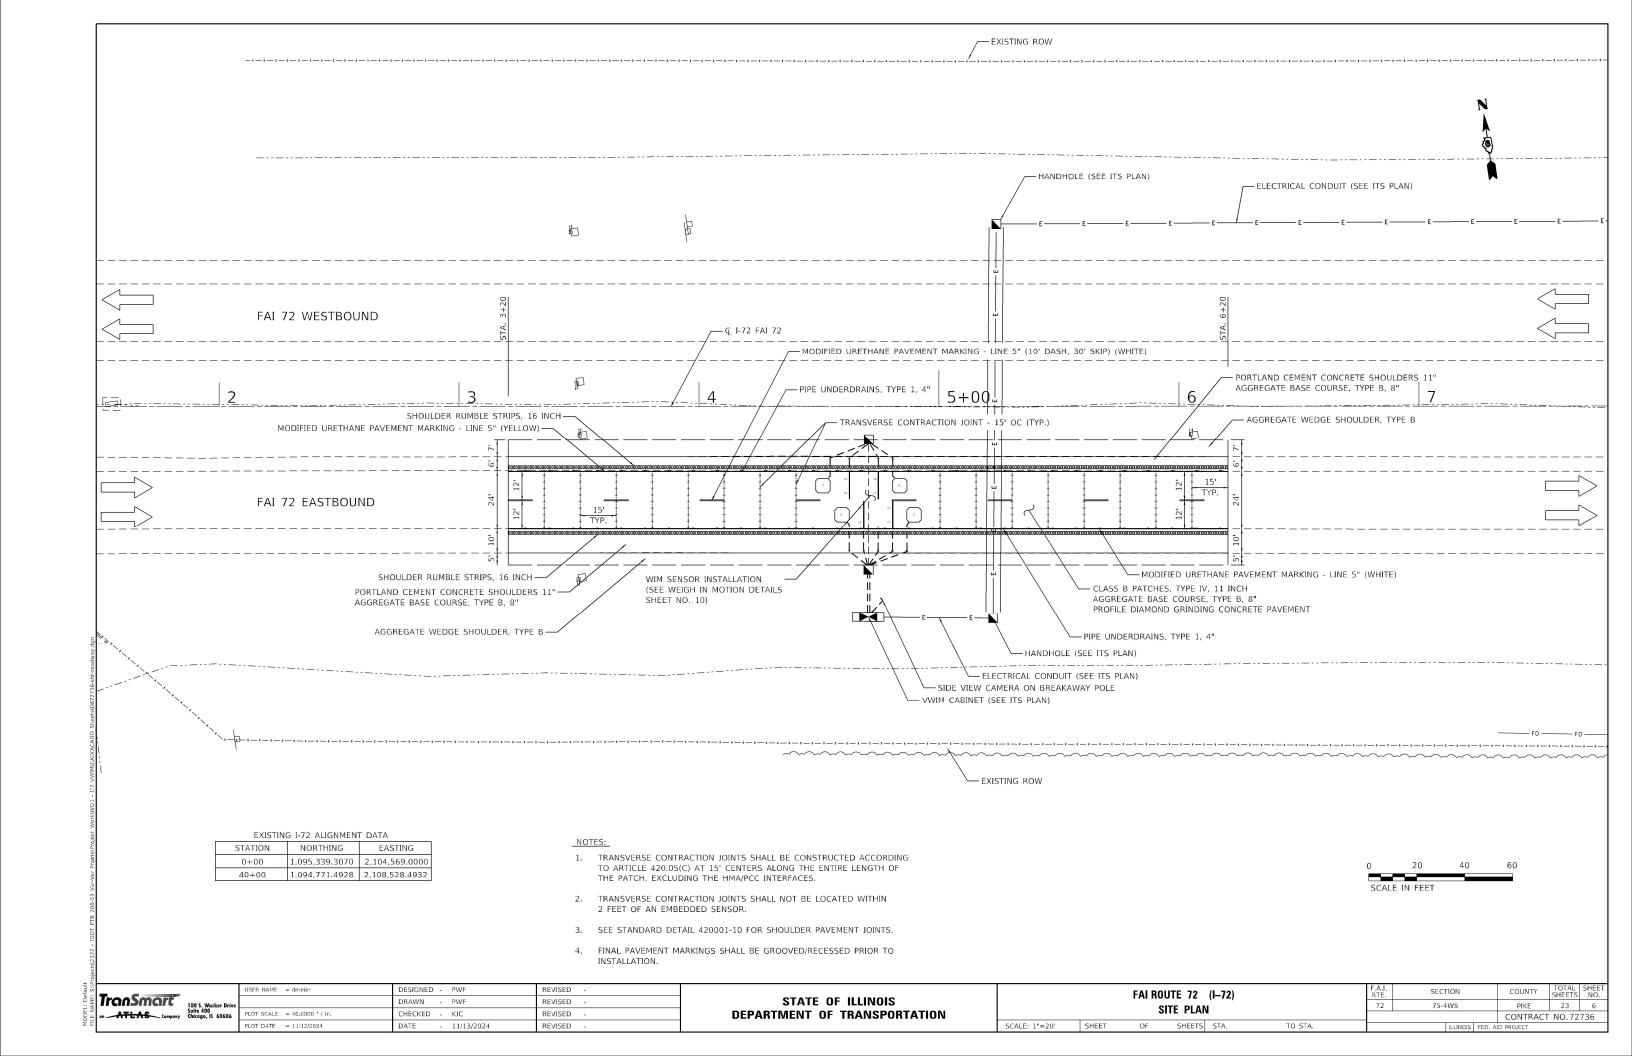

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Chicago, IL 60606

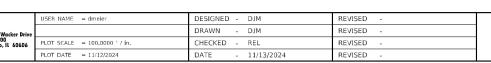

STATE OF ILLINOIS **DEPARTMENT OF TRANSPORTATION** 

SECTION FAI ROUTE 72 (I-72) PIKE 23 7 75-4WS ITS PLANS CONTRACT NO.72736 SCALE: 1" = 50' SHEET 1 OF 3 SHEETS STA. 0+00 TO STA. 13+00

276' - (1) 2" CNC CONDUIT (81028750) -(3) 1/C #4 XLP-TYPE USE (81702140) HDHH (81400200) STA 5+23 -500' - (1) 2" CNC CONDUIT (81028750) -(3) 1/C #4 XLP-TYPE USE (81702140) -(1) 1/C #8 XLP-TYPE USE (GRD) (81702120) -(1) 1/C #8 XLP-TYPE USE (GRD) (81702120) 164' - (1) 5" GALV STEEL CONDUIT (81028250) -(1) 2" CNC CONDUIT (81028750) -(3) 1/C #4 XLP-TYPE USE (81702150) -(1) 1/C #8 XLP-TYPE USE (GRD) (81702130) 12 00+02+ I-72 WB STA 4+70 5#00 10+00 0+00I-72 EB HDHH (8140020 STA 4+70 HDHH (81400200) STA 5+23 -52' - (1) 2" CNC CONDUIT (81028750) -(3) 1/C #4 XLP-TYPE USE (81702140) -(1) 1/C #8 XLP-TYPE USE (GRD) (81702120) VWIM 334 CABINET (Z0026290)

- 1. THE EDGE OF THE CABINET SHALL BE PLACED A MINIMUM OF 35' FROM THE EDGE OF THE TRAVELED WAY.
- 2. FOR VWIM DETAILS, SEE SHEETS 10 TO 21
- 3. INSTALL HANDHOLES/CONDUIT BETWEEN 10' AND 15' FROM EDGE OF SHOULDER, UNLESS OBSTRUCTION IS ENCOUNTERED, TYP.



NOTES

1. INSTALL HANDHOLES/CONDUIT BETWEEN 10' AND 15' FROM EDGE OF SHOULDER, UNLESS OBSTRUCTION IS ENCOUNTERED, TYP.

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Chicago, IL 6060

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STATE	: OI	F ILLINOIS
DEPARTMENT	OF	TRANSPORTATION

						F.A.I. RTE.	SECTION	COUNTY	TOTAL SHEETS	SHEET NO.
ITS PLANS					72	75-4WS	PIKE	23	8	
II TEANS							CONTRACT	NO.72	736	
SCALE: 1" = 50' SHEET 2 OF 3 SHEETS STA. 13+00 TO STA. 26+00					ILLINOIS FEE	. AID PROJECT				

SCALE IN FEET ELECTRIC SERVICE INSTALLATION TYPE A (MODIFIED) (X8050115) UTILITY POLE (E) 135' - (1) 2" CNC CONDUIT (81028750) -(3) 1/C #4 XLP-TYPE USE (81702140) UTILITY POLE (E) -(3) 1/C #4 XLP-TYPE USE (6RD) (81702120) -(1) 1/C #8 XLP-TYPE USE (6RD) (81702120) SERVICE (E) 131' - (1) 5" GALV STEEL CONDUIT (81028250) -(1) 2" CNC CONDUIT (81028750) -(3) 1/C #4 XLP-TYPE USE (\$1702140) -(1) 1/C #8 XLP-TYPE USE (\$RD) (81702120) 135' - (1) 2" CNC CONDUIT (81028750) -(3) 1/C #4 XLP-TYPE USE (81702140) -(1) 1/C #8 XLP-TYPE USE (GRD) (81702120) LEE HDHH (81400200) STA 30+54 100' - (1) 5" GALV STEEL CONDUIT (81028250) - (1) 2" CNC CONDUIT (81028750) - (3) 1/C #4 XLP-TYPE USE (81702140) -(1) 1/C #8 XLP-TYPE USE (GRD) (81702120) 403 MATCHLINE CONB STA 5+00
RAMP TO 1-72 WB 405 250' - (1) 2" CNC CONDUIT (81028750) -(3) 1/C #4 XLP-TYPE USE (81702150) -(1) 1/C #8 XLP-TYPE USE (GRD) (81702130) 401== 39+00 I-72 WB 27 28 29 I-72 EB 399

> NOTES 1. INSTALL HANDHOLES/CONDUIT BETWEEN 10' AND 15' FROM EDGE OF SHOULDER, UNLESS OBSTRUCTION IS ENCOUNTERED, TYP.

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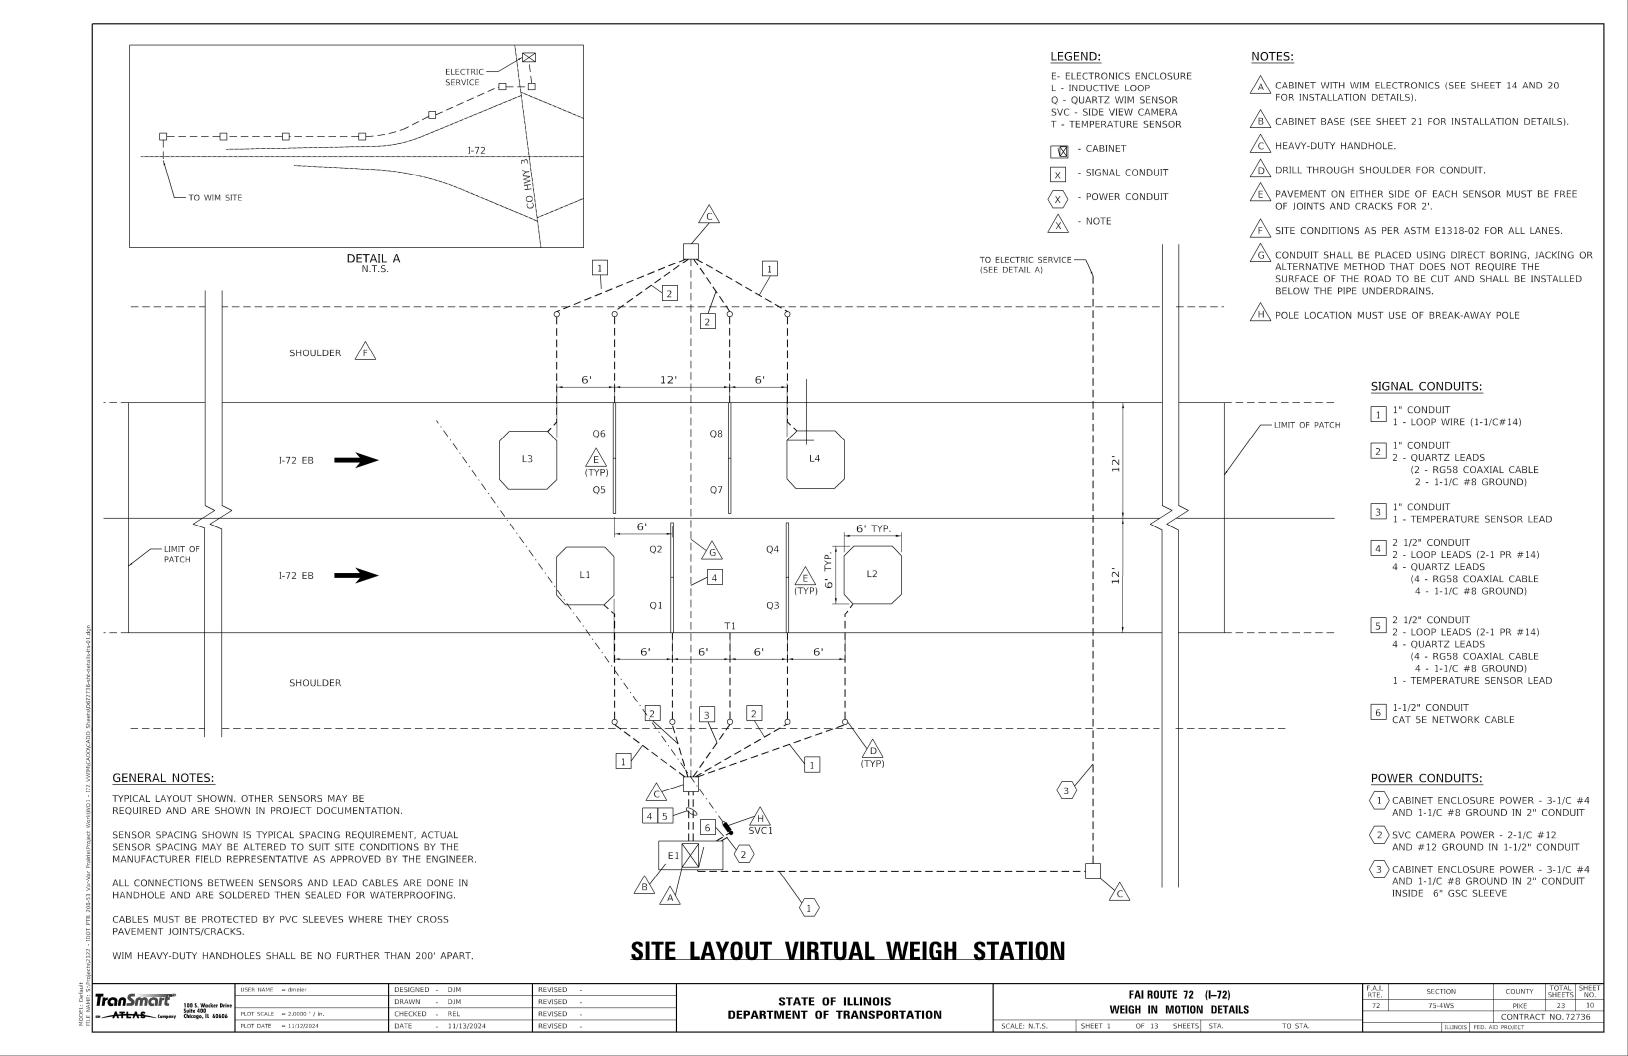
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chicago, il 60606


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STATE OF ILLINOIS **DEPARTMENT OF TRANSPORTATION** 

SECTION FAI ROUTE 72 (I-72) 75-4WS ITS PLANS SCALE: 1" = 50' SHEET 3 OF 3 SHEETS STA. 26+00 TO STA. 32+80

COUNTY PIKE 23 9 CONTRACT NO.72736



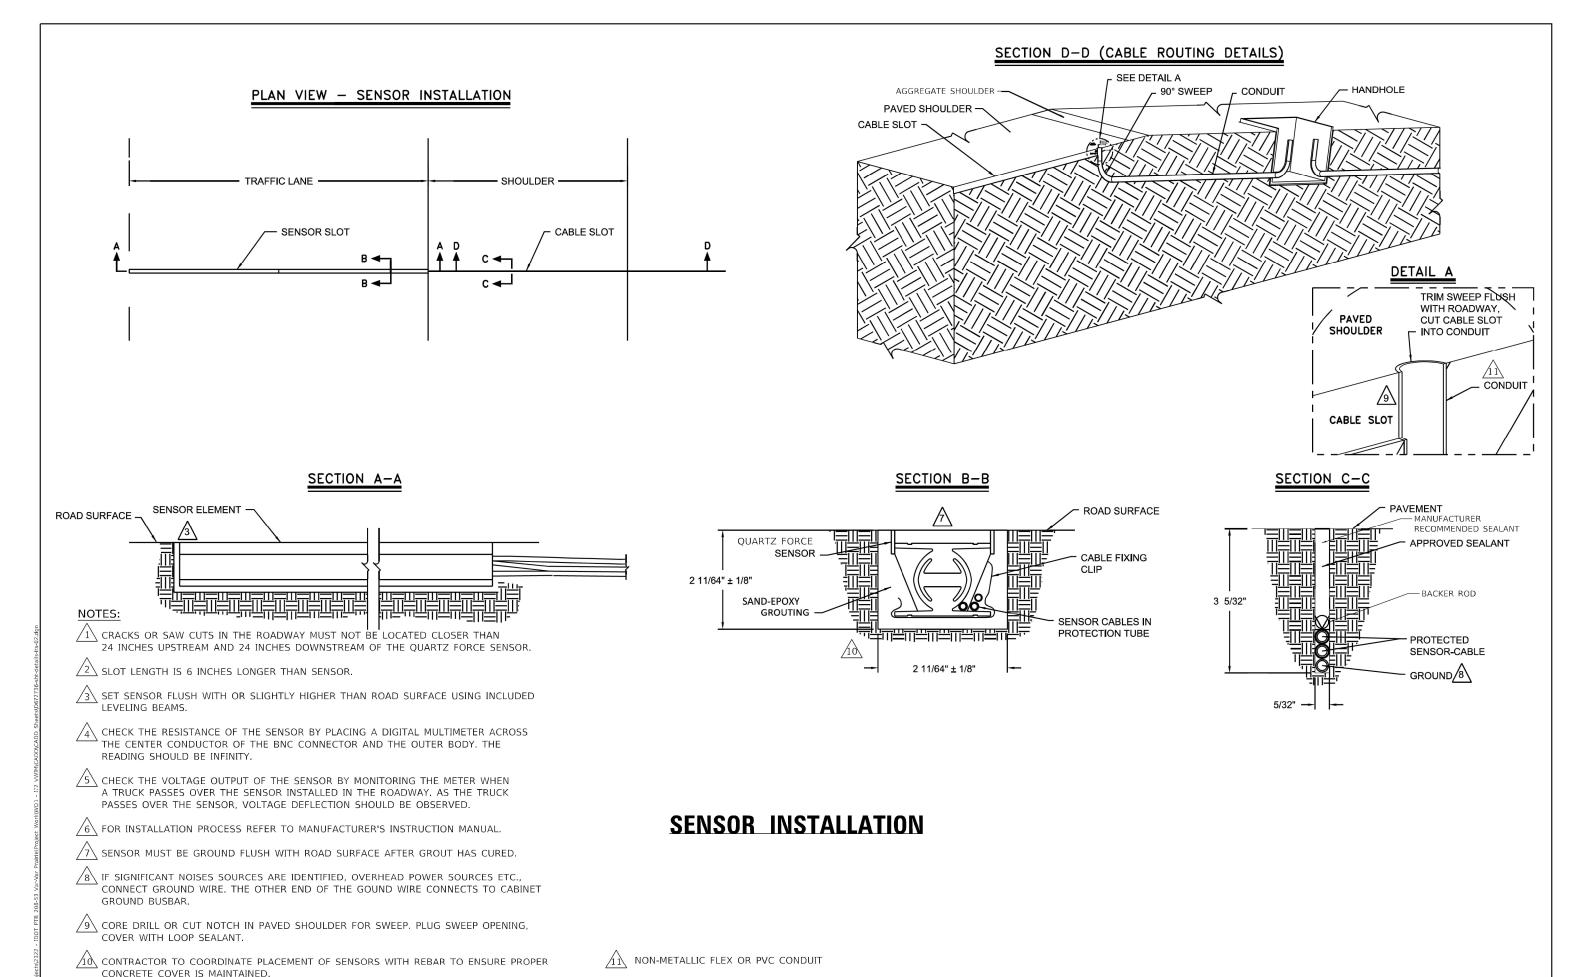

STATE OF ILLINOIS

**DEPARTMENT OF TRANSPORTATION** 

SECTION

75-4WS

PIKE

23

CONTRACT NO. 72736

FAI ROUTE 72 (I-72)

WEIGH IN MOTION DETAILS

TO STA.

OF 13 SHEETS STA.

SCALE: N.T.S.

SHEET 2

TranSmart"

100 S. Wacker Drive Suite 400 Chicago, IL 60606

PLOT DATE = 11/12/2024

DESIGNED - DJM

DRAWN - DJM

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- 11/13/2024

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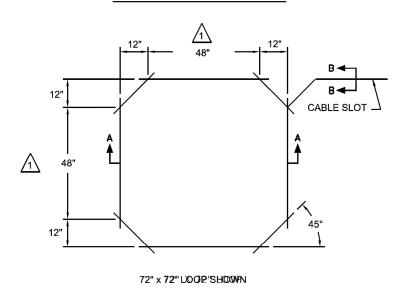
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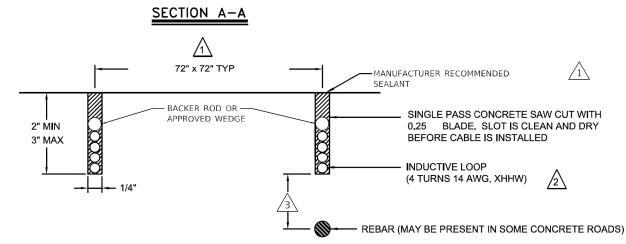
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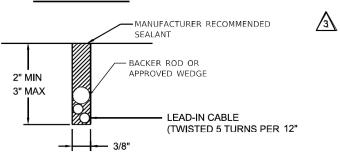
# AGGREGATE SHOULDER PAVED SHOULDER CABLE SLOT PAVED TRIM SWEEP FLUSH WITH RDADWAY, CUT CABLE SLOT PAVED SHOULDER PAVED SHOULDER CABLE SLOT CONDUIT A CABLE SLOT

### LOOP DIMENSION DETAIL





### SECTION B-B



 $\sqrt{1}$  USE CAULKING GUN PER MANUFACTURER'S SPECIFICATIONS.

2 LOOP INSTALLATION PER MANUFACTURER'S MANUALS - PERMANENT OCTAGON LOOPS.

IF LOOP IS INSTALLED OVER REBAR, THERE MUST BE A MINIMUM OF 2 INCHES OF CONCRETE BELOW AND A MINIMUM OF 1 INCH OF FILL ABOVE THE WIRES. CONTRACTOR TO COORDINATE PLACEMENT OF LOOPS WITH REBAR TO ENSURE PROPER CONCRETE COVER IS MAINTAINED.

4 CORE DRILL OR CUT NOTCH IN PAVED SHOULDER FOR SWEEP. PLUG SWEEP OPENING, COVER WITH LOOP SEALANT.

5 NON-METALLIC FLEX OR PVC CONDUIT.

### **DETECTION LOOP INSTALLATION**


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STATE OF ILLINOIS
DEPARTMENT OF TRANSPORTATION

FAI ROUTE 72 (I–72)		F.A.I. RTE.	SECTION	COUNTY	TOTAL SHEETS	SHEET NO.	
WEIGH IN MOTION DETA	II ¢	72	75-4WS	PIKE	23	12	
WEIGHT IN MOTION BETA	ILU			CONTRAC	T NO.72	736	
HEET 3 OF 13 SHEETS STA.	TO STA.		TILLINOIS FED. A	ID PROJECT	200		




### **IN-ROADWAY TEMPERATURE SENSOR** ONE DRILL OR CUT NOTCH IN PAVED SHOULDER FOR SWEEP. PLUG SWEEP OPENING,


COVER WITH LOOP SEALANT.

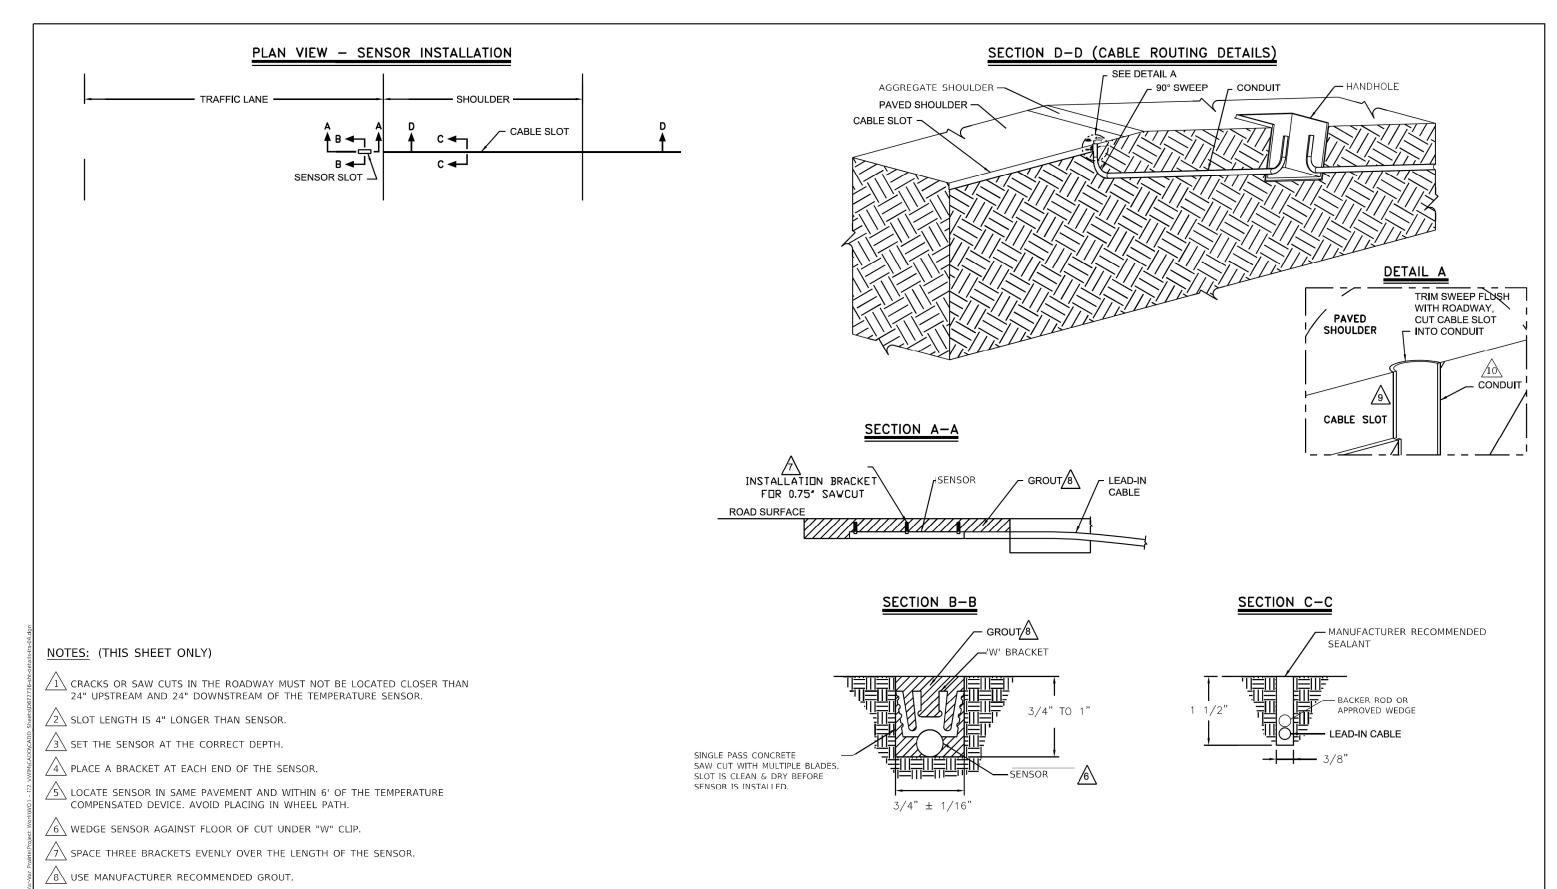NON-METALLIC FLEX OR PVC CONDUIT.

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	FAI RO	UTE 72	(I–72)		F.A.I. RTE.	SECTION		COUNTY	TOTAL SHEETS	
WEIGH IN MOTION DETAILS			72	75-4WS		PIKE	23	13		
						CONTRACT	NO.72	736		
SHEET 4	OF 13	SHEETS	STA.	TO STA.		ILLINOIS	FED. All	D PROJECT		



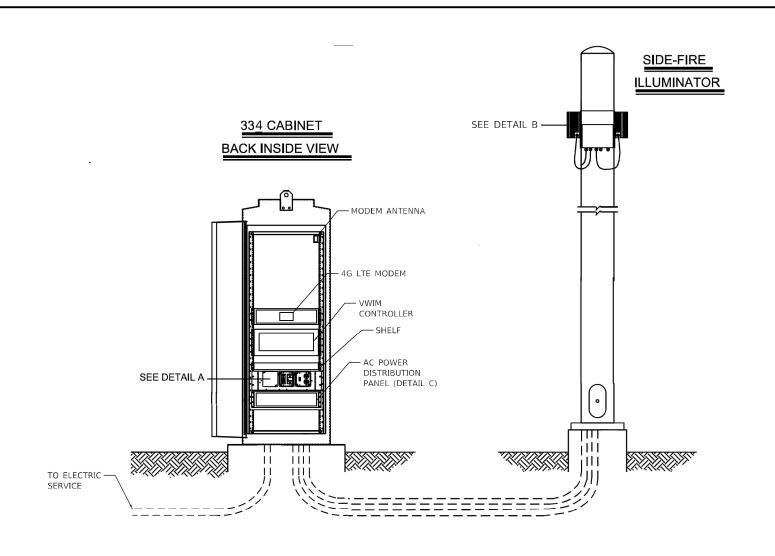
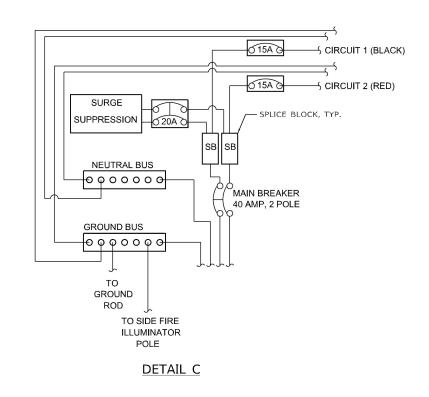
### NOTES:

ALL ELECTRICAL DEVICES, GROUNDING, BONDING, WIRING AND MOUNTING MUST MEET THE NATIONAL ELECTRICAL CODE NFPA70 AND LOCAL ELECTRICAL CODE.

EQUIPMENT MUST BE PROTECTED WITH AN ANSI/IEEE C62.41 CATEGORY C RATED PROTECTION DEVICE WITH A MINIMUM PEAK CURRENT HANDLING CAPABILITY OF 36KA (8/20 S) INSTALLED AT THE LOAD CENTER OR SUB LOAD CENTER.

# PAD MOUNT ENCLOSURE AC DISTRIBUTION SCHEMATIC 120VAC/60Hz 15A CIRCUIT 1 BLACK/WHITE/GREEN DUPLEX DUPLEX CIRCUIT 2 RED/WHITE/GREEN DUPLEX DUPLEX

# 120VAC CABINET POWER INSTALLATION AND LOAD CENTER DETAIL

Transmart 1000 Suit Chic Chic
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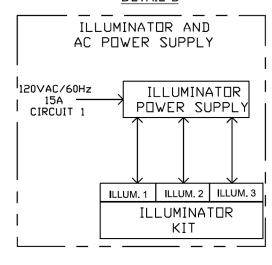
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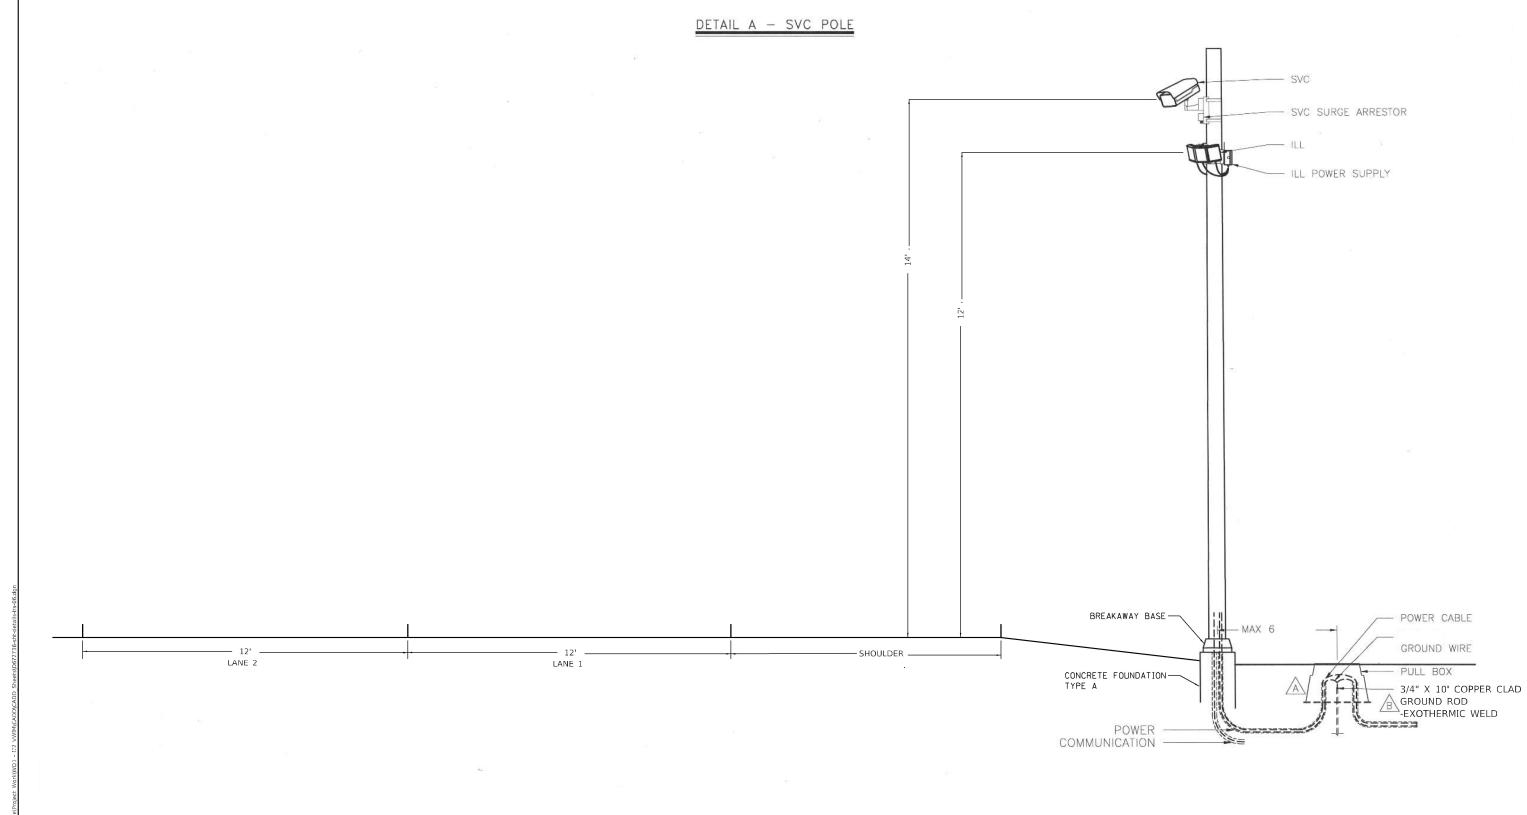
STATE OF ILLINOIS
DEPARTMENT OF TRANSPORTATION

SCALE: N.T.S.

	FAI R	OUTE 72	(I-72)		F.A.I. RTE.	SECTION		COUNTY	TOTAL SHEETS	SHEET NO.
W	/FIGH IN	I MOTION	DETAILS		72	75-4WS		PIKE	23	14
	LIGH III	I WOTTON	DETAILS					CONTRACT	NO.72	736
SHEET 5	OF 1	3 SHEETS	STA.	TO STA.		ILLINOIS	FED. AI	D PROJECT		

DETAIL B





NOTES: (THIS SHEET ONLY)

EQUIPMENT SHOULD BE CONNECTED TO EARTH GROUND IN COMPLIANCE WITH NATIONAL ELECTRICAL CODE AND LOCAL STANDARDS.

B BOND POLE GROUND ROD TO CABINET GROUND BUS USING MINIMUM 6 AWG WIRE.

C DIMENSIONS ARE NOTED AS XX FORMAT. WHERE XX IS IN FEET.


## SITE LAYOUT I-72 VIRTUAL WEIGHT STATION

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AME:	TranSmart*	1
LEN	on ATLAS Company	Š
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STATE OF ILLINOIS
DEPARTMENT OF TRANSPORTATION

### CAMERA/POLE GEOMETRY

### TYPICAL LAYOUT

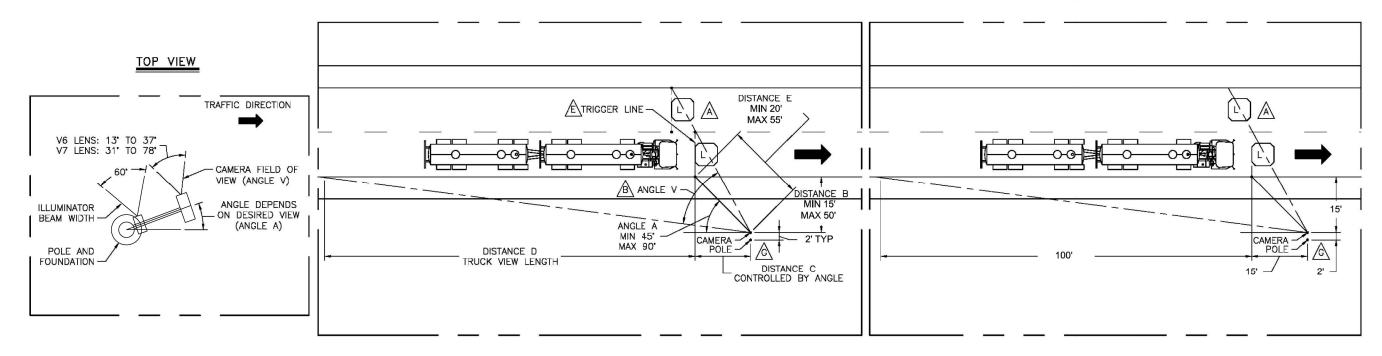

### NOTES: (THIS SHEET ONLY)

ADDITIONAL LANES MAY BE COVERED BY A SINGLE CAMERA. TRIGGER LOOPS IN ADJACENT LANES SHOULD BE IN-LINE WITH THE UPSTREAM EDGE OF THE CAMERA FIELD OF VIEW. NOTE: VEHICLES IN CLOSER LANE MAY BE BLOCKED BY THE VEHICLES IN FARTHER LANES.

ANGLE V IS CONTROLLED BY CAMERA ZOOM. SEE TOP VIEW.

DISTANCE E LIMITED BY ILLUMINATOR RANGE

 $E = \sqrt{B^2 + C^2}$ 

FOR NON-TYPICAL LAYOUTS, USE 3EGRO015 - SIDE FIRE CAMERA POSITION CALCULATOR TO POSITION CAMERA.

E IMAGE CAPTURE TO BE TRIGGERED BY LEADING EDGE OF LOOP SIGNAL.

THE "IDENTIFICATION" VIEW CONFIGURATION PROVIDES AN ENHANCED VIEW OF THE TRACTOR CAB COMPARED TO THE REST OF THE TRUCK. THIS CONFIGURATION IS RECOMMENDED AS IT ALLOWS FOR BETTER VEHICLE IDENTIFICATION. THE "CLASSIFICATION" VIEW PROVIDES A LESS DISTORTED VIEW OF THE ENTIRE TRUCK; IDEAL FOR IDENTIFICATION OF VEHICLE CLASS.

POLE TO BE POSITIONED AWAY FROM CAMERA LOCATION TO ACCOUNT FOR CAMERA LENS/POLE OFFSET.

A	CONFIGURATION TYPE	DISTANCE				ANGLE		
<u> </u>	CONFIGURATION TIPE	В	С	D	E	Α	٧	
	IDENTIFICATION VIEW (RECOMMENDED)	15'	15'	100'	21.2'	45'	54°	
	CLASSIFICATION VIEW (OPTIONAL)	30'	20'	100'	36.1'	56'	51°	

### SITE LAYOUT **SIDE FIRE CAMERA WITH ILLUMINATOR**


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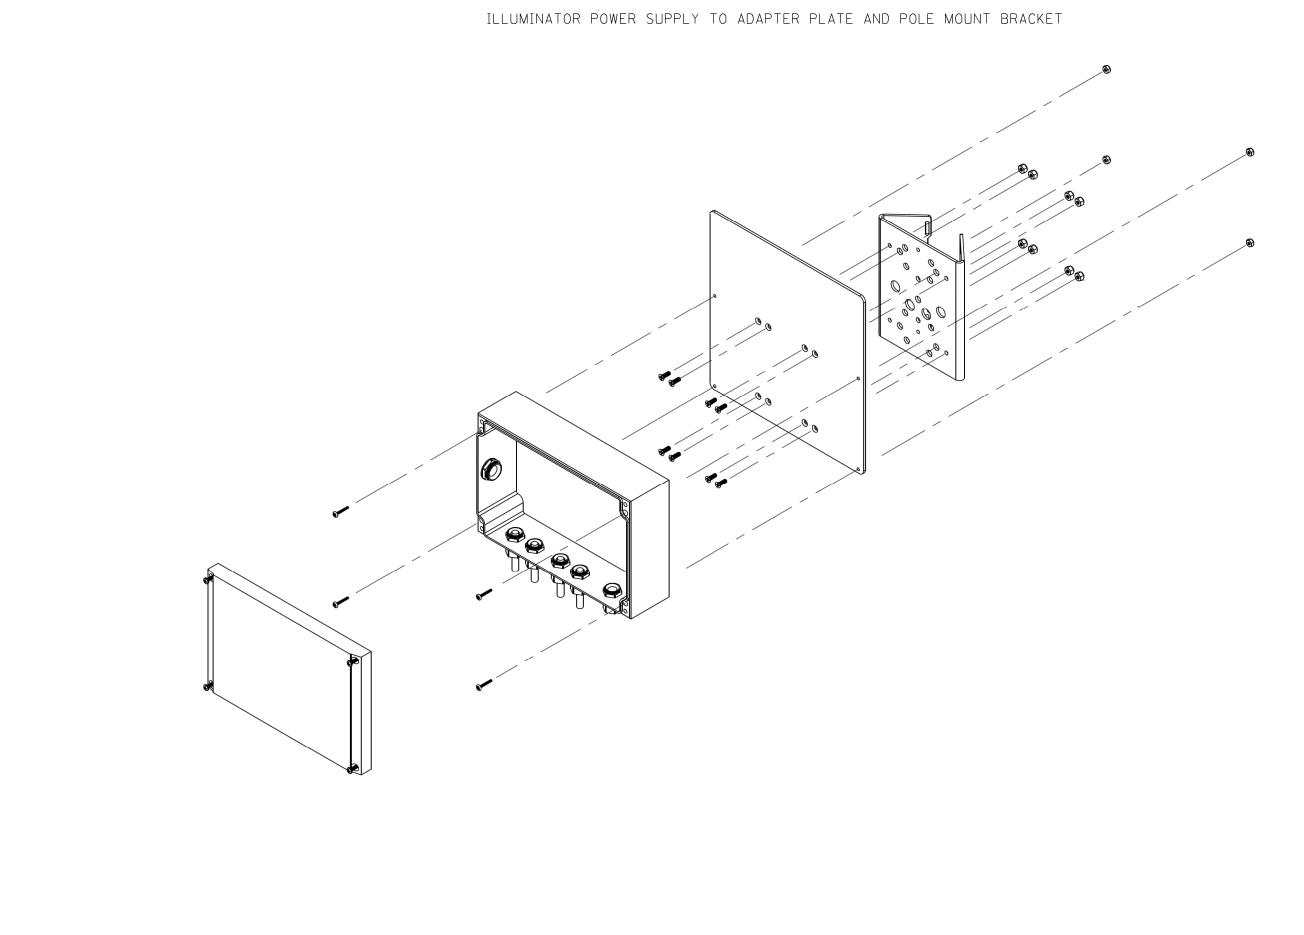
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Suite 400
Chicago, IL 60606

DESIGNED - DJM REVISED DRAWN - DJM REVISED CHECKED - REL REVISED PLOT DATE = 11/12/2024 - 11/13/2024 REVISED

STATE OF ILLINOIS **DEPARTMENT OF TRANSPORTATION** 

SECTION FAI ROUTE 72 (I-72) 75-4WS PIKE WEIGH IN MOTION DETAILS CONTRACT NO.72736 SHEET 7 OF 13 SHEETS STA.



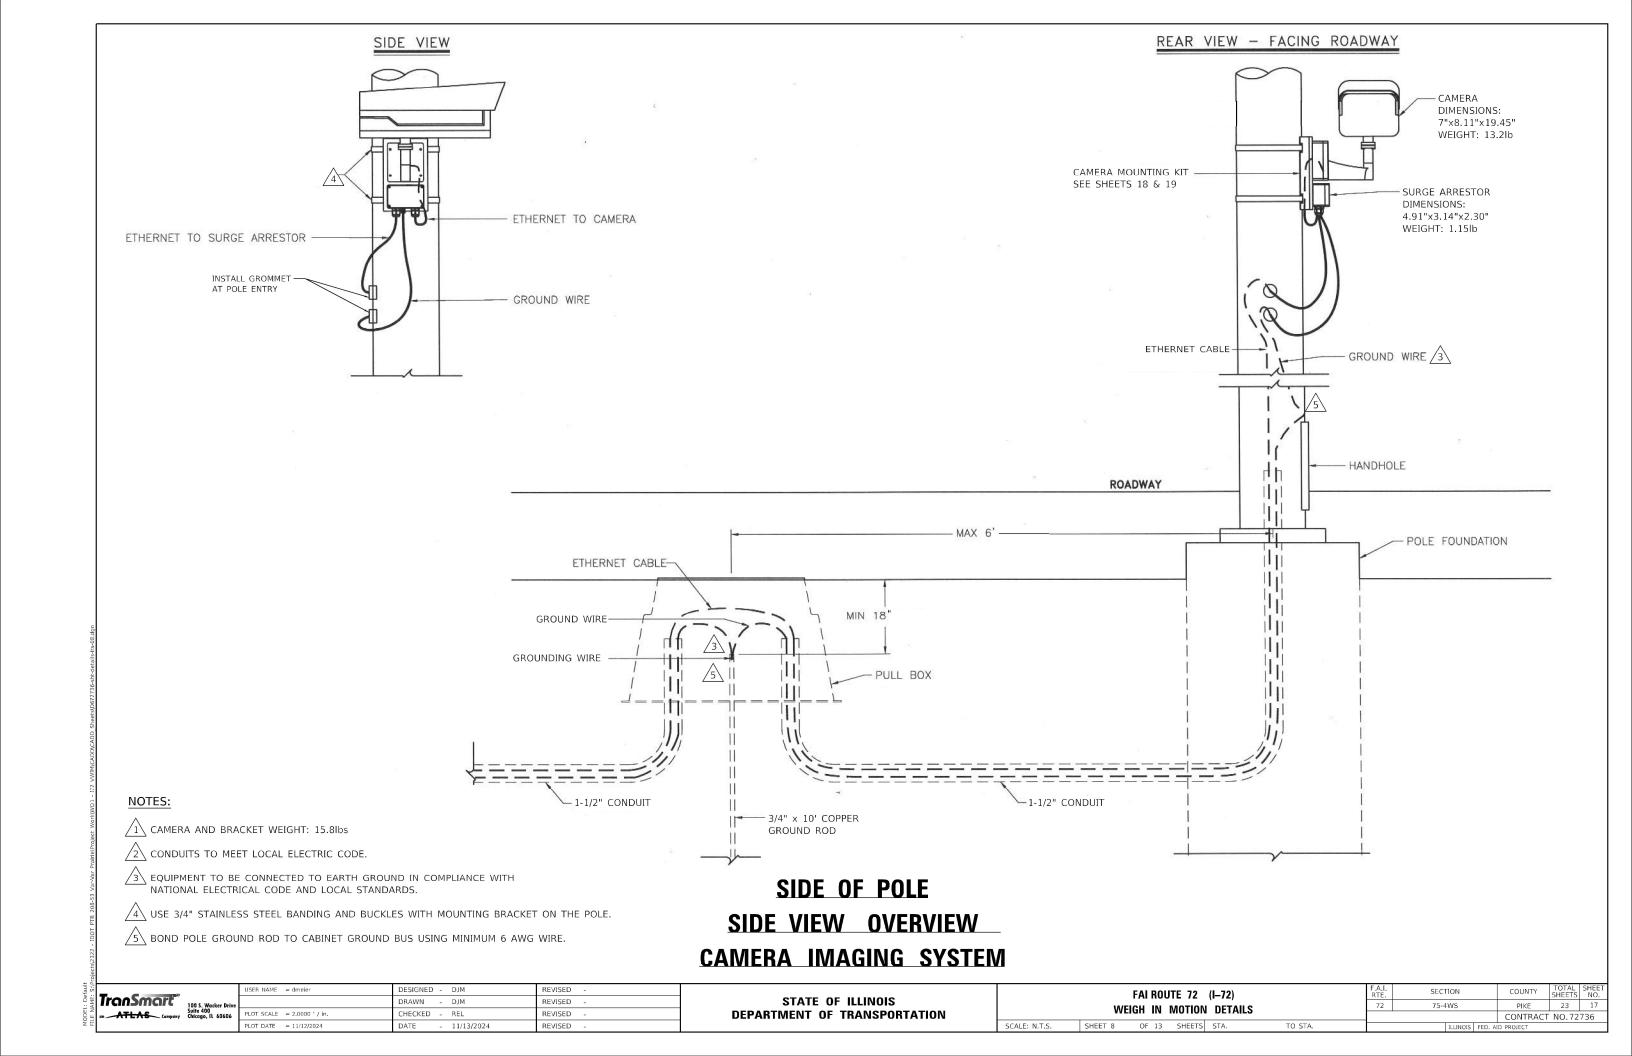

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100 S. Wacker Drive
Suite 400
Company
ATLAS
Company

DESIGNED - DJM REVISED DRAWN - DJM REVISED CHECKED - REL REVISED PLOT DATE = 11/12/2024 DATE - 11/13/2024 REVISED

STATE OF ILLINOIS
DEPARTMENT OF TRANSPORTATION

FAI ROUTE 72 (I-72) WEIGH IN MOTION DETAILS SCALE: N.T.S. SHEET 9 OF 13 SHEETS STA. TO STA.

 
 COUNTY
 TOTAL SHEETS NO.

 PIKE
 23
 18


 CONTRACT
 NO.72736
 SECTION 75-4WS

### ASSEMBLE ILLUMINATOR TO POLE MOUNT BRACKET

### MOUNT ASSEMBLIES TO POLE TO SUIT SITE CONDITIONS


- ASSEMBLIES ON POLE USING SAME BANDING

ORIENT ANGLE TO EACH OTHER AS REQUIRED

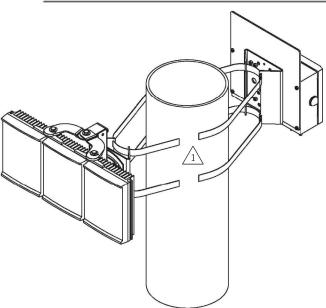

STEP 3B - ORIENT ASSEMBLIES ON POLE AT DIFFERENT ELEVATIONS

ANGLE EACH ASSEMBLY ON POLE AS REQUIRED

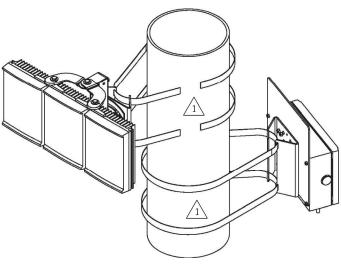

RAYTEC VARIABLE ANGLE CVO SF ILLUMINATOR

-ILLUMINATOR -BRKT POLE MNT SCREW 1/4-20X1/2 HEX PH BINDING-NUT 1/4-20 HEX NYLOC SST-


NOTES: (THIS SHEET ONLY)

USE 1/2" STAINLESS STEEL BANDING AND BUCKLES WITH MOUNTING BRACKET ON THE POLE. REFER TO BRACKET INSTALLATION INSTRUCTIONS AND LOCAL CODE FOR REQUIREMENTS.

Transmart

100 S. Wacker Drive
Suite 400
Company
Chitcago, IL 60606

STATE OF ILLINOIS
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### NOTES:

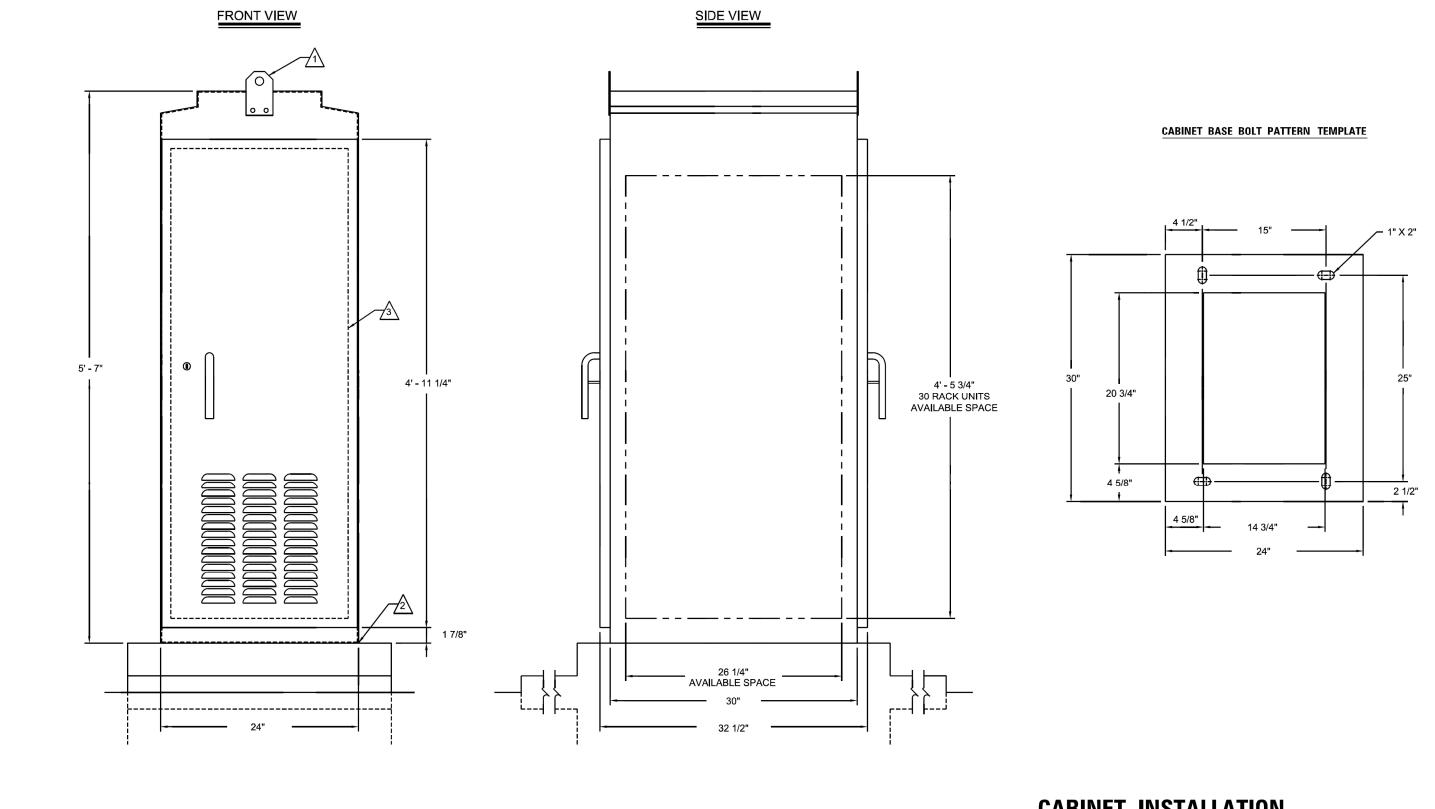LIFTING EYE. MAY BE UNBOLTED AND ROTATED 180° FOR STORAGE.

SEAL CABINET TO FOUNDATION JOINT WITH SILICONE SEALANT TO PREVENT WATER INTRUSION. LOCATE CABINET ABOVE HIGH WATER LEVEL.


REMOVABLE 19" EIA RACK.

### **CABINET INSTALLATION**

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	USER NAME = dmeler	DESIGNED - DJM	REVISED -
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	PLOT DATE = 11/12/2024	DATE - 11/13/2024	REVISED -

FAI ROUTE 72 (I–72)					F.A.I. RTE.	SECTION	COUNTY	TOTAL SHEETS	SHEET NO.
WEIGH IN MOTION DETAILS				72	75-4WS	PIKE	23	20	
						CONTRACT	NO.72	736	
SHEET 11	OF 13	SHEETS	STA.	TO STA.		ILLINOIS FED. AID PROJECT			

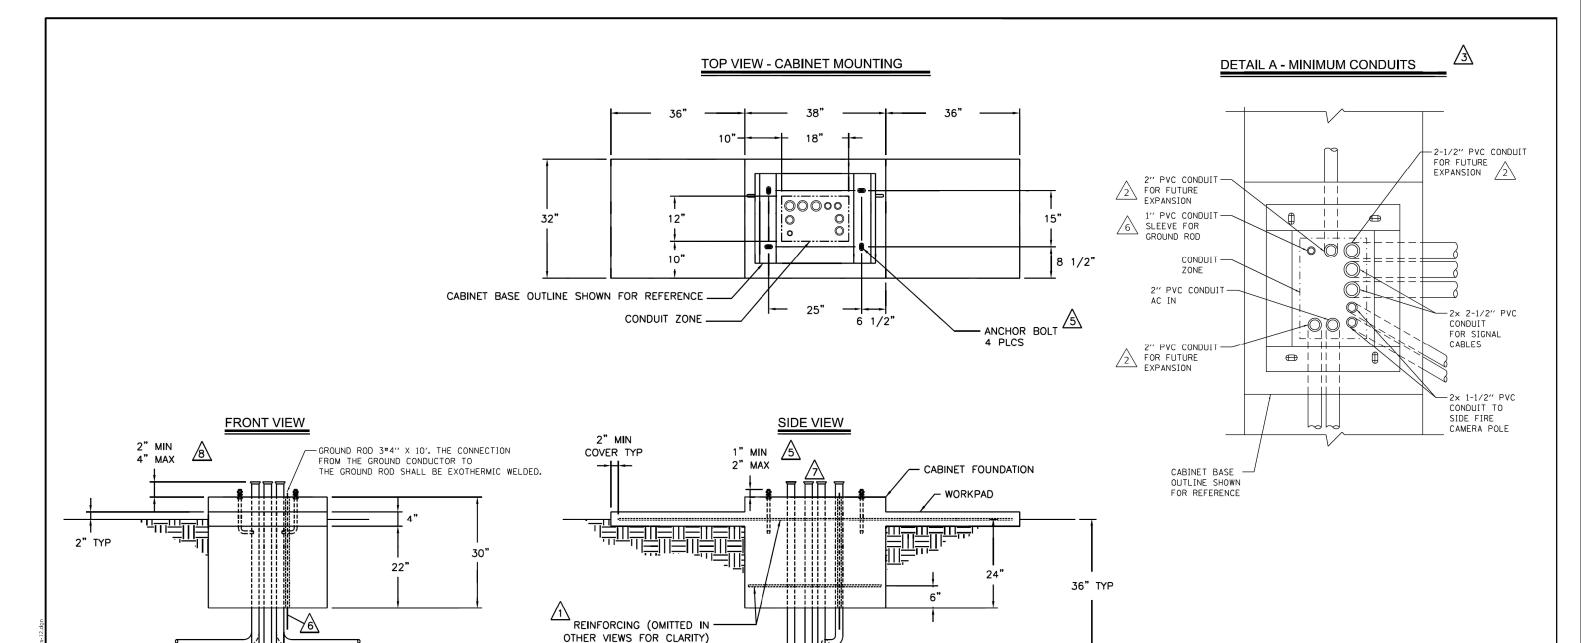

### NOTES:

1 INSTALL REINFORCING MATS. #4 BAR 12" ON CENTER EACH WAY. EPOXY COAT OR GALVANIZE. REINFORCEMENTS ARE MINIMUM REQUIREMENTS AND MAY BE SUPERSEDED BY LOCAL CONSTRUCTION CODES.

/2ackslash SPARE CONDUITS MUST BE CAPPED, STUBBED 24" PAST FOUNDATION, AND LABELED.

ALL CONDUITS SHWON SHALL BE FURNISHED AND INSTALLED IN FOUNDATION IN ACCORDNACE WITH LOCAL CODES. CAP IF NOT USED. CONDUITS SHALL EXIT FOUNDATION IN DIRECTION APPROPRIATE FOR SITE GEOMETRY.

/4
angle CONCRETE SHALL HAVE COMPRESSIVE STRENGTH OF 3000 PSI MINIMUM.

CABINET ANCHORS MUST BE GALVANIZED OR STAINLESS STEEL AND MAY BE CAST IN PLACE, CHEMICAL OR EXPANSION TYPE DRILLED INTO BASE. TYPICAL SIZE IS 3/4" NC x 12" x 4".

6 GROUND ROD MUST BE PROVIDED TO MEET LOCAL ELECTRICAL CODE.

SEAL ALL CONDUIT ENDS WITH STEEL WOOL AND DUCT SEAL TO REDUCE RODENT OR INSECT INTRUSION AND MOISTURE. DO NOT USE PERMANENT SEALANT AS CONDUITS MAY NEED TO BE REENTERED IN THE FUTURE FOR CABLE REPLACEMENT OR ADDITIONS.


### **CABINET FOUNDATION INSTALLATION**

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Iransmart	100 S. Wacker Drive Suite 400 Chicago, IL 60606	ŀ
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DEPARTMENT OF	TRANSPORTATION

FAI ROUTE 72 (I–72)	F.A.I. RTE.	SECTION	COI	JNTY TO	TAL ETS	SHEET NO.
WEIGH IN MOTION DETAILS	72	75-4WS	P	IKE 2	3	21
WEIGH IN MOTION DETAILS			CON	ITRACT NO	.72	736
SHEET 12 OF 13 SHEETS STA. TO STA.		ILLINOIS	FED. AID PROJE	CT		



### **GENERAL NOTES:**

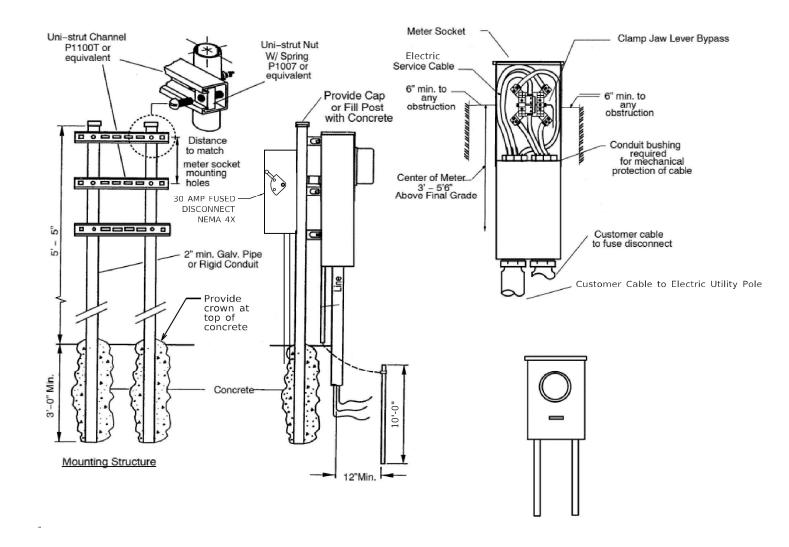
- 1. THE INSTALLATION OF ALL ENTRANCE EQUIPMENT, CONDUCTORS AND CONDUIT SHALL CONFORM TO LOCAL CODES OR THE LATEST NEC REQUIREMENTS.
- 2. ALL MATERIAL SHALL BE FURNISHED AND INSTALLED BY CONTRACTOR.
- 3. NEC APPROVED GROUND REQUIRED.
- 4. DIFFERENT ARRANGEMENTS OF THE SERVICE EQUIPMENT (FUSE/BREAKER BOX) MAY BE USED SIDE-BY-SIDE OR BELOW METER.
- 5. REFER TO ELECTRIC UTILITY PROVIDER FOR METER SOCKETS OR COMBO UNITS REQUIREMENT.
- 6. REFER TO ELECTRIC UTILITY PROVIDER FOR METER MOUNTING HEIGHT.
- 7. WHEN AN EXPANSION COUPLING IS REQUIRED, IT SHOULD BE INSTALLED SO THAT THE OUTER SLEEVE INTO THE METER SOCKET WITH THE INNER SLEEVE POSITIONED AT THE MANUFACTURER'S MIDWAY MARK.
- 8. COST OF ALL WORK ON THIS SHEET (INCLUDING THE FUSED STAINLESS STEEL NEMA 4X DISCONNECT SWITCH) SHALL BE INCLUDED IN THE SERVICE TYPE A (MODIFIED) PAY ITEM.

# UNDERGROUND METER SERVICE /LOAD CENTER METER REQUIREMENTS

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STATE	OF.	ILLINOIS
DEPARTMENT	OF 7	<b>TRANSPORTATION</b>

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HEET 13 OF 13 SHEETS STA TO STA							LUNOIC FED AL	D DDOLECT		

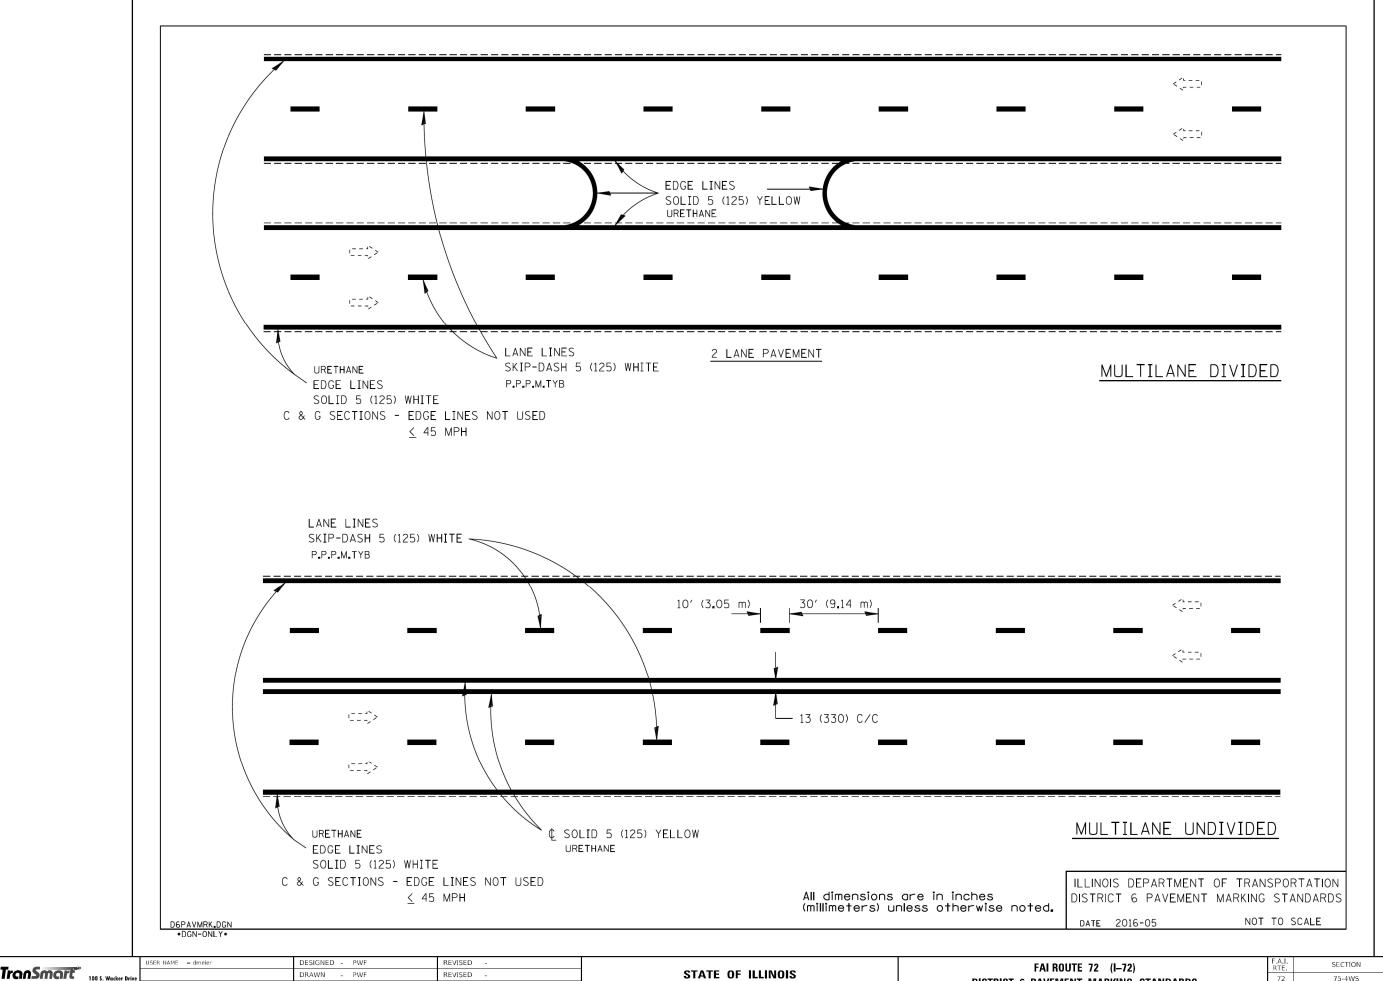

Transmart

100 S. Watker Drive
Suite 400
chitcago, 11 60606

DRAWN - PWF REVISED CHECKED - KJC REVISED PLOT DATE = 11/12/2024 DATE - 11/13/2024 REVISED

**DEPARTMENT OF TRANSPORTATION** 

DISTRICT 6 PAVEMENT MARKING STANDARDS

PIKE 23 23 75-4WS CONTRACT NO. 72736

SCALE: N.T.S. SHEETS STA.