FOR INDEX OF SHEETS, SEE SHEET NO. 2

## STATE OF ILLINOIS DEPARTMENT OF TRANSPORTATION

FOR INDEX OF HIGHWAY STANDARDS, SEE SHEET NO. 2

,

03-07-2025 LETTING ITEM 011

# PLANS FOR PROPOSED FEDERAL AID HIGHWAY

TRAFFIC DATA

HART ROAD


POSTED SPEED LIMIT: 25 MPH

ADT = 3200 (2023)

FUNCTIONAL CLASSIFICATION
MAJOR COLLECTOR

FAU 0201 (HART ROAD)
WEST VILLAGE LIMITS TO FAU 0186 (IL 134 – ROUND LAKE ROAD)
RESURFACING

SECTION: 22-00086-00-RS PROJECT: XXHR(939) VILLAGE OF ROUND LAKE LAKE COUNTY

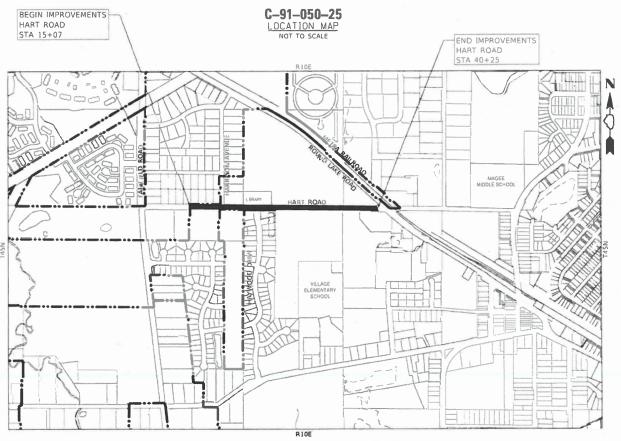


GROSS LE NGTH = 2,600 FT. = 0.492 MILE

NET LENGTH = 2,600 FT. = 0.492 MILE

BAXTER WOODMAN Consulting Engineers

PLICENS2 EXPIRES 11-30-2025"




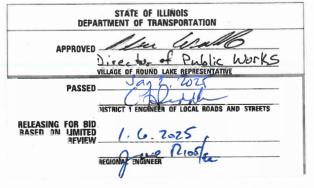

PRINTED BY THE AUTHORITY OF THE STATE OF ILLINOIS

TOW PROJECT NO . 220320

DATE: 12-26-2024

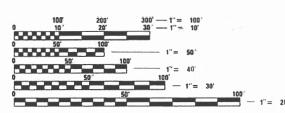

FULL SIZE PLANS HAVE BEEN PREPARED USING STANDARD ENGINEERING SCALES. REDUCED SIZED PLANS WILL NOT CONFORM TO STANDARD SCALES. IN MAKING MEASUREMENTS ON REDUCED PLANS, THE ABOVE SCALES MAY BE USED.

J.U.L.I.E. DESIGN STAGE REQUEST DIG. No. X220560273



TONIAC' CULAF, A' BE OR 800-893-0123 WITH THE FOLLOWING:

550, % 1/4 SEC. NO. = SEC 19 & SEC 20 48 HOURS 12 working cays) 36 TOFE YOU DIG

CONTRACT NO. 61L17

Delault ME:P:\ROULK\;220320-Hart Road STP Impr**av\CAD\Sh**æe**rs\220320\_SMT-Cove**r,dg

- 3. THE CONTRACTOR SHALL NOTIFY THE VILLAGE PUBLIC WORKS ADMINISTRATOR AT LEAST 48 HOURS IN ADVANCE OF BEGINNING WORK TO OBTAIN VILLAGE UTILITY LOCATIONS.
- 4. THE CONTRACTOR MAY OBTAIN MUNICIPAL WATER IN BULK, AT NO CHARGE, AS LONG AS THERE IS NOT A "WATERING BAN" IN EFFECT. THE INDISCRIMINATE USE OF FIRE HYDRANTS IS STRICTLY PROHIBITED. WATER FOR CONSTRUCTION SHALL BE METERED OR OTHERWISE ACCOUNTED FOR AND A DAILY LOG MAINTAINED. THE CONTRACTOR SHALL PROVIDE THE WATER TRUCK AND DRIVER REQUIRED TO OBTAIN AND TRANSPORT THIS WATER. THE VILLAGE RESERVES THE RIGHT TO RESTRICT OR REFUSE THE USE OF VILLAGE WATER IF DEEMED NECESSARY.
- 5. ACCESS TO PRIVATE DRIVEWAYS SHALL BE PROVIDED AT ALL TIMES EXCEPT DURING ACTUAL CONSTRUCTION ADJACENT THERE TO. TEMPORARY RAMPS SHALL BE CONSTRUCTED AS NEEDED TO PROVIDE SUCH ACCESS, UTILIZING CRUSHED STONE OR CRUSHED GRAVEL.
- 6. IT WILL BE THE CONTRACTOR'S RESPONSIBILITY TO NOTIFY THE ENGINEER, RESIDENTS AND THE VILLAGE WHEN ACCESS TO DRIVEWAYS WILL BE TEMPORARILY CLOSED DUE TO CURB AND GUTTER AND/OR DRIVEWAY REPLACEMENT. THE CONTRACTOR SHALL DISTRIBUTE NOTICES PROVIDED BY THE VILLAGE TO RESIDENTS AT LEAST 24 HOURS PRIOR TO PLANNED CLOSURE. EVERY EFFORT SHALL BE MADE TO ACCOMMODATE ACCESS TO THESE PROPERTIES INCLUDING KNOCKING ON DOORS WHEN DRIVEWAYS ARE ABOUT TO BE CLOSED.
- 7. THE DAYS PAVING OPERATION SHOULD RESULT IN A SINGLE TRANSVERSE JOINT. ANY COLD LONGITUDINAL JOINTS WILL NOT BE ACCEPTED. PROVIDING A SINGLE TRANSVERSE JOINT SHALL BE ACCOMPLISHED BY PAVING ONE LANE OF SUFFICIENT LENGTH THAT WILL ALLOW FOR THE PAVING OF THE ADJACENT LANE IN THE SAME DAY.
- 8. THE CONTRACTOR WILL BE REQUIRED TO USE A STEEL PLATE OR PLATES TO CLOSE ANY GAPS OCCURRING WHEN A FRAME IS OFFSET FROM THE STRUCTURE. THE STEEL PLATE SHALL BE  $\frac{1}{2}$ -INCH THICK AND APPROXIMATELY 6-INCH WIDE BY 24-INCH LONG. SOME ADJUSTMENT IN SIZE MAY BE NECESSARY TO PREVENT THE STEEL PLATE FROM OVERHANGING THE OUTSIDE OF THE STRUCTURE WALL. THE STEEL PLATE SHALL BE BEDDED IN AND COVERED WITH MORTAR. THIS WORK SHALL BE INCLUDED IN THE COST OF STRUCTURE ADJUSTMENTS OR STRUCTURE RECONSTRUCTIONS.
- 9. THE CURB SHALL BE TAPERED TO THE GUTTER IN A FIVE (5) FOOT LENGTH WHEREVER THE CURB AND GUTTER TERMINATES, WITH AN EXPANSION JOINT PLACED AT THE START OF THE TAPER.
- 10. A PORTABLE BATHROOM(S) SHALL BE PLACED ON THE JOB SITE(S) AND RELOCATED WHEN NECESSARY SO IT IS ACCESSIBLE TO WORKERS. IF WORK IS OCCURRING AT SEVERAL LOCATIONS, ONE PORTABLE BATHROOM SHALL BE PLACED AT EACH LOCATION WITHIN A REASONABLE DISTANCE FROM THE WORK AS DETERMINED BY THE ENGINEER.
- 11. ON STREETS TO BE FULL WIDTH MILLED (2" OR MORE), THE EXISTING STRUCTURES IN THE PAVEMENT SHALL BE ADJUSTED IN ACCORDANCE WITH THE IDOT DETAIL "DETAILS FOR FRAMES AND LIDS ADJUSTMENT WITH MILLING". THIS WORK SHALL BE IN ADDITION TO THE REQUIREMENTS FOR MANHOLES TO BE
- 12. WHEN MILLED PAVEMENT IS OPEN TO TRAFFIC, THE MAXIMUM GRADE DIFFERENTIAL BETWEEN PASSES OF THE MILLING MACHINE SHALL NOT EXCEED 1  $\frac{1}{2}$  INCHES WHERE THE SPEED LIMIT IS 45 MPH OR LESS, AND SHALL NOT EXCEED 1 INCH WHERE THE SPEED LIMIT IS OVER 45 MPH. A MAXIMUM GRADE DIFFERENCE OF 3 INCHES MAY BE ALLOWED IF THE EDGE OF THE MILLING IS SLOPED A MINIMUM OF 1:3 (V:H), AS DETERMINED BY THE ENGINEER.
- 13. THE CONTRACTOR SHALL TAKE PRECAUTION BY PRESERVING EXISTING TREES WITHIJN THE RIGHT OF WAY. IF ANY DAMAGE OCCURS, TREES SHALL BE REPLACED IN KIND PER ARTICLE 201.07.
- 14. THE CONTRACTOR SHALL CONTACT KALPANA KANNAN-HOSADURGA, THE DISTRICT ONE TRAFFIC CONTROL SUPERVISOR, AT KALPANA.KANNAN-HOSADURGA@ILLINIOIS.GOV A MINIMUM OF 72 HOURS IN ADVANCE OF BEGINNING WORK.

## INDEX OF SHEETS

- COVER
- GENERAL NOTES, INDEX OF SHEETS, AND HIGHWAY
- STANDARDS
- SUMMARY OF QUANTITIES
- TYPICAL SECTIONS
- 6 7 ROADWAY PLAN HART ROAD
- SIDEWALK DETAILS
- DETAIL FOR FRAMES AND LIDS ADJUSTMENT WITH MILLING
- CURB OR CURB AND GUTTER REMOVAL AND REPLACEMENT
- BUTT JOINT AND HMA TAPER DETAILS
- TRAFFIC CONTROL & PROTECTION FOR SIDE ROADS, INTERSECTIONS & DRIVEWAYS
- TYPICAL PAVEMENT MARKINGS
- ARTERIAL ROAD INFORMATION SIGN
- SHORT-TERM PAVEMENT MARKING LETTERS AND SYMBOLS
- DRIVEWAY ENTRANCE SIGNING

## HIGHWAY STANDARDS

- STANDARD SYMBOLS, ABBREVIATIONS AND PATTERNS 000001-08
- 424001-12 PERPENDICULAR CURB RAMPS FOR SIDEWALKS
- 424016-05 MID-BLOCK CURB RAMPS FOR SIDEWALKS
- 424021-07 DEPRESSED CORNER FOR SIDEWALKS
- 442201-03 CLASS C AND D PATCHES
- 606001-08 CONCRETE CURB TYPE B AND COMBINATION CONCRETE CURB AND GUTTER
- 701006-05 OFF-RD OPERATIONS, 2L, 2W, 15' (4.5 m) TO 24" (600 mm) FROM PAVEMENT EDGE
- 701011-04 OFF-RD MOVING OPERATIONS, 2L, 2W, DAY ONLY
- 701301-04 LANE CLOSURE, 2L, 2W, SHORT TIME OPERATIONS
- 701311-03 LANE CLOSURE 2L, 2W MOVING OPERATIONS - DAY ONLY
- 701501-06 URBAN LANE CLOSURE, 2L, 2W, UNDIVIDED
- 701801-06 SIDEWALK, CORNER OR CROSSWALK CLOSURE
- 701901-10 TRAFFIC CONTROL DEVICES

## **COMMITMENTS**

THERE ARE NO COMMITMENTS ON THIS PROJECT

## DISTRICT ONE DETAILS

- DETAILS FOR FRAMES AND LIDS ADJUSTMENT WITH MILLING
- CURB OR CURB AND GUTTER REMOVAL AND REPLACEMENT
- BUTT JOINT AND HMA TAPER DETAILS
- TRAFFIC CONTROL AND PROTECTION FOR SIDE ROADS, INTERSECTIONS & DRIVEWAYS

TO STA.

- DISTRICT ONE TYPICAL PAVEMENT MARKINGS
- SHORT-TERM PAVEMENT MARKING LETTERS AND SYMBOLS
- TC-22 ARTERIAL ROAD INFORMATION SIGN
- DRIVEWAY ENTRANCE SIGNING

SCALE:



USER NAME = javila DESIGNED -CW REVISED REVISED DRAWN REVISED PLOT SCALE = 20.0000 ' / in CHECKED -LJF - 01-20-2025 FILE - 220320 SHT-GenNotes.dgn PLOT DATE = 1/20/2025DATE

**VILLAGE OF ROUND LAKE, ILLINOIS** HART ROAD IMPROVEMENTS

**GENERAL NOTES, HIGHWAY STANDARDS** AND INDEX OF SHEETS

SHEET 1 OF 1 SHEETS STA.

TOTAL SHEET NO. COUNTY **SECTION** 22-00086-00-RS LAKE 13 2 CONTRACT NO. 61L17 ILLINOIS FED. AID PROJECT

M. Miodarylpdi-BW Default, plt
....KLGNPfolsts\_2320 PEN.tbl
....KLGNPfolsts\_2320 PEN.tbl
....KLGNULK\1220320-Hart Road STP Improv\CAD\Sheets\1220320\_SHT-SOC

STATE OF ILLINOIS - PROFESSIONAL DESIGN FIRM ...\alptatrvlpdf
LICENSE NO. - 184-00.1121 - EXPIRES 4/30/2025 ...\CAD)Plotsix
javila 1/20/2025 1.53:21 PM P:\ROULK\220
MODEL: Default 1/20/2025 1.53:21 PM P:\ROULK\220
MODEL: Default 1/20/2025 1.54 Pood 570 Innoved On Separation 2023

1/20/2025 EL: Default NAME: P:/ROULK/220320-Har		
javita MODEL: Default FILE NAME: P:\RI	BAXTER	

				CONSTRUCTI CODE
				80% STATE 20% LOCAL
CODE NO.	ITEM	TINU	TOTAL QUANTITY	ROADWAY 0005 URBAN
20200100	EARTH EXCAVATION	CU YD	22	22
20201200	REMOVAL AND DISPOSAL OF UNSUITABLE MATERIAL	CU YD	49	49
1001000	GEOTECHNICAL FABRIC FOR GROUND STABILIZATION	SQ YD	236	236
1101615	TOPSOIL FURNISH AND PLACE, 4"	SQ YD	1,003	1.003
5000110	SEEDING, CLASS 1A	ACRE	0 20 .	0.20
5000400	NITROGEN FERTILIZER NUTRIENT	POUND	18	18
5000600	POTASSIUM FERTILIZER NUTRIENT	POUND	18	18
5100630	EROSION CONTROL BLANKET	SQ YD	968	968
8000510	INLET FILTERS	EACH	30	30
0300001	AGGREGATE SUBGRADE IMPROVEMENT	CU YD	40	40
5101600	AGGREGATE BASE COURSE, TYPE B 4*	SQ YD	1,821	1.821
0600290	BITUMINOUS MATERIALS (TACK COAT)	POUND	5,738	5,738
0600400	MIXTURE FOR CRACKS, JOINTS, AND FLANGEWAYS	TON	36	36
0600982	HOT-MIX ASPHALT SURFACE REMOVAL, BUTT JOINT	SQ YD	146	146
0603200	POLYMERIZED HOT-MIX ASPHALT BINDER COURSE, IL-4.75, N50	TON	367	367

				CONSTRUCTION
				80% STATE 20% LOCAL
				ROADWAY
CODE NO.	ITEM	UNIT	TOTAL QUANTITY	0005
				URBAN
40604060	HOT-MIX ASPHALT SURFACE COURSE, IL-9.5, MIX "D", NS0	TON	856	856
42400200	PORTLAND CEMENT CONCRETE SIDEWALK 5 INCH	SQ FT	1,796	1,796
42400800	DETECTABLE WARNINGS	SQ FT	112	112
44000158	HOT-MIX ASPHALT SURFACE REMOVAL, 2 1/4"	SQ YD	8,500	8,500
44000600	SIDEWALK REMOVAL	SQ FT	2,302	2,302
44201741	CLASS D PATCHES, TYPE II, 8 INCH	SQ YD	93	93
44201745	CLASS D PATCHES, TYPE III, 8 INCH	SQ YD	209	209
44201747	CLASS D PATCHES, TYPE IV. 8 INCH	SQ YD	170	170
48101200	AGGREGATE SHOULDERS. TYPE B	TON	20	20
50900805	PEDESTRIAN RAILING	FOOT	50	50
60266600	VALVE BOX TO BE ADJUSTED	EACH	2	2
66900200	NON-SPECIAL WASTE DISPOSAL	CU YD	10	10
	NOTE OF COMMUNICATION OF THE PROPERTY OF THE P	010		10
66900530	SOIL DISPOSAL ANALYSIS	EACH	1	1
66901001	REGULATED SUBSTANCES PRE-CONSTRUCTION PLAN	L SUM	1	1
INDICATES S	PECIALTY ITEM			

	USER NAME - Javila	DESIGNED - CW	REVISED -
N		DRAWN - KAR	REVISED -
	PLOT SCALE = 20.0000 ' / in.	CHECKED - LIF	REVISED -
	PLOT DATE = 1/20/2025	DATE - 01-20-2025	FILE - 220320 SHT-500.dgn

VILLAGE OF ROUND LAKE, ILLINOIS HART ROAD IMPROVEMENTS

						F.A.U. RTE.	SECTION	COUNTY	TOTAL SHEETS	SHEET NO.
	SUMMARY OF QUANTITIES				0201	22-00086-00-RS	LAKE	13	3	
								CONTRACT	NO. 6	1L17
SCALE; SHEET 1 OF 2 SHEETS STA. TO STA.				ND PROJECT						

					20 % LOCAL
	CODE	ITEM	UNIT	TOTAL	ROADWAY 0005
	NO.			QUANTITY	URBAN
*	66901003	REGULATED SUBSTANCES FINAL CONSTRUCTION REPORT	L SUM	1	1
*	66901006	REGULATED SUBSTANCES MONITORING	CAL DAY	5	5
		. , , , , , , , , , , , , , , , , , , ,		· · · · · · · · · · · · · · · · · · ·	
	67100100	MOBILIZATION	L SUM	1	1
	70102620	TRAFFIC CONTROL AND PROTECTION. STANDARD 701501	L SUM	1	1
	70102640	TRAFFIC CONTROL AND PROTECTION, STANDARD 701801	L SUM	I	1
		·			
	70300211	TEMPORARY PAVEMENT MARKING - LETTERS AND SYMBOLS - PAINT	SQ FT	73	73
	70300221	TEMPORARY PAVEMENT MARKING LINE 4" PAINT	FOOT	4,533	4,533
	70300241	TEMPORARY PAVEMENT MARKING - LINE 6" - PAINT	FOOT	575	575
	70300251	TEMPORARY PAVEMENT MARKING - LINE 8" - PAINT	FOOT	77	77
	70300261	TEMPORARY PAVEMENT MARKING - LINE 12" - PAINT	FOOT	259	259
	70300281	TEMPORARY PAVEMENT MARKING - LINE 24" - PAINT	FOOT	296	296
					·
	70300100	SHORT TERM PAVEMENT MARKING	FOOT	28,700	28,700
	70300150	SHORT TERM PAVEMENT MARKING REMOVAL	SQ FT	13.870	13,870
*	72000100	SIGN PANEL. TYPE 1	SQ FT	124	124
	72400100	REMOVE SIGN PANEL ASSEMBLY - TYPE A	EACH	4	4
*	INDICATES S	PECIALTY ITEM			
			-		

\* INDICATES SPECIALTY ITEM

78000100	THERMOPLASTIC PAVEMENT MARKING - LETTERS AND SYMBOLS	SQ FT	73	73
78000200	THERMOPLASTIC PAVEMENT MARKING - LINE 4"	FOOT	4.533	4,533
78000400	THERMOPLASTIC PAVEMENT MARKING - LINE 6"	FOOT	575	575
78000500	THERMOPLASTIC PAVEMENT MARKING - LINE 8"	FOOT	77	77
73000600	THERMOPLASTIC PAVEMENT MARKING - LINE 12"	FOOT	259	259
78000650	THERMOPLASTIC PAVEMENT MARKING - LINE 24"	FOOT	296	296
78300202	PAVEMENT MARKING REMOVAL - WATER BLASTING	SQ FT	2,774	2,774
x2020112	GRADING AND SHAPING OF SHOULDERS (SPECIAL)	FOOT	750	750
x4400500	COMBINATION CURB AND GUTTER REMOVAL AND REPLACEMENT LESS THAN OR EQUAL TO 10 FEET	FOOT	259	259
x4400503	COMBINATION CURB AND GUTTER REMOVAL AND REPLACEMENT GREATER THAN 10 FEET	FOOT	617	617
×6026050	SANITARY MANHOLES TO BE ADJUSTED	EACH	1	1
X X 00 6 9 4 7	HOT-MIX ASPHALT DRIVEWAY REMOVAL AND REPLACEMENT	SQ YD	25	25
			****	
Z0017400	DRAINAGE & UTILITY STRUCTURES TO BE ADJUSTED	EACH	8	8
Z0030850	TEMPORARY INFORMATION SIGNING	SQ FT	96	96
NDICATES	RECOLTY TEM			

ITEM

] ;	at 120	USER NAME - Javita	DESIGNED - CW	REVISED -
	BAXTER WOODMAN		DRAWN - KAR	REVISED -
,	DAX I LIK WOOD HAR	PLOT SCALE = 20,0000 * / in.	CHECKED - LIF	REVISED -
1		PLOT DATE = 1/22/2025	DATE - 01-22-2025	FILE - 220320 SHT-SOO.dan

VILLAGE OF ROUND LAKE, ILLINOIS HART ROAD IMPROVEMENTS

CONSTRUCTION CODE

80% STATE 20% LOCAL

CODE NO.

72800100 TELESCOPING STEEL SIGN SUPPORT

l s	RTE.	SECTION	COUNTY	TOTAL SHEETS	SHEET NO.
	0201	22-00086-00-RS	LAKE	13	4
			CONTRACT	NO. 6	1L17
SCALE: SHEET 2 OF 2 SHEETS STA, TO STA,			AID PROJECT		

CONSTRUCTION CODE

80% STATE 20% LOCAL

ROADWAY 0005 URBAN

128

TOTAL QUANTITY


128


UNIT

FOOT





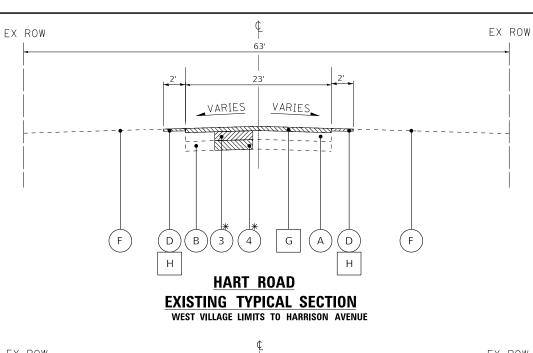

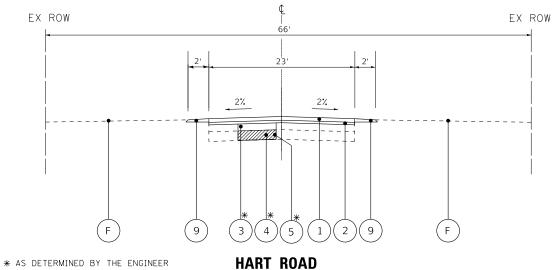


PROPOSED TYPICAL SECTION

WEST VILLAGE LIMITS TO HARRISON AVENUE


**EXISTING LEGEND** 

- EXISTING HOT-MIX ASPHALT PAVEMENT EXISTING AGGREGATE BASE COURSE
- EXISTING CURB AND GUTTER, TYPE B-6.24
- EXISTING AGGREGATE SHOULDER
- EXISTING SIDEWALK EXISTING GROUND
- HOT-MIX ASPHALT SURFACE REMOVAL, 2 1/4"
  - GRADING AND SHAPING OF SHOULDERS (SPECIAL)
  - SIDEWALK REMOVAL ITEM TO BE REMOVED

- HOT-MIX ASPHALT SURFACE COURSE, MIX "D", IL-9.5. N50, 1.75"
- POLYMERIZED HOT-MIX ASPHALT BINDER COURSE, IL-4.75, N50; 0.75"
- CLASS D PATCHES, 8"
- REMOVAL OF UNSUITABLE MATERIAL AGGREGATE SUBGRADE IMPROVEMENT (SEE NOTE 1)
- GEOTECHNICAL FABRIC FOR GROUND STABILIZATION
- PCC SIDEWALK, 5"
- COMBINATION CONCRETE CURB AND GUTTER REMOVAL AND
- TOPSOIL FURNISH AND PLACE 4"; SEEDING CLASS 1A
- AGGREGATE WEDGE SHOULDER, TYPE B
- AGGREGATE BASE COURSE, 4"

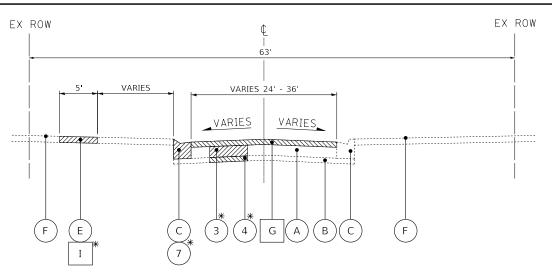

### **HART ROAD EXISTING TYPICAL SECTION** HARRISON AVENUE TO IL 134

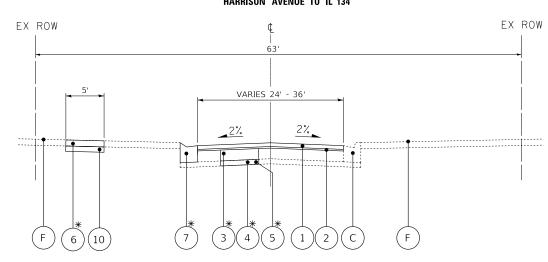

\* AS DETERMINED BY THE ENGINEER

SCALE: NONE

### **HART ROAD** PROPOSED TYPICAL SECTION HARRISON AVENUE TO IL 134

1. AGGREGATE SUBGRADE IMPROVEMENT (ASI) HAS BEEN PROVIDED FOR USE AT THE LOCATIONS INDICATED FOR SOILS THAT TEND TO BE UNSUITABLE OR UNSTABLE. THE ACTUAL NEED FOR REMOVAL AND REPLACEMENT WITH ASI WILL BE DETERMINED IN THE FIELD AT THE TIME OF CONSTRUCTION BY THE ENGINEER. ALL POTENTIALLY UNSTABLE SOILS SHOULD BE TESTED WITH A STATIC CONE PENTROMETER AND TREATED IN ACCORDANCE WITH ARTICLE 301.01 AND THE UNDERCUT GUIDELINES IN THE IDOT SUBGRADE STABILITY MANUAL. IF UNSTABLE AND/OR UNSUITABLE MATERIAL IS ENCOUNTERED, THE SOILS SHALL BE REMOVED AND REPLACED WITH ASI OR EMBANKMENT AS DETERMINED BY THE ENGINEER. THESE LIMITS MAY BE ALTERED BY THE ENGINEER IF FIELD CONDITIONS SO WARRANT. REMOVAL OR THESE UNSUITABLE SOILS SHALL BE PAID FOR AS "REMOVAL AND DISPOSAL OF UNSUITABLE MATERIAL." ANY ASI AND REMOVAL AND DISPOSAL OF UNSUITABLE MATERIAL FOR GROUND STABILIZATION NOT NEEDED AT THE TIME OF CONSTRUCTION SHALL BE DELETED FROM THE CONTRACT.

### **EXISTING PAVEMENT THICKNESS DATA**

STREET	CORE	HOT-MIX ASPHALT	AGG BASE
HART ROAD	1	10"	13"
HART ROAD	2	10 1/4"	4 1/2"
HART ROAD	3	10 3/4"	15"
HART ROAD	4	9 1/2"	15 3/4"
HART ROAD	5	10 3/4"	12 1/4"

### HOT-MIX ASPHALT MIXTURE REQUIREMENTS

MIXTURE TYPE	AIR VOIDS @ Ndes	QMP
PAVEMENT RESURFACING		
POLYMERIZED HOT-MIX ASPHALT BINDER COURSE, IL-4.75, N50; 0.75"	3.5% @ 50 Gyr.	LR1030-2
HOT-MIX ASPHALT SURFACE COURSE, MIX "D", IL-9.5, N50; 1.75"	4% @ 50 Gyr.	LR1030-2
HMA DRIVEWAY SURFACE REMOVAL & REPLACEMENT		
HOT-MIX ASPHALT SURFACE COURSE, MIX "D", IL-9.5, N50; 3" (IN 2 LIFTS)	4% @ 50 Gyr.	LR1030-2
CLASS D PATCHES		
HOT-MIX ASPHALT BINDER COURSE, IL-19.0, N50; 8"	4% @ 50 Gyr.	LR1030-2
QMP DESIGNATION: QUALITY CONTROL/QUALITY ASSURANCE (QC/QA) PER LR 1030-2		

THE UNIT WEIGHT USED TO CALCULATE ALL HMA SURFACE MIXTURE QUANTITIES IS 112 LBS/SQ YD/IN.


THE "AC TYPE" FOR POLYMERIZED HMA MIXES SHALL BE "SBS/SBR PG 76 -22" AND FOR NON-POLYMERIZED HMA THE "AC TYPE" SHALL BE "PG 64 -22" UNLESS MODIFIED BY RECLAIMED MATERIALS SPECIFICATIONS.




USER NAME = mclark	DESIGNED - CW	REVISED -
	DRAWN - KAR	REVISED -
PLOT SCALE = 20,0000 ' / in.	CHECKED - LJF	REVISED -
PLOT DATE = 12/26/2024	DATE - 12-26-2024	FILE - 220320_SHT-PHII TypicalSections
		,


**VILLAGE OF ROUND LAKE, ILLINOIS** HART ROAD IMPROVEMENTS

TYPICAL SECTIONS AND	F.A.U. RTE	SECTION	COUNTY	TOTAL SHEETS	SHEET NO.
HOT-MIX ASPHALT REQUIREMENTS	0201	22-00086-00-RS	LAKE	13	5
TIOT-WIN ASTRIALT RECORDENCENTS			CONTRACT	NO. 6	1L17
SHEET 1 OF 1 SHEETS STA TO STA	THANAGE FED AND ADOLECT				

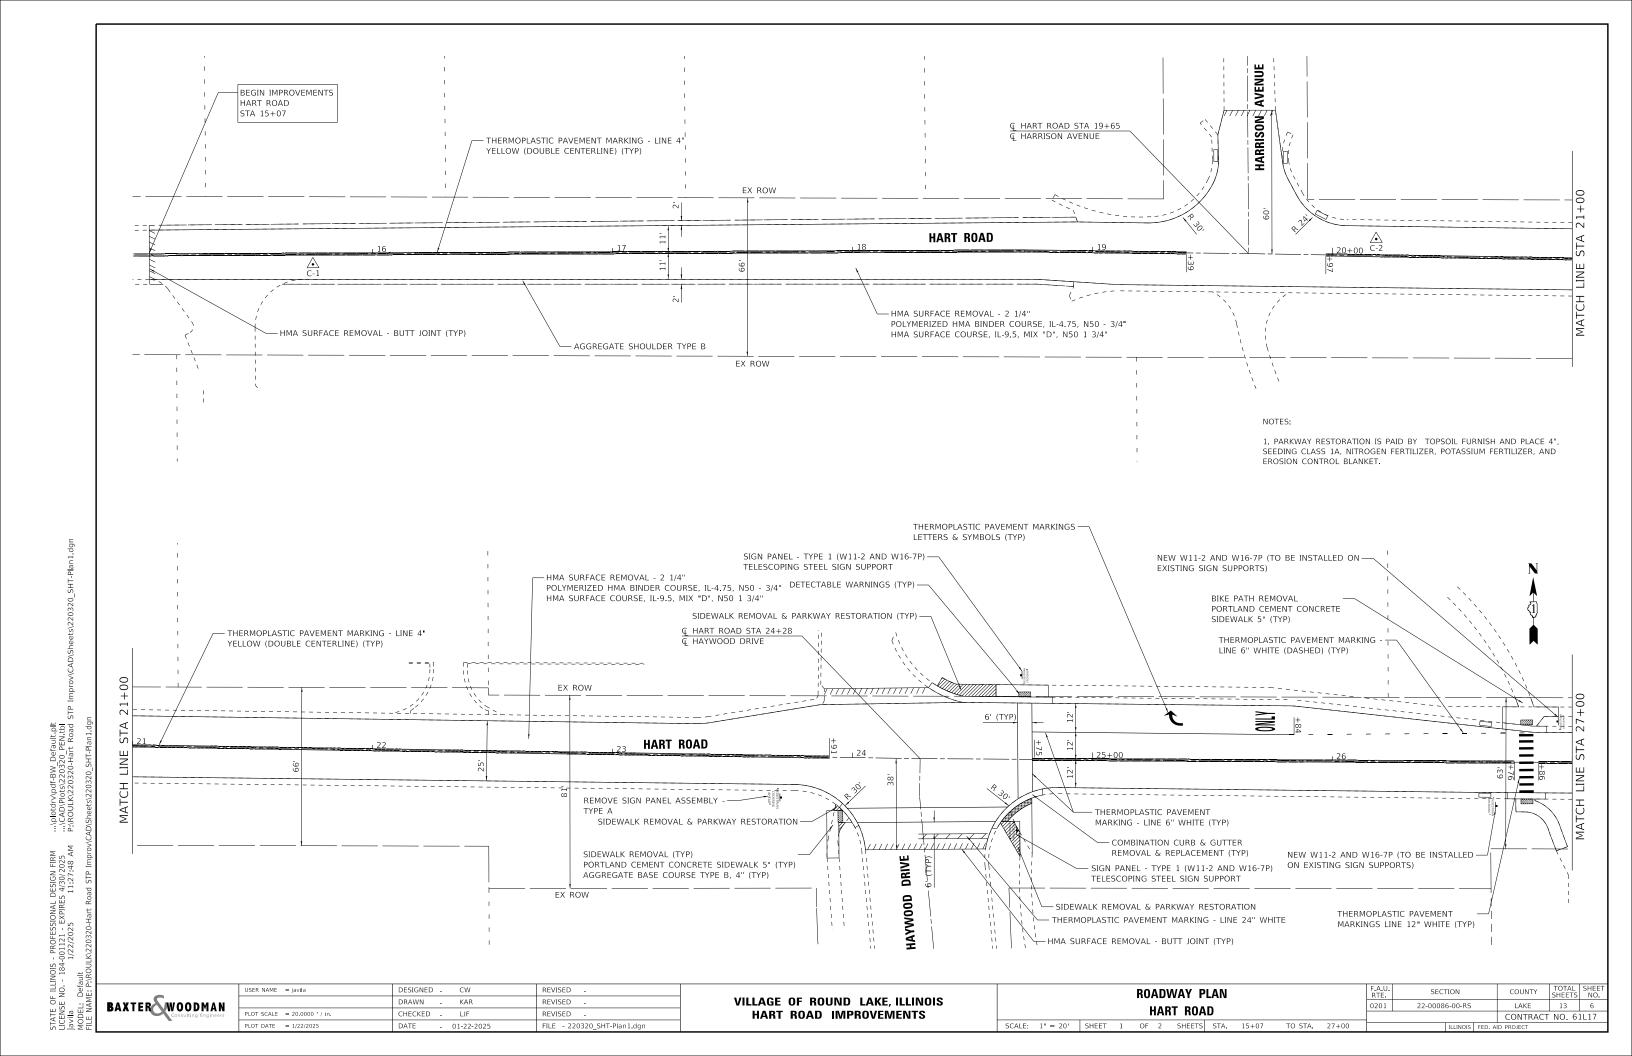

HART'S WOODS ROUND LAKE PARK DISTRICT PORTLAND CEMENT CONCRETE SIDEWALK 5" (TYP) BIKE PATH REMOVAL PORTLAND CEMENT CONCRETE SIDEWALK 5" (TYP) AGGREGATE BASE COURSE TYPE B, 4" (TYP) -SIDEWALK REMOVAL & PARKWAY RESTORATION (TYP) COMBINATION CURB & GUTTER REMOVAL & REPLACEMENT (TYP) THERMOPLASTIC PAVEMENT MARKINGS DETECTABLE WARNINGS (TYP) -SIDEWALK REMOVAL & PARKWAY RESTORATION -LETTERS & SYMOBLS (TYP) REMOVE SIGN PANEL THERMOPLASTIC PAVEMENT MARKING ASSEMBLY - TYPE A LINE 6" WHITE DASHED (TYP) HART ROAD THERMOPLASTIC PAVEMENT MARKING THERMOPLASTIC PAVEMENT LINE 4" (DOUBLE CENTERLINE) (TYP) MARKING - LINE 6" WHITE (TYP) EX ROW HMA SURFACE REMOVAL - 2 1/4" POLYMERIZED HMA BINDER COURSE, IL-4.75, N50 - 3/4" HMA SURFACE COURSE, IL-9.5, MIX "D", N50 1 3/4" - REMOVE SIGN PANEL ASSEMBLY - TYPE A - HMA SURFACE REMOVAL - 2 1/4" POLYMERIZED HMA BINDER COURSE, IL-4.75, N50 - 3/4" 1. PARKWAY RESTORATION IS PAID BY TOPSOIL FURNISH AND PLACE 4", SEEDING CLASS 1A, NITROGEN FERTILIZER, POTASSIUM FERTILIZER, AND EROSION CONTROL BLANKET. HMA SURFACE COURSE, IL-9.5, MIX "D", N50 1 3/4" HART ROAD - THERMOPLASTIC PAVEMENT MARKING DETECTABLE WARNINGS (TYP) LINE 4" (DOUBLE CENTERLINE) (TYP) PEDESTRIAN RAILING (SEE ADA -EX ROW RAMP HANDRAIL DETAIL) PORTLAND CEMENT CONCRETE SIDEWALK 5" (TYP) AGGREGATE BASE COURSE TYPE B, 4" (TYP) wood sign over s COMBINATION CURB & GUTTER REMOVAL & REPLACEMENT (TYP) THERMOPLASTIC PAVEMENT MARKING - LINE 12" WHITE (10' OR LESS SPACING) (TYP) THERMOPLASTIC PAVEMENT MARKING - LINE 8" WHITE (TYP) THERMOPLASTIC PAVEMENT MARKING - LINE 12" WHITE (3' C-C SPACING) (TYP) HART ROAD HMA SURFACE REMOVAL - BUTT JOINT (TYP) END IMPROVEMENTS HART ROAD (O) STA 40+94 THERMOPLASTIC PAVEMENT MARKING - LINE 4" YELLOW THERMOPLASTIC PAVEMENT MARKING - LINE 24" WHITE (DOUBLE CENTERLINE) (TYP) HMA SURFACE REMOVAL - 2 1/4" POLYMERIZED HMA BINDER COURSE, IL-4.75, N50 - 3/4" -SIDEWALK REMOVAL & PARKWAY RESTORATION (TYP) HMA SURFACE COURSE MIX, IL-9.5, "D", N50 1 3/4" REVISED USER NAME = javila DESIGNED -CW COUNTY **ROADWAY PLAN VILLAGE OF ROUND LAKE, ILLINOIS** DRAWN KAR REVISED BAXTER WOODMAN 22-00086-00-RS LAKE 13 HART ROAD LOT SCALE = 20.0000 ' / in. CHECKED -REVISED HART ROAD IMPROVEMENTS CONTRACT NO. 61L17 SCALE: 1" = 20' SHEET 2 OF 2 SHEETS STA. 27+00 TO STA. 40+25

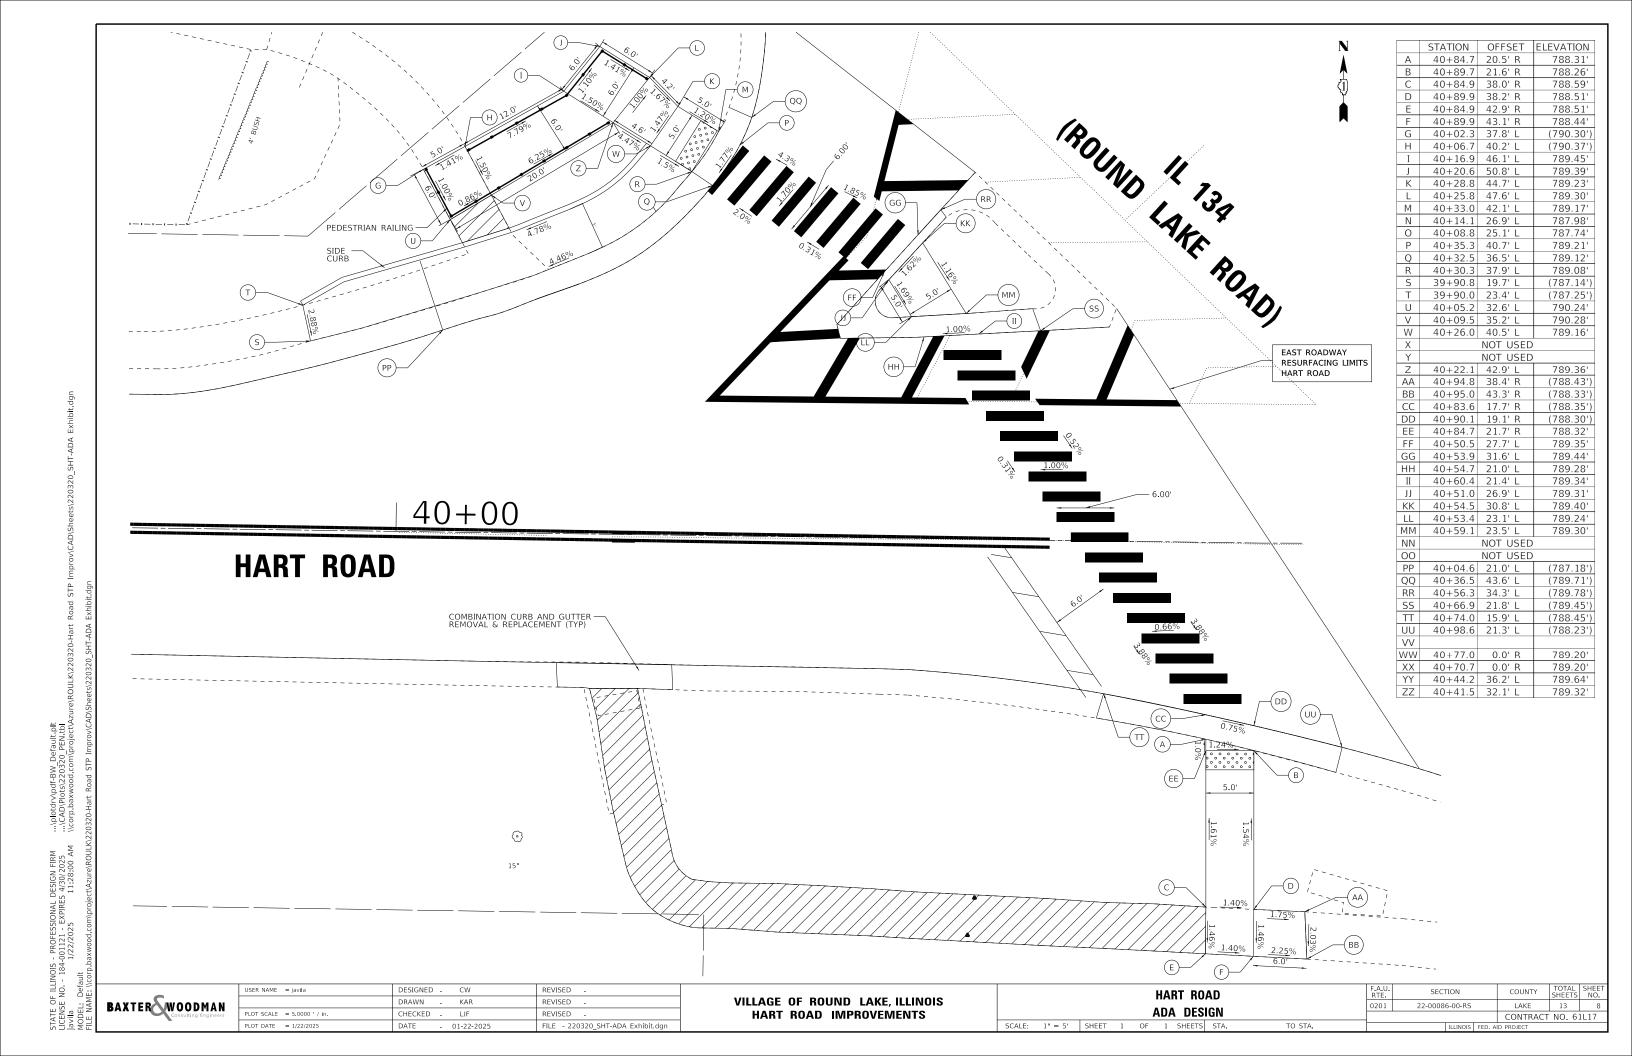

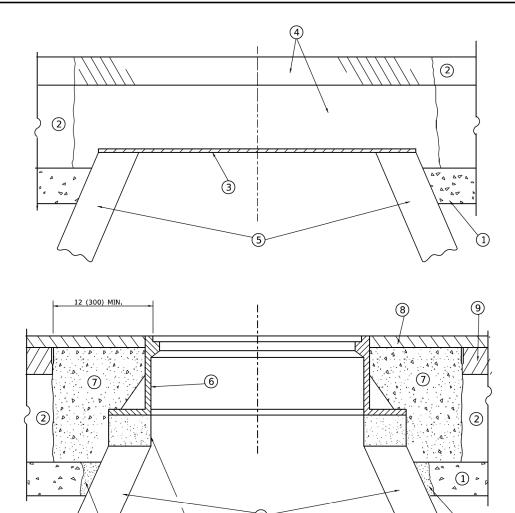

## **DETAILS FOR FRAMES AND LIDS ADJUSTMENT**

BRICK, MORTAR, OR CONC.

ADJUSTING RINGS

- 1. EXISTING BROKEN FRAMES AND LIDS SHALL BE REMOVED AND DISPOSED OF BY THE CONTRACTOR AND SHALL BE REPLACED AS DIRECTED BY THE ENGINEER. REPLACEMENT FRAMES AND LIDS WILL BE PAID FOR IN ACCORDANCE WITH ARTICLE 109.04 OF THE STANDARD SPECIFICATIONS UNLESS A SEPARATE PAY ITEM HAS BEEN PROVIDED.
- 2. IF THE EXISTING LIDS ARE OPEN, THE FRAME WILL BE ADJUSTED TO THE ELEVATION OF THE MILLED PAVEMENT SURFACE PRIOR TO THE MILLING OPERATION. THE FRAME WILL NOT BE REMOVED AND COVERED BY THE METAL PLATE.
- 3. CITY OF CHICAGO CASTINGS ARE THE PROPERTY OF THE CITY AND THE CONTRACTOR SHALL NOTIFY THE CITY FOR REMOVAL AND DISPOSITION OF THE CASTINGS.
- 4. THE METAL PLATE USED TO COVER THE STRUCTURE SHALL REMAIN THE PROPERTY OF THE CONTRACTOR.
- 5. THE CONTRACTOR SHALL REMOVE ALL TRAFFIC CONTROL DEVICES BY THE END OF EACH WORK SHIFT.

### REVISED - R. BORO 03-09-11 JSER NAME = Lawrence.DeManche DESIGNED - R. SHAH DRAWN REVISED - R. BORO 12-06-11 LOT SCALE = 100.0000 ' / in. CHECKED REVISED - K. SMITH 11-18-22 PLOT DATE = 9/15/2023 DATE 10-25-94 REVISED - K. SMITH 09-15-23

### STATE OF ILLINOIS **DEPARTMENT OF TRANSPORTATION**

## **CONSTRUCTION PROCEDURES**

### STAGE 1 (BEFORE PAVEMENT MILLING)

- A) REMOVE A MINIMUM OF 12 (300) OF THE PAVEMENT FROM AROUND THE STRUCTURE.
- B) REMOVE THE EXISTING FRAME AND LID FROM THE STRUCTURE.
- C) COVER THE STRUCTURE OPENING WITH A 36 (900) DIAMETER
- D) BACKFILL WITH CRUSHED STONE AND HMA SURFACE MIX APPROVED BY THE ENGINEER. (MIN. 3 (80) HMA TO REMAIN AFTER MILLING).

### STAGE 2 (AFTER PAVEMENT MILLING)

- A) REMOVE THE HMA SURFACE MIX AND CRUSHED STONE.
- B) INSTALL THE FRAME AND LID; ADJUST THE FRAME TO ITS FINAL SURFACE ELEVATION.
- C) THE SURROUNDING SPACE SHALL BE FILLED WITH CLASS PP-2\* CONCRETE TO THE ELEVATION OF THE SURFACE OF THE EXISTING BASE COURSE OR THE BINDER COURSE.
- \*UNLESS OTHERWISE SPECIFIED IN THE PLANS.

THE PROCEDURE EXPLAINED ABOVE SHALL CONFORM TO THE APPLICABLE PORTIONS OF SECTIONS 353, 406, 602, AND 603 OF THE STANDARD SPECIFICATIONS EXCEPT THAT "THE CONTRACTOR SHALL ADJUST THE STRUCTURES TO THE FINISHED PAVEMENT ELEVATION NO MORE THAN 5 CALENDAR DAYS PRIOR TO PLACEMENT OF THE FINAL LIFT OF SURFACE UNLESS APPROVED BY THE ENGINEER." **LEGEND** 

## 1 SUB-BASE GRANULAR MATERIAL

(6) FRAME AND LID (SEE NOTES)

(2) EXISTING PAVEMENT

(7) CLASS PP-2\* CONCRETE

3 36 (900) DIAMETER METAL PLATE

(8) PROPOSED HMA SURFACE COURSE

4 PROPOSED CRUSHED STONE AND HMA SURFACE MIX

(9) PROPOSED HMA BINDER COURSE

(5) EXISTING STRUCTURE

### **LOCATION OF STRUCTURES**


THE CONTRACTOR WILL BE REQUIRED TO KEEP A RECORD OF THE LOCATIONS OF THE BURIED STRUCTURES ACCORDING TO THE STATION AND DISTANCE LEFT OR RIGHT OF THE CENTERLINE OF PAVEMENT. UPON COMPLETION OF THE WORK, THE CONTRACTOR WILL DELIVER THE RECORD TO THE ENGINEER.

### **BASIS OF PAYMENT**

- 1. REMOVING FRAMES AND LIDS ON DRAINAGE AND UTILITY STRUCTURES IN THE PAVEMENT PRIOR TO MILLING, AND ADJUSTING TO FINAL GRADE PRIOR TO PLACING THE SURFACE COURSE, WILL BE PAID FOR AT THE CONTRACT UNIT PRICE EACH FOR "FRAMES AND LIDS TO BE ADJUSTED (SPECIAL)."
- 2. THIS WORK WILL NOT BE PAID FOR WHEN DRAINAGE AND UTILITY STRUCTURES ARE SPECIFIED FOR PAYMENT AS STRUCTURE RECONSTRUCTION.
- 3. NEW FRAMES AND LIDS, WHEN SPECIFIED, WILL BE PAID FOR SEPARATELY.
- 4. WHEN STRUCTURES ARE TO BE ADJUSTED OR RECONSTRUCTED, THE LOWERING AND RAISING OF THE FRAMES AND LIDS WILL NOT BE PAID FOR SEPARATELY BUT WILL BE INCLUDED IN THE COST OF THE CORRESPONDING PAY ITEM.

ALL DIMENSIONS ARE IN INCHES (MILLIMETERS) UNLESS OTHERWISE SHOWN

DETAILS FOR 22-00086-00-RS LAKE 13 FRAMES AND LIDS ADJUSTMENT WITH MILLING CONTRACT NO. 61L17 BD600-03 (BD-08) SHEET 1 OF 1 SHEETS STA.

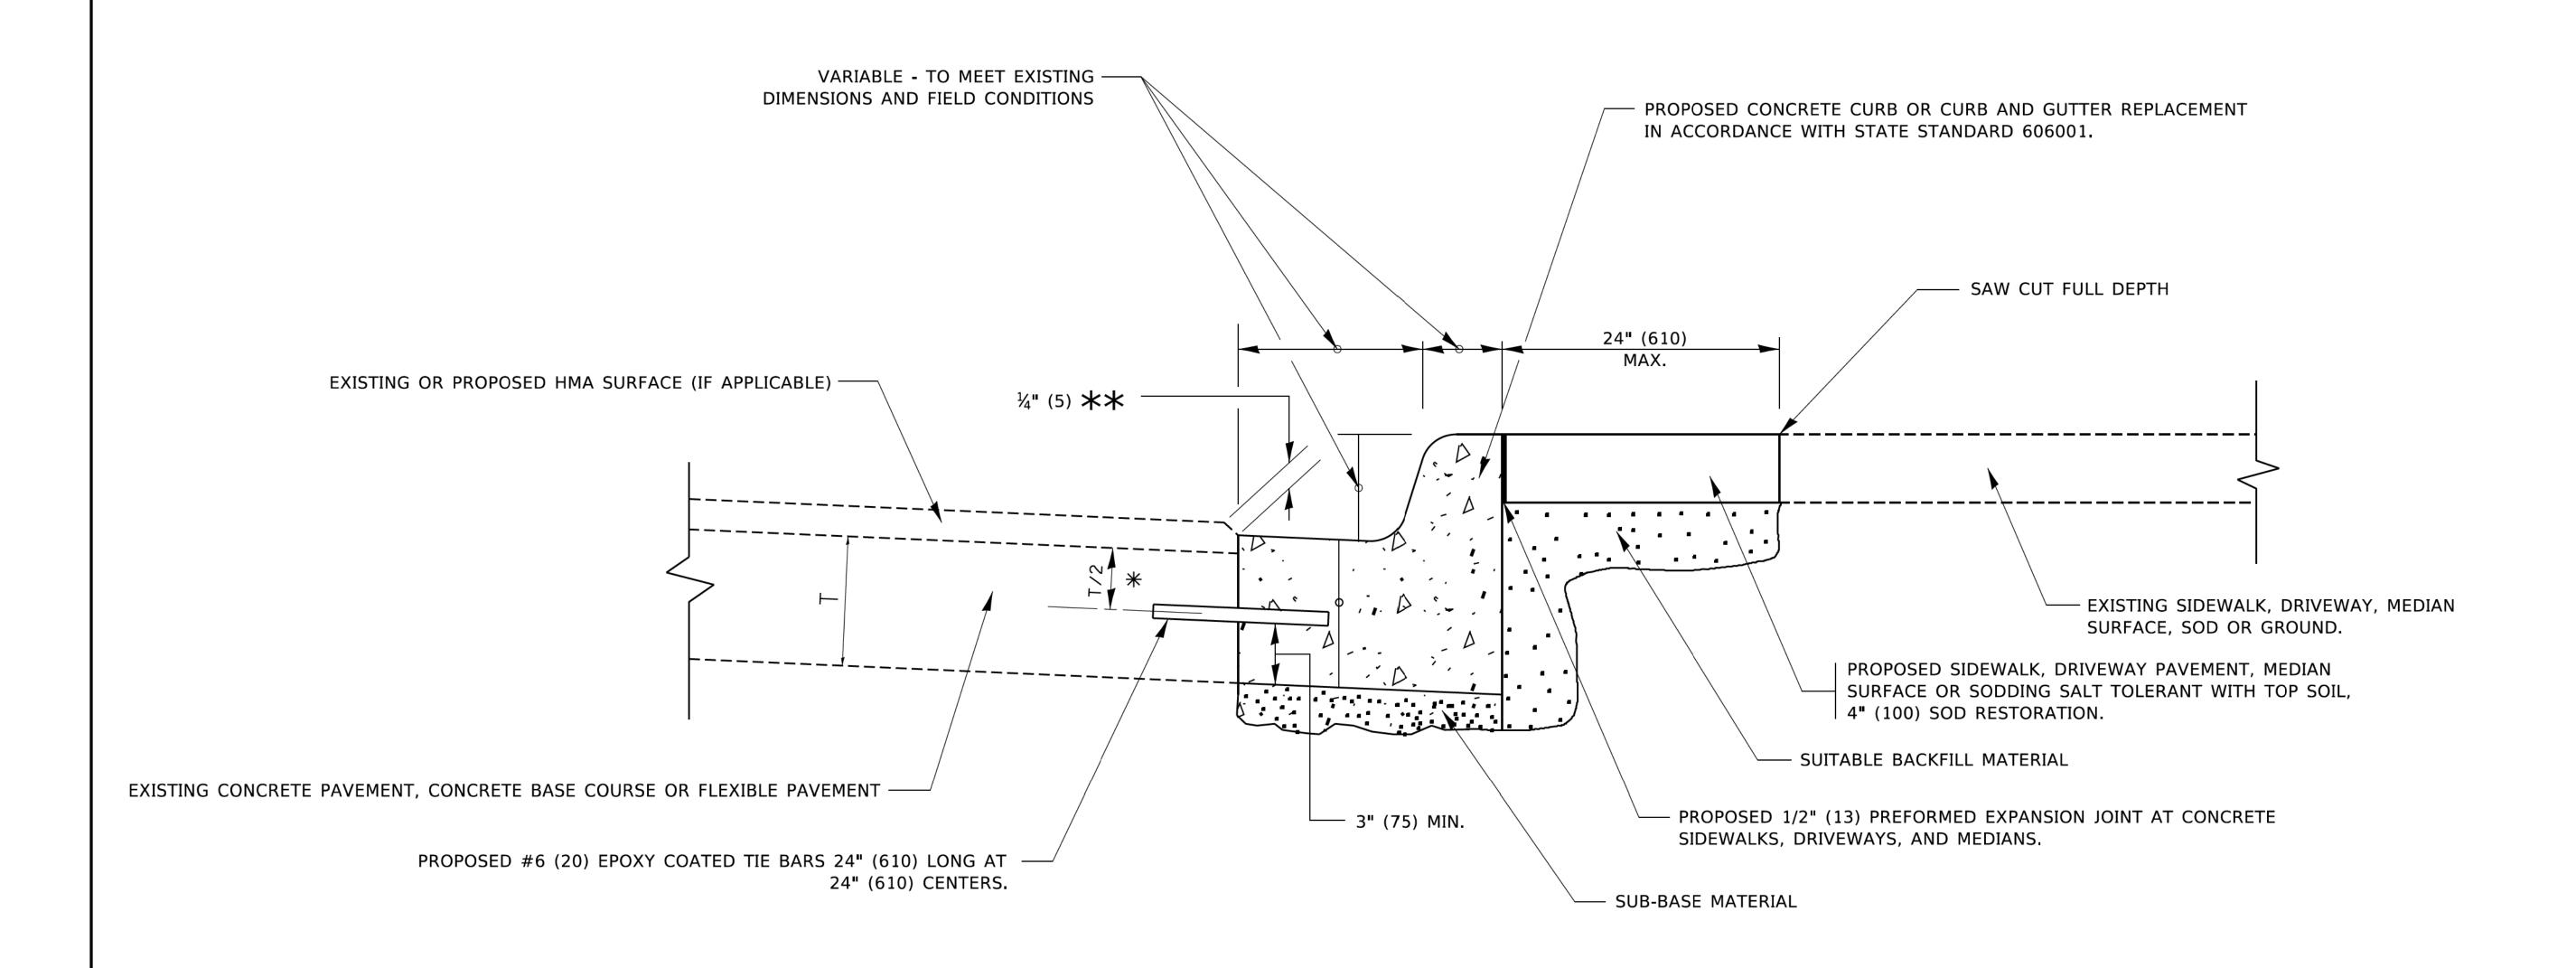

- ★ 3" (75) MINIMUM FROM TOP AND BOTTOM OF THE CONCRETE PAVEMENT OR BASE COURSE.
- \*\* IF THE FINAL SURFACE OF THE PAVEMENT IS CONCRETE, THE GUTTER IS TO BE FLUSH WITH THE PAVEMENT.


## CURB OR CURB AND GUTTER REMOVAL AND REPLACEMENT

ALL DIMENSIONS ARE IN INCHES (MILLIMETERS) UNLESS OTHERWISE SHOWN.

USER NAME = footemj	DESIGNED - A. HOUSEH	REVISED - A. ABBAS 03-21-97			CURB OR CURB AND GUTTER	F.A. RTE.	SECTION	COUNTY	TOTAL   SHEF   SHEETS   NC	<u>-</u> ΕΤ Ι Ο.
	DRAWN -	REVISED - M. GOMEZ 01-22-01	STATE OF ILLINOIS		REMOVAL AND REPLACEMENT	0201	22-00086-00-RS	LAKE	13 9a	a
PLOT SCALE = 50.0000 ' / in.	CHECKED -	REVISED - R. BORO 12-15-09	DEPARTMENT OF TRANSPORTATION		NEIVIOVAL AND NEPLAGEIVIENT		BD600-06 (BD-24)	CONTRAC	T NO. 61L17	
PLOT DATE = 7/11/2019	DATE - 03-11-94	REVISED - K. SMITH 07-11-19		SCALE: NONE	SHEET 1 OF 1 SHEETS STA. TO STA.		ILLINOIS FED. A	ID PROJECT		

(FOR BUTT JOINT AND HMA TAPER SEE DETAIL BELOW)


### OPTION 1

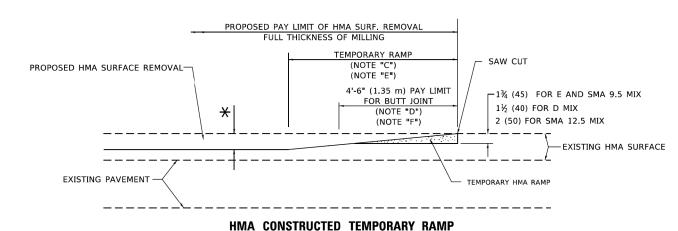

(FOR BUTT JOINT AND HMA TAPER SEE DETAIL BELOW)

### OPTION 2

## TYPICAL TEMPORARY RAMP

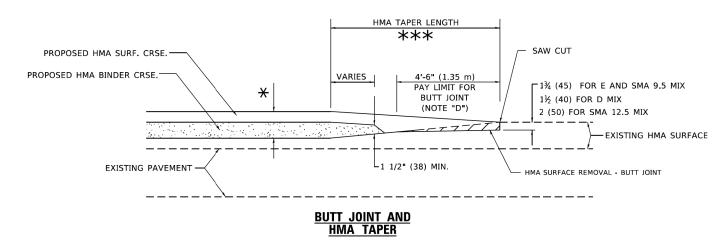


## TYPICAL BUTT JOINT AND HMA TAPER FOR MILLING AND RESURFACING

USER NAME = Lawrence.DeManche DESIGNED - M. DE YONG DRAWN PLOT SCALE = 100,0000 ' / in, CHECKED -REVISED -PLOT DATE = 11/18/2022 REVISED - K. SMITH 11-18-22 DATE

**DEPARTMENT OF TRANSPORTATION** 

SECTION COUNTY **BUTT JOINT AND** 22-00086-00-RS **HMA TAPER DETAILS** BD400-05 BD-32 SCALE: NONE SHEET 1

PROPOSED HMA OR PCC SURFACE REMOVAL - BUTT JOINT 30'-0" (9.0 m) (NOTE "A") EXISTING HMA OR PCC SURFACE -SAW CUT 15'-0" (4.5 m) (NOTE "B") (NOTE "D") 40'-0" (12.0M) (NOTE "A1") -1¾ (45) FOR E AND SMA 9.5 MIX 1½ (40) FOR D MIX 2 (50) FOR SMA 12.5 MIX \* \* EXISTING PAVEMENT **BUTT JOINT DETAIL** 

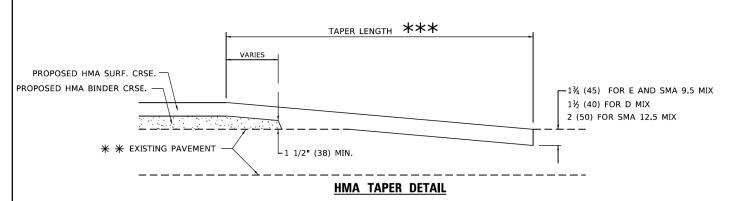

## **TYPICAL BUTT JOINT AND HMA TAPER** FOR RESURFACING ONLY

\*\* PC CONCRETE, HMA OR HMA RESURFACED PAVEMENT.

### **GENERAL NOTES**

- A. MAINLINE ARTERIAL ROADWAYS AND MAJOR SIDE ROADS.
- A1. INTERSTATES
- B. MINOR SIDE ROADS.
- C. THE TEMP. RAMP SHALL BE CONSTRUCTED IMMEDIATELY UPON REMOVAL OF THE EXISTING HMA SURFACE.
- D. THE BUTT JOINT SHALL BE CONSTRUCTED IMMEDIATELY PRIOR TO PLACING THE PROPOSED HMA COURSES.
- E. TAPER THE TEMP. RAMP AT A RATE OF 3' 4" (1.02m) PER 1 INCH (25 mm) OF MILLING THICKNESS.
  - \* SEE TYPICAL SECTIONS FOR MILLING THICKNESS.
- F. SEE ARTICLE 406.08 AND 406.14 OF THE STANDARD SPECIFICATIONS FOR "HMA AND/OR PCC SURFACE REMOVAL, BUTT JOINT".
- \*\*\* 20'-0" (6.1 m) PER 1 (25) RESURFACING (NOTE "A") 10'-0" (3.0 m) PER 1 (25) RESURFACING (NOTE "B")

### **BASIS OF PAYMENT**

- THE BUTT JOINT WILL BE PAID FOR AT THE CONTRACT UNIT PRICE PER SQUARE YARD (SQUARE METER) FOR "HOT-MIX ASPHALT SURFACE REMOVAL BUTT JOINT" OR FOR "PORTLAND CEMENT CONCRETE SURFACE REMOVAL- BUTT JOINT".
- THE TEMPORARY RAMP AND SAW CUT SHALL BE INCLUDED IN THE UNIT COST FOR HMA OR PCC SURFACE REMOVAL-BUTT JOINT.


ALL DIMENSIONS ARE IN INCHES (MILLIMETERS) UNLESS OTHERWISE SHOWN.

13 10

STATE OF ILLINOIS

LAKE CONTRACT NO. 61L17 OF 1 SHEETS STA. TO STA.

REVISED - M. GOMEZ 04-06-01 R. BORO 01-01-07

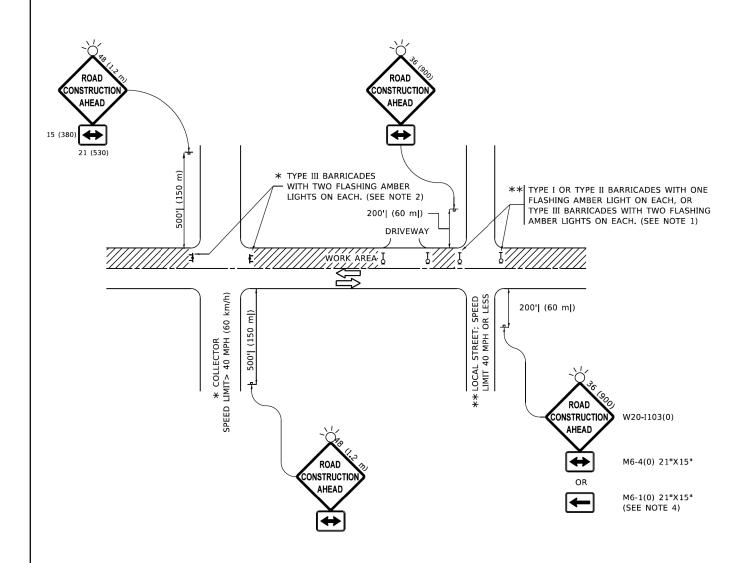

### NOTES:

- 1. SIDE ROAD WITH A SPEED LIMIT OF 40 MPH (60 km/h) OR LESS AS SHOWN ON THE DRAWING AND AS DIRECTED BY THE ENGINEER:
- a) ONE "ROAD CONSTRUCTION AHEAD" SIGN 36 x 36 (900x900) WITH A FLASHER MOUNTED ON IT APPROXIMATELY 200' (60 m) IN ADVANCE OF THE MAIN ROUTE.
- b) THE CLOSED PORTION OF THE MAIN ROUTE SHALL BE PROTECTED BY BLOCKING WITH TYPE I, TYPE II OR TYPE III BARRICADES, 1/3 OF THE CROSS SECTION OF THE CLOSED PORTION.
- 2. SIDE ROAD WITH A SPEED LIMIT GREATER THAN 40 MPH (60 km/h) AS SHOWN ON THE DRAWING AND AS DIRECTED BY THE ENGINEER:
- a) ONE "ROAD CONSTRUCTION AHEAD" SIGN 48 x 48 (1.2 m x 1.2 m) WITH A FLASHER MOUNTED ON IT APPROXIMATELY 500' (150 m) IN ADVANCE OF THE MAIN POLITE
- THE CLOSED PORTION OF THE MAIN ROUTE SHALL BE PROTECTED BY
  b) BLOCKING WITH TYPE III BARRICADES, 1/2 OF THE CROSS SECTION
  OF THE CLOSED PORTION.
- 3. CONES MAY BE SUBSTITUTED FOR BARRICADES OR DRUMS AT HALF THE SPACING DURING DAY OPERATIONS. CONES SHALL BE A MINIMUM OF 28 (710)
  IN HEIGHT
- WHEN THE SIDE ROAD LIES BETWEEN THE BEGINNING OF THE MAINLINE
  4. SIGNING AND THE WORK ZONE, A SINGLE HEADED ARROW (M6-1) SHALL
  BE USED IN LIEU OF THE DOUBLE HEADED ARROW (M6-4).

- WHEN WORK IS BEING PERFORMED ON A SIDE ROAD OR DRIVEWAY, FOLLOW THE APPLICABLE STANDARD(S). THE DIRECTIONAL ARROW (M6-1 OR M6-4) SHALL BE COVERED OR REMOVED WHEN NO LONGER CONSISTENT WITH THE TRAFFIC CONTROL SET-UP.
- 6. ADVANCE WARNING SIGNS ARE TO BE OMITTED ON DRIVEWAYS UNLESS OTHERWISE SPECIFIED IN THE PLANS OR BY THE ENGINEER
- 7. THE TRAFFIC CONTROL AND PROTECTION FOR SIDE ROADS, INTERSECTIONS, AND DRIVEWAYS SHALL BE INCLUDED IN THE COST OF SPECIFIED TRAFFIC CONTROL STANDARDS OR ITEMS.


All dimensions are in inches (millimeters) unless otherwise shown.

USER NAME = Lawrence.DeManche	DESIGNED - L.H.A.	REVISED - T. RAMMACHER 01-06-00
	DRAWN -	REVISED - A. SCHUETZE 07-01-13
PLOT SCALE = 100,0000 ' / in.	CHECKED -	REVISED - A. SCHUETZE 09-15-16
PLOT DATE = 5/3/2024	DATE - 06-89	REVISED - D. SENDERAK 05-03-24

STATE OF ILLINOIS
DEPARTMENT OF TRANSPORTATION

SI	DE RO	ADS	S, INT	ERS	L AND Section	IS, AND	 	
	SHEET	1	OF	1	SHEET	S STA.	то	STA

	ILLINOIS	FED. A	ID PROJECT		
	TC-10	CONTRACT	NO. 61	_17	
0201	22-00086-00-RS	LAKE	13	11	
F.A. RTE.	SECTION	COUNTY	TOTAL SHEETS	SHE	

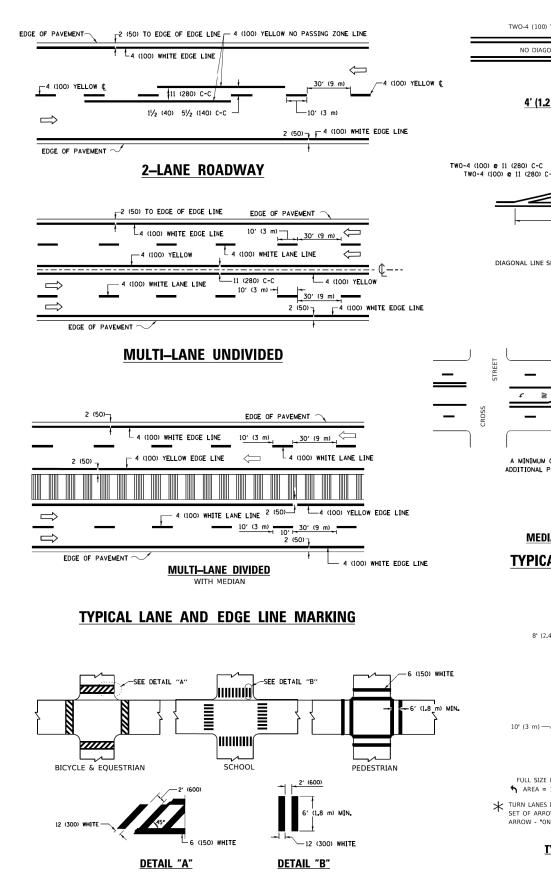

TYPICAL CROSSWALK MARKING

USER NAME = footemj

PLOT SCALE = 50.0000 ' / in.

\* MARKINGS SHALL BE INSTALLED PARALLEL TO THE CENTERLINE OF THE ROAD WHICH IT CROSSES

DESIGNED - EVERS


DRAWN

DATE

CHECKED


4' (1.2 m) OUTSIDE TO OUTSIDE OF LINES —TWO-4 (100) YELLOW @ 11 (280) C-C 4' (1.2 m) WIDE MEDIANS ONLY **VARIES** 12 (300) DIAGONALS 12 (300) WHITE DIAGONALS @ 10' (3 m) OR LESS SPACING TWO-4 (100) € 11 (280) C-E-ISLAND OFFSET FROM PAVEMENT EDGE FOR MEDIAN LENGTHS WHERE DIAGONAL SPACING CANNOT BE ATTAINED, USE 5 (FIVE) EQUALLY SPACED DIAGONAL LINES. DIAGONAL LINE SPACING: 50' (15 m) C-C (LESS THAN 30MPH (50 km/h)) 75' (25 m) C-C 30MPH (50 km/h) TO 45MPH (70 km/h)) 8 (200) WHITE -MEDIANS OVER 4' (1.2 m) WIDE 4 (100) YELLOW LINES (5½ (140) C-C)

4 (100) YELLOW LINES TWO-4 (100) YELLOW @ 11 (280) C-C (5½ (140) C-C) A MINIMUM OF TWO PAIRS OF TURN ARROWS SHALL BE USED, WHITE IN COLOR, ADDITIONAL PAIRS SHALL BE PLACED AT 200' (60 m) TO 300' (90 m) INTERVALS

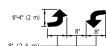

## MEDIAN WITH TWO-WAY LEFT TURN LANE

## TYPICAL PAINTED MEDIAN MARKING

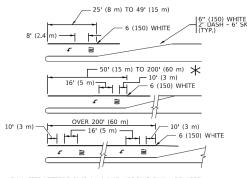

 $\uparrow$  AREA = 15.6 SQ. FT. (1.5 m<sup>2</sup>) AREA = 20.8 SQ. FT. (1.9 m)<sup>2</sup>

\* TURN LANES IN EXCESS OF 400' (120 m) IN LENGTH MAY HAVE AN ADDITIONAL SET OF ARROW - "ONLY" INSTALLED MIDWAY BETWEEN THE OTHER TWO SETS OF

### TYPICAL LEFT (OR RIGHT) TURN LANE

### TYPICAL TURN LANE MARKING

REVISED - C. JUCIUS 09-09-09

REVISED - C. JUCIUS 07-01-13

C. JUCIUS 12-21-15

REVISED -

STATE OF ILLINOIS **DEPARTMENT OF TRANSPORTATION** 

COMBINATION LEFT AND U-TURN 2 (50) 5'-4" (1620) 2 (50) LANE REDUCTION TRANSITION \* LANE REDUCTION ARROWS REQUIRED AT SPEEDS OF 45 MPH OF GREATER OR WHEN SPECIFIED IN PLANS. **U-TURN** WIDTH OF LINE PATTERN COLOR SPACING / REMARKS YELLOW 10' (3 m) LINE WITH 30' (9 m) SPACE 5½ (140) C-C FROM SKIP-DASH CENTERLINE 11 (280) C-C OMIT SKIP-DASH CENTERLINE BETWEEN SKIP-DASH SKIP-DASH 10' (3 m) LINE WITH 30' (9 m) SPACE (125) ON FREEWAYS SAME AS LINE BEING EXTENDED SKIP-DASH SAME AS LINE BEING EXTENDED 2' (600) LINE WITH 6' (1.8 m) SPACE SOLID YELLOW-LEFT WHITE-RIGHT OUTLINE MEDIANS IN YELLOW 6 (150) LINE; FULL SIZE LETTERS & SYMBOLS (8' (2.4m)) SOLID SEE TYPICAL TURN LANE MARKING DETAIL WHITE 2 @ 4 (100) EACH DIRECTION YELLOW 10' (3 m) LINE WITH 30' (9 m) SPACE FOR SKIP-DASH; 5½ (140) C-C BETWEEN SOLID LINE AND SKIP-DASH LINE SEE TYPICAL TWO-WAY LEFT TURN MARKING DETAIL

D(FT)

665

750

SPEED LIMIT

FOR FURTHER DETAILS ON PAVEMENT MARKING REFER TO STANDARD SPECIFICATIONS FOR ROAD AND BRIDGE CONSTRUCTION AND STATE STANDARD 780001.

4 (100)

24 (600)

2 @ 4 (100) WITH 12 (300) DIAGONALS

NO DIAGONALS USED FOR 4' (1.2 m) WIDE MEDIANS

8 (200) WITH 12 (300) DIAGONALS @ 45°

24 (600) TRANSVERSE LINES; "RR" IS 6' (1.8 m) LETTERS; 16 (400) LINE FOR "X"

12 (300) @ 45°

SEE DETAIL

SOLID

SOLID

SOLID

SOLID

SOL TO

WHITE

WHITE

WHITE

WHITE - RIGHT YELLOW - LEFT

YELLOW: TWO WAY TRAFFIC

WHITE: ONE WAY TRAFFIC

unless otherwise shown.

SECTION

LAKE

CONTRACT NO. 61L17

13 12

22-00086-00-RS

TC-13

NOT LESS THAN 6' (1.8 m) APART 2' (600) APART

SEE TYPICAL CROSSWALK MARKING DETAILS.

PLACE 4' (1.2 m) IN ADVANCE OF AND PARALLEL TO CROSSWALK, IF PRESENT, OTHERWISE, PLACE AT DESIRED STOPPING POINT, PARALLEL TO CROSSROAD CENTERLINE, WHERE

DIAGONALS: 15' (4.5 m) C-C (LESS THAN 30MPH (50 km/h)) 20' (6 m) C-C 30MPH (50 km/h) TO 45MPH (70 km/h)) 30' (9 m) C-C (OVER 45MPH (70 km/h))

50' (15 m) C-C (LESS THAN 30MPH (50 km/h)) 75' (25 m) C-C (30 MPH (50 km/h) TO 45MPH (70 km/h)) 150' (45 m) C-C (OVER 45MPH (70 km/h))

11 (280) C-C FOR THE DOUBLE LINE SEE TYPICAL PAINTED MEDIAN MARKING.

SEE STATE STANDARD 780001

30.4 SF

DISTRICT ONE TYPICAL PAVEMENT MARKINGS OF 2 SHEETS STA. SCALE: NONE SHEET 1

SHOULDER DIAGONALS (REQUIRED FOR SHOULDERS > 8')

8 (200) WHITE -

ISLAND AT PAVEMENT EDGE

TYPICAL ISLAND MARKING

TYPE OF MARKING

CENTERLINE ON 2 LANE PAVEMENT

(EXTENSIONS OF CENTER, LANE OR TURN LANE MARKINGS)

NO PASSING ZONE LINES: FOR ONE DIRECTION FOR BOTH DIRECTIONS

LANE LINES

EDGE LINES

STOP LINES

PAINTED MEDIANS

RAILROAD CROSSING

U TURN ARROW

2 ARROW COMBINATION LEFT AND U TURN

TURN LANE MARKINGS

TWO WAY LEFT TURN MARKING

CROSSWALK LINES (PEDESTRIAN) A. DIAGONALS (BIKE & EQUESTRIAN) B. LONGITUDINAL BARS (SCHOOL)

DOTTED LINES

RAISED

## NOTES:

- 1. USE BLACK LETTERING ON ORANGE BACKGROUND.
- 2. ERECT SIGNS IN ADVANCE OF THE LOCATION FOR THE "ROAD CONSTRUCTION AHEAD" SIGN AT LOCATIONS AS DIRECTED BY THE ENGINEER.
- 3. ERECT SIGN 1 WITH INSTALLED PANEL 2 ONE WEEK PRIOR TO THE START OF CONSTRUCTION.
- 4. REMOVE PANEL 2 SOON AFTER THE START OF CONSTRUCTION.
- 5. SEE SPECIAL PROVISION FOR "TEMPORARY INFORMATION SIGNING" FOR ADDITIONAL INFORMATION.
- 6. ONE SIGN ASSEMBLY EQUALS 25.70 SQ. FT. (2.3 SQ. M.)

SCALE: NONE


7. SHALL BE PAID FOR AS TEMPORARY INFORMATION SIGNING.

ALL DIMENSIONS ARE IN INCHES (MILLIMETERS) UNLESS OTHERWISE SHOWN.

USER NAME = footemj	DESIGNED -	REVISED	- R. MIRS 09-15-97
	DRAWN -	REVISED	- R. MIRS 12-11-97
PLOT SCALE = 50.0000 ' / in.	CHECKED -	REVISED	-T. RAMMACHER 02-02-99
PLOT DATE = 3/4/2019	DATE -	REVISED	- C IUCIUS 01-31-07


STATE O	F ILLINOIS
DEPARTMENT OF	TRANSPORTATION

			ART	ERIAL RO	AD		F.A. RTE.	SECTION
		IM	-NR	MATION	SIGN		0201	22-00086-00-RS
		1141	UII	WAIION	JIGIN			TC-22
SHEET	1	OF	1	SHEETS	STA.	TO STA.		ILLINOIS

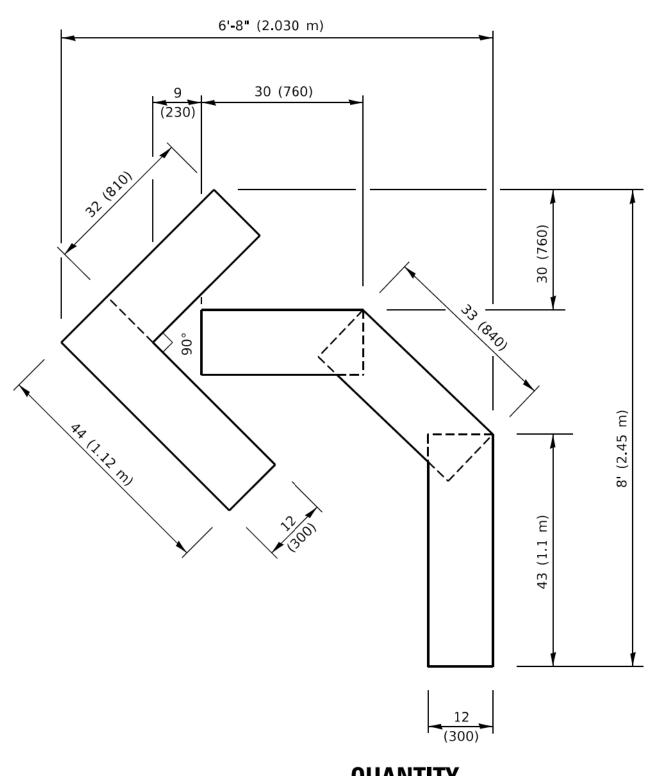

## **QUANTITY**

4 (100) LINE = 45.5 ft. (13.9 m) 15.2 sq. ft. (1.41 sq. m)

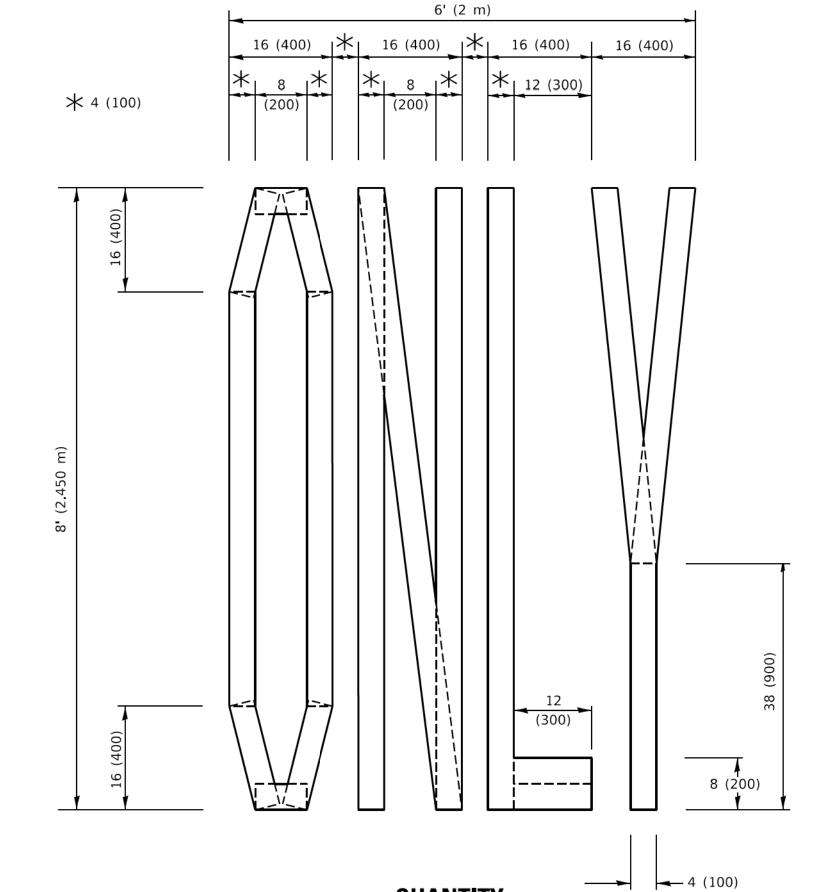

4 (100) LINE = 64.1 ft. (19.5 m) 21.4 sq. ft. (1.99 sq. m)

DESIGNED -

CHECKED -

- 09-18-94

DRAWN


DATE

**QUANTITY** 

USER NAME = footemj

PLOT DATE = 3/4/2019

PLOT SCALE = 50.0068 ' / in.

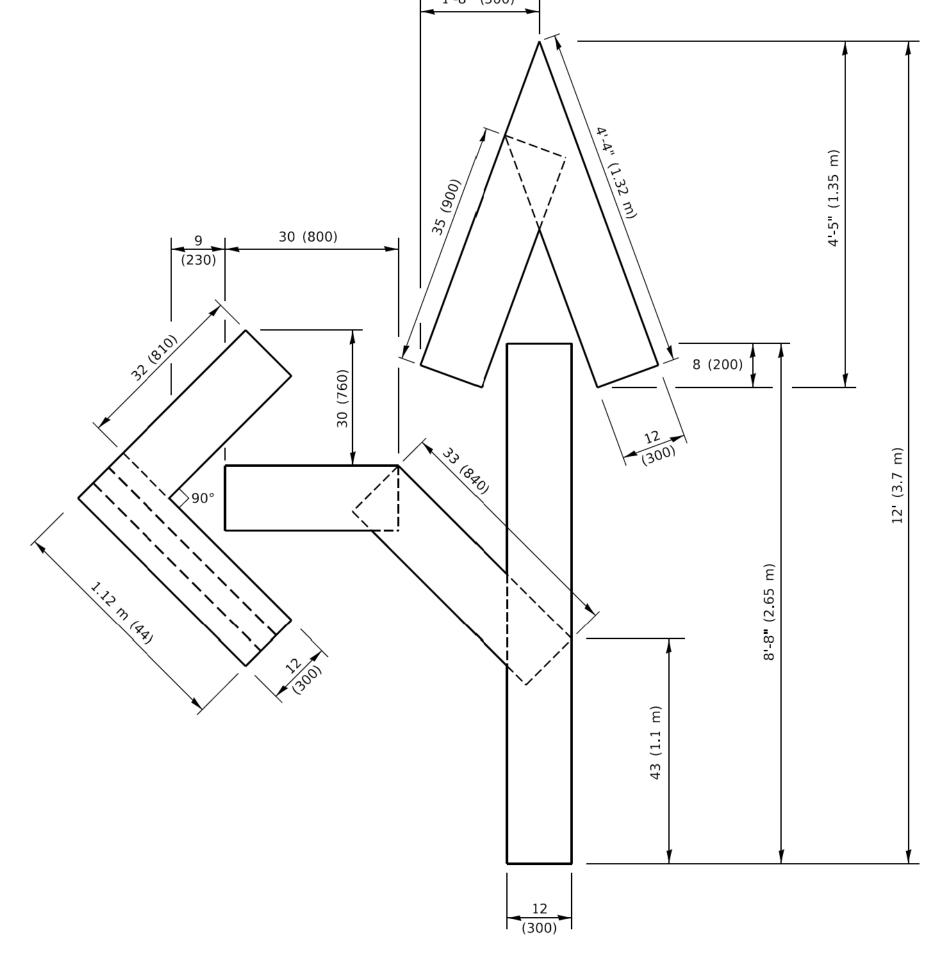


## **QUANTITY**

4 (100) LINE = 82.5 ft. (25.1 m) 27.5 sq. ft. (2.53 sq. m)

## NOTE:

ALL QUANTITIES OF PLACEMENT ARE REPRESENTED IN LINEAR FEET OF 4" LINES TO MATCH THE 4" TEMPORARY TAPE PAY ITEM AND REPRESENTS THE TOTAL QUANTITY OF 4" TAPE REQUIRED.

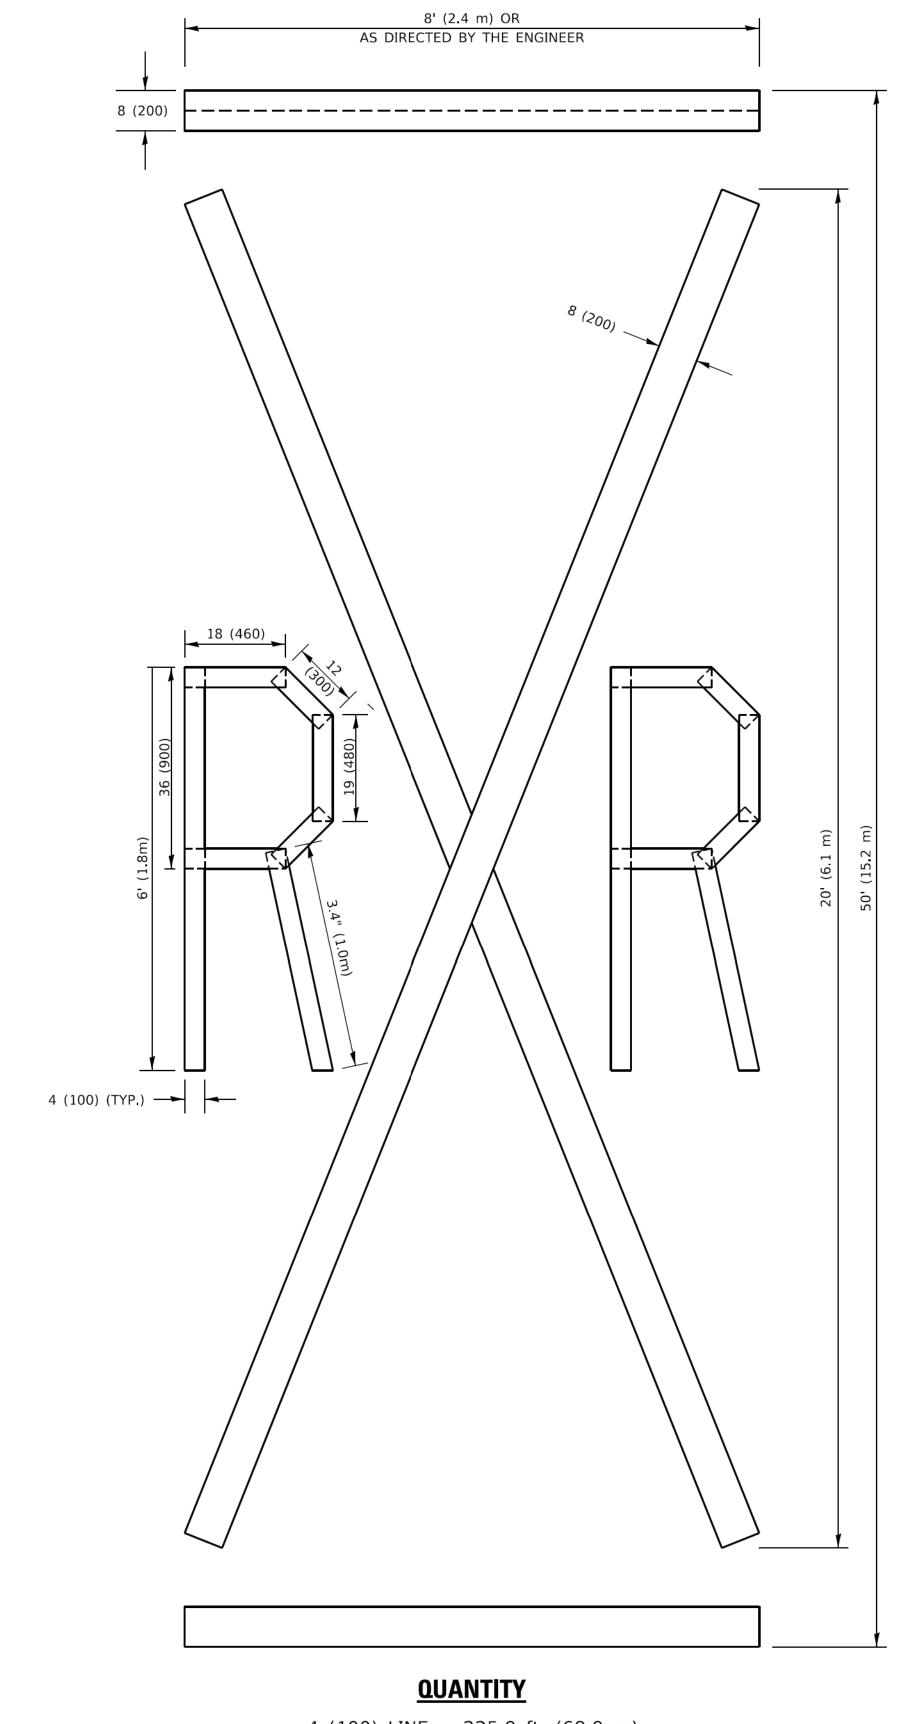

4 (100) LINE = 225.9 ft. (68.9 m) 75.3 sq. ft. (6.99 sq. m)

All dimensions are in inches (millimeters) unless otherwise shown.

REVISED - T. RAMMACHER 03-02-98

REVISED - E. GOMEZ 08-28-00

REVISED - E. GOMEZ 08-28-00

REVISED - A. SCHUETZE 09-15-16

STATE OF ILLINOIS
DEPARTMENT OF TRANSPORTATION

SHORT TERM PAVEMENT MARKING LETTERS AND SYMBOLS

SCALE: NONE SHEET 1 OF 1 SHEETS STA. TO STA.


 F.A. RTE.
 SECTION
 COUNTY
 TOTAL SHEETS NO.

 0201
 22-00086-00-RS
 LAKE
 13
 13a

 TC-16
 CONTRACT NO.61L17

 ILLINOIS FED. AID PROJECT

16.dan 3/4/2019 10:37:35 AM User=foote

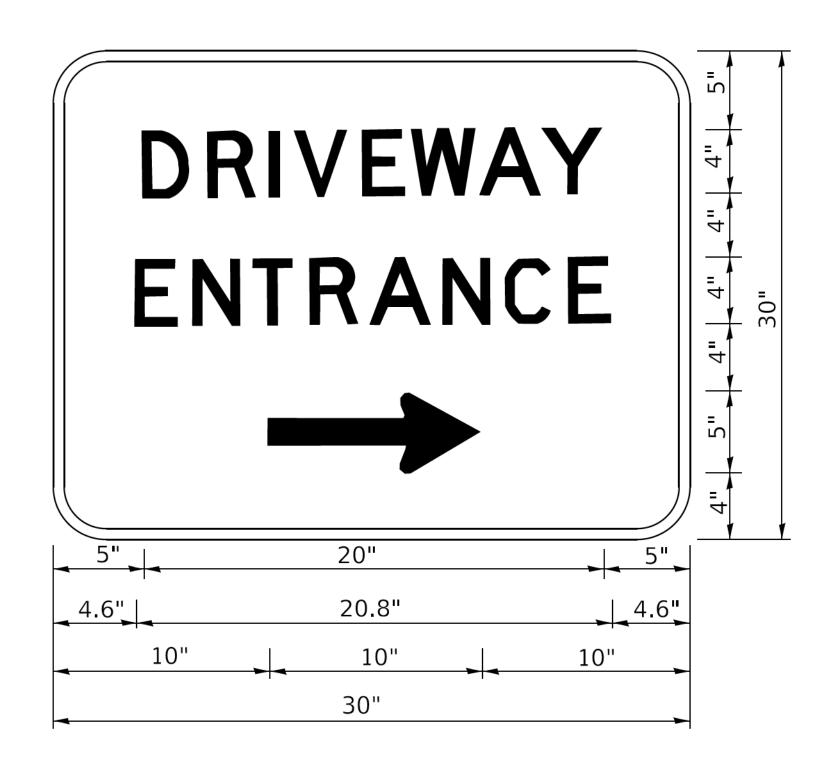

3.0" RADIUS, 0.5" BORDER, WHITE ON GREEN; REFLECTORIZED "DRIVEWAY" D; "ENTRANCE" D; STANDARD ARROW CUSTOM 12.0" x 5.0"

## NOTES:

- 1. HALF OF THE SIGNS WILL REQUIRE A LEFT HAND FACING ARROW.
- 2. TWO SIGNS SHALL BE USED AT EACH COMMERCIAL ENTRANCE PLACED BACK-TO-BACK: ONE WITH A RIGHT HAND ARROW (SHOWN) SHALL BE PLACED ON THE NEAR RIGHT SIDE THE DRIVEWAY AND ONE WITH A LEFT HAND ARROW SHALL BE PLACED ON THE FAR LEFT SIDE OF THE DRIVEWAY.
- 3. SIGNS TO BE PAID FOR AS ITEM "TEMPORARY INFORMATION SIGNING".

USER NAME = leysa	DESIGNED -	REVISED -	C. JUCIUS 02-15-07
	DRAWN -	REVISED -	
PLOT SCALE = 50.0000 ' / in.	CHECKED -	REVISED -	
PLOT DATE = 8/6/2021	DATE -	REVISED -	

STATE OF ILLINOIS
DEPARTMENT OF TRANSPORTATION

SCALE: NONE

DDIVENAV ENTRANCE CICNING					F.A. RTE.	SECTIO	ON		COUNTY TOTAL SHEETS		SHEET NO.	
	DRIVEWAY ENTRANCE SIGNING					0201 22-00086-00-RS L			LAKE	13	13b	
						TC-26			CONTRACT	NO. 61L	_17	
	SHEET 1	OF 1	SHEETS	STA.	TO STA.		ILLINOIS FED. AID PROJECT			D PROJECT		