FOR INDEX OF SHEETS, SEE SHEET NO. 2

FOR HIGHWAY STANDARDS, SEE SHEET NO. 2

STATE OF ILLINOIS **DEPARTMENT OF TRANSPORTATION DIVISION OF HIGHWAYS** 

# **PLANS FOR PROPOSED**

# FEDERAL AID HIGHWAY

**F.A.U. ROUTE 2619 (GRACE STREET)** FROM FAU 1380 (FULLERTON AVENUE) TO **FAP 308 (ILLINOIS ROUTE 64 NORTH AVÉNUE)** 

> PROJECT NO. M-8003(736) SECTION NO.: 06-00096-00-RS

**DUPAGE COUNTY** JOB NO.: C-91-100-07

PROJECT NUMBER: M-8003(736) F.A.U. 2619 SOUTH GRACE STREET END RESURFACING

STA. 46+11

**LOCATION MAP** R. 11 E. FULLERTON FULLERTON AV NTERSTATE RD LOMBARD KAY AVENUE NORTH

WHITESIDE BUREAU WILL STARK KANKAKEE MARSHALL PEORIA WOODFORD IROQUOIS TAZEWELL SCHUTLER DE WITT HAMPAIGN ADAMS MENARD DOUGLAS MOULTRIE CHRISTIAN COLES SHELBY HILLSBORO JERSEY FAYETTE JASPER CLAY CLINTON ST. CLAIR JEFFERSON

F.A.U. ROUTE NO.

ILLINOIS PROJECT

C-91-100-07

SECTION

2619 06-00096-00-RS

CONTRACT NO.: 83990

TOTAL SHEETS

24

M-8003 (736)

24-1-23

DUPAGE

"LICENSE EXPIRES 11-30-09
PROJECT MANAGER

DATE: 7-27-07

# STATE OF ILLINOIS **DEPARTMENT OF TRANSPORTATION DIVISION OF HIGHWAYS**

INDICATES LOCATION OF IMPROVEMENTS

- CHERTADHER HOLT DECEMBER 17 - 2007 DISTRICT 1 ENGINEER OF LOCAL ROADS & STREETS

RELEASING FOR BID BASED ON LIMITED

Dec. 17, 2007 Diane O' Keepe / of
DEPUTY DIRECTOR OF HIGHWAYS, REGION 1 ENGINEER

**LOCATED WITHIN** THE VILLAGE OF **ADDISON** 

THIS PROJECT IS



FULL SIZE PLANS HAVE BEEN PREPARED USING STANDARD ENGINEERING SCALES. REDUCED SIZED PLANS WILL NOT CONFORM TO STANDARD SCALES. IN MAKING MEASUREMENTS ON REDUCED SIZE PLANS, THE ABOVE SCALES SHALL BE USED.

CONTRACT NO.: 83990

Crystal Lake, Illinois 815.459.1260 (OFFICE WHICH PREPARED PLANS)

> Mokena, Illinois 708.478.2090

Burlington, Wisconsin 262.763.7834

ADDISON TOWNSHIP

SCALE: 1"=600"

DeKalb, Illinois 815.787.3111



GROSS LENGTH OF IMPROVEMENT = 5.375 LIN. FT. OR 1.018 MILES

NET LENGTH OF IMPROVEMENT = 3,506 LIN. FT. OR 0.664 MILES

Grayslake, Illinois 847.223.5088

PROJECT NUMBER: M-8003(736)

F.A.U. 2619 GRACE STREET

BEGIN OMISSION

Rockford, Illinois 815,489,1551

Plainfield, Illinois 815.609.7425

2007 ADT = 11,500

Itasca, Illinois 630.773.1870

TRAFFIC DATA

POSTED & DESIGN SPEED LIMIT = 30 MPH

Madison, Wisconsin 608.347.1542

PROJECT NUMBER: M-8003(736)

BEGIN RESURFACING/END OMISSION STA. 11+05

F.A.U. 2619 GRACE STREET

BAXTER & WOODMAN, INC. STATE OF ILLINOIS — PROFESSIONAL DESIGN FIRM LICENSE NO. — 184—001121 — EXPIRES 4/30/2009

COUNTY: DUPAGE SECTION NUMBER: 06-00096-00-RS

PRINTED BY THE AUTHORITY OF THE STATE OF ILLINOIS PROJECT NO.: 060486.40

| F.A.U.<br>RTE. | SECTION                     | COUNTY   | COUNTY   |                     | SHEET<br>NO. |
|----------------|-----------------------------|----------|----------|---------------------|--------------|
| 2619           | 06-0096-00-RS               | DuPAGE   |          | 24                  | 2            |
| STA.           |                             | TO STA,  |          |                     |              |
|                | ROAD DIST. NO<br>-91-100-07 | ILLINOIS | FED<br>M | AID PRO<br>-8003 (7 | JECT<br>36)  |
| CONTR          | ACT NO.: 83990              |          |          |                     |              |

# **HIGHWAY STANDARDS**

| STANDARD NO.<br>000001-05<br>280001-04 | STATE STANDARD STANDARD SYMBOLS, ABBREVIATIONS, AND PATTERNS TEMPORARY EROSION CONTROL SYSTEMS |
|--|--|
| 424001-05                              | CURB RAMPS FOR SIDEWALKS   |
| 442201-03                              | CLASS C AND D PATCHES  |
| 604001-02                              | FRAME AND LIDS TYPE 1  |
| 604011-03                              | FRAME AND GRATE TYPE 3V  |
| 60405602                               | FRAME AND LIDS TYPE 11V  |
| 606001-03                              | CONCRETE CURB TYPE B AND COMBINATION CONCRETE CURB AND GUTTER                                  |
| 701602-03                              | URBAN LANE CLOSURE, MULTILANE, 2W BIDIRECTIONAL LEFT TURN LANE                                 |
| 701606-05                              | URBAN LANE CLOSURE, MULTILANE, 2W WITH MOUNTABLE MEDIAN  |
| 701901                                 | TRAFFIC CONTROL DEVICES  |
| 780001-01                              | TYPICAL PAVEMENT MARKINGS  |

# **INDEX OF SHEETS**

| SHEET NO. | TITLE  |  |  |  |  |  |  |  |
|-----------|--|--|--|--|--|--|--|--|
| 1         | COVER SHEET  |  |  |  |  |  |  |  |
| 2         | NDEX OF SHEETS, HIGHWAY STANDARDS AND BENCHMARKS   |  |  |  |  |  |  |  |
| 3         | GENERAL NOTES AND WATERMAIN GENERAL NOTES  |  |  |  |  |  |  |  |
| 4         | SUMMARY OF QUANTITIES  |  |  |  |  |  |  |  |
| 5         | TYPICAL SECTIONS AND HOT-MIX ASPHALT MIXTURE REQUIREMENTS                                      |  |  |  |  |  |  |  |
| 6         | PLAN: GRACE STREET STA. 10+00 TO STA. 20+00  |  |  |  |  |  |  |  |
| 7         | PLAN AND PROFILE: GRACE STREET STA. 20+00 TO STA. 26+00  |  |  |  |  |  |  |  |
| 8         | PLAN AND PROFILE: GRACE STREET STA. 26+00 TO STA. 32+00  |  |  |  |  |  |  |  |
| 9         | PLAN AND PROFILE: GRACE STREET STA. 32+00 TO STA. 38+00  |  |  |  |  |  |  |  |
| 10        | PLAN AND PROFILE: GRACE STREET STA. 38+00 TO STA. 44+00  |  |  |  |  |  |  |  |
| 11        | PLAN AND PROFILE: GRACE STREET STA. 44+00 TO STA. 46+11  |  |  |  |  |  |  |  |
| 12        | MAINTENANCE OF TRAFFIC - GRACE STREET TRAFFIC DETOUR   |  |  |  |  |  |  |  |
| 13        | MAINTENANCE OF TRAFFIC AND CONSTRUCTION STAGING  |  |  |  |  |  |  |  |
| 14        | MISCELLANEOUS DETAILS  |  |  |  |  |  |  |  |
| 15        | MISCELLANEOUS DETAILS  |  |  |  |  |  |  |  |
| 16        | CURB OR CURB AND GUTTER REMOVAL AND REPLACEMENT  |  |  |  |  |  |  |  |
| 17        | DISTRICT 1 (BD600-03, BD-8) DETAILS FOR FRAMES AND LIDS ADJUSTMENT WITH MILLING                |  |  |  |  |  |  |  |
| 18        | RESERVED   |  |  |  |  |  |  |  |
| 19        | DISTRICT 1 (TC-10) TRAFFIC CONTROL AND PROTECTION FOR SIDE ROADS, INTERSECTIONS, AND DRIVEWAYS |  |  |  |  |  |  |  |
| 20        | DISTRICT 1 (TC-13) TYPICAL PAVEMENT MARKINGS   |  |  |  |  |  |  |  |
| 21        | DISTRICT 1 (TC-16) PAVEMENT MARKINGS LETTERS AND SYMBOLS FOR TRAFFIC STAGING                   |  |  |  |  |  |  |  |
| - 22      | DISTRICT 1 (TC-18) SIGNING FOR FLAGGING OPERATIONS AT WORK ZONE OPENINGS                       |  |  |  |  |  |  |  |
| 23        | DISTRICT 1 (TC-22) ARTERIAL ROAD INFORMATION SIGN  |  |  |  |  |  |  |  |
| 24        | DISTRICT 1 (TC-14) METHOD OF FLAGGING  |  |  |  |  |  |  |  |

# **BENCHMARKS**

| вм-ф- | WEST RIM OF SANITARY MANHOLE ON SOUTH SIDE OF FACTORY ROAD APPROXIMATELY |
|-------|--|
| re to | 200 FEET EAST OF CENTERLINE OF GRACE STREET.                             |
|       | FLEVATION $= 704.56$   |

BM#4- CHISELED "X" ON CONCRETE BASE OF LIGHT POLE ON EAST SIDE OF GRACE STREET NEAR SOUTH LINE OF COMED RIGHT-OF-WAY (POLE #35-8).

ELEVATION = 699.32

BM#5-- RAILROAD SPIKE IN EAST FACE OF POWER POLE ON WEST SIDE OF GRACE STREET. SECOND POLE NORTH OF WEST FACTORY ROAD. ELEVATION = 704.37

BM#8- CHISELED "X" ON CONCRETE BASE OF LIGHT POLE AT NORTHEAST CORNER OF GRACE STREET AND WEST ANNORENO DRIVE (POLE #68-3)
ELEVATION = 707.72

BM#10RAILROAD SPIKE IN WEST FACE OF POWER POLE AT SOUTHEAST CORNER OF GRACE STREET AND FULLERTON AVENUE.
ELEVATION = 695.35

BM#6- CHISELED "X" ON CONCRETE LID FOR ELECTRICAL HANDHOLE AT SOUTHWEST CORNER OF GRACE STREET AND FULLERTON AVENUE. ELEVATION = 695.33

WOODMAN Consulting Engineers

REVISIONS NAME DATE
//LLAGE REVIEW 7-30-07
//DOT REVIEW 11-16-07

VILLAGE OF ADDISON, ILLINOIS

FAU ROUTE 2619 GRACE STREET INDEX OF SHEETS, HIGHWAY STANDARDS & BENCHMARKS

PROJECT NO. 060486.40 SCALE: NONE DATE: 7-27-07

DESIGNED BY: MWP DRAWN BY: KAR CHECKED BY: MWP

#### **GENERAL NOTES**


- ALL CONSTRUCTION SHALL BE DONE IN ACCORDANCE WITH THE DETAILS IN THE PLANS, THE SPECIAL PROVISIONS INCLUDED IN THE CONTRACT DOCUMENTS, AND THE LATEST EDITION OF THE FOLLOWING STATE OF ILLINOIS SPECIFICATIONS: "THE STANDARD SPECIFICATIONS FOR ROAD AND BRIDGE CONSTRUCTION" (REFERED TO AS THE "STANDARD SPECIFICATIONS"), THE "SUPPLEMENTAL SPECIFICATIONS AND RECURRING SPECIAL PROVISIONS", THE "MANUAL ON UNIFORM TRAFFIC CONTROL DEVICES FOR STREETS AND HIGHWAYS", THE "MANUAL OF TEST PROCEDURES FOR MATERIALS" AND THE "STANDARD SPECIFICATIONS FOR WATER AND SEWER MAIN CONSTRUCTION IN ILLINOIS".
- THE LOCATIONS OF PUBLIC OR PRIVATE UTILITIES SHOWN ON THE PLANS ARE APPROXIMATE AND THE VILLAGE DOES NOT GUARANTEE THEIR ACCURACY. THE CONTRACTOR SHALL HAVE THE RESPECTIVE UTILITY COMPANIES FIELD LOCATE ALL OF THEIR FACILITIES PRIOR TO BEGINNING CONSTRUCTION. THE CONTRACTOR SHALL ALSO VERIFY THE DEPTHS OF THE EXISTING UTILITIES IF NECESSARY. VERIFICATION SHALL BE INCLUDED IN THE EXPLORATION TRENCH, SPECIAL PAY ITEM. ANY RELOCATION OR LOWERING OF UTILITIES SHALL BE COORDINATED BY THE CONTRACTOR.
- THE CONTRACTOR SHALL BE RESPONSIBLE FOR THE PROTECTION OF ALL UNDERGROUND OR SURFACE UTILITIES EVEN THOUGH THEY MAY NOT BE SHOWN ON THE PLANS. ANY UTILITY THAT IS DAMAGED DURING CONSTRUCTION SHALL BE REPAIRED OR REPLACED AT THE CONTRACTOR'S EXPENSE TO THE SATISFACTION OF THE ENGINEER OR VILLAGE.
- THE CONTRACTOR SHALL NOTIFY THE VILLAGE ENGINEER AT LEAST 48 HOURS IN ADVANCE OF BEGINNING WORK TO OBTAIN VILLAGE UTILITY LOCATIONS AND SHALL COORDINATE ALL CONSTRUCTION OPERATIONS WITH THE ENGINEER
- 5. MATERIALS RESULTING FROM THE REMOVAL OF PAVEMENT, DRIVEWAYS, CURB AND GUTTER, HOT-MIX ASPHALT SURFACES, ETC. SHALL BE REMOVED AT THE END OF EACH DAY TO AN APPROVED SITE. IN THE JUDGMENT OF THE VILLAGE, SHOULD IT BE NECESSARY FOR VILLAGE PERSONNEL TO REMOVE SUCH MATERIALS, THE VILLAGE WILL HAVE THE MATERIAL REMOVED AND THE CONTRACTOR WILL BE BILLED (CHARGED) ACCORDINGLY.
- THE CONTRACTOR MAY OBTAIN POTABLE MUNICIPAL WATER IN BULK, AT NO CHARGE, AS LONG AS THERE IS NOT A "WATERING BAN" IN EFFECT. THE CONTRACTOR MAY OBTAIN NON-POTABLE WATER IN BULK, AT NO CHARGE IF A "WATERING BAN" IS IN EFFECT. THE USE OF FIRE HYDRANTS IS STRICTLY PROHIBITED. WATER FOR CONSTRUCTION SHALL BE DISTRIBUTED BY THE VILLAGE. THE CONTRACTOR SHALL PROVIDE THE WATER TRUCK AND DRIVER REQUIRED TO OBTAIN AND TRANSPORT THIS WATER. THE VILLAGE RESERVES THE RIGHT TO RESTRICT OR REFUSE THE USE OF VILLAGE WATER IF DEEMED NECESSARY.
- IT WILL BE THE CONTRACTOR'S RESPONSIBILITY TO NOTIFY BUSINESSES AND THE VILLAGE WHEN ACCESS TO DRIVEWAYS WILL BE TEMPORARILY CLOSED DUE TO CURB AND GUTTER AND/OR DRIVEWAY REPLACEMENT. THE CONTRACTOR SHALL DISTRIBUTE NOTICES PROVIDED BY THE VILLAGE TO BUSINESSES. EVERY EFFORT SHALL BE MADE TO ACCOMMODATE ACCESS TO THESE PROPERTIES INCLUDING KNOCKING ON DOORS WHEN DRIVEWAYS ARE ABOUT TO BE CLOSED.
- 8. THE CONTRACTOR SHALL PROTECT AND CAREFULLY PRESERVE ALL SECTION OR SUBSECTION MONUMENTS OR PROPERTY OR REFERENCE MARKERS UNTIL THE OWNERS, THEIR AGENTS OR AN AUTHORIZED SURVEYOR HAS WITNESSED OR OTHERWISE REFERENCED THEIR LOCATIONS.
- 9. ACCESS TO ALL DRIVEWAYS SHALL BE PROVIDED AT ALL TIMES EXCEPT DURING ACTUAL CONSTRUCTION ADJACENT THERETO. TEMPORARY RAMPS UTILIZING AGGREGATE FOR TEMPORARY ACCESS SHALL BE CONSTRUCTED AS NEEDED TO PROVIDE SUCH ACCESS.
- 10. THE CONTRACTOR SHALL PROVIDE A REQUEST FOR MATERIAL TESTING TO THE ILLINOIS DEPARTMENT OF TRANSPORTATION BUREAU OF MATERIALS ORDER BOARD (PHONE (847) 705-4337) BY 4 PM, 24-HOURS IN ADVANCE OF CONSTRUCTION FOR INSPECTION OF ALL HOT-MIX ASPHALT AND CONCRETE MATERIALS USED ON THIS PROJECT.
- 11. EXISTING PAVEMENT, DRIVEWAY PAVEMENT AND CURB AND GUTTER TO REMAIN IN PLACE SHALL BE SAW CUT FULL DEPTH TO PROVIDE A NEAT VERTICAL FACE BETWEEN THE PROPOSED AND EXISTING AND SHALL BE INCLUDED IN THE COST OF THE CONTRACT.
- 12. IN AREAS WHERE THE EXISTING DRIVEWAY OR CURB AND GUTTER IS TO BE REMOVED AND REPLACED, THE REMOVAL AND DISPOSAL OF ANY ADDITIONAL MATERIAL REQUIRED TO ESTABLISH THE PROPOSED DRIVEWAY OR CURB AND GUTTER SUBGRADE ELEVATION SHALL BE INCLUDED IN THE PAY ITEMS, DRIVEWAY PAVEMENT REMOVAL OR COMBINATION CURB AND GUTTER REMOVAL (SPECIAL)
- 13. ALL AGGREGATE USED ON THIS PROJECT SHALL BE CRUSHED MATERIAL
- 14. THE CURB SHALL BE TAPERED TO THE GUTTER IN A THREE (3) FOOT LENGTH WHEREVER THE CURB AND GUTTER TERMINATES, WITH AN EXPANSION JOINT PLACED AT THE START OF THE TAPER.
- 15. CURB AND GUTTER SHALL BE DEPRESSED AT DRIVEWAYS IN ACCORDANCE WITH THE IDOT HIGHWAY STANDARDS
- 16. THE FINISHED HOT-MIX ASPHALT SURFACE SHALL BE CONSTRUCTED 0.25 INCH ABOVE THE GUTTER FLAG.
- 17. THE CONTRACTOR SHALL PROVIDE AND INSTALL TWO (2) WEIGHTED SANDBAGS ON EACH TYPE I OR TYPE II BARRICADE USED. ONE (1) WEIGHTED SANDBAG SHALL BE PLACED ACROSS EACH BOTTOM RAIL.
- 18. A 1/2-INCH THICK EXPANSION JOINT SHALL BE PROVIDED AT THE JUNCTION OF THE DRIVEWAY APRON AND CURB. THIS WORK WILL BE INCLUDED IN THE COST OF THE
- 19. ALL POSTS, RAILROAD TIES, AND DECORATIVE TIMBER IN CONFLICT WITH THE PROPOSED IMPROVEMENTS SHALL BE REMOVED AND RELOCATED AS DETERMINED BY THE ENGINEER AT THE TIME OF CONSTRUCTION AND SHALL BE INCLUDED IN THE COST OF THE CONTRACT. EVERY EFFORT SHALL BE MADE BY THE CONTRACTOR WHEN REMOVING THESE ITEMS TO PRESERVE THEM FROM DAMAGE. ITEMS NOT RELOCATED SHALL BE PROPERLY DISPOSED OF BY THE CONTRACTOR.
- 20. FRAME ELEVATIONS GIVEN ON THE PLANS ARE ONLY TO ASSIST THE CONTRACTOR IN DETERMINING THE APPROXIMATE OVERALL HEIGHT OF THE STRUCTURE. FRAMES ON ALL NEW STRUCTURES SHALL BE ADJUSTED TO THE FINAL ELEVATION OF THE AREA IN WHICH THEY ARE LOCATED AS PART OF COST OF THE STRUCTURE.
- 21. A PORTABLE TOILET SHALL BE PLACED ON THE JOB SITE AND RELOCATED WHEN NECESSARY SO IT IS ACCESSIBLE TO WORKERS. IF WORK IS OCCURRING AT SEVERAL LOCATIONS, ONE PORTABLE TOILET SHALL BE PLACED AT EACH LOCATION WITHIN A REASONABLE DISTANCE FROM THE WORK AS DETERMINED BY THE ENGINEER. THIS SHALL BE INCLUDED IN THE PAY ITEM FOR MOBILIZATION.
- 22. THE PRIME COÁT APPLICATION RATE SHALL BE APPROXIMATELY 0.1 GAL/SY. THE MC-30 PRIME COAT APPLICATION RATE SHALL BE APPROXIMATELY 0.3 GAL/SY.
- 23. FOR STEEL BARS CERTIFICATION, PLEASE CONTACT IDOT BUREAU OF MATERIALS AT (847) 705-4361.
- 24. ON STREETS TO BE FULL WIDTH MILLED (2" OR MORE), THE STRUCTURES IN THE PAVEMENT SHALL BE ADJUSTED IN ACCORDANCE WITH THE IDOT DETAIL "DETAILS FOR FRAMES AND LIDS ADJUSTMENT WITH MILLING". VALVE BOXES IN THE PAVEMENT SHALL ALSO BE ADJUSTED VERTICALLY, THIS WORK SHALL BE PAID FOR AT THE CONTRACT UNIT PRICE FOR SANITARY MANHOLES TO BE ADJUSTED (SPECIAL), DRAINAGE AND UTILITY STRUCTURE ADJUSTMENT (SPECIAL), AND VALVE BOXES TO BE ADJUSTED (SPECIAL).
- 25. THE CONTRACTOR SHALL UTILIZE A MECHANICAL SWEEPER TO CLEAN STREETS AFFECTED BY CONTRACTORS OPERATIONS, INCLUDING HAUL ROUTES, AT LEAST TWICE PER WEEK AND ADDITIONALLY AS DIRECTED BY THE ENGINEER. THIS WORK SHALL BE INCLUDED IN THE COST OF CONSTRUCTION.
- 26. A MINIMUM OF SEVEN (7) WORKING DAYS PRIOR TO THE DETECTION REMOVAL, THE CONTRACTOR SHALL NOTIFY THE VILLAGE TRAFFIC SIGNAL AND MAINTENANCE AND OPERATIONS ENGINEER AND THE VILLAGE ELECTRICAL MAINTENANCE CONTRACTOR AT WHICH TIME ARRANGEMENTS WILL BE MADE TO ADJUST THE TRAFFIC CONTROLLER TIMING TO COMPENSATE FOR THE ABSENCE OF DETECTION. THIS WORK SHALL BE INCLUDED IN THE COST OF CONSTRUCTION.
- 27. TEMPORARY EROSION CONTROL MEASURES SHALL BE INSTALLED AS REQUIRED. WHERE PARKWAYS ARE DISTURBED, TEMPORARY EROSION CONTROL MEASURES SHALL BE ESTABLISHED WITHIN 21 DAYS OF THE COMPLETION OF DISTURBANCE AND MAINTAINED TO THE SATISFACTION OF THE VILLAGE. THIS WORK SHALL BE INCLUDED IN THE COST OF CONSTRUCTION.
- 28. AFTER THE TRENCH BACKFILL HAS BEEN INSTALLED, SATISFACTORILY COMPACTED AND LEVELED TO CREATE A 4-INCH DEEP VOID SPACE, TEMPORARY PAVEMENT SHALL BE INSTALLED TO A THICKNESS OF 4-INCHES TO FILL THE VOID SPACE. MILLING OPERATIONS WILL REDUCE THE THICKNESS OF THE TEMPORARY PAVEMENT TO \$\frac{1}{2}\-\text{inch.}\$ THE CONTRACTOR IS RESPONSIBLE TO INSPECT THE TEMPORARY PAVEMENT AS THE MILLING OPERATIONS OCCUR TO ENSURE THE TEMPORARY PAVEMENT IS SATISFACTORY FOR TRAFFIC, THE CONTRACTOR SHALL CONTINUE TO INSPECT AND MAINTAIN AS NECESSARY THE TEMPORARY PAVEMENT UNTIL THE PERMANENT PAVEMENT PATCH IS INSTALLED. ANY AND ALL MAINTENANCE TO THE TEMPORARY PAVEMENT SHALL BE COMPLETED IMMEDIATELY. ANY AND ALL MAINTENANCE TO THE TEMPORARY PAVEMENT SHALL BE INCLUDED IN THE TEMPORARY PAVEMENT PAY ITEM.

| RIE. | SECTION                | COUNTY |          | SHEETS | NO.               |   |
|------|------------------------|--------|----------|--------|-------------------|---|
| 2619 | 06-0096-00-RS          | 5      | DuPAG    | E.     | 24                | 3 |
| STA. |                        | T      | O STA.   |        |                   |   |
|      | AD DIST. NO<br>-100-07 |        | ILLINOIS |        | AID PR<br>-8003 ( |   |

CONTRACT NO.: 83990

## **WATER MAIN NOTES**

- 1. A PRECONSTRUCTION VIDEO RECORDING OF CONSTRUCTION AREAS MUST BE PROVIDED TO THE VILLAGE PRIOR TO START OF CONSTRUCTION.
- 2. CONTACT THE VILLAGE OF ADDISON PUBLIC WORKS DEPARTMENT AND J.U.L.I.E. 48 HOURS PRIOR TO EXCAVATION FOR UTILITIES.
- 3. INSTALL TRAFFIC CONTROL AND/OR DETOUR SIGNAGE PRIOR TO BEGINNING ANY CONSTRUCTION WORK AND AS AGREED TO IN THE CONTRACT DOCUMENTS.
- 4. COMPLY WITH "THE STANDARD SPECIFICATIONS FOR ROAD AND BRIDGE CONSTRUCTION", "SUPPLEMENTAL SPECIFICATIONS AND RECURRING SPECIAL PROVISIONS" AND "THE MANUAL ON UNIFORM TRAFFIC CONTROL DEVICES FOR STREET AND HIGHWAYS" - THE STATE OF ILLINOIS - DURING ALL
- 5. COMPLY WITH ALL RULES AND REGULATIONS OF OSHA DURING CONSTRUCTION OF THE IMPROVEMENTS AND RESTORATION.
- COORDINATE WITH UTILITY COMPANIES TO SUPPORT, PROTECT, OR REMOVE AND REPLACE ALL POWER POLES OR POLE ANCHORS THAT ARE EFFECTED BY THE CONSTRUCTION, EVEN WHERE SUPPORTS ARE NOT INDICATED ON THE PLAN SHEETS. THE COST OF THIS WORK IS INCLUDED IN THE COST OF
- 7. DO NOT STORE MATERIALS, STRUCTURES, OR MACHINES WHERE THEY WILL OBSTRUCT STREET CROSSING OR DRIVEWAY SIGHTLINES.
- 8. VAULT RIM ELEVATIONS WILL BE ADJUSTED TO FINAL GRADE AT THE TIME OF FINAL PAVING OR LANDSCAPING. ADJUSTMENT OF NEW STRUCTURES TO FINAL GRADE IS INCLUDED IN THE NEW STRUCTURE PAY ITEM, REGARDLESS OF THE NUMBER OF TIMES THE ADJUSTMENTS MUST BE MADE.
- 9 ALL WATER MAIN MUST BE WRAPPED WITH POLYETHYLENE WRAPPING, WRAPPING IS INCLUDED IN THE WATER MAIN PAY ITEM
- 10. WHERE LOCATION OF FITTING OR VALVE IS NOT NOTED BY STATION, THE FINAL LOCATION OF THE ITEM MUST BE DETERMINED DURING CONSTRUCTION.
- 11. WATER MAIN MUST BE INSTALLED DEEPER THAN STANDARD IN SEVERAL LOCATIONS, DEEPER INSTALLATION IS CONSIDERED INCLUDED IN THE ITEM BEING INSTALLED, INCLUDING WATER MAIN, VALVE VAULTS, OR FIRE HYDRANTS. IN SOME AREAS NEW WATER MAIN WILL CROSS BELOW EXISTING MAINS AND IN SOME AREAS ABOVE EXISTING MAINS.
- 12. CONTACT MEADE ELECTRIC FOR LOCATION OF TRAFFIC CONTROL CONDUITS AND WIRING, THESE ITEMS ARE NOT LOCATED AS A PART OF THE JULIE
- 13. CONTACT THE DUPAGE WATER COMMISSION 48 HOURS IN ADVANCE OF ANY CONSTRUCTION IN THE AREA OF THEIR TRANSMISSION MAIN.

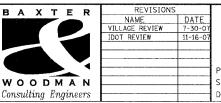

VILLAGE OF ADDISON, ILLINOIS

#### **FAU ROUTE 2619 GRACE STREET GENERAL NOTES & WATERMAIN NOTES**

PROJECT NO. 060486.40 SCALE: NONE DATE: 7-27-07

DESIGNED BY: MWF DRAWN BY: KAR CHECKED BY: MWP

2:57pm Baxter &

# SUMMARY OF QUANTITIES

|     | CODE NO.                   | PAY ITEM  | UNIT   | TOTAL<br>QUANTITY | CONSTRUCTION<br>CODE<br>1000— <b>2</b> 'A<br>PARTICIPATING | Y060<br>NON-<br>PARTICIPATING |
|-----|----------------------------|---|--------|-------------------|--|-------------------------------|
|     | 20800250                   | TRENCH BACKFILL, SPECIAL                                    | CU YD  | 5,204             | 0  | 5,204                         |
| Ι,  | 21300010                   | EXPLORATION TRENCH, SPECIAL                                 | FOOT   | 300               | 0  | 300                           |
|     | 25000210                   | SEEDING, CLASS 2A   | ACRE   | 0.063             | 0  | 0.063                         |
|     | 25000400                   | NITROGEN FERTLIZER NUTRIENT                                 | POUND  | 6                 | 0  | 6                             |
|     | 25000500                   | PHOSPHORUS FERTILIZER NUTRIENT                              | POUND  | 6                 | 0  | 6                             |
|     | 25000600                   | POTASSIUM FERTLIZER NUTRIENT                                | POUND  | 6                 | 0  | 6                             |
|     | 25100401                   | EXCELSIOR BLANKET, SPECIAL                                  | SQ YD  | 301               | 0  | 301                           |
|     | 25200200                   | SUPPLEMENTAL WATERING                                       | UNIT   | 6                 | 0  | 6                             |
|     | 35101600                   | AGGREGATE BASE COURSE, TYPE B 4"                            | SQ YD  | 18                | 18   | . 0                           |
|     | 35501308                   | HOT-MIX ASPHALT BASE COURSE, 6"                             | SQ YD  | 18                | 18   | 0                             |
|     | 40600100                   | BITUMINOUS MATERIALS (PRIME COAT)                           | GALLON | 3,893             | 3,893  | 0                             |
|     | 40600300                   | AGGREGATE (PRIME COAT)                                      | TON    | 78                | 78   | 0                             |
|     | 40600990                   | TEMPORARY RAMP  | SQ YD  | 1,369             | 1,369  | 0                             |
|     | 40603310                   |   | TON    | 3                 | . 3  | 0                             |
|     |                            | HOT-MIX ASPHALT SURFACE COURSE, MIX "C", N50                | TON    | 2,798             | 2,798  | 0                             |
|     | 40603340                   | HOT-MIX ASPHALT SURFACE COURSE, MIX "D" N70                 | ļ      | -                 |  |                               |
|     | 44000162                   | HOT-MIX ASPHALT SURFACE REMOVAL 3 1/4"                      | SQ YD  | 19,461            | 19,461   | 0                             |
|     | 44000200                   | DRIVEWAY PAVEMENT REMOVAL                                   | SQ YD  | 18                | 18   | 0                             |
|     | 44001900                   | COMBINATION CURB AND GUTTER REMOVAL (SPECIAL)               | FOOT   | 1,964             | 1,964  | 0                             |
|     | 44002000                   | CONCRETE CURB REMOVAL                                       | FOOT   | 32                | 32   | 0                             |
|     | 44201781                   | CLASS D PATCHES, TYPE III, 11 INCH                          | SQ YD  | 400               | 400  | 0                             |
|     | 44201783                   | CLASS D PATCHES, TYPE IV, 11 INCH                           | SQ YD  | 3,453             | 600  | 2,853                         |
|     | • 56103300                 | DUCTILE IRON WATER MAIN 12"                                 | FOOT   | 2,345             | 0  | 2,345                         |
|     | • XXXX1253                 | DUCTILE IRON WATER MAIN 14"                                 | FOOT   | 25                | 0  | . 25                          |
|     | <b>●</b> 56400820          | FIRE HYDRANT WITH AUXILIARY VALVE AND VALVE BOX             | EACH   | 8                 | . 0  | 8                             |
|     | 60260505                   | INLETS TO BE ADJUSTED WITH NEW TYPE 3V FRAME AND GRATE      | EACH   | 2                 | 2  | 0                             |
|     | 60261320                   | INLETS TO BE ADJUSTED WITH NEW TYPE 11V FRAME AND GRATE     | EACH   | 1                 | 1  | 0                             |
|     | 60266600                   | VALVE BOXES TO BE ADJUSTED                                  | EACH   | 1                 | 1  | 0                             |
|     | 60266610                   | VALVE BOXES TO BE ADJUSTED (SPECIAL)                        | EACH   | 3                 | . 3  | 0                             |
|     | 60600105                   | CONCRETE CURB   | FOOT   | . 32              | 32   | 0                             |
|     | 60604200                   | COMBINATION CONCRETE CURB AND GUTTER, TYPE B-6.12 (SPECIAL) | FOOT   | 1,328             | 1,328  | 0                             |
|     | 60604800                   | COMBINATION CONCRETE CURB AND GUTTER, TYPE B-6.18 (SPECIAL) | FOOT   | 636               | 636  | 0                             |
|     | 67100100                   | MOBILIZATION  | LSUM   | 1                 | 0.73   | 0.27                          |
|     | 70102625                   | TRAFFIC CONTROL AND PROTECTION, STANDARD 701606             | LSUM   | 1                 | 0.41   | 0.59                          |
| i i | 70102632                   | TRAFFIC CONTROL AND PROTECTION, STANDARD 701602             | LSUM   | 1                 | 0  | 1                             |
|     | 70300100                   | SHORT-TERM PAVEMENT MARKING                                 | FOOT   | 38,700            | 2,700  | 36,000                        |
|     | • 70300600                 | TEMPORARY PAVEMENT MARKING, PAINT                           | FOOT   | 5,400             | 5,400  | 0                             |
|     | 70301000                   | WORK ZONE PAVEMENT MARKING REMOVAL                          | SQ FT  | 12,900            | 900  | 12,000                        |
|     | 78000100                   | THERMOPLASTIC PAVEMENT MARKING - LETTERS AND SYMBOLS        | SQ FT  | 377.2             | 377.2  | 0                             |
|     | • 78000200                 | THERMOPLASTIC PAVEMENT MARKING - LINE 4"                    | FOOT   | 7,738             | 7,738  | . 0                           |
|     | • 78000400                 | THERMOPLASTIC PAVEMENT MARKING - LINE 6"                    | FOOT   | 610               | 610  | 0                             |
|     | • 78000600                 | THERMOPLASTIC PAVEMENT MARKING - LINE 12"                   | FOOT   | 420               | 420  | 0                             |
|     | • 78000650                 | THERMOPLASTIC PAVEMENT MARKING - LINE 24"                   | FOOT   | 219               | 219  | 0                             |
|     | <ul><li>88600600</li></ul> | DETECTOR LOOP REPLACEMENT                                   | FOOT   | 521               | 521  | 0                             |
|     | Z0017400                   | DRAINAGE & UTILITY STRUCTURES TO BE ADJUSTED                | EACH   | 13                | 13   | - 0                           |

|                          |  |       | TOTAL<br>QUANTITY | CONSTRUCTION<br>CODE<br>IOOO-2A | <i>Y060</i><br>NON- |
|--------------------------|--|-------|-------------------|---------------------------------|---------------------|
| CODE NO.                 | PAY ITEM   | UNIT  |                   | PARTICIPATING                   | PARTICIPATIN        |
| Z0017500                 | DRAINAGE & UTILITY STRUCTURE ADJUSTMENT (SPECIAL)                    | EACH  | 20                | 20                              |                     |
| Z0048665                 | RAILROAD PROTECTIVE LIABILITY INSURANCE                              | LSUM  | 1                 | . 1                             |                     |
| △ Z0076600               | TRAINEES   | HOUR  | 500               | 500                             |                     |
| • XX001047               | VALVE VAULTS TO BE ABANDONED   | EACH  | 11                | 0                               |                     |
| • XX002161               | ABANDON EXISTING WATER MAIN  | EACH  | 8                 | 0                               |                     |
| • XX003008               | TRAFFIC CONTROL DETOUR   | LSUM  | 1                 | 0                               |                     |
| XX003435                 | PORTLAND CEMENT CONCRETE DRIVEWAY REMOVAL AND REPLACEMENT            | SQ YD | 46                | 46                              |                     |
| • XX003516               | CONNECTIONS TO EXISTING WATER MAINS (NON-PRESSURE) - 8"              | EACH  | 4                 | 0                               |                     |
| • XX003517               | CONNECTIONS TO EXISTING WATER MAINS (NON-PRESSURE) - 6"              | EACH  | 1                 | 0                               |                     |
| • XX003519               | DUCTILE IRON WATER MAIN FITTING - 12" X 6" TEE                       | EACH  | 9                 | 0                               |                     |
| • XX003531               | WATER SERVICE CONNECTION 1"  | EACH  | 1                 | 0                               |                     |
| • XX003542               | DUCTILE IRON WATER MAIN FITTINGS 6" 45 DEGREE BEND                   | EACH  | 2                 | 0                               |                     |
| • XX003543               | DUCTILE IRON WATER MAIN FITTINGS 8" 45 DEGREE BEND                   | EACH  | 8                 | 0                               |                     |
| • XX003668               | PRECONSTRUCTION VIDEO TAPING   | LSUM  | 1                 | 0                               |                     |
| <ul><li>xxoがとる</li></ul> | TOPSOIL FURNISH AND PLACE (PULVERIZED), VARIABLE DEPTH               | SQ YD | 301               | 0                               | 3                   |
| • XX004907               | GATE VALVE 12" WITH VAULT, 5' DIAMETER                               | EACH  | 4                 | 0                               |                     |
| • XX005107               | CONNECTIONS TO EXISTING WATER MAINS (NON-PRESSURE) - 12"             | EACH  | 1                 | 0                               |                     |
| • XX005476               | DUCTILE IRON WATER MAIN 12" RESTRAINED JOINT TYPE                    | FOOT  | 329               | 0                               | 3                   |
| • XX005478               | DUCTILE IRON WATER MAIN 6" RESTRAINED JOINT TYPE                     | FOOT  | 178               | 0                               | 1                   |
| • XX005479               | DUCTILE IRON WATER MAIN 8" RESTRAINED JOINT TYPE                     | FOOT  | 107               | 0                               | 1                   |
| • XX005776               | DUCTILE IRON WATER MAIN FITTINGS 45 BEND 12"                         | EACH  | 10                | 0                               |                     |
| XX005924                 | TEMPORARY RAMP REMOVAL   | SQ YD | 1,369             | 1,369                           |                     |
| ● XX006113               | REMOVE EXISTING FIRE HYDRANTS  | EACH  | 8                 | 0                               |                     |
| • X0322256               | TEMPORARY INFORMATION SIGNING  | SQ FT | 128.5             | 51.4                            | 7                   |
| • X0323189               | DUCTILE IRON WATER MAIN TEE, 12" X 8"                                | EACH  | 4                 | 0                               |                     |
| • X0323190               | DUCTILE IRON WATER MAIN TEE, 12" X 12"                               | EACH  | 2                 | 0                               |                     |
| • X×90729                | DUCTILE IRON WATER MAIN REDUCER, 14" X 12"                           | EACH  | 2                 | 0                               |                     |
| X0712400                 | TEMPORARY PAVEMENT   | SQ YD | 2,853             | 0                               | 2,8                 |
| X4022000                 | TEMPORARY ACCESS (COMMERCIAL ENTRANCE)                               | EACH  | 6                 | 6                               |                     |
| X4067107                 | POLYMERIZED LEVELING BINDER (MACHINE METHOD), IL-4.75, N50           | TON   | 1,120             | 1,120                           |                     |
| • xx0072                 | MANHOLES TO BE ADJUSTED WITH NEW TYPE 1 GRATE, OPEN LID              | EACH  | 1                 | 1                               |                     |
| ● X032155                | SANITARY MANHOLES TO BE ADJUSTED                                     | EACH  | 10                | 10                              |                     |
| • XX0072                 | 20 PVC CASING PIPE - 20".  | FOOT  | 211               | 0                               |                     |
| • XX0072                 | DUCTILE IRON WATER MAIN TEE, 14" X 12"                               | EACH  | 1                 | 0                               |                     |
| • XX00723                | DUCTILE IRON WATER MAIN 14" CUTTING IN SLEEVE                        | EACH  | 1                 | 0                               |                     |
| • XX00723                | GATE VALVE 14" WITH VAULT, 6' DIAMETER (VALVE ATTACHED TO LINE TEE)  | EACH  | 1                 | 0                               |                     |
| • XX0072                 | GATE VALVE 12" WITH VAULT, 6' DIAMETER (VALVE ATTACHED TO LINE TEE)  | EACH  | 1                 | 0                               |                     |
| • XX00722                | 5 GATE VALVE 8" WITH VAULT, 6' DIAMETER (VALVE ATTACHED TO LINE TEE) | EACH  | 4                 | 0                               |                     |
| • XX00723                | GATE VALVE 6" WITH VAULT, 6' DIAMETER (VALVE ATTACHED TO LINE TEE)   | EACH  | 1                 | 0                               |                     |
| • XX00722                | CONNECTIONS TO EXISTING WATER MAINS (NON-PRESSURE) - 14"             | EACH  | 3                 | 0                               |                     |

|   | F.A.U.<br>RTE. | SECTION                     | COUNTY   | SI    | OTAL.<br>HEETS | SHEET<br>NO. |  |
|---|----------------|-----------------------------|----------|-------|----------------|--------------|--|
|   | 2619           | 06-0096-00-RS               | DuPAGE   |       | 24             | 4            |  |
|   | STA.           |                             | TO STA.  |       |                |              |  |
| 1 |                | ROAD DIST, NO<br>-91-100-07 | ILLINOIS | FED A | ID PR          |              |  |
|   | CONTR          | ACT NO.: 83990              |          |       |                |              |  |

• INDICATES SPECIALTY ITEM

D Y080

WOODMAN
Consulting Engineers

|       |          | REVISIONS |     |
|-------|----------|-----------|-----|
|       | DATE     | AME .     | N   |
| FA    | 11-16-07 | REVIEW    | DOT |
|       |          |           |     |
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|       |          |           |     |
| SCALE |          |           |     |

VILLAGE OF ADDISON, ILLINOIS

# AU ROUTE 2619 SOUTH GRACE STREET SUMMARY OF QUANTITIES

PROJECT NO. 060486.40 DESIGNED BY: MWP SCALE: NONE DRAWN BY: UKB DATE: 7-27-07 CHECKED BY: MWP

A HOT-MIX ASPHALT SURFACE COURSE, 1 1/2"

B HOT-MIX ASPHALT BINDER COURSE, 2 1/2"

(C) HOT-MIX ASPHALT BASE COURSES, 10"

D CRUSHED STONE SUB-BASE, 4-INCHES

E) EXISTING CURB AND GUTTER TO REMAIN

F GROUND SURFACE

G HOT-MIX ASPHALT SURFACE REMOVAL, 3 1/4"

H COMBINATION CURB AND GUTTER REMOVAL (SPECIAL)

ITEM TO BE REMOVED

#### PROPOSED LEGEND

1) HOT-MIX ASPHALT SURFACE COURSE, MIX "D" N70, 2 1/2-INCH

2) POLYMERIZED LEVELING BINDER (MACHINE METHOD), IL-4.75, N50,

OMBINATION CONCRETE CURB AND GUTTER, TYPE B-6.12 (SPECIAL) (STA. 34+46 LT. TO STA. 46+11 LT., STA. 32+39 RT. TO STA. 46+11 RT.)

COMBINATION CONCRETE CURB AND GUTTER, TYPE B-6.18 (SPECIAL) (STA. 11+05 LT. TO STA. 34+46 LT., STA. 11+05 RT. TO STA. 32+39 RT.)

5 FURNISH AND PLACING TOPSOIL (PULVERIZED), VARIABLE DEPTH,

(SEE NOTES 1 & 2 THIS SHEET)

6 SODDING, SALT TOLERANT (SEE NOTE 1)

7 SEEDING, CLASS 2A (SEE NOTE 2)


8 EXCELSIOR BLANKET, SPECIAL (SEE NOTE 2)

# HOT-MIX ASPHALT MIXTURE REQUIREMENTS

| MIXTURE TYPE   | AC TYPE                   | % AIR VOIDS               |
|--|---------------------------|---------------------------|
| ROADWAY  |                           |                           |
| HOT-MIX ASPHALT SURFACE COURSE, MIX "D", N70                             | PG 64-22                  | 4% @ 70 Gyr.              |
| POLYMERIZED LEVELING BINDER (MACHINE METHOD), IL-4.75, N50               | SBS/SBR<br>PG 76-28 / -22 | 4% @ 50 Gyr.              |
| PATCHING **  |                           |                           |
| CLASS D PATCHES-TYPES III AND IV-11"                                     | PG 64-22*                 | E.<br>4% <b>@</b> 70 Gyr. |
| TEMPORARY PAVEMENT   |                           |                           |
| TEMPORARY PAVEMENT, 4" (HMA BINDER IL-19 mm)                             | PG 64-22*                 | 4% @ 50 Gyr.              |
| DRIVEWAYS  |                           |                           |
| HOT-MIX ASPHALT BASE COURSE, 6"  | PG 64-22*                 | 4% @ 50 Gyr.              |
| HOT-MIX ASPHALT SURFACE COURSE, MIX "C", N50, 2"                         | PG 64-22                  | 4% @ 50 Gyr.              |
| THE HAIT METALT HOPE TO AN AUGUSTE AND HOST HIT ADDRESS AND HOPE AND THE | 70 440 100 (00 1/0 /1)    |                           |


THE UNIT WEIGHT USED TO CALCULATE ALL HOT-MIX ASPHALT SURFACE MIXTURES IS 112 LBS/SQ. YD./IN

 $\star$  WHEN RAP EXCEEDS 20%, THE NEW ASPHALT BINDER IN THE MIX SHALL BE PG 58-22

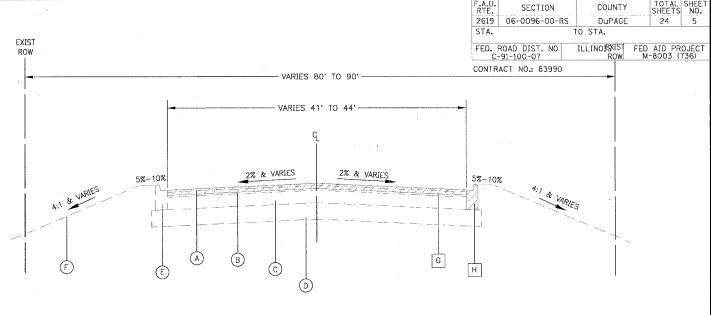

EXISTING TYPICAL SECTION

GRACE STREET
STA. 11+05 TO STA. 46+11

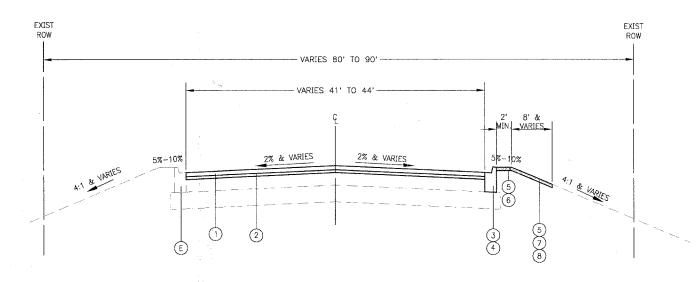

PROPOSED TYPICAL SECTION
GRACE STREET
DRIVEWAYS STA. 11+05 TO STA. 46+11

NOTES:

PARKAWAY DAMAGED BY CURB AND GUTTER REMOVAL AND REPLACEMENT AND DRIVEWAY REMOVAL AND REPLACEMENT WILL NOT BE PAID FOR SEPERATELY. PARKWAY RESTORATION SHALL CONSIST OF SALT TOLERANT SOD AND PULVERIZED TOPSOIL FOR A MINIMUM DISTANCE OF 2' PERPENDICULAR TO THE BACK OF CURB.

2. PARKWAY DAMAGED BY WATER MAIN INSTALLATION WILL BE PAID FOR AS FURNISH AND PLACING TOPSOIL (PULVERIZED), VARIABLE DEPTH, EXCELSIOR BLANKET, SPECIAL AND SEEDING, 2A. THE AREA OF RESTORATION SHALL BE DETERMINED BY THE VILLAGE AND ENGINEER. RESTORATION REQUIRED BEYOND THE AREA DETERMINED SHALL BE COMPLETED TO THE SATISFACTION OF THE VILLAGE AND ENGINEER AT THE CONTRACTOR'S EXPENSE.

BAXTER

REVISIONS

NAME
VILLAGE REVIEW

7-30-07

IDOT REVIEW

11-16-07

HC

PRO

Consulting Engineers

REVISIONS

NAME
11-16-07

HC

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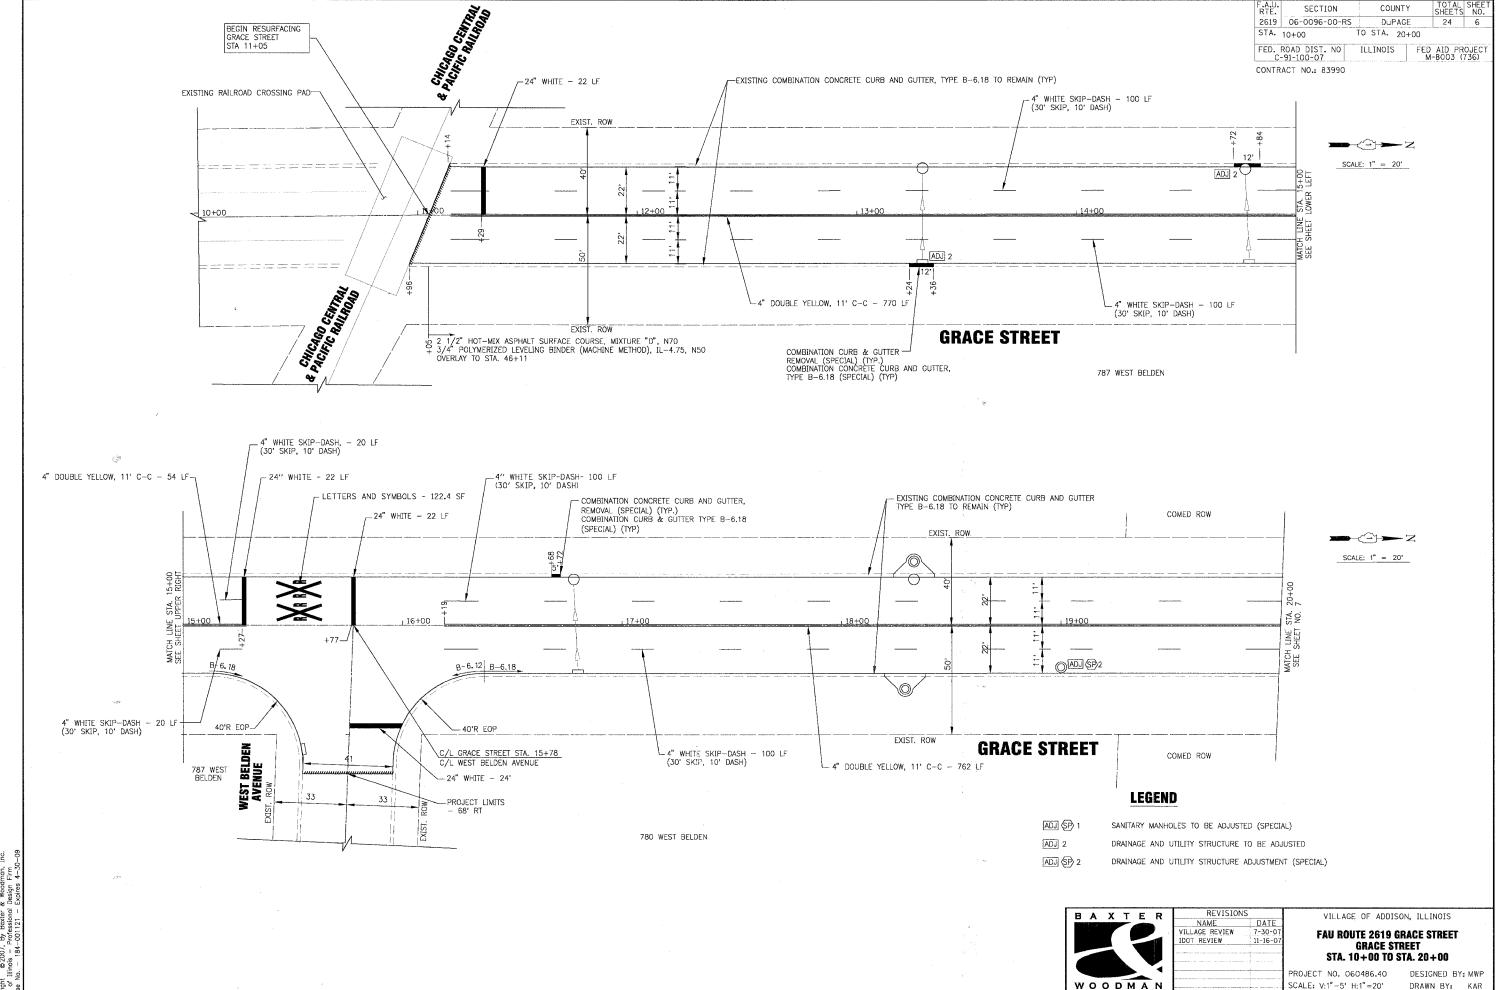
VILLAGE OF ADDISON, ILLINOIS

#### FAU ROUTE 2619 GRACE STREET TYPICAL SECTIONS & HOT-MIX ASPHALT MIXTURE REQUIREMENTS

PROJECT NO. 060486.40 DES SCALE: NONE DRA DATE: 7-27-07 CHE

DESIGNED BY: MWP
DRAWN BY: KAR
CHECKED BY: MWP

11–20–07 @ 3:03pm By: 560kar tt @2006, By Baxter & Woodman, Inc. Illinois – Professional Design Firm No. – 184–001121 – Expires 4–30–07





I.\ADDNV\060486 – Grace STP (LAPP)\DWG Plotted: 11-20-07 @ 2:41pm By: 560kar Copyright @ 2007, By Baxter & Woodman, State of Illinois – Professional Design Frm License No. – 184-001121 – Expires 4-36


SCALE: V:1"-5' H:1"=20' DATE: 7-27-07


Consulting Engineers


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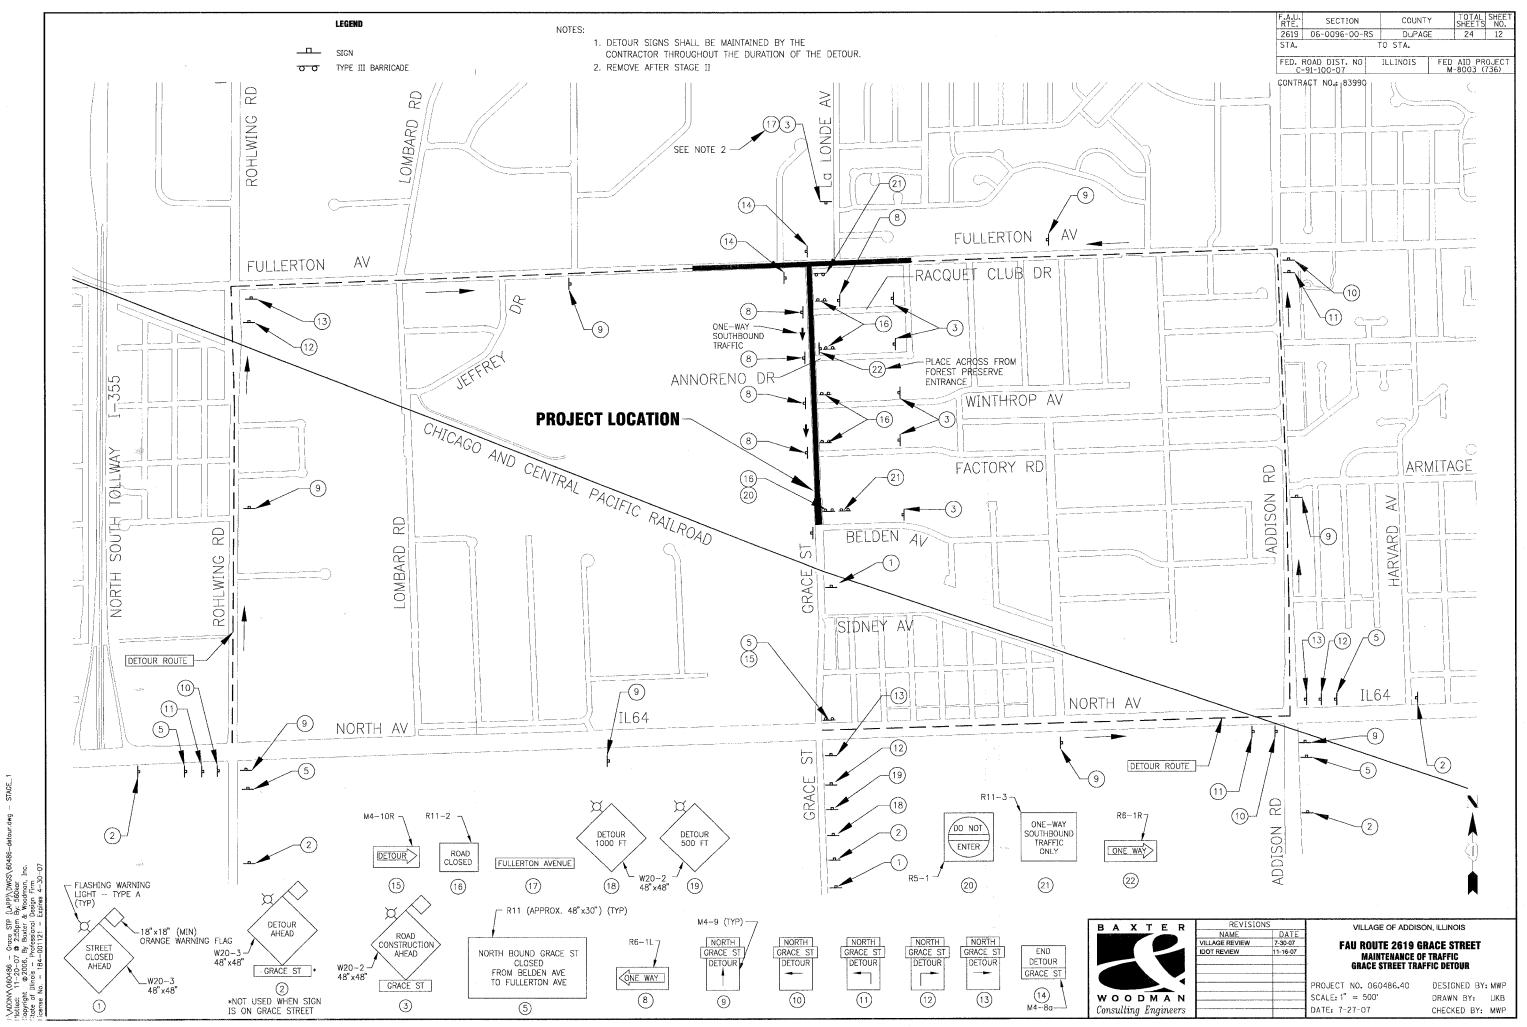


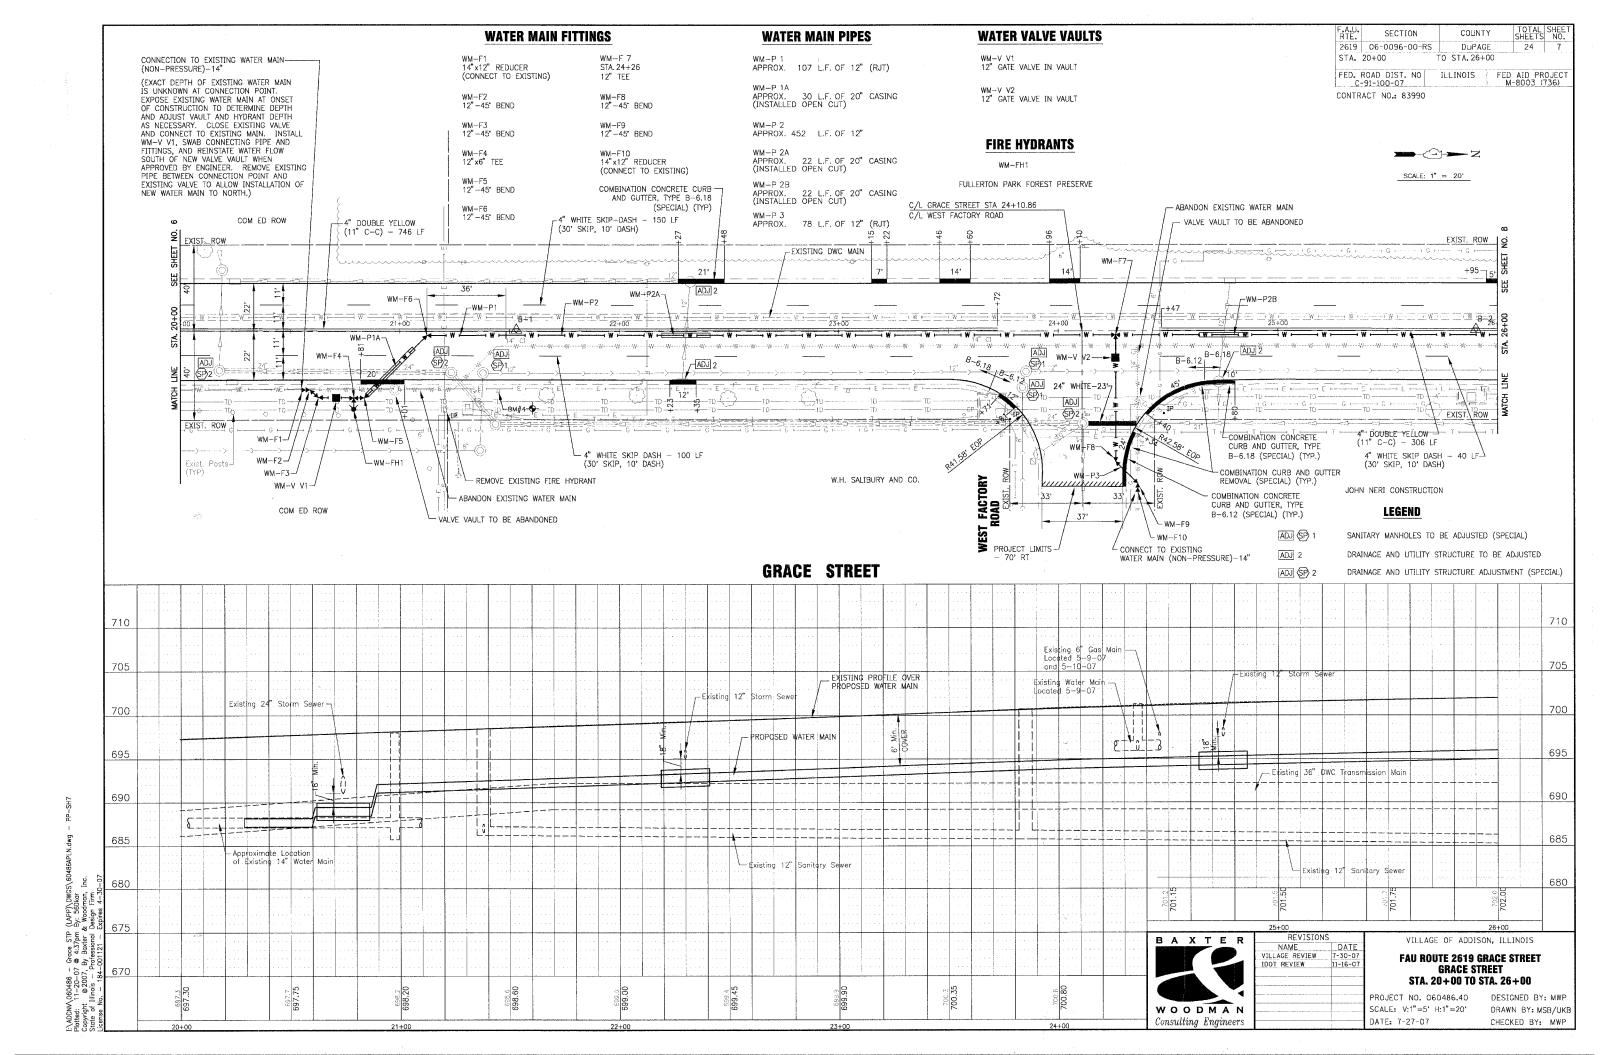

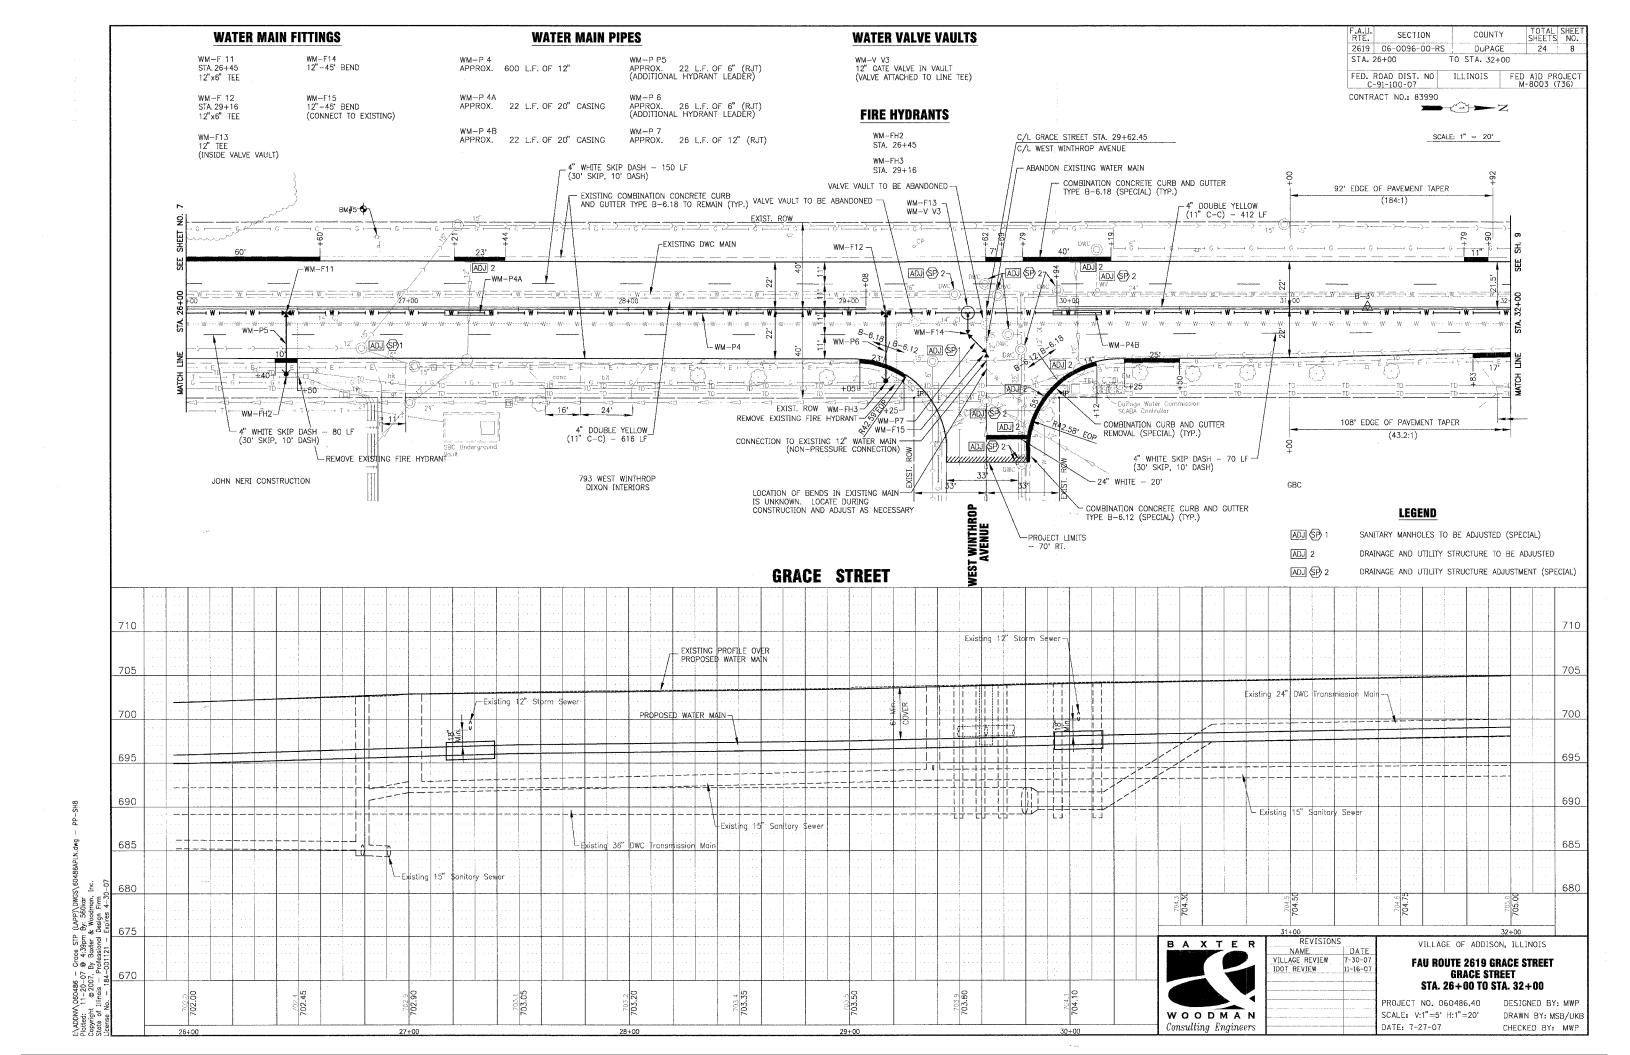


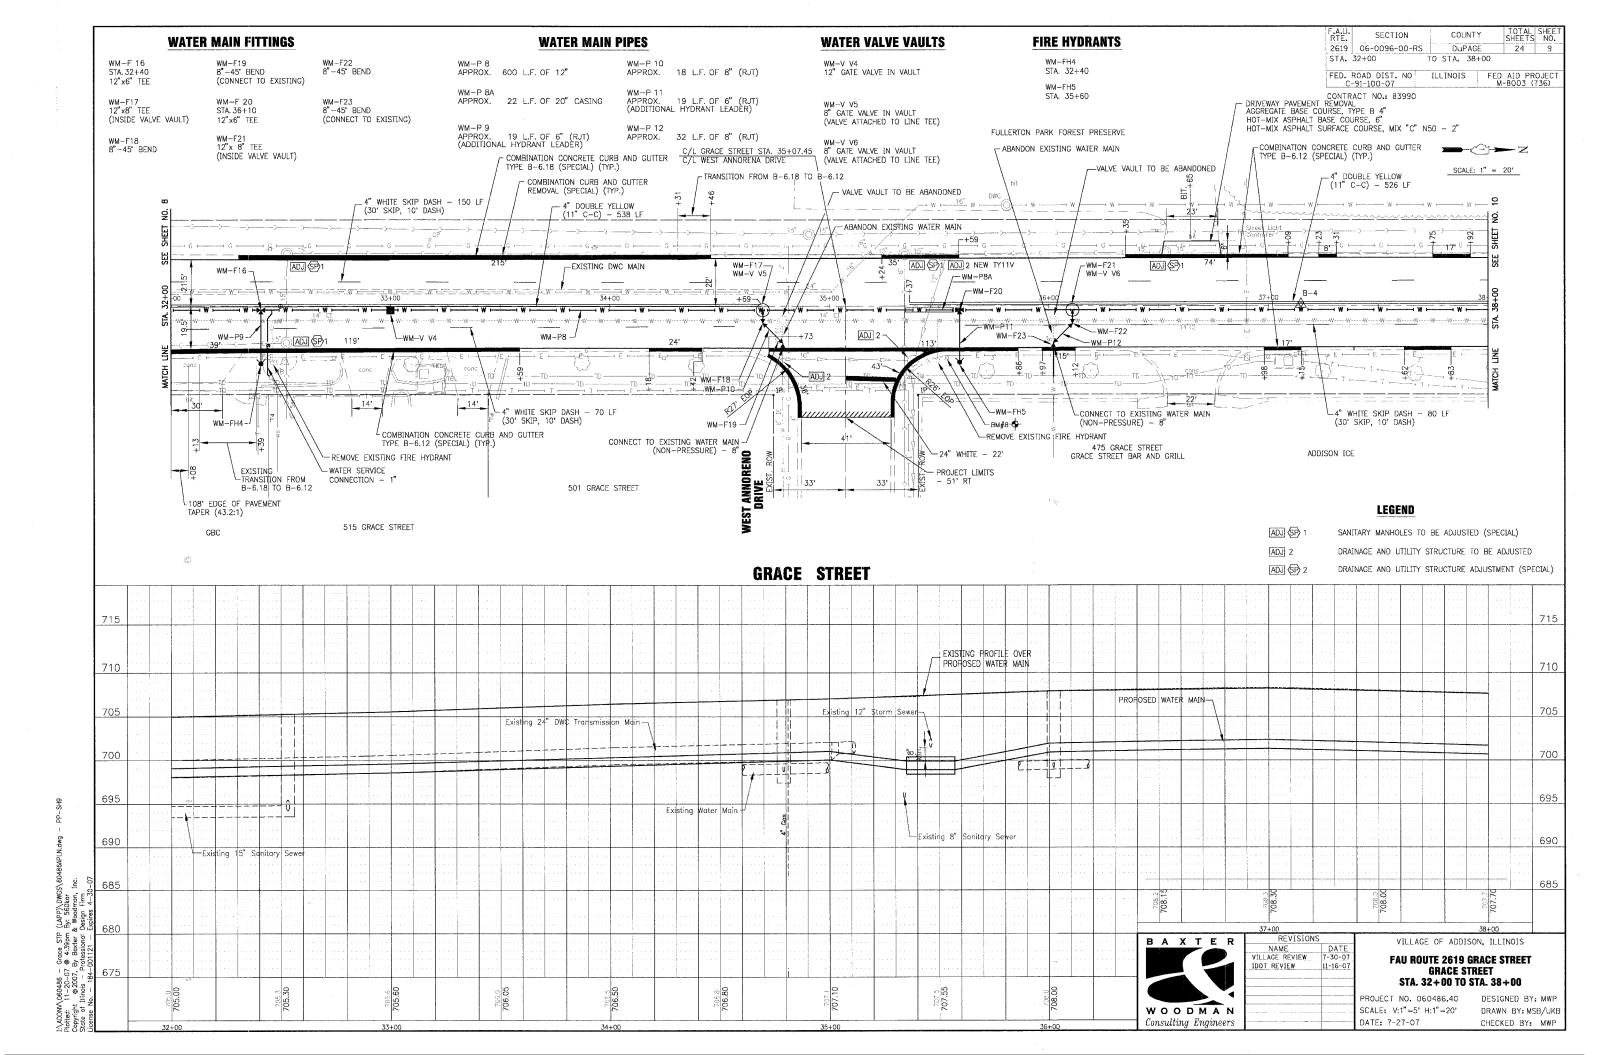

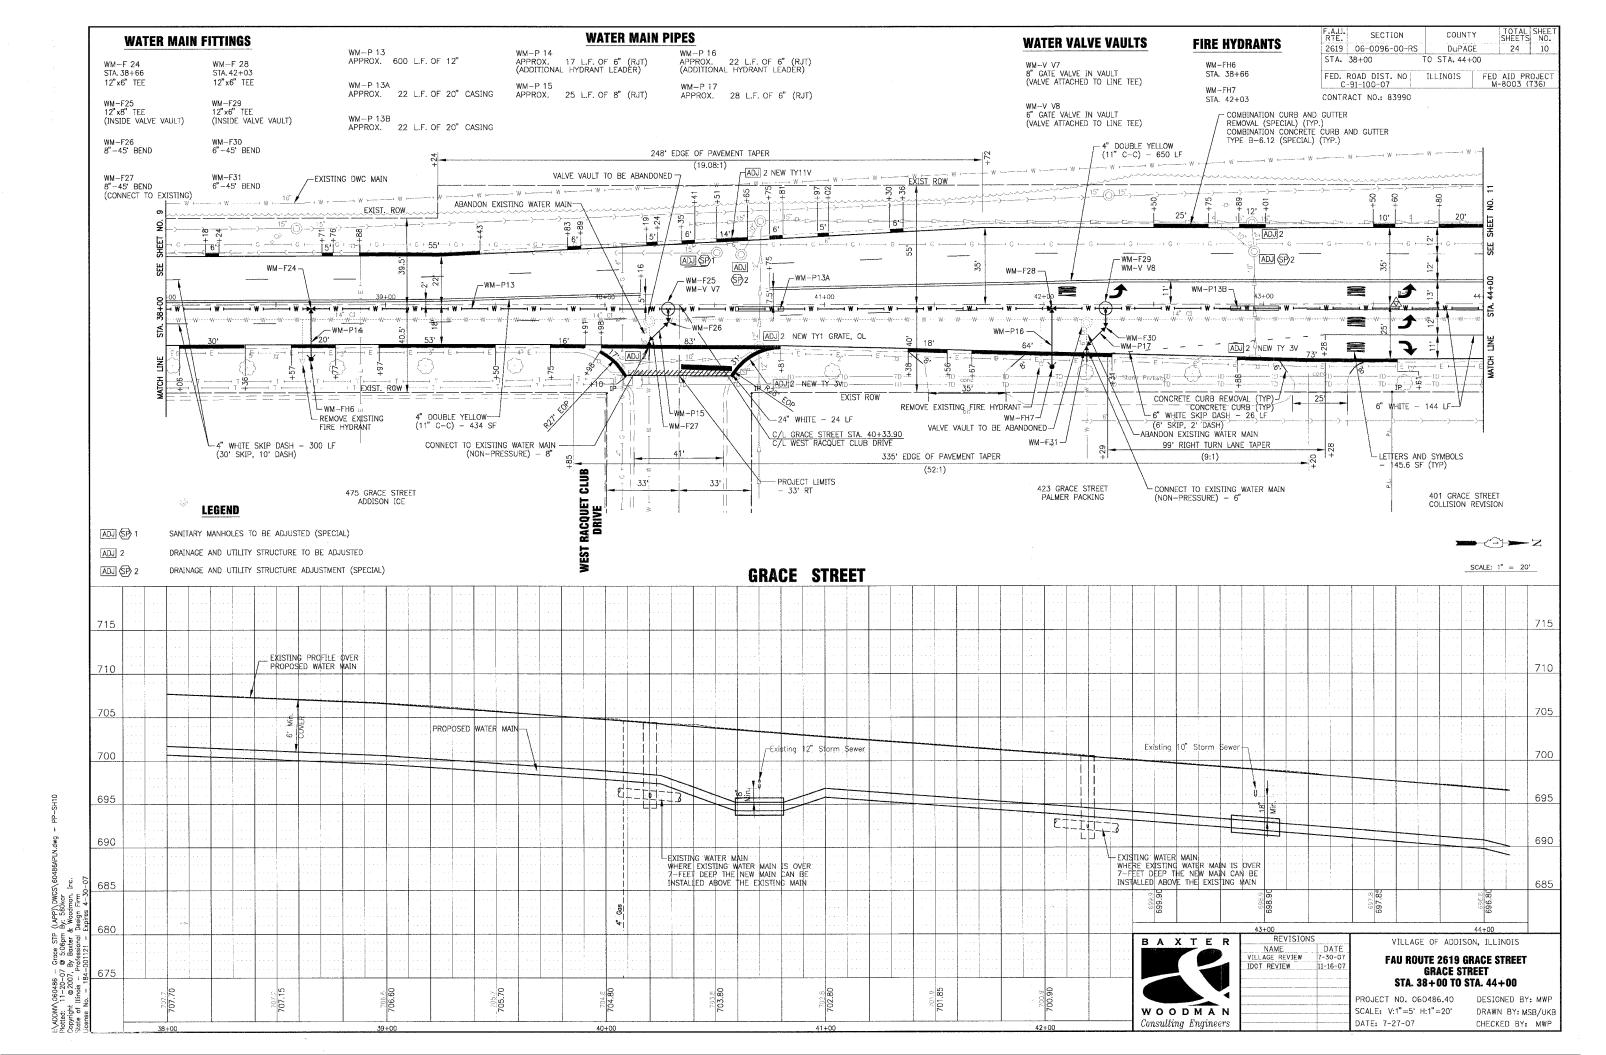


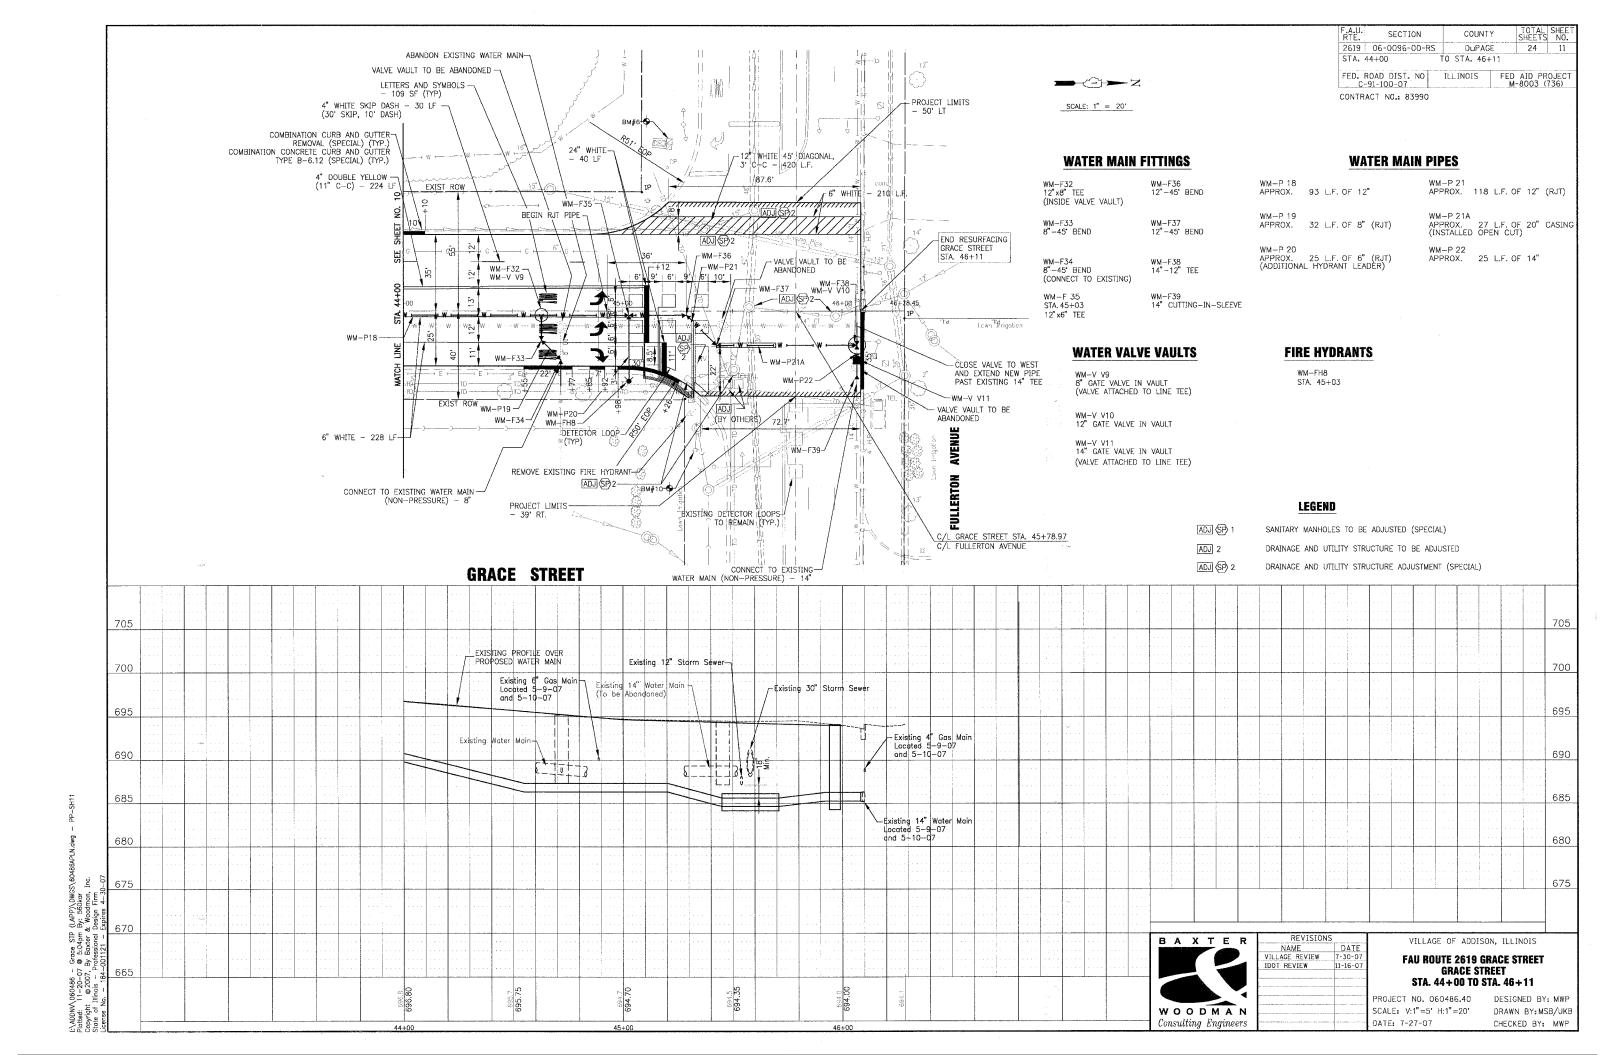

# **STAGE I TYPICAL SECTION FULLERTON AVENUE**

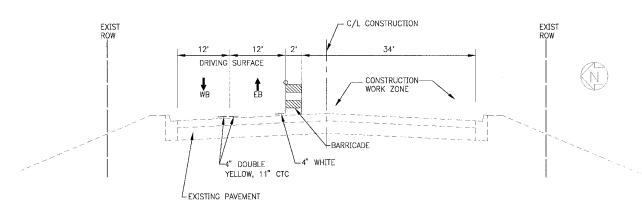

STAGE II TYPICAL SECTION **FULLERTON AVENUE** 

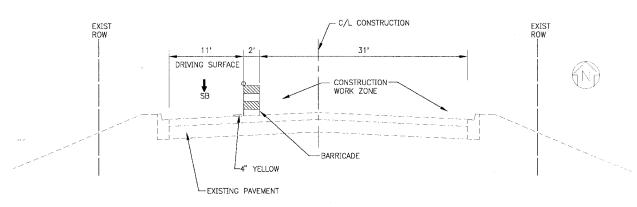

STAGE I, II, III TYPICAL SECTION **GRACE STREET** 

SECTION COUNTY 2619 06-0096-00-RS DuPAGE FED. ROAD DIST, NO ILLINOIS FED AID PROJECT M-8003 (736) CONTRACT NO.: 83990

## **MAINTENANCE OF TRAFFIC AND CONSTRUCTION STAGING**

#### CONSTRUCTION HOURS.

CONSTRUCTION ACTIVITY WITHIN THE PROJECT LIMITS SHALL OCCUR BETWEEN 7:00 AM AND 7:00 PM IN ACCORDANCE WITH

#### EMERGENCY SERVICES NOTIFICATION.

EMERGENCY ACCESS SHALL BE MAINTAINED AT ALL TIMES.

THE CONTRACTOR SHALL ADVISE ALL EMERGENCY RESPONDERS A MINIMUM OF 3 DAYS IN ADVANCE OF CONSTRUCTION ACTIVITIES WHICH IMPACT ALL EMERGENCY SERVICES. THIS WILL INCLUDE, BUT IS NOT LIMITED TO, THE ADDISON FIRE DEPARTMENT.

# **GENERAL NOTES**

- THE CONTRACTOR SHALL MAINTAIN EXISTING LANE WIDTHS FOR TRAFFIC FLOW THROUGHOUT THE DURATION OF THE CONTRACT UNLESS OTHERWISE DETERMINED BY THE ENGINEER.
- 2. ALL SIDE STREETS SHALL BE OPEN TO TRAFFIC THROUGHOUT THE DURATION OF THE CONTRACT.
- DURING FULLERTON AVENUE WATERMAIN WORK, THE VILLAGE WILL OPERATE THE FULLERTON/GRACE AND FULLERTON/LA LONDE TRAFFIC SIGNALS IN FLASHING RED/STOP CONTROL MODE.
- THE CONTRACTOR SHALL NOTIFY THE VILLAGE A MINIMUM OF 72 HOURS PRIOR TO CONSTRUCTION OPERATIONS INVOLVING THE TEMPORARY CLOSING OF DRIVES OR THE ROADWAY. THE CONTRACTOR SHALL PROVIDE A 48-HOUR NOTICE TO AFFECTED PARTIES BY DISTRIBUTING WRITTEN NOTICES AND/OR POSTING SIGNS.
- BUSINESSES SHALL HAVE ACCESS TO THEIR DRIVES.
- THE ENGINEER SHALL BE INFORMED 72-HOURS IN ADVANCE OF ANY CHANGE IN CONSTRUCTION STAGING.
- TYPE'I BARRICADES, BARRELS AND VERTICAL PANELS SHALL BE EQUIPPED WITH MONO-DIRECTIONAL STEADY BURN LIGHTS AND SHALL BE PLACED AT 50-FOOT INTERVALS ALONG THE PROPOSED CONSTRUCTION ZONE AND 25-FOOT INTERVALS WITHIN TAPER SECTIONS OR AS DETERMINED BY THE ENGINEER.
- 8. UTILIZE SHORT TERM PAVEMENT MARKINGS ON FULLERTON AVENUE AND GRACE STREET. SHORT—TERM PAVEMENT MARKINGS SHALL NOT DAMAGE EXISTING PAVEMENT MARKINGS TO REMAIN. ANY AND ALL REPLACEMENT OF EXISTING PAVEMENT MARKINGS, AS DETERMINED BY THE ENGINEER, SHALL BE INCLUDED IN THE COST FOR TRAFFIC CONTROL DETOUR.
- ALL SHORT-TERM PAVEMENT MARKINGS SHOWING DETERIORATION SHALL BE REPLACED BY THE CONTRACTOR AS DETERMINED BY THE ENGINEER. ALL MARKINGS REQUIRING REPLACEMENT SHALL BE REPLACED BY THE CONTRACTOR AT HIS
- 10. THE FURNISHING, INSTALLING AND RELOCATION OF ALL TRAFFIC SIGNS SHALL BE INCLUDED IN THE COST FOR TRAFFIC CONTROL AND PROTECTION. ALL CONFLICTING TRAFFIC SIGNS SHALL BE COVERED AS DETERMINED BY THE ENGINEER. THIS SHALL BE INCLUDED IN THE COST FOR TRAFFIC CONTROL DETOUR.
- 11. CONTRACTOR SHALL ESTABLISH A 30 MPH CONSTRUCTION ZONE SPEED LIMIT.

#### **SUGGESTED CONSTRUCTION STAGING**

INSTALL TRAFFIC DETOUR. SET GRACE STREET AND FULLERTON AVENUE AND LA LONDE AVENUE AND FULLERTON AVENUE INTERSECTION TRAFFIC SIGNALS TO FLASHING RED/STOP CONTROL MODE. STAGE I:

SET UP LANE CLOSURE AND SIGNAGE ON FULLERTON AVENUE PER HIGHWAY STANDARDS.

MOVE TRAFFIC TO SOUTH SIDE OF FULLERTON AVENUE.

INSTALL WATER MAIN ON THE NORTH SIDE OF FULLERTON AVENUE.

PROVIDE TEMPORARY PAVEMENT ON ALL TRENCHES.

SWITCH FULLERTON AVENUE TRAFFIC TO NORTH SIDE OF PAVEMENT PER HIGHWAY STANDARDS. STAGE II:

INSTALL WATER MAIN ON THE SOUTH SIDE OF FULLERTON AVENUE. PROVIDE TEMPORARY PAVEMENT ON ALL TRENCHES.

OPEN FULLERTON AVENUE TO TRAFFIC AND RESTORE ALL TRAFFIC SIGNALS TO NORMAL OPERATION.

INSTALL WATER MAIN ON GRACE STREET. PROVIDE TEMPORARY PAVEMENT ON ALL TRENCHES. REMOVE GRACE STREET TRAFFIC DETOUR. STAGE III:

STAGE IV:

COMPLETE CURB REMOVAL AND REPLACEMENT, MILLING, PATCHING, RESURFACING AND PAVEMENT MARKINGS.

Consulting Engineers


REVISIONS VILLAGE REVIEW 7-30-0 WOODMAN


VILLAGE OF ADDISON, ILLINOIS


**FAU ROUTE 2619 GRACE STREET** MAINTENANCE OF TRAFFIC AND CONSTRUCTION STAGING


PROJECT NO. 060486.40 DESIGNED BY: MWF SCALE:


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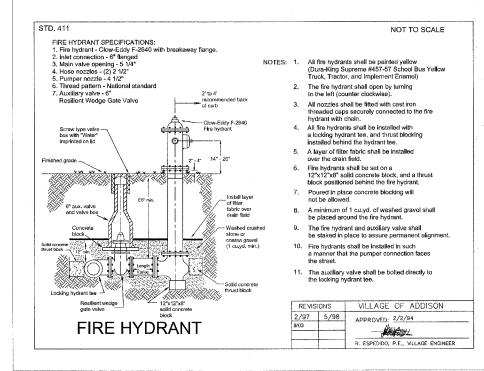


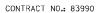


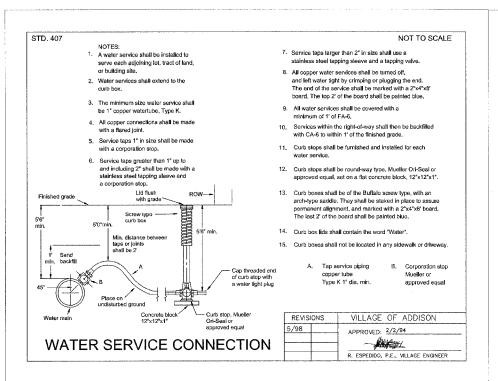

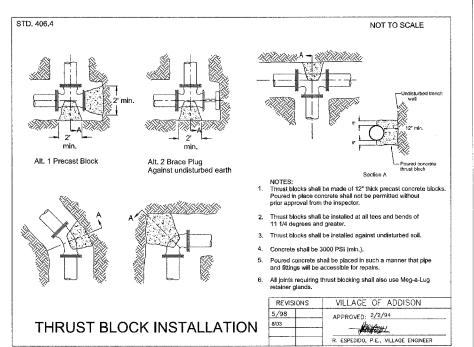

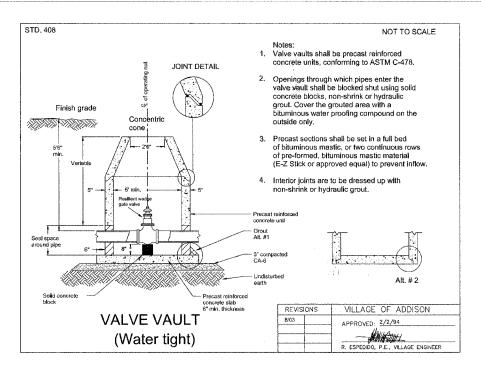

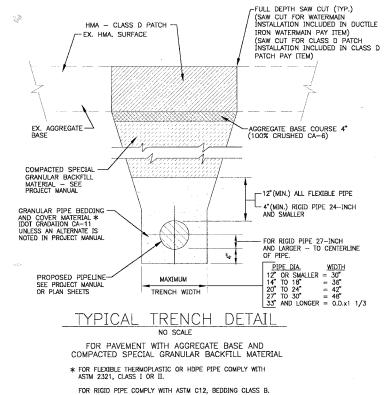

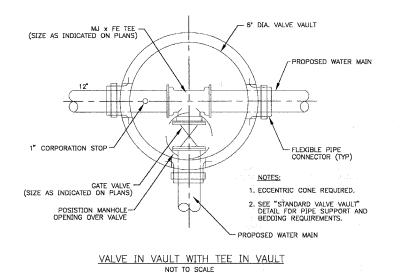




VILLAGE OF ADDISON, ILLINOIS


#### **FAU ROUTE 2619 GRACE STREET MISCELLANEOUS DETAILS**


PROJECT NO. 060486.40 SCALE: NONE DATE: 7-27-07

DESIGNED BY: MWP DRAWN BY: MSB CHECKED BY: MWP.

(LAPP)\DWC By: 560kar k Woodman, Design Firm

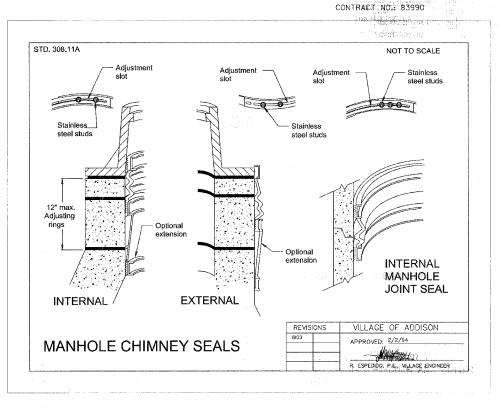

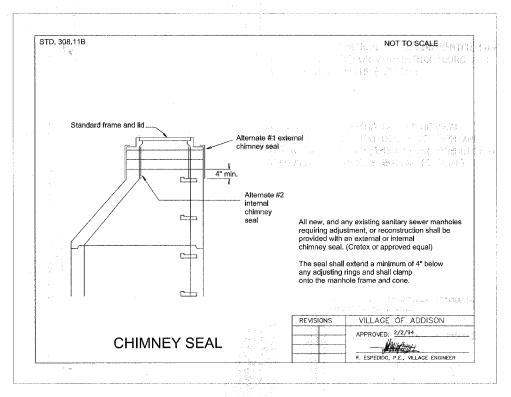

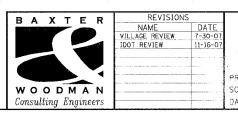

VILLAGE OF ADDISON, ILLINOIS


# FAU ROUTE 2619 GRACE STREET MISCELLANEOUS DETAILS

PROJECT NO. 060486.40 SCALE: NONE DATE: 7-27-07


DESIGNED BY: MWP DRAWN BY: MSB CHECKED BY: MWP

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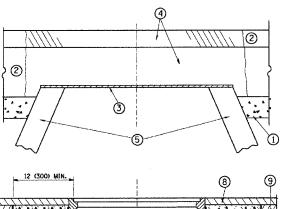


CONCRETE CURB AND GUTTER REMOVAL (SPECIAL) REPLACEMENT SHALL BE INCLUDED IN THE COST OF COMBINATION CONCRETE CURB AND GUTTER TYPE
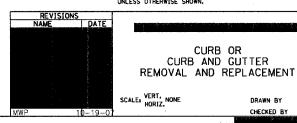
> B-6.12 (SPECIAL) OR COMBINATION CURB AND GUTTER TYPE B-6.18 (SPECIAL) CURB OR CURB AND GUTTER REMOVAL AND REPLACEMENT

DATE NAME SCALE NAME
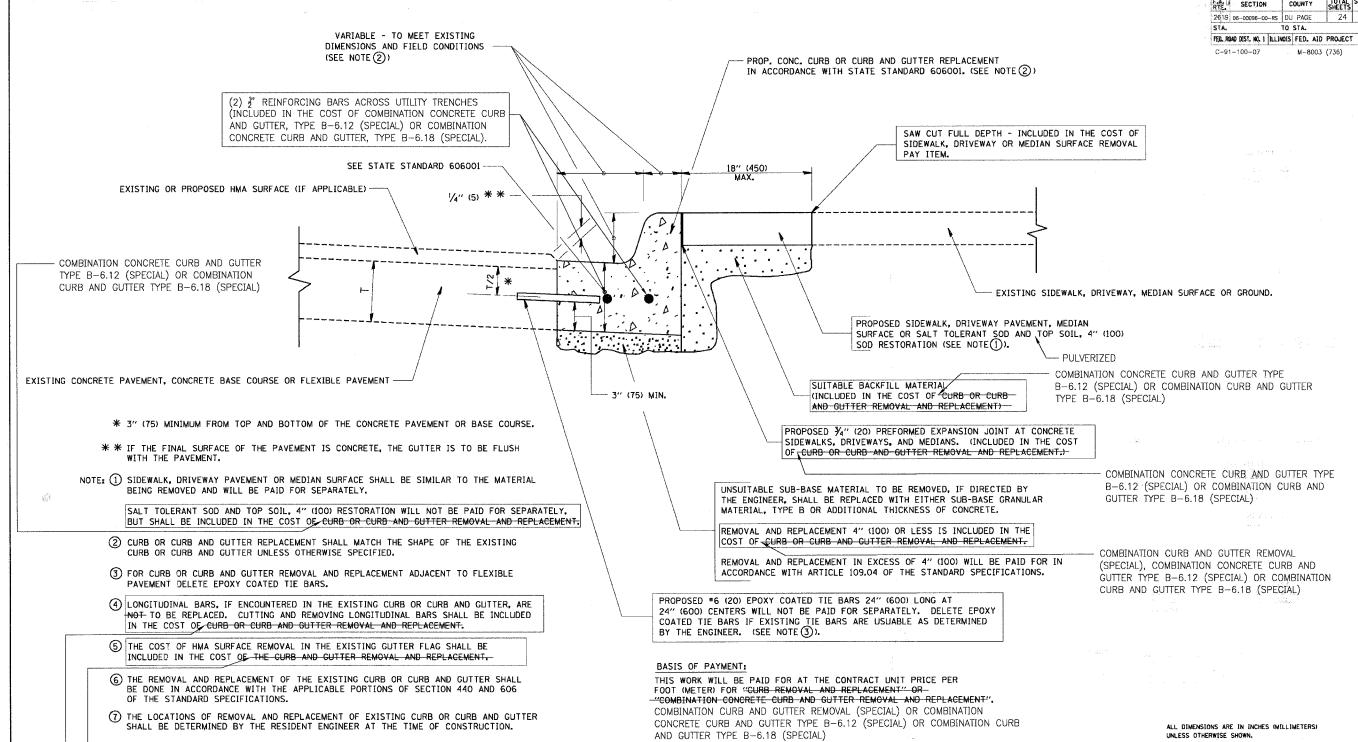
| F.A.U.  | SECTION         |   | COUNT | Y   | TOTAL   | SHEET<br>NO. |
|---------|-----------------|---|-------|-----|---------|--------------|
| 2619    | 06-00096-00     | -RS Di                                  | PAGE  | Ξ   | 24      | 17           |
| STA.    |                 | TO                                      | STA.  |     |         |              |
| FED. RO | DAD DEST. NO. 1 | ILLINOIS                                | FED.  | AID | PROJECT |              |
| C-91    | -100-07         | *************************************** | M-8   | 003 | (736)   |              |



# B) INSTALL THE FRAME AND LID; ADJUST THE FRAME TO ITS FINAL SURFACE ELEVATION. C) THE SURROUNDING SPACE SHALL BE FILLED WITH CLASS SI CONCRETE, OR HMA SURFACE COURSE OR HMA BINDER COURSE TO THE ELEVATION OF THE SURFACE OF THE EXISTING BASE COURSE OR THE BINDER COURSE. THE PROCEDURE EXPLAINED ABOVE SHALL CONFORM TO THE APPLICABLE PORTIONS OF SECTIONS 353, 406, 602, AND 603 OF THE STANDARD SPECIFICATIONS. ( D. - PROPOSED SAND FILL

LEGEND

CONSTRUCTION PROCEDURES

A) REMOVE A MINIMUM OF 12 (300) OF THE PAVEMENT FROM AROUND THE STRUCTURE. B) REMOVE THE EXISTING FRAME AND LID FROM THE STRUCTURE. C) COVER THE STRUCTURE OPENING WITH A 36 (900) DIAMETER METAL PLATE.

DI BACKFILL WITH CRUSHED STONE AND A MINIMUM 11/2 (40)
THICK HMA SURFACE MIX APPROVED BY THE ENGINEER.

A) REMOVE THE HMA SURFACE MIX AND CRUSHED STONE.

STAGE 1 (BEFORE PAVEMENT MILLING)

STAGE 2 (AFTER PAVEMENT MILLING)

1 SUB-BASE GRANULAR MATERIAL

6 FRAME AND LID (SEE NOTES)

2 EXISTING PAVEMENT

CLASS SI CONCRETE, HMA SURFACE COURSE OR HMA BINDER COURSE

3 36 (900) DIAMETER METAL PLATE PROPOSED CRUSHED STONE AND HMA SURFACE MIX

8 PROPOSED HMA SURFACE COURSE

5 EXISTING STRUCTURE

9 PROPOSED HMA BINDER COURSE

#### LOCATION OF STRUCTURES:

THE CONTRACTOR WILL BE REQUIRED TO KEEP A RECORD OF THE LOCATIONS OF THE BURIED SITUCTURES ACCORDING TO THE STATION AND DISTANCE LEFT OR RIGHT OF THE CENTERLINE OF PAVEMENT. UPON COMPLETION OF THE WORK, THE CONTRACTOR WILL DELIVER THE RECORD TO THE ENGINEER.

BASIS OF PAYMENT: THIS WORK WILL BE PAID FOR AT THE CONTRACT UNIT PRICE PER EACH FOR "FRAMES AND LIDS TO BE ADJUSTED, SPECIAL"

NEW FRAMES AND LIDS, WHEN SPECIFIED, WILL BE PAID FOR SEPARATELY.

# DETAILS FOR FRAMES AND LIDS ADJUSTMENT

WITH MILLING

ALL DIMENSIONS ARE IN INCHES (MILLIMETERS) UNLESS OTHERWISE SHOWN

ILLINOIS DEPARTMENT OF TRANSPORTATION DETAILS FOR R. SHAH
R. SHAH
A. ABBAS
R. WIEDEMAN
R. BORO FRAMES AND LIDS ADJUSTMENT WITH MILLING

CHECKED BY BD600-03 (BD-8)

= 3/5/2887 = Ki\distatd\bd88.dgn E = 58.8888 ' IN. = beuerdl DATE NAME SCALE NAME

.0. -6 PROPOSED - BRICK, MORTAR, OR CONC. ADJUSTING RINGS \_PROPOSED SAND FILL


EXISTING BROKEN FRAMES AND LIDS SHALL BE REMOVED AND DISPOSED OF BY THE CONTRACTOR AND SHALL BE REPLACED AS DIRECTED BY THE ENGINEER, REPLACEMENT FRAMES AND LIDS WILL BE PAID FOR IN ACCORDANCE WITH ARTICLE 109AU OF THE STANDARD SPECIFICATIONS UNLESS A SEPARATE PAY ITEM HAS BEEN PROVIDED.

IF THE EXISTING LIDS ARE OPEN, THE FRAME WILL BE ADJUSTED TO THE ELEVATION OF THE MILLED PAYEMENT SURFACE PRIOR TO THE MILLING OPERATION. THE FRAME WILL NOT BE REMOVED AND COVERED BY THE METAL PLATE.

CITY OF CHICAGO CASTINGS ARE THE PROPERTY OF THE CITY AND THE CONTRACTOR SHALL MOTIFY THE CITY FOR REMOVAL AND DISPOSITION OF THE CASTINGS.

THE METAL PLATE USED TO COVER THE STRUCTURE SHALL REMAIN THE PROPERTY OF THE CONTRACTOR.

WHEN STRUCTURES ARE TO BE ADJUSTED OR RECONSTRUCTED, THE LOWERING AND RAISING OF THE FRAMES AND LIDS WILL NOT BE PAID FOR SEPARATELY BUT WILL BE INCLUDED IN THE COST OF THE CORRESPONDING PAY ITEM.

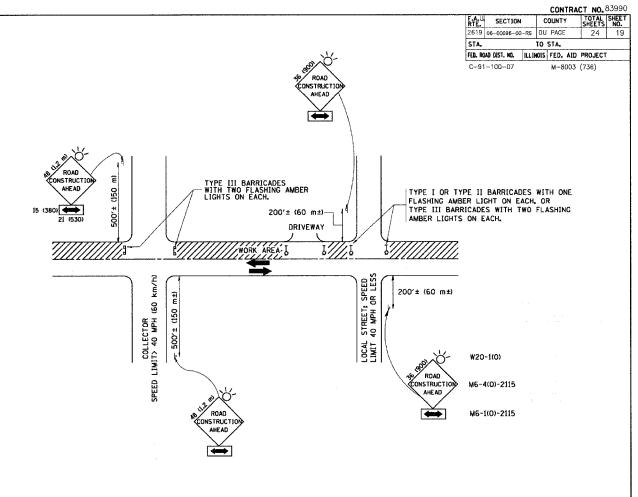

TRAFFIC CONTROL AND PROTECTION FOR SIDE ROADS, INTERSECTIONS, AND DRIVEWAYS

# NOTES:

- A. FOR NO LANE RESTRICTION ON THE SIDE ROAD OR DRIVEWAYS
- 1. SIDE ROAD WITH A SPEED LIMIT OF 40 MPH (60 km/h) OR LESS AS SHOWN ON THE DRAWING AND AS DIRECTED BY THE ENGINEER:
- O) ONE ROAD CONSTRUCTION AHEAD SIGN 36 x 36 (900x900) WITH A FLASHER AND FLAG MOUNTED ON IT APPROXIMATELY 200' (60 m) IN ADVANCE OF THE MAIN ROUTE.
- b) THE CLOSED PORTION OF THE MAIN ROUTE SHALL BE PROTECTED BY BLOCKING WITH TYPE I, TYPE II OR TYPE III BARRICADES, 1/3 OF THE CROSS SECTION OF THE CLOSED PORTION.
- 2. SIDE ROAD WITH A SPEED LIMIT GREATER THAN 40 MPH (60 km/h)
  AS SHOWN ON THE DRAWING AND AS DIRECTED BY THE ENGINEER:
- O) ONE ROAD CONSTRUCTION AHEAD SIGN 48 x 48 (1.2 m x 1.2 m) WITH A FLASHER MOUNTED ON IT APPROXIMATELY 500' (150 m) IN ADVANCE OF THE MAIN ROUTE.
- b) THE CLOSED PORTION OF THE MAIN ROUTE SHALL BE PROTECTED BY BLOCKING WITH TYPE III BARRICADES, 1/2 OF THE CROSS SECTION OF THE CLOSED PORTION.
- 3. WHEN THE SIDE ROAD LIES BETWEEN THE BEGINNING OF THE MAINLINE SIGNING AND THE WORK ZONE, A SINGLE HEADED ARROW (MG-1) SHALL BE USED IN LIEU OF THE DOUBLE HEADED ARROW (MG-4).

- B. FOR A LANE CLOSURE ON A SIDE ROAD OR DRIVEWAY:
- USE APPLICABLE PORTIONS OF THE TYPICAL APPLICATION OF TRAFFIC CONTROL DEVICES (STD. 701501, STD. 701506 OR THE APPROPRIATE STANDARD). THE SPACING OF SIGNS AND BARRICADES SHALL BE ADJUSTED FOR FIELD CONDITIONS AS DIRECTED BY THE ENGINEER. THE DIRECTIONAL ARROW SHALL BE COVERED OR REMOVED WHEN NO LONGER CONSISTENT WITH THE SIDE ROAD LANE CLOSURE.
- C. ADVANCE WARNING SIGNS ARE TO BE OMITTED ON DRIVEWAY UNLESS OTHERWISE NOTED.
- D. THE TRAFFIC CONTROL AND PROTECTION FOR SIDE ROADS, INTERSECTIONS, AND DRIVEWAYS SHALL BE INCIDENTAL TO THE COST OF SPECIFIED TRAFFIC CONTROL STANDARDS OR ITEMS.

All dimensions are in millimeters (inches) unless otherwise shown.


| REVISIO      | NS .     | ILLINOIS DEDARTMEN | T OF TRANSPORTATION |
|--------------|----------|--------------------|---------------------|
| NAME         | DATE     | ILLINOIS DEPARTMEN | I OF TRANSPORTATION |
| LHA          | 6/89     | TRAFFIC CONTROL    | AND PROTECTION      |
| T. RAMMACHER | 09/08/94 |                    |                     |
| J. OBERLE    | 10/18/95 | F                  | OR                  |
| A. HOUSEH    | 03/06/96 | CIDE BOADS IN      | TERSECTIONS. AND    |
| A. HOUSEH    | 10/15/96 | SIDE MONDS! IN     | EKSECTIONS, MIND    |
| T. RAMMACHER | 01/06/00 | DRIV               | EWAYS               |
|              |          |                    |                     |
|              |          | SCALE: NONE        | ODAWN DV            |
|              |          | SCALET NONE        | DRAWN BY            |
|              |          |                    |                     |

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DATE = 3/6/2087 NAME = KINdistacd/sol6.dgn SCALE = 56.886 / IN. NAME = bewerd!


2-4 (100) YELLOW # 11 (280) C-C-4' (1.2 m) OUTSIDE TO NO DIAGONALS -- 2-4 (100) YELLOW @ 11 (280) C-C

# 4' (1.2 m) WIDE MEDIANS ONLY

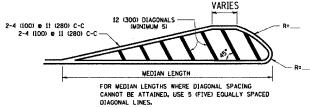

DIAGONAL LINE SPACING: 50' (15 m) C-C (LESS THAN 30MPH (50 km/h))
75' (25 m) C-C 30MPH (50 km/h) TO 45MPH (70 km/h))
150' (45 m) C-C (MORE THAN 45MPH (70 km/h))

#### MEDIANS OVER 4' (1,2 m) WIDE

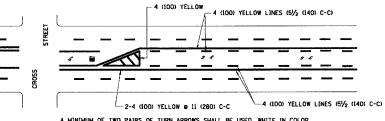


A MINIMUM OF TWO PAIRS OF TURN ARROWS SHALL BE USED, WHITE IN COLOR, ADDITIONAL PAIRS SHALL BE PLACED AT 200' (60 m) TO 300' (90 m) INTERVALS.



MEDIAN WITH TWO-WAY LEFT TURN LANE

## TYPICAL PAINTED MEDIAN MARKING

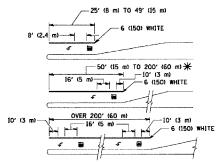


FULL SIZE LETTERS 8' (2.4 m) AND ARROWS SHALL BE USED.  $\P$  AREA = 15.6 SO. FT. (1.5 m<sup>2</sup> )  $ML_I^V$  AREA = 20.8 SO. FT. (1.9 m<sup>2</sup>)

\* TURN LANES IN EXCESS OF 400' (120 m) IN LENGTH MAY HAVE AN ADDITIONAL SET OF ARROW - "ONLY" INSTALLED MIDWAY BETWEEN THE OTHER TWO SETS OF ARROW - "ONLY".

TYPICAL LEFT (OR RIGHT) TURN LANE

# TYPICAL TURN LANE MARKING

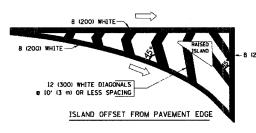

|    |                     |              |         |                   | CUN  | IMA   | CI NU.             | 02330 |
|----|---------------------|--------------|---------|-------------------|------|-------|--------------------|-------|
|    | F.A.U.              | SECTION      |         | COUNTY<br>DU PAGE |      | TOTAL | SHEET<br>NO.<br>20 |       |
|    | 2619 06-00096-00-RS |              | )-RS    |                   |      | 24    |                    |       |
|    | STA.                |              | TO STA. |                   |      |       |                    |       |
|    | FED. RO             | AD DIST, NO. | ILLE    | NOIS              | FED. | AID   | PROJECT            |       |
| TE | C-91                | -100-07      |         |                   | M-8  | 003   | (736)              |       |

--- 2 (50) 8 (200) WHITE -RAISED ISLAND ISLAND AT PAVEMENT EDGE

# TYPICAL ISLAND MARKING

|   | 1   |                         |                                |  |
|---|---|-------------------------|--------------------------------|--|
| TYPE OF MARKING   | WIDTH OF LINE   | PATTERN                 | COLOR                          | SPACING / REMARKS  |
| CENTERLINE ON 2 LANE PAVEMENT   | 4 (100)   | SKIP-DASH               | YELLOW                         | 10' (3 m) LINE WITH 30' (9 m) SPACE  |
| CENTERLINE ON MULTI-LANE UNDIVEDED PAVEMENT   | 2 8 4 (100)   | SOLID                   | YELLOW                         | 11 (280) C-C   |
| NO PASSING ZONE LINES:<br>FOR ONE DIRECTION<br>FOR BOTH DIRECTIONS                                | 4 (100)<br>2 0 4 (100)  | SOLID<br>SOLID          | YELLOW<br>YELLOW               | 5/2 (140) C-C FROM SKIP-DASH CENTERLINE<br>11 (280) C-C<br>OWIT SKIP-DASH CENTERLINE BETWEEN   |
| LANE LINES  | 4 (100)<br>5 (125) ON FREEWAYS  | SKIP-DASH<br>SKIP-DASH  | WHITE<br>WHITE                 | 10' (3 m) LINE WITH 30' (9 m) SPACE  |
| DOTTED LINES (EXTENSIONS OF CENTER, LANE OR TURN LANE MARKINGS)                                   | SAME AS LINE BEING<br>EXTENDED  | SKIP-DASH               | SAME AS LINE BEING<br>EXTENDED | 2' (600) LINE WITH 6' (1.8 m) SPACE  |
| EDGE LINES  | 4 (100)   | SOLID                   | YELLOW-LEFT<br>WHITE-RIGHT     | OUTLINE MOUNTABLE MEDIANS IN<br>YELLOW: EDGE LINES ARE NOT<br>USED NEXT TO BARRIER CURB  |
| TURN LANE MARKINGS  | 6 (150) LINE; FULL<br>SIZE LETTERS &<br>SYMBOLS (8' (2.4m))                           | SOLID                   | WHITE                          | SEE TYPICAL TURN LANE MARKING DETAIL   |
| TWO WAY LEFT TURN MARKING   | 2 e 4 (100)<br>EACH DIRECTION   | SKIP-DASH<br>AND SOLID  | YELLOW                         | 10' (3 m) LINE WITH 30' (9 m) SPACE FOR<br>SKIP-DASH: 5½ (140) C-C BETWEEN SOLID<br>LINE AND SKIP-DASH LINE  |
| × 1   | 8' (2.4m) LEFT ARROW  | IN PAIRS                | WHITE                          | SEE TYPICAL TWO-WAY LEFT TURN<br>MARKING DETAIL  |
| CROSSWALK LINES (PEDESTRIAN)<br>A. DIAGONALS (BIKE & EQUESTRIAN)<br>B. LONGITUDINAL BARS (SCHOOL) | 2 g 6 (150)<br>12 (300) g 45°<br>12 (300) g 90°                                       | SOLID<br>SOLID<br>SOLID | WHITE<br>WHITE<br>WHITE        | NOT LESS THAN 6' (1.8 m) APART<br>2' (500) APART<br>2' (500) APART<br>SEE TYPICAL CROSSWALK MARKING DETAILS.   |
| STOP LINES  | 24 (600)  | SOLID                   | WHITE                          | PLACE 4' 11.2 mJ IN ADVANCE OF AND PARALLEL TO CROSSMALK, IF PRESENT. OTHERWISE, PLACE AT DESIRED STOPPING POINT. PARALLEL TO CROSSROAD CENTERLINE, WHERE POSSIBLE |
| PAINTED MEDIANS   | 2 e 4 (100) WITH<br>12 (300) DIAGONALS  | SOLID                   | YELLOW:<br>TWO WAY TRAFFIC     | 11 (280) C-C FOR THE DOUBLE LINE   |
| - "   | e 45°  NO DIAGONALS USED FOR 4' (1.2 m) WIDE MEDIANS                                  |                         | WHITE:<br>ONE WAY TRAFFIC      | SEE TYPICAL PAINTED MEDIAN MARKING.  |
| GORE MARKING AND<br>CHANNELIZING LINES  | 8 (200) WITH 12 (300)<br>DIAGONALS @ 45°  | SOLID                   | WHITE                          | DIAGONALS: 15' (4.5 m) C-C (LESS THAN 30MPH (50 km/h)) 20' (6 m) C-C 30MPH (50 km/h) TO 45MPH (70 km/h)) 30' (9 m) C-C (OVER 45MPH (70 km/h))                      |
| RAILROAD CROSSING   | 24 (600) TRANSVERSE<br>LINES; "RR" IS 6' (1.8 m)<br>LETTERS; 16 (400)<br>LINE FOR "X" | SOLID                   | WHITE                          | SEE STATE STANDARD 780001<br>AREA OF1<br>"M"=3.6 SO. FT. (0.33 m <sup>2</sup> ) EACH<br>"X"=54.0 SO. FT. (5.0 m <sup>2</sup> )                                     |
| SHOULDER DIAGONALS  | (2 (300) <b>e</b> 45°   | SOLID                   | WHITE - RIGHT<br>YELLOW - LEFT | 50' (15 m) C-C (LESS THAN 30MPH (50 km/h))<br>75' (25 m) C-C (30 MPH (50 km/h) T0 45MPH (70 km/h))<br>150' (45 m) C-C (0VER 45MPH (70 km/h))                       |
|   | -L  |                         |                                | <del></del>  |

FOR FURTHER DETAILS ON PAVEMENT MARKING REFER TO STANDARD SPECIFICATIONS FOR ROAD AND BRIDGE CONSTRUCTION AND STATE STANDARD 780001.

All dimensions are in inches (millimeters) unless otherwise shown.


| REVISIONS    |          | ILLINOIS DEPARTMENT OF TRANSPORTATION |                |  |
|--------------|----------|---------------------------------------|----------------|--|
| NAME         | DATE     | LILINOIS DEPARTMENT OF TRANSPORTA     |                |  |
| EVERS        | 03-19-90 |                                       |                |  |
| T. RAMMACHER | 10-27-94 |                                       | DISTRICT ONE   |  |
| ALEX HOUSEH  | 10-09-96 |                                       |                |  |
| ALEX HOUSEH  | 10-17-96 | TYF                                   | PICAL PAVEMENT |  |
| T. RAMMACHER | 01-06-00 |                                       | MARKINGS       |  |
|              |          |                                       |                |  |
|              |          | SCALE: NONE                           | DRAWN BY CADD  |  |
| ······       |          |                                       | CHECKED BY     |  |

DATE = 3/6/2887
NAME = KNdstard/
SCALE = 56,888 / ...

PLOT PLOT USER


| F.A.U.<br>RTE. | SECTION .     | COUNTY       | TOTAL   | SHEET<br>NO. |
|----------------|---------------|--------------|---------|--------------|
| 2619 0         | 6-00096-00-RS | DU PAGE      | 24      | 21           |
| STA.           |               | TO STA.      |         |              |
| FEN BOAT       | DIST NO THE   | UNIS FED ATO | PRO IFC | 7            |

FED. ROAD DIST. NO. C-91-100-07 M-8003 (736)

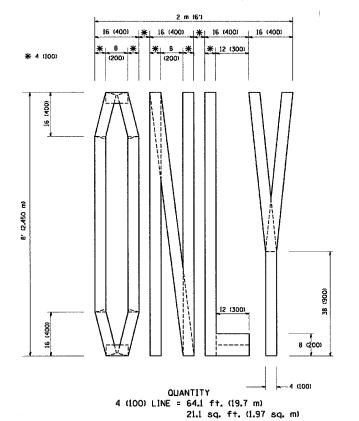

6'-8" (2,030 m) 30 (760) 12 (300)

QUANTITY 4 (100) LINE = 45.5 ft. (13.9 m) 15.2 sq. ft. (1.39 sq. m)

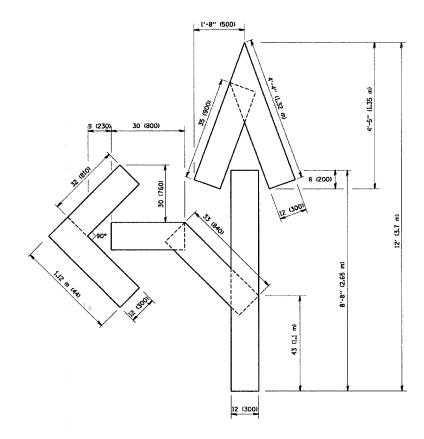

QUANTITY 4 (100) LINE = 82.5 ft. (25.3 m) 27.5 sq. ft. (2.53 sq. m)

All dimensions are in inches (millimeters) unless otherwise shown.

| NAME         | DATE    |
|--------------|---------|
| T. RAMMACHER | 09/18/9 |
| J. OBERLE    | 06/01/9 |
| T. RAMMACHER | 06/05/9 |
| T. RAMMACHER | 11/04/9 |
| T. RAMMACHER | 03/02/9 |
| E. GOMEZ     | 08/28/0 |

ILLINOIS DEPARTMENT OF TRANSPORTATION

PAVEMENT MARKING LETTERS AND SYMBOLS FOR TRAFFIC STAGING

SCALE: NONE

DRAWN BY CADD CHECKED BY

PLOT DATE » 3/7/2007 FILE NAME » Krydistacd/solficigin PLOT SCALE » 58.8800 "/ IN. USER NAME » bewerd!


CONTRACT NO.83990


RTE. SECTION COUNTY TOTAL SHEETS NO. 2619 06-00096-00-RS DU PAGE 24 22 STA. TO STA. FED. ROAD DIST. NO. BLUNOIS FED. AID PROJECT

C-91-100-07 M-8003 (736)

WORK ZONE EXIT OPENING

SIGNING FOR FLAGGING OPERATIONS AT WORK ZONE OPENINGS

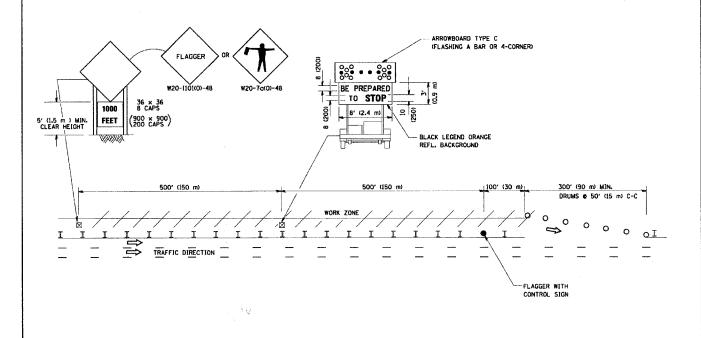

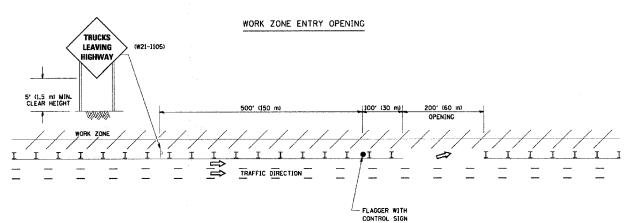

NOTES:

- 1. The Arrowboard, the Flagger Ahead trailer mounted sign, and the Trucks Leaving Highway sign shall be removed or turned away from traffic and the exit and entry openings shall be closed when the flagging operation ceases.
- 2. Work Zone Exit Openings should be a minimum of one half mile apart.
- 3. Exiting the work zone at any place other than at a Work Zone Exit Opening will be prohibited.

4. All vehicles shall enter the work zone at entry openings, using their turn signals to warn motorists

ALL DIMENSIONS ARE IN INCHES (MILLIMETERS)
LINLESS OTHERWISE SHOWN

ILLINOIS DEPARTMENT OF TRANSPORTATION SIGNING FOR FLAGGING OPERATIONS AT WORK ZONE OPENINGS

SCALE: NONE

CHECKED BY TC-18

DRAWN BY CADD

DATE = 3/7/2867
NAME = KNUMMELALAGEA
SCALE = 50-286 / IN.
NAME = bauerdi 

10/61

**CONTRACT NO. 83990** FED. ROAD DIST. NO. ILLINOIS FED. AID PROJECT C-91-100-07 M-8003 (736) USE APPROPRIATE MONTH AND DATE FOR CONTRACT BEGINS  $\times \times \times \times \times$ 58 (1450)

1. USE BLACK LETTERING ON ORANGE BACKGROUND.

- 2. ERECT SIGNS IN ADVANCE OF THE LOCATION FOR THE "ROAD CONSTRUCTION AHEAD" SIGN AT LOCATIONS AS DIRECTED BY THE ENGINEER.
- 3. ERECT SIGN (1) WITH INSTALLED PANEL (2) ONE WEEK PRIOR TO THE START OF CONSTRUCTION.
- 4. REMOVE PANEL 2 SOON AFTER THE START OF CONSTRUCTION.

68 (1700)

54 (1350)

ROAD WORK

—1 (25) BLACK BORDER

(175)

(175)

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(2.1

NOTES:

- 5. SEE SPECIAL PROVISION FOR "TEMPORARY INFORMATION SIGNING" FOR ADDITIONAL INFORMATION.
- 6. ONE SIGN ASSEMBLY EQUALS 25.70 SQ. FT. (2.3 SQ. M.)
- 7. SHALL BE PAID FOR AS TEMPORARY INFORMATION SIGNING.

ALL DIMENSIONS ARE IN INCHES (MILLIMETERS)
UNLESS OTHERWISE SHOWN. ILLINOIS DEPARTMENT OF TRANSPORTATION ARTERIAL ROAD INFORMATION SIGN SCALE: NONE DRAWN BY DESIGN CHECKED BY

DATE = 3/8/2807 NAME = Kardamatokv GCALE = 58,880 / P PLOT PLOT USER

---ARROWBOARD TYPE C (FLASHING A BAR OR 4-CORNER) TO STA. FED. ROAD DIST. NO. ILLINOIS FED. AID PROJECT C-91-100-07 M-8003 (736) BE PREPARED TO STOP TRUCKS ENTERING FLAGGER AHEAD -FROM LEFT (48"x48" W21-I104c) (48"x48" FLAG & FLASHER) APPROX. 500' APPROX. 500' APPROX. 500' FLAGGER WITH CONTROL SIGN TRAFFIC DIRECTION

#### METHOD OF FLAGGING

## NOTE:

- 1. SIGNS SHALL BE MOUNTED AT A MINIMUM CLEARANCE HEIGHT OF 5 FEET
- 2. ALL SIGNS SHALL BE REMOVED WHEN THE FLAGGING OPERATION CEASES.
- 3. THIS CASE ALSO APPLIES WHEN THE WORK ZONE IS ON THE RIGHT. UNDER THESE CONDITIONS "TRUCKS ENTERING FROM RIGHT" SIGNS SHALL BE SUBSTITUTED FOR "TRUCKS ENTERING FROM LEFT" SIGNS. ALSO THE ARROWBOARD AND "BE PREPARED TO STOP" SIGNS SHALL BE RELOCATED TO THE RIGHT SIDE OF THE ROAD.
- 4. WORK ZONE ACCESS POINTS SHOULD BE A MINIMUM OF ONE HALF MILE APART. MEDIAN WORK ZONE ACCESS POINTS SHOULD NOT BE LOCATED OPPOSITE OF EACH OTHER.
- 5. NIGHTIME FLAGGING OPERATIONS: THE FLAG STATION SHALL BE LIGHTED WITH ADDITIONAL LIGHTS OTHER THAN STREET LIGHTS. THE FLAGGER CONTROL SIGN AND THE FLAGGER'S VEST SHALL BE REFLECTORIZED. IN ADDITION, THE FLAGGER SHALL HAVE A FLASHLIGHT OR LIGHTED WAND.

| DEVICE         | NC I          |                     |                     |
|----------------|---------------|---------------------|---------------------|
| REVISIONS DATE |               | ILLINOIS DEPARTMEN  | T OF TRANSPORTATION |
| NAME           |               |                     |                     |
| RAY RITCHIE    | 5/10/00       |                     |                     |
|                |               |                     |                     |
|                |               |                     |                     |
|                |               | METHOD O            | F FLAGGING          |
|                |               |                     |                     |
|                |               |                     |                     |
|                | $\overline{}$ |                     |                     |
|                |               |                     |                     |
|                |               | SCALE: NOT TO SCALE | DRAWN BY C.A.D.     |
|                |               | D.T. 0.45.10005     | A                   |
|                |               | DATE: 2/15/2006     | CHECKED BY          |
|                |               |                     | BM-14               |

Ortobration Design Third Ortotal - Expires 4-30-07

REVISION DATE: 05/10/00

CONTRACT NO.83990